MONTGOMERY SISAM ARCHITECTS INC. ARCHITECTURAL

21511.F01

ISSUED FOR REVIEW

FLOORING REPLACEMENT
FUDGER HOUSE
LONG-TERM CARE HOMES AND SERVICES

439 Sherbourne St, Toronto, ON M4X 1K6



Long-Term Care Homes and Services Division

PHASING & CONSTRUCTION NOTES

1.THE WORK OF THIS CONTRACT SHALL BE PERFORMED IN PHASES. ALL PHASING WILL BE SUBJECT TO APPROVAL FROM THE MANAGER OF BUILDING SERVICES AND AS IDENTIFIED IN THE MINISTRY OF HEALTH OPERATIONAL PLAN FOR THE WORK

2.ALL WORK WITHIN THIS PROJECT WILL BE COMPREHENSIVELY SCHEDULED WITH THE HOME PRIOR TO START-UP ON SITE. CONTRACTORS WILL BE REQUIRED TO ADHERE TO THIS SCHEDULE FOR THE DURATION OF THE WORK. NO WORK SHALL BE LEFT IN AN UNFINISHED STATE AT DAYS END. ALL AREAS OF WORK SHOULD BE MADE SAFE AND COMPLETELY OPERATIONAL AT THE END OF EACH DAYS WORK. ALL REPLACEMENT WORK WITHIN RESIDENT ROOMS IS EXPECTED TO TAKE PLACE OVER THE COURSE OF A SINGLE DAY. RESIDENT ROOMS ARE TO BE COMPLETE AND FULLY OCCUPIABLE AT THE COMPLETION OF EACH DAYS WORK OMITTING THE NEED TO RELOCATE RESIDENTS. RESIDENT ROOMS SHOULD BE RETURNED TO THE RESIDENT EXACTLY AS THEY WERE HANDED OVER TO THE CONTRACTOR THAT MORNING. REFER ALSO TO THE OPERATIONAL PLANS ISSUED FOR EACH HOME.

3.THE REQUIRED MOVING AND REINSTALLATION OF ALL FURNITURE IS TO BE INCLUDED IN THE BASE BID PRICE. IT IS EXPECTED THAT ALL AREAS WILL BE HANDED BACK. TO THE HOME IN A RESTORED AND FULLY FUNCTIONAL ORDER BY THE CONTRACTOR. TEMPORARY STORAGE FOR ALL REMOVED FURNITURE AND EQUIPMENT WILL BE PROVIDED BY AND COORDINATED WITH THE HOME.

- 4.THE CONTRACTOR SHALL PROVIDE THE FOLLOWING MOCK-UPS:
- CONSTRUCT ONE (1) RESIDENT ROOM, INCLUDING BUT NOT LIMITED TO NEW FLOORING, NEW BASE, PATCH / REPAIR WORK AND ALL OTHER WORK AS PER THE
- ARRANGE FOR THE CONSULTANTS REVIEW AND ACCEPTANCE, ALLOW 48HRS AFTER ACCEPTANCE BEFORE PROCEEDING WITH WORK. MOCK-UP MAY REMAIN AS PART OF THE WORK IF ACCEPTED BY THE CONSULTANT. REMOVE AND DISPOSE OF MOCK-UPS THAT DO NOT CONFORM TO THE WORK. UPON ACCEPTANCE, MOCK-UP SHALL SERVE AS A MINIMUM STANDARD OF QUALITY FOR THE BALANCE OF THE RELATED WORK. THE LOCATION OF THE MOCK-UPS SHALL BE DETERMINED BY

GENERAL NOTES


- 1. REPAIR, PATCH & MAKE GOOD ALL EXISTING STRUCTURE AND FINISHES AFFECTED BY CONSTRUCTION.
- 2. ALL REQUIRED CUTTING & FITTING INCLUDING ELECTRICAL & MECHANICAL TO CONNECT THE EXISTING WORK WITH THE NEW WORK SHALL BE PERFORMED AS PART OF THIS CONTRACT AS AN ENTIRE OR COMPLETE WORK IN A PROFESSIONAL AND WHOLE MANNER.
- 3. ALL NEW WORK TO MAKE GOOD EXISTING; SHALL MATCH EXISTING IN MATERIAL, CONSTRUCTION AND FINISH UNLESS OTHERWISE SPECIFIED.
- 4. CONTRACTOR SHALL PERFORM ALL NECESSARY DEMOLITION, ALTERATIONS AND NEW CONSTRUCTIONS AS REQUIRED TO MAKE THE WORK A COMPLETE JOB, INCLUDING BUT NOT LIMITED TO WORK SHOWN ON DRAWINGS AND SPECIFICATIONS.
- 5. ANY OPENINGS IN FIRE RATED WALLS, CEILINGS AND FLOORS TO BE RETURNED TO EQUIVALENT CONDITION PRIOR TO THE OPENING. ALL ELECTRICAL & MECHANICAL PENETRATIONS TO BE SEALED WITH FIRE STOP MATERIAL AS PER SPECIFICATION. ALL ELECTRICAL & MECHANICAL PENETRATIONS TO BE SEALED WITH FIRE STOP
- MATERIAL AS REQUIRED BY O.B.C.

 6. All ITEMS INDICATED IN THE CONTRACT DOCUMENTS AS 'COORDINATION ITEMS' OR ITEMS IDENTIFIED AS NIC, INCLUDING BUT NOT LIMITED TO EQUIPMENT AND OTHER SPECIALTY ITEMS IDENTIFIED AS TO BE SUPPLIED AND INSTALLED BY OTHER PARTIES OR ALLOWANCES WILL REQUIRE THE COMMON ACTION OR EFFORT OF THE
- GENERAL CONTRACTOR IN RELATION TO THE OVERALL PROJECT. WITH RESPECT TO ALL COORDINATION ITEMS IDENTIFIED, THE GENERAL CONTRACTOR IS EXPECTED TO:

 a. REVIEW ALL ITEMS IDENTIFIED AS 'COORDINATION ITEMS' IN THE DRAWINGS AND COMMUNICATE WITH THE REQUIRED RESPONSIBLE PARTIES OF THE DEVICES THE DETAILED REQUIREMENTS OF EACH ITEM AS IT IMPACTS THE WORK OF GENERAL CONTRACTOR AND AS IT RELATES TO THE OVERALL COMPLETION OF THE PROJECT.
- b. VERIFY THE EXISTING CONDITION AND ANY LIMITATIONS OF THE DEVICE AS INSTALLED IN THE PROPOSED LOCATION.

 c. PROVIDE ALL REQUIRED ROUGH-INS, RELATED CONSTRUCTIONS AND CONNECTIONS REQUIRED BY THE DEVICES OF OTHERS TO SUIT THE COORDINATION ITEM AND AS INDICATED IN THE CONTRACT DOCUMENTS.
- d. SCHEDULE AND COORDINATE THE WORK OF OTHERS INTO THE OVERALL CONSTRUCTION SEQUENCE TO AVOID UNNECESSARY DELAY TO THE COMPLETION OF THE
- OVERALL PROJECT.
- e. ENSURE THAT THE PROPOSED ITEM IS INSTALLED AS INTENDED AND IS MADE FULLY OPERATIONAL AT THE COMPLETION OF THE WORK.
- 7. THE EXISTING PORTIONS OF THESE PLANS ARE TAKEN FROM ARCHIVE DRAWINGS AND LIMITED SITE SURVEY INFORMATION. CONTRACTOR TO SITE VERIFY ALL DIMENSIONS, CONDITIONS AND LEVELS ON SITE PRIOR TO FABRICATIONS/ INSTALLATIONS. ALL DIMENSIONS ARE PER SITE REVIEW AND EXIST. ARCH. DWGS. ALL DISCREPANCIES BETWEEN CONDITIONS SHOWN AND SITE CONDITIONS ARE TO BE REPORTED TO THE ARCHITECT. PRIOR TO SUBMITTING A BID, THE CONTRACTOR SHALL VISIT THE SITE AND EXAMINE THE FOLLOWING:
- i: VERIFY EXISTING AREAS WITHIN THE SCOPE OF WORK WITH RESPECT TO THE PROPOSED FOR PROBLEMS AND ANY LIMITATIONS.
 ii: VERIFY EXISTING ARCHITECTURE, STRUCTURE AND ALL ADJACENT FINISHES IMPACTED BY THE WORK.
- UPON EXAMINING ALL OF THE ABOVE AGAINST THE DRAWINGS AND SPECIFICATIONS AND TERMS OF THE CONTRACT, THE CONTRACTOR MUST SATISFY HIMSELF THAT THE PROPOSED WORK CAN BE CARRIED OUT AS INTENDED, TO THE SATISFACTION OF THE OWNER, AT NO ADDITIONAL COST TO THE CONTRACT.
- 8. PROTECT ALL FINISHES TO REMAIN PART OF THE FINAL PRODUCT. ALL FINISHES DAMAGED AS A RESULT OF CONSTRUCTION SHALL BE MADE GOOD BY THE GC.
- 9. COORDINATE ALL WORK WITH THE HOME AND FOLLOW ALL HOME PROTOCOLS.
- 11. COORDINATE ALL WORK WITH ARCHITECTURAL DRAWINGS AND SPECIFICATIONS. WHERE A DISCREPANCY IS DISCOVERED BETWEEN THE DOCUMENTS NOTIFY THE ARCHITECT
- 12. ALL REMOVED AND DEMOLISHED MATERIAL TO BE REMOVED FROM THE SITE. LOCATION OF REMOVAL RECEPTACLE TO BE CO-ORDINATED WITH BUILDING MAINTENANCE DEPARTMENT.

	FINISH / MATERIAL / PRODUCT SCHEDULE							
REFERENCE	PRODUCT	MANUFACTURER	TYPE	COLOUR	COMMENTS			
CC1	COVE CAP	ALTRO	C7	FULL COLOUR RANGE	COLOUR TO BE VERIFIED BY ARCHITECT.			
FL01	SHEET FLOORING	FORBO	LINOLEUM	FULL COLOUR RANGE	COLOUR TO BE VERIFIED BY ARCHITECT.			
FL02	SHEET FLOORING	FORBO	LINOLEUM	FULL COLOUR RANGE	COLOUR TO BE VERIFIED BY ARCHITECT.			
FL03	RESILIENT SHEET FLOORING	ALTRO	ORCHESTRA	FULL COLOUR RANGE	COLOUR TO BE VERIFIED BY ARCHITECT.			

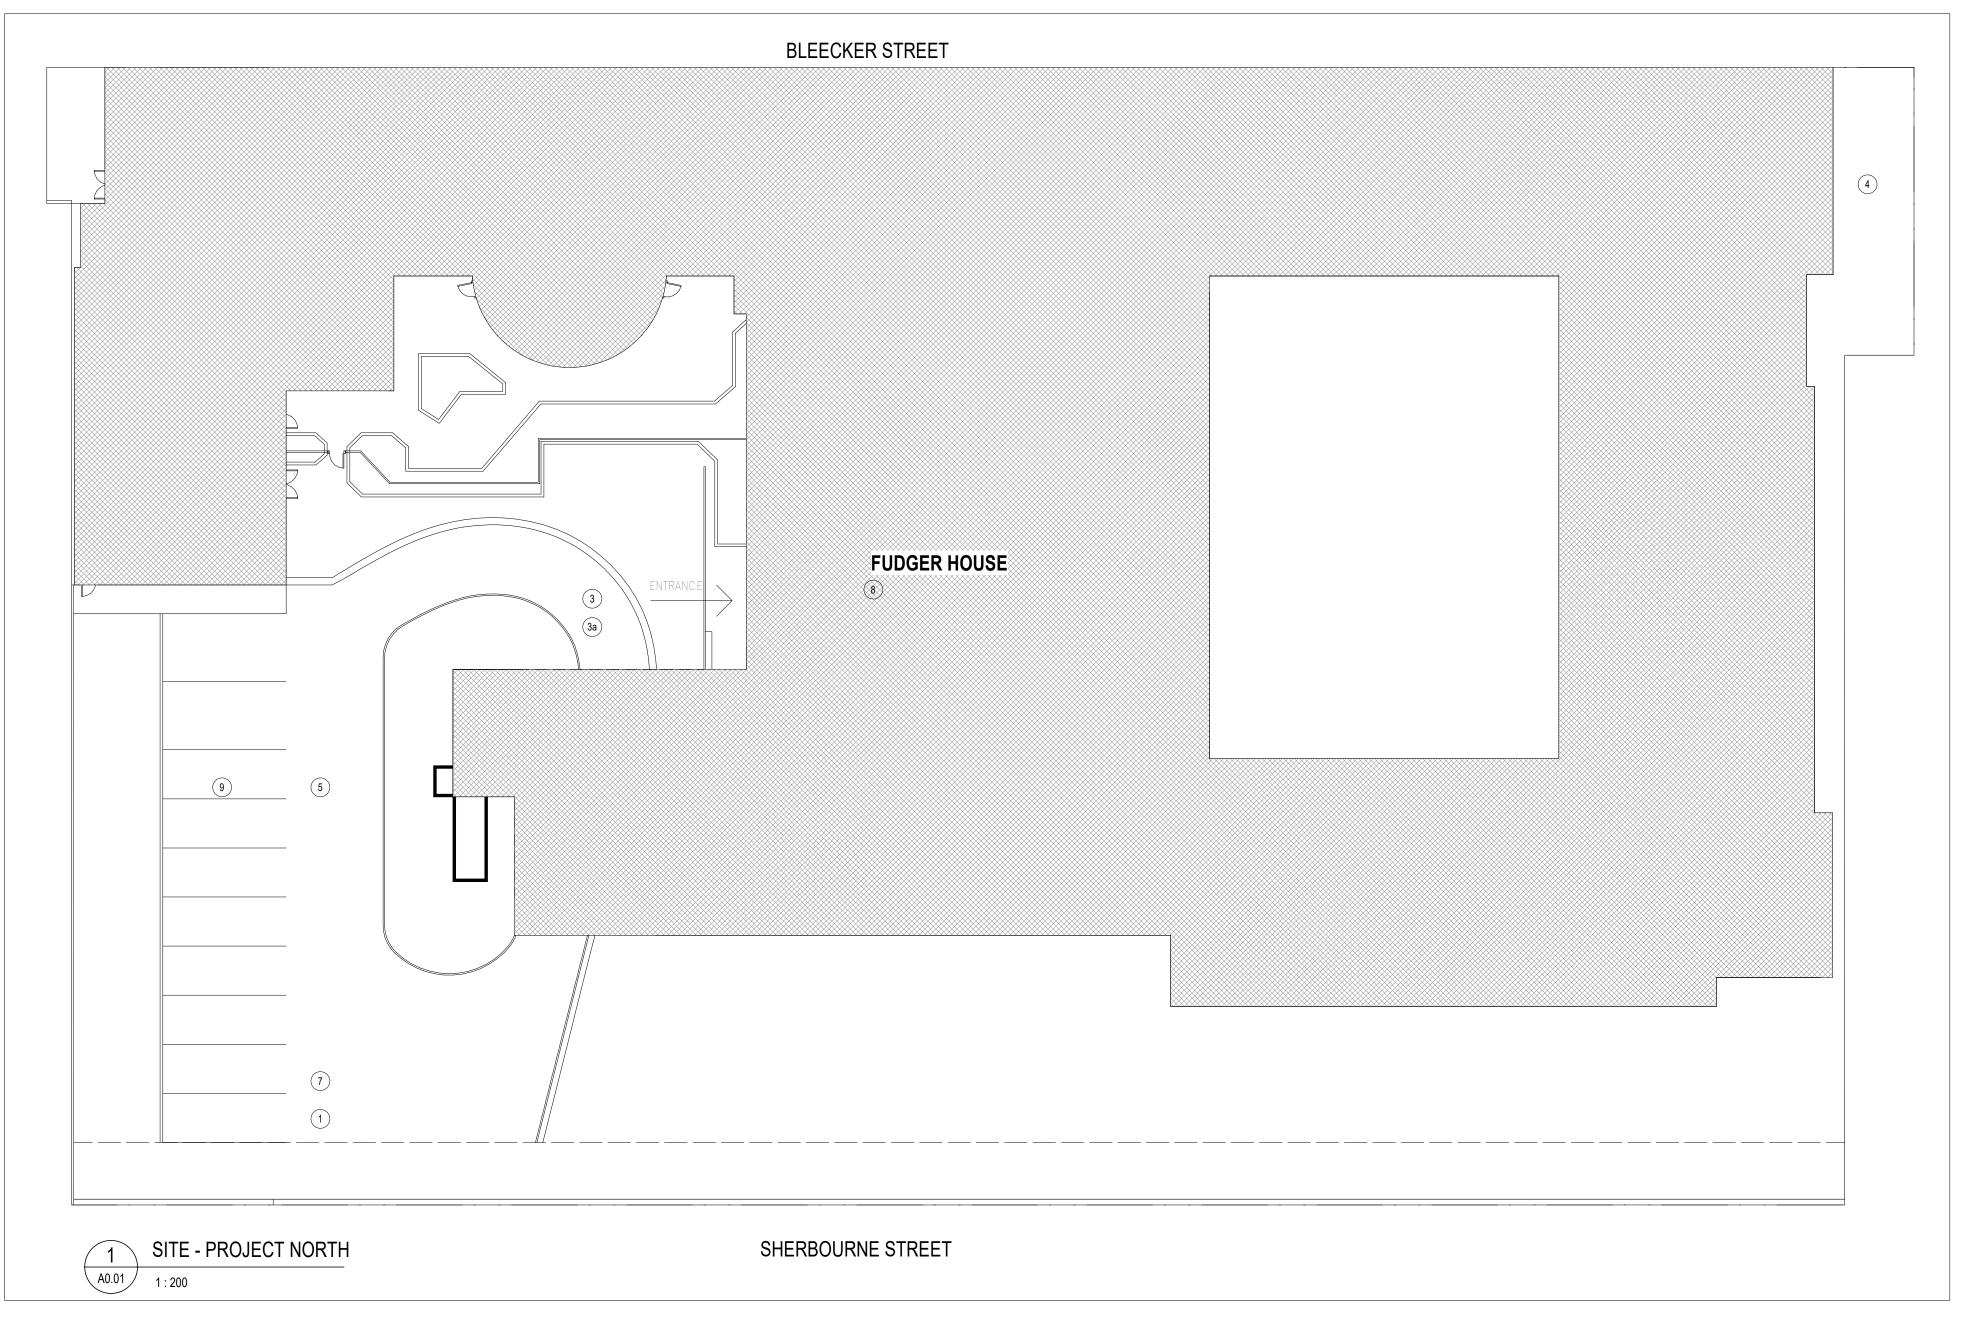

DEMOLITION AND INSTALLATION NOTES FOR ALL DRAWINGS

- TEMPORARILY REMOVE ALL FURNITURE AND EQUIPMENT IN FLOOR REPLACEMENT AREAS. STORAGE LOCATION TO BE
- COORDINATED WITH BUILDING MAINTENANCE DEPARMENT.

 DEMOLISH ALL EXISTING FLOORING AND BASE TO EXISTING SUBSTRATE AS INDICATED ON DRAWINGS. REPAIR ANY CRACKS AND/OR SKIM COATS FOR NEW LEVEL FLOOR FINISH. REMOVE EXISTING FLOOR ALONG WELD SEEM WHERE POSSIBLE.
- CLEAN AND PREPARE SURFACES FOR NEW FLOORING AS REQUIRED.

 EXISTING DRAINS TO REMAIN. PROTECT DURING DEMOLITION. IF EXISTING FLOOR DRAIN IS NOT CLAMPING FOLLOW
- MANUFACTOR FLOORING INSTRUCTION FOR MODIFICATION OF EXISTING FLOOR DRAINS.

 ALL REMOVED AND DEMOLISHED MATERIAL TO BE REMOVED FROM THE SITE. LOCATION OF REMOVAL RECEPTACLE TO BE
- COORDINATED WITH BUILDING MAINTENANCE DEPARTMENT.
- ALL BASEBOARD HEATER COVERS INTERFERING WITH INSTALLATION OF NEW BASE TO BE TEMPORARILY REMOVED AND RE-INSTATED AFTER COMPLETION OF THAT SECTION OF WORK. CONTRACTOR TO COORDINATE WITH OWNER.
- ALL EXISTING CORNER GUARDS IMPACTED BY REPLACEMENT OF FLOOR BASE TO BE REMOVED IF REQUIRED, MODIFIED AS REQUIRED AND RE-INSTATED.
- EXISTING MILLWORK TO REMAIN. DEMOLITION AND NEW FLOOR REPLACEMENT AREA OF WORK TO BE COMPLETED UP TO BASE OF EXISTING MILLWORK. PROTECT MILLWORK AND MAKE GOOD OF ANY DAMAGES.
- CONTRACTOR SHALL REPAIR SUBFLOOR AS REQUIRED BY MANUFACTURE SPECIFICATION OF FINISHED FLOOR MATERIAL.

 REPAIR PITS & CRACKS. LEVEL AS REQUIRED. APPLY SELECTIVE SORTED COATS & SELF LEVELER TO ENSURE NO TELEGRAPHING OF SUBFLOOR. ASSUME TOLERANCE OF ±1/2" FOR SELF LEVELING.
- REPAIR ANY CONSTRUCTION DAMAGE. TOUCH UP PAINT TO MATCH EXISTING COLOURS WHERE REQUIRED THROUGHOUT DUE TO DEMOLITION WORK.
- 03 IN CASE OF NEW PENETRATION IN WALLS/FLOORS MAKE GOOD AND REPAIR AS REQUIRED.
- PROTECT/HOARD ALL AREAS OF WORK AS REQUIRED DURING RENOVATION WORK. PROVIDE DUST TIGHT FLOOR TO CEILING HOARDING ASSEMBLY TO FULLY SEPARATE ALL AREAS OF WORK FROM OCCUPIED AREAS OF THE HOME TO THE SATISFACTION OF THE BUILDING SERVICES MANAGER AND THE MINISTRY OF HEALTH OPERATIONAL PLAN FOR THE WORK.
- 05 PROTECT FINISHED INSTALLATION AFTER INSTALLATION IS COMPLETE.
- BUILDING EXPANSION JOINTS TO BE MAINTAINED DURING DEMOLITION AND INSTALLATION. ANY VOIDS IN STRUCTURAL CONCRETE ADJACENT TO EXPANSION JOINTS TO BE MADE GOOD CREATING A LEVEL SURFACE ON EITHER SIDE OF JOINT.
- 07 ALL JOINTS BETWEEN EXISTING SHEET FLOORING AND NEW SHEET FLOORING TO BE WELDED CREATING A SEAMLESS TRANSITION.
- NEW FLOORING TO BE DRESSED AROUND AND SEALED AGAINST EXISTING FLOOR DRAINS, POP UPS AND PROTRUDING PIPE
- WORK.

 MAKE GOOD ALL WALL DAMAGED BY THE REMOVAL OF EXISTING WALL BASE. NEW WALL TO MATCH EXISTING ABOVE. TAPE
- 10 RE-INSTATE EXISTING FURNITURE AND EQUIPMENT AS PER ORIGINAL LAYOUT.

ALL JOINTS NO FINISH REQUIRED BELOW LINE OF NEW WALL BASE.

- 11 RE-INSTATE EXISITING CORNER GUARDS AS PER ORIGINAL LOCATION.
- NEW FLOORING NEED NOT GO ALL THE WAY UNDER BASEBOARD DIFFUSERS. REFER DEMO NOTE D06.

ABBREVIATION SCHEDULE

AFF ABOVE FINISHED FLOOR ADJ ADJUSTABLE BSM BUILDING SERVICE MANAGER CG CORNER GUARD CJ CONTROL JOINT CMU CONCRETE MASONRY UNIT CONC CONCRETE CO CLEAN OUT CTCERAMIC TILE CR CLOSET RAIL COVE COVE/INTEGRAL BASE C/W COMPLETED WITH DO DOOR OPERATOR DU DUPLEX RECEPTACLE PLATE DIA. DIAMETER **ELEV ELEVATION** ELEMERGENCY LIGHT **ECPEXISTING CONDITION PHOTO** E.GWB EXISTING WALL BOARD FAFIRE ALARM DEVICE FECFIRE EXTINGUISHER CABINET FHCFIRE HOSE CABINET FDFIRE DAMPER FIX FIXED

FIN FINISH

FLR FLOOR

GA GAUGE

GALV GALVANIZED

GB GRAB BAR

FRRFIRE RESISTANT RATING

ACTACOUSTIC CEILING TILE

LVT LUXURY VINYL TILE MAT'L MATERIAL MAX MAXIMUM MIN MINIMUM MIR MIRROR M.GWB MOISTURE RESISTANT GWB MG MED.GASES N/A NOT APPLICABLE NC NURSE CALL NIC NOT IN CONTRACT NTSNOT TO SCALE O.C.ON CENTRE O/H OVER HEAD PLAMPLASTIC LAMINATE +PLUS/MINUS PLY PLYWOOD PSPULL STATION PTW PRESSURE TREATED WOOD PTPAINT PTDPAPER TOWEL DISPENSER QU QUAD RECEPTACLE PLATE

GWB GYPSUM WALL BOARD

HIM HOLLOW INSULATED METAL

HC HOLLOW CORE

HD HAND DRYER

HM HOLLOW METAL

HB HOSE BIB

HTHFIGHT

INT INTERIOR

L.L. LOOSE LINTEL

SIM SIMII AR SO EMERGENCY SHUT OFF SSPEAKER SSTL STAINLESS STEEL STL STEEL STNSTONE SVSHEET VINYL TEMPTEMPORARY TTHERMOSTAT TERRTERRAZZO T.O. TOP OF TYP TYPICAL U/S UNDERSIDE OF U.N.O. UNLESS NOTED OTHERWISE VBVAPOUR BARRIER V.I.F. VERIFY IN FIELD VR VAPOUR RETARDER WD WOOD WE WINDOW FILM WP WALL PROTECTION WS WINDOW SHADE

RCP REFLECTED CEILING PLAN

RSFRESILIENT SHEET FLOORING

SCR SHOWER CURTAIN ROD

R.O.ROUGH OPENING

SD SOAP DISPENSER

SH SHOWER

ZV ZONE VALVE

SFSAFETY FLOORING

SHEET LIST

Sheet Number

GENERAL INFORMATION

Sheet Name

TYPICAL RESIDENT ROOM - SEAMING DIAGRAM, DETAILS

MontgomerySisam

Montgomery Sisam Architects Inc.

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197 Spadina Avenue, Toronto, Ontario M5T 2C8 montgomerysisam.com

SITE LEGEND

- ACCESS TO SITE
- DESIGNATED PARKING AREA FOR CONSTRUCTION VEHICLES(RESERVED)
- ACCESS TO DESIGNATED PARKING
- (2a) AREA FOR CONSTRUCTION VEHICLES(RESERVED)
- (3) MAIN ENTRANCE(3a) SERVICE ENTRANCE
- 4 LOADING DOCKS
- 5 EQUIPMENT AND MATERIAL DROP-
- 6 RESERVED
- 7 ACCESS FOR EMERGENCY VEHICLES
- 8 MEETING AREA FOR SITE VISITS
- 9 VISITOR PARKING

1 21.11.12 Issued for Review
date: revision:

All drawing and specifications are the property of the architect. The contractor shall verify all dimensions and information on site and report any discrepancy to architect before proceeding.

FUDGER HOUSE - FLOORING REPLACEMENT

439 Sherbourne St, Toronto, ON M4X 1K6


revisions

GENERAL INFORMATION

scale: As indicated
drawn by: SK
reviewed by: AR
job number: 21511.F01
plot date: 2021-11-12

drawing number:

A0.01

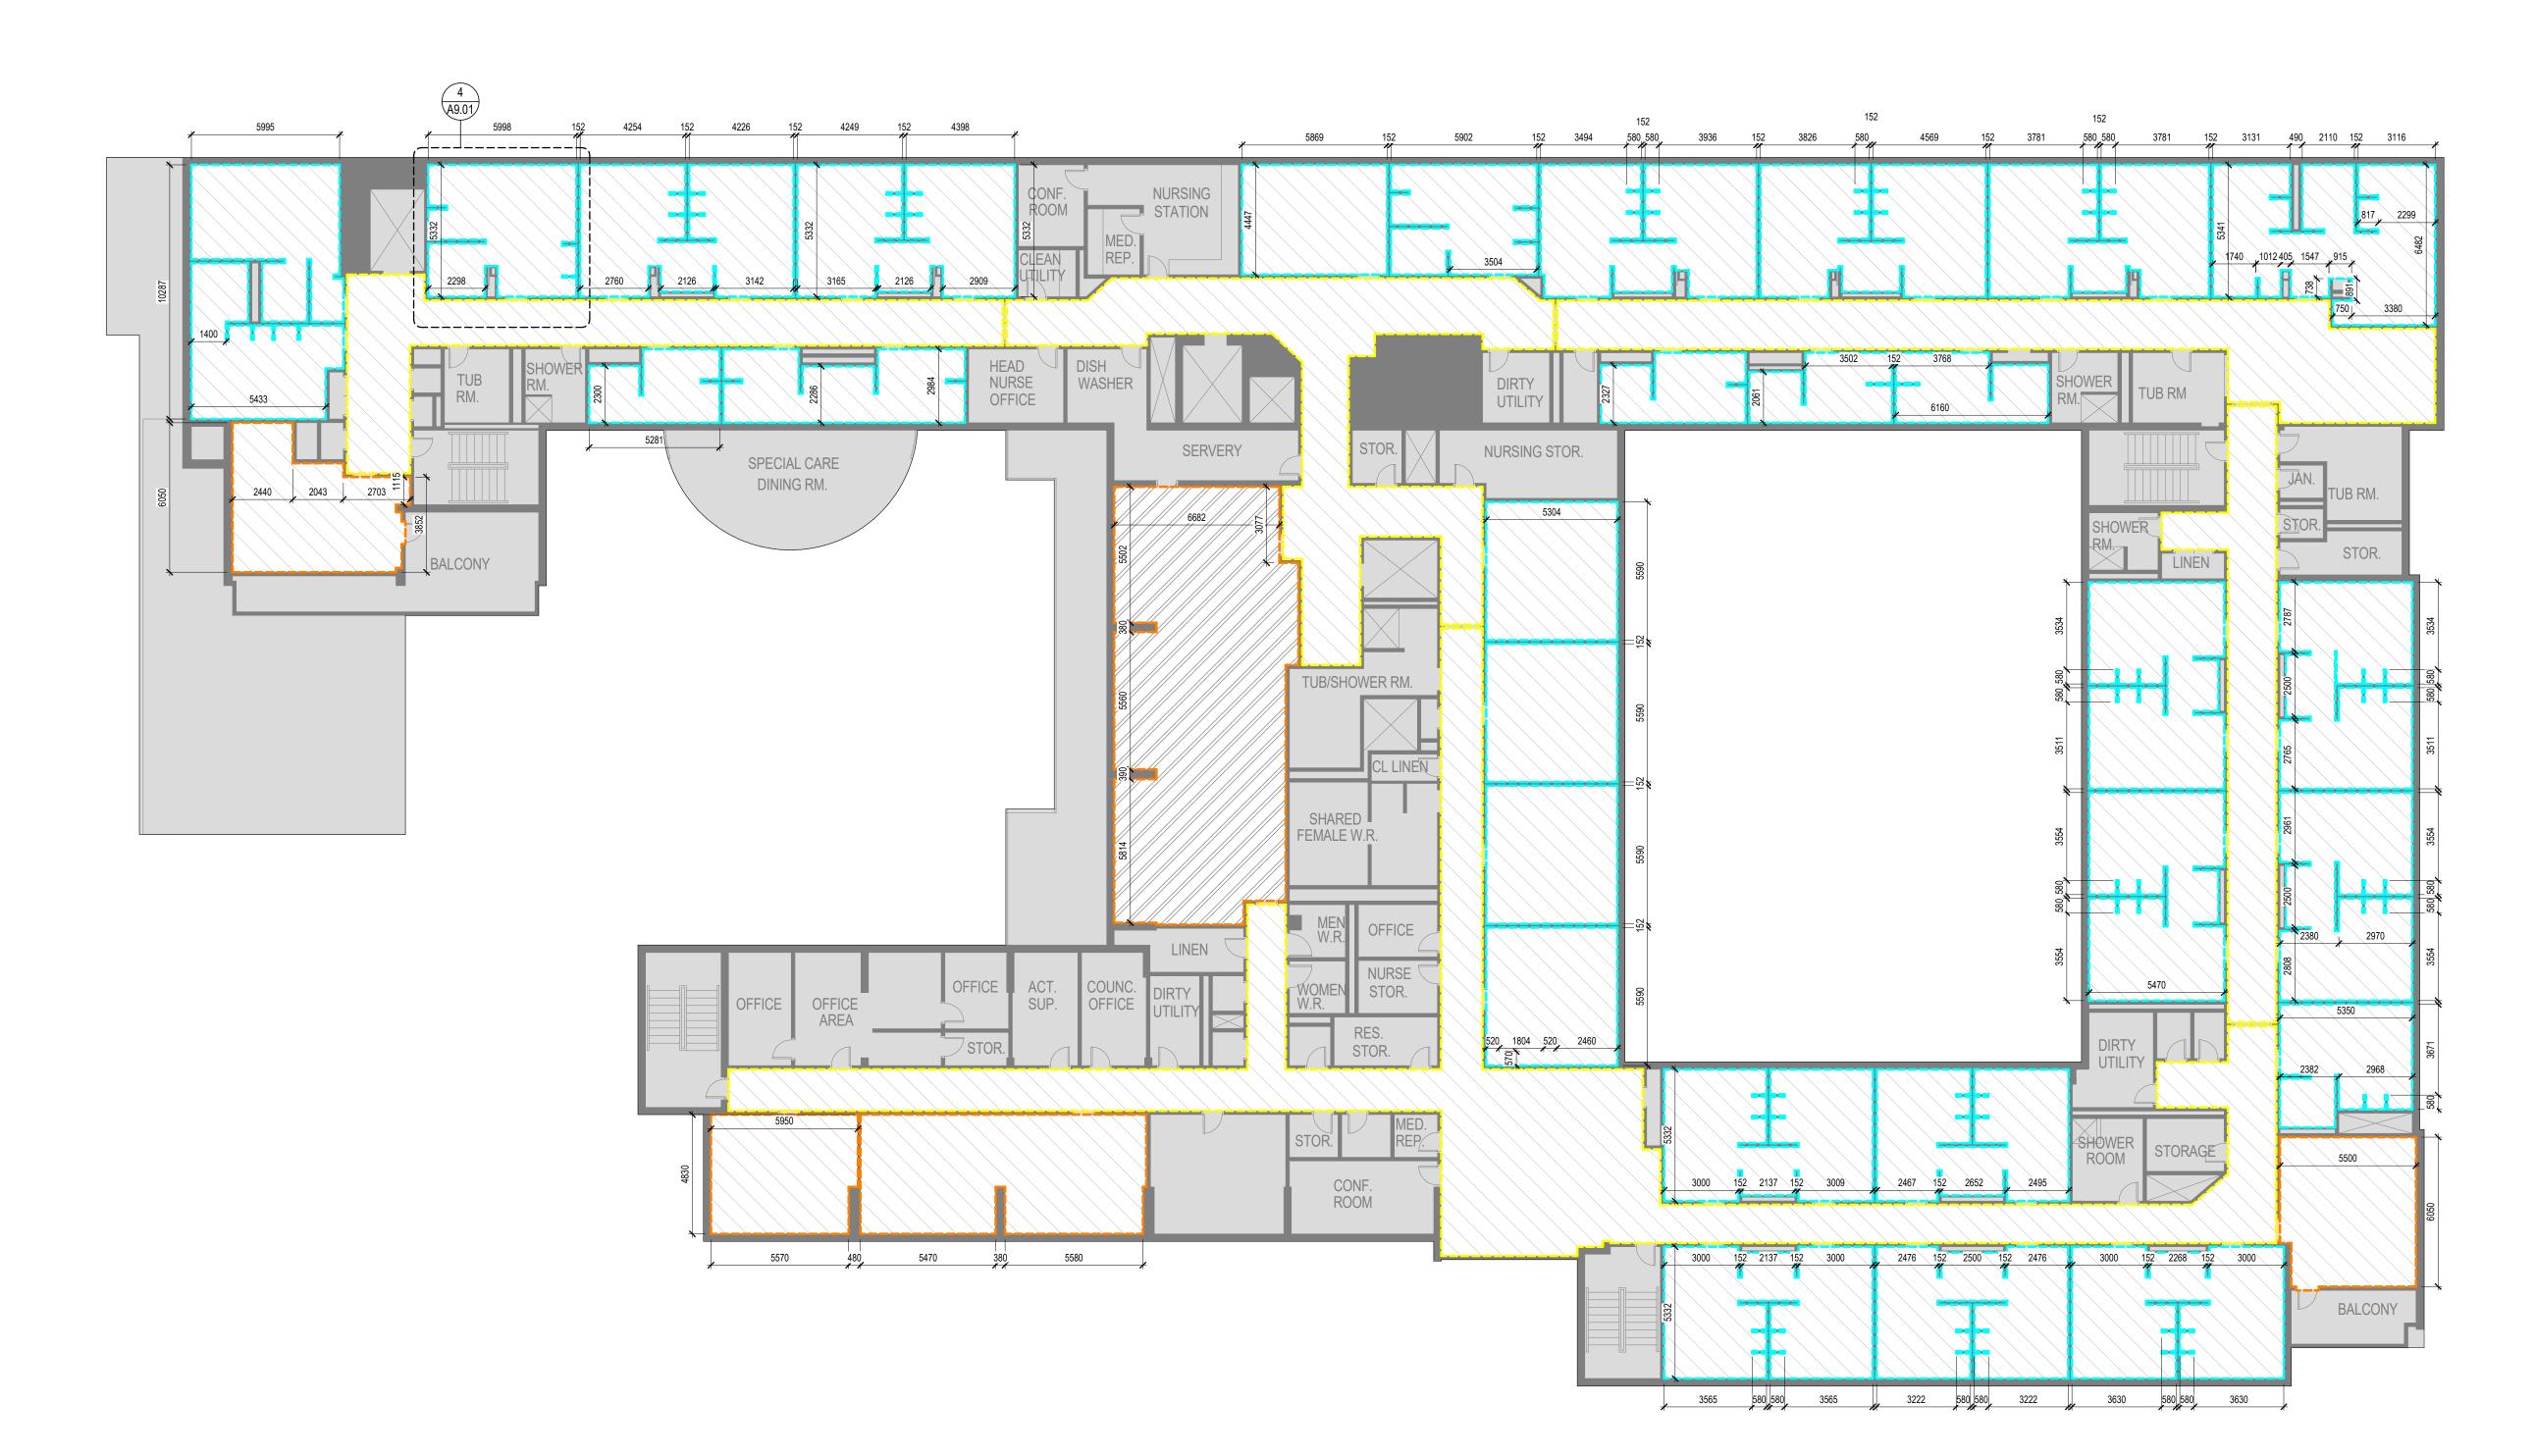


SECOND FLOOR PLAN - AREA OF WORK

1 : 150

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AREA OF WORK LEGEND

- BASE SCOPE RESIDENT ROOMS
- ALTERNATE PRICE AREA COMMON AREAS
- ALTERNATE PRICE AREA CORRIDORS
- EXISTING AREA TO REMAIN AS-IS

AREA
1,025 M ² / 11,033 SF
270 M ² / 2,906 SF
514 M ² / 5,532 SF

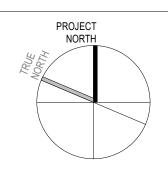1810 M² / 19,500 SF

TOTAL

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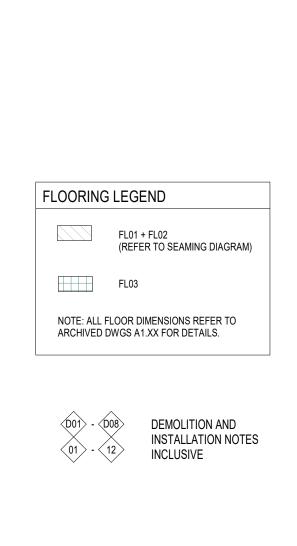
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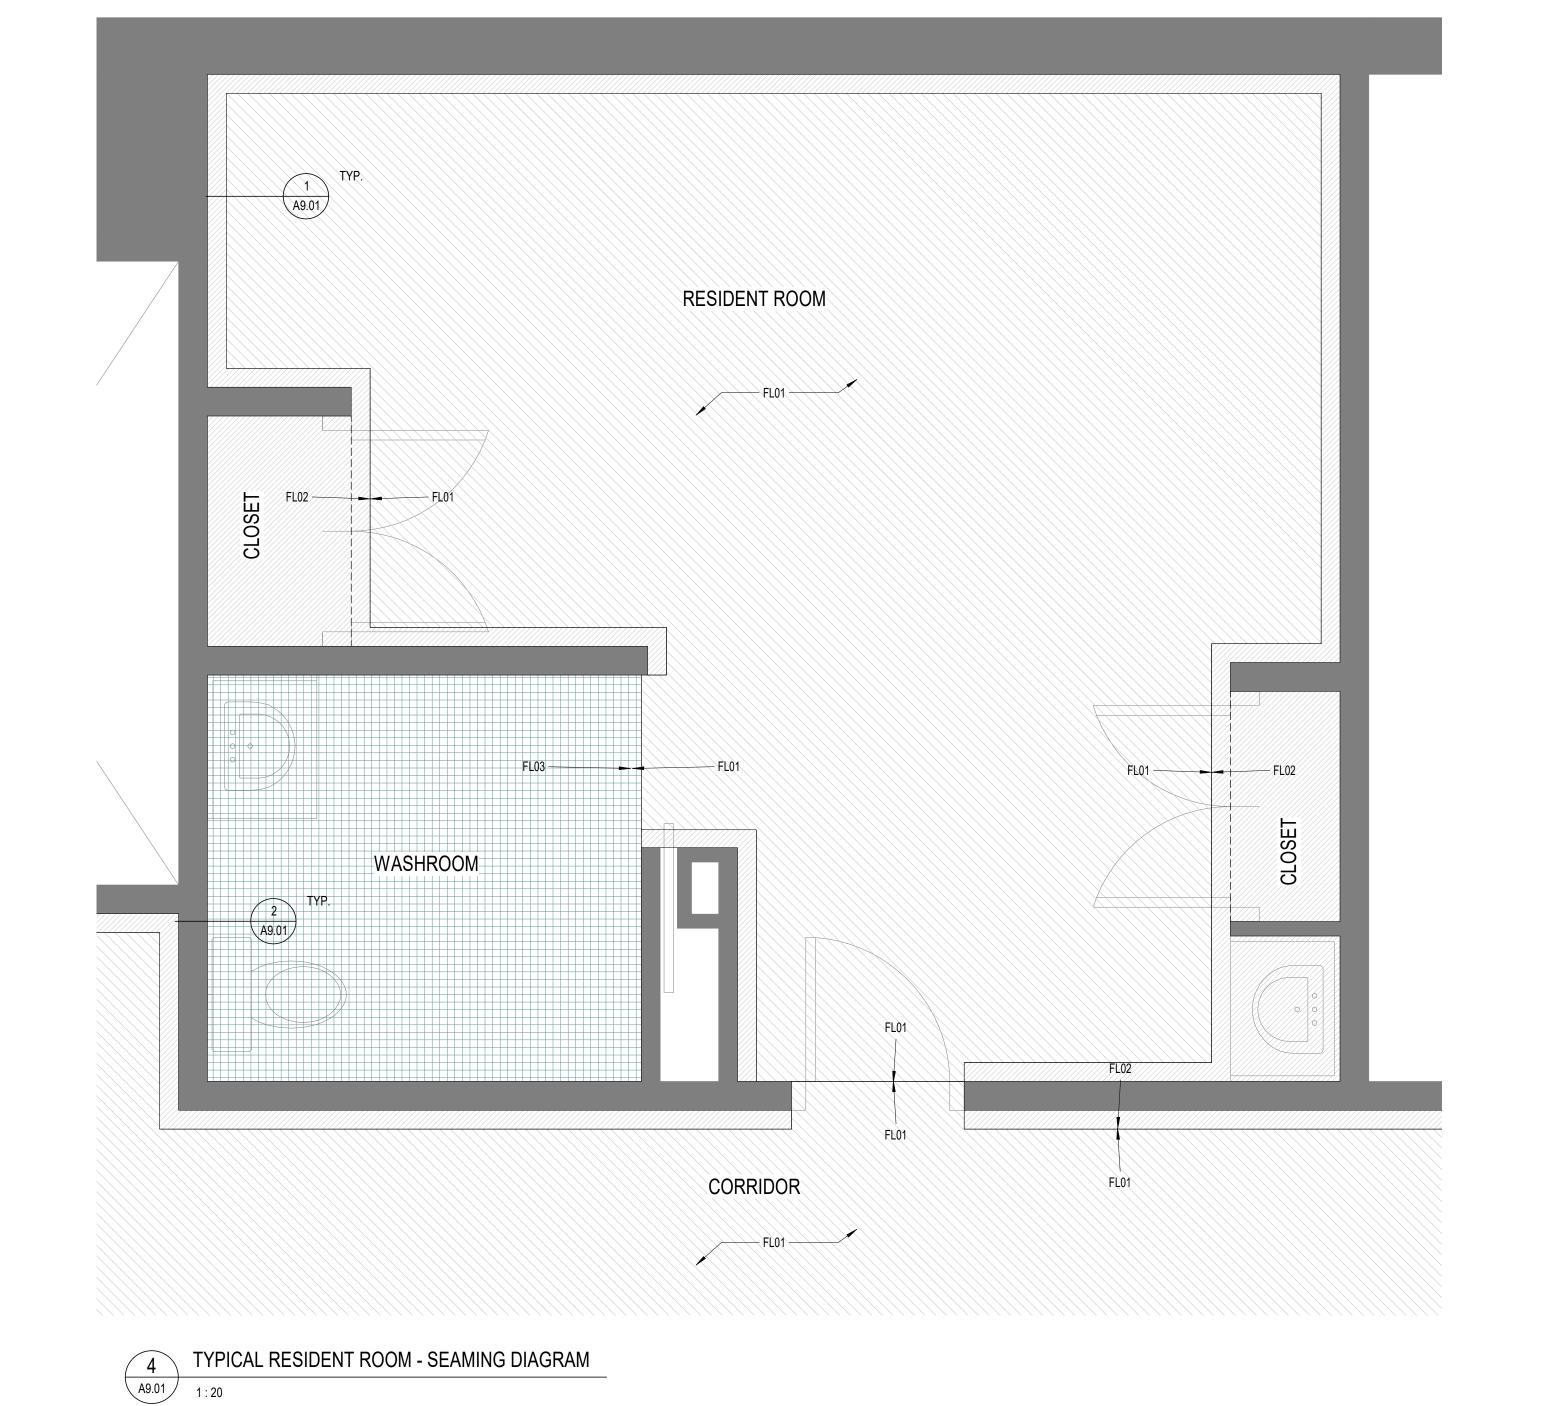
PLANS


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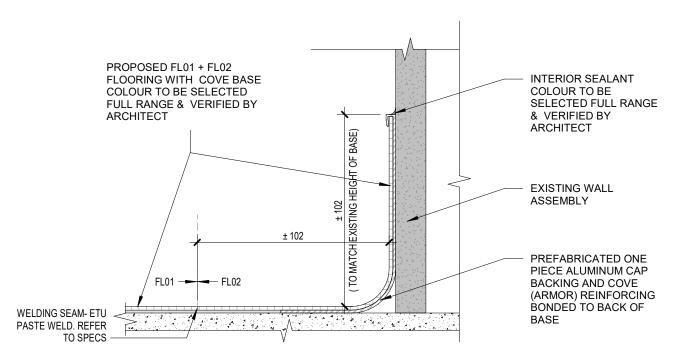
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TYP. NEW COVE BASE FOR FLOORING - F03



TYP. NEW COVE BASE FOR FLOORING 'FL01 + FL02'

1:2

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TYPICAL RESIDENT ROOM -SEAMING DIAGRAM, DETAILS
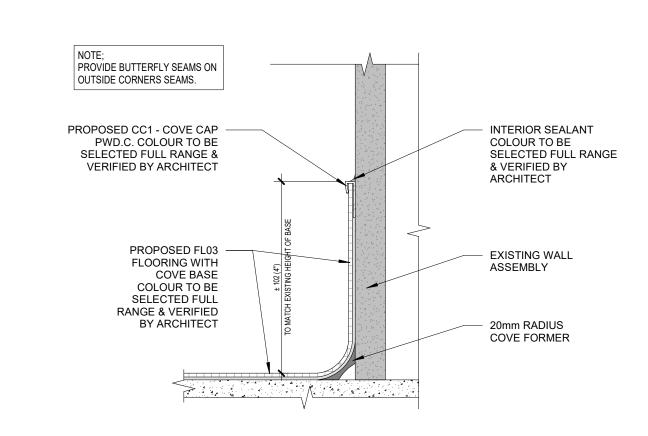
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