


VPCH OFFICE EXPANSION

155 Queen Street North Hamilton, Ontario, L8R 2V6



SEALS

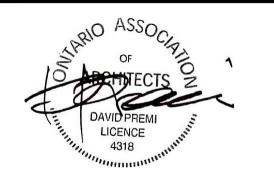

DATE: 06 SEPTEMBER 2023

ARCHITECT: **DPAI Architecture Inc.**25 Main Street West Hamilton, Ontario L8P 1H1 Canada T: (905) 522-0220

ARCHITECTURAL

DRAWING #	DRAWING TITLE
A00	COVER SHEET / NOTES
A00.00	COVER SHEET
A00.01	CONSULTANT INFORMATION & DRAWING INDEX
A00.02	GENERAL NOTES & OBC MATRIX
A00.03	ASSEMBLIES SCHEDULE
SP01	SITE
SP01.00	SITE SURVEY
SP01.01 SP01.02	SITE DEMOLITION PLAN FOCUSED SITE PLAN & SITE PLAN STATISTICS
SP01.02 SP01.03	SITE PLAN
A01	PLANS
A01.00	REFERENCE PLAN
A01.01	DEMOLITION PLAN - LEVEL 1
A01.02	DEMOLITION PLAN - LEVEL 1 FLOOR FINISHES
A01.03	DEMOLITION PLAN - LEVEL 1 REFLECTED CEILING PLAN LEVEL 1
A01.04 A01.05	RENOVATION PLAN - LEVEL 1 ADDITION PLAN - LEVEL 2
A01.06	ROOF PLAN
A01.07	FLOOR FINISH PLAN - LEVEL 1
A01.08	FLOOR FINISH PLAN - LEVEL 2
A01.09	FLOOR FURNITURE PLAN - LEVEL 1
A01.10	FLOOR FURNITURE PLAN - LEVEL 2
A01.11	WALL FINISH PLAN - LEVEL 1
A01.12	WALL FINISH PLAN - LEVEL 2
A01.13	REFLECTED CEILING PLAN - LEVEL 1
A01.14	REFLECTED CEILING PLAN - LEVEL 2
A02	ELEVATIONS
A02.00	DEMOLITION ELEVATIONS
A02.01	DEMOLITION ELEVATIONS
A02.02	EXTERIOR ELEVATIONS
A02.03 A02.04	EXTERIOR ELEVATIONS INTERIOR ELEVATIONS & MOUNTING HEIGHT SCHEDULE
402	DETAILS
A03 A03.00	DETAILS WASHROOM DETAILS
A03.01	WASHROOM DETAILS WASHROOM DETAILS
A03.02	WASHROOM DETAILS
A03.03	MILLWORK DETAILS
A03.04	MILLWORK DETAILS
A03.05	MILLWORK DETAILS
A03.06	MILLWORK DETAILS
A03.07	MILLWORK DETAILS
A03.08	MILLWORK DETAILS
A03.09	RESERVED - PLAN DETAILS
A03.10	RESERVED - PLAN DETAILS RESERVED - PLAN DETAILS
A03.11 A03.12	RESERVED - PLAIN DETAILS RESERVED - SECTION DETAILS
A03.12	RESERVED - SECTION DETAILS RESERVED - SECTION DETAILS
A03.14	RESERVED - SECTION DETAILS
A04	SECTIONS
A04.00	BUILDING SECTIONS
A04.01	WALL SECTIONS
A04.02	WALL SECTIONS
A04.03	WALL SECTIONS
A04.04	WALL SECTIONS
A04.05	RESERVED - WALL SECTIONS
A05	ADDITIONAL DRAWINGS
A05.00	ACCESSIBILITY REFERENCE PLAN
A05.01	FIRE, LIFE SAFETY, AND AODA PLAN - LEVEL 1
A05.02	FIRE, LIFE SAFETY, AND AODA PLAN - LEVEL 2
A05.03	DOOR & GLAZING SCHEDULES
0.115-114	HARDWARE SCHEDULE
A05.04	FUDNITUDE MATERIAL & FINIOUEC COUERUS EC
A05.04 A05.05 A05.06	FURNITURE, MATERIAL & FINISHES SCHEDULES PLUMBING, EQUIPMENT & ACCESSORIES SCHEDULES

STRUCTURAL ENGINEER:

MTE Consultants Inc.

1016 Sutton Drive, Unit A

Burlington, Ontario L7L 6B8 Canada
T: (905) 639-2552

STRUCTURAL

DRAWING #	DRAWING TITLE
S0.01	COVER SHEET
S0.02	GENERAL NOTES
S0.03	GENERAL NOTES
S1.01	EXISTING PARTIAL LEVEL 1 FRAMING PLAN
S1.02	EXISTING PARTIAL PARKING ROOF PLAN
S1.03	PROPOSED ELEVATED 2ND FLOOR FRAMING PLAN
S1.04	PROPOSED ROOF FRAMING PLAN
S2.01	STEEL ELEVATIONS
S3.01	BASEPLATE DETAILS
S4.01	2ND FLOOR SECTIONS
S4.02	2ND FLOOR SECTIONS
S4.03	ROOF SECTIONS
S5.01	COLUMN SCHEDULE

MECHANICAL ENGINEER:

MCW Consultants Ltd.

27 Queens's Quay West, Suite 615

Toronto, Ontario M5J 1A7 Canada

T: (416) 598-2920

MECHANICAL

DRAWING #	DRAWING TITLE	
M0.01	DRAWING LIST, LEGEND, & GENERAL NOTES	
M1.01	LEVEL 1 WASHROOM HVAC PLANS	
M1.02	LEVEL 1 HVAC PLAN	
M1.03	LEVEL 2 HVAC PLAN	
M1.04	ROOF HVAC PLAN	
M1.05	LEVEL 1 HVAC DEMO PLAN	
M3.01	MECHANICAL DETAILS	
M5.01	LEVEL 1 WASHROOM FIRE PROTECTION PLANS	
M5.02	LEVEL 1 FIRE PROTECTION PLAN	
M5.03	LEVEL 2 FIRE PROTECTION PLAN	
M5.04	LEVEL 1 FIRE PROTECTION DEMO PLAN	
M6.01	MECHANICAL SCHEDULES	
P1.01	LEVEL 1 WASHROOM PLUMING PLANS	
P1.02	LEVEL 1 PLUMBING PLAN	
P1.03	LEVEL 2 PLUMBING PLAN	
P1.04	LEVEL 1 PLUMBING DEMO PLAN	

ELECTRICAL ENGINEER:

MCW Consultants Ltd.

27 Queens's Quay West. Suite 6

27 Queens's Quay West, Suite 615 Toronto, Ontario M5J 1A7 Canada T: (416) 598-2920

ELECTRICAL

DRAWING #	DRAWING TITLE
E0.00	ELECTRICAL LEGEND AND DRAWING LIST
E1.01	LEVEL 01 - ELECTRICAL PLAN - WASHROOM
E1.02	LEVEL 01 - LIGHTING PLAN - OFFICE
E1.03	LEVEL 02 - LIGHTING PLAN - OFFICE
E1.04	LEVEL 01 - POWER & SYSTEMS PLAN - OFFICE
E1.05	LEVEL 02 - POWER & SYSTEMS PLAN - OFFICE
E1.06	LEVEL 01 - LIGHTING DEMOLITION PLAN - OFFICE
E1.07	LEVEL 01 & P1 - POWER & SYSTEMS DEMOLITION PLAN - OFFICE
E3	ELECTRICAL DETAILS
E5	ELECTRICAL SINGLE LINE DIAGRAM AND PANEL SCHEDULES



VPCH OFFICE EXPANSION

155 QUEEN ST NORTH HAMILTON, ONTARIO



25 Main Street West Hamilton, Ontario L8P 1H1 Canada

T: 905-522-0220

DRAWINGS ARE NOT TO BE SCALED.

CONTRACTOR MUST VERIFY ALL DIMENSIONS ON THE JOB AND REPORT ANY DISCREPANCY TO ARCHITECTS BEFORE PROCEEDING WITH WORK.

ALL DRAWINGS AND SPECIFICATIONS ARE THE PROPERTY OF THE ARCHITECT AND MUST BE RETURNED AT THE COMPLETION OF THE WORK.





Key Plan:	
157 162 45 50 24 49 185 186 186	
151 156 41 181 184 184 184 184 184 184 184 184	
146 33 40 172 16 174 172 16	
70 142 29 5	
136 25 05 150 150 151 151 151 151 151 151 151	
21 19 17 17 151	
144	
130	

03	ISSUED FOR TENDER	2023.09.03
02	PERMIT REVISION 01	2023.07.20
01	ISSUED FOR PERMIT	2023.05.16
NO.	ISSUES/REVISIONS	DATE
DRAWIN	NG TITLE:	

CONSULTANT INFORMATION & DRAWING INDEX

ISSUE DATE:	2023.09.
DRAWN BY: MM	CHECKED BY:
PROJECT NO.: 12228	SCALE: N
DRAWING NO.:	REVISIO

A00.01

01

GENERAL NOTES

GRAPHIC SYMBOLS:

+ 254.400

PROJECT NORTH

GRID REFERENCE

EXISTING GRID REFERENCE

- INDICATES SKETCH SHEET

ON WHICH REVISION IS SHOWN

EXISTING ELEVATION

NEW ELEVATION

- INDICATES REVISION

NUMBER

GENERAL REQUIREMENTS

- 1. ALL WORK SHALL CONFORM TO THE REQUIREMENTS OF ALL EXISTING BY-LAWS, CODES, MUNICIPAL GOVERNMENTS AND AUTHORITIES HAVING JURISDICTION. OBTAIN ALL PERMITS REQUIRED IN ACCORDANCE WITH THE CONTRACT.
- 2. GENERAL CONTRACTOR AND SUBTRADES SHALL READ ALL THE GENERAL NOTES WITHIN THE CONTRACT DOCUMENTS. GENERAL NOTES CONTAIN INFORMATION THAT IS ESSENTIAL TO UNDERSTANDING AND EXECUTION OF THE SCOPE OF WORK
- 3. IT IS STRONGLY ADVISED THAT THE CONTRACTOR ENSURE ALL SUBTRADES REFER AND COORDINATE WITH A-SERIES DRAWINGS IN THE EXECUTION OF THEIR RESPECTIVE SCOPE OF
- 4. DRAWINGS ARE TO BE READ IN CONJUNCTION WITH MECHANICAL, ELECTRICAL, AND STRUCTURAL DRAWINGS
- 5. DRAWINGS ARE TO BE READ IN CONJUNCTION WITH SEPARATE DEMOLITION PERMIT/TENDER DRAWING PACKAGE. APPLICABLE SCOPE IS AS SHOWN IN THIS COMPLETE CONTRACT
- 6. DETAILS ILLUSTRATED HEREIN ARE REPRESENTATIVE OF THE CHARACTER, QUALITY, AND PROFILES REQUIRED FOR THE WORK. CONDITIONS NOT COVERED BY SPECIFIC DETAILS ARE SIMILAR TO THOSE DETAILED.
- 7. ALL DIMENSIONS SHALL BE VERIFIED ON SITE. CONTRACTOR TO NOTIFY CONSULTANT IMMEDIATELY OF ANY DISCREPANCIES PRIOR TO COMMENCEMENT OF WORK AND ORDERING OF
- 8. DO NOT SCALE THE DRAWINGS. VERIFY ALL CONDITIONS ON-SITE BEFORE PROCEEDING WITH WORK. ANY CONFLICT OR DISCREPANCY BETWEEN INFORMATION ON DRAWINGS AND ACTUAL FIELD CONDITIONS SHOULD BE BROUGHT TO THE ARCHITECT'S ATTENTION FOR RESOLUTION PRIOR TO COMMENCING WORK
- 9. GENERAL CONTRACTOR SHALL COORDINATE AND PROVIDE IN FULL FOR ALL SIGNAGE, FENCES, AND FREQUENT REMOVAL OF DEBRIS FROM THE SITE.
- 10. GENERAL CONTRACTOR SHALL PAY FOR AND COORDINATE ANY FIRE ALARM/SMOKE AND/OR HEAT DETECTOR BY-PASSES/RESTORATION.
- 11. GENERAL CONTRACTOR SHALL BE RESPONSIBLE FOR ANY SCANNING, CORING, & MOISTURE TESTING (ATM-2170) OF EXISTING CONCRETE SLABS, FLOOR FINISHES AND WALL BASES TO BE INSTALLED AS PER MANUFACTURERS RECOMMENDED INSTALLATION AND TECHNIQUES INCLUDING MOISTURE RETARDANT & ADHESIVES.

CORRIDOR

CUBIC

COURSE (S)

CERAMIC TILE

CEMENT BOARD

NUMBER

─ IF SIMILAR

✓ IF SIMILAR

NOTE AS SHOWN

DETAIL NUMBER

A-00 X

DETAIL NUMBER

CRS

CU

∕— IF SIMILAR

NUMBER

— IF SIMILAR

NUMBER

─ IF SIMILAR

NUMBER

NOTE AS SHOWN

- INDICATES SECTION

NOTE AS SHOWN

NOTE AS SHOWN

- INDICATES DETAIL

- INDICATES DRAWING SHEET

ON WHICH DETAIL IS SHOWN

(CROSS REFERENCING)

- INDICATES ELEVATION

- INDICATES DRAWING SHEET

ON WHICH DETAIL IS SHOWN

- INDICATES DRAWING SHEET

ON WHICH DETAIL IS SHOWN

(CROSS REFERENCING)

(CROSS REFERENCING)

CWB

GEORGIAN WIRED GLASS

GYPSUM TEXTURE SPRAY

HOSE BIBB

HAND DRYER

GXT

ABBRE	VIATIONS:								
A/C	AIR CONDITIONING	D	DRYER	HDWR	HARDWARE	NV	NAPKIN VENDOR	SUSP	SUSPENDED
A/V	AIR/VAPOUR	DEMO	DEMOLISH, DEMOLITION	НМ	HOLLOW METAL				
ABV	ABOVE	DET	DETAIL	HORIZ	HORIZONTAL	O/C	ON CENTRE (S)	T/O	TOP OF
ACT	ACOUSTICAL TILE	DF	DRINKING FOUNTAIN	HP	HYDRO POLE	OA	OVERALL	T&G	TONGUE AND GROOVE
AD	AREA DRAIN	DIA	DIAMETER	HPC	HIGH PERFORMANCE COATING	OD	OUTSIDE DIAMETER	Т	TREAD
ADD	ADDENDUM	DIM	DIMENSION	HR	HOSE REEL	ОН	OVERHEAD	TB	TOWEL BAR
ADJ	ADJACENT	DIV	DIVISION	HSS	HOLLOW STEEL SECTION	OPG	OPENING	TBD	TACK BOARD
ADO	AUTOMATIC DOOR OPERATOR	DN	DOWN	HT	HEIGHT	OV	OVEN	TEL	TELEPHONE
AFF	ABOVE FINISHED FLOOR	DR	DOOR	HTG	HEATING	OWSJ	OPEN-WEB STEEL JOIST	TEMP	TEMPERED
ALT	ALTERNATE	DRR	DOOR RELEASE	HTR	HEATER			TP	TELEPHONE POLE
AL/ALUM	ALUMINUM	DW	DISH WASHER	HVAC	HEATING/VENTILATION/	PL	PROPERTY LINE	TPD	TOILET PAPER DISPENSER
AN	ANODIZED	DWR	DRAWER		AIR CONDITIONING	PLAM	PLASTIC LAMINATE	TOL	TOLERANCE
AP	ALUMINUM PANEL	DWG	DRAWING	HWB	HAND WASH BASIN	PLB	PUSH TO LOCK BUTTON	TTD	TOILET TISSUE DISPENSER
APPROX	APPROXIMATE			HWH	HOT WATER HEATER	PCT	PORCELAIN TILE	TV	TELEVISION
AS	ACRYLIC STUCCO	Е	EAST	HWT	HOT WATER TANK	PREFAB	PREFABRICATE (D)	TYP	TYPICAL
AUTO	AUTOMATIC	EL	ELEVATION			PREFIN	PREFINISHED	TZ	TERRAZZO
AVC	AUDIO VISUAL CONTROL PANEL	ELEC	ELECTRIC (AL)	ID	INSIDE DIAMETER	PT	PAINT (ED)		
		ELEV	ELEVATOR	IN	INCH	PTD	PAPER TOWEL DISPENSER	U/C	UNDERCOUNTER
B/O	BOTTOM OF	EOS	EDGE OF SLAB	INCL	INCLUDE (D), (ING)	PTN	PARTITION	U/S	UNDERSIDE
B/S	BOTH SIDES	EP	ELECTRICAL PANEL	INT	INTERIOR	PVC	POLYVINYL CHLORIDE OR	URN	URINAL
BBT	BIO- BASE COMPOSITE TILE	EQ	EQUAL	INV	INVERT		COATING	UTP	UTILITY POLE
BCS	BABY CHANGE STATION	EQUIP	EQUIPMENT						
BD	BOARD	ESP	EXPOSED SLAB PAINTED	JAN	JANITORIAL	R	RISER	VB	VINYL BASE
BLDG	BUILDING	EX	EXISTING	JB	JUCTION BOX	RAD	RADIUS, RADIATOR	VC	VALVE CABINET
BLK	BLOCK	EXH	EXHAUST	JS	JANITORS SINK	RB	RUBBER BASE	VCT	VINYL COMPOSITE TILE
BLKG	BLOCKING	EXP	EXPANSION	JT	JOINT	RCP	REFLECTED CEILING PLAN	VERT	VERTICAL
BLW	BELOW	EXPOS	EXPOSED			RD	ROOF DRAIN	VIF	VERIFY IN FIELD
ВМ	BENCH MARK	EXT	EXTERIOR	KIT	KITCHEN	REC	RECESSED	VT	VINYL TILE
BRG	BEARING					RECP	RECEPTACLE		
BSMT	BASEMENT	FA	FIRE ALARM	LAB	LABORATORY	REF	REFERENCE	W/	WITH
ВТМ	ВОТТОМ	FD	FLOOR DRAIN	LAV	LAVATORY	REV	REVISION (S), REVISED	W/O	WITHOUT
BUR	BUILT UP ROOF	FDTN	FOUNDATION	LB	POUND (S)	RFG	REFRIGERATOR	W	WEST
		FE	FIRE EXTINGUISHER	LKR	LOCKER	RH	ROBE HOOK	WBD	WHITE BOARD
C/C	CENTRE TO CENTRE	FEC	FIRE EXTINGUISHER CABINET	LS	LIGHT STANDARD	RI	RISER	WC	WATER CLOSET
C/L	CENTRE LINE	FFE	FINISHED FLOOR ELEVATION	LT	LIGHT	RM	ROOM	WD	WOOD
C/W	COMPLETE WITH	FH	FIRE HYDRANT	LVR	LOUVRE	RO	ROUGH OPENING	WM	WASHING MACHINE
СВ	CATCH BASIN	FHC	FIRE HOSE CABINET			RP	RESIN PANEL	WO	WINDOW OPENING
CBD	CHALK BOARD	FIN	FINISH (ED)	M	METRE (S)	RT	RUBBER TILE	WPP	WALL PROTECTION PANEL
CG	CORNER GUARD	FLR	FLOOR	MANUF	MANUFACTURE (R)	RWL	RAINWATER LEADER	WR	WASHROOM
CJ	CONTROL JOINT	FT	FOOT	MAS	MASONRY		00171	WSCB	WATER STATION CONTROL BOX
CL	CLOSET	FTG	FOOTING	MAT	MATERIAL (S)	S	SOUTH	WV	WATER VALVE
CLG	CEILING	FUT	FUTURE	MAX	MAXIMUM	SAN	SANITARY	WWM	WELDED WIRE MESH
CLR	CLEAR (ANCE)	FVCB	FLUSH VALVE CONTROL BOX	MECH	MECHANIC (AL)	SD	SOAP DISPENSER		
CM	CENTIMETER (S)	0.4	041105	MEZZ	MEZZANINE	SH	SHOWER		O SCHEDULES FOR
CMU	CONCRETE MASONRY UNIT	GA	GAUGE	MH	MANHOLE	SHT	SHEET	ADDITIO	NAL ABBREVIATIONS
CO	CLEAR OPENING	GALV	GALVANIZED	MIN	MINIMUM	SHL	SHEET LINOLEUM		
COL	COLUMN	GB	GRAB BAR	MISC	MISCELLANEOUS	SHV	SHEET VINYL		
COMP	COMPRESS(IBLE)	GFRC	GLASS FIBRE REINFORCED	MM	MILLIMETRE (S)	SIM	SIMILAR		
CONC	CONCRETE TORRING	OI.	CONCRETE	MOD DIT	MASONRY OPENING	SPEC	SPECIFICATION (S)		
CONCT	CONCRETE TOPPING	GL	GLASS, GLAZING	MOD-BIT	MODIFIED BITUMEN	SPKR	SPEAKER		
CONST	CONSTRUCTION	GLBLK	GLASS BLOCK	MR MR T	MIRROR TILTED	SQ	SQUARE		
CONT	CONTINUOUS OR CONTINUE	GR	GRAPHIC FILM	MR-T	MIRROR - TILTED	SS	STAINLESS STEEL		
CPT T	CARPET (ED)	GRND	GROUND CYDSUM SHEATING	MTL	METAL	STB	SLIDING TACK BOARD STANDARD		
CPT-T	CARPET TILE	GS	GYPSUM SHEATING	MW	MICROWAVE	STD			
CR	CARD READER	GWB	GYPSUM WALLBOARD			SVC	STANDPIPE VALVE CABINET		

ONTARIO BUILDING CODE DATA MATRIX

Name of Practice DPATArchitecture Inc.

25 Main Street West

Sebastian Lubczynski

Name of Project Victoria Park Community Homes Office Expansion

Suite 1800

Location/Address 155 Queen Street North, Hamilton

April 26, 2023

Address 1

Address 2

3.00 BUILDING CODE VERSION

MAJOR OCCUPANCY

3.03 SUPERIMPOSED MAJOR
OCCUPANCIES

3.04 BUILDING AREA (m²)

3.05 GROSS AREA (m²)

3.06 MEZZANINEAREA (m²)

NUMBER OF STREETS/ 3.09 FIREFIGHTER ACCESS

3.10 BUILDING CLASSIFICATION

3.11 SPRINKLER SYSTEM

3.12 STANDPIPESYSTEM

3.13 FIRE A LARM SYSTEM

WATER SERVICE/ 3.14 SUPPLY IS ADEQUATE 3.15 CONSTRUCTION TYPE

3.16 IMPORTAINCE CATEGORY

3.18 OCCUPANT LOAD

3.19 BARRIER-FREE DESIGN

3.22 SPATIAL SEPARATION

3.24 ENERGY EFFICIENCY

3.23 PLUMBING FIXTURE REQUIREMENTS RATIO:

3.21 RATINGS

3.20 HAZARDOUS SUBSTANCES

REQUIRED FIRE RESISTANCE

3.17 SEISMIC HAZARD INDEX $(I_F F_a S_a (0.2)) =$

3.07 BUILDING HEIGHT

3.08 HIGH BUILDING

Contact

3.01 PROJECT TYPE

3.02 CLASSIFICATION

PART 3 - FIRE PROTECTION, OCCUPANT SAFETY AND ACCESSIBILITY

O.Reg. 332/12

OCCUPANCY

DESCRIPTION

DESCRIPTION

TOTAL

TOTAL

TOTAL

3.2.2.56.

Required

DESCRIBE

ACTUAL

LEVEL/AREA

HORIZONTAL ASSEMBLY

FLOORS OVER BSMT

FLOORS

MEZZA NINE ROOF

LEVEL/AREA

COMPLIANCE PATH: CLIMATIC ZONE:

Normal

Not Required

DESCRIPTION

Addition and Renovation

Level 1 - Existing / Renovation Area of Work

Level 1 - Existing / Renovation Area of Work

Level 2 - Addition Area of Work

Washroom Renovation

Business & Personal Services

STOREYS ABOVE GRADE

STOREYS BELOW GRADE

Group D, up to 2 Storeys, Sprinklered

1 STREET(S)

RESTRICTIONS Combustible Permitted

Noncombustible

MATERIAL DESIGNATION			PLAN SYMBOLS:
PLAN/SECTIONS BRICK MASONRY CUT STONE MASONRY	RIGID INSULATION BATT INSULATION/ SOUND ATTENUATION BATTS	PLYWOOD STRUCTURAL STEEL	EXISTING WALL ASSEMBLY TO REMAIN NEW WALL ASSEMBLY EXISTING WALL ASSEMBLY TO BE DEMOLISHED
MARBLE TERRAZZO TILE/ACOUSTIC CEILING TILE	GLASS GLASS BLOCK EARTH	PRECAST CONCRETE/ SOLID SURFACE ALUMINUM	EXISTING DOOR ASSEMBLY TO REMAIN NEW DOOR ASSEMBLY
CONCRETE CONCRETE BLOCK SOLID CORE CONCRETE BLOCK	ROCK GRAVEL FILL SAND, FILL, PLASTER, GYPSUM BOARD & CEMENT	COMPOSITE WOOD BOARD ROOF MEMBRANE/ WATER-PROOFING/AIR VAPOUR BARRIER/DAMPPROOFING	EXISTING DOOR ASSEMBLY TO BE DEMOLISHED EXISTING SCREEN ASSEMBLY TO REMAIN
WOOD (FINISHED) WOOD FRAMING	NATURAL STONE- RIP RAP, FIELD STONE, ETC. SEALANT		NEW SCREEN ASSEMBLY EXISTING SCREEN ASSEMBLY TO BE DEMOLISHED

NAPKIN DISPOSAL


NOT IN CONTRACT

NUMBER

NOT TO SCALE

NO

NTS

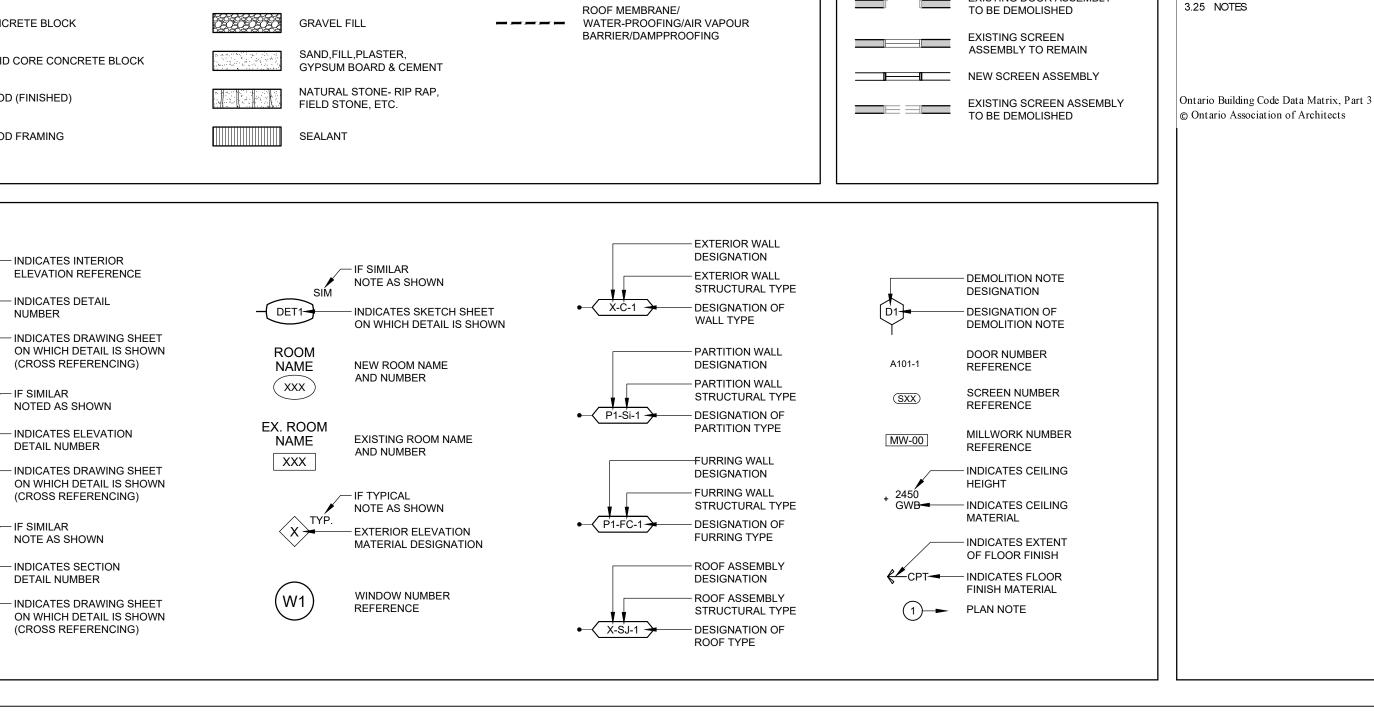

STEEL

STORAGE

STORM

STRUCT STRUCTURAL

STN STATION

STOR

STM



VPCH OFFICE EXPANSION

155 QUEEN ST NORTH HAMILTON, ONTARIO



OBC REFERENCE[1]

[A] 1.1.2.

3.1.2.1.(1)

3.2.2.7.

TOTAL [A] 1.4.1.2.

TOTAL [A] 1.4.1.2.

472.0

472.0

472.0

360.0

832.0

(m) ABOVE GRADE [A] 1.4.1.2. &

TOTAL 3.2.1.1.

3.2.1.1.

3.2.6

3.2.2.10. & 3.2.5.

3.2.2.20-83.

3.2.1.5. & 3.2.2.17.

3.2.9.

3.2.4.

3.2.1.4. 4.1.2.1.(3),

3.1.17.

OCCUPANT LOAD

(PERSONS)

RATING (H) ASSEMBLY (H) LIEU OF RATING? 3.2.1.4.

CONSTRUCTION TYPE CLADDING TYPE 3.2.3.

FIXTURES REQUIRED FIXTURES PROVIDED

T4.1.2.1.B.

4.1.8.18.(1)

3.3.1.2. &

August 2018 *

3 3 1 19

NONCOMBUSTIBLE IN 3.2.2.20.-83,

3.2.2.2.20.-83.

Seal & Signature

0.00

NEW

360.00

360.0

NEW

LAST AMENDMENT O.Reg. 762/20

EXISTING

472.00

472.0

472.00

472.0

EXISTING

TYPE PROVIDED N/A

HEAVY TIMBER CONSTRUCTION

BASED ON

PROVIDED: Entire Building

0.00 Seismic Design Not Required for Table 4.1.8.18. Items 6 to 21

AREA L.D. (m) L/H OR H/L

OCCUPANCY TYPE

MALE: FEMALE = 50:50 EXCEPT AS NOTED OTHERWISE

SENTENCE

OCCUPANT OBC

0.00

EXISTING

USE

Office


25 Main Street West Hamilton, Ontario L8P 1H1 Canada

T: 905-522-0220

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02	ISSUED FOR TENDER	2023.09.06
01	ISSUED FOR PERMIT	2023.05.16
NO.	ISSUES/REVISIONS	DATE
DRAWIN	NG TITLE:	

GENERAL NOTES & **OBC MATRIX**

ISSUE DATE:	2023.09.06
DRAWN BY: MM	CHECKED BY: SL
PROJECT NO.: 12228	SCALE: NTS
DRAWING NO.:	REVISION:

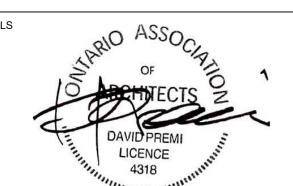

GENERAL NOTES - WALL ASSEMBLES

1. EXTERIOR WALL ASSEMBLIES

- 1. THE SPECIFICATIONS, INSTALLATION, AND PERFORMANCE OF AIR BARRIER SYSTEMS AND VAPOUR BARRIERS MUST MEET OR EXCEED DIV. B PART 5 OF THE ONTARIO BUILDING CODE.
- 2. THE REQUIREMENTS FOR AN AIR BARRIER AND A VAPOUR BARRIER ARE INTENDED TO BE PROVIDED AS CONTINUOUS PLANES WITHIN THE BUILDING ENVELOPE. ENSURE CONTINUITY OF AIR AND VAPOUR MEMBRANES BETWEEN COMPONENTS, TO ADJACENT CONSTRUCTION AND AT ALL
- PENETRATIONS TO PREVENT OR RETARD PASSAGE OF MOISTURE LADEN AIR AND/OR THE DIFFUSION OF WATER VAPOUR. 3. EXTERIOR ASSEMBLIES NOTING STUD FRAMING SHALL BE CONSTRUCTED USING WIND-LOAD BEARING FRAMING DESIGNED TO CARRY REQUIRED LATERAL LOADS. PROVIDE ENGINEERED SHOP DRAWING PRIOR TO COMMENCEMENT OF WORK.

2. INTERIOR WALL ASSEMBLIES

- . GENERAL REQUIREMENTS I. THE CONTRACTOR SHALL NOTIFY THE ARCHITECT OF ANY DISCREPANCIES
- BETWEEN THE ARCHITECTURAL AND STRUCTURAL DRAWINGS AND SPECIFICATIONS PRIOR TO THE COMMENCEMENT OF WORK
- 2. ALL PARTITIONS TO EXTEND TO U/S OF STRUCTURE UNLESS OTHERWISE NOTED. PROVIDE LATERAL BRACING AS REQUIRED 3. FURRING TO EXTEND TO 150MM ABOVE FINISHED CEILING OR TO U/S OF
- STRUCTURE WHERE NO CEILING EXISTS UNLESS OTHERWISE NOTED. REFER
- TO REFLECTED CEILING PLANS 4. WHERE INTERIOR DOORS ARE CLOSE TO AN INSIDE CORNER, PROVIDE MIN.
- 150MM CLEARANCE FROM DOOR JAMB TO ADJACENT WALL. 5. PROVIDE STEEL REINFORCING AS REQUIRED IN ALL INTERIOR GLAZED SCREENS (ALUMINUM OR HOLLOW METAL) TO U/S OF DECK AND/OR FIRE RATED FLOOR ASSEMBLY.

2. LOAD BEARING PARTITIONS (INTERIOR)

1. WHERE A PARTITION IS A LOAD BEARING WALL, REFER TO THE STRUCTURAL DRAWINGS FOR DESIGN REQUIREMENTS. THE CONTRACTOR SHALL NOTIFY THE CONSULTANT OF ANY DISCREPANCIES BETWEEN THE ARCHITECTURAL AND STRUCTURAL DRAWINGS AND SPECIFICATIONS PRIOR TO THE

COMMENCEMENT OF WORK. 3. STEEL STUD FRAMED PARTITIONS (INTERIOR) 1. ALL PARTITIONS ARE TO UNDERSIDE OF DECK UNLESS OTHERWISE NOTED. 2. PROVIDE DEFLECTION DETAIL AT TOP OF ALL WALLS THAT ABUT UNDERSIDE OF DECK OR STRUCTURE. SEE ALSO TOP OF WALL DETAILS AS INDICATED.

3. WHERE SOUND ATTENUATION BATTS ARE CALLED FOR ON THE WALL TYPE.

SEAL PERIMETER OF WALLS AND AROUND PENETRATIONS THROUGH WALLS

SIDES OF TRACK AT THE JUNCTIONS WITH FLOORS AND ROOF DECKS, AND

WITH ACOUSTIC SEALANT, APPLY CONTINUOUS ACOUSTIC SEALANT TO BOTH

CLEARANCE FROM DOOR JAMB TO ADJACENT WALL AS INDICATED ON DETAIL

- AROUND PENETRATIONS TO PARTITIONS. RECESSED OUTLETS ARE TO BE STAGGERED SO THAT ONLY ONE OUTLET IS INSTALLED BETWEEN TWO
- 4. DO NOT FASTEN METAL STUDS TO CURTAIN WALL MULLIONS OR TEE BAR 5. WHERE INTERIOR DOORS ARE CLOSE TO AN INSIDE CORNER, PROVIDE MIN.
- TITLED 'FRAME TYPES' 6. CONTRACTOR SHALL ENSURE STEEL STUD THICKNESS, SIZE AND SPACING IS
- ADEQUATE FOR THE HEIGHTS OF PARTITIONS INDICATED. CONTRACTOR SHALL PROVIDE BRACING AS REQUIRED.
- 7. USE WATER RESISTANT GYPSUM WALL BOARD ON ALL WET SIDES OF PARTITIONS.

4. MASONRY PARTITIONS (INTERIOR) 1. HEIGHT OF CONCRETE MASONRY UNIT WALLS TO BE TO UNDERSIDE OF

FLOOR/ROOF DECK ABOVE UNLESS OTHERWISE NOTED. 2. WHERE CONCRETE UNIT MASONRY WALLS ABUT REINFORCED CONCRETE WALLS AND PIERS, RAKE BACK MORTAR JOINT WHERE THE TWO MATERIALS MEET AND PROVIDE CONTINUOUS SEALANT

5. FIRE RATED PARTITIONS (INTERIOR) 1. FOR WALL ASSEMBLIES THAT DENOTE FRR (FIRE RESISTANCE RATING), THE ASSEMBLY SHALL BE CONSTRUCTED AS A FIRE SEPARATION AT THE LOCATIONS INDICATED IN THE CONTRACT DRAWINGS GRAPHICALLY USING

- LINES AND/OR TEXT AND SYMBOLS 2. AT RECESSED PANEL INSTALLATIONS (E.G. ELECTRICAL PANELS) WITHIN RATED WALLS PROVIDE FOR CONTINUITY OF THE REQUIRED RATING BEHIND THE PANEL. REFER TO THE ONTARIO BUILDING CODE DIVISION B, SECTION
- 3.1.9.2 FOR REQUIREMENTS FOR COMBUSTIBILITY OF SERVICE PENETRATIONS AND SECTION 3.1.10.2 FOR RATING OF FIREWALLS. 3. WHERE FIRE RATED PARTITIONS ABUT NON-RATED PARTITIONS THE FIRE RATED ASSEMBLY SHALL BE CONTINUOUS AND UNINTERRUPTED BY THE
- ABUTTING WALLS TO MAINTAIN A CONTINUOUS FIRE SEPARATION. 4. SEAL PERIMETER OF FIRE RATED WALLS AND AROUND PENETRATIONS THROUGH FIRE RATED WALLS WITH APPROVED FIRESTOP MATERIALS, DO NOT SEAL CLEARANCE SPACES WITHIN FIRE DAMPERS. SEAL ONLY IN STRICT
- ACCORDANCE WITH MANUFACTURERS INSTRUCTIONS 5. WHERE DUCTS, PIPES, AND CONDUITS PENETRATE RATED PARTITIONS. ENSURE FIRE-SEALANT IS PROVIDED IN GAPS/OPENINGS

6. ACOUSTIC PARTITIONS

1. WHERE ACOUSTIC BLANKET INSULATION IS SPECIFIED AS A COMPONENT PART OF A WALL OR PARTITION ASSEMBLY, CONTRACTOR SHALL PROVIDE A CONTINUOUS SEALANT TO BOTH STUDS AND TRACKS ALONG PARTITION

2. IN ACOUSTIC PARTITIONS, RECESSED OUTLETS ARE TO BE STAGGERED, AND CONTINUOUS FLEXIBLE SEALANT SHALL BE PROVIDED AT THE JUNCTIONS WITH FLOORS, CEILINGS AND STRUCTURAL MEMBERS. CONTRACTOR SHALL PROVIDE FLEXIBLE SEALANT AROUND PENETRATIONS IN THE PARTITION.

7. BLOCKING FOR MILLWORK & SPECIALITIES 1. PROVIDE BLOCKING IN PARTITIONS AND WALLS (INTERIOR AND EXTERIOR) FOR THE FOLLOWING:

- 2. WINDOW FRAMES, MILLWORK, FIXTURES AND FITTINGS, HANDRAILS, GRAB
- BARS, TACKBOARDS, WHITEBOARDS, MIRRORS, WASHROOM ACCESSORIES AND OTHER ITEMS AS REQUIRED 3. PROVIDE BLOCKING TO ACCOMMODATE ALL SURFACE MOUNTED AND

FURRED-IN ACCESSORIES AND FIXTURES UNLESS OTHERWISE INDICATED.



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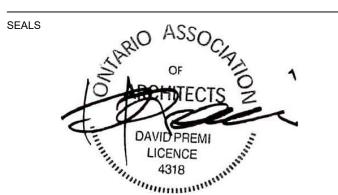
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CONTRACTOR MUST VERIFY ALL DIMENSIONS ON THE JOB AND REPORT ANY

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DISCREPANCY TO ARCHITECTS BEFORE PROCEEDING WITH WORK.






03	ISSUED FOR TENDER	2023.09.06
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01	ISSUED FOR PERMIT	2023.05.16
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ASSEMBLIES SCHEDULE

DRAWING TITLE:

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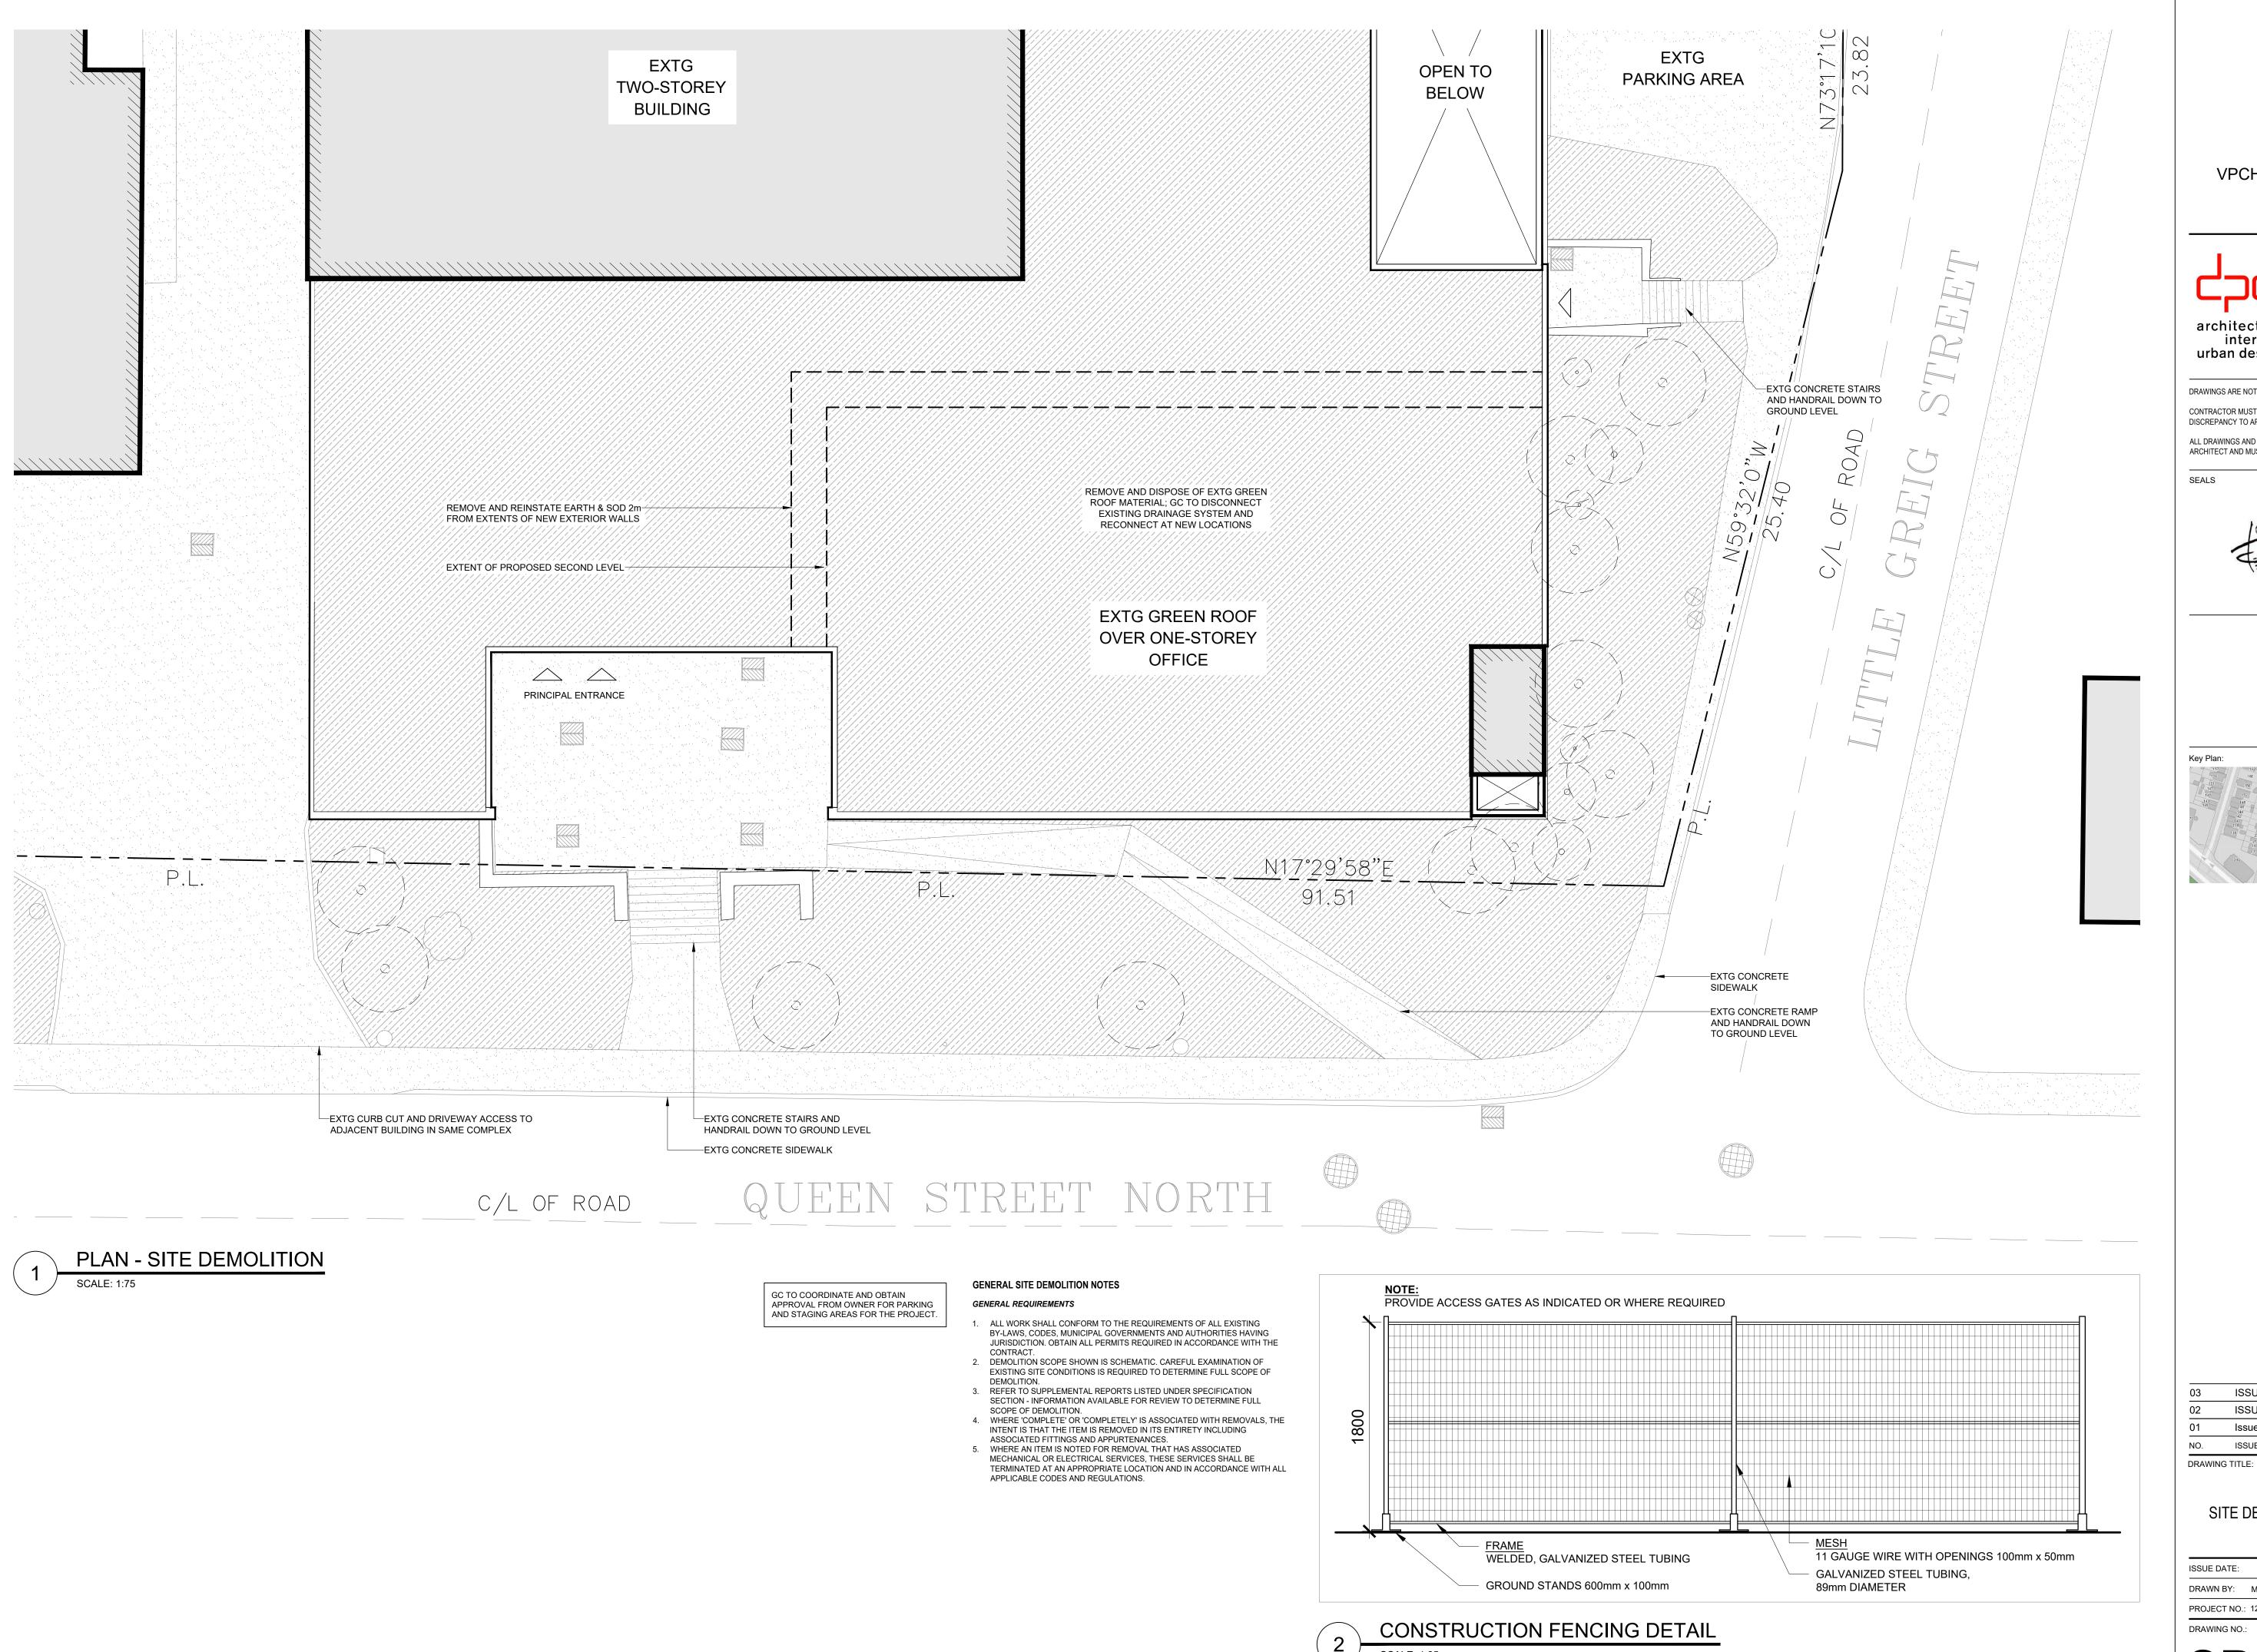
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SITE SURVEY

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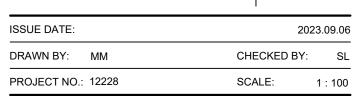
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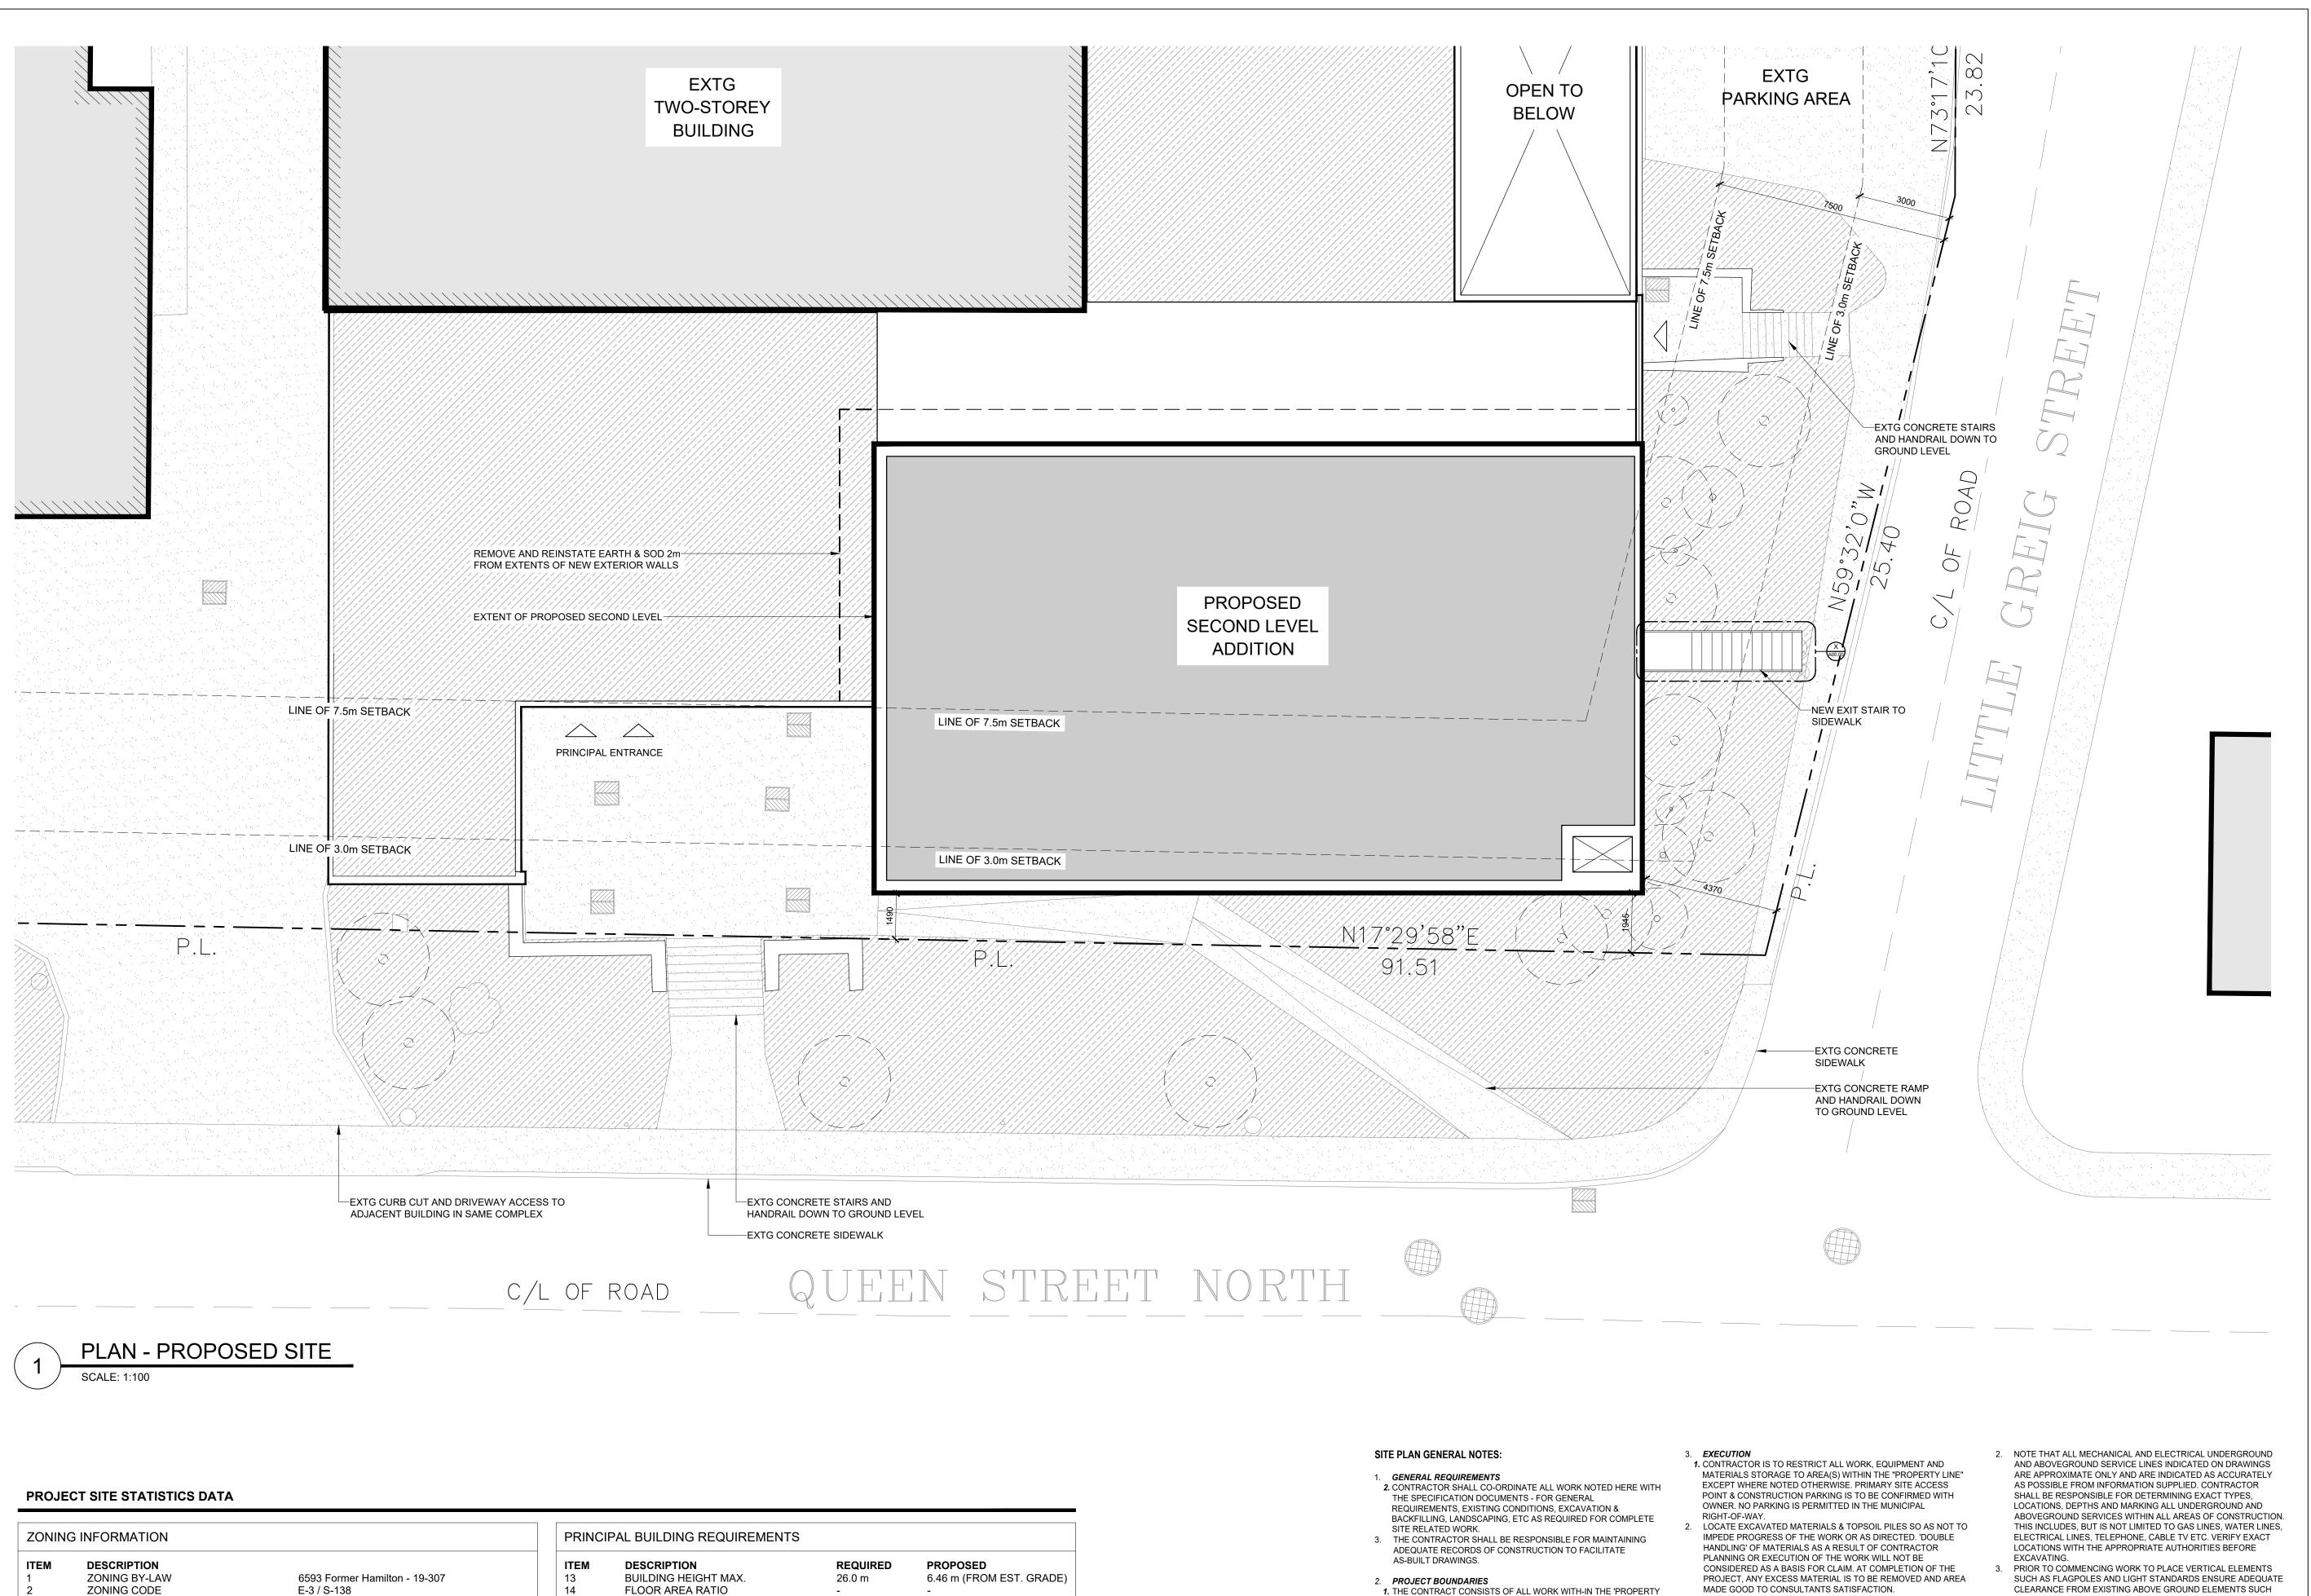
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SITE DEMOLITION PLAN

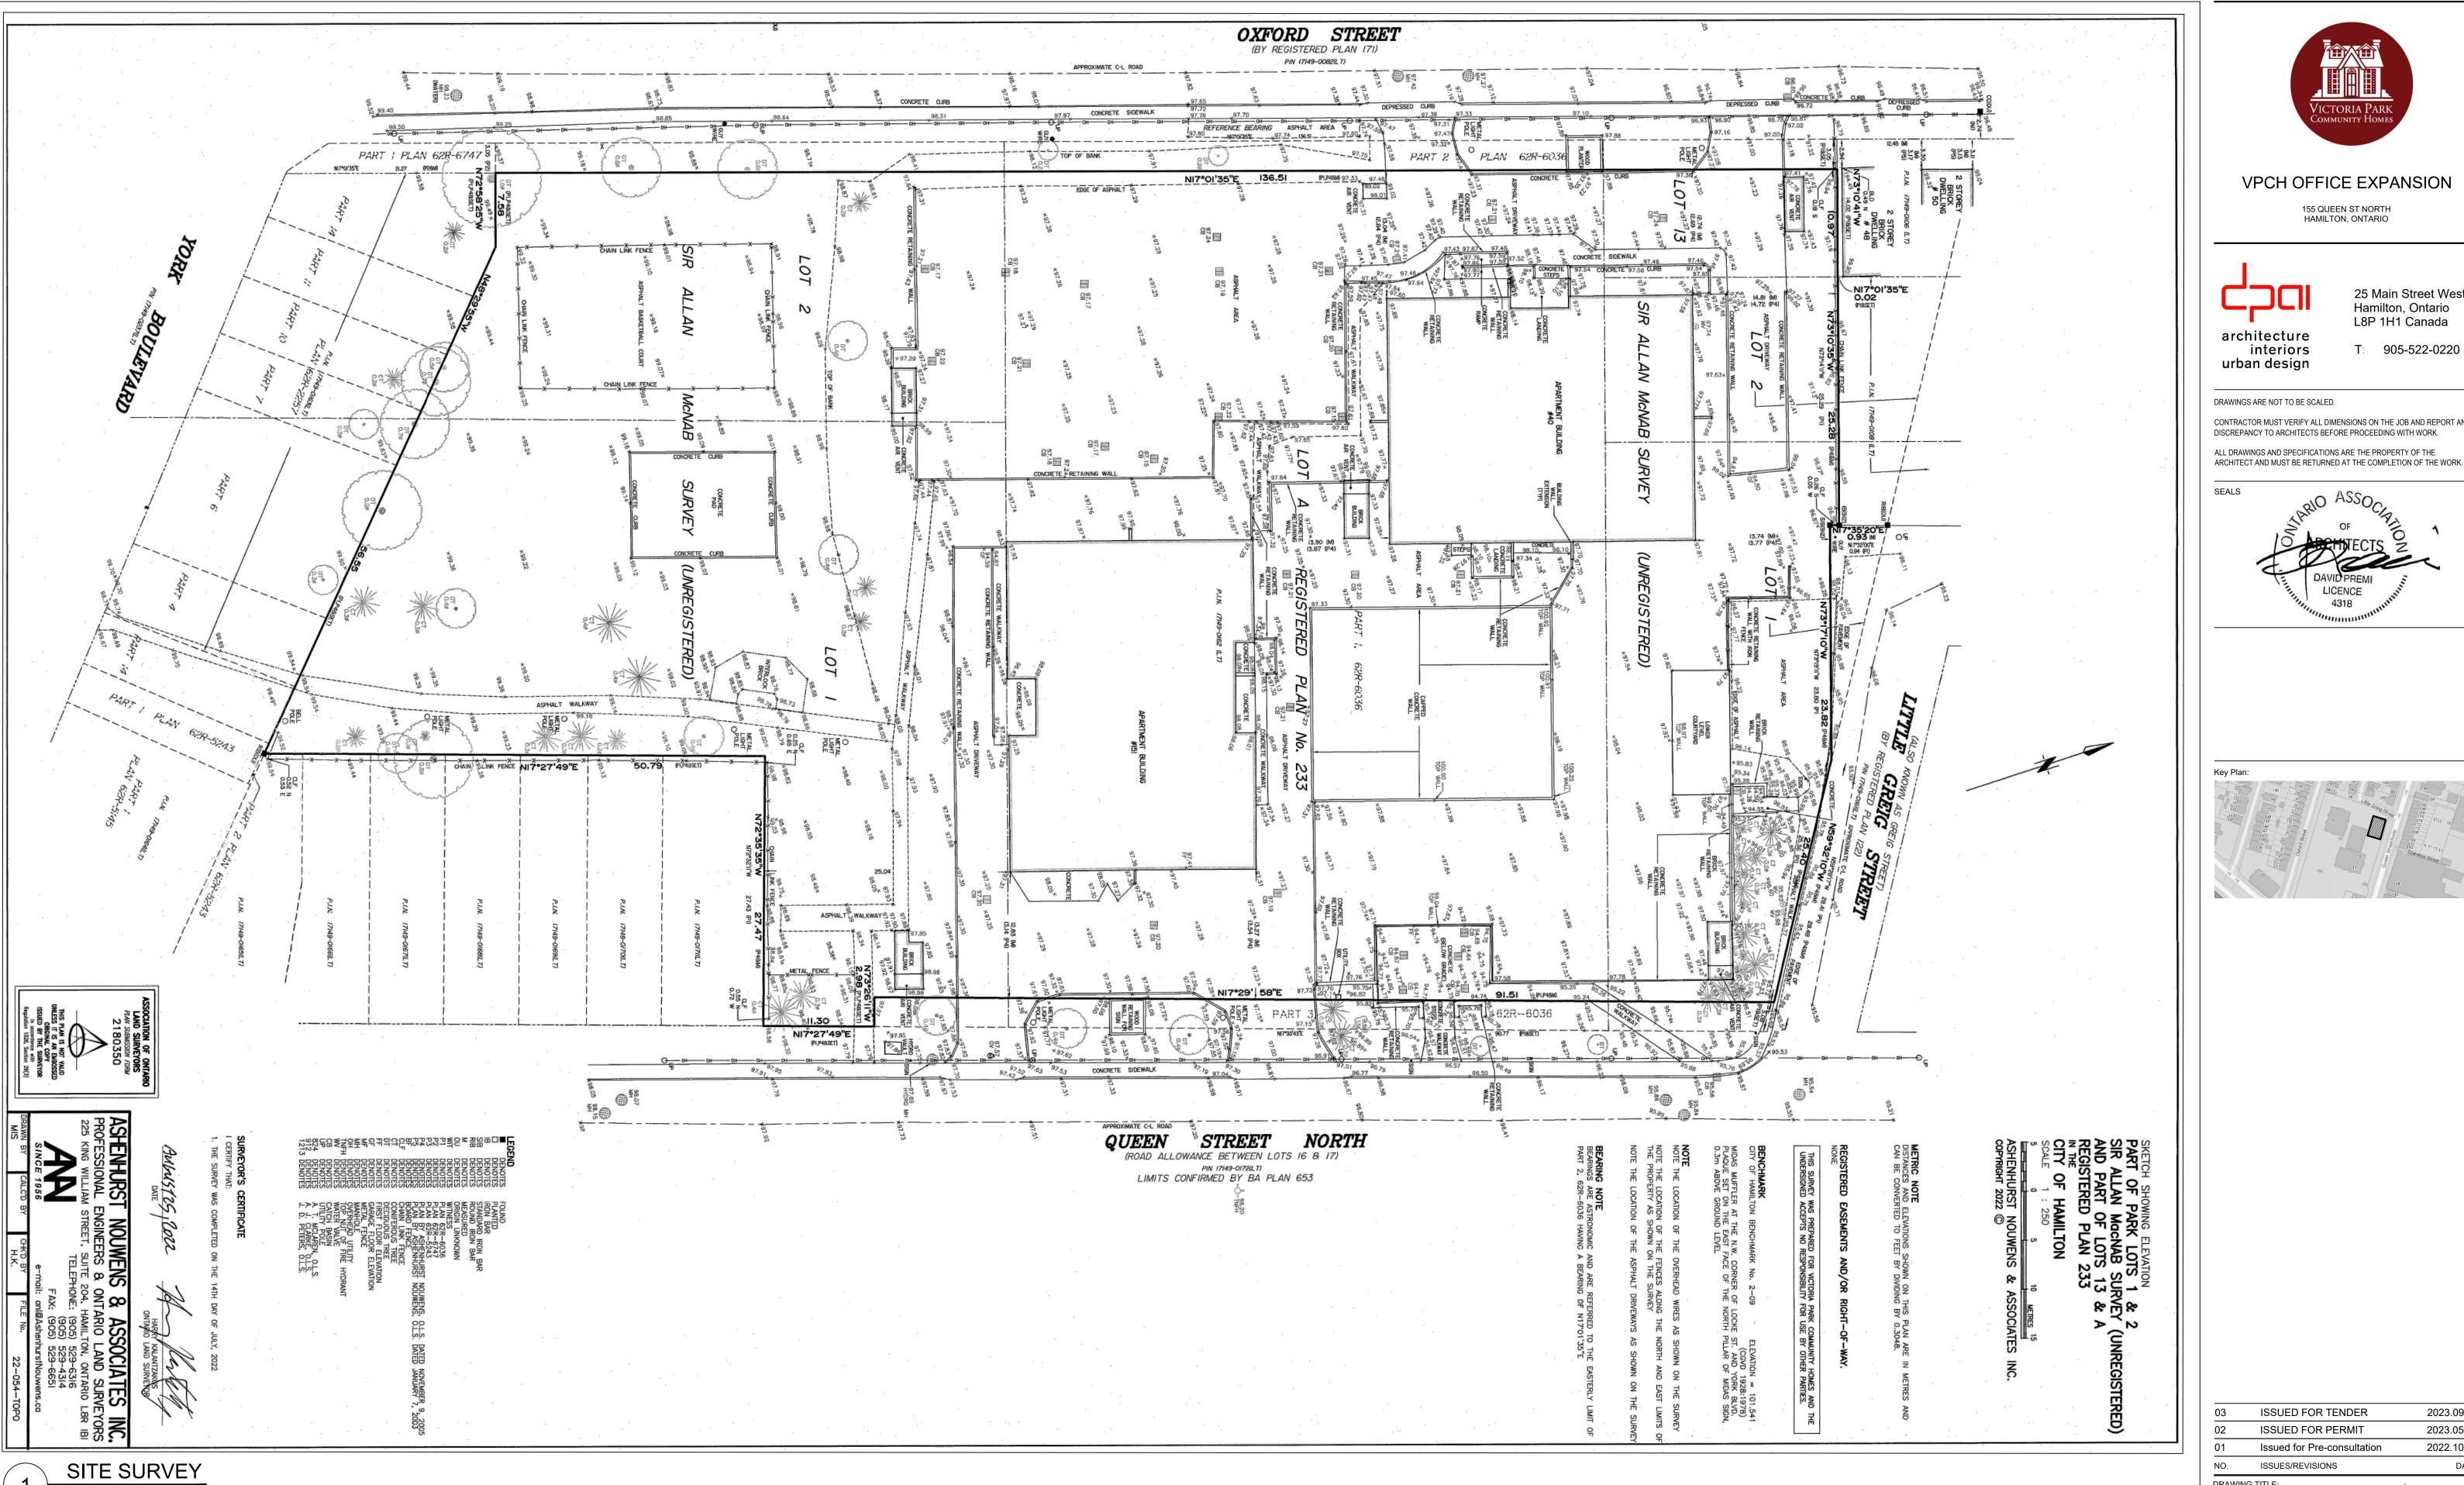

REVISION:



PERMITTED USES

DESCRIPTION

LOT FRONTAGE

PAVED AREA

LOT COVERAGE %

LANDSCAPED AREA %

FRONT YARD LANDSCAPE AREA

GREEN ROOF AREA

HARDSCAPED AREA

LOT AREA

LOT REQUIREMENTS

LOT AND PLAN NUMBER

High Density Multiple Dwellings

EXISTING

11,792 m2

102.77 m2

1,114.58 m2

242.50 m2

3,844 m2

17.9 %

49.5 %

Part of Lot 1 of Sir Allan McNab Survey

PROPOSED

NO CHANGE

NO CHANGE

20.9 %

46.4 %

751.58 m2

3,481 m2

NO CHANGE

(unregistered), and Lot A of Plan 233

BUILDING FOOTPRINT

GROSS FLOOR AREA

SIDE YARD SETBACK

DESCRIPTION

BUILDING TO PROPERTY LINE SETBACKS

ESTABLISHED GRADE (AVG. CURB)

FRONT YARD SETBACK (QUEEN ST N)

STREET LINE S.Y.S. (LITTLE GREIG ST)

REAR YARD SETBACK (TO OXFORD ST)

NO CHANGE

NO CHANGE

PROPOSED

NO CHANGE

NO CHANGE

1.49 m (NO CHANGE)

4.37 m (NO CHANGE)

848 m2

96.03 m

3.0 m

3.0 m

1.5 m



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ALL DRAWINGS AND SPECIFICATIONS ARE THE PROPERTY OF THE ARCHITECT AND MUST BE RETURNED AT THE COMPLETION OF THE WORK



- 1. THE CONTRACT CONSISTS OF ALL WORK WITH-IN THE 'PROPERTY LINE' AND/OR 'SITE EXTENTS' LINE AS INDICATED PLUS ANY WORK SPECIFICALLY NOTED OUTSIDE OF THAT LINE OR AS REQUIRED TO DELIVER A OPERATIONAL, FUNCTIONING PROJECT.

2. THE TERM 'SITE EXTENTS' REFERS TO THE AREA THAT THE

FENCING FOR THE DURATION OF THE WORK. 3. ALL WORK DONE OUTSIDE OF THESE LIMITS MUST BE EXECUTED IN STRICT ACCORDANCE WITH THE STANDARDS OF THE MUNICIPALITY AND ALL OTHER AUTHORITIES HAVING JURISDICTION. MAKE GOOD AT NO ADDITIONAL COST TO THE OWNER OR MUNICIPALITY ANY DAMAGE CAUSED BY THIS CONSTRUCTION TO MATERIALS OR FINISHES BEYOND THE "PROPERTY LINE" INDICATED.

CONTRACTOR IS REQUIRED TO ENCLOSE WITH CONSTRUCTION

- MADE GOOD TO CONSULTANTS SATISFACTION.
- FOR TRENCHING & BACKFILLING OF ALL SERVICE LINES AND DIVISION OF RESPONSIBILITY REFER TO APPROPRIATE SPECIFICATION SECTIONS AND DRAWINGS. TRENCHING & BACKFILLING NOT IDENTIFIED BY A PARTICULAR SUB-TRADE WILL BE THE RESPONSIBILITY OF THE GENERAL CONTRACTOR TO PROVIDE TRENCHING AND BACKFILLING. GRADE FINISHED WORK TO MATCH SURROUNDING SURFACES.
- 1. NOTE THAT THE EXACT LOCATIONS OF ALL NEW MECHANICAL & ELECTRICAL ITEMS ARE APPROXIMATE UNLESS DIMENSIONS ARE GIVEN. ADJUST LOCATIONS AS REQUIRED AND AS APPROVED BY CONSULTANT TO SUIT SITE CONDITIONS.
- CLEARANCE FROM EXISTING ABOVE GROUND ELEMENTS SUCH AS OVERHEAD WIRES CABLES ETC. NOTIFY THE CONSULTANT OF ANY DISCREPANCIES PRIOR TO COMMENCEMENT OF WORK. 4. ALL FINISHED PAVING AND GRADING TO BE TO NEW LEVELS SHOWN. ALL DRAINAGE TO BE POSITIVE, LEAVING NO POCKETS IN FINISHED GRADE. FINISHED GRADING TO SLOPE MINIMUM 1:12 AND ASPHALT TO SLOPE MAX 1:10 AWAY FROM BUILDING UNLESS

SHOWN OTHERWISE. NEW GRADES TO MEET EXISTING GRADES

FALLING AWAY FROM BUILDING AND FEATHERED OUT EVENLY.


04	ISSUED FOR TENDER	2023.09.06
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FOCUSED SITE PLAN,

DRAWING TITLE:



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PARKING STATISTICS

(PARKING REQD AT 1 SPACE / UNIT) BELOW-GRADE PARKING PROVIDED SURPLUS PARKING BELOW-GRADE *	265	238	-
	265	238	-
SURPLUS PARKING BELOW-GRADE *			
COMMERCIAL AREA (INCL. PORILIA)			
COMMERCIAL AREA (INCL. PODIUM)			
COMMERCIAL GFA	1953 m2	-	357 m2 (NEW SECOND FLOOR)
(PARKING REQD AT 1 SPACE / 31 m2 IN EXCESS OF 450 m2)			
SURFACE PARKING PROVIDED	35	60	-
DEFICIT PARKING ABOVE-GRADE *			

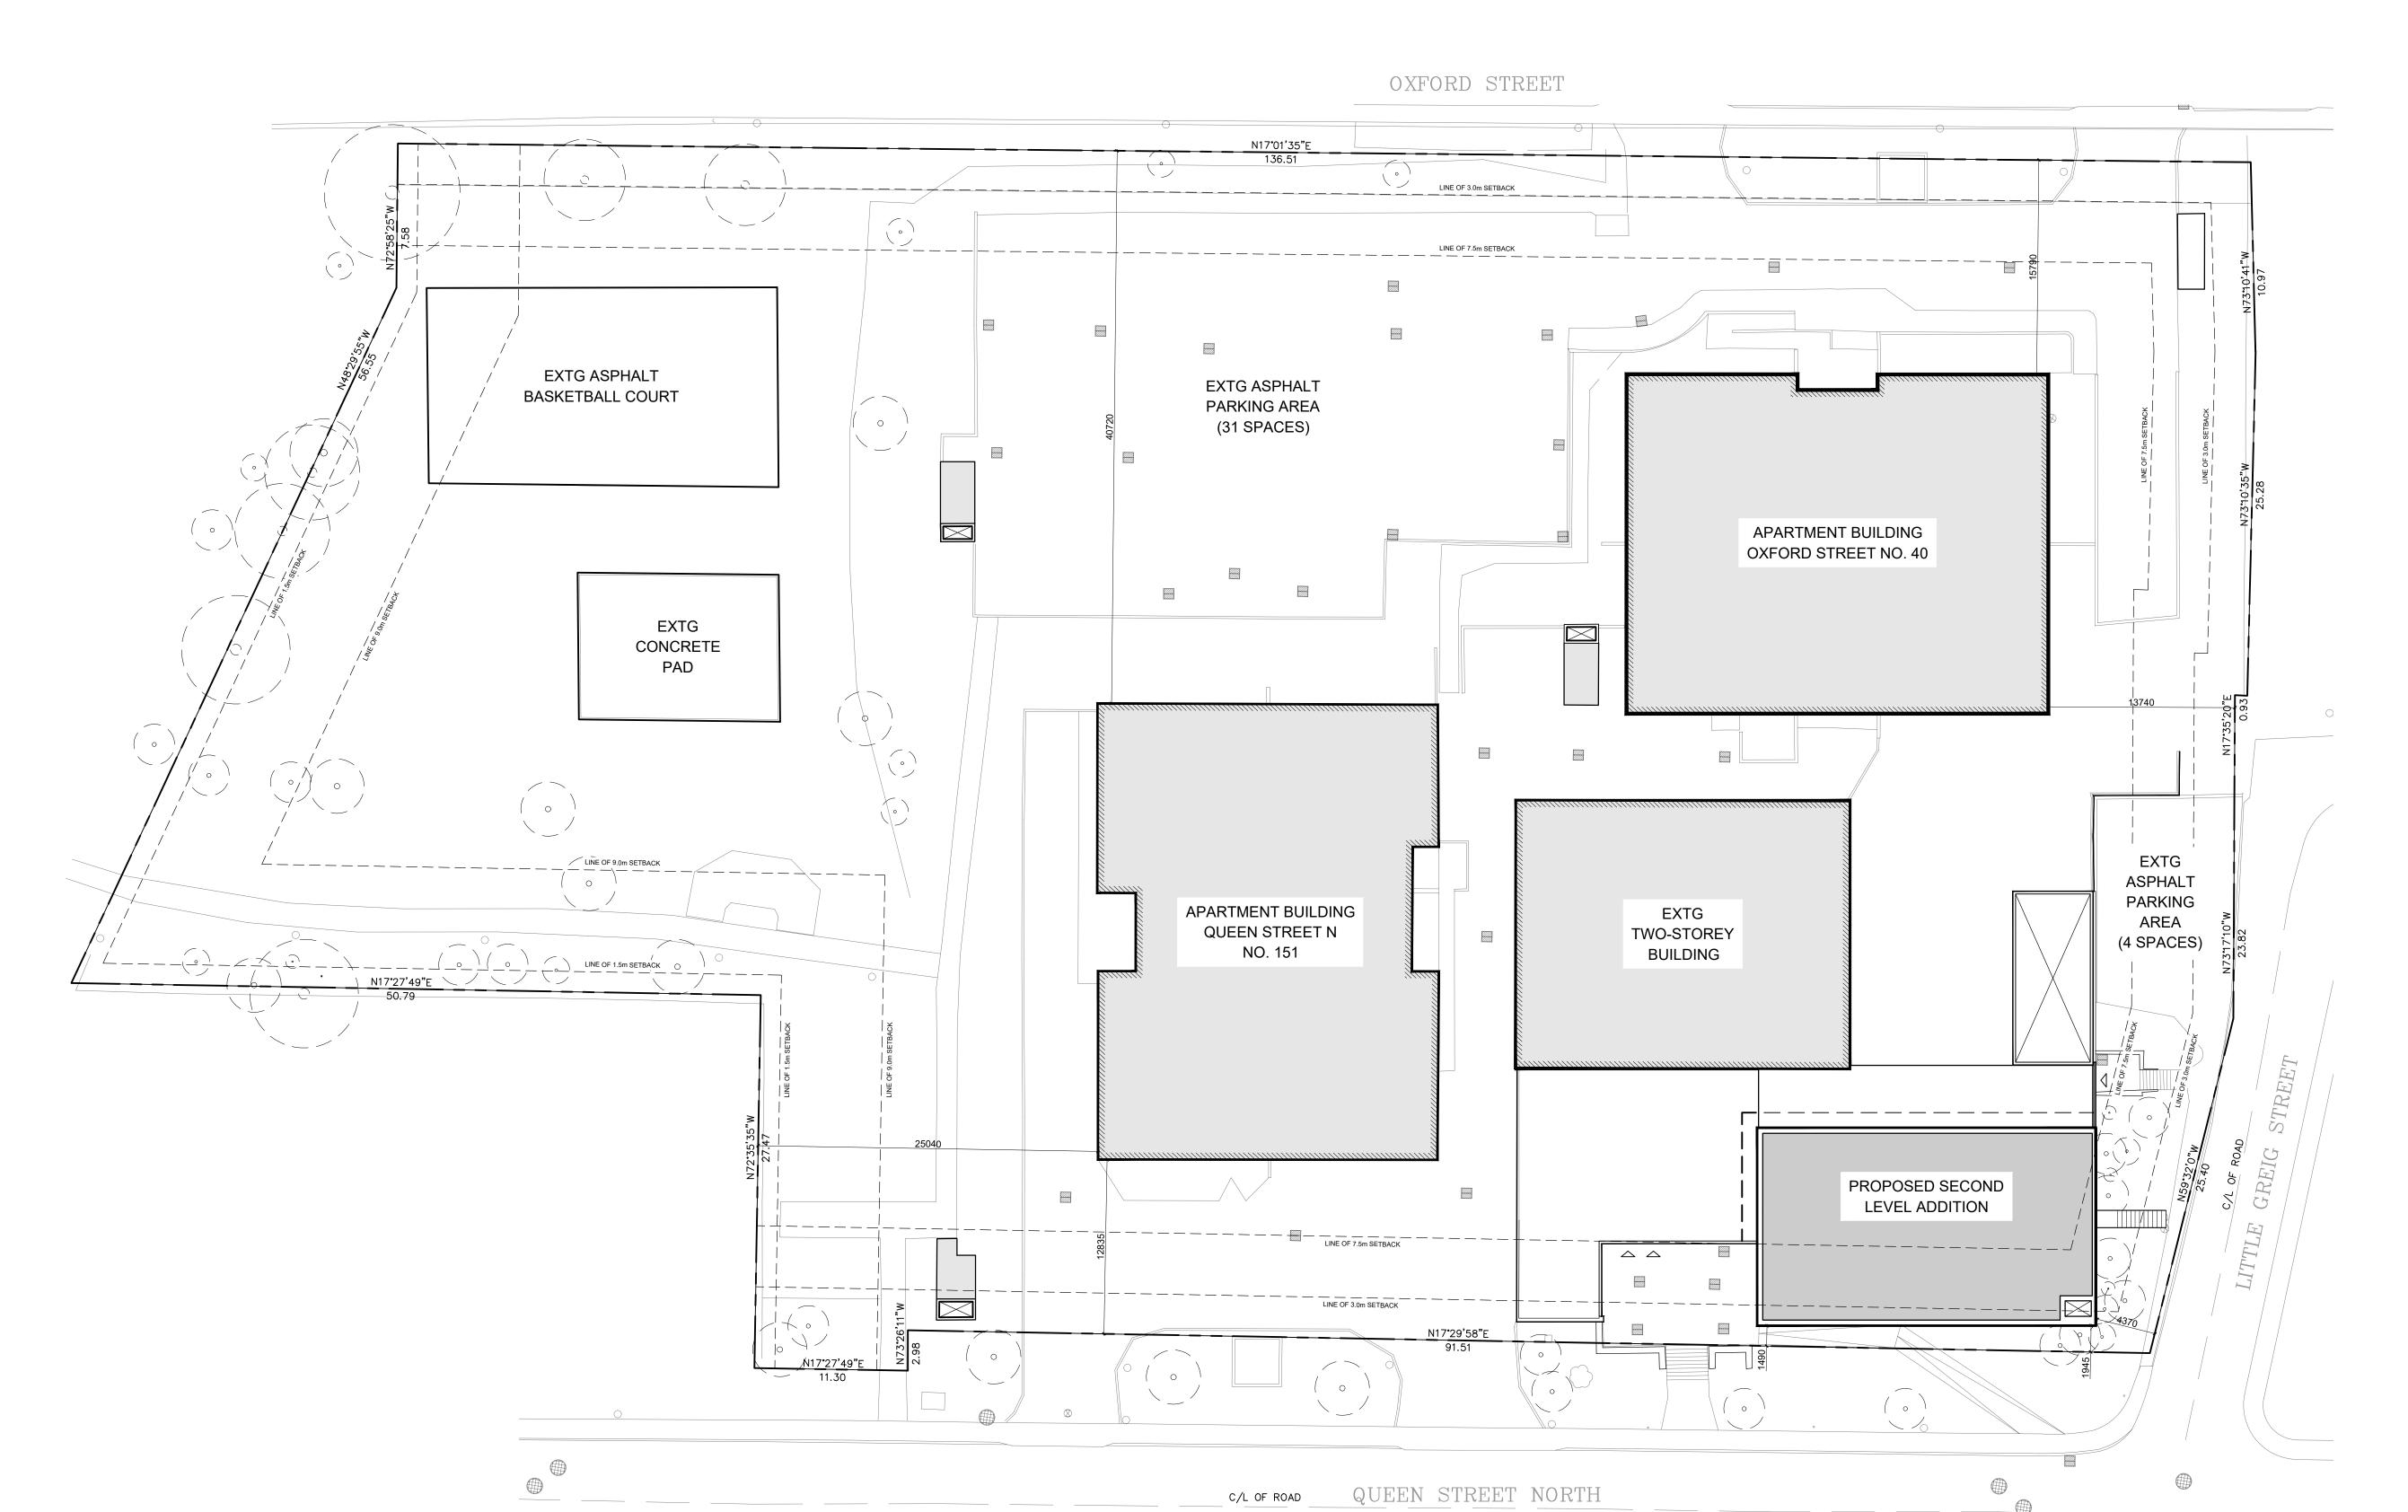SITE PLAN GENERAL NOTES:

- 1. **GENERAL REQUIREMENTS** 2. CONTRACTOR SHALL CO-ORDINATE ALL WORK NOTED HERE WITH THE SPECIFICATION DOCUMENTS - FOR GENERAL REQUIREMENTS, EXISTING CONDITIONS, EXCAVATION & BACKFILLING, LANDSCAPING, ETC AS REQUIRED FOR COMPLETE
- SITE RELATED WORK. 3. THE CONTRACTOR SHALL BE RESPONSIBLE FOR MAINTAINING ADEQUATE RECORDS OF CONSTRUCTION TO FACILITATE AS-BUILT DRAWINGS.

2. PROJECT BOUNDARIES

- 1. THE CONTRACT CONSISTS OF ALL WORK WITH-IN THE 'PROPERTY LINE' AND/OR 'SITE EXTENTS' LINE AS INDICATED PLUS ANY WORK SPECIFICALLY NOTED OUTSIDE OF THAT LINE OR AS REQUIRED TO DELIVER A OPERATIONAL, FUNCTIONING PROJECT.
- 2. THE TERM 'SITE EXTENTS' REFERS TO THE AREA THAT THE CONTRACTOR IS REQUIRED TO ENCLOSE WITH CONSTRUCTION FENCING FOR THE DURATION OF THE WORK. 3. ALL WORK DONE OUTSIDE OF THESE LIMITS MUST BE EXECUTED
- IN STRICT ACCORDANCE WITH THE STANDARDS OF THE MUNICIPALITY AND ALL OTHER AUTHORITIES HAVING JURISDICTION. MAKE GOOD AT NO ADDITIONAL COST TO THE OWNER OR MUNICIPALITY ANY DAMAGE CAUSED BY THIS CONSTRUCTION TO MATERIALS OR FINISHES BEYOND THE "PROPERTY LINE" INDICATED.
- 3. **EXECUTION** 1. CONTRACTOR IS TO RESTRICT ALL WORK, EQUIPMENT AND MATERIALS STORAGE TO AREA(S) WITHIN THE "PROPERTY LINE" EXCEPT WHERE NOTED OTHERWISE. PRIMARY SITE ACCESS POINT & CONSTRUCTION PARKING IS TO BE CONFIRMED WITH OWNER. NO PARKING IS PERMITTED IN THE MUNICIPAL
- RIGHT-OF-WAY. LOCATE EXCAVATED MATERIALS & TOPSOIL PILES SO AS NOT TO IMPEDE PROGRESS OF THE WORK OR AS DIRECTED. 'DOUBLE HANDLING' OF MATERIALS AS A RESULT OF CONTRACTOR PLANNING OR EXECUTION OF THE WORK WILL NOT BE CONSIDERED AS A BASIS FOR CLAIM. AT COMPLETION OF THE PROJECT, ANY EXCESS MATERIAL IS TO BE REMOVED AND AREA

MADE GOOD TO CONSULTANTS SATISFACTION.

TO MATCH SURROUNDING SURFACES.

- FOR TRENCHING & BACKFILLING OF ALL SERVICE LINES AND DIVISION OF RESPONSIBILITY REFER TO APPROPRIATE SPECIFICATION SECTIONS AND DRAWINGS. TRENCHING & BACKFILLING NOT IDENTIFIED BY A PARTICULAR SUB-TRADE WILL BE THE RESPONSIBILITY OF THE GENERAL CONTRACTOR TO PROVIDE TRENCHING AND BACKFILLING. GRADE FINISHED WORK
- LOCATION OF SERVICES 1. NOTE THAT THE EXACT LOCATIONS OF ALL NEW MECHANICAL & ELECTRICAL ITEMS ARE APPROXIMATE UNLESS DIMENSIONS ARE GIVEN. ADJUST LOCATIONS AS REQUIRED AND AS APPROVED BY CONSULTANT TO SUIT SITE CONDITIONS.
- 2. NOTE THAT ALL MECHANICAL AND ELECTRICAL UNDERGROUND AND ABOVEGROUND SERVICE LINES INDICATED ON DRAWINGS ARE APPROXIMATE ONLY AND ARE INDICATED AS ACCURATELY AS POSSIBLE FROM INFORMATION SUPPLIED. CONTRACTOR SHALL BE RESPONSIBLE FOR DETERMINING EXACT TYPES, LOCATIONS, DEPTHS AND MARKING ALL UNDERGROUND AND ABOVEGROUND SERVICES WITHIN ALL AREAS OF CONSTRUCTION. THIS INCLUDES, BUT IS NOT LIMITED TO GAS LINES, WATER LINES, ELECTRICAL LINES, TELEPHONE, CABLE TV ETC. VERIFY EXACT
- LOCATIONS WITH THE APPROPRIATE AUTHORITIES BEFORE EXCAVATING. PRIOR TO COMMENCING WORK TO PLACE VERTICAL ELEMENTS SUCH AS FLAGPOLES AND LIGHT STANDARDS ENSURE ADEQUATE CLEARANCE FROM EXISTING ABOVE GROUND ELEMENTS SUCH AS OVERHEAD WIRES CABLES ETC. NOTIFY THE CONSULTANT OF ANY DISCREPANCIES PRIOR TO COMMENCEMENT OF WORK.
- 4. ALL FINISHED PAVING AND GRADING TO BE TO NEW LEVELS SHOWN. ALL DRAINAGE TO BE POSITIVE, LEAVING NO POCKETS IN FINISHED GRADE. FINISHED GRADING TO SLOPE MINIMUM 1:12 AND ASPHALT TO SLOPE MAX 1:10 AWAY FROM BUILDING UNLESS SHOWN OTHERWISE. NEW GRADES TO MEET EXISTING GRADES FALLING AWAY FROM BUILDING AND FEATHERED OUT EVENLY.



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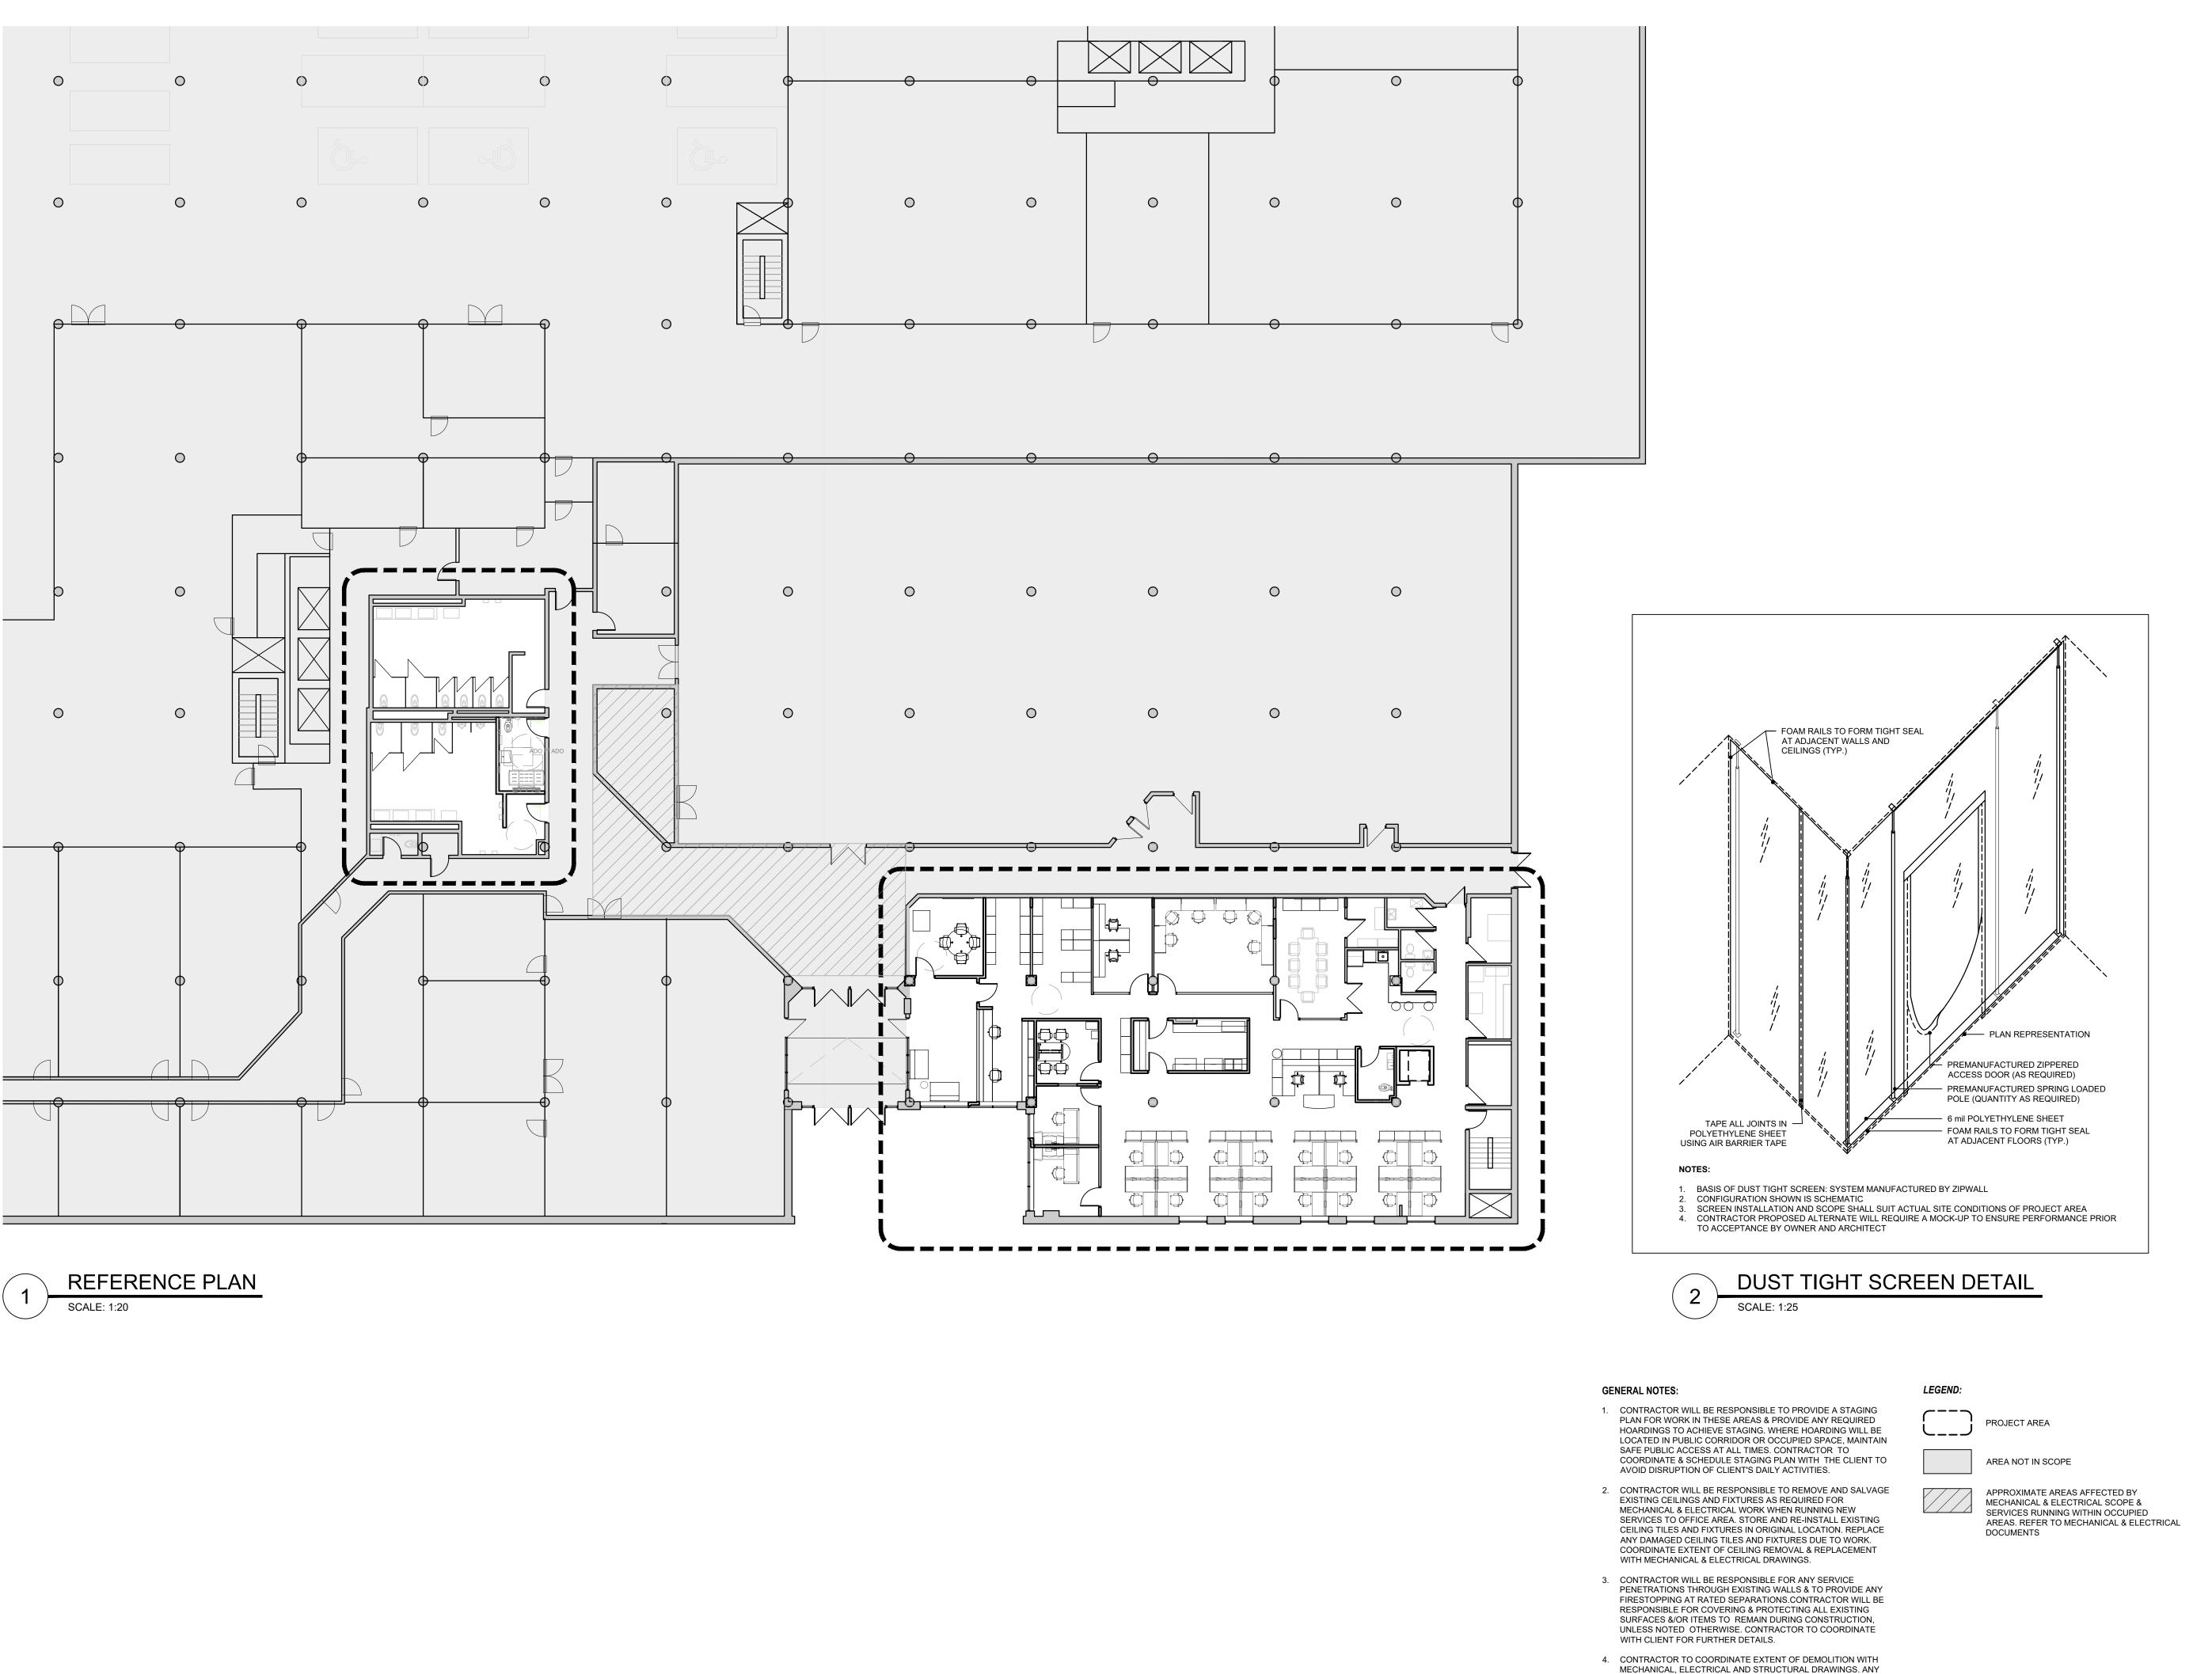
02	ISSUED FOR TENDER	2023.0	9.06
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SITE PLAN

2023.09.06

ISSUE DATE: 2023.09	
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AREAS NOT SHOWN ON ARCHITECTURAL DRAWINGS WHICH REQUIRE INSTALLATION OF NEW SERVICES SHALL BE RETURNED


TO ORIGINAL STATE TO MATCH EXISTING.

NO.

REFERENCE PLAN


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2022.07.29

DATE

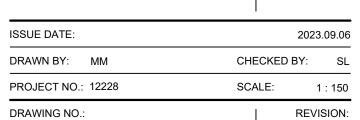

DEMOLITION PLAN - LEVEL 1

EX WOMEN'S WASHROOM EXISTING URINAL -TO BE REMOVED EXISTING DOOR REMOVE TO BE REMOVED FLOOR FINISH LOCATION. **EXISTING** FIX AND MAKE PARTITION TO BE GOOD REMOVED ADJACENT. EX MEN'S WASHROOM PORTION OF METAL STUD WALL TO BE REMOVED FOR NEW DOOR

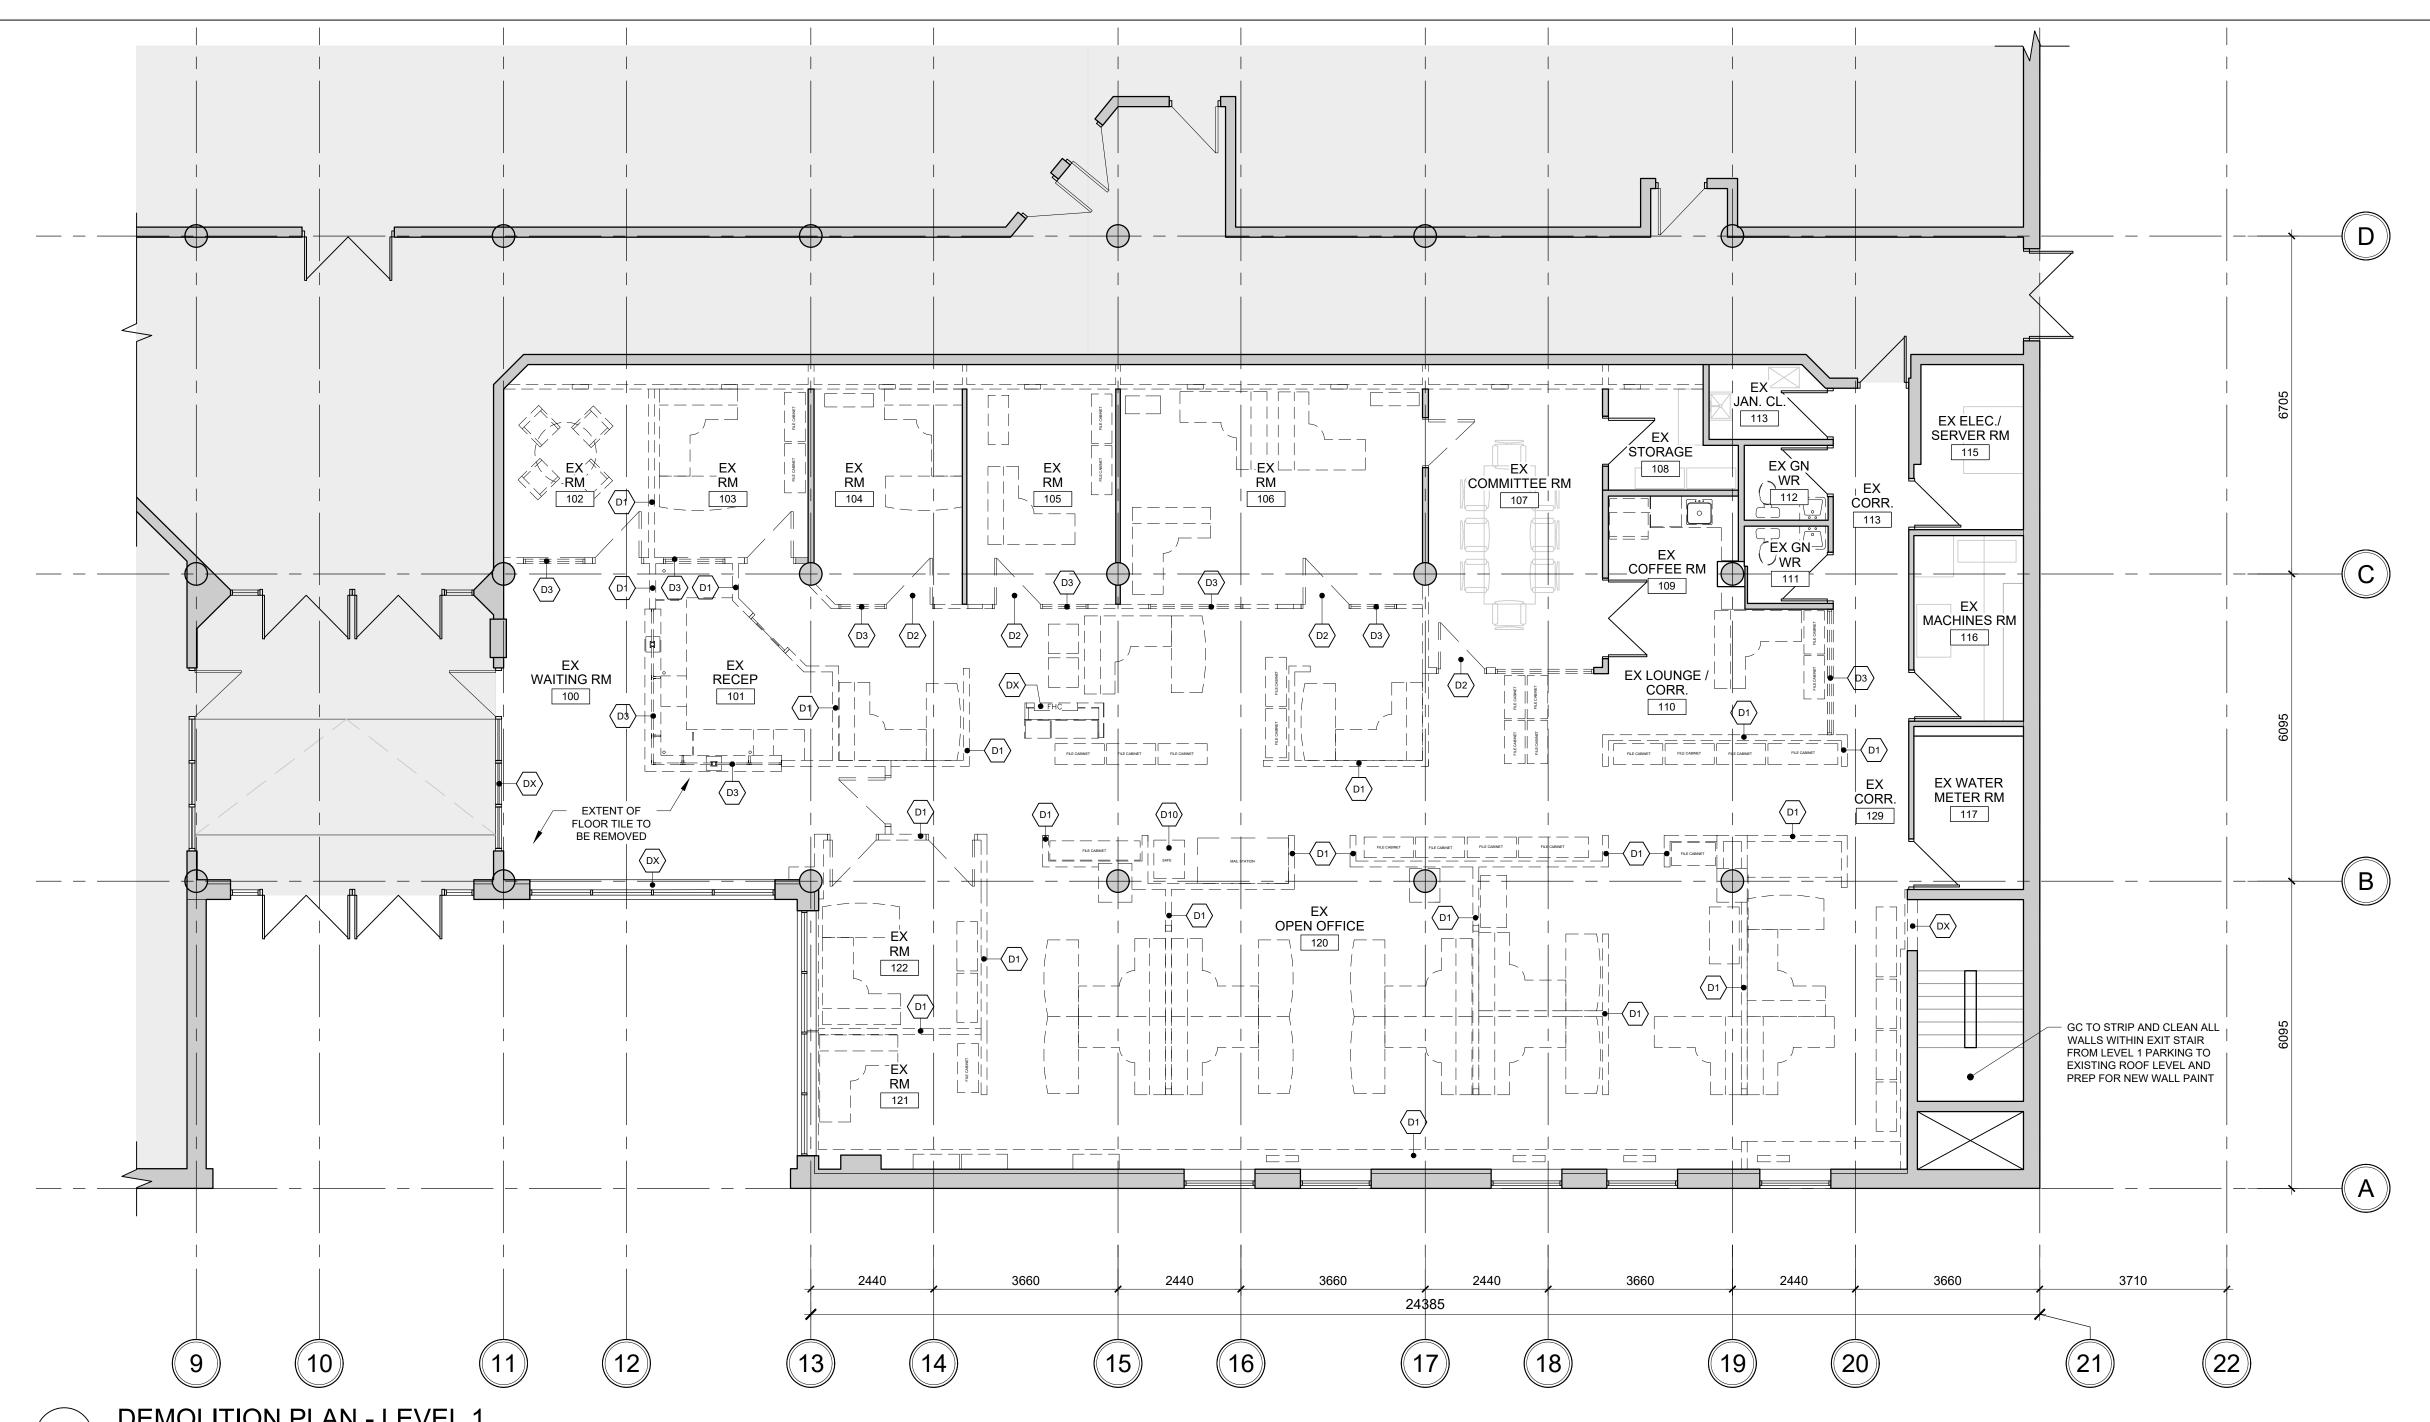DEMOLITION PLAN - LEVEL 1 WASHROOMS

GENERAL DEMOLITION NOTES:

GENERAL REQUIREMENTS

- 1. ALL WORK SHALL CONFORM TO THE REQUIREMENTS OF ALL EXISTING BY-LAWS, CODES, MUNICIPAL GOVERNMENTS AND AUTHORITIES HAVING JURISDICTION. OBTAIN ALL PERMITS REQUIRED IN ACCORDANCE WITH THE CONTRACT.
- 2. CAREFUL EXAMINATION OF ALL TENDER DOCUMENTS IS REQUIRED TO DETERMINE THE FULL SCOPE OF THE WORK. 3. PROVIDE DUST-TIGHT HOARDING PARTITIONS WHERE REQUIRED
- FOR PHASING. SEAL ALL AREAS OF CONSTRUCTION TO ALLOW FOR ALL OTHER FLOOR AREAS TO REMAIN OPERATIONAL DURING CONSTRUCTION. 4. GC TO COORDINATE EXTENT OF DEMOLITION WITH MECHANICAL,

ELECTRICAL, AND STRUCTURAL DRAWINGS. ANY AREAS NOT

- SHOWN ON ARCHITECTURAL DRAWINGS, WHICH REQUIRE INSTALLATION OF NEW SERVICES, IS TO BE RETURNED TO ORIGINAL STATE TO MATCH EXISTING. 5. PATCH AND REPAIR ALL ADJACENT SURFACES TO AREAS OF
- DEMOLITION AS REQUIRED TO MATCH EXISTING OR READY FOR NEW FINISH.
- 6. CLEAN, PATCH AND REPAIR ALL SURFACES TO REMAIN AS REQUIRED FOR NEW FINISHES.
- 7. PROVIDE TEMPORARY SUPPORT FOR ADJACENT CEILINGS, LIGHT FIXTURES, DIFFUSERS, CEILING MOUNTED DEVICES, ETC, AS REQUIRED FOR AREAS WHERE CEILINGS ARE REQUIRED TO BE REMOVED TO INSTALL NEW OR MODIFY EXISTING SERVICES. ALL CEILINGS TO BE RESTORED BACK TO ORIGINAL STATE.
- 8. GC TO VERIFY IN FIELD ALL EXISTING MEASUREMENTS AND CONDITIONS. ANY DISCREPANCIES SHALL BE BROUGHT TO THE PROJECT MANAGER'S ATTENTION PRIOR TO THE END OF TENDER
- 9. WHERE EXISTING SURFACES TO REMAIN ARE DISTURBED BY THE REMOVAL OF EXISTING WORK OR THE INSTALLATION OF NEW WORK, MAKE GOOD ALL SURFACES TO MATCH ADJACENT EXISTING SURFACES. REPAINT EXISTING PAINTED SURFACES COMPLETE TO THE NEAREST CHANGES IN PLANE.
- 10. UNLESS OTHERWISE NOTED, ALL DIMENSIONS ARE MEASURED TO FINISH FACE OF MASONRY OR GYPSUM WALL BOARD WHERE APPLICABLE.
- 11. UNLESS OTHERWISE NOTED, ALL GRID LINES ARE ON CENTRE OF COLUMNS 12. WHERE EXISTING SURFACES TO REMAIN ARE DISTURBED BY THE
- REMOVAL OF EXISTING WORK OR THE INSTALLATION OF NEW WORK, MAKE GOOD ALL SURFACES TO MATCH THE ADJACENT EXISTING SURFACES. REPAINT EXISTING PAINTED SURFACES COMPLETE TO THE NEAREST CHANGES IN PLANE, APPLIES FOR BOTH WALLS AND

FLOOR PLAN DEMOLITION NOTES:

- REMOVE AND DISPOSE OF EXISTING PARTITION / WALL. PATCH AND REPAIR ADJACENT WALL AS REQUIRED AND MAKE READY FOR NEW FINISHES. REMOVAL TO INCLUDE ALL EXISTING SERVICES. REFER TO AND COORDINATE WITH MECHANICAL AND ELECTRICAL DRAWINGS
- REMOVE AND DISPOSE OF EXISTING DOOR AND FRAMES.
- REMOVE AND DISPOSE OF EXISTING WINDOW, SCREEN, GLAZING, AND ACCESSORIES
- REMOVE AND DISPOSE OF FURNITURE AND EQUIPMENT. HANDOVER OF FURNITURE AND EQUIPMENT TO OWNER.
- REMOVE AND DISPOSE OF EXISTING MILLWORK, CASEWORK AND/OR SHELVING, WHITEBOARDS, WALLCOVERING TYPE C/W ALL ASSOCIATED TRIMS . REMOVAL TO INCLUDE ALL ASSOCIATED HARDWARE AND ACCESSORIES. PATCH, REPAIR AND MAKE GOOD. FLAT, SMOOTH (TAPING, MUDDING AS REQUIRED) ADJACENT SURFACES
- EXISTING FLOOR STRUCTURE TO BE REMOVED. PATCH, REPAIR AND MAKE GOOD, FLAT, SMOOTH (TAPING, MUDDING AS REQUIRED) ADJACENT SURFACES AS REQUIRED
- EXISTING ELECTRICAL COMPONENTS TO BE DISCONNECTED AND REMOVED (REFER TO AND COORDINATE WITH ELECTRICAL DRAWINGS). PATCH AND REPAIR ADJACENT SURFACES AS REQUIRED

REQUIRED

- EXISTING ROOF TO BE REMOVED. INCLUDING BUT NOT LIMITED TO ROOFING, STRUCTURE, VENTS, GUTTERS, FASCIA, SOFFITS, ETC. PATCH, REPAIR AND MAKE GOOD, FLAT, SMOOTH (TAPING, MUDDING AS REQUIRED) EXISTING ADJACENT SURFACES AS
- DISCONNECT, REMOVE AND DISPOSE OF EXISTING PLUMBING FIXTURES. REMOVE REDUNDANT PIPING, CAP LINES AS REQUIRED. REFER TO AND COORDINATE WITH MECHANICAL DRAWINGS
- REMOVE AND RELOCATE EXISTING FLOOR-MOUNTED CAST IRON SAFE TO A SECURE LOCATION ON SITE FOR DURATION OF WORK. COORDINATE TEMPORARY RELOCATION WITH OWNER.



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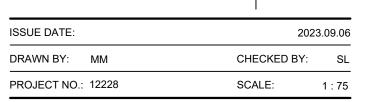
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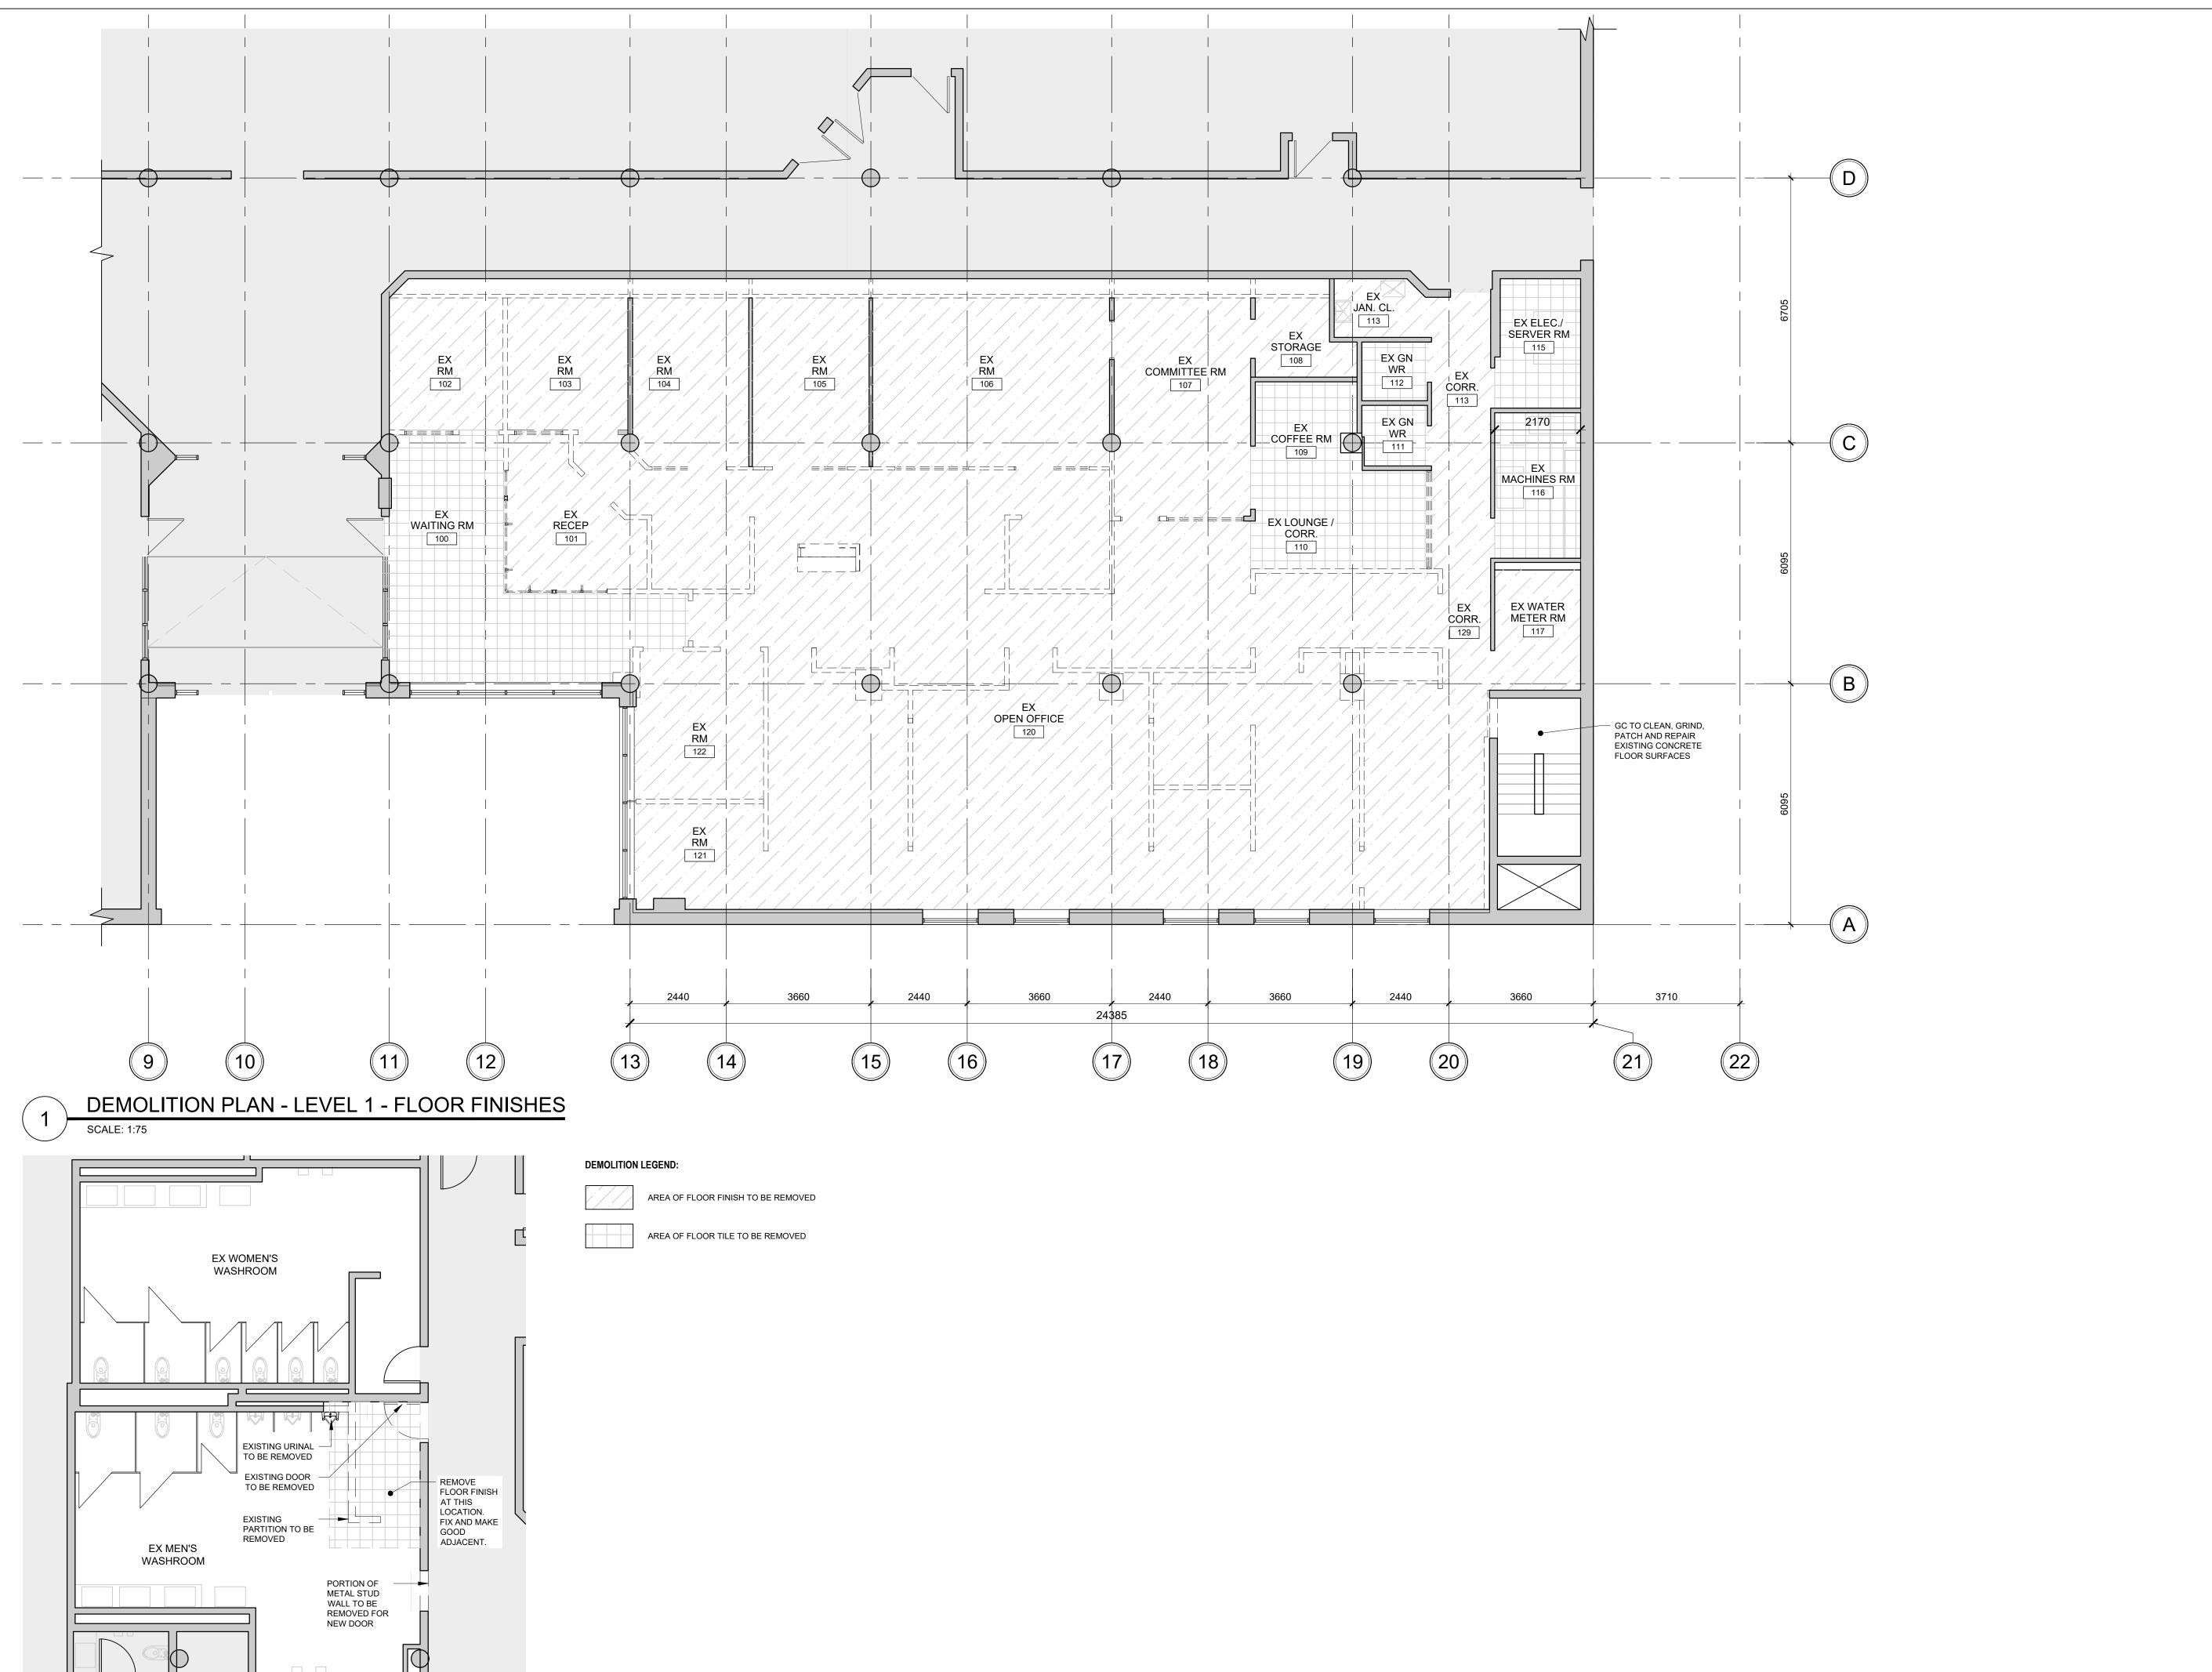
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Issued for Pre-consultation	2022.10.07
Issued for Coordination	2022.07.29
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DEMOLITION PLAN



DRAWING NO.:

REVISION:



DEMOLITION PLAN - LEVEL 1 WASHROOMS



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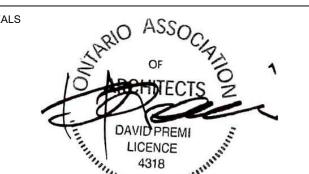
25 Main Street West Hamilton, Ontario L8P 1H1 Canada

interiors T: 905-522-0220 urban design

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 04
 ISSUED FOR TENDER
 2023.09.06

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 2022.10.07

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DEMOLITION PLAN LEVEL 1 FLOOR FINISHES


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A01.02

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REVISION:



DEMOLITION PLAN - LEVEL 1 - REFLECTED CEILING PLAN

REFLECTED CEILING PLAN DEMOLITION NOTES:

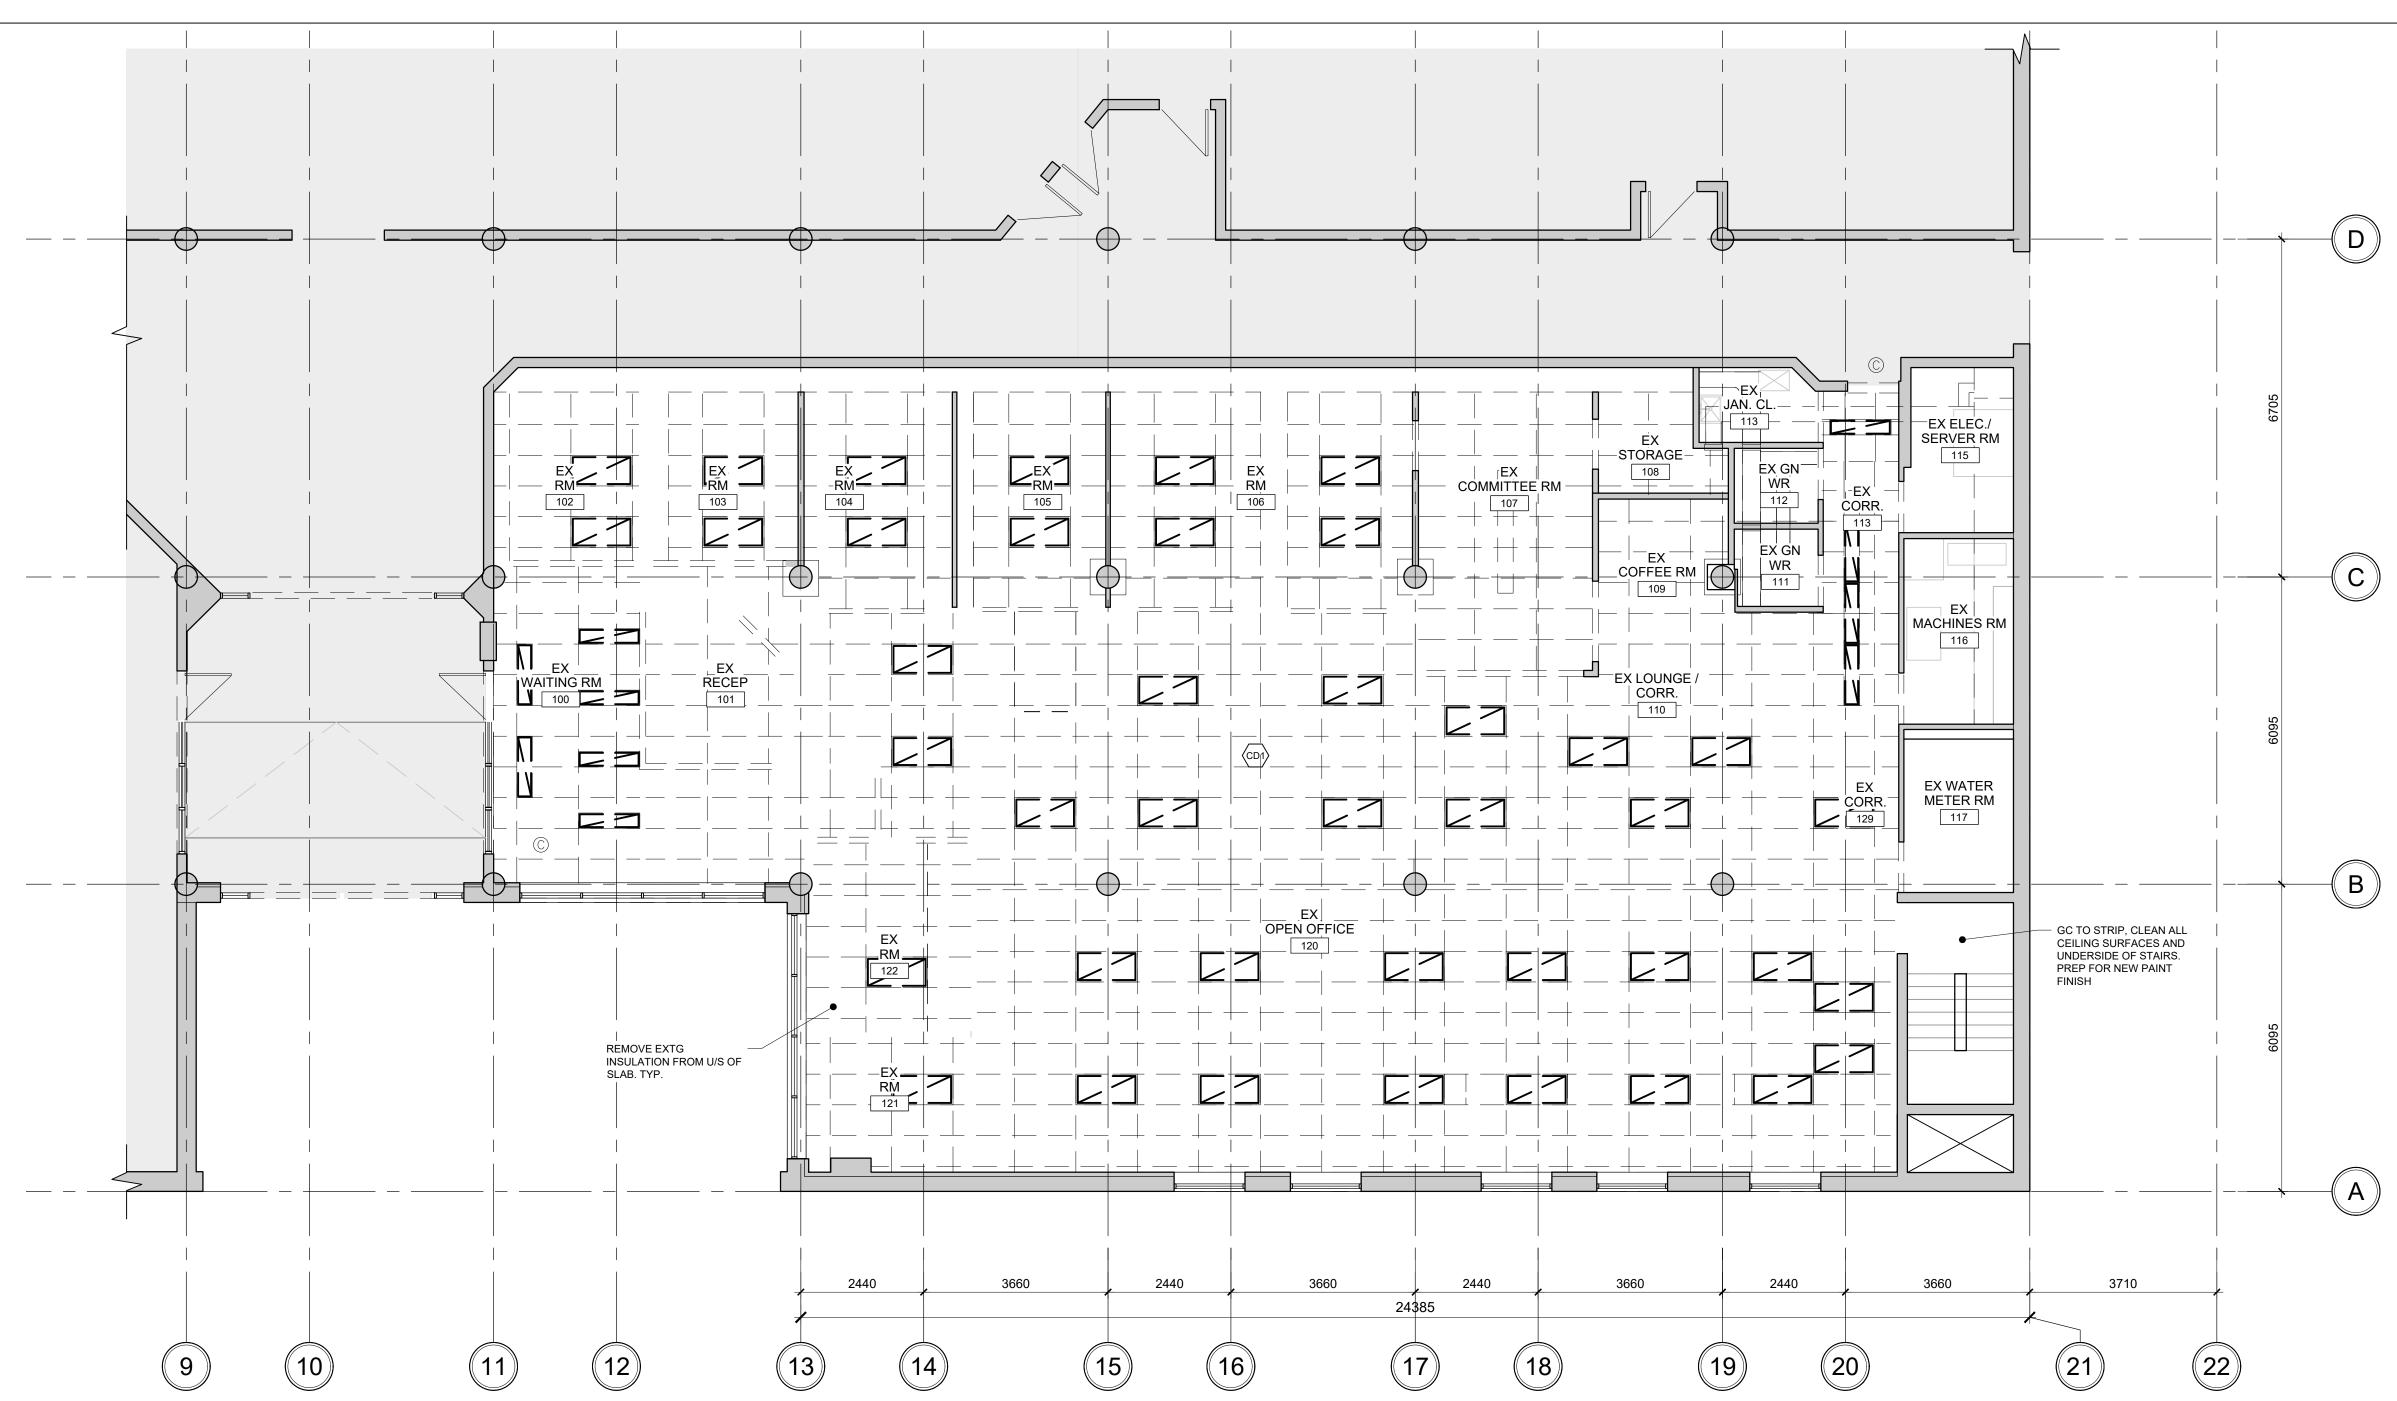GENERAL REQUIREMENTS

1. THIS DRAWING IS TO BE READ IN CONJUNCTION WITH ALL ARCHITECTURAL, ELECTRICAL, MECHANICAL & STRUCTURAL DEMOLITION DRAWINGS.

- 2. PRIOR TO DEMOLITION WORK, THE GENERAL CONTRACTOR MUST COORDINATE THE REMOVAL, STORAGE, RELOCATION OR DISPOSAL OF EQUIPMENT WITH OWNER AND CONSULTANT.
- 3. GENERAL CONTRACTOR TO COORDINATE EXTENT OF DEMOLITION WITH MECHANICAL, ELECTRICAL, AND STRUCTURAL DRAWINGS. 4. PROVIDE DUST-TIGHT HOARDING PARTITIONS WHERE INDICATED. SEAL ALL AREAS OF CONSTRUCTION TO ALLOW FOR ALL OTHER

FLOOR AREAS TO REMAIN OPERATIONAL DURING CONSTRUCTION.

- 5. PROVIDE DUST-TIGHT, SEALED PROTECTIVE BARRIERS IN EXPOSED FLOOR OPENINGS THAT MAY AFFECT ADJACENT (ABOVE OR BELOW) FLOOR AREAS THAT REMAIN OPERATIONAL DURING DEMOLITION. 6. GENERAL CONTRACTOR TO VERIFY IN FIELD ALL EXISTING MEASUREMENTS AND CONDITIONS. ANY DISCREPANCIES SHALL BE BROUGHT TO THE PROJECT MANAGER'S ATTENTION PRIOR TO THE
- 7. REMOVE ALL INTERIOR PARTITIONS AS INDICATED. 8. ALL STRUCTURAL COMPONENTS TO REMAIN UNLESS OTHERWISE

END OF TENDER CLOSING.

- 9. CEILINGS AND FLOORING TO BE REMOVED WHERE REMOVAL OF
- PARTITIONS ARE INDICATED UNLESS NOTED OTHERWISE. 10. REMOVE ALL EXISTING FLOOR FINISHES WHERE INDICATED. PATCH, REPAIR AND MAKE GOOD FLOOR SLAB INCLUDING LEVELLING AND SKIM COATS AS REQUIRED.
- 11. ALL WALL FIXED ITEMS (SPEAKERS, BELLS, EMERGENCY PHONES, LIGHTS, SIGNAGE, ETC.), AS WELL AS CEILING MOUNTED EQUIPMENT ARE TO REMAIN UNLESS OTHERWISE INDICATED. REFER TO AND COORDINATE WITH MECHANICAL AND ELECTRICAL DRAWINGS. GENERAL CONTRACTOR TO ENSURE THE PROTECTION OF THESE
- ITEMS DURING DEMOLITION. 12. REMOVE ALL REDUNDANT POWER OUTLETS AND CONDUIT TO THE NEAREST JUNCTION BOX & MAKE SAFE. REFER TO ELECTRICAL
- DRAWINGS FOR ADDITIONAL INFORMATION. 13. ALL AFFECTED ELECTRICAL SERVICES TO BE PULLED BACK TO ELECTRICAL PANELS, UNLESS NOTED OTHERWISE. REFER TO AND COORDINATE WITH ELECTRICAL DRAWINGS.
- 14. PROVIDE TEMPORARY SUPPORT FOR ADJACENT CEILINGS, LIGHT FIXTURES, DIFFUSERS, CEILING MOUNTED DEVICES, ETC., AS REQUIRED FOR AREAS WHERE CEILINGS ARE REQUIRED TO BE
- REMOVED, TO INSTALL NEW OR MODIFY EXISTING SERVICES. 15. WHERE CEILINGS ARE REMOVED, ALL MECHANICAL DUCTS ARE TO BE REMOVED BACK TO AIR HANDLING UNITS, UNLESS NOTED OTHERWISE. REFER TO AND COORDINATE WITH MECHANICAL

- 16. REMOVE ALL PLUMBING FIXTURES IN AREA OF DEMOLITION AS NOTED. CAP, REMOVE, OR RELOCATE PLUMBING SERVICES AS REQUIRED. REFER TO AND COORDINATE WITH MECHANICAL DRAWINGS. 17. ELECTRICAL AND MECHANICAL DEVICES ARE SHOWN FOR APPROXIMATE LOCATION ONLY. REFER TO AND COORDINATE WITH MECHANICAL AND ELECTRICAL DRAWINGS FOR ACCURATE QUANTITIES AND LOCATIONS.
- 18. FURNITURE AND EQUIPMENT SHOWN FOR REFERENCE ONLY. GENERAL CONTRACTOR TO VERIFY IN FIELD ALL LOCATIONS AND QUANTITIES PRIOR TO DEMOLITION WORK.

DEMOLITION NOTES:

EXISTING SUSPENDED ACOUSTIC CEILING TILES AND GRID TO BE EXISTING SUSPENDED ACOUSTIC CEILING TILES AND GRID TO BE REMOVED AND DISPOSED OF REMOVAL TO INCLUDE ALL CEILING MOUNTED FIXTURES, DEVICES AND EQUIPMENT; REFER TO ARCHITECTURAL, MECHANICAL AND ELECTRICAL DRAWING PACKAGES FOR EXTENT OF DISPOSAL. PATCH, REPAIR AND MAKE GOOD EXISTING SUBSTRATE AS REQUIRED FOR APPLICATION OF NEW FINISHES, UNLESS NOTED OTHERWISE.

DEMOLITION RCP SYMBOLS:

NOTE: ALL HATCHES, SYMBOLS AND REFERENCE TO BE COORDINATED WITH THE GENERAL RENOVATION NOTES, CONSTRUCTION TYPES, AND GENERAL NOTES ON DRAWING A00.01

DENOTED AREA OF EXISTING NON-RATED INDICATES EXISTING LIGHTING FIXTURES TO BE

ACOUSTIC CEILING TILE AND GRID TO BE REMOVED AND DISPOSED OF



INDICATES EXISTING LIGHTING FIXTURES TO BE REMOVED AND DISPOSED OF

REPLACED. REFER TO ELECTRICAL DRAWINGS

ALL EXISTING CCTV CAMERA AND SECURITY DEVICES TO REMAIN UNLESS OTHERWISE NOTED



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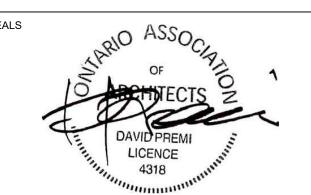
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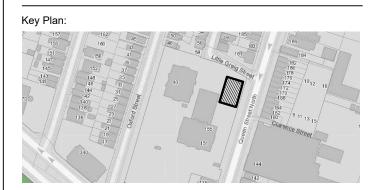
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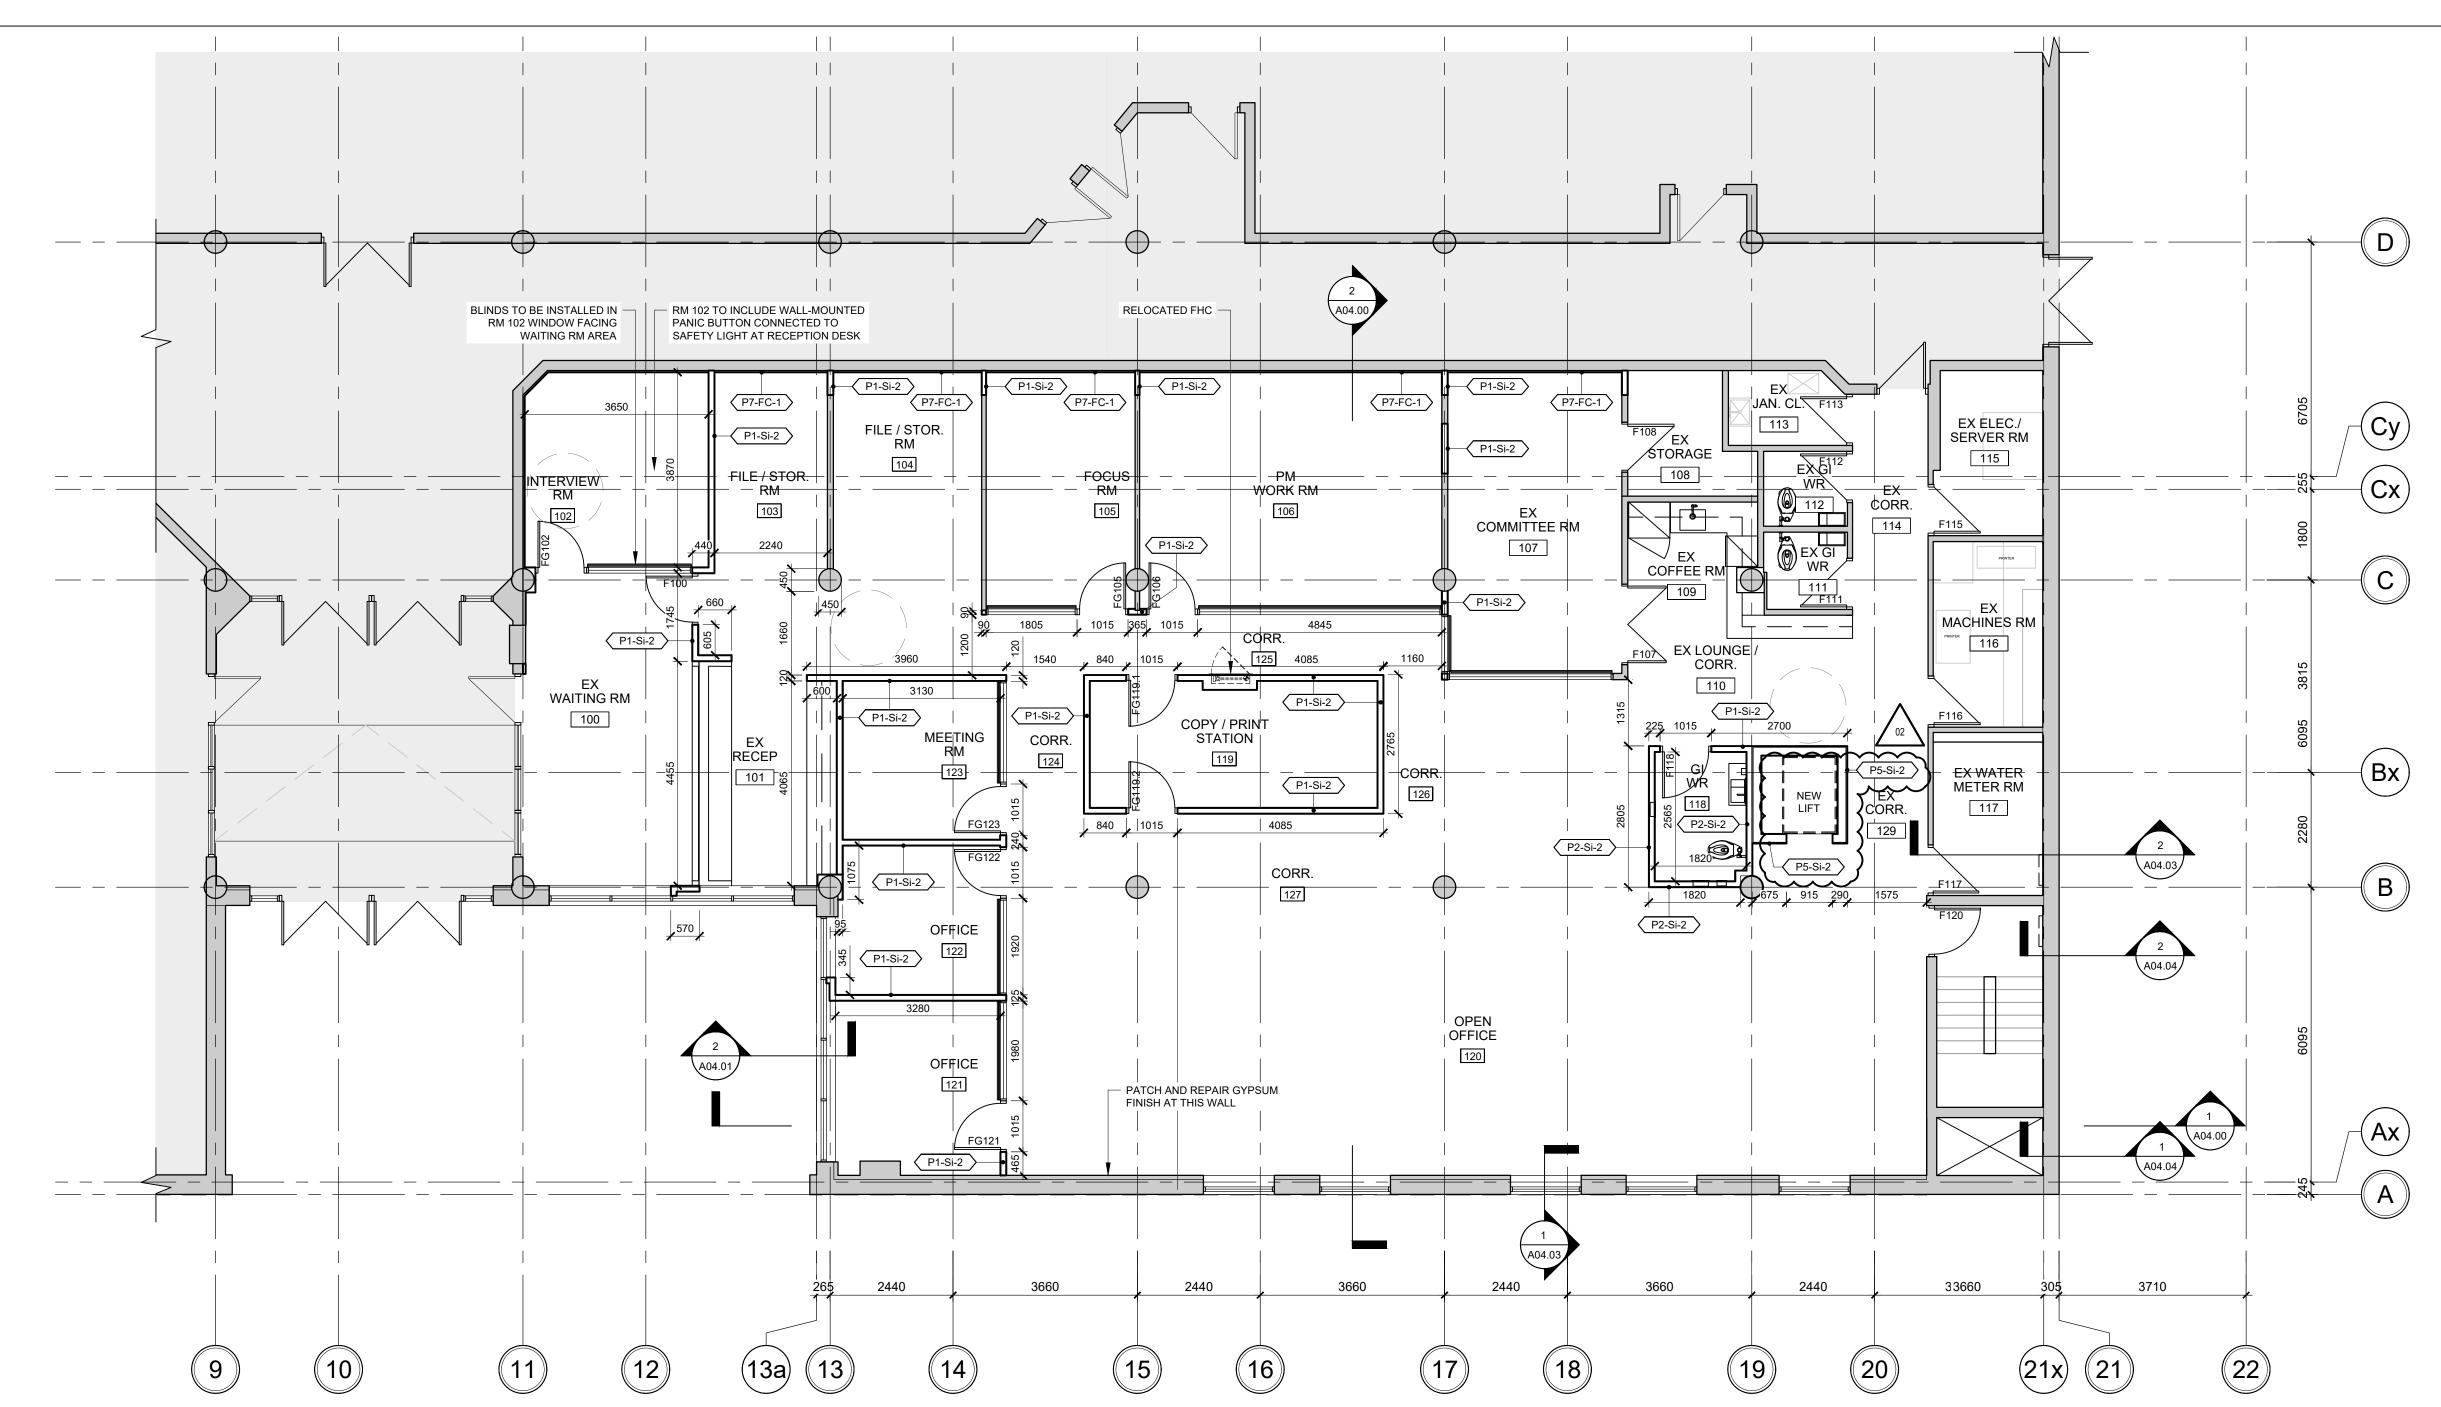




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DEMOLITION PLAN REFLECTED CEILING PLAN

ISSUE DATE:	202	3.09.06
DRAWN BY: GL	CHECKED BY:	SL
PROJECT NO.: 12228	SCALE:	1 : 75
DRAWING NO.:	l REV	/ISION:



RENOVATION PLAN - LEVEL 1

SCALE: 1:75

SCALE: 1:75

EX WOMEN'S WASHROOM NEW DOOR, $^{
lap}$ Partitions. FIXTURES, MODIFICATIONS AND FINISHES EX MEN'S WASHROOM NEW DOOR TO EX -WASHROOM

RENOVATION PLAN - LEVEL 1 WASHROOMS

GENERAL RENOVATION PLAN NOTES:

GENERAL REQUIREMENTS

1. ALL WORK SHALL CONFORM TO THE REQUIREMENTS OF ALL EXISTING BY-LAWS, CODES, MUNICIPAL GOVERNMENTS AND AUTHORITIES HAVING JURISDICTION. OBTAIN ALL PERMITS REQUIRED IN

- ACCORDANCE WITH THE CONTRACT. 2. IF APPLICABLE, EXECUTION OF THE WORK SHALL FOLLOW ANY PHASING AS INDICATED. ISOLATE EACH AREA OF WORK AS REQUIRED SO AS TO NOT DISRUPT DAY TO DAY OPERATION. ACCESS TO WASHROOMS, ELEVATORS, STAIRS ETC. MUST BE MAINTAINED AT ALL
- 3. DIMENSIONS SHOWN ARE TAKEN TO FACE OF CMU, POURED CONCRETE, OR WALL UNLESS NOTED OTHERWISE. ALL GWB OR CMU PARTITIONS TO EXTEND TIGHT TO U/S OF DECK UNLESS NOTED OTHERWISE.
- 4. CONSTRUCT PARTITIONS AND WALLS AS FIRE SEPARATIONS WHERE INDICATED ON PLAN 5. ALL INTERIOR ALUM SCREENS SHALL HAVE GWB AND METAL STUD
- ASSEMBLIES FROM TOP OF SCREEN/DOOR FRAME TO UNDERSIDE OF DECKS UNLESS A LINTEL HAS BEEN PROVIDED BY STRUCTURAL DRAWINGS WITH BLOCK WALL ABOVE TO U/S DECKS. 6. WHERE SCREENS OR DOORS OCCUR WITHIN WALLS CONSTRUCTED
- AS FIRE SEPARATIONS, THE WALL ABOVE SUCH SCREENS OR DOORS SHALL BE CONSTRUCTED TO PROVIDE THE REQUIRED FIRE RESISTANCE RATING INDICATED. 7. WHERE FIRE RATED PARTITIONS ABUT NON-RATED PARTITIONS THE
- CONTINUITY OF THE FIRE RATED ASSEMBLY SHALL BE MAINTAINED. 8. SEAL PERIMETER OF WALLS AND AROUND PENETRATIONS THROUGH
- WALLS WITH ACOUSTIC SEALANT WHERE SOUND ATTENUATION BATTS ARE CALLED FOR ON THE WALL TYPE. 9. SEAL PERIMETER OF FIRE RATED WALLS AND AROUND
- PENETRATIONS THROUGH FIRE RATED WALLS WITH APPROVED FIRESTOP MATERIALS.
- 10. CORNERS OF EXPOSED MASONRY WALLS SHALL BE BULLNOSE BLOCK UNLESS NOTED OTHERWISE. 11. REFER TO ELECTRICAL DWGS FOR LOCATIONS OF PANELS, DOOR CONTROLS, SECURITY DEVICES ETC NOT SHOWN ON ARCHITECTURAL DRAWINGS.



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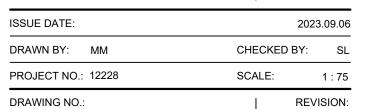
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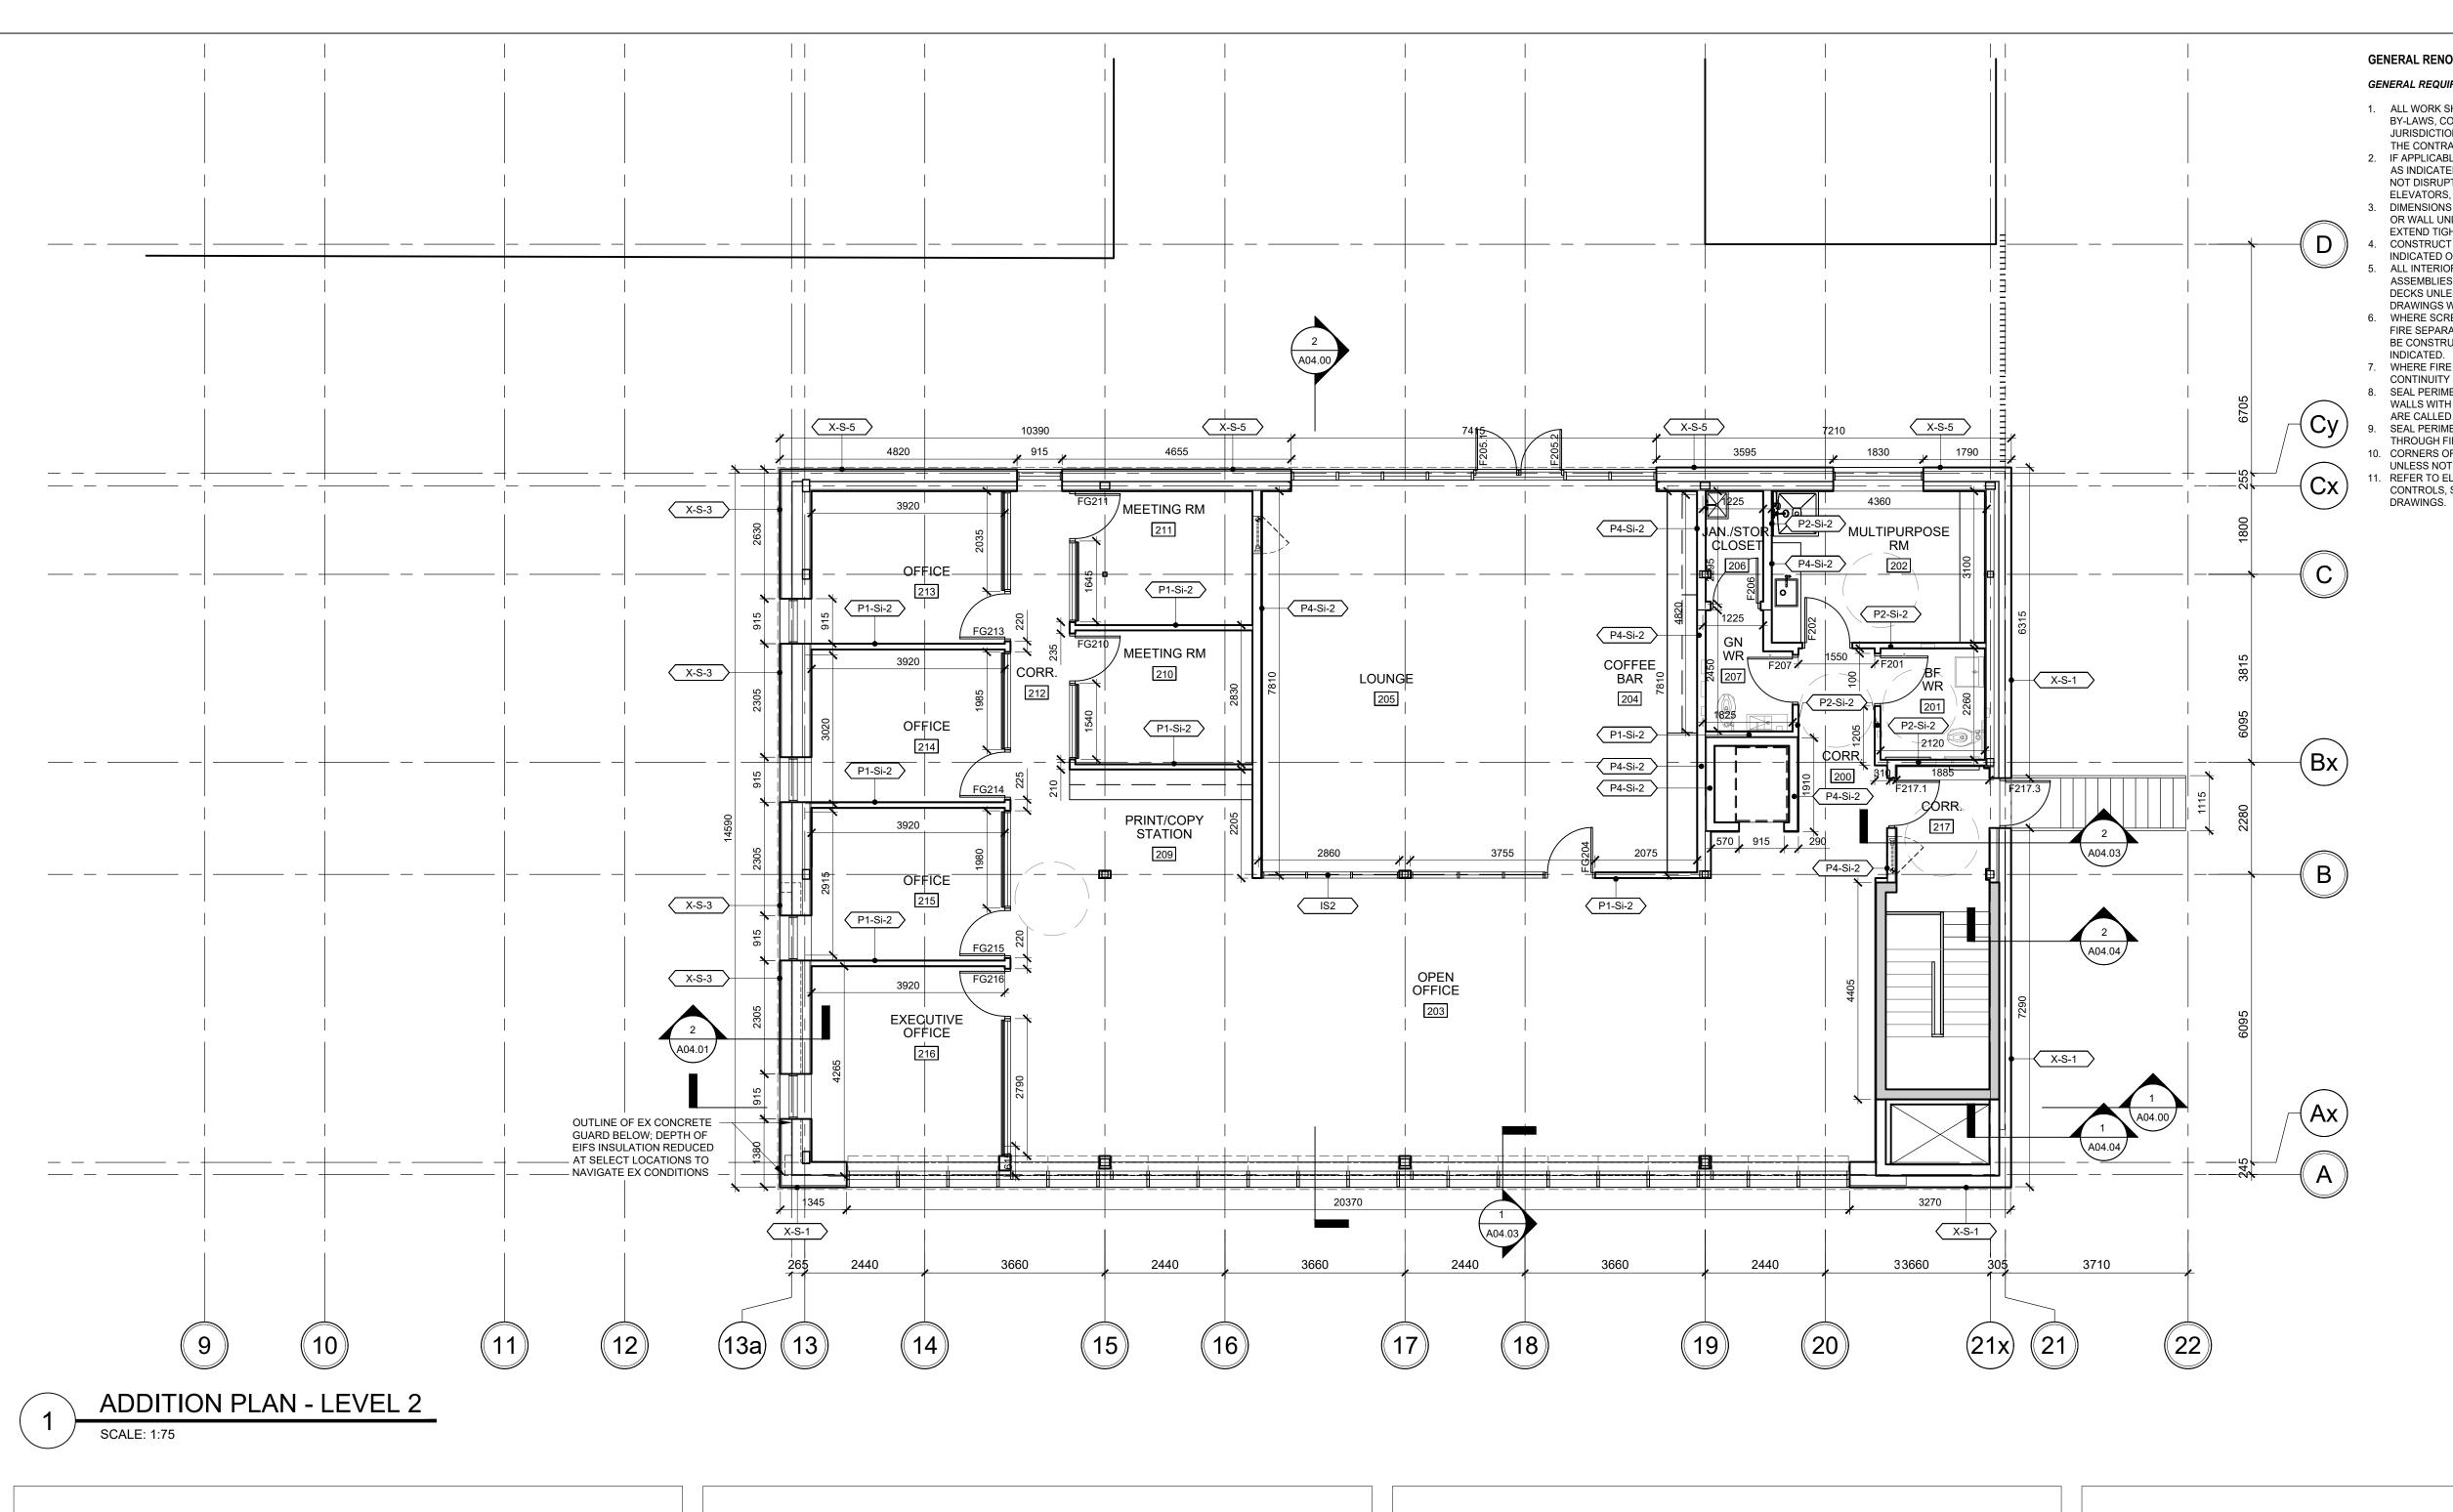
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RENOVATION PLAN





DETAIL APPLIES TO ALL AREAS

WHERE CONDITION EXISTS

REGARDLESS OF WALL TYPE

PACK MINERAL WOOL (DECK

PLUGS PREFERRED) TO FILL

GAP BETWEEN TOP OF WALL

AND DECK, FILLING FLUTES

TO INTERIOR FACE OF WALL

SEAL EXPOSED FACES

OUTSIDE

TOW EXT. WALL - DECK PERP. TO FLUTES

ROOF

U/S OF DECK-

INSIDE

DETAIL APPLIES TO ALL AREAS

WHERE CONDITION EXISTS

REGARDLESS OF WALL TYPE

-PACK MINERAL WOOL (DECK

PLUGS PREFERRED) TO FILL

GAP BETWEEN TOP OF WALL

AND DECK, FILLING FLUTES

TO INTERIOR FACE OF WALL

SEAL EXPOSED FACES

OUTSIDE

TOW EXT. WALL - DECK PARALLEL TO FLUTES

/ROOF\

U/S OF DECK-

SCALE: 1:4

INSIDE

GENERAL RENOVATION PLAN NOTES:

GENERAL REQUIREMENTS

- 1. ALL WORK SHALL CONFORM TO THE REQUIREMENTS OF ALL EXISTING BY-LAWS, CODES, MUNICIPAL GOVERNMENTS AND AUTHORITIES HAVING JURISDICTION. OBTAIN ALL PERMITS REQUIRED IN ACCORDANCE WITH
- THE CONTRACT. 2. IF APPLICABLE, EXECUTION OF THE WORK SHALL FOLLOW ANY PHASING AS INDICATED. ISOLATE EACH AREA OF WORK AS REQUIRED SO AS TO NOT DISRUPT DAY TO DAY OPERATION. ACCESS TO WASHROOMS,
- ELEVATORS, STAIRS ETC. MUST BE MAINTAINED AT ALL TIMES. DIMENSIONS SHOWN ARE TAKEN TO FACE OF CMU, POURED CONCRETE, OR WALL UNLESS NOTED OTHERWISE. ALL GWB OR CMU PARTITIONS TO EXTEND TIGHT TO U/S OF DECK UNLESS NOTED OTHERWISE.
- CONSTRUCT PARTITIONS AND WALLS AS FIRE SEPARATIONS WHERE INDICATED ON PLAN ALL INTERIOR ALUM SCREENS SHALL HAVE GWB AND METAL STUD
- ASSEMBLIES FROM TOP OF SCREEN/DOOR FRAME TO UNDERSIDE OF DECKS UNLESS A LINTEL HAS BEEN PROVIDED BY STRUCTURAL DRAWINGS WITH BLOCK WALL ABOVE TO U/S DECKS. WHERE SCREENS OR DOORS OCCUR WITHIN WALLS CONSTRUCTED AS
- FIRE SEPARATIONS. THE WALL ABOVE SUCH SCREENS OR DOORS SHALL BE CONSTRUCTED TO PROVIDE THE REQUIRED FIRE RESISTANCE RATING 7. WHERE FIRE RATED PARTITIONS ABUT NON-RATED PARTITIONS THE CONTINUITY OF THE FIRE RATED ASSEMBLY SHALL BE MAINTAINED.
- 8. SEAL PERIMETER OF WALLS AND AROUND PENETRATIONS THROUGH WALLS WITH ACOUSTIC SEALANT WHERE SOUND ATTENUATION BATTS ARE CALLED FOR ON THE WALL TYPE. SEAL PERIMETER OF FIRE RATED WALLS AND AROUND PENETRATIONS
- THROUGH FIRE RATED WALLS WITH APPROVED FIRESTOP MATERIALS. 10. CORNERS OF EXPOSED MASONRY WALLS SHALL BE BULLNOSE BLOCK UNLESS NOTED OTHERWISE.

TOP OF DECK

OR DECK PLUG

- BOTTOM OF DECK

MINERAL FIBER INSULATION

(DECK PLUG PREFERRED)

DEFLECTION TRACK ASSEMBLY

TRACK ALSO ACCEPTABLE)

- METAL STUD

GYPSUM BOARD

BY WALL TYPE)

(DOUBLE DEFLECTION TRACK SHOWN - DEEP LEG DEFLECTION

MINERAL FIBER INSULATION

MULTIPLE LAYERS IF REQ'D

(IF REQ'D BY WALL TYPE)

(SINGLE LAYER SHOWN -

NO CONNECTIÓN TO **DEFLECTION TRACK**

REFER TO ELECTRICAL DWGS FOR LOCATIONS OF PANELS, DOOR CONTROLS, SECURITY DEVICES ETC NOT SHOWN ON ARCHITECTURAL



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> ADDITION PLAN LEVEL 2

DRAWING TITLE:

ISSUE DATE: 2023.09.06 DRAWN BY: MM CHECKED BY: SL PROJECT NO.: 12228 SCALE: DRAWING NO.: REVISION:

FIRE RATED DETAIL - MAINTAIN REQUIRED FIRE RESISTANCE RATING OVER ENTIRE ASSEMBLY METAL TRACK DEFLECTION DETAIL METAL TRACK DEFLECTION DETAIL - FR

 FIRE RATED SEALANT MINERAL FIBER INSULATION

(DECK PLUG PREFERRED)

REF: ULC No. HW-D-0513 OR

- TYPE 'X' GYPSUM BOARD RIP (SINGLE LAYER SHOWN -

MULTIPLE LAYERS IF REQ'D BY

OR DECK PLUG

EQUIVALENT

U/S OF DECK

FIRE RATED DEFLECTION TRACK

WALL TYPE)

FIRE RATED SEALANT

- METAL STUD SCREWED

FRAMING BELOW


THROUGH TRACK SLOT


- MINERAL FIBER INSULATION

- NO CONNECTION TO WALL

TYPE'X' GYPSUM BUARD

(SINGLE LAYER SHOWN -MULTIPLE LAYERS IF REQ'D BY WALL TYPE)

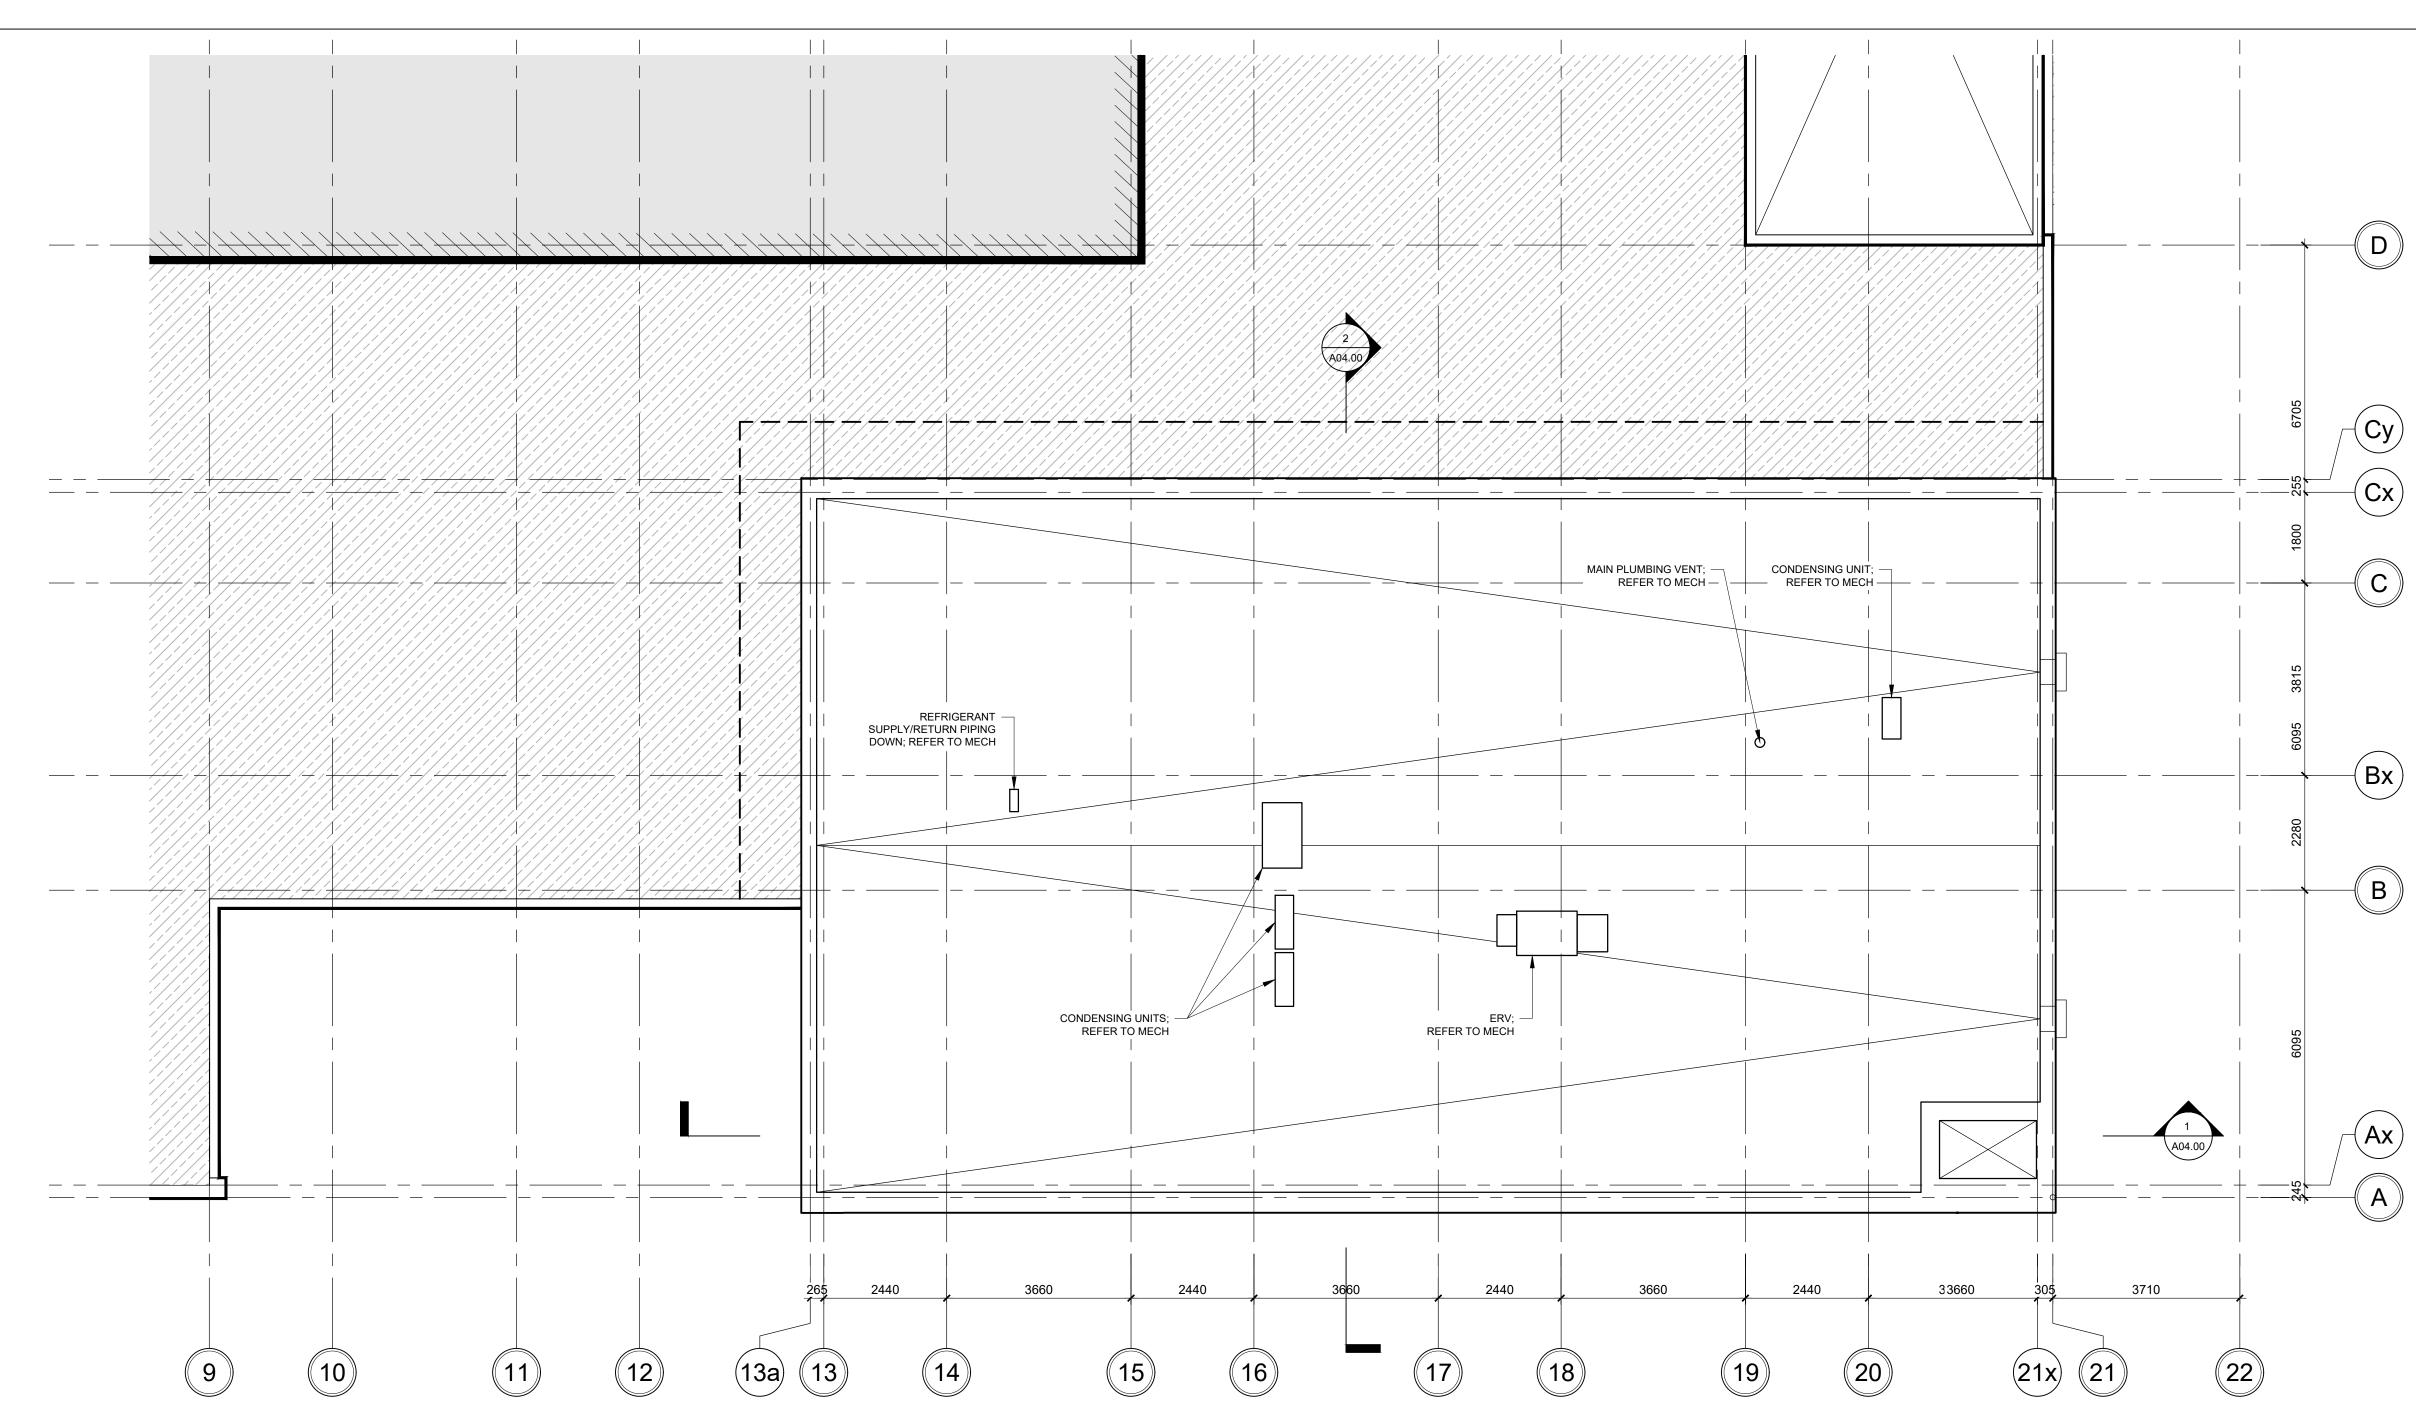

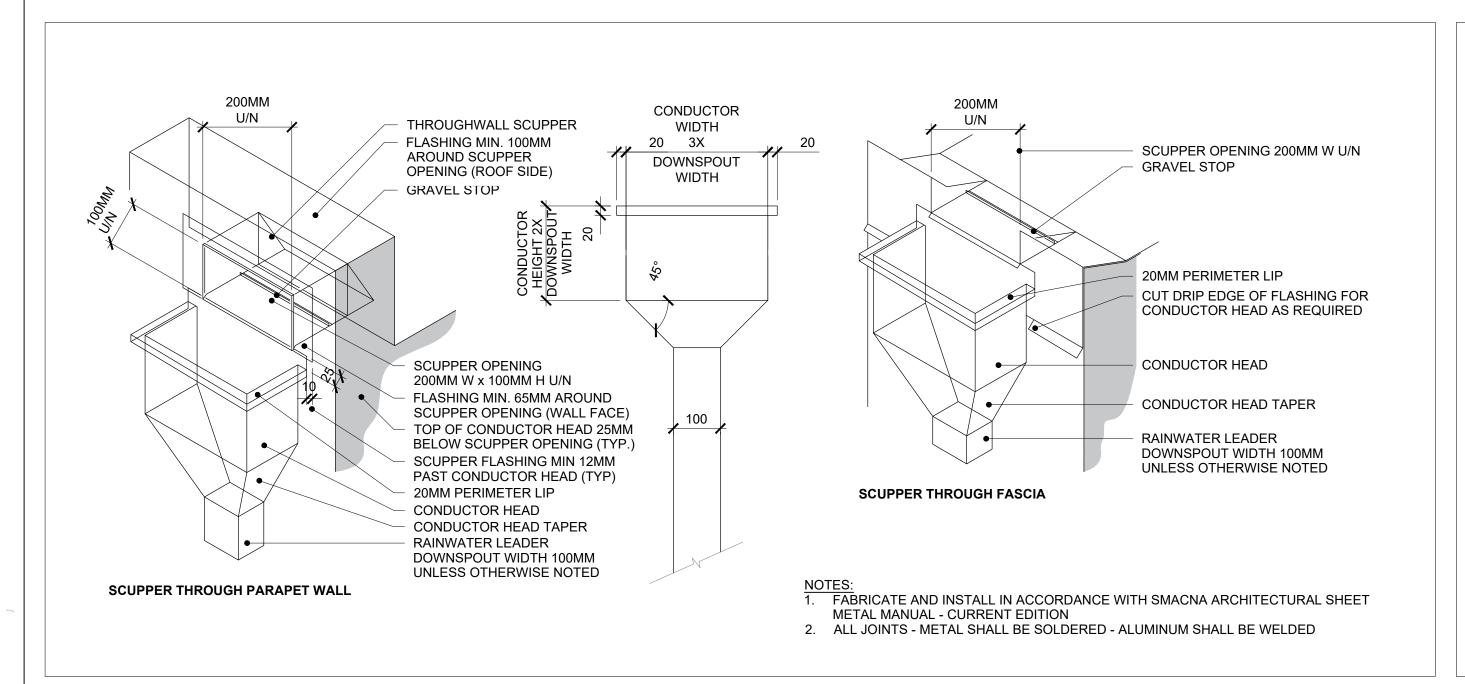

RTU (OR SIMILAR EQUIPMENT)— —NOT INTENDED TO ROOF CURB-DESCRIBE ACTUAL ROOF ROOF SURFACE— CURB INSTALLATION. ROOF CURB INSTALLED IN ACCORDANCE WITH MANUFACTURERS RECOMMENDATION

WITHOUT EXCEPTION

ROOF MOUNTED EQUIPMENT AND FITTINGS THAT REQUIRE A ROOF CURB SHALL BE SUPPORTED BY A CURB OF SUFFICIENT HEIGHT SO THAT THE TOP OF CURB IS AT LEAST 250mm ABOVE THE ADJACENT ROOF SURFACE.

ROOF CURB HEIGHT AS INDICATED BELOW **MUST** BE NOTED ON SUBMITTALS. ALL CURB LOCATIONS MUST BE COORDINATED WITH RELEVANT STRUCTURAL STEEL SUBMITTALS. CONTRACTOR TO COORDINATE WITH SUPPLIERS/MANUFACTURERS ACCORDINGLY.

ROOF PLAN GENERAL NOTES:

- GENERAL REQUIREMENTS

 1. ROOF PLAN DOES NOT SHOW ALL PENETRATIONS THROUGH ROOF. 2. CONTRACTOR SHALL REVIEW ALL CONTRACT DRAWINGS AND SPECIFICATIONS TO
- DETERMINE FULL SCOPE OF WORK. B. MAKE PROVISIONS FOR ROOF PENETRATIONS WHERE INDICATED AND REQUIRED UNDER THE SCOPE OF THIS CONTRACT.

INSULATION

- 1. PROVIDE TAPERED INSULATION AT PERIMETER OF ALL ROOFS, SKYLIGHTS AND AS INDICATED. SLOPE SHALL BE NO LESS THAN 2%. UNLESS NOTED OTHERWISE, SUMP ALL ROOF DRAINS IN ACCORDANCE WITH APPLICABLE CRCA DETAIL. AS INDICATED OR AS REQUIRED, PROVIDE TAPERED CRICKETS OR SIMILAR TYPE MEASURES TO ENSURE THAT ROOF WATER FLOWS
- 3. SLOPE OF ROOF STRUCTURE TO BE SUPPLEMENTED BY TAPERED INSULATION. SLOPE ROOF INSULATION MIN. 1.5% TO DRAINS, TYPICAL. CRICKETS, CONSTRUCTED OUT OF TAPERED INSULATION, ARE TO PROVIDE TWO TIMES THE SLOPE OF THE ROOF STRUCTURE.

PENETRATIONS ALL ROOF PENETRATIONS SHALL BE SEALED USING TALL CONE FLASHING OR PITCH POCKETS AS REQUIRED. CONES SHALL BE SEAMLESS AND INCLUDE A STORM COLLAR.

EQUIPMENT 1. UPSTANDS ON ROOF FOR MECHANICAL UNITS, PARAPETS, SKYLIGHTS TO COME

COMPLETE WITH CANT STRIPS.

WITHOUT EXCEPTION, ROOF MOUNTED EQUIPMENT AND FITTINGS THAT REQUIRE A ROOF CURB SHALL BE SUPPORTED BY A CURB OF SUFFICIENT HEIGHT SO THAT THE TOP OF CURB IS AT LEAST 250mm ABOVE THE ADJACENT ROOF SURFACE. CONTRACTORTO COORDINATE WITH SUPPLIERS/MANUFACTURERS

ACCORDINGLY. **MEMBRANES**

1. CONTINUOUS VAPOUR RETARDER MEMBRANE COMPONENT OF ROOF ASSEMBLIES TO BE WRAPPED UP AT ALL PARAPETS, CURBS, EXTERIOR WALL ASSEMBLIES BY A MIN. 200mm OR AS DETAILED ON DRAWINGS. TIE INTO VAPOUR BARRIER & AVB MEMBRANES ON ALL VERTICAL SURFACES. PROVIDE 'PEEL & STICK' TYPE TRANSITION MEMBRANES IN ORDER TO ENSURE CONTINUITY OF AIR BARRIERS/BUILDING ENVELOPE

- **ROOF ANCHORS** REFER TO SPECIFICATIONS FOR ROOF ANCHORS AND RELATED REQUIREMENTS. FULLY COORINDATE ROOF ANCHOR LOCATIONS WITH STRUCTURAL DRAWINGS & ROOF ANCHOR SHOP DRAWINGS TO ENSURE PROPER PLACEMENT OF ALL ROOF
- 3. LAYOUT SHOWN IS PERLIMINARY ONLY. FINAL LAYOUT TO BE CONFIRMED WITH ROOF ANCHOR SUPPLIER.



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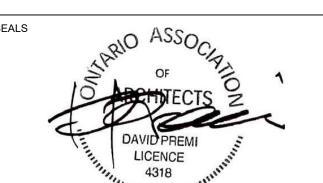
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PROJECT NO.: 12228


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SCALE:	1:	— 75

REVISION:

DRAWING NO.:

RWL(CH)-1 RAIN WATER LEADER DETAILS

ROOF CURB DETAIL

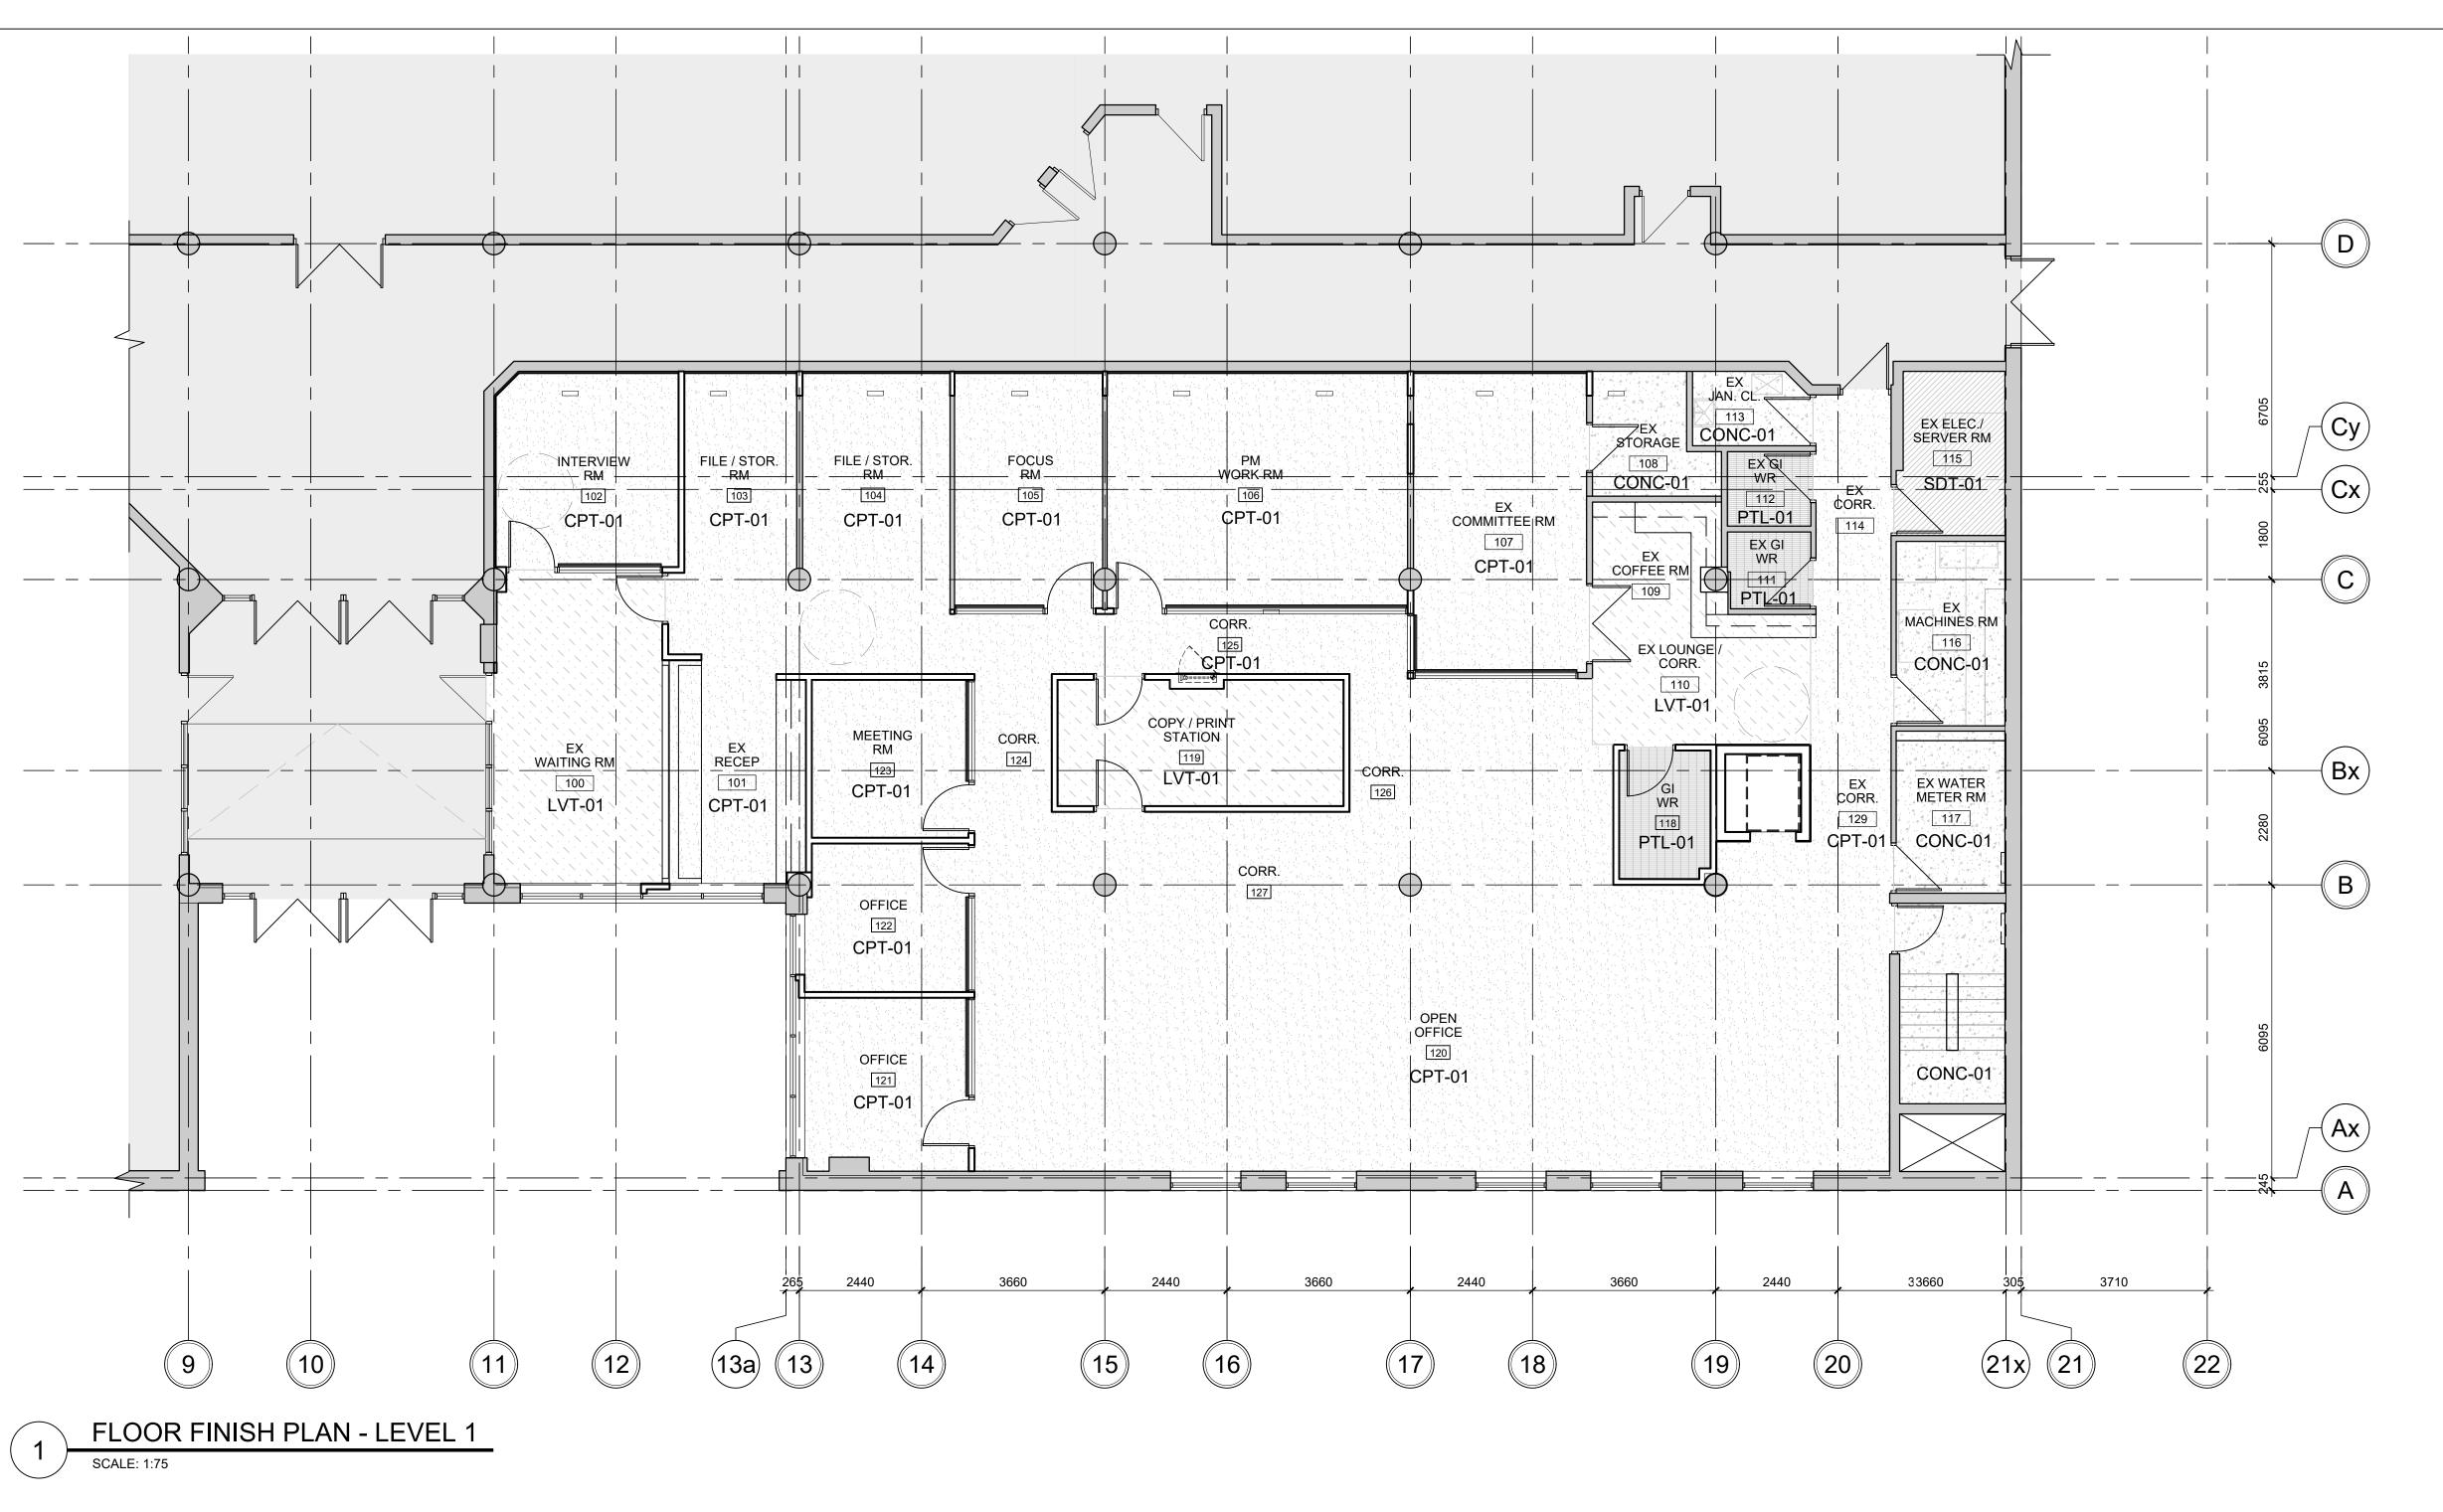

FLOOR FINISH GENERAL NOTES:

GENERAL REQUIREMENTS

1. ALL INTERIOR FINISHES SHALL COMPLY WITH THE REQUIREMENTS OF THE BUILDING CODE (LATEST REVISION) THE TERRAZZO, TILE & MARBLE ASSOCIATION OF CANADA (TTMAC) AND AUTHORITIES HAVING JURISDICTION.

- 2. REFER TO ROOM FINISH SCHEDULE FOR FLOOR AND BASE 3. ALL FLOOR FINISHES TO BE INSTALLED IN ACCORDANCE WITH
- MANUFACTURERS INSTRUCTIONS AND PROJECT
- SPECIFICATION. 4. FLOOR TILES ARE TO BE INSTALLED IN PATTERNS AS INDICATED.
- 5. WHERE TILES ARE INDICATED TO BE INSTALLED IN A RUNNING BOND PATTERN, INSTALL IN A 1/5 RUNNING BOND PATTERN (20% OVERLAP) TO REDUCE LIPPAGE AS DEFINED BY TTMAC.
- 6. MOVEMENT JOINTS SHALL BE IN ACCORDANCE WITH TTMAC DOCUMENT 301MJ- (CURRENT REVISION). 7. UNLESS OTHERWISE NOTED, ALL FLOOR FINISHES TO BE
- INSTALLED PRIOR TO INSTALLATION OF MILLWORK.
- 8. NO SUBSTITUTIONS OF FLOOR FINISHES PERMITTED WITHOUT CONSULTANT WRITTEN APPROVAL.
- 9. CONTRACTOR IS RESPONSIBLE FOR THE PROTECTION OF ALL FLOOR FINISHES FOR THE DURATION OF THE WORK.
- 10. CONTRACTOR TO PROVIDE PROTECTION OF ALL FINISHED CONCRETE FLOORS USING PREMANUFACTURED CARDBOARD TEMPORARY FLOOR PROTECTION (OR APPROVED EQUIVALENT) FOR THE DURATION OF THE WORK.
- 11. CONTRACTOR TO PROVIDE PROTECTION OF ALL FINISHED TILED FLOORS USING PREMANUFACTURED CARDBOARD TEMPORARY FLOOR PROTECTION (OR APPROVED EQUIVALENT) FOR THE DURATION OF THE WORK.
- 12. CHANGES IN FLOOR FINISH AT DOOR OPENINGS SHALL OCCUR UNDERNEATH THE DOOR (IN THE CLOSED POSITION) UNLESS OTHERWISE NOTED. WHERE THERE IS AN OPENING WITH NO DOOR, CHANGES IN FLOOR FINISH SHALL OCCUR AT THE
- MIDPOINT OF THE OPENING. 13. UNLESS NOTED OTHERWISE, TILE BASES SHALL BE 100MM HIGH MEASURED FROM THE ADJACENT FINISHED FLOOR.
- 14. WHERE A CHANGE OF FLOORING MATERIAL THICKNESS OCCURS, FEATHER FLOOR AS REQUIRED.

FLOOR FINISH PLAN LEGEND AND SYMBOLS:

SYMBOL CODE TYPE

NOTE: ALL HATCHES, SYMBOLS AND REFERENCES ARE TO COORDINATED WITH THE GENERAL RENOVATION NOTES, CONSTRUCTION TYPES AND GENERAL NOTES ON DRAWING A00.01

CPT-01 NEW FIELD CARPET TILE NEW LUXURY VINYL TILE NEW PORCELAIN TILE

CONC-01 FINISHED CONCRETE SLAB

AREA NOT IN CONTRACT/SCOPE



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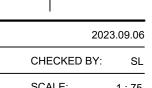
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DRAWIN	NG TITLE:	1

FLOOR FINISH PLAN

ISSUE DATE:



DRAWN BY: AW	CHECKED BY:	SL
PROJECT NO.: 12228	SCALE:	1:75
DRAWING NO.:	REV	ISION:



FLOOR FINISH PLAN - LEVEL 2

FLOOR FINISH GENERAL NOTES:

GENERAL REQUIREMENTS

- ALL INTERIOR FINISHES SHALL COMPLY WITH THE REQUIREMENTS OF THE BUILDING CODE (LATEST REVISION) THE TERRAZZO, TILE & MARBLE ASSOCIATION OF CANADA (TTMAC) AND AUTHORITIES HAVING JURISDICTION.
 REFER TO ROOM FINISH SCHEDULE FOR FLOOR AND BASE
- ALL FLOOR FINISHES TO BE INSTALLED IN ACCORDANCE WITH MANUFACTURERS INSTRUCTIONS AND PROJECT

BOND PATTERN, INSTALL IN A 1/5 RUNNING BOND PATTERN

- SPECIFICATION.

 4 FLOOR TILES ARE TO BE INSTALLED IN PATTERNS AS
- 4. FLOOR TILES ARE TO BE INSTALLED IN PATTERNS AS INDICATED.
 5. WHERE TILES ARE INDICATED TO BE INSTALLED IN A RUNNING
- (20% OVERLAP) TO REDUCE LIPPAGE AS DEFINED BY TTMAC.

 6. MOVEMENT JOINTS SHALL BE IN ACCORDANCE WITH TTMAC
- DOCUMENT 301MJ- (CURRENT REVISION).
 7. UNLESS OTHERWISE NOTED, ALL FLOOR FINISHES TO BE
- UNLESS OTHERWISE NOTED, ALL FLOOR FINISHES TO BE INSTALLED PRIOR TO INSTALLATION OF MILLWORK.
 NO SUBSTITUTIONS OF FLOOR FINISHES PERMITTED WITHOUT
- CONSULTANT WRITTEN APPROVAL.
 9. CONTRACTOR IS RESPONSIBLE FOR THE PROTECTION OF ALL
- FLOOR FINISHES FOR THE DURATION OF THE WORK.

 10. CONTRACTOR TO PROVIDE PROTECTION OF ALL FINISHED CONCRETE FLOORS USING PREMANUFACTURED CARDBOARD TEMPORARY FLOOR PROTECTION (OR APPROVED EQUIVALENT) FOR THE DURATION OF THE WORK.
- 11. CONTRACTOR TO PROVIDE PROTECTION OF ALL FINISHED TILED FLOORS USING PREMANUFACTURED CARDBOARD TEMPORARY FLOOR PROTECTION (OR APPROVED EQUIVALENT) FOR THE DURATION OF THE WORK.
- 12. CHANGES IN FLOOR FINISH AT DOOR OPENINGS SHALL OCCUR UNDERNEATH THE DOOR (IN THE CLOSED POSITION) UNLESS OTHERWISE NOTED. WHERE THERE IS AN OPENING WITH NO DOOR, CHANGES IN FLOOR FINISH SHALL OCCUR AT THE
- MIDPOINT OF THE OPENING.

 13. UNLESS NOTED OTHERWISE, TILE BASES SHALL BE 100MM HIGH MEASURED FROM THE ADJACENT FINISHED FLOOR.
- 14. WHERE A CHANGE OF FLOORING MATERIAL THICKNESS OCCURS, FEATHER FLOOR AS REQUIRED.

FLOOR FINISH PLAN LEGEND AND SYMBOLS:

SYMBOL CODE TYPE

NOTE: ALL HATCHES, SYMBOLS AND REFERENCES ARE TO COORDINATED WITH THE GENERAL RENOVATION NOTES, CONSTRUCTION TYPES AND GENERAL NOTES ON DRAWING A00.01

CPT-01 NEW FIELD CARPET TILE

LVT-01 NEW LUXURY VINYL TILE

PTL-01 NEW PORCELAIN TILE

CONC-01 FINISHED CONCRETE SLAB

- AREA NOT IN CONTRACT/SCOPE



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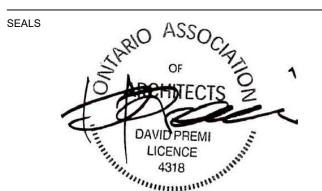
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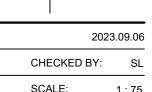
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02	ISSUED FOR TENDER	2023.09.06
01	ISSUED FOR PERMIT	2023.05.16
NO.	ISSUES/REVISIONS	DATE
DRAWIN	NG TITLE:	

FLOOR FINISH PLAN LEVEL 2


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PROJECT NO.:	12228	SCALE:	1 : 75
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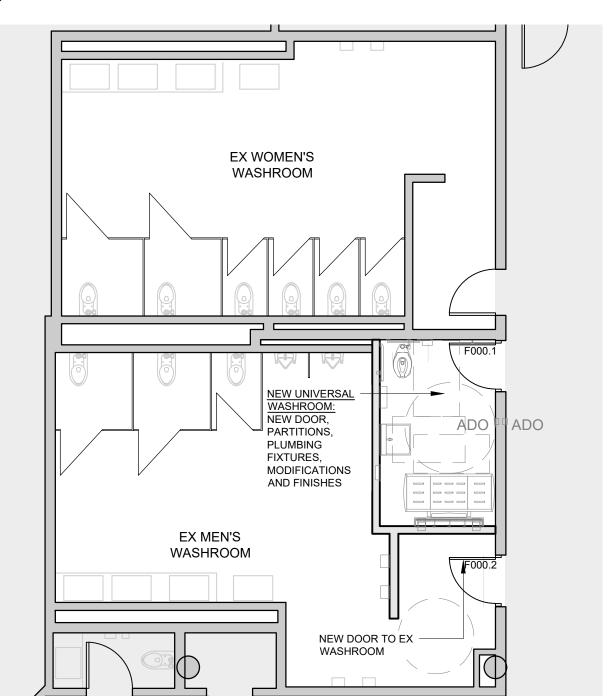
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RENOVATION PLAN - LEVEL 1 - FURNITURE AND FINISHES

SCALE: 1:75



GENERAL RENOVATION PLAN NOTES:

GENERAL REQUIREMENTS

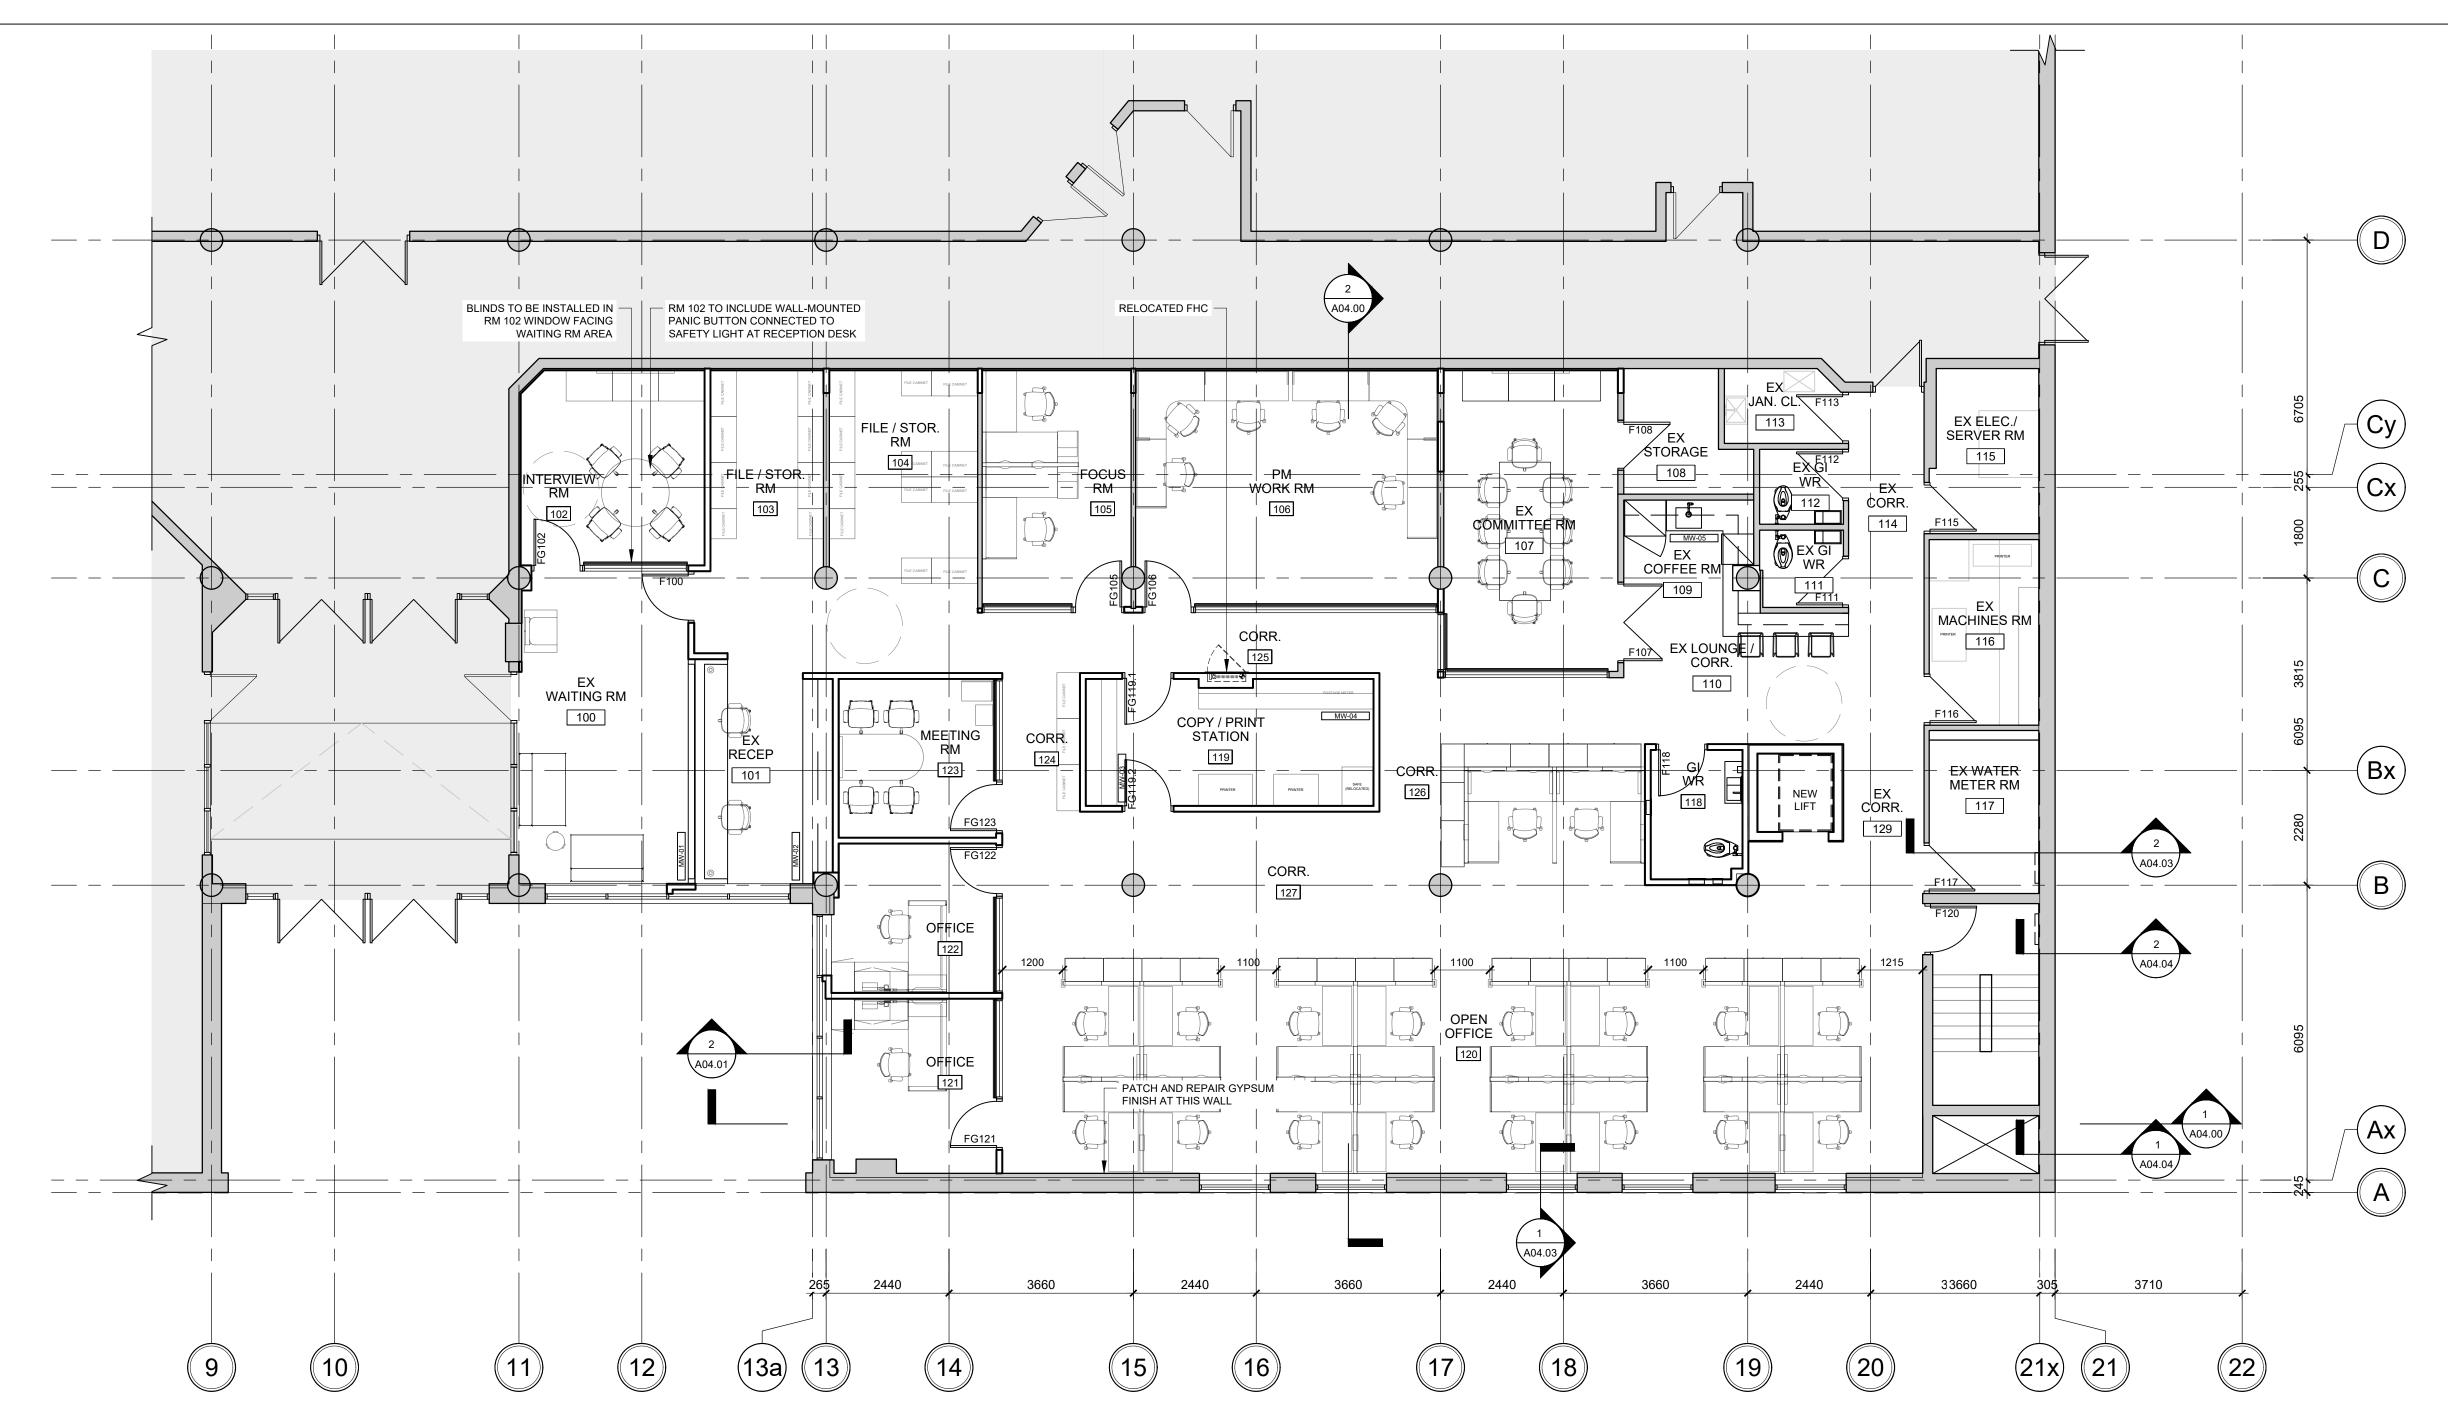DRAWINGS.

1. ALL WORK SHALL CONFORM TO THE REQUIREMENTS OF ALL EXISTING BY-LAWS, CODES, MUNICIPAL GOVERNMENTS AND AUTHORITIES

HAVING JURISDICTION. OBTAIN ALL PERMITS REQUIRED IN ACCORDANCE WITH THE CONTRACT. 2. IF APPLICABLE, EXECUTION OF THE WORK SHALL FOLLOW ANY

PHASING AS INDICATED. ISOLATE EACH AREA OF WORK AS REQUIRED SO AS TO NOT DISRUPT DAY TO DAY OPERATION. ACCESS TO WASHROOMS, ELEVATORS, STAIRS ETC. MUST BE MAINTAINED AT ALL

3. DIMENSIONS SHOWN ARE TAKEN TO FACE OF CMU, POURED CONCRETE, OR WALL UNLESS NOTED OTHERWISE. ALL GWB OR CMU PARTITIONS TO EXTEND TIGHT TO U/S OF DECK UNLESS NOTED OTHERWISE.

4. CONSTRUCT PARTITIONS AND WALLS AS FIRE SEPARATIONS WHERE INDICATED ON PLAN 5. ALL INTERIOR ALUM SCREENS SHALL HAVE GWB AND METAL STUD ASSEMBLIES FROM TOP OF SCREEN/DOOR FRAME TO UNDERSIDE OF

DECKS UNLESS A LINTEL HAS BEEN PROVIDED BY STRUCTURAL

DRAWINGS WITH BLOCK WALL ABOVE TO U/S DECKS. 6. WHERE SCREENS OR DOORS OCCUR WITHIN WALLS CONSTRUCTED AS FIRE SEPARATIONS, THE WALL ABOVE SUCH SCREENS OR DOORS SHALL BE CONSTRUCTED TO PROVIDE THE REQUIRED FIRE

RESISTANCE RATING INDICATED. 7. WHERE FIRE RATED PARTITIONS ABUT NON-RATED PARTITIONS THE CONTINUITY OF THE FIRE RATED ASSEMBLY SHALL BE MAINTAINED. 8. SEAL PERIMETER OF WALLS AND AROUND PENETRATIONS THROUGH

WALLS WITH ACOUSTIC SEALANT WHERE SOUND ATTENUATION BATTS ARE CALLED FOR ON THE WALL TYPE.

9. SEAL PERIMETER OF FIRE RATED WALLS AND AROUND PENETRATIONS THROUGH FIRE RATED WALLS WITH APPROVED

FIRESTOP MATERIALS. 10. CORNERS OF EXPOSED MASONRY WALLS SHALL BE BULLNOSE BLOCK UNLESS NOTED OTHERWISE. 11. REFER TO ELECTRICAL DWGS FOR LOCATIONS OF PANELS, DOOR CONTROLS, SECURITY DEVICES ETC NOT SHOWN ON ARCHITECTURAL



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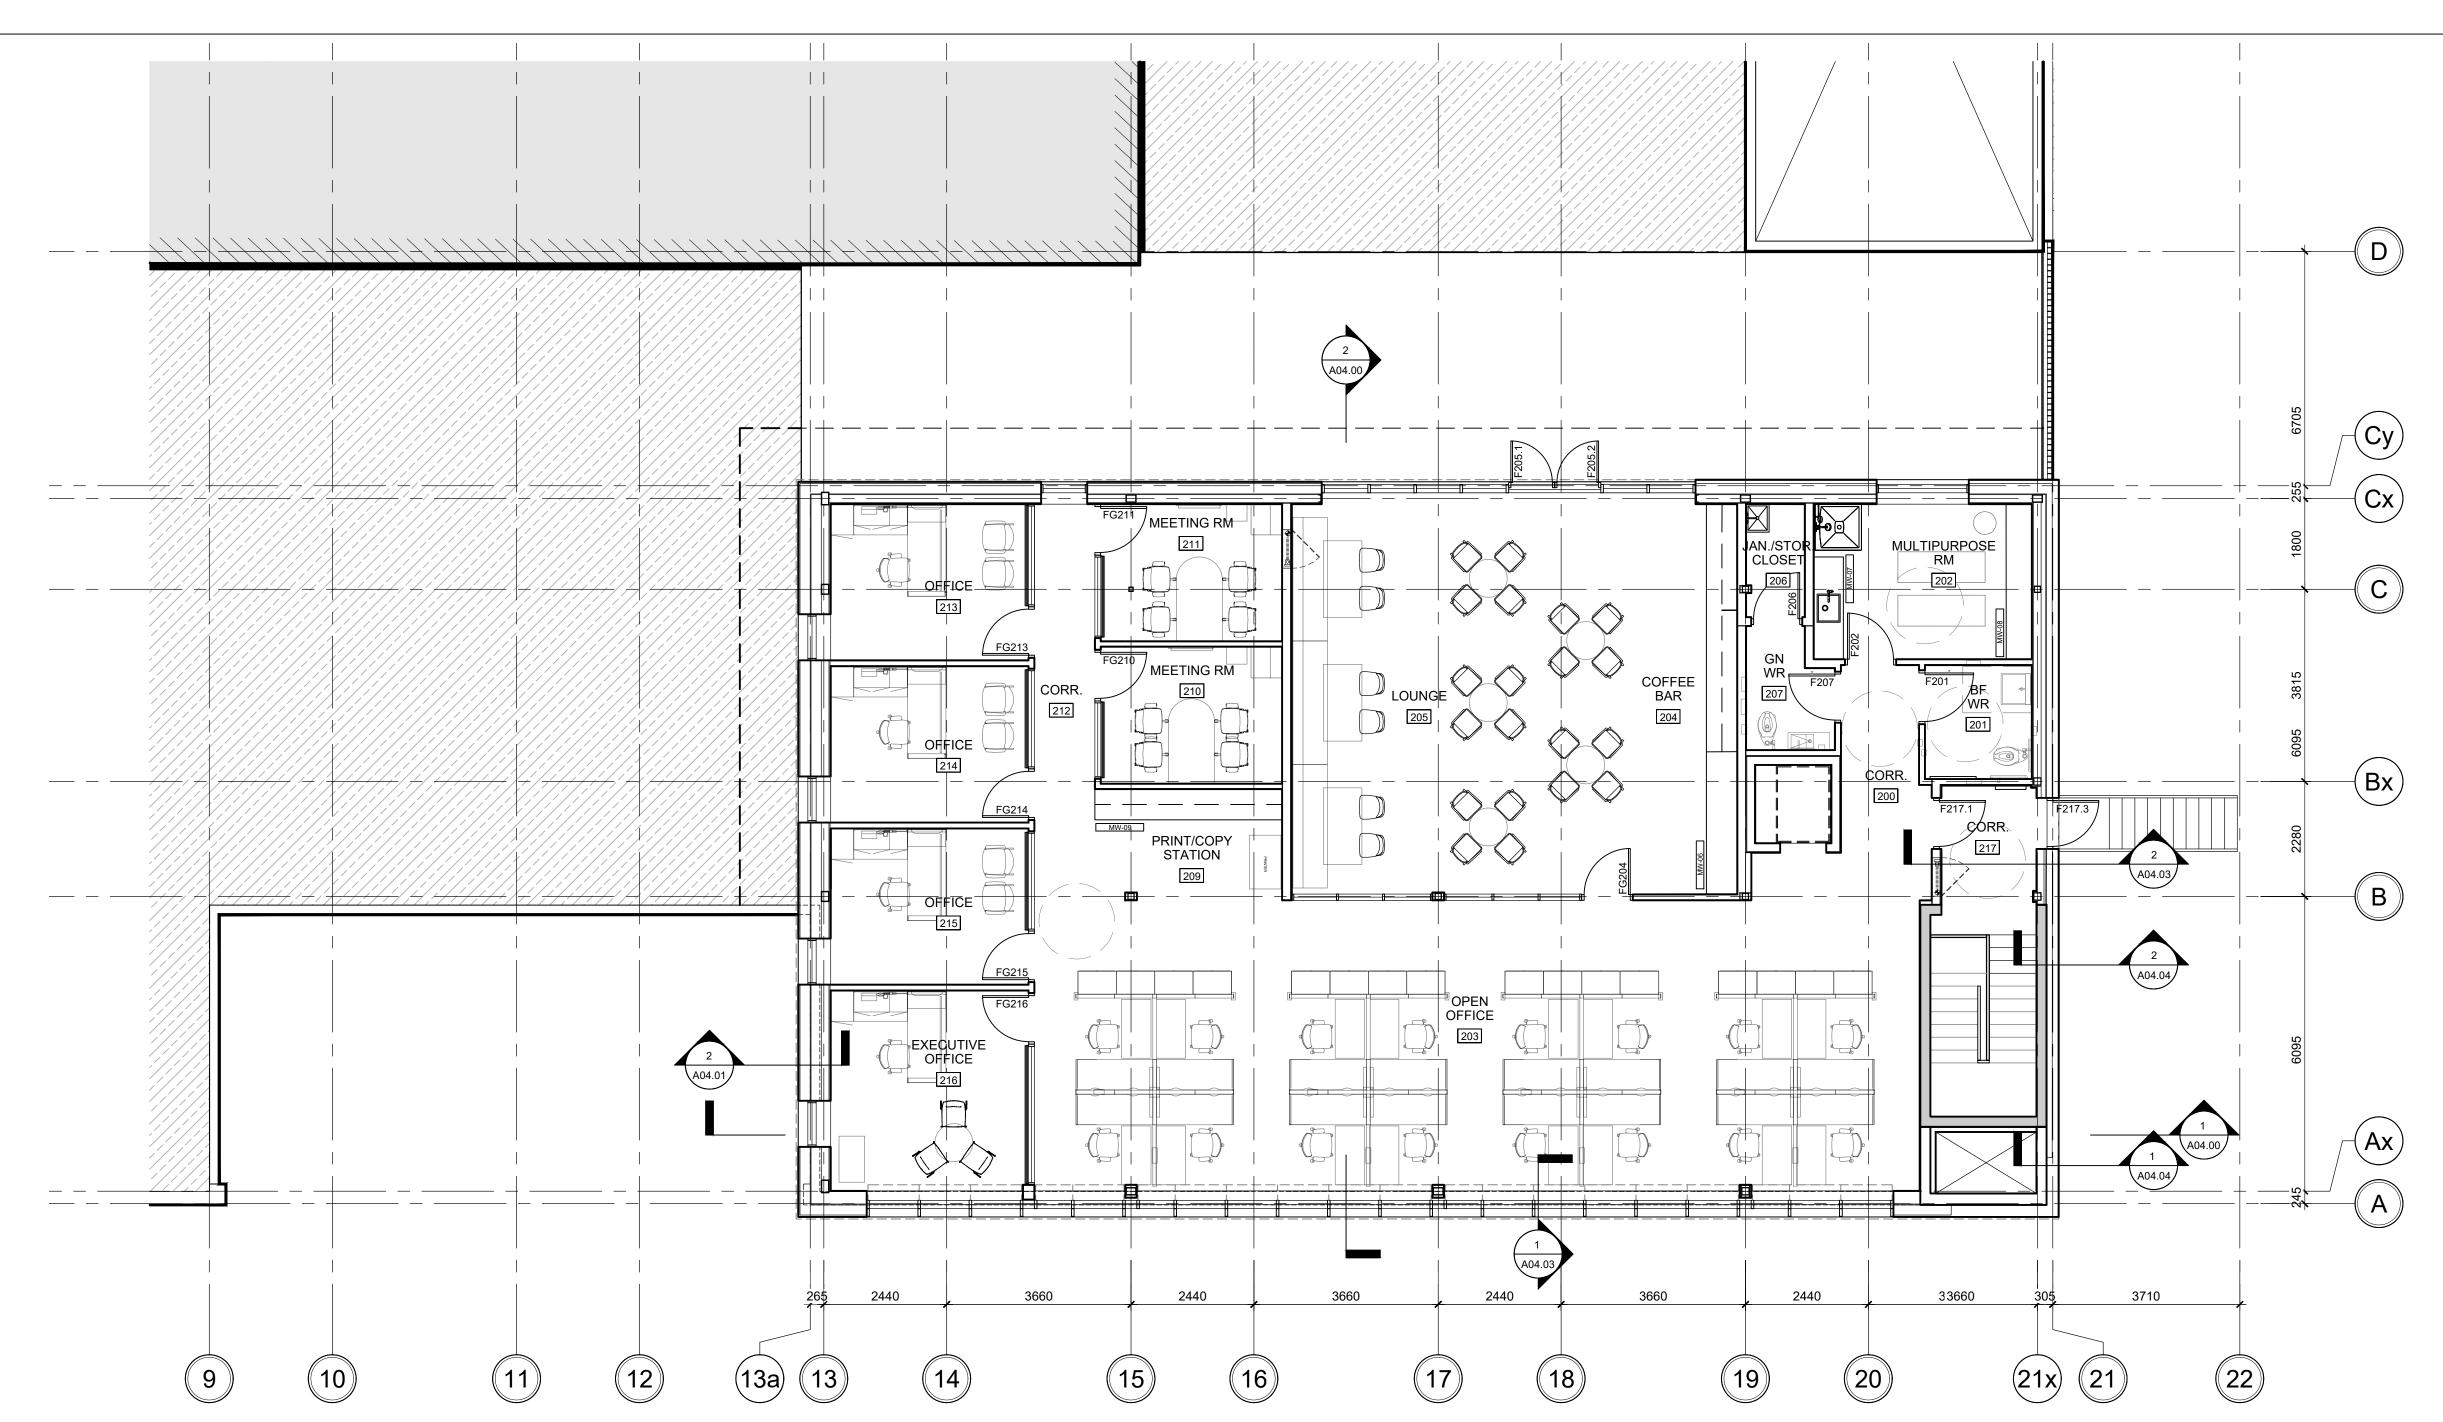


DRAWIN	NG TITLE:	1
NO.	ISSUES/REVISIONS	DAT
01	Issued for Coordination	2022.07.2
02	Issued for Pre-consultation	2022.10.0
03	ISSUED FOR PERMIT	2023.05.1
04	ISSUED FOR TENDER	2023.09.0

RENOVATION PLAN FURNITURE PLAN

ISSUE DATE:	2023.09.06		
DRAWN BY: MM	CHECKED BY:	SL	
PROJECT NO.: 12228	SCALE: 1:	75	
DRAWING NO.:	REVISIO	DN:	

RENOVATION PLAN - LEVEL 1 WASHROOMS SCALE: 1:75



ADDITION PLAN - LEVEL 2 - FURNITURE AND FINISHES

GENERAL RENOVATION PLAN NOTES:

GENERAL REQUIREMENTS

- 1. ALL WORK SHALL CONFORM TO THE REQUIREMENTS OF ALL EXISTING BY-LAWS, CODES, MUNICIPAL GOVERNMENTS AND AUTHORITIES HAVING JURISDICTION. OBTAIN ALL PERMITS REQUIRED IN ACCORDANCE WITH THE CONTRACT. 2. IF APPLICABLE, EXECUTION OF THE WORK SHALL FOLLOW ANY PHASING
- AS INDICATED. ISOLATE EACH AREA OF WORK AS REQUIRED SO AS TO NOT DISRUPT DAY TO DAY OPERATION. ACCESS TO WASHROOMS, ELEVATORS, STAIRS ETC. MUST BE MAINTAINED AT ALL TIMES. 3. DIMENSIONS SHOWN ARE TAKEN TO FACE OF CMU, POURED CONCRETE,
- OR WALL UNLESS NOTED OTHERWISE. ALL GWB OR CMU PARTITIONS TO EXTEND TIGHT TO U/S OF DECK UNLESS NOTED OTHERWISE. 4. CONSTRUCT PARTITIONS AND WALLS AS FIRE SEPARATIONS WHERE INDICATED ON PLAN
- 5. ALL INTERIOR ALUM SCREENS SHALL HAVE GWB AND METAL STUD ASSEMBLIES FROM TOP OF SCREEN/DOOR FRAME TO UNDERSIDE OF DECKS UNLESS A LINTEL HAS BEEN PROVIDED BY STRUCTURAL DRAWINGS WITH BLOCK WALL ABOVE TO U/S DECKS.
- 6. WHERE SCREENS OR DOORS OCCUR WITHIN WALLS CONSTRUCTED AS FIRE SEPARATIONS, THE WALL ABOVE SUCH SCREENS OR DOORS SHALL BE CONSTRUCTED TO PROVIDE THE REQUIRED FIRE RESISTANCE RATING INDICATED.
- 7. WHERE FIRE RATED PARTITIONS ABUT NON-RATED PARTITIONS THE CONTINUITY OF THE FIRE RATED ASSEMBLY SHALL BE MAINTAINED.
- 8. SEAL PERIMETER OF WALLS AND AROUND PENETRATIONS THROUGH WALLS WITH ACOUSTIC SEALANT WHERE SOUND ATTENUATION BATTS ARE CALLED FOR ON THE WALL TYPE. 9. SEAL PERIMETER OF FIRE RATED WALLS AND AROUND PENETRATIONS
- THROUGH FIRE RATED WALLS WITH APPROVED FIRESTOP MATERIALS. 10. CORNERS OF EXPOSED MASONRY WALLS SHALL BE BULLNOSE BLOCK UNLESS NOTED OTHERWISE.
- 11. REFER TO ELECTRICAL DWGS FOR LOCATIONS OF PANELS, DOOR CONTROLS, SECURITY DEVICES ETC NOT SHOWN ON ARCHITECTURAL



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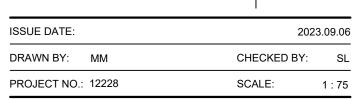


02	ISSUED FOR TENDER	2023.09.0
01	ISSUED FOR PERMIT	2023.05.1
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ADDITION PLAN LEVEL 2


ISSUE DATE:

DRAWING NO.:



FURNITURE PLAN

REVISION:

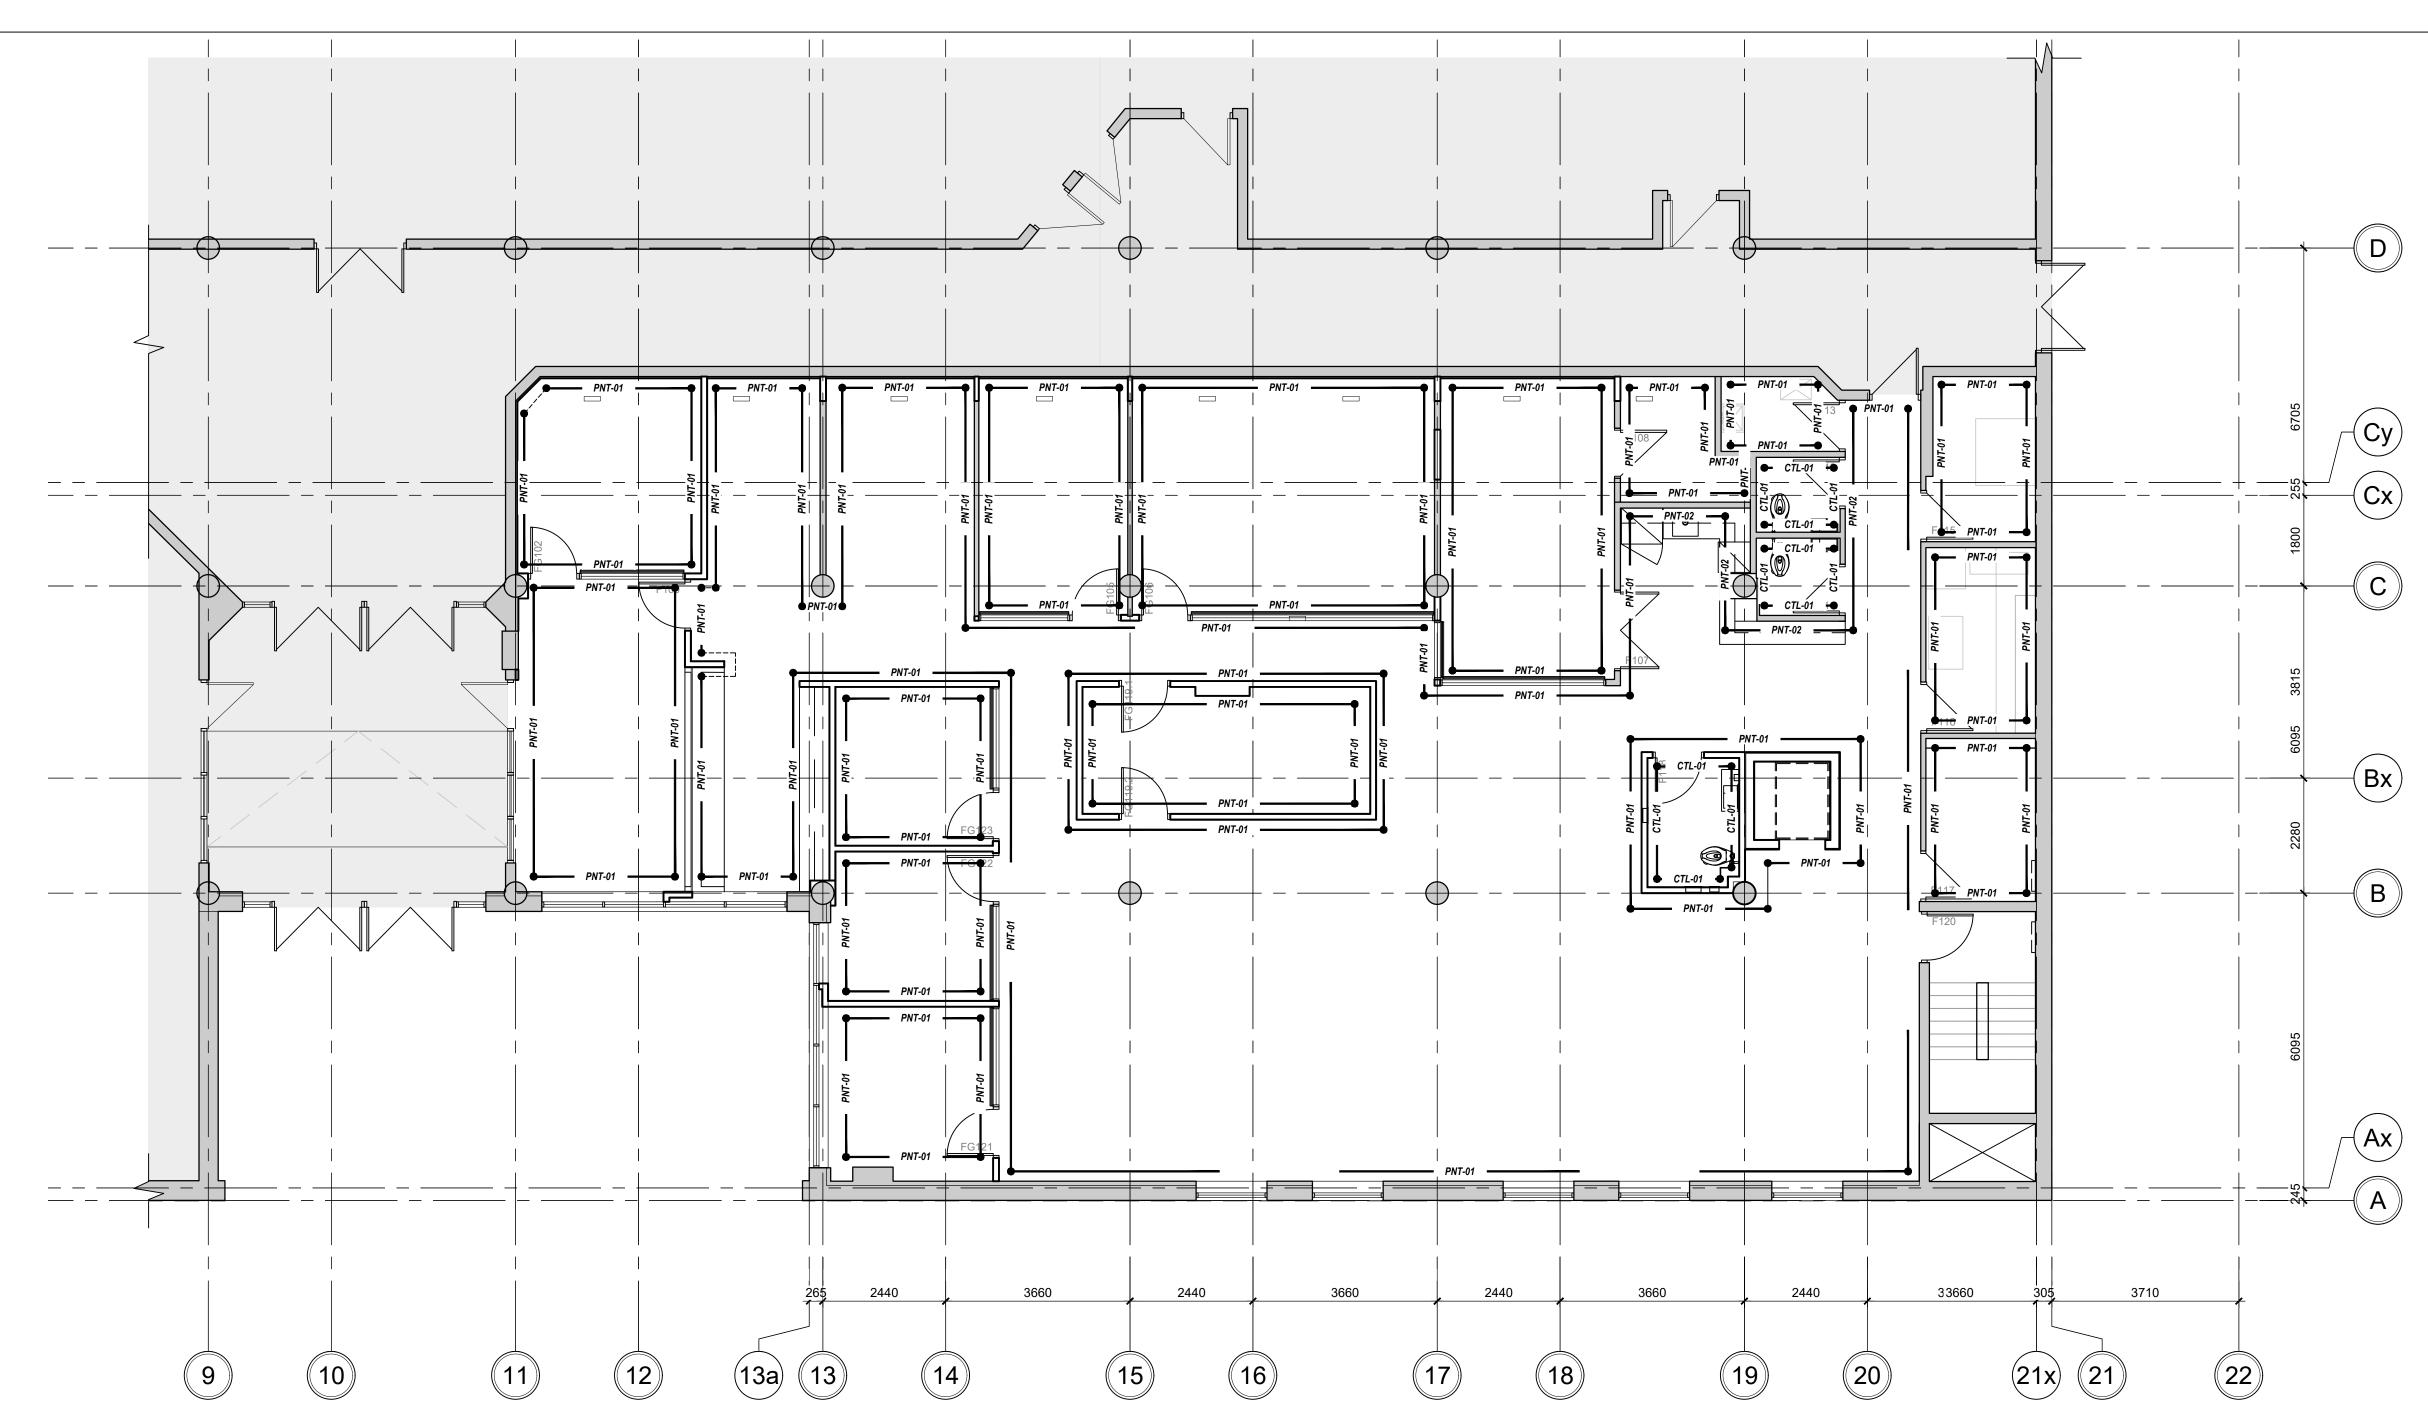



RENOVATION / NEW WORK LEGEND

WALL FINISH GENERAL NOTES:

- ALL WALL FINISH DRAWINGS ARE TO BE READ IN CONJUNCTION WITH FLOOR PLANS, FURNITURE PLANS, INTERIOR ELEVATIONS, AND FINISH SPECIFICATIONS.
- 2. LEVEL 5 FINISHING REQUIRED ON WALLS RECEIVING GRAPHICS.
- 3. GC TO ENSURE THAT SURFACE TO RECEIVE GRAPHICS ARE PREPPED AND SMOOTH. EXISTING ITEMS TO REMAIN AND NEW ITEMS ARE PROTECTED DURING INSTALL.
- 4. ALL EXISTING DOORS AND FRAMES SHALL BE FRESHLY PAINTED AS NOTED. REFER TO DOOR SCHEDULE A12.00 FOR PAINT.

WALL FINISH TYPES:

PAINTED SURFACE, PT-01

REFER TO FINISHES SCHEDULE A12.02 & ELEVATIONS A04.00



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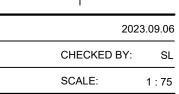


02	ISSUED FOR TENDER	2023.09.06
01	ISSUED FOR PERMIT	2023.05.16
NO.	ISSUES/REVISIONS	DATE
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WALL FINISH PLAN LEVEL 1


ISSUE DATE:

DRAWN BY: AW
PROJECT NO.: 12228



REVISION:

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RENOVATION / NEW WORK LEGEND

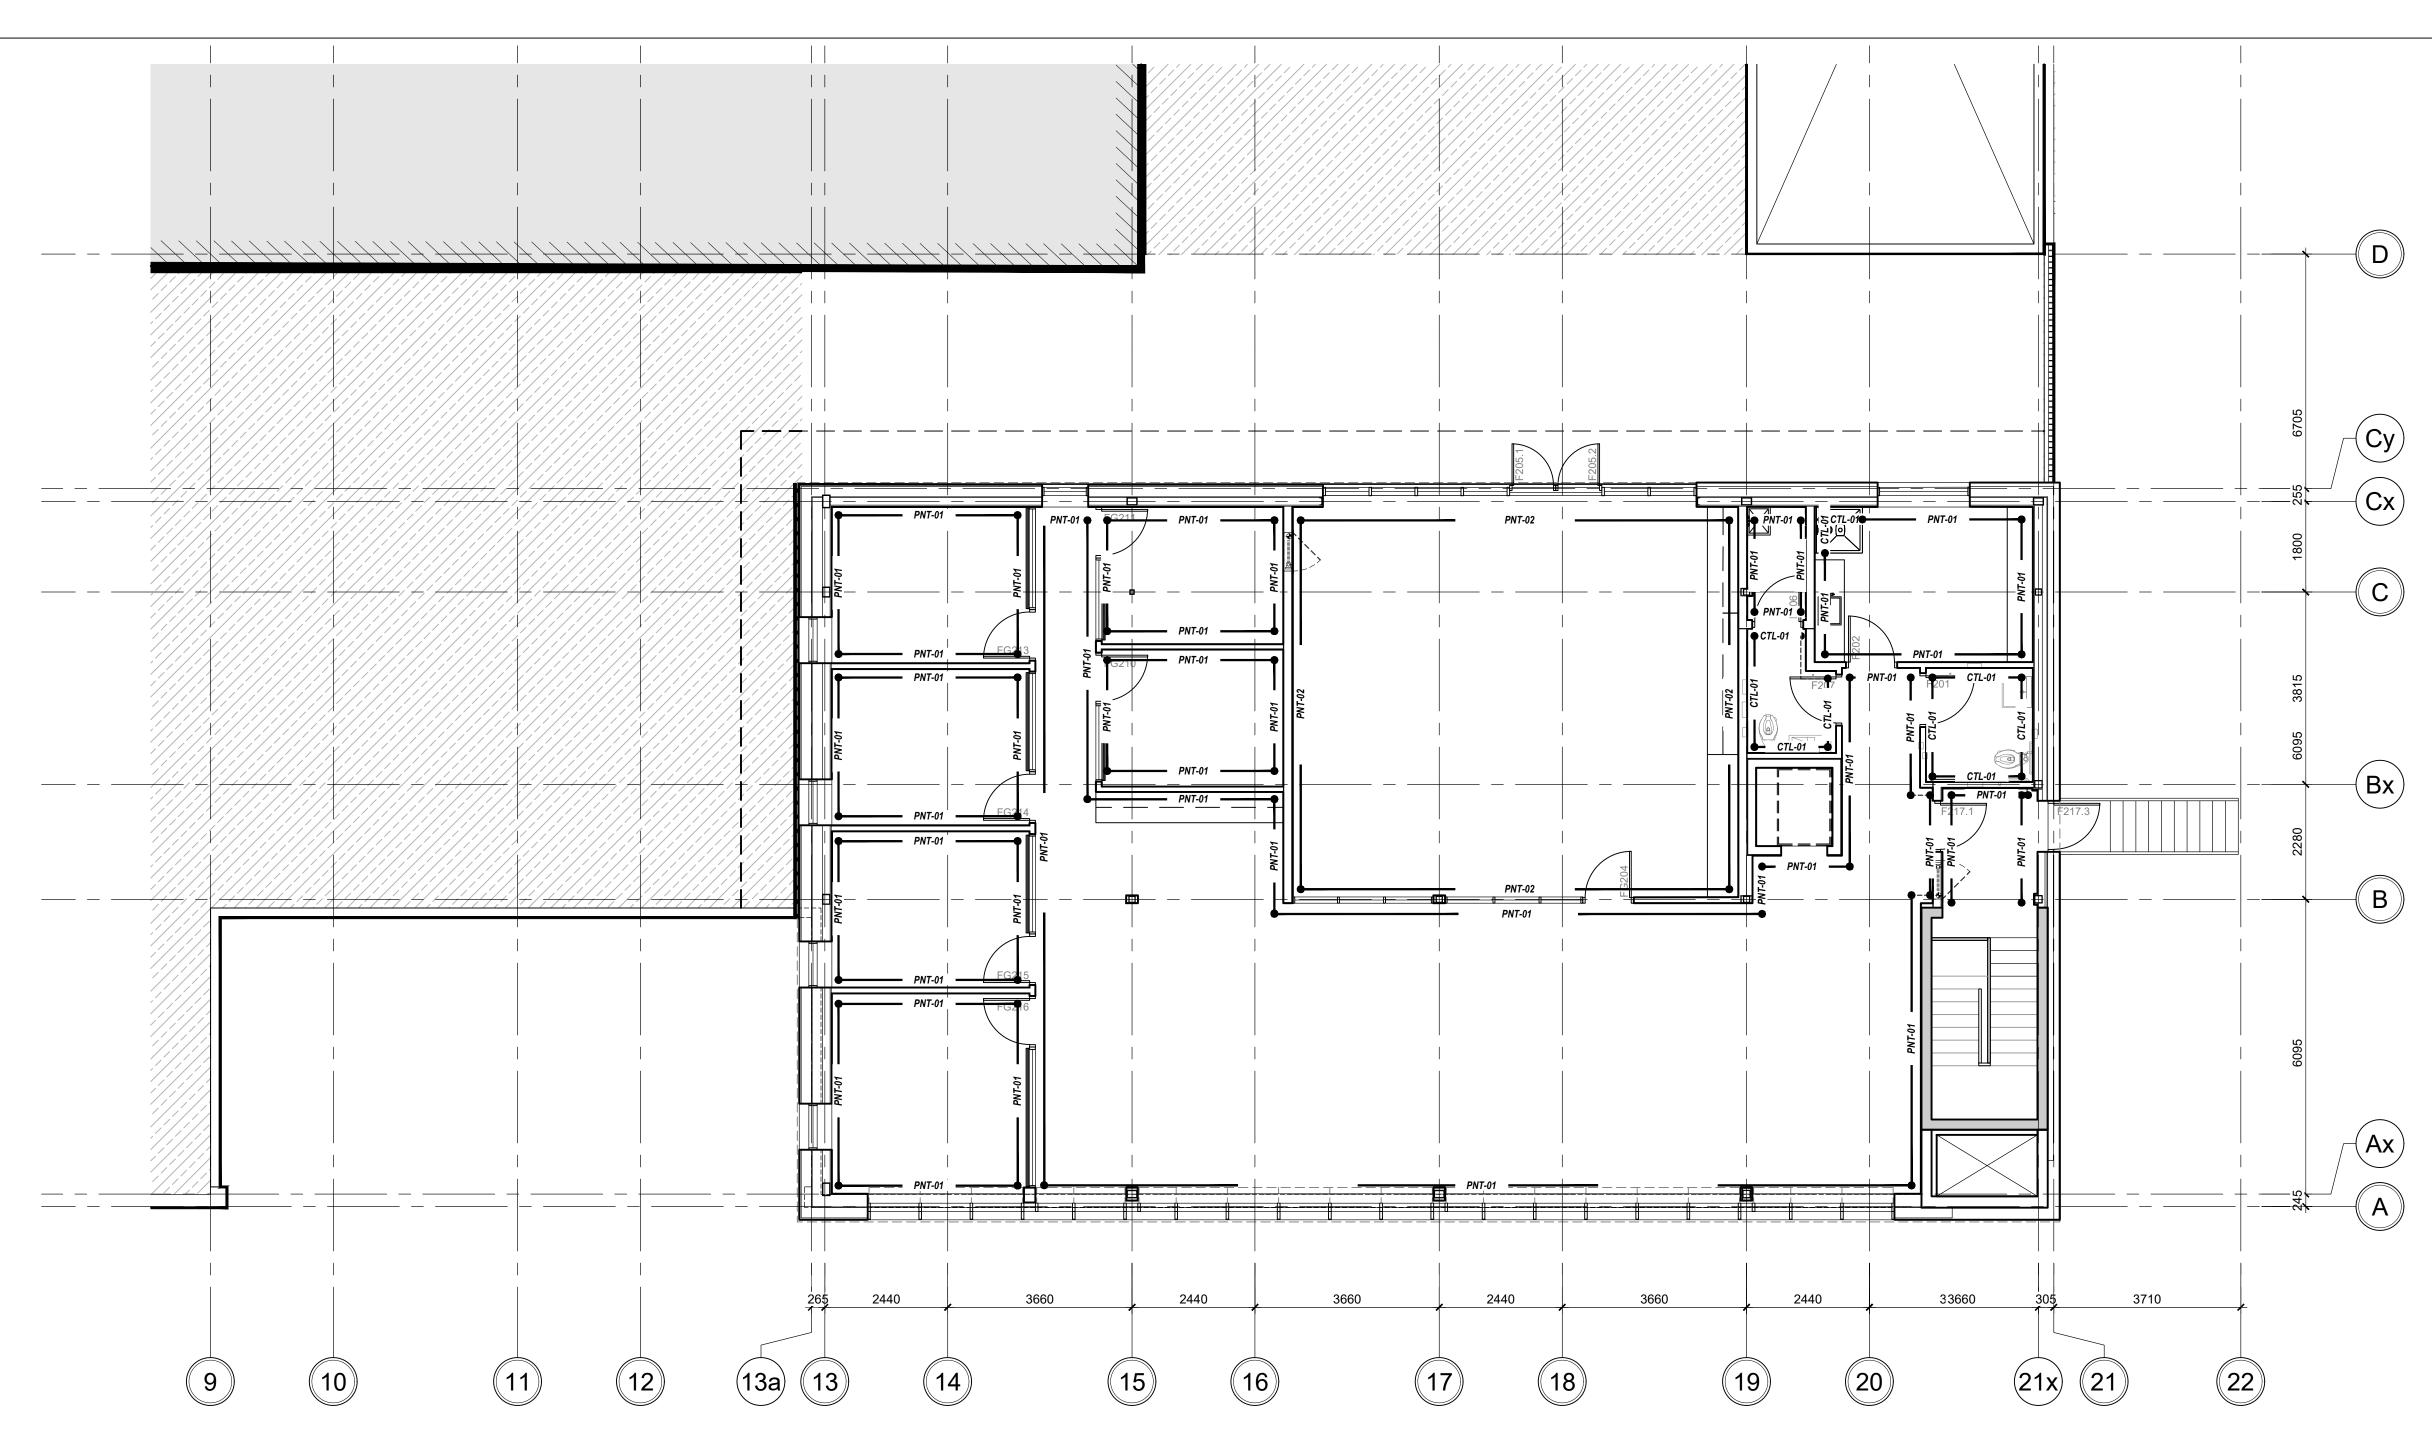WALL FINISH GENERAL NOTES:

- ALL WALL FINISH DRAWINGS ARE TO BE READ IN CONJUNCTION WITH FLOOR PLANS, FURNITURE PLANS, INTERIOR ELEVATIONS, AND FINISH SPECIFICATIONS.
- 2. LEVEL 5 FINISHING REQUIRED ON WALLS RECEIVING GRAPHICS.
- 3. GC TO ENSURE THAT SURFACE TO RECEIVE GRAPHICS ARE PREPPED AND SMOOTH. EXISTING ITEMS TO REMAIN AND NEW ITEMS ARE PROTECTED DURING INSTALL.
- 4. ALL EXISTING DOORS AND FRAMES SHALL BE FRESHLY PAINTED AS NOTED. REFER TO DOOR SCHEDULE A12.00 FOR PAINT.

WALL FINISH TYPES:

PAINTED SURFACE, PT-01 PT-01 — REFER TO FINISHES SCHEDULE A12.02 & ELEVATIONS



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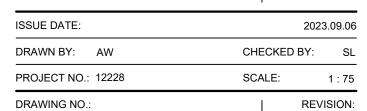





02 ISSUED FOR TENDER 2023.09.06 ISSUED FOR PERMIT 2023.05.16 NO. ISSUES/REVISIONS DATE

> WALL FINISH PLAN LEVEL 2

DRAWING TITLE:



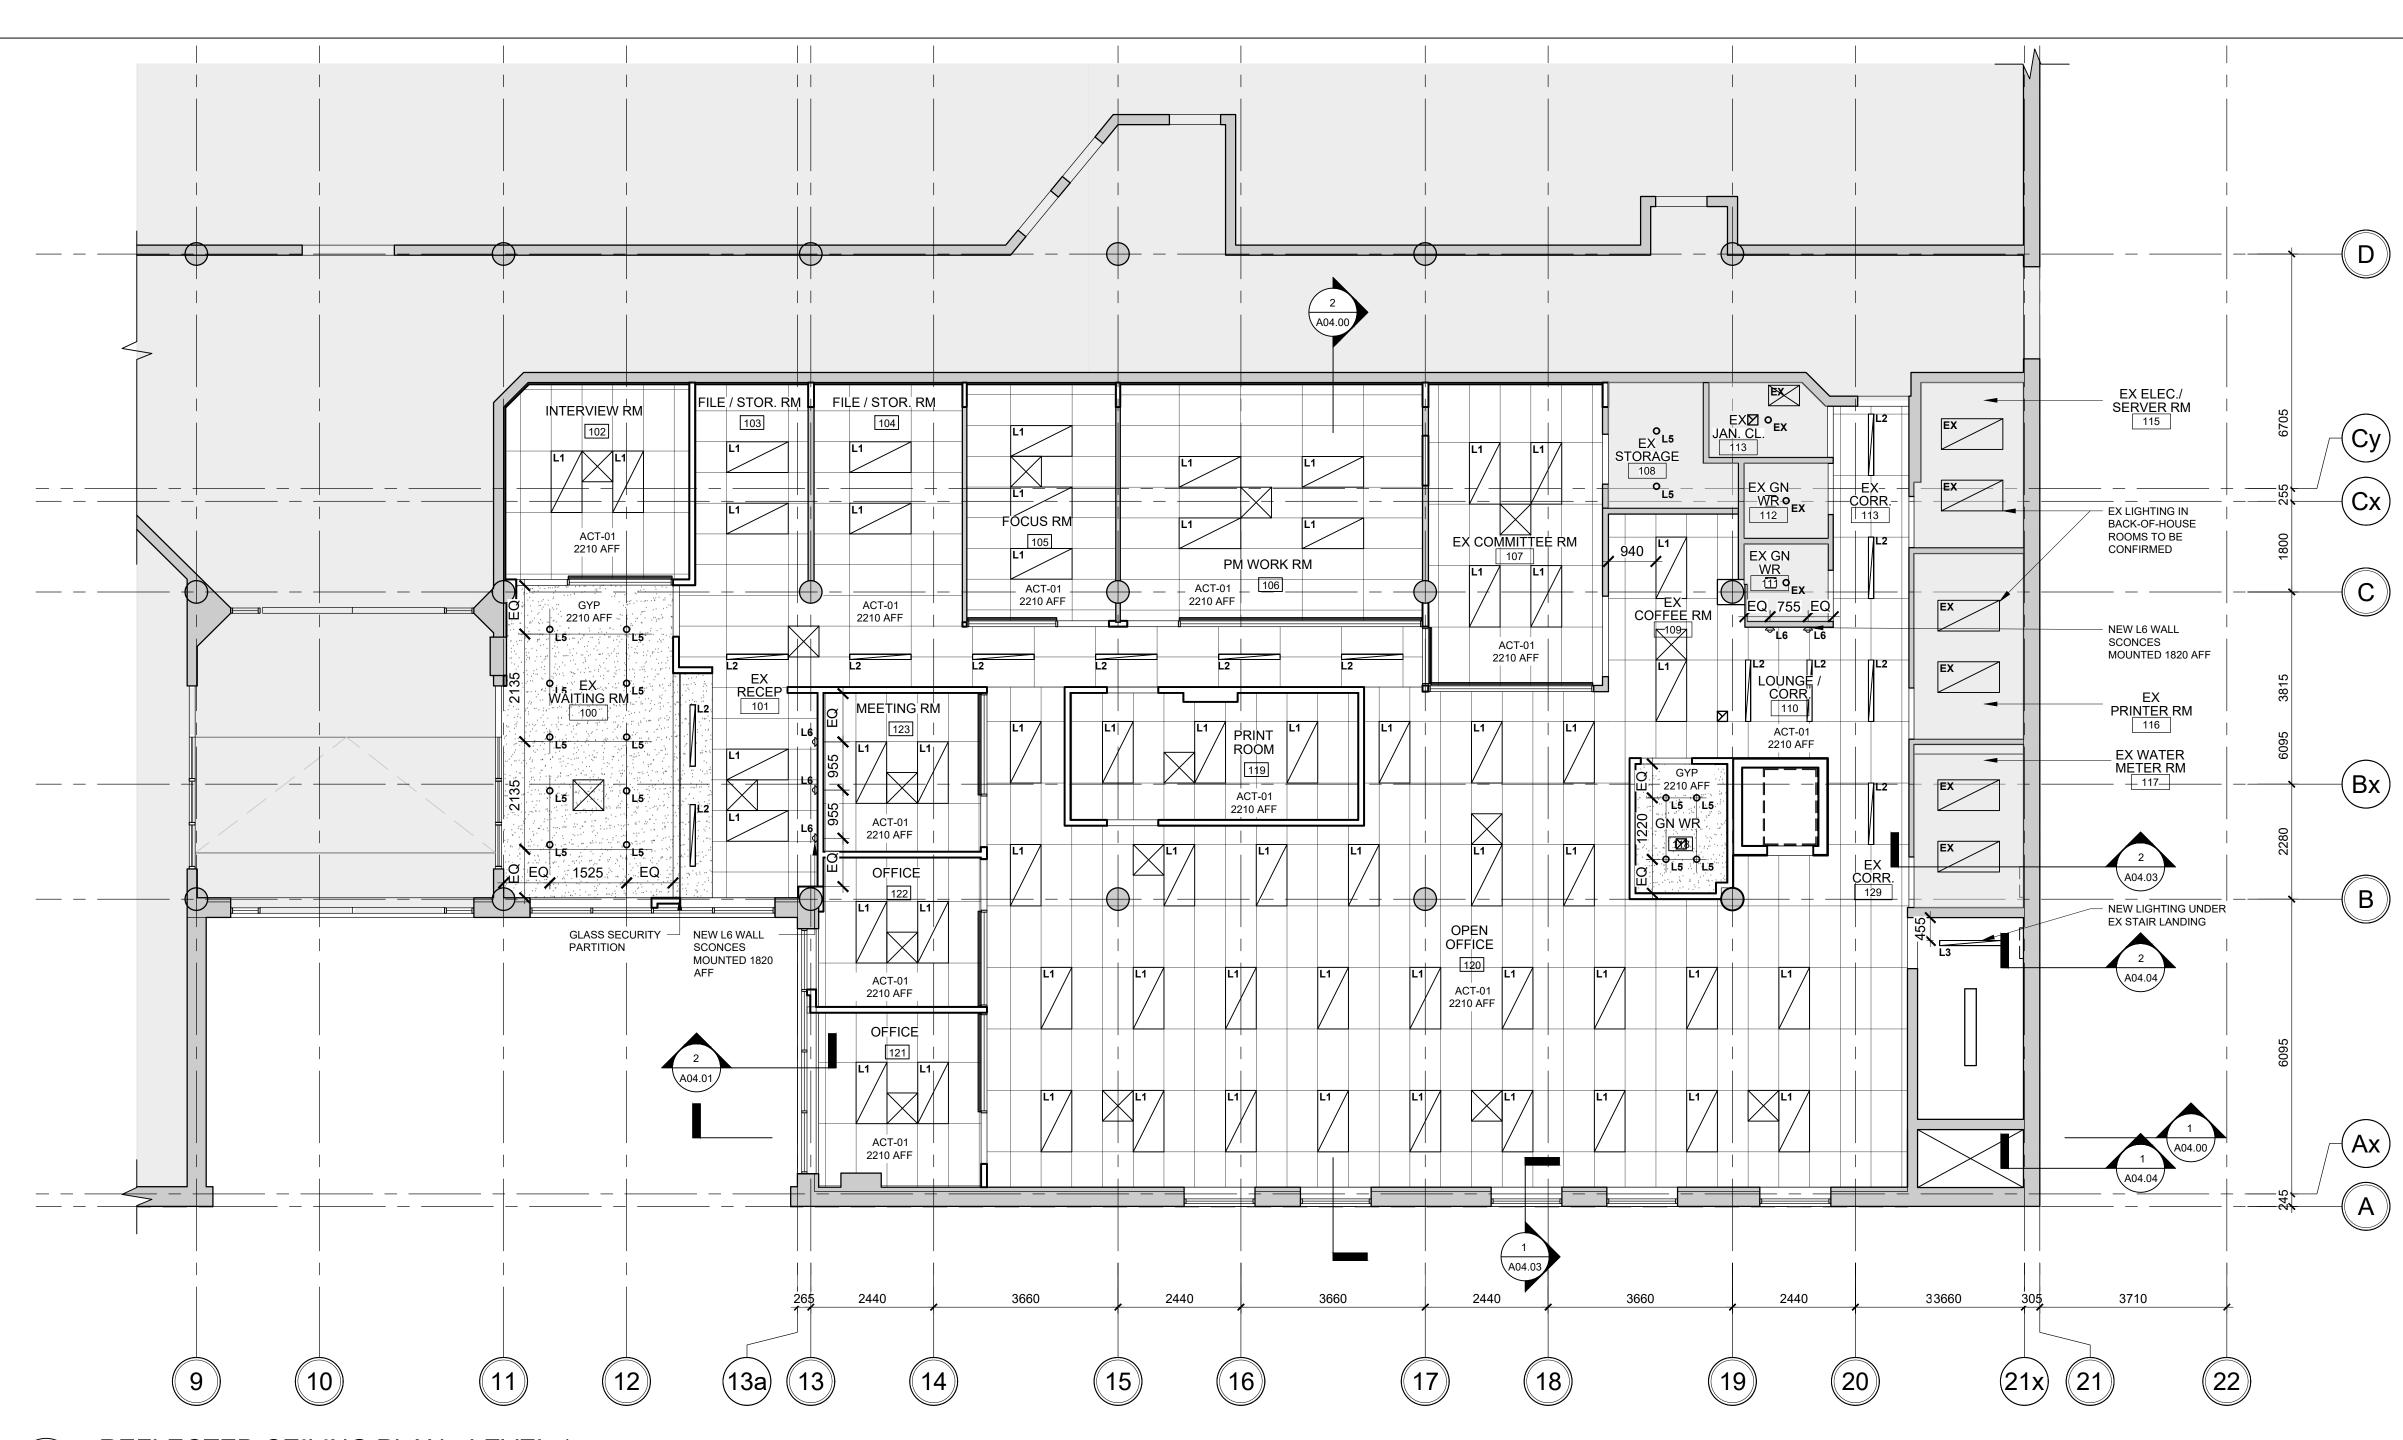

REFLECTED CEILING PLAN - LEVEL '

GENERAL NOTES - REFLECTED CEILING PLAN

- 1. REFER TO MECHANICAL AND ELECTRICAL DRAWINGS FOR ALL CEILING MOUNTED FIXTURES AND MECHANICAL AND ELECTRICAL EQUIPMENT. POSITIONING OF ALL MECHANICAL AND ELECTRICAL FIXTURES AND EQUIPMENT SHALL BE GOVERNED BY ARCHITECTURAL DRAWINGS SUBJECT TO FULL COMPLIANCE WITH ONTARIO BUILDING CODE REQUIREMENTS. REFLECTED CEILING PLANS MAY NOT SHOW ALL MECHANICAL AND ELECTRICAL FIXTURES OR EQUIPMENT. ARCHITECTURAL DRAWINGS SHALL BE READ IN CONJUNCTION WITH MECHANICAL AND ELECTRICAL
- 2. GENERAL CONTRACTOR SHALL REPORT ANY DISCREPANCIES BETWEEN ENGINEERING AND ARCHITECTURAL DRAWINGS PRIOR TO COMMENCEMENT OF THE WORK. 3. PRIOR TO COMMENCEMENT OF THE WORK, THE CONTRACTOR
- SHALL CONDUCT AN INTERFERENCE STUDY. THE OBJECTIVE OF THE STUDY IS TO IDENTIFY AND MITIGATE ISSUES WITH THE INSTALLATION OF MECHANICAL & ELECTRICAL SYSTEMS, FIXTURES AND EQUIPMENT.
- THE STUDY SHALL CONSIST OF THE FOLLOWING: 4. MARK LOCATIONS AND ROUTES ON SITE OF ALL EQUIPMENT, PIPING, VENTS, DUCTS, CONDENSATES ETC. CONTRACTOR SHALL ESTABLISH MINIMUM CLEARANCES AND REPORT ANY INTERFERENCES WITH LIGHT FIXTURES, CONDUIT OR WIRE RUNS,
- STRUCTURE ETC. 5. MARK LOCATIONS ON SITE OF ALL LIGHTING. CONTRACTOR SHALL

- ESTABLISH MINIMUM CLEARANCES AND REPORT ANY INTERFERENCES WITH DUCTS, PIPES, STRUCTURE ETC.
- 6. LOCATE ALL FIXTURES IN ACCORDANCE WITH ARCHITECTURAL
- 7. IDENTIFY ALL SERVICES INSTALLED WITHIN OR ABOVE CEILING SYSTEMS. COORDINATE ALL PENETRATIONS AND ACCESS PANELS WITH THE CEILING SUPPORT SYSTEMS.
- 8. REPORT ANY DISCREPANCIES OR INTERFERENCES TO CONSULTANT IMMEDIATELY. OBTAIN INSTRUCTION FROM CONSULTANT BEFORE COMMENCING INSTALLATION. 9. PROVIDE CONFIRMATION THAT INTERFERENCE STUDY HAS BEEN CONDUCTED AND THAT INTERFERENCES HAVE BEEN IDENTIFIED
- FIXTURE INSTALLATION / LOCATION REQUIREMENTS 1. REFER TO ELECTRICAL DRAWINGS /SPECIFICATIONS FOR ALL

AND MITIGATED

- LIGHTING FIXTURE TYPES & QUANTITY LAYOUTS 2. UNLESS OTHERWISE NOTED, LOCATE LIGHT FIXTURES ON CENTER OF ACOUSTIC CEILING TILES.
- 3. WHERE INDICATED, DIMENSIONS ARE TAKEN FROM CENTER OF LIGHT FIXTURES. 4. REFER TO TOP OF WALL DEFLECTION TRACK DETAILS FOR
- TERMINATION OF WALLS AT FLOORS AND ROOFS. 5. WHERE MECHANICAL AND ELECTRICAL FIXTURES PENETRATE A PARTITION, PATCH AND PROVIDE AN AIR-TIGHT SEAL AROUND

PENETRATION. AT FIRE SEPARATIONS USE FIRESTOP SYSTEM

- MATERIAL AT PENETRATIONS TO MATCH THE FIRE RATING OF THE PARTITION, WALL, OR FLOOR ASSEMBLY.
- 6. LOCATE SPRINKLERS, DETECTORS, SPEAKERS, ETC. ON CENTER LINE OR MID-POINT OF LAY-IN CEILING PANELS UNLESS OTHERWISE NOTED 7. CONTRACTOR SHALL PROVIDE ALL NECESSARY SUPPORTS FOR ALL WINDOW TREATMENTS, ROLLER SHADES, ETC. AS
- RECOMMENDED BY MANUFACTURERS 8. CONTRACTOR SHALL PROVIDE CONCEALED BRACING TO LATERALLY STABILIZE SUSPENDED CEILINGS WHERE CEILINGS ARE NOT FASTENED TO WALLS. 9. REFER TO ELECTRICAL DRAWINGS AND SPECIFICATIONS FOR FIRE

EXIT SIGNS, EMERGENCY LIGHTING AND OTHER LIFE SAFETY

- DEVICES (i.e. HEAT DETECTORS, SMOKE DETECTORS ETC). 10. ALL EXPOSED ROUTING OF ELECTRICAL SERVICES ON CEILINGS/LEVELS ABOVE SHALL BE REVIEWED ONSITE WITH CONSULTANT PRIOR TO INSTALLATION. 11. WHERE REQUIRED, PATCH, PAINT OR REPLACE ANY DAMAGED T-BAR AND REPLACE ANY DAMAGED OR SOILED CEILING TILES NOTED PRIOR TO OCCUPANCY.
- 12. CONTROL JOINTS SHALL BE INSTALLED TO DIVIDE GYPSUM CEILINGS & WALLS INTO 20' MAX. LENGTHS & WIDTHS. JOINTS SHALL ALSO BE INSTALLED AT EXPANSION OR CONTRACTION JOINTS IN THE STRUCTURAL FRAMEWORK OVER WHICH GYPSUM BOARD IS REQUIRED.

13. CONTRACTOR SHALL PROVIDE CUT-OUTS AND OPENINGS FOR

- ITEMS WHICH PENETRATE THROUGH CEILINGS SYSTEMS (INCLUDING SPECIAL EQUIPMENT HANGERS AND DEVICES, CONDUIT, PIPING, ELECTRICAL REQUIREMENTS, ETC.).
- FIRE SEPERATIONS 1. FIRE SEPARATIONS ARE TO THE UNDERSIDE (U/S) OF THE DECK OR STRUCTURE COMPLETE WITH FIRESTOP SYSTEM MATERIAL
- AND SMOKE SEAL AS REQUIRED. REFER TO FIRE SEPERATION 2. REFER TO TOP OF WALL DETAILS FOR TERMINATION OF WALLS AT FLOORS AND ROOFS THAT REQUIRE FIRE SEPERATION.
- 1. REFER TO FINISHS SCHEDULE FOR CEILING FINISHES. 2. WHERE INDICATED, CEILINGS NOTED AS EXPOSED SHALL BE PAINTED PNT-04 UNLESS OTHERWISE NOTED. 3. ALL EXPOSED CONDUIT, DUCT WORK, PIPING, ETC. SHALL BE PAINTED TO MATCH CEILING UNLESS OTHERWISE NOTED OR REQUIRED BY CODE.

4. ALL EXPOSED STEEL BEAMS, JOISTS, DECK SHALL BE PAINTED

PER CEILING FINISH SCHEDULE UNLESS OTHERWISE NOTED.

1. FOR EQUIPMENT THAT REQUIRES ACCESS THROUGH CEILINGS, LOCATE ABOVE ATC CEILINGS WHERE POSSIBLE. WHERE ACCESS IS REQUIRED THROUGH GYPSUM BOARD CEILINGS, CONTRACTOR

- SHALL PROVIDE ACCESS PANELS AS REQUIRED. CONSULTANT SHALL REVIEW LOCATIONS PRIOR TO CONTRACTOR PROCEEDING
- WITH INSTALLATION. 2. IN AREAS WHERE ACCESS CAN NOT BE GAINED FROM ACT CEILINGS, ACCESS PANELS ARE TO BE PROVIDED. 3. PROVIDE ACCESS PANELS OF APPROPRIATE SIZE, TYPE, AND FIRE RATING FOR ALL CONCEALED ITEMS THAT REQUIRE ADJUSTMENT,
- MAINTENANCE, MONITORING, ETC. 4. ACCESS PANELS SHALL BE SIZED ACCORDING TO ACCESS REQUIREMENTS, PREFABRICATED OR ALTERNATIVELY, CONSTRUCTED OF MIN. 12.7MM MDF PANELS, FINISH FLUSH WITH ADJACENT CEILING AND FINISHED TO MATCH ADJACENT CEILING
- FINISH. PROVIDE 3MM REVEAL AROUND ENTIRE PANEL (TYP.) 5. COORDINATE LOCATION AND FINISH WITH ARCHITECT. 6. WHERE POSSIBLE, SERVICES TO BE GANGED TO LIMIT THE NUMBER OF PANELS REQUIRED.
- 7. ALL ACCESS PANELS TO BE KEYED WITH THE SAME LOCK 8. ACCESS PANELS SHALL BE PREFABRICATED AND SIZED ACCORDING TO ACCESS REQUIREMENTS, FINISH FLUSH WITH ADJACENT CEILING AND COLOR SHALL MATCH ADJACENT CEILING

REFLECTED CEILING PLAN LEGEND AND SYMBOLS: NOTE: ALL HATCHES, SYMBOLS AND REFERENCES ARE TO BE COORDINATED WITH THE GENERAL RENOVATION NOTED, CONSTRUCTION TYPES & GENERAL NOTES ON DRAWING

RCP HATCH LEGEND:

EXISTING CEILING FINISH TO REMAIN



NEW GYPSUM CEILING, PAINTED PNT-03 UNLESS OTHERWISE NOTED

LIGHTING SPECIFICATIONS:

PER DRAWINGS

- L1 610mm X 1220mm RECESSED LED PANEL FIXTURE, MOUNTED
- L2 102mm X 1220mm RECESSED LED PANEL FIXTURE, MOUNTED
- L3 102mm X 1220mm SUSPENDED LINEAR LED FIXTURE FOR OPEN CEILING, CABLE HUNG
- L4 25mm UNDER-CABINET LED STRIP C/W DIFFUSER, LENGTH
- L5 102mm RECESSED ROUND POT LIGHT
- L6 JONI WALL WALL SCONCE BY SEAN LAVIN FOR TECH

REFER TO A11.00 SCHEDULES FOR MORE INFORMATION



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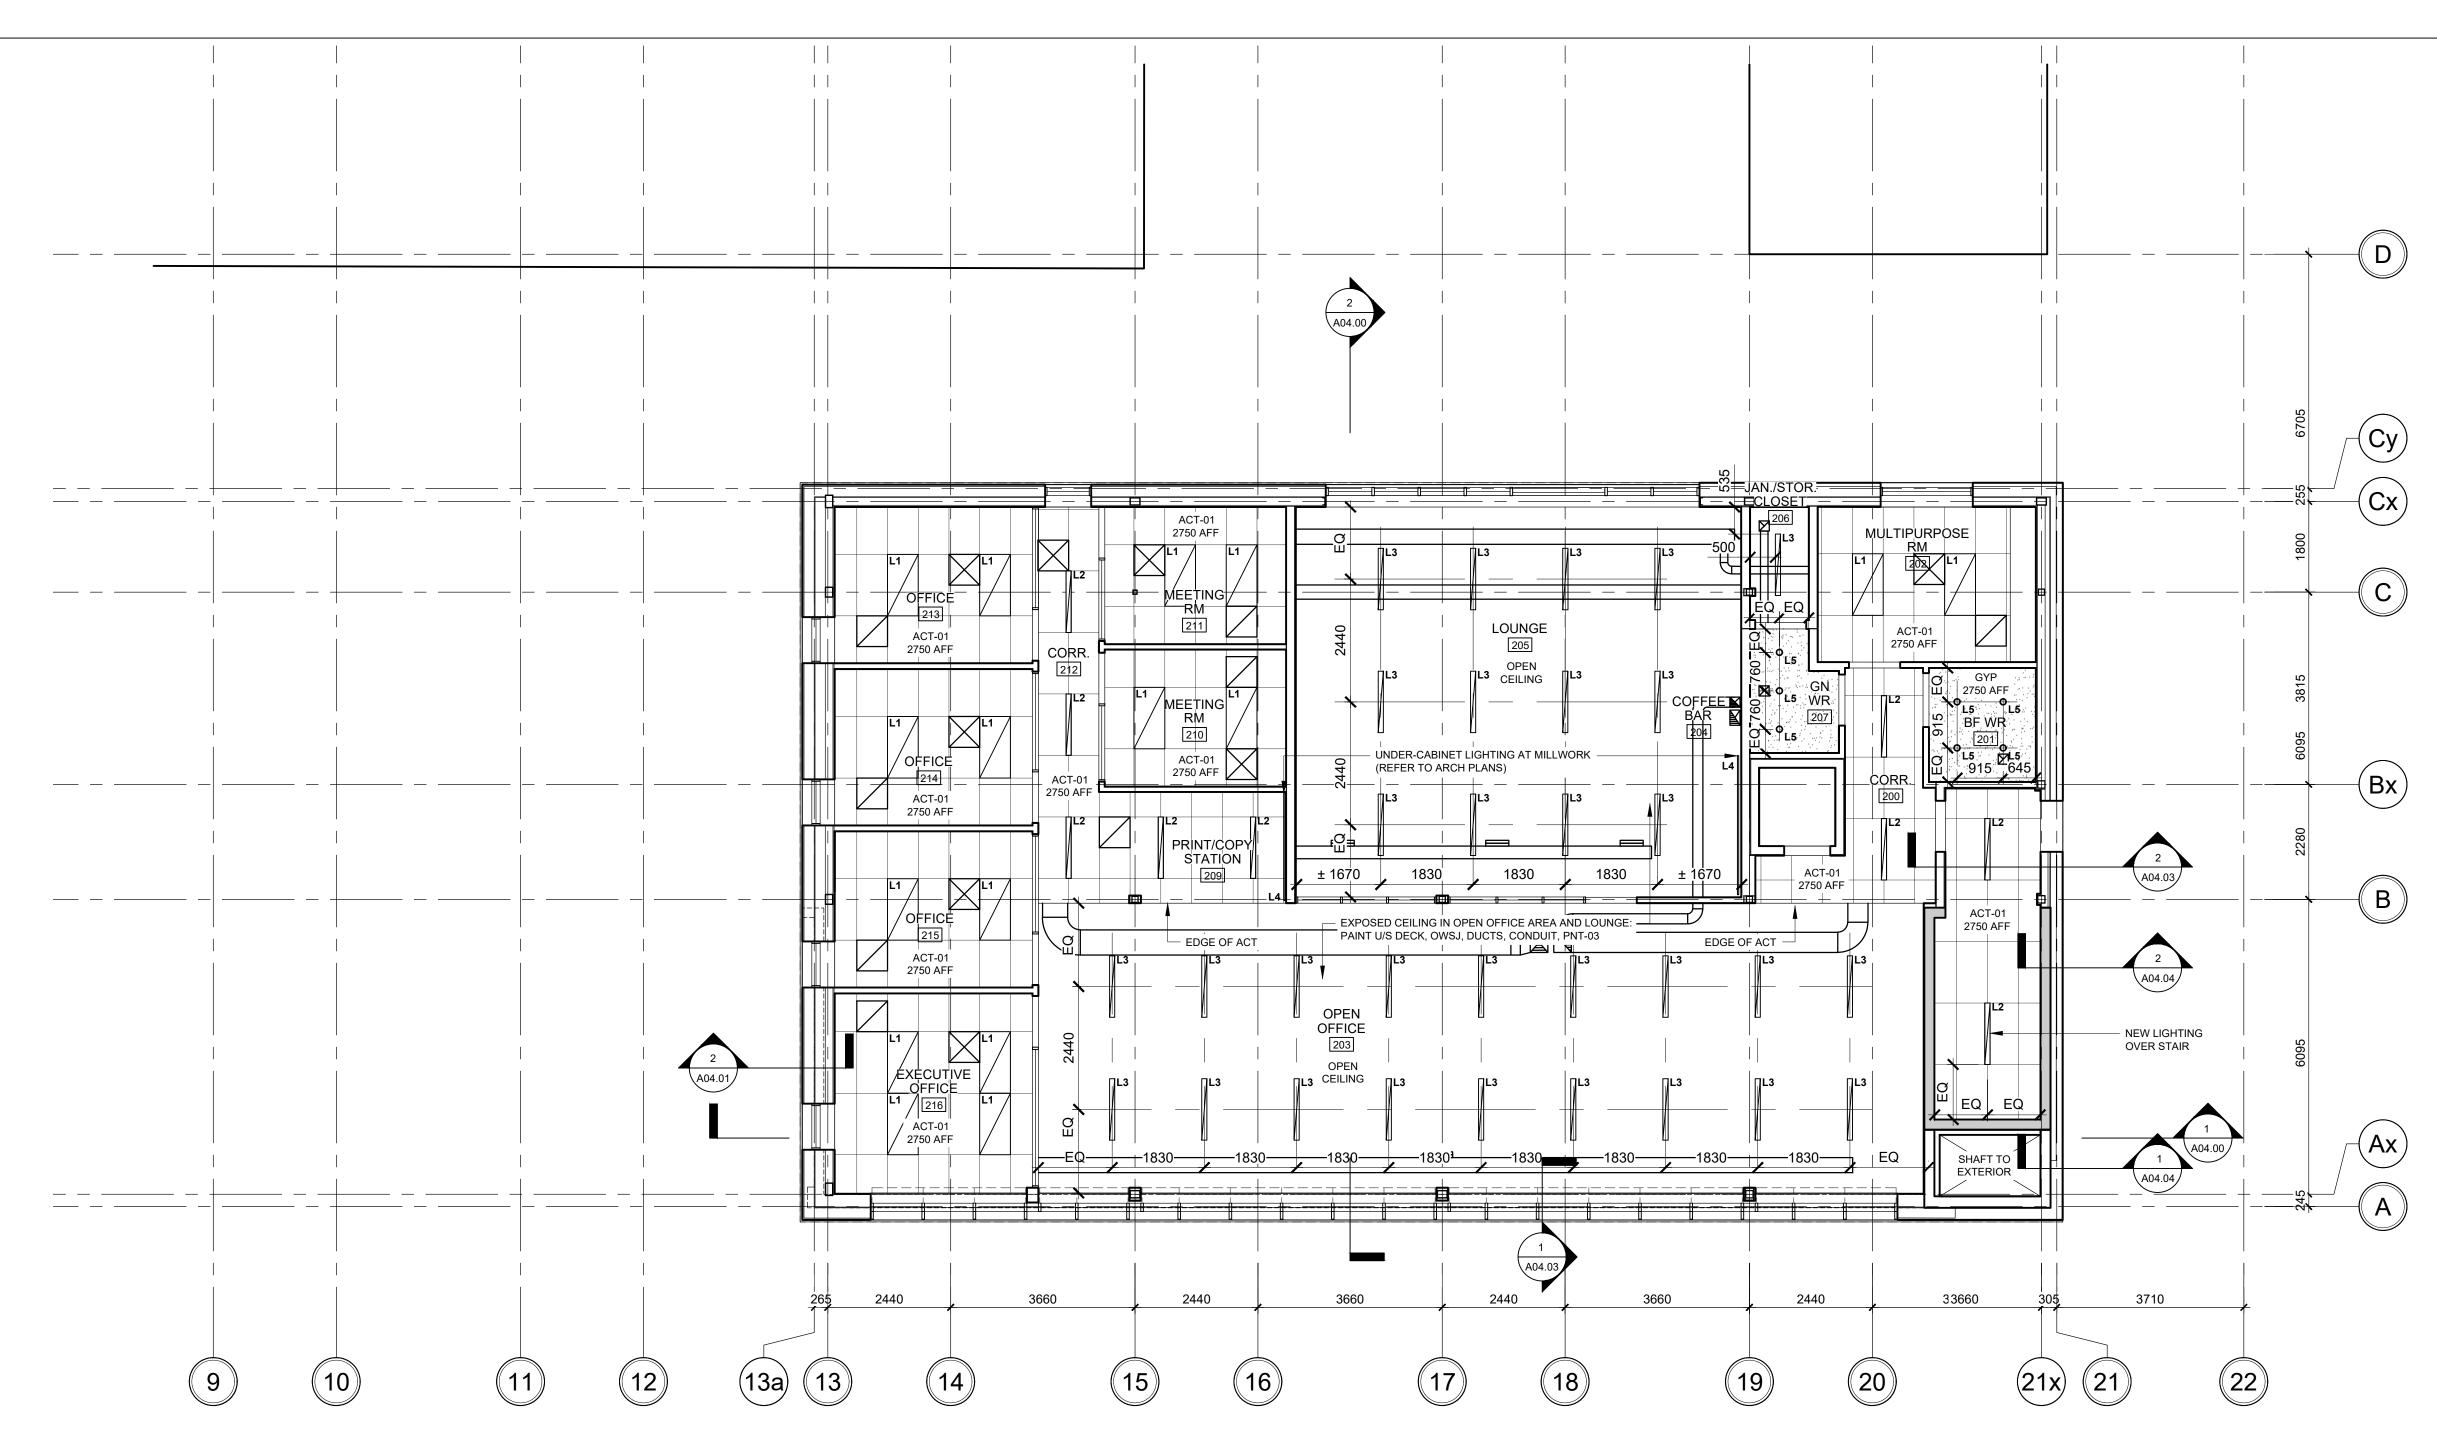


03	ISSUED FOR TENDER	2023.09.0
02	ISSUED FOR PERMIT	2023.05.1
01	Issued for Coordination	2022.07.2
NO.	ISSUES/REVISIONS	DAT

REFLECTED CEILING PLAN

DRAWING TITLE:

ISSUE DATE: 2023.09.06 DRAWN BY: MM CHECKED BY: SL PROJECT NO.: 12228 SCALE: DRAWING NO.: REVISION:



REFLECTED CEILING PLAN - LEVEL 2

GENERAL NOTES - REFLECTED CEILING PLAN

- 1. REFER TO MECHANICAL AND ELECTRICAL DRAWINGS FOR ALL CEILING MOUNTED FIXTURES AND MECHANICAL AND ELECTRICAL EQUIPMENT. POSITIONING OF ALL MECHANICAL AND ELECTRICAL FIXTURES AND EQUIPMENT SHALL BE GOVERNED BY ARCHITECTURAL DRAWINGS SUBJECT TO FULL COMPLIANCE WITH ONTARIO BUILDING CODE REQUIREMENTS. REFLECTED CEILING PLANS MAY NOT SHOW ALL MECHANICAL AND ELECTRICAL FIXTURES OR EQUIPMENT. ARCHITECTURAL DRAWINGS SHALL BE READ IN CONJUNCTION WITH MECHANICAL AND ELECTRICAL
- 2. GENERAL CONTRACTOR SHALL REPORT ANY DISCREPANCIES BETWEEN ENGINEERING AND ARCHITECTURAL DRAWINGS PRIOR
- TO COMMENCEMENT OF THE WORK. 3. PRIOR TO COMMENCEMENT OF THE WORK, THE CONTRACTOR SHALL CONDUCT AN INTERFERENCE STUDY. THE OBJECTIVE OF THE STUDY IS TO IDENTIFY AND MITIGATE ISSUES WITH THE INSTALLATION OF MECHANICAL & ELECTRICAL SYSTEMS, FIXTURES AND EQUIPMENT.
- THE STUDY SHALL CONSIST OF THE FOLLOWING: 4. MARK LOCATIONS AND ROUTES ON SITE OF ALL EQUIPMENT, PIPING, VENTS, DUCTS, CONDENSATES ETC. CONTRACTOR SHALL ESTABLISH MINIMUM CLEARANCES AND REPORT ANY INTERFERENCES WITH LIGHT FIXTURES, CONDUIT OR WIRE RUNS,
- STRUCTURE ETC. 5. MARK LOCATIONS ON SITE OF ALL LIGHTING. CONTRACTOR SHALL

- ESTABLISH MINIMUM CLEARANCES AND REPORT ANY INTERFERENCES WITH DUCTS, PIPES, STRUCTURE ETC.
- 6. LOCATE ALL FIXTURES IN ACCORDANCE WITH ARCHITECTURAL 7. IDENTIFY ALL SERVICES INSTALLED WITHIN OR ABOVE CEILING
- SYSTEMS. COORDINATE ALL PENETRATIONS AND ACCESS PANELS WITH THE CEILING SUPPORT SYSTEMS. 8. REPORT ANY DISCREPANCIES OR INTERFERENCES TO
- CONSULTANT IMMEDIATELY. OBTAIN INSTRUCTION FROM CONSULTANT BEFORE COMMENCING INSTALLATION. 9. PROVIDE CONFIRMATION THAT INTERFERENCE STUDY HAS BEEN CONDUCTED AND THAT INTERFERENCES HAVE BEEN IDENTIFIED
- FIXTURE INSTALLATION / LOCATION REQUIREMENTS 1. REFER TO ELECTRICAL DRAWINGS /SPECIFICATIONS FOR ALL

AND MITIGATED

- LIGHTING FIXTURE TYPES & QUANTITY LAYOUTS 2. UNLESS OTHERWISE NOTED, LOCATE LIGHT FIXTURES ON CENTER OF ACOUSTIC CEILING TILES.
- LIGHT FIXTURES. 4. REFER TO TOP OF WALL DEFLECTION TRACK DETAILS FOR TERMINATION OF WALLS AT FLOORS AND ROOFS.
- 3. WHERE INDICATED, DIMENSIONS ARE TAKEN FROM CENTER OF
- 5. WHERE MECHANICAL AND ELECTRICAL FIXTURES PENETRATE A JOINTS IN THE STRUCTURAL FRAMEWORK OVER WHICH GYPSUM PARTITION, PATCH AND PROVIDE AN AIR-TIGHT SEAL AROUND BOARD IS REQUIRED. 13. CONTRACTOR SHALL PROVIDE CUT-OUTS AND OPENINGS FOR PENETRATION. AT FIRE SEPARATIONS USE FIRESTOP SYSTEM

- MATERIAL AT PENETRATIONS TO MATCH THE FIRE RATING OF THE PARTITION, WALL, OR FLOOR ASSEMBLY.
- 6. LOCATE SPRINKLERS, DETECTORS, SPEAKERS, ETC. ON CENTER LINE OR MID-POINT OF LAY-IN CEILING PANELS UNLESS OTHERWISE NOTED 7. CONTRACTOR SHALL PROVIDE ALL NECESSARY SUPPORTS FOR
- ALL WINDOW TREATMENTS, ROLLER SHADES, ETC. AS RECOMMENDED BY MANUFACTURERS 8. CONTRACTOR SHALL PROVIDE CONCEALED BRACING TO LATERALLY STABILIZE SUSPENDED CEILINGS WHERE CEILINGS ARE NOT FASTENED TO WALLS.
- 9. REFER TO ELECTRICAL DRAWINGS AND SPECIFICATIONS FOR FIRE EXIT SIGNS, EMERGENCY LIGHTING AND OTHER LIFE SAFETY DEVICES (i.e. HEAT DETECTORS, SMOKE DETECTORS ETC). 10. ALL EXPOSED ROUTING OF ELECTRICAL SERVICES ON CEILINGS/LEVELS ABOVE SHALL BE REVIEWED ONSITE WITH CONSULTANT PRIOR TO INSTALLATION. 11. WHERE REQUIRED, PATCH, PAINT OR REPLACE ANY DAMAGED
- T-BAR AND REPLACE ANY DAMAGED OR SOILED CEILING TILES NOTED PRIOR TO OCCUPANCY. 12. CONTROL JOINTS SHALL BE INSTALLED TO DIVIDE GYPSUM CEILINGS & WALLS INTO 20' MAX. LENGTHS & WIDTHS. JOINTS SHALL ALSO BE INSTALLED AT EXPANSION OR CONTRACTION
 - REQUIRED BY CODE. 4. ALL EXPOSED STEEL BEAMS, JOISTS, DECK SHALL BE PAINTED PER CEILING FINISH SCHEDULE UNLESS OTHERWISE NOTED. 1. FOR EQUIPMENT THAT REQUIRES ACCESS THROUGH CEILINGS,

FIRE SEPERATIONS

ITEMS WHICH PENETRATE THROUGH CEILINGS SYSTEMS

CONDUIT, PIPING, ELECTRICAL REQUIREMENTS, ETC.).

FLOORS AND ROOFS THAT REQUIRE FIRE SEPERATION.

2. WHERE INDICATED, CEILINGS NOTED AS EXPOSED SHALL BE

3. ALL EXPOSED CONDUIT, DUCT WORK, PIPING, ETC. SHALL BE

PAINTED TO MATCH CEILING UNLESS OTHERWISE NOTED OR

LOCATE ABOVE ATC CEILINGS WHERE POSSIBLE. WHERE ACCESS

IS REQUIRED THROUGH GYPSUM BOARD CEILINGS, CONTRACTOR

1. REFER TO FINISHS SCHEDULE FOR CEILING FINISHES.

PAINTED PNT-04 UNLESS OTHERWISE NOTED.

(INCLUDING SPECIAL EQUIPMENT HANGERS AND DEVICES,

AND SMOKE SEAL AS REQUIRED. REFER TO FIRE SEPERATION

2. REFER TO TOP OF WALL DETAILS FOR TERMINATION OF WALLS AT


SHALL PROVIDE ACCESS PANELS AS REQUIRED. CONSULTANT SHALL REVIEW LOCATIONS PRIOR TO CONTRACTOR PROCEEDING

- WITH INSTALLATION. 2. IN AREAS WHERE ACCESS CAN NOT BE GAINED FROM ACT CEILINGS, ACCESS PANELS ARE TO BE PROVIDED. 1. FIRE SEPARATIONS ARE TO THE UNDERSIDE (U/S) OF THE DECK 3. PROVIDE ACCESS PANELS OF APPROPRIATE SIZE, TYPE, AND FIRE OR STRUCTURE COMPLETE WITH FIRESTOP SYSTEM MATERIAL RATING FOR ALL CONCEALED ITEMS THAT REQUIRE ADJUSTMENT,
 - MAINTENANCE, MONITORING, ETC. 4. ACCESS PANELS SHALL BE SIZED ACCORDING TO ACCESS REQUIREMENTS, PREFABRICATED OR ALTERNATIVELY,
 - CONSTRUCTED OF MIN. 12.7MM MDF PANELS, FINISH FLUSH WITH ADJACENT CEILING AND FINISHED TO MATCH ADJACENT CEILING FINISH. PROVIDE 3MM REVEAL AROUND ENTIRE PANEL (TYP.) 5. COORDINATE LOCATION AND FINISH WITH ARCHITECT.
 - 6. WHERE POSSIBLE, SERVICES TO BE GANGED TO LIMIT THE NUMBER OF PANELS REQUIRED. 7. ALL ACCESS PANELS TO BE KEYED WITH THE SAME LOCK
 - 8. ACCESS PANELS SHALL BE PREFABRICATED AND SIZED ACCORDING TO ACCESS REQUIREMENTS, FINISH FLUSH WITH ADJACENT CEILING AND COLOR SHALL MATCH ADJACENT CEILING

REFLECTED CEILING PLAN LEGEND AND SYMBOLS: NOTE: ALL HATCHES, SYMBOLS AND REFERENCES ARE TO BE COORDINATED WITH THE GENERAL RENOVATION NOTED, CONSTRUCTION TYPES & GENERAL NOTES ON DRAWING

RCP HATCH LEGEND:

EXISTING CEILING FINISH TO REMAIN

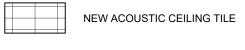

NEW GYPSUM CEILING, PAINTED PNT-03 UNLESS OTHERWISE NOTED

LIGHTING SPECIFICATIONS:

- L1 610mm X 1220mm RECESSED LED PANEL FIXTURE, MOUNTED
- L2 102mm X 1220mm RECESSED LED PANEL FIXTURE, MOUNTED
- L3 102mm X 1220mm SUSPENDED LINEAR LED FIXTURE FOR
- OPEN CEILING, CABLE HUNG L4 25mm UNDER-CABINET LED STRIP C/W DIFFUSER, LENGTH
- PER DRAWINGS
- L5 102mm RECESSED ROUND POT LIGHT L6 JONI WALL WALL SCONCE BY SEAN LAVIN FOR TECH

REFER TO A11.00 SCHEDULES FOR MORE INFORMATION

VPCH OFFICE EXPANSION 155 QUEEN ST NORTH HAMILTON, ONTARIO

25 Main Street West Hamilton, Ontario L8P 1H1 Canada

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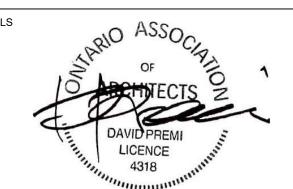
interiors urban design


architecture

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ALL DRAWINGS AND SPECIFICATIONS ARE THE PROPERTY OF THE

ARCHITECT AND MUST BE RETURNED AT THE COMPLETION OF THE WORK.



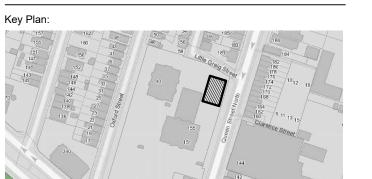

03	ISSUED FOR TENDER	2023.09.0
02	ISSUED FOR PERMIT	2023.05.1
01	Issued for Coordination	2022.07.2
NO.	ISSUES/REVISIONS	DAT


REFLECTED CEILING PLAN

DRAWING TITLE:


DRAWING NO.:

ISSUE DATE:	2023.09.06		
DRAWN BY: MM	CHECKED BY: SL		
PROJECT NO.: 12228	SCALE:	1 : 75	

REVISION:

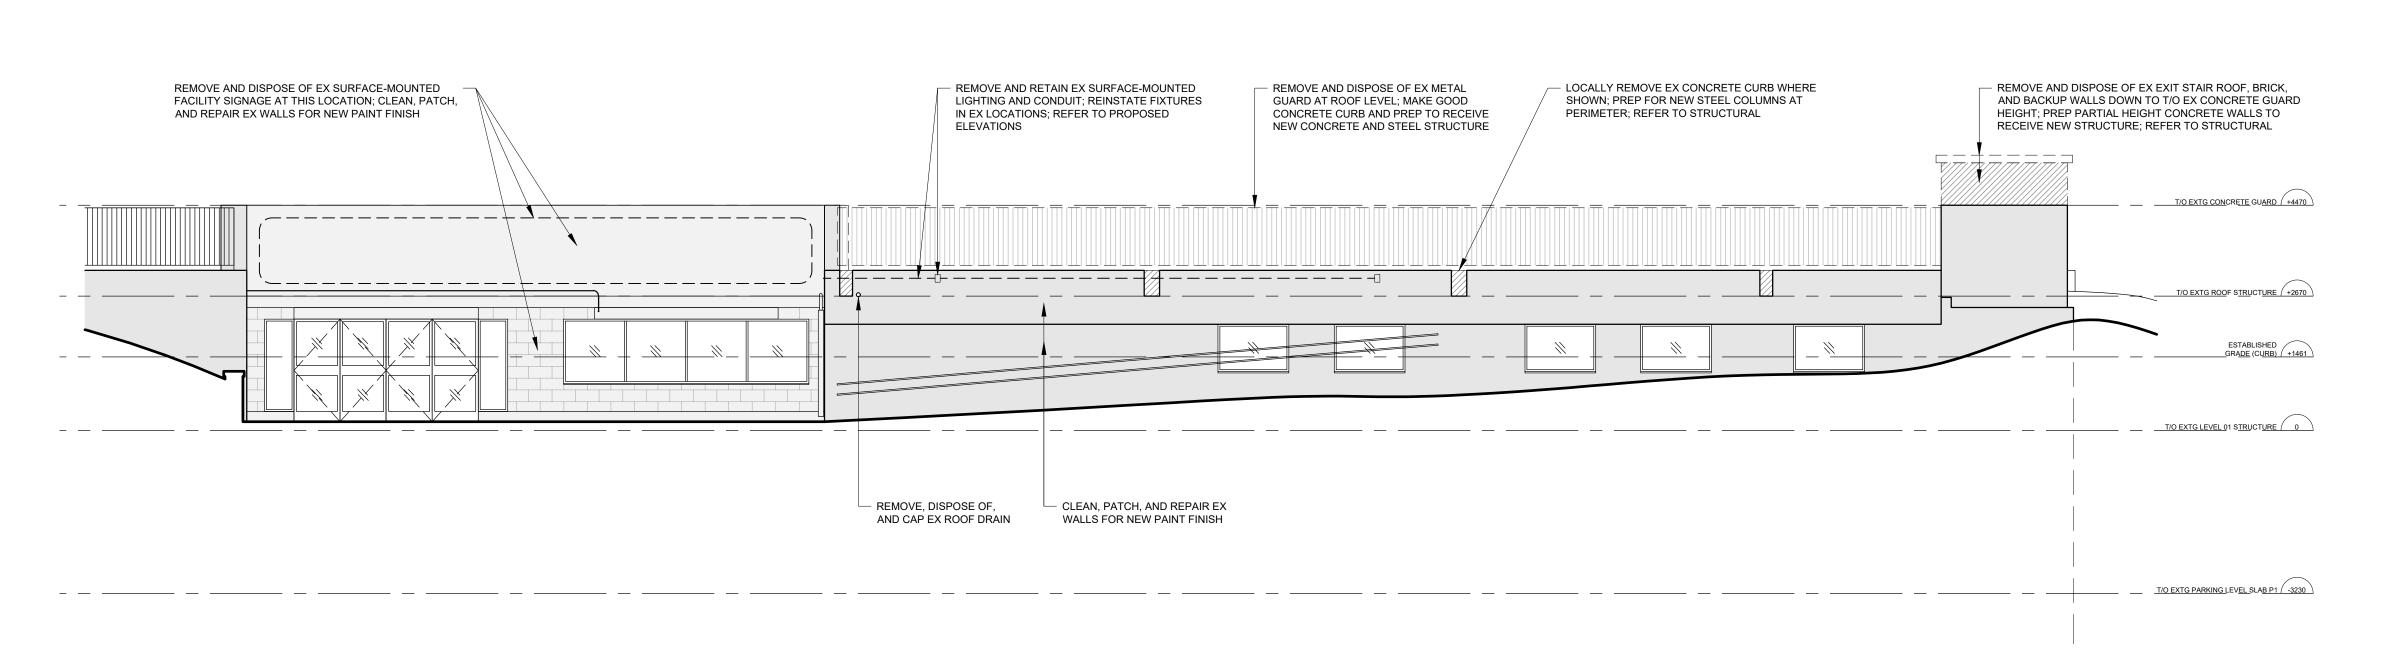

DEMOLITION ELEVATION - EXTERIOR SOUTH

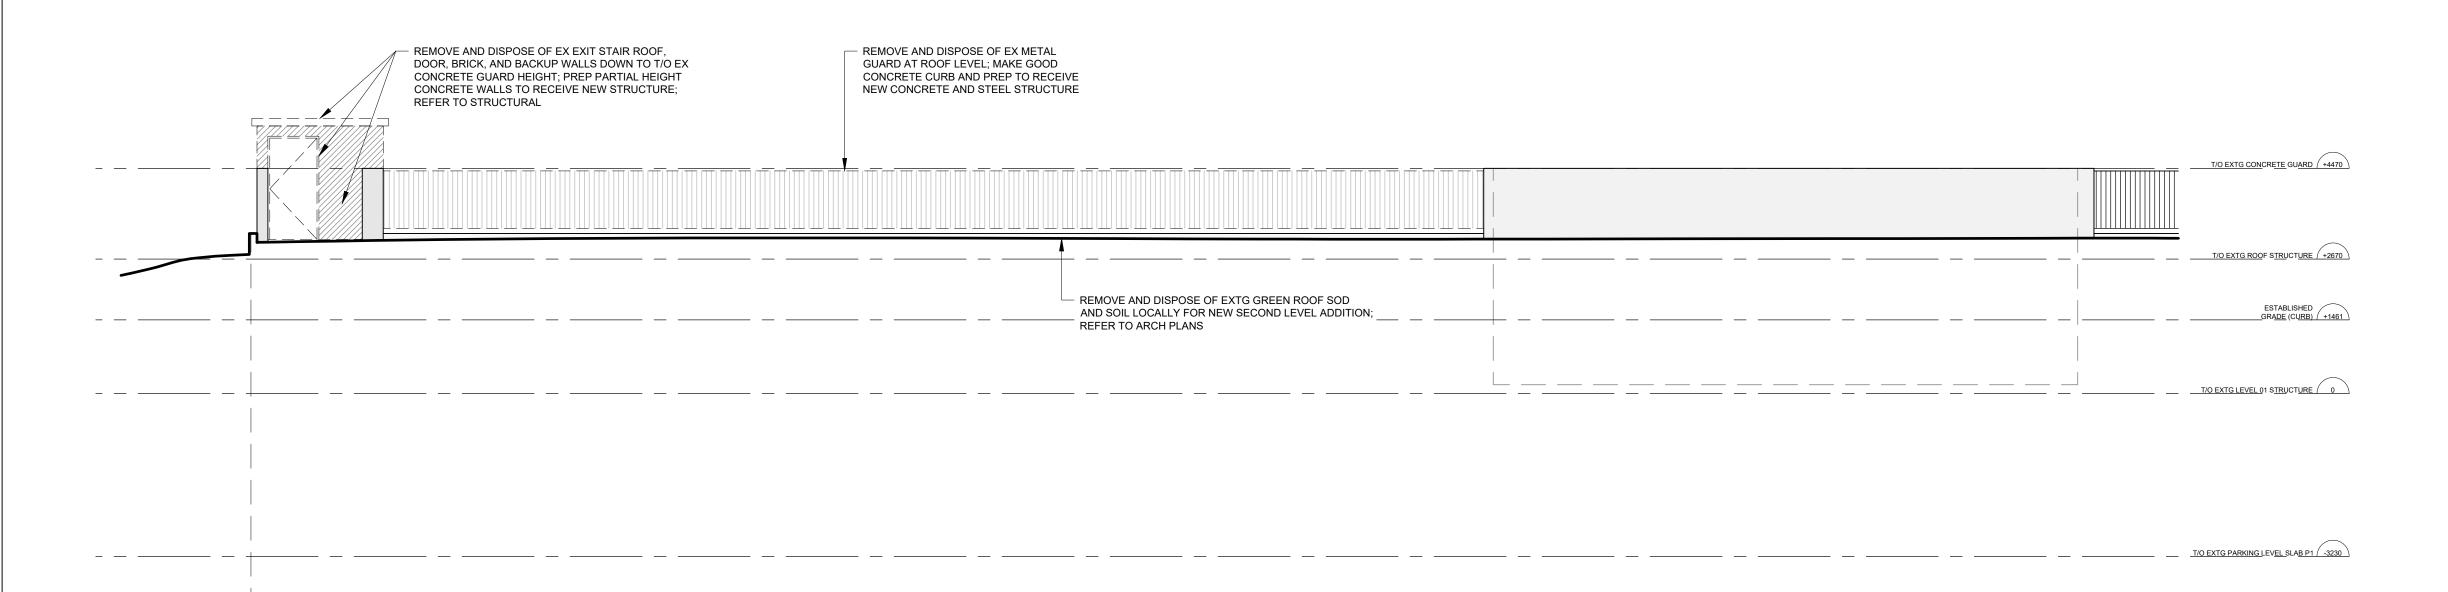

DEMOLITION ELEVATION - EXTERIOR NORTH SCALE: 1:75

GENERAL DEMOLITION NOTES:

- DRAWINGS.
- 2. PROVIDE DUST-TIGHT HOARDING PARTITIONS WHERE REQUIRED FOR PHASING. SEAL ALL AREAS OF CONSTRUCTION TO ALLOW FOR ALL OTHER FLOOR AREAS TO REMAIN OPERATIONAL DURING CONSTRUCTION.
- 3. GC TO COORDINATE EXTENT OF DEMOLITION WITH MECHANICAL, ELECTRICAL, AND STRUCTURAL DRAWINGS. ANY AREAS NOT SHOWN ON ARCHITECTURAL DRAWINGS, WHICH REQUIRE INSTALLATION OF NEW SERVICES, IS TO BE RETURNED TO ORIGINAL STATE TO MATCH EXISTING.
- 4. ALL WALL FIXED ITEMS (SPEAKERS, BELLS, LIGHTS, SIGNAGE, ETC.), AS WELL AS CEILING MOUNTED EQUIPMENT ARE TO REMAIN UNLESS OTHERWISE NOTED (REFER TO AND COORDINATE WITH MECHANICAL AND ELECTRICAL DRAWINGS). GC TO ENSURE THE PROTECTION OF THESE ITEMS DURING CONSTRUCTION.
- 5. REMOVE ALL REDUNDANT POWER OUTLETS AND CONDUIT TO THE JUNCTION BOX AND MAKE SAFE. REFER TO ELECTRICAL DRAWINGS FOR ADDITIONAL INFORMATION.
- 1. REFER TO AND COORDINATE DEMOLITION WORK WITH PHASING 6. PATCH AND REPAIR ALL ADJACENT SURFACES TO AREAS OF DEMOLITION AS REQUIRED TO MATCH EXISTING OR READY FOR
 - 7. CLEAN, PATCH AND REPAIR ALL SURFACES TO REMAIN AS REQUIRED FOR NEW FINISHES.
 - 8. PROVIDE TEMPORARY SUPPORT FOR ADJACENT CEILINGS, LIGHT FIXTURES, DIFFUSERS, CEILING MOUNTED DEVICES, ETC, AS REQUIRED FOR AREAS WHERE CEILINGS ARE REQUIRED TO BE REMOVED TO INSTALL NEW OR MODIFY EXISTING SERVICES. ALL CEILINGS TO BE RESTORED BACK TO ORIGINAL STATE.
 - 9. GC TO VERIFY IN FIELD ALL EXISTING MEASUREMENTS AND CONDITIONS. ANY DISCREPANCIES SHALL BE BROUGHT TO THE PROJECT MANAGER'S ATTENTION PRIOR TO THE END OF TENDER
 - 10. RETROFIT EXISTING RADIATOR COVERS, WIRE MOLDS, ETC. AS REQUIRED TO ACCOMMODATE NEW WALL CONSTRUCTION AND DEMOLITION OF EXISTING.

11. EXISTING ITEMS NOTED TO REMAIN, BE RETRO-FIT OR RE-FINISHED, ARE TO HAVE THEIR EXISTING STATE SITE VERIFIED FOR INTEGRITY. ANY DISCREPANCIES SHALL BE BROUGHT TO THE PROJECT MANAGER'S ATTENTION PRIOR TO CONSTRUCTION.



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155 QUEEN ST NORTH HAMILTON, ONTARIO




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T: 905-522-0220 interiors urban design

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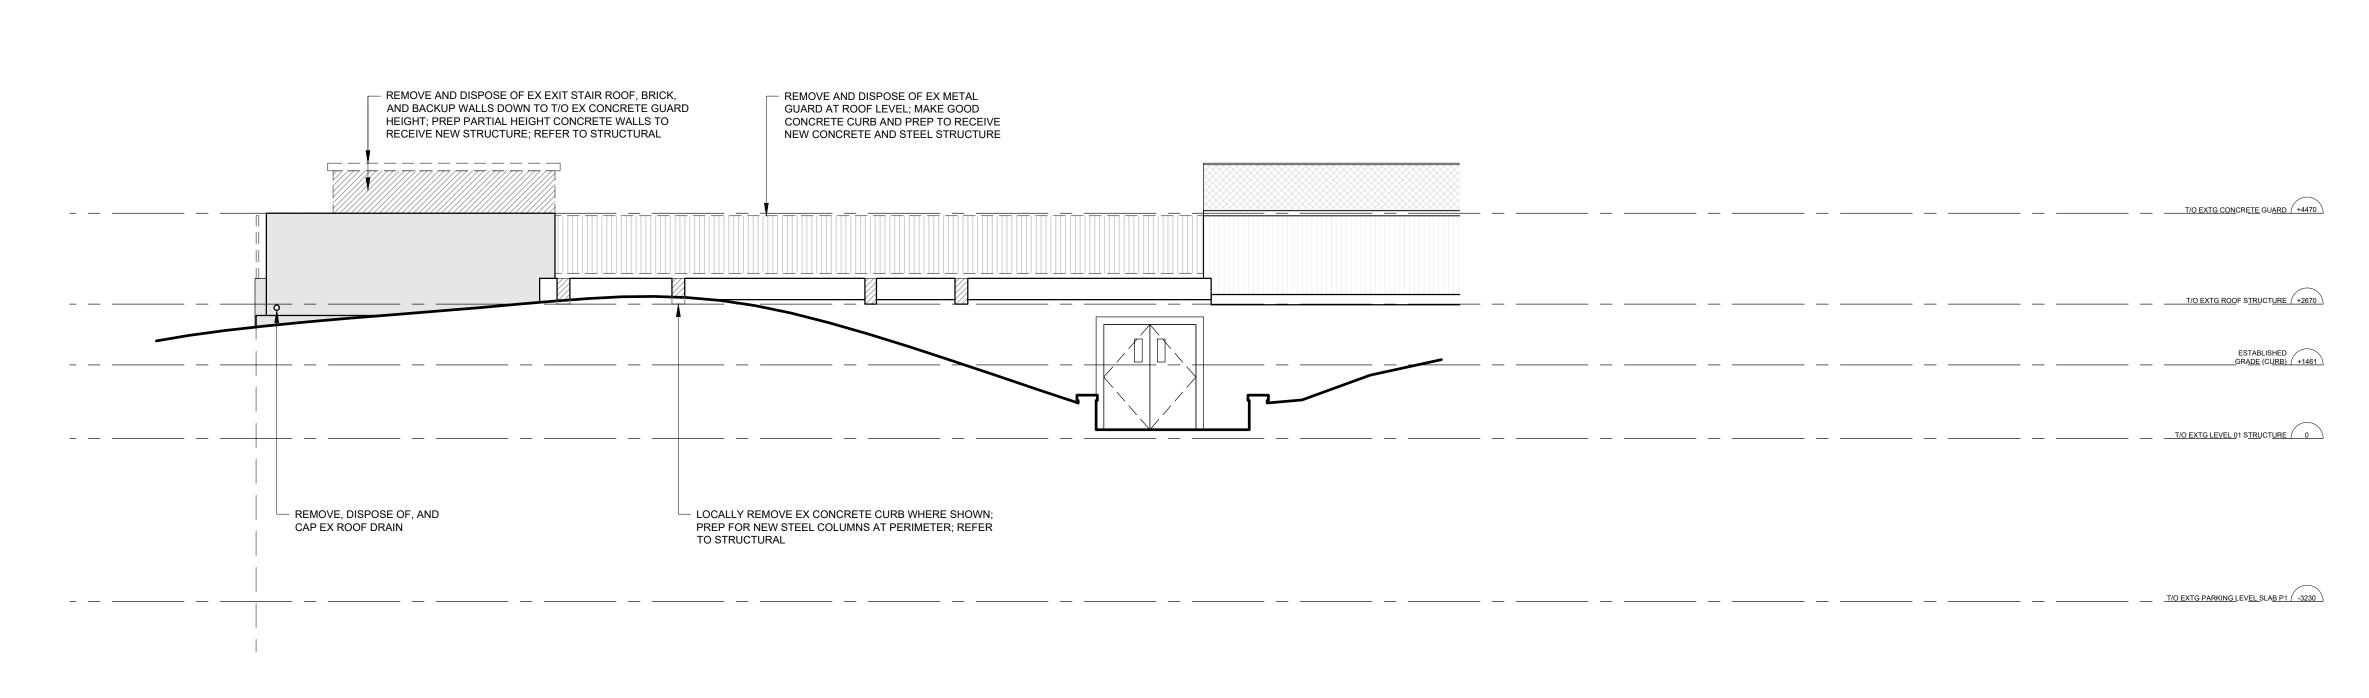


04	ISSUED FOR TENDER	2023.09.06
03	ISSUED FOR PERMIT	2023.05.16
02	Issued for Pre-consultation	2022.10.07
01	Issued for Coordination	2022.07.29
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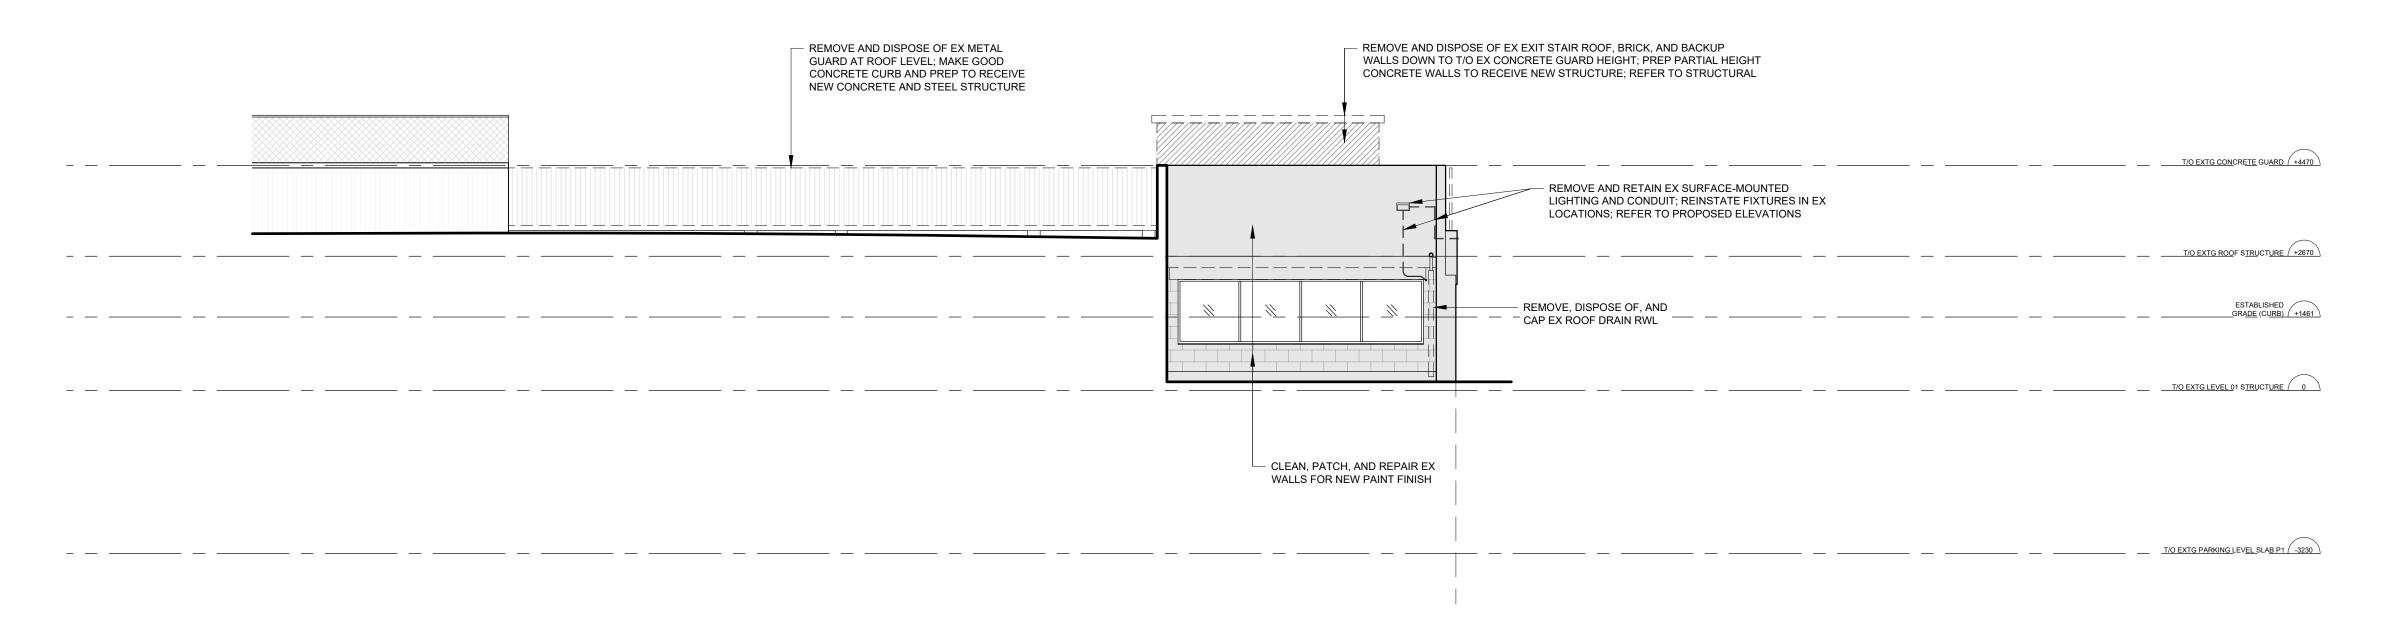
DEMOLITION **EXTERIOR ELEVATIONS**

DRAWING TITLE:

ISSUE DATE:	2023	3.09.06
DRAWN BY: MM	CHECKED BY:	SL
PROJECT NO.: 12228	SCALE:	1:75
DRAWING NO.:	REV	ISION:

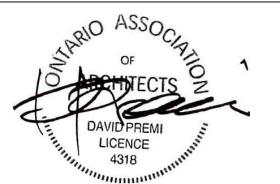

DEMOLITION ELEVATION - EXTERIOR WEST



DEMOLITION ELEVATION - EXTERIOR EAST SCALE: 1:75

GENERAL DEMOLITION NOTES:

- 1. REFER TO AND COORDINATE DEMOLITION WORK WITH PHASING 6. PATCH AND REPAIR ALL ADJACENT SURFACES TO AREAS OF DRAWINGS (BY OTHERS).
- 2. PROVIDE DUST-TIGHT HOARDING PARTITIONS WHERE REQUIRED FOR PHASING (BY OTHERS). SEAL ALL AREAS OF CONSTRUCTION 7. CLEAN, PATCH AND REPAIR ALL SURFACES TO REMAIN AS TO ALLOW FOR ALL OTHER FLOOR AREAS TO REMAIN OPERATIONAL DURING CONSTRUCTION.
- 3. GC TO COORDINATE EXTENT OF DEMOLITION WITH MECHANICAL, ELECTRICAL, AND STRUCTURAL DRAWINGS. ANY AREAS NOT SHOWN ON ARCHITECTURAL DRAWINGS, WHICH REQUIRE INSTALLATION OF NEW SERVICES, IS TO BE RETURNED TO ORIGINAL STATE TO MATCH EXISTING.
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- 5. REMOVE ALL REDUNDANT POWER OUTLETS AND CONDUIT TO THE JUNCTION BOX AND MAKE SAFE. REFER TO ELECTRICAL DRAWINGS FOR ADDITIONAL INFORMATION.
- DEMOLITION AS REQUIRED TO MATCH EXISTING OR READY FOR NEW FINISH.
- REQUIRED FOR NEW FINISHES.
- 8. PROVIDE TEMPORARY SUPPORT FOR ADJACENT CEILINGS, LIGHT FIXTURES, DIFFUSERS, CEILING MOUNTED DEVICES, ETC, AS REQUIRED FOR AREAS WHERE CEILINGS ARE REQUIRED TO BE REMOVED TO INSTALL NEW OR MODIFY EXISTING SERVICES. ALL CEILINGS TO BE RESTORED BACK TO ORIGINAL STATE.
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- 10. RETROFIT EXISTING RADIATOR COVERS, WIRE MOLDS, ETC. AS REQUIRED TO ACCOMMODATE NEW WALL CONSTRUCTION AND DEMOLITION OF EXISTING.

11. EXISTING ITEMS NOTED TO REMAIN, BE RETRO-FIT OR RE-FINISHED, ARE TO HAVE THEIR EXISTING STATE SITE VERIFIED FOR INTEGRITY. ANY DISCREPANCIES SHALL BE BROUGHT TO THE PROJECT MANAGER'S ATTENTION PRIOR TO CONSTRUCTION.



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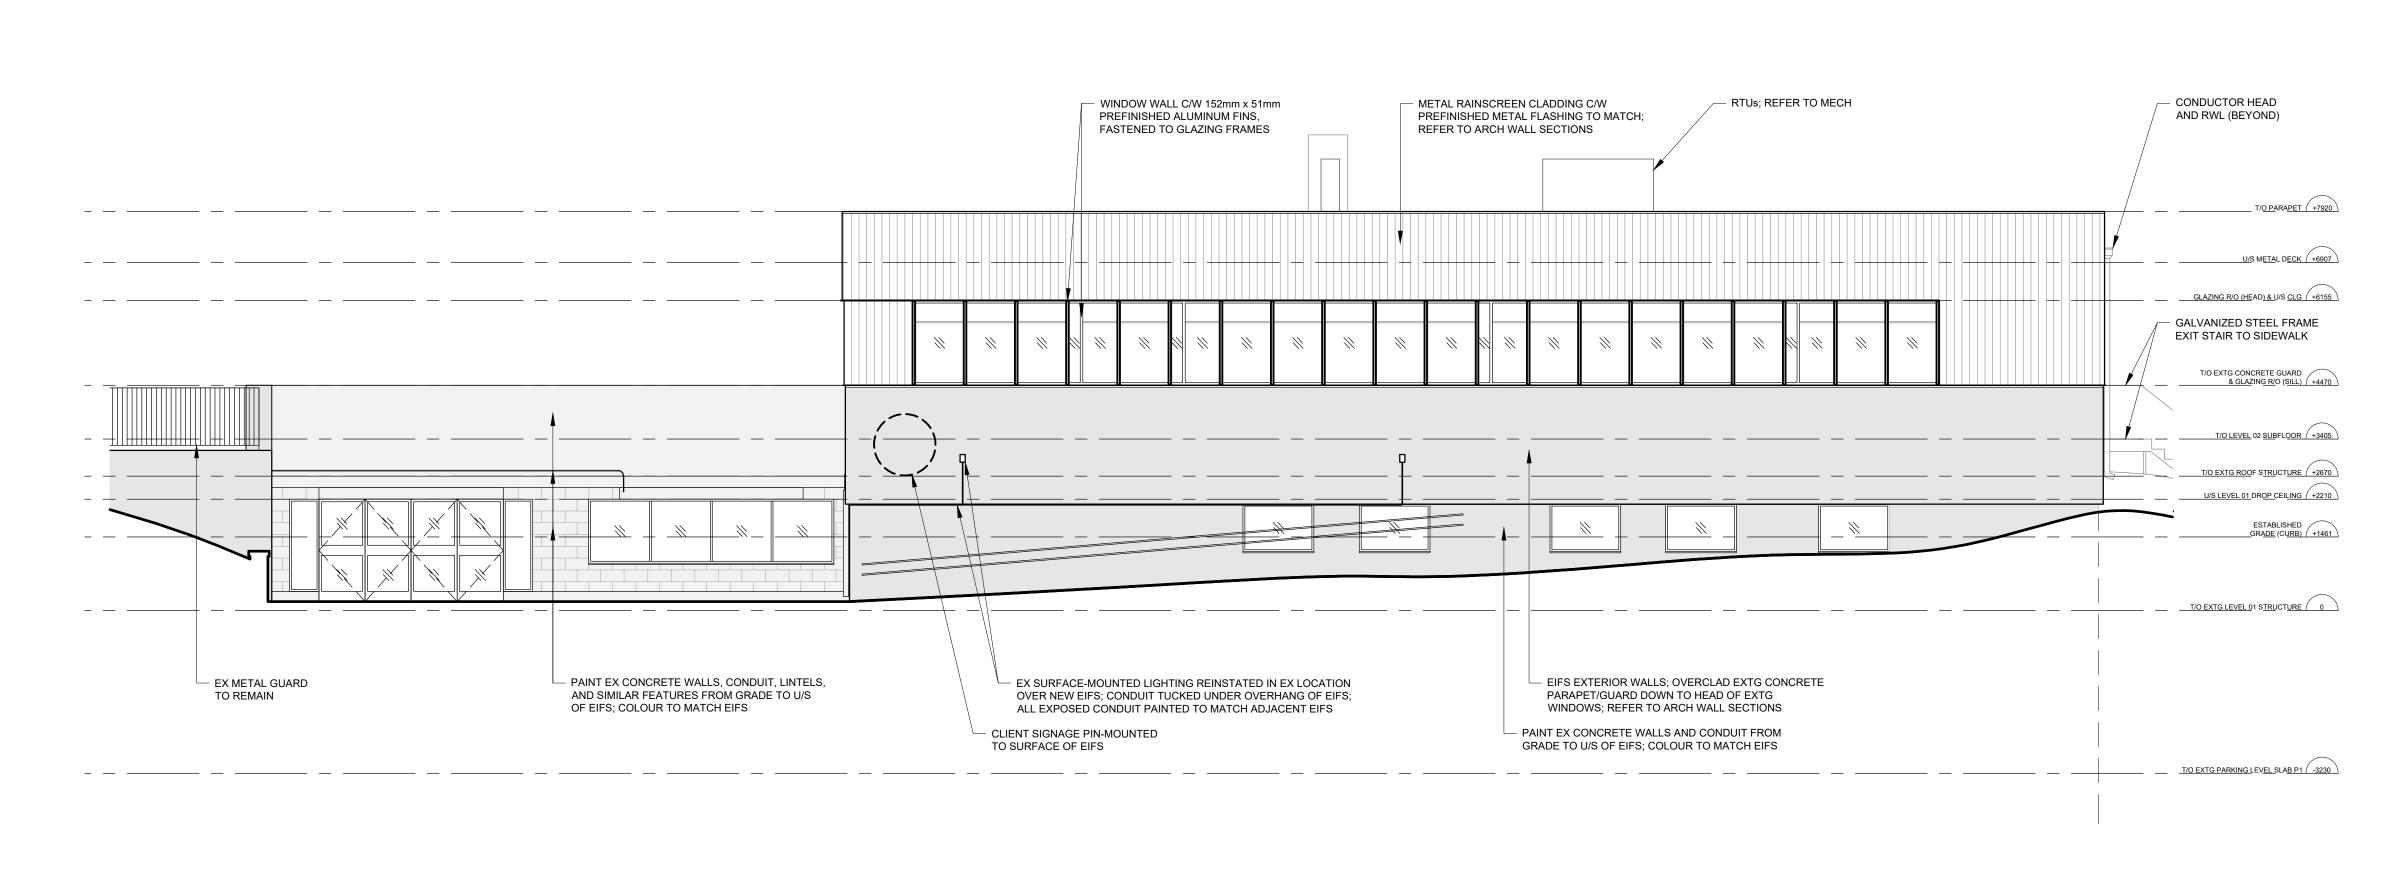


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01	Issued for Coordination	2022.07.29
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DEMOLITION **EXTERIOR ELEVATIONS**


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ISSUE DATE:	:	2023.09.06
DRAWN BY: MM	CHECKED B	Y: SL
PROJECT NO.: 12228	SCALE:	1 : 75
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1 ELEVATION - SOUTH EXTERIOR

ELEVATION - NORTH EXTERIOR





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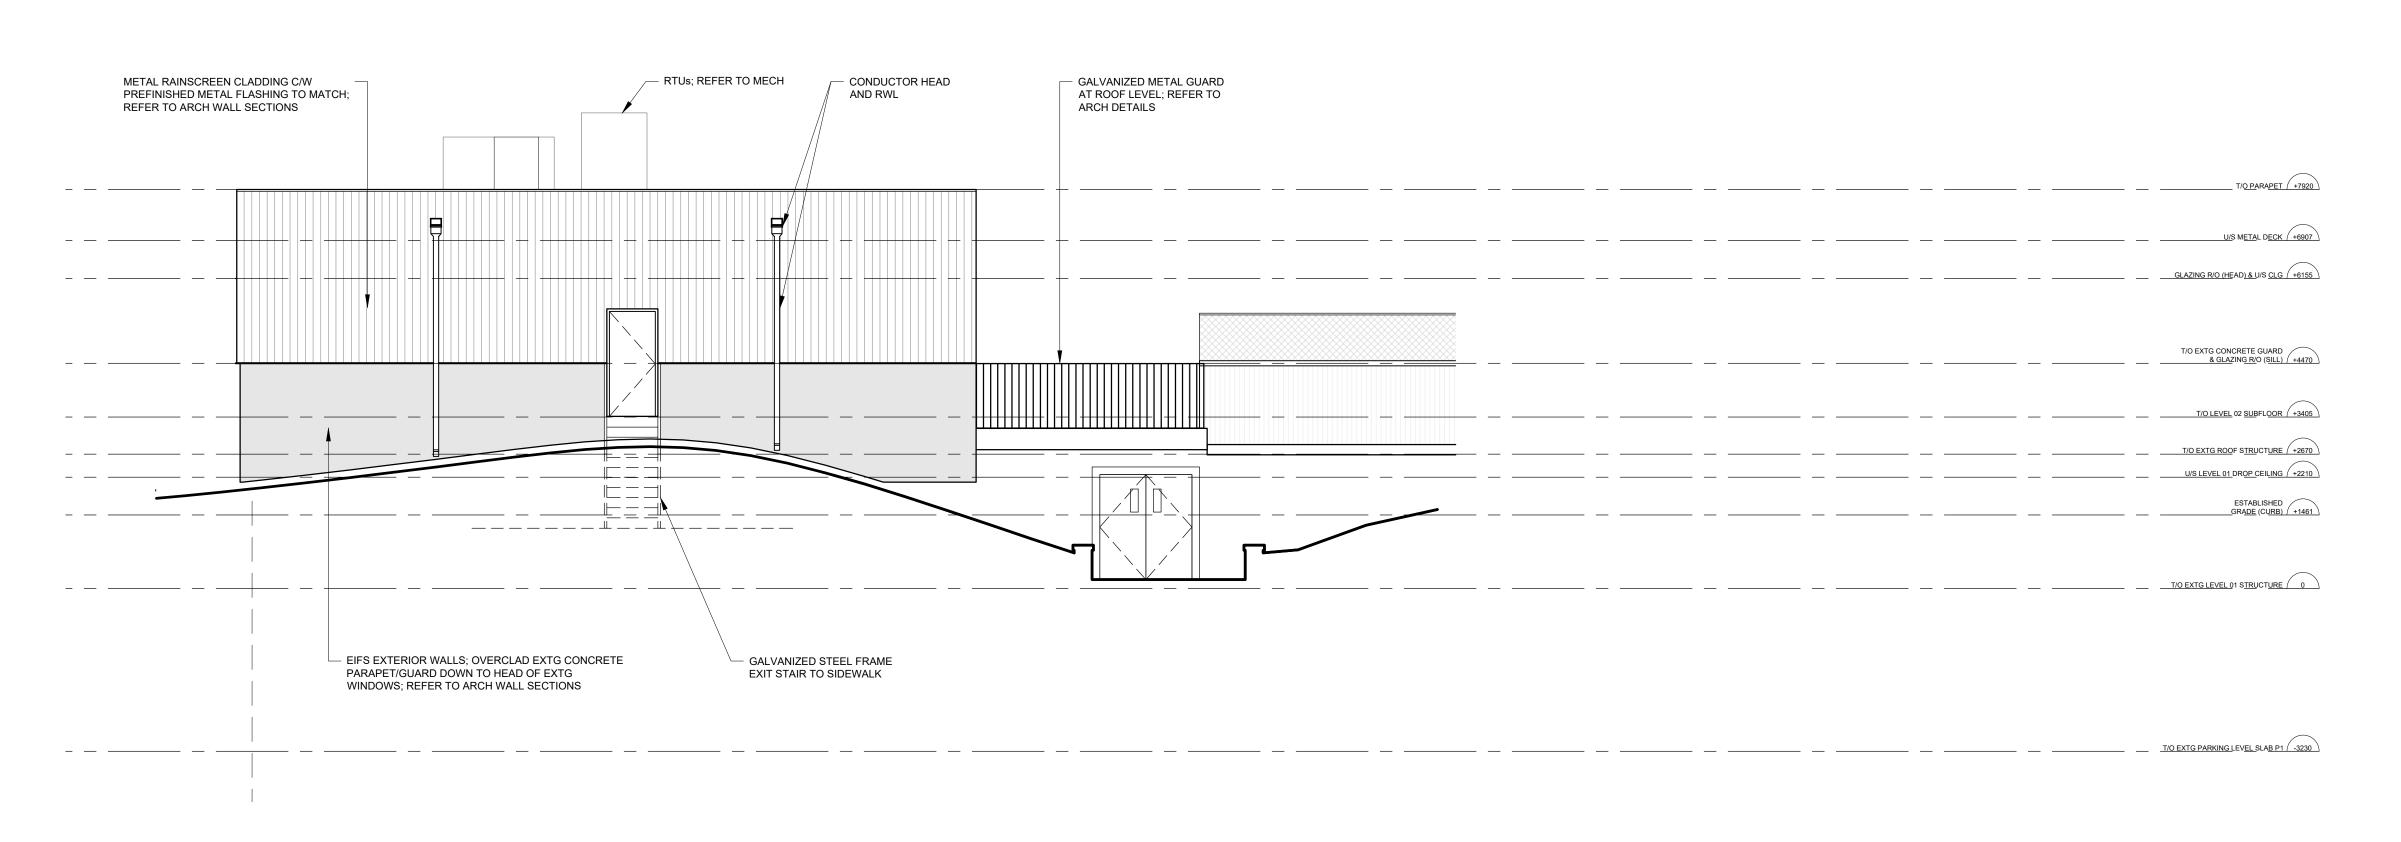
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03	ISSUED FOR PERMIT 2023.05.	
02	Issued for Pre-consultation 2022.10.07	
01	Issued for Coordination 2022.07.2	
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EXTERIOR ELEVATIONS
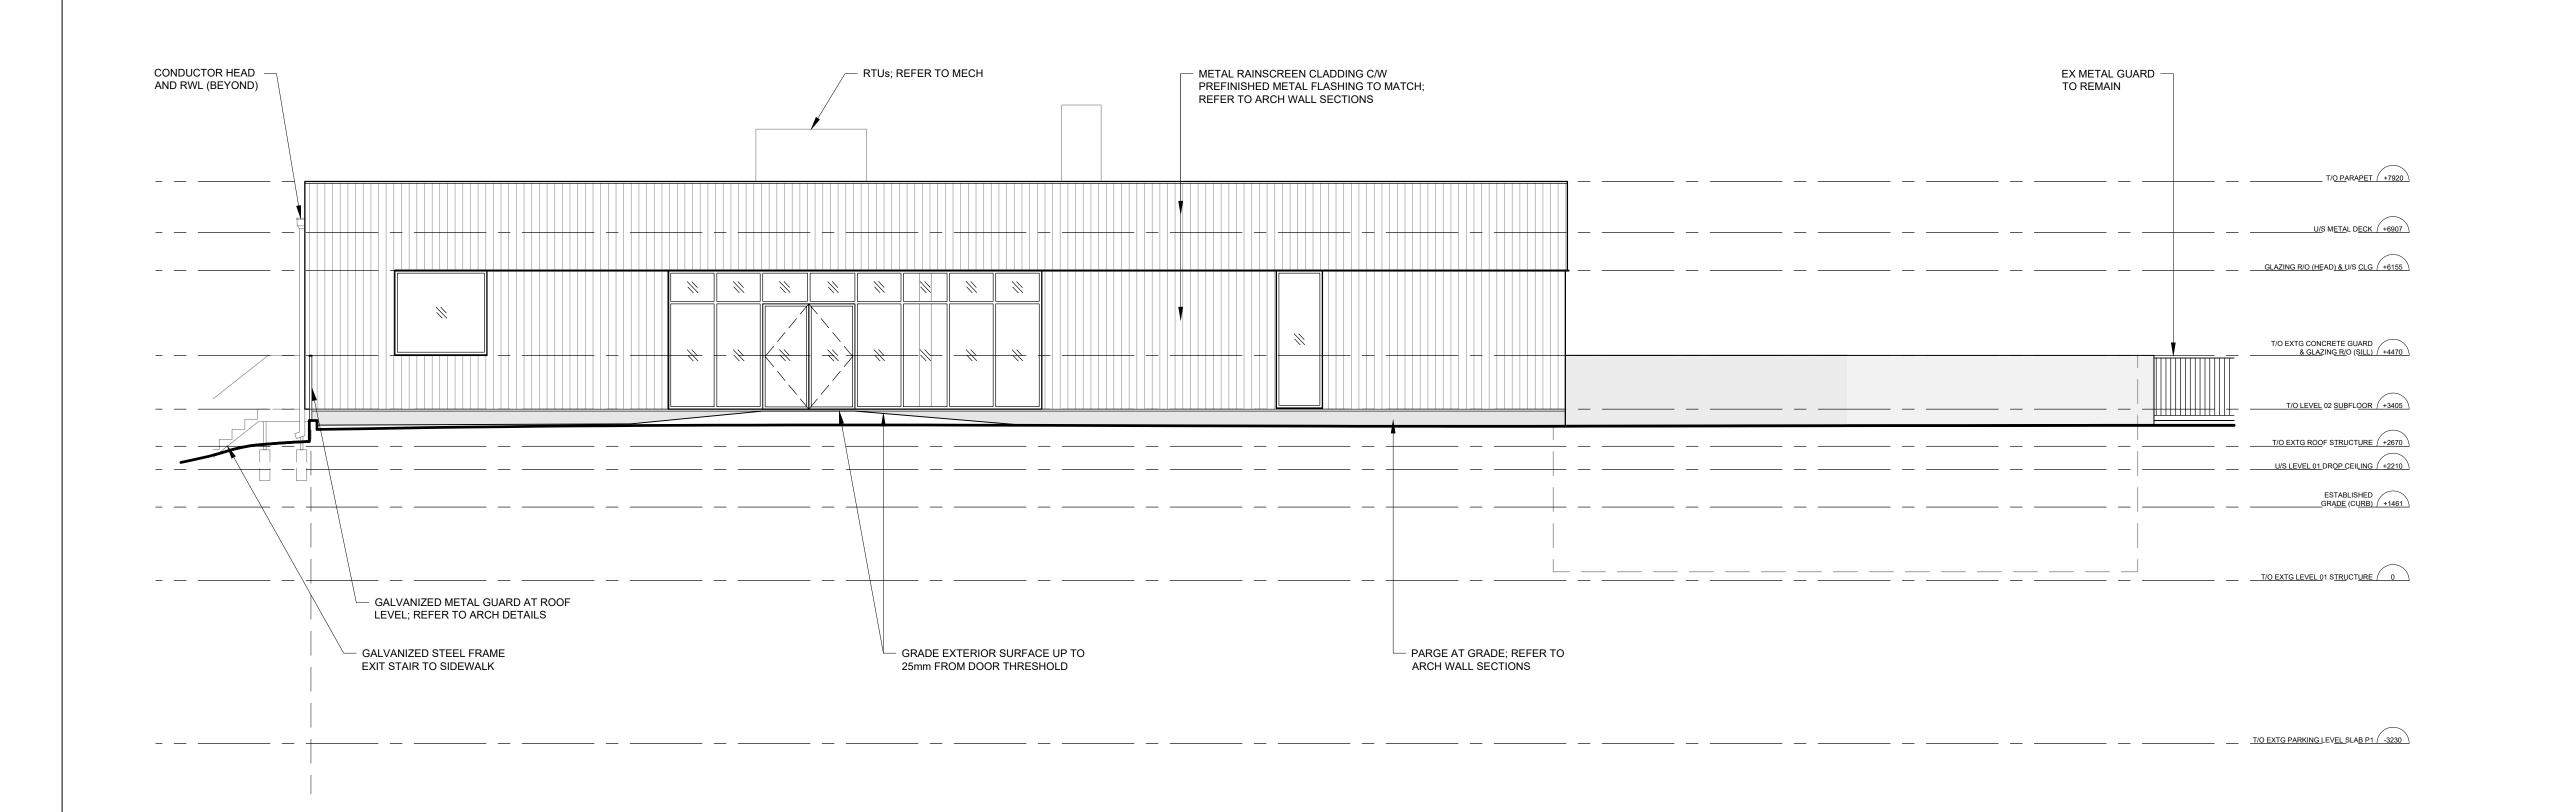
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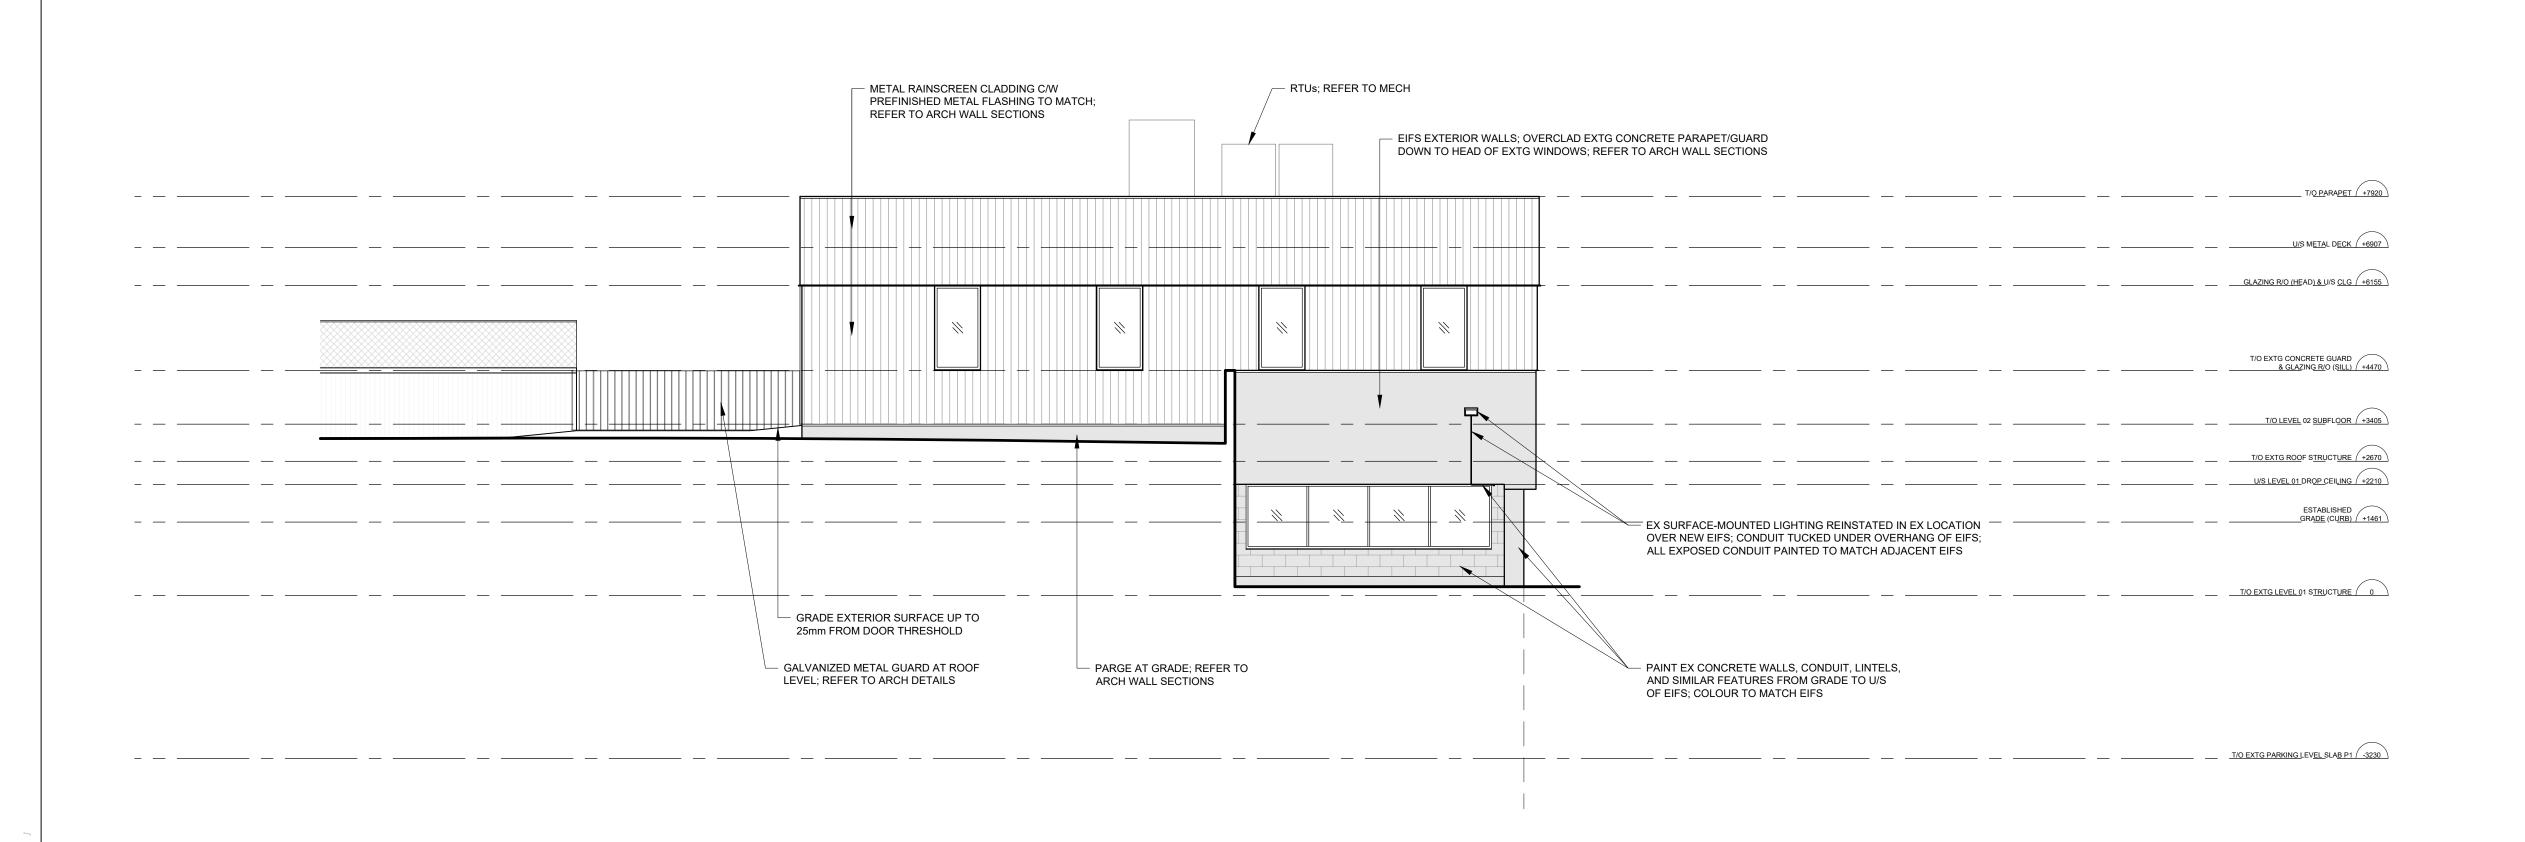
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ELEVATION - WEST EXTERIOR

ELEVATION - EAST EXTERIOR





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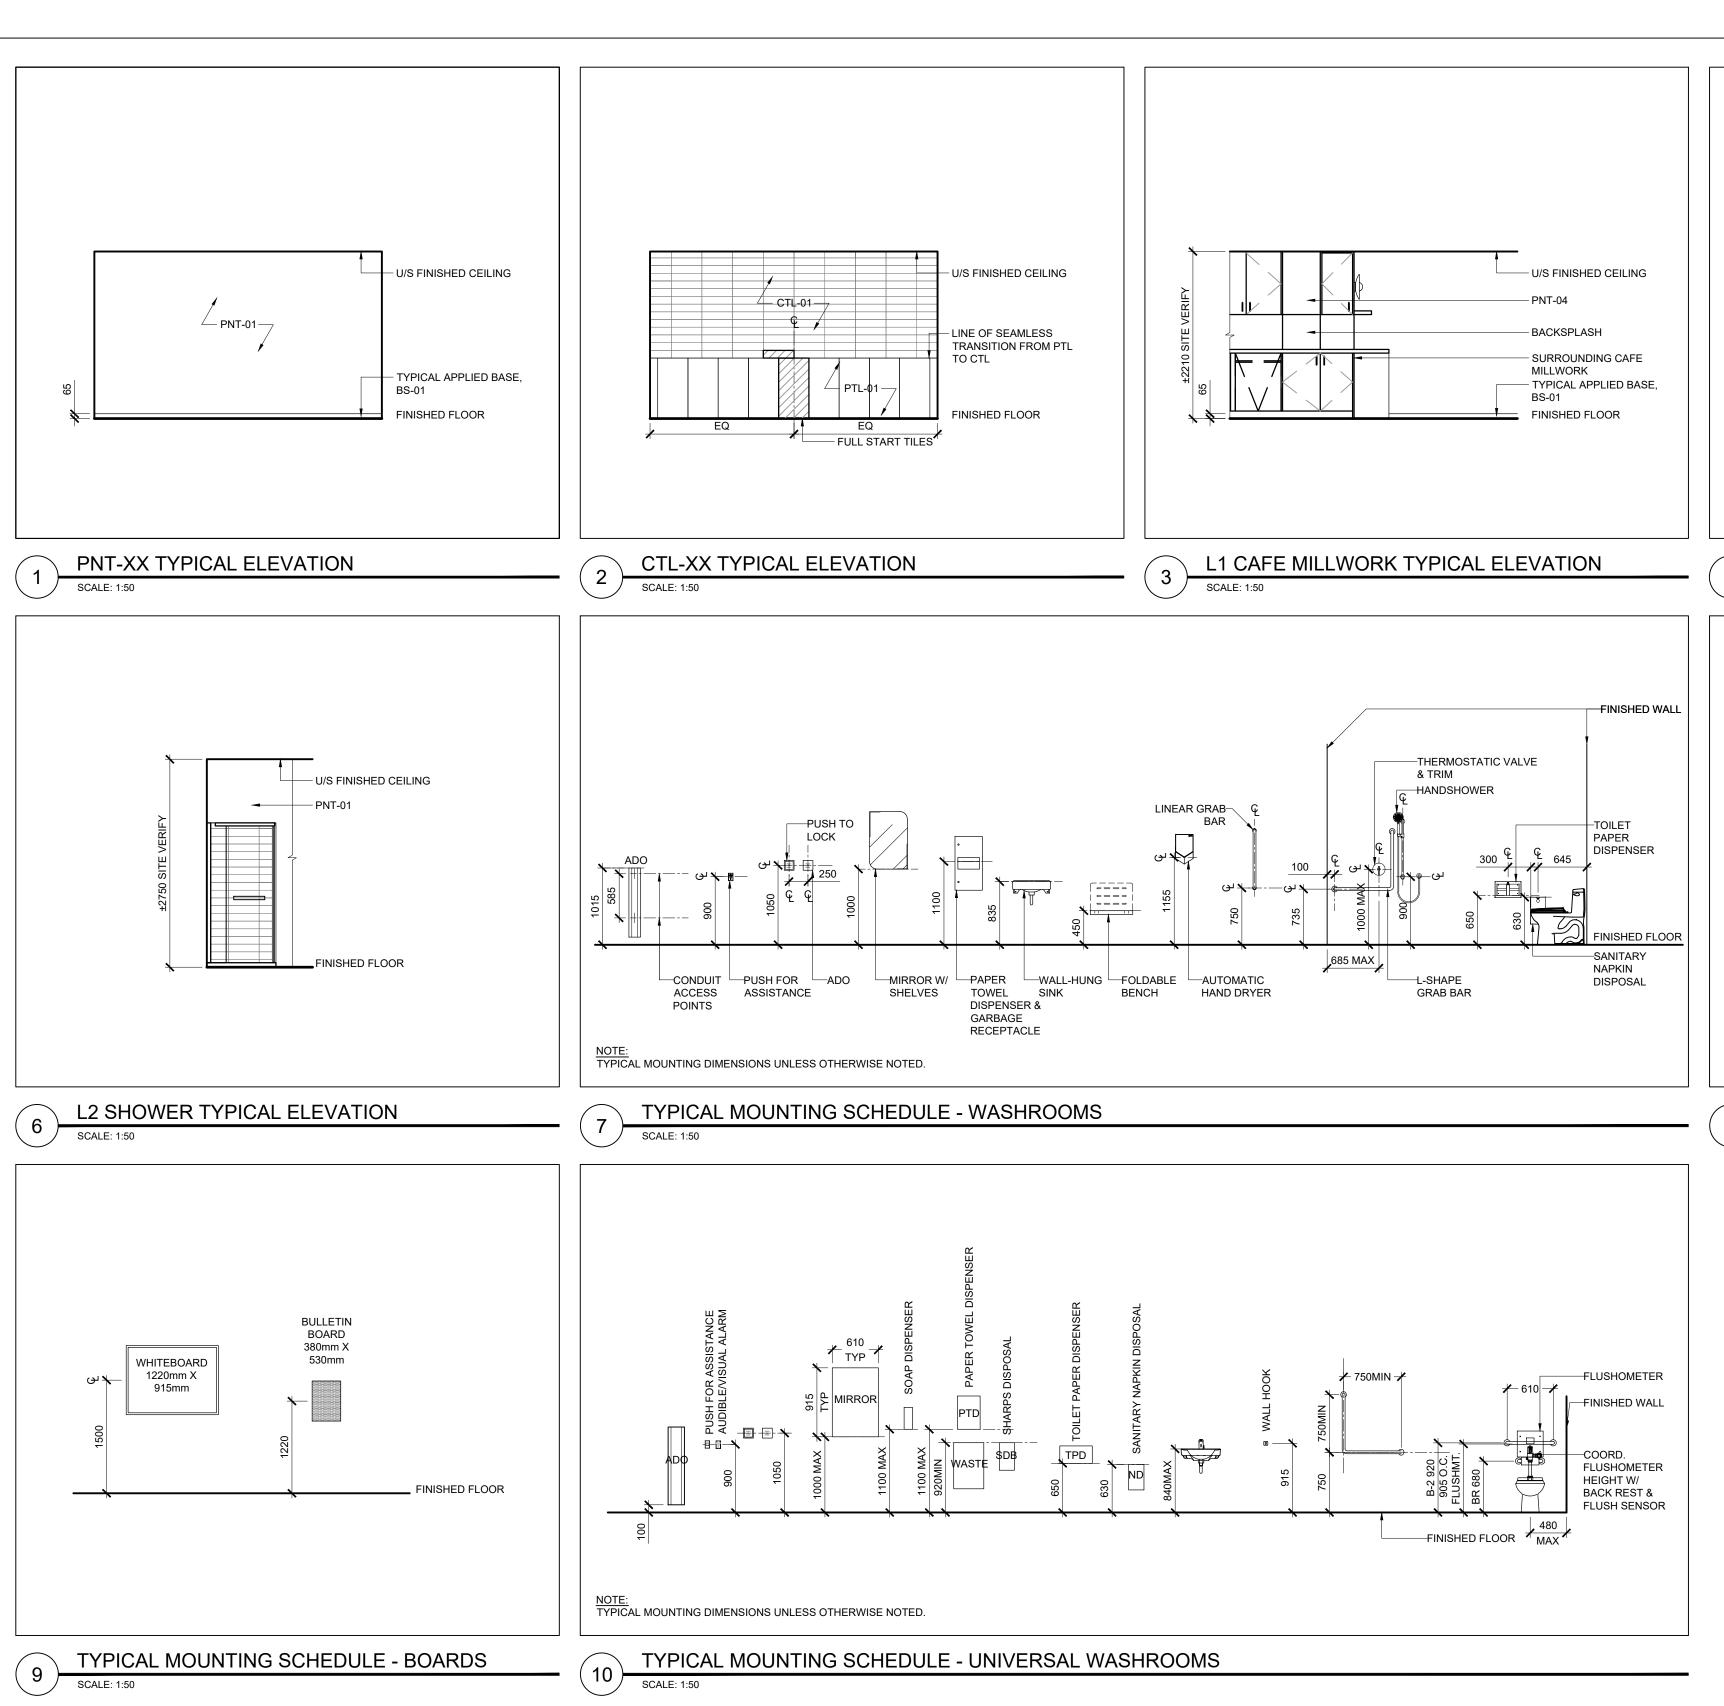






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NO.	ISSUES/REVISIONS	DATE
01	Issued for Coordination	2022.07.29
02	Issued for Pre-consultation	2022.10.07
03	ISSUED FOR PERMIT	2023.05.16
04	ISSUED FOR TENDER	2023.09.06

EXTERIOR ELEVATIONS

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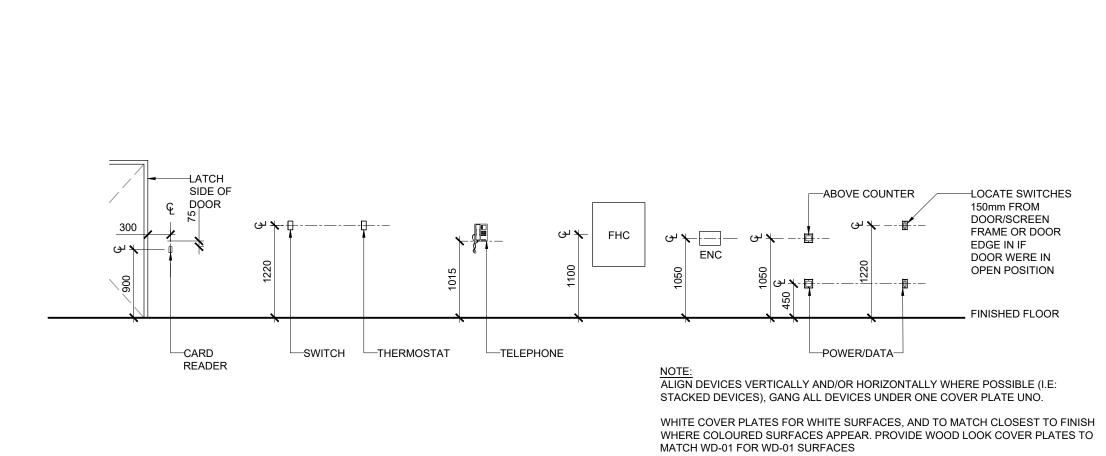




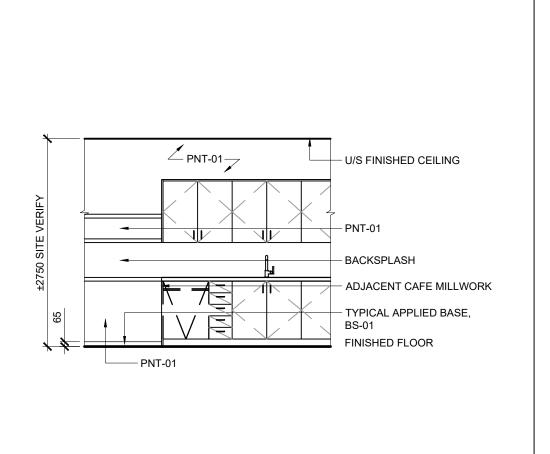

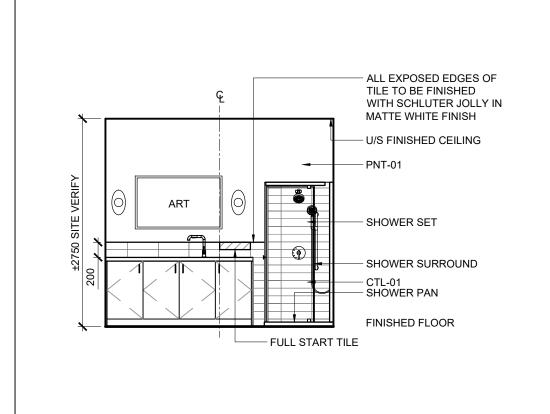L2 COFFEE BAR MILLWORK TYPICAL ELEVATION

L2 SHOWER TYPICAL ELEVATION



TYPICAL MOUNTING SCHEDULE - MISC

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architecture interiors urban design


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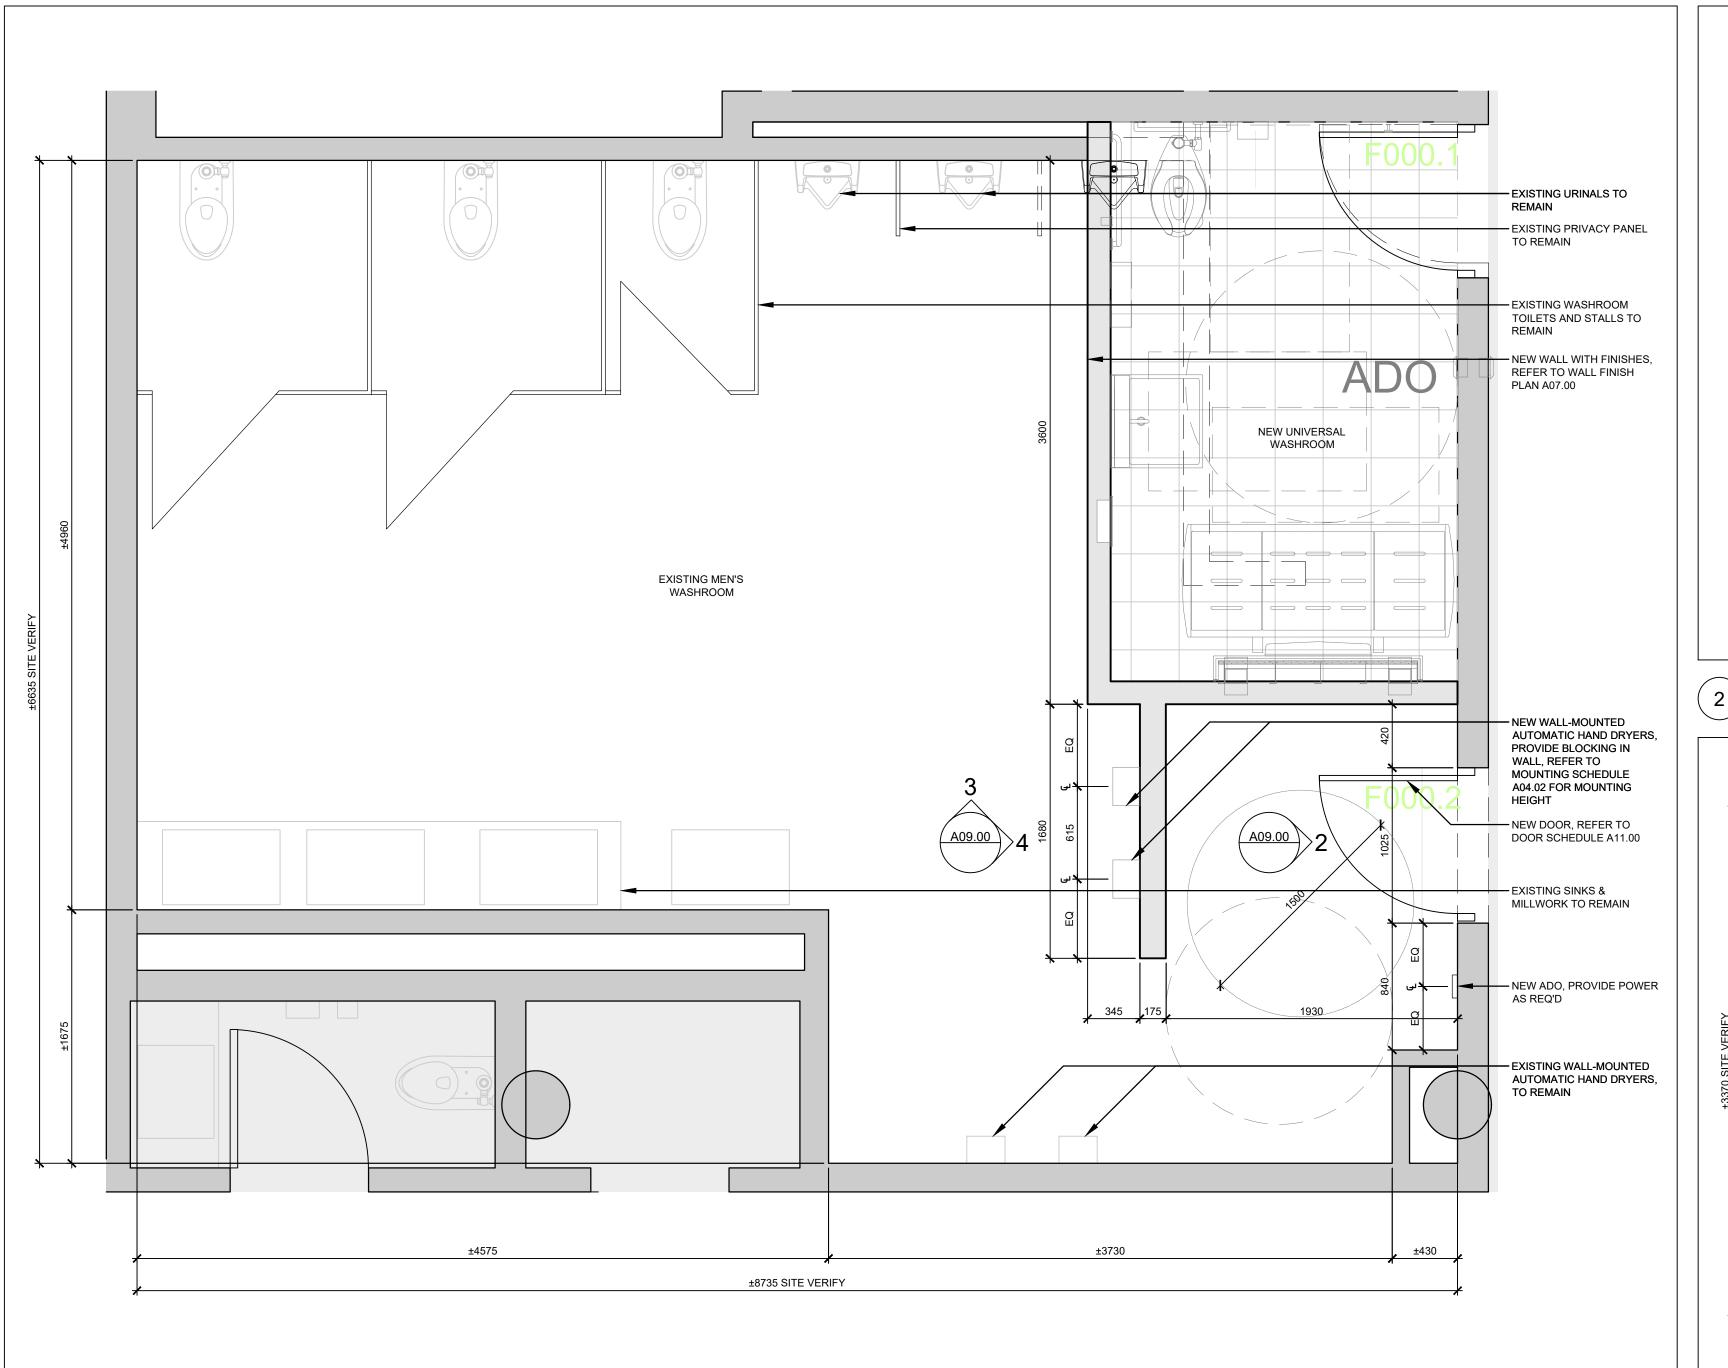





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ISSUES/REVISIONS	DATE
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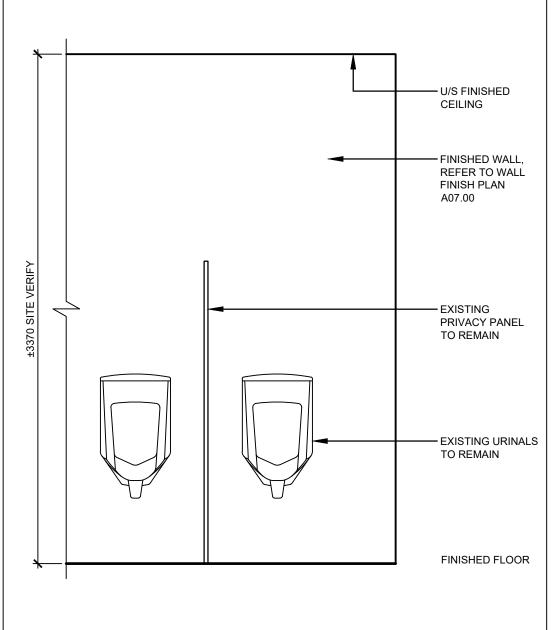
INTERIOR ELEVATIONS & MOUNTING HEIGHT SCHEDULE

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DRAWING NO ·	l REV	/ISION:




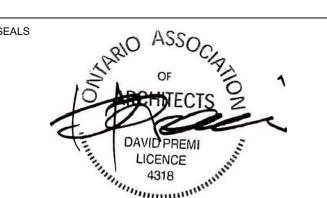

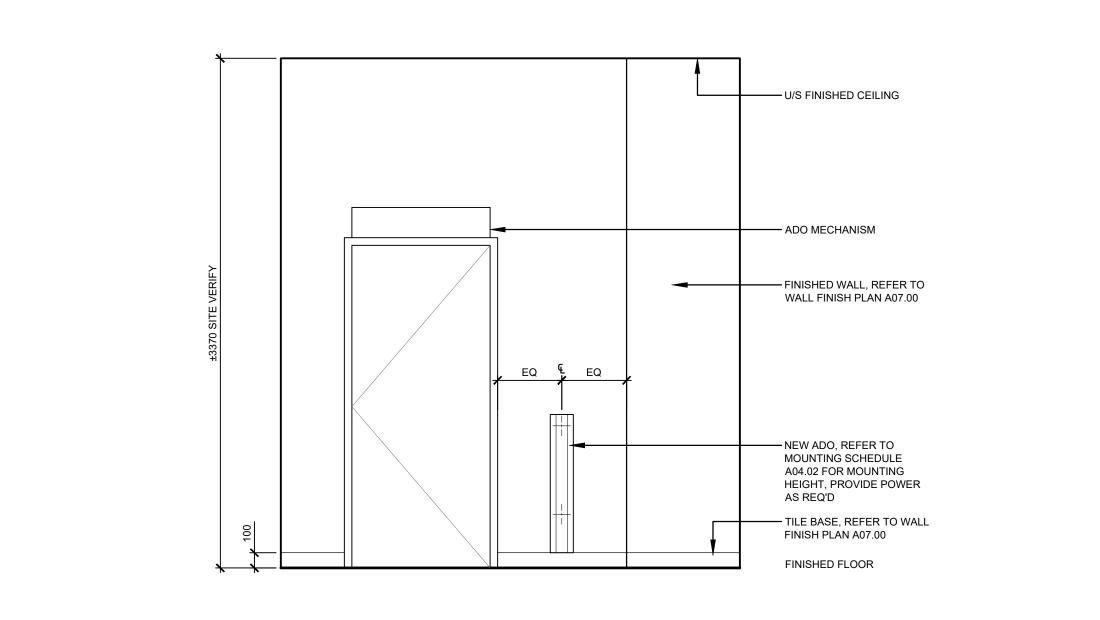EAST ELEVATION - EXISTING MEN'S WASHROOM



NORTH ELEVATION - EXISTING MEN'S WASHROOM SCALE: 1:25

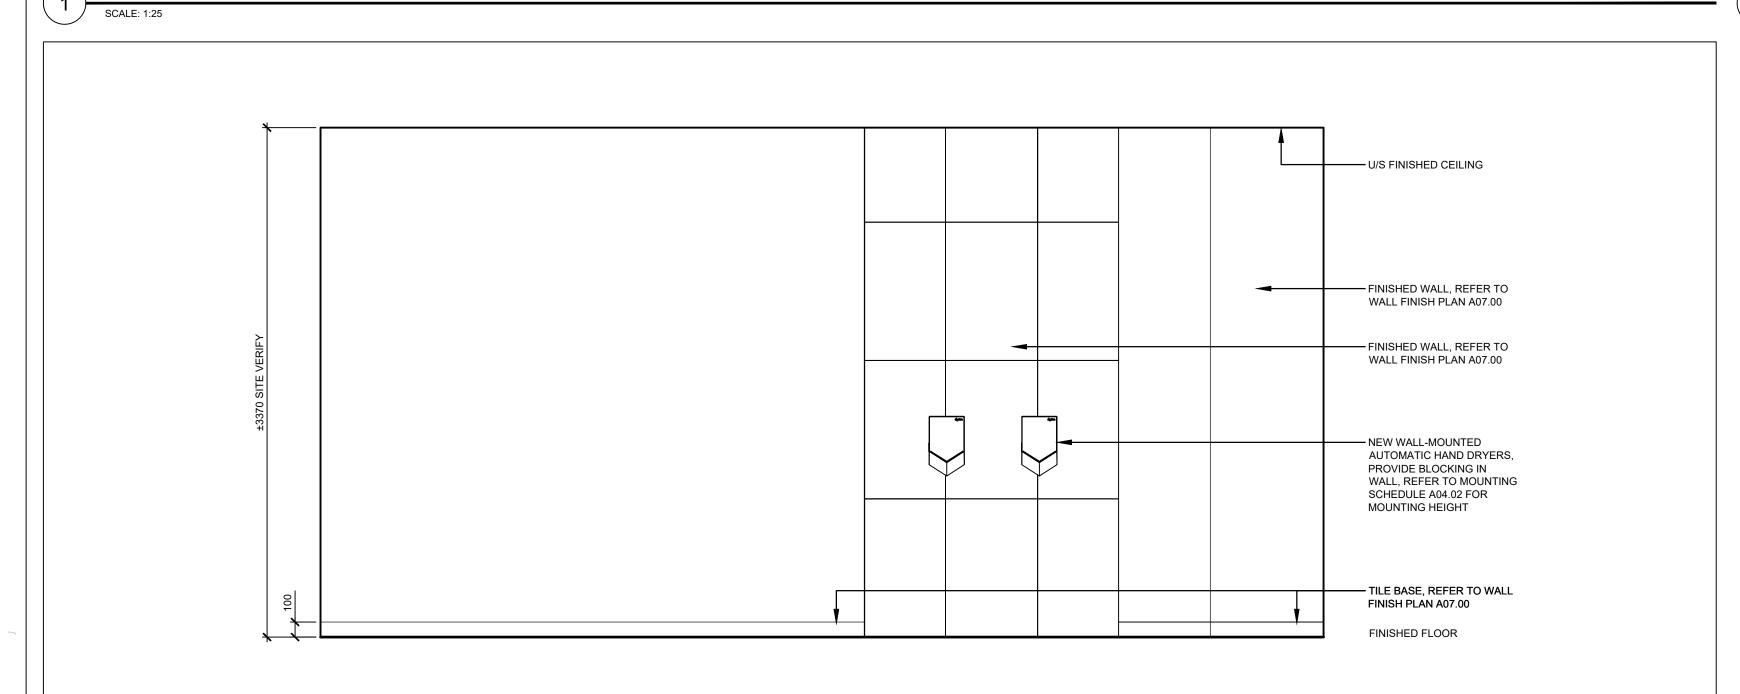

PLAN - EXISTING MEN'S WASHROOM

EAST ELEVATION - EXISTING MEN'S WASHROOM

SCALE: 1:25

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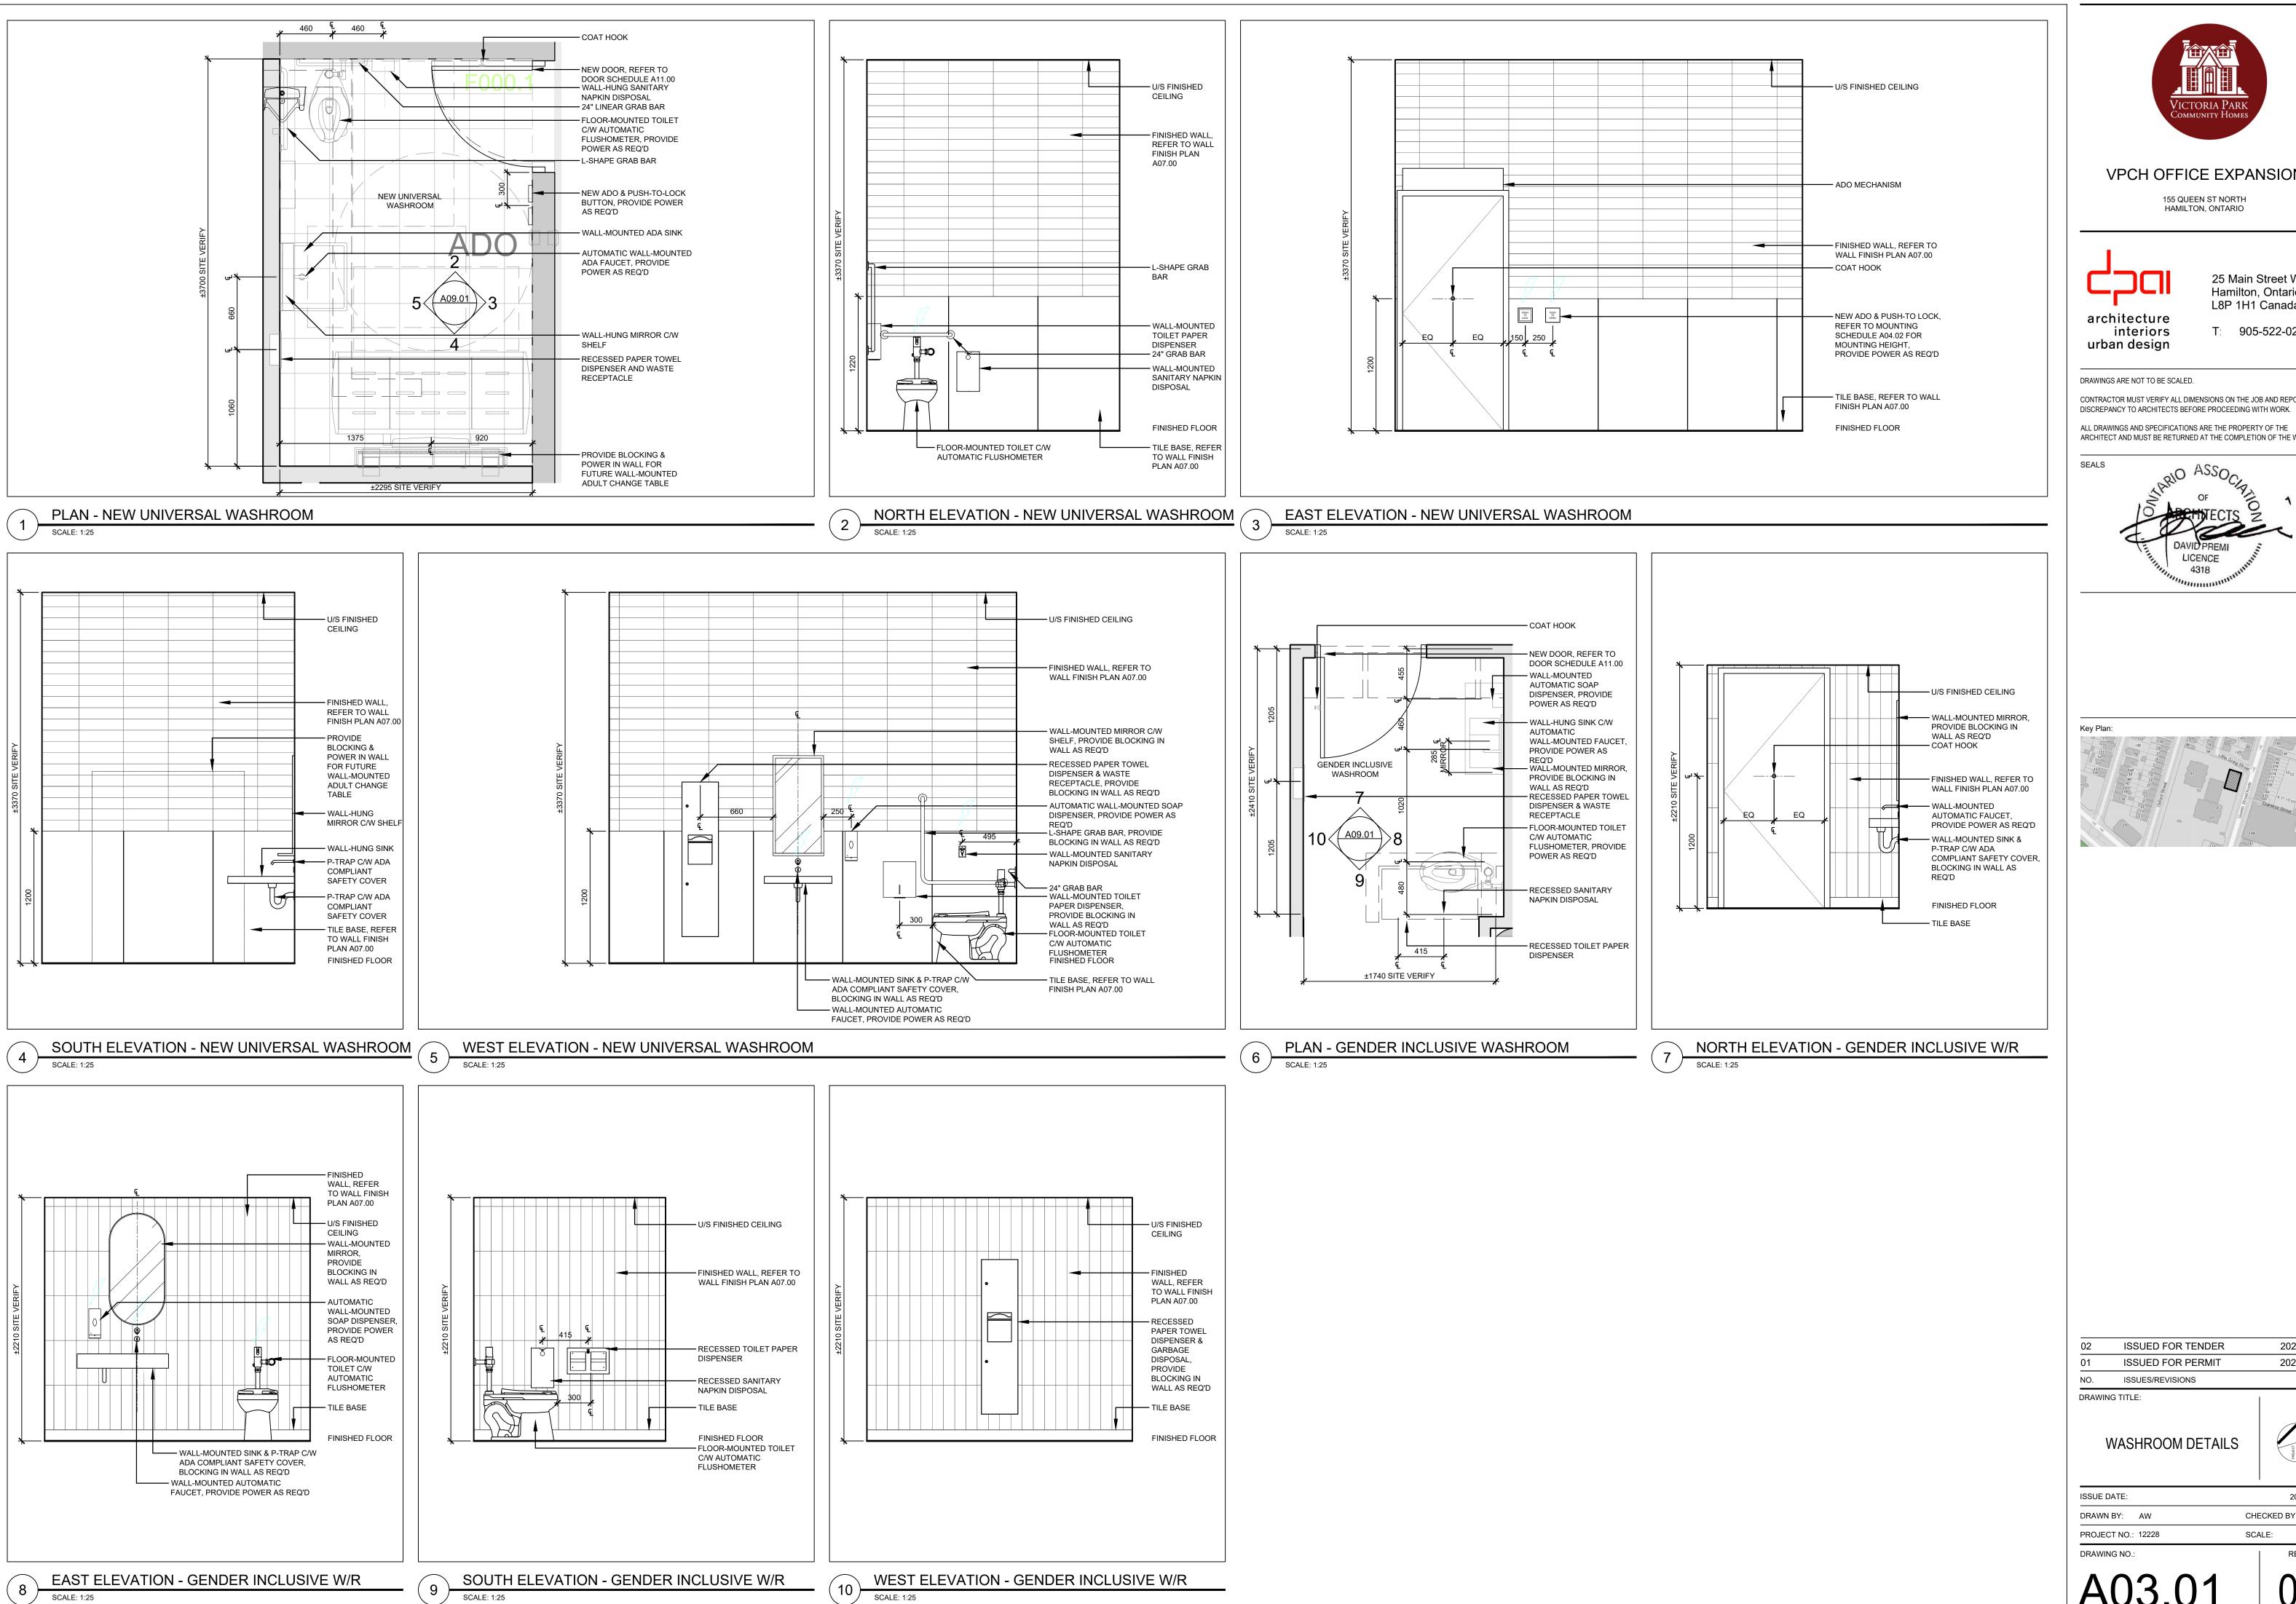
CONTRACTOR MUST VERIFY ALL DIMENSIONS ON THE JOB AND REPORT ANY



02	ISSUED FOR TENDER	2023.09.06
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WASHROOM DETAILS

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ISSUE DATE:	2023.09.06
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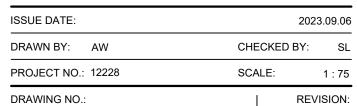
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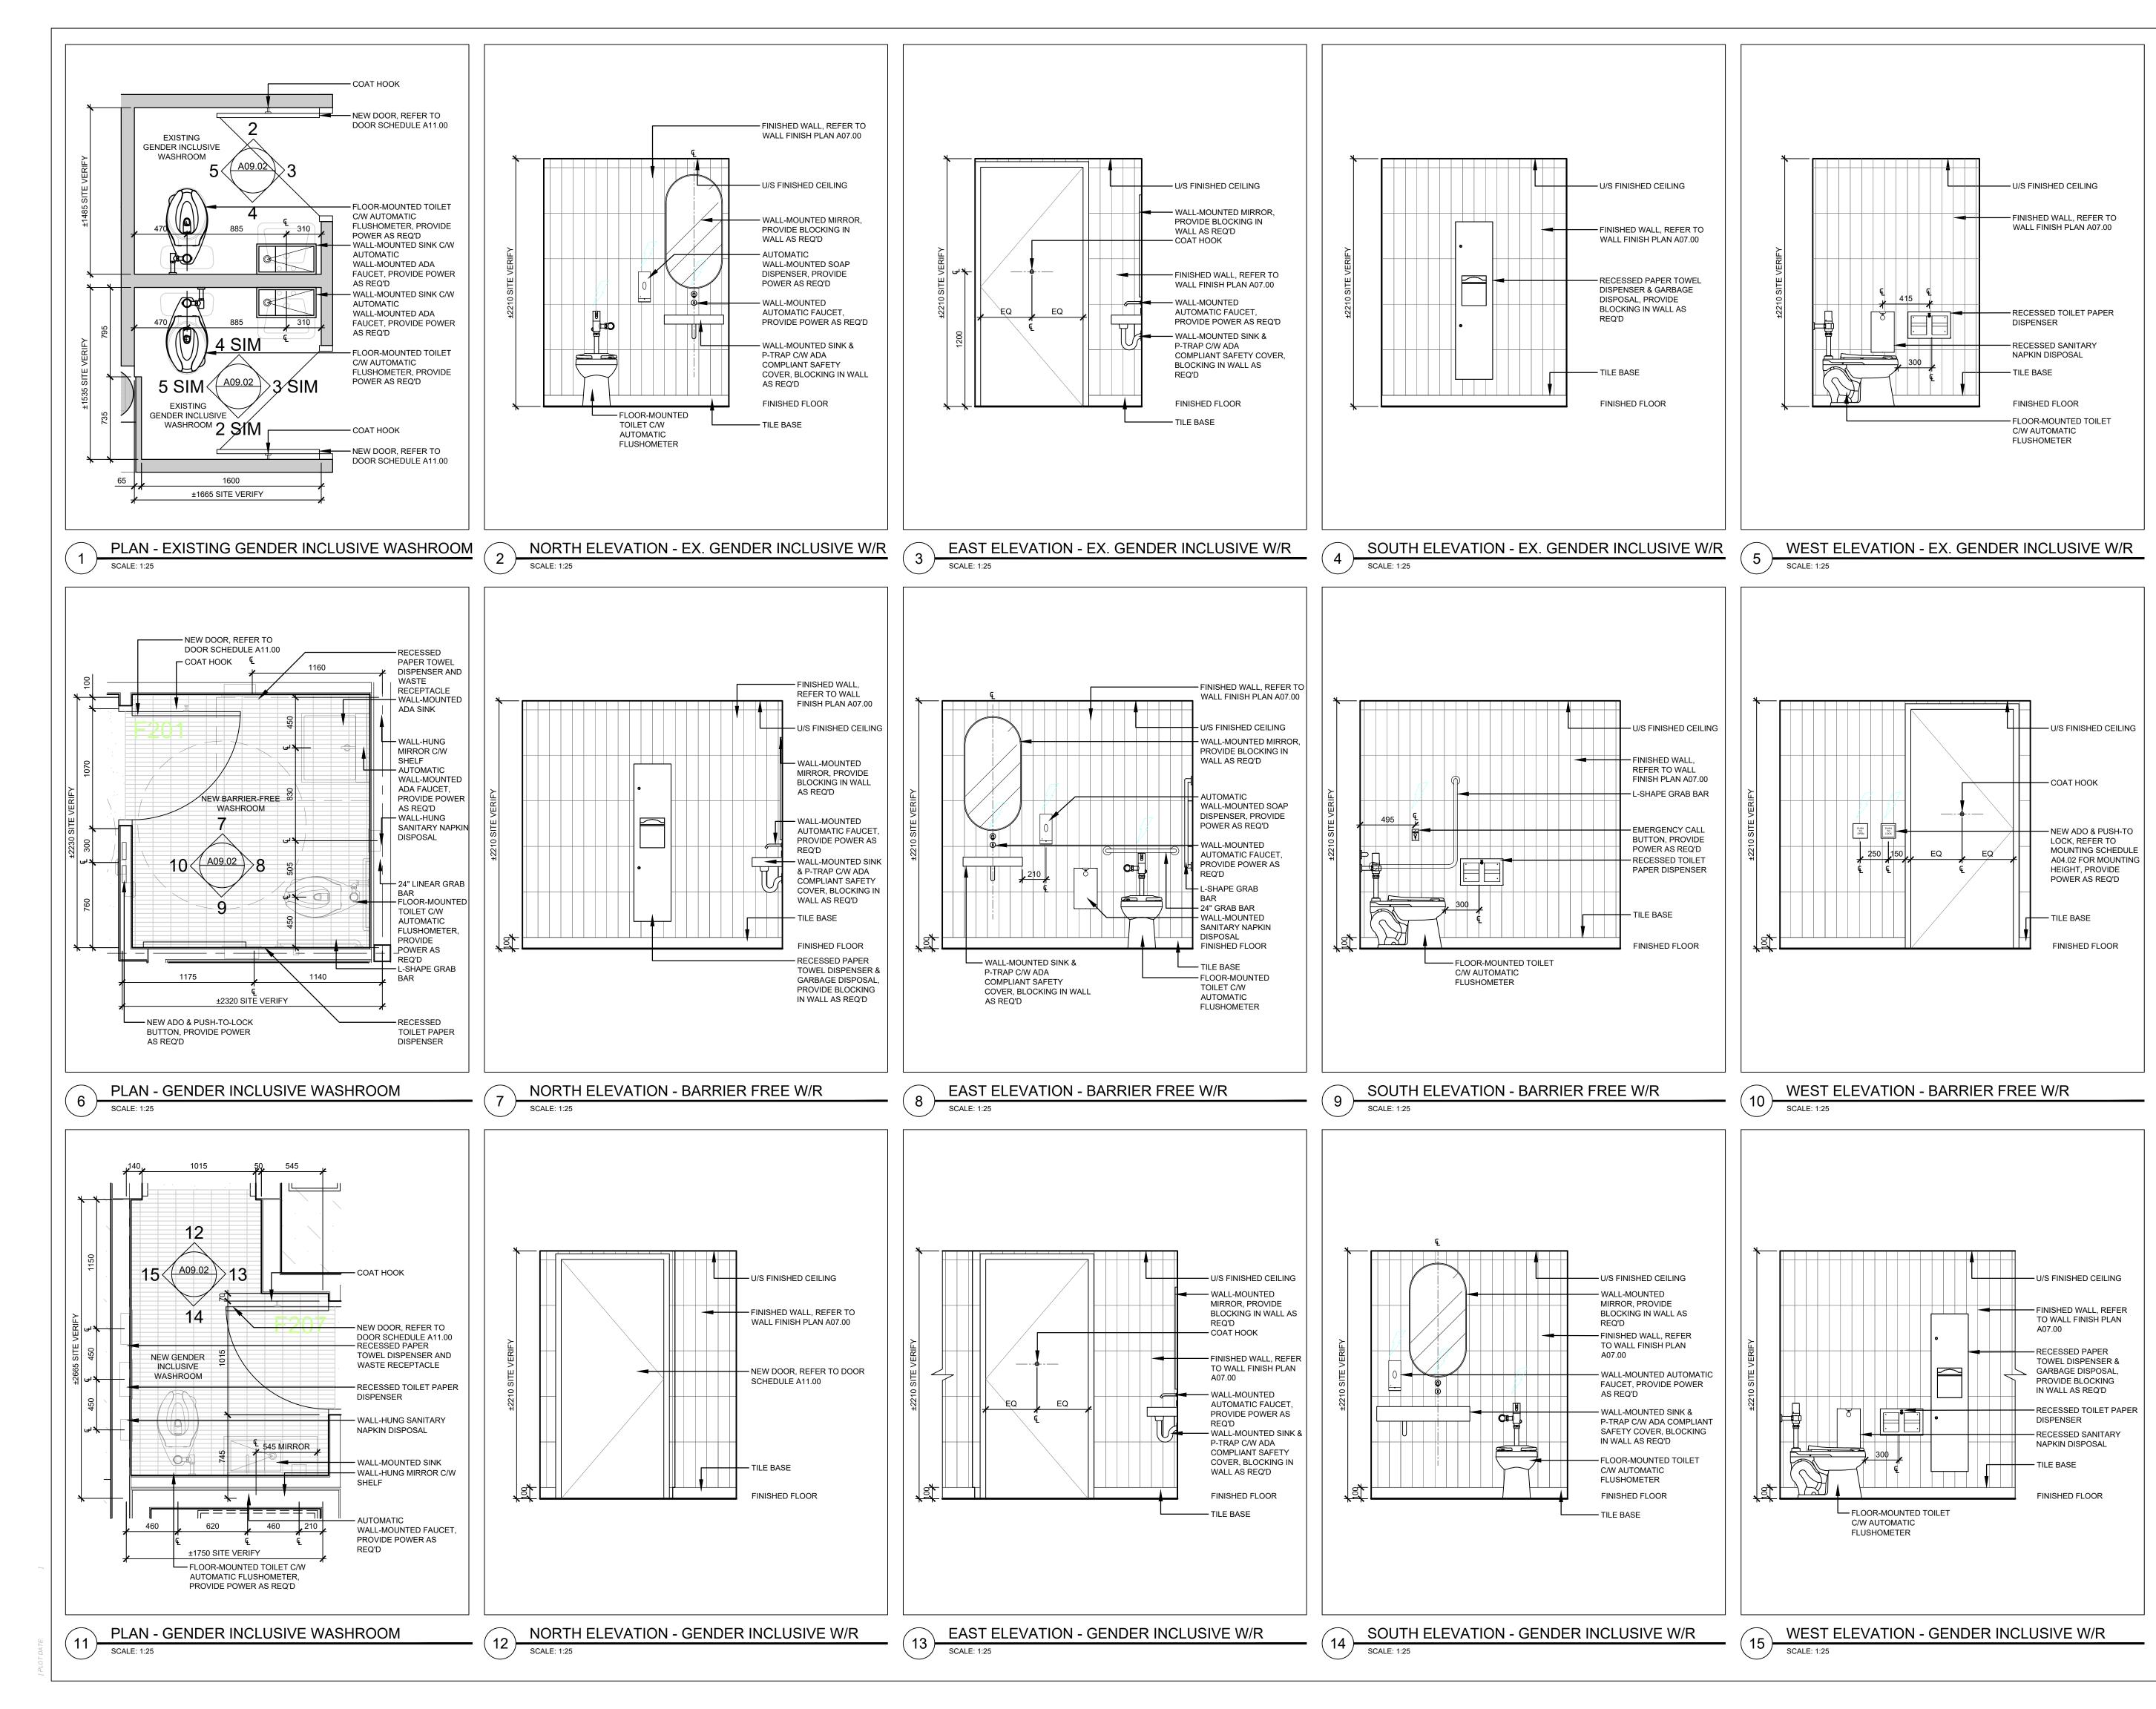




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WASHROOM DETAILS





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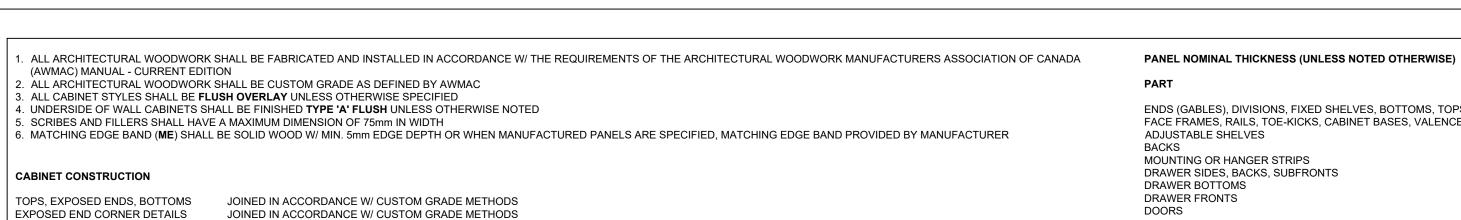
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WASHROOM DETAILS

ISSUE DATE: 2023.09.06 CHECKED BY: SL DRAWN BY: AW PROJECT NO.: 12228 SCALE: DRAWING NO.: REVISION:



JOINED IN ACCORDANCE W/ CUSTOM GRADE METHODS

JOINED IN ACCORDANCE W/ CUSTOM GRADE METHODS

JOINED IN ACCORDANCE W/ CUSTOM GRADE METHODS

CABINET BACKS (FLOOR STANDING) JOINED IN ACCORDANCE W/ CUSTOM GRADE METHODS

BACKSPLASH

CABINET BODY

CABINET FACES

CABINET PULLS

COUNTER TOP

EXPOSED PARTS

CONCEALED SURFACES

SEMI-EXPOSED PARTS

2. SEMI-EXPOSED PARTS SHALL BE FINISHED ON VISIBLE SIDES W/ MATCHING EDGE BAND AS INDICATED

3. ENDS AND TOE-KICKS SHALL BE TREATED AS EXPOSED SURFACES WHEN VISIBLE AFTER INSTALLATION

MATCHING EDGE BAND (ALL SIDES)

TOE KICK (LOWER CABINETS ONLY)

VALENCE (UPPER CABINETS ONLY)

MATCHING EDGE BAND (EXPOSED SIDES)

I. EXPOSED PARTS SHALL BE FINISHED ON BOTH SIDES OF PANELS W/ LIKE MATERIALS AND MATCHING EDGE BAND AS INDICATED

4. WHERE PANEL EDGES ABUT EXPOSED PARTS, EDGE BAND SHALL MATCH EXPOSED PART MATERIAL. CONCEALED PARTS CAN REMAIN IN MILL FINISH

MATERIAL THICKNESS ENDS (GABLES), DIVISIONS, FIXED SHELVES, BOTTOMS, TOPS PLYWOOD 19mm FACE FRAMES, RAILS, TOE-KICKS, CABINET BASES, VALENCES PLYWOOD 19mm ADJUSTABLE SHELVES PARTICLE BOARD 19mm 6.4mm 12.7mm HARDBOARD MOUNTING OR HANGER STRIPS PLYWOOD DRAWER SIDES, BACKS, SUBFRONTS MDF 12.7mm DRAWER BOTTOMS 12.7mm PLYWOOD 19mm DRAWER FRONTS PLYWOOD DOORS PLYWOOD 19mm

MILLWORK PANEL SCHEDULE

DOOR AND DRAWER HANDLE SCHEDULE

NAME

RICHELIEU CONTEMPORARY METAL PULL 2288, MATTE BLACK, 110MM (4" C2C)

FINISHES

ST-01

PLM-01

HPL-01 HIGH-PRESSURE LAMINATE SPEC HPL-02 HIGH-PRESSURE LAMINATE SPEC THERMALLY FUSED LAMINATE SPEC TFL-02 THERMALLY FUSED LAMINATE SPEC MTL-01 METAL SPEC

SUPPLY AND INSTALL HARDWARE AS FOLLOWS:

STONE SPEC

ALL HARDWARE SHALL BE IN ACCORDANCE W/ CUSTOM GRADE AS DEFINED BY AWMAC CONCEALED HEAVY-DUTY SELF-CLOSING HINGES THROUGHOUT


ALL DRAWERS ON HEAVY-DUTY TELESCOPING CUSHIONED ROLLING METAL SLIDES PINS & FERRULES STANDARD C/W NUMBER REQUIRED

PROVIDE KEY LOCKS WHERE INDICATED, EACH LOCK SHALL BE UNIQUE UNLESS OTHERWISE

ALL MILLWORK HARDWARE SUPPLIED AND INSTALLED UNDER MILLWORK CONTRACT

NOTATION ON DRAWINGS

CF: (MATERIAL) CB: (MATERIAL) TK or VA: (MATERIAL) CP: (HANDLE)

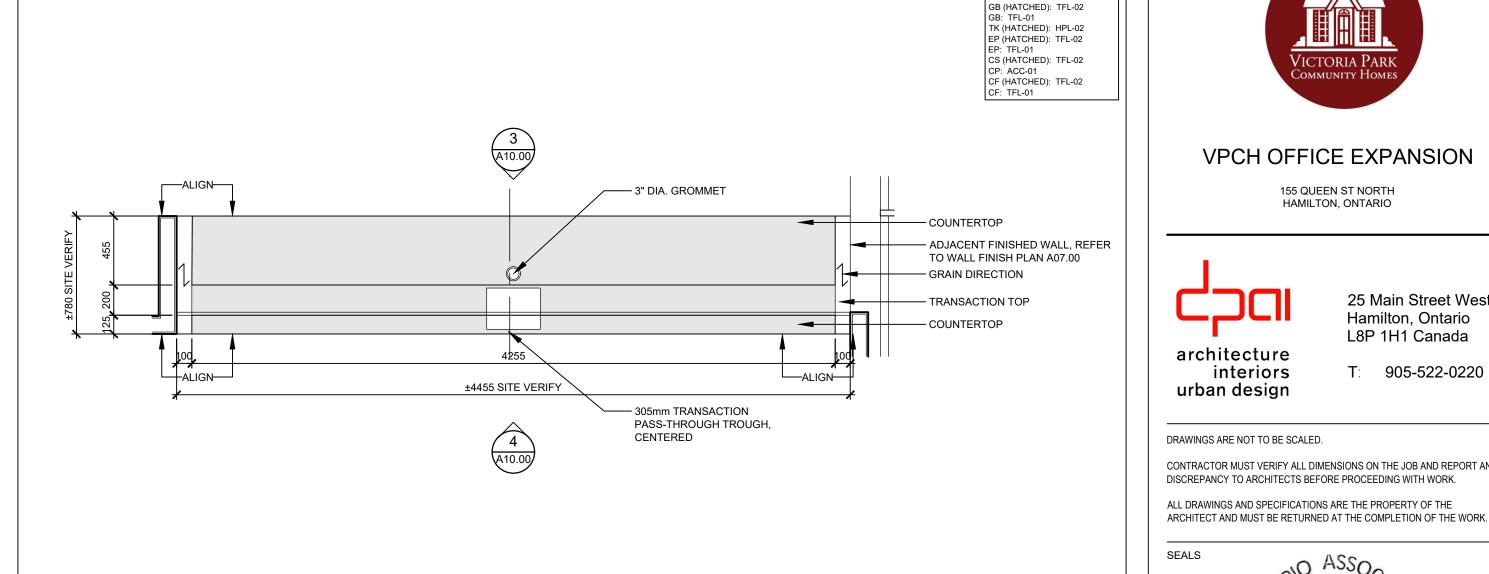



ON DETAIL DRAWINGS, THE FOLLOWING PARTS ARE INDICATED BY PATTERNS:

FACE FRAME ATTACHMENT

DRAWER CONSTRUCTION

FRONTS, SIDES, BOTTOMS

ABBREVIATIONS

ME(AS)

ME(ES) SEP

MILLWORK LEGEND


EP - EXPOSED PARTS


SEP - SEMI-EXPOSED PARTS

CS - CONCEALED SURFACES

CABINET BACKS (WALL-HUNG)


PLAN - MW-01 RECEPTION DESK SCALE: N/A

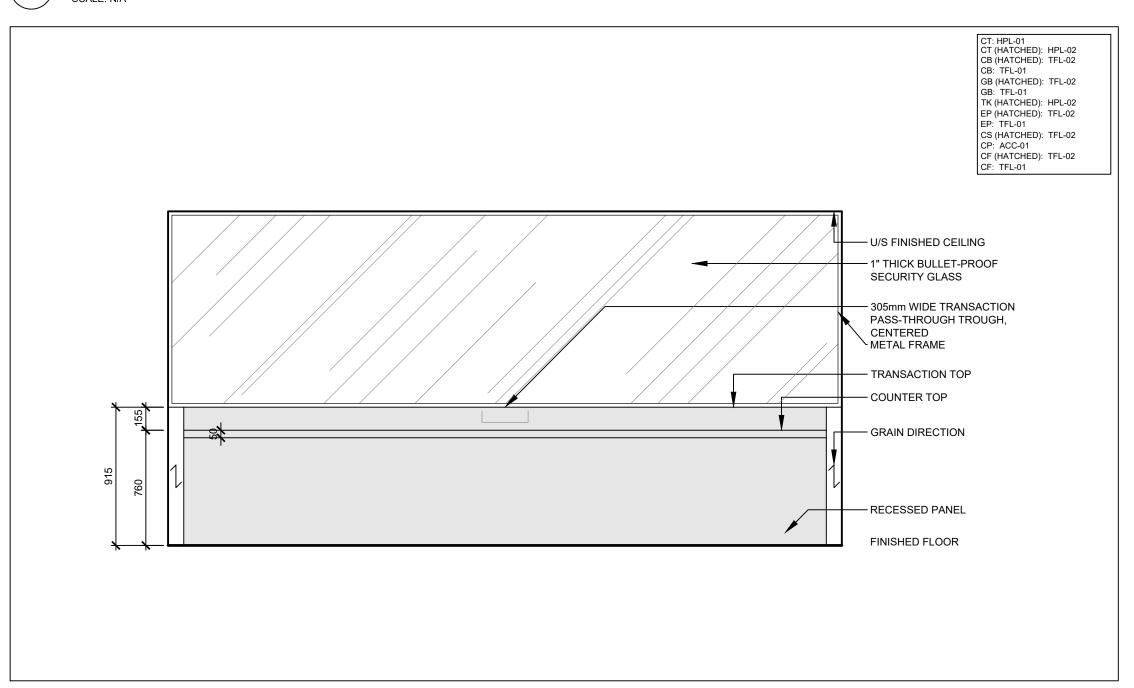


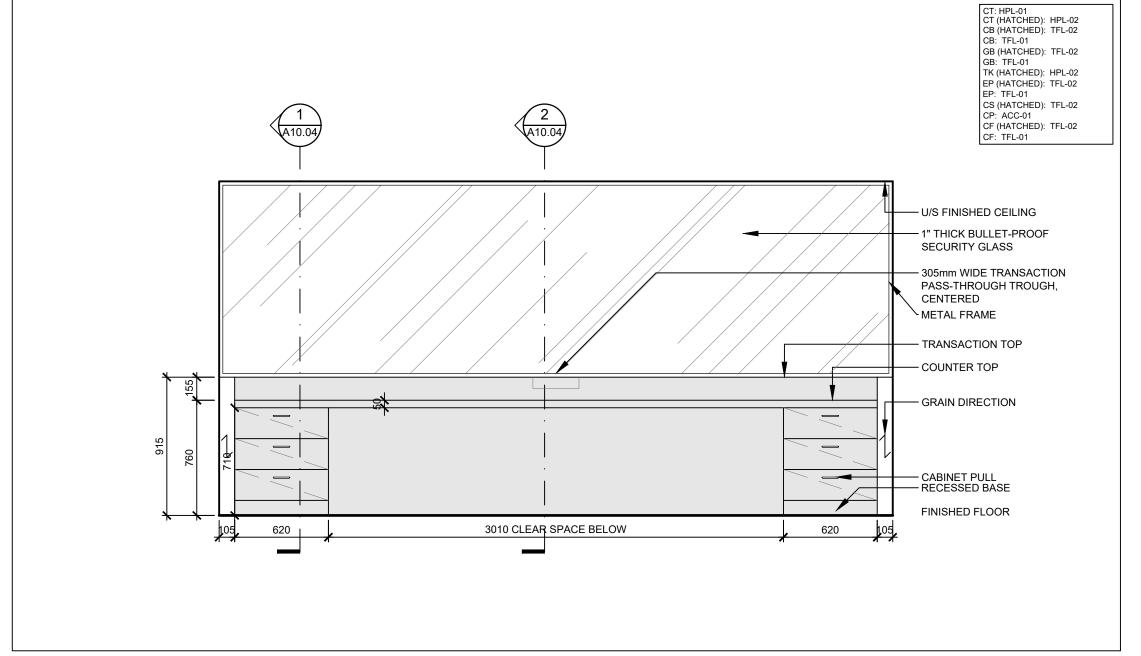

ELEVATION - MW-01 RECEPTION DESK SCALE: N/A

ELEVATION - MW-01 RECEPTION DESK SCALE: N/A

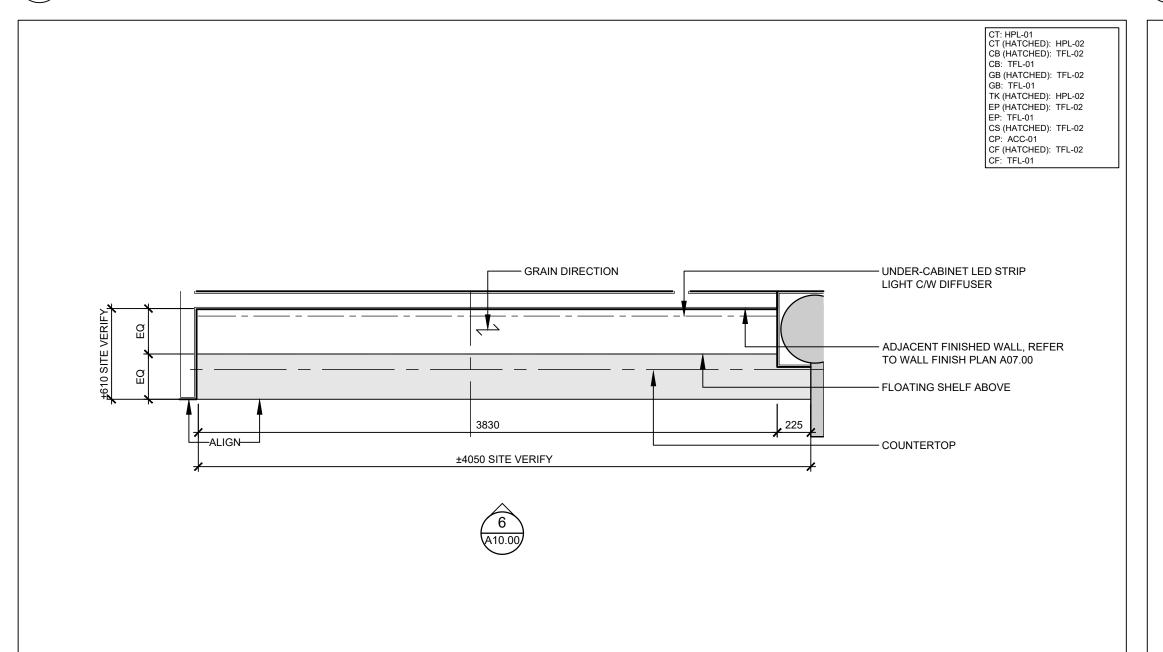

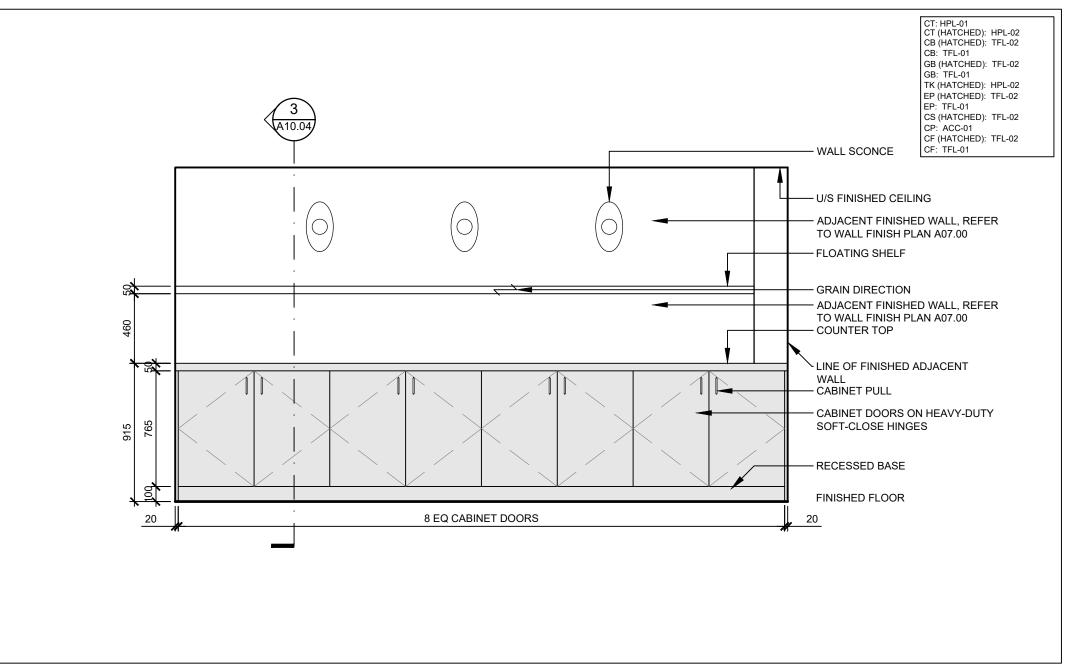

ELEVATION - MW-02 RECEPTION STORAGE



VPCH OFFICE EXPANSION

155 QUEEN ST NORTH HAMILTON, ONTARIO



urban design

CT: HPL-01 CT (HATCHED): HPL-02 CB (HATCHED): TFL-02 CB: TFL-01

25 Main Street West Hamilton, Ontario L8P 1H1 Canada

T: 905-522-0220

DRAWINGS ARE NOT TO BE SCALED.


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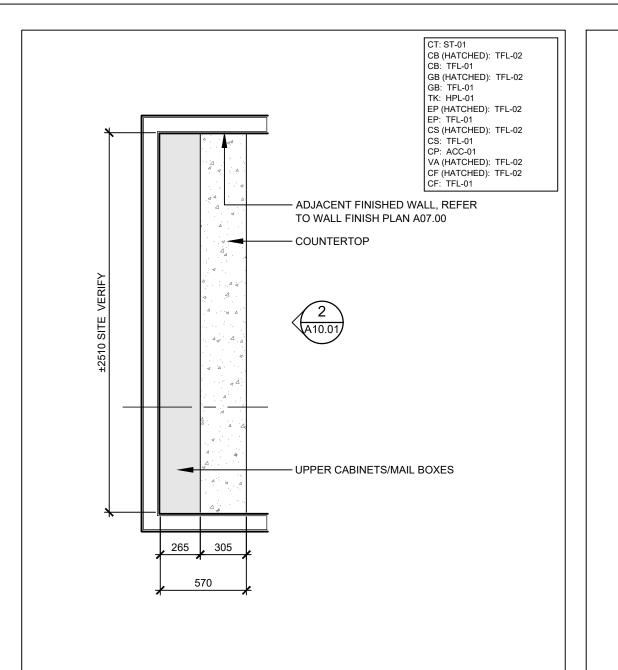
ISSUED FOR TENDER	2023.09.06
ISSUED FOR PERMIT	2023.05.16
ISSUES/REVISIONS	DATE
	ISSUED FOR PERMIT

MILLWORK DETAILS

DRAWING TITLE:




PLAN - MW-02 RECEPTION STORAGE

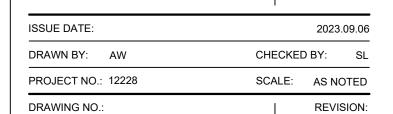


PLAN - MW-03 PRINT ROOM STORAGE

ELEVATION - MW-04 PRINT ROOM STORAGE

SCALE: 1:25

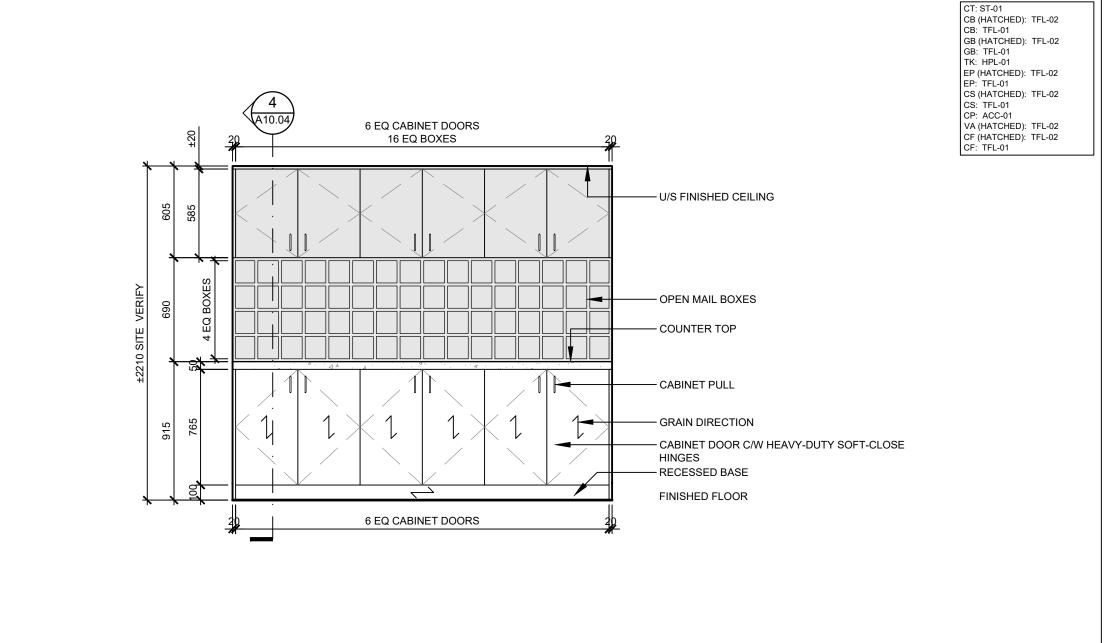

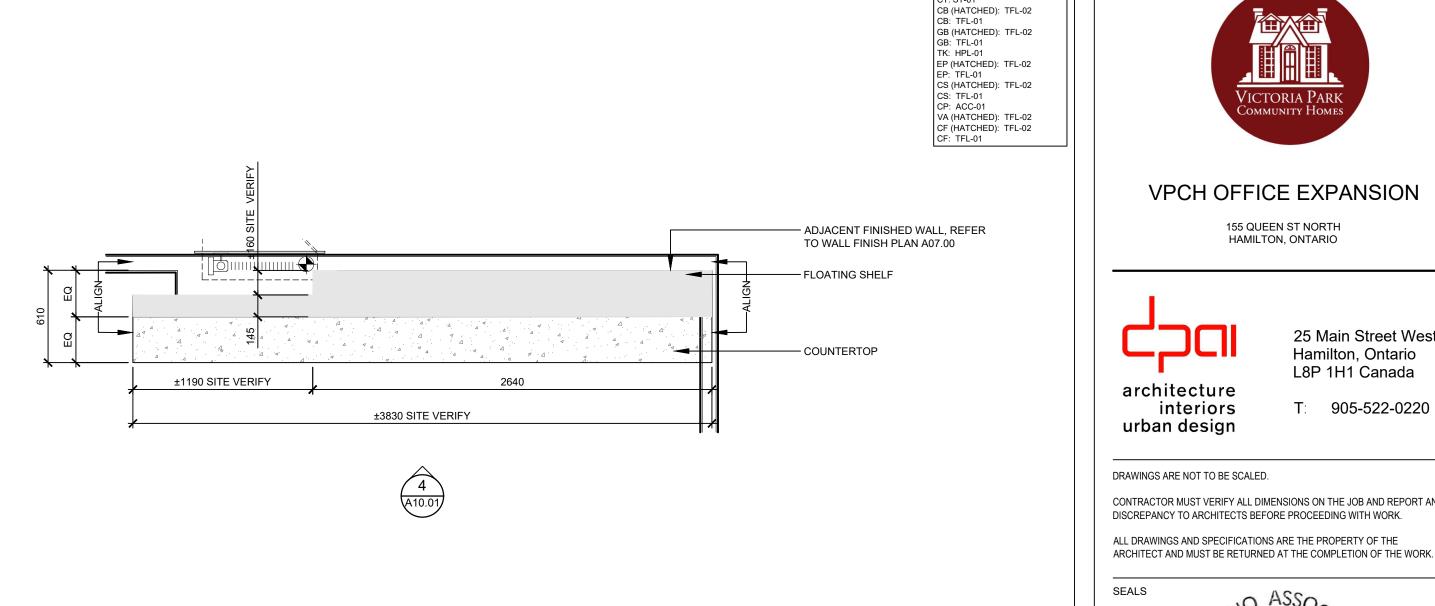

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SEALS

LICENCE



ELELVATION - MW-03 PRINT ROOM STORAGE
SCALE: 1:25

- U/S FINISHED CEILING


PLAN A07.00 - COUNTER TOP

— CABINET PULL

GRAIN DIRECTION


HINGES — RECESSED BASE FINISHED FLOOR


CB (HATCHED): TFL-02 CB: TFL-01 GB (HATCHED): TFL-02 TK: HPL-01 EP (HATCHED): TFL-02 EP: TFL-01 CS (HATCHED): TFL-02 CS: TFL-01 CP: ACC-01 VA (HATCHED): TFL-02 CF (HATCHED): TFL-02 CF: TFL-01 — ADJACENT WALL, REFER TO WALL FINISH - CABINET DOOR C/W HEAVY-DUTY SOFT-CLOSE

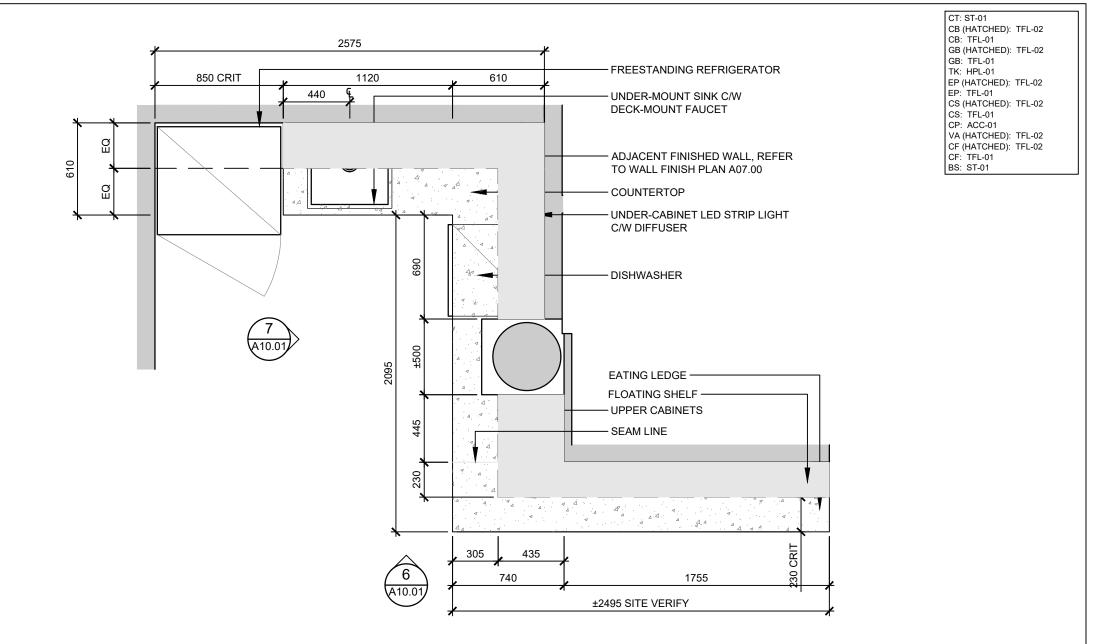

PLAN - MW-04 PRINT ROOM STORAGE

PLAN - MW-05 CAFE MILLWORK

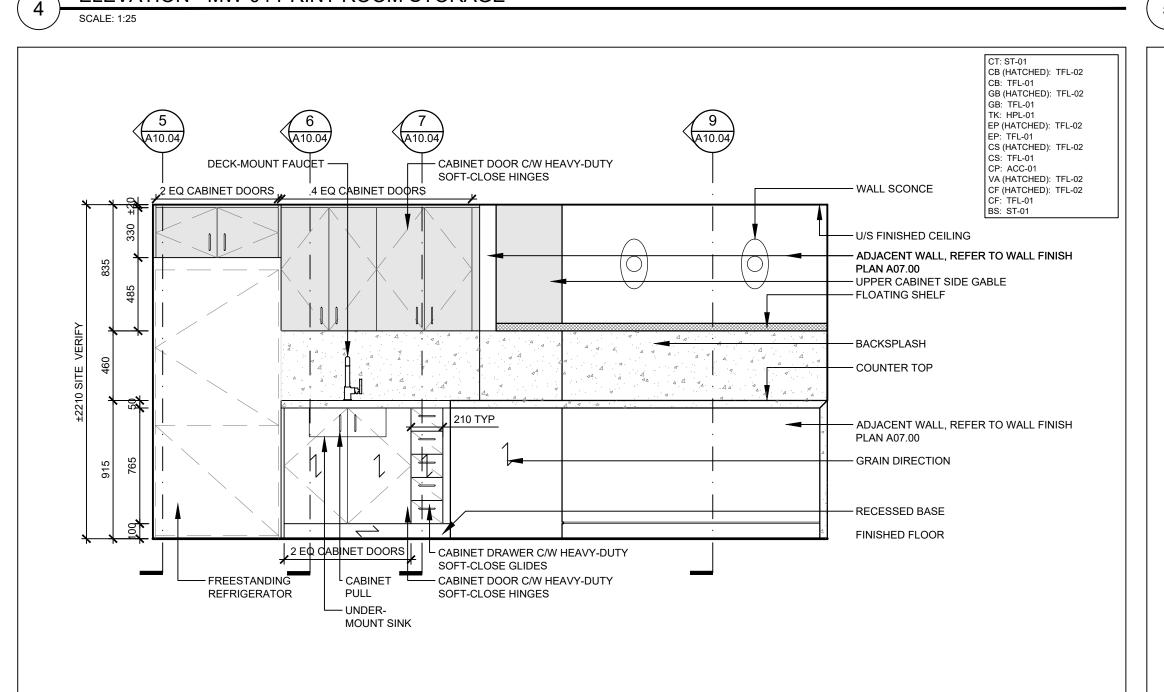

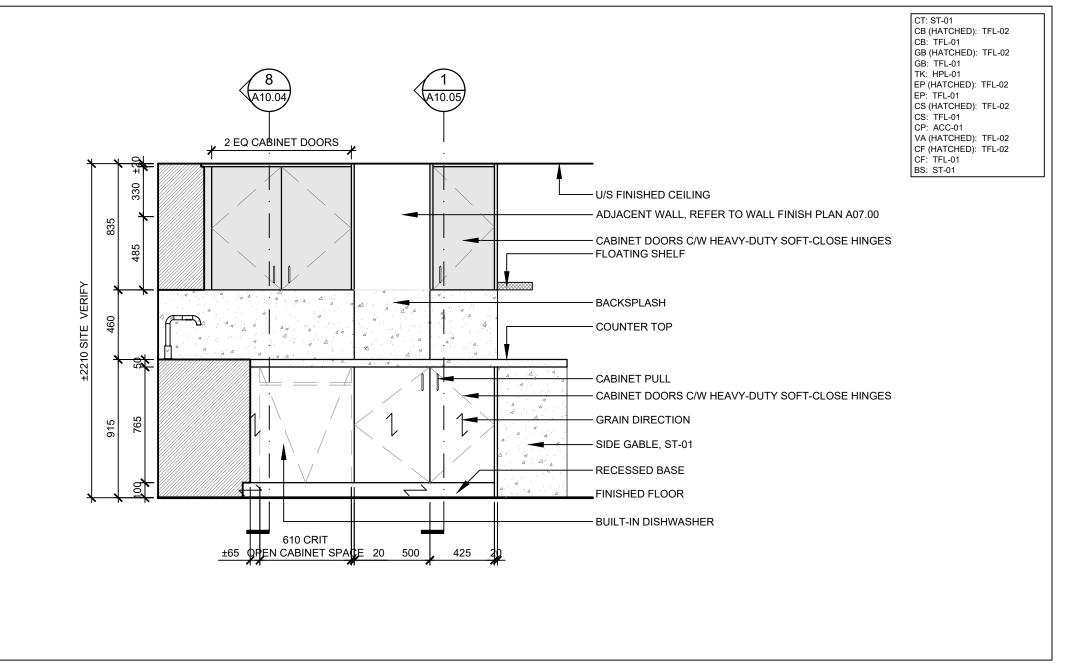

ELEVATION - MW-05 CAFE MILLWORK

MILLWORK DETAILS

ISSUED FOR TENDER

ISSUED FOR PERMIT

NO. ISSUES/REVISIONS

DRAWING TITLE:


2023.09.06

2023.05.16

DATE


ISSUE DATE: 2023.09.06 DRAWN BY: AW CHECKED BY: SL PROJECT NO.: 12228 SCALE: AS NOTED DRAWING NO.: REVISION:


ELEVAITON - MW-05 CAFE MILLWORK

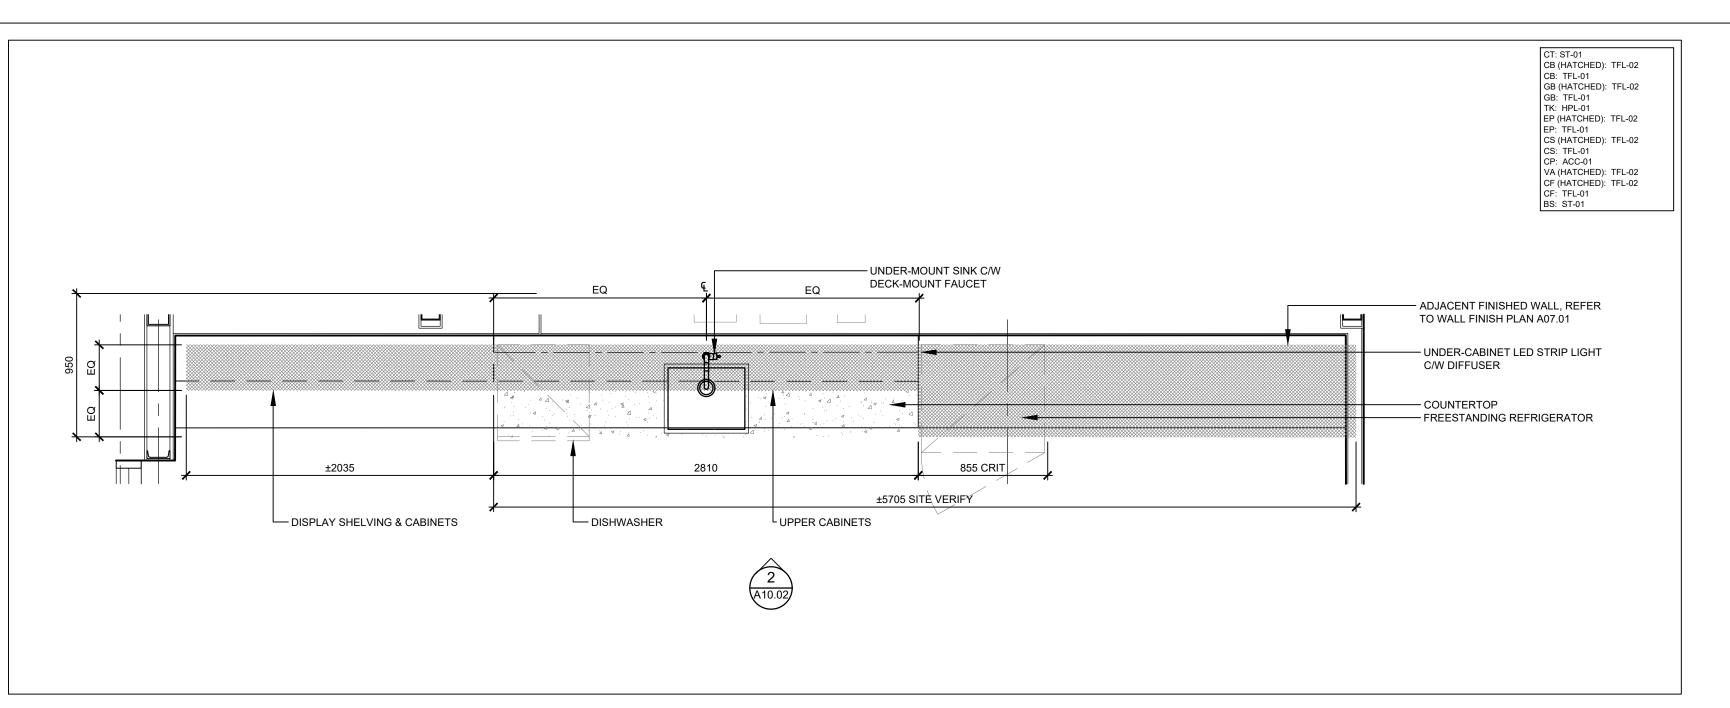

PLAN - MW-06 COFFEE BAR MILLWORK

SCALE: 1:25

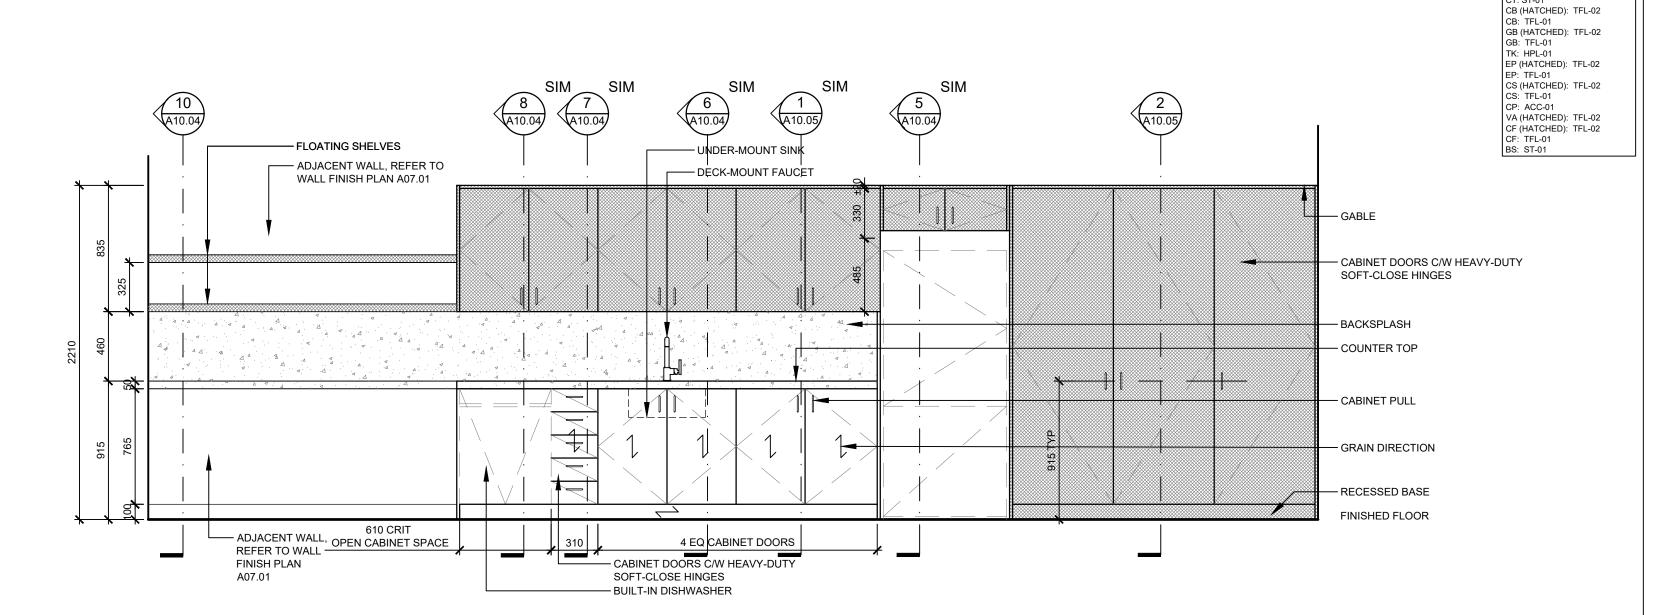

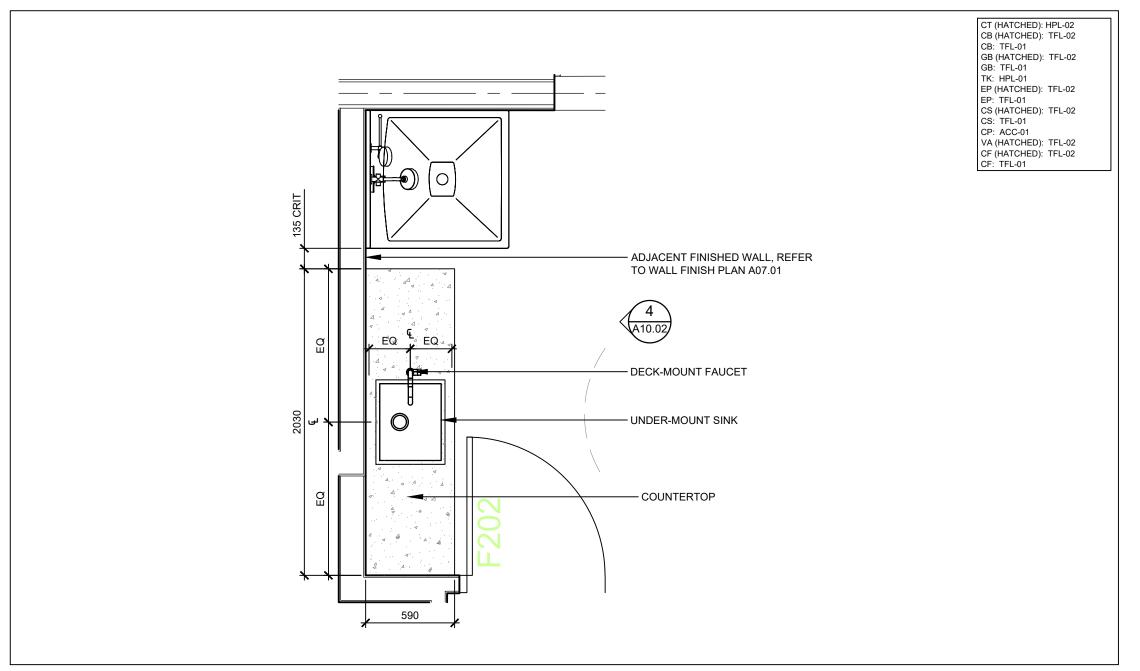



ELEVATION - MW-06 COFFEE BAR MILLWORK

ELEVATION - MW-07 MULTI-PURPOSE RM MILLWORK

SCALE: 1:25

SCALE: 1:25

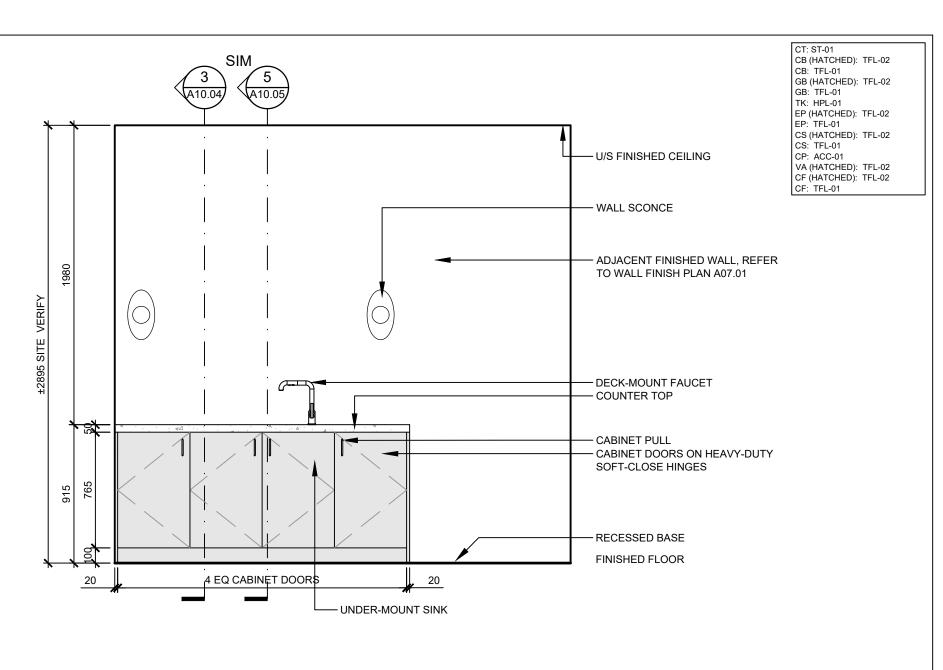

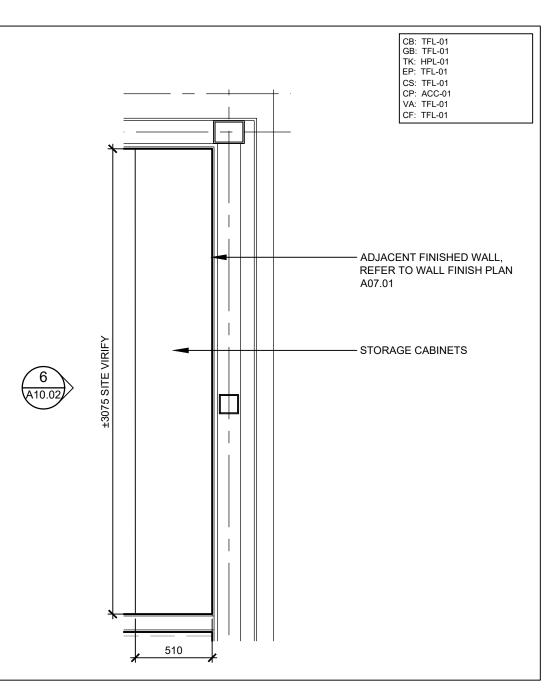

PLAN - MW-08 MULTI-PURPOSE RM STORAGE

PLAN - MW-07 MULI-PURPOSE RM MILLWORK
SCALE: 1:25 CB: TFL-01 GB: TFL-01 TK: HPL-01 EP: TFL-01 CS: TFL-01 CP: ACC-01 VA: TFL-01 CF: TFL-01 4 A10.05 — ADJACENT FINISHED WALL, REFER TO WALL FINISH PLAN A07.01 - CABINET DOORS ON HEAVY-DUTY SOFT-CLOSE HINGES - GRAIN DIRECTION — CABINET PULL — FIXED SHELVES — RECESSED BASE FINISHED FLOOR EQ

ELEVATION - MW-08 MULTI-PURPOSE RM STORAGE

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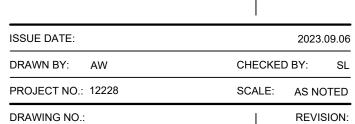
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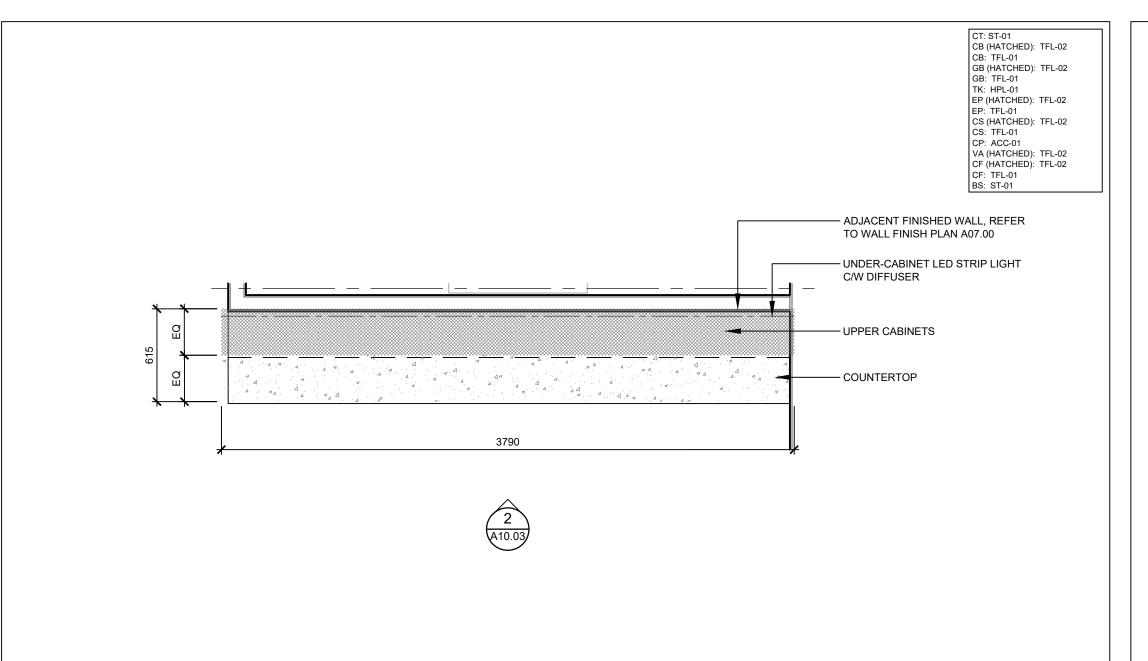
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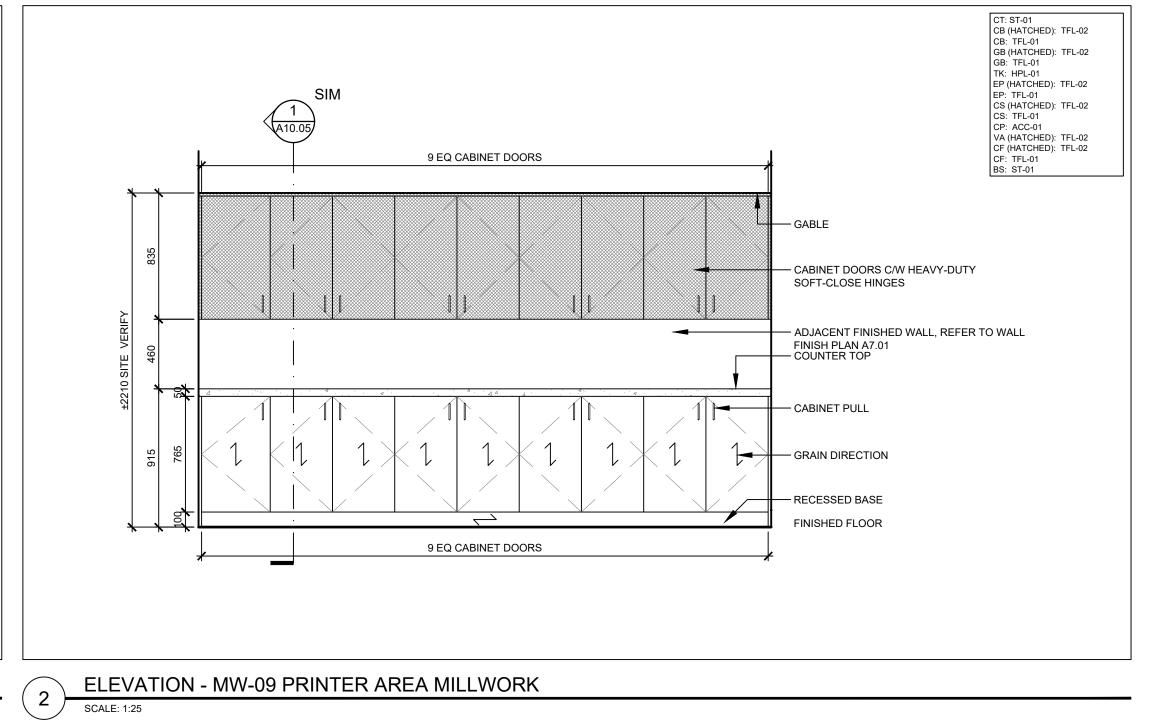


ISSUED FOR TENDER 2023.09.06 ISSUED FOR PERMIT 2023.05.16 ISSUES/REVISIONS DRAWING TITLE:

MILLWORK DETAILS







1 PLAN - MW-09 PRINTER AREA MILLWORK
SCALE: 1:25

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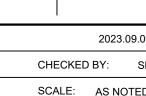
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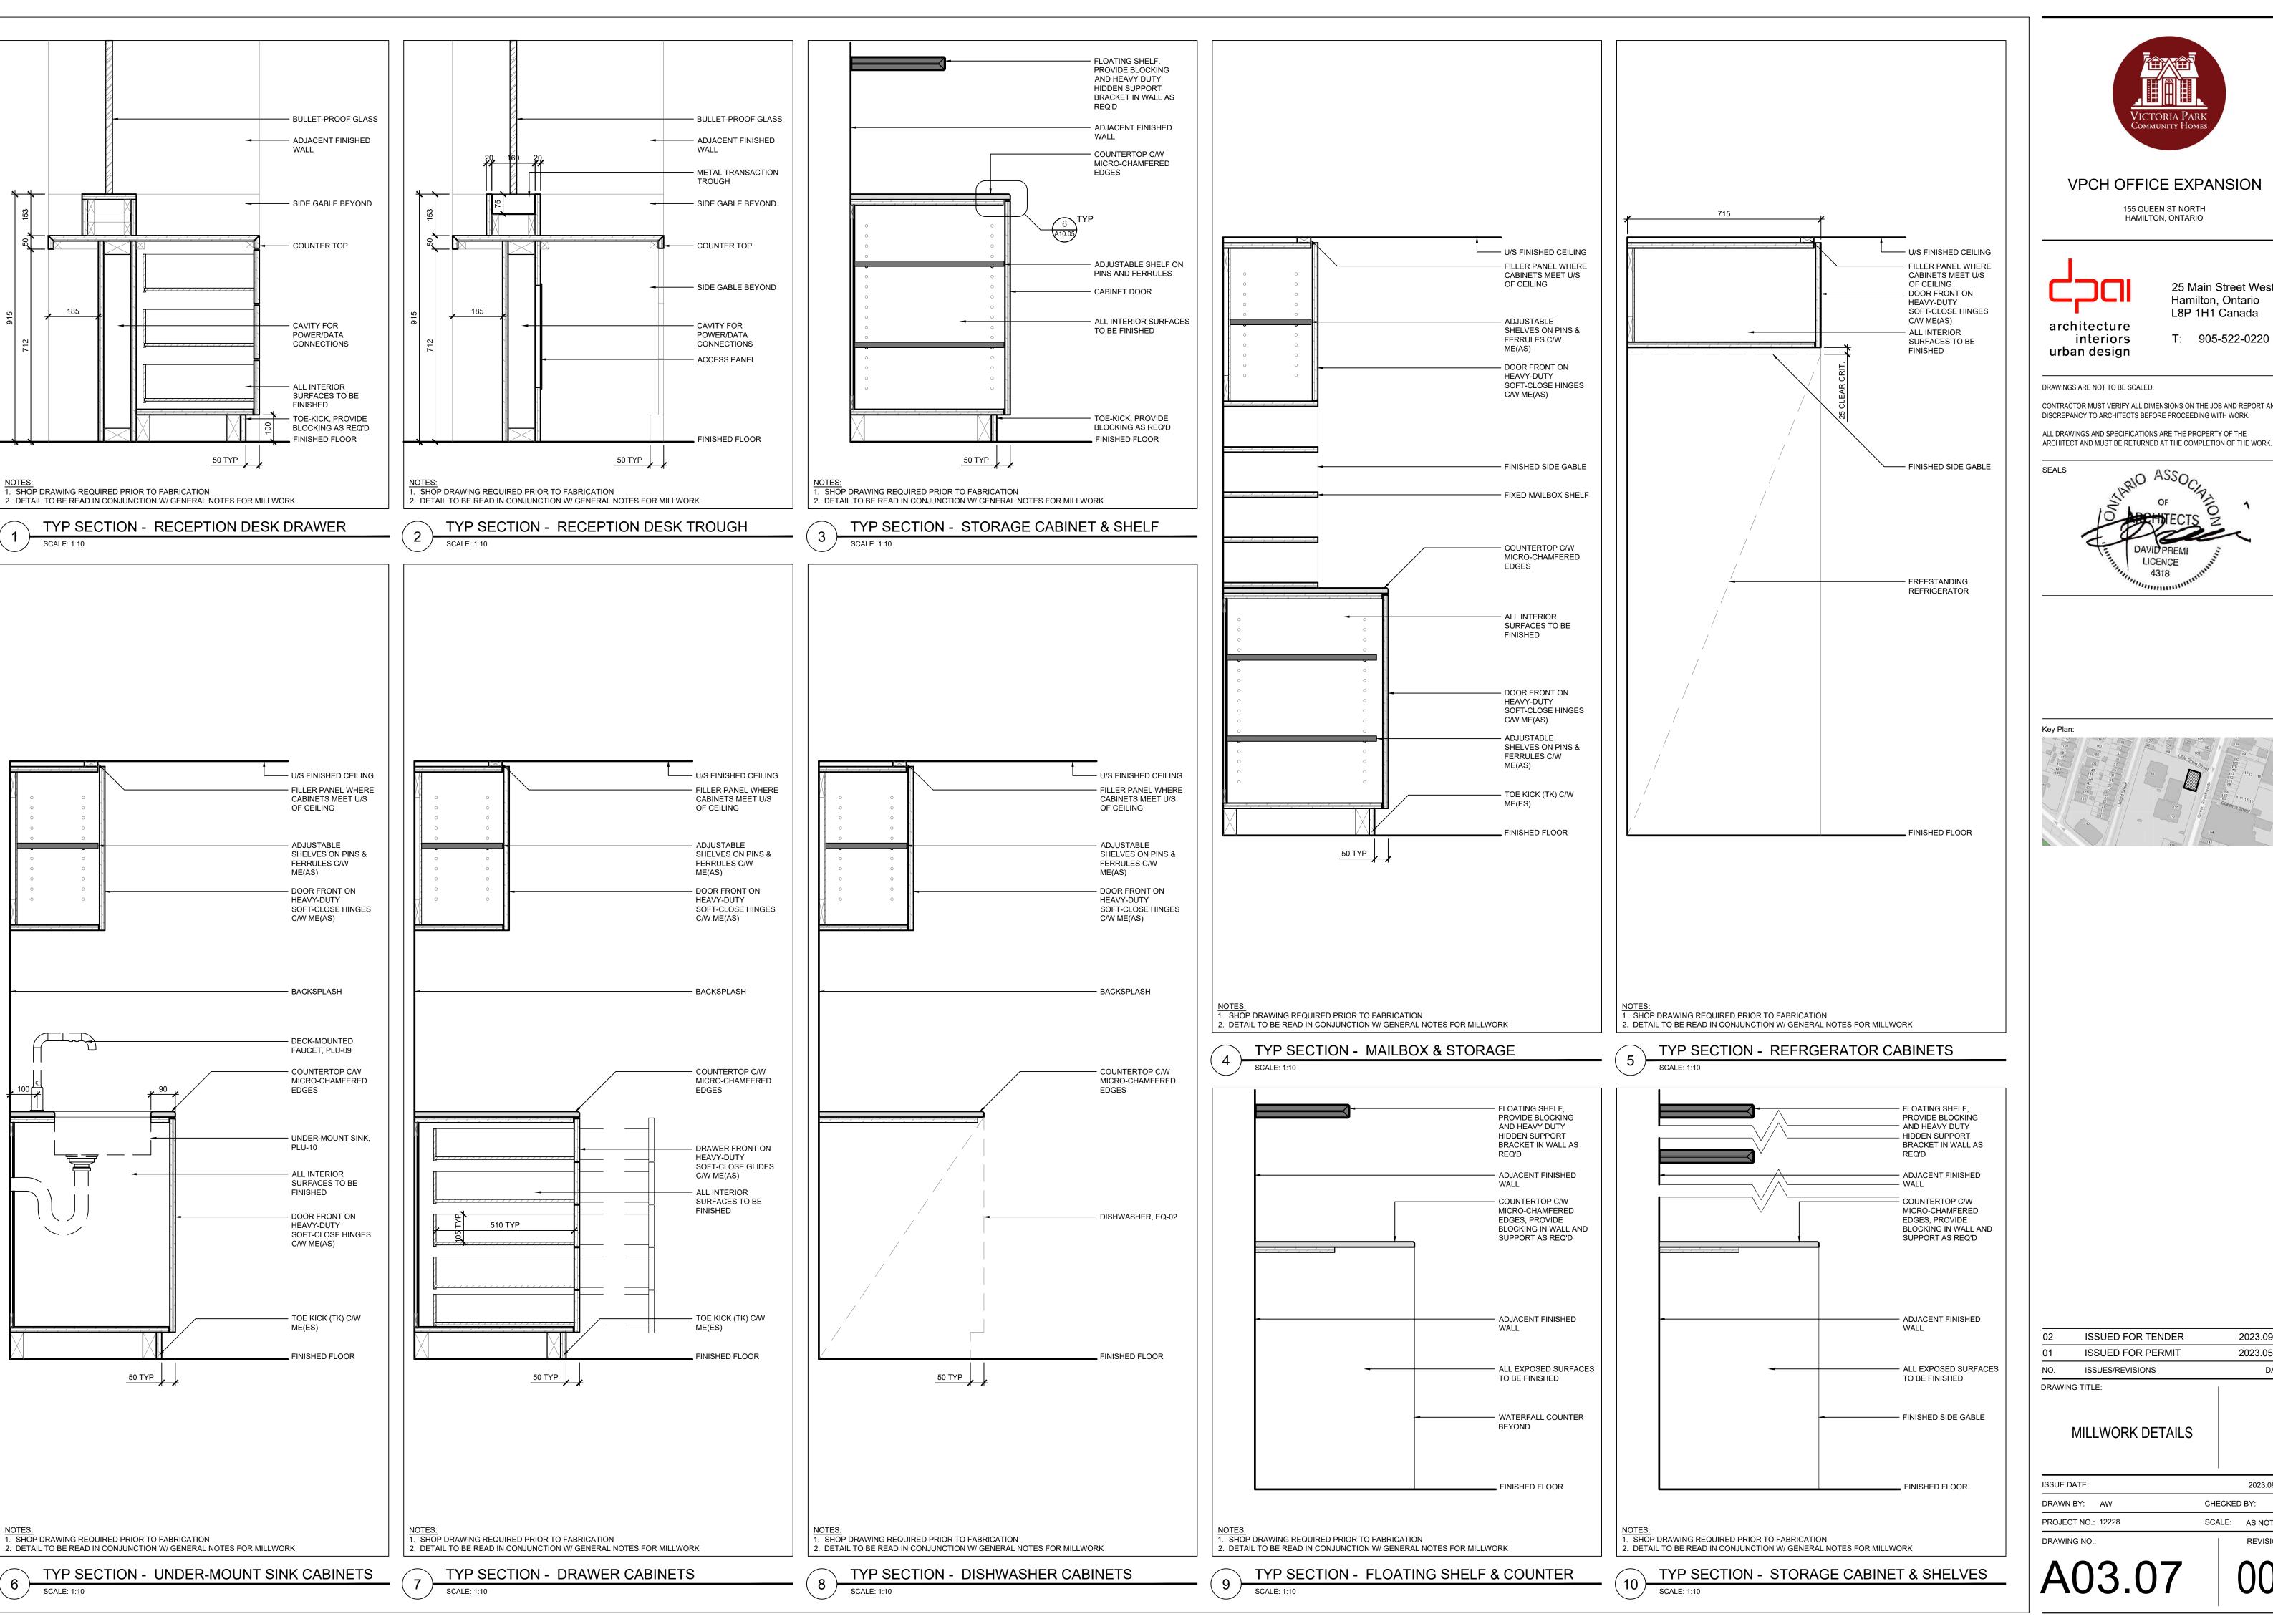
Key Plan:

02	ISSUED FOR TENDER	2023.09.06
01	ISSUED FOR PERMIT	2023.05.16
NO.	ISSUES/REVISIONS	DATE

MILLWORK DETAILS



ISSUE DATE:	2023.09.
DRAWN BY: AW	CHECKED BY:
PROJECT NO.: 12228	SCALE: AS NOTE
DRAWING NO.:	REVISIO



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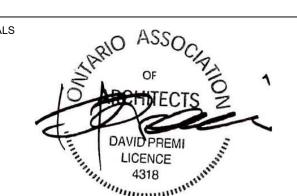


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T: 905-522-0220

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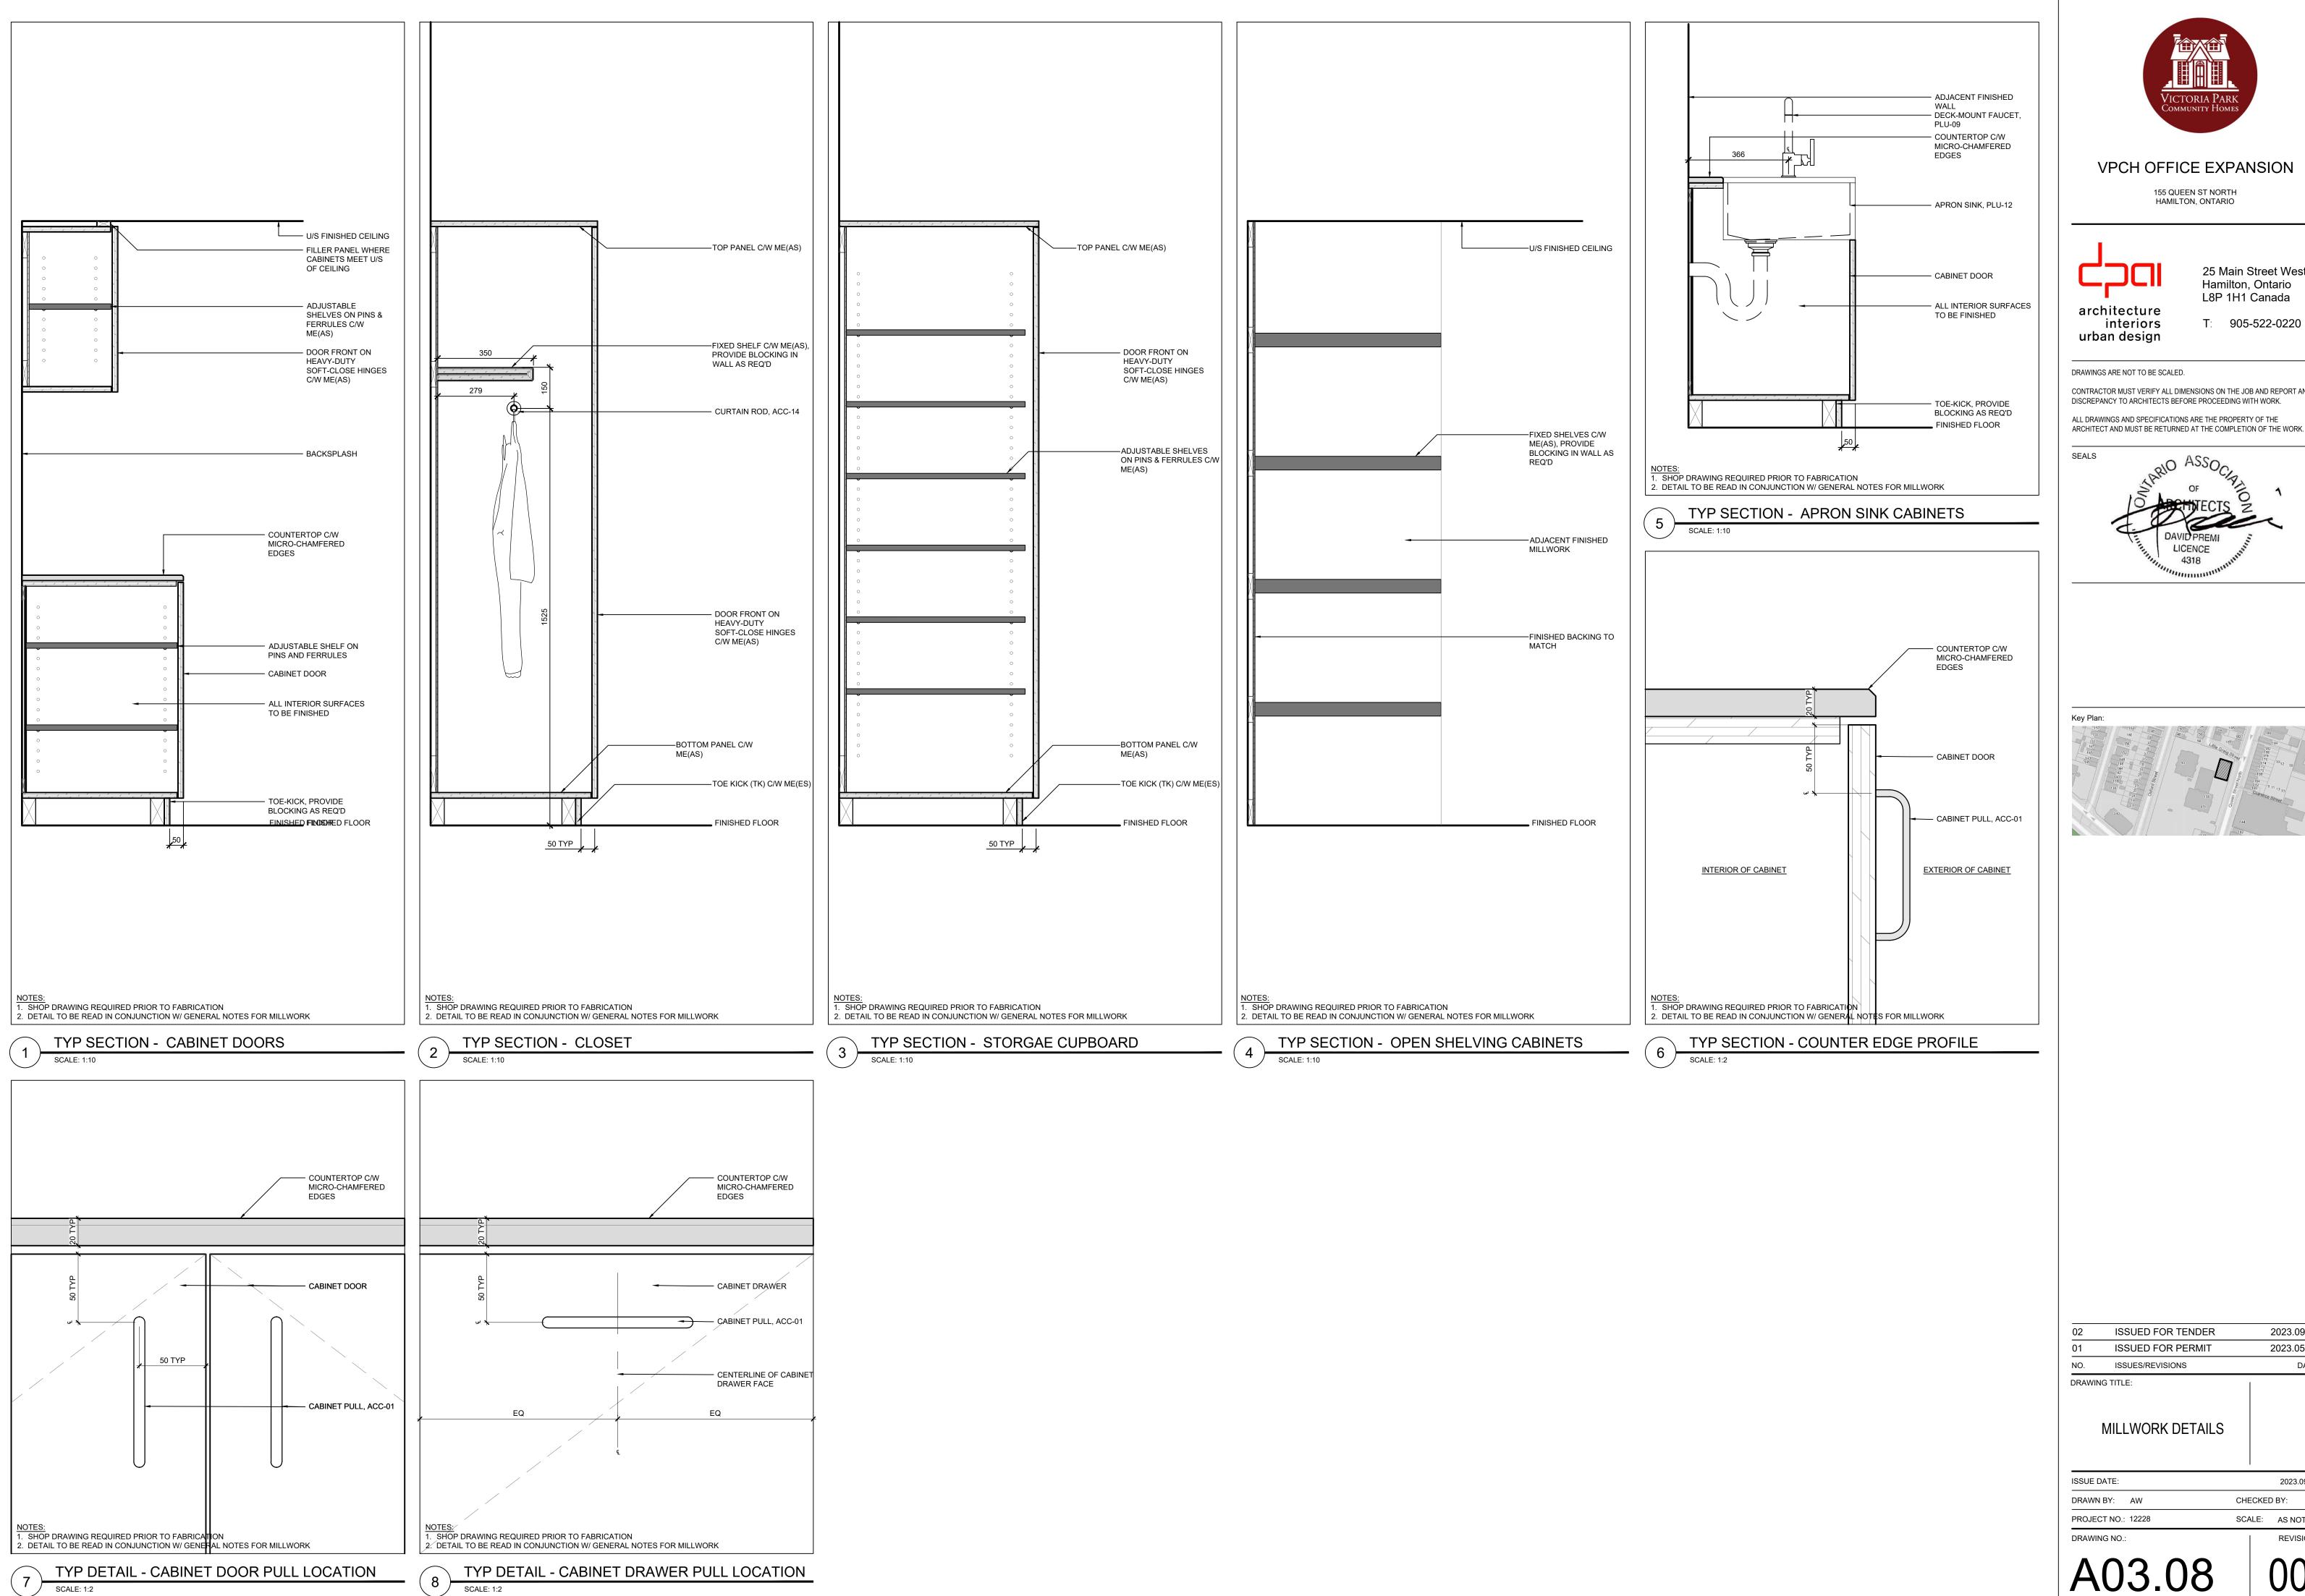
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MILLWORK DETAILS

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PROJECT NO.: 12228	SCALE:	AS NO	TED
DRAWING NO.:		REVIS	ION:





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architecture interiors

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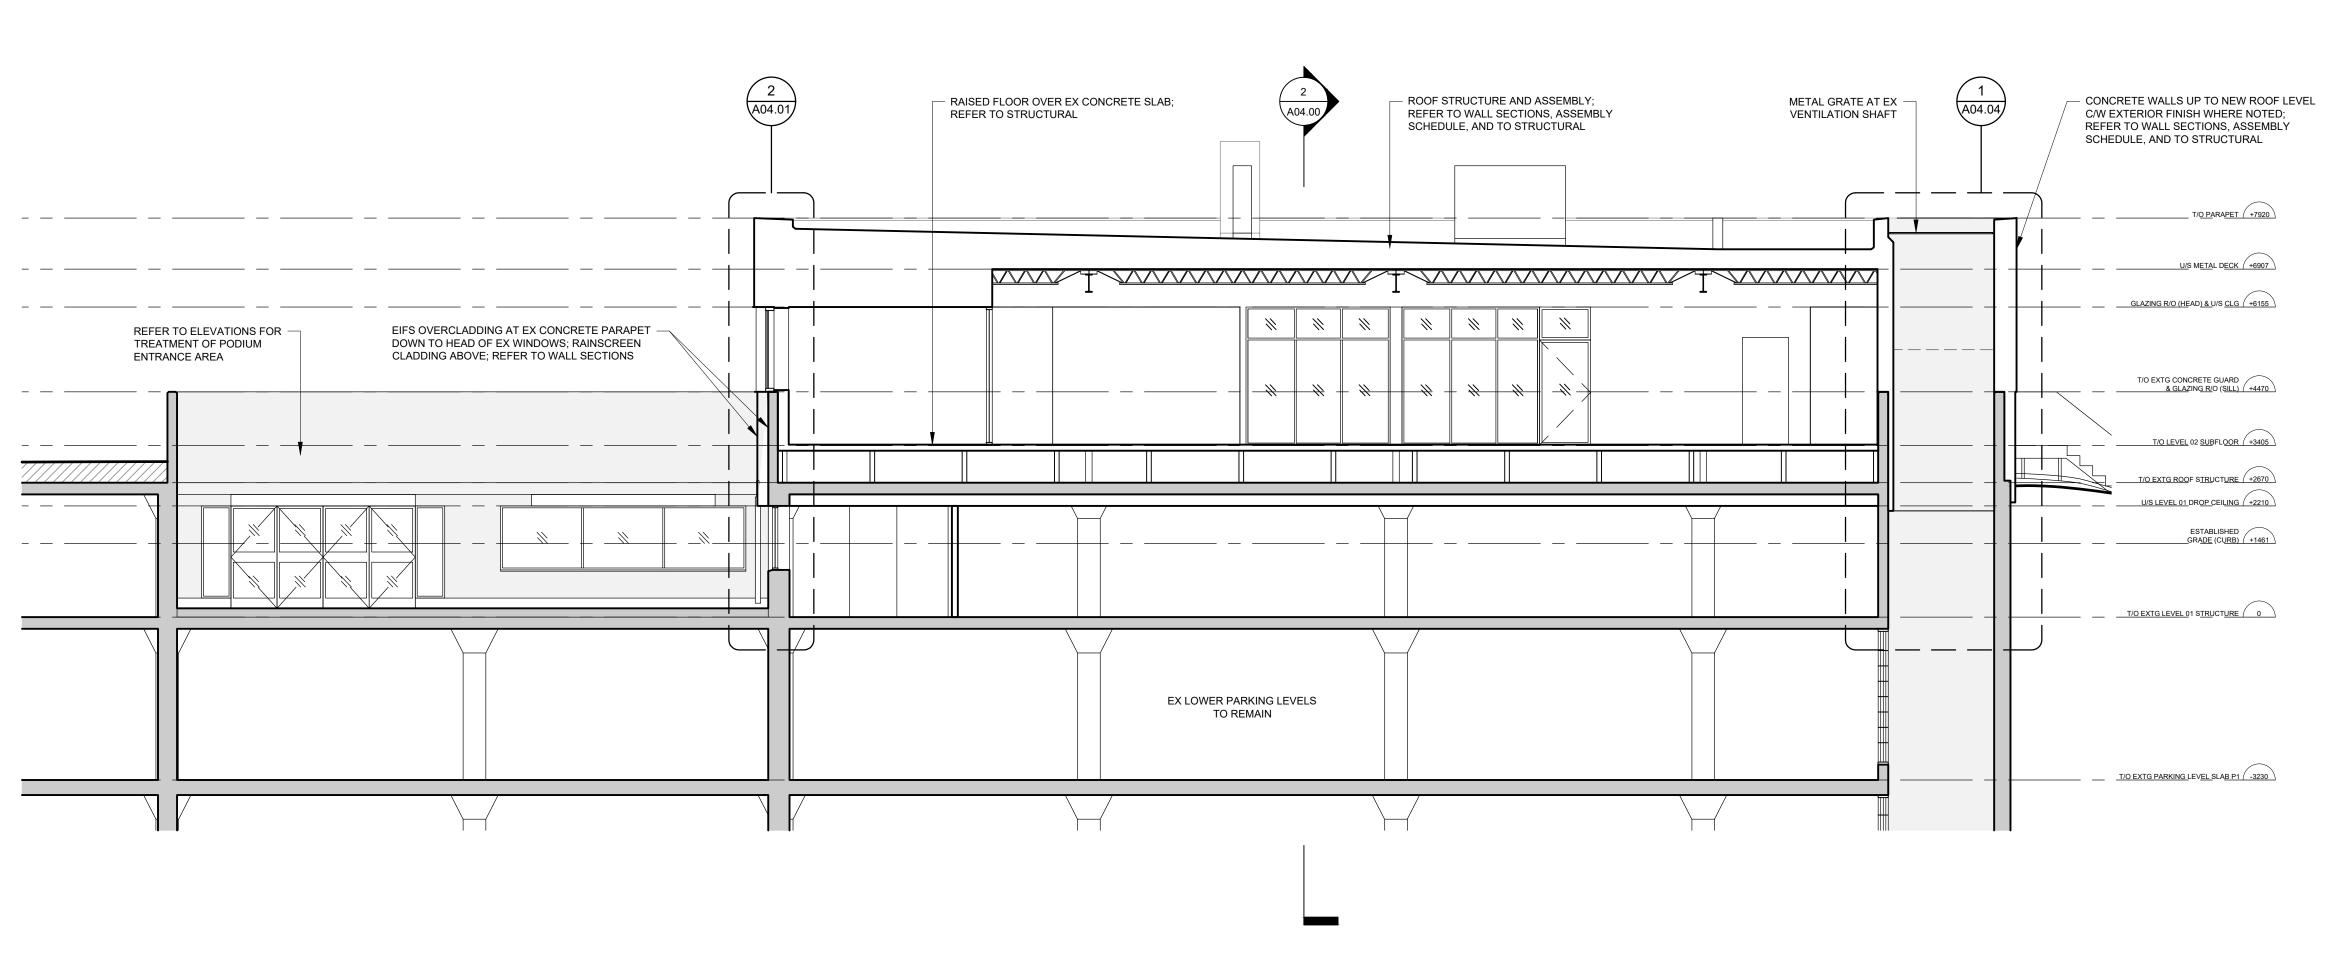
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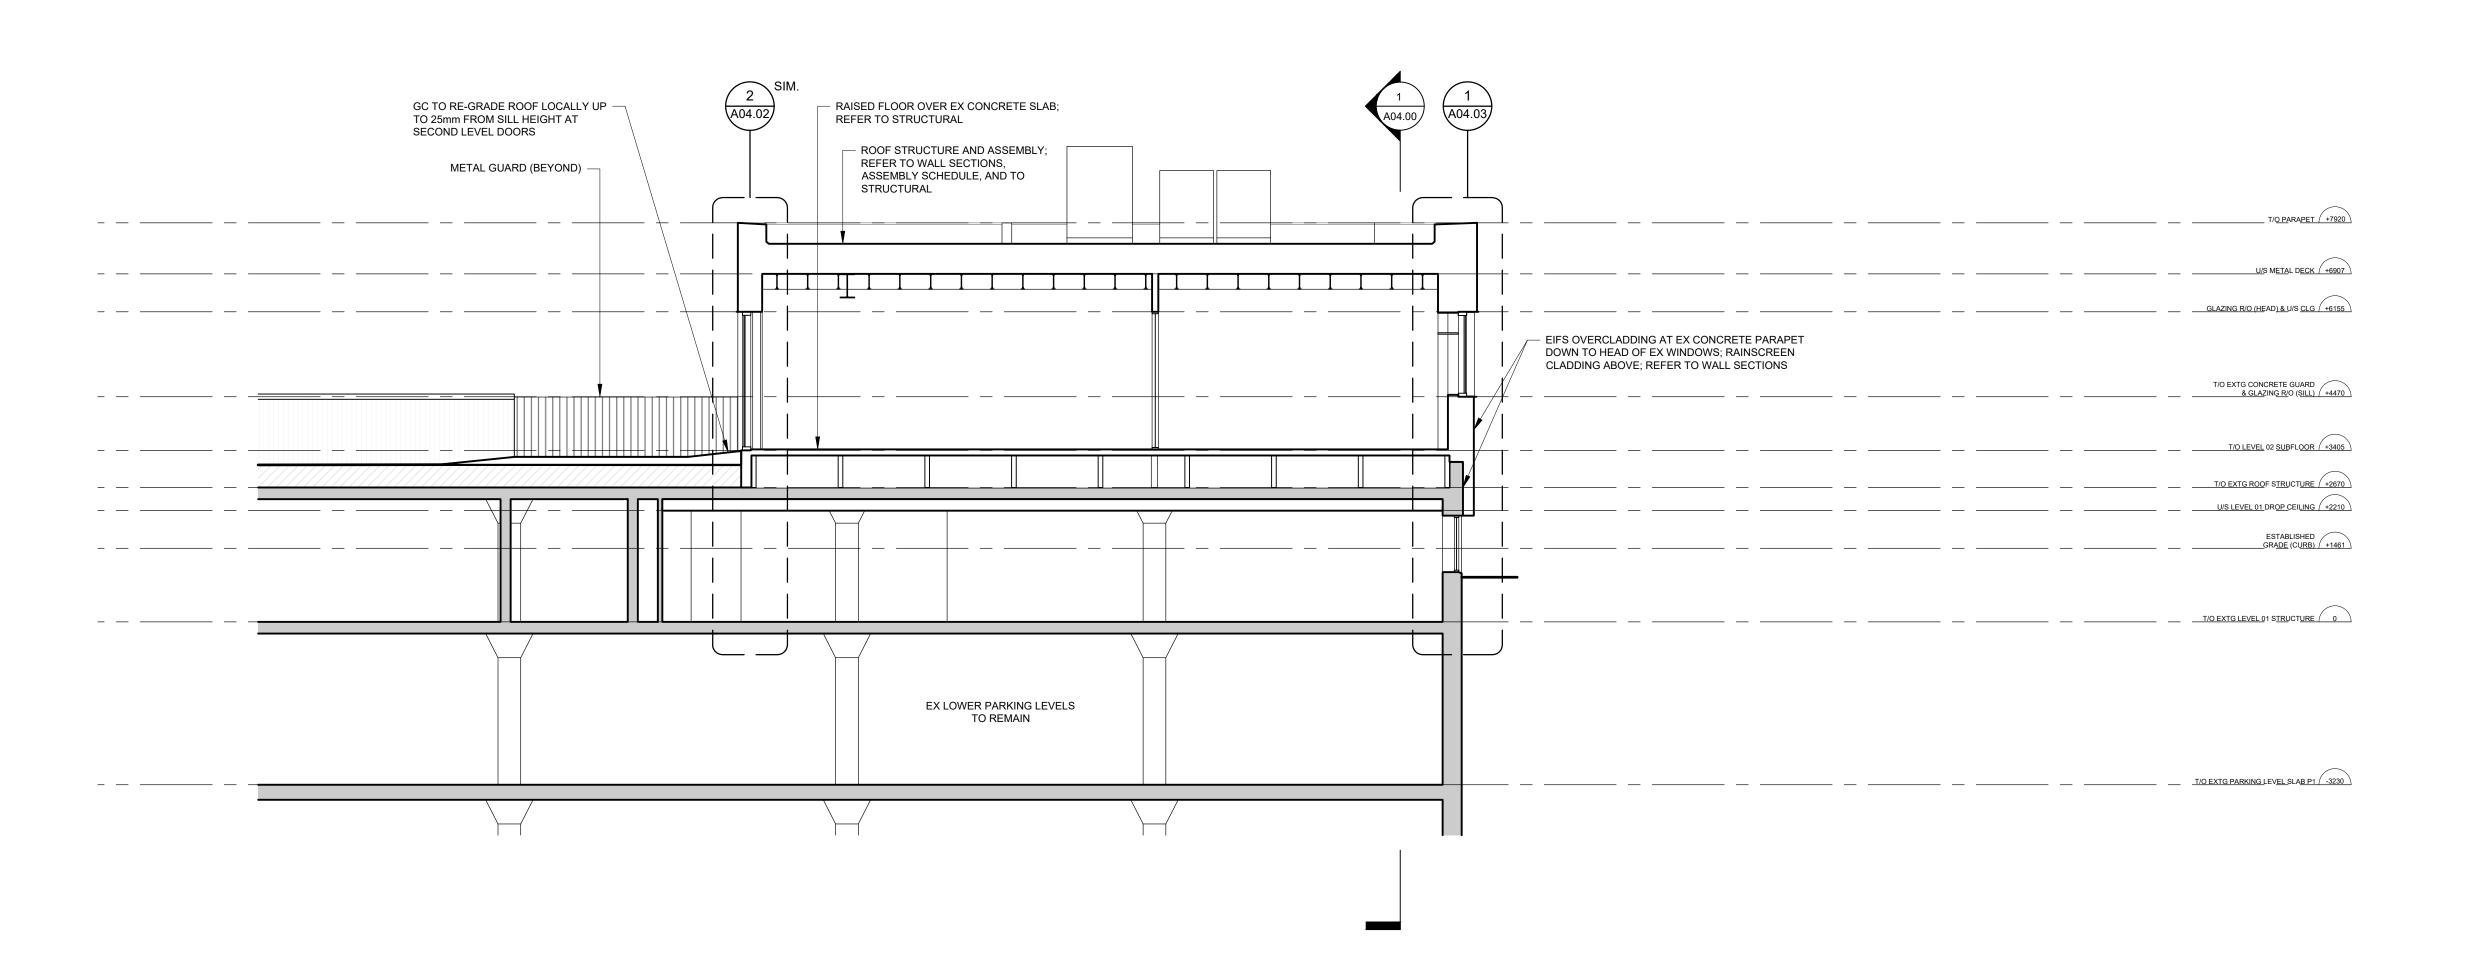
ISSUED FOR TENDER 2023.09.06 ISSUED FOR PERMIT 2023.05.16 NO. ISSUES/REVISIONS

MILLWORK DETAILS

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DRAWN BY: AW	CHECKE	BY:	SL
PROJECT NO.: 12228	SCALE:	AS NO	ΓED
DRAWING NO.:	1	REVISI	ON:



WEST-EAST BUILDING SECTION





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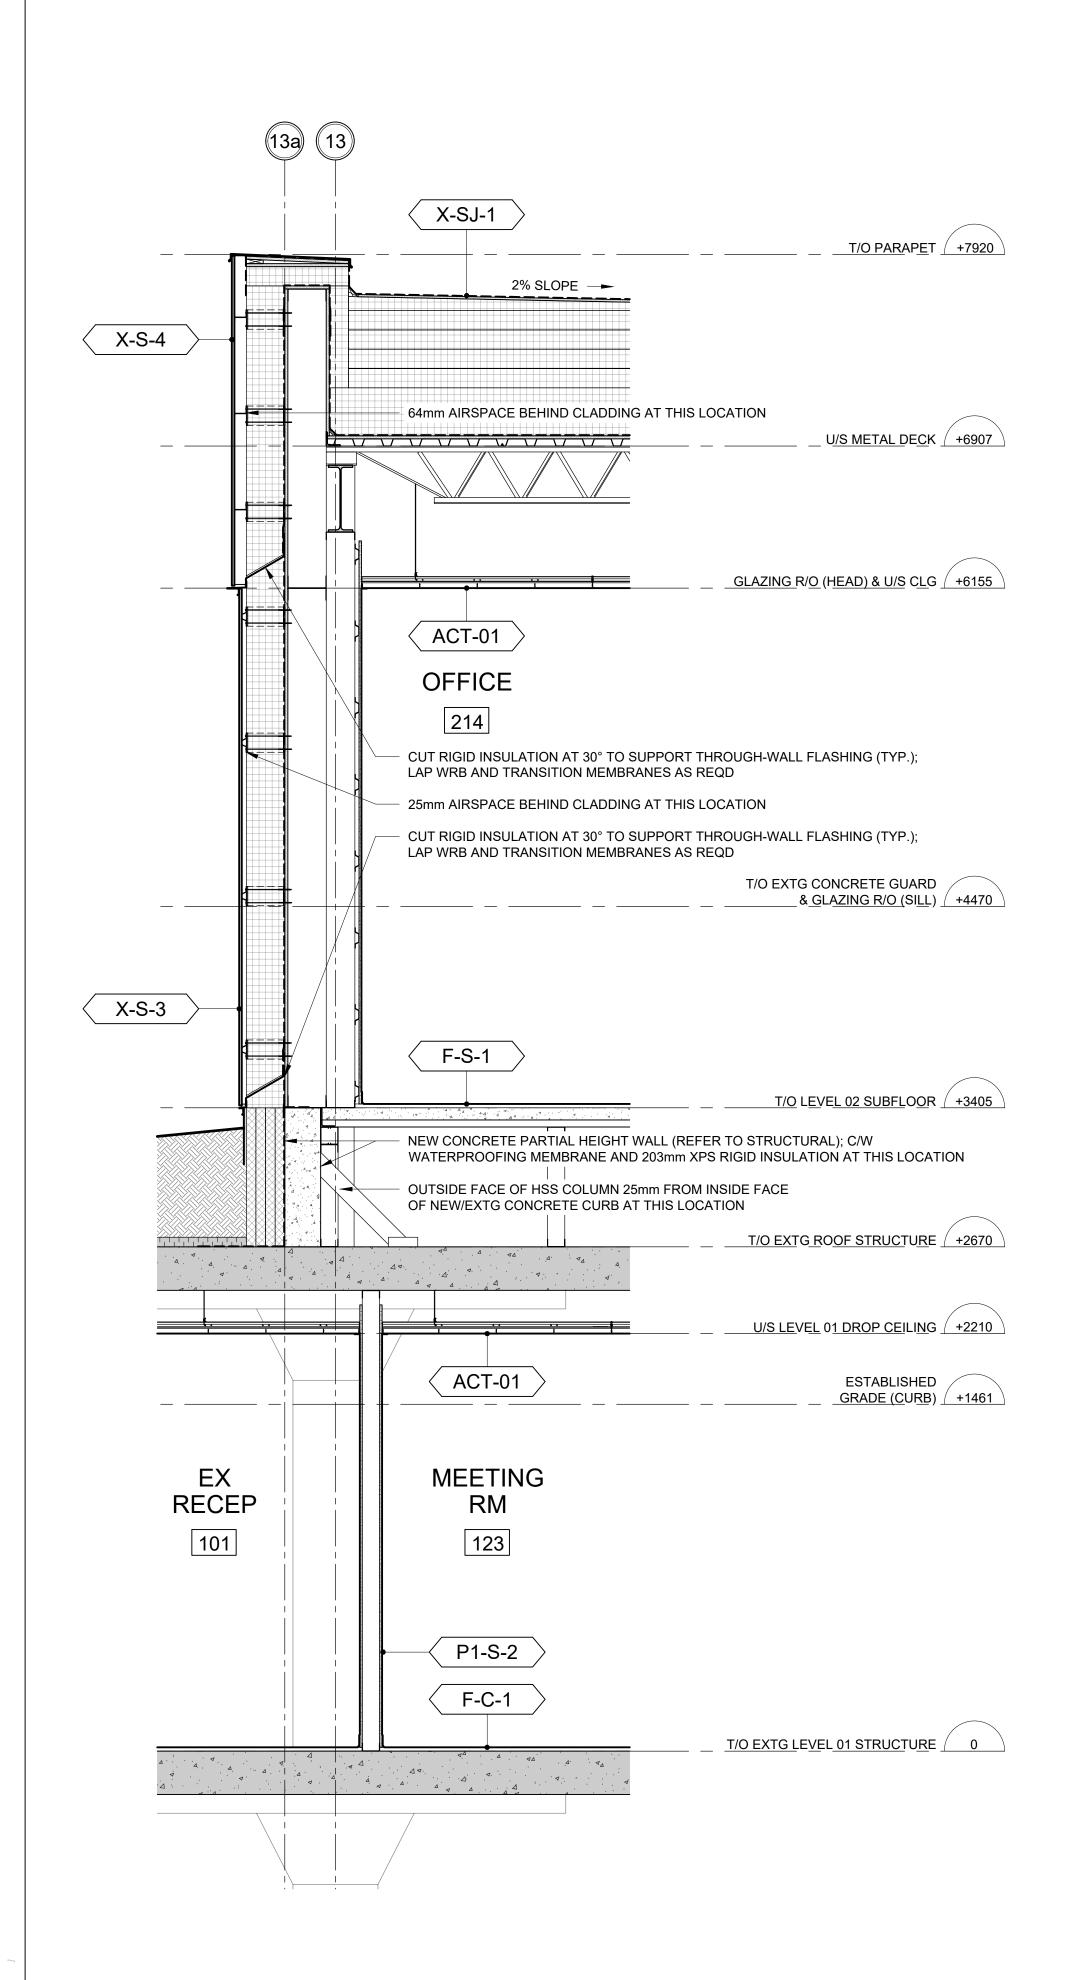


04	ISSUED FOR TENDER	2023.09.06
03	ISSUED FOR PERMIT	2023.05.16
02	Issued for Pre-consultation	2022.09.27
01	Issued for Coordination	2022.07.29
NO.	ISSUES/REVISIONS	DATE
DRAWIN	NG TITLE:	


BUILDING SECTIONS

ISSUE DATE:	2023.09
DRAWN BY: MM	CHECKED BY:
PROJECT NO.: 12228	SCALE: 1:
DRAWING NO :	I REVISIO

NORTH-SOUTH BUILDING SECTION



WALL SECTION - WEST EXTERIOR WALL AT GREEN ROOF

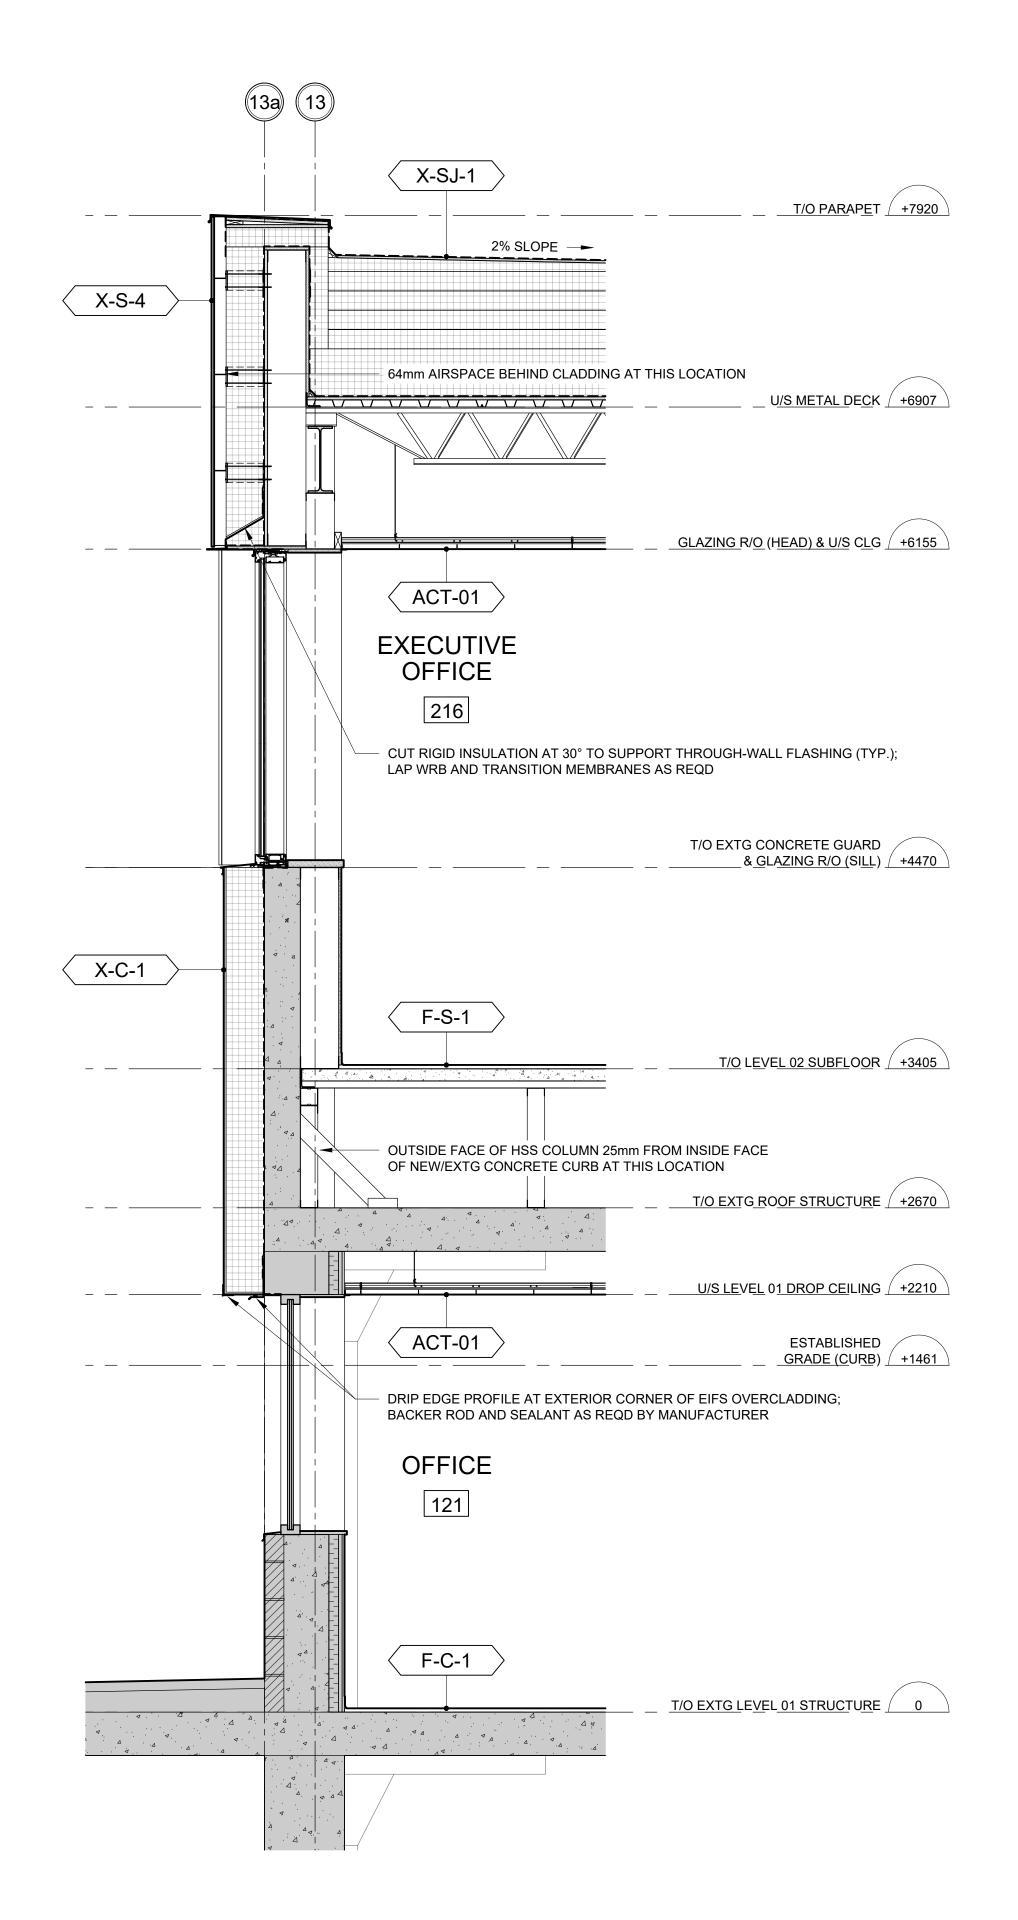

WALL SECTION - WEST EXTERIOR WALL AT PUNCHED WINDOW SCALE: 1:20



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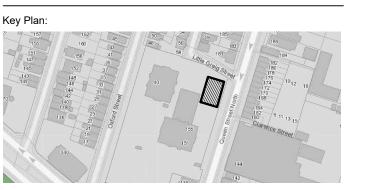
interiors T: 905-522-0220 urban design

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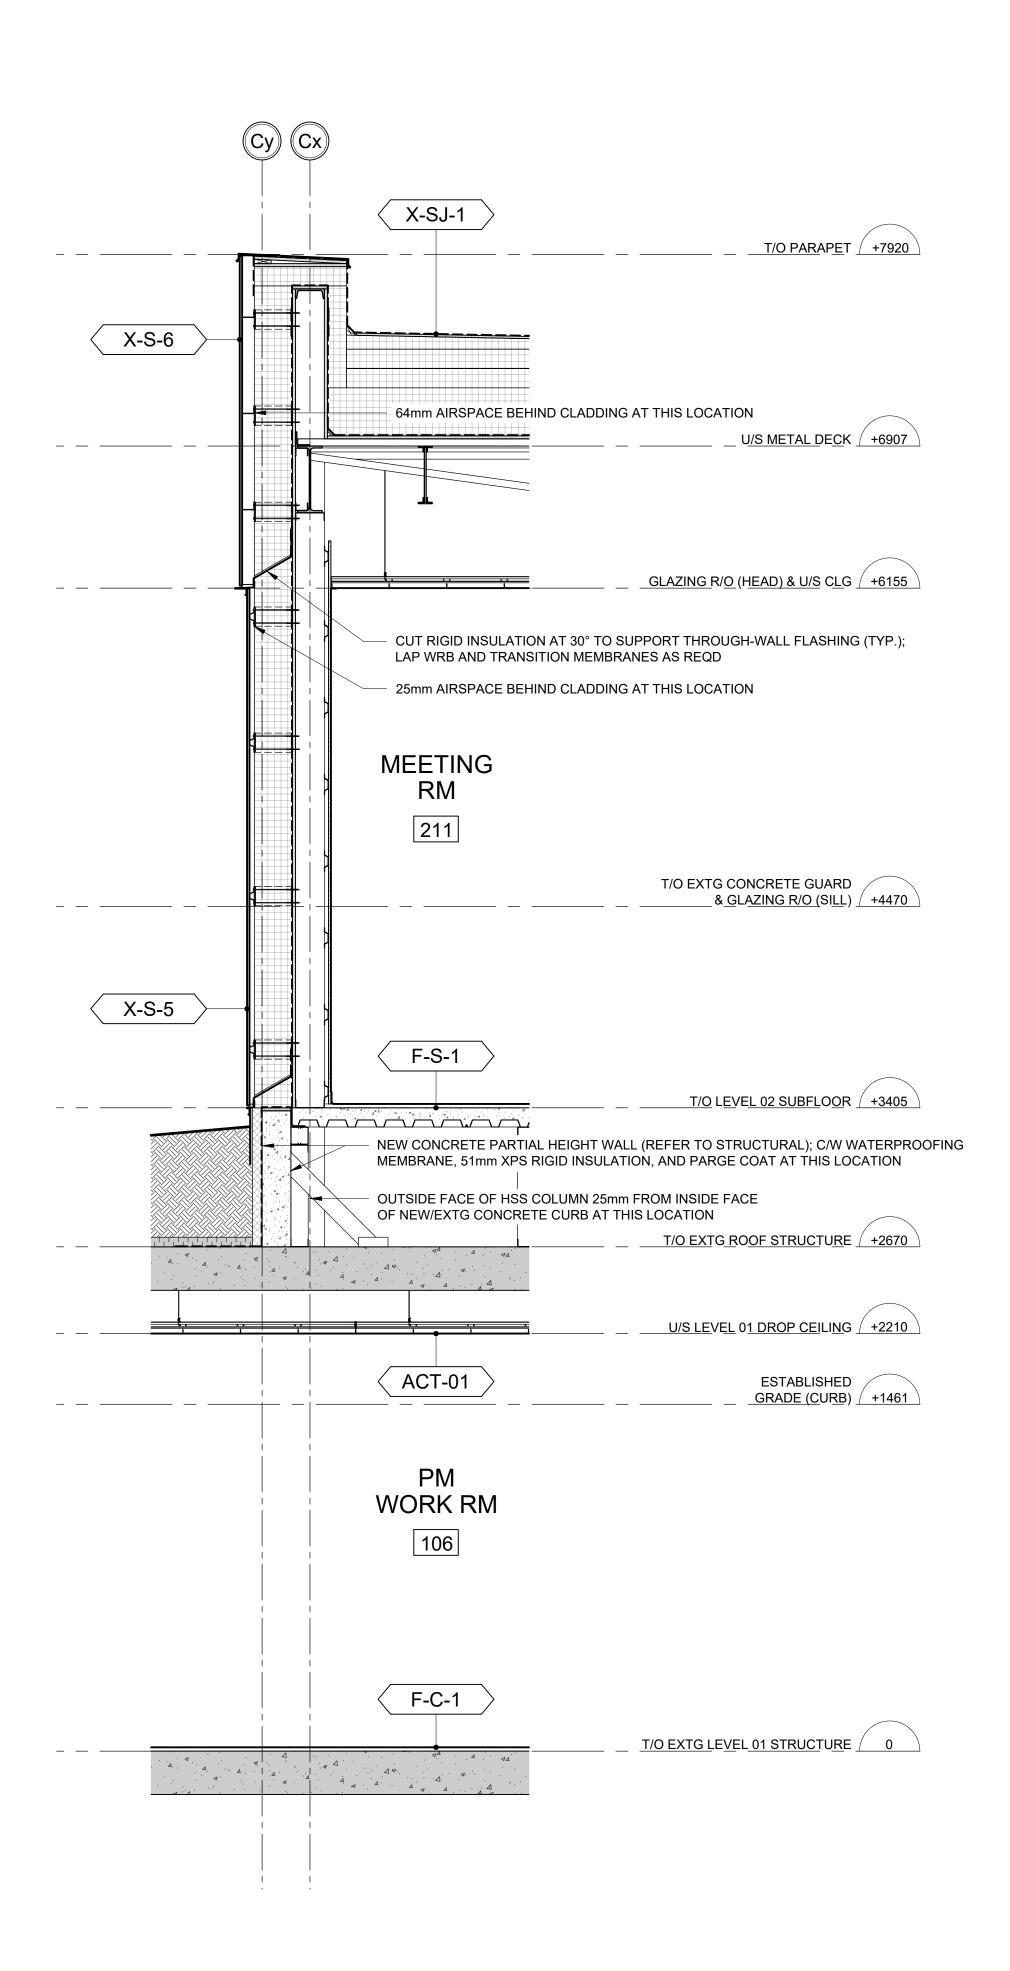
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\ 	1001150/05/101010	DATE
01	Issued for Coordination	2022.07.29
02	ISSUED FOR PERMIT	2023.05.16
03	ISSUED FOR TENDER	2023.09.06


WALL SECTIONS

ISSUE DATE:	202	23.09.06
DRAWN BY: MM	CHECKED BY:	SL
PROJECT NO.: 12228	SCALE:	1:20
DRAWING NO.:	l RE\	/ISION:

A04.01

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WALL SECTION - NORTH EXTERIOR WALL AT PUNCHED WINDOW SCALE: 1:20

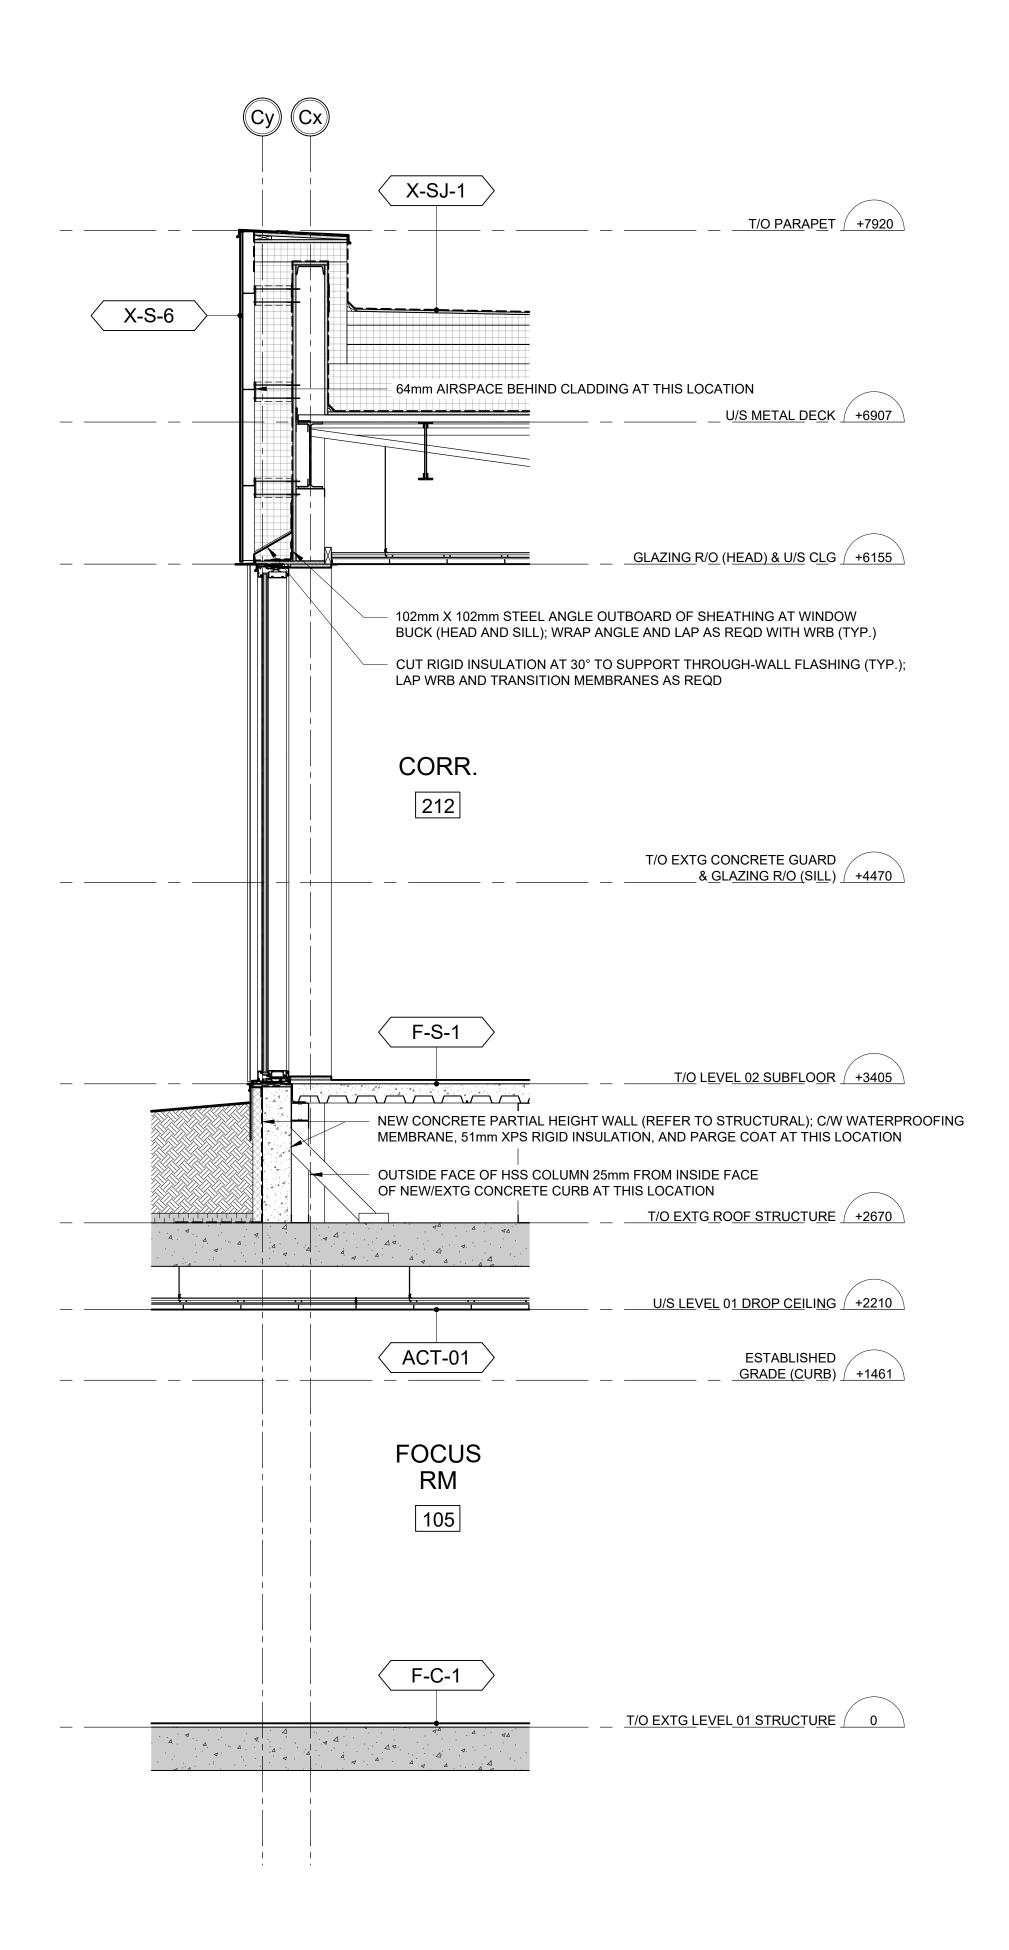

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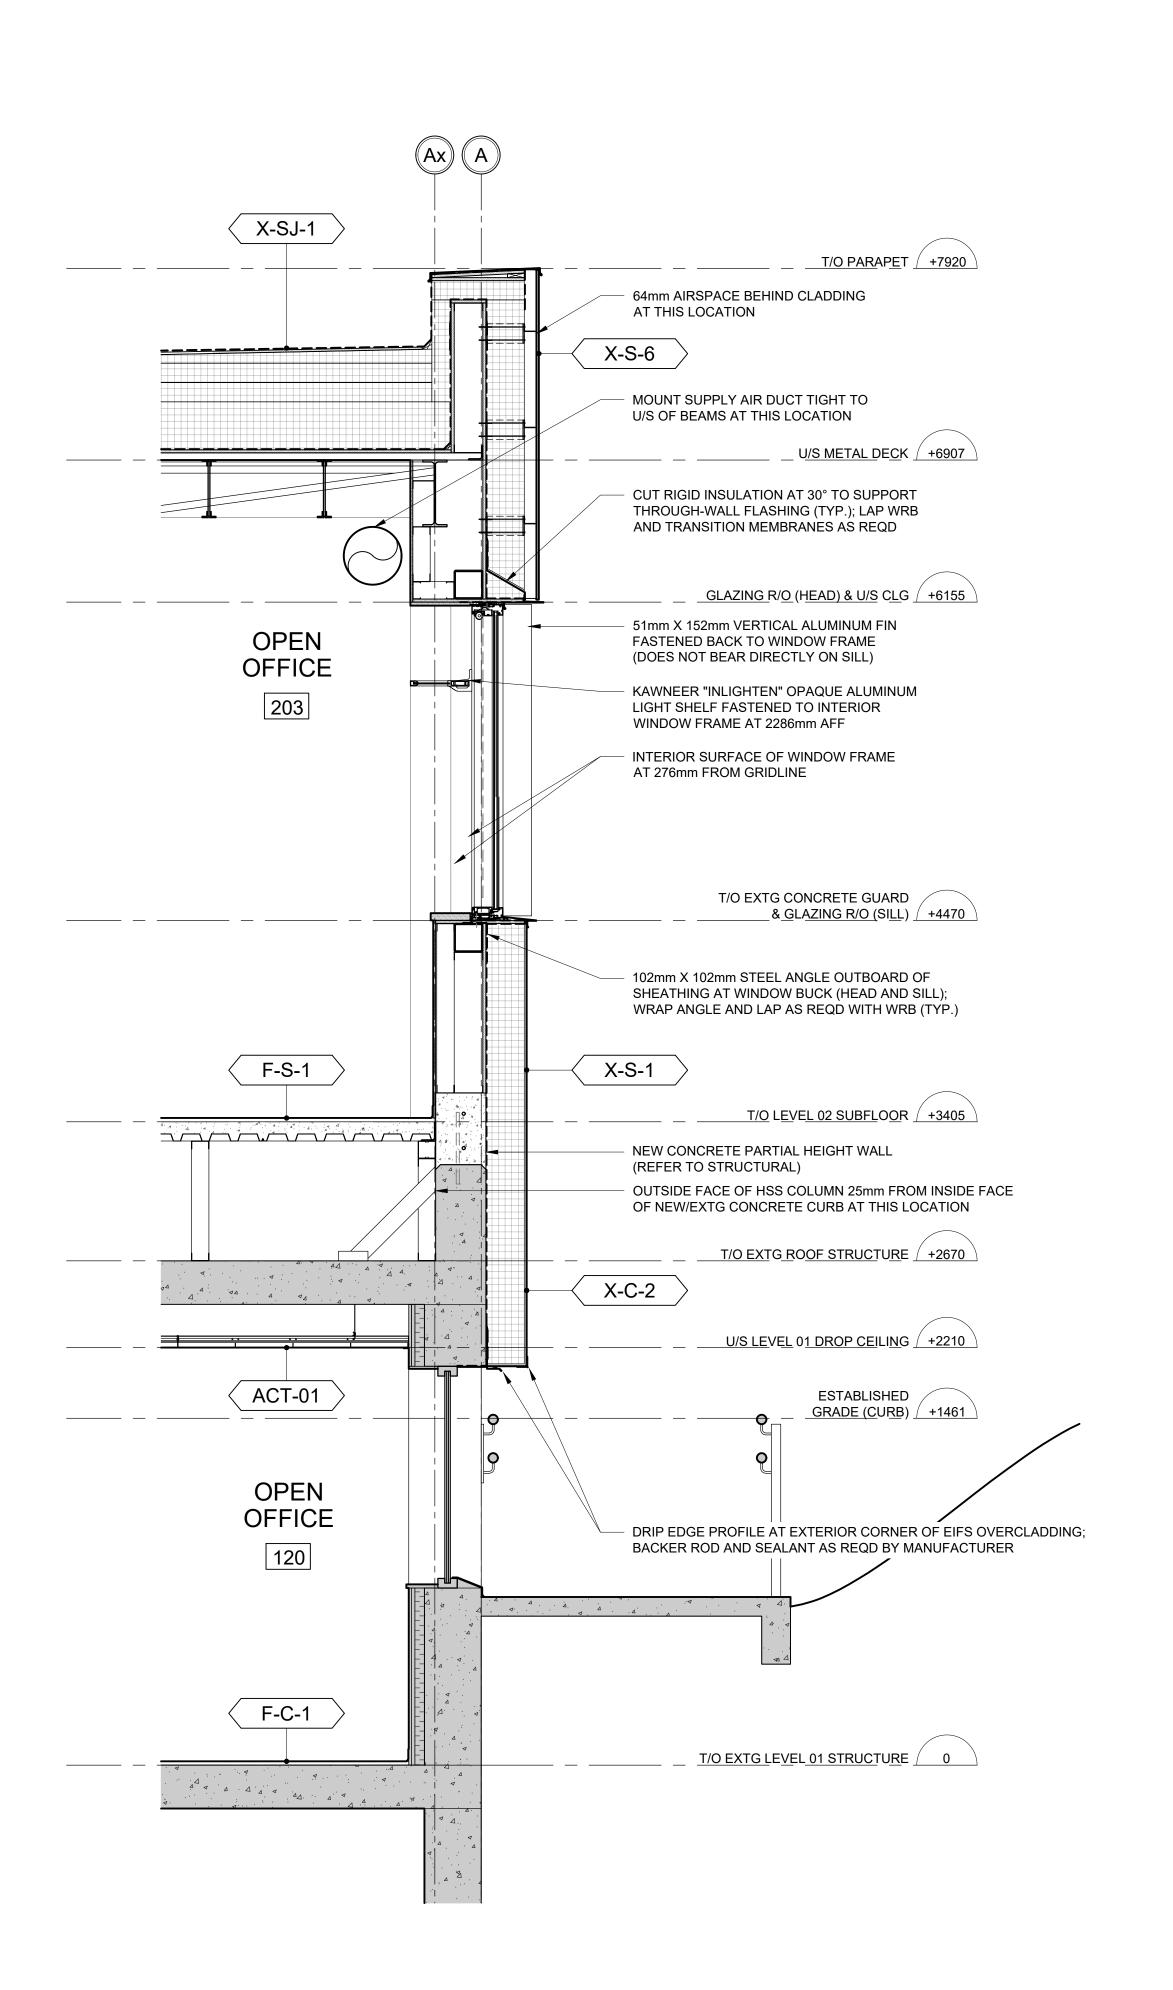



NO.	ISSUES/REVISIONS	DATE
01	ISSUED FOR PERMIT	2023.05.16
02	ISSUED FOR TENDER	2023.09.06

WALL SECTIONS

ISSUE DATE:	2023.09.06
DRAWN BY: MM	CHECKED BY: SL
PROJECT NO.: 12228	SCALE: 1 : 20
DRAWING NO.:	REVISION:

WALL SECTION - NORTH EXTERIOR WALL



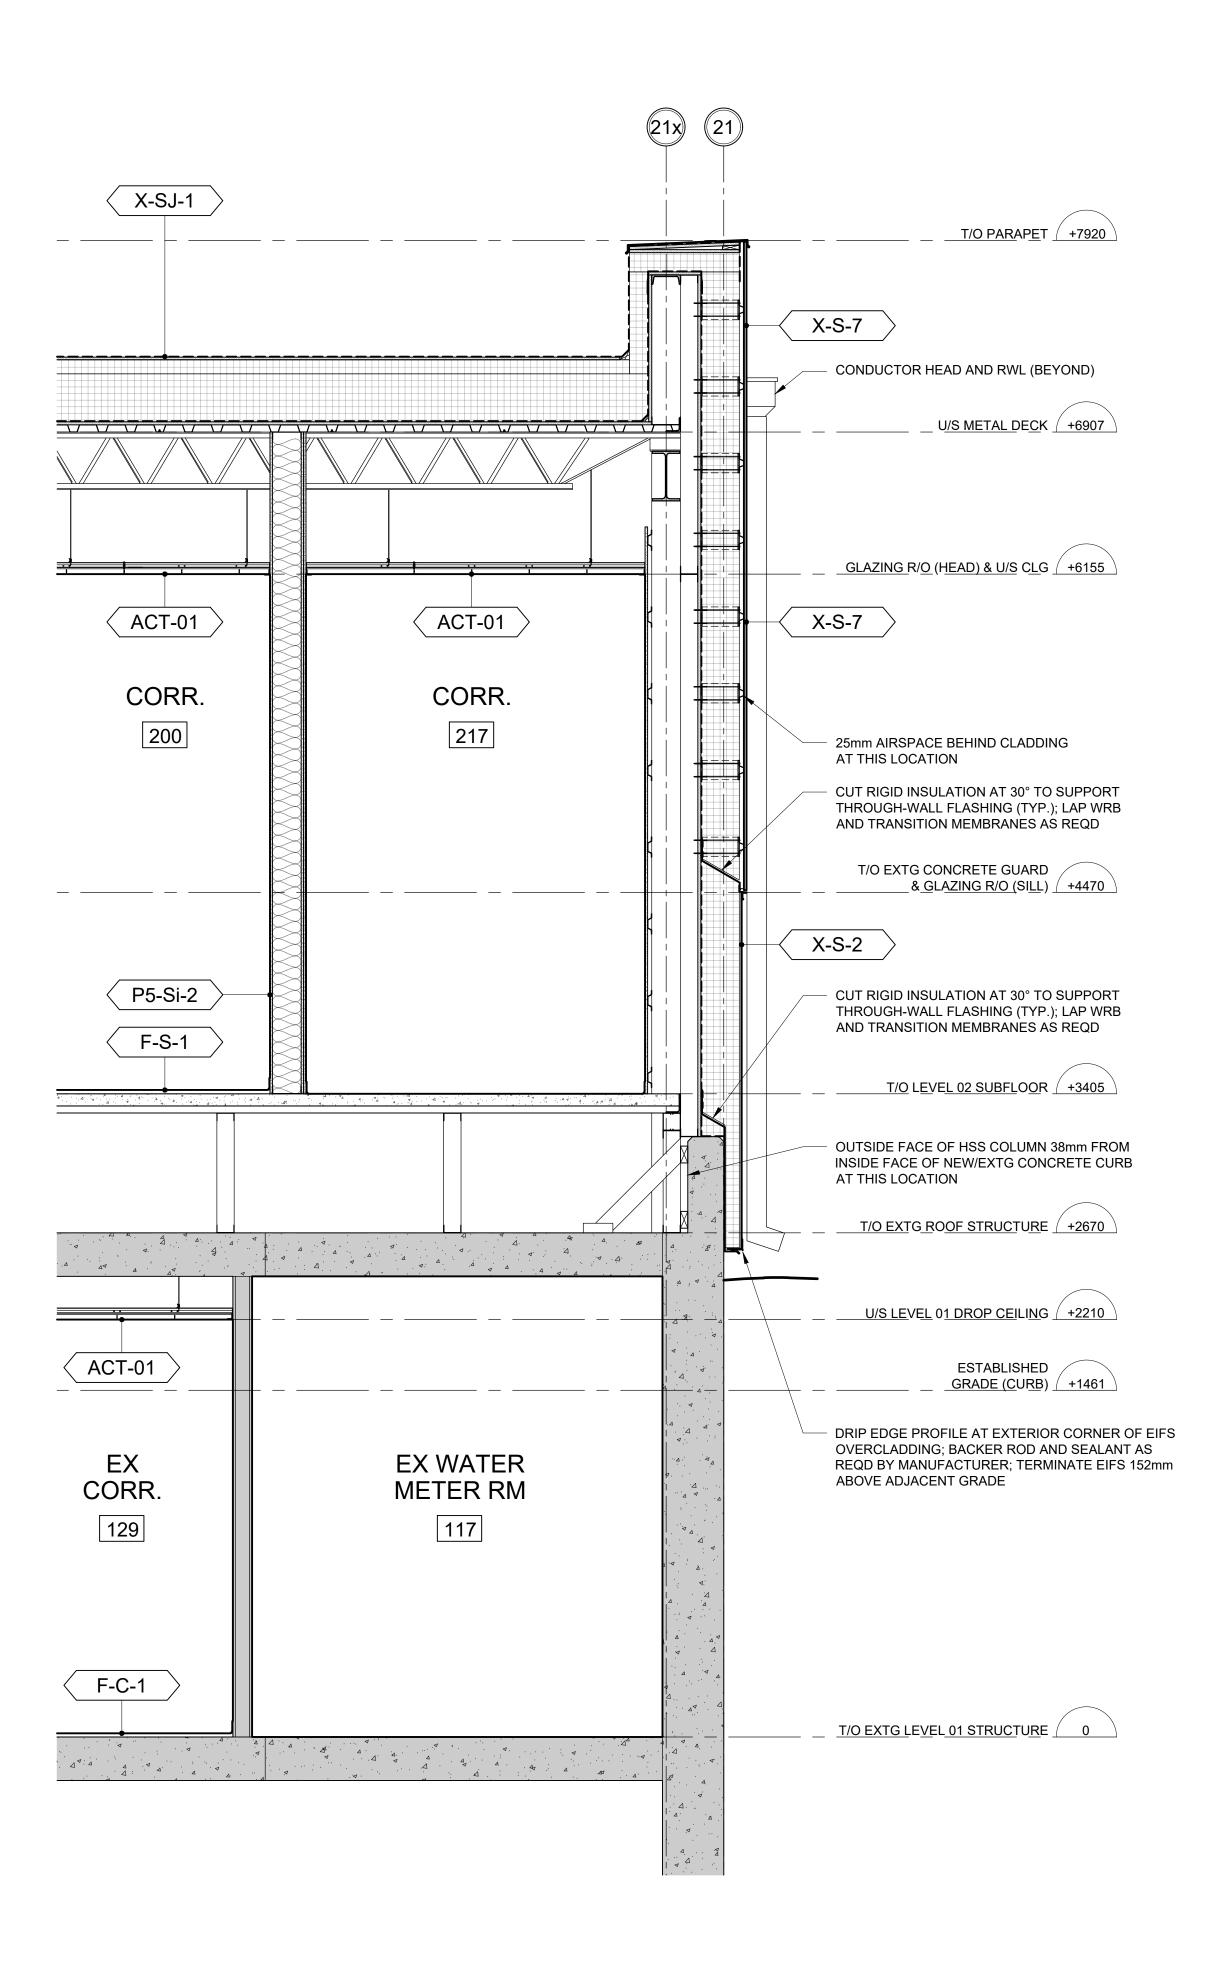

WALL SECTION - EAST EXTERIOR WALL AT EXTG STAIR LANDING SCALE: 1:20

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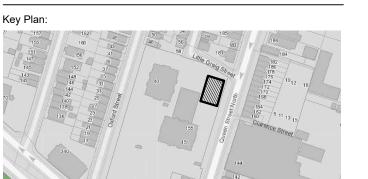
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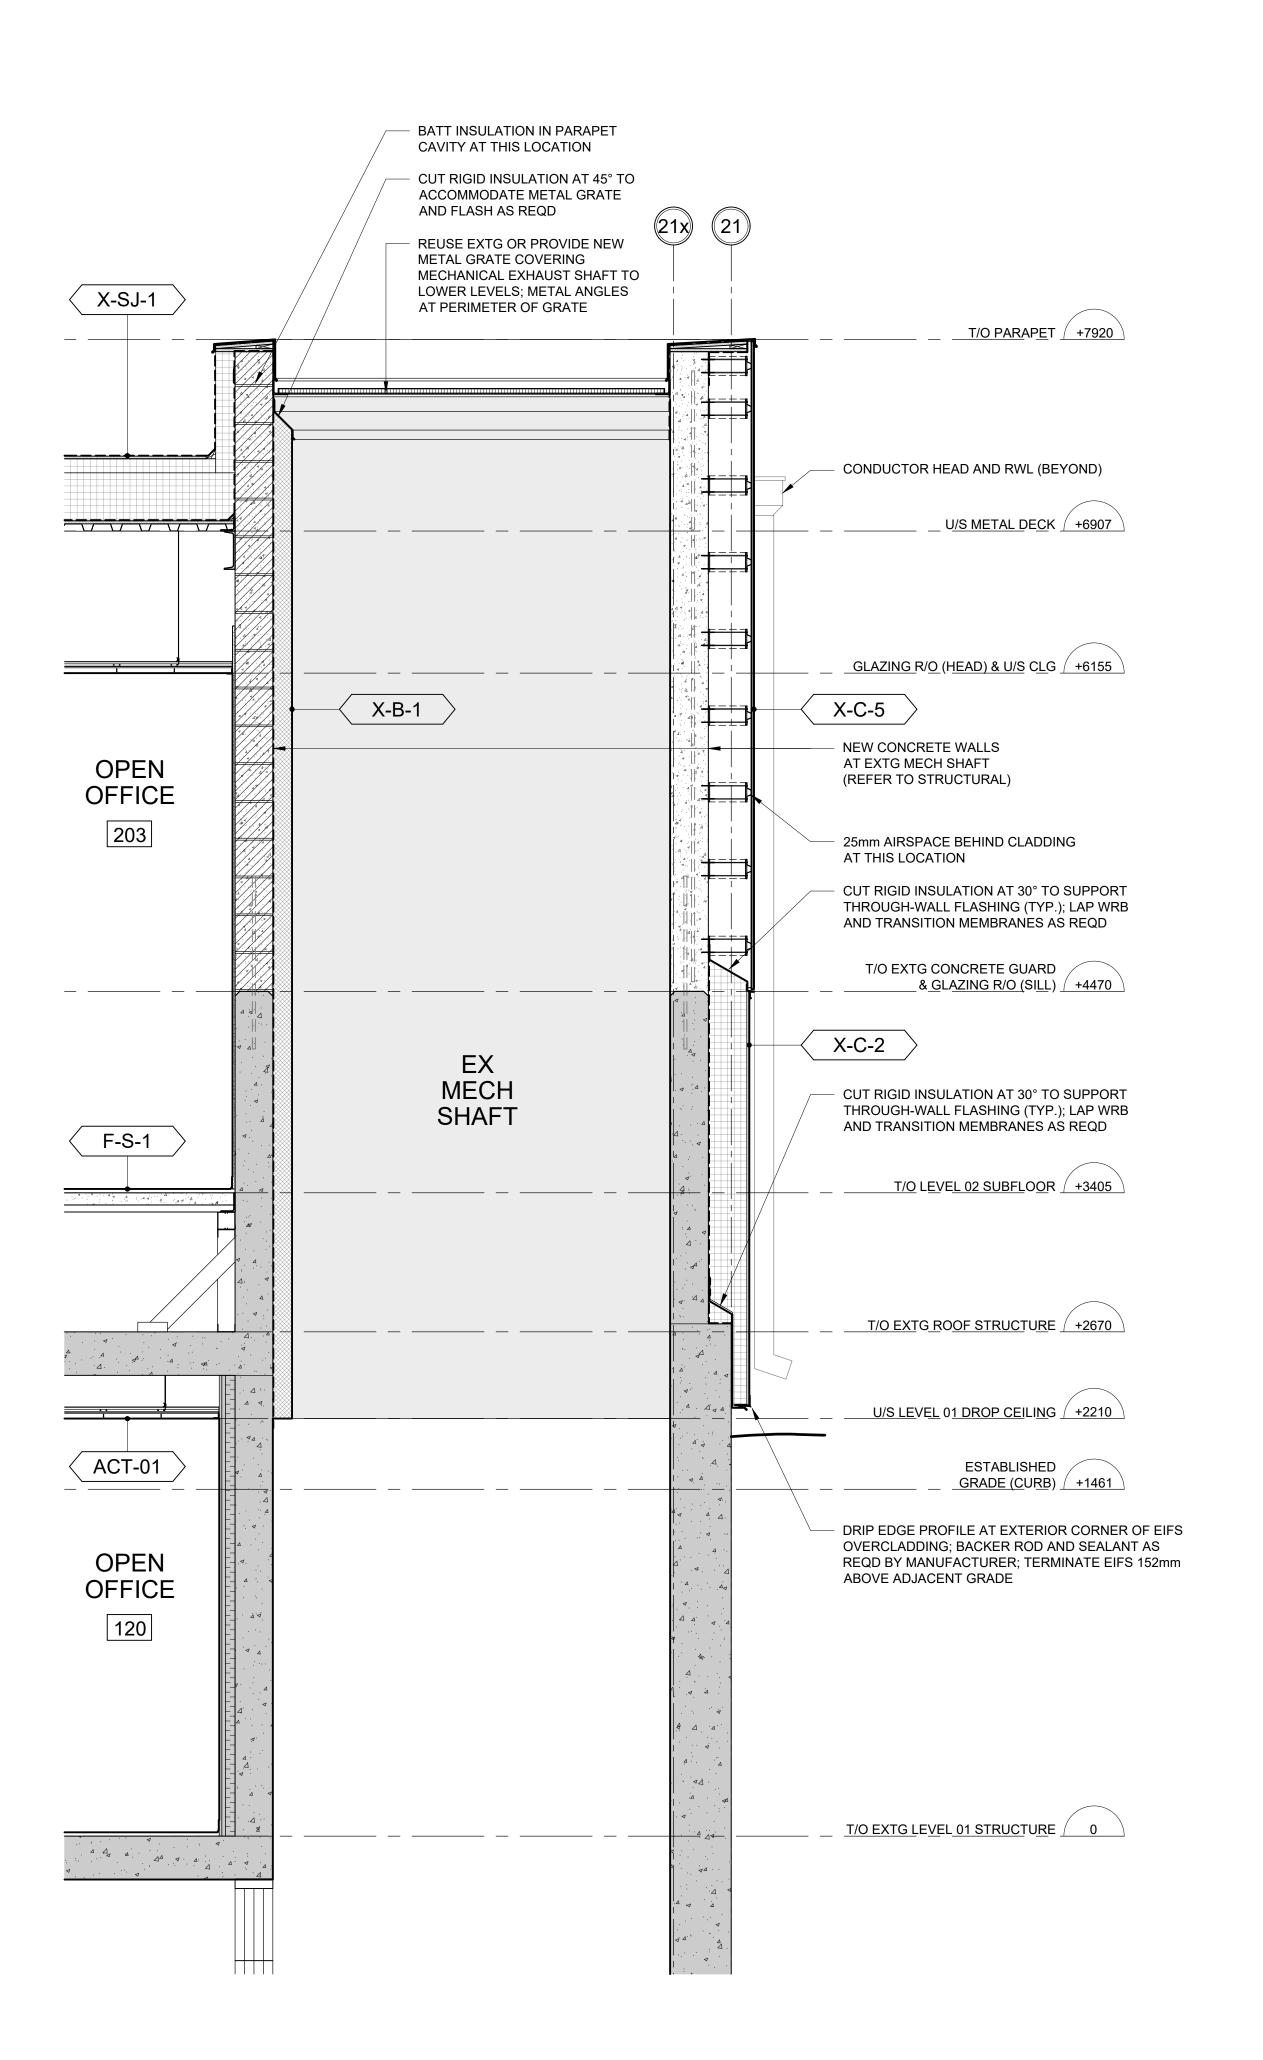


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WALL SECTIONS


DRAWING TITLE:

ISSUE DATE:	2023.09.06
DRAWN BY: MM	CHECKED BY: SL
PROJECT NO.: 12228	SCALE: 1:20
DRAWING NO.:	REVISION:



WALL SECTION - EAST EXTERIOR WALL AT MECHANICAL SHAFT

SCALE: 1:20

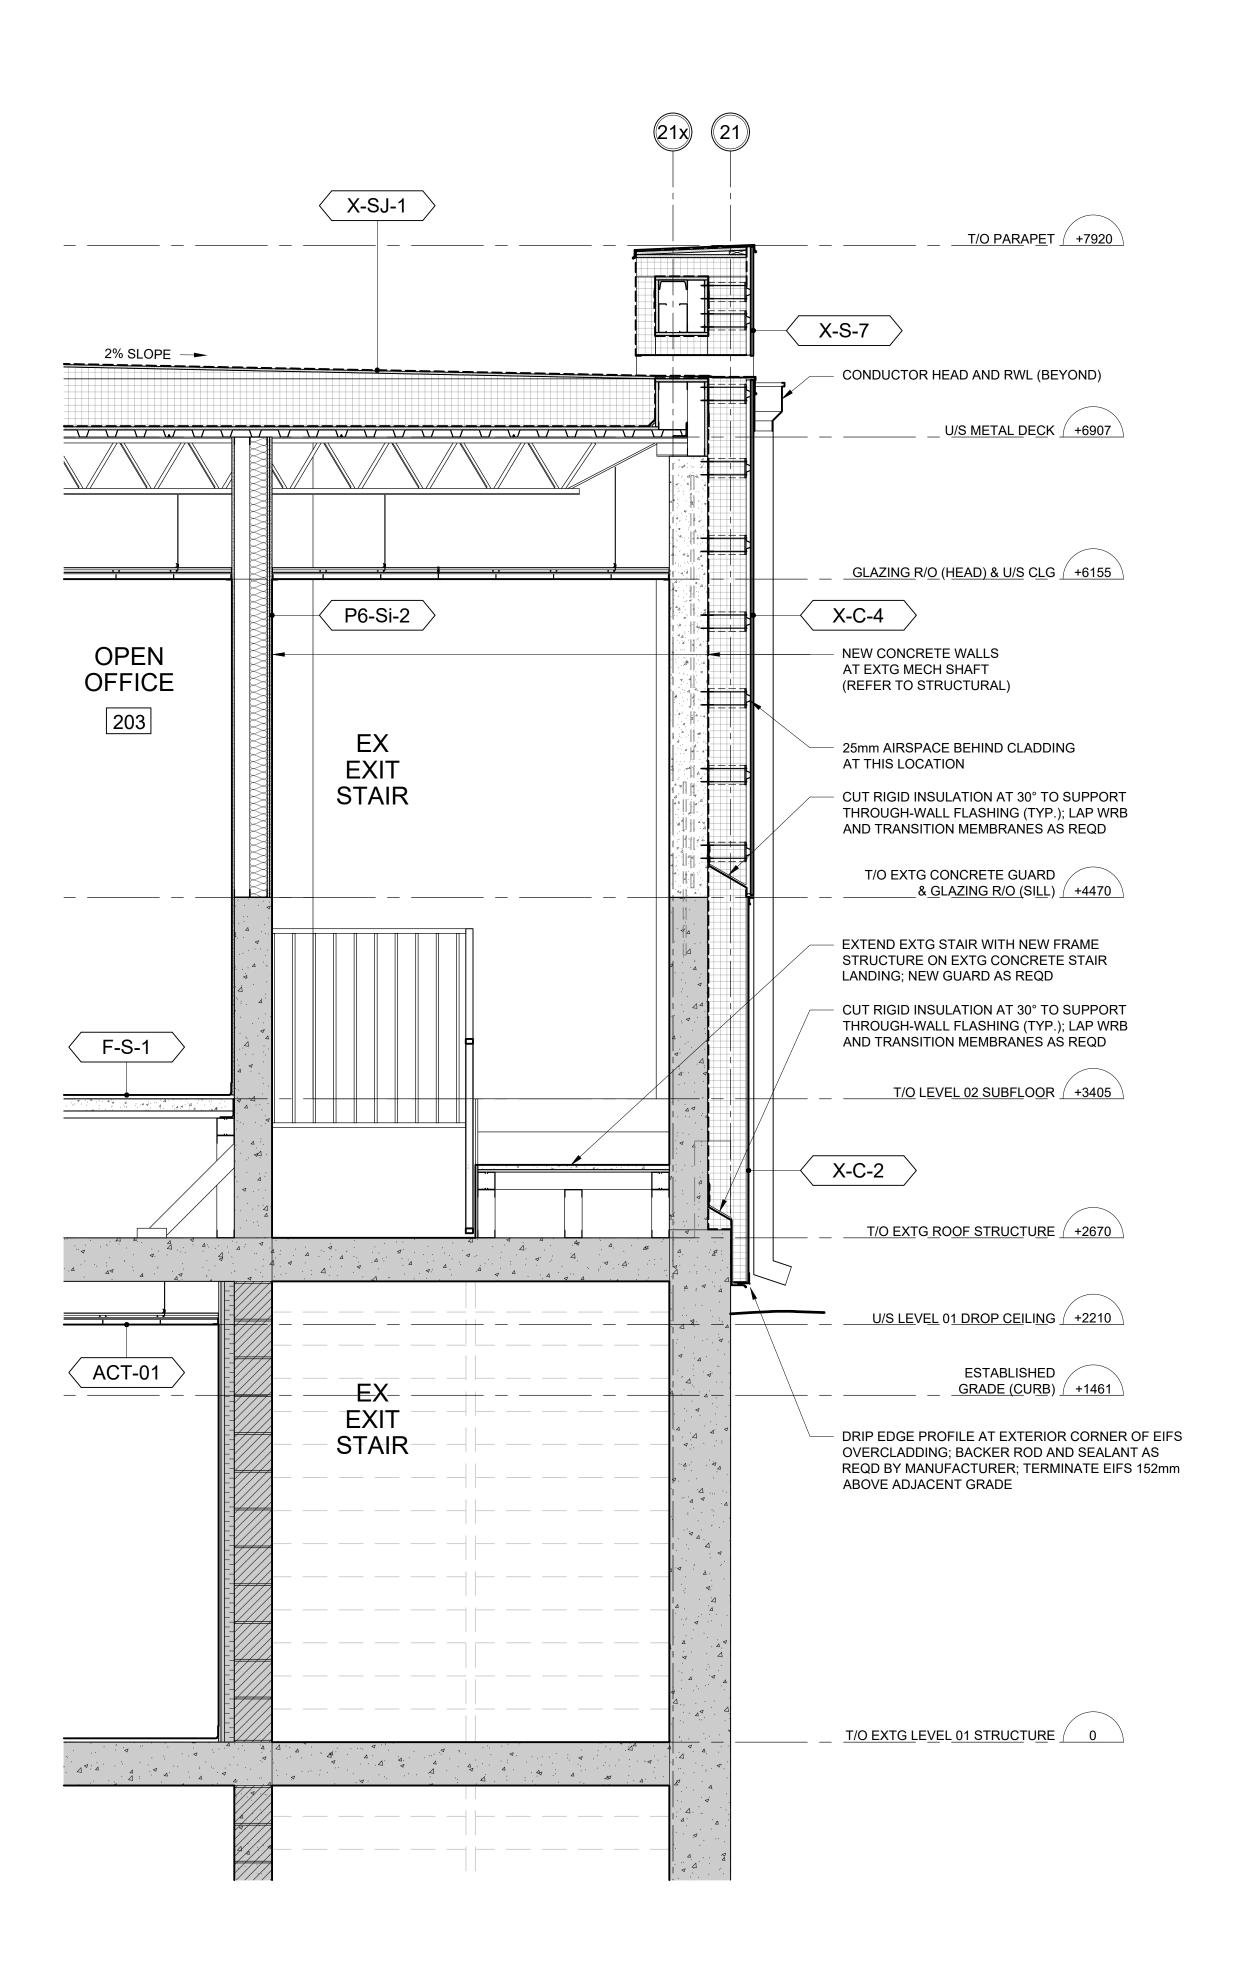

WALL SECTION - EAST EXTERIOR WALL AT EXTG EXIT STAIR

SCALE: 1:20

VICTORIA PARK COMMUNITY HOMES

VPCH OFFICE EXPANSION

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urban design


25 Main Street West Hamilton, Ontario L8P 1H1 Canada

interiors T: 905-522-0220

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01	ISSUED FOR PERMIT	2023.05.1
NO.	ISSUES/REVISIONS	DAT

WALL SECTIONS

ISSUE DATE:	2023.	09.0
DRAWN BY: MM	CHECKED BY:	SI
PROJECT NO.: 12228	SCALE: 1	1:20
DRAWING NO.:	l REVIS	NOIS

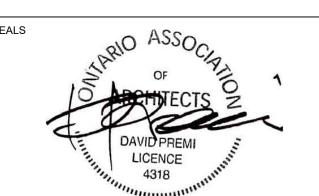A04.04

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BARRIER FREE PATH OF TRAVEL - OFFICE TO WASHROOMS - LEVEL 1 SCALE: 1:100

FIRE & LIFE SAFETY GENERAL NOTES: GENERAL REQUIREMENTS


MANUFACTURERS INSTRUCTIONS.

- FOR WALL ASSEMBLIES THAT BEAR THE NOTE "*CONSTRUCT AS FIRE SEPARATION WHERE NOTED", THE ASSEMBLY SHALL BE CONSTRUCTED AS A FIRE SEPARATION AT THE LOCATIONS INDICATED IN THE CONTRACT DRAWINGS.
- ALL PENETRATIONS THROUGH NEW AND EXISTING FIRE SEPARATIONS ARE TO BE SEALED TO MEET REQUIREMENTS OF THE SEPARATION NOTED.
 AT RECESSED PANEL INSTALLATIONS (E.G. ELECTRICAL PANELS) WITHIN RATED WALLS PROVIDE FOR CONTINUITY OF THE REQUIRED RATING BEHIND THE PANEL. REFER TO THE ONTARIO BUILDING
- RATING BEHIND THE PANEL. REFER TO THE ONTARIO BUILDING CODE DIVISION B, SECTION 3.1.9.2 FOR REQUIREMENTS FOR COMBUSTIBILITY OF SERVICE PENETRATIONS AND SECTION 3.1.10.2 FOR RATING OF FIREWALLS.

 4. WHERE FIRE RATED PARTITIONS ABUT NON-RATED PARTITIONS THE FIRE RATED ASSEMBLY SHALL BE CONTINUOUS AND UNINTERRUPTED BY THE ABUTTING WALLS TO MAINTAIN A
- FIRE RATED ASSEMBLY SHALL BE CONTINUOUS AND UNINTERRUPTED BY THE ABUTTING WALLS TO MAINTAIN A CONTINUOUS FIRE SEPARATION.

 5. SEAL PERIMETER OF FIRE RATED WALLS AND AROUND PENETRATIONS THROUGH FIRE RATED WALLS WITH APPROVED FIRESTOP MATERIALS. DO NOT SEAL CLEARANCE SPACES WITHIN FIRE DAMPERS. SEAL ONLY IN STRICT ACCORDANCE WITH

FIRE & LIFE SAFETY PLAN LEGEND OF SYMBOLS:

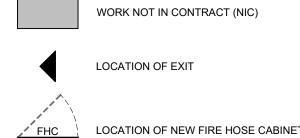

LOCATION OF NEW FIRE HOSE CABINET (FHC)
- REFER TO MECHANICAL DRAWINGS

LOCATION OF EXIT SIGNAGE - REFER TO
ELECTRICAL DRAWINGS

LOCATION OF EMERGENCY LIGHTING -

REFER TO ELECTRICAL DRAWINGS

14.32m

TRAVEL DISTANCE

NEW FIRE PULL STATION

PARTITION FIRE RATINGS:	
	EXISTING FIRE RATED SEPARATION TO REMAIN
	PROPOSED NON-RATED EXTERIOR WALL

1 HOUR FIRE RATED SEPARATION


02	ISSUED FOR TENDER	2023.09.0
01	ISSUED FOR PERMIT	2023.05.1
NO.	ISSUES/REVISIONS	DAT

REFERENCE PLAN

ISSUE DATE:	2023.09.06
DRAWN BY: AW	CHECKED BY: SL
PROJECT NO.: 12228	SCALE: 1:75
DRAWING NO.:	REVISION:

A05.00

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LIFE SAFTEY PLAN - LEVEL 1

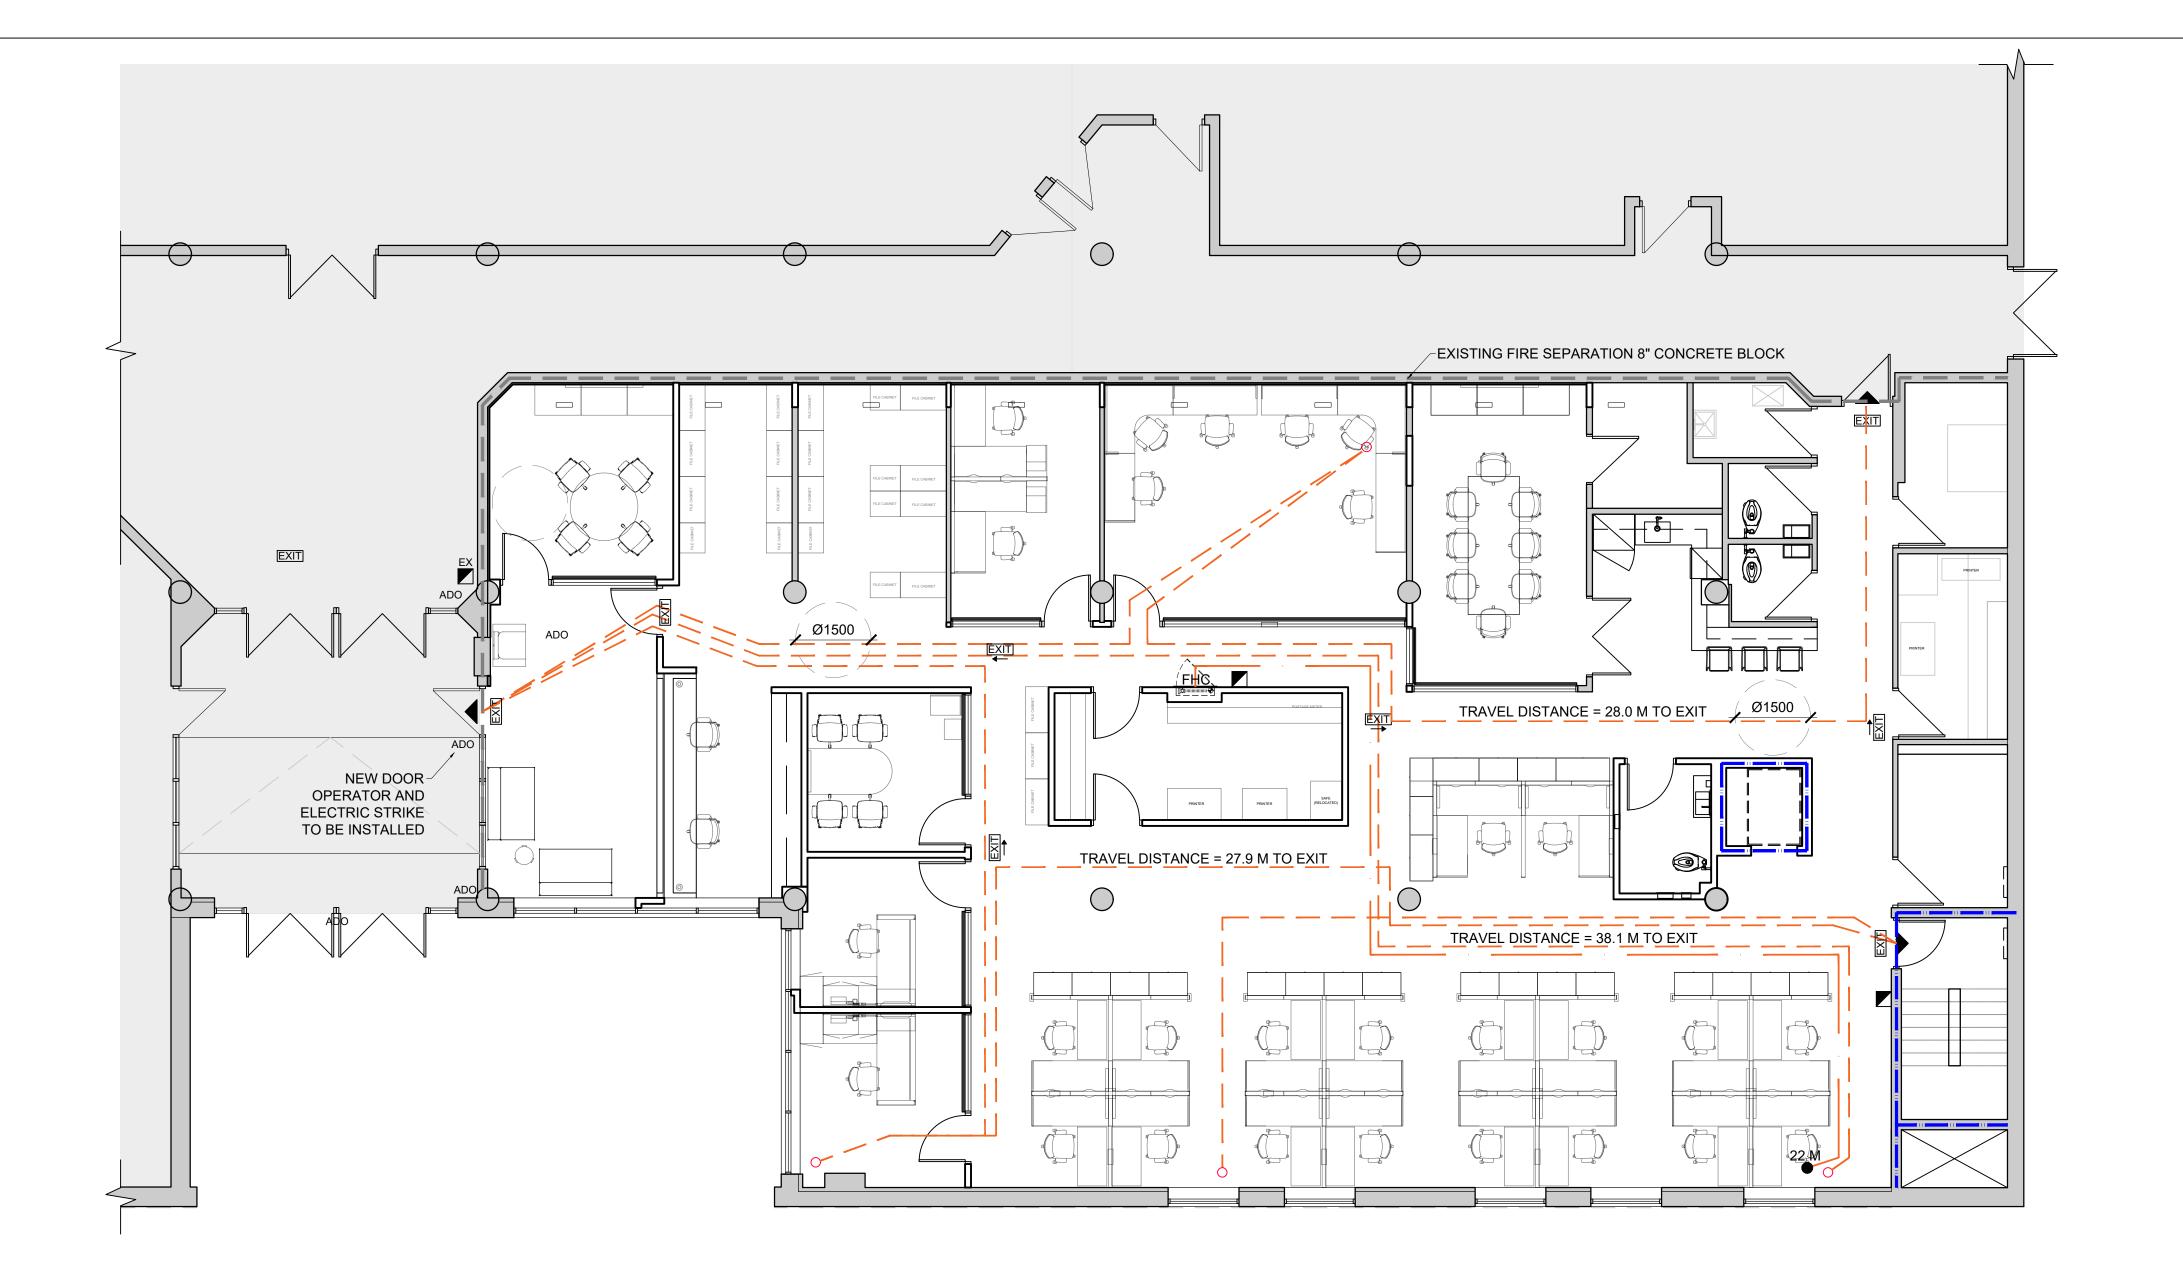FIRE & LIFE SAFETY GENERAL NOTES: GENERAL REQUIREMENTS

- 1. FOR WALL ASSEMBLIES THAT BEAR THE NOTE '*CONSTRUCT AS FIRE SEPARATION WHERE NOTED', THE ASSEMBLY SHALL BE CONSTRUCTED AS A FIRE SEPARATION AT THE LOCATIONS
- INDICATED IN THE CONTRACT DRAWINGS. 2. ALL PENETRATIONS THROUGH NEW AND EXISTING FIRE SEPARATIONS ARE TO BE SEALED TO MEET REQUIREMENTS OF THE
- SEPARATION NOTED. 3. AT RECESSED PANEL INSTALLATIONS (E.G. ELECTRICAL PANELS) WITHIN RATED WALLS PROVIDE FOR CONTINUITY OF THE REQUIRED RATING BEHIND THE PANEL. REFER TO THE ONTARIO BUILDING CODE DIVISION B, SECTION 3.1.9.2 FOR REQUIREMENTS FOR COMBUSTIBILITY OF SERVICE PENETRATIONS AND SECTION 3.1.10.2 FOR RATING OF FIREWALLS.
- 4. WHERE FIRE RATED PARTITIONS ABUT NON-RATED PARTITIONS THE FIRE RATED ASSEMBLY SHALL BE CONTINUOUS AND UNINTERRUPTED BY THE ABUTTING WALLS TO MAINTAIN A

 CONTINUOUS FIRE SEPARATION. CONTINUOUS FIRE SEPARATION.
- 5. SEAL PERIMETER OF FIRE RATED WALLS AND AROUND PENETRATIONS THROUGH FIRE RATED WALLS WITH APPROVED FIRESTOP MATERIALS. DO NOT SEAL CLEARANCE SPACES WITHIN FIRE DAMPERS. SEAL ONLY IN STRICT ACCORDANCE WITH MANUFACTURERS INSTRUCTIONS.

FIRE & LIFE SAFETY PLAN LEGEND OF SYMBOLS:

WORK NOT IN CONTRACT (NIC) LOCATION OF EXIT





•14.32m TRAVEL DISTANCE

FHC LOCATION OF NEW FIRE HOSE CABINET (FHC)
- REFER TO MECHANICAL DRAWINGS

LOCATION OF EXIT SIGNAGE - REFER TO LOCATION OF EMERGENCY LIGHTING -REFER TO ELECTRICAL DRAWINGS


NEW FIRE PULL STATION

PARTITION FIRE RATINGS:												
	EXISTING FIRE RATED SEPARATION TO REMAIN											
	PROPOSED NON-RATED EXTERIOR WALL											
	1 HOUR FIRE RATED SEPARATION											

03	ISSUED FOR TENDER	2023	3.09.06
02	PERMIT REVISION 01	2023	3.07.20
01	ISSUED FOR PERMIT	2023	3.05.16
NO.	ISSUES/REVISIONS		DATE
DRAWIN			

FIRE, LIFE SAFETY, & LEVEL 1

ISSUE DATE:	2023.09.06								
DRAWN BY: AW	CHECKED BY:	SL							
PROJECT NO.: 12228	SCALE:	1:75							
DRAWING NO.:	REVI	SION:							

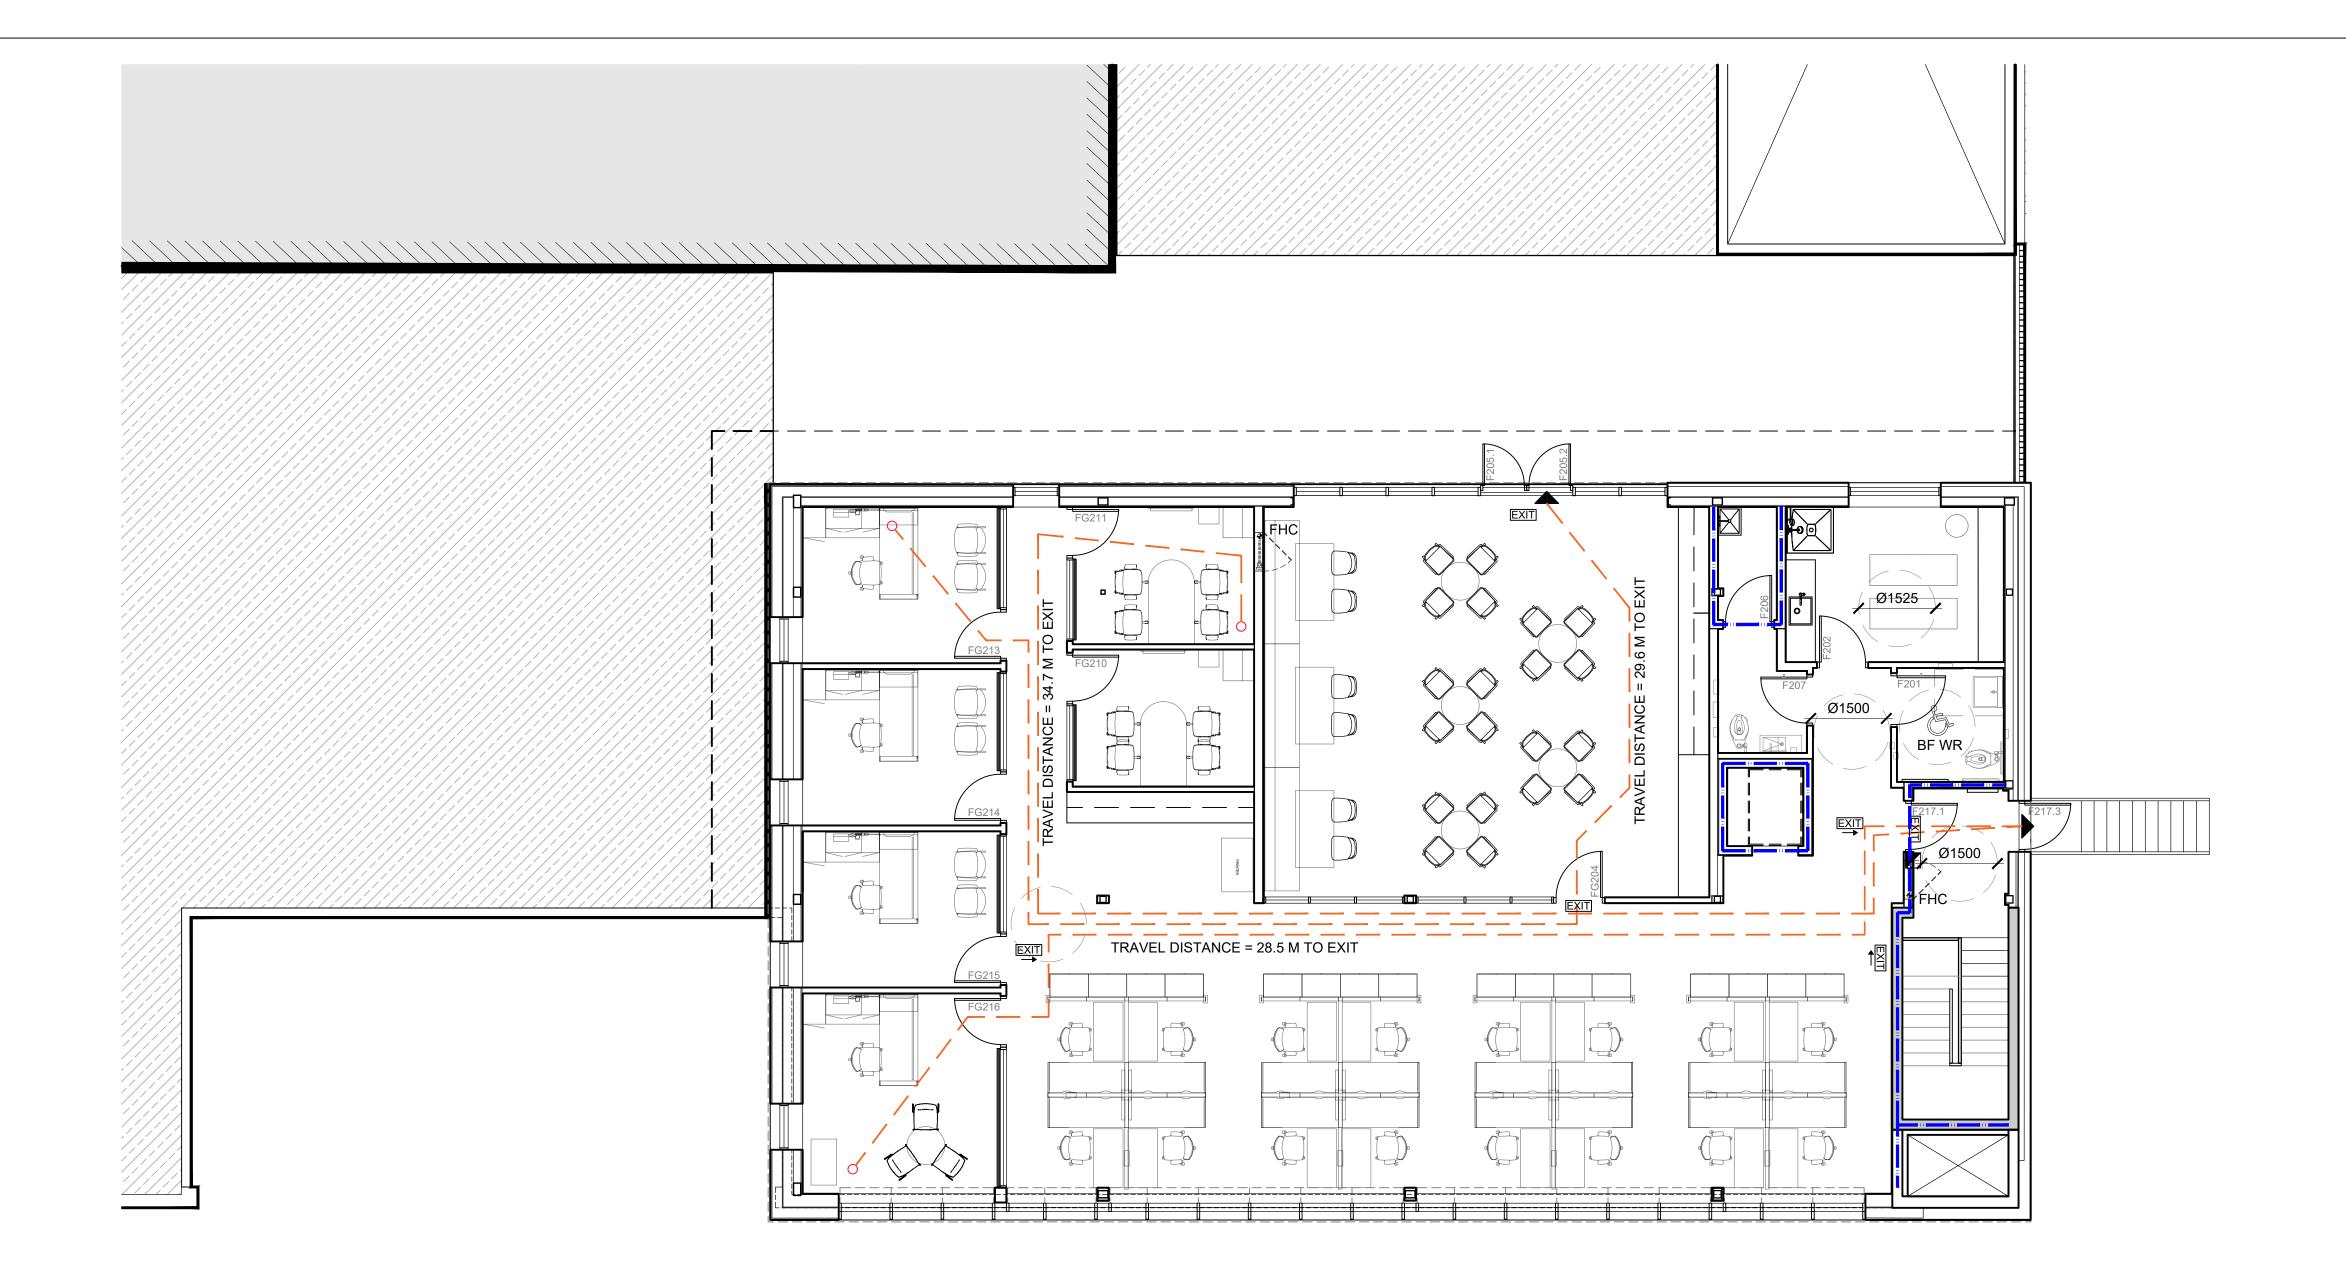



155 QUEEN ST NORTH HAMILTON, ONTARIO




Hamilton, Ontario L8P 1H1 Canada

T: 905-522-0220 interiors urban design

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LIFE SAFTEY PLAN - LEVEL 2

FIRE & LIFE SAFETY GENERAL NOTES: GENERAL REQUIREMENTS

- 1. FOR WALL ASSEMBLIES THAT BEAR THE NOTE '*CONSTRUCT AS FIRE SEPARATION WHERE NOTED', THE ASSEMBLY SHALL BE CONSTRUCTED AS A FIRE SEPARATION AT THE LOCATIONS
- INDICATED IN THE CONTRACT DRAWINGS. 2. ALL PENETRATIONS THROUGH NEW AND EXISTING FIRE SEPARATIONS ARE TO BE SEALED TO MEET REQUIREMENTS OF THE SEPARATION NOTED.
- 3. AT RECESSED PANEL INSTALLATIONS (E.G. ELECTRICAL PANELS) WITHIN RATED WALLS PROVIDE FOR CONTINUITY OF THE REQUIRED RATING BEHIND THE PANEL. REFER TO THE ONTARIO BUILDING CODE DIVISION B, SECTION 3.1.9.2 FOR REQUIREMENTS FOR COMBUSTIBILITY OF SERVICE PENETRATIONS AND SECTION 3.1.10.2 FOR RATING OF FIREWALLS.
- 4. WHERE FIRE RATED PARTITIONS ABUT NON-RATED PARTITIONS THE FIRE RATED ASSEMBLY SHALL BE CONTINUOUS AND UNINTERRUPTED BY THE ABUTTING WALLS TO MAINTAIN A

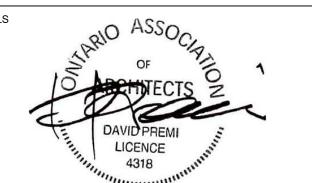 CONTINUOUS FIRE SEPARATION. CONTINUOUS FIRE SEPARATION.
- 5. SEAL PERIMETER OF FIRE RATED WALLS AND AROUND PENETRATIONS THROUGH FIRE RATED WALLS WITH APPROVED FIRESTOP MATERIALS. DO NOT SEAL CLEARANCE SPACES WITHIN FIRE DAMPERS. SEAL ONLY IN STRICT ACCORDANCE WITH MANUFACTURERS INSTRUCTIONS.

FIRE & LIFE SAFETY PLAN LEGEND OF SYMBOLS:

WORK NOT IN CONTRACT (NIC) LOCATION OF EXIT



FHC LOCATION OF NEW FIRE HOSE CABINET (FHC)
- REFER TO MECHANICAL DRAWINGS



LOCATION OF EMERGENCY LIGHTING -REFER TO ELECTRICAL DRAWINGS •14.32m TRAVEL DISTANCE

NEW FIRE PULL STATION

PARTITION FIRE RATINGS:

EXISTING FIRE RATED SEPARATION TO REMAIN

	SEL / II O (LI O I) E IVI/ III V
	PROPOSED NON-RATED EXTERIOR WALL
1.1	1 HOUR FIRE RATED SEPARATION

DRAWING TITLE:										
FIRE, LIFE SAFETY, &										
AODA PLAN										
LEVEL 2										

ISSUED FOR TENDER

PERMIT REVISION 01

ISSUED FOR PERMIT

ISSUES/REVISIONS

ISSUE DATE:	2023.09.06
DRAWN BY: AW	CHECKED BY: SL
PROJECT NO.: 12228	SCALE: 1:75
DRAWING NO.:	REVISION:


2023.09.06

2023.07.20


2023.05.16

DATE

DOOR, FRAME	OOR, FRAME & HARDWARE SCHEDULE																																	
			DIRECTION	N						DOOR					Fi	RAME	RE	FIRE QUIREMEN	ITS	BF O	PERATION	N .		DOOR (OPERATION				ACCES	SORIES			LOCKSET FUNCTION	
DOOR NUMBER	FROM ROOM#	FROM ROOM	TO ROOM #	# TO ROOM	EXISTING OR NEW	WIDTH (mm)	HEIGHT (mm)	THICKNESS (mm)	DOOR MATERIAL	DOOR FINISH	DOOR TYPE	GLAZING	FILM	LOUVER	FRAME MATERIAL	FRAME FINISH	FRAME TYPE	RATING * SMOKE SEAL	AUTO DOOR OPERATOR	ELECTRIC STRIKE	ACTUATOR BUTTON	PUSH TO LOCK	PANIC HARDWARE	DOOR CLOSER	DOOR LEVER	DOOR PUSH BAR	KICK PLATE	PUSH PLATE	WEATHER STRIP	FLOOR STOP	, DROP SEAL	SIGNAGE	STOREROOM OFFICE / PRIVACY The privacy The privacy of the priva	COMMENTS
F000.1		CORRIDOR	-	NEW UNIVERSAL WASHROOM	N	965	2134	45	WD	PNT-05	Α	-	-			ALU	А		•	•	•	•		•	•							•	•	
F000.2	-	CORRIDOR	-	EXISITNG MEN'S WASHROOM	N	965	2134	45	WD	PNT-05	А	-	-			ALU	А							•		•	•					•	•	
FG102		EXISTING WAITING ROOM	102	INTERVIEW ROOM	N	915	2134	35	WD	PNT-05	FG	Y	Y	- P	C350	ALU	Α								•					•		•	•	
FG100		EXISTING WAITING ROOM	101	EXISTING RECEPTION	N	915	2134	35	WD	PNT-05	В	Y	-			ALU	А		•	•	•	•		•	•							•	•	
FG105		CORRIDOR	105	FOCUS ROOM	N	915	2134	35	WD	PNT-05	Α	Y	-			ALU	Α								•					•		•	•	
FG106		CORRIDOR	106	PM WORK ROOM	N	915	2134	35	WD	PNT-05	Α	Υ	-			ALU	Α								•					•		•	•	
F107		EXISTING COFFEE ROOM	107	EXISTING COMMITTEE ROOM	EX	EX	EX	EX	EX	PNT-05	EX	EX	EX	EX	EX	EX	EX								•					•		•	•	
F108		EXISTING COMMITTEE ROOM	108	EXISTING STORAGE ROOM	EX	EX	EX	EX	EX	PNT-05	EX	EX	EX	EX	EX	EX	EX								•					•		•	•	
F113	114	EXISTING CORRIDOR	113	EXITING JANITORIAL CLOSET	EX	EX	EX	EX	EX	PNT-05	EX	EX	EX	EX	EX	EX	EX								•					•		•	•	
F112	114	EXISTING CORRIDOR	112	EXISTING GENDER INCLUSIVE WASHROOM	EX	EX	EX	EX	EX	PNT-05	EX	EX	EX	EX	EX	EX	EX								•					•		•	•	
F111		EXISTING CORRIDOR	111	EXISTING GENDER INCLUSIVE WASHROOM		EX	EX	EX		PNT-05	EX	EX			EX		EX								•					•		•	•	
F115		EXISTING CORRIDOR	115	EXISTING ELECTRICAL/SERVER ROOM	EX		EX	EX	EX	PNT-05	EX	EX			EX		EX								•					•		•	•	
F116		EXISTING CORRIDOR	116	EXISTING MACHINES ROOM	EX	EX	EX	EX	EX	PNT-05	EX	EX			EX		EX								•					•		•	•	
F117		EXISTING CORRIDOR	117	EXISTING WATER METER ROOM	EX	EX	EX	EX	EX	PNT-05	EX	EX	EX		EX		EX								•					•		•	•	
F118		EXISTING LOUNGE	118	GENDER INCLUSIVE WASHROOM	N	915	2134	35	WD	PNT-05	A	-	-			ALU	Α							_	•					•		•	•	
FG119.1	125	CORRIDOR	119	COPY/PRINT STATION ROOM	N	915	2134	35		PNT-05	В	Y	-			ALU	Α							•	•					•		•	•	
FG119.2		CORRIDOR	119	COPY/PRINT STATION ROOM	N	915	2134	35	WD	PNT-05	В	Y				ALU	Α						_	•	•		_			•		•	•	
F120		EXISTING CORRIDOR	-	STAIRWELL	N		2134	35		PNT-05	С	Y			C350			5 HR 🌘	•				•	•		•	•					•		
FG121	120	OPEN OFFICE	121	OFFICE	N				WD		1					ALU									•					•		•		
FG122		CORRIDOR	122	OFFICE	N		2134					Y			C350		A								•							•	•	
FG123		CORRIDOR	123	MEETING ROOM	N		2134	35		PNT-05	A	Y			C350		A		-						•					<u> </u>		•		
F201		CORRIDOR	201	BARRIER-FREE WASHROOM	N		2134	1		PNT-05	A		-			ALU			-	-	•	-		•	_							•	•	
F202		CORRIDOR	202	MULTI-PURPOSE ROOM	I N		2134	35		PNT-05	A	Y			C350		Α								•					•		•		
FG204		OPEN OFFICE LOUNGE	204	COFFEE BAR	IN N		2134	35	WD	PNT-05	A					ALU							-	_	•				_	•		•	 	
FG205.1 FG205.2		LOUNGE	-	ROOFTOP ROOFTOP	IN NI		2134 2134	35		PNT-05 PNT-05	ח		-			-							•	•					•				<u> </u>	
FG205.2 F206		GENDER INCLUSIVE	206	JANITORIAL/STORAGE CLOSET	N N	915	2134	35	WD	PNT-05	Δ		-			- ALU							•			-							 	+
F207	200	CORRIDOR	207	GENDER INCLUSIVE WASHROOM	N		2134	35		PNT-05	A		-		C350		A						+ -		•					•		•	•	
FG210		CORRIDOR	210	MEETING ROOM	N		2134			PNT-05	A	Y				ALU																	•	
FG211		CORRIDOR	211	MEETING ROOM	N	_	2134	35		PNT-05		Y			C350		A						+ -		-								<u> </u>	
FG213		CORRIDOR	213	OFFICE	N		2134	35	-	PNT-05	A	Y			C350		A								•								•	
FG214		CORRIDR	214	OFFICE	N			35	WD	PNT-05	A	Y			C350		A						+ -		-								•	
FG215		OPEN OFFICE	215	OFFICE	N			35		PNT-05	A	Y				ALU	A								-							-		
FG216		OPEN OFFICE	216	EXECUTIVE OFFICE	N		2134	35	_	PNT-05	A	Y				ALU									•								_	
F217.1		CORRIDOR	217	CORRIDOR	N	_	2134	35		PNT-05	A		-			ALU								•	-		•			_				
F217.3		CORRIDOR	-	OUTDOOR STAIRS		915					-		-			ALU				_	•		•	•			•			-			•	
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VICTORIA PARK COMMUNITY HOMES

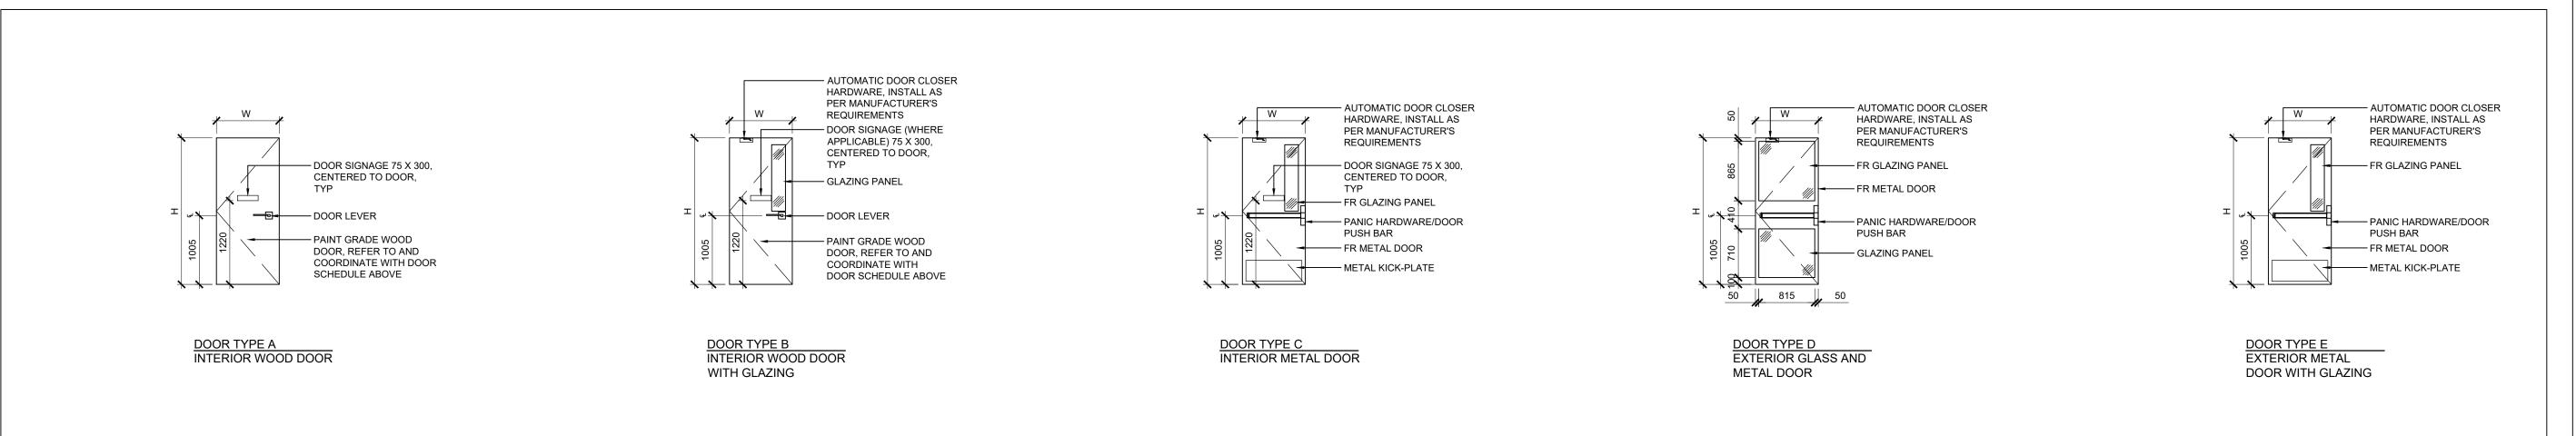VPCH OFFICE EXPANSION

155 QUEEN ST NORTH HAMILTON, ONTARIO

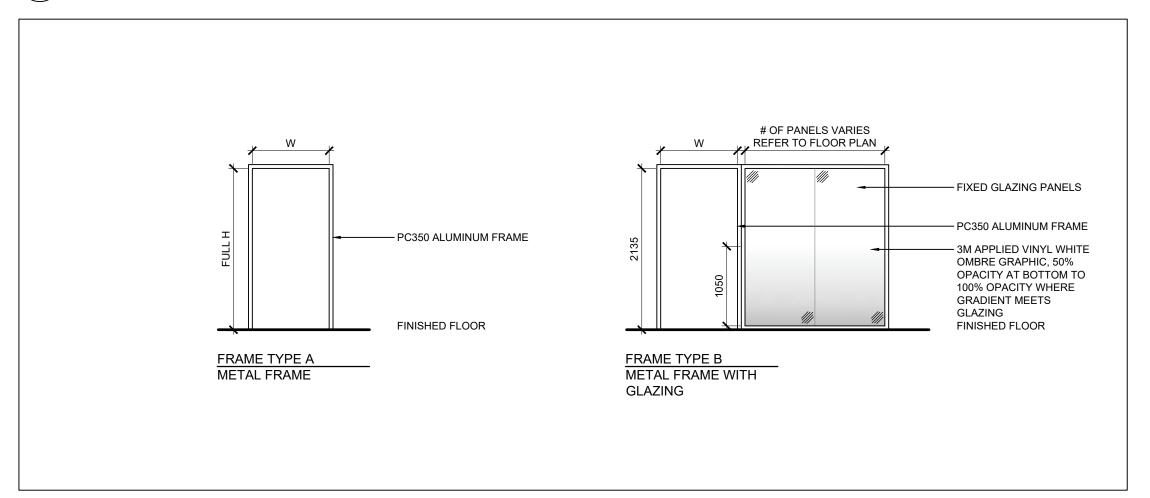

25 Main Street West Hamilton, Ontario L8P 1H1 Canada

T: 905-522-0220

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02	ISSUED FOR TENDER	2023.09.06							
01	ISSUED FOR PERMIT	2023.05.16							
NO.	ISSUES/REVISIONS	DATE							
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DOOR & GLAZING SCHEDULE

ISSUE DATE:		2023.	09.06
DRAWN BY: MM	CHECKE	D BY:	SL
PROJECT NO.: 12228	SCALE:	AS NO	TED
DRAWING NO.:	ĺ	REVIS	SION:

FINISH CODE	BM HA CODE	DESCRIPTION
C10	612	SATIN BRONZE, CLEAR COATED
C10B	613*	DARK OXIDIZED SATIN BRONZE, OIL RUBBED*
C14	618	BRIGHT NICKEL PLATED, CLEAR COATED
C15	619	SATIN NICKEL PLATED, CLEAR COATED
C19	622	FLAT BLACK COATED
C20	623	LIGHT OXIDIZED STATUARY BRONZE, CLEAR COATED
C20	690	DARK BRONZE PAINTED
C20A	624	DARK OXIDIZED STATUARY BRONZE, CLEAR COATED
C26	625	BRIGHT CHROMIUM PLATED
C26D	626	SATIN CHROMIUM PLATED
C27	627	SATIN ALUMINUM, CLEAR COATED
C28 OR AL	628	SATIN ALUMINUM, CLEAR ANODIZED
C28 OR AL	689	ALUMINUM PLATED
C2G	603	ZINC PLATED
C3	605	BRIGHT BRASS, CLEAR COATED
C32	629	BRIGHT STAINLESS STEEL
C32D	630	SATIN STAINLESS STEEL
C4	606	SATIN BRASS, CLEAR COATED
C5	609	SATIN BRASS, BLACKENED, SATIN RELIEVED, CLEAR COATED
C9	611	BRIGHT BRONZE, CLEAR COATED
CP	600	PRIMED FOR PAINTING
EAD	EAD	BRASS PAINTED
EB	EB	DARK BRONZE PAINTED
ED	ED	BLACK PAINTED
EN	EN	ALUMINUM PAINTED
K29	K29	BLACK ANODIZED ALUMINUM
K40	K40	DARK BRONZE ALUMINUM
NOTE: THE BASE M	ATERIAL (BRASS, BF	LOUR FROM ITEM TO ITEM AND WILL WEAR ACCORDING TO USE. RONZE, STEEL, ALUMINUM) DETERMINES WHICH FINISHES ARE AVAILABLE ARE ONLY AVAILABLE ON PRODUCTS MADE OF ALUMINUM)

Manual Content	E DOOR
Windlester	TA 744 4 5 4 DOD
15.00 10.0	TA714 4.5 x 4 BSP AHI DOOR LEVER PASS
March Marc	BASE BUILDING KEY WA
The control of the	HES 4500C 630 KIT INCLUDES: CM-A F50
Company Comp	CX-33, CX-WC11
ACCORDING ACCOUNTS CONTINUES CONTINUES ACCOUNTS ACCOU	FRAME CUTOUT NOT IN PULL STRINGS BY OTHI
March Marc	POWER, BLOCKING, DEV
The Control Appealment	SW100 PULL OPERATOR
MADE 1996	RICHELIEU 3" PROJECTIO
March Marc	S773BL 21FT E DOOR
Committed Comm	
Marie Mari	TA714 4.5 x 4 BSP AHI DOOR LEVER PRIVA
Control Amenic	SUGATSUNE/LAMP 758
Comment	<u>E DOOR</u>
10 Sept 10	TA714 4.5 x 4 BSP
1996-15 1996	A HI DOOR LEVER PASS SUGATSUNE/LAMP 758
### DESTRUCTION OF THE PROPERTY OF THE PROPERT	
Semantian Monoto Cont 1990-1500	FI
	BASE BUILDING KEY WA
	CC-0048-BSUC-TRILAR-
INCOME PARAMETERS	MKA2 DPDT MAINTAINE E DOOR
PRINCE P	
Control Cont	TA 714 4.5 x 4 BSP
ADMINISTRATION DESIGNED	AHI DOOR LEVER PASS SUGATSUNE/LAMP 758
INCOMES CONTROLOGICAL PROPERTY OF CONTROLO	
Control Cont	TA714 4.5 x 4 BSP
Transmit Content and June 1 Design Content State Design Conten	AHI DOOR LEVER PRIVA
MATERIAN	RICHELIEU 3" PROJECTIO
The control	MAG-MATE DIRECT-MOU
COMMINION CONTROLLED CONT	
CAMER OF AM PRINTED NOTE - 1997	TA714 4.5 x 4 BSP AHI DOOR LEVER PASS
PAYOR PAYO	RICHELIEU 3" PROJECTION
### PART ORACE CÓCIO DOUR PESSO PESSO PART ORACE CÓCIO DOUR PESSO PESSO PART ORACE CONTROL PESSO P	E DOOR
CONTRACTOR CON	TA714 4.5 x 4 BSP
	AHI DOOR LEVER PASS
EXERTING COMMETTER ROOM - DITT	RICHELIEU 3" PROJECTIO
LICOMERT 6379-1954-04 RESISTER 6570 ACCORDER 7480-1954-1950-1950-1950-1950-1950-1950-1950-1950	
RESTINGS PROPER PROPERTY PART STONE SHOULD SHOW 1 SMALE PROPERTY	TA714 4.5 x 4 BSP
MISSING PLANE	A HI DOOR LEVER PRIVA
Mathematical Math	
EASTERN ASKERN EASTERN SCORE PARKET FRAME LOCKERS ANTERN ASKERS FRAME CONTROL TO A MANUAL PROPERTY AND SET CONTROL TO A MANUAL PROPERTY ASKERS FRAME CONTROL TO A MANUAL PROPERTY ASKERS F	TA714 4.5 x 4 BSP
	AHI DOOR LEVER PRIVA
Mathematics	RICHELIEU 3" PROJECTIO
LICODEST_EATHORNUS OF STEEL 600	<u> </u>
ILCOTE PLAN LOCK PROPRIES AND ASSISTED SUSTING AND TOTAL CLOSET - DATE	TA714 4.5 x 4 BSP
MONTH MATCH MATC	A HI DOOR LEVER PRIVA
MIDDORELES AND AS EMBRES 0012	
DUSTING MACHINES STEEL 600	
AMDIOCREESES SATINSTANCESS STEEL 630	TA714 4.5 x 4 BSP AHI DOOR LEVER PRIVA
EXISTING SINGLE PROOF EXISTING SINGLE DOOR EXISTING SINGLE DOOR EXISTING SINGLE PROOF EXISTING SINGLE PROOF EXISTING DOOR EXISTI	RICHELIEU 3" PROJECTIO
EASTING DOOR, EASTING FRAME 4 COMPARATE BEARMS HABES AND CORP. LEVER PASSAGE 2-36* MODEL 12 LARGE CROLL ROSETTE MODEL 20 1 LACH CROUND BUT LEVER DEALERS STEEL 500 EXISTING WARTER METERS ROOM - D1171 EXISTING SINCLE DOOR	<u> E DOOR</u>
EXISTING WATER METER ROOM - D1171 EXISTING SINGLE DOOR	TA714 4.5 x 4 BSP
EXSTINUS DOOR / EXISTING FRAME	SARGENT 8815 ETL RIM
SENDER INCLUSIVE WASHROOM - D1181	LCN 4021-REG RH/LH A RICHELIEU 3" PROJECTION
945mm x2134mm x35mm	GSH80A 8 X 36.5 TAPE
CONCSALED BEARING HINGE	<u>E DOOR</u>
WALL STOP, CHROME & WHITE TIP	TA714 4.5 x 4 BSP
14 15 15 15 15 15 15 15	SARGENT 8815 ETL RIM
915mm x2134mm x35mm	RICHELIEU 3" PROJECTION
4 EACH CONCEALED BEARING HINGE TA714 4.5 x 4 BSP 915mm x 2134mm x 35mm 1 EACH LOCKSET, SATIN STAINLESS STELE 630 A HI DOOR LEVER PASSAGE 2-3/8" MODEL 152, LARGE CIRCLE ROSEITE MODEL 201 EACH MORTISE CY LINDER 1 EACH LOCKSET, SATINISTAINLESS STELE, 304 SUGAT SUNBILLAMP 75872170 DOOR STOPPER 35mm DIA X 50mm H 1 ACCESS CARD READER, BLACK STAIRWELL - D1201 1 SINGLE DOOR LH 1 EACH ROOM EXIT DEVICE, SATIN STAINLESS STELE, 630 915mm x 2134mm x 35mm FR ALUMINIUM DOOR / HOLLOW METAL FRAME 1 EACH ROOM EXIT DEVICE, SATIN STAINLESS STEEL 630 4 CONCEALED BEARINS HINGE TA714 4.5 x 4 BSP 1 EACH ROOM EXIT DEVICE, SATIN STAINLESS STEEL 630 1 EACH ROOM EXIT DEVICE, SATIN STAINLESS STEEL 630 1 EACH ROOM EXIT DEVICE, SATIN STAINLESS STEEL 630 1 EACH SOWN EXIT DEVICE, SATIN STAINLESS STEEL 630 1 EACH SOWN EXIT DEVICE, SATIN STAINLESS STEEL 630 1 EACH SOWN EXIT DEVICE, SATIN STAINLESS STEEL 630 1 EACH SOWN EXIT DEVICE, SATIN STAINLESS STEEL 630 1 EACH SOWN EXIT DEVICE, SATIN STAINLESS STEEL 630 1 EACH SOWN EXIT DEVICE, SATIN STAINLESS STEEL 630 1 EACH SOWN EXIT DEVICE, SATIN STAINLESS STEEL 630 1 EACH SOWN EXIT DEVICE, SATIN STAINLESS STEEL 630 1 EACH SOWN EXIT DEVICE, SATIN STAINLESS STEEL 630 1 EACH SOWN EXIT DEVICE, SATIN EXIT DEVICE, SATIN EXIT DEVICE, SATIN STAINLESS STEEL 630 1 EACH SOWN EXIT DEVICE, SATIN STAINLESS STEEL 630 1 EACH SOWN EXIT DEVICE, SATIN EXIT DEVICE, SATIN EX	GSH80A 8 X 36.5 TAPE
1 EACH LOCKSET, SATIN STANLESS STEEL 630 AH DOOR LEVER PASSAGE 2-3/8" MODEL 152, LARGE CIRCLE ROSETTE MODEL 201 EACH MORTISE CY LINDER 1 EACH DOOR CLOSER, ALLUMNUM LON 4021-REG RHULH AL CLOSER TOP JAMB RIGHT HANDLETT HAND 1 KEY ING 1 EACH FLOOR STOP, STAINLESS STEEL 304 SUGAT SUNELAMP 75872170 DOOR STOPPER 35mm DA X 50mm H 1 ACCESS CARD READER, BLACK STAIRWELL - D1201 1 SINGLE DOOR LH 1 EACH ROOM EXIT DEVICE, SATIN STAINLESS STEEL 630 1 EACH ROOM EXIT DEVICE, SATIN STAINLESS STEEL 630 1 EACH ROOM EXIT DEVICE, SATIN STAINLESS STEEL 630 1 EACH ROOM EXIT DEVICE, SATIN STAINLESS STEEL 630 1 EACH ROOM EXIT DEVICE, SATIN STAINLESS STEEL 630 1 EACH ROOM EXIT DEVICE, SATIN STAINLESS STEEL 630 1 EACH ROOM EXIT DEVICE, SATIN STAINLESS STEEL 630 1 EACH ROOM EXIT DEVICE, SATIN STAINLESS STEEL 630 1 EACH ROOM EXIT DEVICE, SATIN STAINLESS STEEL 630 1 EACH ROOM EXIT DEVICE, SATIN STAINLESS STEEL 630 1 EACH ROOM EXIT DEVICE, SATIN STAINLESS STEEL 630 1 EACH ROOM EXIT DEVICE, SATIN STAINLESS STEEL 630 1 EACH SWITCH STAINLESS STEEL 630 1 EACH SWITCH STAINLESS STEEL 630 1 EACH BOALD STAINLESS STEEL 630 1 EACH ROOM EXIT DEVICE, SATIN STAINLESS STEEL 630 1 EACH ROOM EXIT DEVICE, SATIN STAINLESS STEEL 630 1 EACH SWITCH STAINLESS STEEL 630 1 SINGLE DOOR RH	<u> EDOOR</u>
1 EACH FLOOR STOP, STAINLESS STEEL 304 SUGATSUNE/LAMP 75872170 DOOR STOPPER 35mm DIA X 50mm H 1 ACCESS CARD READER, BLACK STARWELL - D1201 1 SINGLE DOOR LH 1 EACH ROOM EXIT DEVICE, SATIN STAINLESS STEEL 630 915mm x 2134mm x 35mm TA714 4.5 x 4 BSP 1 EACH BOOR FLOOR STOP JAMB RIGHT HAND 1 EACH KEY SWITCH - SINGLE GANG 1 EACH DOOR CLOSER ALUMINUM LCN 4021-REG RH/LH AL CLOSER TOP JAMB RIGHT HANDLEFT HAND 1 EACH KEY SWITCH - SINGLE GANG 1 WALL STOP, CHROME & WHITE TIP RICHELIEU 3" PROJECTION RIGID DOOR STOP 216CV. 25mm DJA BASE 17mm DJA TIP LH 1 EACH BOOR ALUMINUM 1 SINGLE DOOR LH 915mm x 2134mm x 35mm PAINT-GRADE WOOD DOOR / PC350 FRAME 4 CONCEALED BEARING HINGE TA714 4.5 x 4 BSP 1 LOCKSET, SATIN STAINLESS STEEL 630 AH DOOR LEVER PASSAGE 2-3/8" MODEL 152, LARGE CIRCLE ROSETTE MODEL 201 1 FLOOR STOP, STAINLESS STEEL 304 SUGATSUNE/LAMP 75872170 DOOR STOPPER 35mm DJA X 50mm H OFFICE - D1221 1 SINGLE DOOR RH 915mm x 2134mm x 35mm PAINT-GRADE WOOD DOOR / PC350 FRAME 4 CONCEALED BEARING HINGE TA714 4.5 x 4 BSP 1 LOCKSET, SATIN STAINLESS STEEL 303 AH DOOR LEVER PASSAGE 2-3/8" MODEL 152, LARGE CIRCLE ROSETTE MODEL 201	BASE BUILDING KEY WA
1 SINGLE DOR 1 SINGLE Sing	GMK TO BUILDING SYST
4 CONCEALED BEARING HINGE TA714 4.5 x 4 BSP SARGENT 8815 ETL RIM EXIT DEVICE PANIC BAR & PASSAGE LEVER 8815FETLUS32DLHR 1 EACH ROOM EXIT DEVICE, SATIN STAINLESS STEEL 630 SARGENT 8815 ETL RIM EXIT DEVICE PANIC BAR & PASSAGE LEVER 8815FETLUS32DLHR 1 EACH BOOR CLOSER, ALUMNUM LCN 4021-REG RH/LH AL CLOSER TOP JAMB RIGHT HAND/LEFT HAND 1 WALL STOP, CHROME & WHITE TIP RICHELIEJ 3" PROJECTION RIGID DOOR STOP 216CV, 25mm DIA BASE, 17mm DIA TIP 1 EACH KICKPLATE GSH80A 8 X 36.5 TAPE C32 PAINT-GRADE WOOD DOOR / PC350 FRAME 4 CONCEALED BEARING HINGE TA714 4.5 x 4 BSP 1 LOCKSET, SATIN STAINLESS STEEL 630 AH DOOR LEVER PASSAGE 2-38" MODEL 152, LARGE CIRCLE ROSETTE MODEL 201 1 ELOOR STOP, STAINLESS STEEL 304 SUGATSUNEILAMP 75872170 DOOR STOPPER 35mm DIA X 50mm H 1 SIGNED DOOR PAINT-GRADE WOOD DOOR / PC350 FRAME 4 CONCEALED BEARING HINGE TA714 4.5 x 4 BSP 1 LOCKSET, SATIN STAINLESS STEEL 630 AH DOOR LEVER PASSAGE 2-38" MODEL 152, LARGE CIRCLE ROSETTE MODEL 201 1 CONCEALED BEARING HINGE TA714 4.5 x 4 BSP 1 LOCKSET, SATIN STAINLESS STEEL 630 AH DOOR LEVER PASSAGE 2-38" MODEL 152, LARGE CIRCLE ROSETTE MODEL 201 1 CONCEALED BEARING HINGE TA714 4.5 x 4 BSP 1 LOCKSET, SATIN STAINLESS STEEL 630 AH DOOR LEVER PASSAGE 2-38" MODEL 152, LARGE CIRCLE ROSETTE MODEL 201 1 WALL STOP, CHROME & WHITE TIP RICHELIEJ 3" PROJECTION RIGID DOOR STOP 216CV, 25mm DIA BASE, 17mm DIA TIP	SARGENT 8815 ETL RIM
1 EACH ROOM EXIT DEVICE, SATIN STAINLESS STEEL 630 SARGENT 8815 ETL RIM EXIT DEVICE PANIC BAR & PASSAGE LEVER 8815FETLUS32DLHR 1 EACH DOOR CLOSER, ALUMINUM LON 4021-REG RH/LH AL CLOSER TOP JAMB RIGHT HAND/LEFT HAND 1 WALL STOP, CHROME & WHITE TIP RICHELIEU 3" PROJECTION RIGID DOOR STOP 216CV, 25mm DIA BASE, 17mm DIA TIP 1 EACH KICKPLATE GSH80A 8 X 36.5 TAPE C32 CFRICE - D1211 1 SINGLE DOOR TA714 4.5 x 4 BSP 1 LOCKSET, SATIN STAINLESS STEEL 630 AHI DOOR LEVER PASSAGE 2-3/8" MODEL 152, LARGE CIRCLE ROSETTE MODEL 201 1 FLOOR STOP, STAINLESS STEEL 304 9 CINCEALED BEARING HINGE 1 SINGLE DOOR TA714 4.5 x 4 BSP 9 SAMDT-GRADE WOOD DOOR / PC350 FRAME 4 CONCEALED BEARING HINGE 1 SINGLE DOOR PAINT-GRADE WOOD DOOR / PC350 FRAME 4 CONCEALED BEARING HINGE 1 SINGLE DOOR PAINT-GRADE WOOD DOOR / PC350 FRAME 4 CONCEALED BEARING HINGE 1 SINGLE DOOR PAINT-GRADE WOOD DOOR / PC350 FRAME 4 CONCEALED BEARING HINGE 1 SINGLE DOOR PAINT-GRADE WOOD DOOR / PC350 FRAME 4 CONCEALED BEARING HINGE 1 CONCEALED BEARING HINGE 1 AT14 4.5 x 4 BSP 1 LOCKSET, SATIN STAINLESS STEEL 630 AHI DOOR LEVER PASSAGE 2-3/8" MODEL 152, LARGE CIRCLE ROSETTE MODEL 201 1 WALL STOP, CHROME & WHITE TIP RICHELIEU 3" PROJECTION RIGID DOOR STOP 216CV, 25mm DIA BASE, 17mm DIA TIP	CC-0048-BSUC-TRILAR-
1 EACH DOOR CLOSER, ALUMINUM LCN 4021-REG RH/LH AL CLOSER TOP JAMB RIGHT HAND/LEFT HAND 1 WALL STOP, CHROME & WHITE TIP RICHELIEU 3" PROJECTION RIGID DOOR STOP 216CV, 25mm DIA BASE, 17mm DIA TIP 1 EACH KICKPLATE GSH80A 8 X 36.5 TAPE C32 OFRCE - D1211 1 SINGLE DOOR LH 915mm x 2134mm x 35mm PAINT-GRADE WOOD DOOR / PC350 FRAME 4 CONCEALED BEARING HINGE TA714 4.5 x 4 BSP 1 LOCKSET, SATIN ISSAN ILESS STEEL 630 AH I DOOR LEV'ER PASSAGE 2-3/8" MODEL 152, LARGE CIRCLE ROSETTE MODEL 201 1 FLOOR STOP, STAINLESS STEEL 304 SUGATSUNE/LAMP 75872170 DOOR STOPPER 35mm DIA X 50mm H 0FRCE - D1221 1 SINGLE DOOR RH 915mm x 2134mm x 35mm PAINT-GRADE WOOD DOOR / PC350 FRAME 4 CONCEALED BEARING HINGE TA714 4.5 x 4 BSP 1 LOCKSET, SATIN STAINLESS STEEL 630 AH I DOOR LEV'ER PASSAGE 2-3/8" MODEL 152, LARGE CIRCLE ROSETTE MODEL 201 1 LOCKSET, SATIN STAINLESS STEEL 630 AH ID DOOR LEV'ER PASSAGE 2-3/8" MODEL 152, LARGE CIRCLE ROSETTE MODEL 201 1 WALL STOP, CHROME & WHITE TIP RICHELIEU 3" PROJECTION RIGID DOOR STOP 216CV, 25mm DIA BASE, 17mm DIA TIP	MKA2 DPDT MAINTAINEI CX12 SWITCHING RELA
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1 WALL STOP, CHROME & WHITE TIP RICHELIEU 3" PROJECTION RIGID DOOR STOP 216CV, 25mm DIA BASE, 17mm DIA TIP	
MEETING ROOM - D1231 1 SINGLE DOOR LH	
915mm x 2134mm x 35mm PAINT-GRADE WOOD DOOR / PC350 FRAME	
4 CONCEALED BEARING HINGE TA714 4.5 x 4 BSP 1 LOCKSET, SATIN STAINLESS STEEL 630 AHI DOOR LEVER PASSAGE 2-3/8" MODEL 152, LARGE CIRCLE ROSETTE MODEL 201	

RICHELIEU 3" PROJECTION RIGID DOOR STOP 216CV, 25mm DIA BASE, 17mm DIA TIP

1 LOCKSET, SATIN STAINLESS STEEL 630 1 WALL STOP, CHROME & WHITE TIP



VPCH OFFICE EXPANSION

155 QUEEN ST NORTH HAMILTON, ONTARIO



WOOD DOOR / HOLLOW METAL FRAME

PAINT-GRADE WOOD DOOR / PC350 FRAME

FR ALUMINIUM DOOR / HOLLOW METAL FRAME

FR METAL EXTERIOR DOOR / HOLLOW METAL FRAME

FR ALUMINIUM DOOR / HOLLOW METAL FRAME

FR METAL & GLASS EXTERIOR DOOR / HOLLOW METAL FRAME

AHI DOOR LEVER PASSAGE 2-3/8" MODEL 152, LARGE CIRCLE ROSETTE MODEL 201

RICHELIEU 3" PROJECTION RIGID DOOR STOP 216CV, 25mm DIA BASE, 17mm DIA TIP

AHI DOOR LEVER PRIVACY 2-3/8" MODEL 152, LARGE CIRCLE ROSETTE MODEL 201

A HI DOOR LEVER PASSAGE 2-3/8" MODEL 152, LARGE CIRCLE ROSETTE MODEL 201

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SARGENT 8815 ETL RIM EXIT DEVICE PANIC BAR & PASSAGE LEVER 8815FETLUS32DLHR

SARGENT 8815 ETL RIM EXIT DEVICE PANIC BAR & PASSAGE LEVER 8815FETLUS32DLHR

SARGENT 8815 ETL RIM EXIT DEVICE PANIC BAR & PASSAGE LEVER 8815FETLUS32DLHR

RICHELIEU 3" PROJECTION RIGID DOOR STOP 216CV, 25mm DIA BASE, 17mm DIA TIP

RICHELIEU 3" PROJECTION RIGID DOOR STOP 216CV, 25mm DIA BASE, 17mm DIA TIP

LCN 4021-REG RH/LH AL CLOSER TOP JAMB RIGHT HAND/LEFT HAND

LCN 4021-REG RH/LH AL CLOSER TOP JAMB RIGHT HAND/LEFT HAND

KIT INCLUDES: CM-A F500, CM-400/8, CX-MDC, CX-33, 2 x CM-45/4, CX-MDC,

POWER, BLOCKING, DEVICE BOXES AND PULL STRINGS BY OTHERS

SUGATSUNE/LAMP 75872170 DOOR STOPPER 35mm DIA X 50mm H

SUGATSUNE/LAMP 75872170 DOOR STOPPER 35mm DIA X 50mm H

SUGATSUNE/LAMP 75872170 DOOR STOPPER 35mm DIA X 50mm H

BASE BUILDING KEYWAY

GSH80A 8 X 36.5 TAPE C32

GSH80A 8 X 36.5 TAPE C32

BASE BUILDING KEYWAY GMK TO BUILDING SYSTEM

CC-0048-BSUC-TRILAR-02

CX12 SWITCHING RELAY

MKA2 DPDT MAINTAINED KEYSWITCH C32D

GMK TO BUILDING SYSTEM CC-0048-BSUC-TRILAR-02

MKA2 DPDT MAINTAINED KEYSWITCH C32D

MAG-MATE DIRECT-MOUNT FP01 5" X 4" X 2-1/2"

BASE BUILDING KEYWAY

FRAME CUTOUT NOT INCLUDED PULL STRINGS BY OTHERS


SW100 PULL OPERATOR 51 INCH CLEAR

25 Main Street West Hamilton, Ontario L8P 1H1 Canada

T: 905-522-0220

DRAWINGS ARE NOT TO BE SCALED. CONTRACTOR MUST VERIFY ALL DIMENSIONS ON THE JOB AND REPORT ANY DISCREPANCY TO ARCHITECTS BEFORE PROCEEDING WITH WORK.

ALL DRAWINGS AND SPECIFICATIONS ARE THE PROPERTY OF THE ARCHITECT AND MUST BE RETURNED AT THE COMPLETION OF THE WORK.

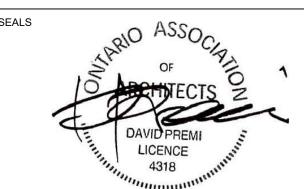



02	ISSUED FOR TENDER	2023.09.06
01	ISSUED FOR PERMIT	2023.05.16
NO.	ISSUES/REVISIONS	DATE

HARDWARE SCHEDULES

DRAWING TITLE:

ISSUE DATE:	2023.09
DRAWN BY: MM	CHECKED BY:
PROJECT NO.: 12228	SCALE: AS NOT
DRAWING NO :	I BEVISIO

FURNITURE SCHEDULE PROJECT: VICTORIA PARK COMMUNITY HOMES PROJECT #: 12228 PROJECT ADDRESS: 155 QUEEN STREET N, HAMILTON, ONTARIO, CANADA DATE: 2022.11.XX TAG. WAGE DOM: WANUFACTURED MORE WANUFACTURED WANUFACTURED											TORIA PARK 2228 PRESS: 155 C
TAG	IMAGE	TYPE	ROOM	MANUFACTURER + MODEL	SPECIFICATIONS	DIMENSIONS	FINISH	NOTES	VENDOR/SUPPLIER/LINK	TAG	
CG-01		CONSOLE	INTERVIEW ROOM	MANUFACTURER: STEELCASE MODEL: UNIVERSAL STORAGE CABINET	PROUD STEEL LAMINATE FRONT WITH LEDGE PULL CW COMMON WORKSURFACE TO MATCH UNIVERSAL BASE	WIDTH: 36" DEPTH: 24" H∃GHT: 28"	WHITE		STELCASE https://www.steelcase.com/products/systems-storage/universalstorage/	ACT-01	
CG-02		FILING CABINET	THROUGHOUT	SELECTION BY CLIENT						BS-01	
CG-03		FILING CABINET	THROUGHOUT	SELECTION BY CLIENT						CPT-01	
CHAIRS		TASK CHAIR	THROUGHOUT	SELECTION BY CLIENT						CTL-01	
CH-02	厢	LOUNGECHAIR	EXISTING WAITING ROOM 100	MANUFACTURER: MATTIAZZI MODEL: CLERICI LOUNGE CHAIR	SOLID OAK WOOD	WDTH: 33.07" DEPTH: 25.78" HEIGHT: 27.55" SEAT HEIGHT: 15.35"	NATURAL OAK WOOD	BIFMA COMPLIANT FSC CERTIFIED WOOD 2 Y EAR WARRANTY	STEELCASE https://www.steelcase.com/products/lounge-chairs/clerici-lounge/	HPL-01	
CH-03		COUNTER STOOL	EXISTING LOUNGE 110	MANUFACTURER: BLUDOT MODEL: READY STACKING COUNTER STOOL	POWDER-COATED STEEL LEGS WITH RUBBER FEET MOLDED PLYWOOD SEAT WITH ASH WOOD VENEER STACKING	WIDTH: 20" DEPTH: 19" HEIGHT: 27" SEAT HEIGHT: 25"	BLACK	BIFMA COMPLIANT	STELCASE https://www.bludot.com/ready- stacking-counter-stool.html	HPL-02	
CH-04	F	DINING CHAIR	DINING CHAIR	MANUFACTURER: STEELCASE MODEL: SIMPLE CHAIR	POLYPROPYLENE AND STEEL FRAME WOOD SEAT STACKS 4-HIGH	WIDTH: 19 2/3" DEPTH: 19 2/3" HEIGHT: 31 8/9" SEAT HEIGHT: 17 5/7"	BLACK 7207	BIFMA COMPLIANT 12 YEAR WARRANTY	STELCASE https://www.steelcase.com/products/side-guest-chairs/simple-chair/	LVT-01	
CH-05		DINING CHAIR	DINING CHAIR	MANUFACTURER: BLUDOT MODEL: CLEAN CUT CHAIR	3D BENT PLY WITH WOOD VENEER	WDTH: 19" DEPTH: 18" HEIGHT: 31" SEAT HEIGHT: 19"	WHITE OAK SEAT BLACK POWDER-COATED STEEL BASE	BIFMA COMPLIANT	STEELCASE https://www.bludot.com/clean- cut-dining-chair.html	PNT-01	
CH-06	1/	STOOL	MULTI-PURPOSE ROOM 202	MANUFACTURER: MATTIAZZI MODEL: CUGINO STOOL	SOLID OAK WOOD	WIDTH: 12.99" DEPTH: 12.99" HEIGHT: 17.71"	NATURAL OAK WOOD	BIFMA COMPLIANT FSC CERTIFIED WOOD 2 Y EAR WARRANTY	STELCASE https://www.steelcase.com/products/stools/cugino-stool/	PNT-02	
	300034003777504404002	T			SOFT GOODS					PNT-03	
SG-01		SOFA	EXISTING WAITING ROOM 100	MANUFACTURER: BLUDOT MODEL: CLEON 56" ARMLESS SOFA	SOLID HARDWOOD FRAME SINUOUS STEEL SPRINGS FOAM AND DACRON FIBER FILLED CUSHIONS ANILINE LEATHER, BURNISHED AND POLISHED	WIDTH: 56" DEPTH: 36" HEIGHT: 28" SEAT HEIGHT: 17" SEAT DEPTH: 26"	SLATE LEATHER		STELCASE https://www.bludot.com/cleon- modern-unarmed-sofa.html	PMT 04	
SG-02		BENCH	LOUNGE 205	MANUFACTURER: COALESSE MODEL: TOGETHER BENCH	STRAIGHT WITH BACK	WIDTH: 96.5" DEPTH: 26.75" HEIGHT: 31" SEAT HEIGHT: 18.5"	DESIGNTEX BIRDSEYE GROUP 7	SCS INDOOR ADVANTAGE GOLD CERTIFIED BIFMA LEVEL 2 LIMITED LIFETIME WARRANTY	STELCASE https://www.bludot.com/cleon-modern-unarmed-sofa.html	PNT-04	
SG-03	*Image does not reflect finishes*	GUEST CHAIR	OFFICES THROUGHOUT	MANUFACTURER: WEST ELM MODEL: SLOPE GUEST CHAIR		WDTH: 19.25" DEPTH: 21.5" HEIGHT: 33.25" SEAT HEIGHT: 18.75"	STEELCASE NEW BLACK HARLEY GROUP 7 STEELCASE 4CZ4 MERLOT BASE	BIFMA COMPLIANT LIMITED LIFETIME WARRANTY	STELCASE https://www.steelcase.com/products/side-guest-chairs/west-elm-work-slope-made-to-order/	PNT-05	
TABLES										PTL-01	
TB-01	*Image does not reflect finish*	SIDETABLE	EXISTING WAITING ROOM 100	MANUFACTURER: MEMO MODEL: KINO STOOL	KNO1-S1-WOA STACKING	WIDTH: 15.75" DEPTH: 17.75" H⊟GHT: 15.75"	OAK OVER ASH		STELCASE https://www.bludot.com/cleon-modern-unarmed-sofa.html	ST-01	
TB-02		DINING TABLE	LOUNGE 205	MANUFACTURER: BOLIA MODEL: TURNED DINING TABLE		DIAMETER: 29.52" HEIGHT: 27.75"	LACQUERED OAK	EN COMPLIANT FSC CERTIFIED WOOD 10 YEAR WARRANTY	STELCASE https://www.steelcase.com/products/occasional-tables/turned-dining-table/	TFL-01	
TB-03	JJ	DINING TABLE	LOUNGE 205	MANUFACTURER: STEELCASE MODEL: SYLVI BOOTH COLLABORATIVE TABLE		WIDTH: 60" DEPTH: 30" HEIGHT: 26.5"	ARCTIC WHITE	BIFMA COMPLIANT LIMITED LIFETIME WARRANTY	STELCASE https://www.steelcase.com/products/education-desks-tables/sylvi-booth-collaborative-table/	TFL-02	
TABLELAMPS		T							LICHTECOM		
TL-01		TABLE LAMP	EXISTING RECEPTION 101	MANUFACTURER: FLOS MODEL: BELLHOP PORTABLE TABLE LAMP	F1060009 2.5W LED 2700K CRI90 250lm INDOOR IP20 120V	DAMETER: 12.45cm HEIGHT: 21.08cm	WHITE	1 YEAR WARRANTY	LIGHTFORM https://www.lightformshop.com/t able-lamps/portable- lamps/bellhop-portable-table	TFL-03	
WORKSTATION	s										403 // 12
WS-01		WORKSTATION	THROUGHOUT	SELECTION BY CLIENT						TFL-04	

	PROJECT #: 122	ORIA PARK COMMUNITY HOI 228 RESS: 155 QUEEN STREET N,									
LINK	TAG	TAG IMAGE TYPE ROOM MANUFACTURER + MODEL SPECIFICATIONS DIMENSIONS FINISH NOTES VENDOR/SUPPLIER/LINK									
om/pro niversal-	ACT-01		ACOUSTIC CELING TILE	CELING THROUGHOUT	MANUFACTURER: ARMSTRONG MODEL: CANYON FOR PRELUDE XL MAX	CLASS A (UL) FIRE PERFORMANCE MINERAL FIBRE HUMIGUARD PLUS SAG/HUMIDITY RESISTANCE SQUARELAY-IN	WIDTH: 23-13/16" LENGTH: 47-13/16" THICKNESS: 5/8"	1488 IN WHITE (WH)	0.65 NRC 35 CAC 80% LIGHT REFLECTANCE 44% RECYCLED CONTENT	ARMSTRONG	VICTORIA PARK COMMUNITY HOMES
	BS-01		BASEBOARD	WALL BASE THROUGHOUT	MANUFACTURER: JOHNSONITE MODEL: TRADITIONAL WALL BASE	TYPETV WITH TOE	THICKNESS: 1/8" HEIGHT: 2.5"	38 PEWTER CG		TARKETT	VPCH OFFICE EXPANSION 155 QUEEN ST NORTH HAMILTON, ONTARIO
	CPT-01		CARPET TILE	FLOORING THROUGHOUT	MANUFACTURER: MOHAWK MODEL: TIMELESS TAILORED COLLECTION	GT469	LENGTH: 36" WIDTH: 12"	DISTRESSED TWILL IRON 969		MOHAWK GROUP	
	CTL-01		CERA MIC TILE	WALL TILE THROUGHOUT	MANUFACTURER: CENTURA MODEL: RAINBOW	#FL216WM GLAZED	LENGTH: 16" WIDTH: 4"	WHITE MATTE		CENTURA TILE	25 Main Street West Hamilton, Ontario L8P 1H1 Canada architecture interiors T: 905-522-0220
om/pro i-	HPL-01		HIGH- PRESSURE LA MINA TE	HORIZONTAL MILLWORK SURFACES THROUGHOUT	MANUFACTURER: PANOLAM MODEL: BURGUNDY	SR521 STANDARD HPL		TEXTURED/SUEDE (SD)		PANOLAM	DRAWINGS ARE NOT TO BE SCALED.
eady-	HPL-02		HIGH- PRESSURE LA MINA TE	HORIZONTAL MILLWORK SURFACES THROUGHOUT	MANUFACTURER: NEVAMAR MODEL: BLACK	S6001 STANDARD HPL		SUPER MATTE (SM)		PANOLAM	CONTRACTOR MUST VERIFY ALL DIMENSIONS ON THE JOB AND REPORT ANY DISCREPANCY TO ARCHITECTS BEFORE PROCEEDING WITH WORK. ALL DRAWINGS AND SPECIFICATIONS ARE THE PROPERTY OF THE ARCHITECT AND MUST BE RETURNED AT THE COMPLETION OF THE WORK.
ni om/pro imple-	LVT-01		LUXURY VINYL TILE		MANUFACTURER: MOHAWK GROUP MODEL: LARGE AND LOCAL WOOD	C0128	LENGTH: 59" WIDTH: 9.25" THICKNESS: 4.5mm WEAR LAYER: 20 MIL	UNICOI 822 M-FORCE ULTRA ENHANCED URETHANE	100% CARBON NEUTRAL PLUS 5%	MOHAWK GROUP	SEALS SEALS OF OF 10 ASSOCIATION OF 10 ASSOCIATION 10 ASSOCIATIO
elean-	PNT-01		PA INT	WALL PAINT THROUGHOUT	MANUFACTURER: BENJAMIN MOORE MODEL: CHANTILLY LACE	OC-65	NA	EGGSHELL		BENJA MIN MOORE	DAVID PREMI LICENCE 4318
om/pro	PNT-02		PA INT	WALL PAINT THROUGHOUT	MANUFACTURER: BENJAMIN MOORE MODEL: CLASSIC BURGUNDY	HC-182	N/A	EGGSHELL		BENJA MIN MOORE	""mmmm"
Noon	PNT-03		PA INT	CELING PAINT THROUGHOUT	MANUFACTURER: BENJAMIN MOORE MODEL: CHANTILLY LACE	OC-65	N/A	FLAT		BENJA MIN MOORE	
eleon-	PNT-04		PA INT	CELING PAINT	MANUFACTURER: BENJAMIN MOORE MODEL: CLASSIC BURGUNDY	HC-182	N/A	FLAT		BENJA MIN MOORE	Key Plan: 50 49 185 50 49 185 50 49 185 50 49 185 60 49 169 169
nl pm/pro	PNT-05		PA INT	TRIM & DOOR PAINT THROUGHOUT	MANUFACTURER: BENJAMIN MOORE MODEL: CHANTILLY LACE	OC-65	N/A	SEMI-GLOSS		BENJA MIN MOORE	145 152 31/ 145 152 31/ 143 148 35 141 146 (3) 40 1174 10 ₁₂ 18 144 31 8 8 10 144 31 8 10 140 21 8 10 138 72 8 10 138 72 8 10 136 73 8 10 136 73 8 10 136 73 8 10 137 157 157 157 157 157 157 157 157 157 15
rest- order/	PTL-01		PORCELAIN TILE	FLOOR TILE THROUGHOUT	MANUFACTURER: CENTURA MODEL: CEPPOSTONE	K947204R0001VTE0 RECTIFIED	WIDTH: 40cm LENGTH: 80cm	908 DOVE GRAY MATTE		CENTURA TILE	17 151 8 144 170 132
sleon- nl	ST-01		TERRAZZO	COUNTERTOPS THROUGHOUT	MANUFACTURER: ANN SACKS MODEL: TERRAZZO REVATA SLAB	AS16751	WIDTH: 31" LENGTH: 84" THICKNESS: 3/4"	BLACK	28% PRE-CONSUMER RECYCLED CONTENT LEED V4 CERTIFIED	ANN SACKS	
om/pro irned-	TFL-01		THERMALLY FUSED LAMINATE	VERTICAL MILLWORK SURFACES THROUGHOUT	MANUFACTURER: PANOLAM MODEL: BURGUNDY	FS695 STANDARD FRL		TEXTURED/SUEDE (SD)		PANOLA M	
em/pro	TFL-02		THERMALLY FUSED LAMINATE	VERTICAL MILLWORK SURFACES THROUGHOUT	MANUFACTURER: NEVAMAR MODEL: BLACK	90S/S405 STANDARD TFL		SUPER MATTE (SM)		PANOLA M	
p.com/t ble	TFL-03		THERMALLY FUSED LAMINATE	VERTICAL MILLWORK SURFACES THROUGHOUT	MANUFACTURER: PANOLAM MODEL: TRUE WHITE	S645 STANDARD TFL		SUPER MATTE (SM)		PANOLAM	
	TFL-04		THERMALLY FUSED LAMINATE	VERTICAL MILLWORK SURFACES THROUGHOUT	MANUFACTURER: PANOLAM MODEL: SLICED RED OAK	W230 STANDARD TFL		TIMBERLINE (TL)		PANOLAM	









	02	ISSUED FOR TENDER	2023.09.0
	01	ISSUED FOR PERMIT	2023.05.1
	NO.	ISSUES/REVISIONS	DAT

FURNITURE, MATERIALS & FINISHES SCHEDULES

DRAWING TITLE:

ISSUE DATE:			2023.09.				
DRAWN BY:	MM	CHECKED	BY:				
PROJECT NO.:	12228	SCALE:	AS NOTE				
		1	DEVISIO				

ACCESSORIES SCHEDULE PROJECT: VICTORIA PARK COMMUNITY HOMES

PROJECT #: 12228
PROJECT ADDRESS: 155 QUEEN STREET N, HAMILTON, ONTARIO, CANADA DATE: 2022.11.XX

DATE: 2022.11	.XX								P
TAG	IMAGE	TYPE	ROOM	MANUFACTURER + MODEL	SPECIFICATIONS	FINISH	NOTES	VENDOR/SUPPLIER/LINK	
ACC-01		CABINET PULL	MILLWORK THROUGHOUT	MANUFACTURER: RICHELIEU MODEL: CONTEMPORARY METAL PULL	2288 BP228804900 4" CENTER TO CENTER	MATTE BLACK	110mm OVERALL LENGTH	RICHELIEU	
ACC-02	"IM A SEO DES NOT REFLECT FINISH"	PAPER TOWEL DISPENSER AND WASTE RECEPTACLE	EXSITING GENDER INCLUSIVE WASHROOMS 111 & 112 GENDER INCLUSIVE WASHROOMS 118 & 207	MANUFACTURER: BOBRICK MODEL: TRIM LINE SERIES RECESSED PAPER TOWEL DISPENSER AND WASTE RECEPTACLE	B-3803.MLBK	MATTE BLACK		BOBRICK	
ACC-03		GRAB BAR	NEW UNIVERSAL WASHROOM & BARRIER-FREE WASHROOM 201	MANUFACTURER: BOBRICK MODEL: 1-1/4" (32mm) DIAMETER STAINLESS STEEL GRAB BAR WITH SNAP FLANGE	B-5806.99	STAINLESS STEEL, SATIN FINISH PEENED		BOBRICK	
ACC-04		GRAB BAR	NEW UNIVERSAL WASHROOM & BARRIER-FREE WASHROOM 201	MANUFACTURER: BOBRICK MODEL: 1-1/2" (38mm) DIAMETER STAINLESS STEEL 30"X30" (762mm X 762mm) 90-DEGREE GRAB BAR	B-6898.99	STAINLESS STEEL, SATIN FINISH PEENED		BOBRICK	
ACC-05		MIRROR	NEW UNIVERSAL WASHROOM & BARRIER-FREE WASHROOM 201	MANUFACTURER: BOBRICK MODEL: MIRROR WITH STAINLESS STEEL CHANNEL FRAME AND SHELF	B-166 1836 18"X37-1/4"	STAINLESS STEEL, SATIN FINISH		BOBRICK	
ACC-06	•	SANITARY NAPKIN DISPOSAL	NEW UNIVERSAL WASHROOM & BARRIER-FREE WASHROOM 201	MANUFACTURER: BOBRICK MODEL: TRIM LINE SERIES SURFACE- MOUNTED SANITARY NAPKIN DISPOSAL	B-35139	STAINLESS STEEL, SATIN FINISH		BOBRICK	
ACC-07		TOILET PAPER DISPENSER	NEW UNIVERSAL WASHROOM & BARRIER-FREE WASHROOM 201	MANUFACTURER: BOBRICK MODEL: FINO COLLECTION SURFACE- MOUNTED SINGLE JUMBO TOILET ROLL HOLDER	B-9890	STAINLESS STEEL, SATIN FINISH		BOBRICK	
ACC-08	·IM A SEODES NOT REFLECT FINISH	TOILER PAPER DISPENSER	EXSITING GENDER INCLUSIVE WASHROOMS 111 & 112 GENDER INCLUSIVE WASHROOMS 118 & 207	MANUFACTURER: BOBRICK MODEL: TRIM LINE SERIES RECESSED MULTI- ROLL TOILET TISSUE DISPENSER	B-35883. MBLK	MATTE BLACK		BOBRICK	_
ACC-09		SANITARY NAPKIN DISPOSAL	EXSITING GENDER INCLUSIVE WASHROOMS 111 & 112 GENDER INCLUSIVE WASHROOMS 118 & 207	MANUFACTURER: BOBRICK MODEL: TRIM LINE SERIES RECESSED SANITARY NAPKIN DISPOSAL	B-3513.MBLK	MATTE BLACK		BOBRICK	
ACC-10		WALL HOOK	NEW UNIVERSAL WASHROOM & BARRIER-FREE WASHROOM 201	MANUFACTURER: BOBRICK MODEL: FINO COLLECTION COAT HOOK	B-9542	STAINLESS STEEL, SATIN FINISH		BOBRICK	
ACC-11		WALL HOOK	EXSITING GENDER INCLUSIVE WASHROOMS 111 & 112 GENDER INCLUSIVE WASHROOMS 118 & 207	MANUFACTURER: BOBRICK MODEL: FINO COLLECTION COAT HOOK	B-9542.MBLK	MATTE BLACK		BOBRICK	
ACC-12		MIRROR	EXSITING GENDER INCLUSIVE WASHROOMS 111 & 112 GENDER INCLUSIVE WASHROOMS 118 & 207	MANUFACTURER: KOHLER MODEL: ESSENTIALS 20"X40" CAPSULE DECORATIVE MIRROR	K-26051	MATTE BLACK (BLL)		KOHLER	
ACC-13		FOOT-PULL DOOR OPENER	ALL WASHROOMS THROUGHOUT	MANUFACTURER: MAG-MATE MODEL: FOOT-PULL DOOR OPENER, DIRECT MOUNT	FP01	STAINLESS STEEL		GRAINGER	
ACC-14	1	SHOWER ENCLOSURE	MULTI-PURPOSE ROOM	MANUFACTURER: BATH DEPOT MODEL: CRISTO COLLECTION 36"X36" MATTE BLACK SQUARE SHOWER DOOR WITH TOWEL BAR	DO573636BK	MATTE BLACK		BATH DEPOT	

PLUMBING SCHEDULE

PROJECT: VICTORIA PARK COMMUNITY HOMES

PROJECT #: 12228 PROJECT ADDRESS: 155 QUEEN STREET N, HAMILTON, ONTARIO, CANADA DATE: 2022.11.XX

TAG	IMAGE	TYPE	ROOM	MANUFACTURER + MODEL	SPECIFICATIONS	FINISH	NOTES	VENDOR/SUPPLIER/LI
PLU-01		SINK		MANUFACTURER: KAST MODEL: FLOR MINI A1 RHS		STONE		
PLU-02		SINK	WASHROOMS	MANUFACTURER: KAST MODEL: FLOR MINI C6 RHS		STONE		KAST CONCRETE BASINS
PLU-03		SINK		MANUFACTURER: KOHLER MODEL: PURIST VESSEL BATHROOM SINK	K-2314	WHITE (0)	INCLUDE PARTS: K-7129 DRAIN K-7605-PANGLE SUPPLY WITH STOP K-9018 P-TRAP K-9583 BATHROOM SINK BRACKET KIT	KOHLER
PLU-04		FLUSHOMETER	ALL WASHROOMS	MANUFACTURER: KOHLER MODEL: TRIPOINT EXPOSED HYBRID 1.28 GPF TOILET FLUSHOMETER	K-7531	POLISHED CHROME (CP)		KOHLER
PLU-05		TOILET	ALL WASHROOMS	MANUFACTURER: KOHLER MODEL: HIGHCLIFF ULTRA TOP SPUD FLUSHOMETER BOWL	K-96057-B	WHITE (0)		KOHLER
PLU-06		FA UCET		MANUFACTURER: KOHLER MODEL: PURIST WALL-MOUNT FAUCET TRIM W/INSIGHT TECHNOLOGY, NO VALVE	K-T11839	VIBRANT STAINLESS (VS)	0.5 GPM	KOHLER
PLU-07		FA UCET	111 & 112	MANUFACTURER: KOHLER MODEL: PURIST WALL-MOUNT BATHROOM FAUCET TRIM	K-T11840	POLISHED CHROME (CP)	0.5 GPM	KOHLER
PLU-08		SHOWER SET		MANUFACTURER: KOHLER MODEL: PURIST SHOWERING KIT, 1.75GPM	K-22181-G-BL	MATTE BLACK (BL)	1.75 GPM	KOHLER
PLU-09	F	FA UCET	&	MANUFACTURER: KOHLER MODEL: PURIST PULL-OUT KITCHEN SINK FAUCET WITH THREE-FUNCTION SPRAYHEAD		MATTE BLACK (BL)	1.5 GPM	KOHLER
PLU-10		SINK	χ.	MANUFACTURER: BLANCO MODEL: QUATRUS R15 U 1	401516	BRUSHED STAINLESS STEEL		BLA NCO
PLU-11		SHOWER PAN	MULTI-PURPOSE ROOM 202	MANUFA CTURER: KOHLER MODEL: A RCHER 36"X36" SINGLE THRESHOLD CENTRE DRAIN SHOWER BASE WITH REMOVABLE COVER	K-9396-0	WHITE (0)		KOHLER

EQUIPMENT SCHEDULE

PROJECT: VICTORIA PARK COMMUNITY HOMES
PROJECT #: 12228
PROJECT ADDRESS: 155 QUEEN STREET N, HAMILTON, ONTARIO, CANADA

DATE: 2022.11	ATE: 2022.11.XX								
TAG	IMAGE	TYPE	ROOM	MANUFACTURER + MODEL	SPECIFICATIONS	DIMENSIONS	FINISH	NOTES	VENDOR/SUPPLIER/LINK
EQ-01		REFRIGERATOR	EXISTING COFFEE ROOM 109 COFFEE BAR 204	MANUFACTURER: SAMSUNG MODEL: 33" COUNTER-DEPTH FRENCH DOOR REFRIGERATOR WITH TWIN COOLING PLUS	RF18A5101SR/AA	WIDTH: 32.33" DEPTH: 28.12" HEIGHT: 70" 17.5 cu.ft.	STAINLESS STEEL		SAMSUNG
EQ-02		DISHWASHER	EXISTING COFFEE ROOM 109 COFFEE BAR 204	MANUFACTURER: SAMSUNG MODEL: SMART STORMWASH+ 6 SERIES	BUILT-UNDER 44dBa AUTORELEASE DW80B6060US/AC	WIDTH: 605mm DEPTH: 636mm HEIGHT: 860-890mm	STAINLESS STEEL		SAMSUNG
EQ-03		SOAP DISPENSER	ALL WASHROOMS THROUGHOUT	MANUFACTURER: BOBRICK MODEL: AUTOMATIC WALL-MOUNTED SOAP DISPENSER	B-2021	WIDTH: 108mm DEPTH: 107mm HEIGHT: 268mm	STAINLESS STEEL		BOBRICK
EQ-04		COFFEE MA CHINE	EXISTING COFFEE ROOM 109 COFFEE BAR 204	MANUFACTURER: DELONGHI MODEL: COFFEE & ESPRESSO MAKER	BCO430BC	WIDTH: DEPTH: HEIGHT:	BLACK & CHROME		DELONGHI
EQ-XX	200 AND	ADULT CHANGE TABLE	SPEC PROVIDED FOR FUTURE REFERENCE	MANUFACTURER: KOALA KARE MODEL: ADJUSTABLE HEIGHT CHANGING STATION	KB3000-AHL	WIDTH: 1913mm DEPTH: 1032mm HEIGHT: 1536mm			BOBRICK



VPCH OFFICE EXPANSION

155 QUEEN ST NORTH HAMILTON, ONTARIO




25 Main Street West Hamilton, Ontario L8P 1H1 Canada

T: 905-522-0220

DRAWINGS ARE NOT TO BE SCALED.

CONTRACTOR MUST VERIFY ALL DIMENSIONS ON THE JOB AND REPORT ANY DISCREPANCY TO ARCHITECTS BEFORE PROCEEDING WITH WORK. ALL DRAWINGS AND SPECIFICATIONS ARE THE PROPERTY OF THE ARCHITECT AND MUST BE RETURNED AT THE COMPLETION OF THE WORK.

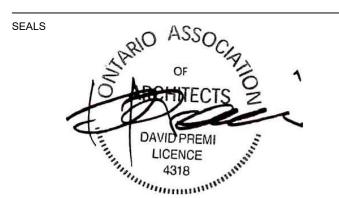



02 ISSUED FOR TENDER 2023.09.06 ISSUED FOR PERMIT 2023.05.16 NO. ISSUES/REVISIONS DATE DRAWING TITLE:

PLUMBING, EQUIPMENT & ACCESSORIES SCHEDULES

ISSUE DATE:	2023.09.0
DRAWN BY: MM	CHECKED BY: S
PROJECT NO.: 12228	SCALE: AS NOTE
DRAWING NO.:	I REVISION