VPCH Office Expansion 155 Queen St N Hamilton, ON L8R 2V6

Construction Tender ARCHITECTURAL ADDENDUM No. 03

Friday, October 06, 2023

1. GENERAL INSTRUCTIONS

- .1 Date of Issue: October 6, 2023
- .2 Revised Closing date: October 13, 2023
- .3 All bidders are hereby advised that the information contained in the Permit/Tender Documents, dated September 22, 2023, for the noted captioned project, has been amended to include the information contained within this document, and such information shall be covered in the Tender submission, and shall form part of the *Contract*. This Addendum forms part of the *Contract Documents* and is to be read, interpreted, and coordinated with other parts of the *Contract Documents*. Acknowledge receipt of this Addendum by referencing on the bid form.

2. CLOSING DATE

The closing date for this tender has been extended to October 13, 2023 at 12:00pm.

3. ARCHITECTURAL DRAWNGS

- .1 Replace the following Issued for Permit/Tender drawings with issued for Addendum No. 3, dated October 6, 2022, in its entirety (attached hereto).
 - .i A00.02 GENERAL NOTES, OBC MATRIX, & WALL ASSEMBLIES
 - .ii A01.01 DEMO PLANS LEVEL 1
 - .iii A01.01 DEMO PLANS LEVEL 2
 - .iv A01.04 RENOVATION PLAN & FURN PLAN LEVEL 1
 - .v A01.05 ADDITION PLAN & FURN PLAN LEVEL 2-A01.05
 - .vi A01.07 FLOOR FINISH PLAN LEVEL 1-A01.07
 - .vii A01.08 FLOOR FINISH PLAN LEVEL 2-A01.08
 - .viii A01.11 WALL FINISH PLAN LEVEL 1-A01.11
 - .ix A01.12 WALL FINISH PLAN LEVEL 2-A01.12
 - .x A01.13 RCP LEVEL 1-A01.13
 - .xi A01.14 RCP LEVEL 2-A01.14
 - .xii A02.00 DEMO ELEVATIONS-A02.00
 - .xiii A02.02 BUILDING ELEVATIONS & INTERIOR ELEVATIONS-A02.02
 - .xiv A02.02 BUILDING ELEVATIONS & INTERIOR ELEVATIONS-A02.03
 - .xv A03.00 WASHROOM DETAILS-A03.00
 - .xvi A03.00 WASHROOM DETAILS-A03.01
 - .xvii A03.00 WASHROOM DETAILS-A03.02
- .xviii A03.03 MILLWORK DETAILS-A03.03
- .xix A03.03 MILLWORK DETAILS-A03.04
- .xx A03.03 MILLWORK DETAILS-A03.05
- .xxi A03.03 MILLWORK DETAILS-A03.06
- .xxii A03.03 MILLWORK DETAILS-A03.07
- .xxiii A03.03 MILLWORK DETAILS-A03.08
- .xxiv A04.00 BUILDING SECTIONS & WALL SECTIONS-A04.03

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- .xxvi A04.00 BUILDING SECTIONS & WALL SECTIONS-A04.04
 .xxvii A05.03 SCHEDULES-A05.03
 .xxviii A05.03 SCHEDULES-A05.04
 .xxviiii A05.03 SCHEDULES-A05.05
 .xxix SP01.01 DEMO & PROPOSED SITE PLANS-SP01.01
- .2 Insert the following drawing.
 - .i A04.00 BUILDING SECTIONS & WALL SECTIONS-A04.05

SP01.01 DEMO & PROPOSED SITE PLANS-SP01.02

- 4. ARCHITECTURAL SPECIFICATIONS
 - Insert the following into the specifications:09 51 23 Acoustical Tile Ceiling Systems
- 5. STRUCTURAL

.XXX

- .1 Please see attached Structural Addendum 1.
- 6. ELECTRICAL
 - .1 Please see attached Electrical Addendum 1.

END OF ADDENDUM No. 03

PART 1 - GENERAL

1.1 GENERAL INSTRUCTIONS

.1 Read and be governed by conditions of the Contract Documents, including sections of Division 1.

1.2 SECTION INCLUDES

- .1 1.1 General Instructions
- .2 1.2 Section Includes
- .3 1.3 Summary
- .4 1.4 Administrative Requirements
- .5 1.5 Submittals
- .6 1.6 Closeout submittals:
- .7 1.7 Quality Assurance
- .8 1.8 Delivery, Storage, and Handling
- .9 1.9 Field Conditions
- .10 2.1 Performance/Design Requirements
- .11 2.2 General
- .12 2.3 Acoustical Tiles
- .13 2.4 Metal Suspension Systems
- .14 2.5 Miscellaneous Materials
- .15 2.6 Metal Finish
- .16 3.1 Installation General
- .17 3.2 Installation Suspension System
- .18 3.3 Installation Tiles
- .19 3.4 Installation Tolerances
- .20 3.5 Field Quality Control
- .21 3.6 Adjusting and Cleaning

1.3 SUMMARY

- .1 Section Includes
 - .1 Acoustical tile ceiling systems.

1.4 ADMINISTRATIVE REQUIREMENTS

- .1 Coordination
 - .1 Cooperate with mechanical and electrical *Subcontractors*.
 - .2 Coordinate layout and installation of acoustic ceiling units and suspension systems components with other work supported by or penetrating through ceilings, including light fixtures, HVAC equipment, partition system, fire suppression system components and other work required to be incorporated in or coordinated with the ceiling system.

1.5 SUBMITTALS

.1 Submit required submittals in accordance with Section 01 33 00.

.2 Product data sheets:

.1 Submit manufacturer's *Product* data sheets for Products proposed for use in the work of this section.

.3 Shop drawings:

- .1 Submit manufacturer's standard details.
- .2 Indicate lay-out, insert and hanger spacing and fastening details, splicing method for main and cross runners, location of access splines, and acoustical unit support at ceiling fixture.
- .3 Submit reflected ceiling plans for special grid patterns as indicated.

.4 Samples:

- .1 Submit sample of each component of ceiling system. Samples shall fully represent materials to be supplied in colour, texture, finish and construction.
- .2 Submit samples, load test data and design tables for each type of insert to be used in the *Work* for hanger supports.

.5 Certificates:

.1 Submit certificate of compliance stating that the suspension system provided, including materials and installation, comply with the requirements of the *Contract Documents*.

1.6 CLOSEOUT SUBMITTALS:

.1 Submit closeout submittals in accordance with Section 01 77 00.

.2 Maintenance data:

.1 Submit maintenance and cleaning instructions for acoustical ceiling systems for incorporation into the maintenance manuals.

.3 Maintenance materials:

- .1 Deliver for maintenance use, 2% of each type and colour of suspension components and acoustical tiles used in the *Work*.
- .2 Pack panels in suitable containers, clearly dated and identified as to type and location of installation in the *Work*, and store where directed by the *Owner*.

1.7 QUALITY ASSURANCE

.1 Qualifications:

- .1 Installers / applicators / erectors:
 - .1 *Provide* work of this section, executed by competent installers with a minimum of 5 years' experience in application of Products, systems and assemblies specified and with approval and training of *Product* manufacturers.

.2 Mock-ups:

.1 Construct in locations acceptable to the *Consultant* a typical sample ceiling installation 10 m2 in area, complete with perimeter wall trim, and cut tegular tile demonstrating rectified edge. Modify sample as required to obtain approval. Upon acceptance retain sample as standard of quality for acoustical ceiling.

.2 Do not begin fabrication and erection of remainder of ceiling system until sample installation has been reviewed and accepted. Accepted sample may become a part of the final *Work*, subject of approval of the *Consultant*.

1.8 DELIVERY, STORAGE, AND HANDLING

- .1 Ship exposed members and mouldings in rigid crates to avoid damage. Bent or deformed material shall be rejected. Baked enamelled members shall be suitably wrapped and protected against damage.
- .2 Deliver acoustical ceiling units to the *Place of the Work* in original, unopened packages and store in a fully enclosed space where they will be protected against damage from moisture, direct sunlight, surface contamination, and other causes.
- .3 Before installing acoustical ceiling units, permit them to reach room temperature and stabilized moisture content.
- .4 Handle acoustical ceiling units carefully to avoid chipping edges or damaging units.

1.9 FIELD CONDITIONS

- .1 Commence installation after building is enclosed with windows and exterior doors in place and glazed, and roof watertight.
- .2 Interior temperature of building to range from 15°C to 30°C and relative humidity of not more than 70% before and during installation. Maintain uniform temperatures for 72 hours prior to commencement of the work of this section and maintain temperature until completion of the work of this Section.

PART 2- PRODUCTS

2.1 PERFORMANCE/DESIGN REQUIREMENTS

- .1 Design suspension systems for a maximum mid-span deflection not exceeding L/360 in accordance with ASTM C635/C635M-13a deflection test.
- .2 Design suspension system to support safely, and without distortion, the superimposed loads of:
 - .1 Air supply diffusers and return grilles.
 - .2 Lighting fixtures.

2.2 GENERAL

.1 Single source responsibility: Obtain each type of acoustical ceiling unit and suspension system from a single source with resources to *Provide* products of consistent quality in appearance and physical properties without delaying progress of the *Work*. Products installed as part of the work of this section shall be from same production run.

2.3 ACOUSTICAL TILES

- .1 ACT-01; Lay-in acoustical tiles:
 - .1 Classification: Type III, Form 2, Pattern C E in accordance with ASTM E1264- 08e1.
 - .2 Size: to suit metal suspension system.
 - .3 NRC: 0.50.
 - .4 Material: wet formed mineral fibre.

- .5 Surface texture: Smooth.
- .6 Edge: Square.
- .7 Colour: White.
- .8 Flame Spread: Class A Flame Spread 25 or under, to CAN/ULC S102.
- .9 Acceptable Products: Canyon by Armstrong.

2.4 METAL SUSPENSION SYSTEMS

- .1 Hanger anchorage devices: Screws, clips, bolts, concrete inserts or other devices applicable to the indicated method of structural anchorage for ceiling hangers and whose suitability for use intended has been proven through standard construction practices or by certified test data. Size devices for 3 x calculated load supported except size direct pull-out concrete inserts for 5 x calculated loads.
- .2 Concrete hanger anchors; post installed: Steel eye bolts and nuts to suit ceiling hangers with capability to sustain, without failure, a load equal to 4 times that imposed by ceiling construction, as determined by testing per ASTM E488/E488M-15, conducted by a qualified independent testing laboratory.
 - .1 ITW Ramset Dynabolt Sleeve Anchor 'TW-1614' or Readi-Tie-Drive 'TD4-112' tie wire anchor by ITW Construction Products Canada or equivalent.
 - .2 Kwik-Bolt II 'HCKB 1/4' tie wire anchor by Hilti Corporation or equivalent.
 - .3 Fasteners exposed to weather, condensation, and corrosion: Zinc-plated or stainless steel fasteners in applicable product lines specified in preceding paragraphs.
- .3 Hangers and tie wire: Galvanized wire, recommended by manufacturer of suspension system, minimum 2.66 mm (0.1") (12 gauge).
- .4 Suspension system accessories:
 - .1 Splices, clips, and perimeter moulding, of manufacturer's standard type to suit the applicable conditions unless special conditions and access area are shown or specified in the Contract Documents.
 - .2 Angle wall mouldings; hemmed with prefinished exposed flanges:
 - .1 For 24 mm (15/16") grid applications; angle moulding with exposed bottom flange of 22 mm (7/8").
 - .1 Armstrong World Industries '7803' or equivalent.
 - .2 CGC Inc. 'M7' or equivalent.
- .5 Standard suspension system, non fire-rated:
 - .1 Intermediate duty to ASTM C635/C635M-13a, 24 mm (15/16") interlocking tee system, designed to support acoustical panels in patterns indicated with deflection of main tees less than L/360, consisting of main tees and cross tees. The system shall *Provide* lock joint intersections of cross and main tees.
 - .2 Acceptable Products:
 - .1 Armstrong World Industries 'Prelude XL 15/16" Exposed Tee Systems'.

- .2 CGC Inc. 'DX'.
- .3 Or equivalent.

2.5 MISCELLANEOUS MATERIALS

.1 Acoustical sealant: Non-drying, non-hardening, non-skinning, non-staining, non- bleeding, gunnable sealant complying with requirements specified in Section 07 92 00.

2.6 METAL FINISH

- .1 Metal exposed in finished work shall have a pre-coated baked enamel finish in non- yellowing colour. Submit paint formulation of grid system to lighting fixture, speaker grille, sprinkler and diffuser manufacturers to ensure consistency of colour, sheen and texture of all exposed metal components in the ceiling assemblies. Colour shall be:
 - .1 Flat white.

PART 3 - EXECUTION

3.1 INSTALLATION - GENERAL

- .1 Install ceiling panels and metal suspension system in accordance with manufacturer's directions. Where manufacturer's directions are at variance with the *Contract Documents*, notify the *Consultant* before proceeding with installation.
- .2 Do not commence installation until all work above suspended ceiling has been completed, inspected and accepted.

3.2 INSTALLATION - SUSPENSION SYSTEM

- .1 Install suspension system rigid, secure, square, level and plumb, framed and erected to maintain dimensions and contours indicated, and in accordance with ASTM C636 / C636M 13, CISCA installation standards and any other applicable national or local code requirements. Make allowance for thermal and structural movement.
- .2 Attach hangers to structure with inserts and hanger supports. Do not use powder activated fasteners.
- .3 Support hangers for suspended ceiling grid independent of walls, columns, pipes and ducts.
- .4 Space hangers for ceilings at maximum 1220 mm (48") on centre in both directions. *Provide* additional hangers as required to comply with manufacturer's written installation instructions.
- .5 Locate hangers at not more than 150 mm (6") from ends of main tee members.
- .6 Install exposed tee members to pattern indicated. Securely attach hangers to main tee members.
- .7 Exposed tees shall be as long as possible to minimize joints. Make joints square, tight, flush and reinforce with splines. Distribute joints to prevent clustering in one area.
- .8 Space tee bars to suit ceiling panels and as detailed, and to accommodate lighting fixtures, diffusers and return grilles.
- .9 Cooperate in the installation of ceiling systems, making adjustments where required to ensure that the lighting fixtures, supply diffusers, exhaust grilles and other built-in items properly fit into ceiling module and finish flush with rest of ceiling.
- .10 Restrict creep inside module panels so that in all cases strips are centred on module lines.

- .11 Install edge moulding as detailed where ceiling abuts vertical surfaces. Lap corners use maximum lengths to minimize joints. Make joints square, tight and flush.
 - .1 Apply continuous ribbon of acoustical sealant, concealed on back of vertical leg before installing mouldings.
 - .2 Screw attach mouldings to substrates at intervals not more than 400 mm (16") on centre and not more than 210 mm (8") from ends, levelling with suspension system. Lap corners accurately and connect securely.

3.3 INSTALLATION - TILES

- .1 Take precautions during installation to ensure tile edges are not chipped or otherwise damaged.
- .2 Minimize field cutting. Rectify cut tile edges of tile to match factory cut edge profile and colour.
- .3 Install acoustical tiles to form horizontal and level ceiling with all parts flush and joints butted tightly to hairline appearance.
- .4 Distribute variations in colour and texture of panels to obtain a uniform appearance.

3.4 INSTALLATION - TOLERANCES

- .1 Allowable tolerances: to ASTM C636 / C636M 13.
- .2 Install suspension systems level to tolerance of 1:1200.
- .3 Install edge mouldings level to tolerance of 3 mm in 3660 mm (1/8" in 12'-0").

3.5 FIELD QUALITY CONTROL

.1 Conduct quality control in accordance with Section 01 45 00.

3.6 ADJUSTING AND CLEANING

- .1 Replace uneven, defective or damaged materials and finishes, eliminate waves, and remove soiled or stained areas.
- .2 Clean dirty and discoloured surfaces of acoustical units and suspension system according to manufacturer's recommendations.

END OF SECTION

Addendum #03

Victoria Park Community Housing

155 Queen St N Hamilton, ON L8R 2V6

PROJECT NUMBER: 12228
DATE ISSUED: October 06, 2023

1 Question:

Door F217.3 is an exit door, but calls for PC 350 & a wood door. I assume that you want a HM door & frame at this location. Clarify.

Response:

Please refer to section 3. DRAWINGS of this addendum. Drawing A05.03 - Door and Glazing Schedules.

2 Question:

07 21 00 Thermal Insulation pg 211-214

Calls for sprayfoam but I don't see anywhere that this is installed on the drawing

Response:

Refer to Construction Schedule assembly's matrix for insulation requirements.

3 Question

07 62 00 - Metal Cladding pg 238-247

On pg. 243 refers to Rigid insulation in accordance with 07 21 00

The Thermal Insulation section only calls for below ground XPS and sprayfoam.

Response:

Refer to Construction Schedule assembly's matrix for insulation requirements.

4 Question:

Can we get more information in regards to lighting spec's (e.g. Lumens, wattage, K values) for fixture types L2, L3, L4, L6.

Response:

Please refer to Electrical Addendum 1.

5 Question:

Clarification on whether there will be three wall sconces behind the reception desk on level 1 as they are shown on the architectural drawings but not on the electrical drawings.

Response:

Yes, Please refer to Electrical Addendum 1.

6 Question:

Clarification on lighting type L6, architectural drawings have it listed as a decorative wall sconce and the electrical lighting schedule has it as a keyless lamp holder.

Response:

Please refer to Electrical Addendum 1.

7 Question:

Can it be clarified if the new fire alarm sub control panel is to be installed in the Mobile Maintenance Workshop and all of the new zones are to be wired back to this panel?

Response:

Yes, it's correct. See fire alarm riser and schedule is located on drawing E5.

8 Question:

Is the wiring between the existing Fire alarm control panel and the new fire alarm sub control panel required to be wired in a class A configuration and is the wiring required to be 2 hour fire rated cable?

Response:

Yes, Please refer to Electrical Addendum 1.

9 Question:

- 1. Spec for SDT-01 indicated in elec./ server room.
- 2. Wall finishes drawing A07.00 and A09.00 that show the large format wall tile in ex. Men's washroom and new uni. Washroom
- 3. What is the spec for the large format wall tile in ex. Men's washroom and new uni. Washroom?
- 4. What is the spec for floor tile in new uni. Washroom?

Response:

- 1. Specification noted in Addendum 3. Please refer to finish specifications.
- 2. Adjustments made to wall tile in elevations for Addendum 3.
- 3. Same as above.
- 4. Please refer to updated floor finish plan in Addendum 3.

10 Question:

Please provide Model No. of lighting types; L2, L3 and L4

Response:

Please refer to Electrical Addendum 1.

11 Question:

See drawing A01.07.

I cannot locate a proper transition point from LVT to Cpt.

Further -- Are finishes required in rms 115/116/117 & stairwell?

- LVT & CPT install patterns, offsets &/or layout direction? Not indicated.
- Vinyl base height is scheduled for 2.5 inch. Should that not be 4"?

Response: Transitions added to floor finish plans in Addendum 3.

Please refer to finish specifications and floor finish plans for install patterns in Addendum 3 Vinyl base will be the height as noted in finish specifications.

12 Question:

Please advise as to location(s) of roller shades? There is only one noted for an interior screen on drawing A01.04. Are the other windows, interior and/or exterior, to receive blind; or is it just the one for room 102?

Response:

All offices, interior screen and exterior window shall have a Window Shade. Please refer to section 3. DRAWINGS of this addendum. Drawing A01.13 – Reflected Ceiling Plan Level 1 and A01.14 – Reflected Ceiling Plan Level 2. On drawing notation WS – Window Shade.

13 Question:

On drawing A03.01, there are multiple reference to drawing A0.07. However, there is no drawing A0.07 within the tender package. Please provide drawing A0.07.

Response:

Drawing references have been corrected. Please refer to section 3. DRAWINGS of this addendum for all sheets re-issued.

14 Question:

The furniture included in the specs is not consistent with the options available on the websites indicated. Please consider changing the furniture to a cash allowance or send product numbers to ensure the correct item is being quoted.

Response:

GC to carry costs for items noted in the furniture schedule. If an item is discontinued, GC to carry discontinued costs. Alternative will be reviewed after award of tender.

15 Question:

On some of the interior elevations for washrooms, it shows 2 sizes of wall tiles but no "tag" is indicated. The tile above 1200aff is consistent with CTL-01 wall ceramic tile listed on drawing A05.05. However, the tile shown from FFE to 1200 aff (appears to be 48"x32") labelled as tile base (ex. on 2/A03.01, 3/A03.01, 4/A03.01 & 5/A03.01) is not on the list of finishes on the finishes schedule on drawing A05.05. Please clarify.

Response: Please refer to changes made in Addendum 3.

16 Question:

HVAC room in the garage, does the removal includes all the electrical break & related staffes

Response:

Demolition scope of work is indicated in this room on Drawing E1-07

17 Question:

All the structural steel to have Intumescent paint or just primer?

Response:

Just primer.

18 Question:

The drawing says window schedule is on A05.03, but that page has only door schedule. Should we just scale the drawings for windows?

Response.

Exterior Window Schedule has been included on issued A02.02 BUILDING ELEVATIONS & INTERIOR ELEVATIONS-A02.02.

19 Question:

A05.03 door types has metal door, but the table shows all wood doors

Response.

Please refer to section 3. DRAWINGS of this addendum. Drawing A05.03 - Door and Glazing Schedules

20 Question:

Please provide specifications/details for the floor box in Room #107 (Ex - Committee Room).

Response:

Please refer to Electrical Addendum 1.

21 Question:

On the Fire alarm system notes we are told that 24HR fire watch is required for the complete construction period of the project. Also this note is referencing to coordinate with the Toronto Fire Marshall. Please confirm that this is required for the renovations.

Response:

Not applicable to this project. Delete this fire alarm note 1.2. See Electrical Addendum 1.

22 Question:

On the Fire alarm system notes we are told that there is an emergency generator that will be removed? There is no other reference on the drawings which shows that a generator is being demolished on this project. Please advise if this note applies to this project.

Response:

Not applicable to this project. Delete this fire alarm note 1.3. See Electrical Addendum 1.

23 Question:

There are blinds shown on Drawing A1.04, in Room 102. Are all other interior glazed walls to receive blinds that are shown with a bold line?

Response:

All offices, interior screen and exterior window shall have a Window Shade. Please refer to section 3. DRAWINGS of this addendum. Drawing A01.13 – Reflected Ceiling Plan Level 1 and A01.14 – Reflected Ceiling

Plan Level 2. On drawing notation WS - Window Shade.

24 Question:

Are there any exterior locations requiring blinds?

Response:

All offices, interior screen and exterior window shall have a Window Shade. Please refer to section 3. DRAWINGS of this addendum. Drawing A01.13 – Reflected Ceiling Plan Level 1 and A01.14 – Reflected Ceiling Plan Level 2. On drawing notation WS – Window Shade.

25 Question:

Is the roofing or waterproofing material under the existing soil to be removed down to concrete substrate?

Response:

Yes, GC to remove and dispose of all existing soil and waterproofing down to concrete substrate where the second floor will be constructed.

26 Question:

Could you provide a cross-section for the new exterior stairs shown on A1.05?

Response:

Please refer to section 3. DRAWINGS of this addendum. Drawing A04.05 - Stair Details and Railings.

27 Question:

Can you confirm that this contract does not have any hazardous to be removed for tender purposes?

Response:

Assume None. Asbestos report is underway.

28 Question:

Is there any masonry required for this project?

Response:

Yes, refer to A00.03 Assemblies Schedule.

29 Question:

Could you provide a spec section for 09-51-23?

Response:

Specification section has been issued as part of Addendum 3.

30 Question:

What is to happen at edge of ACT on 2nd floor in the open area on GL B, between GL's 14 and 16 and 19 and 20? Will there be a bulkhead?

Response:

Yes, a bulkhead is required. Please refer to section 3. DRAWINGS of this addendum. Drawing A01.14 Reflected Ceiling Plan – Level 2.

31 Question:

Confirm extent of framed structure required in the stairwell? Drawing/cut detail is not clear on where it will be needed, refer to detail 2 on A04.04.

Response:

Please review structural drawings for extent.

32 Question:

On 2^{nd} floor in room 202, there looks to be a line in the ceiling finish parallel to the exterior wall. Is this a miss print or will there need to be a bulkhead/ceiling height change etc? Theres no cut or detail.

Response:

Yes, there is a bulkhead in this location. Height to be coordinate with millwork below it.

33 Question:

Please request a detail to confirm what the build/finish requirements are for columns if needed?

Columns on GL's 15,17 and 19 on GL's A and B show to have something happening but no detail provided.

Response:

All columns at shall be furred out with 13mm drywall and 22mm hat channels.

34 Question:

Will there be drywall returns at the windows and doors?

Response:

Yes, provide drywall returns at all window openings and doors. All exterior windows shall receive a solid surface sill.

35 Question:

Can Furniture, chairs, tables, couches, Lamps etc. be a cash allowance, as contractors don't typically purchase these

Response:

Refer to addendum 2.

36 Question:

Please advise who the base building air balancing contractor is, and if they are mandatory.

Response:

ADDA mechanical. Not mandatory.

37 Question:

Please provide clarification for the scope of work for roller shades. Drawing A01.09 notes Blind required in room 102. Is this the only shade required?

Response:

All offices, interior screen and exterior window shall have a Window Shade. Please refer to section 3. DRAWINGS of this addendum. Drawing A01.13 – Reflected Ceiling Plan Level 1 and A01.14 – Reflected Ceiling Plan Level 2. On drawing notation WS – Window Shade.

38 Question:

Specification 1.3.1 in Division 12 notes sunshades at interior locations and then blackout at interior locations. Please clarify

Response:

All offices, interior screen and exterior window shall have a Window Shade. Please refer to section 3. DRAWINGS of this addendum. Drawing A01.13 – Reflected Ceiling Plan Level 1 and A01.14 – Reflected Ceiling Plan Level 2. On drawing notation WS – Window Shade.

39 Question:

Drawing A03.00 Washroom Details shows some references for finishes on A07.00 and 2/A9.0, 3/A09.00 and 04/A9.0. But these drawings are not in the provided drawings. Please provide drawings if available. Can you please advise what are the painting scopes in these washrooms? What is the ceiling type?

Response:

Drawing references have been corrected. Please refer to the RCP pages for ceiling types, and A01.11 and A0.12 for wall finishes requirements.

40 Question:

On door schedule, most of the new wood doors are 35mm thk. However, the specified hinge size is 4.5"X4" and might be too big for 35mm thk doors. Please clarify.

Response:

Wood Doors shall be 45mm thick. Provide hinge size to suit door width.

41 Question:

Please provide specifications/details for the floor box in Room #107 (Ex - Committee Room).

Response:

Please refer to Electrical Addendum 1.

42 Question:

The table of contents lists 09 51 23 Acoustical tile ceiling systems, but it is missing from the specification. Please provide this item.

Response:

Specification section has been included as part of this addendum.

43 Question:

The specification lists 12 26 00 Interior Daylighting devices, I have not been able to find this on the drawings. Please advise if this item will be required.

Response:

Yes this will be required at Room 203 Open Office. Refer to Wall section detail A04.03.

44 Question:

Door schedule lists doors #F120 Type C, FG205.1 Type D, FG205.2 Type D, F217.3 Type E as paint grade wood doors, but elevations for types C, D & E indicates metal doors, please clarify which is required?

Response:

Please refer to section 3. DRAWINGS of this addendum. Drawing A05.03 - Door and Glazing Schedules.

45 Question:

Please provide door elevation for type FG indicated for door #FG102 on door schedule?

Response:

Please refer to section 3. DRAWINGS of this addendum. Drawing A05.03 - Door and Glazing Schedules.

46 Question:

Section 081400 Item #1.3.1.1 indicates solid core doors with wood veneer, please clarify if all wood doors are paint grade or wood veneer?

Response:

All door wood doors shall be paint grade.

47 Question:

Washrooms on level 1 & 2 per A03.01, A03.02 show wall mounted sinks and no millwork; please clarify where L2 vanity is required per 5/A02.04?

Response: Please refer to plumbing specifications for locations of wall mounted sinks.

48 Question:

Please provide sizing & thickness required for thermally fused laminates TFL-01, TFL-02, TFL-03 & TFL-04?

Response: Please refer to millwork notes for thicknesses.

49 Question:

Please advise where thermally fused laminates TFL-03 & TFL-04 are required (listed on finish schedule)?

Response: TFL-03 and TFL-04 deleted from project.

50 Question:

Please advise on working hours & schedule for this project?

Response:

Monday to Friday – 8am to 7pm

51 Question:

Are we to assume the remaining spaces in the building will be occupied during construction?

Response:

Yes, the building will be occupied.

52 Question:

Will the contractor have to provide alternative washrooms for during the renovation of the men's

washroom/construction of new universal washroom?

Response:

No, the owner will advise at time of construction the procedure needed to allow for facilities to be operational.

53 Question:

Please advise wall type for walls for new universal washroom and men's washroom.

Response:

Refer to updated floor plans.

54 Question:

Dwg.# A01.04, please advise if blinds are required at all sidelights/windows on level 1 & 2 or just Area 102?

Response: All areas, please refer to adjustments in Addendum 3.

55 Question:

Assemblies schedule on drawing A00.03 notes P5-Si-2 wall type removed but drawing A01.04 notes P5-Si-2 wall type surrounding new lift. Please advise correct wall type.

Response:

Please refer to section 3. DRAWINGS of this addendum. Drawing A01.04 – Renovation Plan Level 1 & A01.05 – Renovation Plan Level 2.

56 Question:

Please advise specification for floor type CONC-01.

Response: Exposed concrete to be ground smooth and sealed with slip-resistant clear coat.

57 Question:

Please advise specification for floor type SDT-01.

Response: Please refer to finish specifications adjusted in Addendum 3.

58 Question:

Is GC responsible for furniture as noted on Furniture Schedule on drawing A05.05?

Response:

Please provide a price for this in the bid form under furniture. Owner may remove this item from GC's scope of work after award of Contract. Pricing line has been included on Bids and Tenders.

59 Question:

Demolition plan notes for GC to strip existing surfaces in stairwell and prep to receive new paint finish, but wall finish plan does not indicate for the stairwell to be painted. Please advise.

Response:

Please refer to section 3. DRAWINGS of this addendum. Drawing A01.11 –Wall Finish Plan Level 1 & A01.12 – Wall Finish Plan Level 2.

60 Question:

Please advise how we are to finish the walls inside the existing men's washroom where we are building the new walls. Please provide specification.

Response: Walls to be painted to match existing.

61 Question:

Please advise if appliances are to be under GC scope of work.

Response:

Yes it is under the scope of work of the GC. Owner may remove this item from the GC's scope of work after contract Award.

62 Question:

On drawing A02.02 detail 1 (Elevation - South Exterior) notes client signage pin-mounted to surface of EllFs - please advise if this signage is to be carried under GC scope of work. If yes, please provide specification.

Response: GC to carry exterior signage under GC scope. 10mm thick metal pinmounted round sign of VPCH logo shall be installed at this location.

63 Question:

Please provide more detailed drawings for the new guard in the stairwell as noted on drawing A04.04 detail 2

Response:

New railing shall match existing metal railing and be on site painted black to match existing.

64 Question:

Please provide more detailed drawings for the galvanized steel frame at exit stair as noted on drawing A02.02 detail 1.

Response:

Please refer to section 3. DRAWINGS of this addendum. Drawing A04.05 - Stair Details and Railings.

65 Question:

On drawing A03.01 the tiles on the lower half of walls in new universal washroom indicate to see drawing A07.00 for tile size. But A07.00 is not existed. and by scale the tile is 80cm x120cm. - When A07.00 as Wall Finish Plan is not existed; there are A01.11 & A01.12 are Wall Finish Plan, but doesn't have wall tile information in fact, some other place refer to Architecture drawing A10.xx, and not drawings with number bigger A05.xx are existed

Response: Please refer to new naming conventions on drawings in Addendum 3.

66 Question:

In door schedule, door style FG has no detail

Response:

Please refer to section 3. DRAWINGS of this addendum. Drawing A05.03 - Door and Glazing Schedules.

67 Question:

A01.01 "DX" means what? It looks like to remain, but the stair door with "DX" is new in door schedule

Response:

Demo notes have been corrected on the page. Please refer to section 3. DRAWINGS of this addendum. Drawing A01.01 – Demolition Plan Level 1.

68 Question:

Item LANDSCAPE in bid form to include what? there is no landscape drawing, and no landscape scope of work in SP drawing either

Response:

Please refer to the site plan and the scope of work identified for the reinstatement of the green roof portion.

69 Question:

Item APPLIANCE in bid form to include what? There is no appliance schedule. - do we need to include all the furniture? There is a very detail furniture schedule, but no item FURNITURE in bid form

Responses

Appliances are listed on drawing A05.06 – Plumbing, Equipment and Accessories Schedules. Furniture line item has been included on the Bid Form on Bids and Tenders.

70 Question:

We were informed by the supplier that a lift minimum is required for finishes HPL-01, HPL-02, TFL-01, TFL-02, TFL-04, please provide new finishes that are in stock?

Response: GC to provide alternates or equal or greater quality to Architect for approval.

71 Question:

Is there a color finish specified for the Bellara metal siding cladding system from Vicwest. There is a difference between a woodgrain finish and a solid color finish. Kindly clarify and confirm.

Response:

Color selection shall be from the solid color finishes. Final color will be selected by the architect.

72 Question:

Who is the base building BAS controls contractor for this site?

Response:

There is no Base Building BAS control for the office area.

73 Question:

Regarding the image attached, is that a tile that goes up the wall 4'0" ?? It is labelled as "Tile Base."

Response: Refer to adjusted drawings in Addendum 3.

74 Question:

Regarding the actual tile itself. There is no Wall Finish Plan A0.7.00. Please confirm the tile for this room (both floor and walls).

Response:

References have been corrected. Refer to A01.11 and A0.12 for Wall Finishes requirements.

75 Question:

Regarding the Reception desk Bulletproof glass metal frame - is this u-channel or welded metal.

Response:

Bulletproof glass metal frame shall be composed of welded metal.

76 Question:

Lift shaft is a wall type P5-Si-2, is this masonry? The wall type has been deleted from the wall schedule. Clarify.

Response:

Please refer to section 3. DRAWINGS of this addendum. Drawing A01.04 - Renovation Plan Level 1

77 Question

Should the new concrete slab-on-deck receive welded wire mesh? Currently not listed.

Response:

Yes, refer to Structural Addendum 1 attached to this addendum.

78 Question:

Since addendum 2 states that all furniture and appliances are to be included by GC, please provide required quantities for all furniture and appliances specified and requested.

Response: GC to coordinate quantities with vendors. Architect does not provide quantities.

79 Question:

The door schedule states for PC350 with frame type 'A', which is just a frame without side light, while on the drawings the offices have doors with side lights. For example: FG121, FG122, FG123 shown on the floor plan as doors with side light glazing which is based on the schedule a PC350 system; however, door schedule indicates for frame type 'A' but not type 'B'. Please coordinate the schedules with the floor plan.


Response:

Please refer to section 3. DRAWINGS of this addendum. Drawing A05.03 – Door and Glazing Schedules.

CONSULTANT:

DPAI

Design Partners in Architecture and Interiors

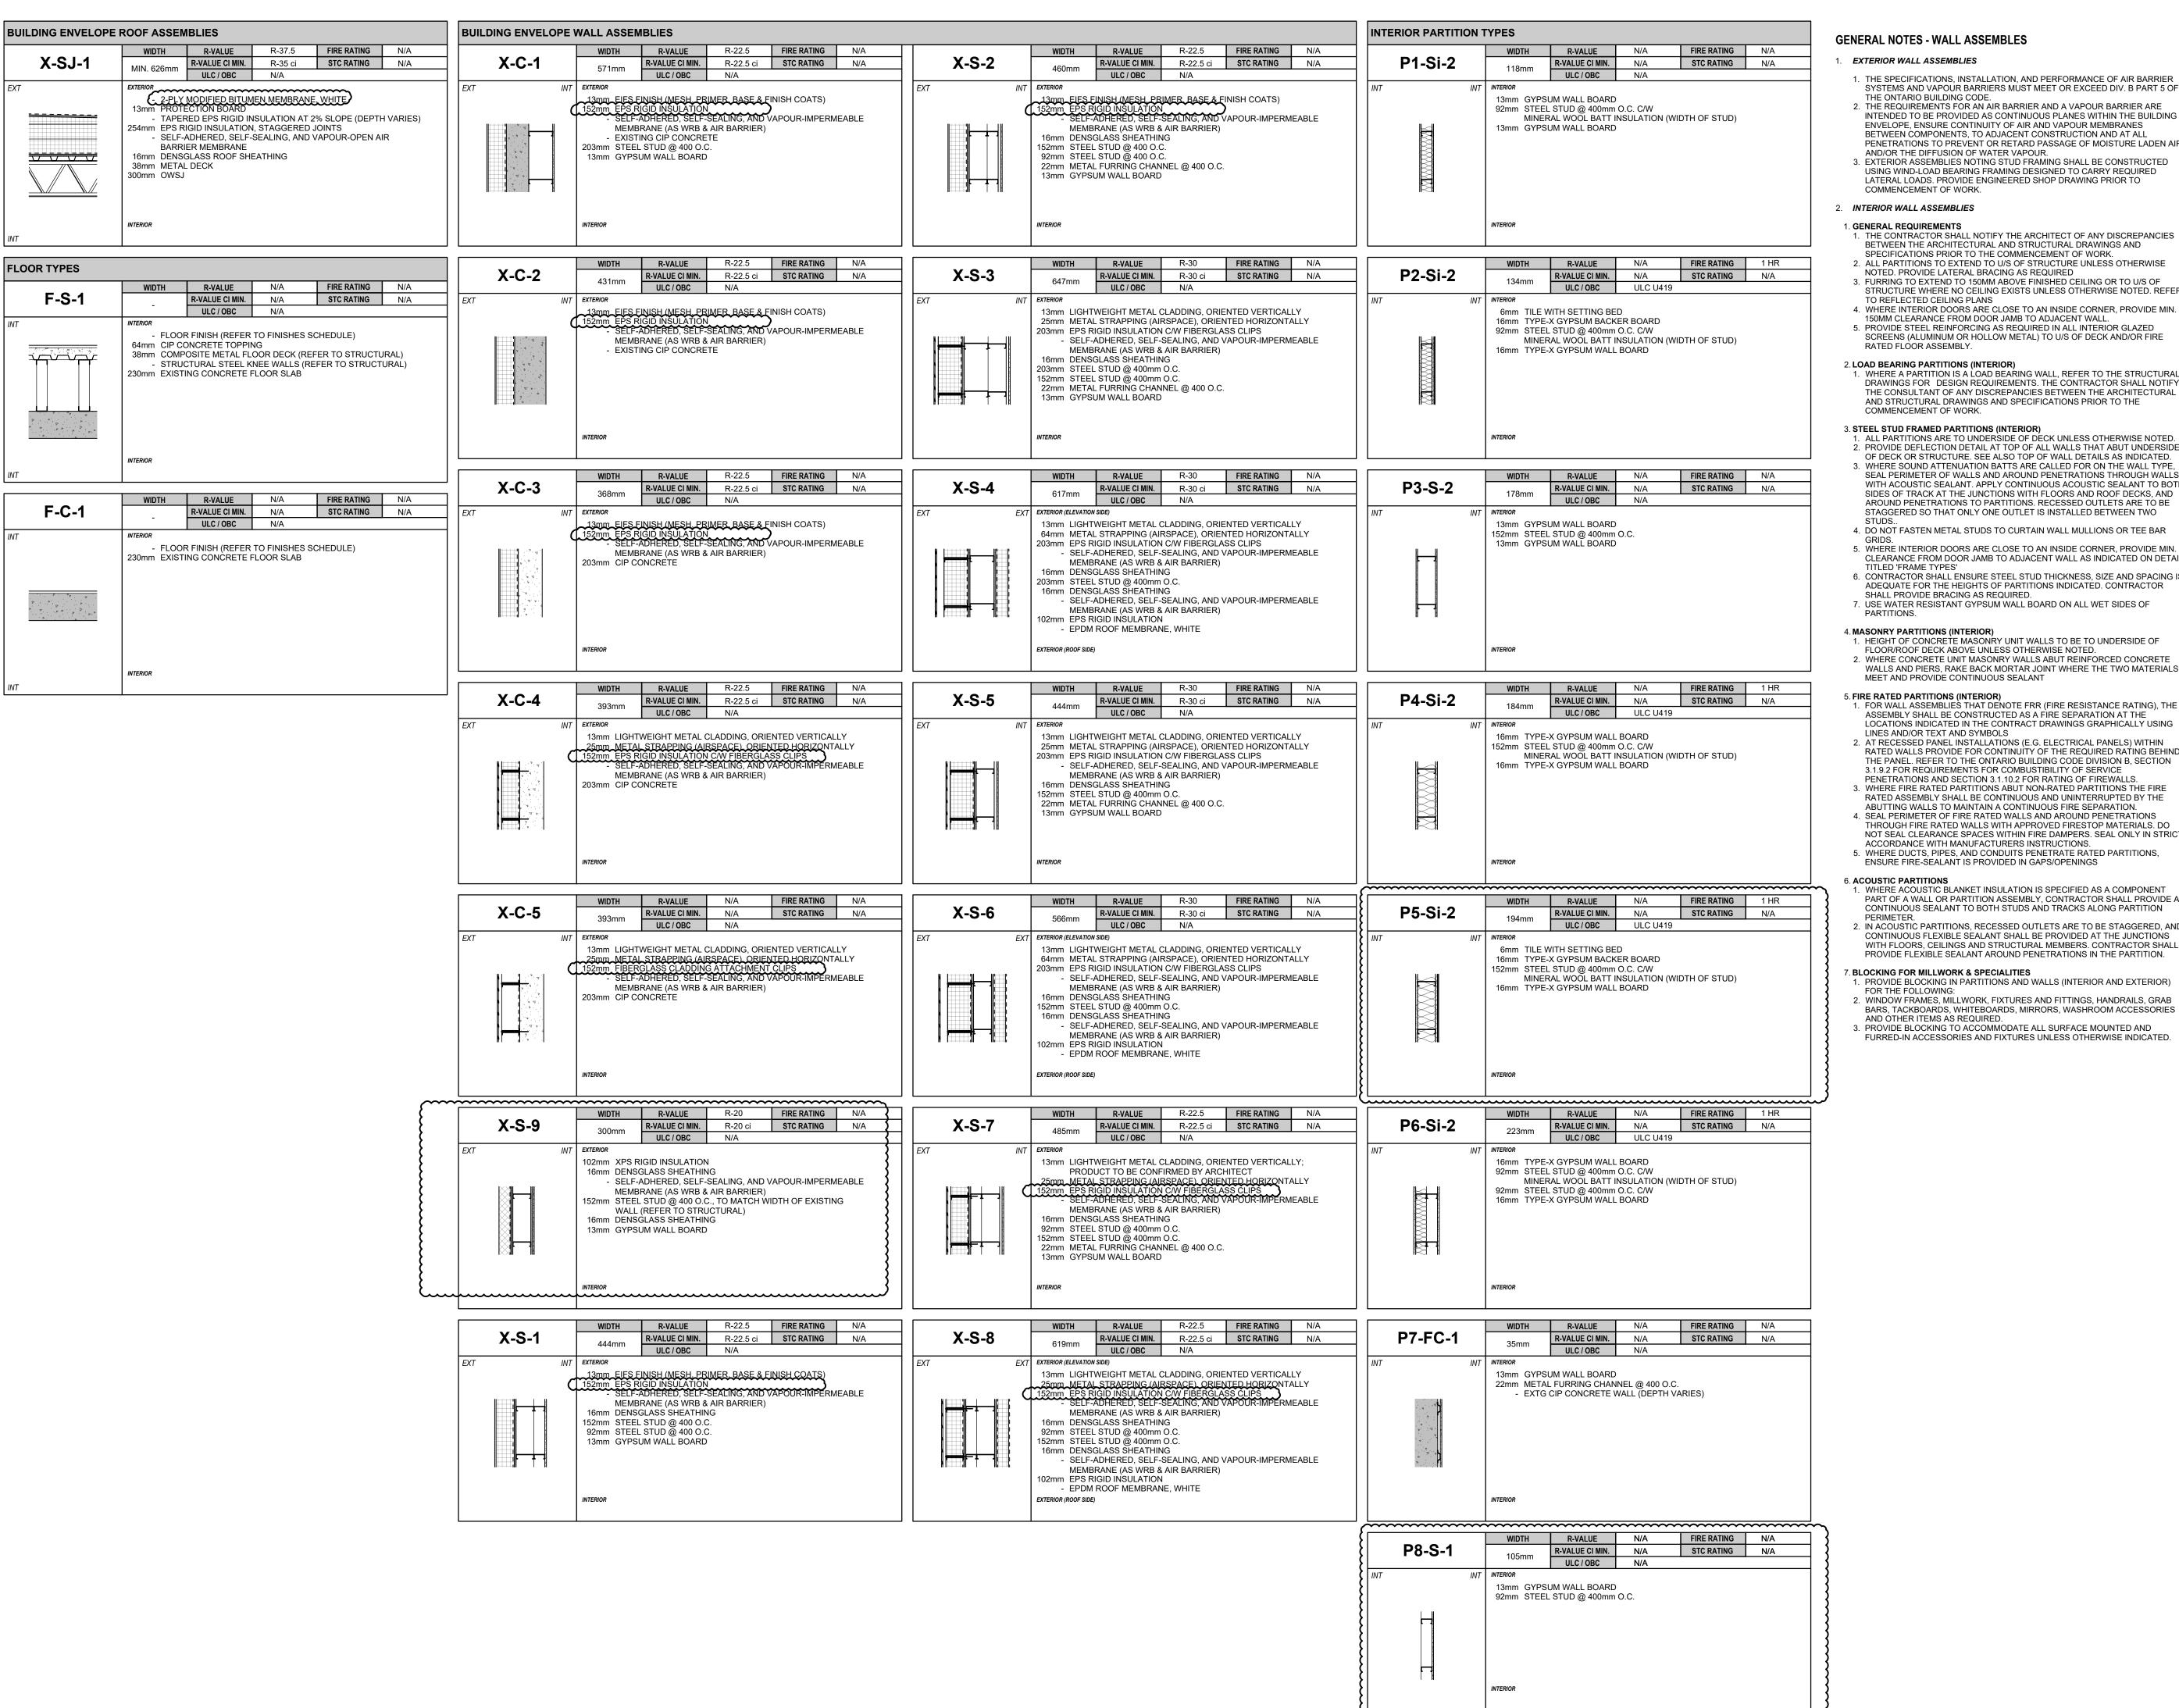

GENERAL NOTES - WALL ASSEMBLES

1. EXTERIOR WALL ASSEMBLIES

- 1. THE SPECIFICATIONS, INSTALLATION, AND PERFORMANCE OF AIR BARRIER SYSTEMS AND VAPOUR BARRIERS MUST MEET OR EXCEED DIV. B PART 5 OF
- THE ONTARIO BUILDING CODE. 2. THE REQUIREMENTS FOR AN AIR BARRIER AND A VAPOUR BARRIER ARE INTENDED TO BE PROVIDED AS CONTINUOUS PLANES WITHIN THE BUILDING ENVELOPE. ENSURE CONTINUITY OF AIR AND VAPOUR MEMBRANES
- PENETRATIONS TO PREVENT OR RETARD PASSAGE OF MOISTURE LADEN AIR AND/OR THE DIFFUSION OF WATER VAPOUR. 3. EXTERIOR ASSEMBLIES NOTING STUD FRAMING SHALL BE CONSTRUCTED USING WIND-LOAD BEARING FRAMING DESIGNED TO CARRY REQUIRED LATERAL LOADS. PROVIDE ENGINEERED SHOP DRAWING PRIOR TO COMMENCEMENT OF WORK.

2. INTERIOR WALL ASSEMBLIES

- . GENERAL REQUIREMENTS I. THE CONTRACTOR SHALL NOTIFY THE ARCHITECT OF ANY DISCREPANCIES BETWEEN THE ARCHITECTURAL AND STRUCTURAL DRAWINGS AND
- SPECIFICATIONS PRIOR TO THE COMMENCEMENT OF WORK 2. ALL PARTITIONS TO EXTEND TO U/S OF STRUCTURE UNLESS OTHERWISE
- NOTED. PROVIDE LATERAL BRACING AS REQUIRED 3. FURRING TO EXTEND TO 150MM ABOVE FINISHED CEILING OR TO U/S OF
- STRUCTURE WHERE NO CEILING EXISTS UNLESS OTHERWISE NOTED. REFER TO REFLECTED CEILING PLANS
- 150MM CLEARANCE FROM DOOR JAMB TO ADJACENT WALL. 5. PROVIDE STEEL REINFORCING AS REQUIRED IN ALL INTERIOR GLAZED SCREENS (ALUMINUM OR HOLLOW METAL) TO U/S OF DECK AND/OR FIRE RATED FLOOR ASSEMBLY.

2. LOAD BEARING PARTITIONS (INTERIOR)

1. WHERE A PARTITION IS A LOAD BEARING WALL, REFER TO THE STRUCTURAL DRAWINGS FOR DESIGN REQUIREMENTS. THE CONTRACTOR SHALL NOTIFY AND STRUCTURAL DRAWINGS AND SPECIFICATIONS PRIOR TO THE

- THE CONSULTANT OF ANY DISCREPANCIES BETWEEN THE ARCHITECTURAL COMMENCEMENT OF WORK. 3. STEEL STUD FRAMED PARTITIONS (INTERIOR)
- 1. ALL PARTITIONS ARE TO UNDERSIDE OF DECK UNLESS OTHERWISE NOTED.
- 2. PROVIDE DEFLECTION DETAIL AT TOP OF ALL WALLS THAT ABUT UNDERSIDE OF DECK OR STRUCTURE, SEE ALSO TOP OF WALL DETAILS AS INDICATED. 3. WHERE SOUND ATTENUATION BATTS ARE CALLED FOR ON THE WALL TYPE. SEAL PERIMETER OF WALLS AND AROUND PENETRATIONS THROUGH WALLS WITH ACOUSTIC SEALANT, APPLY CONTINUOUS ACOUSTIC SEALANT TO BOTH SIDES OF TRACK AT THE JUNCTIONS WITH FLOORS AND ROOF DECKS, AND AROUND PENETRATIONS TO PARTITIONS. RECESSED OUTLETS ARE TO BE
- 4. DO NOT FASTEN METAL STUDS TO CURTAIN WALL MULLIONS OR TEE BAR
- 5. WHERE INTERIOR DOORS ARE CLOSE TO AN INSIDE CORNER, PROVIDE MIN. CLEARANCE FROM DOOR JAMB TO ADJACENT WALL AS INDICATED ON DETAIL
- TITLED 'FRAME TYPES' 6. CONTRACTOR SHALL ENSURE STEEL STUD THICKNESS, SIZE AND SPACING IS ADEQUATE FOR THE HEIGHTS OF PARTITIONS INDICATED. CONTRACTOR
- SHALL PROVIDE BRACING AS REQUIRED. 7. USE WATER RESISTANT GYPSUM WALL BOARD ON ALL WET SIDES OF PARTITIONS.

4. MASONRY PARTITIONS (INTERIOR) 1. HEIGHT OF CONCRETE MASONRY UNIT WALLS TO BE TO UNDERSIDE OF

FLOOR/ROOF DECK ABOVE UNLESS OTHERWISE NOTED. 2. WHERE CONCRETE UNIT MASONRY WALLS ABUT REINFORCED CONCRETE WALLS AND PIERS, RAKE BACK MORTAR JOINT WHERE THE TWO MATERIALS MEET AND PROVIDE CONTINUOUS SEALANT

5. FIRE RATED PARTITIONS (INTERIOR)

1. FOR WALL ASSEMBLIES THAT DENOTE FRR (FIRE RESISTANCE RATING), THE ASSEMBLY SHALL BE CONSTRUCTED AS A FIRE SEPARATION AT THE LOCATIONS INDICATED IN THE CONTRACT DRAWINGS GRAPHICALLY USING

- LINES AND/OR TEXT AND SYMBOLS 2. AT RECESSED PANEL INSTALLATIONS (E.G. ELECTRICAL PANELS) WITHIN RATED WALLS PROVIDE FOR CONTINUITY OF THE REQUIRED RATING BEHIND THE PANEL. REFER TO THE ONTARIO BUILDING CODE DIVISION B, SECTION 3.1.9.2 FOR REQUIREMENTS FOR COMBUSTIBILITY OF SERVICE
- PENETRATIONS AND SECTION 3.1.10.2 FOR RATING OF FIREWALLS. 3. WHERE FIRE RATED PARTITIONS ABUT NON-RATED PARTITIONS THE FIRE RATED ASSEMBLY SHALL BE CONTINUOUS AND UNINTERRUPTED BY THE
- ABUTTING WALLS TO MAINTAIN A CONTINUOUS FIRE SEPARATION. 4. SEAL PERIMETER OF FIRE RATED WALLS AND AROUND PENETRATIONS THROUGH FIRE RATED WALLS WITH APPROVED FIRESTOP MATERIALS, DO NOT SEAL CLEARANCE SPACES WITHIN FIRE DAMPERS. SEAL ONLY IN STRICT
- ACCORDANCE WITH MANUFACTURERS INSTRUCTIONS 5. WHERE DUCTS, PIPES, AND CONDUITS PENETRATE RATED PARTITIONS. ENSURE FIRE-SEALANT IS PROVIDED IN GAPS/OPENINGS

6. ACOUSTIC PARTITIONS

1. WHERE ACOUSTIC BLANKET INSULATION IS SPECIFIED AS A COMPONENT PART OF A WALL OR PARTITION ASSEMBLY, CONTRACTOR SHALL PROVIDE A CONTINUOUS SEALANT TO BOTH STUDS AND TRACKS ALONG PARTITION 2. IN ACOUSTIC PARTITIONS, RECESSED OUTLETS ARE TO BE STAGGERED, AND

CONTINUOUS FLEXIBLE SEALANT SHALL BE PROVIDED AT THE JUNCTIONS WITH FLOORS, CEILINGS AND STRUCTURAL MEMBERS. CONTRACTOR SHALL PROVIDE FLEXIBLE SEALANT AROUND PENETRATIONS IN THE PARTITION.

7. BLOCKING FOR MILLWORK & SPECIALITIES 1. PROVIDE BLOCKING IN PARTITIONS AND WALLS (INTERIOR AND EXTERIOR) FOR THE FOLLOWING:

- 2. WINDOW FRAMES, MILLWORK, FIXTURES AND FITTINGS, HANDRAILS, GRAB BARS, TACKBOARDS, WHITEBOARDS, MIRRORS, WASHROOM ACCESSORIES AND OTHER ITEMS AS REQUIRED
- 3. PROVIDE BLOCKING TO ACCOMMODATE ALL SURFACE MOUNTED AND FURRED-IN ACCESSORIES AND FIXTURES UNLESS OTHERWISE INDICATED.



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DISCREPANCY TO ARCHITECTS BEFORE PROCEEDING WITH WORK.







04	ISSUED FOR ADDENDUM #3	2023.10.06
03	ISSUED FOR TENDER	2023.09.06
02	PERMIT REVISION 01	2023.07.20
01	ISSUED FOR PERMIT	2023.05.16
NO	ISSLIES/PEVISIONS	DATE

ASSEMBLIES SCHEDULE

DRAWING TITLE:

ISSUE DATE:	202	23.09.06
DRAWN BY: MM	CHECKED BY:	SL
PROJECT NO.: 12228	SCALE:	NTS
DRAWING NO :	l DEV	/ICION:

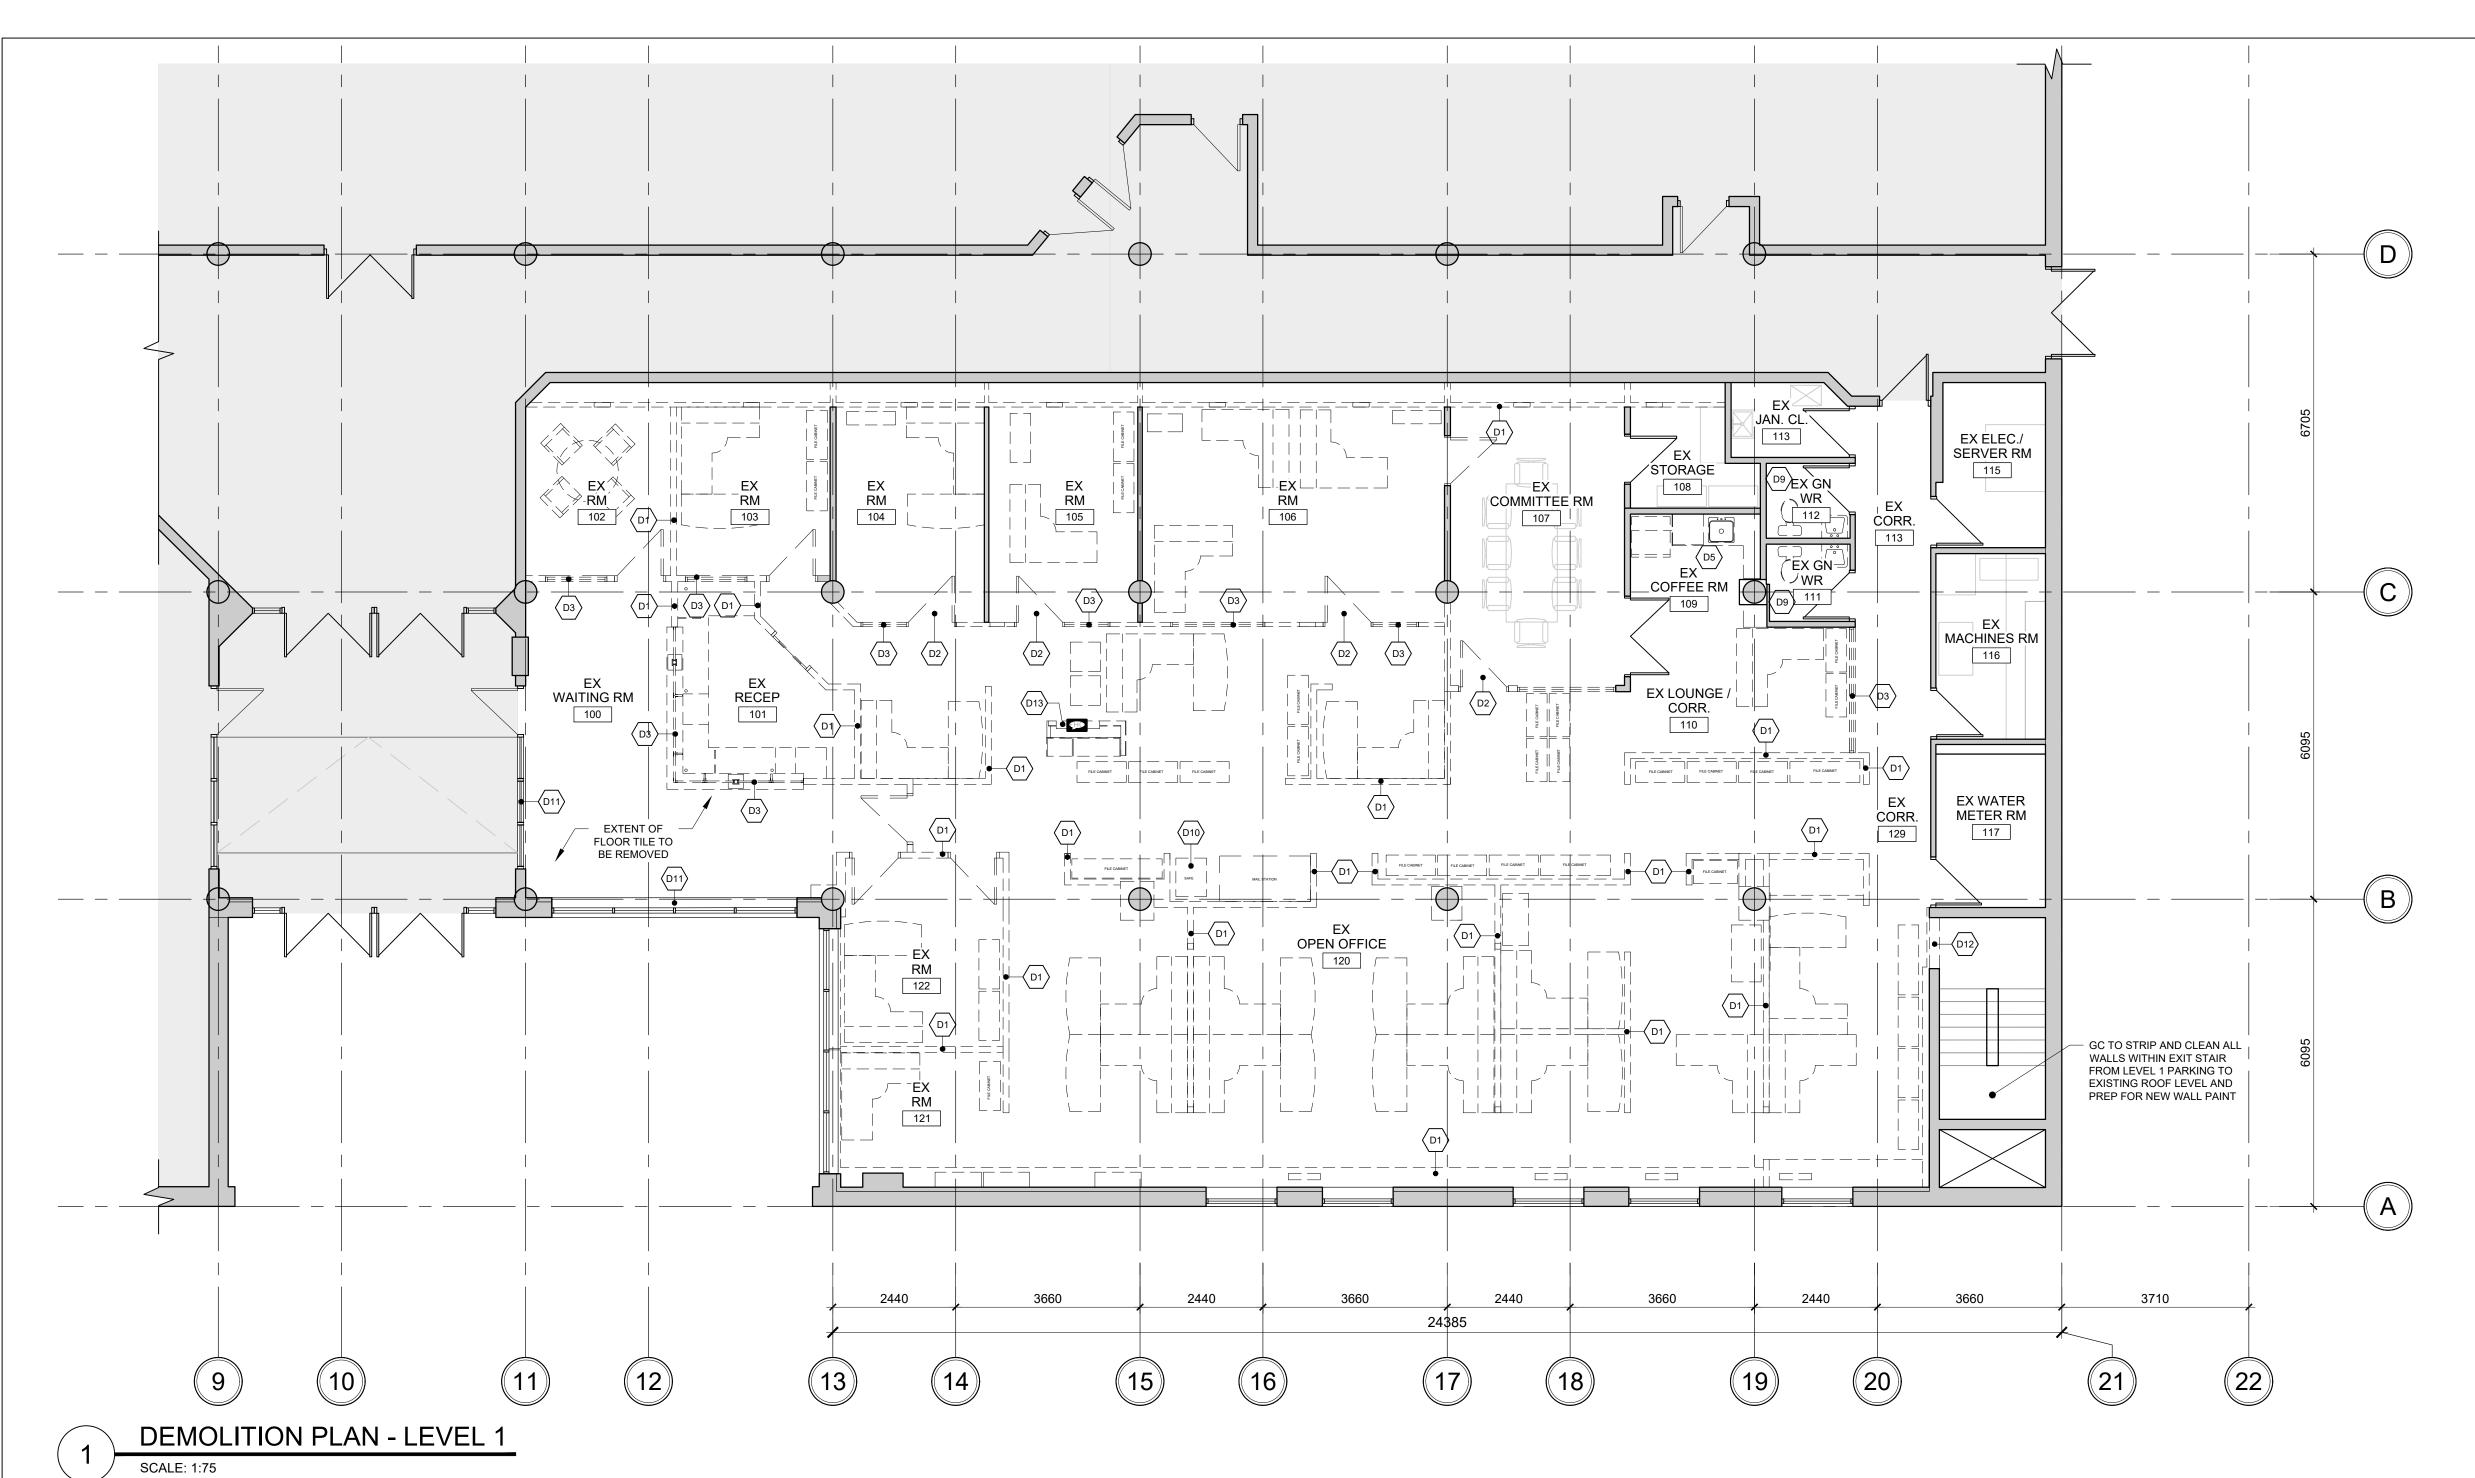

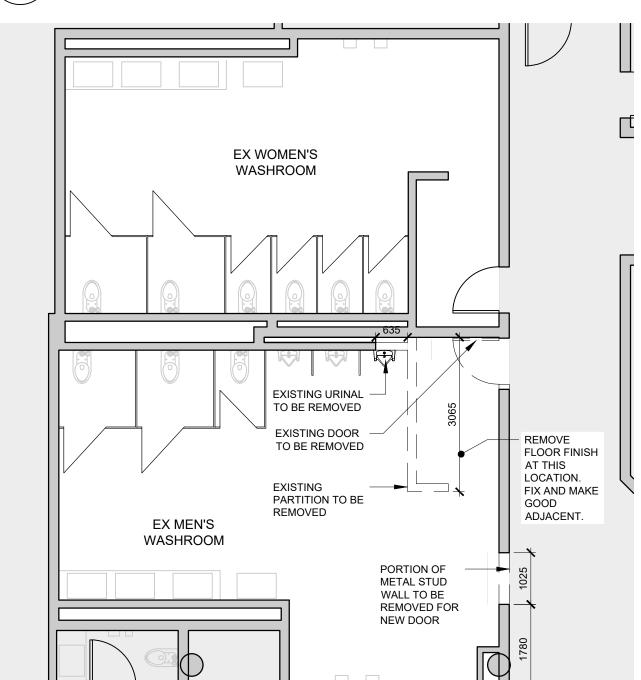

GENERAL DEMOLITION NOTES:

GENERAL REQUIREMENTS

1. ALL WORK SHALL CONFORM TO THE REQUIREMENTS OF ALL EXISTING BY-LAWS, CODES, MUNICIPAL GOVERNMENTS AND AUTHORITIES HAVING JURISDICTION. OBTAIN ALL PERMITS

REQUIRED IN ACCORDANCE WITH THE CONTRACT.

- 2. CAREFUL EXAMINATION OF ALL TENDER DOCUMENTS IS REQUIRED TO DETERMINE THE FULL SCOPE OF THE WORK. 3. PROVIDE DUST-TIGHT HOARDING PARTITIONS WHERE REQUIRED
- FOR PHASING. SEAL ALL AREAS OF CONSTRUCTION TO ALLOW FOR ALL OTHER FLOOR AREAS TO REMAIN OPERATIONAL DURING CONSTRUCTION. 4. GC TO COORDINATE EXTENT OF DEMOLITION WITH MECHANICAL, ELECTRICAL, AND STRUCTURAL DRAWINGS. ANY AREAS NOT
- SHOWN ON ARCHITECTURAL DRAWINGS, WHICH REQUIRE INSTALLATION OF NEW SERVICES, IS TO BE RETURNED TO ORIGINAL STATE TO MATCH EXISTING 5. PATCH AND REPAIR ALL ADJACENT SURFACES TO AREAS OF
- DEMOLITION AS REQUIRED TO MATCH EXISTING OR READY FOR
- 6. CLEAN, PATCH AND REPAIR ALL SURFACES TO REMAIN AS REQUIRED FOR NEW FINISHES.
- FIXTURES, DIFFUSERS, CEILING MOUNTED DEVICES, ETC, AS REQUIRED FOR AREAS WHERE CEILINGS ARE REQUIRED TO BE REMOVED TO INSTALL NEW OR MODIFY EXISTING SERVICES. ALL CEILINGS TO BE RESTORED BACK TO ORIGINAL STATE. 8. GC TO VERIFY IN FIELD ALL EXISTING MEASUREMENTS AND

7. PROVIDE TEMPORARY SUPPORT FOR ADJACENT CEILINGS, LIGHT

- CONDITIONS. ANY DISCREPANCIES SHALL BE BROUGHT TO THE PROJECT MANAGER'S ATTENTION PRIOR TO THE END OF TENDER 9. WHERE EXISTING SURFACES TO REMAIN ARE DISTURBED BY THE
- REMOVAL OF EXISTING WORK OR THE INSTALLATION OF NEW WORK, MAKE GOOD ALL SURFACES TO MATCH ADJACENT EXISTING SURFACES. REPAINT EXISTING PAINTED SURFACES COMPLETE TO THE NEAREST CHANGES IN PLANE.
- 10. UNLESS OTHERWISE NOTED, ALL DIMENSIONS ARE MEASURED TO FINISH FACE OF MASONRY OR GYPSUM WALL BOARD WHERE APPLICABLE.
- 11. UNLESS OTHERWISE NOTED, ALL GRID LINES ARE ON CENTRE OF COLUMNS 12. WHERE EXISTING SURFACES TO REMAIN ARE DISTURBED BY THE
- REMOVAL OF EXISTING WORK OR THE INSTALLATION OF NEW WORK. MAKE GOOD ALL SURFACES TO MATCH THE ADJACENT EXISTING SURFACES. REPAINT EXISTING PAINTED SURFACES COMPLETE TO THE NEAREST CHANGES IN PLANE, APPLIES FOR BOTH WALLS AND

FLOOR PLAN DEMOLITION NOTES:

REMOVE AND DISPOSE OF EXISTING PARTITION / WALL. PATCH AND REPAIR ADJACENT WALL AS REQUIRED AND MAKE READY FOR NEW FINISHES. REMOVAL TO INCLUDE ALL EXISTING SERVICES. REFER TO AND COORDINATE WITH MECHANICAL

D13 EXISTING FIRE HOSE CABINET TO BE RELOCATED.
REFER TO MECHANICAL DRAWINGS.

REFER TO MECHANICAL DRAWINGS.

- REMOVE AND DISPOSE OF EXISTING DOOR AND
- REMOVE AND DISPOSE OF EXISTING WINDOW,
- REMOVE AND DISPOSE OF EXISTING MILLWORK, CASEWORK AND/OR SHELVING, WHITEBOARDS, WALLCOVERING TYPE C/W ALL ASSOCIATED TRIMS . REMOVAL TO INCLUDE ALL ASSOCIATED HARDWARE AND ACCESSORIES. PATCH, REPAIR AND MAKE GOOD, FLAT, SMOOTH (TAPING, MUDDING AS
- EXISTING ELECTRICAL COMPONENTS TO BE DISCONNECTED AND REMOVED (REFER TO AND COORDINATE WITH ELECTRICAL DRAWINGS). PATCH
- EXISTING ROOF TO BE REMOVED. INCLUDING BUT NOT LIMITED TO ROOFING, STRUCTURE, VENTS, GUTTERS. FASCIA, SOFFITS, ETC. PATCH, REPAIR
- DISCONNECT, REMOVE AND DISPOSE OF EXISTING PLUMBING FIXTURES. REMOVE REDUNDANT PIPING. CAP LINES AS REQUIRED. REFER TO AND
- REMOVE AND RELOCATE EXISTING FLOOR-MOUNTED CAST IRON SAFE TO A SECURE LOCATION ON SITE FOR DURATION OF WORK. COORDINATE TEMPORARY RELOCATION WITH OWNER.
- PROVIDE OPENING IN EXISTING PATCHED WALL FOR

REMOVE EXISTING WINDOW BLINDS AND HAND OVER

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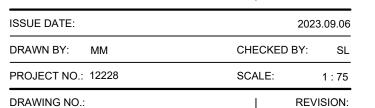
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ISSUED FOR ADDENDUM 3 2023.10.06 ISSUED FOR TENDER 2023.09.06 ISSUED FOR PERMIT 2023.05.16 Issued for Pre-consultation 2022.10.07 Issued for Coordination 2022.07.29 ISSUES/REVISIONS DATE DRAWING TITLE:

DEMOLITION PLAN



DEMOLITION PLAN - LEVEL 1 WASHROOMS

AND ELECTRICAL DRAWINGS

SCREEN, GLAZING, AND ACCESSORIES REMOVE OF FURNITURE AND EQUIPMENT. HANDOVER OF FURNITURE AND EQUIPMENT TO OWNER.

REQUIRED) ADJACENT SURFACES


EXISTING FLOOR STRUCTURE TO BE REMOVED. PATCH, REPAIR AND MAKE GOOD, FLAT, SMOOTH (TAPING, MUDDING AS REQUIRED) ADJACENT SURFACES AS REQUIRED

AND REPAIR ADJACENT SURFACES AS REQUIRED

AND MAKE GOOD, FLAT, SMOOTH (TAPING, MUDDING AS REQUIRED) EXISTING ADJACENT SURFACES AS

COORDINATE WITH MECHANICAL DRAWINGS

NEW DOOR. REMOVE AND DISPOSE OF EXISTING DOOR IN STAIR WELL. MAKE GOOD FOR NEW FINISHES

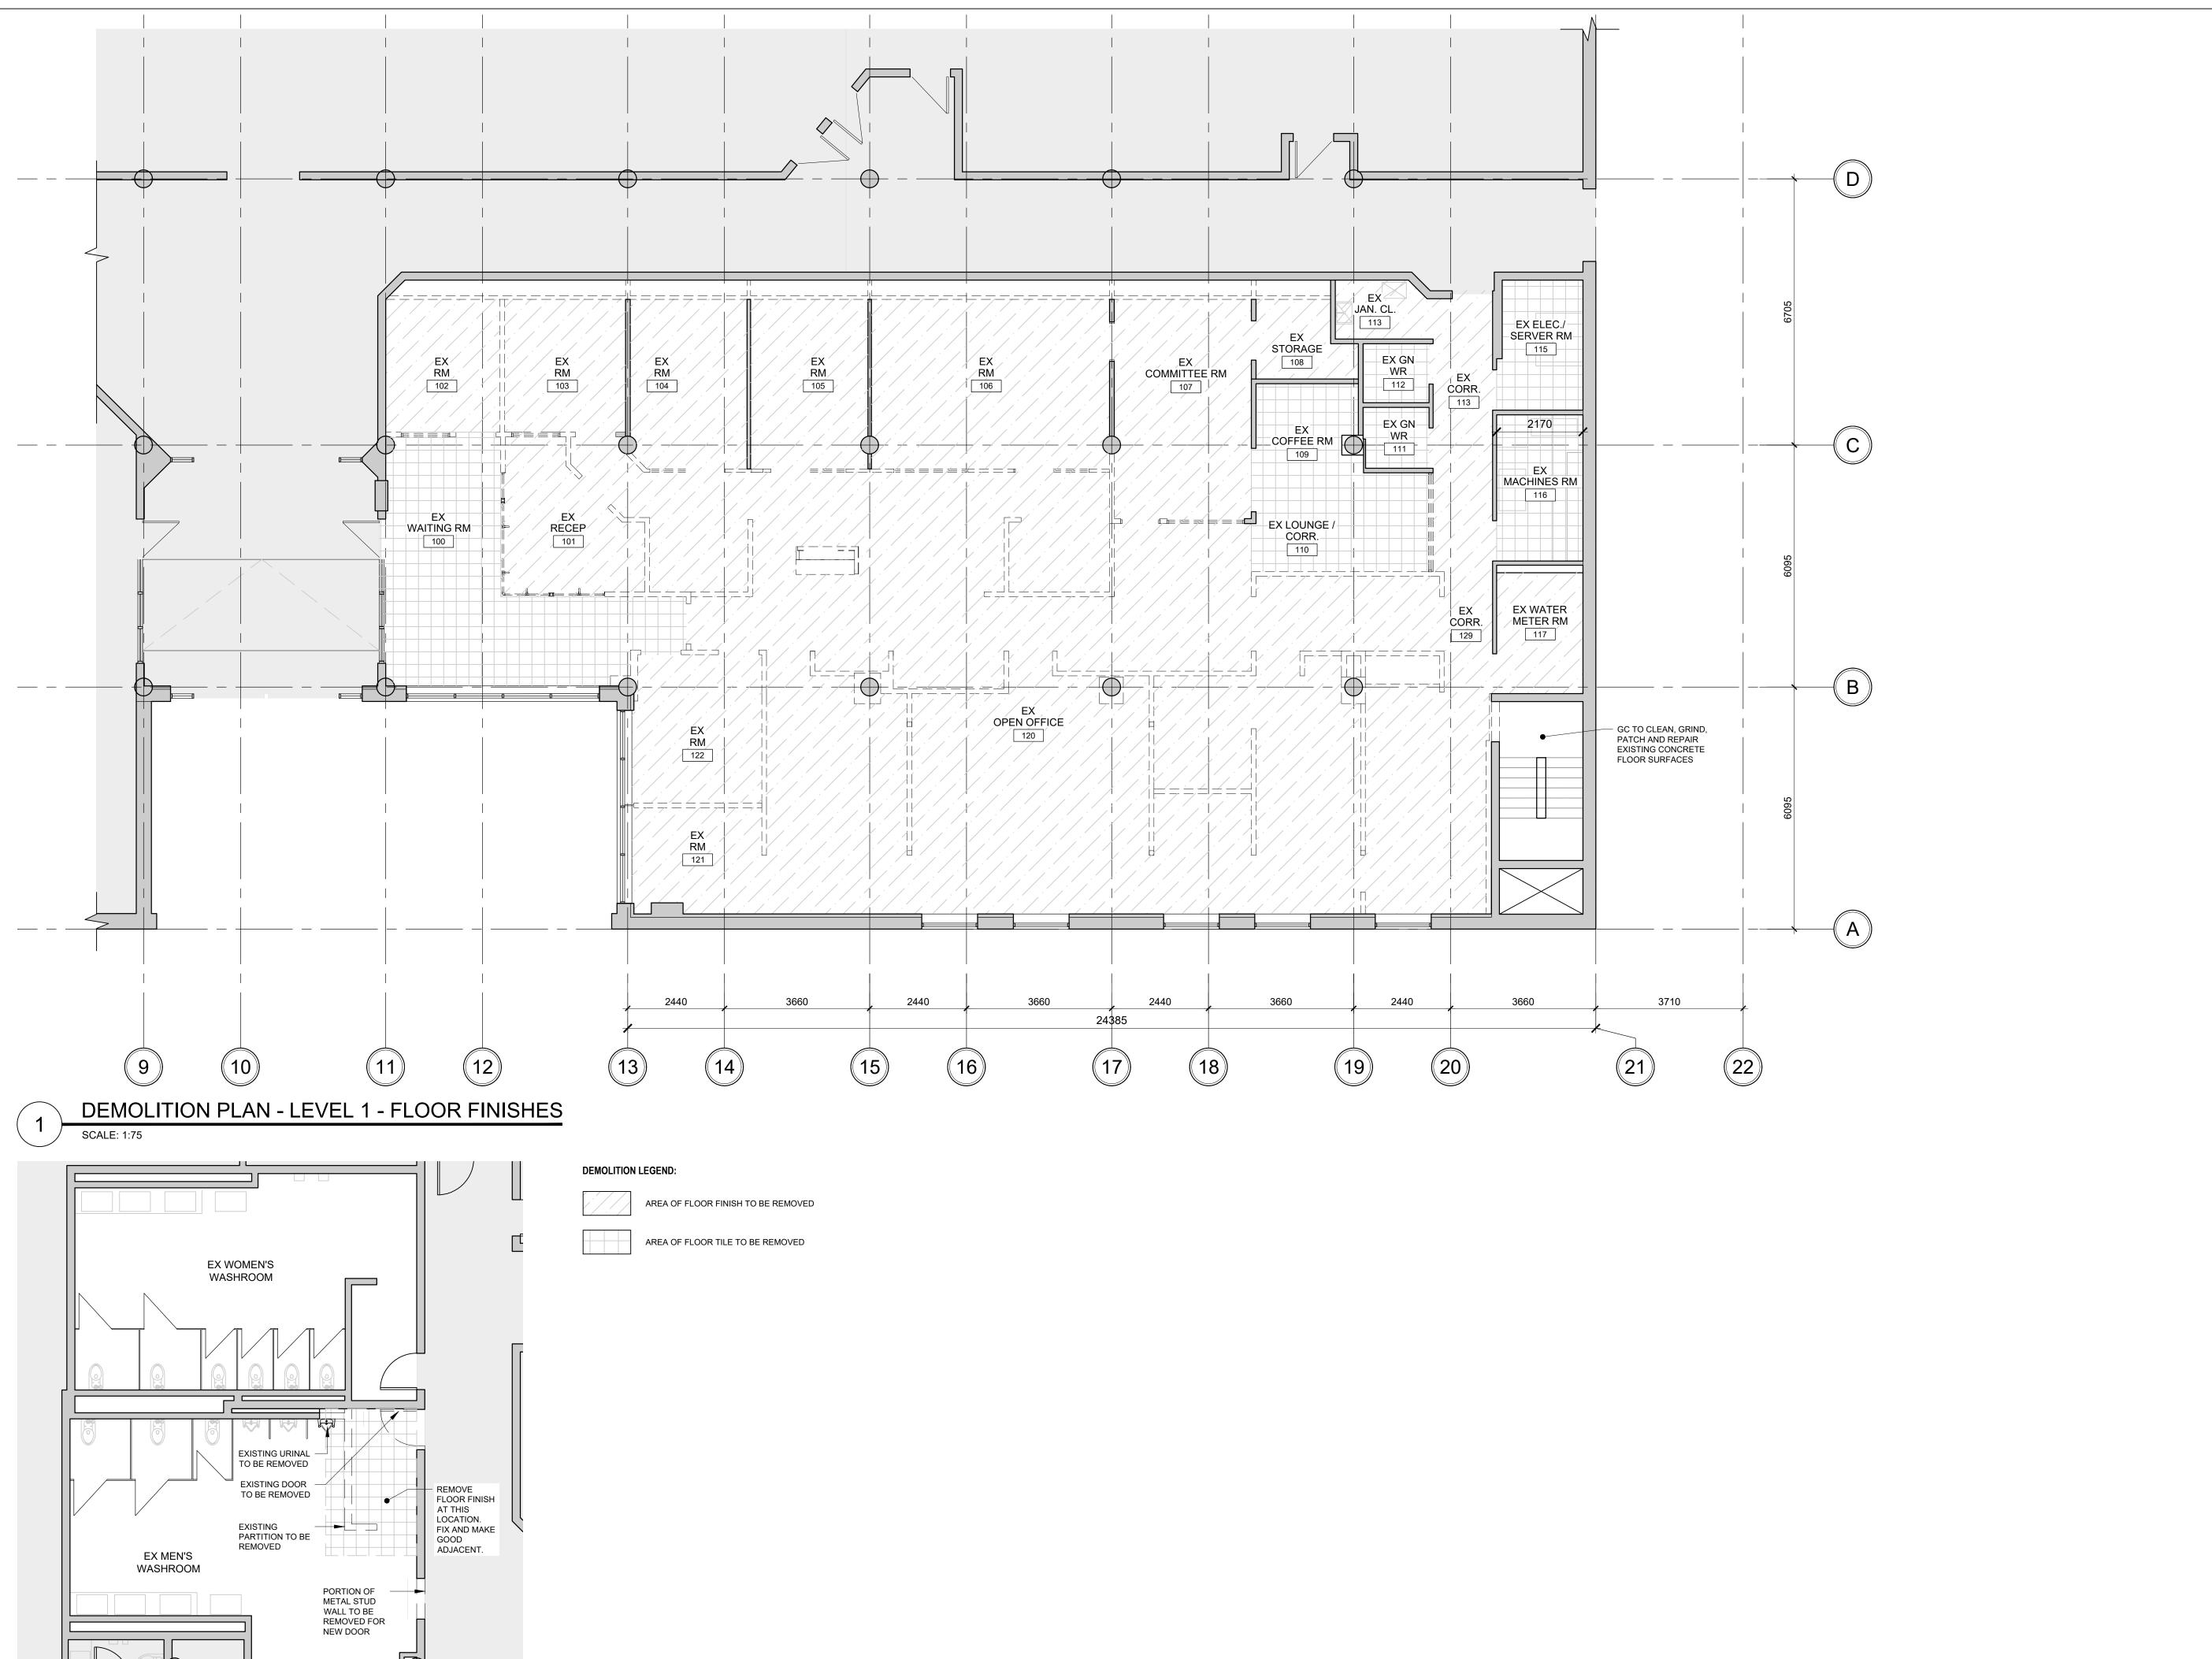

DEMOLITION PLAN - LEVEL 1 WASHROOMS



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Key Plan:



04	ISSUED FOR ADDENDUM 3	2023.10.06
04	ISSUED FOR TENDER	2023.09.06
03	ISSUED FOR PERMIT	2023.05.16
02	Issued for Pre-consultation	2022.10.07
01	Issued for Coordination	2022.07.29
NO.	ISSUES/REVISIONS	DATE


DEMOLITION PLAN LEVEL 1 FLOOR FINISHES

DRAWING TITLE:

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ISSUE DATE: 2023		
DRAWN BY: GL	CHECKED BY:	SL
PROJECT NO.: 12228	SCALE:	1 : 75
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RENOVATION PLAN - LEVEL 1

SCALE: 1:75

SCALE: 1:75

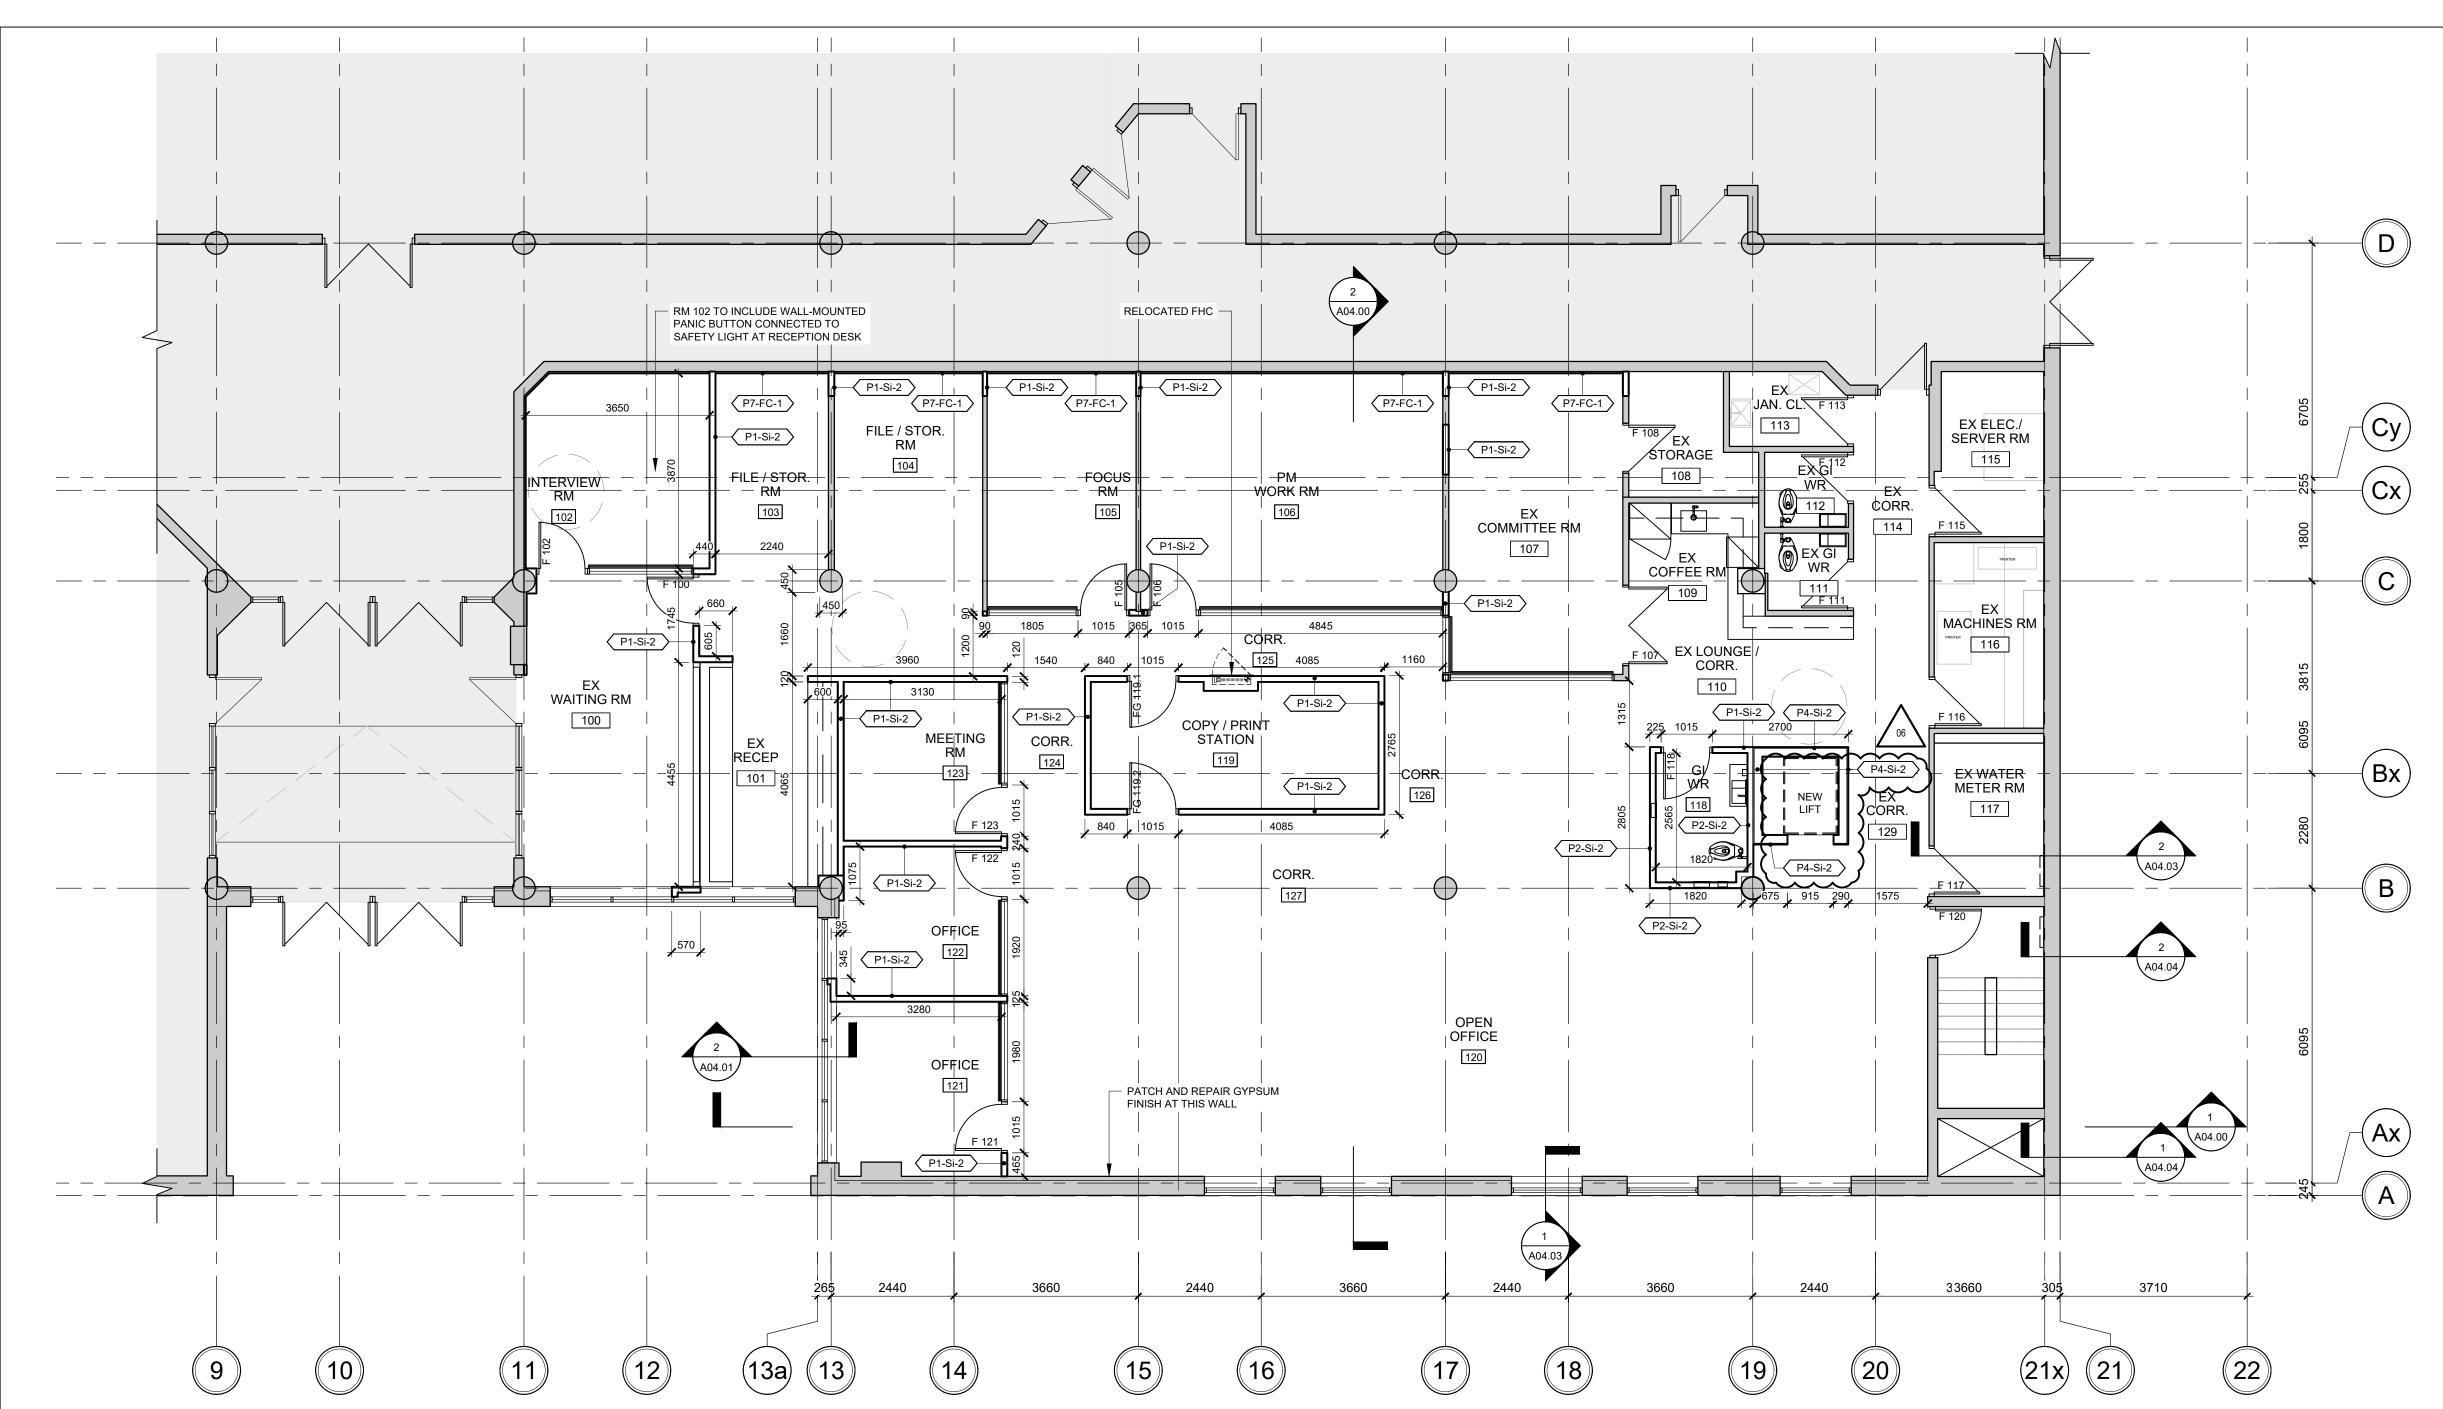EX WOMEN'S
WASHROOM

NEW UNIVERSAL
WASHROOM,
PARTITIONS,
PLUMBING
FIXTURES,
MODIFICATIONS,
AND FINISHES

EX MEN'S
WASHROOM

NEW DOOR TO EX
WASHROOM

RENOVATION PLAN - LEVEL 1 WASHROOMS

GENERAL RENOVATION PLAN NOTES:

GENERAL REQUIREMENTS

 ALL WORK SHALL CONFORM TO THE REQUIREMENTS OF ALL EXISTING BY-LAWS, CODES, MUNICIPAL GOVERNMENTS AND AUTHORITIES HAVING JURISDICTION. OBTAIN ALL PERMITS REQUIRED IN

- ACCORDANCE WITH THE CONTRACT.

 2. IF APPLICABLE, EXECUTION OF THE WORK SHALL FOLLOW ANY PHASING AS INDICATED. ISOLATE EACH AREA OF WORK AS REQUIRED SO AS TO NOT DISRUPT DAY TO DAY OPERATION. ACCESS TO WASHROOMS, ELEVATORS, STAIRS ETC. MUST BE MAINTAINED AT ALL
- 3. DIMENSIONS SHOWN ARE TAKEN TO FACE OF CMU, POURED CONCRETE, OR WALL UNLESS NOTED OTHERWISE. ALL GWB OR CMU PARTITIONS TO EXTEND TIGHT TO U/S OF DECK UNLESS NOTED OTHERWISE.
- CONSTRUCT PARTITIONS AND WALLS AS FIRE SEPARATIONS WHERE INDICATED ON PLAN
 ALL INTERIOR ALUM SCREENS SHALL HAVE GWB AND METAL STUD
- ASSEMBLIES FROM TOP OF SCREEN/DOOR FRAME TO UNDERSIDE OF DECKS UNLESS A LINTEL HAS BEEN PROVIDED BY STRUCTURAL DRAWINGS WITH BLOCK WALL ABOVE TO U/S DECKS.

 6. WHERE SCREENS OR DOORS OCCUR WITHIN WALLS CONSTRUCTED
- 6. WHERE SCREENS OR DOORS OCCUR WITHIN WALLS CONSTRUCTED AS FIRE SEPARATIONS, THE WALL ABOVE SUCH SCREENS OR DOORS SHALL BE CONSTRUCTED TO PROVIDE THE REQUIRED FIRE RESISTANCE RATING INDICATED.
- 7. WHERE FIRE RATED PARTITIONS ABUT NON-RATED PARTITIONS THE CONTINUITY OF THE FIRE RATED ASSEMBLY SHALL BE MAINTAINED.
- 8. SEAL PERIMETER OF WALLS AND AROUND PENETRATIONS THROUGH WALLS WITH ACOUSTIC SEALANT WHERE SOUND ATTENUATION BATTS
- ARE CALLED FOR ON THE WALL TYPE.

 9. SEAL PERIMETER OF FIRE RATED WALLS AND AROUND
- PENETRATIONS THROUGH FIRE RATED WALLS WITH APPROVED FIRESTOP MATERIALS.

 10. CORNERS OF EXPOSED MASONRY WALLS SHALL BE BULLNOSE BLOCK
- CORNERS OF EXPOSED MASONRY WALLS SHALL BE BULLNOSE BLOCK UNLESS NOTED OTHERWISE.
 REFER TO ELECTRICAL DWGS FOR LOCATIONS OF PANELS, DOOR CONTROLS, SECURITY DEVICES ETC NOT SHOWN ON ARCHITECTURAL DRAWINGS.



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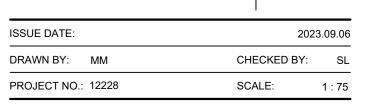
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06	ISSUED FOR ADDENDUM #3	2023.10.06
05	ISSUED FOR TENDER	2023.09.06
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RENOVATION PLAN LEVEL 1




A01.04

DRAWING NO.:

. 0

REVISION:

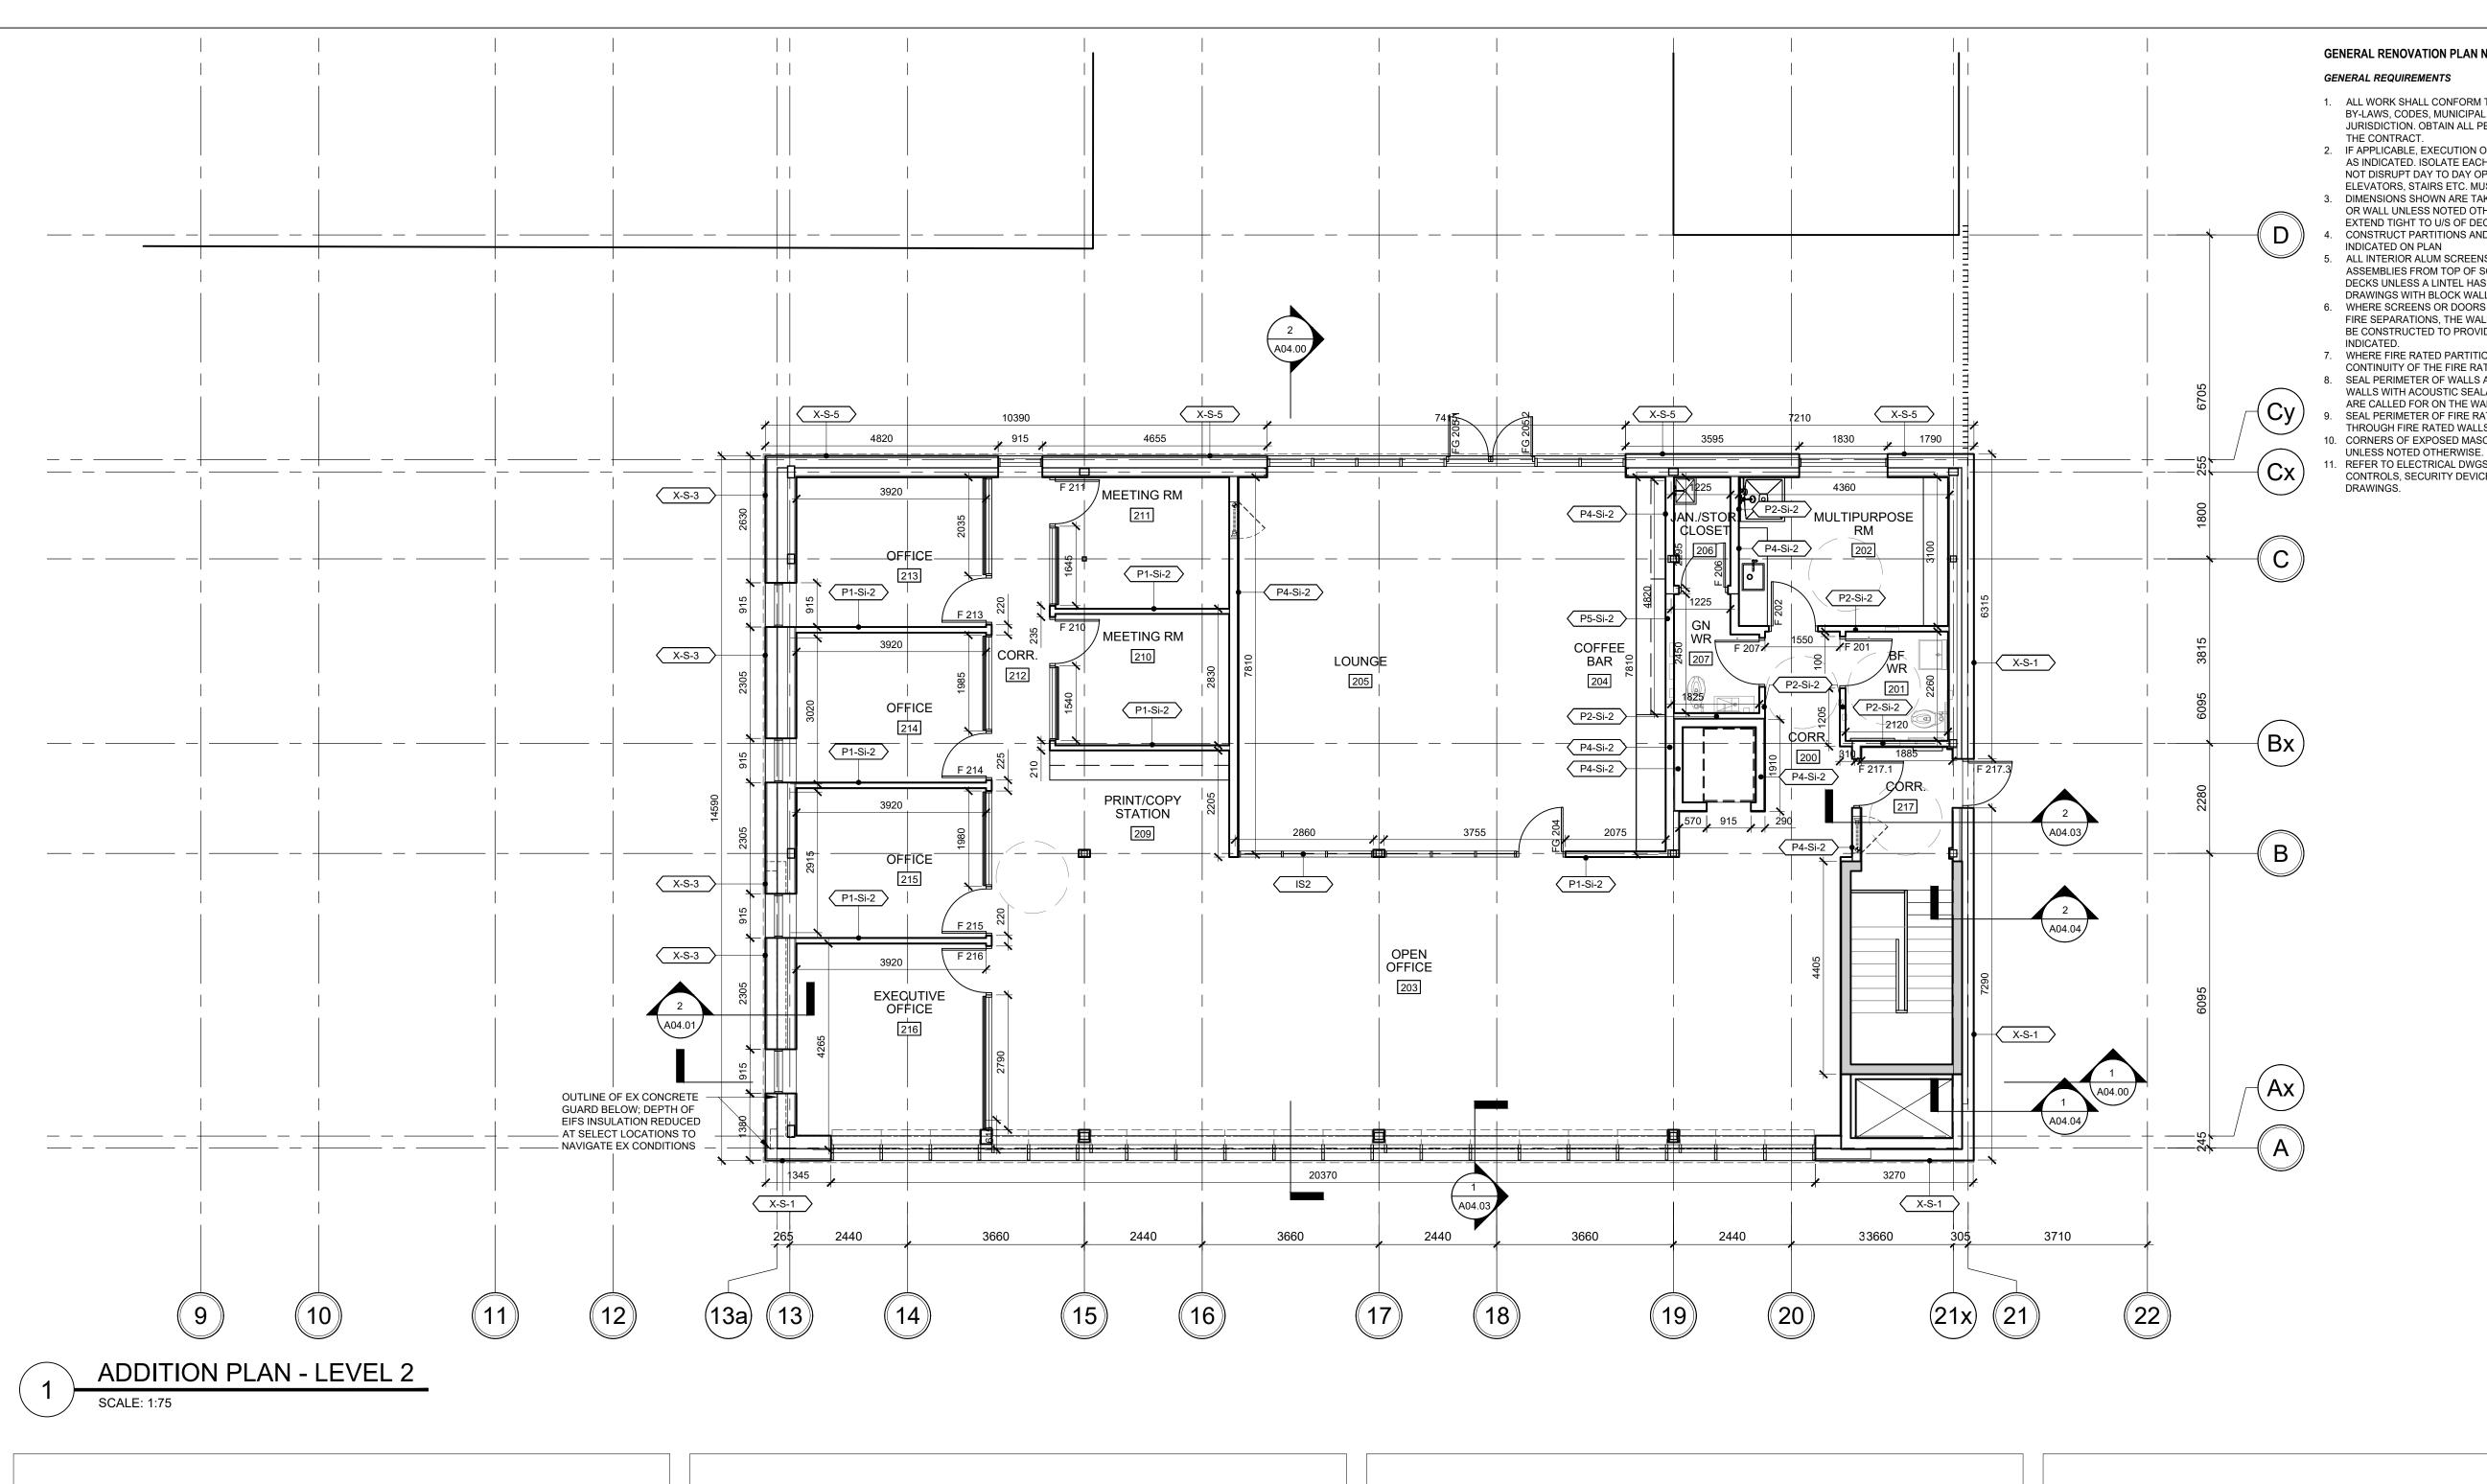

DETAIL APPLIES TO ALL AREAS

WHERE CONDITION EXISTS

REGARDLESS OF WALL TYPE

PACK MINERAL WOOL (DECK

PLUGS PREFERRED) TO FILL

GAP BETWEEN TOP OF WALL

AND DECK, FILLING FLUTES

TO INTERIOR FACE OF WALL

SEAL EXPOSED FACES

OUTSIDE

GENERAL RENOVATION PLAN NOTES:

GENERAL REQUIREMENTS

- 1. ALL WORK SHALL CONFORM TO THE REQUIREMENTS OF ALL EXISTING BY-LAWS, CODES, MUNICIPAL GOVERNMENTS AND AUTHORITIES HAVING JURISDICTION. OBTAIN ALL PERMITS REQUIRED IN ACCORDANCE WITH
- THE CONTRACT. 2. IF APPLICABLE, EXECUTION OF THE WORK SHALL FOLLOW ANY PHASING AS INDICATED. ISOLATE EACH AREA OF WORK AS REQUIRED SO AS TO NOT DISRUPT DAY TO DAY OPERATION. ACCESS TO WASHROOMS,
- ELEVATORS, STAIRS ETC. MUST BE MAINTAINED AT ALL TIMES. DIMENSIONS SHOWN ARE TAKEN TO FACE OF CMU, POURED CONCRETE, OR WALL UNLESS NOTED OTHERWISE. ALL GWB OR CMU PARTITIONS TO
- EXTEND TIGHT TO U/S OF DECK UNLESS NOTED OTHERWISE. CONSTRUCT PARTITIONS AND WALLS AS FIRE SEPARATIONS WHERE INDICATED ON PLAN ALL INTERIOR ALUM SCREENS SHALL HAVE GWB AND METAL STUD
- ASSEMBLIES FROM TOP OF SCREEN/DOOR FRAME TO UNDERSIDE OF DECKS UNLESS A LINTEL HAS BEEN PROVIDED BY STRUCTURAL DRAWINGS WITH BLOCK WALL ABOVE TO U/S DECKS.
- WHERE SCREENS OR DOORS OCCUR WITHIN WALLS CONSTRUCTED AS FIRE SEPARATIONS. THE WALL ABOVE SUCH SCREENS OR DOORS SHALL BE CONSTRUCTED TO PROVIDE THE REQUIRED FIRE RESISTANCE RATING 7. WHERE FIRE RATED PARTITIONS ABUT NON-RATED PARTITIONS THE
- CONTINUITY OF THE FIRE RATED ASSEMBLY SHALL BE MAINTAINED. 8. SEAL PERIMETER OF WALLS AND AROUND PENETRATIONS THROUGH WALLS WITH ACOUSTIC SEALANT WHERE SOUND ATTENUATION BATTS ARE CALLED FOR ON THE WALL TYPE.
- SEAL PERIMETER OF FIRE RATED WALLS AND AROUND PENETRATIONS THROUGH FIRE RATED WALLS WITH APPROVED FIRESTOP MATERIALS. 10. CORNERS OF EXPOSED MASONRY WALLS SHALL BE BULLNOSE BLOCK

TOP OF DECK

OR DECK PLUG

- BOTTOM OF DECK

MINERAL FIBER INSULATION

(DECK PLUG PREFERRED)

DEFLECTION TRACK ASSEMBLY

TRACK ALSO ACCEPTABLE)

- METAL STUD

GYPSUM BOARD

BY WALL TYPE)

(DOUBLE DEFLECTION TRACK SHOWN - DEEP LEG DEFLECTION

MINERAL FIBER INSULATION

MULTIPLE LAYERS IF REQ'D

(IF REQ'D BY WALL TYPE)

(SINGLE LAYER SHOWN -

NO CONNECTIÓN TO **DEFLECTION TRACK**

REFER TO ELECTRICAL DWGS FOR LOCATIONS OF PANELS, DOOR CONTROLS, SECURITY DEVICES ETC NOT SHOWN ON ARCHITECTURAL



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CONTRACTOR MUST VERIFY ALL DIMENSIONS ON THE JOB AND REPORT ANY

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DISCREPANCY TO ARCHITECTS BEFORE PROCEEDING WITH WORK.



ISSUED FOR ADDENDUM #3 2023.10.06 ISSUED FOR TENDER 2023.09.06 PERMIT REVISION 01 2023.07.20 **ISSUED FOR PERMIT** 2023.05.16 Issued for Pre-consultation 2022.10.07 2022.07.29 Issued for Coordination ISSUES/REVISIONS DATE DRAWING TITLE:

> ADDITION PLAN LEVEL 2

> > 2023.09.06 CHECKED BY: SL SCALE:

ISSUE DATE: DRAWN BY: MM PROJECT NO.: 12228 DRAWING NO.: REVISION:

METAL TRACK DEFLECTION DETAIL

TOW EXT. WALL - DECK PERP. TO FLUTES

ROOF

U/S OF DECK-

INSIDE

DETAIL APPLIES TO ALL AREAS

WHERE CONDITION EXISTS

REGARDLESS OF WALL TYPE

-PACK MINERAL WOOL (DECK

PLUGS PREFERRED) TO FILL

GAP BETWEEN TOP OF WALL

AND DECK, FILLING FLUTES

TO INTERIOR FACE OF WALL

SEAL EXPOSED FACES

OUTSIDE

TOW EXT. WALL - DECK PARALLEL TO FLUTES

/ ROOF \

U/S OF DECK-

SCALE: 1:4

INSIDE

METAL TRACK DEFLECTION DETAIL - FR

FIRE RATED DETAIL - MAINTAIN REQUIRED FIRE RESISTANCE RATING OVER ENTIRE ASSEMBLY

 FIRE RATED SEALANT MINERAL FIBER INSULATION

(DECK PLUG PREFERRED)

REF: ULC No. HW-D-0513 OR

- TYPE 'X' GYPSUM BOARD RIP (SINGLE LAYER SHOWN -

MULTIPLE LAYERS IF REQ'D BY

OR DECK PLUG

EQUIVALENT

U/S OF DECK

FIRE RATED DEFLECTION TRACK

WALL TYPE)

FIRE RATED SEALANT

- METAL STUD SCREWED

FRAMING BELOW


THROUGH TRACK SLOT

- MINERAL FIBER INSULATION

- NO CONNECTION TO WALL

TYPE'X' GYPSUM BUARD

(SINGLE LAYER SHOWN -MULTIPLE LAYERS IF REQ'D BY WALL TYPE)

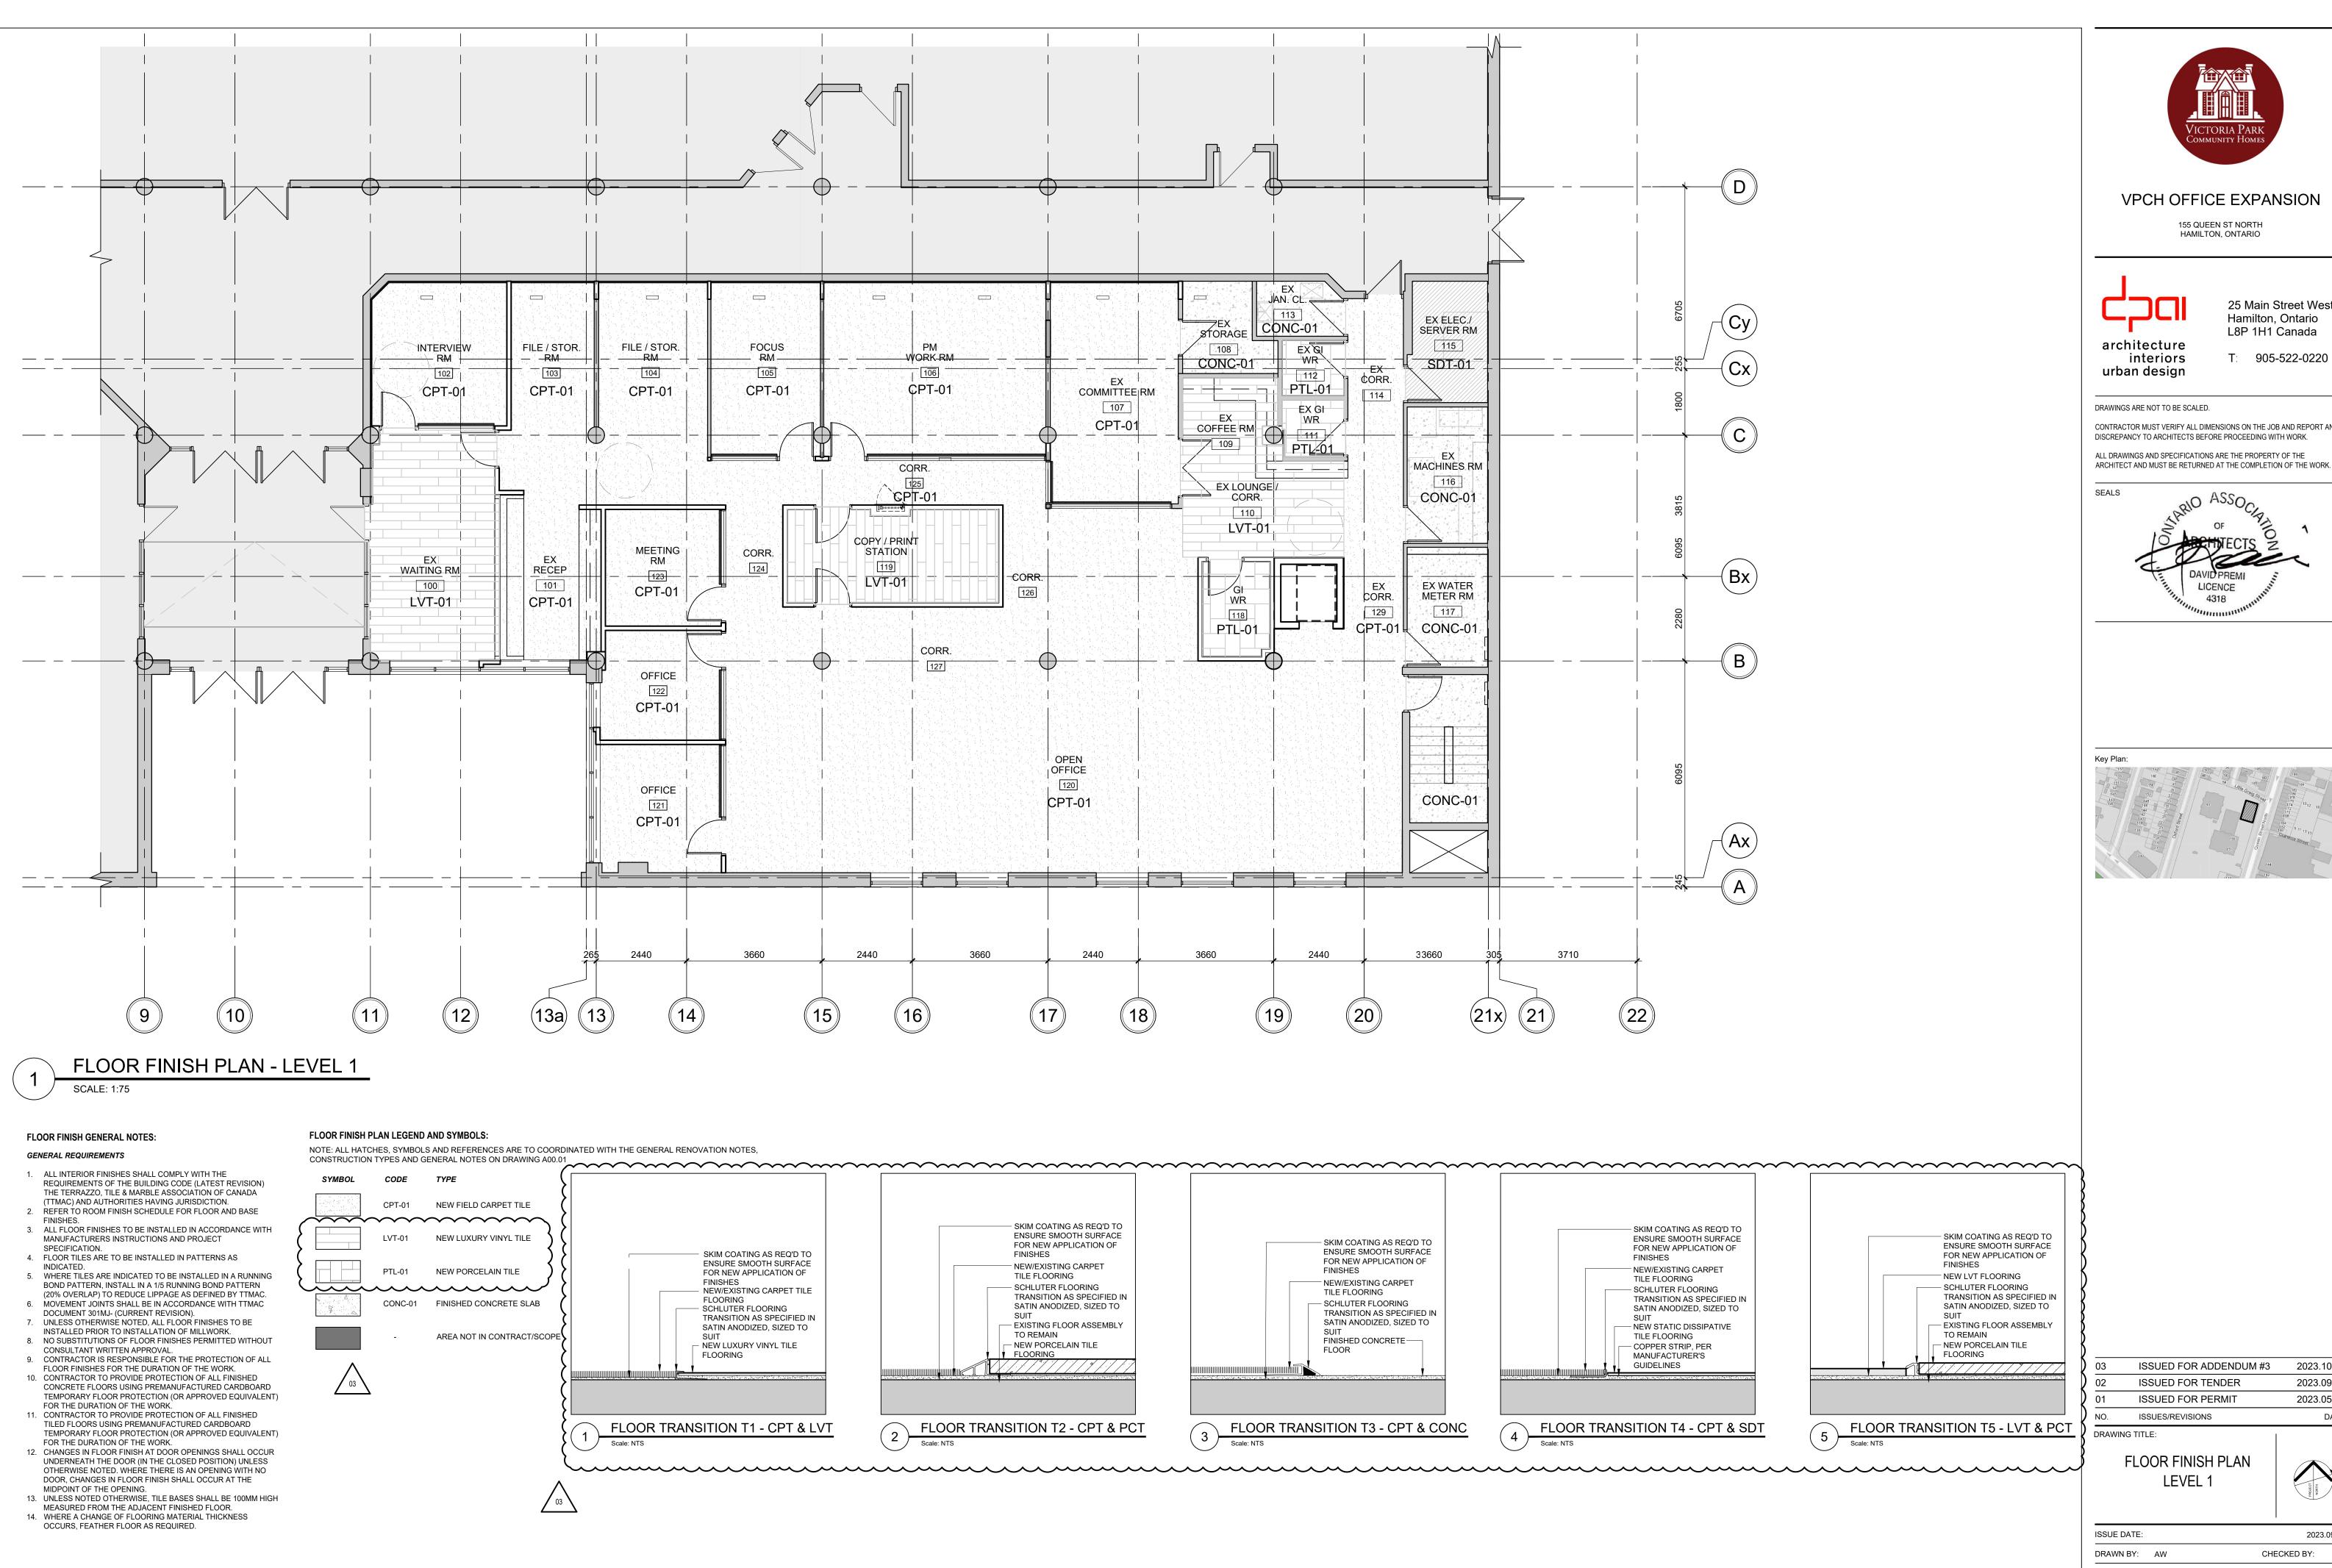

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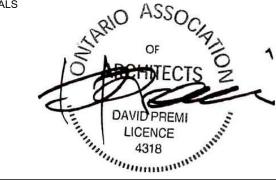
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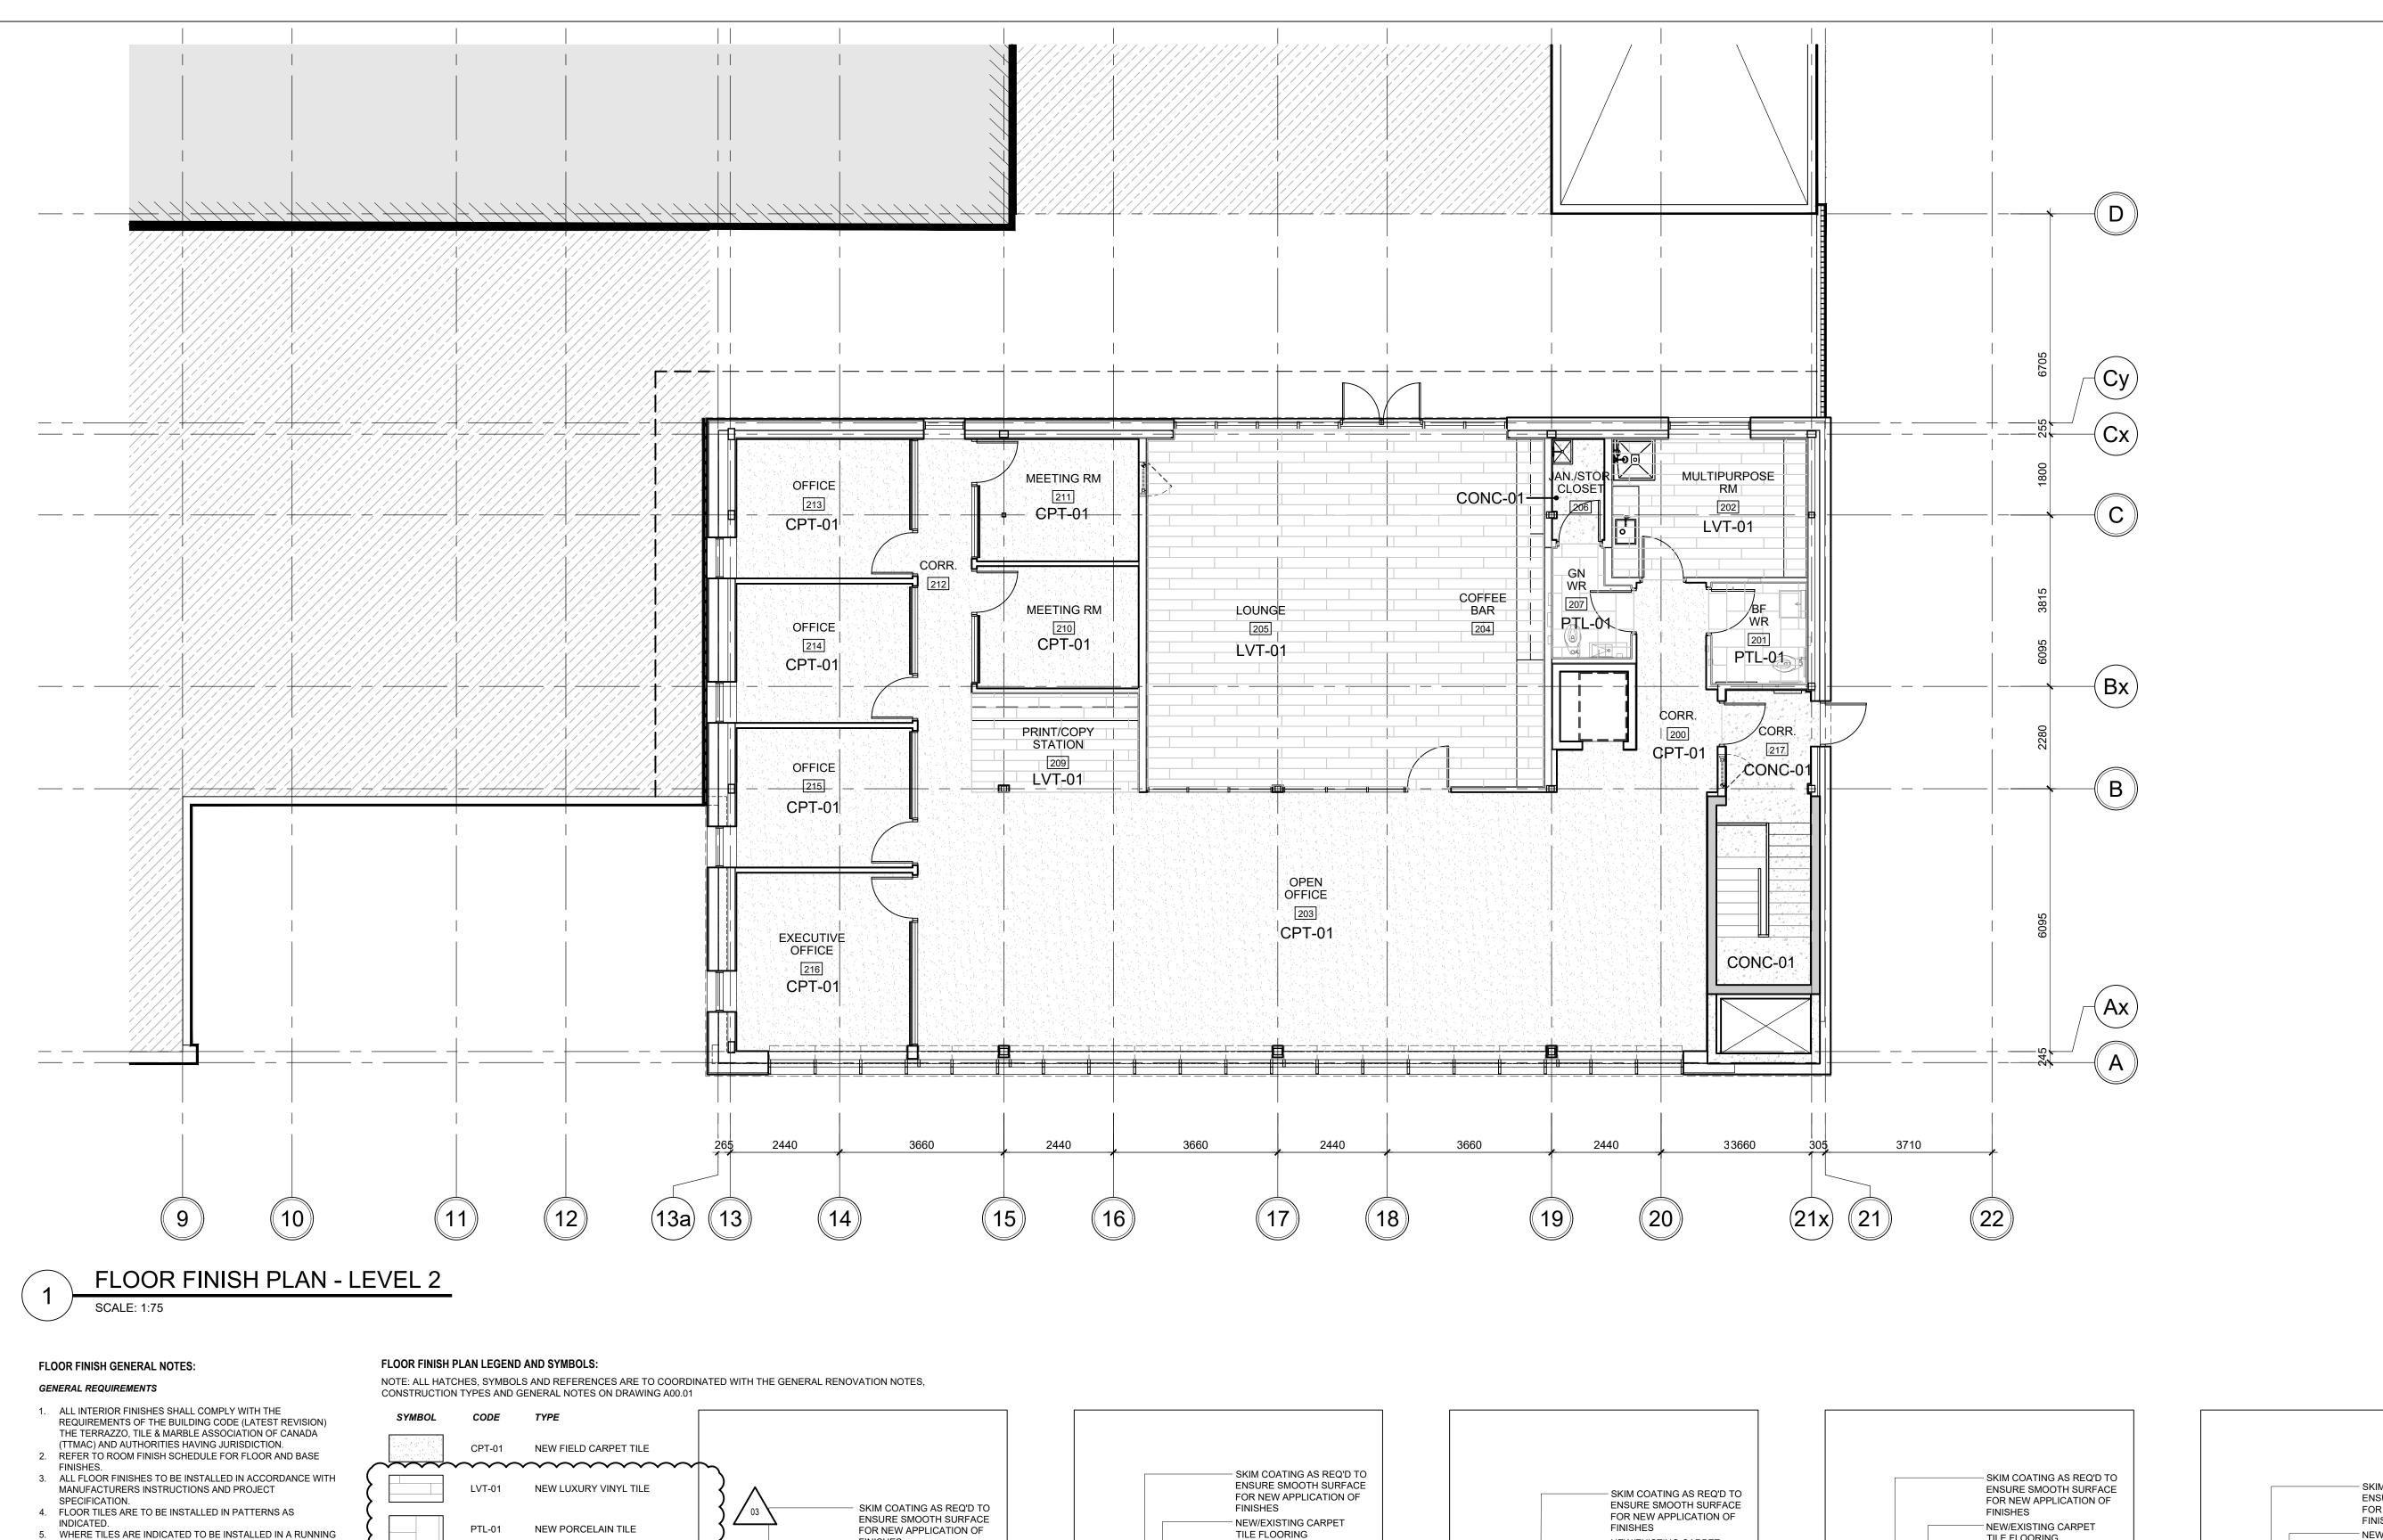


ISSUED FOR ADDENDUM #3 2023.10.06 ISSUED FOR TENDER 2023.09.06 ISSUED FOR PERMIT 2023.05.16

DRAWING TITLE: FLOOR FINISH PLAN

DATE

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SSUE DATE:	2023	.09.0
DRAWN BY: AW	CHECKED BY:	S
PROJECT NO.: 12228	SCALE:	1:7
DRAWING NO :	I DEVI	SION




- BOND PATTERN, INSTALL IN A 1/5 RUNNING BOND PATTERN (20% OVERLAP) TO REDUCE LIPPAGE AS DEFINED BY TTMAC.


 6. MOVEMENT JOINTS SHALL BE IN ACCORDANCE WITH TTMAC DOCUMENT 301MJ- (CURRENT REVISION).
- 7. UNLESS OTHERWISE NOTED, ALL FLOOR FINISHES TO BE
- INSTALLED PRIOR TO INSTALLATION OF MILLWORK.


 8. NO SUBSTITUTIONS OF FLOOR FINISHES PERMITTED WITHOUT CONSULTANT WRITTEN APPROVAL.
- CONTRACTOR IS RESPONSIBLE FOR THE PROTECTION OF ALL FLOOR FINISHES FOR THE DURATION OF THE WORK.
 CONTRACTOR TO PROVIDE PROTECTION OF ALL FINISHED
- CONCRETE FLOORS USING PREMANUFACTURED CARDBOARD
 TEMPORARY FLOOR PROTECTION (OR APPROVED EQUIVALENT)
 FOR THE DURATION OF THE WORK.


 11. CONTRACTOR TO PROVIDE PROTECTION OF ALL FINISHED
- TILED FLOORS USING PREMANUFACTURED CARDBOARD TEMPORARY FLOOR PROTECTION (OR APPROVED EQUIVALENT) FOR THE DURATION OF THE WORK.

 12. CHANGES IN FLOOR FINISH AT DOOR OPENINGS SHALL OCCUR UNDERNEATH THE DOOR (IN THE CLOSED POSITION) UNLESS
- OTHERWISE NOTED. WHERE THERE IS AN OPENING WITH NO DOOR, CHANGES IN FLOOR FINISH SHALL OCCUR AT THE MIDPOINT OF THE OPENING.
- UNLESS NOTED OTHERWISE, TILE BASES SHALL BE 100MM HIGH MEASURED FROM THE ADJACENT FINISHED FLOOR.
 WHERE A CHANGE OF FLOORING MATERIAL THICKNESS OCCURS, FEATHER FLOOR AS REQUIRED.

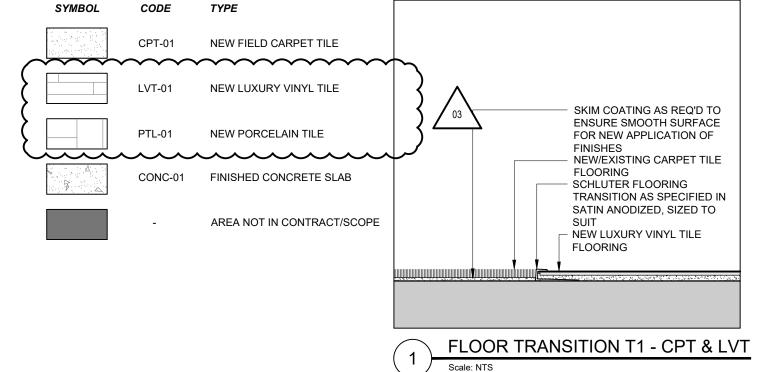

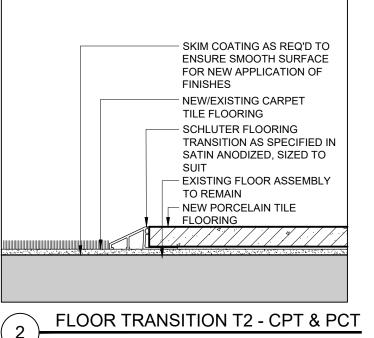

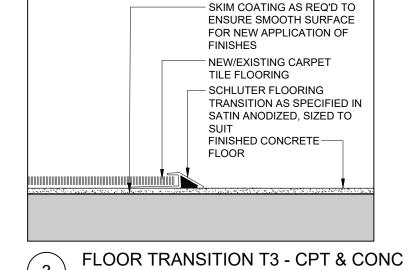

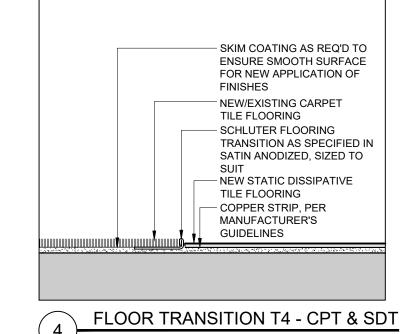

SKIM COATING AS REQ'D TO
ENSURE SMOOTH SURFACE
FOR NEW APPLICATION OF
FINISHES
NEW LVT FLOORING
SCHLUTER FLOORING
TRANSITION AS SPECIFIED IN
SATIN ANODIZED, SIZED TO
SUIT
EXISTING FLOOR ASSEMBLY
TO REMAIN
NEW PORCELAIN TILE
FLOORING

FLOOR TRANSITION T5 - LVT & PCT



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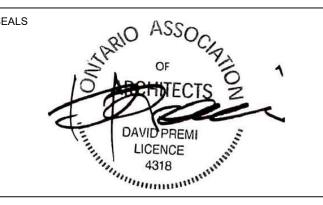
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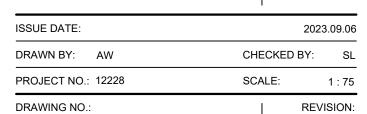
ARCHITECT AND MUST BE RETURNED AT THE COMPLETION OF THE WORK.



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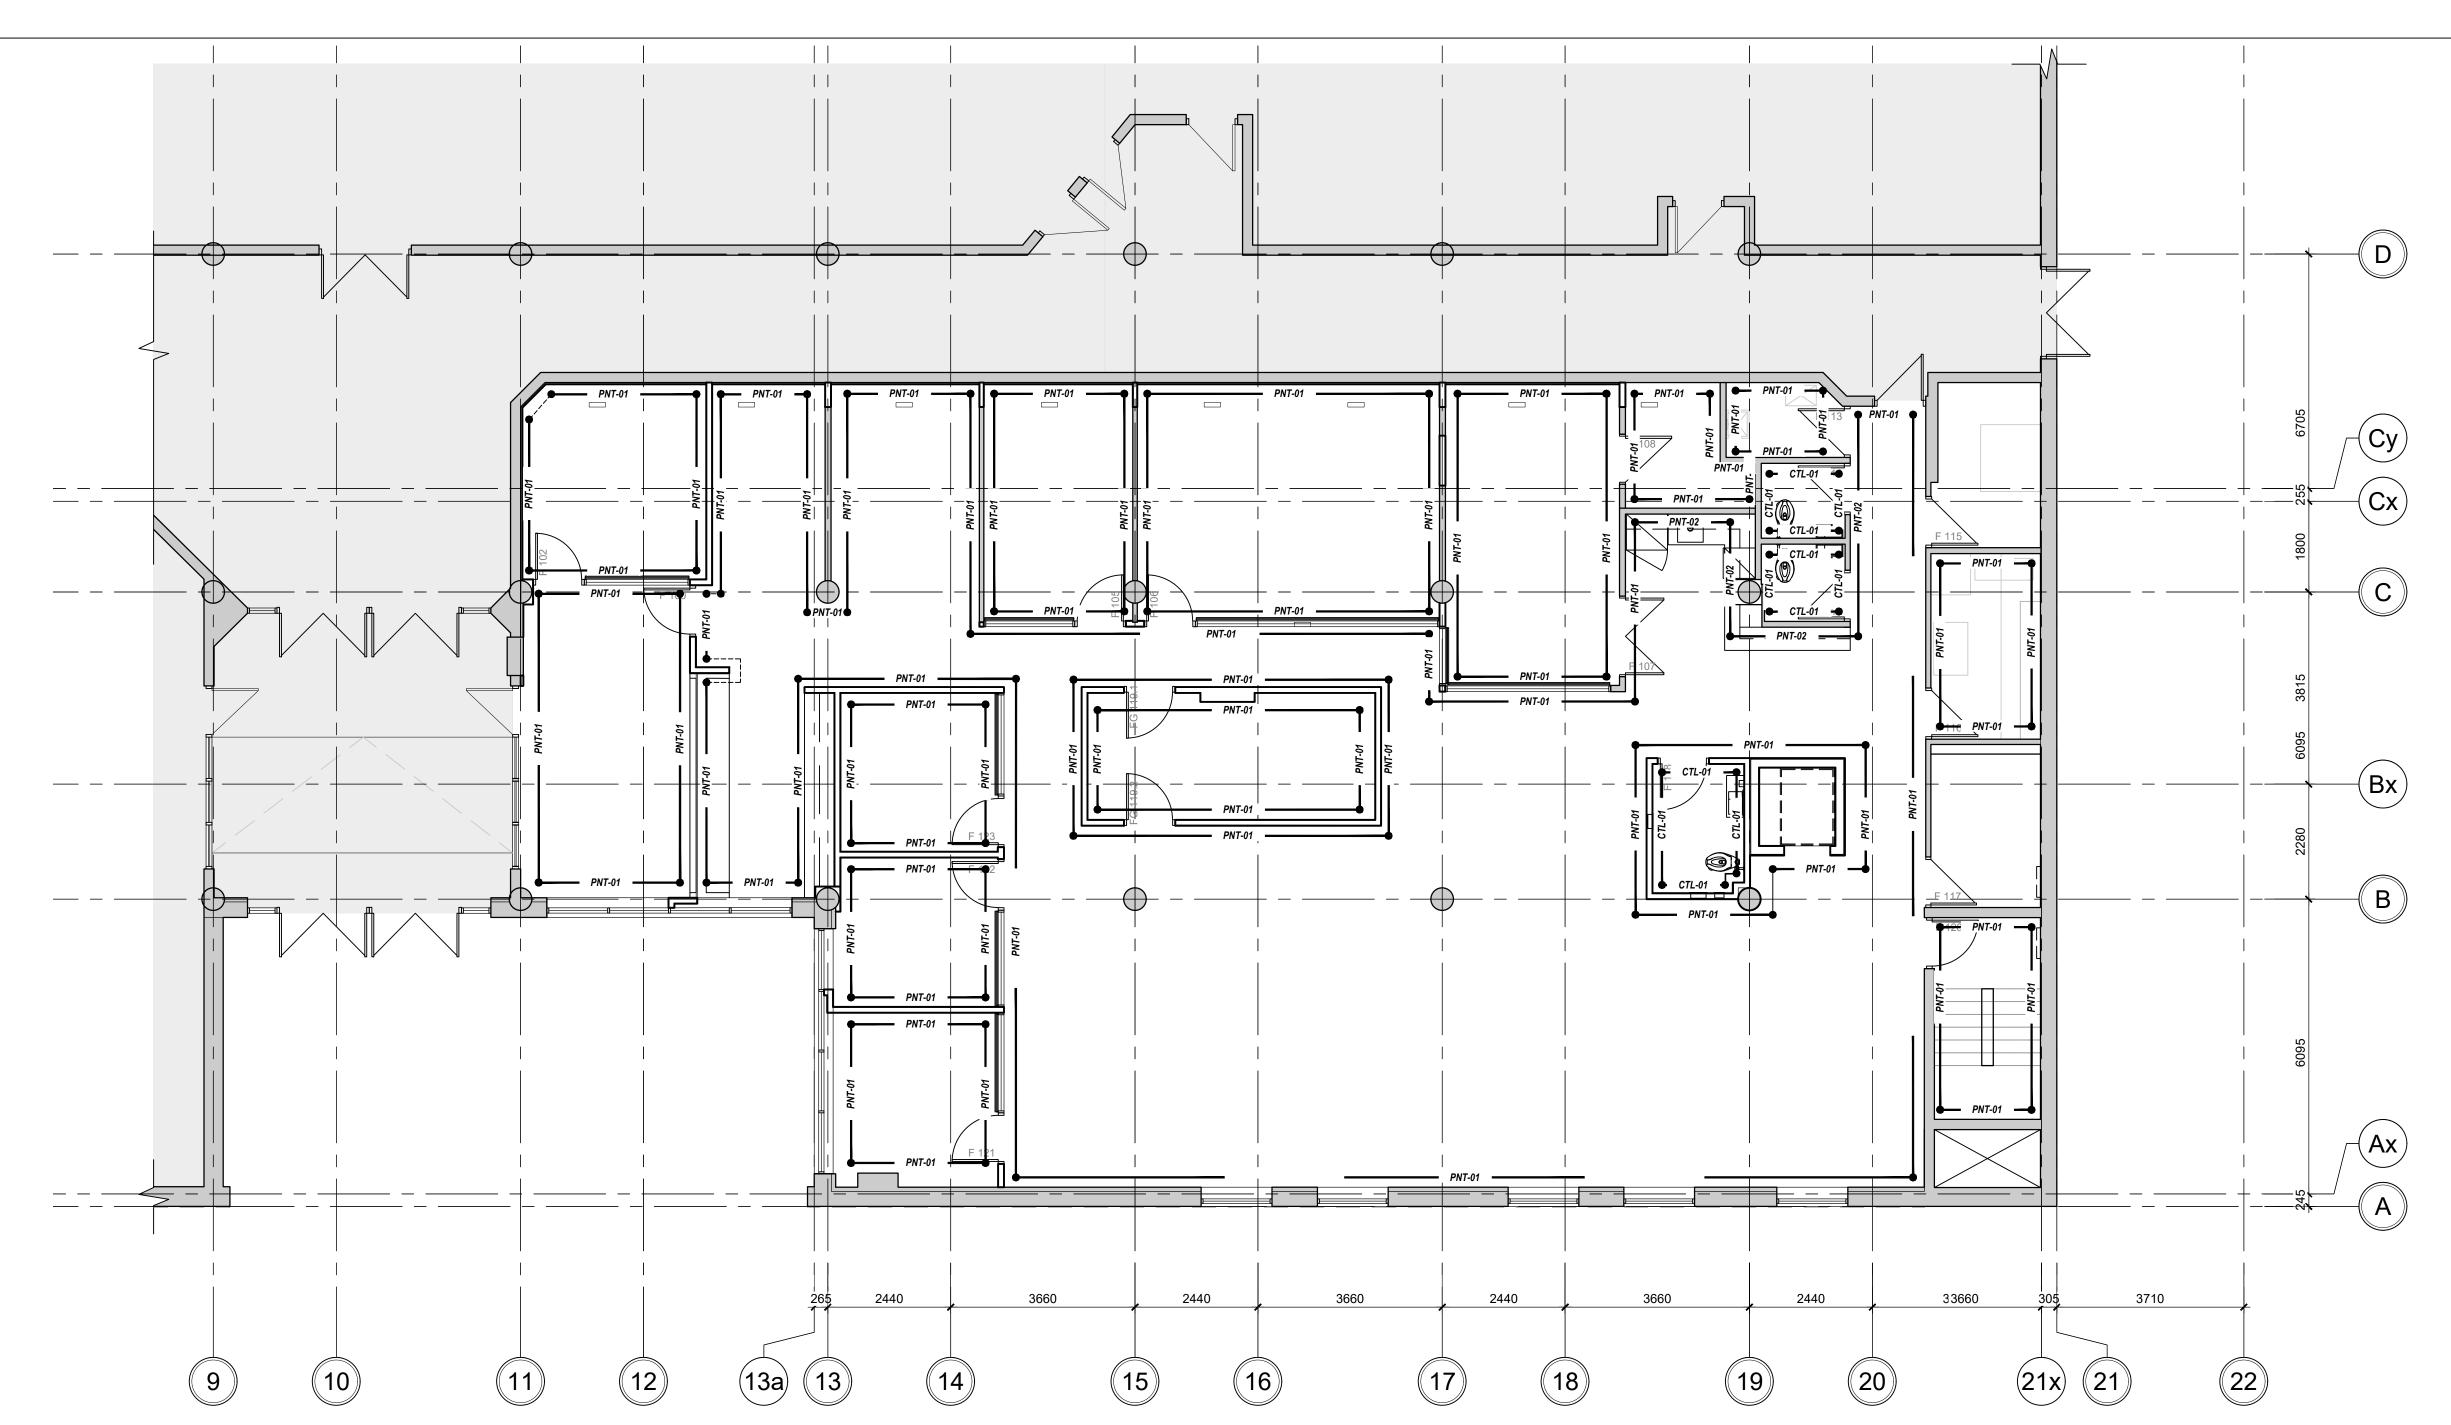
FLOOR FINISH PLAN LEVEL 2

DRAWING TITLE:



A01.08

00





RENOVATION / NEW WORK LEGEND

WALL FINISH GENERAL NOTES:

- ALL WALL FINISH DRAWINGS ARE TO BE READ IN CONJUNCTION WITH FLOOR PLANS, FURNITURE PLANS, INTERIOR ELEVATIONS, AND FINISH SPECIFICATIONS.
- 2. LEVEL 5 FINISHING REQUIRED ON WALLS RECEIVING GRAPHICS.
- 3. GC TO ENSURE THAT SURFACE TO RECEIVE GRAPHICS ARE PREPPED AND SMOOTH. EXISTING ITEMS TO REMAIN AND NEW ITEMS ARE PROTECTED DURING INSTALL.
- 4. ALL EXISTING DOORS AND FRAMES SHALL BE FRESHLY PAINTED AS NOTED. REFER TO DOOR SCHEDULE FOR PAINT FINISH

WALL FINISH TYPES:

PAINTED SURFACE, PT-01
REFER TO FINISHES SCHEDULE & INTERIOR ELEVATIONS



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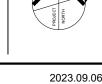
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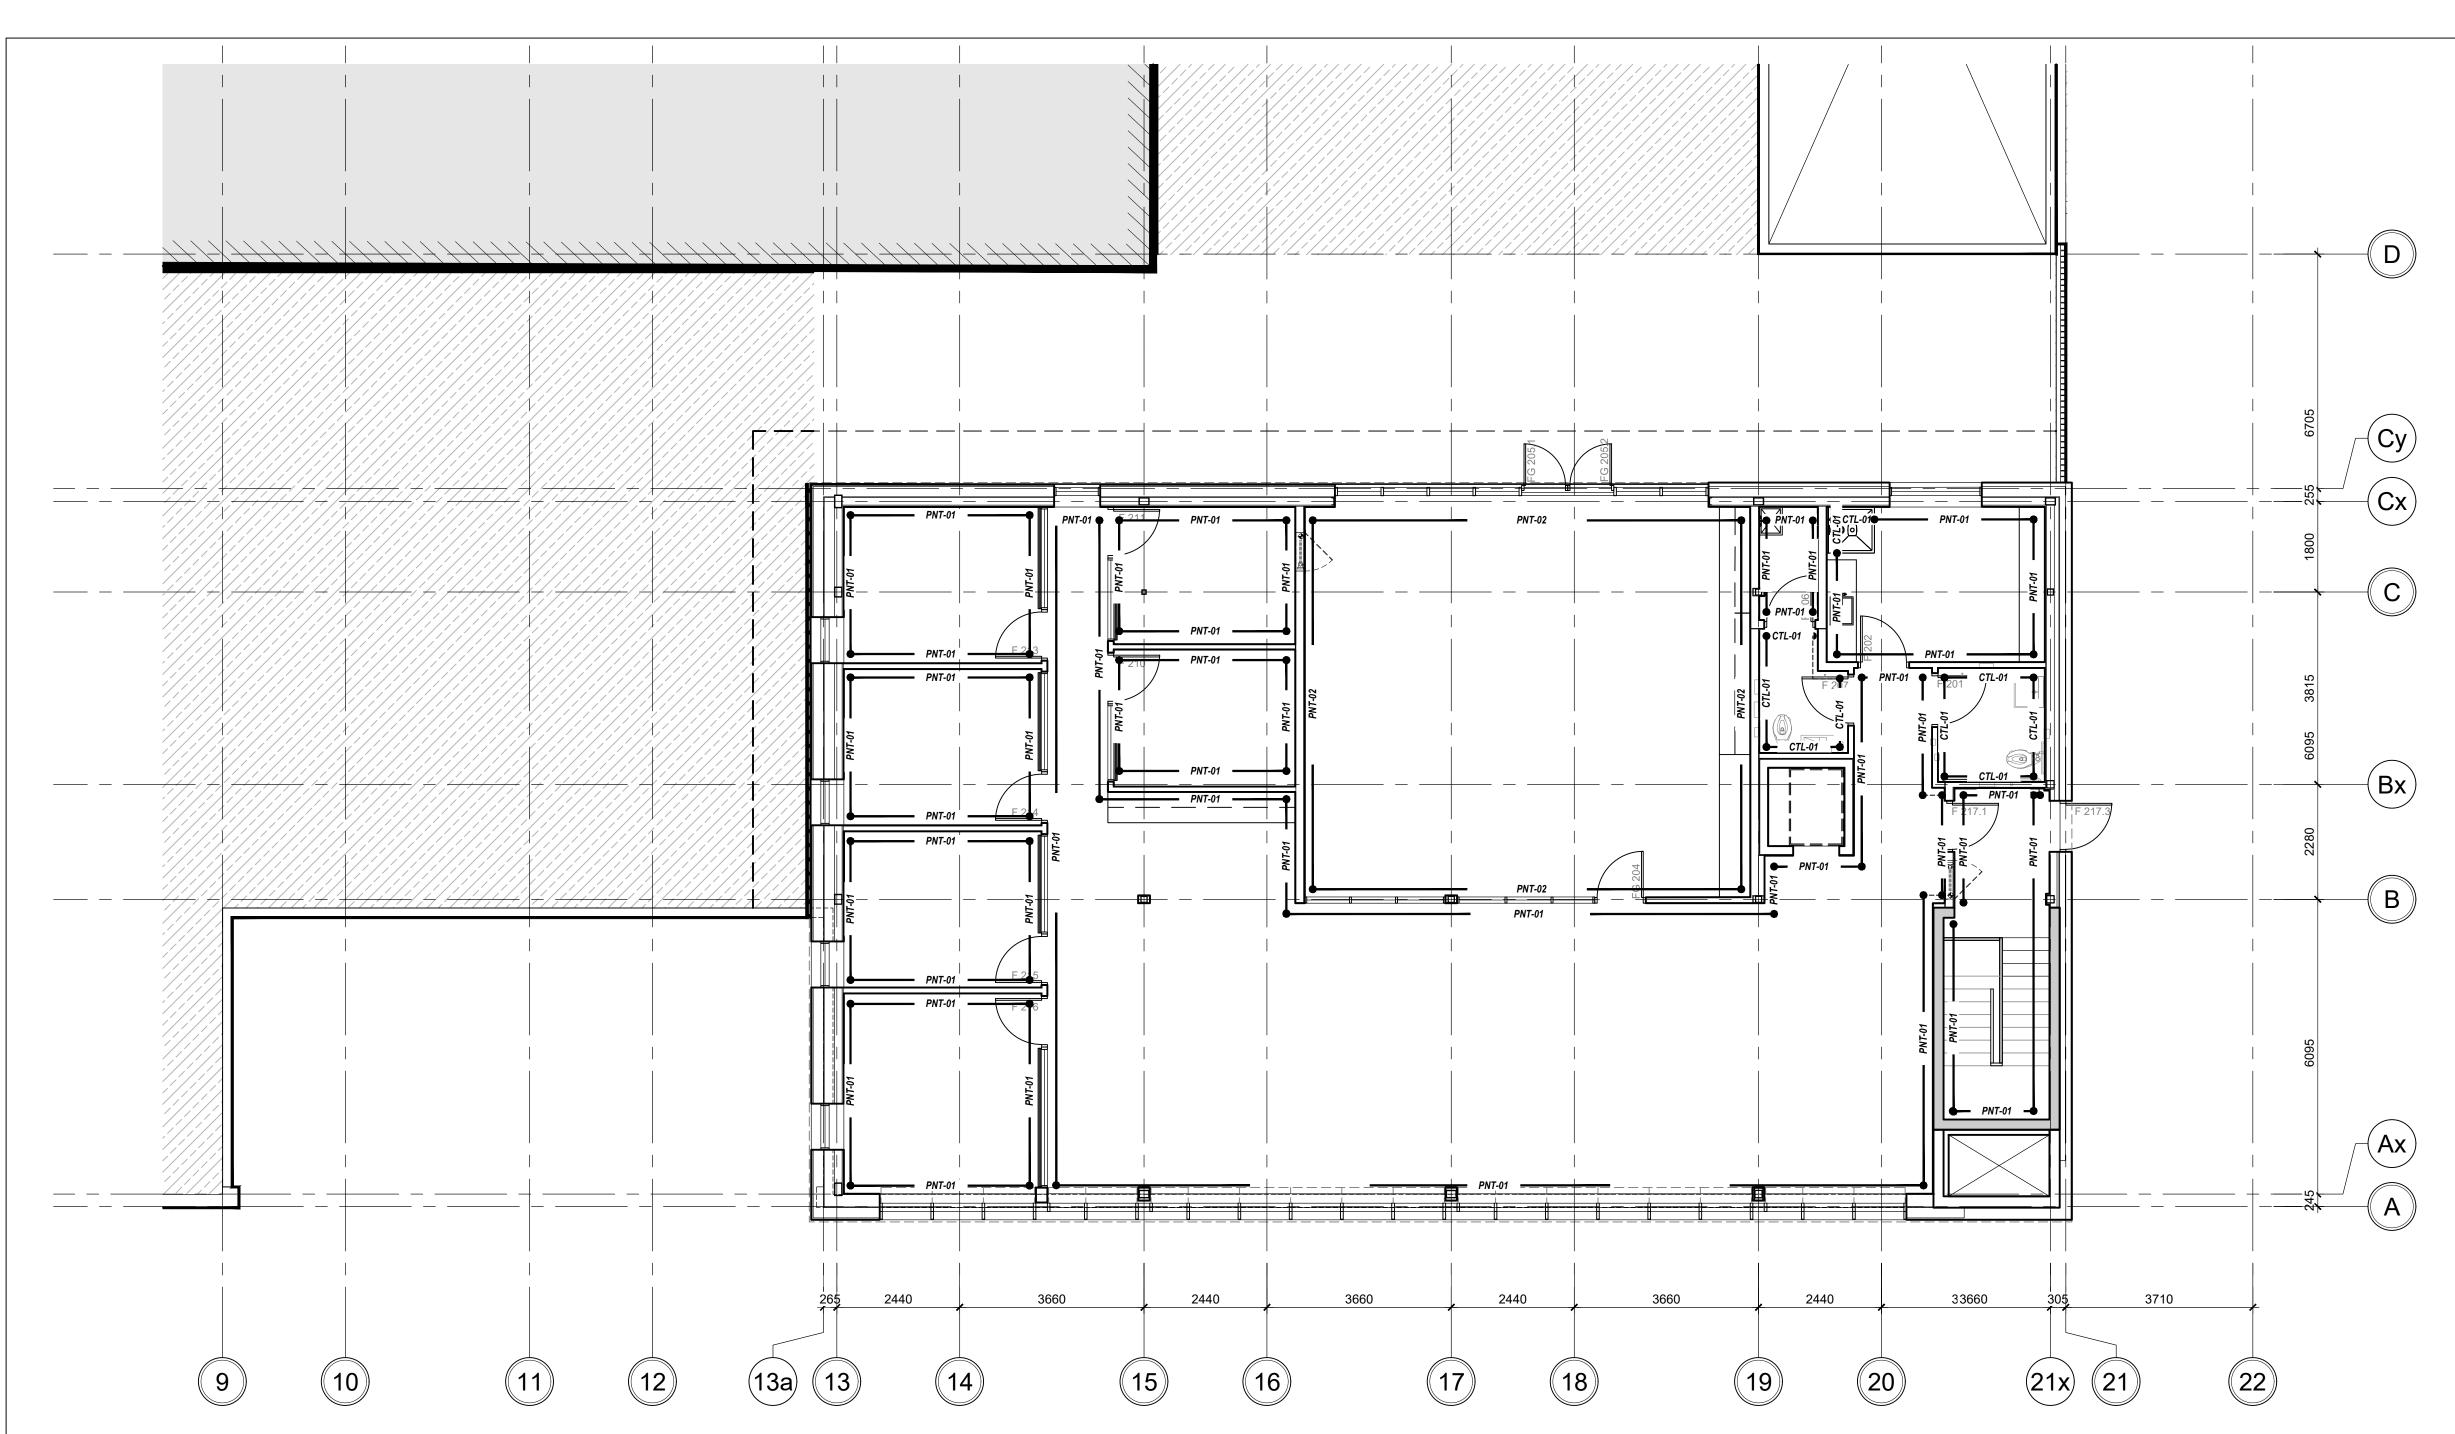


02 ISSUED FOR TENDER 2023.09.06 ISSUED FOR PERMIT 2023.05.16 NO. ISSUES/REVISIONS DATE

DRAWING TITLE: WALL FINISH PLAN LEVEL 1



ISSUE DATE:	2023.09.
DRAWN BY: AW	CHECKED BY:
PROJECT NO.: 12228	SCALE: 1:7
DRAWING NO.:	l REVISIO



WALL FINISH PLAN - LEVEL 2

RENOVATION / NEW WORK LEGEND

WALL FINISH GENERAL NOTES:

- ALL WALL FINISH DRAWINGS ARE TO BE READ IN CONJUNCTION WITH FLOOR PLANS, FURNITURE PLANS, INTERIOR ELEVATIONS, AND FINISH SPECIFICATIONS.
- 2. LEVEL 5 FINISHING REQUIRED ON WALLS RECEIVING GRAPHICS.
- 3. GC TO ENSURE THAT SURFACE TO RECEIVE GRAPHICS ARE PREPPED AND SMOOTH. EXISTING ITEMS TO REMAIN AND NEW ITEMS ARE PROTECTED DURING INSTALL.
- 4. ALL EXISTING DOORS AND FRAMES SHALL BE FRESHLY PAINTED AS NOTED. REFER TO DOOR SCHEDULE A12.00 FOR PAINT.

WALL FINISH TYPES:

PAINTED SURFACE, PT-01 PT-01 — REFER TO FINISHES SCHEDULE A12.02 & ELEVATIONS



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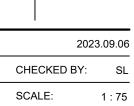
WALL FINISH PLAN LEVEL 2

DRAWING TITLE:


ISSUE DATE:

DRAWING NO.:

DRAWN BY: AW PROJECT NO.: 12228



REVISION:

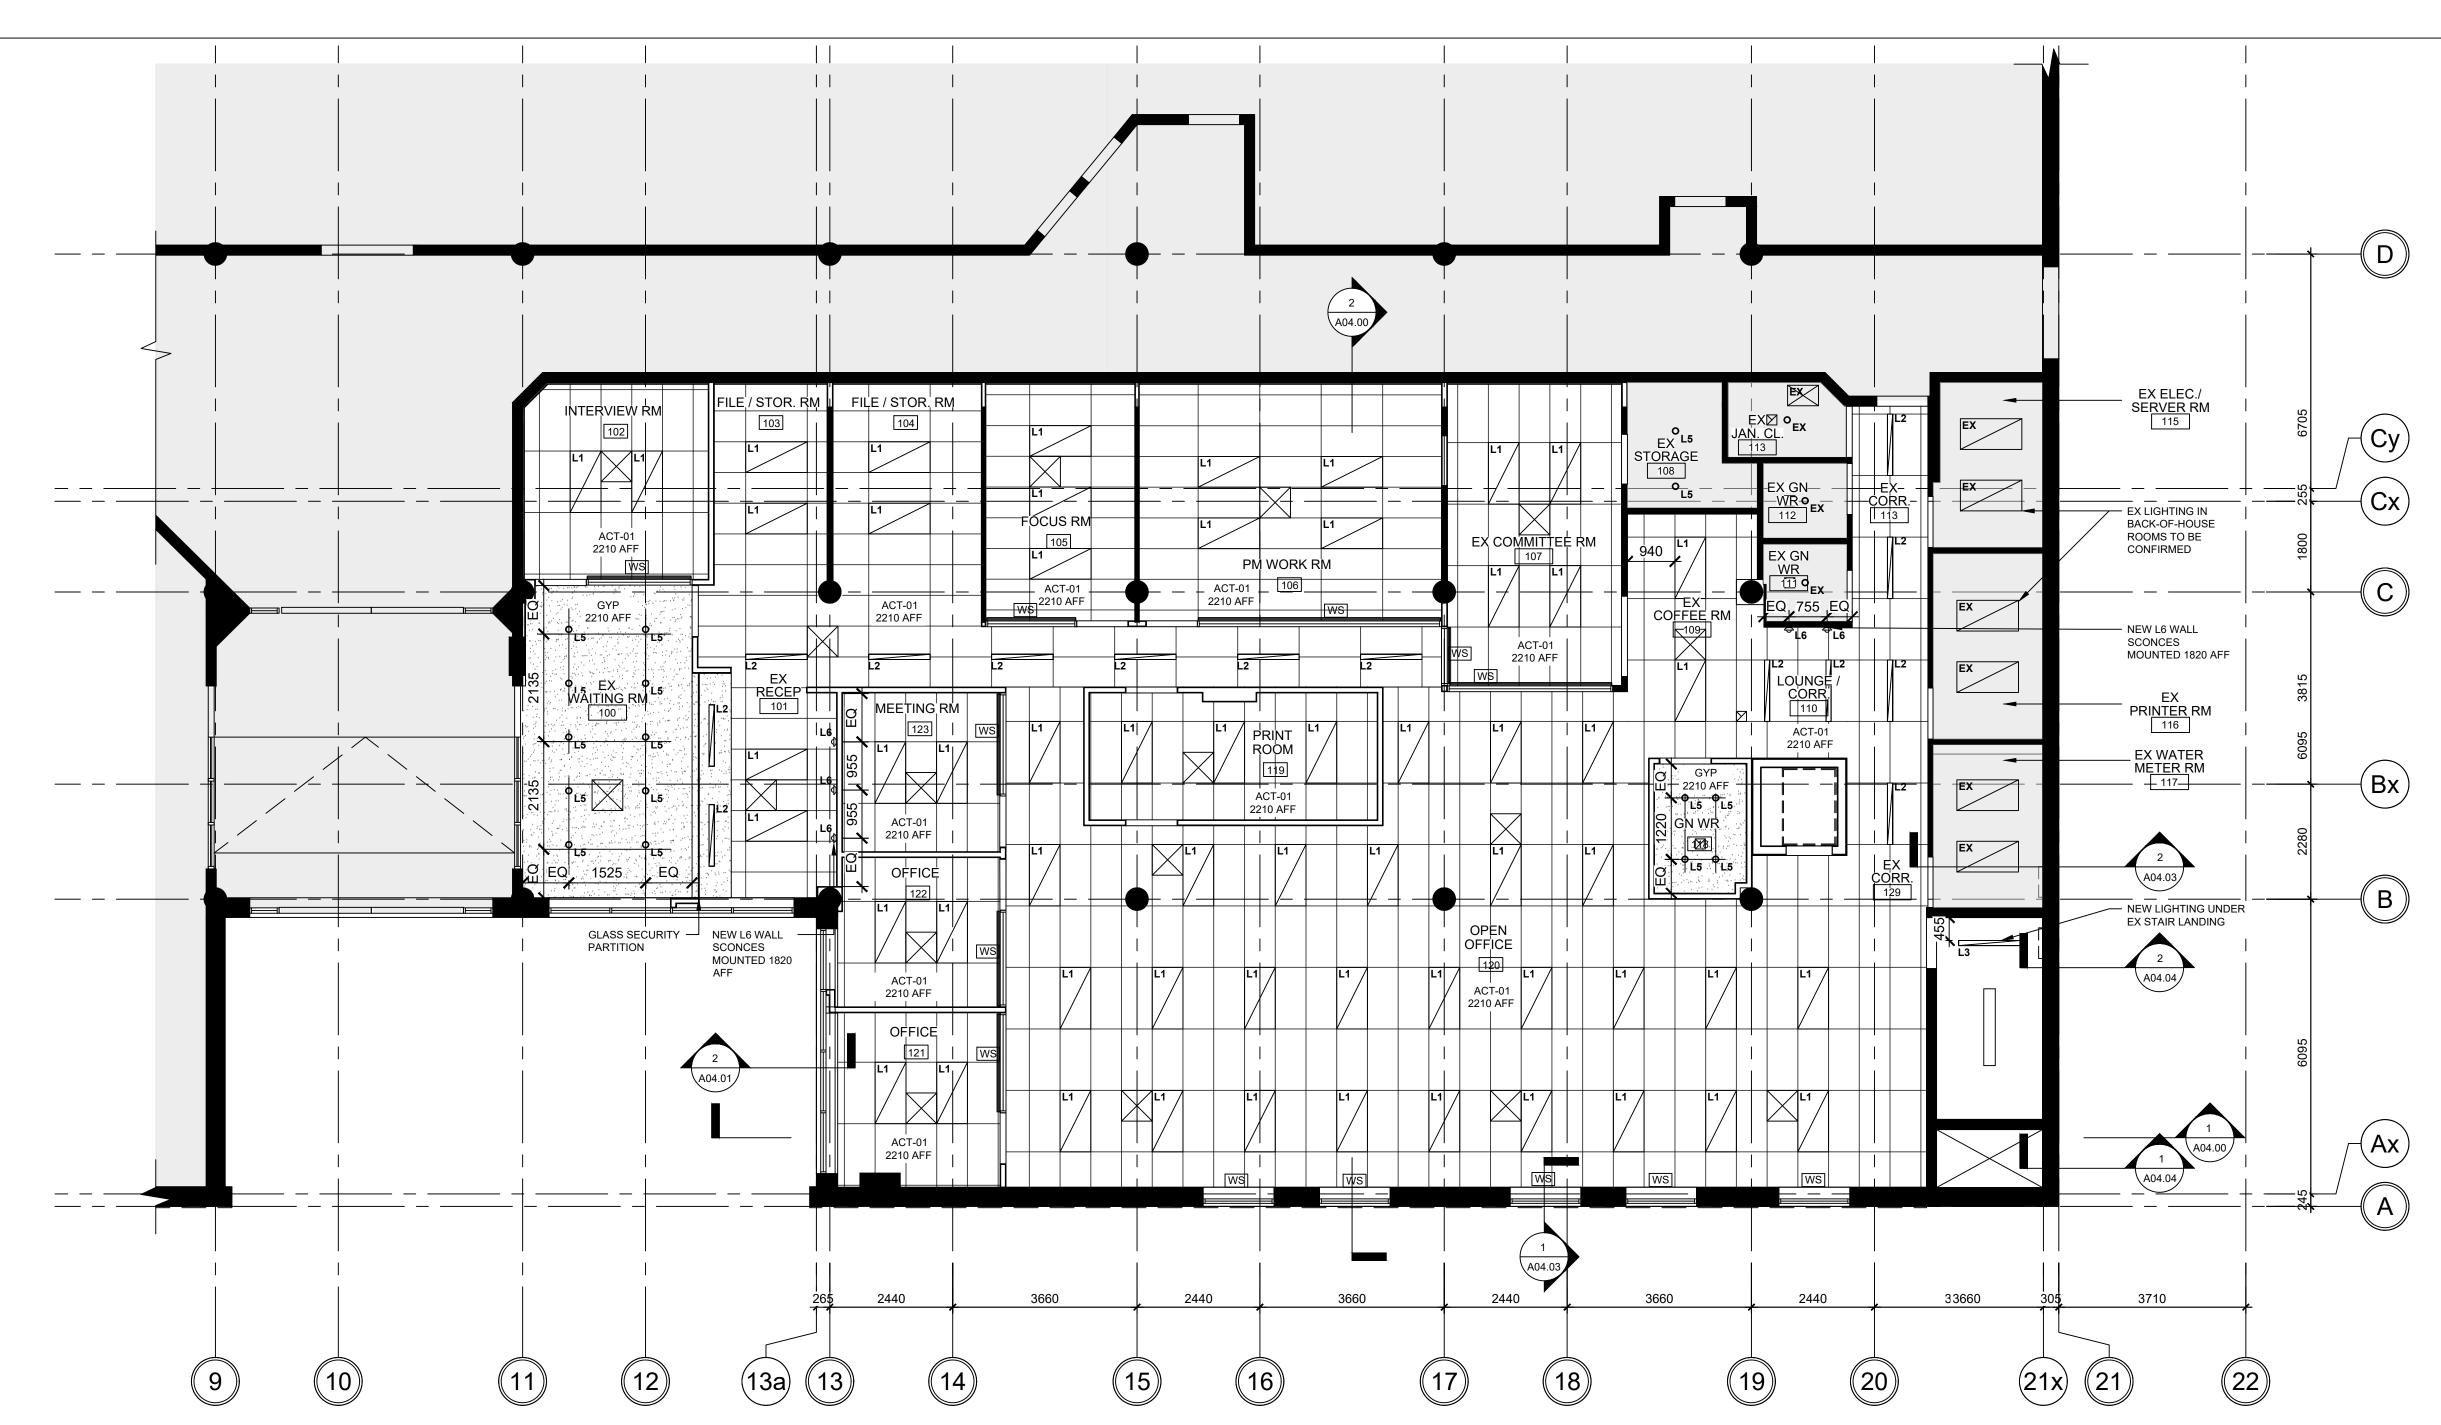

REFLECTED CEILING PLAN - LEVEL '

GENERAL NOTES - REFLECTED CEILING PLAN

- 1. REFER TO MECHANICAL AND ELECTRICAL DRAWINGS FOR ALL CEILING MOUNTED FIXTURES AND MECHANICAL AND ELECTRICAL EQUIPMENT. POSITIONING OF ALL MECHANICAL AND ELECTRICAL FIXTURES AND EQUIPMENT SHALL BE GOVERNED BY ARCHITECTURAL DRAWINGS SUBJECT TO FULL COMPLIANCE WITH ONTARIO BUILDING CODE REQUIREMENTS. REFLECTED CEILING PLANS MAY NOT SHOW ALL MECHANICAL AND ELECTRICAL FIXTURES OR EQUIPMENT. ARCHITECTURAL DRAWINGS SHALL BE READ IN CONJUNCTION WITH MECHANICAL AND ELECTRICAL
- 2. GENERAL CONTRACTOR SHALL REPORT ANY DISCREPANCIES BETWEEN ENGINEERING AND ARCHITECTURAL DRAWINGS PRIOR TO COMMENCEMENT OF THE WORK.
- 3. PRIOR TO COMMENCEMENT OF THE WORK, THE CONTRACTOR SHALL CONDUCT AN INTERFERENCE STUDY. THE OBJECTIVE OF THE STUDY IS TO IDENTIFY AND MITIGATE ISSUES WITH THE INSTALLATION OF MECHANICAL & ELECTRICAL SYSTEMS, FIXTURES AND EQUIPMENT. THE STUDY SHALL CONSIST OF THE FOLLOWING:
- 4. MARK LOCATIONS AND ROUTES ON SITE OF ALL EQUIPMENT, PIPING, VENTS, DUCTS, CONDENSATES ETC. CONTRACTOR SHALL ESTABLISH MINIMUM CLEARANCES AND REPORT ANY INTERFERENCES WITH LIGHT FIXTURES, CONDUIT OR WIRE RUNS,
- STRUCTURE ETC. 5. MARK LOCATIONS ON SITE OF ALL LIGHTING. CONTRACTOR SHALL

- ESTABLISH MINIMUM CLEARANCES AND REPORT ANY INTERFERENCES WITH DUCTS, PIPES, STRUCTURE ETC.
- 6. LOCATE ALL FIXTURES IN ACCORDANCE WITH ARCHITECTURAL 7. IDENTIFY ALL SERVICES INSTALLED WITHIN OR ABOVE CEILING
- SYSTEMS. COORDINATE ALL PENETRATIONS AND ACCESS PANELS WITH THE CEILING SUPPORT SYSTEMS. 8. REPORT ANY DISCREPANCIES OR INTERFERENCES TO
- CONSULTANT IMMEDIATELY. OBTAIN INSTRUCTION FROM CONSULTANT BEFORE COMMENCING INSTALLATION. 9. PROVIDE CONFIRMATION THAT INTERFERENCE STUDY HAS BEEN CONDUCTED AND THAT INTERFERENCES HAVE BEEN IDENTIFIED
- FIXTURE INSTALLATION / LOCATION REQUIREMENTS

AND MITIGATED

- 1. REFER TO ELECTRICAL DRAWINGS /SPECIFICATIONS FOR ALL LIGHTING FIXTURE TYPES & QUANTITY LAYOUTS 2. UNLESS OTHERWISE NOTED, LOCATE LIGHT FIXTURES ON CENTER
- OF ACOUSTIC CEILING TILES. 3. WHERE INDICATED, DIMENSIONS ARE TAKEN FROM CENTER OF LIGHT FIXTURES. 4. REFER TO TOP OF WALL DEFLECTION TRACK DETAILS FOR
- TERMINATION OF WALLS AT FLOORS AND ROOFS. 5. WHERE MECHANICAL AND ELECTRICAL FIXTURES PENETRATE A PARTITION, PATCH AND PROVIDE AN AIR-TIGHT SEAL AROUND PENETRATION. AT FIRE SEPARATIONS USE FIRESTOP SYSTEM

- MATERIAL AT PENETRATIONS TO MATCH THE FIRE RATING OF THE PARTITION, WALL, OR FLOOR ASSEMBLY. 6. LOCATE SPRINKLERS, DETECTORS, SPEAKERS, ETC. ON CENTER
- LINE OR MID-POINT OF LAY-IN CEILING PANELS UNLESS OTHERWISE NOTED 7. CONTRACTOR SHALL PROVIDE ALL NECESSARY SUPPORTS FOR ALL WINDOW TREATMENTS, ROLLER SHADES, ETC. AS
- RECOMMENDED BY MANUFACTURERS 8. CONTRACTOR SHALL PROVIDE CONCEALED BRACING TO LATERALLY STABILIZE SUSPENDED CEILINGS WHERE CEILINGS ARE NOT FASTENED TO WALLS. 9. REFER TO ELECTRICAL DRAWINGS AND SPECIFICATIONS FOR FIRE

EXIT SIGNS, EMERGENCY LIGHTING AND OTHER LIFE SAFETY

- DEVICES (i.e. HEAT DETECTORS, SMOKE DETECTORS ETC). 10. ALL EXPOSED ROUTING OF ELECTRICAL SERVICES ON CEILINGS/LEVELS ABOVE SHALL BE REVIEWED ONSITE WITH CONSULTANT PRIOR TO INSTALLATION. 11. WHERE REQUIRED, PATCH, PAINT OR REPLACE ANY DAMAGED T-BAR AND REPLACE ANY DAMAGED OR SOILED CEILING TILES NOTED PRIOR TO OCCUPANCY.
- 12. CONTROL JOINTS SHALL BE INSTALLED TO DIVIDE GYPSUM CEILINGS & WALLS INTO 20' MAX. LENGTHS & WIDTHS. JOINTS SHALL ALSO BE INSTALLED AT EXPANSION OR CONTRACTION JOINTS IN THE STRUCTURAL FRAMEWORK OVER WHICH GYPSUM BOARD IS REQUIRED.

13. CONTRACTOR SHALL PROVIDE CUT-OUTS AND OPENINGS FOR

- ITEMS WHICH PENETRATE THROUGH CEILINGS SYSTEMS (INCLUDING SPECIAL EQUIPMENT HANGERS AND DEVICES, CONDUIT, PIPING, ELECTRICAL REQUIREMENTS, ETC.).
- FIRE SEPERATIONS 1. FIRE SEPARATIONS ARE TO THE UNDERSIDE (U/S) OF THE DECK OR STRUCTURE COMPLETE WITH FIRESTOP SYSTEM MATERIAL AND SMOKE SEAL AS REQUIRED. REFER TO FIRE SEPERATION
- 2. REFER TO TOP OF WALL DETAILS FOR TERMINATION OF WALLS AT FLOORS AND ROOFS THAT REQUIRE FIRE SEPERATION.
- 1. REFER TO FINISHS SCHEDULE FOR CEILING FINISHES. 2. WHERE INDICATED, CEILINGS NOTED AS EXPOSED SHALL BE PAINTED PNT-04 UNLESS OTHERWISE NOTED. 3. ALL EXPOSED CONDUIT, DUCT WORK, PIPING, ETC. SHALL BE PAINTED TO MATCH CEILING UNLESS OTHERWISE NOTED OR REQUIRED BY CODE. 4. ALL EXPOSED STEEL BEAMS, JOISTS, DECK SHALL BE PAINTED
- 1. FOR EQUIPMENT THAT REQUIRES ACCESS THROUGH CEILINGS. LOCATE ABOVE ATC CEILINGS WHERE POSSIBLE. WHERE ACCESS IS REQUIRED THROUGH GYPSUM BOARD CEILINGS, CONTRACTOR

PER CEILING FINISH SCHEDULE UNLESS OTHERWISE NOTED.

SHALL PROVIDE ACCESS PANELS AS REQUIRED. CONSULTANT SHALL REVIEW LOCATIONS PRIOR TO CONTRACTOR PROCEEDING WITH INSTALLATION.

- 2. IN AREAS WHERE ACCESS CAN NOT BE GAINED FROM ACT CEILINGS, ACCESS PANELS ARE TO BE PROVIDED. 3. PROVIDE ACCESS PANELS OF APPROPRIATE SIZE, TYPE, AND FIRE RATING FOR ALL CONCEALED ITEMS THAT REQUIRE ADJUSTMENT,
- MAINTENANCE, MONITORING, ETC. 4. ACCESS PANELS SHALL BE SIZED ACCORDING TO ACCESS REQUIREMENTS, PREFABRICATED OR ALTERNATIVELY, CONSTRUCTED OF MIN. 12.7MM MDF PANELS, FINISH FLUSH WITH ADJACENT CEILING AND FINISHED TO MATCH ADJACENT CEILING
- FINISH. PROVIDE 3MM REVEAL AROUND ENTIRE PANEL (TYP.) 5. COORDINATE LOCATION AND FINISH WITH ARCHITECT. 6. WHERE POSSIBLE, SERVICES TO BE GANGED TO LIMIT THE NUMBER OF PANELS REQUIRED.
- ACCORDING TO ACCESS REQUIREMENTS, FINISH FLUSH WITH ADJACENT CEILING AND COLOR SHALL MATCH ADJACENT CEILING

REFLECTED CEILING PLAN LEGEND AND SYMBOLS:

- 7. ALL ACCESS PANELS TO BE KEYED WITH THE SAME LOCK 8. ACCESS PANELS SHALL BE PREFABRICATED AND SIZED

NOTE: ALL HATCHES, SYMBOLS AND REFERENCES ARE TO BE COORDINATED WITH THE GENERAL RENOVATION NOTED, CONSTRUCTION TYPES & GENERAL NOTES ON DRAWING

OR AS REQUIRED

FACE OF FRAME OPENING WIDTH (SITE MEASURE)

FACE OF WINDOW OPENING

* SHOP DRAWING REQUIRED PRIOR TO FABRICATION

WINDOW SHADE DETAIL

RCP HATCH LEGEND:





NEW GYPSUM CEILING, PAINTED PNT-03 UNLESS OTHERWISE NOTED

LIGHTING SPECIFICATIONS:

MOUNTING SURFACE -WALL OR WINDOW FRAME 19MM PLYWOOD BLOCKING MOUNTING ANGLE SPRING CLIP -FABRIC (BLACKOUT) 5000 SERIES COLOUR TO BÉ COMFIRMED FABRIC: 3% OPENNESS, 300 SERIES COLOUR TO BE COMFIRMED CLEAR ANODIZED EXTRUDED ALUMINUM FASCIA STAINLESS STEEL BALL CHAIN(S)

ALUMINUM END PLATE

CLEAR ANODIZED EXTRUDED ALUMINUM EXTERIOR HEMBAR(S) CLEAR ANODIZED MANUAL BLACKOUT SIDE CHANNELS CLEAR ANODIZED MANUAL BLACKOUT BOTTOM CHANNELS

L1 610mm X 1220mm RECESSED LED PANEL FIXTURE, MOUNTED

TO SIZE WIDTH OF SHADE

NOT FACE OF FRAME

- SITE MEASURE FROM FACE OF WINDOW OPENINGS

- L2 102mm X 1220mm RECESSED LED PANEL FIXTURE, MOUNTED
- L3 102mm X 1220mm SUSPENDED LINEAR LED FIXTURE FOR OPEN CEILING, CABLE HUNG
- L4 25mm UNDER-CABINET LED STRIP C/W DIFFUSER, LENGTH PER DRAWINGS
- L5 102mm RECESSED ROUND POT LIGHT L6 JONI WALL WALL SCONCE BY SEAN LAVIN FOR TECH

REFER TO SCHEDULES FOR MORE INFORMATION



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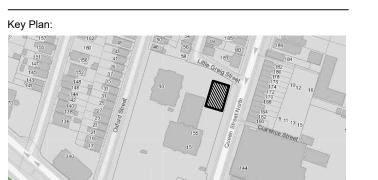
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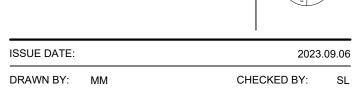
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01	Issued for Coordination	2022.07.29
NO	ISSUES/REVISIONS	DATE

DRAWING TITLE: REFLECTED CEILING PLAN



DRAWN BY: MM CHECKED BY: SL PROJECT NO.: 12228 SCALE: DRAWING NO.: REVISION:



GENERAL NOTES - REFLECTED CEILING PLAN

1. REFER TO MECHANICAL AND ELECTRICAL DRAWINGS FOR ALL CEILING MOUNTED FIXTURES AND MECHANICAL AND ELECTRICAL EQUIPMENT. POSITIONING OF ALL MECHANICAL AND ELECTRICAL FIXTURES AND EQUIPMENT SHALL BE GOVERNED BY ARCHITECTURAL DRAWINGS SUBJECT TO FULL COMPLIANCE WITH ONTARIO BUILDING CODE REQUIREMENTS. REFLECTED CEILING PLANS MAY NOT SHOW ALL MECHANICAL AND ELECTRICAL FIXTURES OR EQUIPMENT. ARCHITECTURAL DRAWINGS SHALL BE READ IN CONJUNCTION WITH MECHANICAL AND ELECTRICAL

2. GENERAL CONTRACTOR SHALL REPORT ANY DISCREPANCIES BETWEEN ENGINEERING AND ARCHITECTURAL DRAWINGS PRIOR TO COMMENCEMENT OF THE WORK.

3. PRIOR TO COMMENCEMENT OF THE WORK, THE CONTRACTOR SHALL CONDUCT AN INTERFERENCE STUDY. THE OBJECTIVE OF THE STUDY IS TO IDENTIFY AND MITIGATE ISSUES WITH THE INSTALLATION OF MECHANICAL & ELECTRICAL SYSTEMS, FIXTURES AND EQUIPMENT.

THE STUDY SHALL CONSIST OF THE FOLLOWING: 4. MARK LOCATIONS AND ROUTES ON SITE OF ALL EQUIPMENT, PIPING, VENTS, DUCTS, CONDENSATES ETC. CONTRACTOR SHALL ESTABLISH MINIMUM CLEARANCES AND REPORT ANY INTERFERENCES WITH LIGHT FIXTURES, CONDUIT OR WIRE RUNS,

STRUCTURE ETC. 5. MARK LOCATIONS ON SITE OF ALL LIGHTING. CONTRACTOR SHALL

ESTABLISH MINIMUM CLEARANCES AND REPORT ANY INTERFERENCES WITH DUCTS, PIPES, STRUCTURE ETC. 6. LOCATE ALL FIXTURES IN ACCORDANCE WITH ARCHITECTURAL

7. IDENTIFY ALL SERVICES INSTALLED WITHIN OR ABOVE CEILING SYSTEMS. COORDINATE ALL PENETRATIONS AND ACCESS PANELS

WITH THE CEILING SUPPORT SYSTEMS. 8. REPORT ANY DISCREPANCIES OR INTERFERENCES TO

CONSULTANT IMMEDIATELY. OBTAIN INSTRUCTION FROM CONSULTANT BEFORE COMMENCING INSTALLATION. 9. PROVIDE CONFIRMATION THAT INTERFERENCE STUDY HAS BEEN CONDUCTED AND THAT INTERFERENCES HAVE BEEN IDENTIFIED AND MITIGATED

FIXTURE INSTALLATION / LOCATION REQUIREMENTS

1. REFER TO ELECTRICAL DRAWINGS /SPECIFICATIONS FOR ALL LIGHTING FIXTURE TYPES & QUANTITY LAYOUTS 2. UNLESS OTHERWISE NOTED, LOCATE LIGHT FIXTURES ON CENTER OF ACOUSTIC CEILING TILES.

3. WHERE INDICATED, DIMENSIONS ARE TAKEN FROM CENTER OF LIGHT FIXTURES. 4. REFER TO TOP OF WALL DEFLECTION TRACK DETAILS FOR TERMINATION OF WALLS AT FLOORS AND ROOFS.

5. WHERE MECHANICAL AND ELECTRICAL FIXTURES PENETRATE A PARTITION PATCH AND PROVIDE AN AIR-TIGHT SEAL AROUND 13. CONTRACTOR SHALL PROVIDE CUT-OUTS AND OPENINGS FOR PENETRATION. AT FIRE SEPARATIONS USE FIRESTOP SYSTEM

MATERIAL AT PENETRATIONS TO MATCH THE FIRE RATING OF THE PARTITION, WALL, OR FLOOR ASSEMBLY.

6. LOCATE SPRINKLERS, DETECTORS, SPEAKERS, ETC. ON CENTER LINE OR MID-POINT OF LAY-IN CEILING PANELS UNLESS OTHERWISE NOTED 7. CONTRACTOR SHALL PROVIDE ALL NECESSARY SUPPORTS FOR ALL WINDOW TREATMENTS, ROLLER SHADES, ETC. AS

RECOMMENDED BY MANUFACTURERS 8. CONTRACTOR SHALL PROVIDE CONCEALED BRACING TO LATERALLY STABILIZE SUSPENDED CEILINGS WHERE CEILINGS ARE NOT FASTENED TO WALLS. 9. REFER TO ELECTRICAL DRAWINGS AND SPECIFICATIONS FOR FIRE

EXIT SIGNS, EMERGENCY LIGHTING AND OTHER LIFE SAFETY

DEVICES (i.e. HEAT DETECTORS, SMOKE DETECTORS ETC). 10. ALL EXPOSED ROUTING OF ELECTRICAL SERVICES ON CEILINGS/LEVELS ABOVE SHALL BE REVIEWED ONSITE WITH CONSULTANT PRIOR TO INSTALLATION. 11. WHERE REQUIRED, PATCH, PAINT OR REPLACE ANY DAMAGED T-BAR AND REPLACE ANY DAMAGED OR SOILED CEILING TILES NOTED PRIOR TO OCCUPANCY.

12. CONTROL JOINTS SHALL BE INSTALLED TO DIVIDE GYPSUM CEILINGS & WALLS INTO 20' MAX. LENGTHS & WIDTHS. JOINTS SHALL ALSO BE INSTALLED AT EXPANSION OR CONTRACTION JOINTS IN THE STRUCTURAL FRAMEWORK OVER WHICH GYPSUM BOARD IS REQUIRED.

ITEMS WHICH PENETRATE THROUGH CEILINGS SYSTEMS (INCLUDING SPECIAL EQUIPMENT HANGERS AND DEVICES, CONDUIT, PIPING, ELECTRICAL REQUIREMENTS, ETC.).

FIRE SEPERATIONS 1. FIRE SEPARATIONS ARE TO THE UNDERSIDE (U/S) OF THE DECK OR STRUCTURE COMPLETE WITH FIRESTOP SYSTEM MATERIAL

AND SMOKE SEAL AS REQUIRED. REFER TO FIRE SEPERATION 2. REFER TO TOP OF WALL DETAILS FOR TERMINATION OF WALLS AT FLOORS AND ROOFS THAT REQUIRE FIRE SEPERATION.

1. REFER TO FINISHS SCHEDULE FOR CEILING FINISHES. 2. WHERE INDICATED, CEILINGS NOTED AS EXPOSED SHALL BE PAINTED PNT-04 UNLESS OTHERWISE NOTED. 3. ALL EXPOSED CONDUIT, DUCT WORK, PIPING, ETC. SHALL BE PAINTED TO MATCH CEILING UNLESS OTHERWISE NOTED OR REQUIRED BY CODE. 4. ALL EXPOSED STEEL BEAMS, JOISTS, DECK SHALL BE PAINTED

PER CEILING FINISH SCHEDULE UNLESS OTHERWISE NOTED.

CEILING ACCESS PANELS 1. FOR EQUIPMENT THAT REQUIRES ACCESS THROUGH CEILINGS, LOCATE ABOVE ATC CEILINGS WHERE POSSIBLE. WHERE ACCESS IS REQUIRED THROUGH GYPSUM BOARD CEILINGS, CONTRACTOR SHALL PROVIDE ACCESS PANELS AS REQUIRED. CONSULTANT SHALL REVIEW LOCATIONS PRIOR TO CONTRACTOR PROCEEDING WITH INSTALLATION.

2. IN AREAS WHERE ACCESS CAN NOT BE GAINED FROM ACT CEILINGS, ACCESS PANELS ARE TO BE PROVIDED. 3. PROVIDE ACCESS PANELS OF APPROPRIATE SIZE, TYPE, AND FIRE RATING FOR ALL CONCEALED ITEMS THAT REQUIRE ADJUSTMENT,

MAINTENANCE, MONITORING, ETC. 4. ACCESS PANELS SHALL BE SIZED ACCORDING TO ACCESS REQUIREMENTS, PREFABRICATED OR ALTERNATIVELY, CONSTRUCTED OF MIN. 12.7MM MDF PANELS, FINISH FLUSH WITH ADJACENT CEILING AND FINISHED TO MATCH ADJACENT CEILING FINISH. PROVIDE 3MM REVEAL AROUND ENTIRE PANEL (TYP.)

6. WHERE POSSIBLE, SERVICES TO BE GANGED TO LIMIT THE NUMBER OF PANELS REQUIRED. 7. ALL ACCESS PANELS TO BE KEYED WITH THE SAME LOCK 8. ACCESS PANELS SHALL BE PREFABRICATED AND SIZED ACCORDING TO ACCESS REQUIREMENTS. FINISH FLUSH WITH ADJACENT CEILING AND COLOR SHALL MATCH ADJACENT CEILING

5. COORDINATE LOCATION AND FINISH WITH ARCHITECT.

REFLECTED CEILING PLAN LEGEND AND SYMBOLS: NOTE: ALL HATCHES, SYMBOLS AND REFERENCES ARE TO BE COORDINATED WITH THE GENERAL RENOVATION NOTED, CONSTRUCTION TYPES & GENERAL NOTES ON DRAWING

RCP HATCH LEGEND:





NEW GYPSUM CEILING, PAINTED

PNT-03 UNLESS OTHERWISE NOTED

LIGHTING SPECIFICATIONS:

L1 610mm X 1220mm RECESSED LED PANEL FIXTURE, MOUNTED

L2 102mm X 1220mm RECESSED LED PANEL FIXTURE, MOUNTED

L3 102mm X 1220mm SUSPENDED LINEAR LED FIXTURE FOR

OPEN CEILING, CABLE HUNG

L4 25mm UNDER-CABINET LED STRIP C/W DIFFUSER, LENGTH PER DRAWINGS

L5 102mm RECESSED ROUND POT LIGHT

REFER TO SCHEDULES FOR MORE INFORMATION

L6 JONI WALL WALL SCONCE BY SEAN LAVIN FOR TECH

ISSUED FOR TENDER 2023.09.06 ISSUED FOR PERMIT 2023.05.16 Issued for Coordination 2022.07.29


DRAWING TITLE:

DRAWING NO.:

REFLECTED CEILING PLAN

ISSUES/REVISIONS

ISSUED FOR ADDENDUM 3

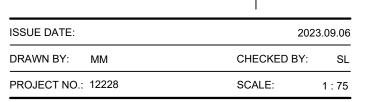

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LICENCE

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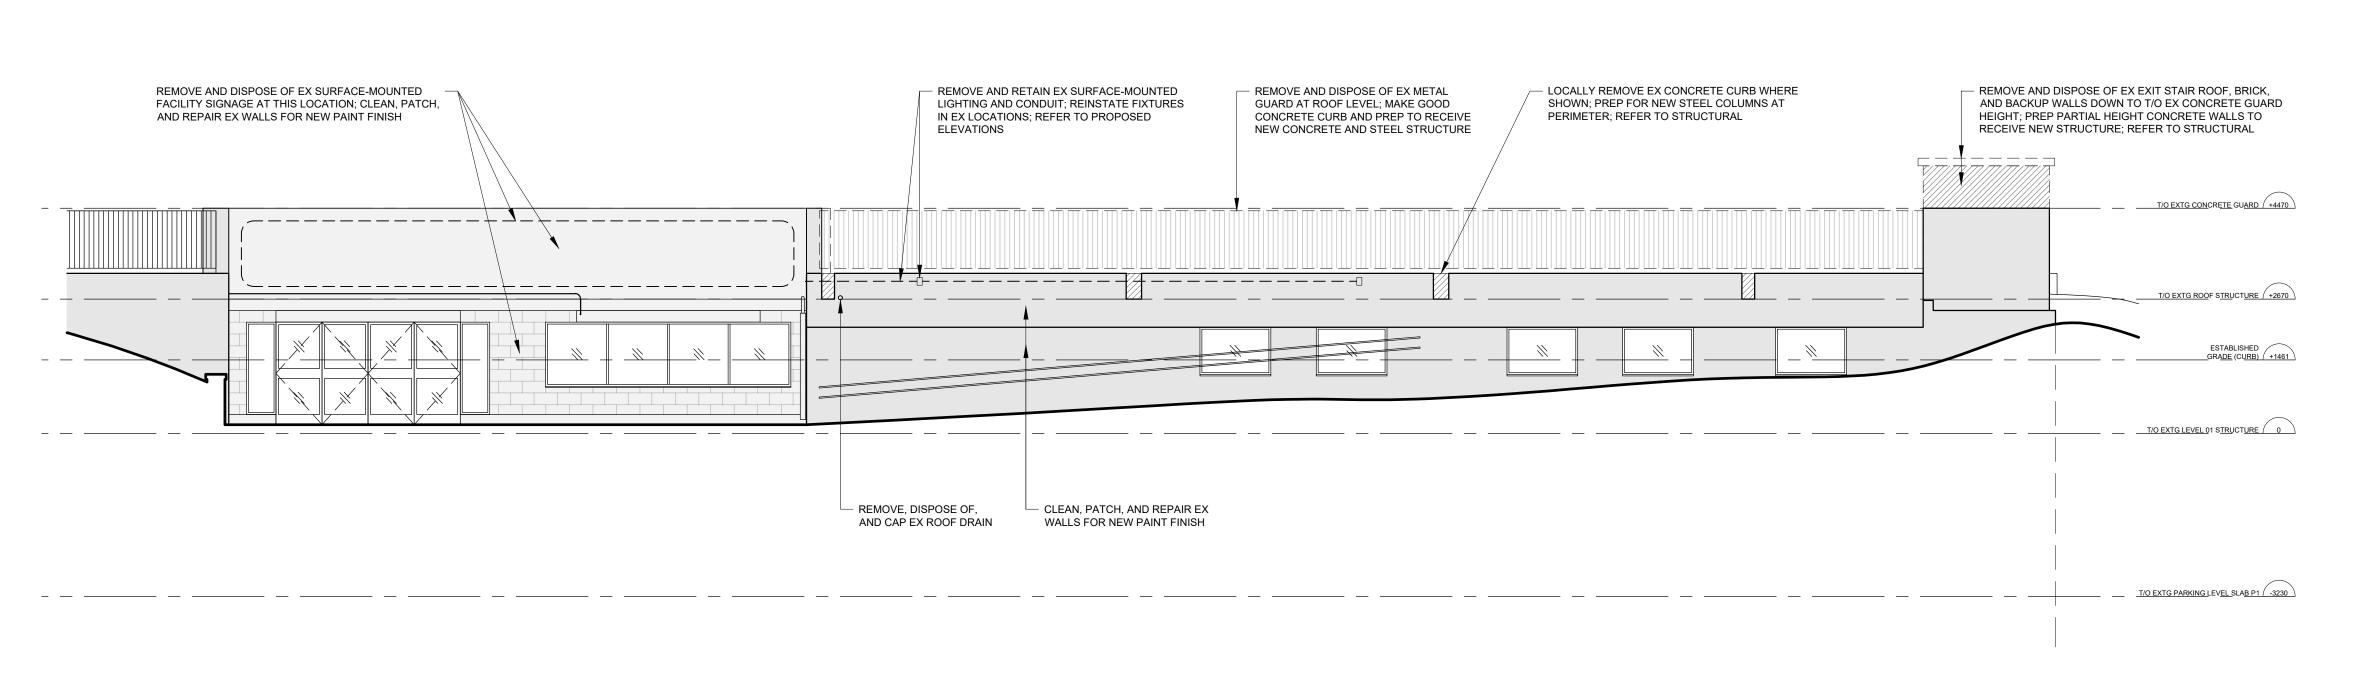
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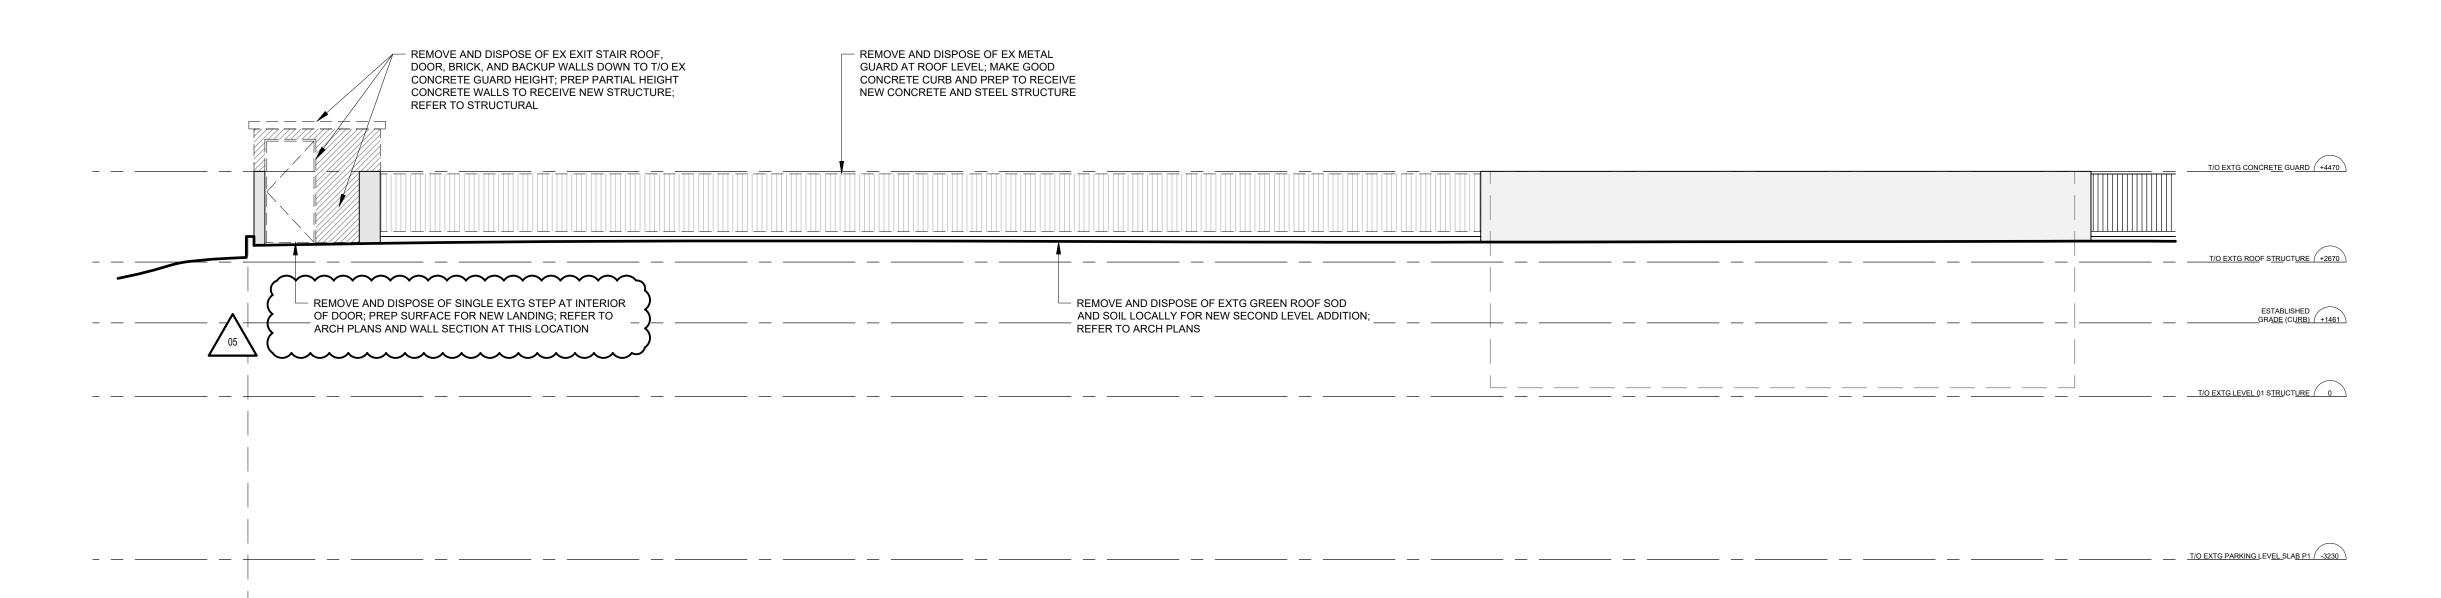
REVISION:

2023.10.06

DATE



DEMOLITION ELEVATION - EXTERIOR SOUTH



DEMOLITION ELEVATION - EXTERIOR NORTH SCALE: 1:75

GENERAL DEMOLITION NOTES:

1. REFER TO AND COORDINATE DEMOLITION WORK WITH PHASING 6. PATCH AND REPAIR ALL ADJACENT SURFACES TO AREAS OF DRAWINGS (BY OTHERS).

2. PROVIDE DUST-TIGHT HOARDING PARTITIONS WHERE REQUIRED FOR PHASING (BY OTHERS). SEAL ALL AREAS OF CONSTRUCTION 7. CLEAN, PATCH AND REPAIR ALL SURFACES TO REMAIN AS TO ALLOW FOR ALL OTHER FLOOR AREAS TO REMAIN OPERATIONAL DURING CONSTRUCTION.

- 3. GC TO COORDINATE EXTENT OF DEMOLITION WITH MECHANICAL, ELECTRICAL, AND STRUCTURAL DRAWINGS. ANY AREAS NOT SHOWN ON ARCHITECTURAL DRAWINGS, WHICH REQUIRE INSTALLATION OF NEW SERVICES, IS TO BE RETURNED TO ORIGINAL STATE TO MATCH EXISTING.
- 4. ALL WALL FIXED ITEMS (SPEAKERS, BELLS, LIGHTS, SIGNAGE, ETC.), AS WELL AS CEILING MOUNTED EQUIPMENT ARE TO REMAIN UNLESS OTHERWISE NOTED (REFER TO AND COORDINATE WITH MECHANICAL AND ELECTRICAL DRAWINGS). GC TO ENSURE THE PROTECTION OF THESE ITEMS DURING CONSTRUCTION.
- 5. REMOVE ALL REDUNDANT POWER OUTLETS AND CONDUIT TO THE JUNCTION BOX AND MAKE SAFE. REFER TO ELECTRICAL DRAWINGS FOR ADDITIONAL INFORMATION.
- DEMOLITION AS REQUIRED TO MATCH EXISTING OR READY FOR
- REQUIRED FOR NEW FINISHES.
- 8. PROVIDE TEMPORARY SUPPORT FOR ADJACENT CEILINGS, LIGHT FIXTURES, DIFFUSERS, CEILING MOUNTED DEVICES, ETC, AS REQUIRED FOR AREAS WHERE CEILINGS ARE REQUIRED TO BE REMOVED TO INSTALL NEW OR MODIFY EXISTING SERVICES. ALL CEILINGS TO BE RESTORED BACK TO ORIGINAL STATE.
- 9. GC TO VERIFY IN FIELD ALL EXISTING MEASUREMENTS AND CONDITIONS. ANY DISCREPANCIES SHALL BE BROUGHT TO THE PROJECT MANAGER'S ATTENTION PRIOR TO THE END OF TENDER
- 10. RETROFIT EXISTING RADIATOR COVERS, WIRE MOLDS, ETC. AS REQUIRED TO ACCOMMODATE NEW WALL CONSTRUCTION AND DEMOLITION OF EXISTING.

11. EXISTING ITEMS NOTED TO REMAIN, BE RETRO-FIT OR RE-FINISHED, ARE TO HAVE THEIR EXISTING STATE SITE VERIFIED FOR INTEGRITY. ANY DISCREPANCIES SHALL BE BROUGHT TO THE PROJECT MANAGER'S ATTENTION PRIOR TO CONSTRUCTION.



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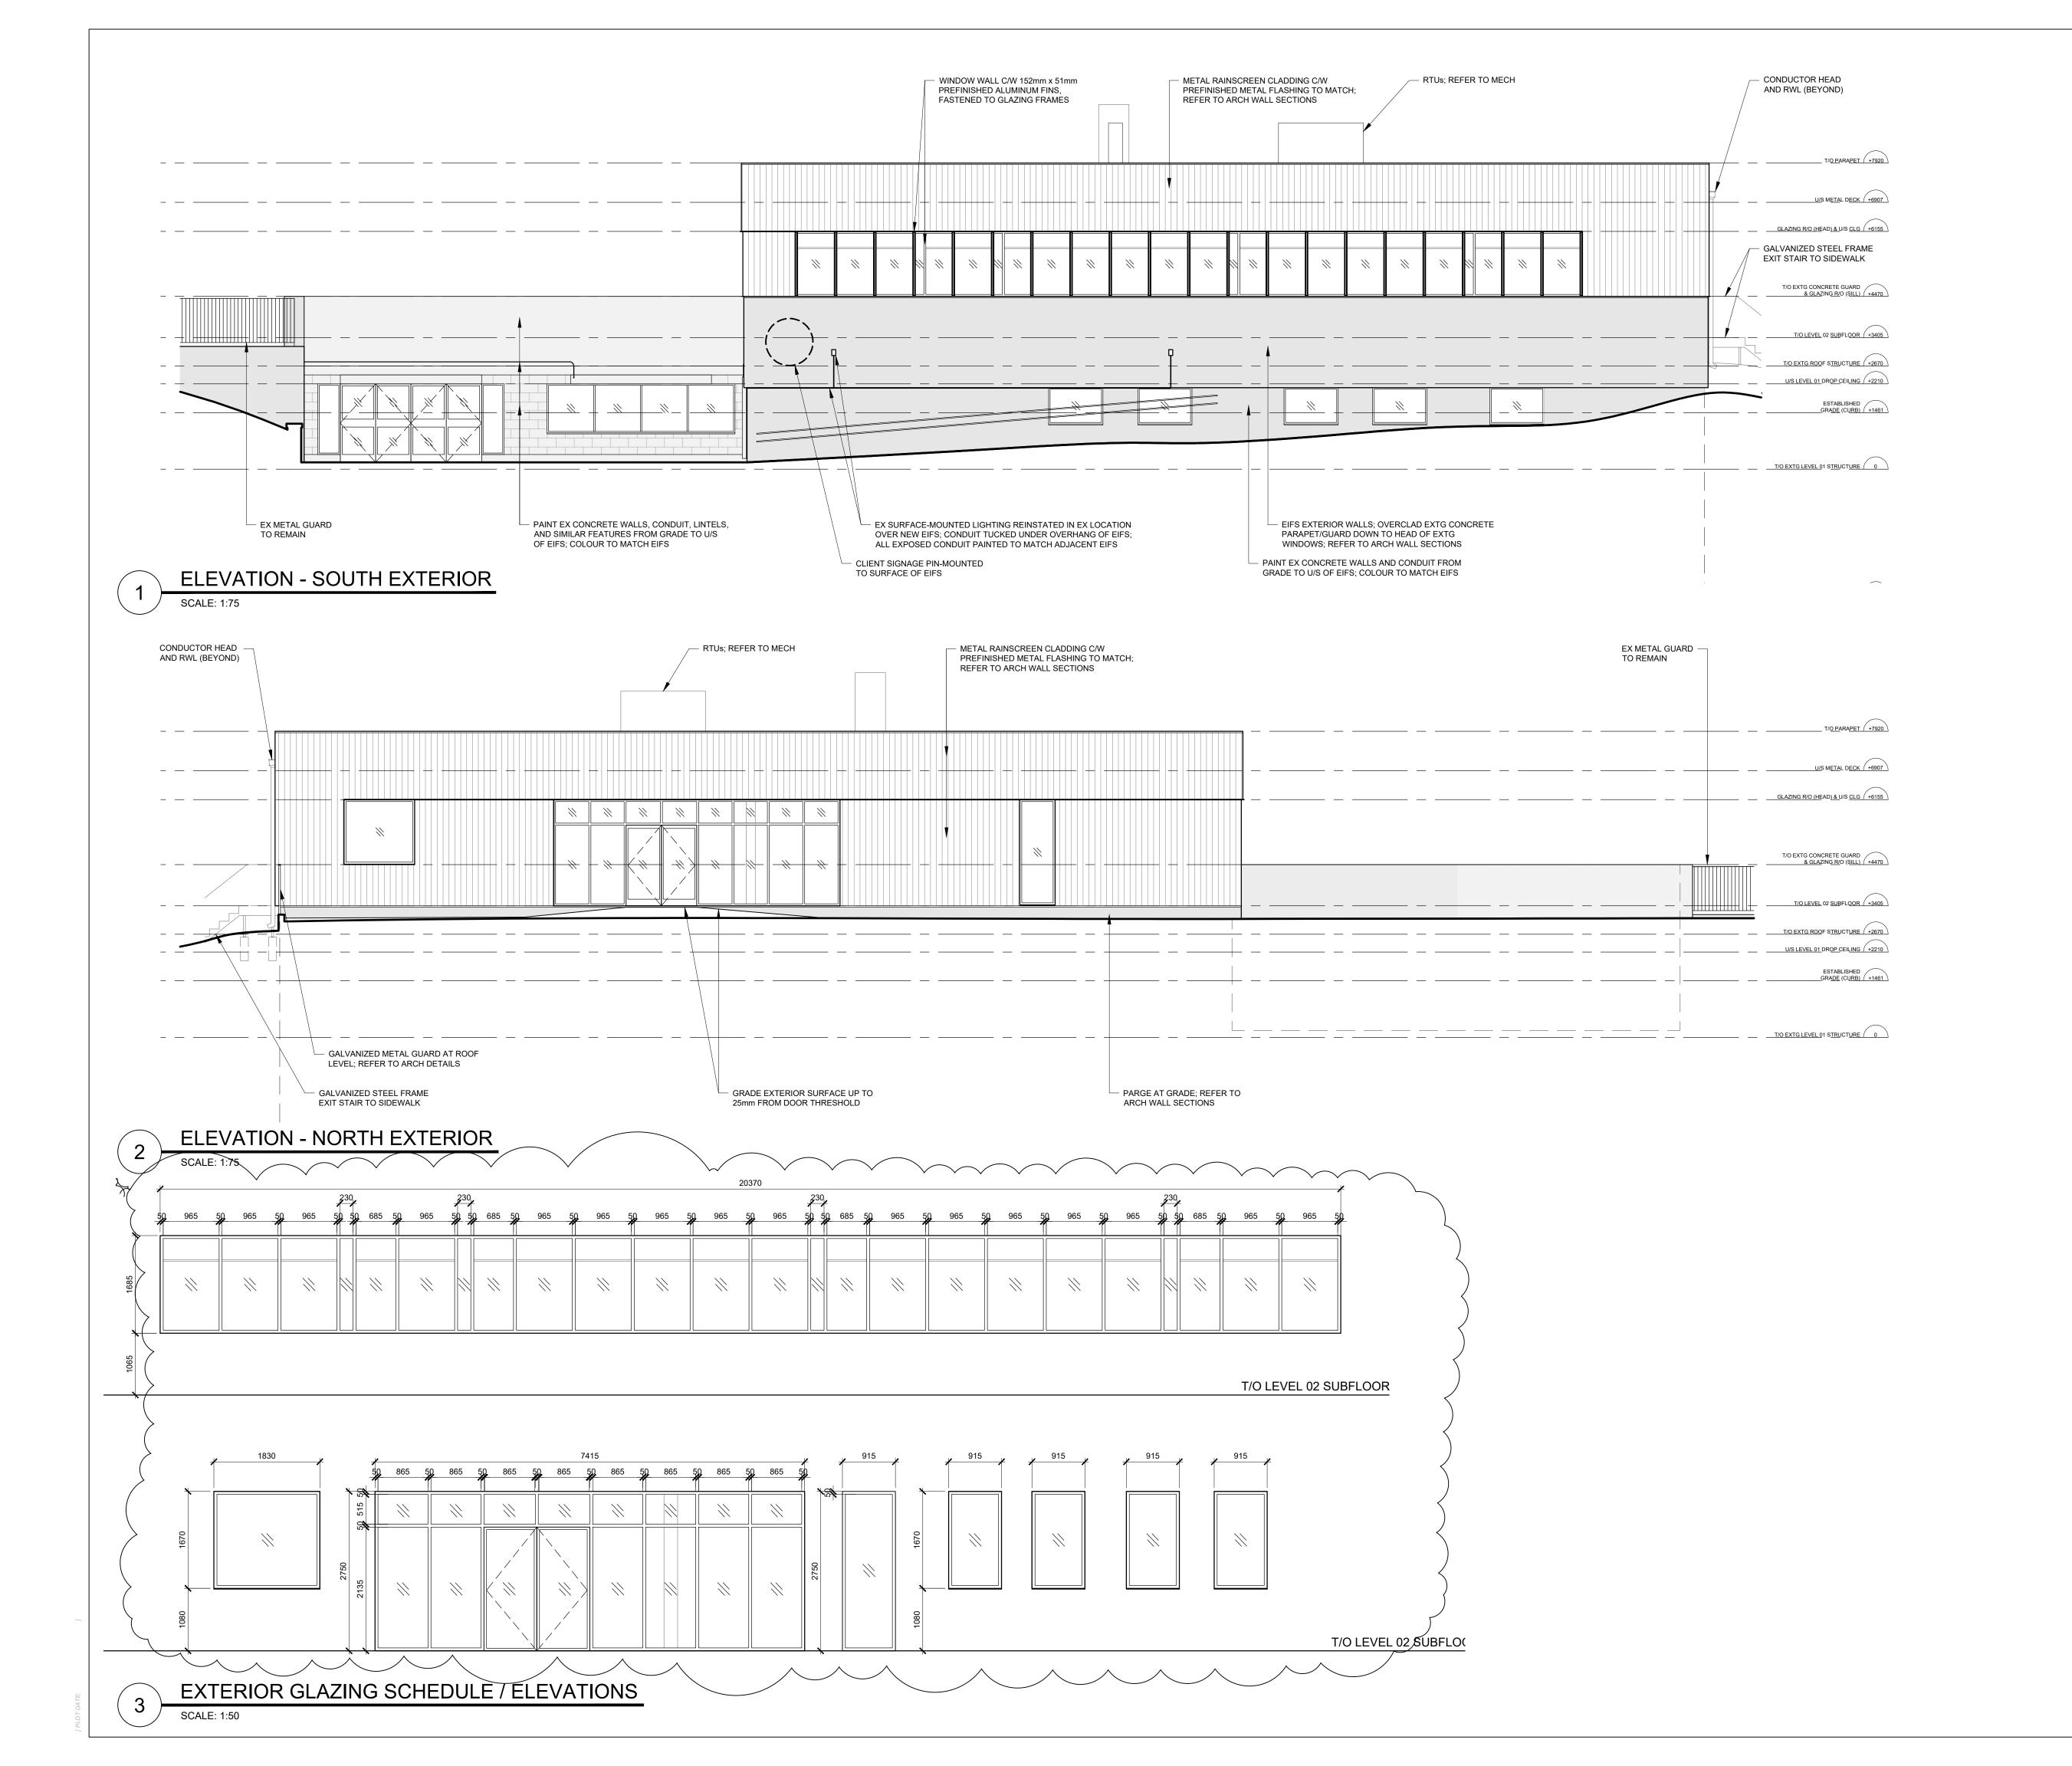


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04	ISSUED FOR TENDER	2023.09.06
03	ISSUED FOR PERMIT	2023.05.16
02	Issued for Pre-consultation	2022.10.07
01	Issued for Coordination	2022.07.29
NO.	ISSUES/REVISIONS	DATE

DEMOLITION **EXTERIOR ELEVATIONS**

DRAWING TITLE:

ISSUE DATE:	20	023.09.06
DRAWN BY: MM	CHECKED BY	: SL
PROJECT NO.: 12228	SCALE:	1 : 75
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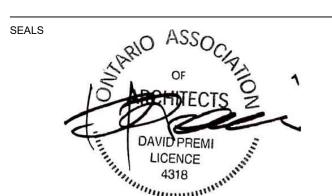
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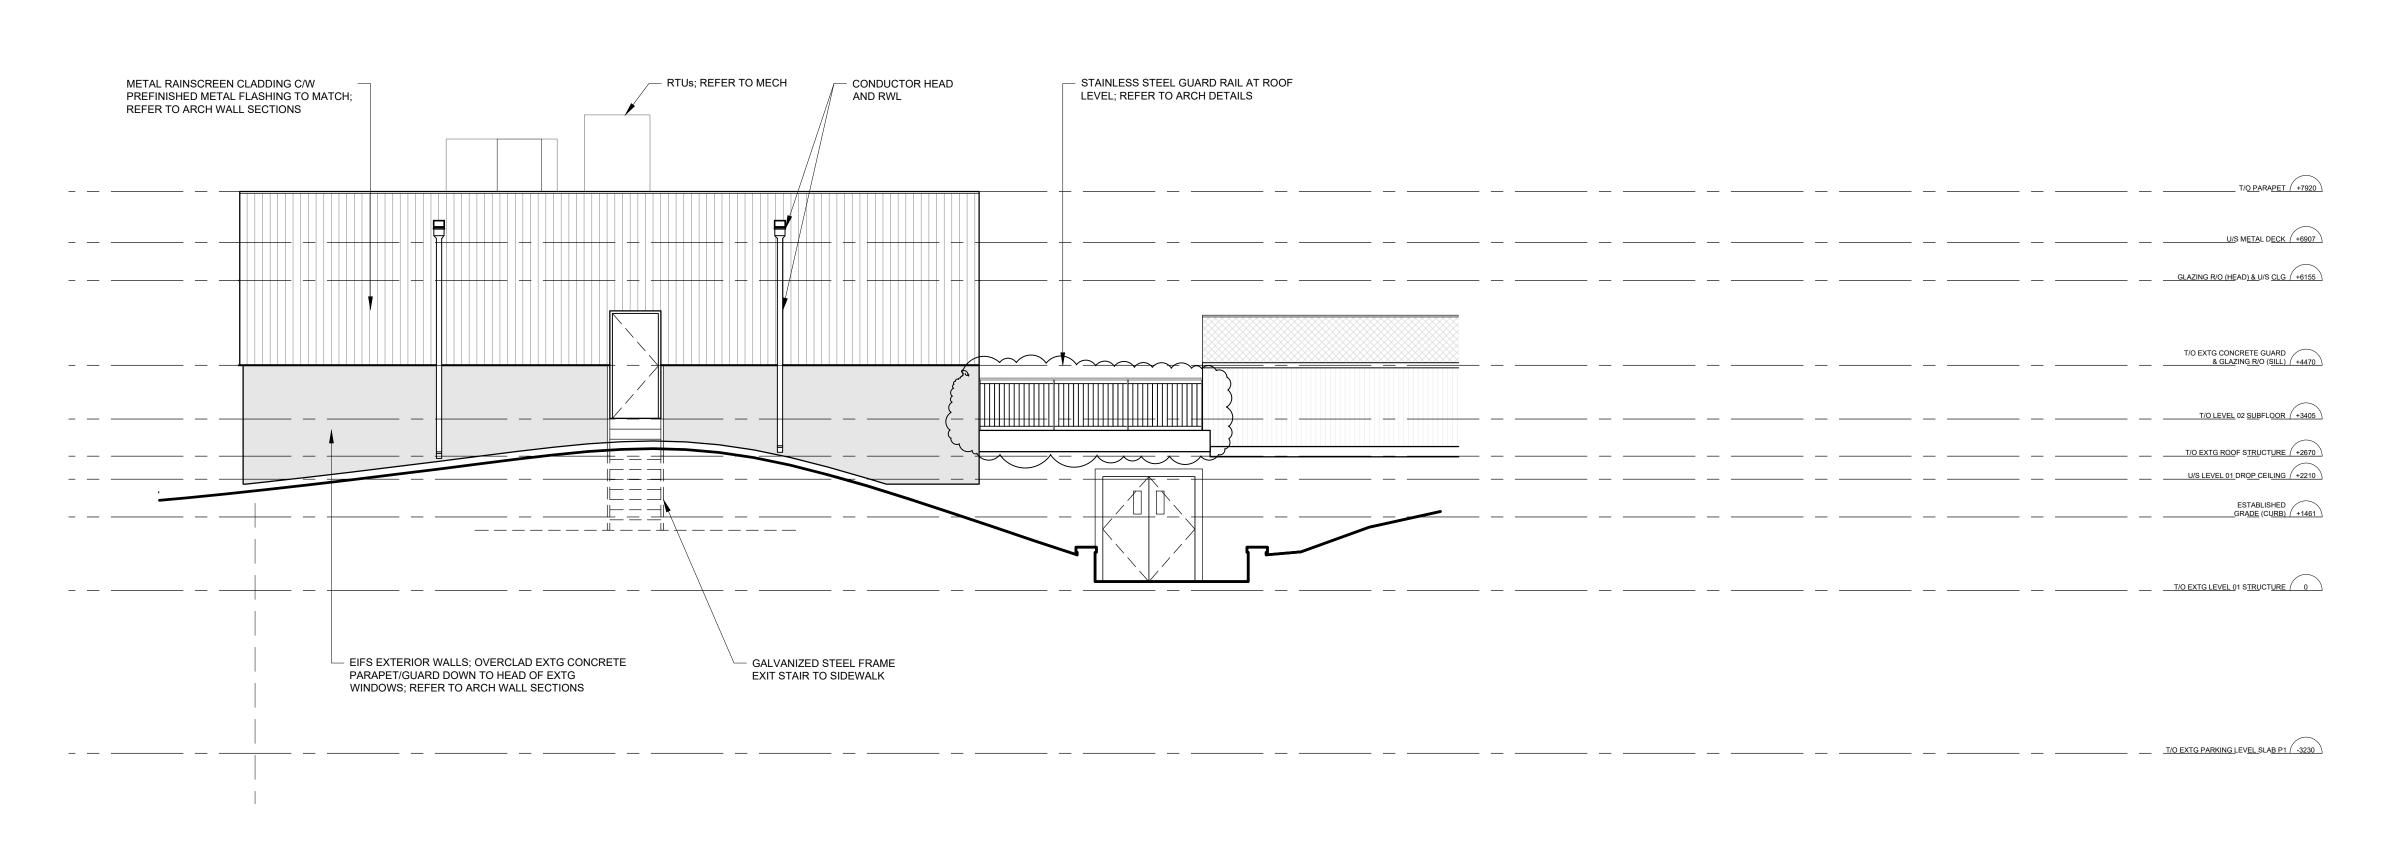
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	NC TITLE:	

EXTERIOR ELEVATIONS


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PROJECT NO.: 12228	SCALE: 1:75
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ELEVATION - WEST EXTERIOR





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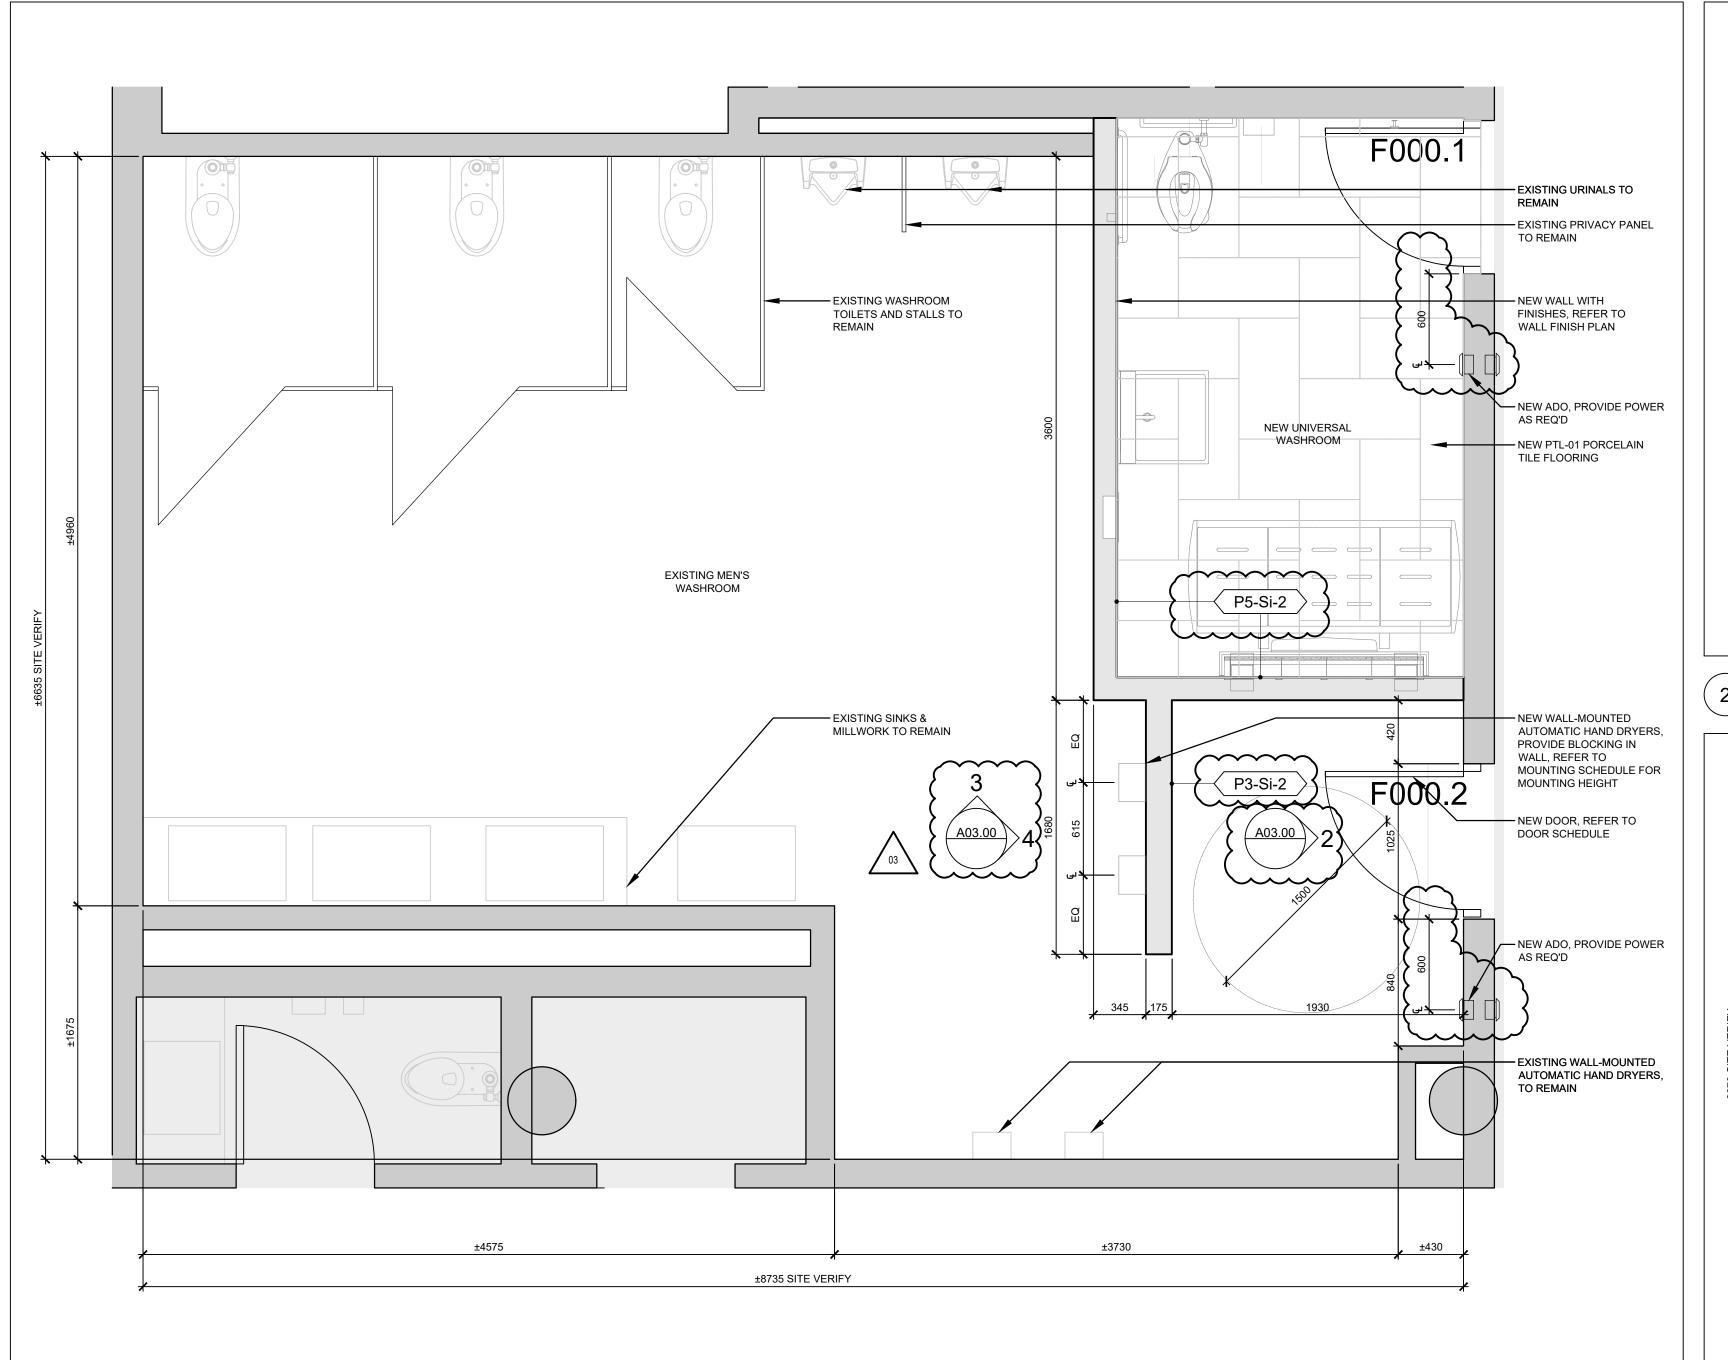



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EXTERIOR ELEVATIONS

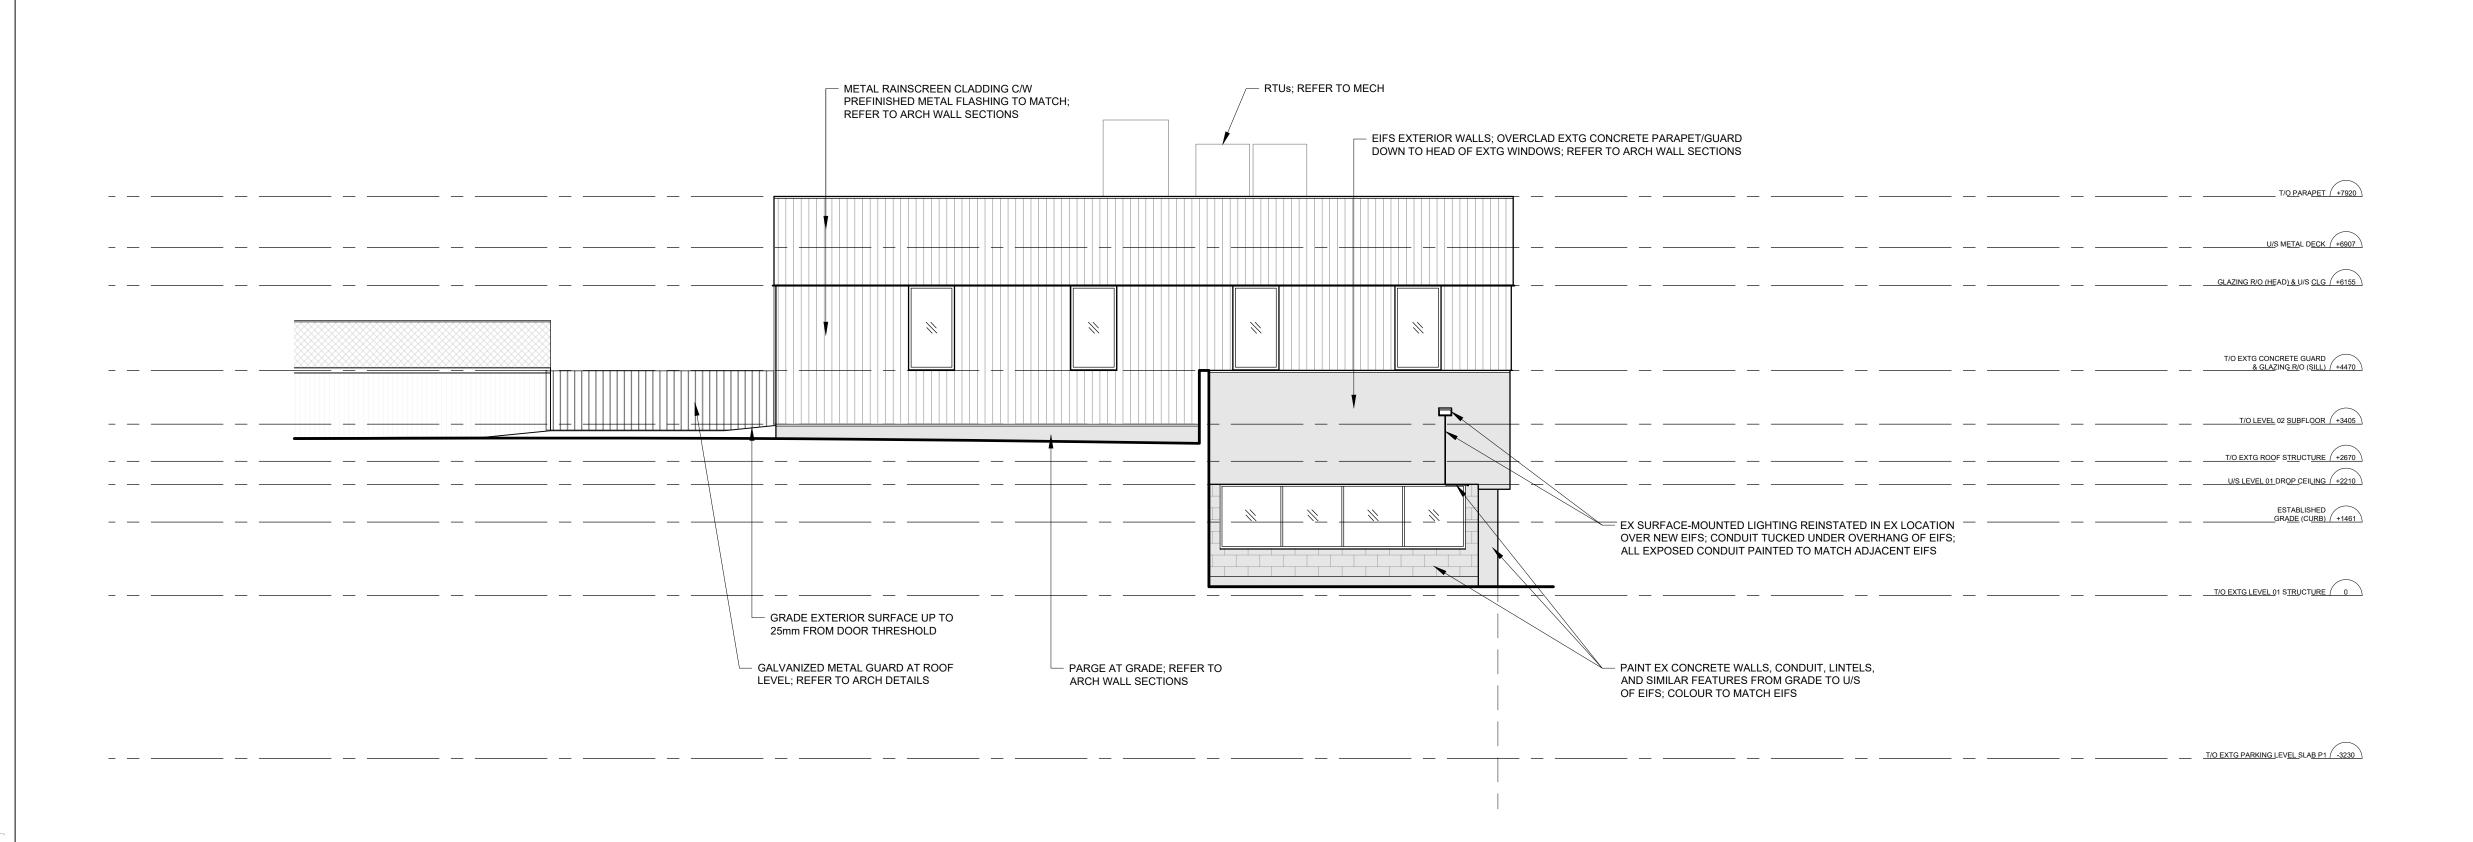
ISSUE DATE:	2023.09
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ELEVATION - EAST EXTERIOR






EAST ELEVATION - EXISTING MEN'S WASHROOM

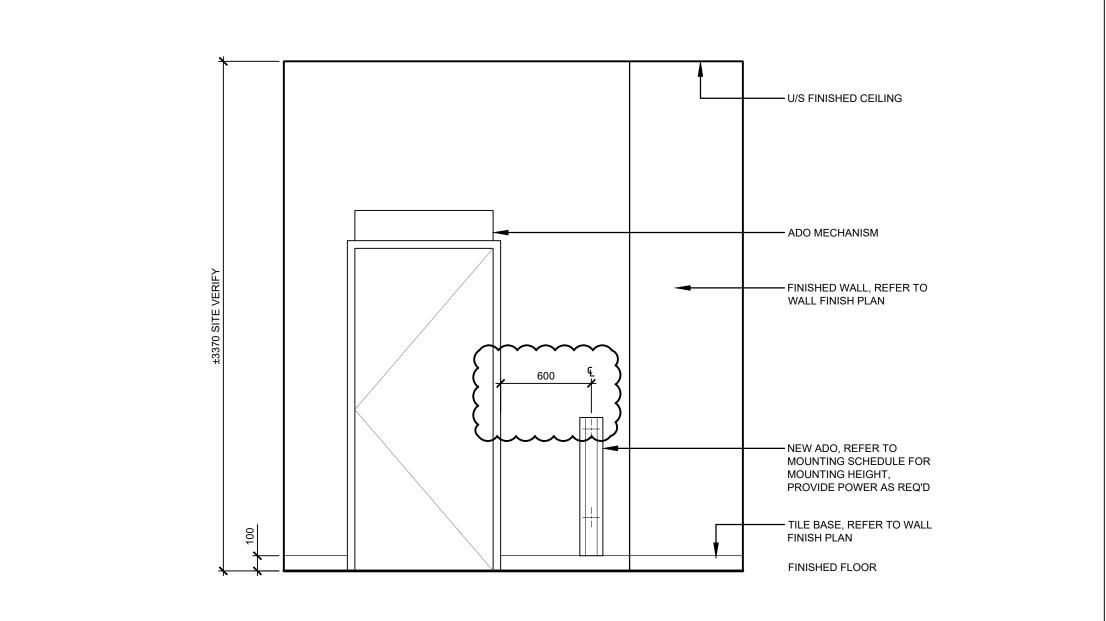

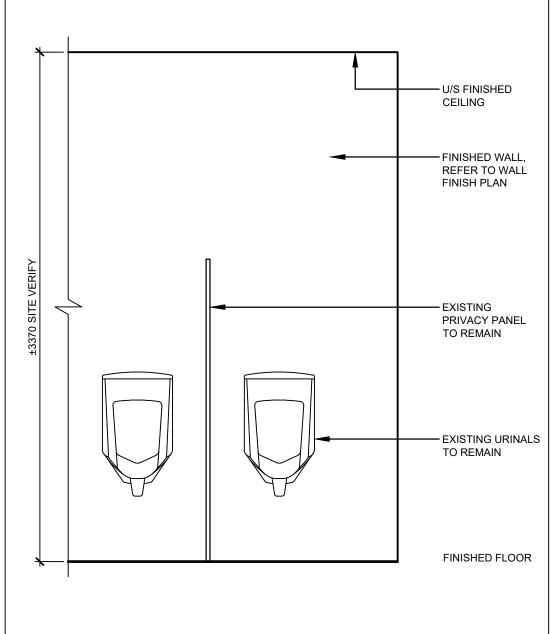PLAN - EXISTING MEN'S WASHROOM

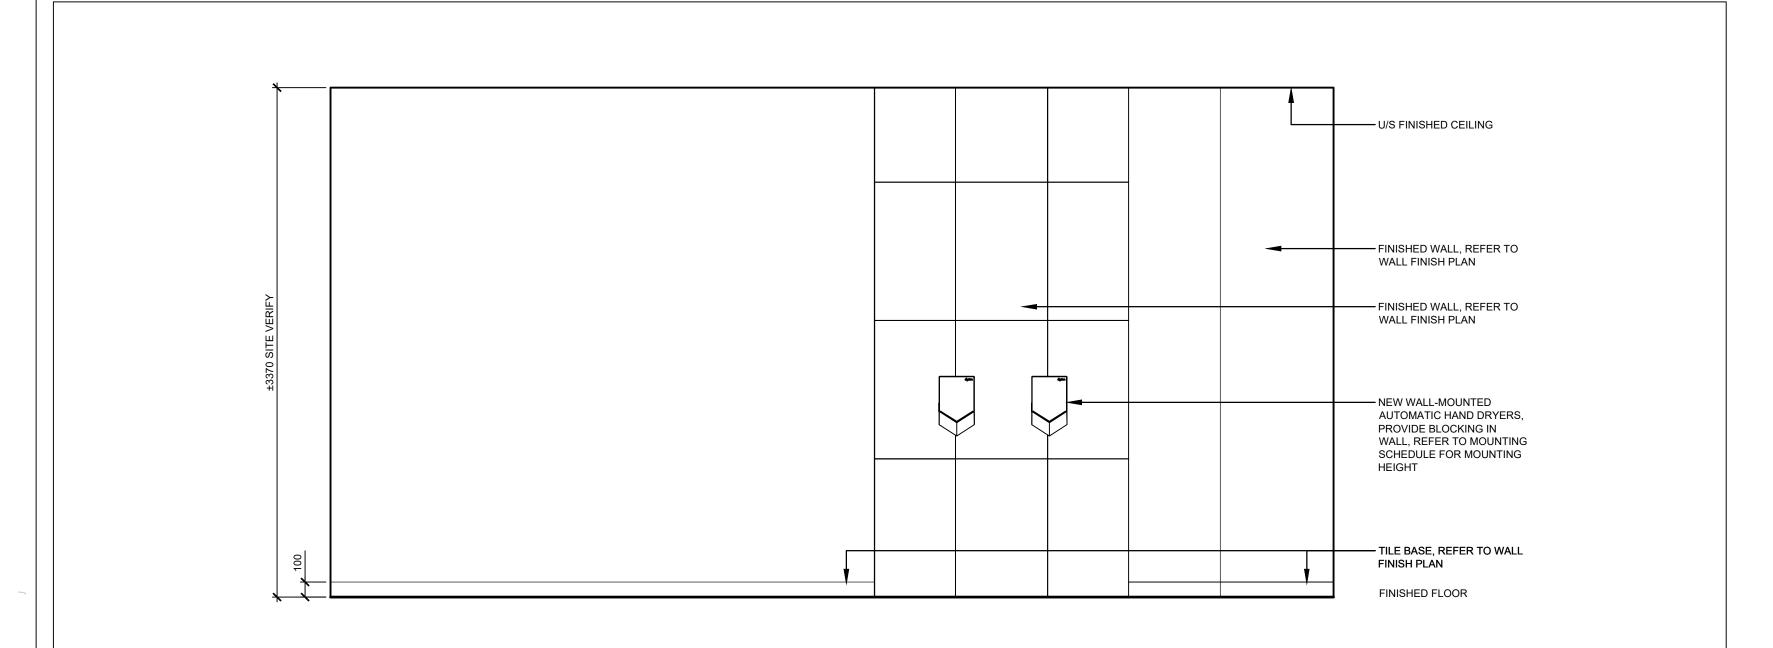

SCALE: 1:25

EAST ELEVATION - EXISTING MEN'S WASHROOM

NORTH ELEVATION - EXISTING MEN'S WASHROOM SCALE: 1:25



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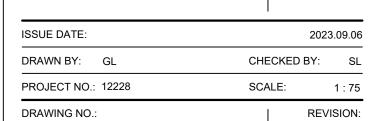
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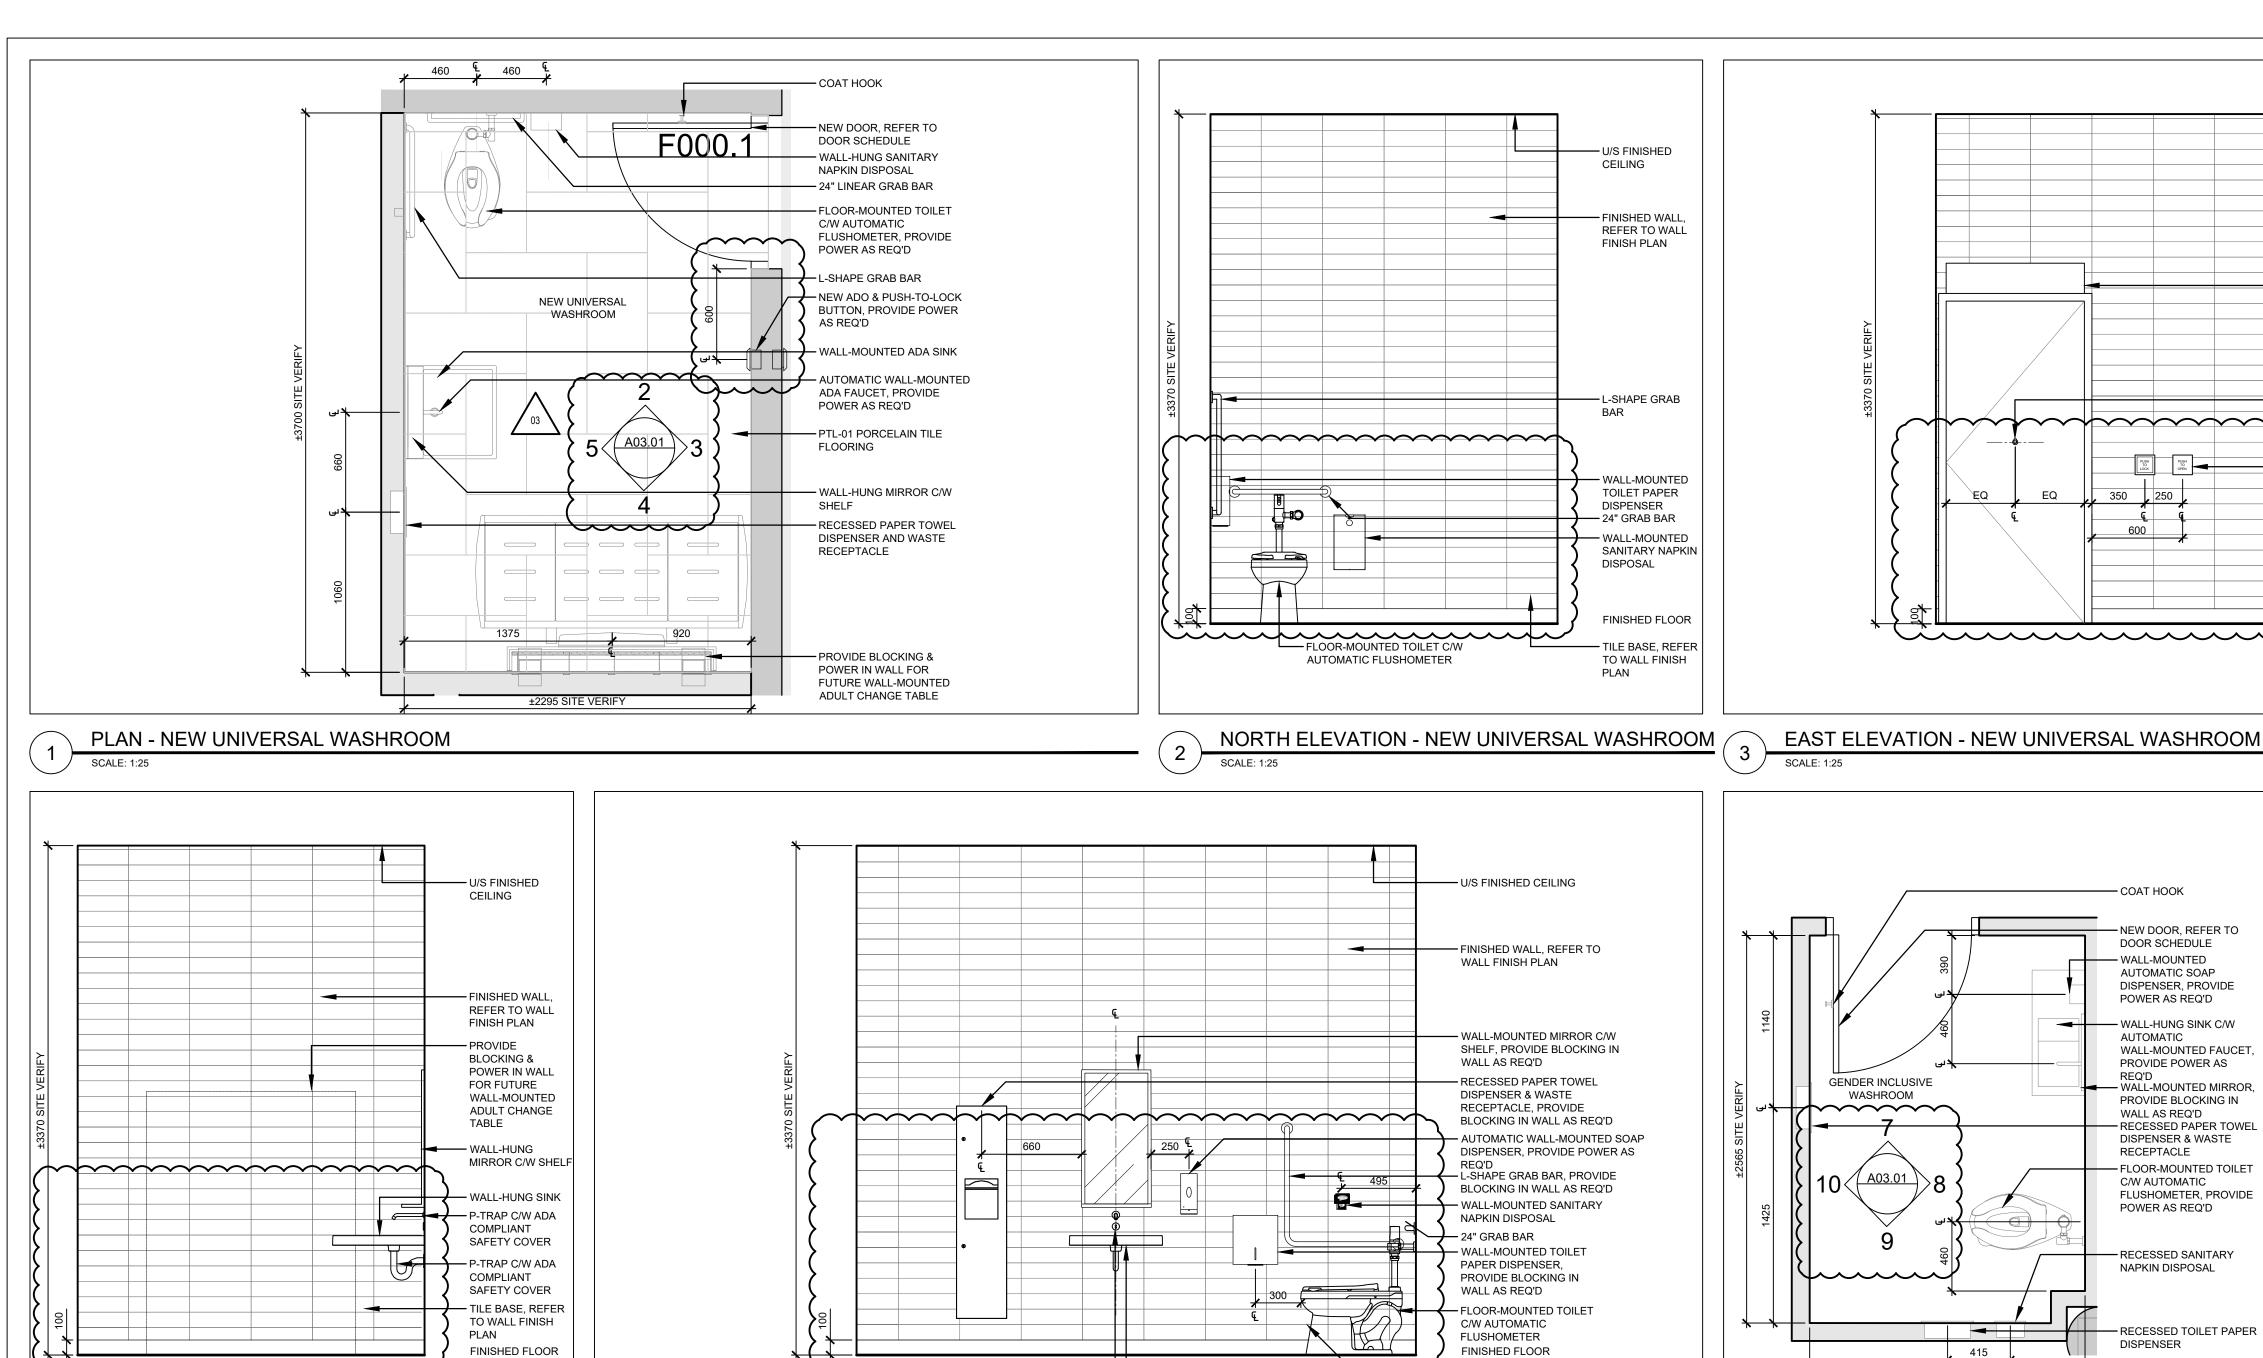



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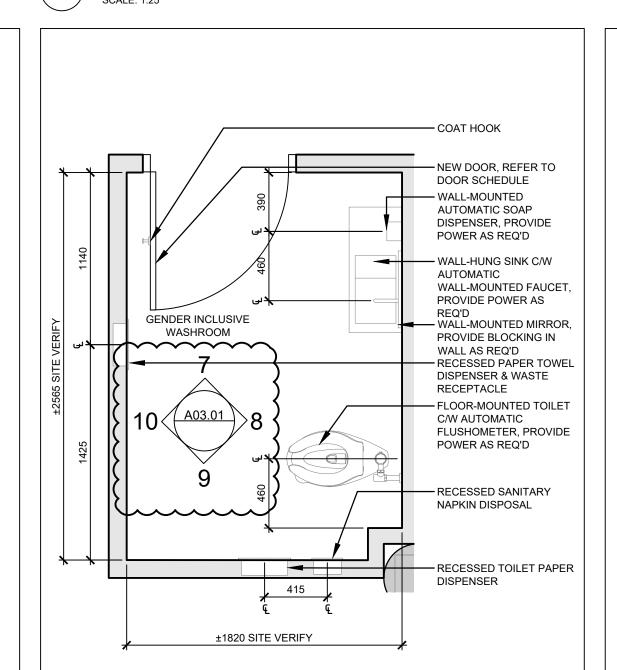
WASHROOM DETAILS

DRAWING TITLE:








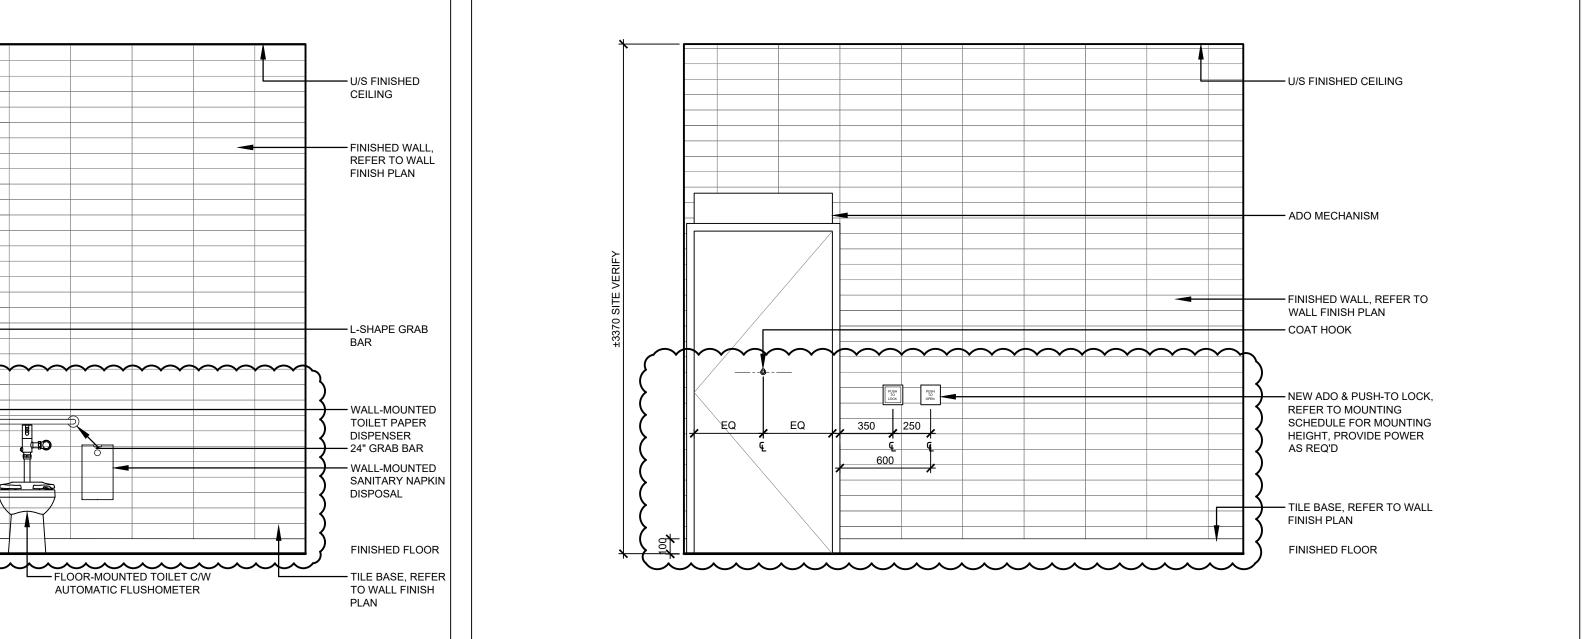


PLAN - GENDER INCLUSIVE WASHROOM

SCALE: 1:25

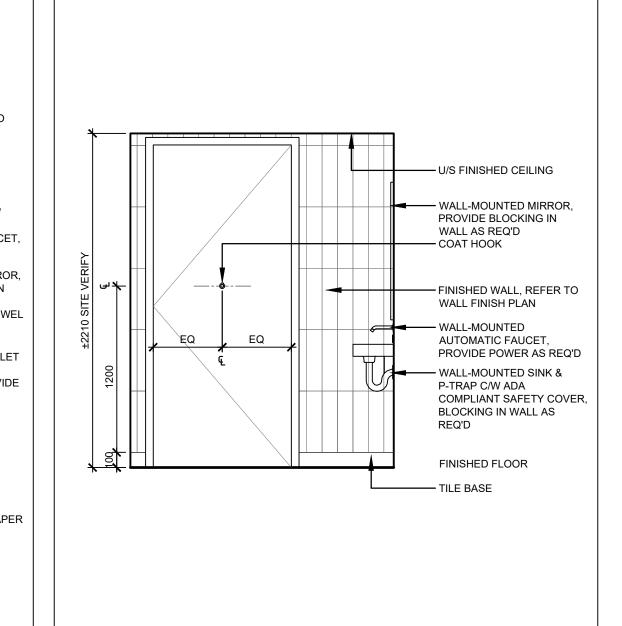

NORTH ELEVATION - GENDER INCLUSIVE W/R

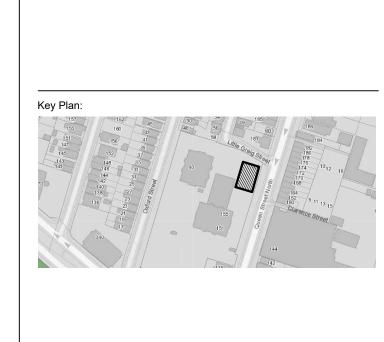

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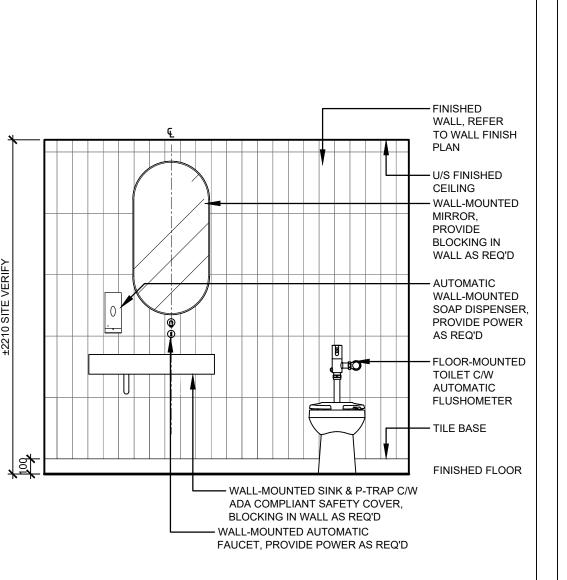
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SOUTH ELEVATION - NEW UNIVERSAL WASHROOM

SCALE: 1:25


WEST ELEVATION - NEW UNIVERSAL WASHROOM

SCALE: 1:25



EAST ELEVATION - GENDER INCLUSIVE W/R

SCALE: 1:25

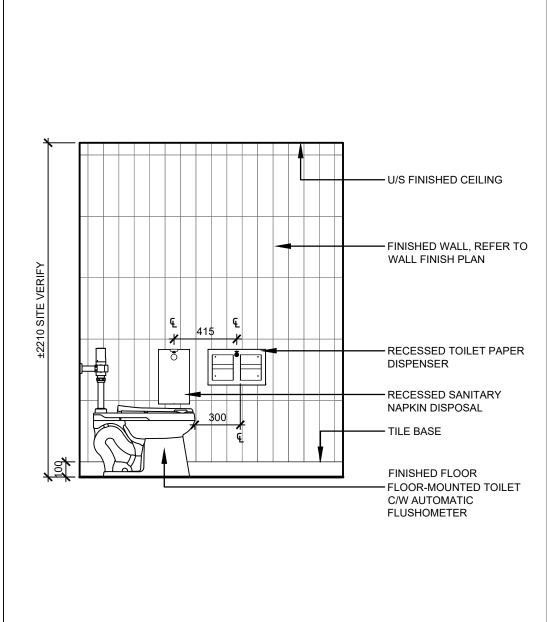


SOUTH ELEVATION - GENDER INCLUSIVE W/R

WALL-MOUNTED SINK & P-TRAP C/W

ADA COMPLIANT SAFETY COVER,

BLOCKING IN WALL AS REQ'D — WALL-MOUNTED AUTOMATIC FAUCET, PROVIDE POWER AS REQ'D

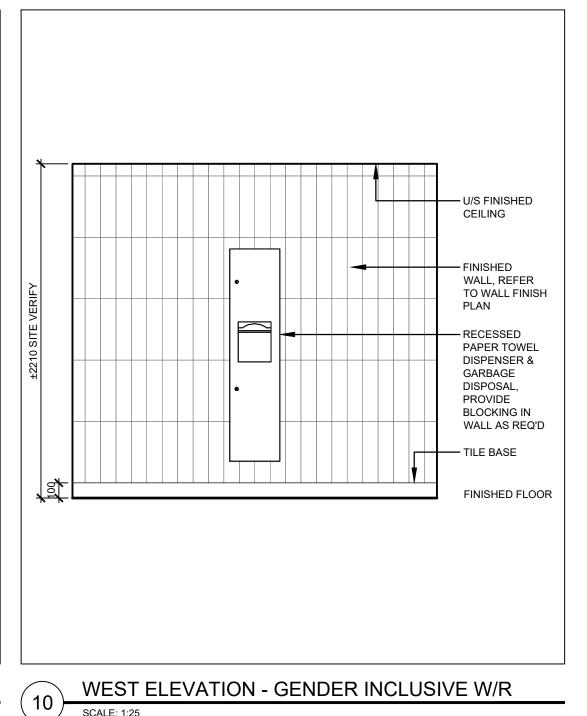



TILE BASE, REFER TO WALL

FINISH PLAN

ISSUED FOR ADDENDUM #3 2023.10.06 ISSUED FOR TENDER 2023.09.06 ISSUED FOR PERMIT 2023.05.16 ISSUES/REVISIONS DATE DRAWING TITLE:

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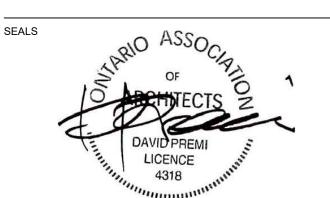
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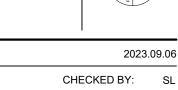
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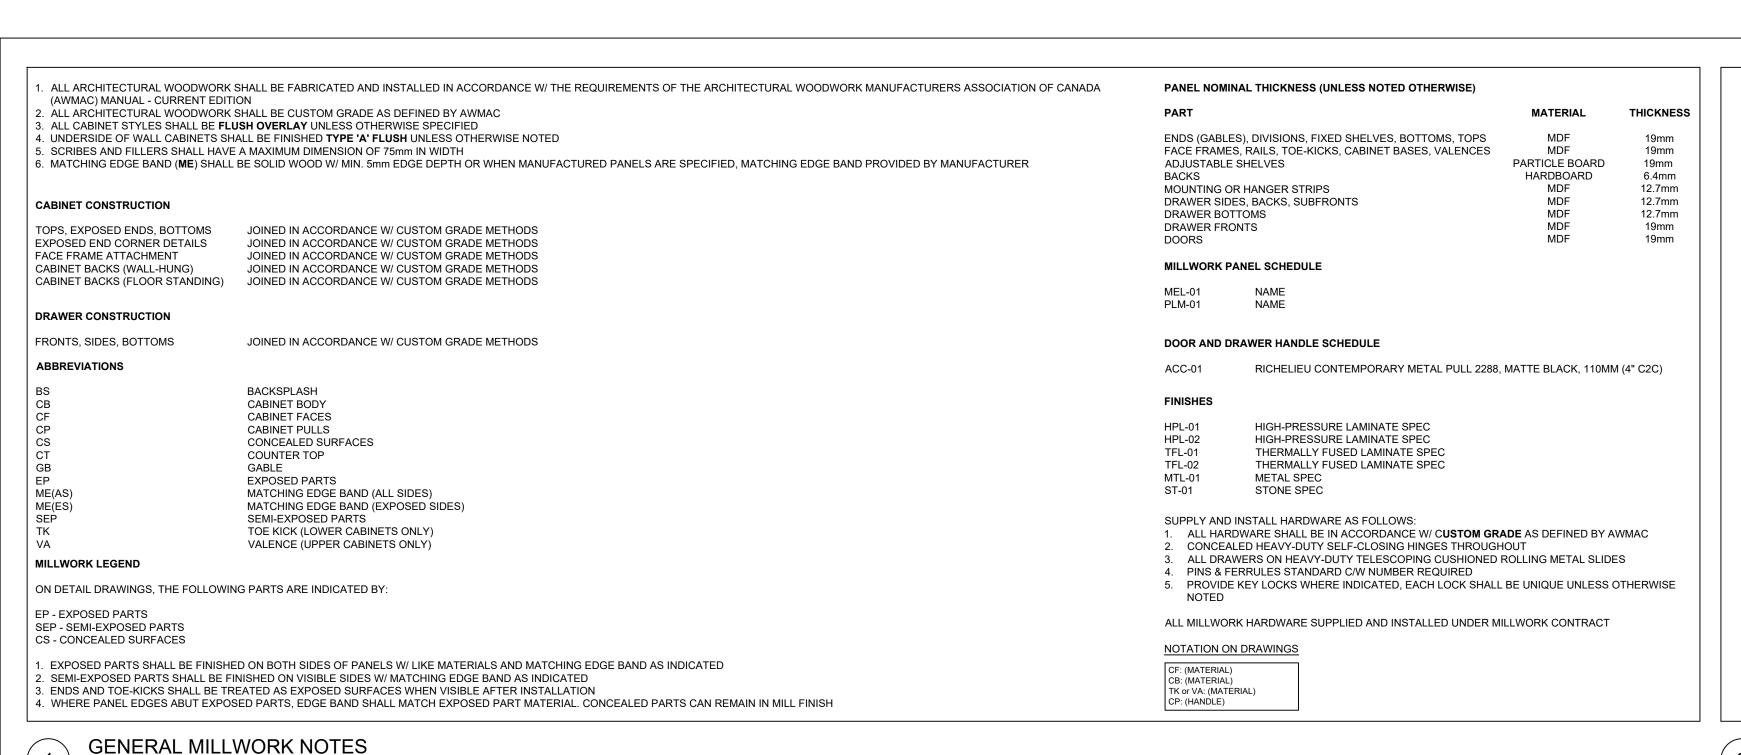
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WASHROOM DETAILS

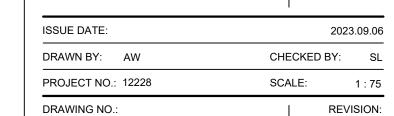ISSUE DATE:

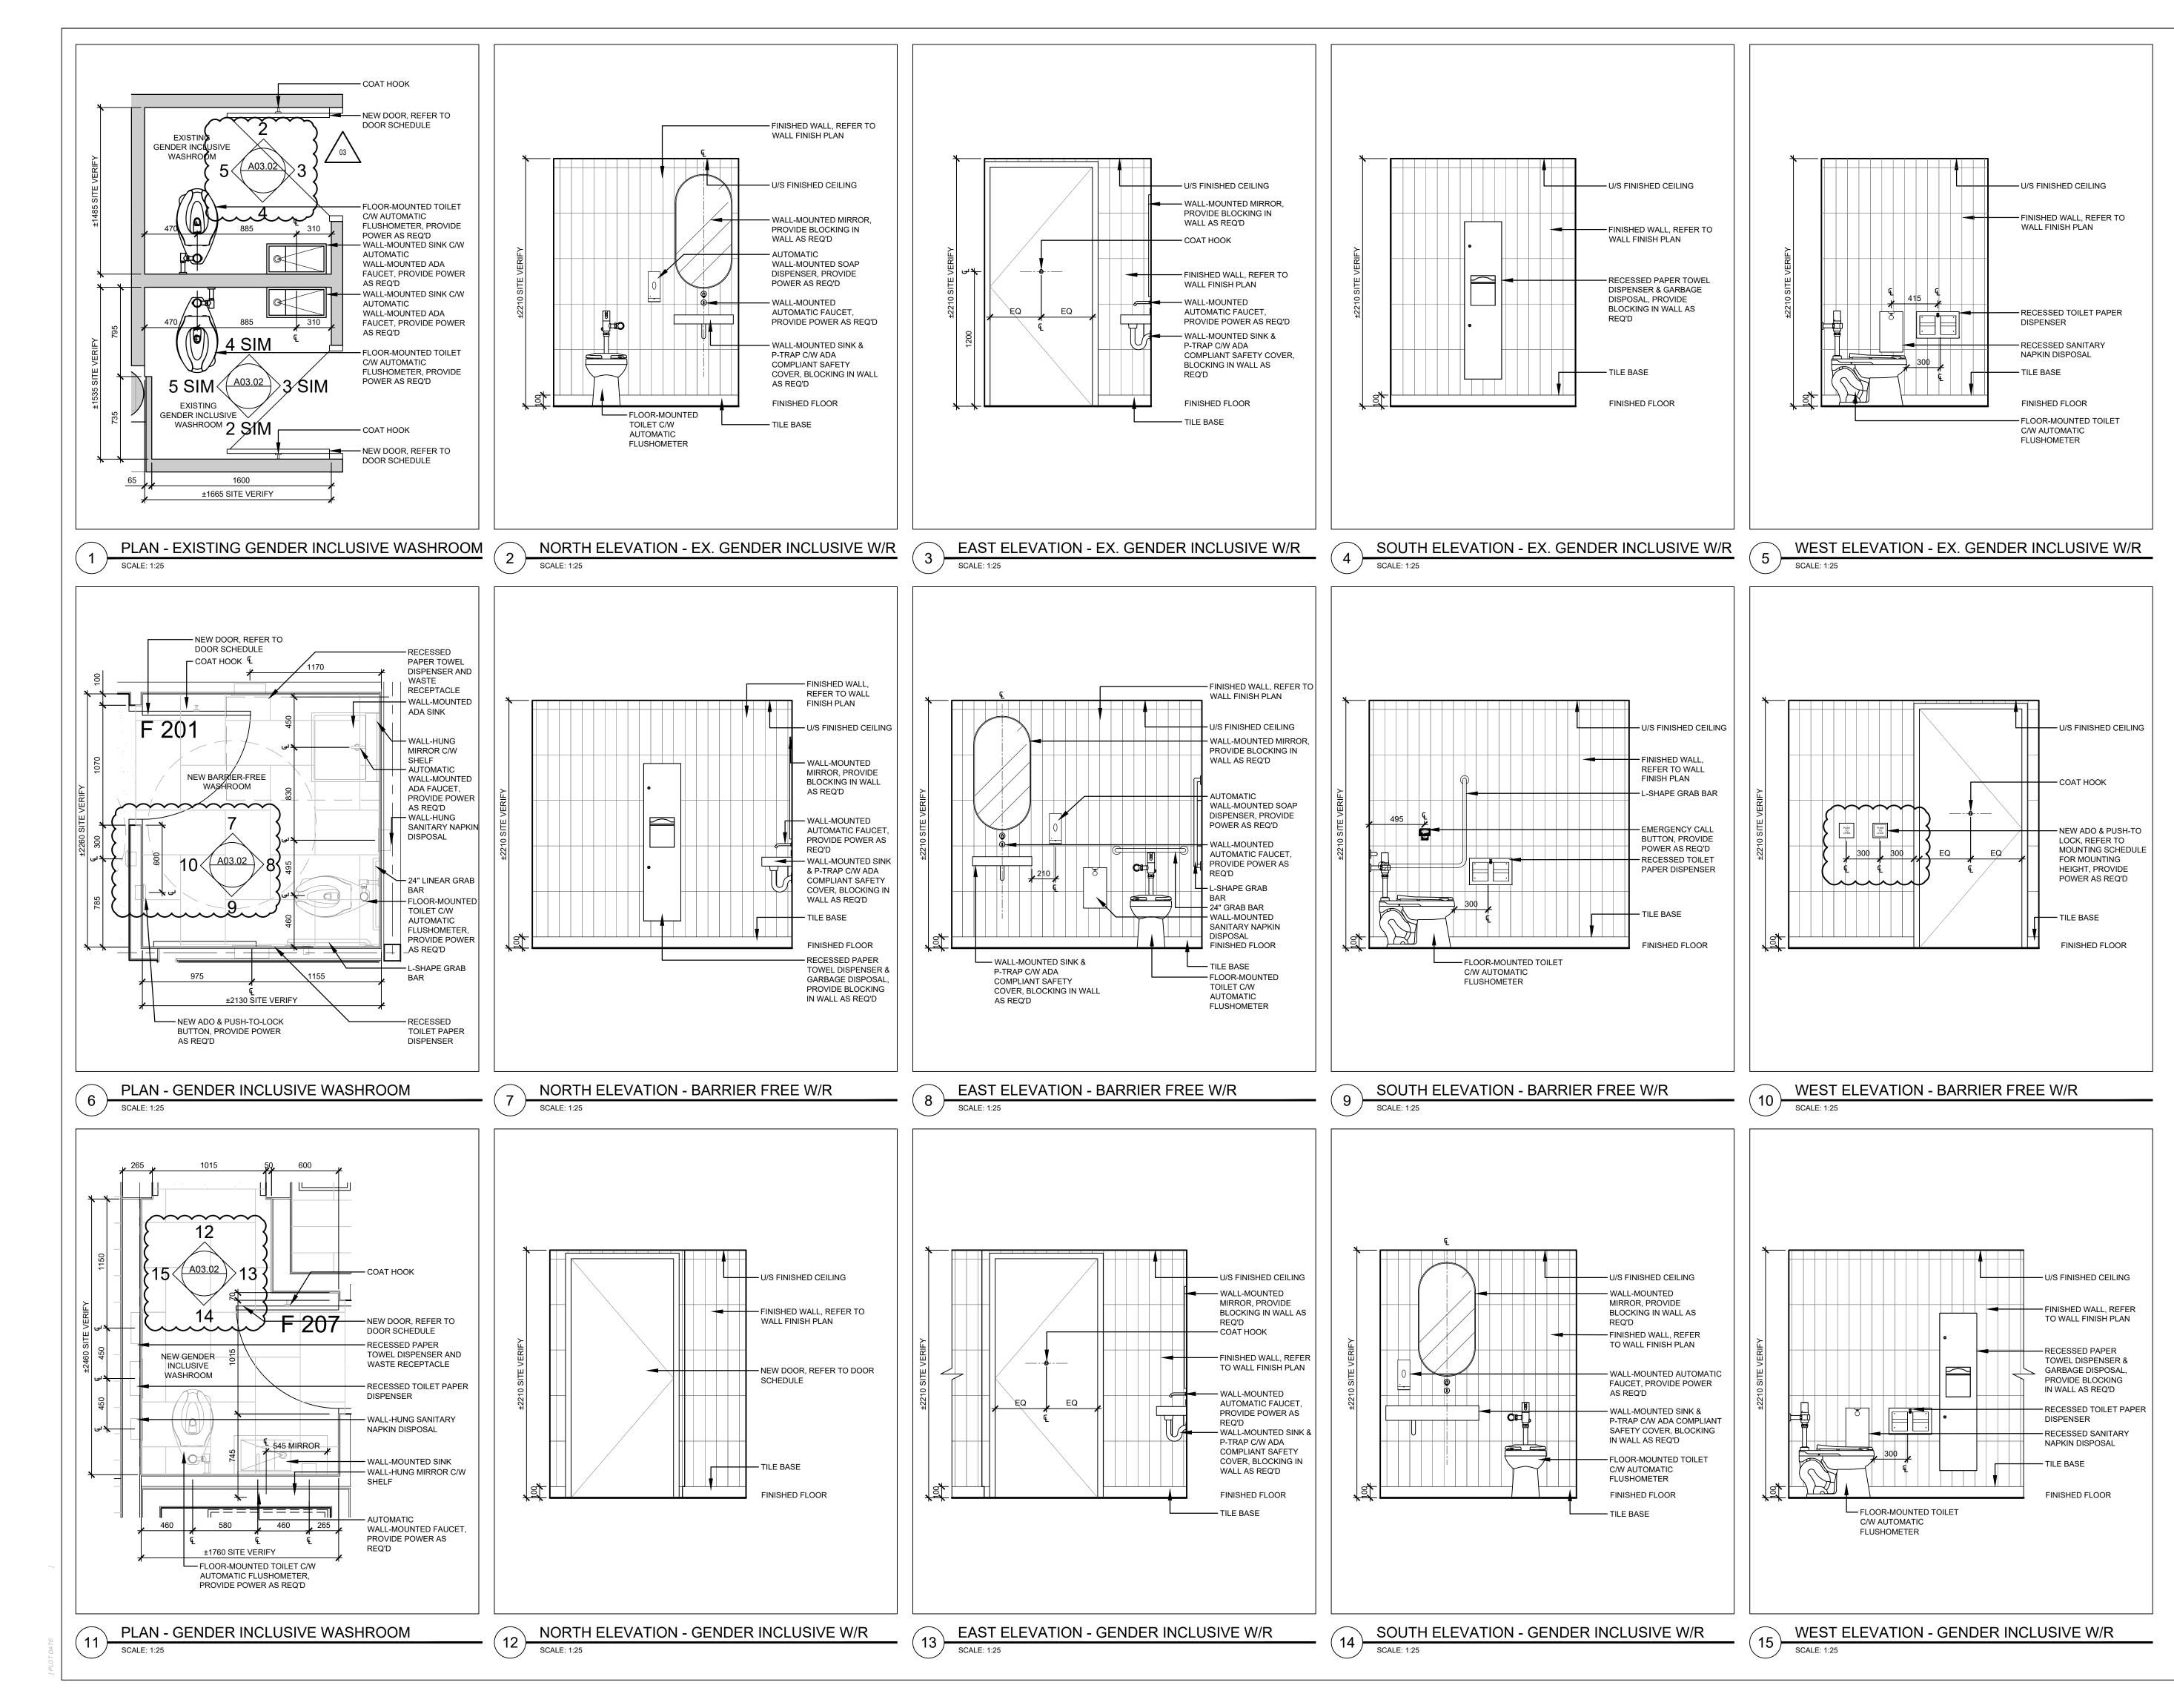

DRAWN BY: AW PROJECT NO.: 12228 SCALE: DRAWING NO.: REVISION:



CT: HPL-01 CT (HATCHED): HPL-02 CB (HATCHED): TFL-02

GB (HATCHED): TFL-02

TK (HATCHED): HPL-02

EP (HATCHED): TFL-02

CS (HATCHED): TFL-02 CP: ACC-01

CF (HATCHED): TFL-02 CF: TFL-01

CB: TFL-01

U/S FINISHED CEILING - 1" THICK BULLET-PROOF SECURITY

GLASS C/W WELDED METAL FRAME,

PROVIDE PERPENDICULAR FINS FOR

SUPPORT AS REQ'D

305mm WIDE TRANSACTION

PASS-THROUGH TROUGH,

CENTERED


— COUNTER TOP

- TRANSACTION TOP

GRAIN DIRECTION

- RECESSED PANEL

FINISHED FLOOR

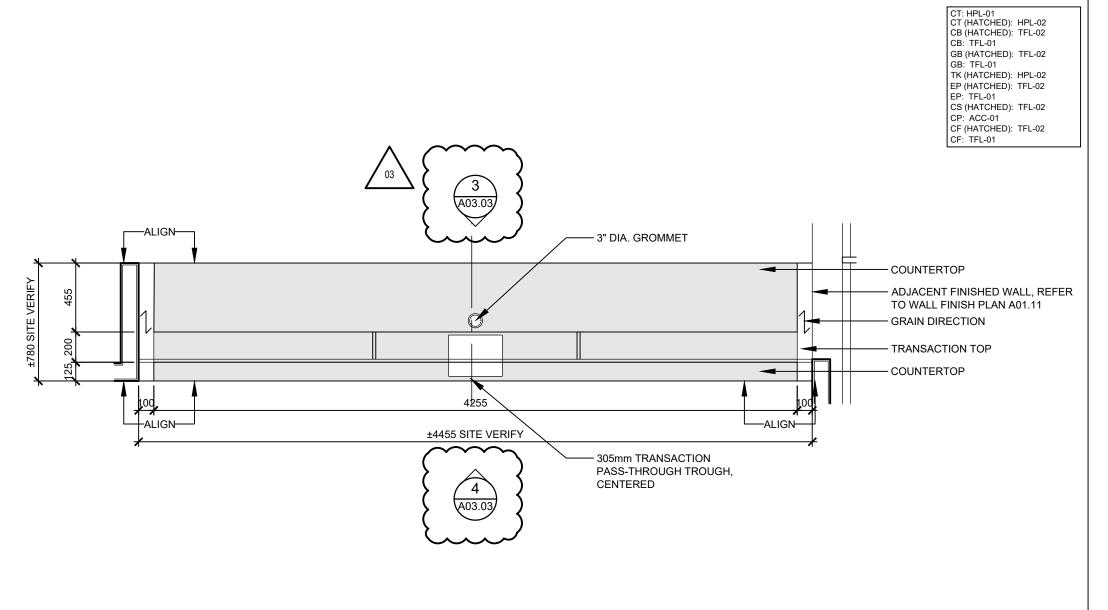



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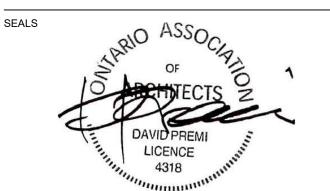
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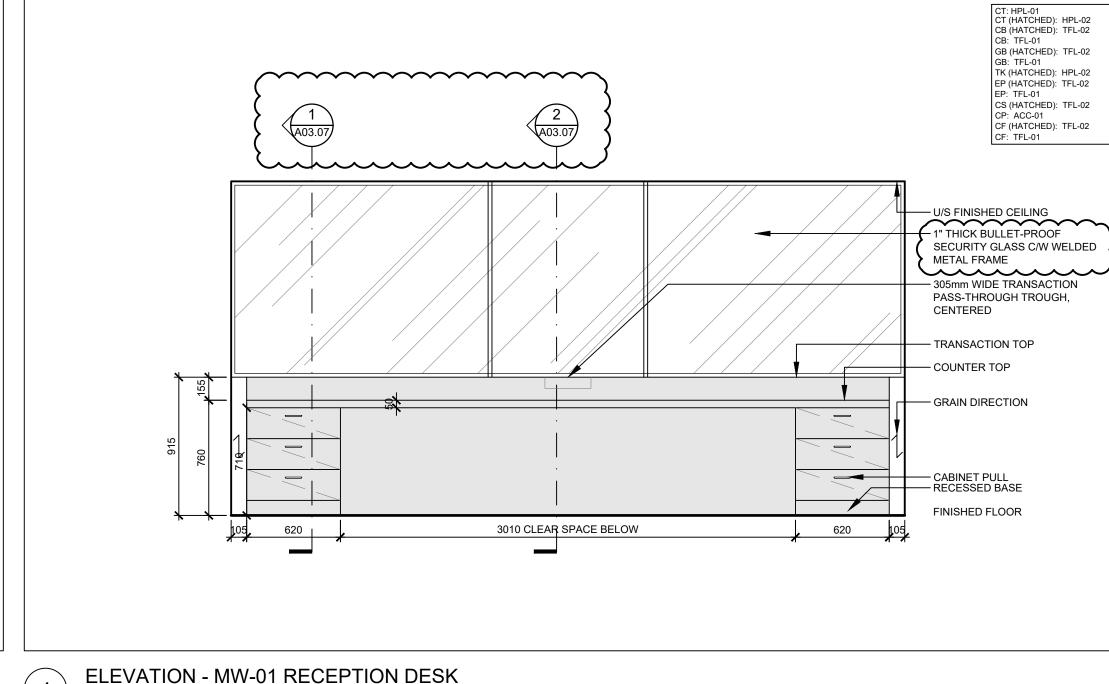
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PLAN - MW-01 RECEPTION DESK SCALE: N/A




ELEVATION - MW-01 RECEPTION DESK SCALE: N/A

PLAN - MW-02 RECEPTION STORAGE

SCALE: N/A

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CT: HPL-01 CT (HATCHED): HPL-02 CB (HATCHED): TFL-02 CB: TFL-01 GB (HATCHED): TFL-02 GB: TFL-01 TK (HATCHED): HPL-02 EP (HATCHED): TFL-02 EP: TFL-01 CS (HATCHED): TFL-02 CP: ACC-01 CF (HATCHED): TFL-02 CF: TFL-01 - WALL SCONCE - U/S FINISHED CEILING — ADJACENT FINISHED WALL, REFER TO WALL FINISH PLAN - FLOATING SHELF - GRAIN DIRECTION - ADJACENT FINISHED WALL, REFER TO WALL FINISH PLAN COUNTER TOP LINE OF FINISHED ADJACENT CABINET PULL - CABINET DOORS ON HEAVY-DUTY SOFT-CLOSE HINGES - RECESSED BASE FINISHED FLOOR 8 EQ CABINET DOORS

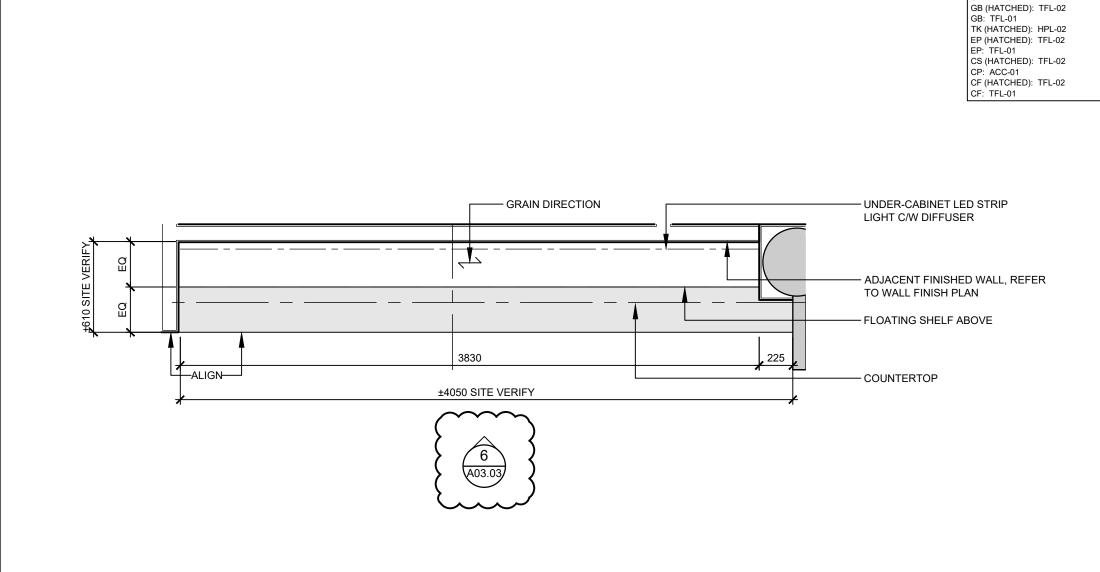
ELEVATION - MW-02 RECEPTION STORAGE


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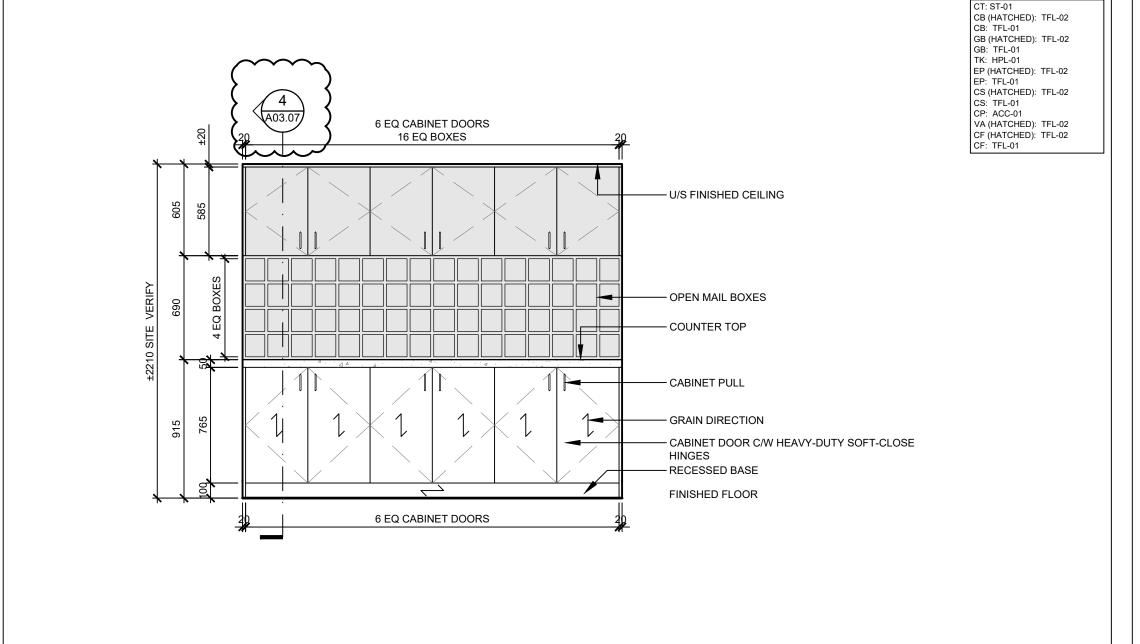
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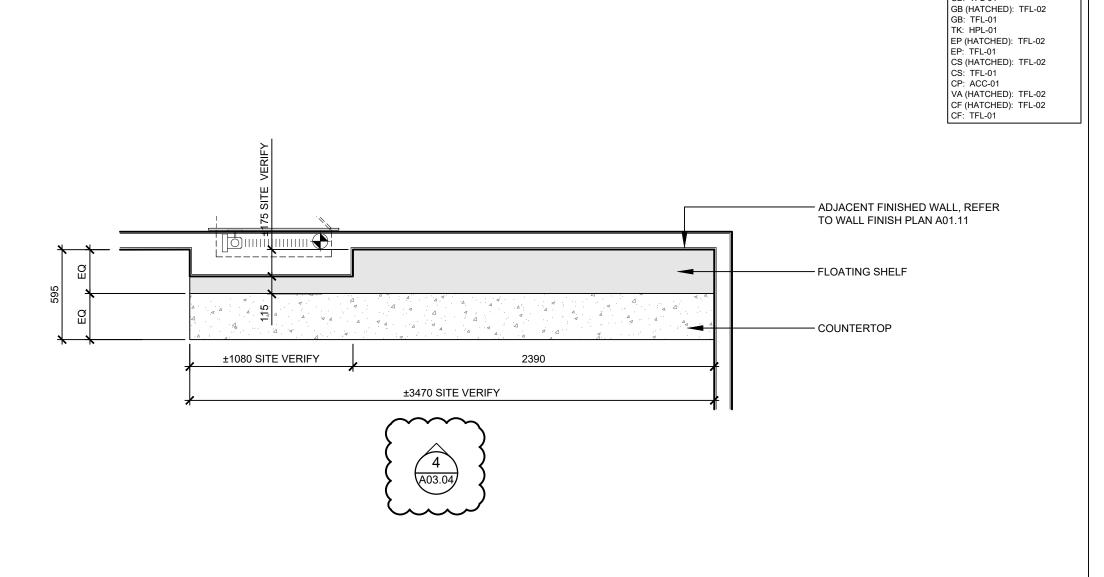
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DRAWING TITLE:







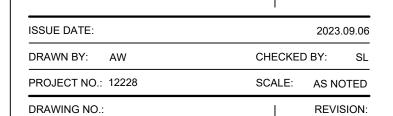


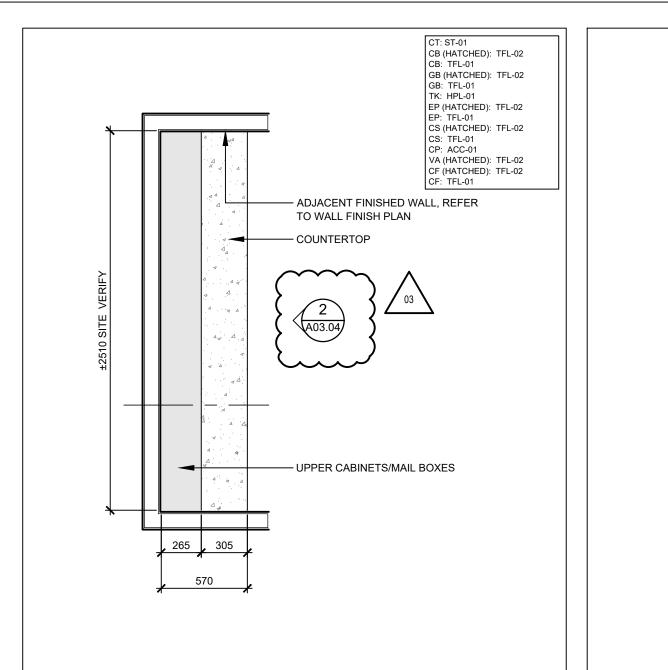PLAN - MW-03 PRINT ROOM STORAGE

2 ELELVATION - MW-03 PRINT ROOM STORAGE
SCALE: 1:25

3 PLAN - MW-04 PRINT ROOM STORAGE


CB (HATCHED): TFL-02 CB: TFL-01 GB (HATCHED): TFL-02 TK: HPL-01 EP (HATCHED): TFL-02 EP: TFL-01 CS (HATCHED): TFL-02 CS: TFL-01 A03.07 CP: ACC-01 VA (HATCHED): TFL-02 CF (HATCHED): TFL-02 CF: TFL-01 - U/S FINISHED CEILING ADJACENT WALL, REFER TO WALL FINISH PLAN — COUNTER TOP — CABINET PULL GRAIN DIRECTION - CABINET DOOR C/W HEAVY-DUTY SOFT-CLOSE HINGES — RECESSED BASE FINISHED FLOOR

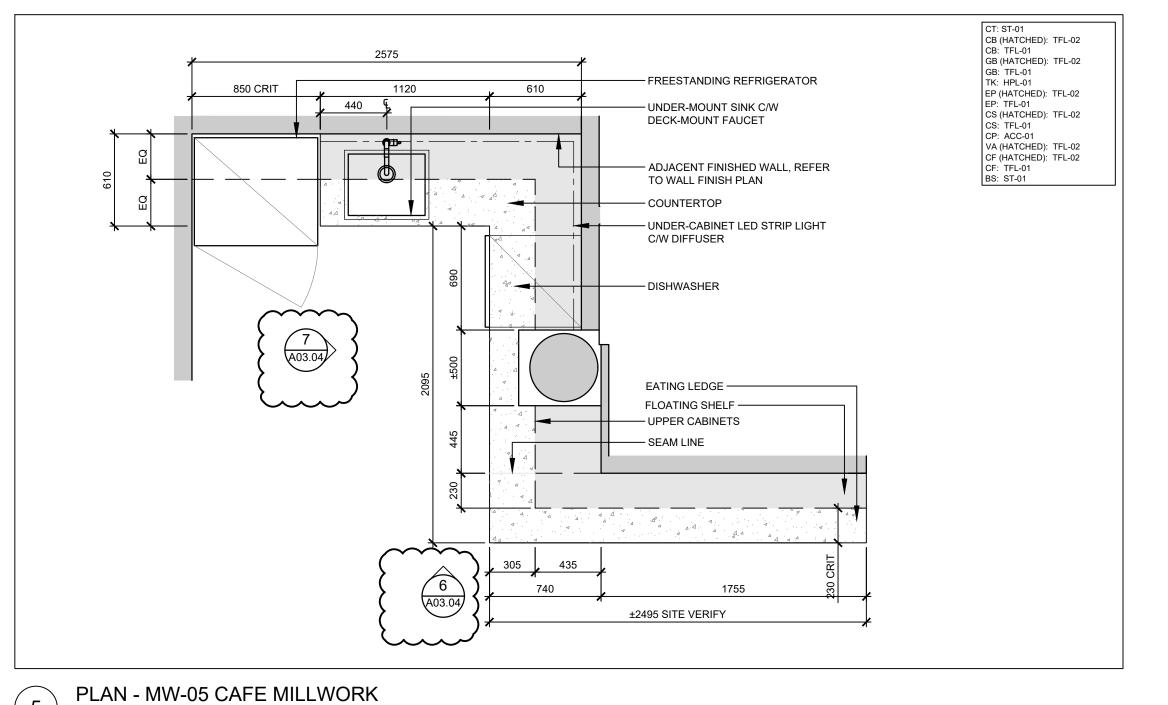

4 ELEVATION - MW-04 PRINT ROOM STORAGE

SCALE: 1:25

CB (HATCHED): TFL-02 CB: TFL-01 GB (HATCHED): TFL-02 TK: HPL-01 EP (HATCHED): TFL-02 CS (HATCHED): TFL-02 CS: TFL-01 SOFT-CLOSE HINGES VA (HATCHED): TFL-02 CF (HATCHED): TFL-02 CF: TFL-01 - WALL SCONCE 2 EQ CABINET DOORS 4 EQ CABINET DOORS - U/S FINISHED CEILING —— ADJACENT WALL, REFER TO WALL FINISH PLAN — UPPER CABINET SIDE GABLE — FLOATING SHELF — BACKSPLASH — COUNTER TOP 210 TYP —— ADJACENT WALL, REFER TO WALL FINISH PLAN — GRAIN DIRECTION — RECESSED BASE FINISHED FLOOR 2 EQ CABINET DOORS L CABINET DRAWER C/W HEAVY-DUTY SOFT-CLOSE GLIDES CABINET DOOR C/W HEAVY-DUTY REFRIGERATOR PULL SOFT-CLOSE HINGES - UNDER-MOUNT SINK

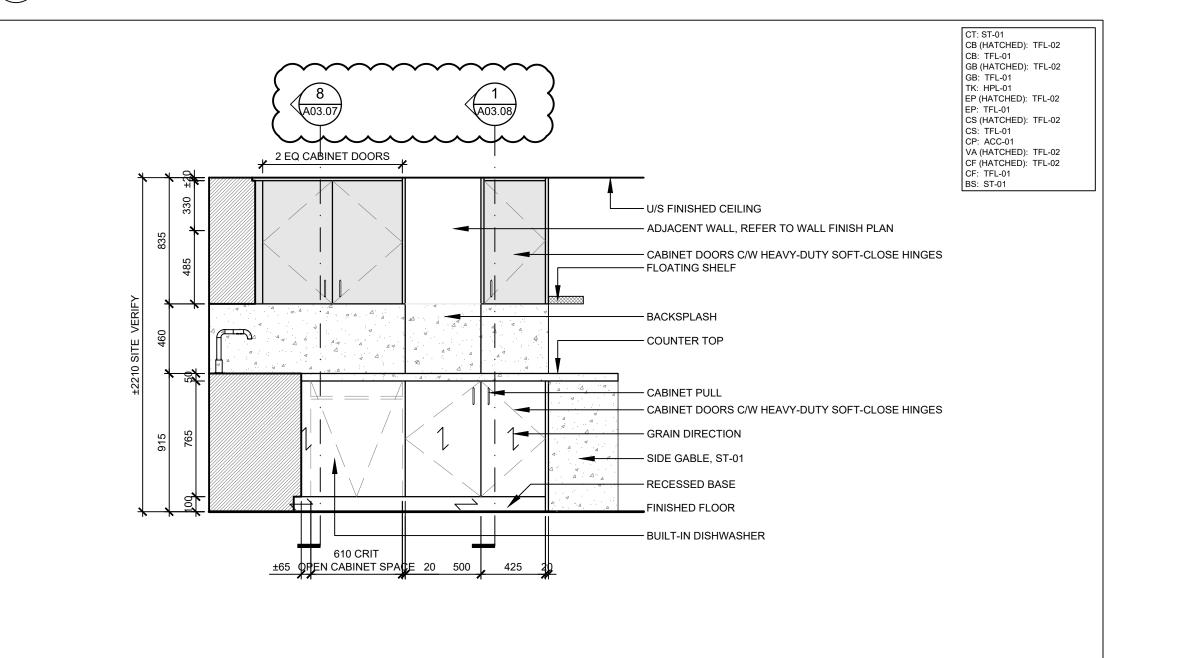

ELEVAITON - MW-05 CAFE MILLWORK

7 ELEVA
SCALE: 1:25

SCALE: 1:25

ELEVATION - MW-05 CAFE MILLWORK



VPCH OFFICE EXPANSION

155 QUEEN ST NORTH HAMILTON, ONTARIO



urban design

CB (HATCHED): TFL-02 CB: TFL-01

> 25 Main Street West Hamilton, Ontario L8P 1H1 Canada

ors T: 905-522-0220

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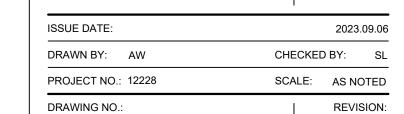
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03	ISSUED FOR ADDENDUM #3	2023.10.06
02	ISSUED FOR TENDER	2023.09.06
01	ISSUED FOR PERMIT	2023.05.16
NO	ISSUES/DEVISIONS	DATE


MILLWORK DETAILS

DRAWING TITLE:




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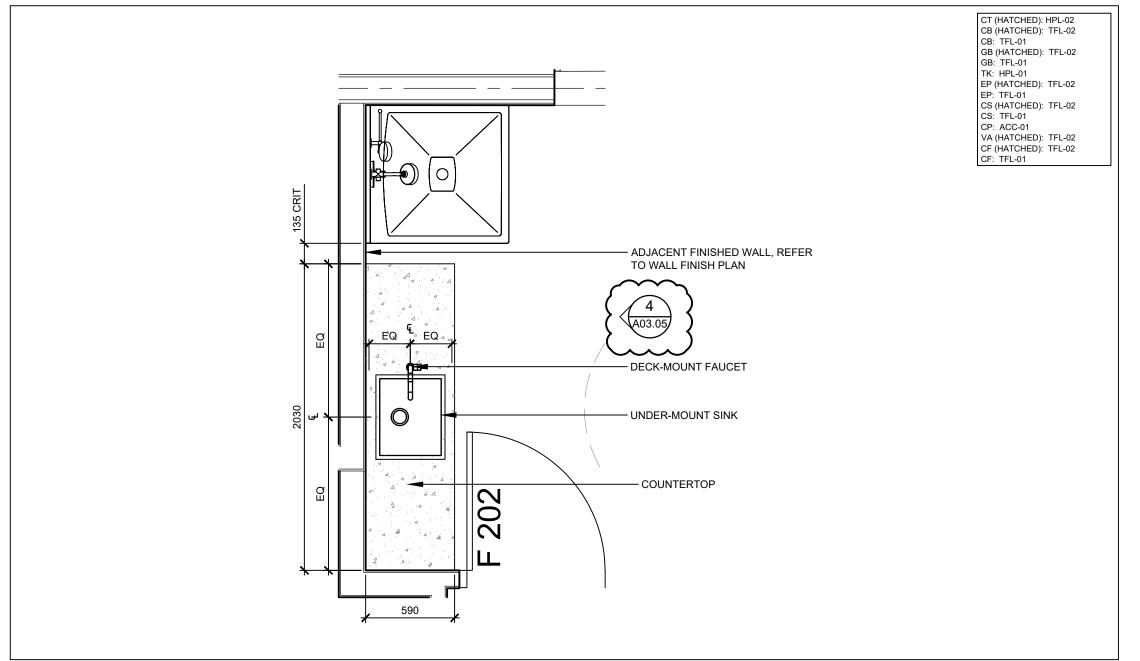
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PLAN - MW-06 COFFEE BAR MILLWORK

SCALE: 1:25

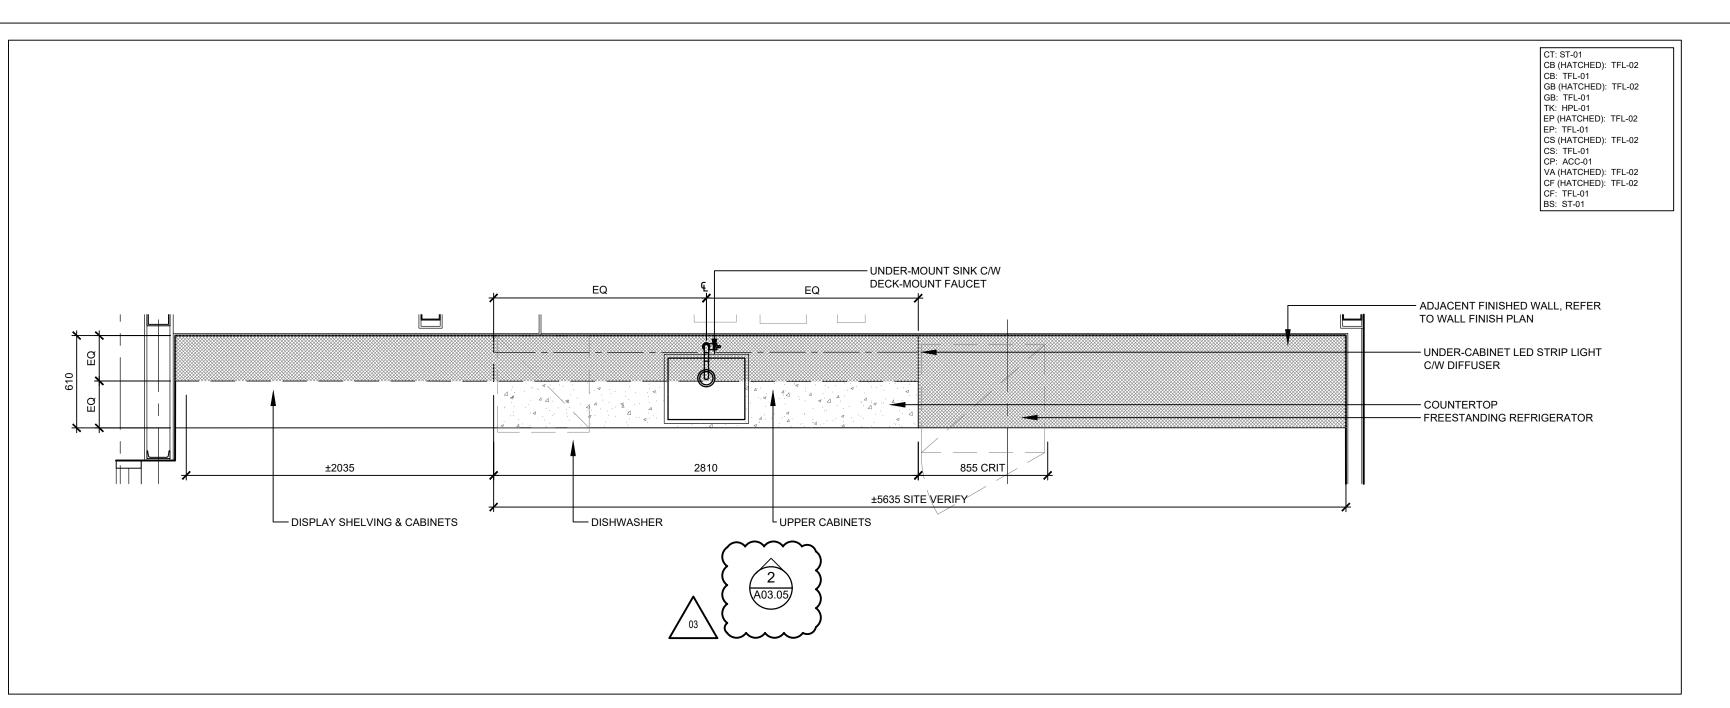




ELEVATION - MW-06 COFFEE BAR MILLWORK SCALE: 1:25

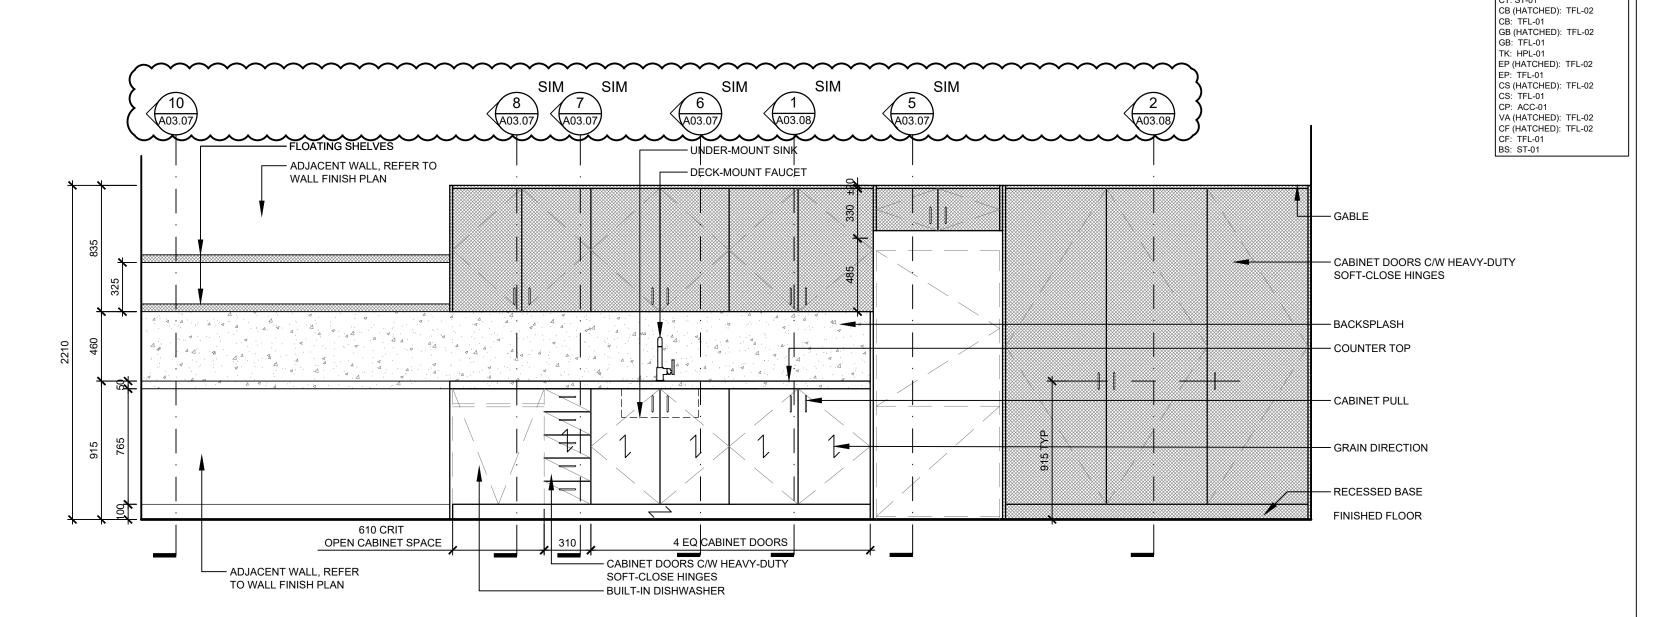ELEVATION - MW-07 MULTI-PURPOSE RM MILLWORK

SCALE: 1:25

CT: ST-01
CB (HATCHED): TFL-02
CB: TFL-01
GB (HATCHED): TFL-02
GB: TFL-01
TK: HPL-01
EP (HATCHED): TFL-02
EP: TFL-01
CS (HATCHED): TFL-02
CS: TFL-01
CP: ACC-01
VA (HATCHED): TFL-02
CF (HATCHED): TFL-02
CF: TFL-01 3 A03.07 5 A03.08 — U/S FINISHED CEILING — WALL SCONCE — ADJACENT FINISHED WALL, REFER TO WALL FINISH PLAN — DECK-MOUNT FAUCET — COUNTER TOP - CABINET PULL — CABINET DOORS ON HEAVY-DUTY SOFT-CLOSE HINGES — RECESSED BASE FINISHED FLOOR 4 EQ CABINET DOORS UNDER-MOUNT SINK

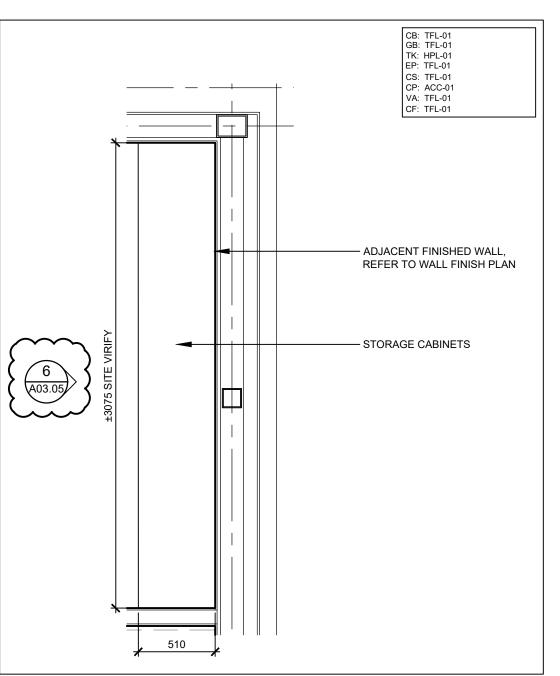

CB: TFL-01 GB: TFL-01 TK: HPL-01 EP: TFL-01 CS: TFL-01 CP: ACC-01 VA: TFL-01 CF: TFL-01 3 A03.08 — ADJACENT FINISHED WALL, REFER TO WALL FINISH PLAN - CABINET DOORS ON HEAVY-DUTY SOFT-CLOSE HINGES - GRAIN DIRECTION — CABINET PULL — FIXED SHELVES — RECESSED BASE FINISHED FLOOR EQ

PLAN - MW-07 MULI-PURPOSE RM MILLWORK
SCALE: 1:25

PLAN - MW-08 MULTI-PURPOSE RM STORAGE

ELEVATION - MW-08 MULTI-PURPOSE RM STORAGE



VPCH OFFICE EXPANSION

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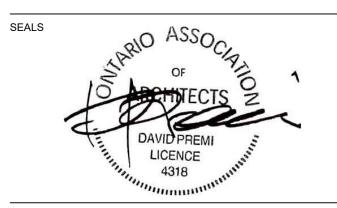
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T: 905-522-0220 interiors urban design

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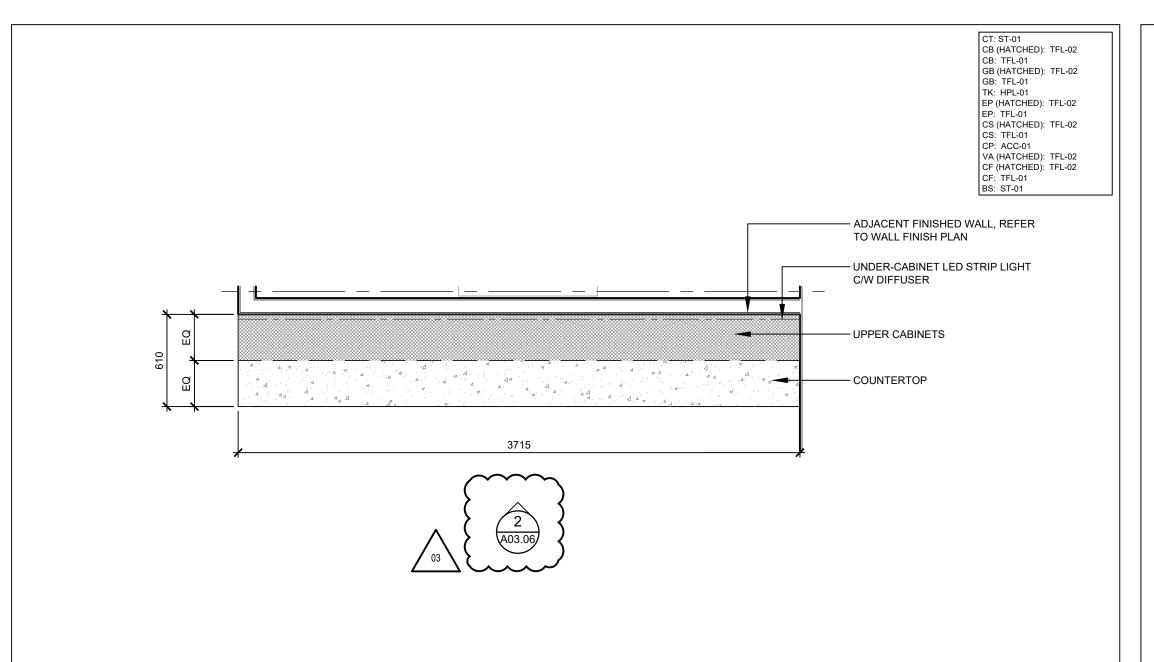



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02	ISSUED FOR TENDER	2023.09.06
01	ISSUED FOR PERMIT	2023.05.16
NO	ISSUES/REVISIONS	DATE

MILLWORK DETAILS

DRAWING TITLE:

ISSUE DATE:	2023.09.06
DRAWN BY: AW	CHECKED BY: SL
PROJECT NO.: 12228	SCALE: AS NOTED
DRAWING NO.:	REVISION:



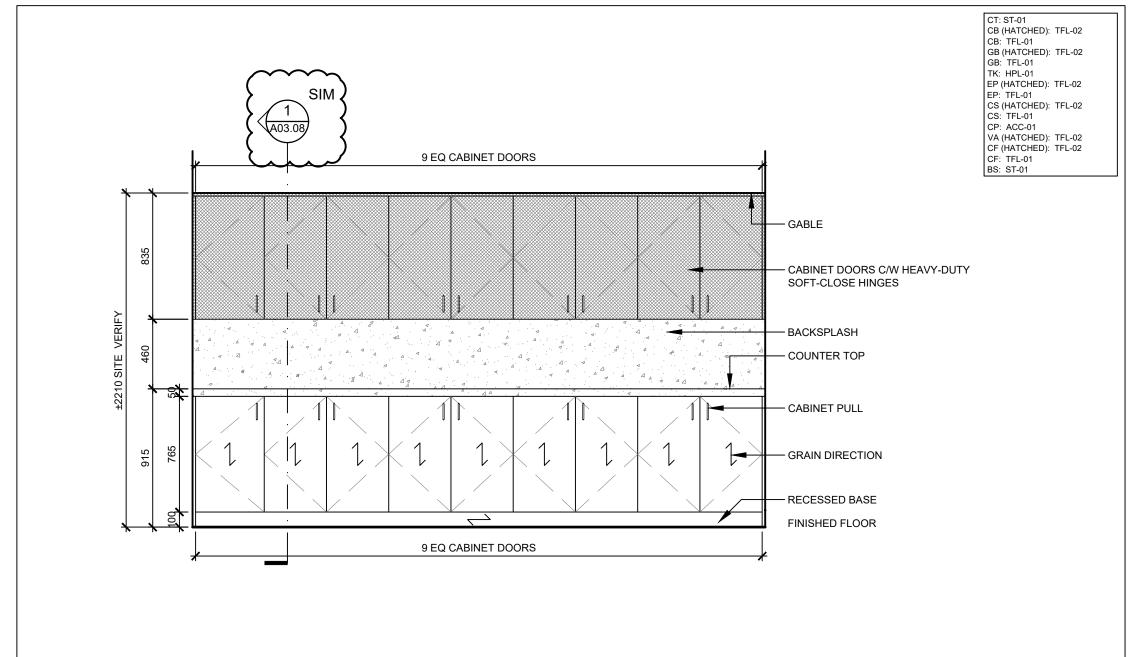

1 PLAN - MW-09 PRINTER AREA MILLWORK
SCALE: 1:25

2 ELEVATION - MW-09 PRINTER AREA MILLWORK

SCALE: 1:25



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155 QUEEN ST NORTH HAMILTON, ONTARIO



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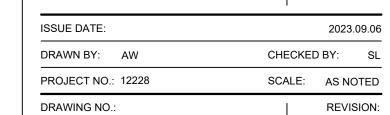
DISCREPANCY TO ARCHITECTS BEFORE PROCEEDING WITH WORK.




Key Plan:

NO.	ISSUES/REVISIONS	DATE
01	ISSUED FOR PERMIT	2023.05.16
02	ISSUED FOR TENDER	2023.09.06
03	ISSUED FOR ADDENDUM #3	2023.10.06





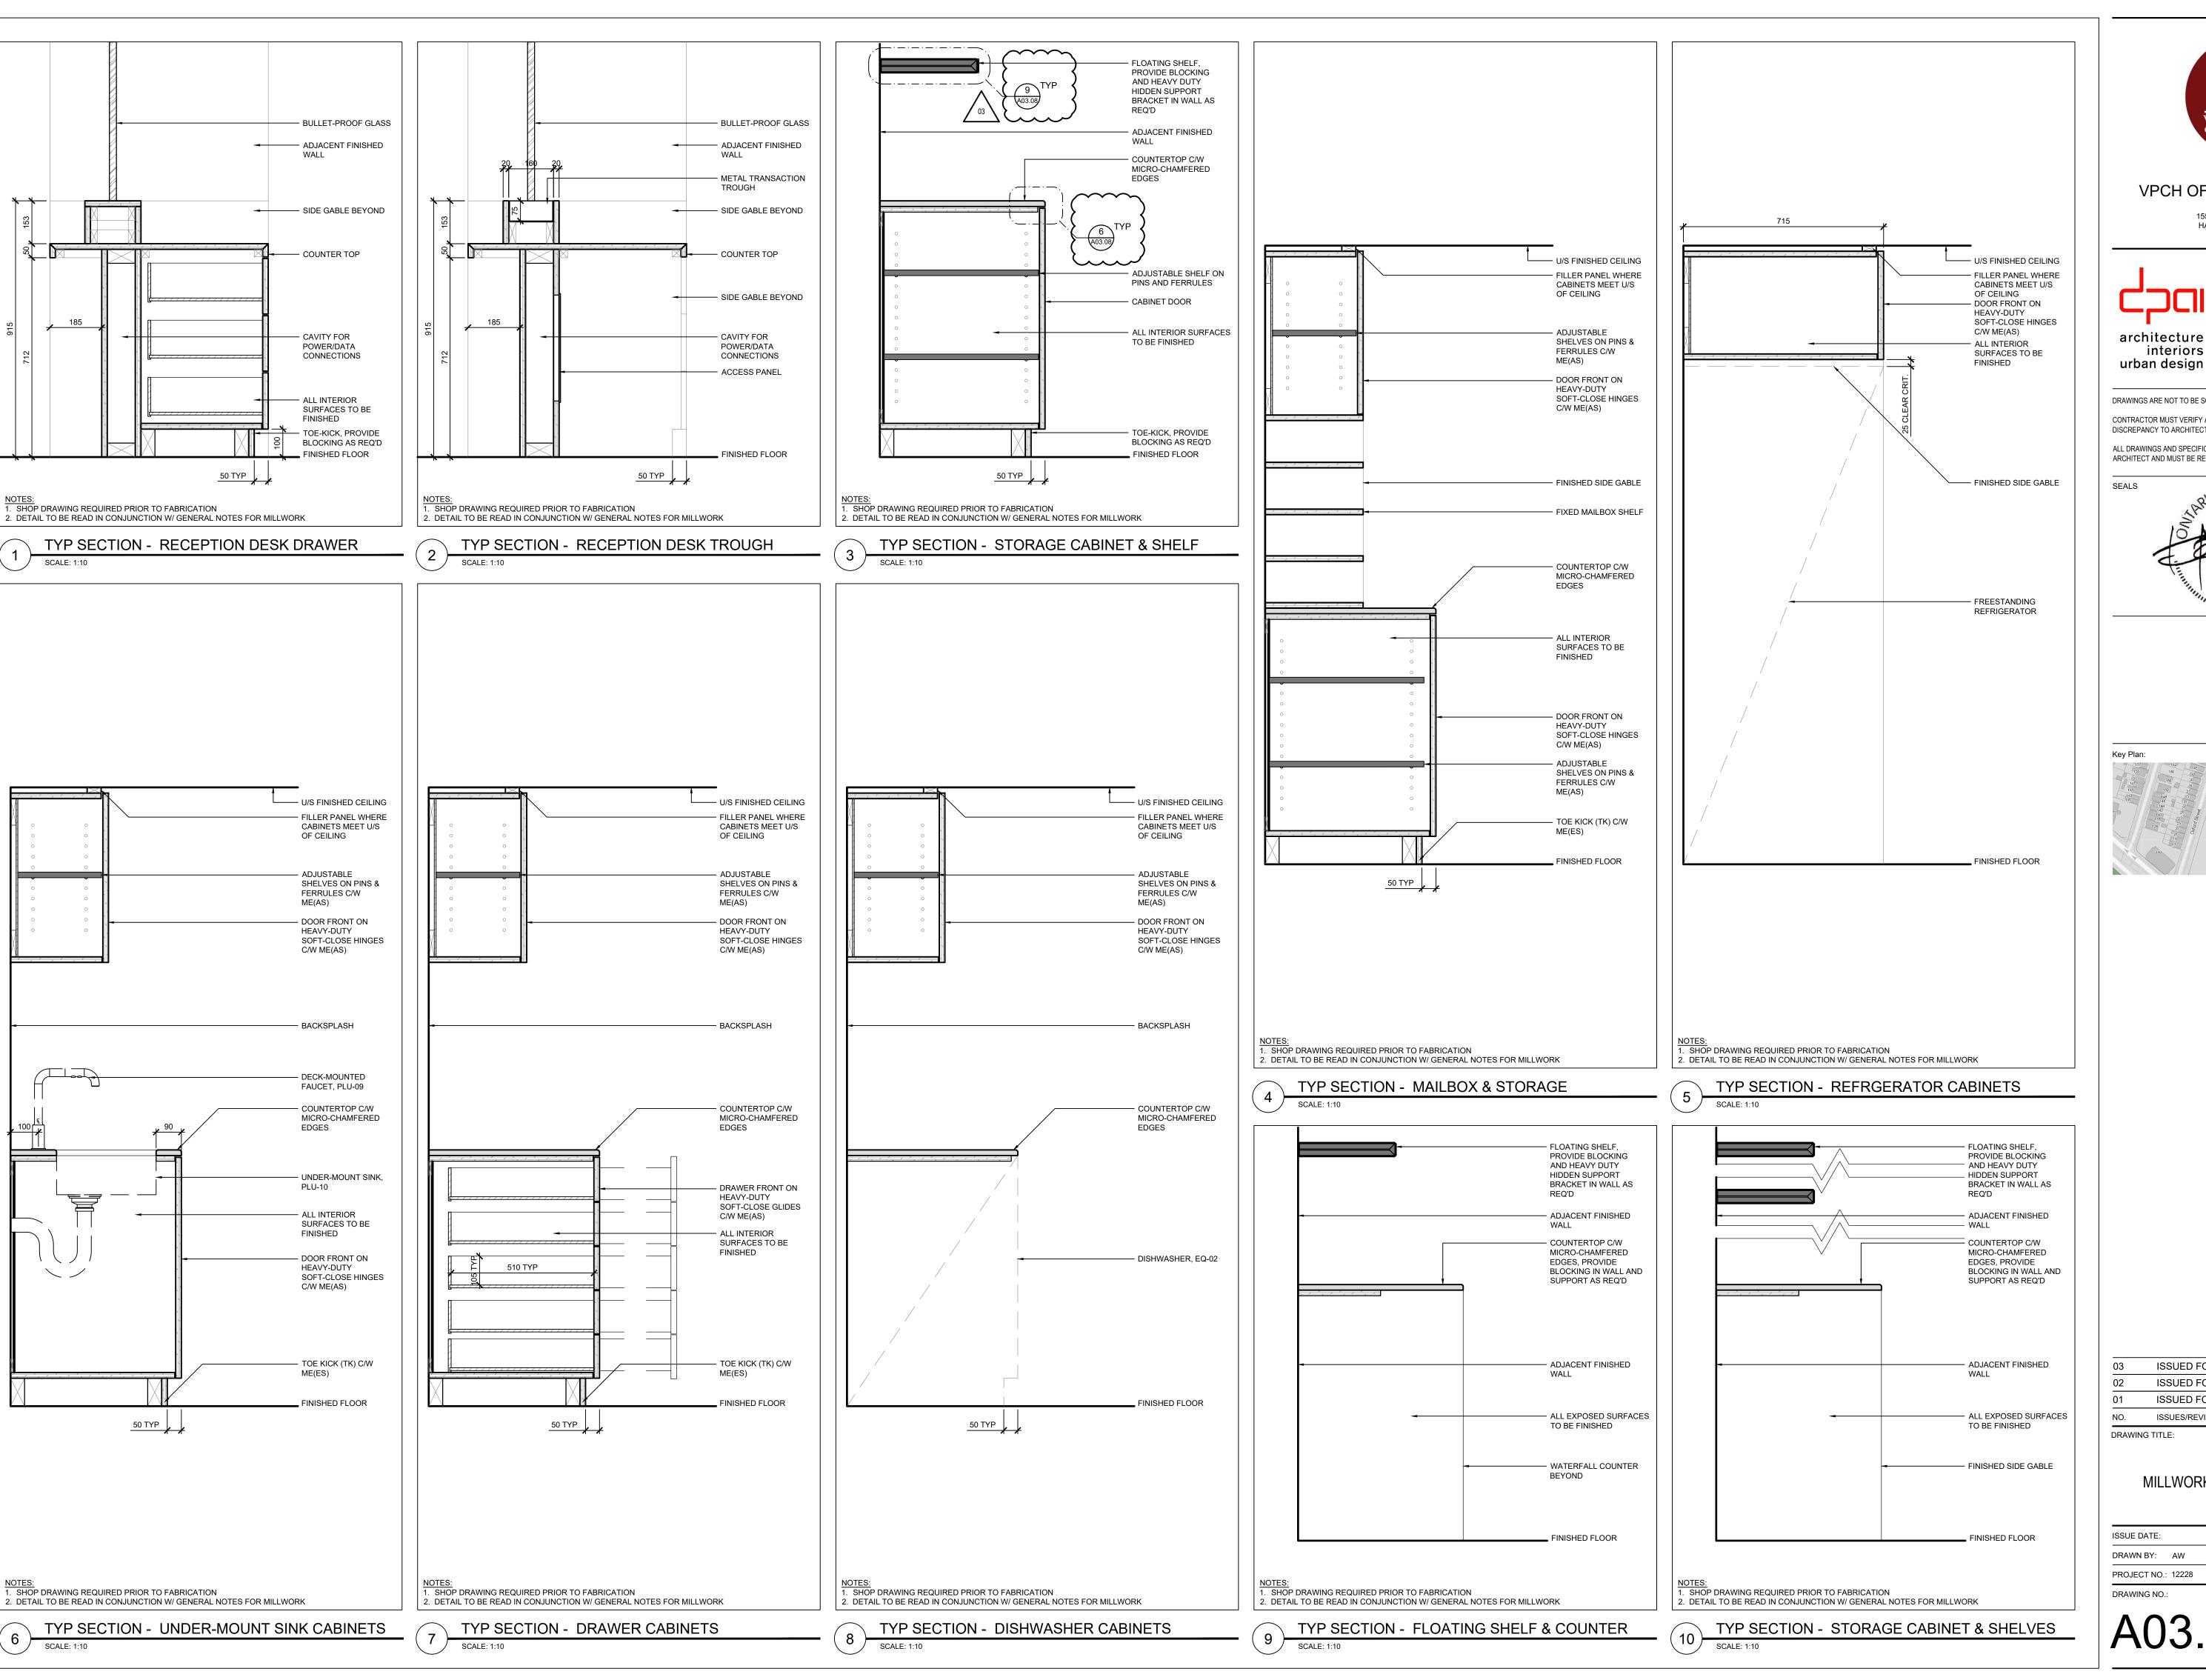

155 QUEEN ST NORTH HAMILTON, ONTARIO




25 Main Street West Hamilton, Ontario L8P 1H1 Canada

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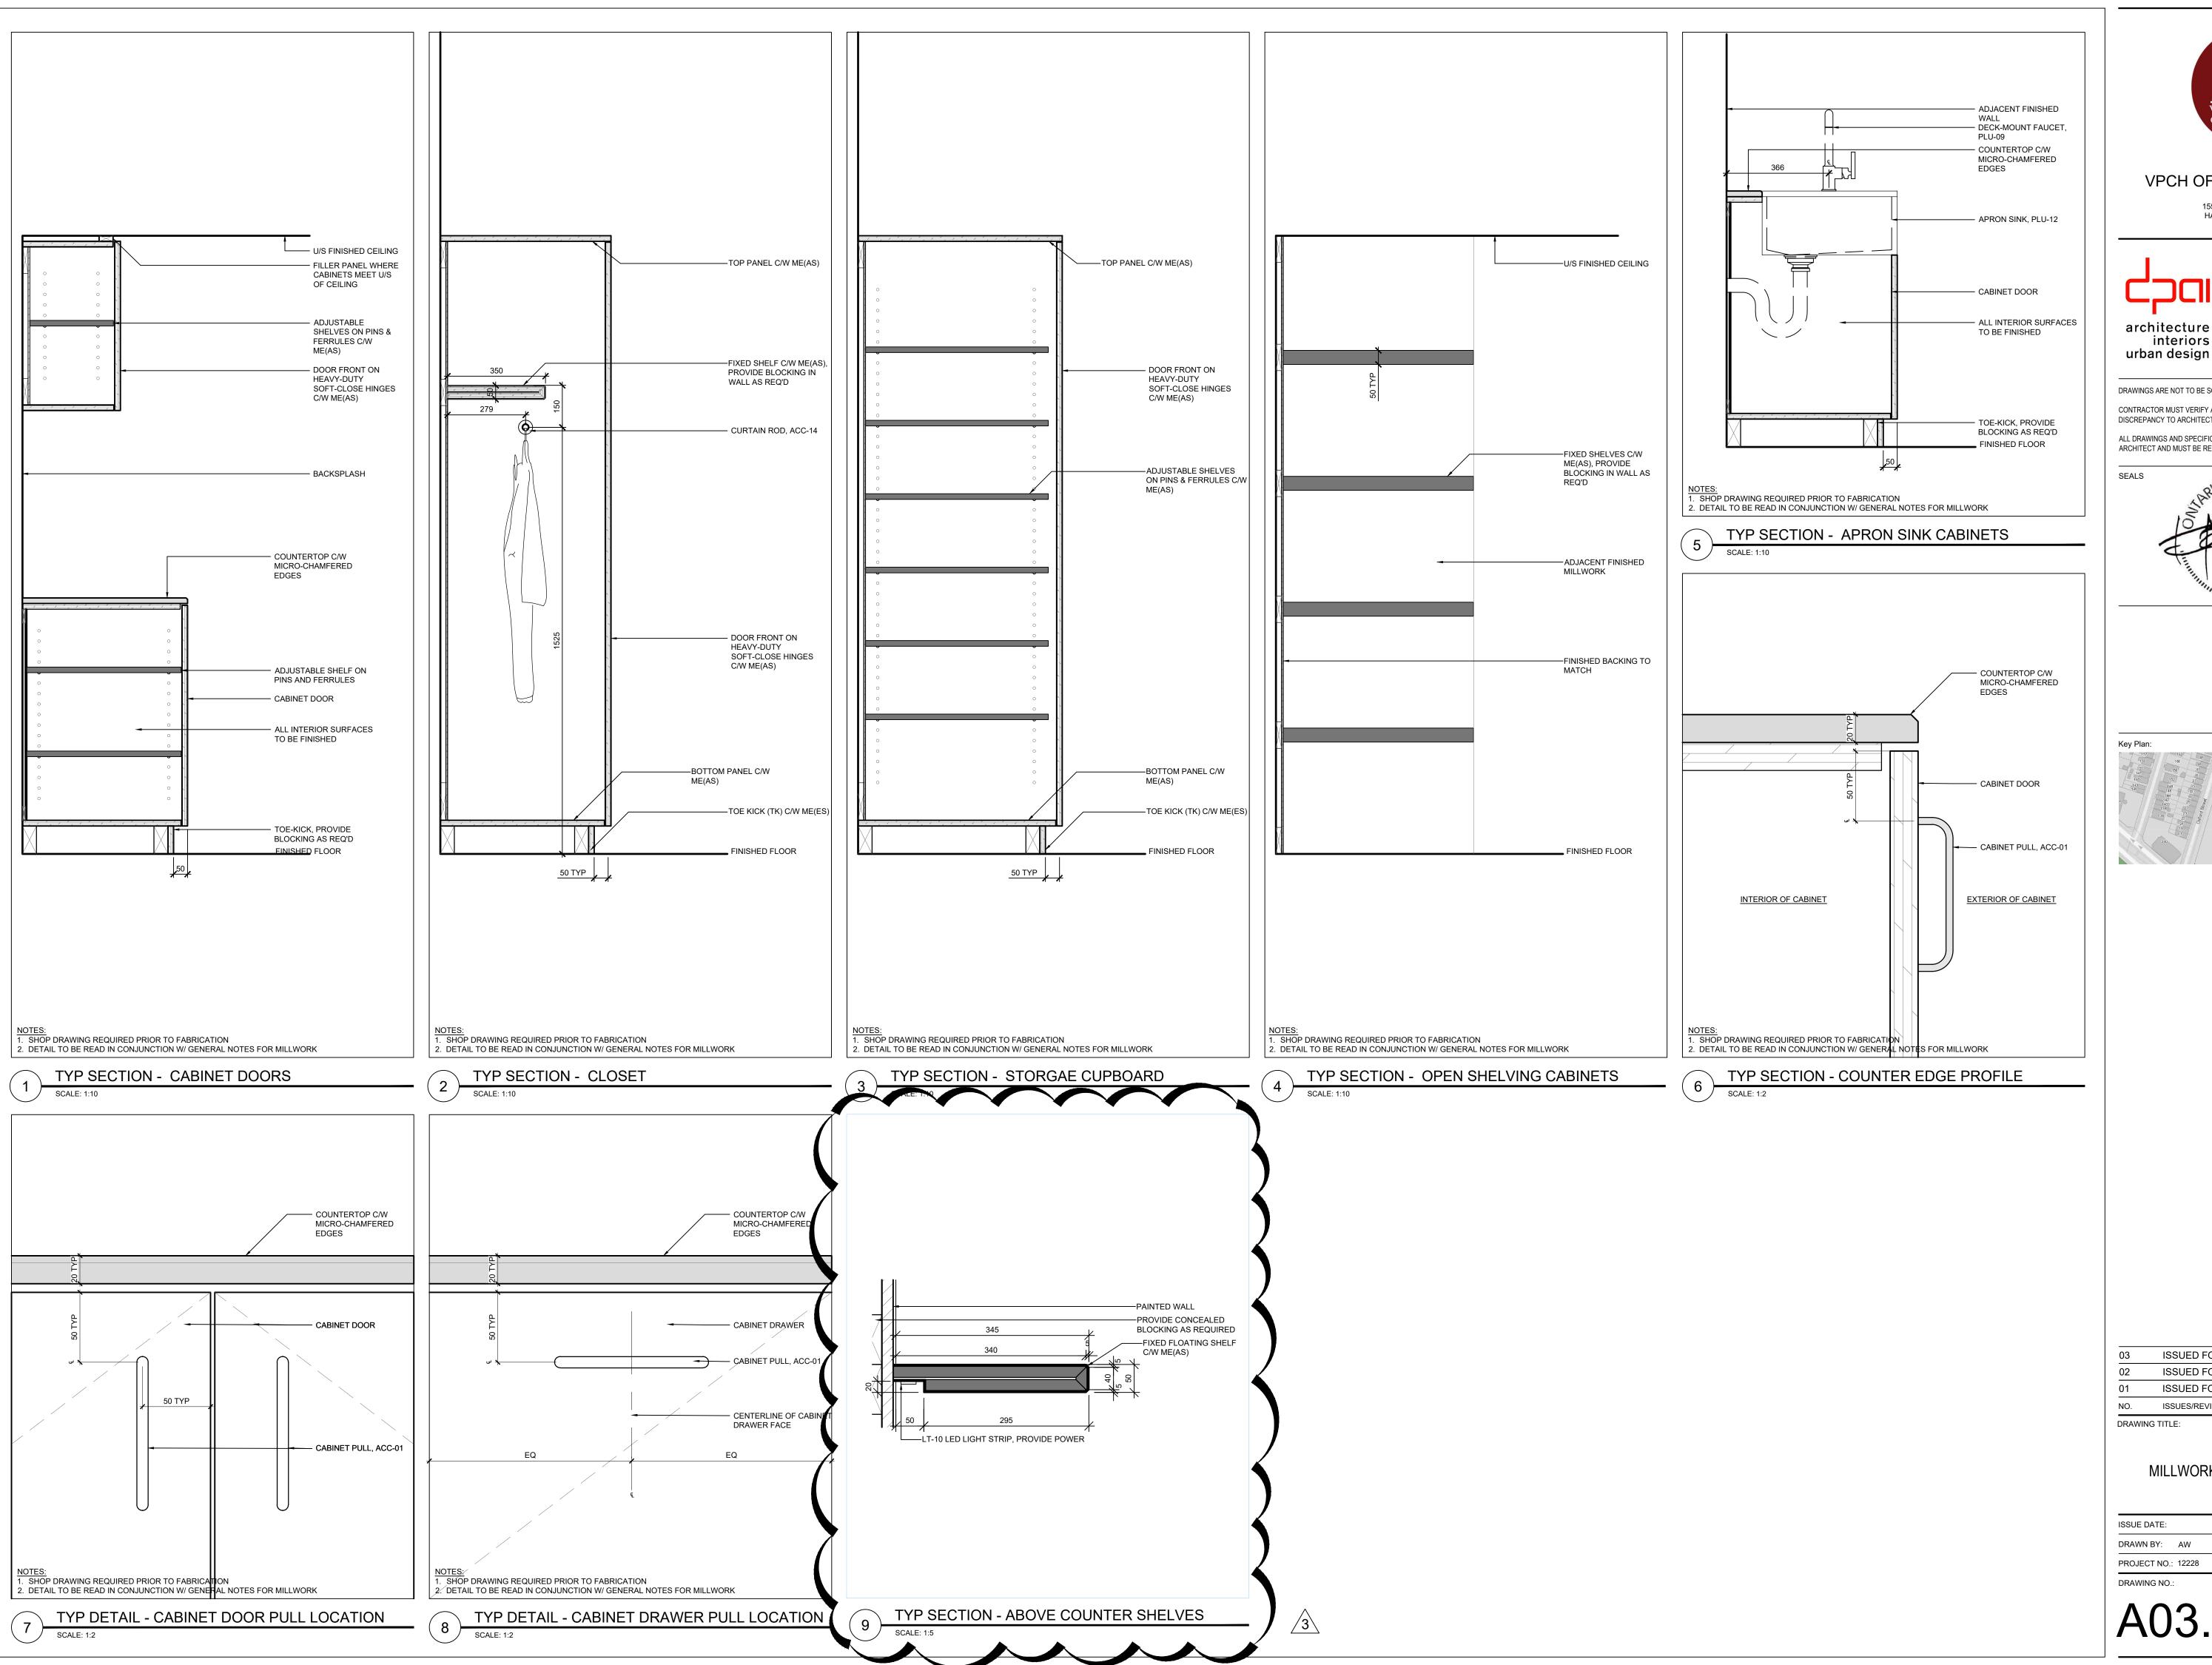


ISSUED FOR ADDENDUM #3 2023.10.06 ISSUED FOR TENDER 2023.09.06 ISSUED FOR PERMIT 2023.05.16

MILLWORK DETAILS

ISSUES/REVISIONS

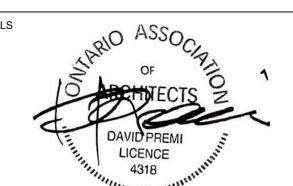ISSUE DATE:		2023.0	9.06
DRAWN BY: AW	CHECKED	BY:	SL
PROJECT NO.: 12228	SCALE:	AS NO	TED
DRAWING NO.:		REVIS	ION:





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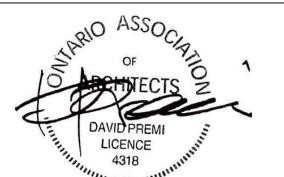
25 Main Street West Hamilton, Ontario L8P 1H1 Canada

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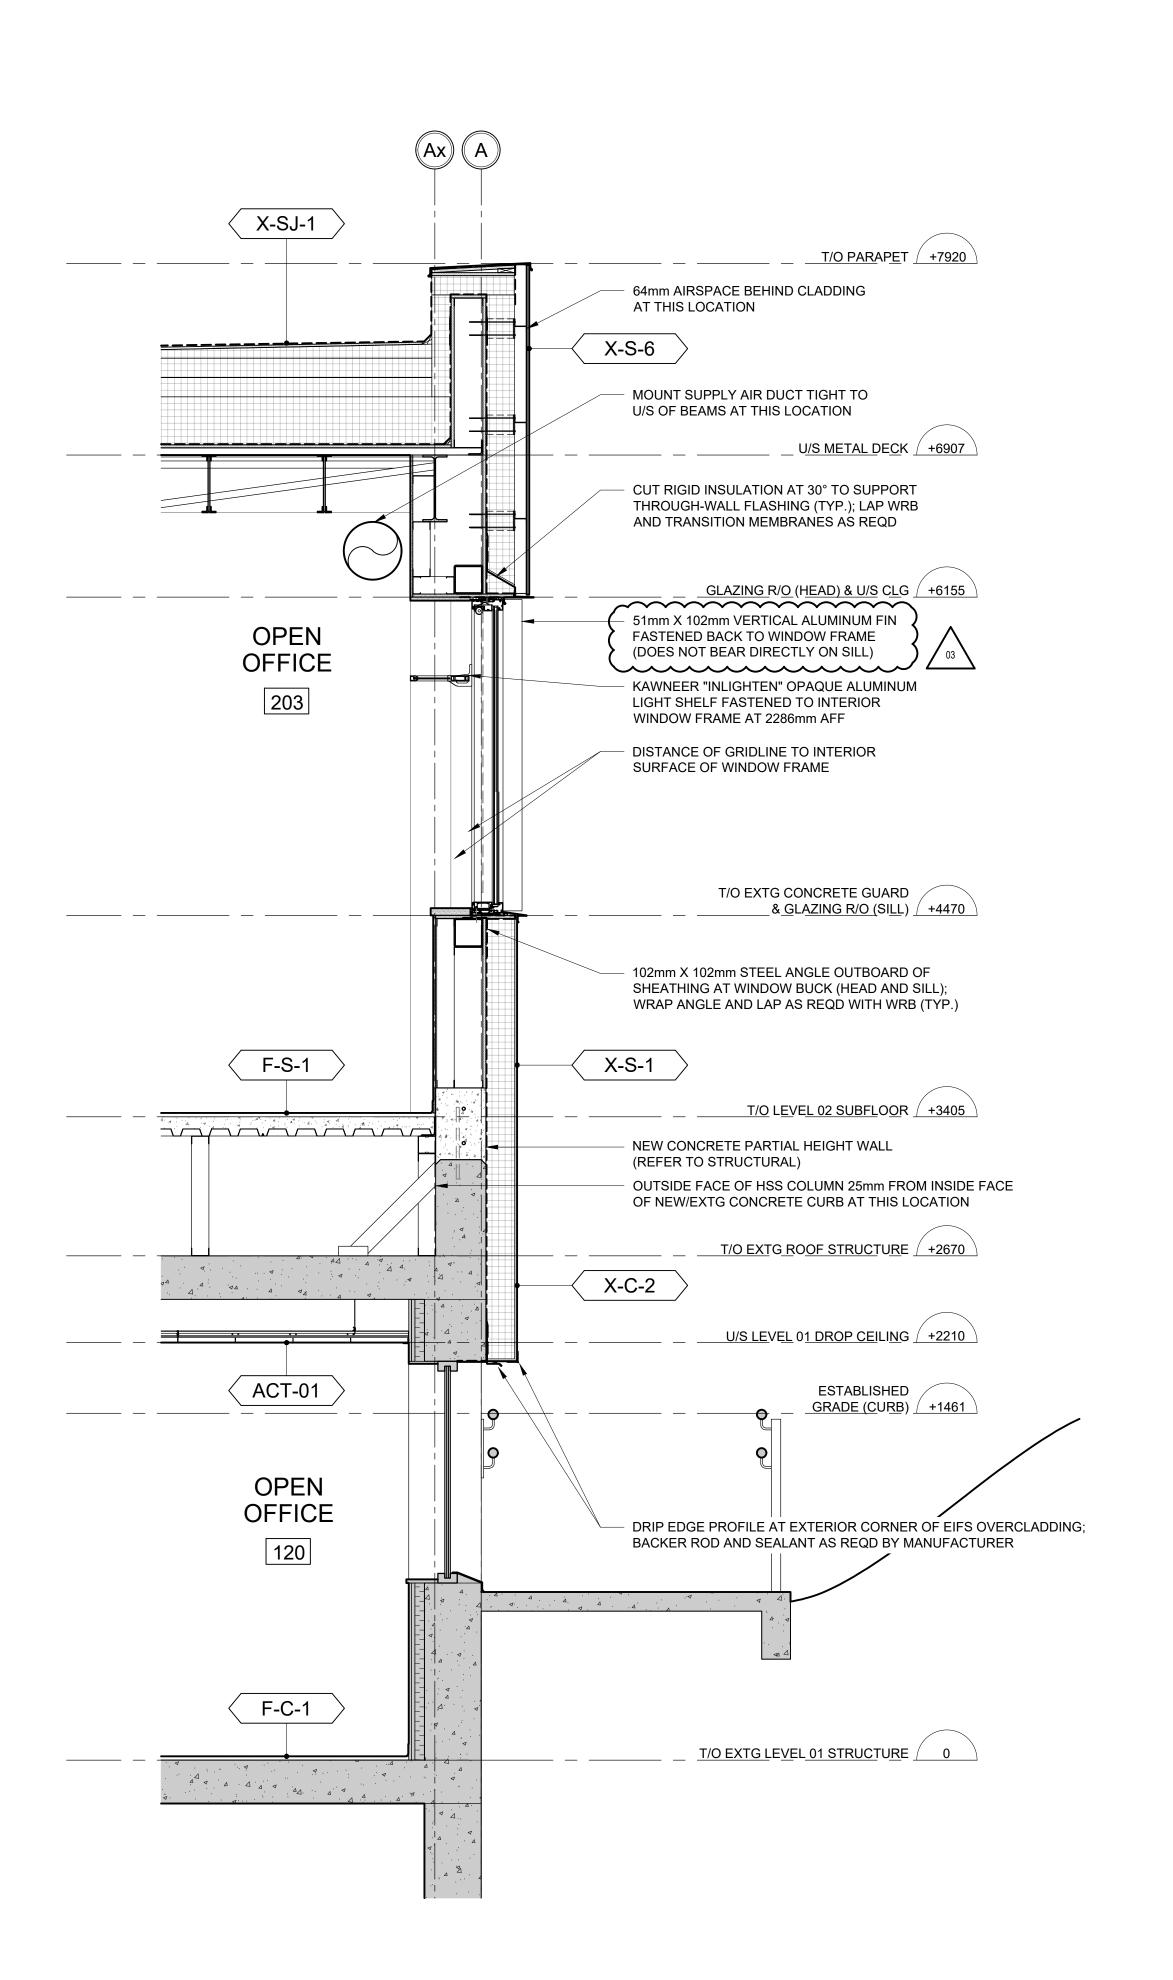





ISSUED FOR ADDENDUM 3 2023.09.29 ISSUED FOR TENDER 2023.09.06 ISSUED FOR PERMIT 2023.05.16 NO. ISSUES/REVISIONS

MILLWORK DETAILS

ISSUE DATE:	2023.09.06
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PROJECT NO.: 12228	SCALE: AS NOTED
DRAWING NO.:	REVISION:



WALL SECTION - SOUTH EXTERIOR WALL AT RIBBON WINDOW

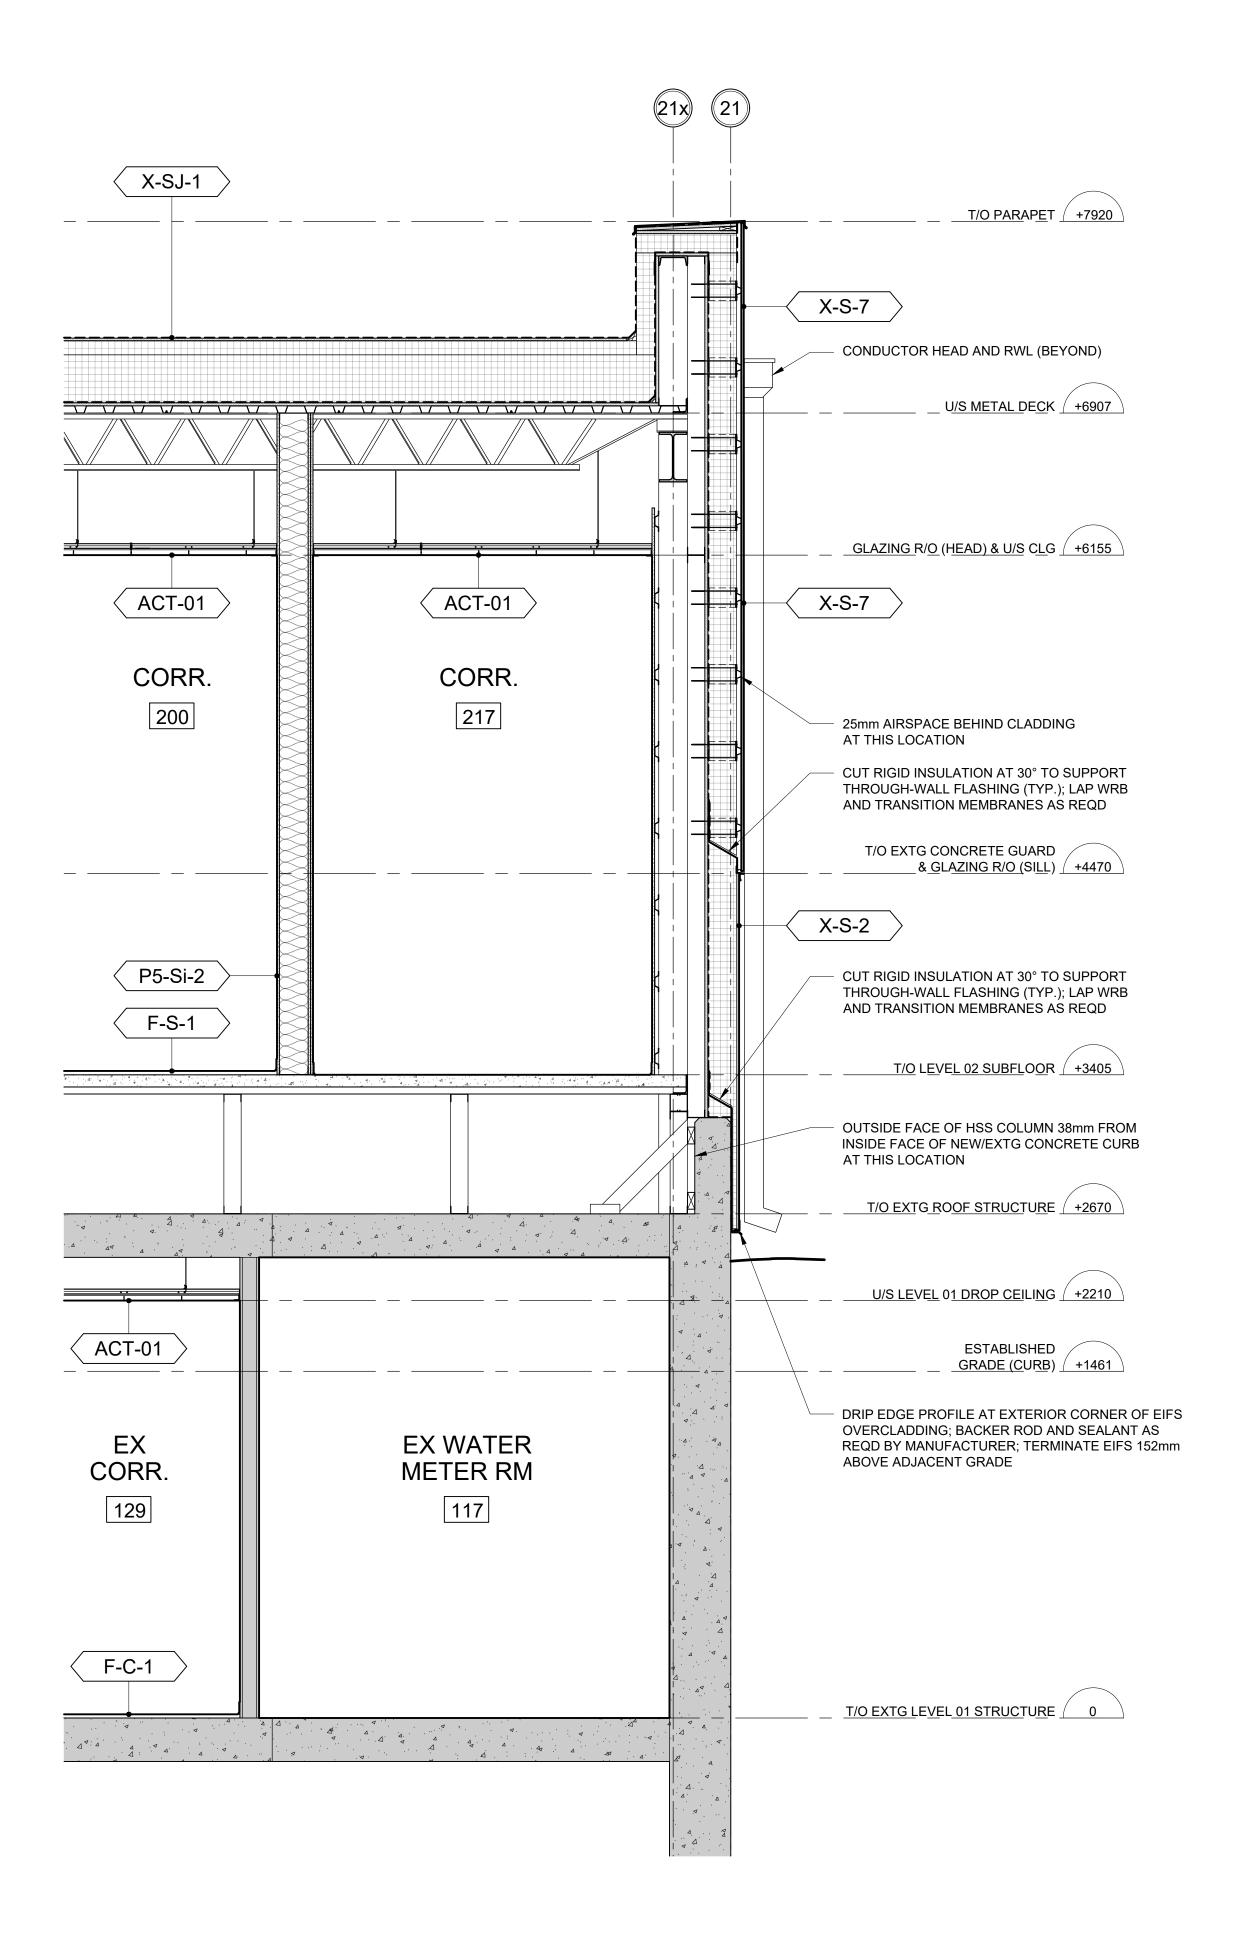

WALL SECTION - EAST EXTERIOR WALL AT EXTG STAIR LANDING SCALE: 1:20



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155 QUEEN ST NORTH HAMILTON, ONTARIO



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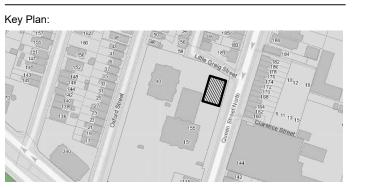
T: 905-522-0220 interiors urban design

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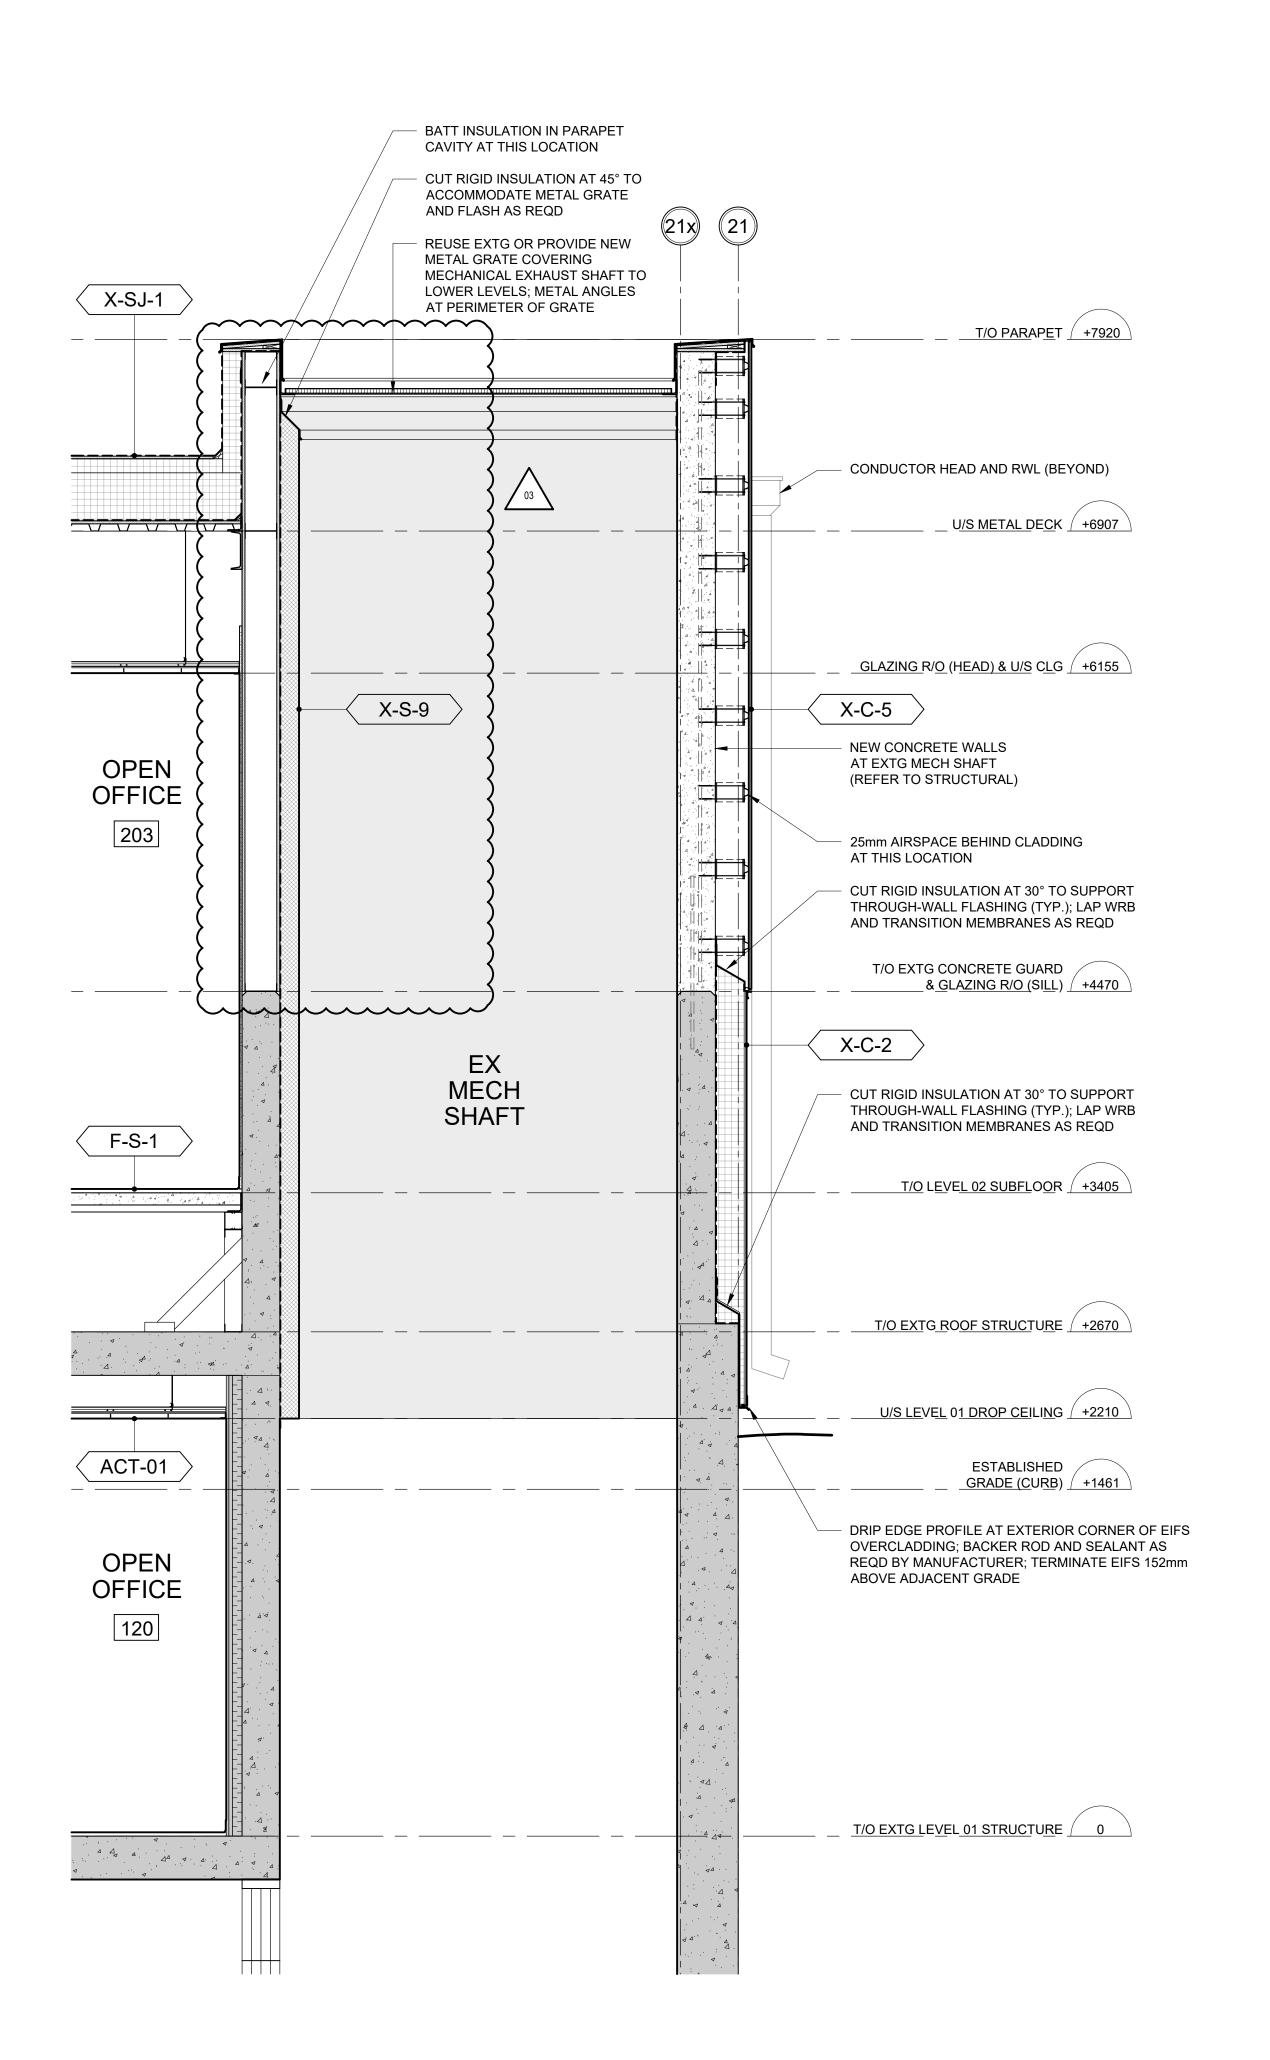




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01	ISSUED FOR PERMIT	2023.05.16
NO.	ISSUES/REVISIONS	DATE
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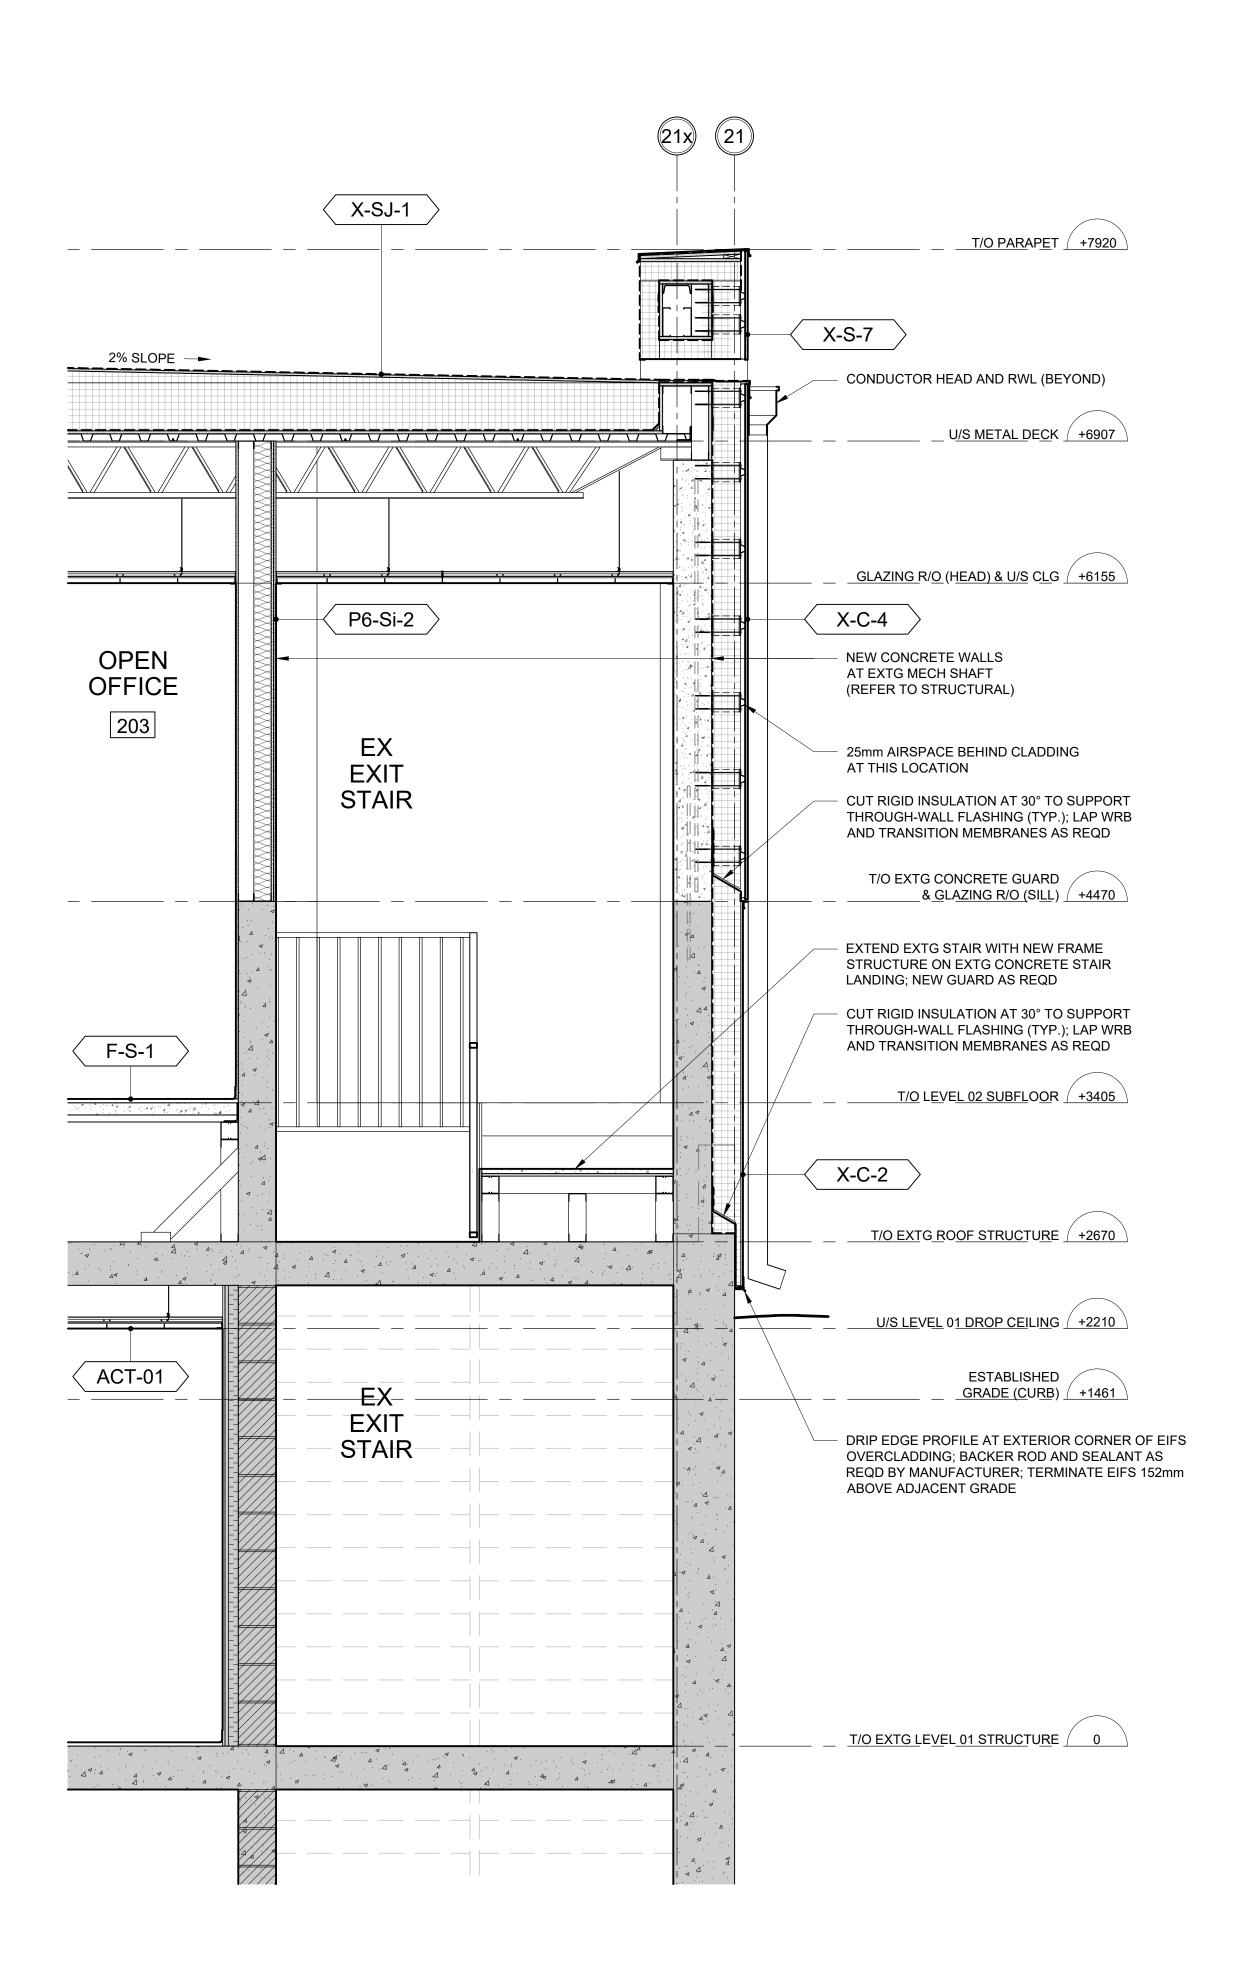
WALL SECTIONS

ISSUE DATE:	202	23.09.0
DRAWN BY: MM	CHECKED BY:	S
PROJECT NO.: 12228	SCALE:	1 : 20
DRAWING NO.:	l RE\	VISION



WALL SECTION - EAST EXTERIOR WALL AT MECHANICAL SHAFT

SCALE: 1:20



WALL SECTION - EAST EXTERIOR WALL AT EXTG EXIT STAIR

SCALE: 1:20



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25 Main Street West Hamilton, Ontario L8P 1H1 Canada


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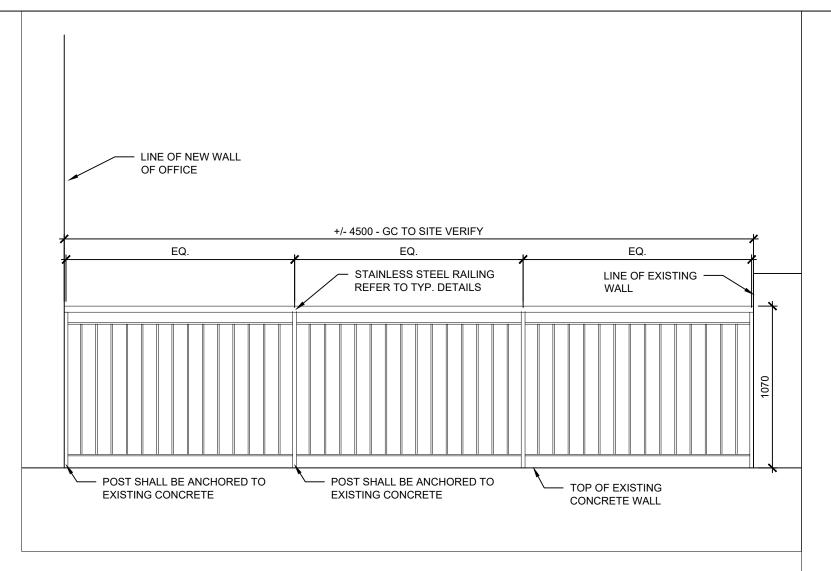





03	ISSUED FOR ADDENDUM #3	2023.10.06
02	ISSUED FOR TENDER	2023.09.06
01	ISSUED FOR PERMIT	2023.05.16
NO.	ISSUES/REVISIONS	DATE
DRAWIN	NG TITLE:	

WALL SECTIONS

ISSUE DATE:	202	23.09.0
DRAWN BY: MM	CHECKED BY:	SI
PROJECT NO.: 12228	SCALE:	1:20
DRAWING NO :	l DE'	VISION

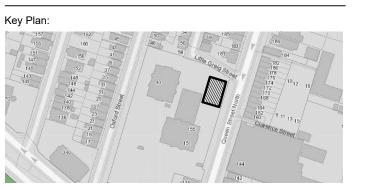

4 STAINLESS STEEL RAILING
SCALE: 1:25

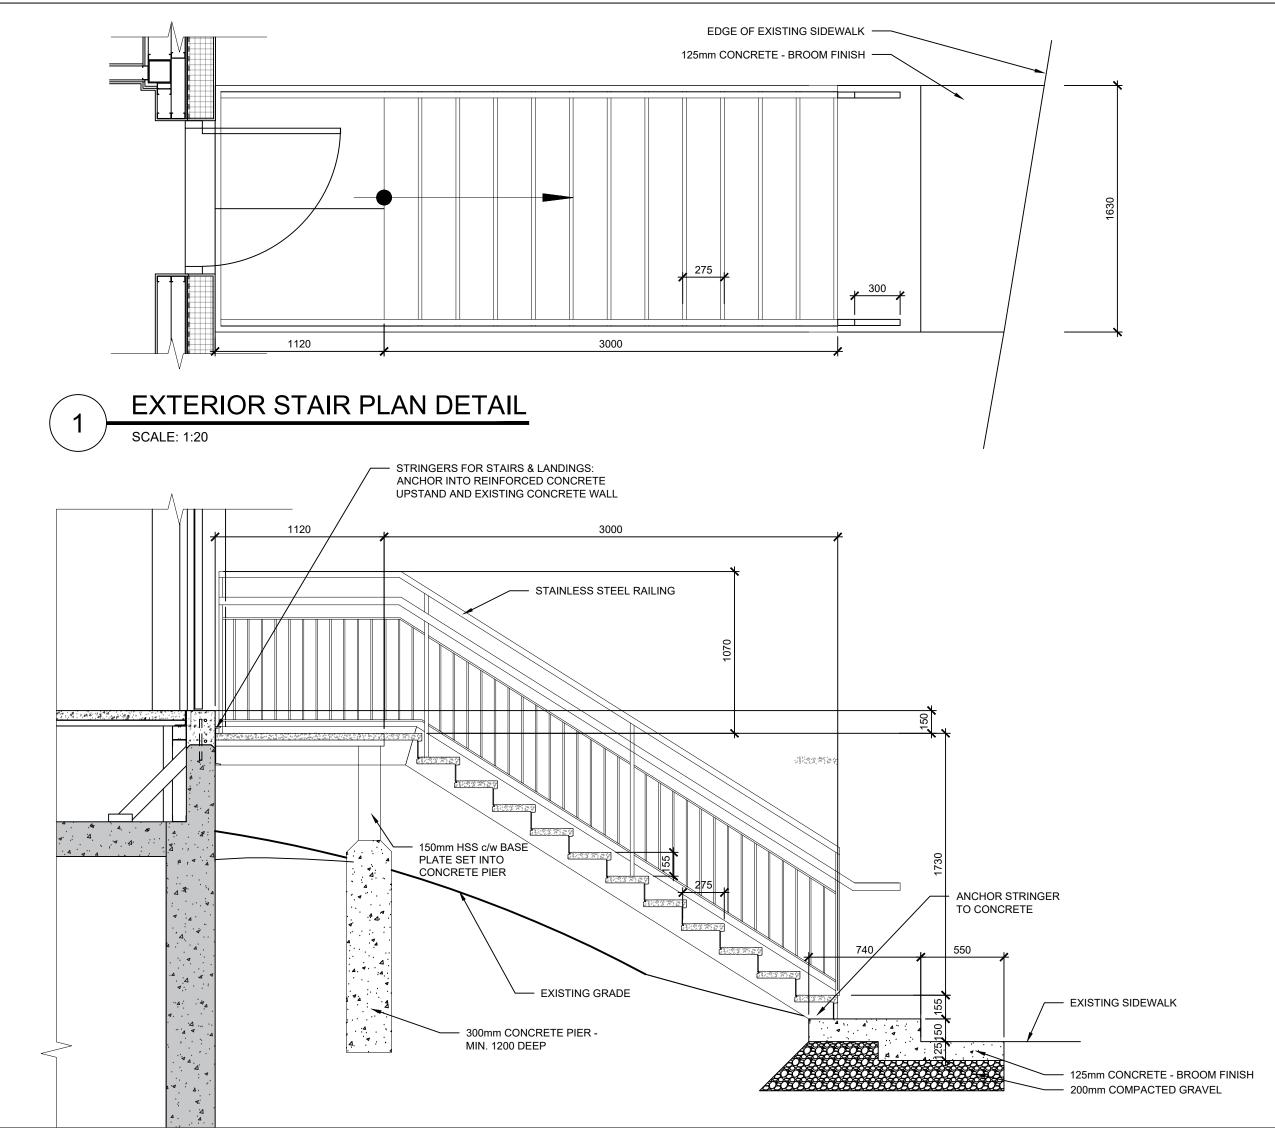



VPCH OFFICE EXPANSION

155 QUEEN ST NORTH HAMILTON, ONTARIO



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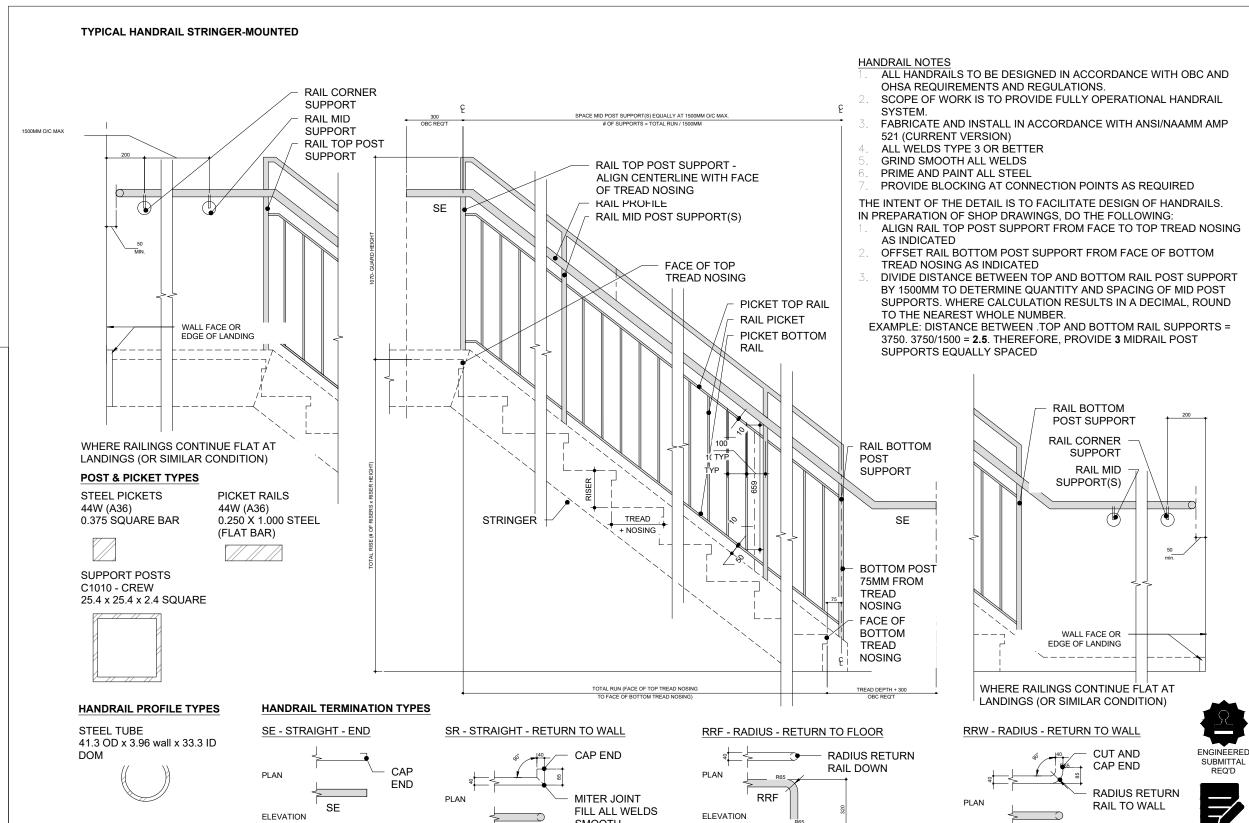
ARCHITECT AND MUST BE RETURNED AT THE COMPLETION OF THE WORK.



Key Plan:



2 WALL SECTION - RESERVED SCALE: 1:20



SMOOTH

CAP END

TREAD TYPE - ST-TR 90

STAIR WIDTH

RAILING WELDED TO TOP OF STRINGER

STEEL CHANNEL STRINGERS

• TREAD WELDED TO STRINGER

AT FACE OF WALL. LEAVE GAP BETWEEN
WALL AND STRINGER.

• IF < 6mm, CAULK GAP.
• IF > 6mm, CAULK GAP.
• IF

TREAD DEPTH

LINE OF STRINGER BEYOND

STEEL SUB-TREAD AND RISER c/w

FORMED NOSING AT 90 deg.

CONCRETE FILLED TREAD

STAIR FINISH

TYP. TREAD AND STRINGER DETAIL

SCALE: 1:20

3 TYPICAL HANDRAIL STRINGER MOUNTED DETAIL

SCALE: 1:20

ELEVATION

NO. ISSUES/REVISIONS DATE
DRAWING TITLE:

ISSUE DATE:

STAIR DETAILS & RAILINGS

 DRAWN BY:
 MM
 CHECKED BY:
 SL

 PROJECT NO.:
 12228
 SCALE:
 1:20


 DRAWING NO.:
 REVISION:

404.05

RRW

ELEVATION

00

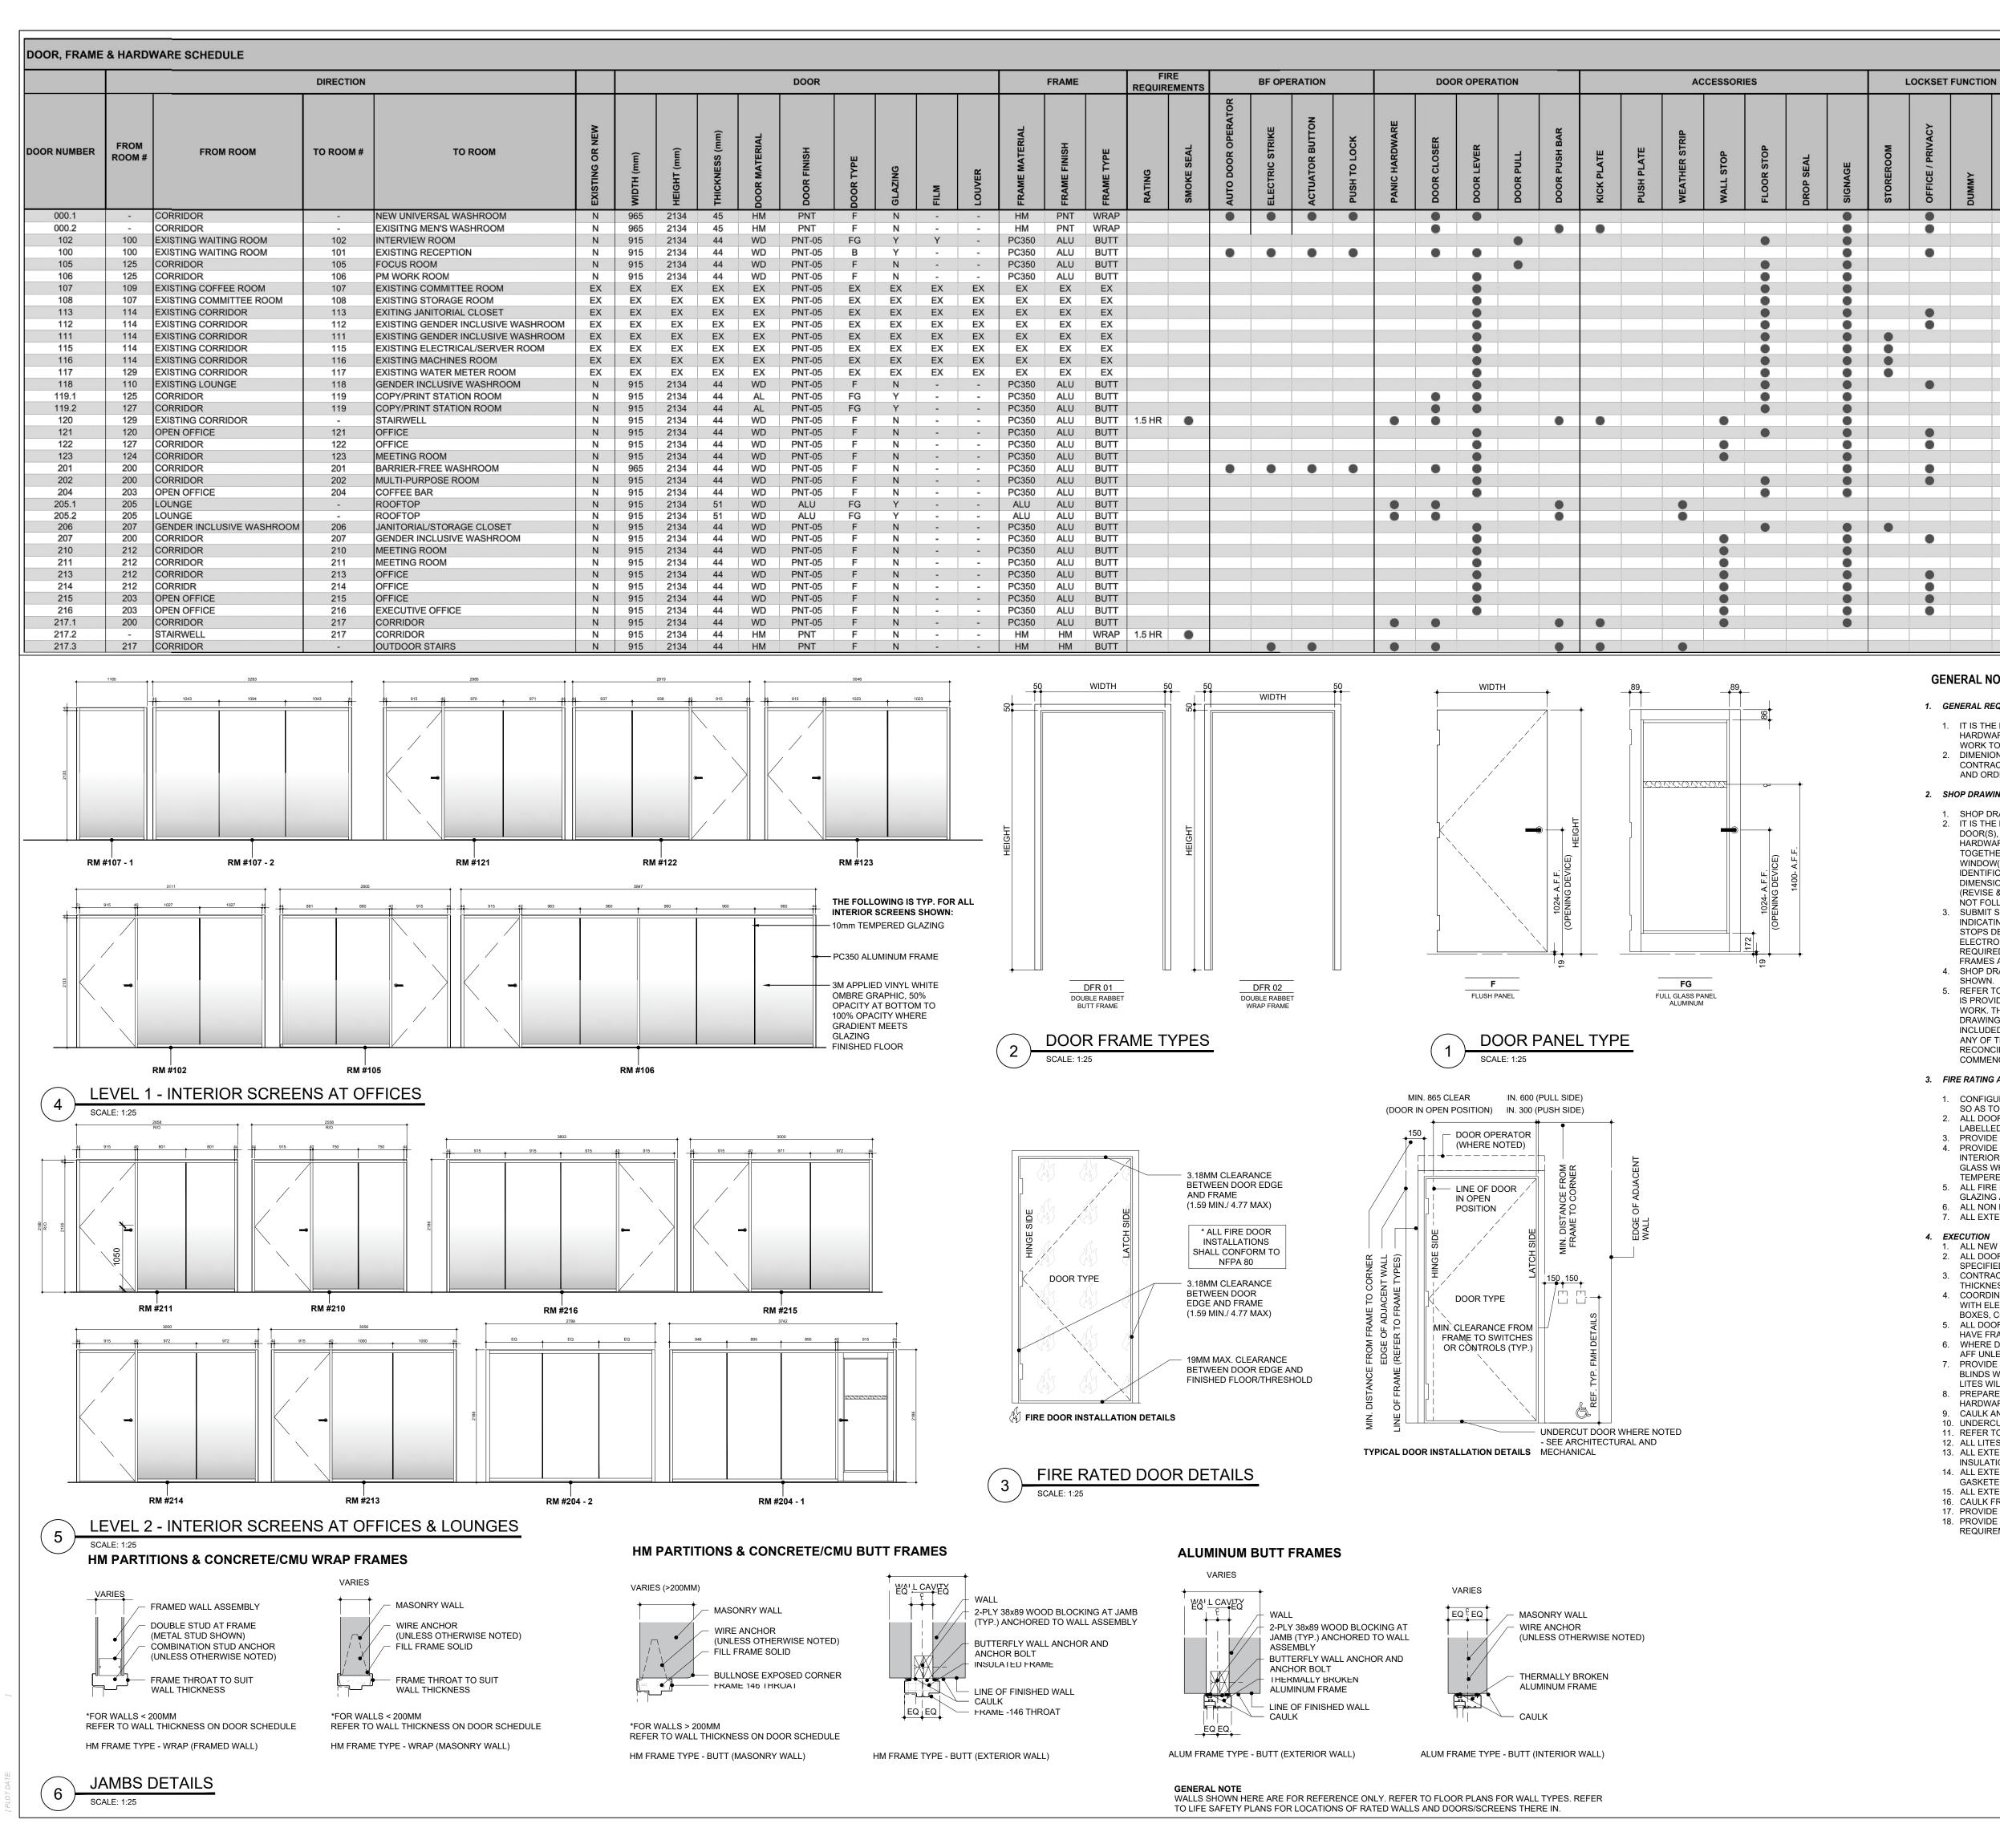



155 QUEEN ST NORTH HAMILTON, ONTARIO



urban design

25 Main Street West Hamilton, Ontario L8P 1H1 Canada

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LICENCE

DOOR(S), SCREEN(S), WINDOW(S), CURTAIN WALL(S), FRAME(S), AND THIER HARDWARE MANUFACTURERS TRADES COORDINATE & EXECUTE THIER WORK TOGETHER & LABEL IDENTIFYING INFORMATION FOR ALL DOOR(S), SCREEN(S), WINDOW(S), CURTAIN WALL(S), FRAME(S) SCHEDULES TO MATCH THE IDENTIFICATION TAG LABLES HERE, NOT HAVING DIFFERENT LABELS & DIMENSIONAL UNITS ON SHOP DRAWINGS THAN TENDERED DOCUMENTS. (REVISE & RESUBMIT SHOP DRAWINGS WILL BE RETURNED IF THIS FORMAT IS NOT FOLLOWED WITH NO REVIEW UNDERTAKEN BY THE CONSULANT TEAM) SUBMIT SHOP DRAWINGS FOR DOORS, FRAMES AND SCREENS CLEARLY

2. IT IS THE RESPONSIBILITY OF THE GENERAL CONTRACTOR TO ENSURE:

COMMENTS

FRAME AND DOOR COLOR SHALL MATCH EXISTING

FRAME AND DOOR COLOR SHALL MATCH EXISTING

EXISTING FRAMES AND DOORS TO BE REPAINTED

PC350 FRAME COLOR SHALL BE WHITE

PC350 FRAME COLOR SHALL BE WHITE PC350 FRAME COLOR SHALL BE WHITE

PC350 FRAME COLOR SHALL BE WHITE

PC350 FRAME COLOR SHALL BE WHITE

PC350 FRAME COLOR SHALL BE WHITE PC350 FRAME COLOR SHALL BE WHITE

PC350 FRAME COLOR SHALL BE WHITE

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PC350 FRAME COLOR SHALL BE WHITE

PC350 FRAME COLOR SHALL BE WHITE

PC350 FRAME COLOR SHALL BE WHITE

PC350 FRAME COLOR SHALL BE WHITE

PC350 FRAME COLOR SHALL BE WHITE

1. IT IS THE RESPONSIBILITY OF THE DOOR, FRAME, WINDOW, CURTAIN WALL & HARDWARE MANUFACTURER TRADES TO CO-ORDINATE & EXECUTE THIER

CONTRACTOR SHALL VERIFY ALL OPENINGS ON SITE PRIOR TO FRABRICATION

2. DIMENIONS INDICATED R.O - INDICATE ROUGH OPENING. GENERAL

1. SHOP DRAWINGS ARE REQUIRED PRIOR TO FABRICATION.

GENERAL NOTES - DOORS, FRAMES, & HARDWARE

PC350 FRAME COLOR SHALL BE WHITE

DOOR COLOR SHALL BE BLACK TO MATCH FRAME

DOOR COLOR SHALL BE BLACK TO MATCH FRAME

PC350 FRAME COLOR SHALL BE WHITE

PC350 FRAME COLOR SHALL BE WHITE

PC350 FRAME COLOR SHALL BE WHITE

- INDICATING PROFILES, ANCHORS, CONSTRUCTION, FIRE RATING, GLAZING STOPS DETAILS. PREPARATION AND REINFORCEMENT OF MANUAL AND ELECTRONIC HARDWARE AND SECURITY DEVICES AND OTHER INFORMATION REQUIRED FOR PROPER COORDINATION AND INSTALLATION OF DOORS, EDAMES AND SCREENS WITH THE WORK
- 4. SHOP DRAWINGS SHALL REFERENCE DOOR TYPE PANEL ELEVATIONS AS
- 5. REFER TO SPECIFICATION FOR DOOR HARDWARE SCHEDULE. THIS SCHEDULE IS PROVIDED TO ASSIST THE CONTRACTOR WITH THE TENDER AND THE WORK. THE INFORMATION PERTAINING TO DOORS AND FRAMES ON DRAWINGS, HARDWARE SCHEDULE AND IN THE SPECIFICATIONS SHALL BE INCLUDED AS PART OF THE WORK. IN THE CARE OF DISCREPANCY BETWEEN ANY OF THE CONTRACT DOCUMENTS THE CONTRACTOR SHALL CLARIFY AND RECONCILE THE DISCREPANCY WITH THE CONSULTANT PRIOR TO COMMENCING THE WORK.

3. FIRE RATING AND SMOLE SEALS

1. GENERAL REQUIREMENTS

WORK TOGETHER.

AND ORDERING.

2. SHOP DRAWINGS

- 1. CONFIGURE FRAME AND DOOR PROTECTION FOR DOORS WITH DOOR SEALS SO AS TO NOT COMPROMISE SEAL.
 2. ALL DOORS AND FRAMES IN RATED ASSEMBLIES SHALL BE APPROPRIATELY
- LABELLED 3. PROVIDE DOOR SEALS AT ALL FIRE RATED DOORS. 4. PROVIDE RATED DOOR FRAMES, DOOR PANELS, GLAZING AND FRAMES AT
- INTERIOR SCREENS TO SUIT INDICATED FIRE SEPARATIONS. USE FIRELITE GLASS WHERE INDICATED GLASS SIZE EXCEEDS MAXIMUM AREAS FOR TEMPERED GLASS AT RATED DOORS 5. ALL FIRE RATED DOORS AND SCREENS W/ CLAZING SHALL HAVE "FIRELITE" GLAZING AS REQUIRED.
- 6. ALL NON RATED GLAZING SHALL BE TEMPERED. 7. ALL EXTERIOR DOOR GLAZING SHALL BE LAMINATED SAFETY GLASS

- ALL NEW HOLLOW METAL FRAMES AND DOORS PANELS SHALL BE PAINTED. 2. ALL DOORS AND FRAMES SHALL BE PREPARED AND REINFORCED FOR
- SPECIFIED HARDWARF AND ACCESSORIES 3. CONTRACTOR TO SITE VERIFY AS-BUILT ROUGH OPENING SIZES AND WALL THICKNESS FOR WRAP AROUND FRAMES PRIOR TO FABRICATION OF FRAMES. 4. COORDINATE PREPARATION AND INSTALLATION OF DOORS AND HARDWARE
- WITH ELECTRICAL DIVISION AND CONCEALING OF ELECTRONIC JUNCTION BOXES, CONDUITS AND WIRING IN DOOR FRAMING. 5. ALL DOORS DESIGNATED WITH ELECTRICAL AND SECURITY CLOSURE SHALL
- HAVE FRAMES PRE-DRILLED TO RECEIVE SUCH DEVICES. 6. WHERE DOOR LITES ARE PRESENT, THEY SHALL NOT BE MORE THAN 900mm AFF UNLESS NOTED OTHERWISE
- 7. PROVIDE PREFABRICATED LITES c/w STAINLESS STEEL FRAME AND INTEGRAL BLINDS WHERE SPECIFIED. SUBSTITUTIONS FOR HOLLOW METAL FRAMED
- LITES WILL NOT BE ACCEPTED 8. PREPARE DOORS TO RECEIVE HARDWARE AS INDICATED ON FINISH
- HARDWARE SCHEDULE AND ELECTRICAL DRAWINGS 9. CAULK AND PAINT ALL EXPOSED EDGES OF DOORS AND FRAMES
- 10. UNDERCUT DOORS WHERE INDICATED ON DRAWINGS 11. REFER TO MECHANCIAL DRAWINGS FOR LOUVER SIZES IN TYPE 'L' DOORS 12. ALL LITES IN EXTERIOR DOORS SHALL BE SEALED AND THERMALLY BROKEN
- 13. ALL EXTERIOR DOOR FRAMES SHALL BE FILLED WITH CLOSED CELL FOAM INSULATION (JAMBS AND HEAD)
- 14. ALL EXTERIOR DOORS SHALL BE COMPLETELY WEATHERSTRIPPED AND
- 15. ALL EXTERIOR DOORS SHALL HAVE A PREFABRICATED ALUMINUM THRESHOLD
- 16. CAULK FRAME TO FLOOR AT EXPOSED CONCRETE FLOOR FINISHES 17. PROVIDE DOOR BUMPERS ON ALL STEEL FRAMES
- 18. PROVIDE VISION STRIPS AS PER ONTARIO BUILDING CODE DIV. 3.8.3.3 REQUIREMENTS AT FULL HEIGHT GLASS AREAS.

DRAWING TITLE: **DOOR & GLAZING**



2023.10.06

2023.09.06

2023.05.16

DATE

ISSUE DATE:		2023.0)9.06
DRAWN BY: MM	CHECKE	BY:	SL
PROJECT NO.: 12228	SCALE:	AS NO	TED
DRAWING NO.:		REVIS	ION:

ISSUED FOR ADDENDUM 3

ISSUED FOR TENDER

ISSUED FOR PERMIT

SCHEDULE

ISSUES/REVISIONS

FINISH CODE	BM HA CODE	DESCRIPTION
C10	612	SATIN BRONZE, CLEAR COATED
C10B	613*	DARK OXIDIZED SATIN BRONZE, OIL RUBBED*
C14	618	BRIGHT NICKEL PLATED, CLEAR COATED
C15	619	SATIN NICKEL PLATED, CLEAR COATED
C19	622	FLAT BLACK COATED
C20	623	LIGHT OXIDIZED STATUARY BRONZE, CLEAR COATED
C20	690	DARK BRONZE PAINTED
C20A	624	DARK OXIDIZED STATUARY BRONZE, CLEAR COATED
C26	625	BRIGHT CHROMIUM PLATED
C26D	626	SATIN CHROMIUM PLATED
C27	627	SATIN ALUMINUM, CLEAR COATED
C28 OR AL	628	SATIN ALUMINUM, CLEAR ANODIZED
C28 OR AL	689	ALUMINUM PLATED
C2G	603	ZINC PLATED
C3	605	BRIGHT BRASS, CLEAR COATED
C32	629	BRIGHT STAINLESS STEEL
C32D	630	SATIN STAINLESS STEEL
C4	606	SATIN BRASS, CLEAR COATED
C5	609	SATIN BRASS, BLACKENED, SATIN RELIEVED, CLEAR COATED
C9	611	BRIGHT BRONZE, CLEAR COATED
CP	600	PRIMED FOR PAINTING
EAD	EAD	BRASS PAINTED
EB	EB	DARK BRONZE PAINTED
ED	ED	BLACK PAINTED
EN	EN	ALUMINUM PAINTED
K29	K29	BLACK A NODIZED A LUMINUM
K40	K40	DARK BRONZE ALUMINUM

^{*} THIS FINISH WILL VARY IN COLOUR FROM ITEM TO ITEM AND WILL WEAR ACCORDING TO USE. NOTE: THE BASE MATERIAL (BRASS, BRONZE, STEEL, ALUMINUM) DETERMINES WHICH FINISHES ARE AVAILABLE (EG. ALUMINUM FINISHES ARE ONLY AVAILABLE ON PRODUCTS MADE OF ALUMINUM)

ERSAL WASHROOM - 000.2	1 SINGLE DOOR	RH BARRIER-FREE WASHROOM - 201	1 SINGLE DOOR	1
m x 2134mm x 45mm		R / HM FRAME 965mm x 2135mm x 45mm 3 CONCEALED BEARING HINGE	TA714 4.5 x 4 BSP	LOW METAL FRAM
RTISE STOREROOM LOCKSET	8204 LNMD L/C BSP	1 MORTISE STOREROOM LOCKSET	8204 LNMD L/C 630 BASE BUILDING KEYWAY	
RTISE CYLINDER ING	BASE BUILDING KEYWAY GMK TO BUILDING SYSTEM	1 MORTISE CYLINDER 1 KEYING	GMK TO BUILDING SYSTEM	
CTRIC STRIKE ALL ELECTRIC STRIKE	HES 4500C 630 FRAME CUTOUT NOT INCLUDED	1 ELECTRIC STRIKE 1 INSTALL ELECTRIC STRIKE	HES 4500C 630 FRAME CUTOUT NOT INCLUDED	
/ERSAL WASHROOM CONTROL KIT	CX-WC13XSM & CX-WEC10	1 UNIVERSAL WASHROOM CONTROL KIT	CX-WC13XSM & CX -WEC10	
VOLTAGE WIRING FOR ADO COMPONENTS OMATIC OPERATOR INSTALLATION	PULL STRINGS BY OTHERS POWER, BLOCKING, DEVICE BOXES AND PULL STRINGS BY OTHERS	1 LOW VOLTAGE WIRING FOR ADO COMF 1 AUTOMATIC OPERATOR INSTALLATION		1
OMATIC OPERATOR R HEAD DOOR STOP	SW100 PULL OPERATOR 51 INCH CLEAR RIXON 1 - X36 - 630	1 AUTOMATIC OPERATOR 1 OVER HEAD DOOR STOP	SW100 PULL OPERATOR 51 INCH CLEAR RIXON 1 - X36 - 630	
L DOOR GASKET	S773BL 21FT 1 SINGLE DOOR	1 ROLL DOOR GASKET RH MULTI-PURPOSE ROOM - 201	S773BL 21FT 1 SINGLE DOOR	
m x 2134mm x 44mm	HM DOOI	R / HM FRAME 915mm x 2134mm x 35mm	PAINT-GRADE WOOD D	OOR / PC350 FRAM
CEALED BEARING HINGE RTISE PASSAGE LATCHSET	TA714 4.5 x 4 BSP 8215 LNMD 630	3 CONCEALED BEARING HINGE 1 MORTISE LOCKSET	TA714 4.5 x 4 BSP 8256 LNMD 630	
R CLOSER PLATE	SARGENT 351-O - 689 GSH80A 8 X 36.5 TAPE C32	1 MORTISE CYLINDER 1 FLOOR STOP, STAINLESS STEEL 304	BASE BUILDING KEYWAY SUGATSUNE/LAMP 75872170 DOOR STOPPER 35mm DIA X 50mm H	
R HEAD DOOR STOP L DOOR GASKET	RIXON 1 - X36 - 630 S773BL 21FT	LOUNGE - 204 915mm x 2134mm x 35mm	1 SINGLE DOOR PAINT-GRADE WOOD D	OOR / PC350 FRAM
	1 SINGLE DOOR	LH 3 CONCEALED BEARING HINGE PC350 FRAME 1 MORTISE LOCKSET	TA714 4.5 x 4 BSP 8256 LNMD 630	
CEALED BEARING HINGE	TA714 4.5 x 4 BSP	1 MORTISE CYLINDER	BASE BUILDING KEYWAY	
OR STOP, STAINLESS STEEL 304	8215 LNMD 630 SUGATSUNE/LAMP 75872170 DOOR STOPPER 35mm DIA X 50mm H	1 FLOOR STOP, STAINLESS STEEL 304 ROOFTOP DOORS - 205.1/205.2	SUGATSUNE/LAMP 75872170 DOOR STOPPER 35mm DIA X 50mm H 1 PAIR OF DOORS	RH/I
m x 2134mm x 44mm	1 SINGLE DOOR PAINT-GRADE WOOD DOOR / I	LHR 915mm x 2134mm x 35mm PC350 FRAME 5 CONCEALED BEARING HINGE	TA314 4.5 x 4 NRP 630	R DOOR / AL FRAM
CEALED BEARING HINGE	TA714 4.5 x 4 BSP 8204 LNMD L/C 630	1 ELECTRIC CONCEALED BEARING HING 1 EXIT DEVICE	CC4-18 TA314 4.5 x 4 NRP 630 SARGENT 56 - AD8413 ETMD- 630 RIM EXIT DEVICE PANIC BAR & LEV	/FR
RTISE CYLINDER	BASE BUILDING KEYWAY	1 EXIT DEVICE	SARGENT AD8410 - 630 RIM EXIT DEVICE PANIC BAR & EXIT ONLY	
ING CTRIC STRIKE	GMK TO BUILDING SYSTEM HES 4500C 630	1 MORTISE CYLINDER 1 DOOR CLOSER	BASE BUILDING KEYWAY SARGENT 351-CPS - 689	
ALL ELECTRIC STRIKE VOLTAGE WIRING FOR ADO COMPONENTS	FRAME CUTOUT NOT INCLUDED PULL STRINGS BY OTHERS	1 SPACER BLOCK 1 DROP PLATE	SARGENT 581-2 - 689 SARGENT 351-D - 689	
OMATIC OPERATOR INSTALLATION R HEAD DOOR STOP	POWER, BLOCKING, DEVICE BOXES AND PULL STRINGS BY OTHERS RIXON 1 - X36 - 630	1 DOOR CONTACT 1 CARD READER	1" DOOR CONTACT BY SECURITY	
OMATIC OPERATOR	SW100 PUSH OPERATOR 51 INCH CLEAR		WEATHER STRIPPING, DOOR SWEEP & THERSHOLD BY ALUM DOOR MANUFACTURE.	
PUSH BUTTON COLUMN ACTUATOR ESS CARD READER, BLACK	CM-7536/CLR BY OTHERS	JANITORIAL/STORAGE CLOSET - 206 915mm x 2134mm x 35mm	PAINT-GRADE WOOD D	OOR / PC350 FRA
S ROOM - 105 m x 2134mm x 44mm	1 SINGLE DOOR PAINT-GRADE WOOD DOOR / I	RH 4 CONCEALED BEARING HINGE PC350 FRAME 1 MORTISE STOREROOM LOCKSET	TA714 4.5 x 4 BSP 8204 LNMD L/C 630	
CEALED BEARING HINGE	TA714 4.5 x 4 BSP 8215 LNMD 630	1 MORTISE CYLINDER 1 FLOOR STOP, STAINLESS STEEL 304	BASE BUILDING KEYWAY SUGATSUNE/LAMP 75872170 DOOR STOPPER 35mm DIA X 50mm H	
OR STOP, STAINLESS STEEL 304	SUGATSUNE/LAMP 75872170 DOOR STOPPER 35mm DIA X 50mm H 1 SINGLE DOOR	GENDER INCLUSIVE WASHROOM - 2 LH 915mm x 2134mm x 35mm	207 1 SINGLE DOOR PAINT-GRADE WOOD D	OOR / PC350 FRA
m x 2134mm x 44mm	PAINT-GRADE WOOD DOOR / I	PC350 FRAME 3 CONCEALED BEARING HINGE	TA714 4.5 x 4 BSP	001(71 0000 11(1)
CEALED BEARING HINGE TISE PASSAGE LATCHSET	TA714 4.5 x 4 BSP 8215 LNMD 630	1 MORTISE PRIVACY SET 1 OVER HEAD DOOR STOP	8265 LNMD 630 RIXON 1 - X36 - 630	
OR STOP, STAINLESS STEEL 304 TNG COMMITTEE ROOM - 107 EXIS*	SUGATSUNE/LAMP 75872170 DOOR STOPPER 35mm DIA X 50mm H TING PAIR OF DOORS	1 FOOT PULL DOOR OPENER, SILVER STA	TAINLESS STEEL MAG-MATE DIRECT-MOUNT FP01 5" X 4" X 2-1/2" 1 SINGLE DOOR	
20mm X 44mm	EXISTING DOOR / EXISTING DOOR	STING FRAME 915mm x 2134mm x 35mm 3 CONCEALED BEARING HINGE	PAINT-GRADE WOOD D TA714 4.5 x 4 BSP	OOR / PC350 FRAM
IARDWARE SUPPLIER TO CONFIRM COMPATABILITY WI	TH EXISTING DOOR. USE SARGENT DL SERIES IF CYLINDERICAL PREP IS REQUIRED.	1 MORTISE PASSAGE LATCHSET	8215 LNMD 630	E 47 BIA TIP
FING STORAGE ROOM - 108 EXISTED 20mm X 44mm		LH 1 WALL STOP, CHROME & WHITE TIP STING FRAME MEETING ROOM - 211	RICHELIEU 3" PROJECTION RIGID DOOR STOP 216CV, 25mm DIA BAS 1 SINGLE DOOR	•
RTISE PASSAGE LATCHSET HARDWARE SUPPLIER TO CONFIRM COMPATABILITY WI	8215 LNMD 630 TH EXISTING DOOR. USE SARGENT DL SERIES IF CYLINDERICAL PREP IS REQUIRED.	915mm x 2134mm x 35mm 3 CONCEALED BEARING HINGE	PAINT-GRADE WOOD D TA714 4.5 x 4 BSP	OOR / PC350 FRAI
TING GEN. INCLUSIVE W/R - 111 EXIS	STING SINGLE DOOR EXISTING DOOR / EXIS	LH 1 MORTISE PASSAGE LATCHSET STING FRAME 1 WALL STOP, CHROME & WHITE TIP	8215 LNMD 630 RICHELIEU 3" PROJECTION RIGID DOOR STOP 216CV, 25mm DIA BAS	E. 17mm DIA TIP
RTISE PASSAGE LATCHSET	8215 LNMD 630 TH EXISTING DOOR, USE SARGENT DL SERIES IF CYLINDERICAL PREP IS REQUIRED.	OFFICE - 213 915mm x 2134mm x 35mm	1 SINGLE DOOR PAINT-GRADE WOOD D	
T PULL DOOR OPENER, SILVER STAINLESS STEEL	MAG-MATE DIRECT-MOUNT FP01 5" X 4" X 2-1/2"	3 CONCEALED BEARING HINGE	TA714 4.5 x 4 BSP	OUR / PC350 FRAM
FING GEN. INCLUSIVE W/R - 112 EXIS 5mm X 44mm	STING SINGLE DOOR EXISTING DOOR / EXISTING DOO	RH 1 MORTISE LOCKSET STING FRAME 1 MORTISE CYLINDER	8256 LNMD 630 BASE BUILDING KEYWAY	
RTISE PASSAGE LATCHSET HARDWARE SUPPLIER TO CONFIRM COMPATABILITY WI	8215 LNMD 630 TH EXISTING DOOR. USE SARGENT DL SERIES IF CYLINDERICAL PREP IS REQUIRED.	1 WALL STOP, CHROME & WHITE TIP OFFICE - 214	RICHELIEU 3" PROJECTION RIGID DOOR STOP 216CV, 25mm DIA BAS 1 SINGLE DOOR	E, 17mm DIA TIP
T PULL DOOR OPENER, SILVER STAINLESS STEEL	MAG-MATE DIRECT-MOUNT FP01 5" X 4" X 2-1/2" STING SINGLE DOOR	915mm x 2134mm x 35mm RH 3 CONCEALED BEARING HINGE	PAINT-GRADE WOOD D	OOR / PC350 FRAM
5mm X 44mm	EXISTING DOOR / EXIS	STING FRAME 1 MORTISE LOCKSET	8256 LNMD 630	
RTISE LOCKSET RTISE CYLINDER	8204 LNMD 630 BASE BUILDING KEYWAY	1 MORTISE CYLINDER 1 WALL STOP, CHROME & WHITE TIP	BASE BUILDING KEYWAY RICHELIEU 3" PROJECTION RIGID DOOR STOP 216CV, 25mm DIA BAS	E, 17mm DIA TIP
	TH EXISTING DOOR. USE SARGENT DL SERIES IF CYLINDERICAL PREP IS REQUIRED. STING SINGLE DOOR	OFFICE - 215 RH 915mm x 2134mm x 35mm	1 SINGLE DOOR PAINT-GRADE WOOD D	OOR / PC350 FRAM
5mm X 44mm	EXISTING DOOR / EXISTING DOOR	STING FRAME 3 CONCEALED BEARING HINGE 1 MORTISE LOCKSET	TA714 4.5 x 4 BSP 8256 LNMD 630	
RTISE CYLINDER	BASE BUILDING KEYWAY	1 MORTISE CYLINDER 1 WALL STOP, CHROME & WHITE TIP	BASE BUILDING KEYWAY	E 47 DIA TID
ING MACHINES ROOM - 116 EXIS	TH EXISTING DOOR. USE SARGENT DL SERIES IF CYLINDERICAL PREP IS REQUIRED. STING SINGLE DOOR	RH EXECUTIVE OFFICE - 216	RICHELIEU 3" PROJECTION RIGID DOOR STOP 216CV, 25mm DIA BAS 1 SINGLE DOOR	
5mm X 44mm TISE LOCKSET	EXISTING DOOR / EXISTING DOOR	STING FRAME 915mm x 2134mm x 35mm 3 CONCEALED BEARING HINGE	PAINT-GRADE WOOD D TA714 4.5 x 4 BSP	OOR / PC350 FRA
TISE CYLINDER ARDWARE SUPPLIER TO CONFIRM COMPATABILITY WI	BASE BUILDING KEYWAY TH EXISTING DOOR. USE SARGENT DL SERIES IF CYLINDERICAL PREP IS REQUIRED.	1 MORTISE LOCKSET 1 MORTISE CYLINDER	8256 LNMD 630 BASE BUILDING KEYWAY	
	STING SINGLE DOOR	RH 1 WALL STOP, CHROME & WHITE TIP STING FRAME STAIRWELL - 217.1	RICHELIEU 3" PROJECTION RIGID DOOR STOP 216CV, 25mm DIA BAS 1 SINGLE DOOR	E, 17mm DIA TIP
TISE LOCKSET	8204 LNMD 630	915mm x 2134mm x 35mm	HM DOOR / HM	FRAME FIRE RAT
TISE CYLINDER ARDWARE SUPPLIER TO CONFIRM COMPATABILITY WI	BASE BUILDING KEYWAY TH EXISTING DOOR. USE SARGENT DL SERIES IF CYLINDERICAL PREP IS REQUIRED.	3 CONCEALED BEARING HINGE 1 EXIT DEVICE	TA714 4.5 x 4 626 SARGENT 12 8804 ETMD 32D RIM EXIT DEVICE PANIC BAR & STORES	ROOM LEVER
DER INCLUSIVE WASHROOM - 118 m x 2134mm x 44mm	1 SINGLE DOOR PAINT-GRADE WOOD DOOR / I	RH 1 MORTISE CYLINDER PC350 FRAME 1 ELECTRIC STRIKE	BASE BUILDING KEYWAY HES 9500 630	
CEALED BEARING HINGE	TA714 4.5 x 4 BSP 8265 LNMD 630	1 DOOR CLOSER 1 WALL STOP, CHROME & WHITE TIP	SARGENT 351-O - 630 RICHELIEU 3" PROJECTION RIGID DOOR STOP 216CV, 25mm DIA BAS	F 17mm DIA TID
R HEAD DOOR STOP	RIXON 1 - X36 - 630	1 EACH KICKPLATE	GSH80A 8 X LDW TAPE C32	S. COMMUNATE
T PULL DOOR OPENER, SILVER STAINLESS STEEL /PRINT STATION - 119.1/119.2	MAG-MATE DIRECT-MOUNT FP01 5" X 4" X 2-1/2" 2 SINGLE DOORS	1 DOOR CONTACT RH/LH 1 CARD READER	1" DOOR CONTACT BY SECURITY	
	TA714 4.5 x 4 BSP	PC350 FRAME STAIRWELL - 217.2 915mm x 2134mm x 35mm	1 SINGLE DOOR HM DOOR / HM	FRAME FIRE RAT
	8215 LNMD 630	EXTERIOR - 217.2	DOOR, FRAME AND ALL HARDWARE DELETED 1 SINGLE DOOR	
CONCEALED BEARING HINGE TISE PASSAGE LATCHSET	SARCENT 354 O COD	915mm x 2134mm x 35mm	HM DOOR / HM	FRAME FIRE RAT
CONCEALED BEARING HINGE TISE PASSAGE LATCHSET R CLOSER HEAD DOOR STOP	SARGENT 351-O - 689 RIXON 1 - X36 - 630		TA314 4.5 x 4 NRP 630 SARGENT 8804 ETMD 32D RIM EXIT DEVICE PANIC BAR & STOREROO	DM LEVER
H CONCEALED BEARING HINGE TISE PASSAGE LATCHSET R CLOSER R HEAD DOOR STOP WELL - 120	RIXON 1 - X36 - 630 1 SINGLE DOOR	RHR 3 CONCEALED BEARING HINGE R / HM FRAME 1 EXIT DEVICE	CARCELL SOFT ELLING SED WIN EAT DEVICE LANG BARK COLONERO	
CONCEALED BEARING HINGE TISE PASSAGE LATCHSET R CLOSER R HEAD DOOR STOP WELL - 120 D X 2134mm x 44mm CEALED BEARING HINGE	RIXON 1 - X36 - 630 1 SINGLE DOOR	R / HM FRAME 1 EXIT DEVICE 1 MORTISE CYLINDER	BASE BUILDING KEYWAY HES 9500 630	
m x 2134mm x 44mm CEALED BEARING HINGE DEVICE RTISE CYLINDER	RIXON 1 - X36 - 630 1 SINGLE DOOR FIRE RATED - HM DOO! TA714 4.5 x 4 626 SARGENT 12 8804 ETMD 32D RIM EXIT DEVICE PANIC BAR & STOREROOM LEVER BASE BUILDING KEYWAY	1 EXIT DEVICE 1 MORTISE CYLINDER /ER 1 ELECTRIC STRIKE 1 DOOR CLOSER	BASE BUILDING KEYWAY HES 9500 630 SARGENT 351-CPS - 689	
H CONCEALED BEARING HINGE RISE PASSAGE LATCHSET RICLOSER R HEAD DOOR STOP RWELL - 120 m x 2134mm x 44mm CEALED BEARING HINGE DEVICE RISE CYLINDER CTRIC STRIKE RICLOSER	RIXON 1 - X36 - 630 1 SINGLE DOOR FIRE RATED - HM DOOI TA714 4.5 x 4 626 SARGENT 12 8804 ETMD 32D RIM EXIT DEVICE PANIC BAR & STOREROOM LEVEN BASE BUILDING KEYWAY HES 9500 630 SARGENT 351-O - 630	R / HM FRAME 1 EXIT DEVICE 1 MORTISE CYLINDER VER 1 ELECTRIC STRIKE 1 DOOR CLOSER 1 SET WEATHERSTRIP 1 DOOR SWEEP	BASE BUILDING KEYWAY HES 9500 630 SARGENT 351-CPS - 689 W-1 - DOOR WIDTH X DOOR HEIGHT W -13S - DOOR WIDTH	
H CONCEALED BEARING HINGE RISE PASSAGE LATCHSET R CLOSER R HEAD DOOR STOP RWELL - 120 m x 2134mm x 44mm CEALED BEARING HINGE DEVICE RTISE CYLINDER CTRIC STRIKE	RIXON 1 - X36 - 630 1 SINGLE DOOR FIRE RATED - HM DOOI TA714 4.5 x 4 626 SARGENT 12 8804 ETMD 32D RIM EXIT DEVICE PANIC BAR & STOREROOM LEVER BASE BUILDING KEYWAY HES 9500 630	R / HM FRAME 1 EXIT DEVICE 1 MORTISE CYLINDER /ER 1 ELECTRIC STRIKE 1 DOOR CLOSER 1 SET WEATHERSTRIP 1 DOOR SWEEP DIA TIP 1 THERSHOLD 1 EACH KICKPLATE	BASE BUILDING KEYWAY HES 9500 630 SARGENT 351-CPS - 689 W-1 - DOOR WIDTH X DOOR HEIGHT	
H CONCEALED BEARING HINGE RTISE PASSAGE LATCHSET R CLOSER R HEAD DOOR STOP RWELL - 120 m x 2134mm x 44mm CEALED BEARING HINGE DEVICE RTISE CYLINDER CTRIC STRIKE RR CLOSER L STOP, CHROME & WHITE TIP	RIXON 1 - X36 - 630 1 SINGLE DOOR FIRE RATED - HM DOO! TA714 4.5 x 4 626 SARGENT 12 8804 ETMD 32D RIM EXIT DEVICE PANIC BAR & STOREROOM LEVENT BASE BUILDING KEYWAY HES 9500 630 SARGENT 351-O - 630 RICHELIEU 3" PROJECTION RIGID DOOR STOP 216CV, 25mm DIA BASE, 17mm	R / HM FRAME 1 EXIT DEVICE 1 MORTISE CYLINDER /ER 1 ELECTRIC STRIKE 1 DOOR CLOSER 1 SET WEATHERSTRIP 1 DOOR SWEEP DIA TIP 1 THERSHOLD	BASE BUILDING KEYWAY HES 9500 630 SARGENT 351-CPS - 689 W-1 - DOOR WIDTH X DOOR HEIGHT W -13S - DOOR WIDTH CT-10 - DOOR WIDTH	
H CONCEALED BEARING HINGE RISE PASSAGE LATCHSET RICLOSER R HEAD DOOR STOP RWELL - 120 m x 2134mm x 44mm CEALED BEARING HINGE DEVICE RTISE CYLINDER CTRIC STRIKE R CLOSER L STOP, CHROME & WHITE TIP H KICKPLATE R CONTACT D READER CE - 121	RIXON 1 - X36 - 630 1 SINGLE DOOR FIRE RATED - HM DOOI TA714 4.5 x 4 626 SARGENT 12 8804 ETMD 32D RIM EXIT DEVICE PANIC BAR & STOREROOM LEVEN BASE BUILDING KEYWAY HES 9500 630 SARGENT 351-O - 630 RICHELIEU 3" PROJECTION RIGID DOOR STOP 216CV, 25mm DIA BASE, 17mm GSH80A 8 X LDW TAPE C32 1" DOOR CONTACT BY SECURITY 1 SINGLE DOOR	R / HM FRAME 1 EXIT DEVICE 1 MORTISE CYLINDER /ER 1 ELECTRIC STRIKE 1 DOOR CLOSER 1 SET WEATHERSTRIP 1 DOOR SWEEP DIA TIP 1 THERSHOLD 1 EACH KICKPLATE 1 DOOR CONTACT 1 CARD READER	BASE BUILDING KEYWAY HES 9500 630 SARGENT 351-CPS - 689 W-1 - DOOR WIDTH X DOOR HEIGHT W -13S - DOOR WIDTH CT-10 - DOOR WIDTH GSH80A 8 X LDW TAPE C32 1" DOOR CONTACT	
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H CONCEALED BEARING HINGE TISE PASSAGE LATCHSET R CLOSER R HEAD DOOR STOP WELL - 120 In x 2134mm x 44mm CEALED BEARING HINGE DEVICE TISE CYLINDER CTRIC STRIKE R CLOSER L STOP, CHROME & WHITE TIP H KICKPLATE R CONTACT D READER SE - 121 In x 2134mm x 44mm	RIXON 1 - X36 - 630 1 SINGLE DOOR FIRE RATED - HM DOOI TA714 4.5 x 4 626 SARGENT 12 8804 ETMD 32D RIM EXIT DEVICE PANIC BAR & STOREROOM LEVEN BASE BUILDING KEYWAY HES 9500 630 SARGENT 351-O - 630 RICHELIEU 3" PROJECTION RIGID DOOR STOP 216CV, 25mm DIA BASE, 17mm GSH80A 8 X LDW TAPE C32 1" DOOR CONTACT BY SECURITY 1 SINGLE DOOR PAINT-GRADE WOOD DOOR / 18	R / HM FRAME 1 EXIT DEVICE 1 MORTISE CYLINDER /ER 1 ELECTRIC STRIKE 1 DOOR CLOSER 1 SET WEATHERSTRIP 1 DOOR SWEEP DIA TIP 1 THERSHOLD 1 EACH KICKPLATE 1 DOOR CONTACT 1 CARD READER	BASE BUILDING KEYWAY HES 9500 630 SARGENT 351-CPS - 689 W-1 - DOOR WIDTH X DOOR HEIGHT W -13S - DOOR WIDTH CT-10 - DOOR WIDTH GSH80A 8 X LDW TAPE C32 1" DOOR CONTACT	
CONCEALED BEARING HINGE ISE PASSAGE LATCHSET CLOSER HEAD DOOR STOP VELL - 120 x 2134mm x 44mm EALED BEARING HINGE DEVICE ISE CYLINDER RIC STRIKE CLOSER STOP, CHROME & WHITE TIP KICKPLATE CONTACT READER E - 121 x 2134mm x 44mm EALED BEARING HINGE ISE CYLINDER STOP, STAINLESS STEEL 304	RIXON 1 - X36 - 630 1 SINGLE DOOR FIRE RATED - HM DOOI TA714 4.5 x 4 626 SARGENT 12 8804 ETMD 32D RIM EXIT DEVICE PANIC BAR & STOREROOM LEVEN BASE BUILDING KEYWAY HES 9500 630 SARGENT 351-O - 630 RICHELIEU 3" PROJECTION RIGID DOOR STOP 216CV, 25mm DIA BASE, 17mm GSH80A 8 X LDW TAPE C32 1" DOOR CONTACT BY SECURITY 1 SINGLE DOOR PAINT-GRADE WOOD DOOR / 18 TA714 4.5 x 4 BSP 8256 LNMD 630	R / HM FRAME 1 EXIT DEVICE 1 MORTISE CYLINDER /ER 1 ELECTRIC STRIKE 1 DOOR CLOSER 1 SET WEATHERSTRIP 1 DOOR SWEEP DIA TIP 1 THERSHOLD 1 EACH KICKPLATE 1 DOOR CONTACT 1 CARD READER	BASE BUILDING KEYWAY HES 9500 630 SARGENT 351-CPS - 689 W-1 - DOOR WIDTH X DOOR HEIGHT W -13S - DOOR WIDTH CT-10 - DOOR WIDTH GSH80A 8 X LDW TAPE C32 1" DOOR CONTACT	
CONCEALED BEARING HINGE SE PASSAGE LATCHSET CLOSER HEAD DOOR STOP //ELL - 120 x 2134mm x 44mm EALED BEARING HINGE EVICE SE CYLINDER RIC STRIKE CLOSER STOP, CHROME & WHITE TIP KICKPLATE CONTACT READER - 121 x 2134mm x 44mm EALED BEARING HINGE SE LOCKSET SE CYLINDER STOP, STAINLESS STEEL 304 - 122 x 2134mm x 44mm	RIXON 1 - X36 - 630 1 SINGLE DOOR FIRE RATED - HM DOO! TA714 4.5 x 4 626 SARGENT 12 8804 ETMD 32D RIM EXIT DEVICE PANIC BAR & STOREROOM LEVEN BASE BUILDING KEYWAY HES 9500 630 SARGENT 351-O - 630 RICHELIEU 3" PROJECTION RIGID DOOR STOP 216CV, 25mm DIA BASE, 17mm GSH80A 8 X LDW TAPE C32 1" DOOR CONTACT BY SECURITY 1 SINGLE DOOR PAINT-GRADE WOOD DOOR / II TA714 4.5 x 4 BSP 8256 LNMD 630 BASE BUILDING KEYWAY SUGATSUNE/LAMP 75872170 DOOR STOPPER 35mm DIA X 50mm H 1 SINGLE DOOR	R / HM FRAME 1 EXIT DEVICE 1 MORTISE CYLINDER /ER 1 ELECTRIC STRIKE 1 DOOR CLOSER 1 SET WEATHERSTRIP 1 DOOR SWEEP DIA TIP 1 THERSHOLD 1 EACH KICKPLATE 1 DOOR CONTACT 1 CARD READER LH PC350 FRAME RH	BASE BUILDING KEYWAY HES 9500 630 SARGENT 351-CPS - 689 W-1 - DOOR WIDTH X DOOR HEIGHT W -13S - DOOR WIDTH CT-10 - DOOR WIDTH GSH80A 8 X LDW TAPE C32 1" DOOR CONTACT	
CONCEALED BEARING HINGE ISE PASSAGE LATCHSET CLOSER HEAD DOOR STOP WELL - 120 x 2134mm x 44mm EALED BEARING HINGE DEVICE ISE CYLINDER TRIC STRIKE CLOSER STOP, CHROME & WHITE TIP KICKPLATE CONTACT READER E - 121 x 2134mm x 44mm EALED BEARING HINGE ISE CYLINDER STOP, STAINLESS STEEL 304	RIXON 1 - X36 - 630 1 SINGLE DOOR FIRE RATED - HM DOOI TA714 4.5 x 4 626 SARGENT 12 8804 ETMD 32D RIM EXIT DEVICE PANIC BAR & STOREROOM LEVEN BASE BUILDING KEYWAY HES 9500 630 SARGENT 351-O - 630 RICHELIEU 3" PROJECTION RIGID DOOR STOP 216CV, 25mm DIA BASE, 17mm GSH80A 8 X LDW TAPE C32 1" DOOR CONTACT BY SECURITY 1 SINGLE DOOR PAINT-GRADE WOOD DOOR / 10 TA714 4.5 x 4 BSP 8256 LNMD 630 BASE BUILDING KEYWAY SUGATSUNE/LAMP 75872170 DOOR STOPPER 35mm DIA X 50mm H 1 SINGLE DOOR	R / HM FRAME 1 EXIT DEVICE 1 MORTISE CYLINDER /ER 1 ELECTRIC STRIKE 1 DOOR CLOSER 1 SET WEATHERSTRIP 1 DOOR SWEEP DIA TIP 1 THERSHOLD 1 EACH KICKPLATE 1 DOOR CONTACT 1 CARD READER LH PC350 FRAME RH	BASE BUILDING KEYWAY HES 9500 630 SARGENT 351-CPS - 689 W-1 - DOOR WIDTH X DOOR HEIGHT W -13S - DOOR WIDTH CT-10 - DOOR WIDTH GSH80A 8 X LDW TAPE C32 1" DOOR CONTACT	

TA714 4.5 x 4 BSP

8215 LNMD 630 RICHELIEU 3" PROJECTION RIGID DOOR STOP 216CV, 25mm DIA BASE, 17mm DIA TIP

PAINT-GRADE WOOD DOOR / PC350 FRAI

1 WALL STOP, CHROME & WHITE TIP MEETING ROOM - 123

4 CONCEALED BEARING HINGE

1 MORTISE PASSAGE LATCHSET 1 WALL STOP, CHROME & WHITE TIP



VPCH OFFICE EXPANSION

155 QUEEN ST NORTH HAMILTON, ONTARIO



25 Main Street West Hamilton, Ontario L8P 1H1 Canada

T: 905-522-0220

DRAWINGS ARE NOT TO BE SCALED.


CONTRACTOR MUST VERIFY ALL DIMENSIONS ON THE JOB AND REPORT ANY DISCREPANCY TO ARCHITECTS BEFORE PROCEEDING WITH WORK. ALL DRAWINGS AND SPECIFICATIONS ARE THE PROPERTY OF THE ARCHITECT AND MUST BE RETURNED AT THE COMPLETION OF THE WORK.





03	ISSUED FOR ADDENDUM 3	2023.10.06
02	ISSUED FOR TENDER	2023.09.06
01	ISSUED FOR PERMIT	2023.05.16
NO.	ISSUES/REVISIONS	DATE

HARDWARE SCHEDULES

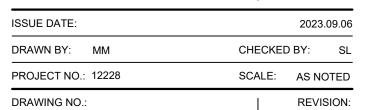

URNITURE SCH	HEDULE									FINISHES SO									
ROJECT#: 12228										PROJECT: VICTORIA PARK COMMUNITY HOMES PROJECT #: 12228 PROJECT ADDRESS: 155 QUEEN STREET N, HAMILTON, ONTARIO, CANADA									
ROJECT ADDRES ATE: 2022.11.XX	SS: 155 QUEEN STREET N	HAMILTON, ONTA	RIO, CANADA							DATE: 2022.1		N, HAMILTON, ON	TARIO, CANADA		1		1		
TAG	IMAGE	TYPE	ROOM	MANUFACTURER + MODEL	SPECIFICATIONS	DIMENSIONS	FINISH	NOTES	VENDOR/SUPPLIER/LINK	TAG	IMAGE	TYPE	ROOM	MANUFACTURER + MODEL	SPECIFICATIONS	DIMENSIONS	FINISH	NOTES	VENDOR/SUPPLIER/LINK
ASEGOODS CG-01		CONSOLE	INTERVIEW ROOM	MANUFACTURER: STEEL CASE	PROUD STEEL LAMINATE FRONT WITH LEDGE PULL CW COMMON WORKSURFACE TO MATCH	WDTH: 36" D₽TH: 24"	WHITE		STEELCASE https://www.steelcase.com/pro	ACT-01		ACOUSTIC CEILING TILE	CEILING THROUGHOUT	MANUFACTURER: ARMSTRONG MODEL: CANY ON FOR PRELUDE XL MAX	CLASS A (UL) FIRE PERFORMANCE MNERAL FIBRE HUMIGUARD PLUS SAG/HUMIDITY RESISTANCE SQUARE LAY-IN	WIDTH: 23-13/16" LENGTH: 47-13/16" THICKNESS: 5/8"	1488 IN WHITE (WH)	0.65 NRC 35 CAC 80% LIGHT REFLECTANCE 44% RECY CLED CONTENT	ARMSTRONG
	And the second			MODEL: UNIVERSAL STORAGE CABINET	UNIVERSAL BASE	H⊟GHT: 28"			ducts/systems-storage/universal storage/	BS-01		BASEBOARD	WALL BASE THROUGHOUT	MANUFACTURER: JOHNSONITE MODEL: TRADITIONAL WALL BASE	TY PE TV WITH TOE	THICKNESS: 1/8" HEIGHT: 2.5"	38 PEWTER CG		TARKETT 3
CG-02		FILING CABINET	THROUGHOUT	SELECTION BY CLIENT						CPT-01		CARPET TILE	FLOORING THROUGHOUT	MANUFACTURER: MOHAWK MODEL: TIMELESS TAILORED COLLECTION	GT469	LENGTH: 36" WIDTH: 12"	DISTRESSED TWILL IRON 969	INSTALL METHOD: HALF LAP	MOHAWK BROUP
CG-03		FILING CABINET	THROUGHOUT	SELECTION BY CLIENT						CTL-01		CERAMIC TILE	WALL TILE THROUGHOUT	MANUFACTURER: CENTURA MODEL: RAINBOW	#FL216WM GLAZED	LENGTH: 16" WIDTH: 4"	WHITE MATTE GROUT: MAPEI ULTRACOLOUR MAX 117 PURE WHITE	PLUS 3	CENTURA TILE
CH-01		TASK CHAIR	THROUGHOUT	SELECTION BY CLIENT						HPL-01		HIGH- PRESSURE LAMINATE	HORIZONTAL MILLWORK SURFACES THROUGHOUT		SR521 STANDARD HPL		TEXTURED/SUEDE (SD)		PANOLAM
CH-02	丽	LOUNGECHAIR	EXISTING WAITING ROOM	MANUFACTURER: MATTIAZZI MODEL: CLERICI LOUNGE CHAIR	SOLID OAK WOOD	WIDTH: 33.07" DEPTH: 25.78" HEIGHT: 27.55" SEAT HEIGHT: 15.35"	NATURAL OAK WOOD	BIFMA COMPLIANT FSC CERTIFIED WOOD 2 YEAR WARRANTY	STELCASE https://www.steelcase.com/products/lounge-chairs/clerici-lounge/	HPL-02		HIGH- PRESSURE LAMINATE	HORIZONTAL MILLWORK SURFACES THROUGHOUT	MANUFACTURER: NEVAMAR MODEL: BLACK	S6001 STANDARD HPL		SUPER MATTE (SM)		PANOLAM
CH-03		COUNTER STOOL	EXISTING LOUNGE 110	MANUFACTURER: BLUDOT MODEL: READY STACKING COUNTER STOC	POWDER-COATED STEEL LEGS WITH RUBBER FEET MOLDED PLY WOOD SEAT WITH ASH WOOD VENEER STACKING	WIDTH: 20" DEPTH: 19" HEIGHT: 27" SEAT HEIGHT: 25"	BLACK	BIFMA COMPLIANT	STEELCASE https://www.bludot.com/ready- stacking-counter-stool.html	LVT-01		LUXURY VINYL TILE	FLOORING THROUGHOUT	MANUFACTURER: MOHAWK GROUP MODEL: LARGE AND LOCAL WOOD	∞ 128	LENGTH: 59" WIDTH: 9.25" THICKNESS: 4.5mm WEAR LAY ER: 20 MIL	UNICOI 822 M-FORCE ULTRA ENHANCED URETHANE	100% CARBON NEUTRAL PLU 5%	S MOHAWK GROUP
CH-04	A	DINING CHAIR	DINING CHAIR	MANUFACTURER: STEELCASE MODEL: SIMPLE CHAIR	POLYPROPYLENE AND STEEL FRAME WOOD SEAT STACKS 4-HIGH	WIDTH: 19 2/3" DEPTH: 19 2/3" HEIGHT: 31 8/9" SEAT HEIGHT: 17 5/7"	BLACK 7207	BIFMA COMPLIANT 12 YEAR WARRANTY	STELCASE https://www.steelcase.com/products/side-guest-chairs/simple-chair/	PNT-01		PAINT	WALL PAINT THROUGHOUT	MANUFACTURER: BENJAMIN MOORE MODEL: CHANTILLY LACE	OC-65	N∕A	EGGSHELL		BENJAMIN MOORE
CH-05		DINING CHAIR	DINING CHAIR	MANUFACTURER: BLUDOT MODEL: CLEAN CUT CHAIR	3D BENT PLY WITH WOOD VENEER	WDTH: 19" DEPTH: 18" HBGHT: 31" SEAT HBGHT: 19"	WHITE OAK SEAT BLACK POWDER-COATED STEEL BASE	BIFMA COMPLIANT	STEELCASE https://www.bludot.com/clean-cut-dining-chair.html	PNT-02		PAINT	WALL PAINT THROUGHOUT	MANUFACTURER: BENJAMIN MOORE MODEL: CLASSIC BURGUNDY	HC-182	N/A	EGGSHELL		BENJAMIN MOORE
CH-06		STOOL	MULTI-PURPOSE ROOM 202	MANUFACTURER: MATTIAZZI MODEL: CUGINO STOOL	SOLID OAK WOOD	WIDTH: 12.99" DEPTH: 12.99" HBGHT: 17.71"	NATURAL OAK WOOD	BIFMA COMPLIANT FSC CERTIFIED WOOD 2 Y FAR WARRANTY	STELCASE https://www.steelcase.com/products/stools/cugino-stool/	PNT-03		PAINT	CEILING PAINT THROUGHOUT	MANUFACTURER: BENJAMIN MOORE MODEL: CHANTILLY LACE	OC-65	N∕A	FLAT		BENJAMIN MOORE
					SOFT GOODS				data/stoos/orgino stooi	PNT-04		PAINT	CEILING PAINT THROUGHOUT	MANUFACTURER: BENJAMIN MOORE MODEL: MIDNIGHT DREAM	Oct-29	N/A	FLAT		BENJAMIN MOORE
SG-01		SOFA	EXISTING WAITING ROOM 100	MANUFACTURER: BLUDOT MODEL: CLEON 56" ARMLESS SOFA	SOLID HARDWOOD FRAME SINUOUS STEEL SPRINGS FOAM AND DACRON FIBER FILLED CUSHIONS ANILINE LEATHER, BURNISHED AND POLISHED	WIDTH: 56" DEPTH: 36" HEIGHT: 28" SEAT HEIGHT: 17" SEAT DEPTH: 26"	SLATE LEATHER		STELCASE https://www.bludot.com/cleon-modern-unarmed-sofa.html	PNT-05		PAINT	TRIM & DOOR PAINT THROUGHOUT	MANUFACTURER: BENJAMIN MOORE MODEL: CHANTILLY LACE	OC-65	N∕A	SEMI-GLOSS	3	BENJAMIN MOORE
SG-02		велсн	LOUNGE 205	MANUFACTURER: COALESSE MODEL: TOGETHER BENCH	STRAIGHT WITH BACK	WDTH: 96.5" DEPTH: 26.75" HEIGHT: 31" SEAT HEIGHT: 18.5"	DESIGNTEX BIRDSEYE GROUP 7	SCS INDOOR ADVANTAGE GOLD CERTIFIED BIFMA LEVEL 2 LIMITED LIFETIME WARRANT	https://www.bludot.com/cleon-	PTL-01		PORCELAIN TILE	FLOOR TILE THROUGHOUT	MANUFACTURER: CENTURA MODEL: CEPPOSTONE	K947204R0001VTE0 RECTIFIED	WIDTH: 40cm LENGTH: 80cm	VIT MATTE	INSTALL METHOD: MONOLITH	C J ENTURA TILE
SG-03	age does not reflect finishes	GUEST CHAIR	OFFICES THROUGHOUT	MANUFACTURER: WEST ELM MODEL: SLOPE GUEST CHAIR		WDTH: 19.25" DEPTH: 21.5" HEGHT: 33.25" SEAT HEIGHT: 18.75"	STEELCASE NEW BLACK HARLEY GROUP 7 STEELCASE 4CZ 4 MERLOT BASE	BIFMA COMPLIANT LIMITED LIFETIME WARRANT	STELCASE https://www.steelcase.com/products/side-guest-chairs/west-elm-work-slope-made-to-order/	SDT-01		STATIC DISSIPATIVE TILE	вон	MANUFACTURER: ARMSTRONG FLOORING MODEL: EXCELON SDT	51956	12" X 12"		INSTALL METHOD: SOLDIER- STACKED INSTALL WITH SDT ADHESIVE 202	
ABLES TB-01		SIDE TABLE	EXISTING WAITING ROOM 100	MANUFACTURER: MEMO MODEL: KINO STOOL	KNO1-S1-WOA STACKING	WDTH: 15.75" DEPTH: 17.75" HBGHT: 15.75"	OAK OVER ASH		STELCASE https://www.bludot.com/cleon-modern-unarmed-sofa.html	ST-01		TERRAZZO	COUNTERTOPS THROUGHOUT	MANUFACTURER: ANN SACKS MODEL: TERRAZZO RENATA SLAB	AS16751	WIDTH: 31" LENGTH: 84" THICKNESS: 3/4"	BLACK	28% PRE-CONTENT RECY CLED CONTENT LEED V4 CERTIFIED	ANN SACKS
TB-02	age does not reflect finish*	DINING TABLE	LOUNGE 205	MANUFACTURER: BOLIA MODEL: TURNED DINING TABLE		DIAMETER: 29.52" HEIGHT: 27.75"	LACQUERED OAK	EN COMPLIANT FSC CERTIFIED WOOD 10 YEAR WARRANTY	STELCASE https://www.steelcase.com/products/occasional-tables/turned-dining-table/	TFL-01		THERMALLY FUSED LAMINATE	VERTICAL MILLWORK SURFACES THROUGHOUT	MANUFACTURER: PANOLAM MODEL: BURGUNDY	FS695 STANDARD FRL		TEXTURED/SUEDE (SD)		PANOLAM
TB-03		DINING TABLE	LOUNGE 205	MANUFACTURER: STEELCASE MODEL: SYLVI BOOTH COLLABORATIVE TABLE		WIDTH: 60" DEPTH: 30" HBGHT: 26.5"	ARCTIC WHITE	BIFMA COMPLIANT LIMITED LIFETIME WARRANT	STELCASE https://www.steelcase.com/pro	TFL-02	RE	THERMALLY FUSED LAMINATE	VERTICAL MILLWORK SURFACES THROUGHOUT	MANUFACTURER: NEVAMAR - MODEL: BLACK	90S/S405 STANDARD TFL		SUPER MATTE (SM)		PANOLAM
ABLELAMPS			DUOTING STATE	MANUFACTION	F1060009	DANKET CO.			table/	TFL-03	RE								
TL-01		TABLE LAMP	EXISTING RECEPTION 101	MANUFACTURER: FLOS MODEL: BELLHOP PORTABLE TABLE LAMP	2.5W LED 2700K CRI90 250Im INDOOR IP20 120V	DAMETER: 12.45cm HEIGHT: 21.08cm	WHTE	1 YEAR WARRANTY	https://www.lightformshop.com/t able-lamps/portable- lamps/bellhop-portable-table	IFL-04		TRANSITION		MANUFACTURER SCHLUTER	SCHLUTER VINPRO-U RESILIENT SURFACE REDUCER		ALUMINUM ANODIZED BRUSHE		
WS-01		WORKSTATION	THROUGHOUT	SELECTION BY CLIENT						TS-01		STRIP	CARPET TILE TO CONCRETE PORCELAIN TILE TO CONCRE	MANUFACTURER SCHLUTER MODEL: VPU50ACGB MANUFACTURER: SCHLUTER MODEL: VPU50ACGB	PROFILE SCHLUTER VINPRO-U RESILIENT SURFACE REDUCER PROFILE SCHLUTER VINPRO-U RESILIENT SURFACE REDUCER PROFILE	3/10 (3/11/1) // 02-1/2	ALUMINUM ANODIZED BRUSHE CHROME ALUMINUM ANODIZED BRUSHE CHROME		SCHLUTER



155 QUEEN ST NORTH HAMILTON, ONTARIO



urban design

25 Main Street West Hamilton, Ontario L8P 1H1 Canada

T: 905-522-0220

DRAWINGS ARE NOT TO BE SCALED.

DISCREPANCY TO ARCHITECTS BEFORE PROCEEDING WITH WORK. ALL DRAWINGS AND SPECIFICATIONS ARE THE PROPERTY OF THE ARCHITECT AND MUST BE RETURNED AT THE COMPLETION OF THE WORK.

CONTRACTOR MUST VERIFY ALL DIMENSIONS ON THE JOB AND REPORT ANY



03	ISSUED FOR ADDENDUM 3	2023.09.29
02	ISSUED FOR TENDER	2023.09.06
01	ISSUED FOR PERMIT	2023.05.16
NO.	ISSUES/REVISIONS	DATE


FURNITURE,

DRAWING TITLE:

SCHEDULES

	•
ISSUE DATE:	2023.09.06
DRAWN BY: MM	CHECKED BY: SL
PROJECT NO.: 12228	SCALE: AS NOTED
DRAWING NO :	I DEVISION:

A05.05

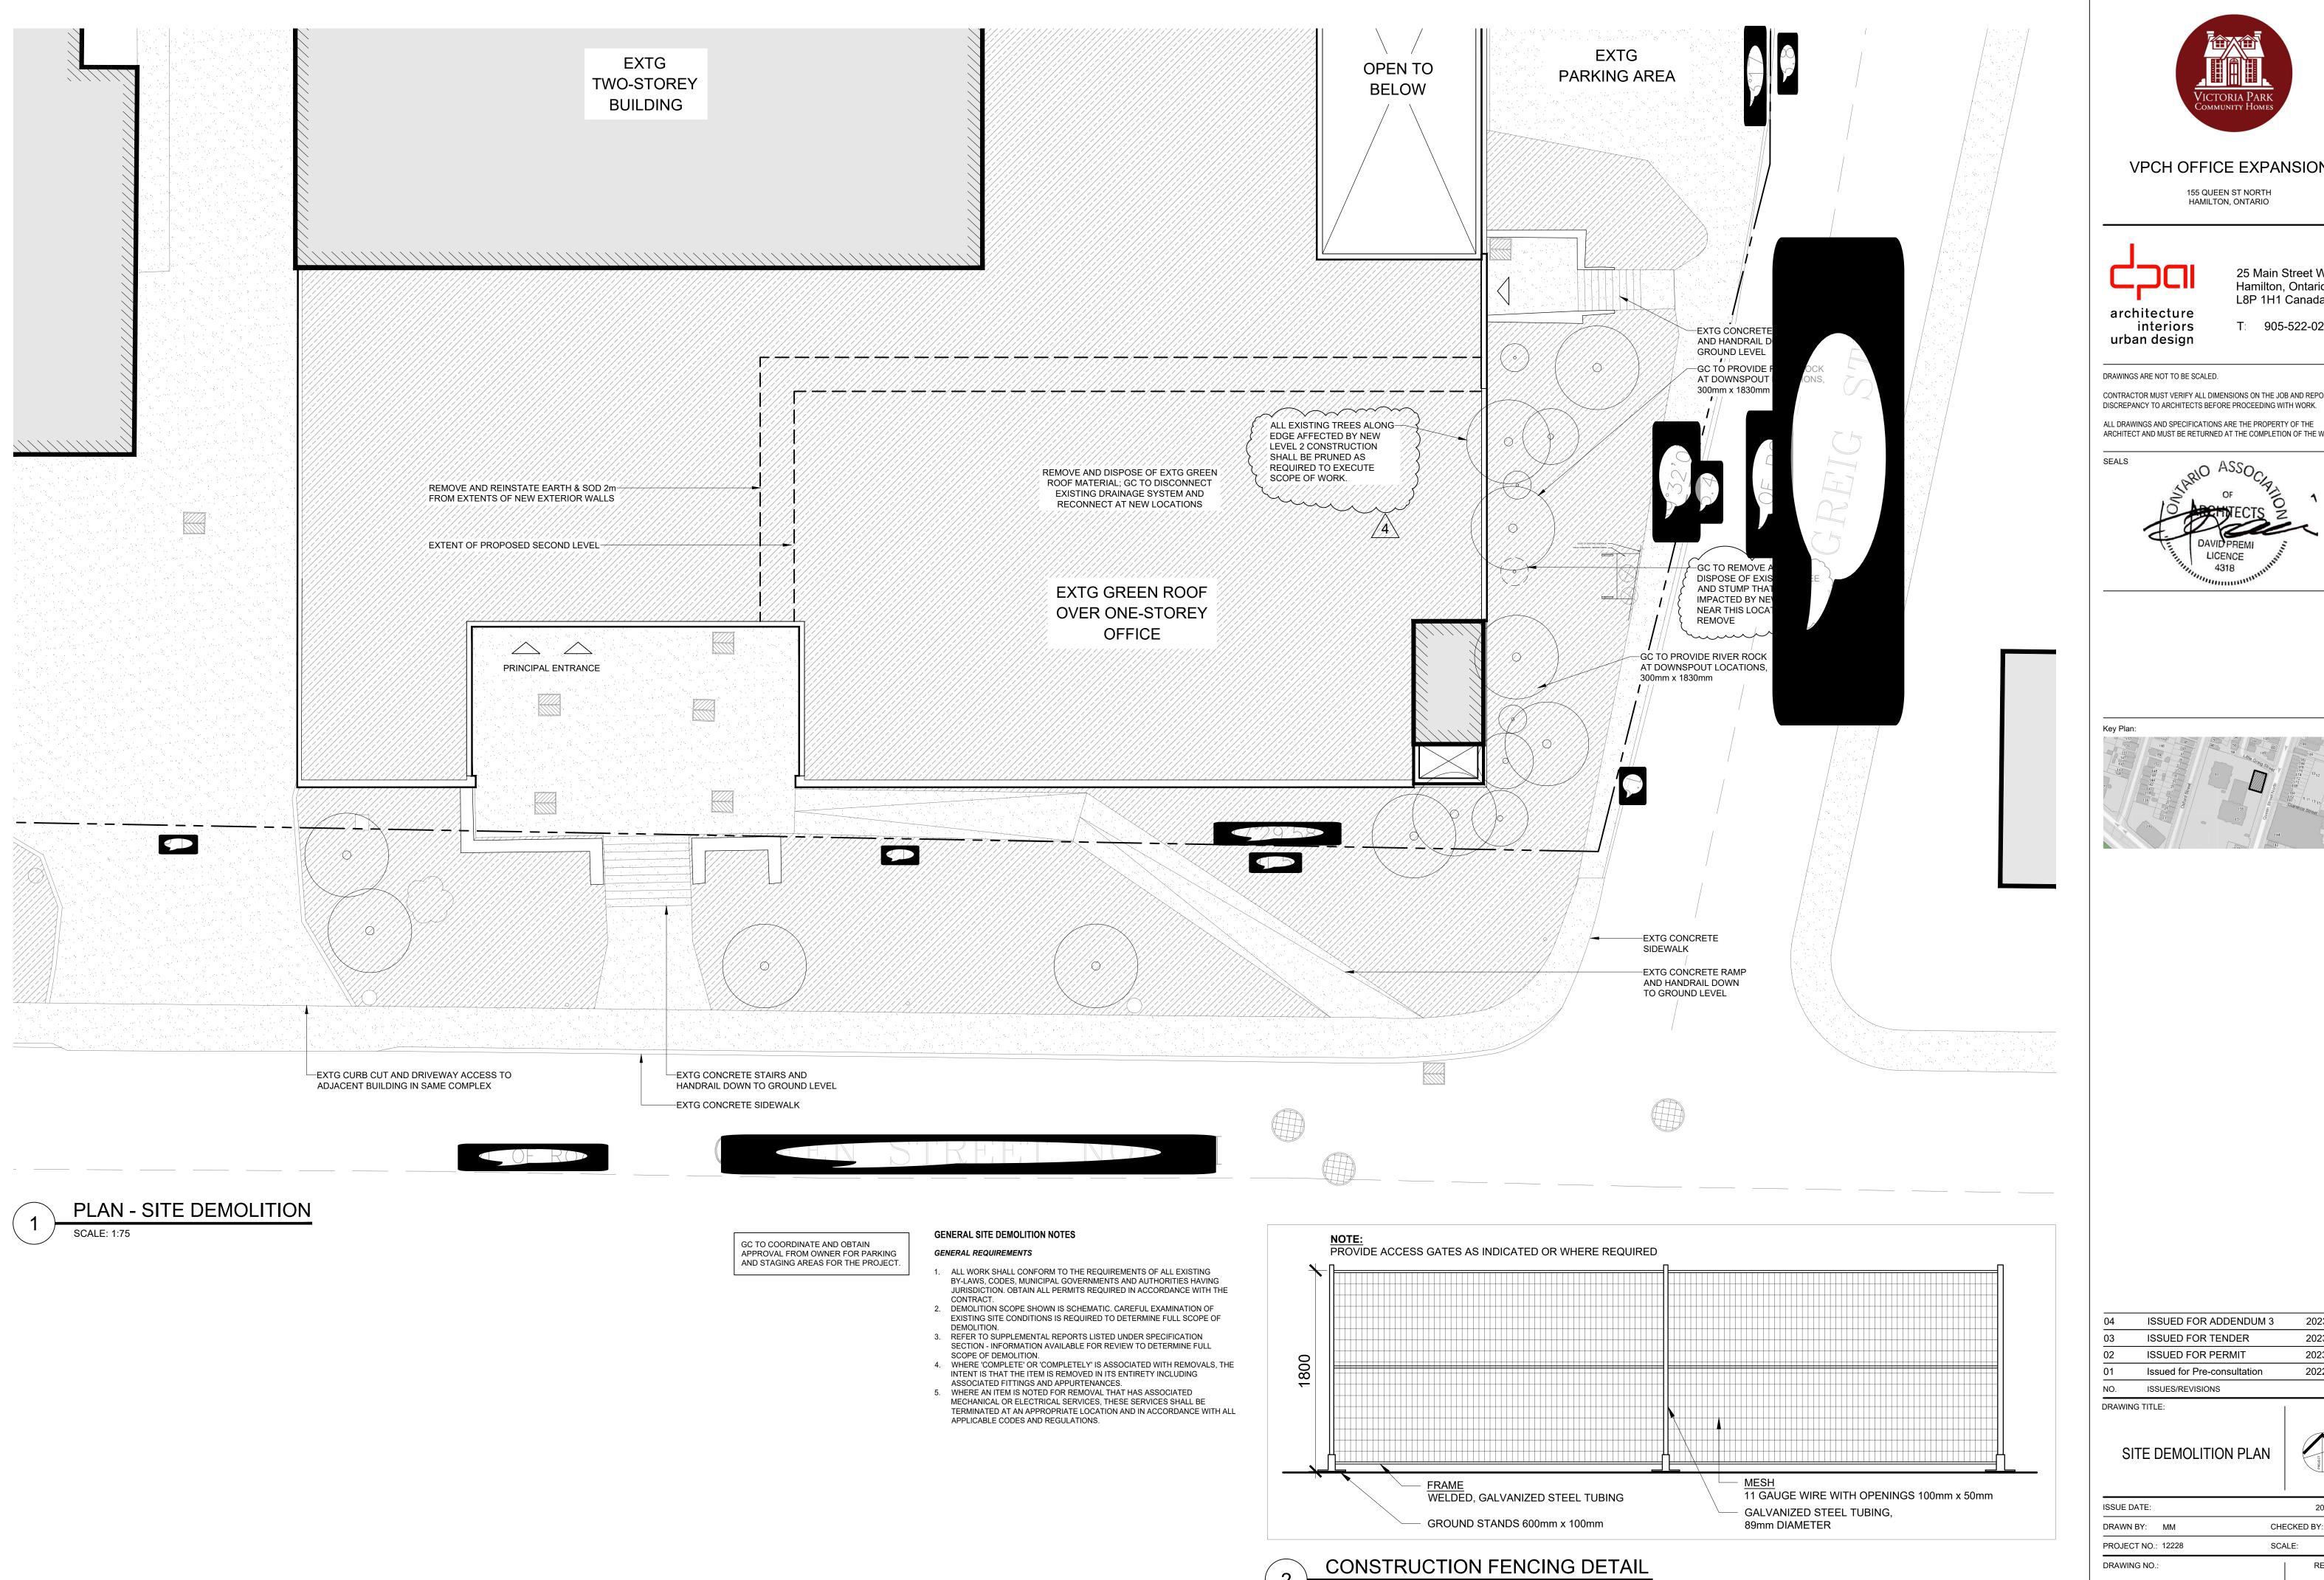



155 QUEEN ST NORTH HAMILTON, ONTARIO




25 Main Street West Hamilton, Ontario L8P 1H1 Canada

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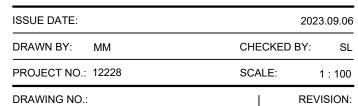
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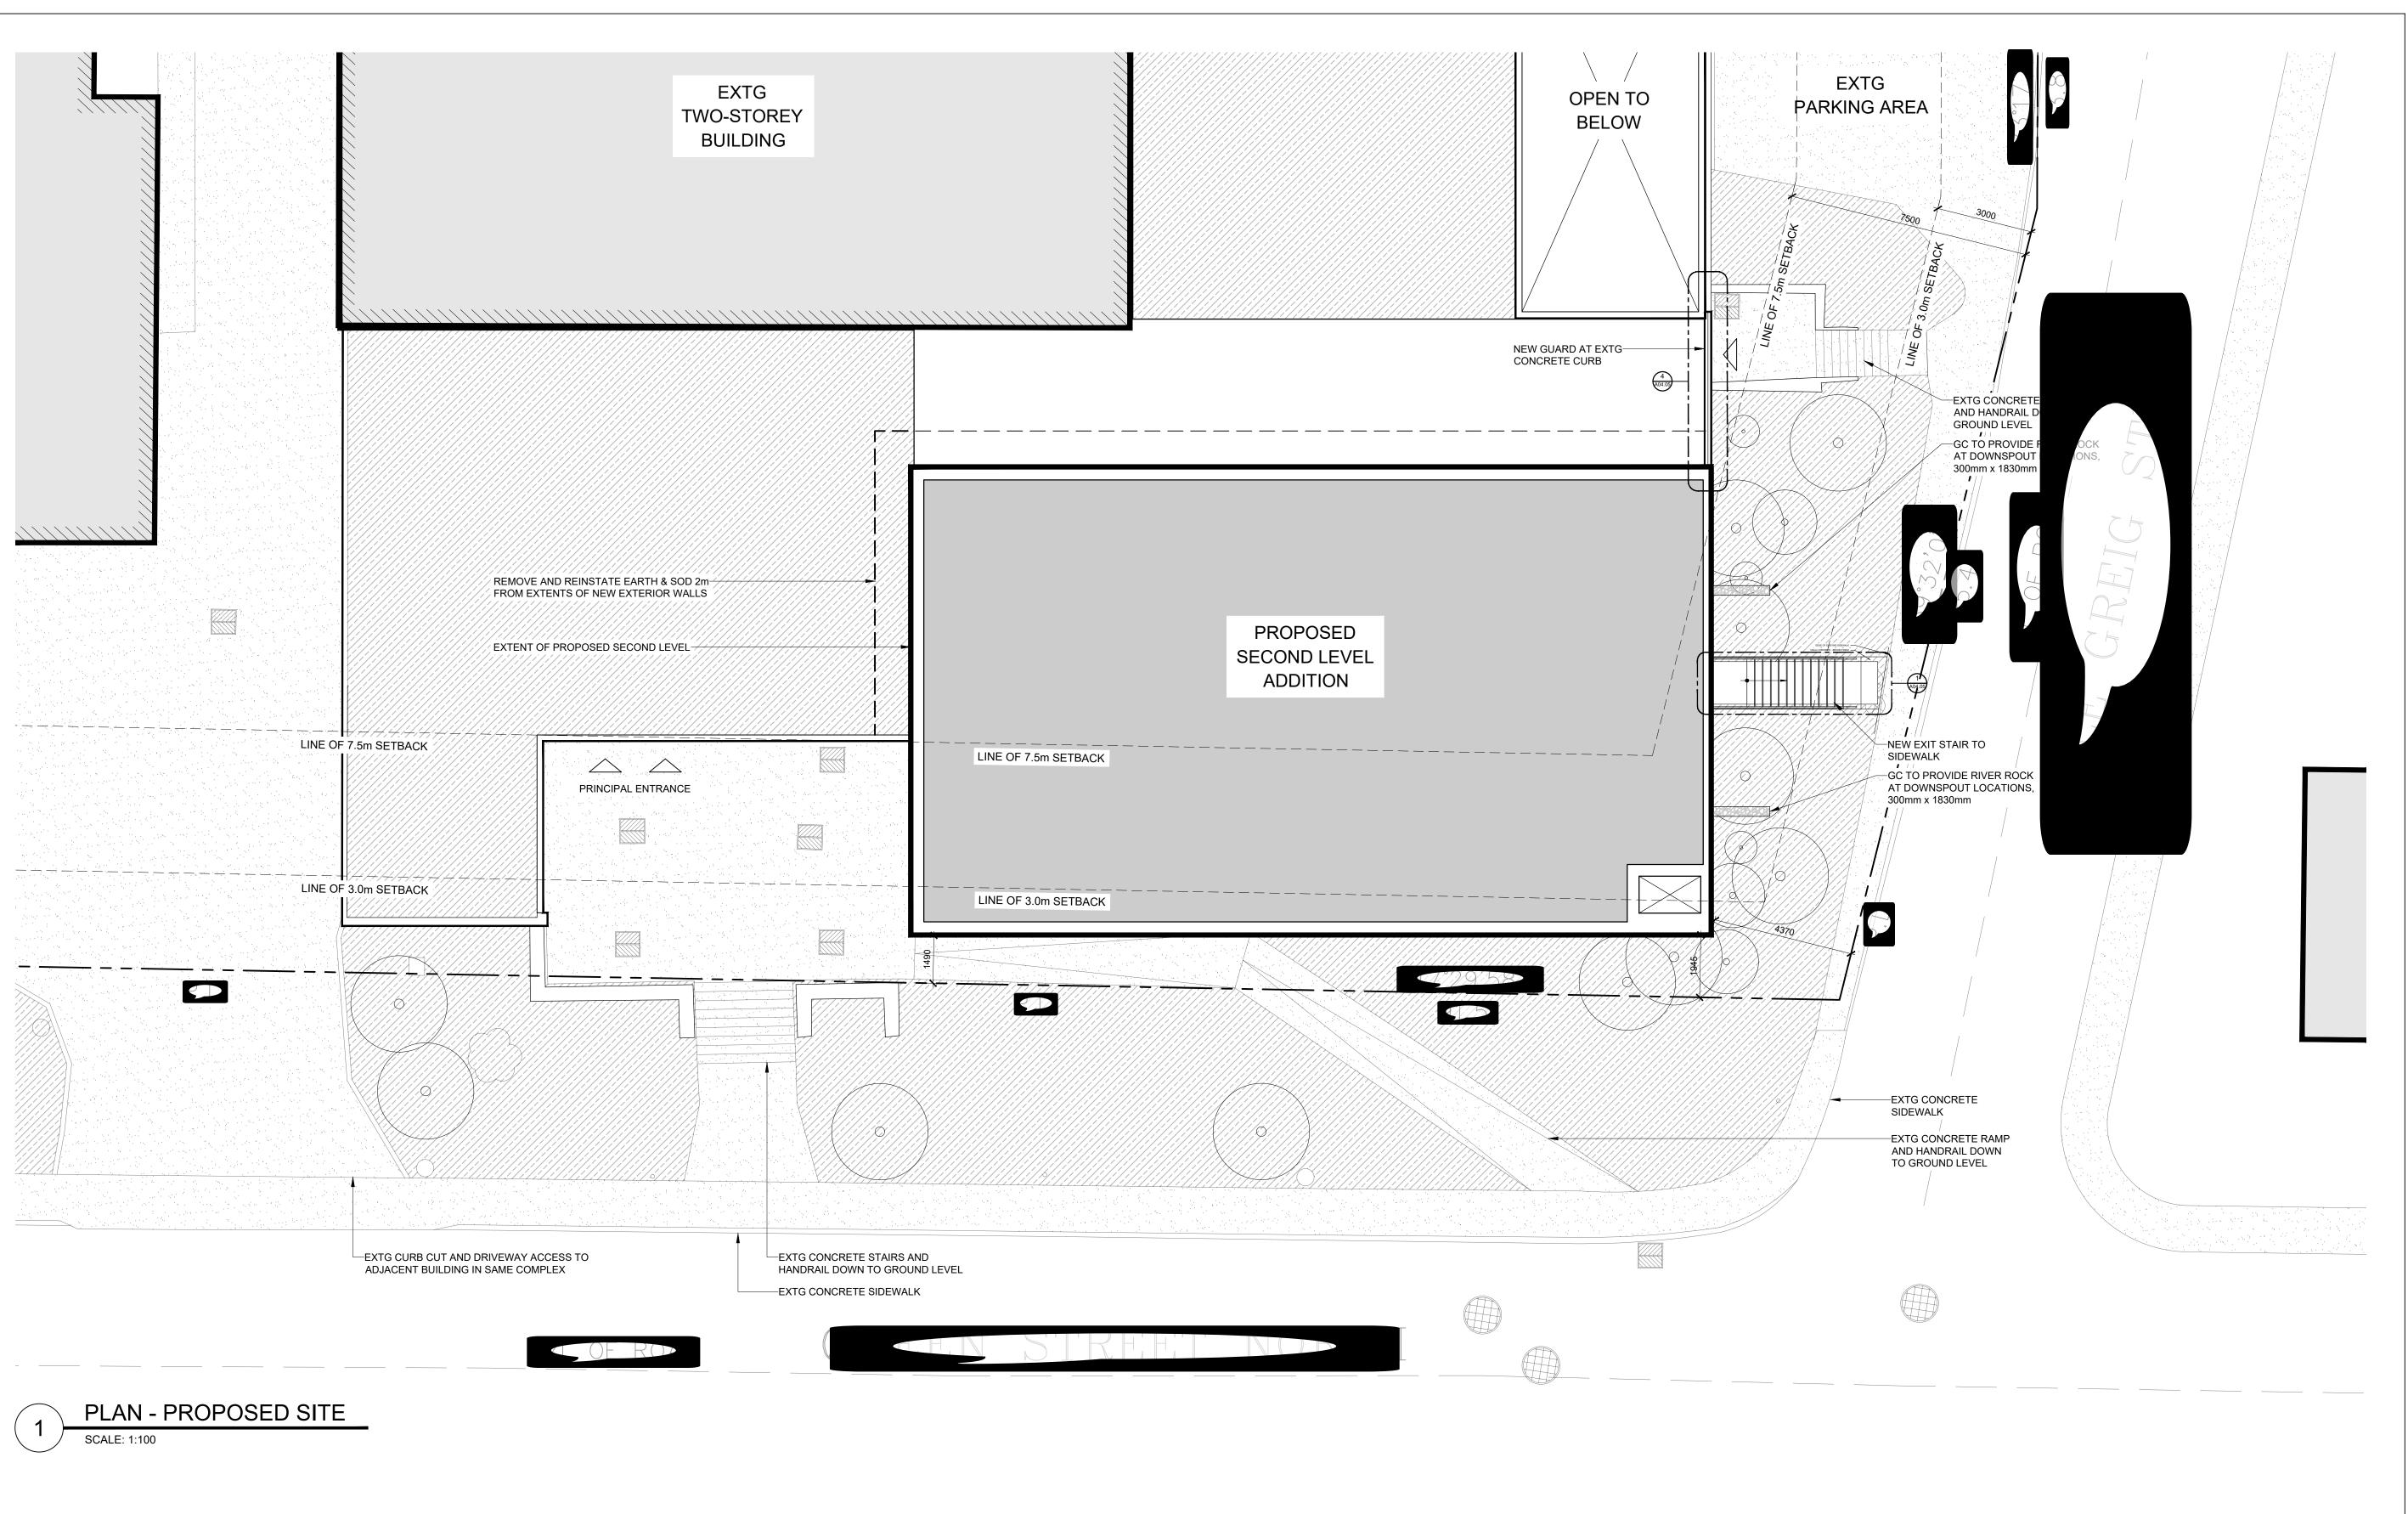
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ISSUED FOR ADDENDUM 3 2023.10.06 2023.09.06 ISSUED FOR TENDER ISSUED FOR PERMIT 2023.05.16 Issued for Pre-consultation 2022.10.07 ISSUES/REVISIONS DATE

SITE DEMOLITION PLAN



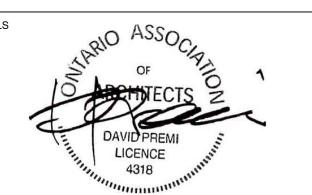

PROJECT SITE STATISTICS DATA

LANDSCAPED AREA %

FRONT YARD LANDSCAPE AREA

GREEN ROOF AREA

HARDSCAPED AREA

PAVED AREA

ZONING INFORMATION ZONING BY-LAW 6593 Former Hamilton - 19-307 ZONING CODE E-3 / S-138 PERMITTED USES High Density Multiple Dwellings LOT AND PLAN NUMBER Part of Lot 1 of Sir Allan McNab Survey (unregistered), and Lot A of Plan 233 LOT REQUIREMENTS DESCRIPTION **EXISTING** PROPOSED LOT AREA 11,792 m2 NO CHANGE LOT FRONTAGE 102.77 m2 NO CHANGE LOT COVERAGE % 17.9 % 20.9 %

49.5 %

1,114.58 m2

242.50 m2

3,844 m2

46.4 %

751.58 m2

3,481 m2

NO CHANGE

PRINCIPAL BUILDING REQUIREMENTS PROPOSED DESCRIPTION 6.46 m (FROM EST. GRADE) BUILDING HEIGHT MAX. 26.0 m FLOOR AREA RATIO BUILDING FOOTPRINT NO CHANGE GROSS FLOOR AREA 848 m2 ESTABLISHED GRADE (AVG. CURB) 96.03 m NO CHANGE

BUILDING TO PROPERTY LINE SETBACKS DESCRIPTION **PROPOSED** FRONT YARD SETBACK (QUEEN ST N) 1.49 m (NO CHANGE) STREET LINE S.Y.S. (LITTLE GREIG ST) 4.37 m (NO CHANGE) 3.0 m REAR YARD SETBACK (TO OXFORD ST) NO CHANGE 3.0 m SIDE YARD SETBACK 1.5 m NO CHANGE

SITE PLAN GENERAL NOTES:

- 2. CONTRACTOR SHALL CO-ORDINATE ALL WORK NOTED HERE WITH THE SPECIFICATION DOCUMENTS - FOR GENERAL REQUIREMENTS, EXISTING CONDITIONS, EXCAVATION & BACKFILLING, LANDSCAPING, ETC AS REQUIRED FOR COMPLETE
- SITE RELATED WORK. 3. THE CONTRACTOR SHALL BE RESPONSIBLE FOR MAINTAINING ADEQUATE RECORDS OF CONSTRUCTION TO FACILITATE AS-BUILT DRAWINGS.
- 2. PROJECT BOUNDARIES
- 1. THE CONTRACT CONSISTS OF ALL WORK WITH-IN THE 'PROPERTY LINE' AND/OR 'SITE EXTENTS' LINE AS INDICATED PLUS ANY WORK SPECIFICALLY NOTED OUTSIDE OF THAT LINE OR AS REQUIRED TO DELIVER A OPERATIONAL, FUNCTIONING PROJECT. 2. THE TERM 'SITE EXTENTS' REFERS TO THE AREA THAT THE
- CONTRACTOR IS REQUIRED TO ENCLOSE WITH CONSTRUCTION FENCING FOR THE DURATION OF THE WORK. 3. ALL WORK DONE OUTSIDE OF THESE LIMITS MUST BE EXECUTED IN STRICT ACCORDANCE WITH THE STANDARDS OF THE MUNICIPALITY AND ALL OTHER AUTHORITIES HAVING JURISDICTION. MAKE GOOD AT NO ADDITIONAL COST TO THE OWNER OR MUNICIPALITY ANY DAMAGE CAUSED BY THIS CONSTRUCTION TO MATERIALS OR FINISHES BEYOND THE "PROPERTY LINE" INDICATED.
- 1. CONTRACTOR IS TO RESTRICT ALL WORK, EQUIPMENT AND MATERIALS STORAGE TO AREA(S) WITHIN THE "PROPERTY LINE" EXCEPT WHERE NOTED OTHERWISE. PRIMARY SITE ACCESS POINT & CONSTRUCTION PARKING IS TO BE CONFIRMED WITH
- LOCATE EXCAVATED MATERIALS & TOPSOIL PILES SO AS NOT TO IMPEDE PROGRESS OF THE WORK OR AS DIRECTED. 'DOUBLE HANDLING' OF MATERIALS AS A RESULT OF CONTRACTOR PLANNING OR EXECUTION OF THE WORK WILL NOT BE CONSIDERED AS A BASIS FOR CLAIM. AT COMPLETION OF THE PROJECT, ANY EXCESS MATERIAL IS TO BE REMOVED AND AREA MADE GOOD TO CONSULTANTS SATISFACTION.

OWNER. NO PARKING IS PERMITTED IN THE MUNICIPAL

RIGHT-OF-WAY.

FOR TRENCHING & BACKFILLING OF ALL SERVICE LINES AND DIVISION OF RESPONSIBILITY REFER TO APPROPRIATE SPECIFICATION SECTIONS AND DRAWINGS. TRENCHING & BACKFILLING NOT IDENTIFIED BY A PARTICULAR SUB-TRADE WILL BE THE RESPONSIBILITY OF THE GENERAL CONTRACTOR TO PROVIDE TRENCHING AND BACKFILLING. GRADE FINISHED WORK

TO MATCH SURROUNDING SURFACES.

- LOCATION OF SERVICES 1. NOTE THAT THE EXACT LOCATIONS OF ALL NEW MECHANICAL & ELECTRICAL ITEMS ARE APPROXIMATE UNLESS DIMENSIONS ARE GIVEN. ADJUST LOCATIONS AS REQUIRED AND AS APPROVED BY CONSULTANT TO SUIT SITE CONDITIONS.
- 2. NOTE THAT ALL MECHANICAL AND ELECTRICAL UNDERGROUND AND ABOVEGROUND SERVICE LINES INDICATED ON DRAWINGS ARE APPROXIMATE ONLY AND ARE INDICATED AS ACCURATELY AS POSSIBLE FROM INFORMATION SUPPLIED. CONTRACTOR SHALL BE RESPONSIBLE FOR DETERMINING EXACT TYPES, LOCATIONS, DEPTHS AND MARKING ALL UNDERGROUND AND ABOVEGROUND SERVICES WITHIN ALL AREAS OF CONSTRUCTION. THIS INCLUDES, BUT IS NOT LIMITED TO GAS LINES, WATER LINES, ELECTRICAL LINES, TELEPHONE, CABLE TV ETC. VERIFY EXACT
- LOCATIONS WITH THE APPROPRIATE AUTHORITIES BEFORE EXCAVATING. PRIOR TO COMMENCING WORK TO PLACE VERTICAL ELEMENTS SUCH AS FLAGPOLES AND LIG CLEARANCE FROM EXIST AS OVERHEAD WIRES CAR ANY DISCREPANCIES PRIC 4. ALL FINISHED PAVING AND SHOWN. ALL DRAINAGE TO FINISHED GRADE. FINISHE

SHOWN OTHERWISE. NEW GRADES TO MEET EXISTING GRADES

FALLING AWAY FROM BUILDING AND FEATHERED OUT EVENLY.

SUCH AS FLAGPOLES AND LIGHT STANDARDS ENSURE ADEQUATE	
CLEARANCE FROM EXISTING ABOVE GROUND ELEMENTS SUCH	FOOLIGED CITE
AS OVERHEAD WIRES CABLES ETC. NOTIFY THE CONSULTANT OF	FOCUSED SITE
ANY DISCREPANCIES PRIOR TO COMMENCEMENT OF WORK.	0 0-1-0-
ALL FINISHED PAVING AND GRADING TO BE TO NEW LEVELS	SITE STATIST
SHOWN. ALL DRAINAGE TO BE POSITIVE, LEAVING NO POCKETS IN	
FINISHED GRADE. FINISHED GRADING TO SLOPE MINIMUM 1:12	
AND ASPHALT TO SLOPE MAX 1:10 AWAY FROM BUILDING UNLESS	
011011111 07117011107 117111 0717070 7017071110 071707	

04	ISSUED FOR TENDER	2023.09.06
03	PERMIT REVISION 01	2023.07.20
02	ISSUED FOR PERMIT	2023.05.16
01	Issued for Pre-consultation	2022.10.07
NO.	ISSUES/REVISIONS	DATE

VPCH OFFICE EXPANSION

155 QUEEN ST NORTH HAMILTON, ONTARIO

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interiors

DRAWINGS ARE NOT TO BE SCALED.

urban design

25 Main Street West

Hamilton, Ontario

L8P 1H1 Canada

T: 905-522-0220

DRAWING TITLE:

		I				
UE DATE:	JE DATE: 2023.09.06					
AWN BY:	MM	CHECKED BY:	SL			
OJECT NO.:	12228	SCALE:	1:100			



Project Name: VPCH Office Expansion **MTE File No.:** 50596-200

Client: VPCH Date: October 05, 2023


Client File No: Addendum No.: 001

This Addendum forms part of the Contract Documents and amends the original Drawings, issued September 06, 2023, as noted below.

This Addendum consists of 2 (two) page (s).

Item 1	Welded Wire Mesh for Composite Slab
Drawing	1. Added plan note 10. to indicate the required reinforcing for the composite
S1.03	concrete floor slab.

End of Addendum 001

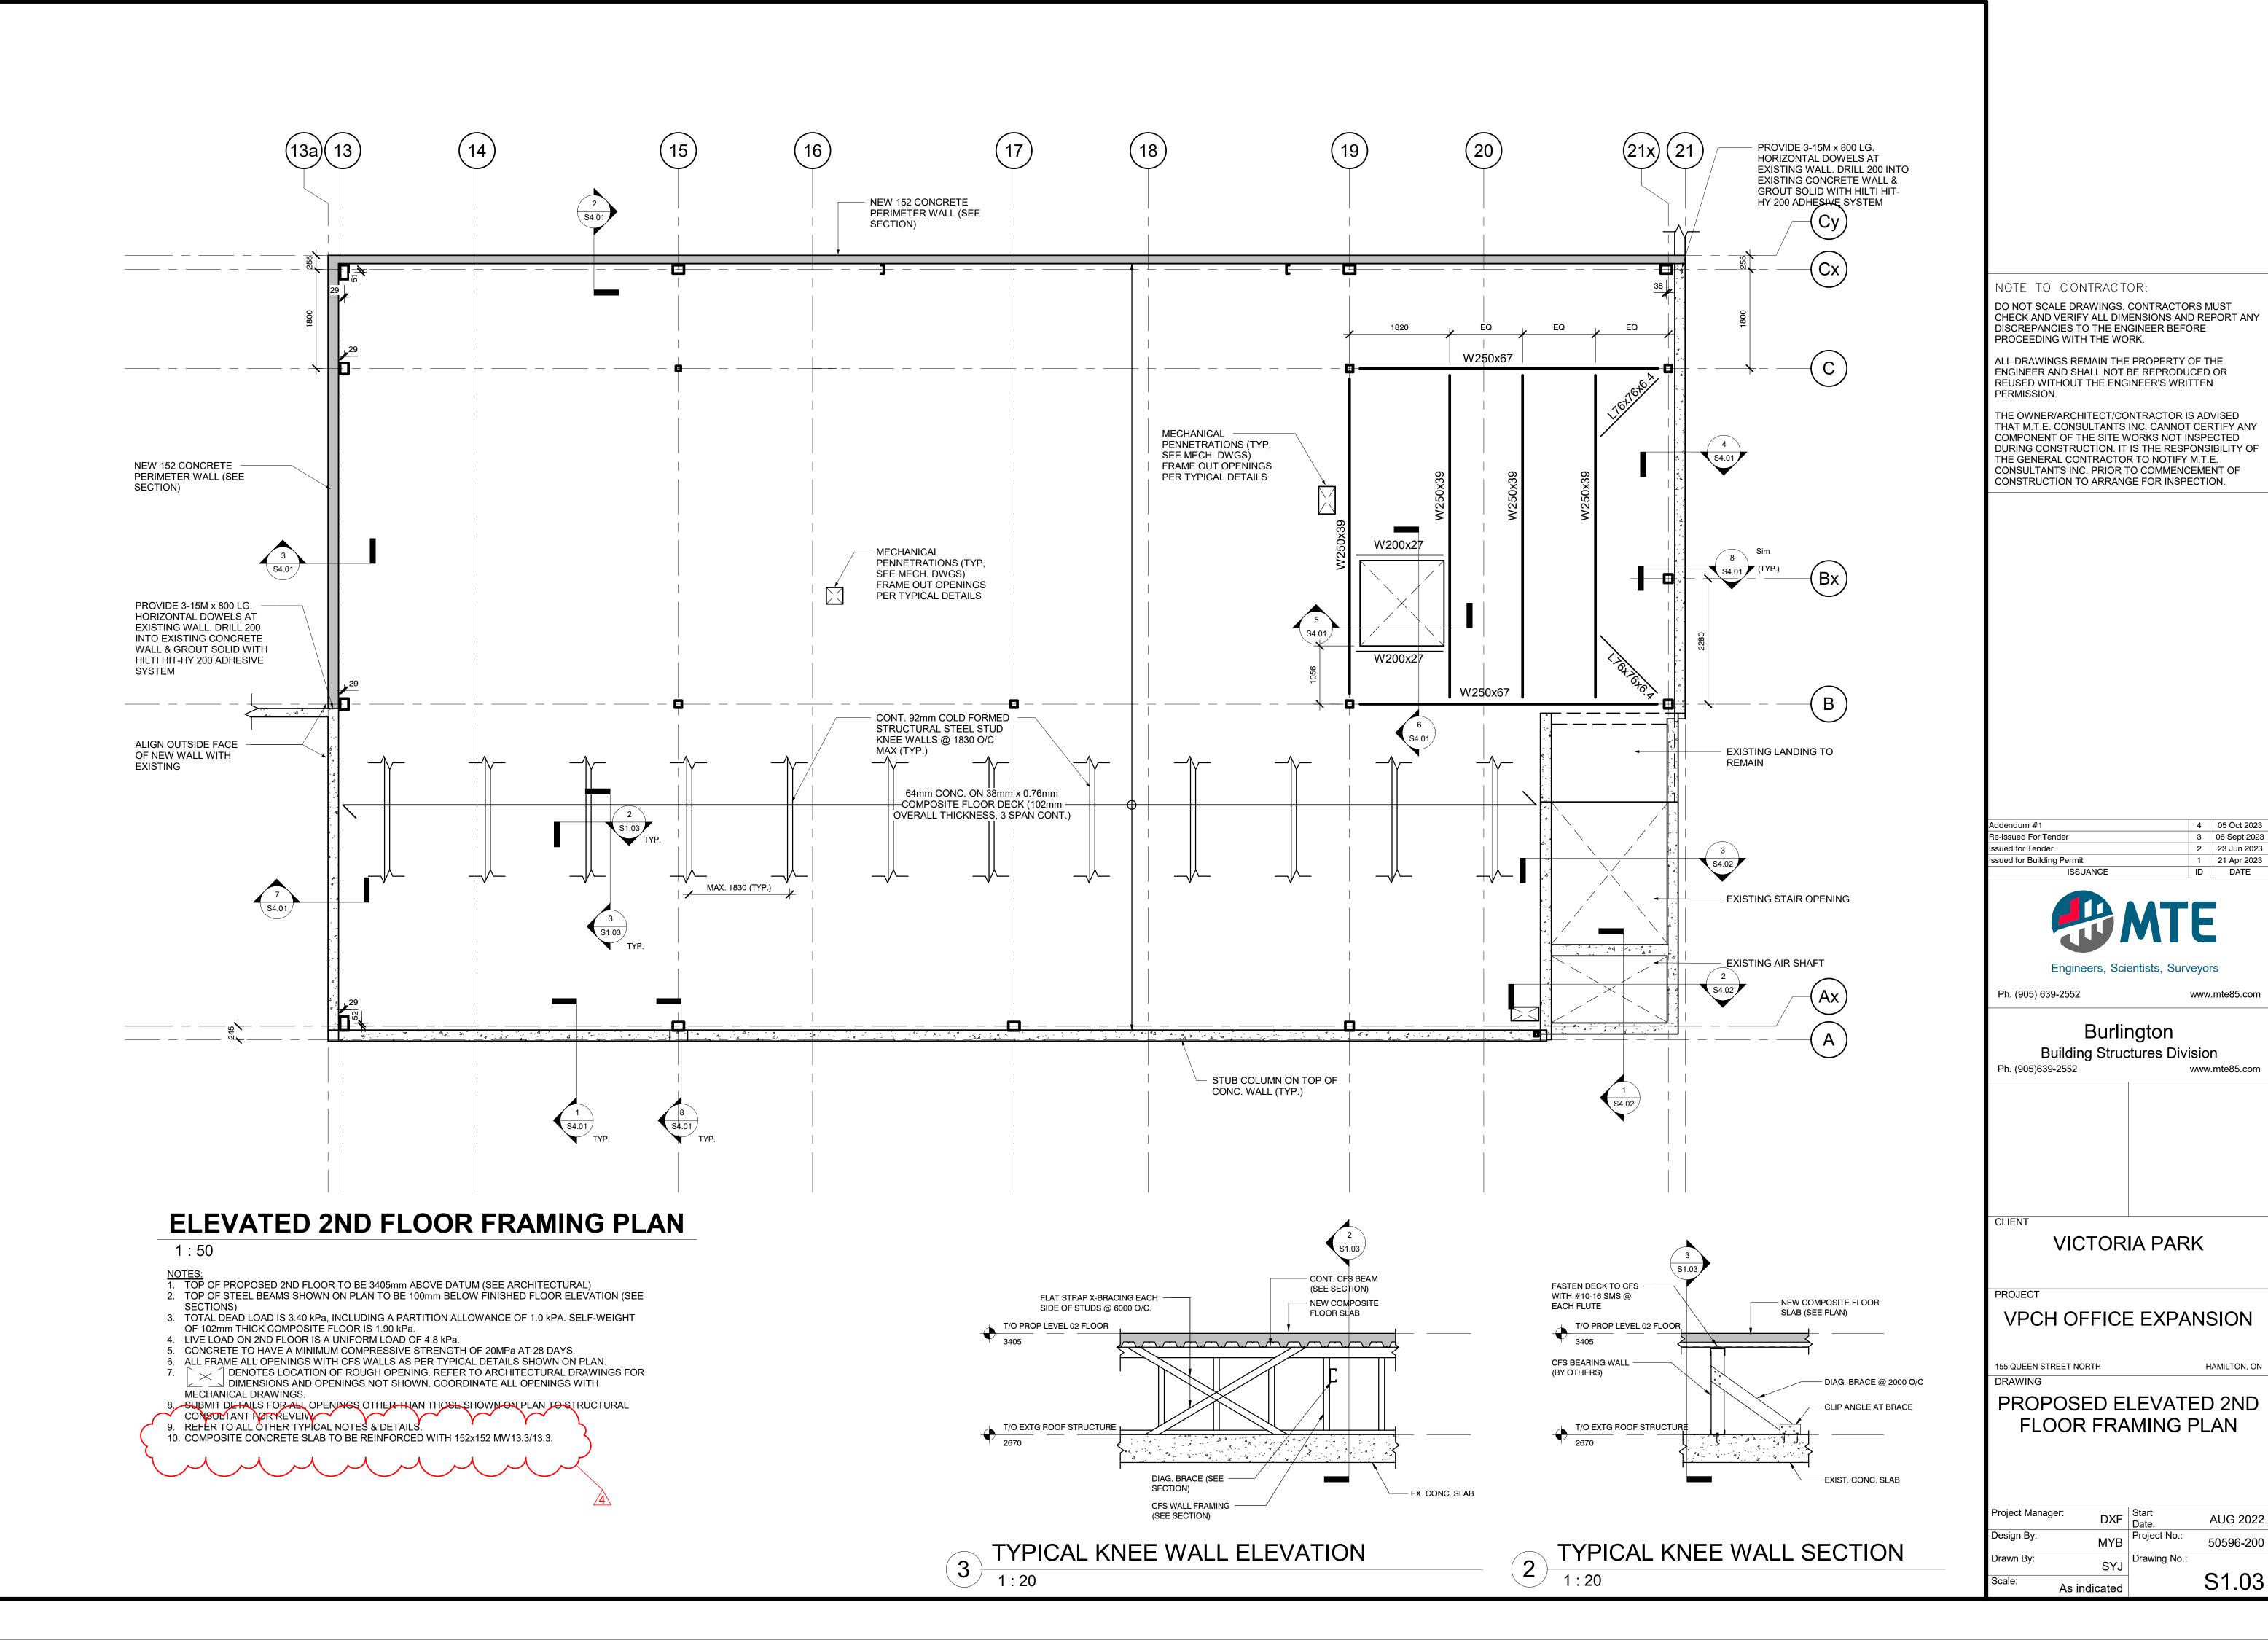



Addendum

Date: October 3, 2023

Queen's Quay Terminal 207 Queen's Quay West, Suite 615 Toronto, Ontario M5J 1A7 Phone 416-598-2920 Fax 416-598-5394 www.mcw.com

Project Name: VPCH Office Expansion

Client: VPCH
To: DPAI Architecture Interiors Urban Design
ADD #: 001
Attention: Sebastian Lubczynski
Page #: 1 of 1

From: Canh Le + Attachment

Distribution: sebastian@dpai.ca

In accordance with the drawings and specifications, provide in the tender all costs required to complete the work including items as listed below.


Title: Add-001

Reason for Change: Response to electrical questions and lighting layout revision

Electrical Drawings:

Drawing #	Revisions
E1-02	 Revise lighting layout at the corridor and open office 120. Add wall sconces type L7 and associated 0-10V dimmer in reception area.
E1-03	Revise lighting layout at corridor 212, print station 209 and open office 203.
E1-04	Update floor box specification in meeting room 107.
E5	 Update lighting fixture schedule. Delete fire alarm notes 1.2 & 1.3 on drawing E5. Provide 2-hrs fire rated cable between existing and new fire alarm control panel.

End of ADD # 001

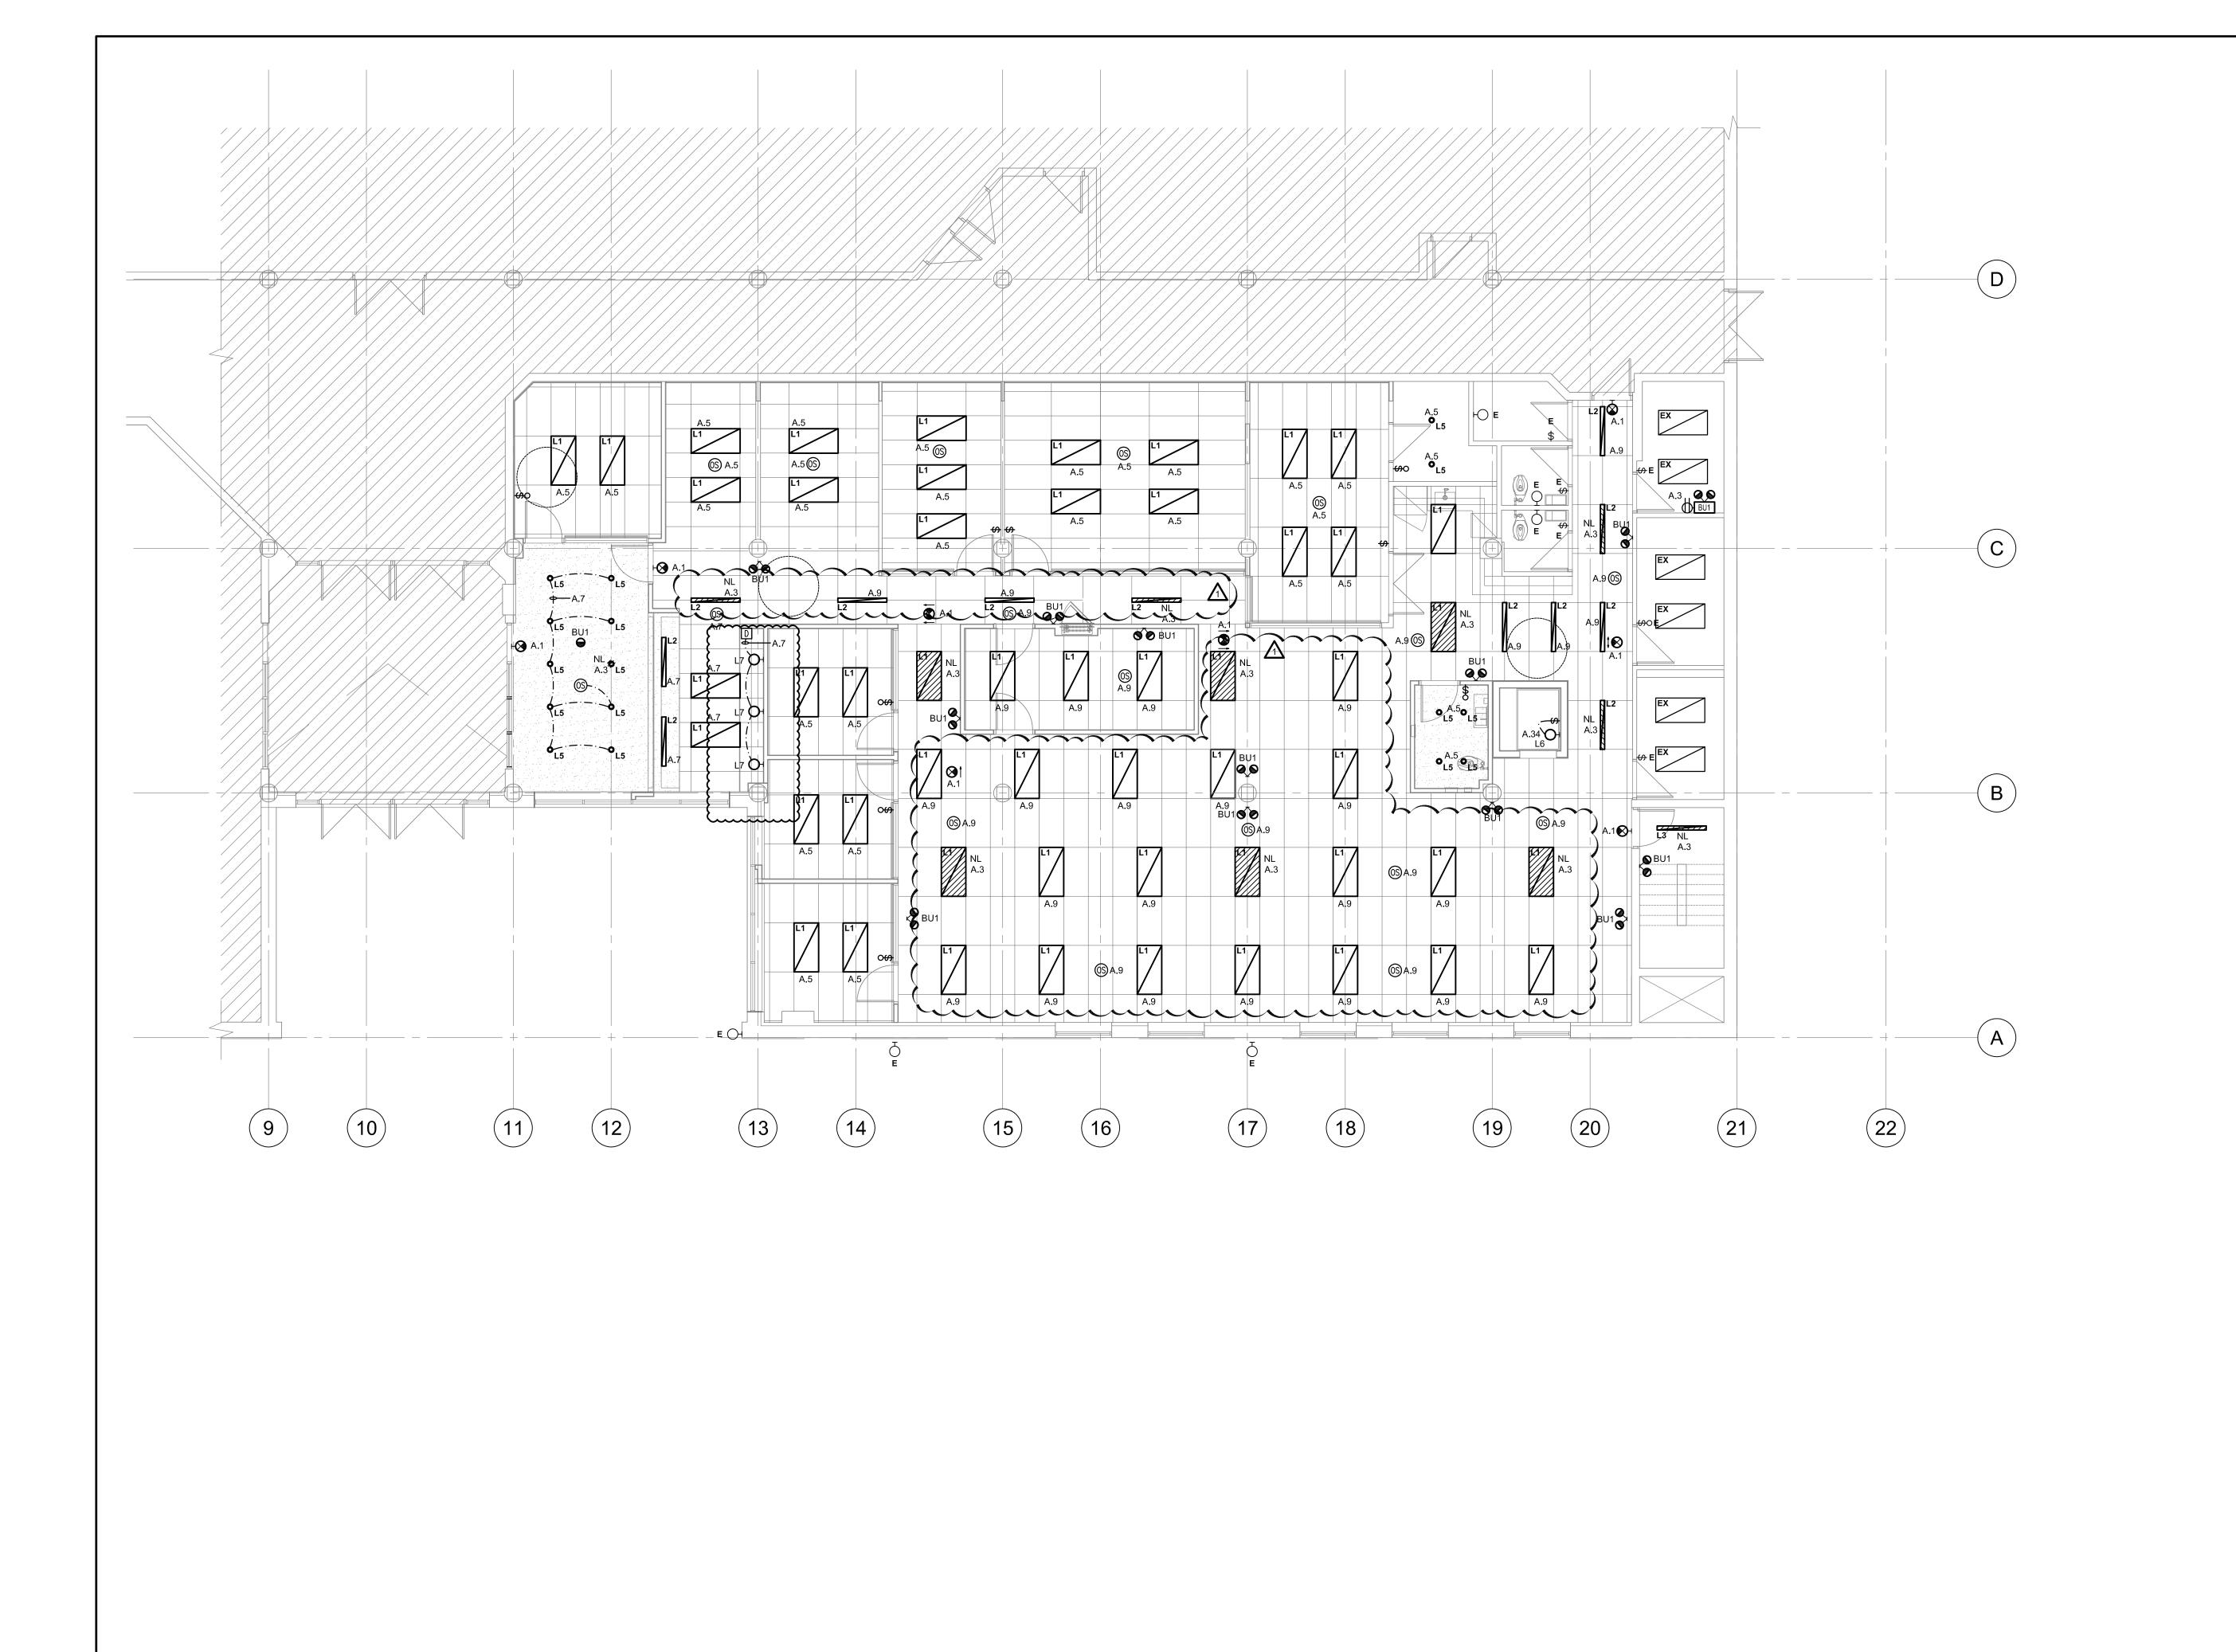



155 QUEEN ST NORTH HAMILTON, ONTARIO



25 Main Street West Hamilton, Ontario L8P 1H1 Canada

T: 905-522-0220

MCW Consultants Ltd.
207 Queen's Quay West, Suite 615, Toronto, ON, M5J 1A7
E-Mail: mcw_tor@mcw.com www.mcw.com
Tel: 416-598-2920 Fax: 416-598-5394
Toronto Vancouver Winnipeg Moncton Ottawa Halifax
Dauphin Kelowna Trail Saint John

 05
 Issued for ADD-001 ⚠
 2023.10.03

 04
 Issued for Tender
 2023.09.08

 03
 Issued for Building Permit
 2023.04.21

 02
 Issued for Review
 2023.03.03

 01
 Issued for Review
 2022.11.23

 No.:
 Issues / Revisions
 YYYY.MM.DD

LEVEL 01 LIGHTING PLAN OFFICE

Issue Date:		20
Drawn By.:	TL	Checked By:
Project No.:	21424	Drawing Scale:



ng No.:





155 QUEEN ST NORTH

HAMILTON, ONTARIO

2



25 Main Street West Hamilton, Ontario L8P 1H1 Canada T: 905-522-0220


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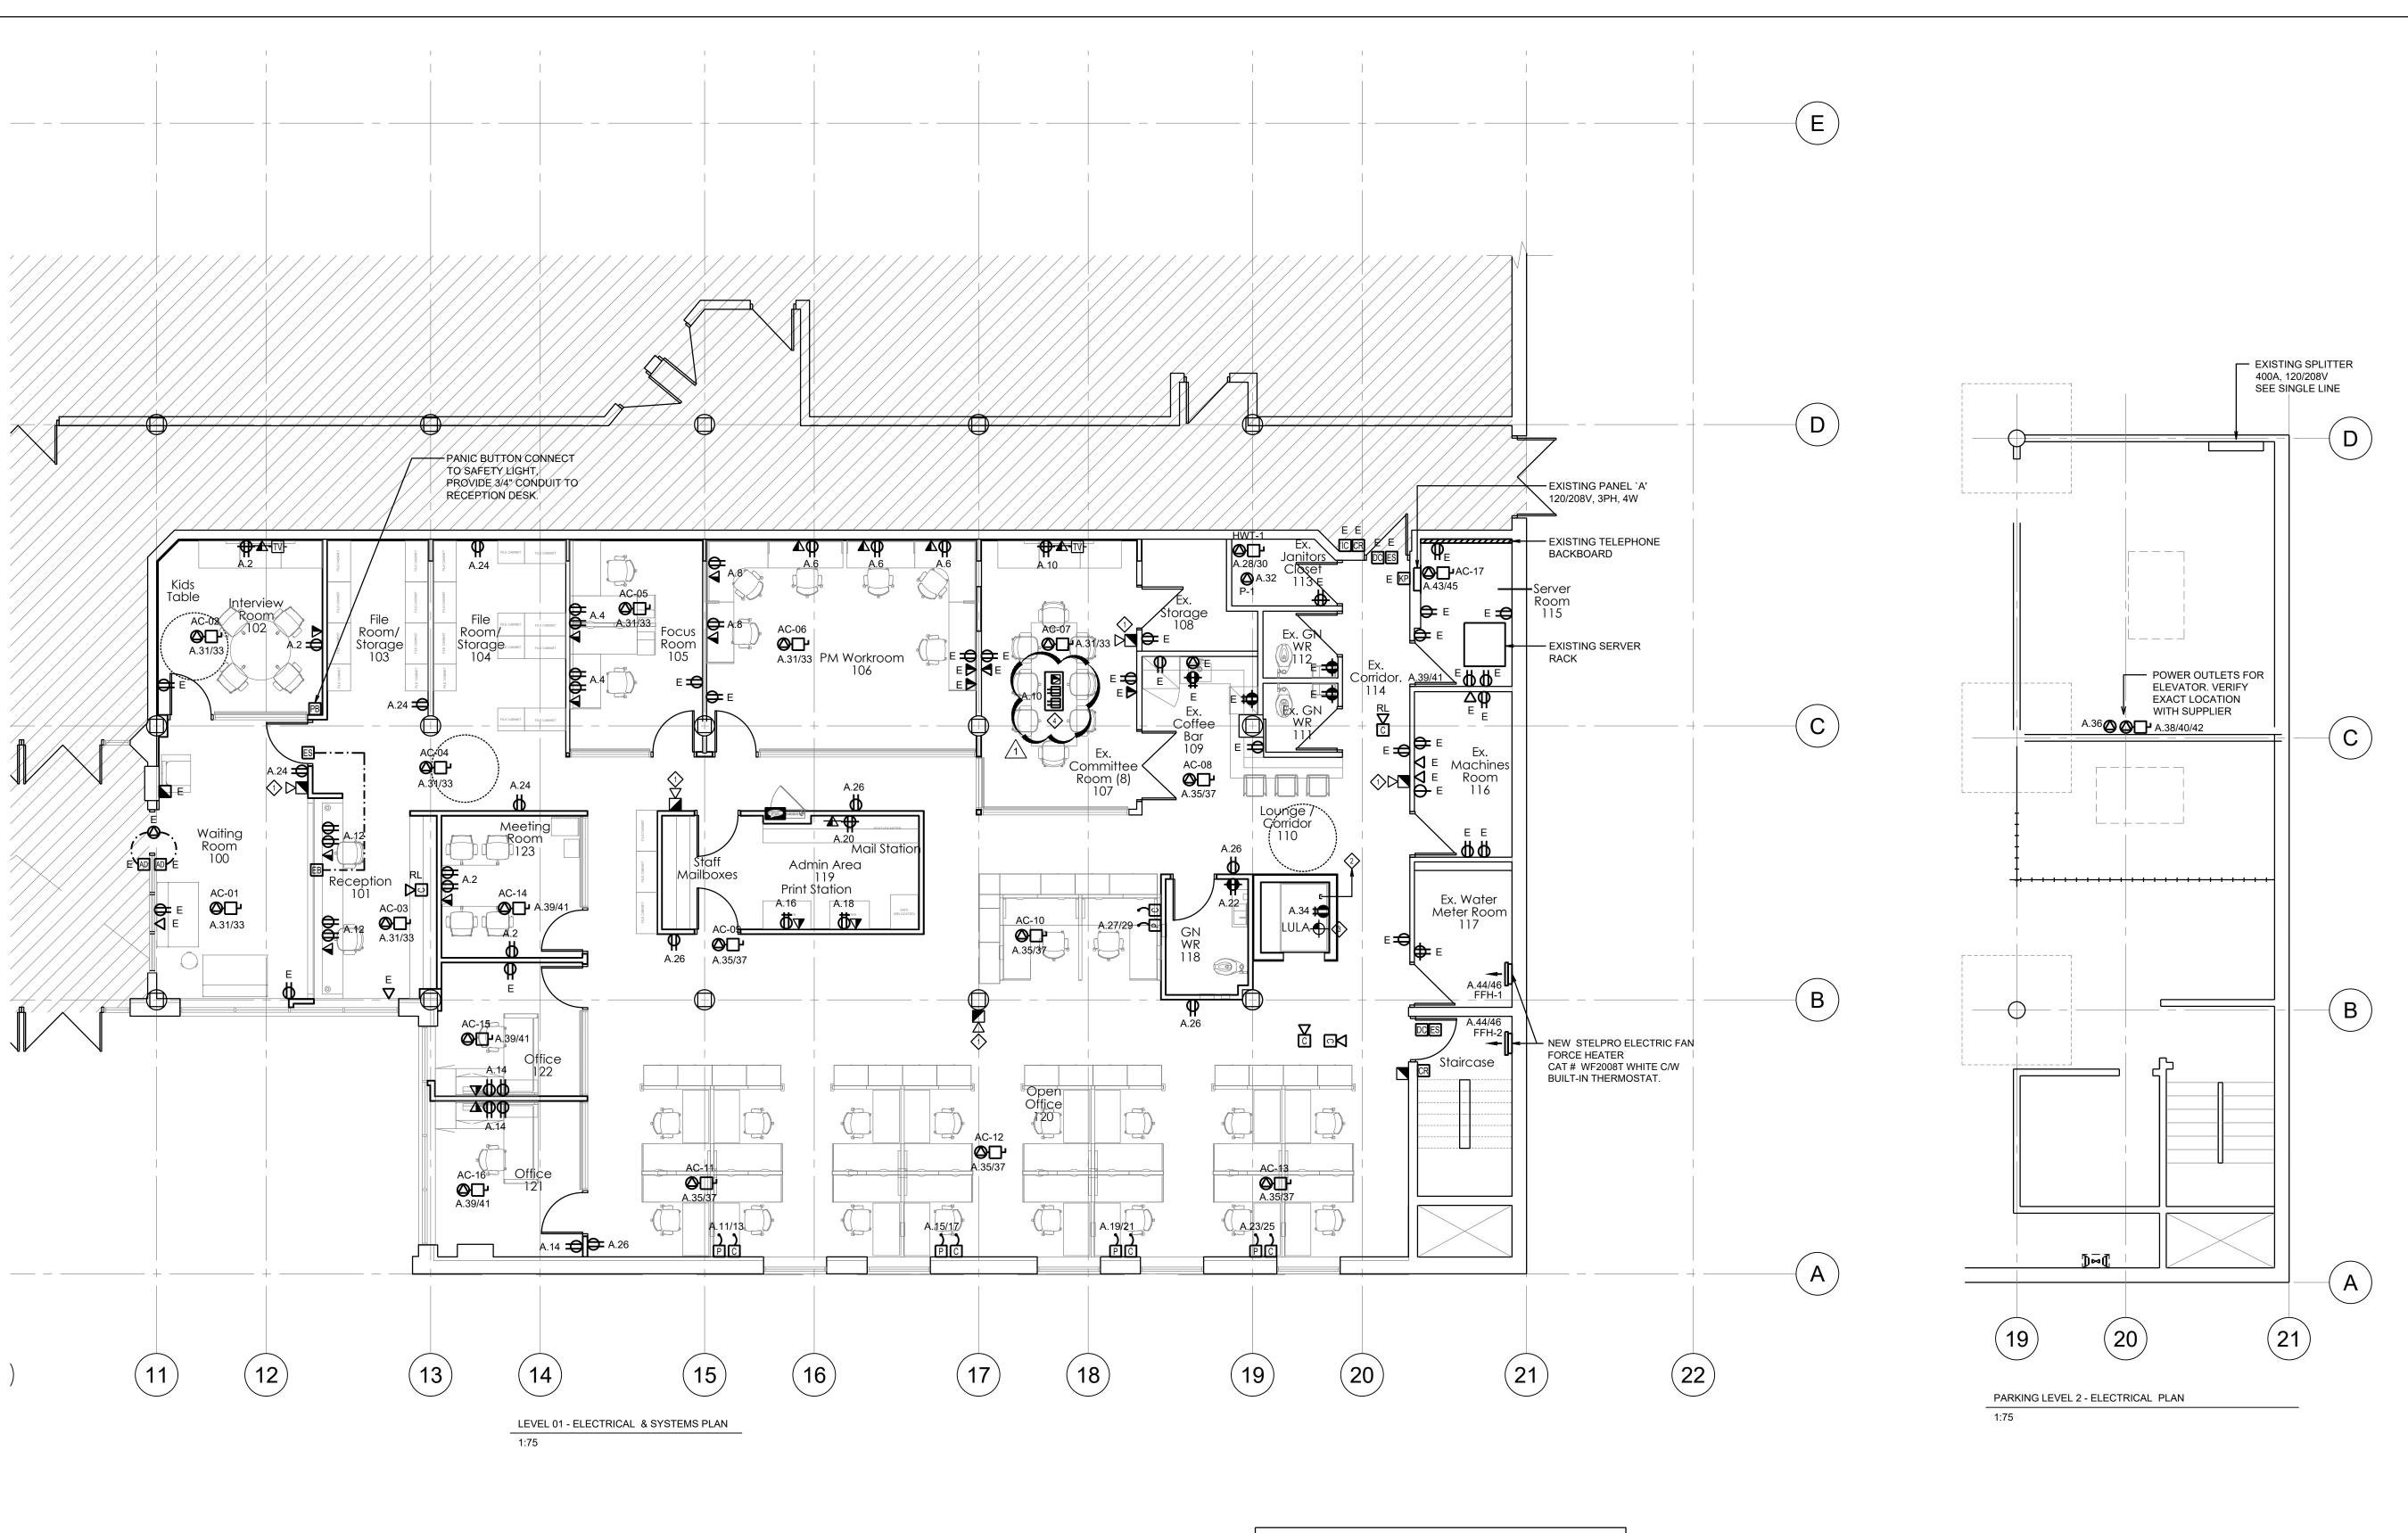
05	Issued for ADD-001 🔨	2023.10.0
04	Issued for Tender	2023.09.0
03	Issued for Building Permit	2023.04.2
02	Issued for Review	2023.03.0
01	Issued for Review	2022.11.2
No.:	Issues / Revisions	YYYY.MM.E


LEVEL 02 LIGHTING PLAN OFFICE

Issue Date: 202		3.06.23	
Drawn By.:	TL	Checked By:	CL
Project No.:	21424	Drawing Scale:	1 : 75



E1-03

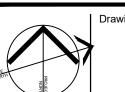

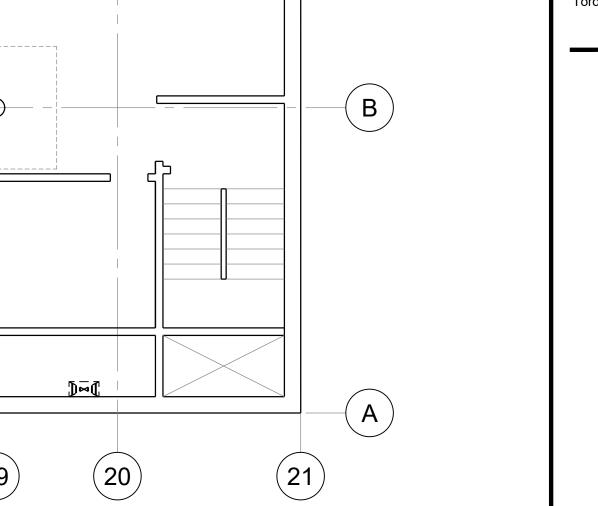

KEY NOTES:

- CONNECT NEW FIRE ALARM HORN TO BASE BUILDING FIRE ALARM HORN CIRCUIT, TYPICAL.
- PROVIDE 1" CONDUIT TO TELEPHONE ROOM FOR COMMUNICATIONS SERVICE.
- CONNECT NEW FIRE ALARM DEVICE IN ELEVATOR SHAFT TO NEW INITIATING ZONE AS INDICATED ON FIRE ALARM RISER ON
- DRAWING E5.

HUBBELL FIRE RATE POKE THROUGH COMPLETE WITH DEVICES HUBBELL FIRE RATE POKE THROUGH COMPLETE WITH DEVICE AS INDICATED, COORDINATE FINAL COVER STYLE AND FINISH SUITABLE FOR FLOOR TOPPING WITH ARCHITECT. HUBBELL CAT# S1R6PTFIT SERIES.



155 QUEEN ST NORTH HAMILTON, ONTARIO

interiors urban design

25 Main Street West Hamilton, Ontario L8P 1H1 Canada T: 905-522-0220


MCW Consultants Ltd. 207 Queen's Quay West, Suite 615, Toronto, ON, M5J 1A7 E-Mail: mcw_tor@mcw.com Tel: 416-598-2920 www.mcw.com Fax: 416-598-5394 Toronto Vancouver Winnipeg Moncton Ottawa Halifax

Dauphin Kelowna Trail Saint John


05	Issued for ADD-001 🛕	2023.10.0
04	Issued for Tender	2023.09.0
03	Issued for Building Permit	2023.04.2
02	Issued for Review	2023.03.0
01	Issued for Review	2022.11.2
No.:	Issues / Revisions	YYYY.MM.D


LEVEL 01 POWER & SYSTEMS PLAN OFFICE

Issue Date:		202	3.06.2
Drawn By.:	TL	Checked By:	С
Project No.:	21424	Drawing Scale:	1:7

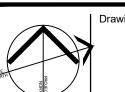


Drawing Title:

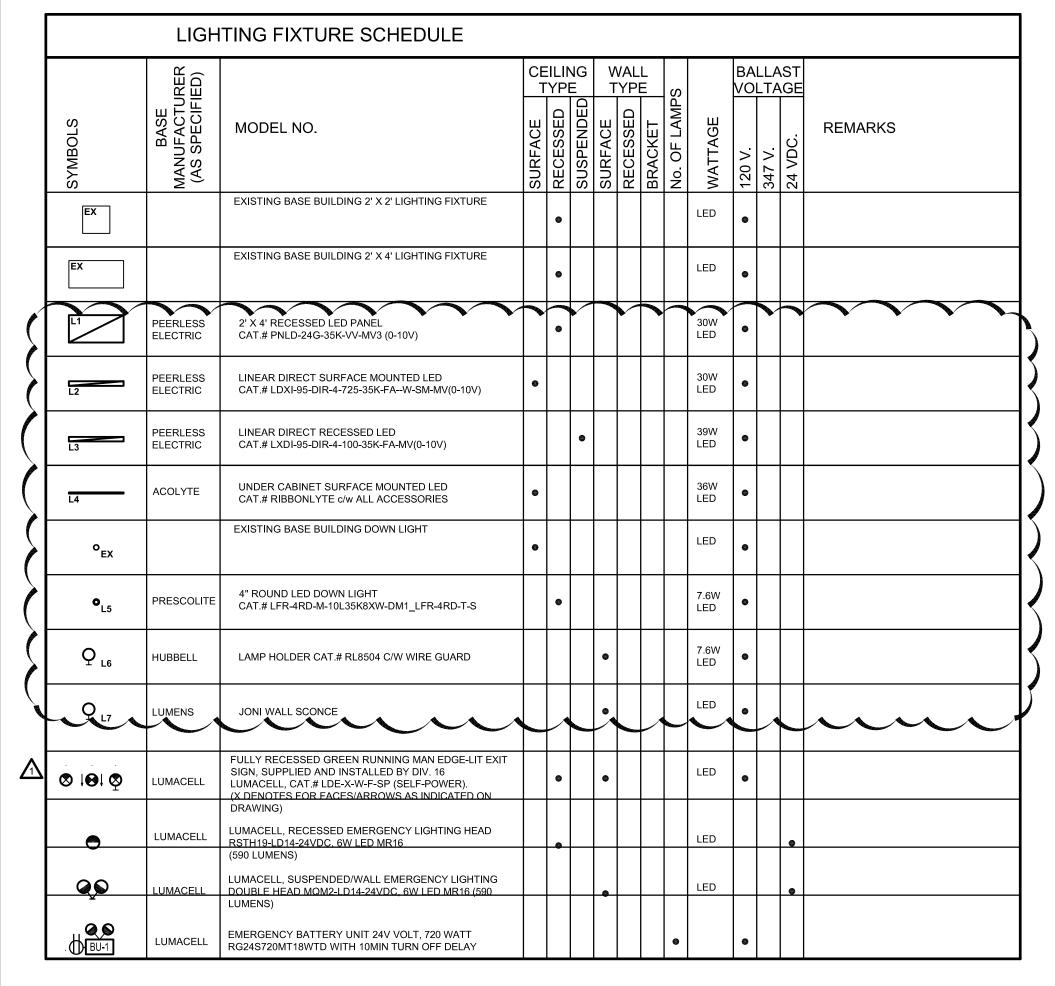

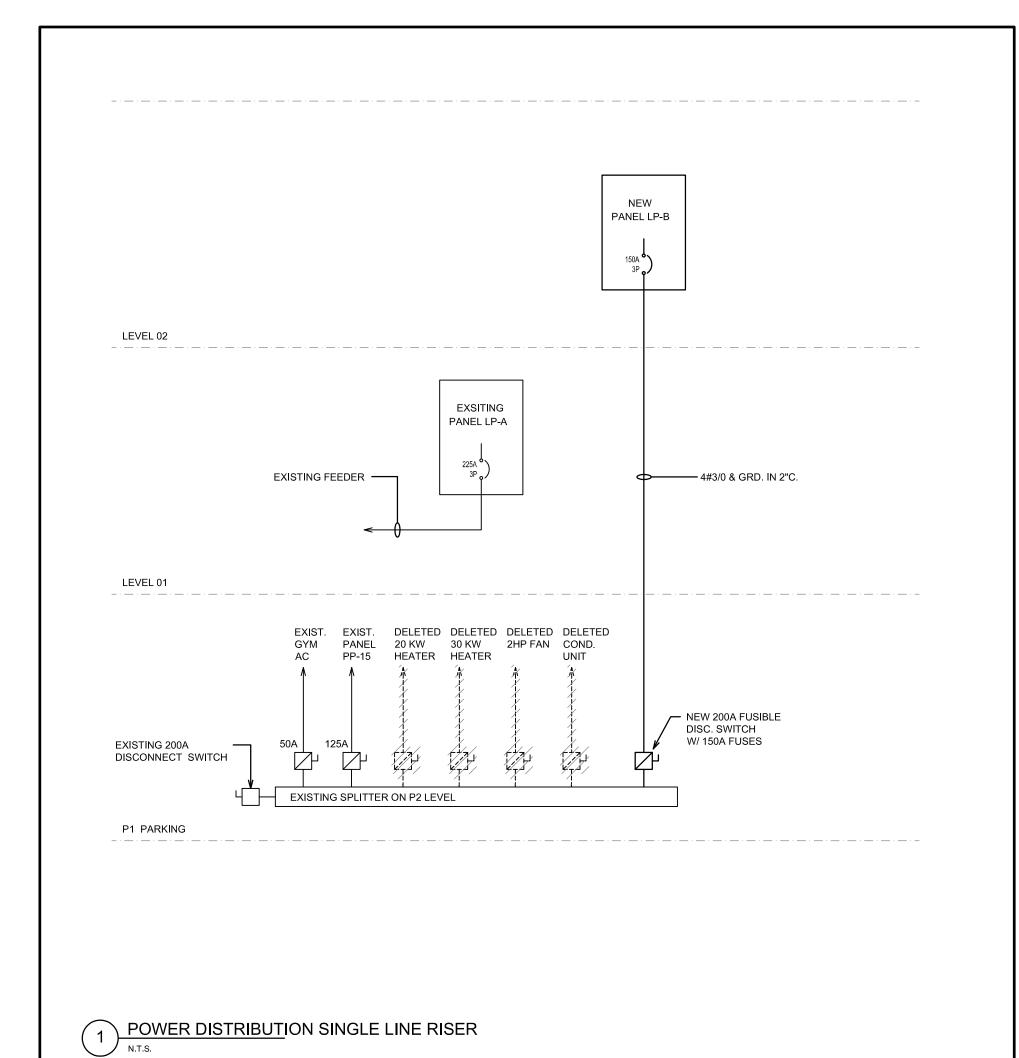


Note	Branch Panel: Location Supply From Mounting Enclosure * Lockable breaker Shaded Breakers denote existing	i: i: j:						Volts: Phase: Wires:		8		22kA MLO 200A			
			Trip		l	Δ.	I	В	(3		Trip			
CKT	Load Name	# REC	1.7	Poles		A)	(V	(A)	(VA)		Poles	, ,	# REC		CK
1			15	1	0	240					1	15		GFI OUTLET	2
3			15	1			0	240			1	15		DOOR/EMERGENCY CALL	4
5			15	1					0	1000	1	15	1	HAND DRYER	6
7			15	1	0	1000					1	15		BASEBOARD HEATER	8
9			15	1			0	0			1	15			1
11			15	1					0	0	1	15			1:
13			15	1	0	0					1	15		EXISTING SERVICE	1-
15			15	1			0	0			1	15		EXISTING SERVICE	1
17	EXISTING SERVICE		15	1					0	0	1	15		EXISTING SERVICE	1
19	EXISTING SERVICE		15	1	0	0					1	15		EXISTING SERVICE	2
	EXISTING SERVICE		15	1			0	0			1	15		EXISTING SERVICE	2
23	EXISTING SERVICE		15	1					0	0	1	15		EXISTING SERVICE	2.
			Tota	l Load:	12	40	24	40	10	00					
			Tota	I Amps	1	0	:	2	8	3					
Load	Classification	Con	nected	Load	Der	nand Fa	ctor	Estima	ated De	mand				Panel Totals	
Light	ing		0			0%			0		TTL Co	nn. Loa	ad:(VA)	2480	
Rece	eptacle		240			70%			168		TTL Es	t. Load	:(VA)	1736	
Equi	pment (largest motor VA		2240			70%			1568		TTL Co	nn. Am	ıp:(A)	7	
Appli	ances		0			0%			0		TTL Est. Demand:(A			5	
Others			0			0%			0						

	Branch Panel: Location: Supply From: Mounting: Enclosure:		EXIST ROOM SURF		P-A"			Volts: Phase: Wires:	22kA MLO 225A						
Note	* Lockable breaker Shaded Breakers denote existing		T			•		-				T =			
СКТ		# REC	Trip (A)	Poles		A 'A)		3 A)	(V		Poles	Trip (A)	# REC	Load Name	скт
1	EXIT LIGHTS		20	1	50	1440					1	15		GROUND FLOOR OUTLETS	2
3	NIGHT LIGHTS & BATTERY UNIT		20	1		0	600	960			1	15		GROUND FLOOR OUTLETS	4
5	GROUND FLOOR LIGHTING		20	1					600	960	1	15	4	GROUND FLOOR OUTLETS	6
7	GROUND FLOOR LIGHTING		20	1	600	720					1	15	3	GROUND FLOOR OUTLETS	8
9	GROUND FLOOR LIGHTING		20	1			600	480			1	15	2	GROUND FLOOR OUTLETS	10
11	GROUND FLOOR WORK STATION		15	2					480	960	1	15	4	GROUND FLOOR OUTLETS	12
13	GROUND FLOOR WORK STATION		15		480	1440					1	15	6	GROUND FLOOR OUTLETS	14
15	GROUND FLOOR WORK STATION		15	2			480	500			1	20	1	GROUND FLOOR COPIER OUTLET	16
17	CROOND I LOOK WORK STATION		10						480	500	1	20		GROUND FLOOR COPIER OUTLET	18
19	GROUND FLOOR WORK STATION		15	2	480	240					1	15		GROUND FLOOR OUTLET	20
21	GROUND FLOOR WORK STATION		10				480	480			1	15	2	GROUND FLOOR OUTLETS	22
23	GROUND FLOOR WORK STATION		15	2					480	960	1	15	4	GROUND FLOOR OUTLETS	24
25	GROUND FLOOK WORK STATION		10		480	1200					1	15	5	GROUND FLOOR OUTLETS	26
27	GROUND FLOOR WORK STATION		15	2			240	2250			2	30		HWT-1	28
29	GROUND FLOOR WORK STATION		15						240	2250	1 ′	30		TVV 1-1	30
31	0014-007		15	,	325	240					1	15	1	P-1	32
33	AC-1 to AC-7		15	2			325	240			1	20	1	ELEVATOR SERVICE OUTLET	34
35	A C A TO A C 40		45						150	100	1	15		ELEVATOR CONTROL	36
37	AC-8 TO AC 13		15	2	150	1500									38
39	AC 44 TO AC 46		45				125	1500			3	30		LULA ELEVATOR	40
41	AC-14 TO AC 16		15	2					125	1500	1				42
43	AC 47		45	2	200	2000						20		FELM / FELL 2	44
45	AC-17		15	2			200	2000			2	30		FFH1 / FFH-2	46
47			15	1					0	0	1	15			48
49			15	1	0	0					1	15			50
51			15	1			0	0			1	15			52
53			15	1					0	0	1	15			54
55			15	1	0	0					1	15			56
57			15	1			0	0			1	15			58
59			15	1					0	0	1	15			60
61			15	1	0	0					1	15			62
63			15	1			0	0			1	15			64
65			15	1					0	0	1	15			66
67			15	1	0	0					1	15			68
69			15	1			0	0			1	15			70
71			15	1					0	0	1	15			72
			Tota	l Load:	11:	545	114	460	97	85					
				l Amps		96		6		2	1				
				. ,			_				1				
Load	Classification	Conr	nected	Load	Der	nand Fa	ctor	Estim	ated De	mand				Panel Totals	
Light			2550			100%			2550		TTL C	onn. Lo	ad:(VA)		
	eptacle		15000			70%			10500			st. Load		24138	
	pment (largest motor VA		15840			70%			11088			onn. An		93	
	ances		0			0%			0				and:(A)		
Othe			-600			70%			-420				. ,		
Note					<u> </u>				-						

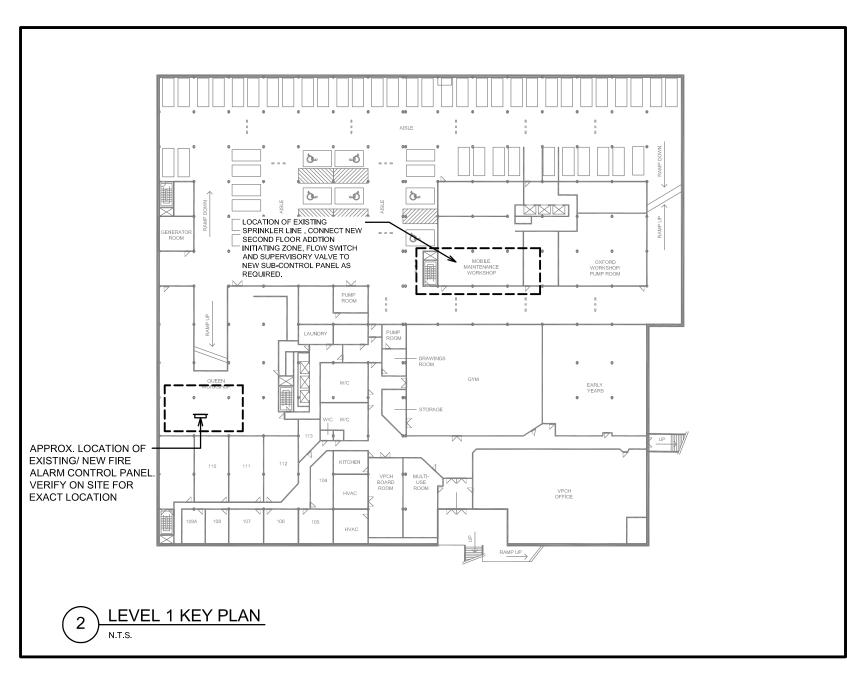

	Location: Supply From: Mounting: Enclosure:		RO0M SURF					Volts: Phase: Wires:	-	8		Mains F	Type:	MLO 225A	
Note	* Lockable breaker Shaded Breakers denote existing	Г	T:	Т								 :	П		
СКТ		# REC	Trip (A)	Poles		A (A)		3 'A)		C (A)	Poles	Trip (A)	# REC	Load Name	
-	EXIT LIGHTS		20	1	50	960					1	15	4	SECOND FLOOR OUTLETS	
	NIGHT LIGHTS & BATTERY UNIT		20	1			600	1200			1	15	5	SECOND FLOOR OUTLETS	
	SECOND FLOOR LIGHTING		20	1					600	960	1	15	4	SECOND FLOOR OUTLETS	
	SECOND FLOOR LIGHTING + EF-1		20	1	600	480					1	15	2	SECOND FLOOR OUTLETS	
9	SECOND FLOOR LIGHTING		20	1			600	960			1	15	4	SECOND FLOOR OUTLETS	
11	SECOND FLOOR WORK STATION		15	2					480	240	1	20	1	SECOND FLOOR COPIER OUTLET	
13	OZGONE I ZGON WONN GINNIGH				480	240					1	20	1	SECOND FLOOR COPIER OUTLET	
15	SECOND FLOOR WORK STATION		15	2			480				1	20	2	SECOND FLOOR OUTLETS	
17	7.		_ ·•						480		1	15	5	SECOND FLOOR OUTLETS	
19	SECOND FLOOR WORK STATION		15	2	480	240					1	15	1	SECOND FLOOR KITCHEN OUTLET	
21							480	240			1	20	1	SECOND FLOOR KITCHEN OUTLET	
23	SECOND FLOOR WORK STATION		15	2					480	240	1	20	1	SECOND FLOOR KITCHEN OUTLET	
25					480	240					1	20	1	SECOND FLOOR KITCHEN OUTLET	
27	FC-01 , FC-02		15	2			740	240			1	20	1	SECOND FLOOR KITCHEN OUTLET	
29	,								740	240	1	20	1	SECOND FLOOR KITCHEN OUTLET	
31	FC-03 , FC-04		15	2	600	480		0.10			1	15	2	SECOND FLOOR OUTLETS	-
33							600	240	5000	0.40	1	15	1	SECOND FLOOR OUTLET	
35	011.3		70	_	5000	0.40			5280	240	1	15	1	SECOND FLOOR OUTLET	-
	CU-3		70	3	5280	240	5000	000			1	15 15	1	SECOND FLOOR OUTLET	-
39	ROOF SERVICE OUTLET	1	20	1			5280	960	240	240	1	15	4	SECOND FLOOR OUTLETS DOOR OPERATOR	
41 43	ROOF SERVICE OUTLET	l 1	20	<u> </u>	3750	1000			240	240	1	15	l I	BASEBOARD HEATER -BBH-2	٠
45	CU-1		50	2	3/30	1000	3750	1000			-	15		BASEBOARD HEATER -BBH-2	
47							0700	1000	3750	1000	2	20		FAN FORCE HEATER - FFH-3	
49	CU-2		50	2	3750	1666			0,00	1000					
	ERV-1		20	1		,,,,,	1752	1666			3	20		EH-1	
53									2500	1666	1				
55	DH-1		30	2	2500	0					1	15			
57	CU-4		30	2			1144	0			1	15			
59	100-4		30						1144	0	1	15			
61				1	1144	0					1	15			
63				1			1144	0			1	15			
	ROOF SERVICE OUTLET	1	20	1					240	0	1	15			
67			15	1	0	0					1	15			
69			15	1			0	0			1	15			-
71			15	1 al Load:	0.44	200	000	070	0	0	1	15			•
				I Amps		660 06		076 92		760 73					
	Classification	Con	nected	Load	Der	nand Fa	ictor	Estim	ated De	emand	T		1075	Panel Totals	
Light	<u> </u>		2450			100%			2450			nn. Loa	_ ,	68856	-
	eptacle		11160			70%				7812		t. Load	, ,	48934	
	pment (largest motor VA		55246 0			70% 0%			38672 0			nn. Am t. Dem		191 136	
Othe	iances		-360			70%			-252		III ES	ı. Dein	anu.(A)	130	
Note			-500			1070			-202		I .				
Note	5.														

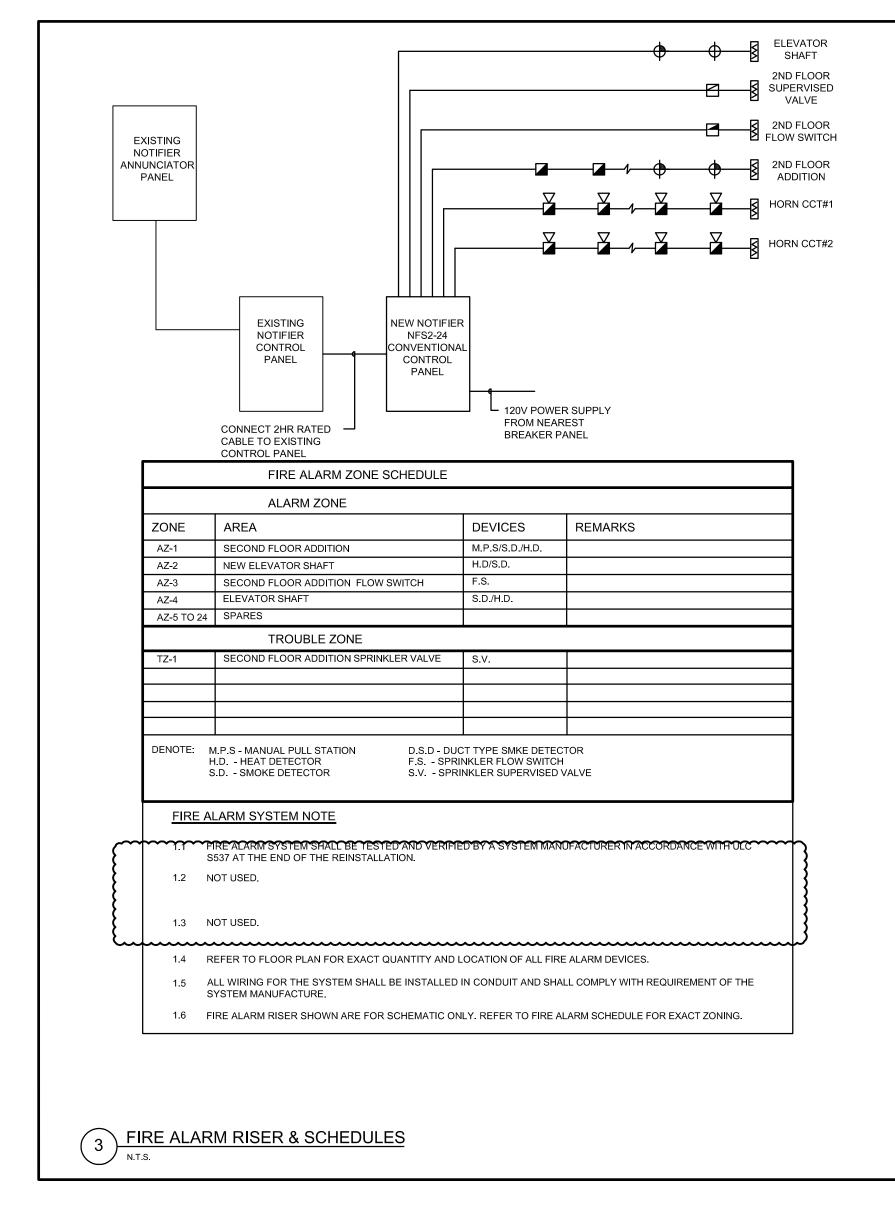



155 QUEEN ST NORTH HAMILTON, ONTARIO



25 Main Street West Hamilton, Ontario L8P 1H1 Canada

T: 905-522-0220

Seals:

Dauphin Kelowna Trail Saint John

05	Issued for ADD-001 🛕	2023.10.03
04	Issued for Tender	2023.09.08
03	Issued for Building Permit	2023.04.21
02	Issued for Review	2023.03.03
01	Issued for Review	2022.11.23
No.:	Issues / Revisions	YYYY.MM.DE
		·

ELECTRICAL SINGLE LINE DIAGRAM AND PANEL SCHEDULES

Issue Date:		202	3.06.23
Drawn By.:	TL	Checked By:	CL
Project No.:	21424	Drawing Scale:	N.T.S
	Drawing No.:		



Drawing Title:

E5