# KAWARTHA HEIGHTS PUBLIC SCHOOL CLASSROOMS 4, 5, 6, AND 7 RENOVATIONS

KAWARTHA PINE RIDGE DISTRICT SCHOOL BOARD

11 KAWARTHA HEIGHTS BOULEVARD PETERBOROUGH, ONTARIO K9J 1N4

## **DRAWING LIST**

ARCH	ITECT	URAL

<u>No.</u>	<u>Drawing Name</u>
A000	DRAWING LIST AND OBC MATRIX
A101	LOCATION PLAN, KEY PLAN & GENERAL NOTES
A201	GROUND FLOOR OVERALL FLOOR PLAN
D201	GROUND FLOOR CLASSROOMS DEMO FLOOR PLANS
D202	GROUND FLOOR CLASSROOMS DEMO REFLECTED CEILING PLANS
A202	GROUND FLOOR CLASSROOMS PROPOSED FLOOR PLANS
A203	GROUND FLOOR CLASSROOMS PROPOSED REFLECTED CEILING PLANS
D301	DEMOLITION INTERIOR ELEVATIONS
D302	DEMOLITION INTERIOR ELEVATIONS
A301	PROPOSED INTERIOR ELEVATIONS
A302	PROPOSED INTERIOR ELEVATIONS
A501	MILLWORK DETAILS
A502	MILLWORK DETAILS
A801	ROOM FINISH, DOOR AND CONSTRUCTION

ASSEMBLY SCHEDULES

#### **ELECTRICAL** MECHANICAL

<u>No.</u>	Drawing Name	<u>No.</u>	<u>Drawing Name</u>
M0-001	LEGEND, DRAWING LIST & SCHEDULES	E-100	ELECTRICAL - KEY PLAN, LEGEND DRAWING LIST & NOTES
M1-101	FLOOR PLAN MECHANICAL DEMOLITION	E-101	ELECTRICAL - LEGEND & DRAWING LIST & NOTES
M1-201	FLOOR PLAN MECHANICAL NEW	E-200	ELECTRICAL - GROUND FLOOR CLASSROOMS - DEMOLITION POWER
		E-201	ELECTRICAL - GROUND FLOOR CLASSROOMS - DEMOLITION LIGHTING
		E-300	ELECTRICAL - GROUND FLOOR NEW CLASSROOM POWER LAYOUT
		E-301	ELECTRICAL - GROUND FLOOR NEW CLASSROOM LIGHTING LAYOUT

Peterbe	vartha Heights Boule orough, ON K9J 1N4	vard	
Date:	February 20, 2024 Pa	Ontario Building Code Data Matrix art 11 – Renovation of Existing Building	Building Code Reference
11.00	Building Code Version:	O. Reg. 332/12         Last Amendment         O. Reg. 89/23	
11.01	Project Type:	☐ Addition ☐ Renovation ☐ Addition and renovation ☐ Change of use  Description:	[A] 1.1.2.
11.02	Major Occupancy Classification:	Occupancy Use  Group A, Division 2 Public School	3.1.2.1.(1)
11.03	Superimposed Major Occupancies:	☑ No ☐ Yes  Description:	3.2.2.7.
11.04	Building Area (m <sup>2</sup> )	Description:         Existing         New         Total           Ground Floor         2310.9 m2         0         2310.9 m2           ————————————————————————————————————	[A] 1.4.1.2.
11.05	Building Height	1 Storeys above grade4.8 (m) Above grade0 Storeys below grade	[A] 1.4.1.2. & 3.2.1.1.
11.06	Number of Streets/ Firefighter access	1_street(s)	3.2.2.10. & 3.2.5.
11.07	Building Size	☐ Small	T.11.2.1.1.B

CMV Group architects

11.08	Existing Building Classification:	Change in Major Occupancy: ☐ Yes ☒ Not Applicable (no change of major occupancy)			occupancy)	11.2.1.1.	
		Construction Index:	0	(no onang	•		T 11.2.1.1A
		Hazard Index:					T 11.2.1.1B
		Importance Category:	□ Low	□ Normal			N
			⊠ High	☐ Post-disa	ster		4.1.2.1.(3), 5.2.2.1.(2)
11.09	Renovation type:	□ Basic Renovation	□ Extensiv	e Renovation			11.3.3.1. 11.3.3.2.
11.10	Occupant Load	Floor Level/Area	Occupa <u>Type</u>	ncy <u>Based</u>		Occupant Load (Persons)	3.1.17.
		No change					
	Insert additional lines as needed						
11.11	Plumbing Fixture Requirements	Ratio: Male to Female existing to remain, no change		3.7.4.			
		Floor Level/Area	<u>Occupar</u>		<u>Fixture</u>		
			<u>Load</u>	Reference	<u>Requii</u>	red <u>Provided</u>	
				_			
	Insert additional lines as needed		-	_			
11.12	Barrier-free Design:	X Yes Entranc	ce is equippe	d with power d	loor operato	or.	11.3.3.2.(2)
		□ No ——					
11.13	Reduction in	Structural:		⊠ No	□ Ye	s	11.4.2.1.
	Performance Level:	By Increase in occupar	nt load:	⊠ No	□ Ye	S	11.4.2.2.
		By change of major occ	cupancy:	⊠ No	□ Ye		11.4.2.3.
		Plumbing:		⊠ No	□ Ye		11.4.2.4.
		Sewage-systems:		⊠ No	□ Ye		11.4.2.5.
		Extension of combustible construction:	ole	⊠ No	□ Ye		11.4.2.6.
		construction:		,,	•	-	

11.14	Compensating	⊠ No □ Yes	11.4.3.1,
	Construction:	Structural: ⊠ No □ Yes	11.4.3.2,
		Increase in occupant load: ⊠ No □ Yes	11.4.3.3,
		Change of major occupancy: ⊠ No □ Yes	11.4.3.4,
		Plumbing: ⊠ No □ Yes	11.4.3.5,
		Sewage systems: ⊠ No □ Yes	11.4.3.6,
		Extension of combustible construction:	11.4.3.7.
11.15	Compliance Alternatives Proposed:	⊠ No □ Yes	11.5.1.
11.16	Notes:		11.5.1.
	Insert additional lines as needed		

references are to Division B of the OBC unless preceded by [A] for Division A and [C] for Division C.



1 FEB 20, 2024 ISSUED FOR KPRDSB REVIEW

3 MAR 13, 2024 ISSUED FOR TENDER





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CLASSROOMS 4, 5, 6, & 7 RENOVATIONS

KAWARTHA PINE RIDGE DISTRICT SCHOOL BD 11 KAWARTHA HEIGHTS BOULEVARD PETERBOROUGH

DRAWING LIST AND OBC MATRIX

Drawn By:	Checked By:	Date Checked:	Project No.
TJ/LR	ОМ		23A123
Date Plotted:		Scale:	
Mar 20, 2	2024 - 10:	AS NOTED	
Drawing No.:		Revision No.:	
	101		

- NOTHING IN THIS SET OF DRAWINGS SHALL BE CONSTRUED TO RELIEVE PERSONS ENGAGED IN CONSTRUCTION OR DEMOLITION OPERATIONS FROM COMPLYING WITH OTHER APPLICABLE PROVISIONS 35. THE CONTRACTOR IS RESPONSIBLE FOR COORDINATING WITH OF LAW, NOR IS IT INTENDED TO ALTER OR DIMINISH ANY OBLIGATION OTHERWISE IMPOSED BY LAW ON THE OWNER.
- WHENEVER A SHOP DRAWING IS REQUIRED BY THE PROVISIONS OF THIS SET OF DRAWINGS, SUCH SHOP DRAWING SHALL BE EXECUTED BY A REGISTERED DESIGN PROFESSIONAL IN ONTARIO WHO HIS OR HER SEAL AND SIGNATURE MUST BE AFFIXED TO ANY DRAWINGS OR SPECIFICATIONS THAT MAY BE REQUIRED FOR THE WORK.
- PROTECTION OF ADJOINING AREAS: SHALL BE PROTECTED FROM DAMAGE DURING CONSTRUCTION OR DEMOLITION WORK. PROTECTION MUST BE PROVIDED FOR ALL ASSEMBLIES AND FINISHES.
- THIS IS A BARRIER FREE ACCESSIBLE BUILDING; ACCESSIBILITY SHALL BE MAINTAINED DURING CONSTRUCTION OR DEMOLITION PERIOD.
- DEMOLITION PLANS ARE INDICATIVE ONLY OF INTENT OF WORK DEMOLITION TRADE TO INCLUDE, AND NOT BE LIMITED TO PROVIDING, THE REMOVAL FROM SITE OF ALL MATERIALS AND EQUIPMENT AS NECESSARY TO PROVIDE A BASE FOR THE CONSTRUCTION PURPOSES.
- A SYSTEM OF DIAGRAMMATIC SYMBOLS AND NOTATIONS IS USED IN THESE DRAWINGS. REVIEW NOTATION CAREFULLY AND NOTIFY ARCHITECT AND REQUEST FOR CLARIFICATION OF ANY UNCLEAR NOTATION OR DISCREPANCY PRIOR TO COMMENCING WORK.
- ALL SYMBOLS ARE SHOWN DIAGRAMMATICALLY ILLUSTRATING APPROXIMATE LOCATION OF EXISTING AND PROPOSED MATERIALS. ANY DISCREPANCIES OR CONFLICTS BETWEEN EXISTING AND PROPOSED CONDITIONS SHALL BE REPORTED TO THE ARCHITECT.
- CONTRACTOR IS TO VERIFY ALL QUANTITIES. IN CASE OF ANY DISCREPANCIES, GRAPHICALLY SHOWN MATERIALS QUANTITIES SHALL TAKE PRECEDENCE.
- DO ALL WORK IN CONFORMANCE WITH GOVERNING CODES AND AUTHORITIES. INCLUDING HAULING, RECYCLING AND DISPOSAL.
- REMOVE, STORE, AND PROTECT DESIGNATED MATERIALS AND EQUIPMENT FOR REINSTALLATION AND COORDINATE WITH OWNER.
- SUBMIT DETAILED SCHEDULE AND PHASING PLANS FOR REMOVAL AND CONTRACTOR TO COORDINATE WITH OWNER, ARCHITECT AND ALL
- SUB-CONTRACTORS PRIOR TO THE COMMENCEMENT OF ANY DEMOLITION ACTIVITY.
- CONTRACTOR TO FIELD REVIEW LAYOUT & NOTIFY ARCHITECT OF ANY CONFLICTS W/ EXISTING ITEMS PRIOR TO THE COMMENCEMENT OF DEMOLITION OR CONSTRUCTION ACTIVITIES.
- THE ARCHITECT IS NOT RESPONSIBLE FOR THE CONSTRUCTION MEANS, METHODS, TECHNIQUES, SEQUENCE OR SAFETY PRECAUTIONS NOT BE RESPONSIBLE FOR THE CONTRACTORS' FAILURE TO CARRY OUT THE WORK IN ACCORDANCE WITH THE CONTRACT DOCUMENTS.
- CONTRACTORS ARE RESPONSIBLE FOR REMOVING AND PRESERVING ITEMS AS INDICATED BY THE OWNER.
- IT IS CONTRACTOR'S SOLE RESPONSIBILITY TO DETERMINE THE EXTENT 48. FIRE DEPARTMENT CONNECTION SYSTEMS. EXISTING HOSE OF DEMOLITION REQUIRED IN ORDER TO PERFORM THE CONTRACT WORK FOR THIS PROJECT. THE SHOWN ASSEMBLIES REQUIRING DEMOLITION ARE INCLUDED FOR CONTRACTOR'S CONVENIENCE ONLY. CONTRACTORS ARE REQUIRED TO FAMILIARIZE THEMSELVES WITH ITEMS HOARDING TO BE DEMOLISHED AND REMOVAL OF REQUIRED EXISTING ASSEMBLIES, FURNITURE, FINISHES, FEATURES, UTILITIES, AND ELEC AND MECH SERVICES ON SITE AND EXAMINE ALL THE INFORMATION WITHIN THESE DOCUMENTS.
- PROVIDE THE HIGHEST DEGREE OF PROTECTION FOR PUBLIC, VISITORS AND PROPERTY AT ALL TIMES.
- 18. CONTINUOUS ACCESS TO EXITS IS TO BE MAINTAINED AT ALL TIMES.
- ALL SITE SIGN LOCATION AND DIMENSIONS ARE TO BE COORDINATED 20. THE DRAWINGS INDICATING EXISTING CONDITIONS ARE PROVIDED FOR
- THE CONTRACTOR'S CONVENIENCE. IT IS THE CONTRACTOR'S RESPONSIBILITY TO VISIT THE EXISTING CONDITION AND ENSURE THAT THE SCOPE OF WORK INDICATED ON THE DRAWINGS IS INTERPRETED IN CONJUNCTION WITH THE FIELD CONDITIONS.
- IT IS THE CONTRACTOR'S RESPONSIBILITY TO ENSURE THAT THE INFORMATION PROVIDED ON THE DRAWINGS AND DURING THEIR FIELD VISIT IS CLEAR AND FULLY UNDERSTOOD PRIOR TO SUBMITTING THEIR
- 22. IT IS THE CONTRACTOR'S RESPONSIBILITY TO REPORT ANY DISCREPANCIES BETWEEN THE DRAWINGS AND FIELD CONDITIONS TO
- THE CONTRACTOR IS RESPONSIBLE FOR COORDINATING AND SCHEDULING ALL WORK WITH THE SCHOOL BOARD PRIOR TO COMMENCEMENT OF ANY WORK.
- REPAIR AND MAKE GOOD ANY EXISTING SURFACES AND MATERIALS TO REMAIN THAT ARE DAMAGED BY THIS WORK (TYPICAL).
- 25. REMOVE ALL EXISTING FINISHES WHERE SHOWN ON THE DRAWINGS, INCLUDING ADHESIVES & RESIDUE, ENSURE A SOUND, SMOOTH & FLUSH CONTINUOUS SURFACE WITHIN ALLOWABLE TOLERANCES (CAN 3-A21.1-M90) THROUGHOUT THE ENTIRE AREA. LEVELS OF FINISHED 57. CONCRETE FLOORS AND FLOORS UNDER FINISHED FLOORING APPLICATIONS SHALL BE WITHIN 3mm OF ESTABLISHED ELEVATIONS IN ANY 3m X 3m SQUARE AREA, AND SHALL BE SUFFICIENTLY EVEN TO CONTACT A 3m LONG STRAIGHT EDGE WITH A TOLERANCE OF 3mm.
- WHEREVER EXISTING CONCRETE FLOOR SURFACES ARE NOT LEVEL AT +/-0.00 (LEVEL OF CONC SLAB AT INTERIOR DOOR) AND WHEREVER EXISTING CONCRETE FLOOR SURFACES ARE NOT LEVEL WITHIN ALLOWABLE TOLERANCES, INSTALL SELF-LEVELLING CONTINUOUS UNDERLAYMENT AS PER SPEC AND FLOORING MANUFACTURER RECOMMENDATIONS. INCLUDE ALL UNDERLAYMENT WORK IN BID PRICE.
- AT LOCATIONS TO RECEIVE NEW FLOOR FINISHES, REPAIR AND MAKE GOOD ANY DAMAGE TO THE EXISTING CONCRETE FLOOR SLAB.
- 28. ALL EXISTING LIGHT FIXTURES IN INDICATED AREAS ARE TO BE REMOVED AND DISPOSED OF. (REFER TO ELECTRICAL DRAWINGS) COORDINATE BASE BUILDING SERVICES SHUT DOWNS WITH OWNER

PRIOR TO COMMENCEMENT OF ANY DEMOLITION. (REFER TO

- MECHANICAL AND ELECTRICAL DRAWINGS) THE CONTRACTOR SHALL TAKE PRECAUTIONARY MEASURES NECESSARY TO PROTECT EXISTING ITEMS AND ASSEMBLIES FROM DAMAGE. ALL SUCH ASSEMBLIES DAMAGED BY THE CONTRACTOR'S OPERATIONS SHALL BE REPAIRED OR RECONSTRUCTED TO THE SATISFACTION OF
- SEE MECHANICAL AND ELECTRICAL DRAWINGS FOR REMOVAL/RELOCATION OF EXISTING FIXTURES AND ASSOCIATED CONTROLS, SMOKE CONTROLS, ETC.
- THE ARCHITECT ASSUMES NO RESPONSIBILITY FOR THE MECHANICAL AND ELECTRICAL INFORMATION SHOWN ON THE ARCHITECTURAL DRAWINGS. SEE MECHANICAL AND ELECTRICAL DRAWINGS. CONTRACTOR SHALL USE CAUTION WHEN WORKING OVER OR NEAR EXISTING SERVICE MAINS AND ELECTRICAL LINES. CONTRACTOR IS TO VERIFY HORIZONTAL AND VERTICAL LOCATION OF ALL EXISTING SERVICES AND UTILITIES, ABOVE AND BELOW GRADE ON SITE. NOTIFY CONSULTANTS OF ANY DISCREPANCIES OR CONFLICTS. DAMAGE SHALL BE REPAIRED BY THE CONTRACTOR WITHOUT ADDITIONAL COST TO THE OWNER.

THE ARCHITECT AND OWNER AT NO ADDITIONAL COST TO THE OWNER.

THE CONTRACTOR IS RESPONSIBLE FOR COORDINATING THE DISCONNECTION OF EXISTING SERVICES CRITICAL TO OPERATION OF THE EXISTING BUILDING.

- 34. MAINTAIN THE SECURITY OF THE WORK AREA AT ALL TIMES.
- GOVERNING CODES AND AUTHORITIES IN ORDER TO MAINTAIN THE INTEGRITY OF THE FIRE DETECTION AND ANNUNCIATION SYSTEMS IN THE DEMOLISHED SPACE.
- 36. ENSURE THE PREMISES ARE LEFT FREE OF ANY DEBRIS AND IN BROOM-CLEAN CONDITION.
- ALL RAIN WATER LEADERS TO REMAIN UNDISTURBED BY THIS WORK UNLESS OTHERWISE NOTED.
- 38. REMOVE IN ALL INDICATED AREAS: FINISHES INCLUDING FLOORING, FLOOR FASTENING AND ADHESIVES, FLOOR LEVELLING/PATCHING MATERIALS, CEILING, CEILING FINISHES, CEILING ATTACHMENTS, WALL FINISHES WALL CLADDING, ALL WOOD VENEERS, LIGHT FIXTURES, FURNITURE, FIXTURES, SIGNAGE, STAINED CONC MARKS, MECH AND <u> EQUIPMENT, CABINETS, MILLWORK, AUDIO AND VIDEO SYSTEM</u>
- 39. EXISTING FIRE SAFETY OF BUILDING, MEANS OF EGRESS AND FIRE RESISTANCE RATING OF ASSEMBLIES TO REMAIN UNDAMAGED AND SHALL NOT BE AFFECTED BY ANY PROPOSED OR DEMOLITION WORKS. 69.
- 40. THE EXISTING BUILDING OUTSIDE OF THE AREAS OF WORK SHALL NOT BE AFFECTED BY THE WORK. EXISTING BUILDING STRUCTURE, ROOF ASSEMBLIES, EXTERIOR WALLS, FIRE RATED WALLS WITHIN THE AREAS OF THE WORK, ARE EXISTING TO REMAIN AND SHALL NOT BE AFFECTED BY ANY DEMOLITION OR PROPOSED WORK.
- 41. DEMOLITION OR CONSTRUCTION OPERATIONS SHALL NOT AFFECT THE EXISTING FIRE PREVENTION AND FIRE FIGHTING ACCESS AND PROCEDURES OF THE BUILDING. ACCESS TO FIRE FIGHTING EQUIPMENT SHALL BE MAINTAINED FREE OF ANY OBSTRUCTION AT ALL TIMES DURING THE DEMOLITION OR CONSTRUCTION PHASE.
- 42. EXIT CORRIDORS CANNOT BE USED FOR WASTE REMOVAL OR DUMPING PATH.
- 43. EXISTING BUILDING DRAWINGS INDICATE STRUCTURE, WALLS AND PARTITIONS, FIXTURES AND EQUIPMENT, SERVICES AND UTILITIES BASED ON THE BEST INFORMATION AVAILABLE. VERIFY ALL CONDITIONS 3. AT JOB SITE AND NOTIFY ARCHITECT OF DIMENSIONAL ERRORS, OMISSIONS OR DISCREPANCIES BEFORE BEGINNING WORK.
- 44. CONCRETE SUB-FLOOR MUST BE SMOOTH, EVEN, SOUND CONSTRUCTION, RIGID, PERMANENTLY DRY, AND CLEAN AFTER REMOVAL OF THE INDICATED MATERIAL AND BEFORE INSTALLATION OF THE NEW FLOOR FINISHES. CONTRACTOR SHALL CONDUCT PROPER INSPECTION AND TESTING AS REQUIRED IN SPECIFICATION SECTION FOR NEW FLOORING.
- 45. REQUIRED EXITS, EXISTING STRUCTURAL ELEMENTS, FIRE PROTECTION DEVICES AND SANITARY SAFEGUARDS SHALL BE MAINTAINED AT ALL TIMES DURING RENOVATION OR CONSTRUCTION.
- OR PROCEDURES UTILIZED IN CONNECTION WITH THE WORK AND WILL 46. DEMOLITION WORK SHALL BE CONSISTENT WITH EXISTING SMOKE MANAGEMENT SYSTEM ZONING.
  - FIRE PREVENTIVE, SANITARY, OR OTHER FACILITIES THAT HAVE BEEN PROVIDED FOR THE PROTECTION OF LIFE, HEALTH, AND PROPERTY SHALL BE CONTINUOUSLY MAINTAINED AND PROTECTED PROPERLY.
  - CONNECTIONS SHALL BE KEPT FREE FROM OBSTRUCTION AND SHALL BE PROPERLY MARKED.

- 49. DUST CONTROL, ADDITIONAL HOARDING, AND TEMPORARY ELECTRICAL <u>HOOK-UPS</u> MUST BE PROVIDED BY CONTRACTORS.
- 50. ALL REQUIRED TEMPORARY PROTECTIONS REQUIRED BY LAW OR AS REQUESTED BY THE OWNER INTENDED BEFORE. AFTER AND DURING THE DEMOLITION OR CONSTRUCTION WORK MUST BE PROVIDED BY THE CONTRACTOR AND SHOULD REMAIN ON THE SITE UNTIL ALL WORK IS COMPLETED.
- 51. HOARDING, GUARDRAILS, AND/OR PUBLIC WALKWAY OVERHEAD HOARDING SHALL CLOSE OFF THE SITE TO PREVENT ANY HAZARD TO THE PUBLIC AND MEET THE REQUIREMENTS OF LAW.
- THIS IS AN OCCUPIED BUILDING, BARRICADES, SIGNS, DROP CLOTHS, AND OTHER PROTECTIVE MEANS SHALL BE ERECTED BY CONTRACTORS AS REQUIRED TO PROVIDE REASONABLE PROTECTION FOR THE OCCUPANTS, VISITORS AND WORKERS AGAINST HAZARD AND NUISANCE. ALL WORK SHALL BE PERFORMED IN ACCORDANCE WITH LAW.
- 53. SIDES OF CONSTRUCTION OPENINGS SHALL BE PROTECTED AND MAINTAINED BY GUARDRAILS, BRACING, SHEETING, OR BY OTHER RESTRAINING STRUCTURES.
- 54. ALL WARNING AND SAFETY SIGNS REQUIRED BY LAW OR AS REQUESTED BY OWNER MUST BE PROVIDED IN PLACE 24 HOURS PRIOR TO COMMENCEMENT OF ANY DEMOLITION OR CONSTRUCTION ACTIVITY AND REMAIN VISIBLE.

- PHASING AND PROVISION OF ADEQUATE HOARDING APPROVED BY LEGAL AUTHORITIES ARE THE SOLE RESPONSIBILITIES OF THE
- 56. NOISY WORK AT NIGHT IS NOT ALLOWED.
- NIGHT SHIFTS, AND MULTI-PHASING SHALL BE CONSIDERED INTEGRAL PART OF THE SCOPE OF WORKS. CONTRACTORS TO CONSIDER THEIR ADDITIONAL PREMIUM FEES AND TO CONFIRM WITH GC BEFORE <u>SUBMITTING FEE PROPOSALS.</u>
- CONTRACTOR TO PROVIDE TEMPORARY MEANS OF EGRESS AND FACILITIES WHEREAS REQUIRED. CONTRACTOR TO PROVIDE AND SUBMIT DRAWINGS FOR REVIEW AND APPROVAL BY CONSULTANTS.
- ALL OF THE WORK SHOWN ON THIS SET OF DRAWINGS SHALL BE IN STRICT ACCORDANCE WITH THE SCHEDULE AS APPROVED BY THE OWNER. CONTRACTOR SHALL SUBMIT THEIR REQUIRED PHASING AND COORDINATE THEIR WORK SCHEDULE WITH OWNER IN REGARD TO BUILDING SAFETY, SECURITY AMENITY AND OPERATION STANDARDS.

- THE LOCATION OF ALL EXISTING UTILITIES AND SERVICE LINES SHALL BE DETERMINED AND ADEQUATE MEASURES TAKEN, OR DEVICES PROVIDED, TO SAFEGUARD THE PUBLIC AND PROPERTY BEFORE SUCH UTILITIES ARE DISTURBED. IF ANY UTILITY IS TO BE REMOVED, RELOCATED, OR HAVE ITS SERVICE INTERRUPTED, SEE MECHANICAL AND ELECTRICAL DRAWINGS
- STORAGE OF MATERIALS. MATERIALS SHALL NOT BE STORED IN PUBLIC CORRIDORS, OR EXITS CORRIDOR EITHER PERMANENTLY OR TEMPORARILY. STORAGE SPACES SHALL NOT INTERFERE WITH ACCESS TO ANY EXITS OR PASSAGEWAY. SUITABLE BARRICADES SHALL BE PROVIDED BY CONTRACTOR SO AS TO PREVENT MATERIAL FROM SLIDING OR REBOUNDING INTO ANY SPACE ACCESSIBLE TO THE
- 62. CONTRACTOR TO REMOVE, PACKAGE AND DISPOSE OF HAZARDOUS MATERIALS INCLUDING MECHANICAL AND ELECTRICAL ITEMS.
- LOCATION(S) OF STORAGE MATERIAL, WASTE DUMPSTERS, DEBRIS BOXES AND SKIP BOXES WILL BE DETERMINED ON SITE BY OWNER AND CONTRACTOR. SUB-CONTRACTORS TO CONFIRM LOCATION(S) WITH CONTRACTOR BEFORE SUBMITTING FEE PROPOSALS.
- 64. ALL DEBRIS SHALL BE REMOVED FROM FLOORS DAILY. CONTRACTOR TO CONDUCT A DAILY INSPECTION FOR DEMOLITION OR CONSTRUCTION

DEMOLITION AND CONSTRUCTION GENERAL NOTES SCALE: NTS

65. COMBUSTIBLE WASTE MATERIAL OR COMBUSTIBLE DEBRIS SHALL NOT BE PERMITTED TO ACCUMULATE, AND SHALL BE REMOVED FROM THE SITE IN ACCORDANCE WITH THE APPLICABLE LAWS OR AS REQUESTED

66. THE CONTRACTOR IS RESPONSIBLE FOR COORDINATING THE DISCONNECTION OF EXISTING SERVICES CRITICAL TO THE OPERATION

OF THE EXISTING BUILDING. 67. ALL EXISTING ELECTRICAL CONDUIT, TELEPHONE, CABLES, ETC. AND REDUNDANT ELECTRICAL INDICATED TO BE DEMOLISHED IS TO BE REMOVED AND CAPPED OFF SAFELY. REFER TO ELECTRICAL DRAWINGS

ALL EXISTING SERVICES, SEWERS, PIPING AND UTILITIES SHOWN ARE NOT TO BE INTERPRETED AS THE EXACT LOCATION. OR AS THE ONLY OBSTACLES THAT MAY OCCUR ON THE SITE, VERIFY EXISTING CONDITIONS AND PROCEED WITH CAUTION AROUND ANY ANTICIPATED FEATURES. GIVE NOTICE TO ALL UTILITY COMPANIES REGARDING DEMOLITION AND REMOVAL OF ALL SERVICE LINES AND CAP ALL LINES BEFORE PROCEEDING WITH THE WORK.

OWNER ENERGY INCENTIVE APPLICATIONS DOCUMENTATION.
CONTRACTOR IS REQUIRED TO PROVIDE DOCUMENTATION TO SUPPORT THE APPLICATION AS FOLLOWS FOR LIGHTING AND LIGHTING CONTROLS:

#### EXISTING FIXTURES

- b.LAMP WATTAGE c.LAMPS/FIXTURE
- PHOTOS OF EACH FIXTURE BEING REMOVED ARE REQUIRED. THE REQUIRED PHOTOS ARE AS FOLLOWS: a.PICTURE OF THE TYPICAL ROOM FOR EACH TYPE OF FIXTURE b.PICTURE OF THE TYPICAL FIXTURE BEING REMOVED, (FOR EACH TYPE OF FIXTURE)
- c.CLOSEUP SHOWING THE WATTAGE, (EITHER OF LAMP INSTALLED, OR THE BOX OF REPLACEMENT LAMPS IF ACTUAL LAMP IS NOT ACCESSIBLE). PHOTOS OF THE NEW FIXTURES BEING INSTALLED ARE REQUIRED.
- THE REQUIRED PHOTOS ARE AS FOLLOWS: a.PICTURE OF THE TYPICAL ROOM FOR EACH TYPE OF FIXTURE b.PICTURE OF THE TYPICAL FIXTURE BEING REMOVED, (FOR EACH TYPE OF FIXTURE) c.CLOSEUP OF THE NAMEPLATE TO VERIFY THE MODEL NUMBER.
- WASTE DISPOSAL DOCUMENTATION IS REQUIRED FROM THE WASTE DISPOSAL COMPANY. A RECEIPT, CERTIFICATE OR INVOICE FROM THE WASTE DISPOSAL COMPANY SHOULD INDICATE THE NUMBER OF LAMPS AND TYPE OF LAMPS DISPOSED-OF, (SOMETIMES LISTED AS # FT). ALSO SEE SPECIFICATIONS

CONTROLS SCOPE OF WORK

CONTROLS (CONTACT INFO: MATTHEW JEWELL, PH:

AS REQUIRED.

PNEUMATIC DEMOLITION WORK.

CLOSEST CONTROL PANEL.

AS REQUIRED.

WIRING DETAILS.

DEMOLISHED.

SUIT NEW FLOOR PLANS.

MATERIALS AND LABOUR.

DAVE STRAIN: 905-640-2333.

AS A SUB-TRADE TO THE MECHANICAL CONTRACTOR.

EXISTING BAS IS RELIABLE CONTROLS THROUGH SETPOINT

705-745-1600, EMAIL: MATTHEWJ@SETPOINT.CA). ALL CONTROLS

WORK SHALL BE DONE BY THE NAMED CONTROLS CONTRACTOR

MECHANICAL CONTRACTOR SHALL PROVIDE TECHNICAL ASSISTANCE

EXISTING ELECTRONIC BUILDING AUTOMATION SYSTEM IS RELIABLE

CONTROLS THROUGH SETPOINT CONTROLS. OBTAIN THE SERVICES

OBTAIN THE SERVICES OF ANALYSTS OF PNEUMATIC SYSTEMS LTD

OF SETPOINT CONTROLS FOR ALL NEW ELECTRONIC CONTROLS

(CONTACT: DAVE STRAIN, PH: 905-640-2333) FOR ALL

SCOPE OF WORK SHALL INCLUDE BUT NOT BE LIMITED TO:

PROVIDE NEW CONTROLLERS FOR NEW EXHAUST FANS.

EXTEND EXISTING BAS COMMUNICATION NETWORK FROM

UPGRADE AND PROVIDE COMPLETE CONTROL FOR UNIT VENTILATORS C/W SPACE SENSOR AS PER CONTROL

APPLICABLE. ALL LOW VOLTAGE CONTROL WIRING (BELOW 120V) SHALL BE PROVIDED BY THE BAS CONTRACTOR.

PNEUMATIC CONTROL VALVES C/W PNEUMATIC TUBING IN

CONTROL VALVES FOR WALL FINS SHALL BE BELIMO CCV

CLASSROOMS. PROVIDE NEW SPACE TEMPERATURE SENSORS

AND NEW DDC CONTROL VALVES. PROVIDE CONTROL PANELS

VALVES. VALVES SHALL BE SIZED FOR MAX 2 PSI PRESSURE

PROGRAMMING, GRAPHICS AND PANELS WHERE REQUIRED TO

COORDINATE ALL SEQUENCES OF OPERATION WITH KPRDSB

REPRESENTATIVE. CONTROLS CONTRACTOR SHALL COMPLY

CONTRACTOR TO SUPPLY CONTROL SHOP DRAWINGS WITH

PROVIDE A ONE YEAR WARRANTY ON ALL CONTROLS

DESIGNATED CONTRACTORS- TYPICAL:

BAS TO BE BY SETPOINT CONTROLS. CONTACT MATTHEW

JEWELL, MATTHEWJ@SETPOINT.CA, WORK: 705-745-1600

• ANY PNEUMATIC CONTROL DEMO TO BE BY APS. CONTACT

• INCENTIVE PROGRAM TO BE SUPPORTED BY GC. ENSURE

• ALL SALVAGE ITEMS (FURNITURE, FIXTURES, EQUIPMENT) TO

ITEMS THAT ARE ATTACHED TO THE BUILDING WILL BE

• INSPECTION AND TESTING, ROOFING INCEPTION BY PINCHIN

BE REMOVED BY OWNER PRIOR TO CONTRACTOR MOBILIZATION.

SPECIFIED LIGHTING QUALIFIES FOR THE INCENTIVE.

ALL CONTROL COMPONENTS, SCHEMATICS, SEQUENCES AND


SCHEMATICS FOR TEMPERATURE CONTROL WHERE

REMOVE EXISTING PNEUMATIC SPACE SENSORS AND


THE CONTROLS CONTRACTOR SHALL UPDATE ALL

WITH ALL KPRDSB CONTROLS STANDARDS.


INSPECT EXISTING CONTROLS OF EXISTING UNIT VENTILATORS.

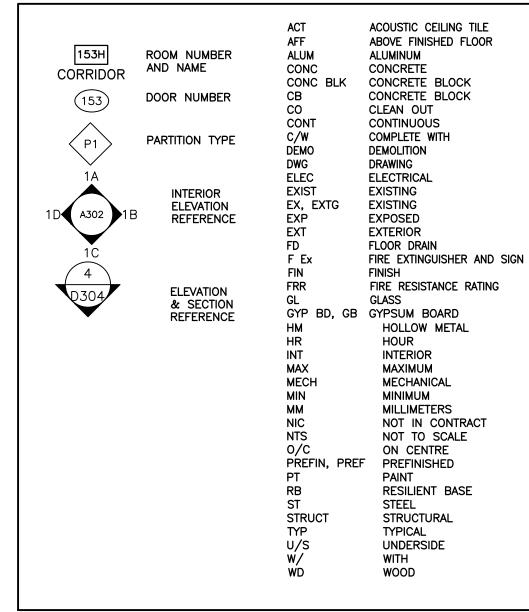



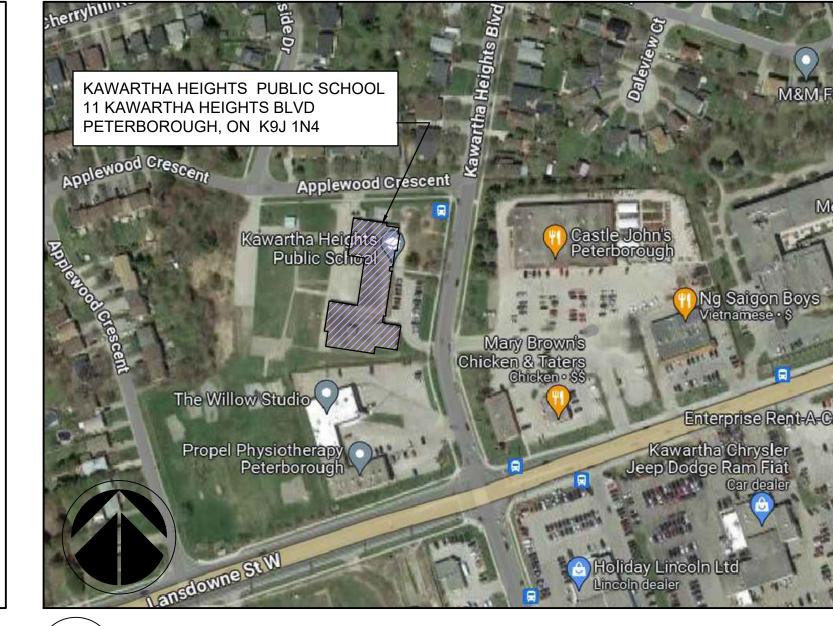



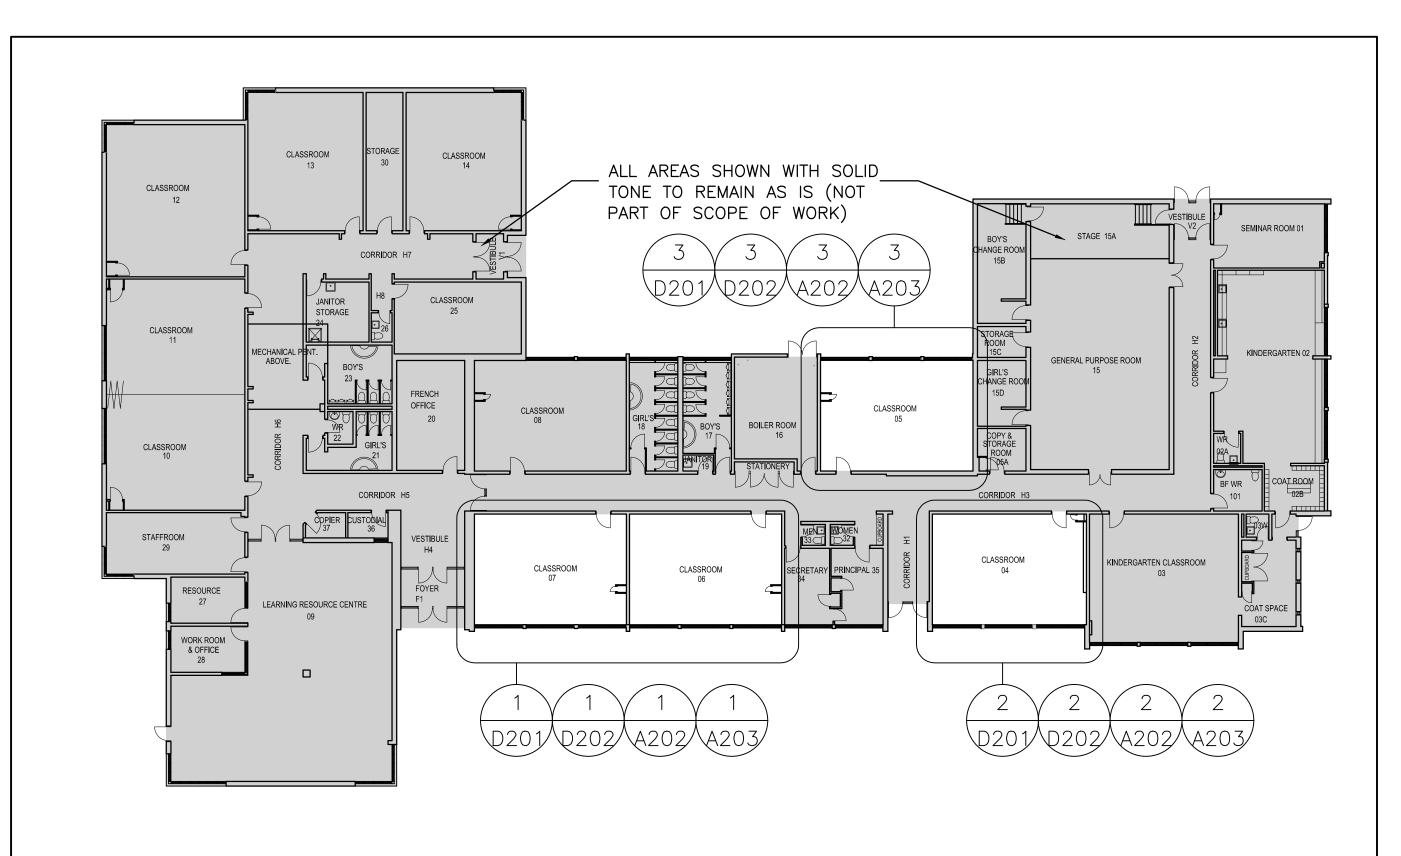





ALL DRAWINGS ARE THE PROPERTY OF THE ARCHITECT AND MUST BE RETURNED ON REQUEST.

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REVISIONS AND DISTRIBUTION LOG

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FEB 20, 2024 | ISSUED FOR KPRDSB REVIEW

MAR 1, 2024 | ISSUED FOR COORDINATION

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#### KAWARTHA HEIGHTS P.S. CLASSROOMS 4, 5, 6, & 7 RENOVATIONS

KAWARTHA PINE RIDGE DISTRICT SCHOOL BD 11 KAWARTHA HEIGHTS BOULEVARD PETERBOROUGH ONTARIO

## LOCATION PLAN, KEY PLAN AND GENERAL NOTES


Drawn By:	Checked By:	Date Checked:	Project No.
TJ/LR	ОМ		23A123
Date Plotted:		Scale:	
Mar 20, 2	2024 - 10:	AS NOTED	
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CONTROLS NOTES SCALE: NTS

GROUND FLOOR KEY PLAN SCALE: 1:250

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REFER TO A101 FOR GENERAL NOTES.





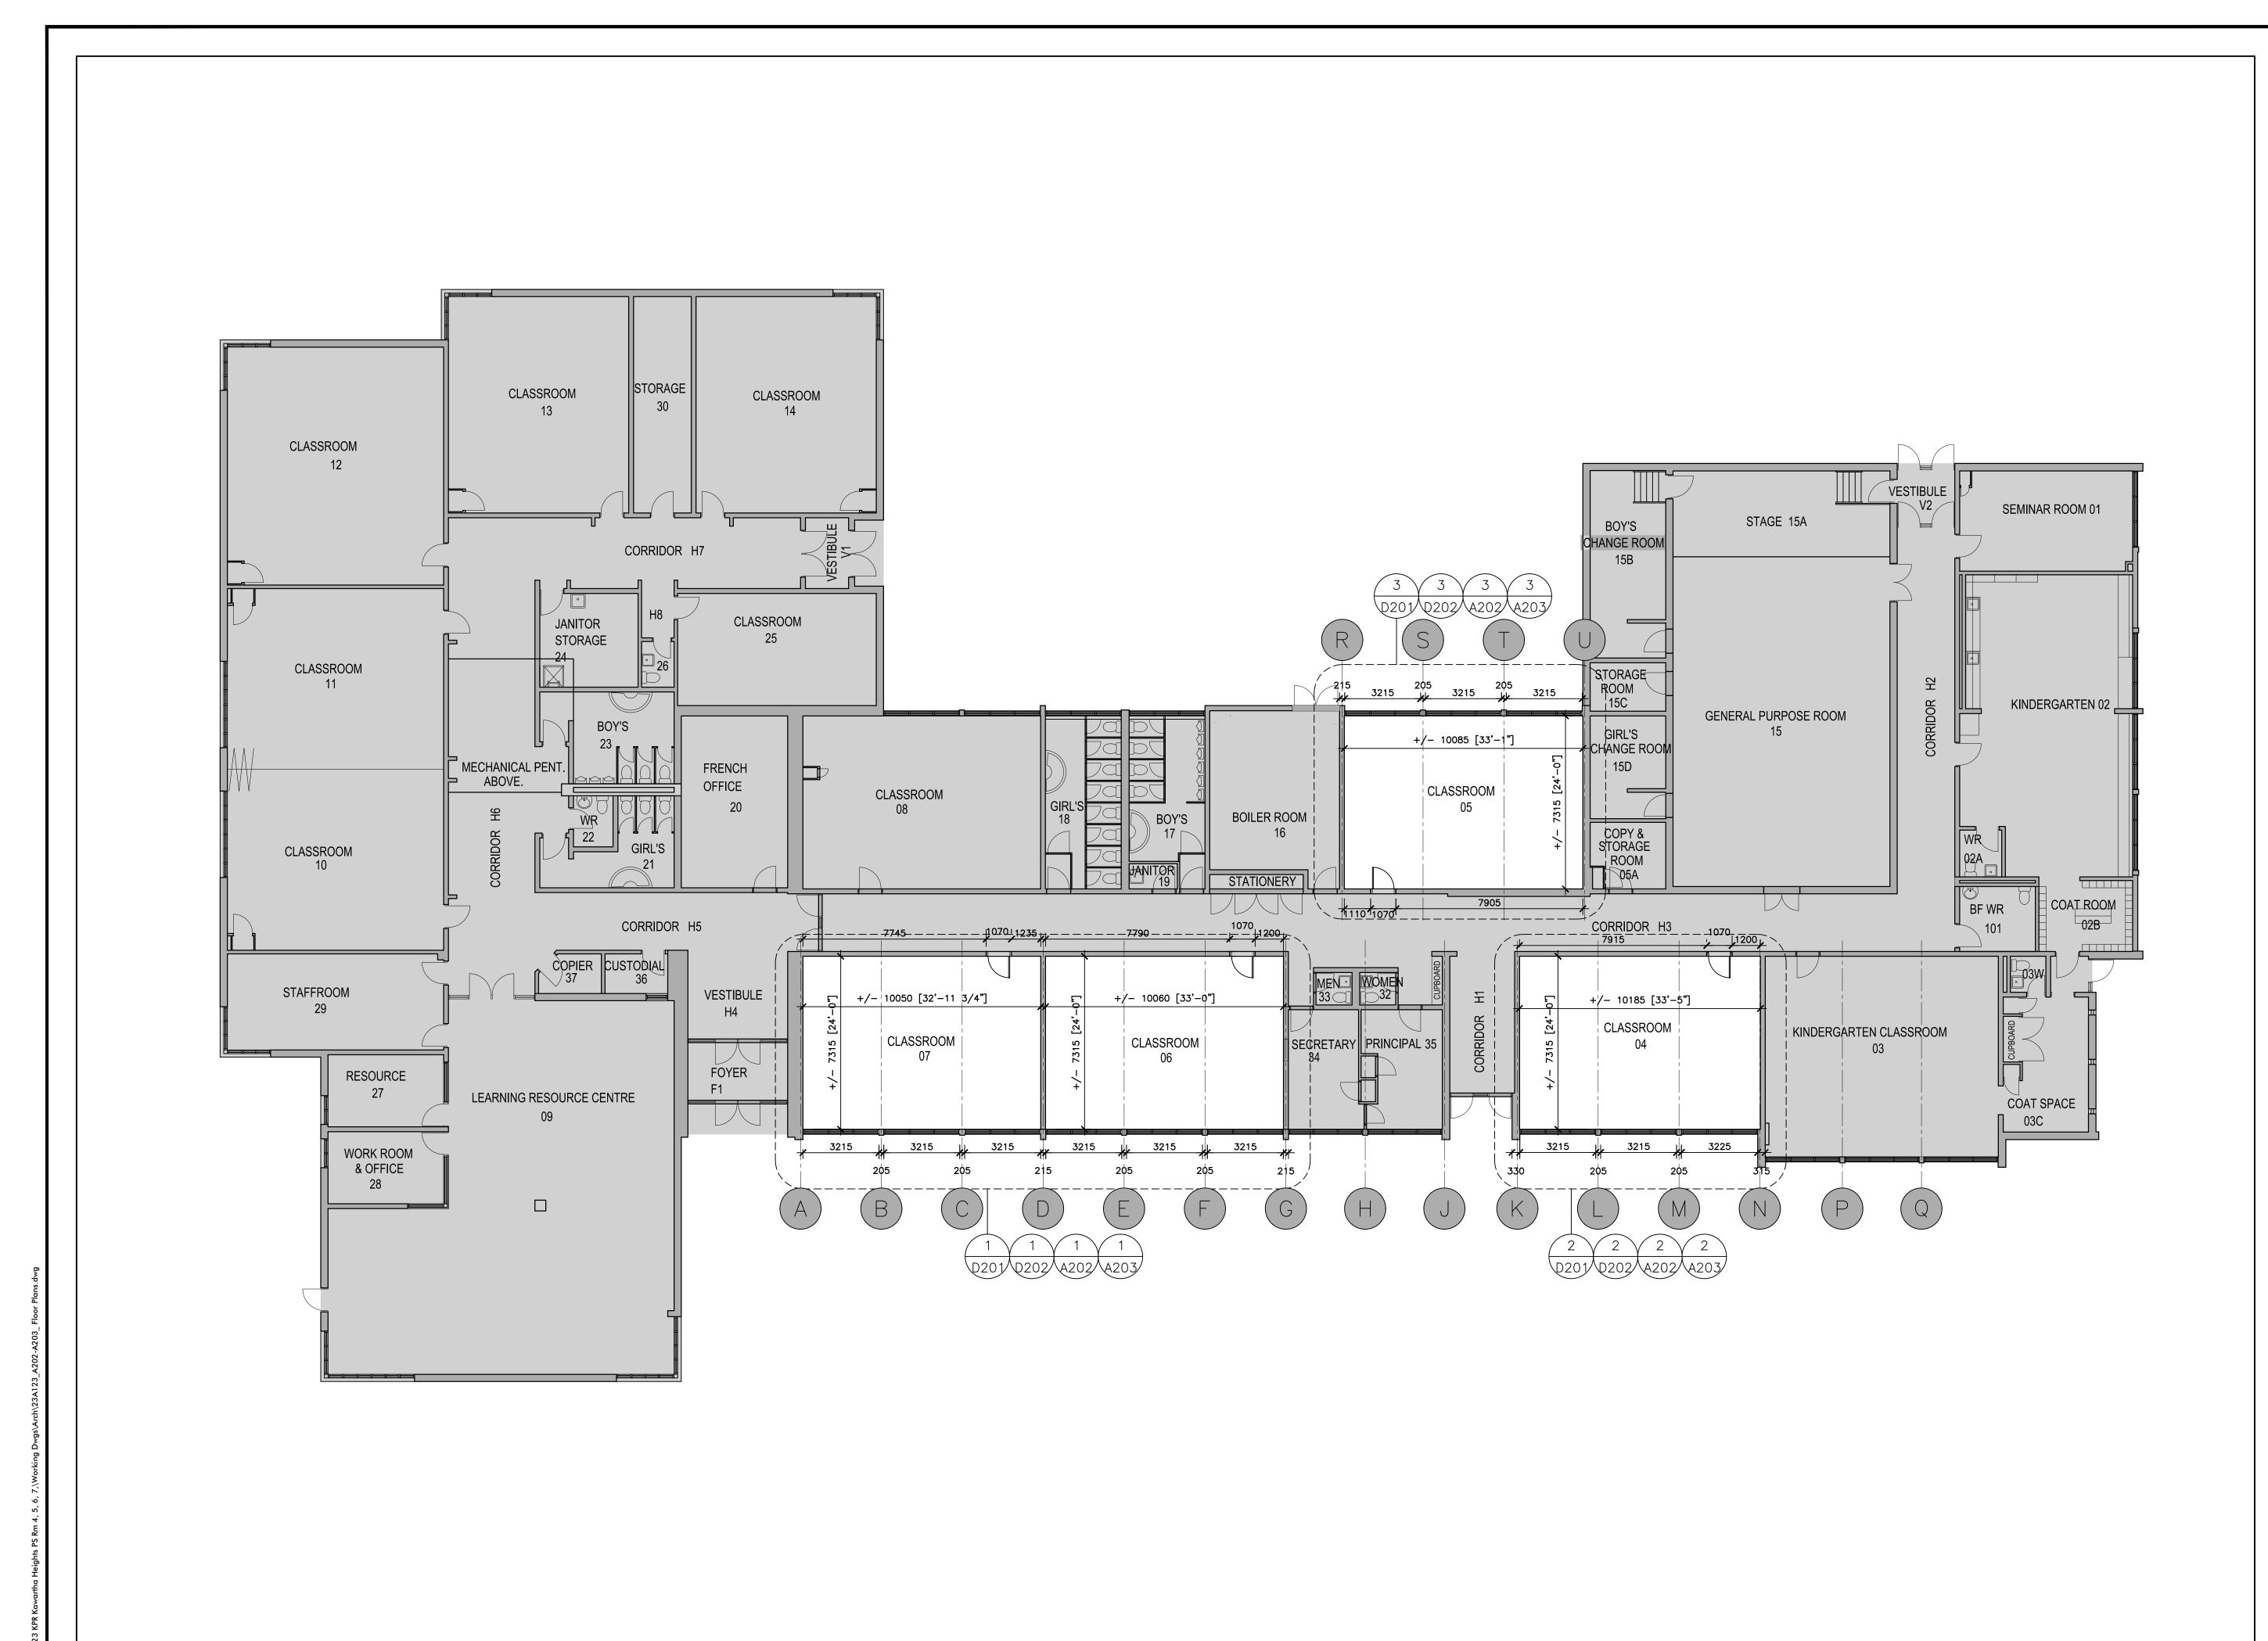

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KAWARTHA HEIGHTS P.S.
CLASSROOMS 4, 5, 6, & 7
RENOVATIONS

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PETERBOROUGH
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## GROUND FLOOR OVERALL FLOOR PLAN

Drawn By:	Checked By:	Project No.	
TJ/LR	ОМ		23A123
Date Plotted:	Scale:		
Mar 20, 2	AS NOTED		
Drawing No.:			Revision No.:
	3		

1 GROUND FLOOR — OVERALL FLOOR PLAN
A201 SCALE: 1:125

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DEMOLITION OF HAZARDOUS MATERIALS (TYPICAL)

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#### <u>DEMOLITION</u> LEGEND

EXISTING WALL, COLUMN OR PARTITION TO REMAIN

DEMOLITION OF BUILDING ELEMENT ----

ALL GRID LINES ARE EXISTING. NO CHANGES ARE PROPOSED. GRID DIMENSIONS ARE PROVIDED FOR REFERENCE ONLY. SITE VERIFY ALL DIMENSIONS.


#### **DEMOLITION NOTES**


ARCHITECTURAL DEMOLITION DRAWINGS AND NOTES TO BE READ IN CONJUNCTION WITH SPECIFICATION, AND FULL SETS OF ARCHITECTURAL, MECHANICAL AND ELECTRICAL DRAWINGS.

SEE INTERIOR ELEVATIONS - DEMOLITION DRAWINGS.


NOTE: ALL HOLES IN THE ENCLOSING WALLS MUST BE PATCHED AND SEALED (FIRE STOPPED OR CAULKING) TO CREATE A CONTINUOUS FIRE RESISTANT RATING AND MAINTAIN THE RÉQUIRED FIRE SEPARATION THROUGHOUT.

- REMOVE AND DISPOSE OF EXISTING FLOORING RESILIENT TILES AND RESILIENT WALL BASE INCLUDING ALL ADHESIVES. PATCH AND MAKE GOOD CONCRETE SLAB AND WALLS TO RECEIVE NEW FLOORING AND NEW WALL BASE. PROVIDE SELF-LEVELING UNDERLAYMENT AS REQUIRED. MEET OR EXCEED SUBSTRATE REQUIREMENTS FOR CONCRETE SLAB AND WALLS AND PARTITIONS AS SPECIFIED IN THE FLOORING AND WALL BASE SPECIFICATION SECTIONS.
- RESERVED
- REMOVE AND DISPOSE OF EXISTING MILLWORK, PATCH AND MAKE GOOD WALLS TO RECEIVE NEW WALL BASE AND DAVID. WALLS TO RECEIVE NEW WALL BASE AND PAINT.
- REMOVE & DISPOSE EXISTING WALL-MOUNTED WHITEBOARDS, CHALKBOARDS AND TACKBOARDS. PATCH AND MAKE GOOD WALLS.
- 5 EXISTING PROJECTOR SCREEN AND CONTROL TO BE REMOVED BY OWNER'S IT REPRESENTATIVE PRIOR TO SCOPE OF THIS WORK. THIS SCOPE TO PATCH AND MAKE GOOD WALLS. SEE ALSO ELECTRICAL DRAWINGS.
- 6 EXTG CONC BLOCK WALL. PATCH & REPAIR ANY DAMAGES CAUSED BY DEMOLITION TO MAINTAIN FIRE RATING.
- TO EXISTING RADIATOR WALL-FINS TO REMAIN, AND TO BE CLEANED. REMOVE AND DISPOSE OF RADIATOR COVERS. SEE MEST. STORES AND DISPOSE OF RADIATOR COVERS. SEÉ MECH. DWGS.
- 8 EXISTING FLOORING AND WALL BASE TO BE REMOVED UNDER RADIATORS, AND MILLWORK UP TO EXISTING TRANSITION AT DOOR THRESHOLDS, TYP.
- 9 REMOVE AND DISPOSE OF EXISTING HAND WASH SINKS INCLUDING PAPER TOWEL DISPENSER AND HAND SOAP DISPENSERS. SEE MECHANICAL DRAWINGS FOR REMOVALS/MODIFICATIONS TO PLUMBING. WHERE WALLS AND SLABS ARE DAMAGED BY THE REMOVALS, PATCH AND MAKE GOOD WITH LIKE ASSEMBLIES, MATERIALS AND FINISHES. FLOOR SLAB AND WALL PATCHES TO BE SMOOTH, LEVEL AND PLUMB.
- EXISTING WOOD DOOR AND HARDWARE TO BE REMOVED AND DISPOSED OF. EXISTING WOOD FRAME TO REMAIN. PATCH AND MAKE GOOD AS REQUIRED FOR NEW DOOR AND HARDWARE. PREP FRAME & TRIM FOR NEW PAINT.
- EXISTING WI-FI ACCESS POINTS TO BE REMOVED BY THIS CONTRACTOR, PRIOR TO DEMOLITION, AND KEEP SAFE UNTIL END OF CONSTRUCTION AND REINSTALLED IN THE EXACT SAME ROOM TO NEW LAYOUT CENTERED IN NEW CEILING. GC ELECTRICIAN TO COORDINATE WITH ELEC. CONSULTANT.

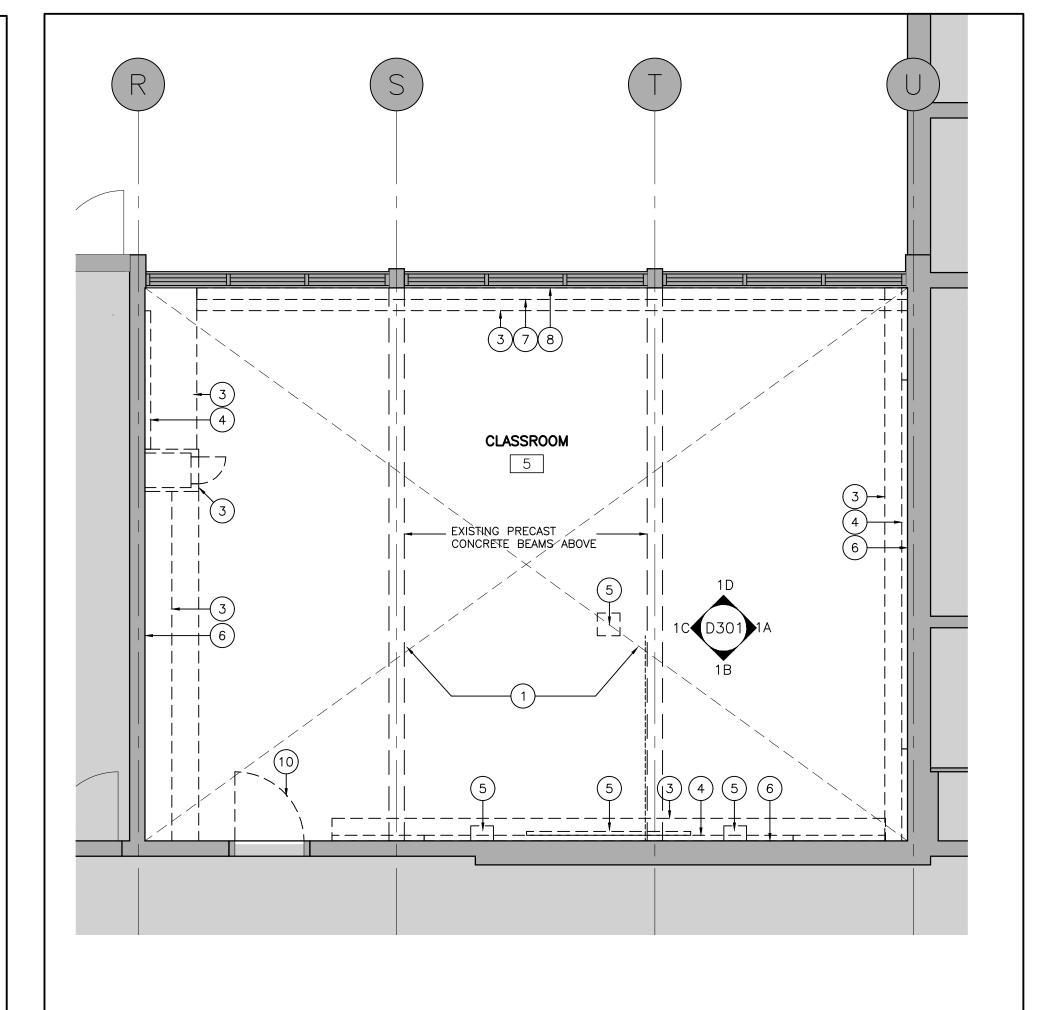

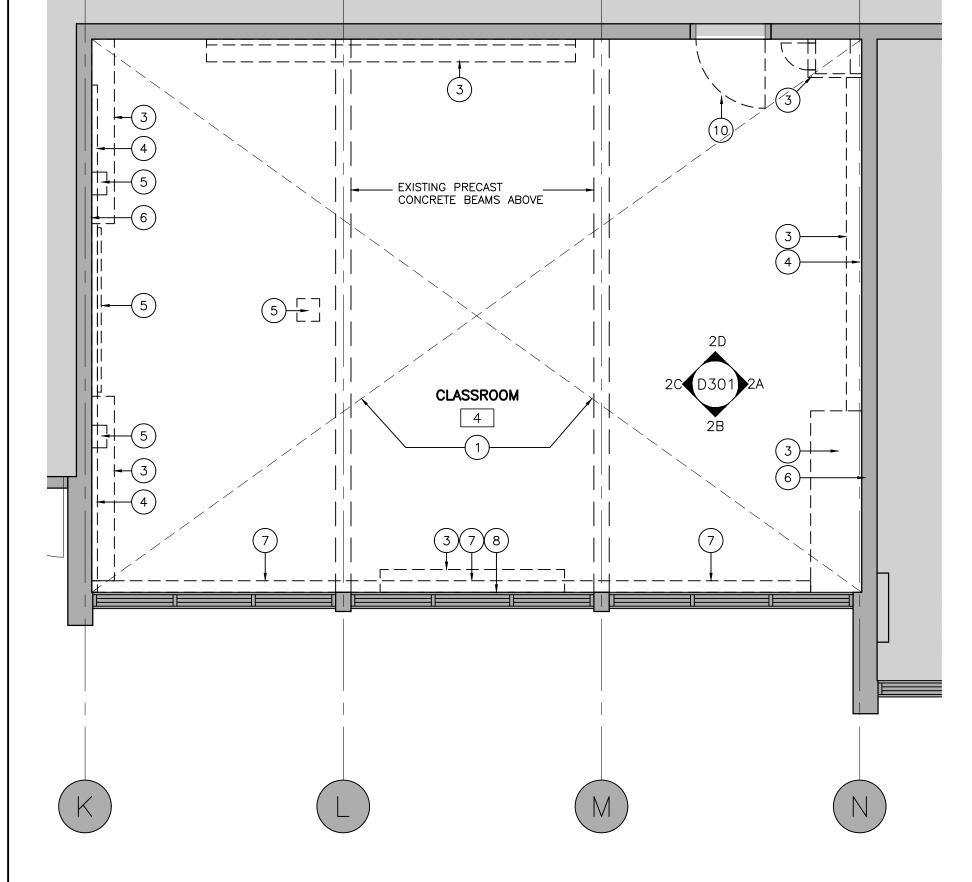

CLASSROOM 4 FLOOR PLAN - DEMO SCALE: 1:50

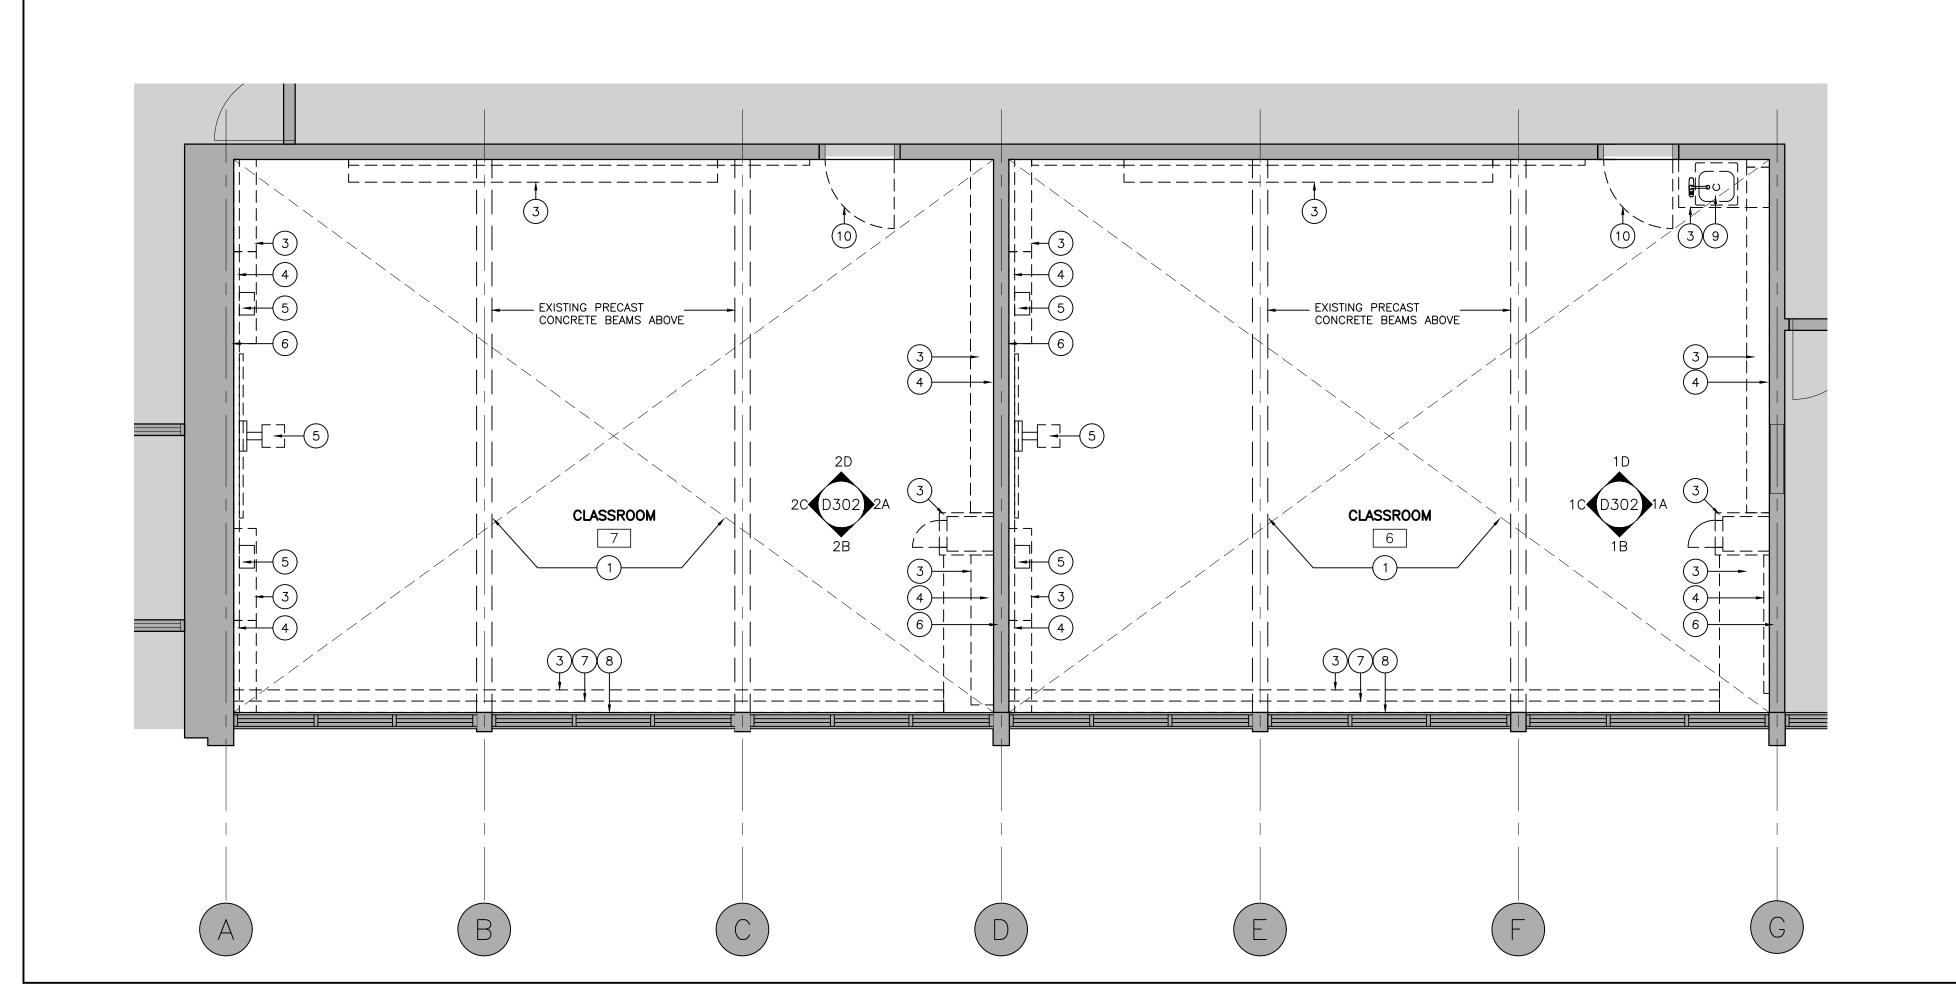

DEMO FLOOR PLAN LEGEND AND NOTES

CLASSROOMS 6 & 7 FLOOR PLAN - DEMO D201/ SCALE: 1:50

CLASSROOM 5 FLOOR PLAN - DEMO

SCALE: 1:50

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## GROUND FLR CLASSROOMS DEMOLITION FLOOR PLANS

23A123 TJ/LR OM Mar 20, 2024 - 9:58am Revision No.: D201

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SCALE: NTS

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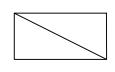
SCALE: NTS

RCP LEGEND


EXISTING WALL, COLUMN OR PARTITION TO REMAIN

\_ \_ \_ \_ \_ \_ \_ \_

DEMOLITION OF BUILDING ELEMENT



NEW LIGHT FIXTURE, SEE ELECTRICAL DRAWINGS

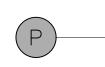

EXISTING GRID LINE REFERENCE. ALL GRID LINES ARE EXISTING. NO CHANGES ARE GRID DIMENSIONS ARE PROVIDED FOR REFERENCE ONLY. SITE VERIFY ALL DIMENSIONS.

#### RCP NOTES

DEMOLITION OF HAZARDOUS MATERIALS (TYPICAL)

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ARCHITECTURAL DRAWING AND NOTES TO BE READ IN CONJUNCTION WITH SPECIFICATION, AND FULL SETS OF ARCHITECTURAL, MECHANICAL AND ELECTRICAL

SEE INTERIOR ELEVATIONS. (DEMOLITION AND PROPOSED)

FULL EXTENT OF EXISTING ACOUSTIC CEILING TILES AND SMOKE DETECTORS ARE NOT SHOWN ON ARCHITECTURAL DRAWINGS. SITE VERIFY LOCATIONS AND QUANTITIES OF ALL CEILING-MOUNTED DEVICES AND EQUIPMENT. SEE MECHANICAL AND ELECTRICAL DRAWINGS.

NOTE: ALL HOLES IN THE ENCLOSING WALLS MUST BE PATCHED AND SEALED (FIRE STOPPED OR CAULKING) TO CREATE A CONTINUOUS FIRE RESISTANT RATING AND MAINTAIN THE REQUIRED FIRE SEPARATION THROUGHOUT.

#### GENERAL RCP NOTES

REFER TO MECHANICAL AND ELECTRICAL DRAWINGS FOR COORDINATION AND ADDITIONAL INFORMATION AND NOTES. EXCEPT WHERE NOTED OTHERWISE ON THE ELECTRICAL OR MECHANICAL DRAWINGS, RETAIN EXISTING FIRE ALARM

PROVIDE PAINT FINISH TO ALL EXPOSED MECHANICAL AND ELECTRICAL PIPES AND ASSOCIATED MECHANICAL AND ELECTRICAL COMPONENTS (NEW AND EXISTING).

ALL CEILING MOUNTED COMPONENTS AND EQUIPMENT ARE TO BE MOUNTED IN THE CENTER OF ACOUSTIC CEILING TILES. THE LOCATION OF ALL CEILING ACCESS PANELS ARE TO BE REVIEWED AND APPROVED BY THE ARCHITECT. ACCESS PANELS ARE TO BE PAINTED TO MATCH ADJACENT CEILING


REMOVE EXIST. ACT & T-BAR CEILING, EX. LIGHT FIXTURES, EX. SMOKE DETECTOR, EX. MECH. VENTS AND AIR SUPPLY GRILLES AND ALL CEILING MOUNTED ITEMS. (TYP.). INSPECT ALL FIRE SEPARATIONS ABOVE EXISTING CEILINGS AND ENSURE FIRE SEPARATIONS ARE CONTINUOUS TO U/S OF ROOF DECK. PATCH AND REPAIR AS NEEDED TO MAINTAIN FIRE SEPARATIONS.

AND FIRE SAFETY PROTECTION ITEMS WITHIN THE AREAS WHERE WORK IS OCCURRING.


- REMOVE AND DISPOSE OF EXISTING LIGHT FIXTURES. SEE ELECTRICAL
- ALL EXISTING ELECTRICAL PANELS, CONDUIT, DEVICES, JUNCTION BOXES, ETC. LOCATED AT UNDERSIDE OF PRECAST CONCRETE SLAB AND BEAMS TO BE VERIFIED BY ELECTRICAL. ALSO SEE MECHANICAL AND ELECTRICAL DRAWINGS. SITE VERIFY QUANTITIES AND EXTENT. ALL EXISTING PHONE/DATA DROPS TO REMAIN.
- 4) EXISTING WALL-MOUNTED OR CEILING-MOUNTED PROJECTOR SCREEN AND CONTROL TO BE REMOVED BY OWNER IT REPRESENTATIVE PRIOR TO SCOPE OF THIS WORK. THIS SCOPE TO PATCH AND MAKE GOOD WALLS AND CEILING SLAB. SEE ELECTRICAL DRAWINGS.
- 5) CLEAN AND PREP EXISTING PRECAST CONCRETE BEAMS FOR NEW PAINT
- REMOVE AND DISPOSE OF EXISTING CEILING FANS. SEE ELECTRICAL
- NEW T-BAR CEILING TO EXTEND TO EXISTING CONCRETE BLOCK DEMISING WALLS
- OR NEW GWB FURRING, TYPICAL. NEW LIGHT FIXTURES. SEE ELECTRICAL DRAWINGS
- PROVIDE NEW WALL-MOUNTED INTERACTIVE WHITEBOARD WITH NEW ELECTRICAL RECEPTACLES AT HIGH LEVEL FOR OWNER PROVIDED WALL-MOUNTED PROJECTOR. SEE ELECTRICAL DRAWINGS.
- EXISTING WALL-MOUNTED OR CEILING-MOUNTED WIRELESS ACCESS POINT. PRIOR TO DEMOLITION, ELECTRICAL CONTRACTOR TO REMOVE AND KEEP SAFE UNTIL END OF CONSTRUCTION, AND RE-INSTALL IN NEW CEILING MOUNTED LOCATION. SEE ELECTRICAL DRAWINGS.
- NEW GYPSUM BOARD BULKHEAD IN FRONT OF EXISTING WINDOWS AND FOR HYDRONIC PIPING TO RADIATORS. PAINT FINISH. SEE DETAILS. HYDRONIC PIPING TO RADIATORS. PAINT FINISH. SEE DETAILS.
- NEW LOW-PROFILE CEILING FANS MOUNTED TO U/S OF NEW T-BAR CEILING WITH DROP CEILING MOUNT TO U/S OF EXISTING ROOF SLAB ABOVE. SEE MECHANICAL AND ELECTRICAL DRÁWINGS.

DEMO REFL. CLG PLAN LEGEND AND NOTES


NEW PAINT ON EXPOSED BOTTOM FACE AND SIDES OF EXISTING PRECAST CONCRETE BEAMS. CONCRETE BEAMS.

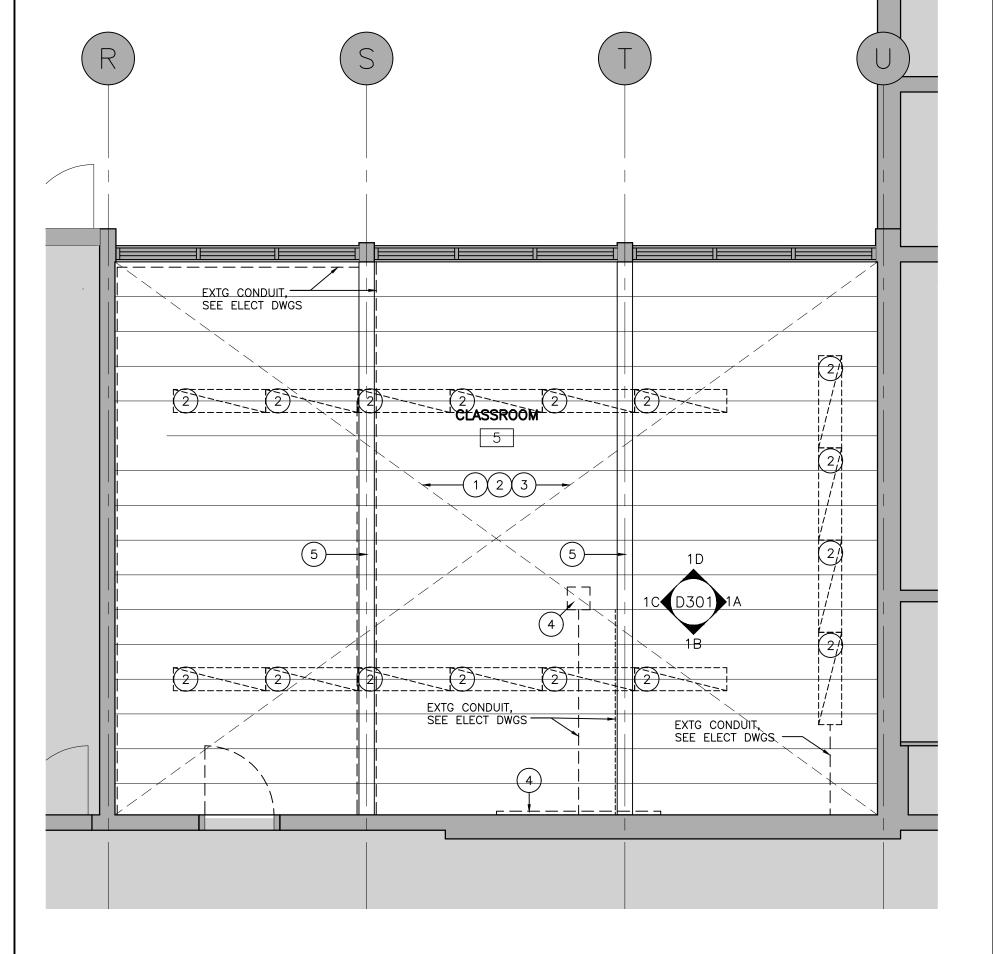

CLASSROOM 5 REFLECTED CEILING PLAN - DEMO SCALE: 1:50

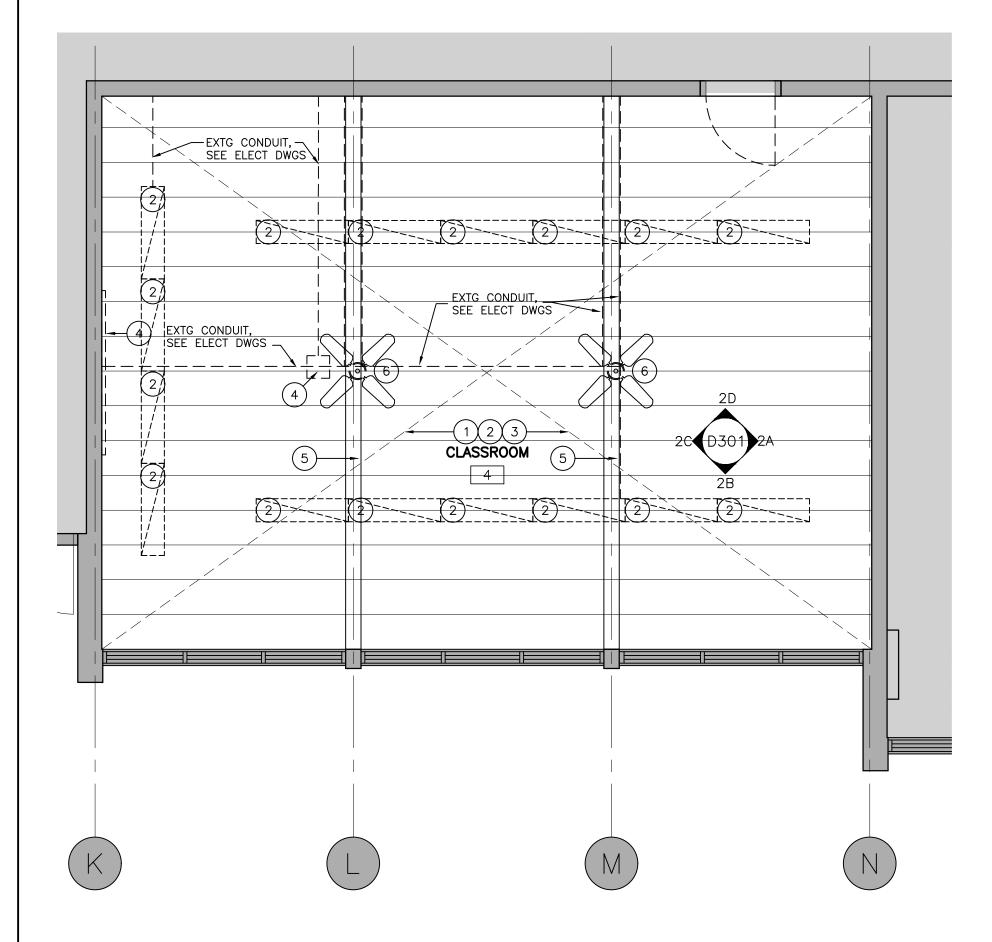

CLASSROOM 4 REFLECTED CEILING PLAN - DEMO SCALE: 1:50

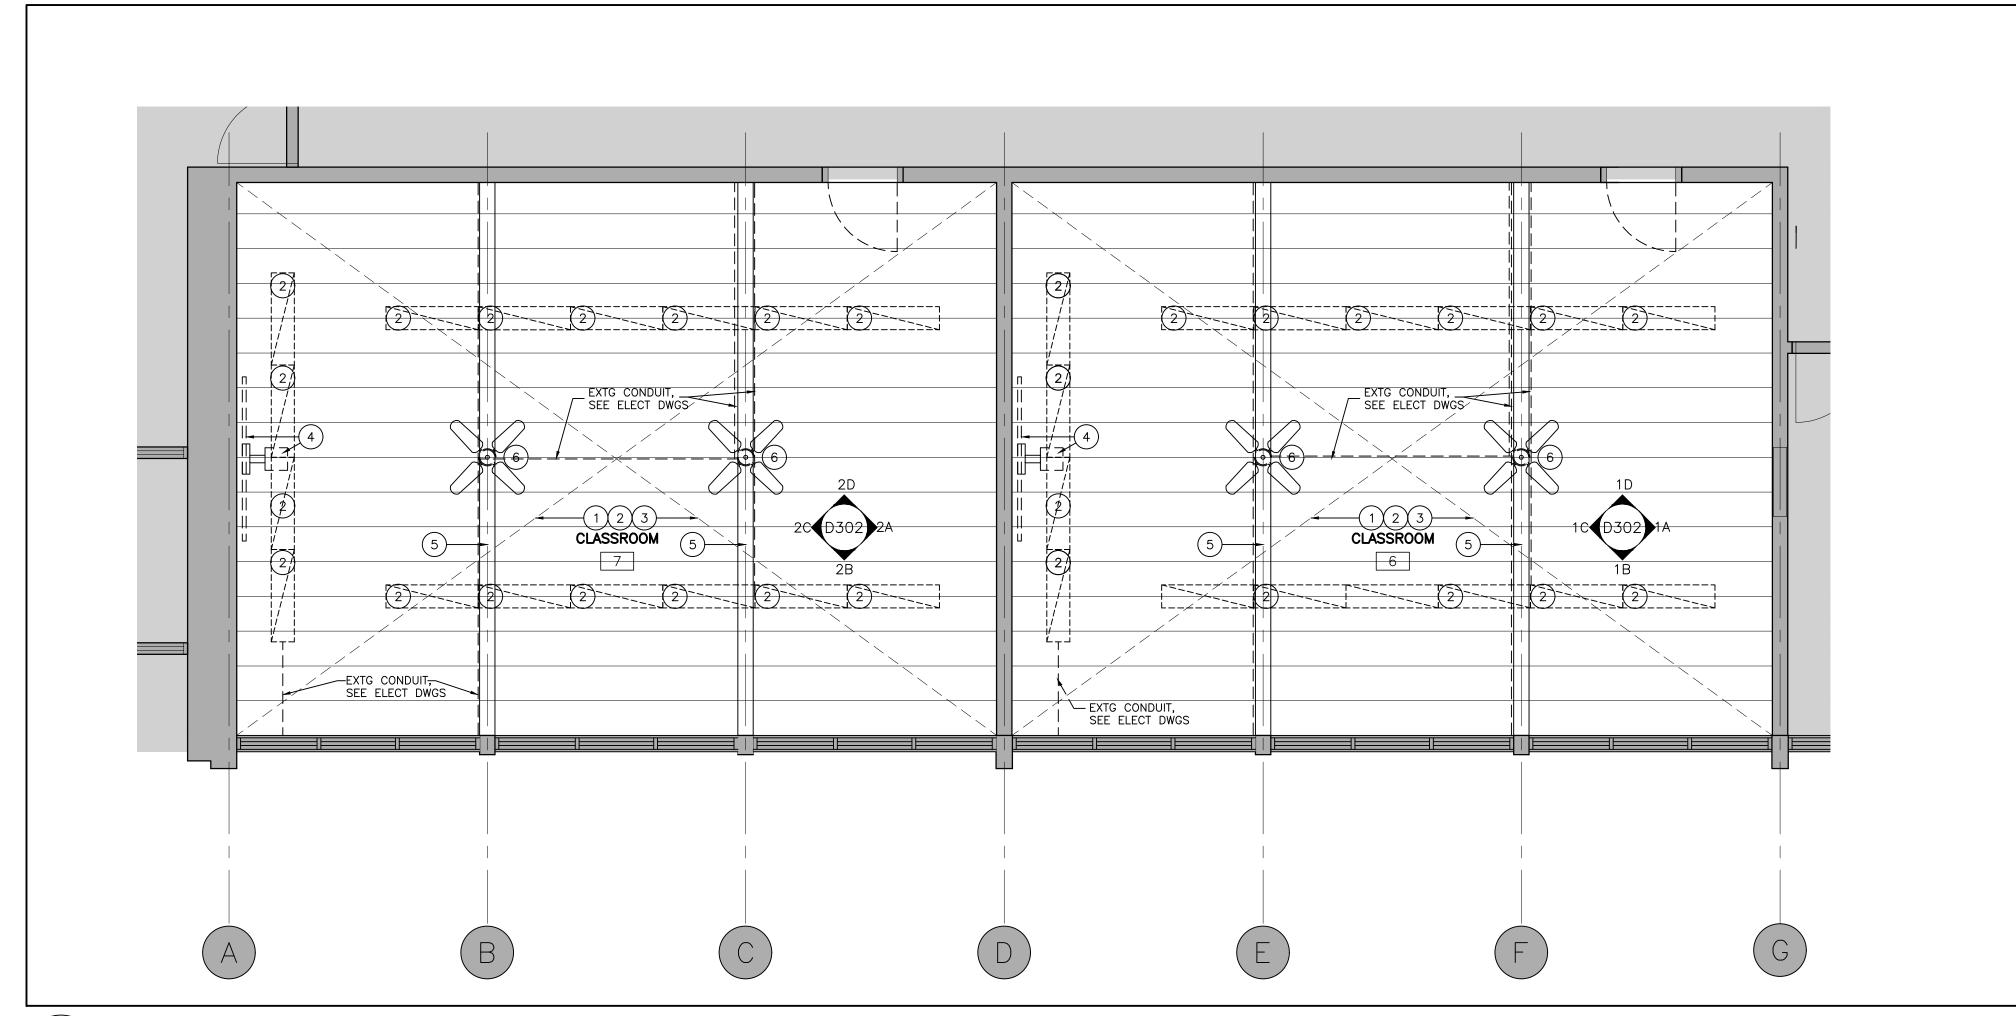

CLASSROOMS 6 & 7 REFLECTED CEILING PLAN - DEMO D202/ SCALE: 1:50

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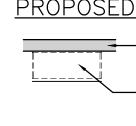
KAWARTHA HEIGHTS P.S. CLASSROOMS 4, 5, 6, & 7 RENOVATIONS

KAWARTHA PINE RIDGE DISTRICT SCHOOL BD 11 KAWARTHA HEIGHTS BOULEVARD PETERBOROUGH ONTARIO

## GROUND FLR CLASSROOMS DEMOLITION REFL CLG PLANS

Drawn By: Checked By: Date Checked: TJ/LR OM 23A123 Date Plotted: Mar 20, 2024 - 9:58am 1:50 Revision No.: **D202** 





PROPOSED LEGEND

- EXISTING WALL, COLUMN OR PARTITION TO REMAIN

NEW MILLWORK, SEE PLAN, DETAILS AND SPECIFICATION

EXISTING GRID LINE REFERENCE.

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PROPOSED NOTES

ARCHITECTURAL DRAWING AND NOTES TO BE READ IN CONJUNCTION WITH SPECIFICATION, AND FULL SETS OF ARCHITECTURAL, MECHANICAL AND ELECTRICAL DRAWINGS.

SEE INTERIOR ELEVATIONS.

NOTE: ALL HOLES IN THE ENCLOSING WALLS MUST BE PATCHED AND SEALED (FIRE STOPPED OR CAULKING) TO CREATE A CONTINUOUS FIRE RESISTANT RATING AND MAINTAIN THE REQUIRED FIRE SEPARATION THROUGHOUT.

- PROVIDE NEW FLOORING. SEE FINISH SCHEDULE AND SPECIFICATION.
  PROVIDE SELF—LEVELING UNDERLAYMENT AS REQUIRED. MEET OR
  EXCEED SUBSTRATE REQUIREMENTS FOR CONCRETE SLAB AS SPECIFIED
  IN THE FLOORING SPECIFICATION SECTION.
  - SUB-FLOOR SHALL COMPLY TO ASTM F 710 STANDARD PRACTICE FOR PREPARING CONCRETE FLOORS TO RECEIVE RESILIENT FLOORING.

    PROVIDE NEW WALL BASE. SEE FINISH SCHEDULE AND SPECIFICATION. PROVIDE SELF-LEVELLING UNDERLAYMENT AS REQUIRED. MEET OR

EXCEED SUBSTRATE REQUIREMENTS FOR WALLS AND PARTITIONS AS

- SPECIFIED IN THE WALL BASE SPECIFICATION SECTION.


  PROVIDE NEW DOOR & HARDWARE IN EXISTING WOOD FRAME. PROVIDE NEW DOOR NUMBER SIGN AND ROOM NAME SIGN. PLAM FINISH ON DOOR AND PAINT EXISTING WOOD FRAME, PT-2 (RACCOON FUR) ON BOTH SIDES. (CONFIRM DIMENSIONS ON SITE PRIOR TO ORDERING).
- PROVIDE NEW CLASSROOM CONTROL PANEL WITH CLOCK, LIGHT SWITCHES, PA CALL SWITCH, PA SPEAKER GRILL, DUPLEX RECEPTACLE, SEE DETAILS AND ALSO ELECTRICAL DRAWINGS.
- ARCHITECTURAL MILLWORK: SEE A500 SERIES DWGS AND SPEC, PROVIDE SHOP DWG & MOCK UP.

SEE DOOR SCHEDULE, SIGN DETAIL AND SPECIFICATION.

- PROVIDE NEW PAINT FINISH ON ALL INTERIOR PAINTABLE SURFACES INCLUDING EXISTING PRECAST CONCRETE BEAMS AND COLUMNS, SEE FINISH SCHEDULE AND SPECIFICATION.
- PROVIDE NEW RESILIENT TRANSITION STRIP AT DOOR. SEE FINISH SCHEDULE AND SPECIFICATION. PROVIDE SELF-LEVELING UNDERLAYMENT
- WINDOWS: REMOVE DIRT AND DEBRIS FROM WINDOW FRAME AND GLAZING. WASH, CLEAN, REMOVE OXIDATION FROM ALUMINUM FRAME. CHECK OPENING HARDWARE AND REPLACE IF REQUIRED. REMOVE EXTG CAULKING, RE—CAULK AROUND FRAMES INTERIOR SIDE ONLY. MAKE GOOD ALL GLAZING & FRAMES SO THAT GLAZING AND FRAMES LOOK AS NEW. SUPPLY AND INSTALL NEW SHADES AND NEW BLINDS TO KPRDSB STANDARDS. PROVIDE CUTSHEET & SAMPLES. PATCH AND PAINT EXISTING DRYWALL SPANDREL PANELS IN UPPER PORTION OF ALL WINDOWS
- SUPPLY AND INSTALL NEW WALL MOUNTED INTERACTIVE WHITE BOARD DA-LITE IDEA SCREEN. 1350H X 2150W. PROVIDE BLOCKING AS REQUIRED. SEE SPECIFICATION. SEE ARCHITECTURAL FLOOR PLAN AND ELECTRICAL DRAWINGS FOR COORDINATION OF POWER AND DATA REQUIREMENTS. DO NOT INSTALL SUPPLIED MARKER TRAY.
- NEW WALL-MOUNTED MARKERBOARDS (WHITE BOARD) AND TACKBOARDS MANUFACTURED BY ARCHITECTURAL SCHOOL PRODUCTS OR EQUIVALENT PRODUCTS AS SUPPLIED BY GLOBAL SCHOOL PRODUCTS INC. PROVIDE SUPPORTS. C/W CLEAR ANODIZED ALUMINUM FRAME. MAP RAIL WITH CORK INSERT, REQ'D DIVIDER STRIP AND MARKER/CHALK TRAY.
- NEW ROLLER BLINDS. SUPPLY AND INSTALL NEW SHADES AND NEW BLINDS TO KPRDSB STANDARDS. PROVIDE CUTSHEET & SAMPLES.
- NEW TEACHERS' CLOSET (TC)/STORAGE UNIT (SU), REFER TO A500 SERIES DWG FOR
- (28) PLAM BACKSPLASH ON BACK AND SIDE WALL, SEE DETAILS.
- CHARGING TOWER SUPPLIED BY OWNER AND INSTALLED BY GC. NO SERVICES, INCLUDING SURFACE MOUNTED CONDUIT (NEW OR EXISTING) ARE TO BE RUN BEHIND THE SPACE WHERE CHARGING TOWER TO BE
- (30) NEW HAT SHELF WITH COAT HOOKS, SEE DETAIL AND SPECS.
- EXISTING RADIANT HEATERS TO REMAIN. CLEAN EXISTING HEATING UNITS. REMOVE GRILLES AND CLEAN ALL DEBRIS OUT OF THE INTERNALS. SEE


PROPOSED FLOOR PLAN LEGEND & NOTES

(32) NEW GYPSUM BOARD BULKHEAD ABOVE, SEE DETAIL 2/A801

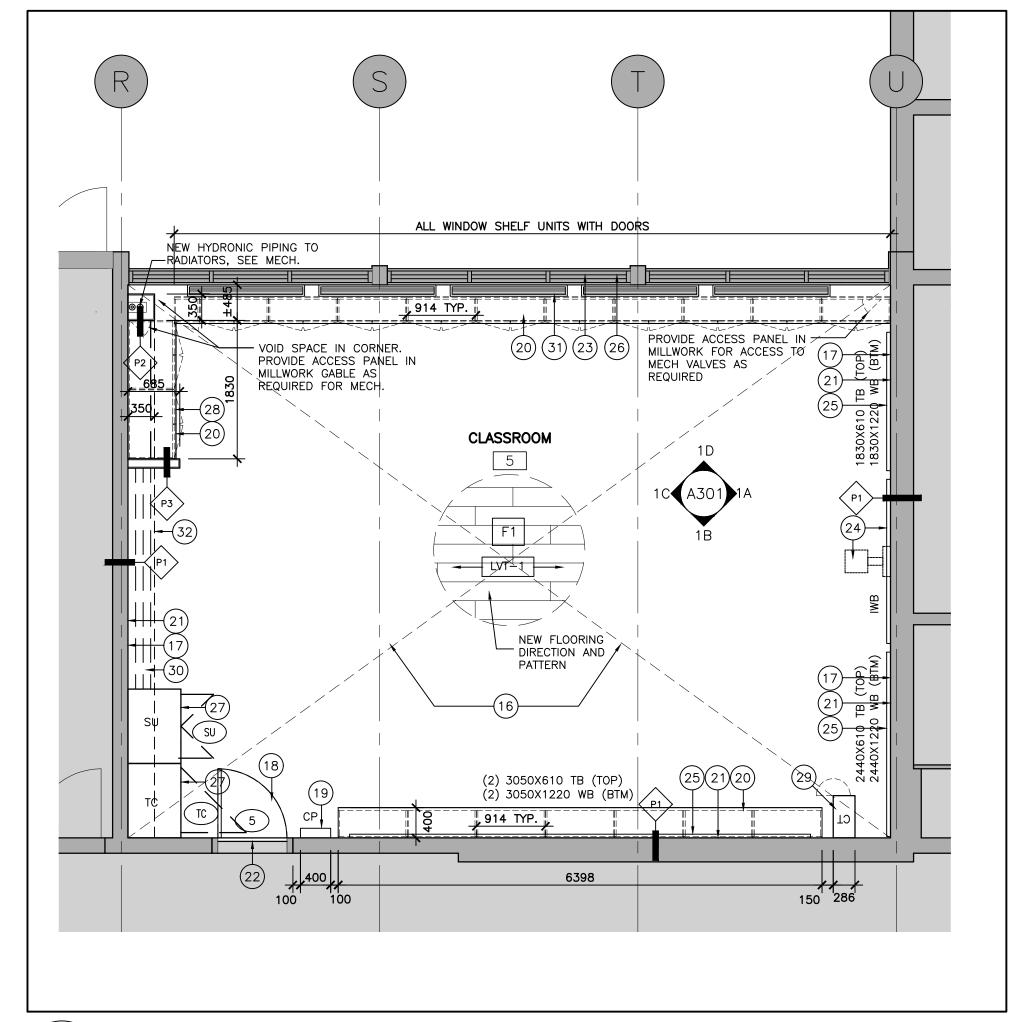


CLASSROOM 5 FLOOR PLAN - PROPOSED

SCALE: 1:50

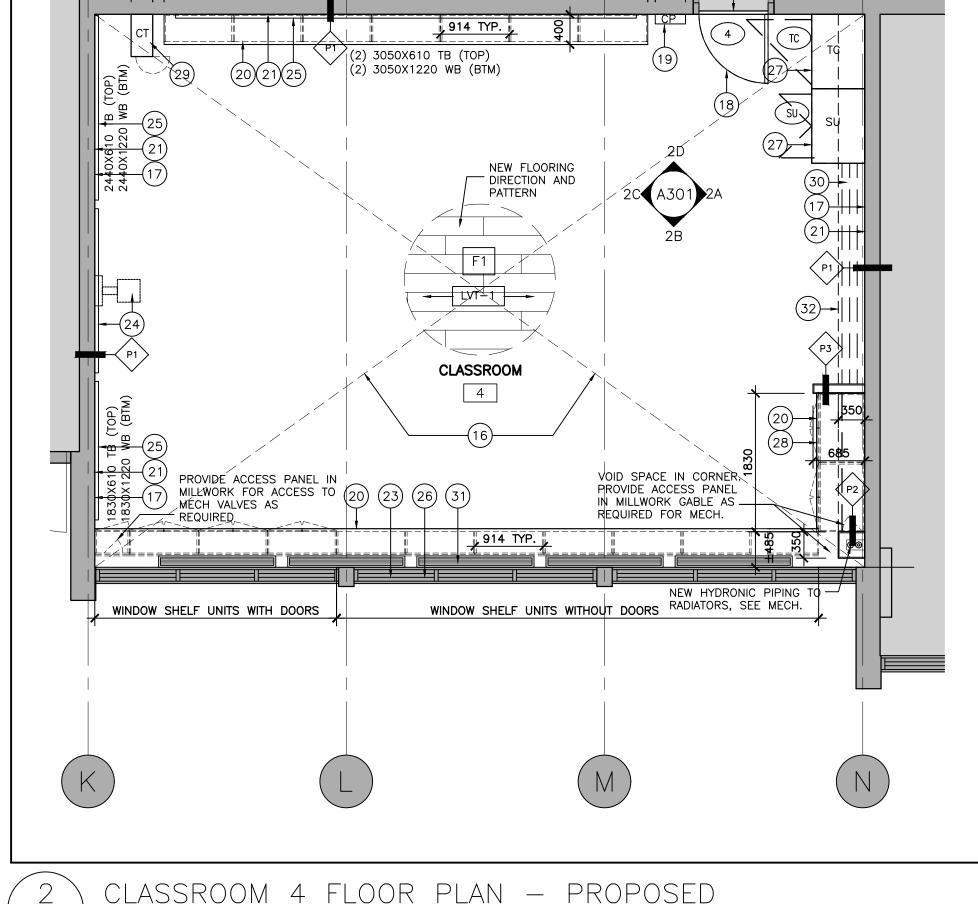

2 CLASSROOM 4 FLOOR PLAN — PROPOSED A202 SCALE: 1:50

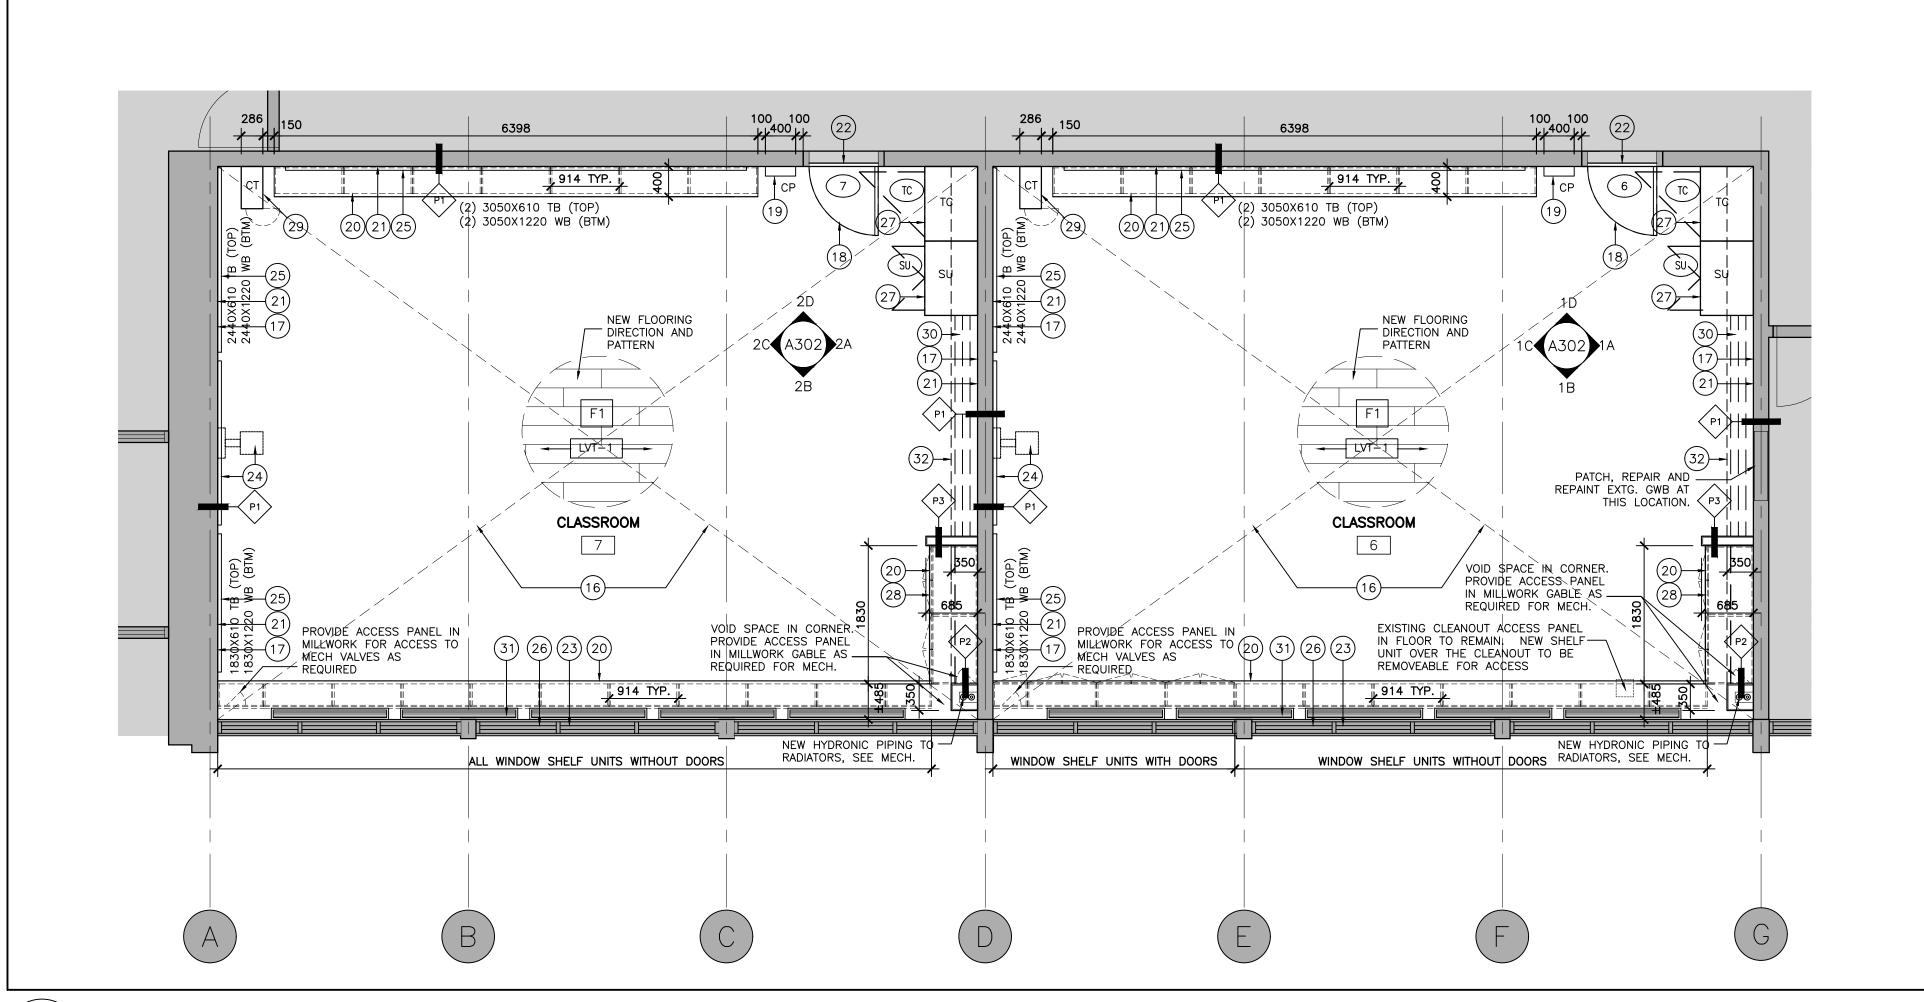

1 CLASSROOMS 6 & 7 FLOOR PLAN — PROPOSED A202 SCALE: 1:50

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GROUND FLR CLASSROOMS
PROPOSED FLOOR PLANS

 Drawn By:
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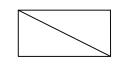
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RCP LEGEND


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DEMOLITION OF BUILDING ELEMENT



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#### RCP NOTES

DEMOLITION OF HAZARDOUS MATERIALS (TYPICAL)

G.C. TO REVIEW ABATEMENT CONSULTANTS REPORT AND RECOMMENDATIONS REGARDING THE REMOVAL OF HAZARDOUS BUILDING MATERIALS. REFER TO HAZARDOUS BUILDING MATERIALS ASSESSMENT REPORT ALONG WITH SPECIFICATIONS AND CONTRACT DOCUMENTS PREPARED BY PINCHIN REGARDING THE REMOVAL AND DEMOLITION OF ALL HAZARDOUS MATERIALS.

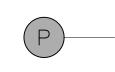ARCHITECTURAL DRAWING AND NOTES TO BE READ IN CONJUNCTION WITH SPECIFICATION, AND FULL SETS OF ARCHITECTURAL, MECHANICAL AND ELECTRICAL

SEE INTERIOR ELEVATIONS. (DEMOLITION AND PROPOSED)

FULL EXTENT OF EXISTING ACOUSTIC CEILING TILES AND SMOKE DETECTORS ARE NOT SHOWN ON ARCHITECTURAL DRAWINGS. SITE VERIFY LOCATIONS AND QUANTITIES OF ALL CEILING-MOUNTED DEVICES AND EQUIPMENT. SEE MECHANICAL AND ELECTRICAL DRAWINGS.

NOTE: ALL HOLES IN THE ENCLOSING WALLS MUST BE PATCHED AND SEALED (FIRE STOPPED OR CAULKING) TO CREATE A CONTINUOUS FIRE RESISTANT RATING AND MAINTAIN THE REQUIRED FIRE SEPARATION THROUGHOUT.

#### GENERAL RCP NOTES

REFER TO MECHANICAL AND ELECTRICAL DRAWINGS FOR COORDINATION AND ADDITIONAL INFORMATION AND NOTES. EXCEPT WHERE NOTED OTHERWISE ON THE ELECTRICAL OR MECHANICAL DRAWINGS, RETAIN EXISTING FIRE ALARM AND FIRE SAFETY PROTECTION ITEMS WITHIN THE AREAS WHERE WORK IS OCCURRING.

PROVIDE PAINT FINISH TO ALL EXPOSED MECHANICAL AND ELECTRICAL PIPES AND ASSOCIATED MECHANICAL AND ELECTRICAL COMPONENTS (NEW AND EXISTING).

ALL CEILING MOUNTED COMPONENTS AND EQUIPMENT ARE TO BE MOUNTED IN THE CENTER OF ACOUSTIC CEILING TILES. THE LOCATION OF ALL CEILING ACCESS PANELS ARE TO BE REVIEWED AND APPROVED BY THE ARCHITECT. ACCESS PANELS ARE TO BE PAINTED TO MATCH ADJACENT CEILING


- REMOVE EXIST. ACT & T-BAR CEILING, EX. LIGHT FIXTURES, EX. SMOKE DETECTOR, EX. MECH. VENTS AND AIR SUPPLY GRILLES AND ALL CEILING MOUNTED ITEMS. (TYP.). INSPECT ALL FIRE SEPARATIONS ABOVE EXISTING CEILINGS AND ENSURE FIRE SEPARATIONS ARE CONTINUOUS TO U/S OF ROOF DECK. PATCH AND REPAIR AS NEEDED TO MAINTAIN FIRE SEPARATIONS.
- REMOVE AND DISPOSE OF EXISTING LIGHT FIXTURES. SEE ELECTRICAL
- 3 ALL EXISTING ELECTRICAL PANELS, CONDUIT, DEVICES, JUNCTION BOXES, ETC. LOCATED AT UNDERSIDE OF PRECAST CONCRETE SLAB AND BEAMS TO BE LOCATED AT UNDERSIDE OF PRECAST CONCRETE SLAB AND BEAMS TO BE VERIFIED BY ELECTRICAL. ALSO SEE MECHANICAL AND ELECTRICAL DRAWINGS. SITE VERIFY QUANTITIES AND EXTENT. ALL EXISTING PHONE/DATA DROPS TO REMAIN.
- 4) EXISTING WALL-MOUNTED OR CEILING-MOUNTED PROJECTOR SCREEN AND CONTROL TO BE REMOVED BY OWNER IT REPRESENTATIVE PRIOR TO SCOPE OF THIS WORK. THIS SCOPE TO PATCH AND MAKE GOOD WALLS AND CEILING SLAB. SEE ELECTRICAL DRAWINGS.
- (5) CLEAN AND PREP EXISTING PRECAST CONCRETE BEAMS FOR NEW PAINT
- REMOVE AND DISPOSE OF EXISTING CEILING FANS. SEE ELECTRICAL
- 7 NEW T-BAR CEILING TO EXTEND TO EXISTING CONCRETE BLOCK DEMISING WALLS OR NEW GWB FURRING TYPICAL
- OR NEW GWB FURRING, TYPICAL. NEW LIGHT FIXTURES. SEE ELECTRICAL DRAWINGS

A203 SCALE: NTS


- PROVIDE NEW WALL-MOUNTED INTERACTIVE WHITEBOARD WITH NEW ELECTRICAL RECEPTACLES AT HIGH LEVEL FOR OWNER PROVIDED WALL-MOUNTED PROJECTOR. SEE ELECTRICAL DRAWINGS.
- EXISTING WALL-MOUNTED OR CEILING-MOUNTED WIRELESS ACCESS POINT.
  PRIOR TO DEMOLITION FLECTRICAL CONTRACTOR TO REMOVE AND KEEP PRIOR TO DEMOLITION, ELECTRICAL CONTRACTOR TO REMOVE AND KEEP SAFE UNTIL END OF CONSTRUCTION, AND RE-INSTALL IN NEW CEILING MOUNTED LOCATION. SEE ELECTRICAL DRAWINGS.
- NEW GYPSUM BOARD BULKHEAD IN FRONT OF EXISTING WINDOWS AND FOR HYDRONIC PIPING TO RADIATORS. PAINT FINISH. SEE DETAILS. HYDRONIC PIPING TO RADIATORS. PAINT FINISH. SEE DETAILS.
- NEW LOW-PROFILE CEILING FANS MOUNTED TO U/S OF NEW T-BAR CEILING WITH DROP CEILING MOUNT TO U/S OF EXISTING ROOF SLAB ABOVE. SEE MECHANICAL AND ELECTRICAL DRÁWINGS.

PROPOSED R.C.P. LEGEND & NOTES


NEW PAINT ON EXPOSED BOTTOM FACE AND SIDES OF EXISTING PRECAST CONCRETE BEAMS. CONCRETE BEAMS.

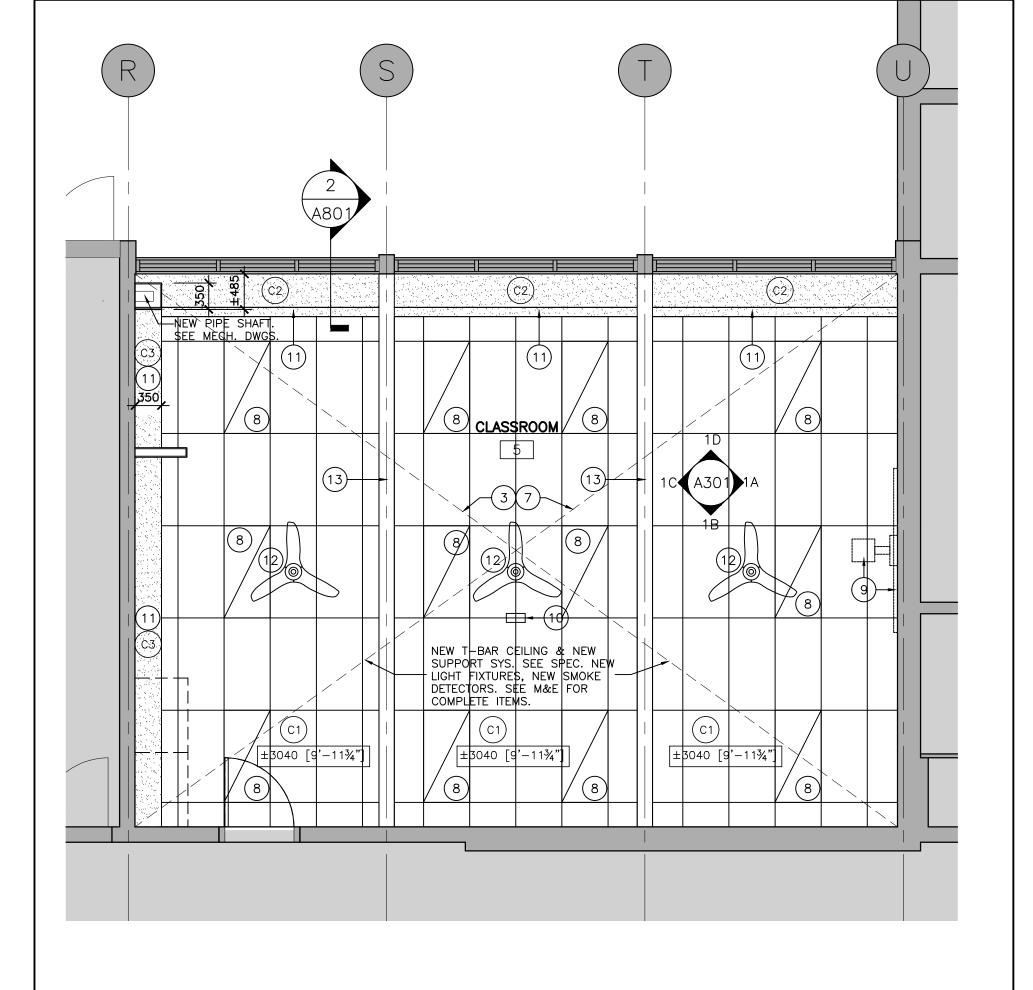

CLASSROOM 5 REFLECTED CEILING PLAN - PROPOSED SCALE: 1:50

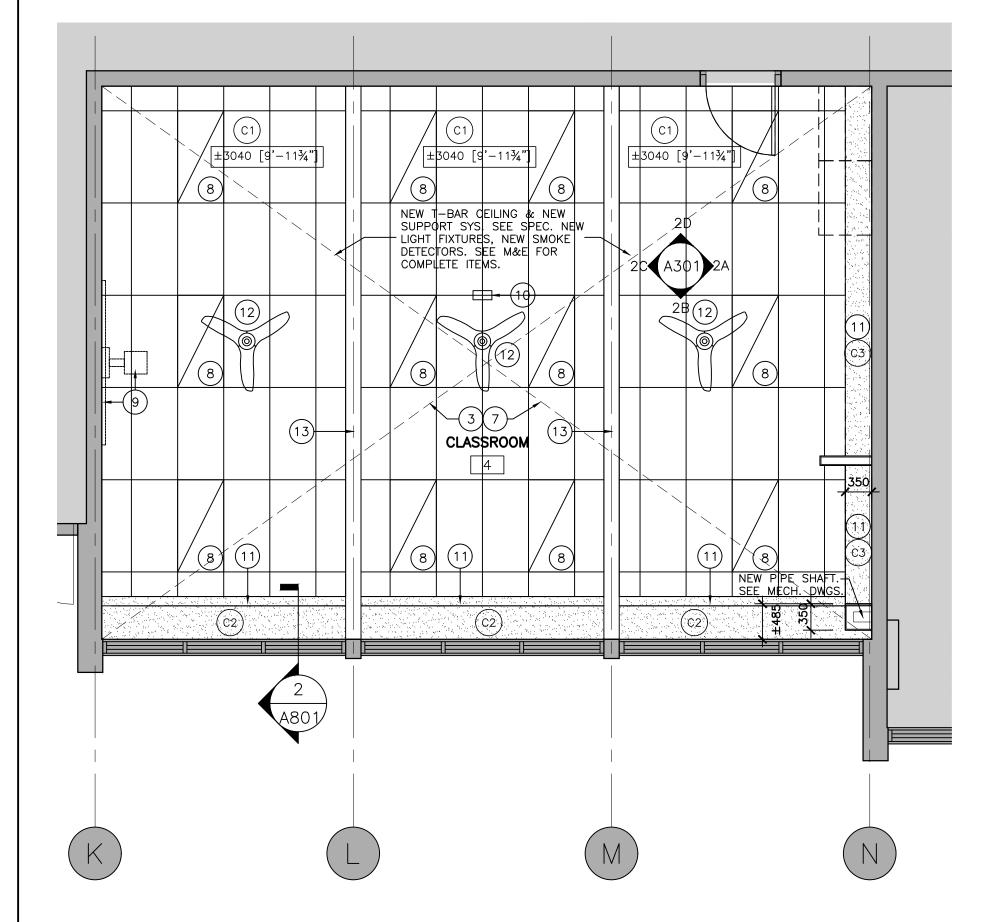

CLASSROOM 4 REFLECTED CEILING PLAN - PROPOSED SCALE: 1:50

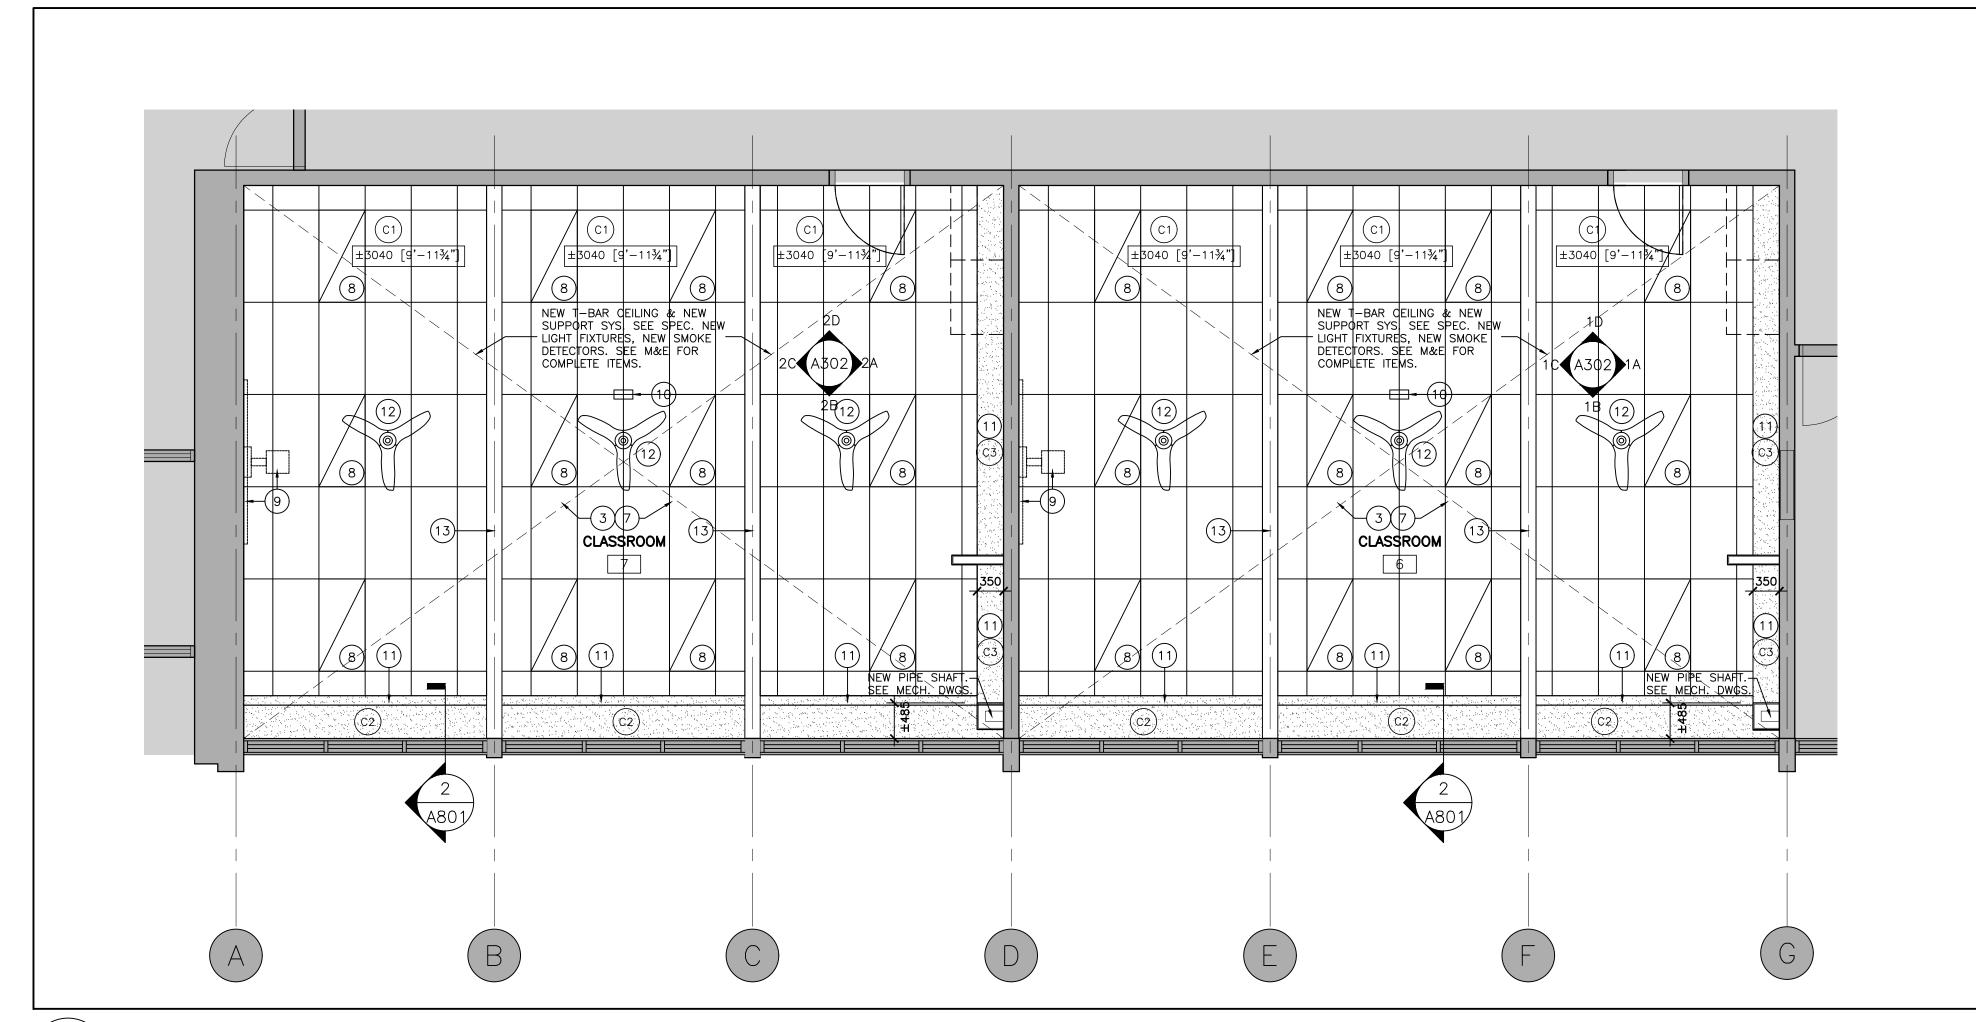

CLASSROOMS 6 & 7 REFLECTED CEILING PLAN - PROPOSED A203 SCALE: 1:50

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> NOTES APPLY TO ALL DEMOLITION & PROPOSED DRAWINGS INCLUDING MECHANICAL AND ELECTRICAL DRAWINGS. CONTRACTORS SHALL READ THE WHOLE SET TOGETHER BEFORE PRICING. GC TO COORDINATE.

DEMOLITION OF HAZARDOUS MATERIALS TYPICAL:

G.C. TO REVIEW ABATEMENT CONSULTANTS REPORT AND RECOMMENDATIONS REGARDING THE REMOVAL OF HAZARDOUS BUILDING MATERIALS. REFER TO HAZARDOUS BUILDING MATERIALS ASSESSMENT REPORT ALONG WITH SPECIFICATIONS AND CONTRACT DOCUMENTS PREPARED BY PINCHIN REGARDING THE REMOVAL AND DEMOLITION OF HAZARDOUS MATERIALS.

REFER TO A101 FOR GENERAL NOTES.





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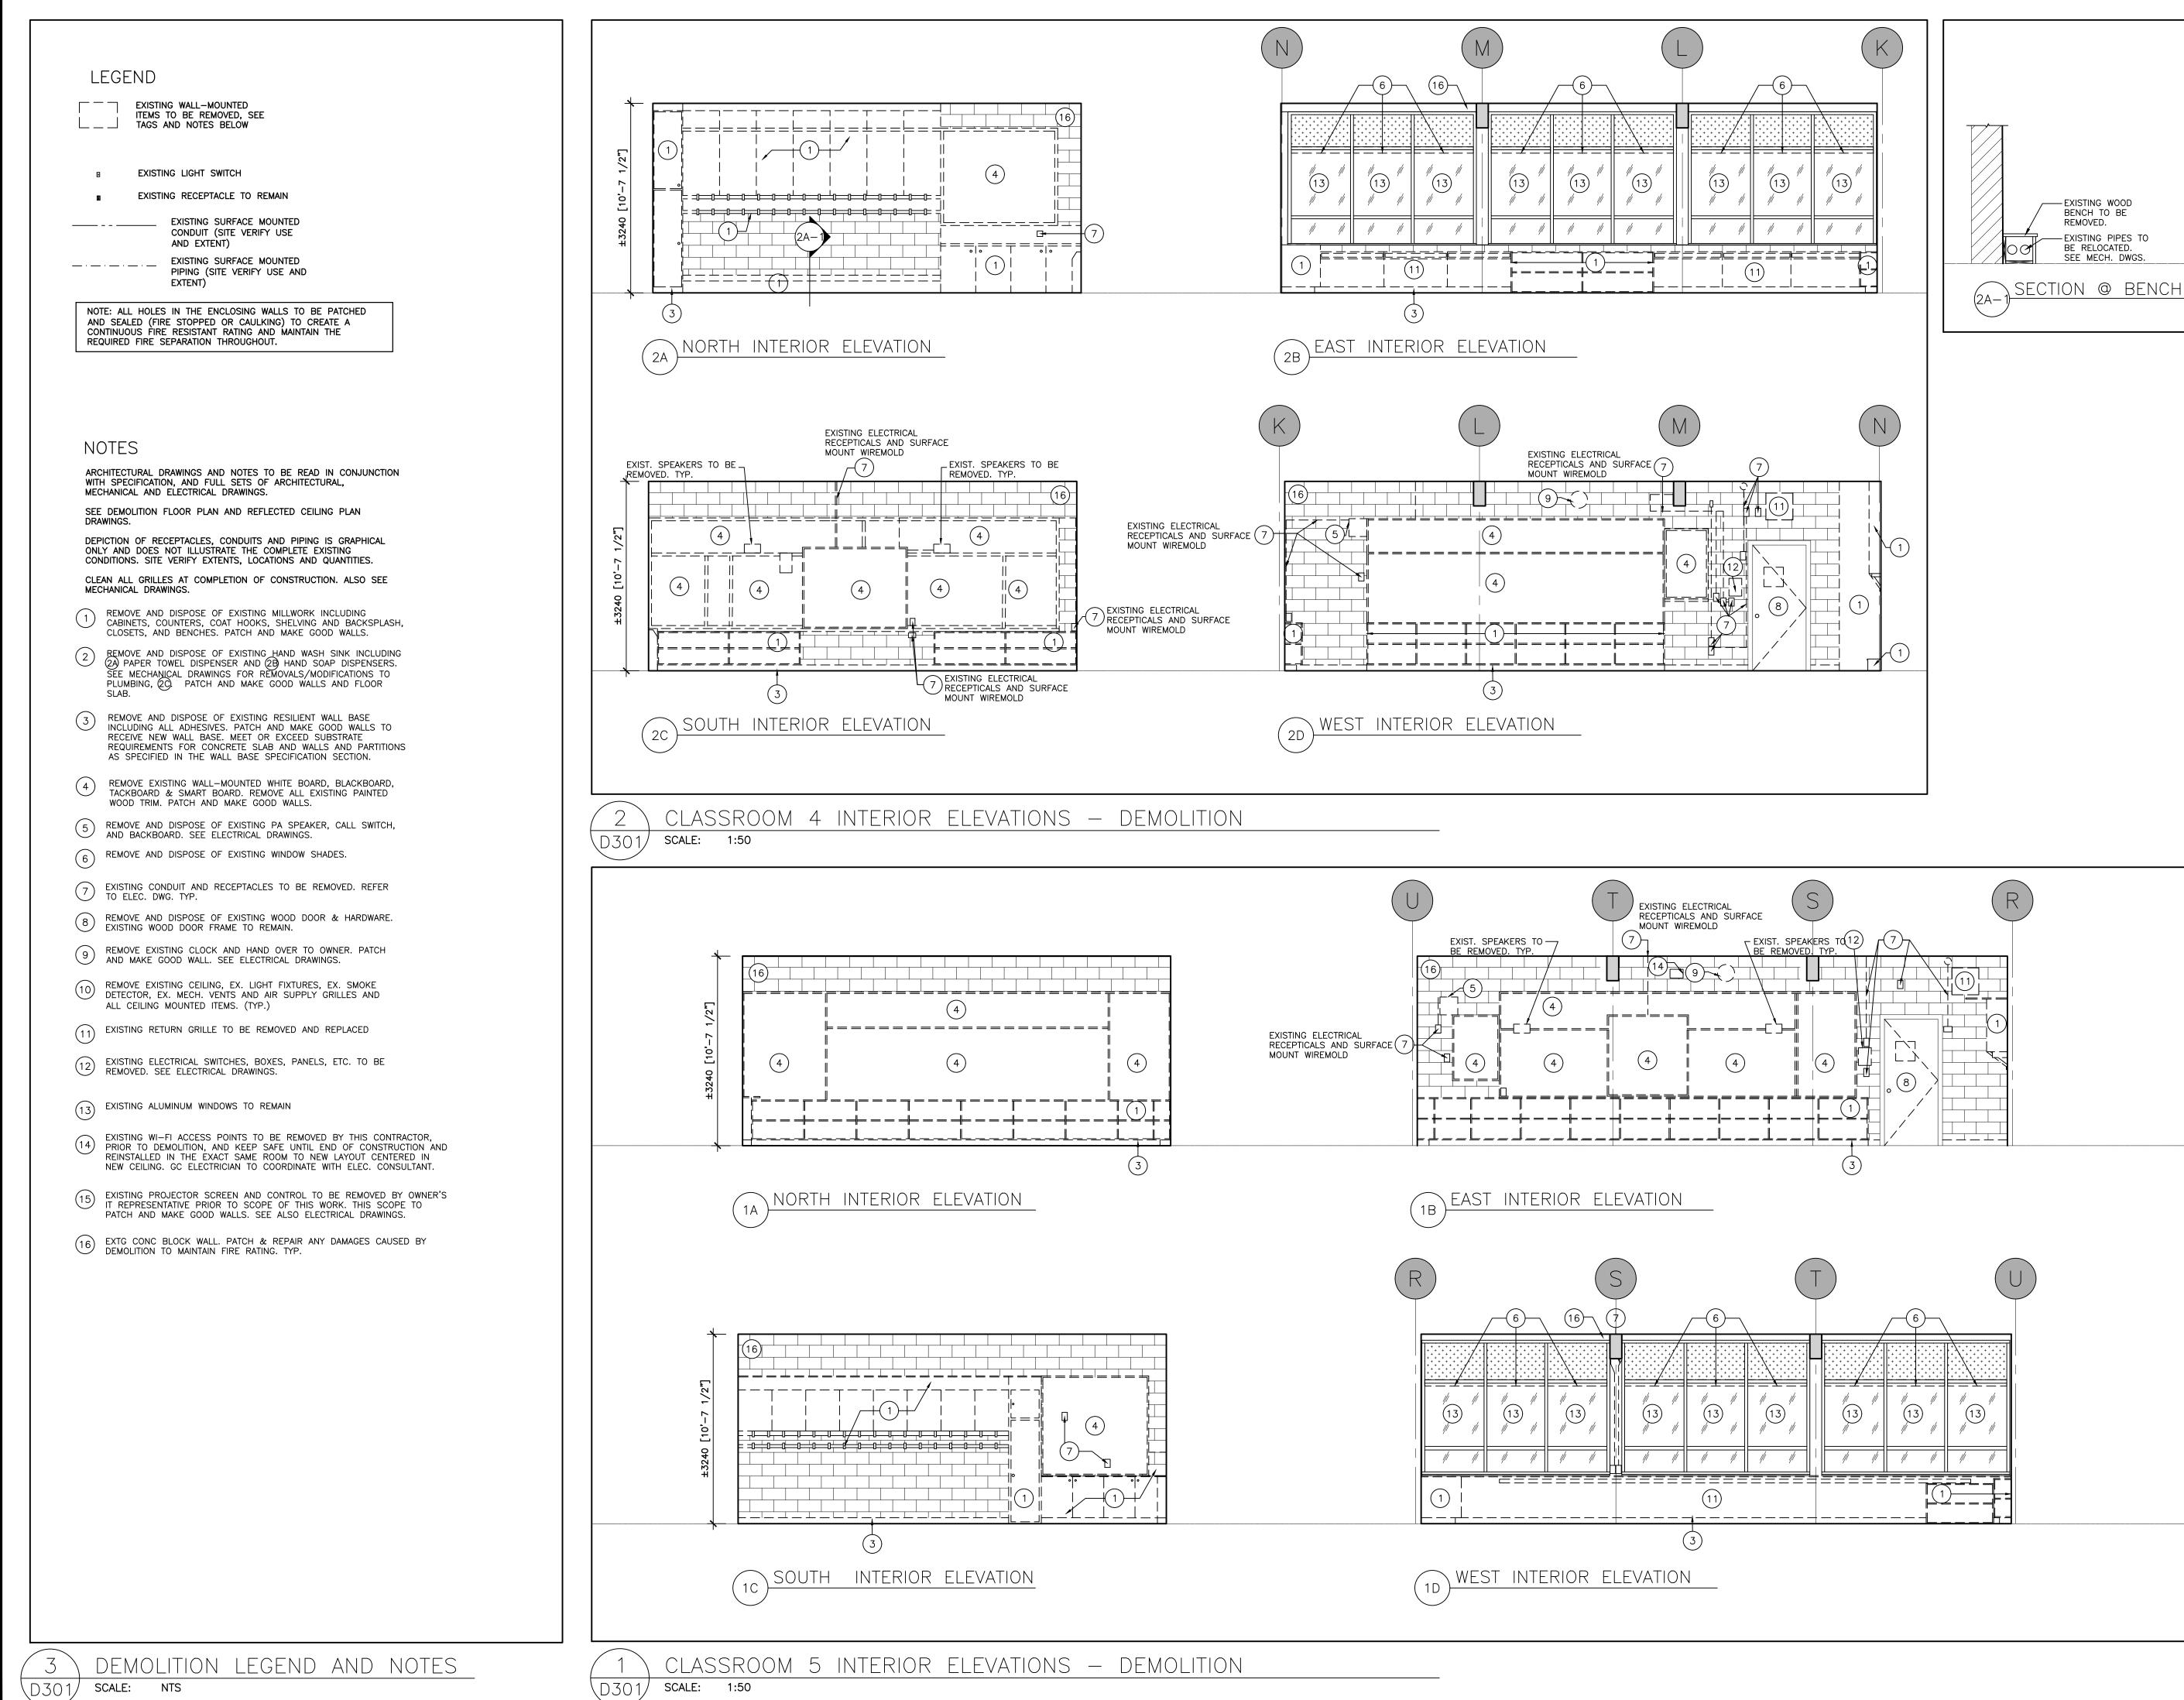
#### KAWARTHA HEIGHTS P.S. CLASSROOMS 4, 5, 6, & 7 RENOVATIONS

KAWARTHA PINE RIDGE DISTRICT SCHOOL BD 11 KAWARTHA HEIGHTS BOULEVARD PETERBOROUGH ONTARIO

## GROUND FLR CLASSROOMS PROPOSED REFL CLG PLANS

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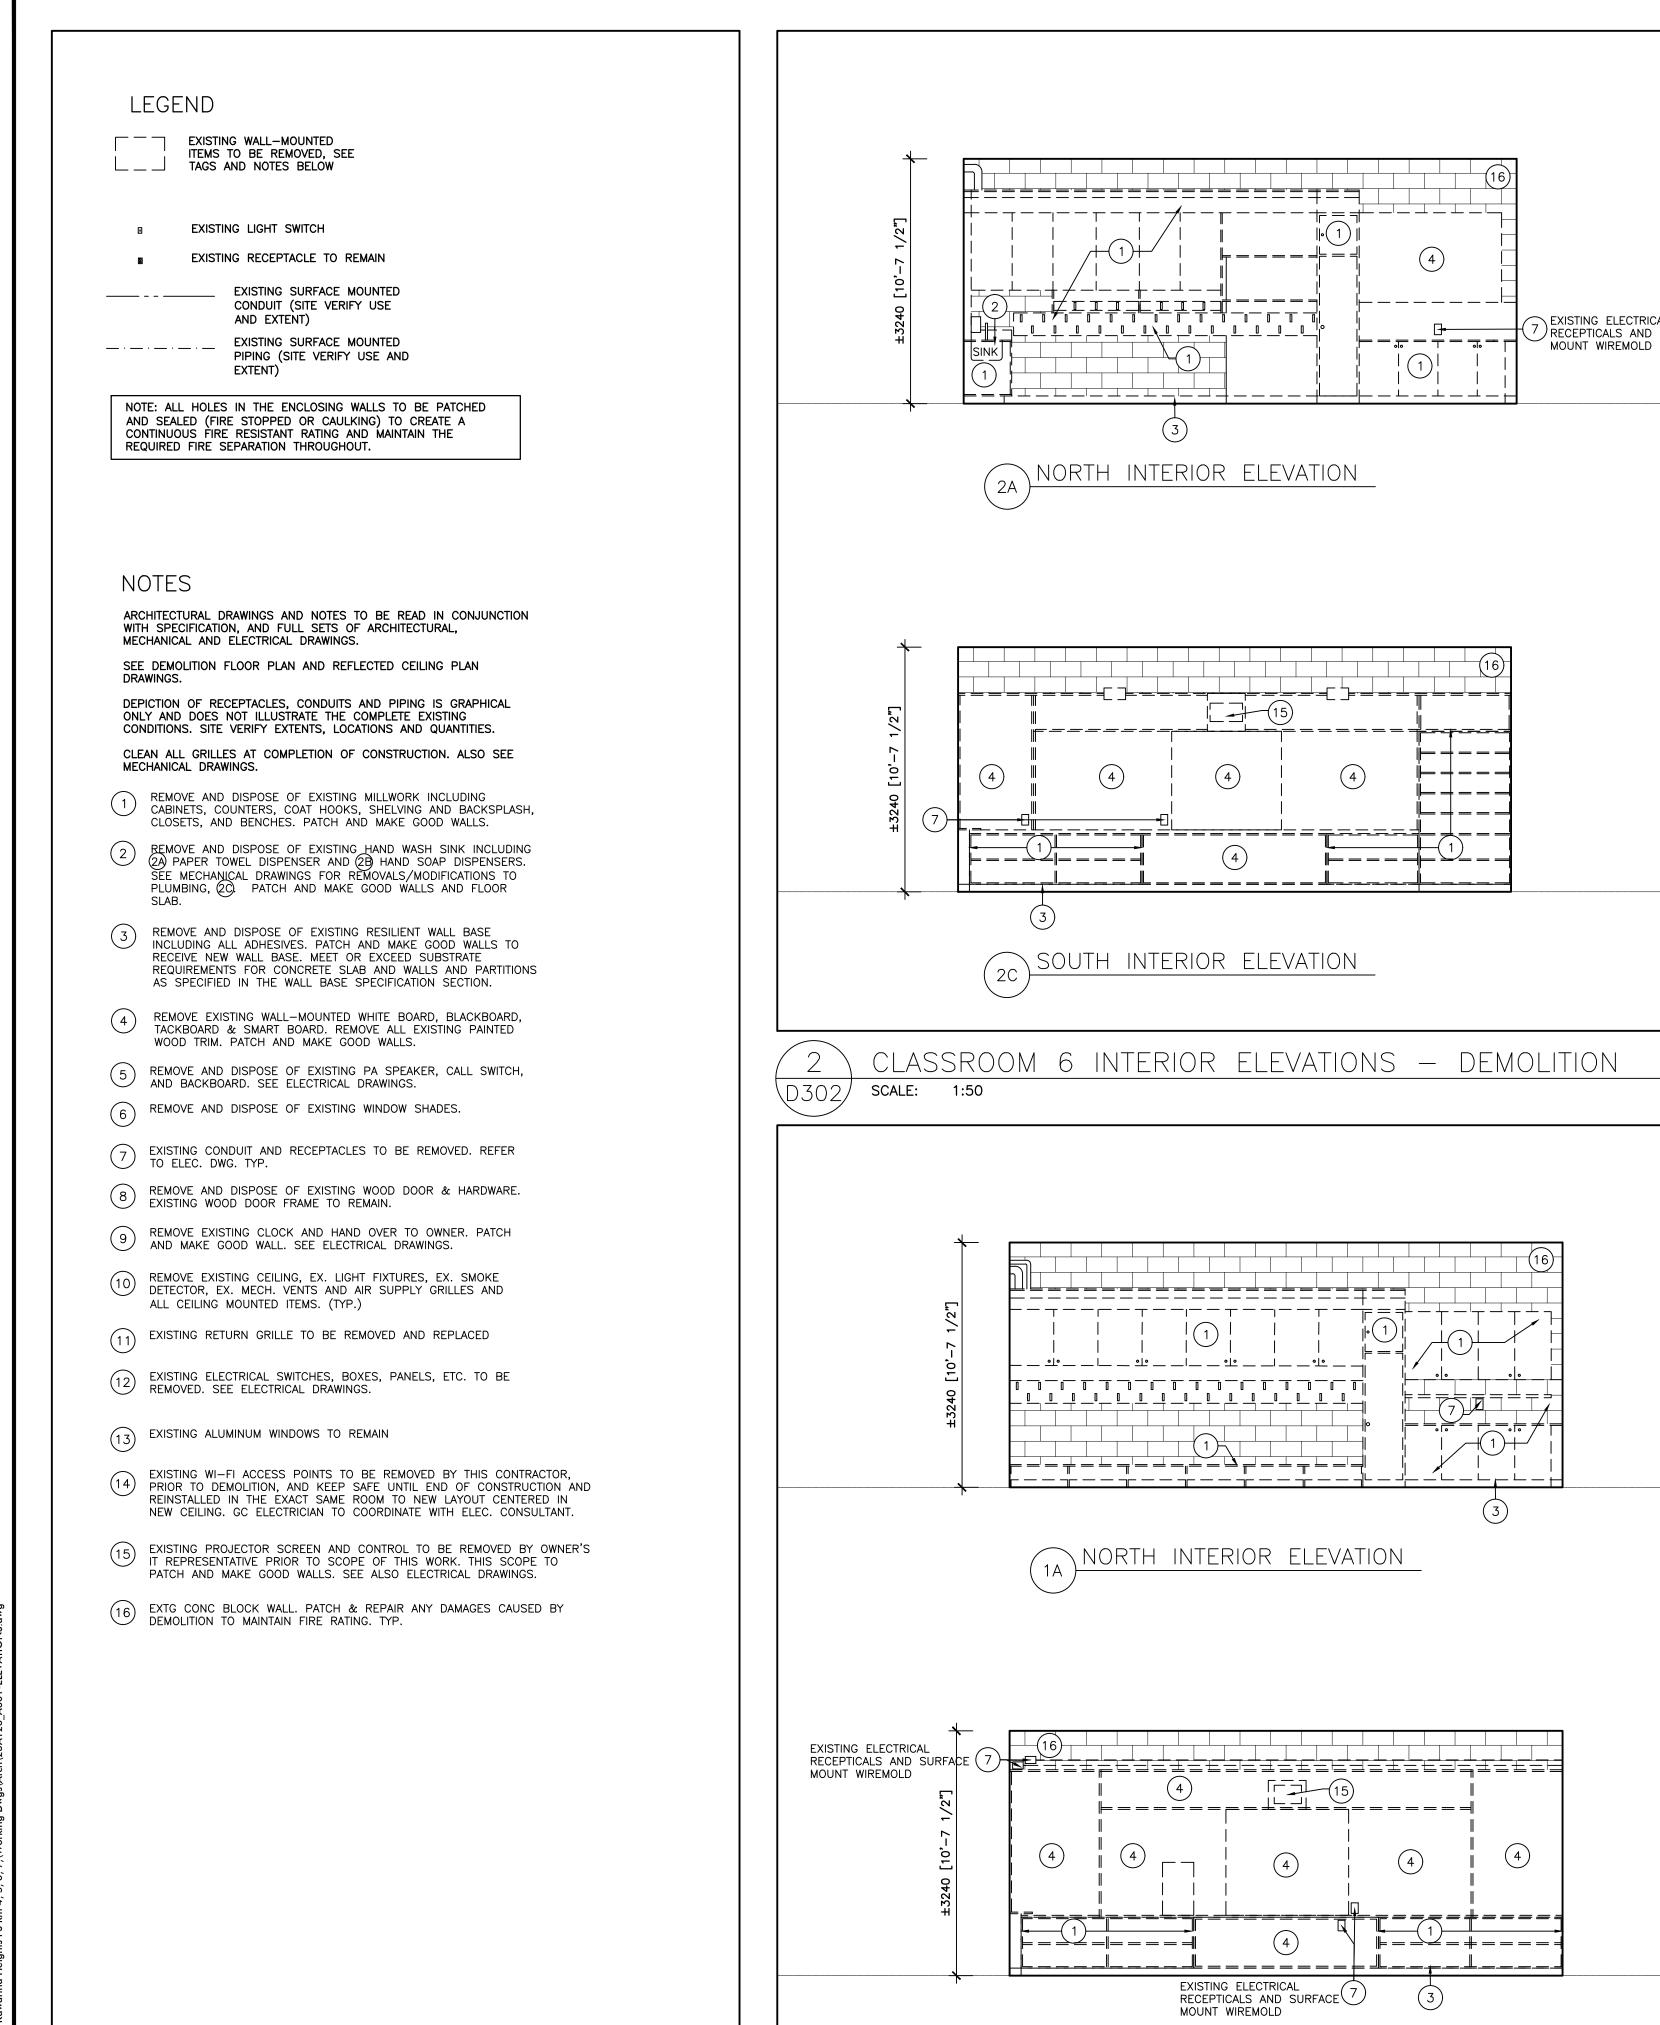
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## DEMOLITION INTERIOR ELEVATIONS

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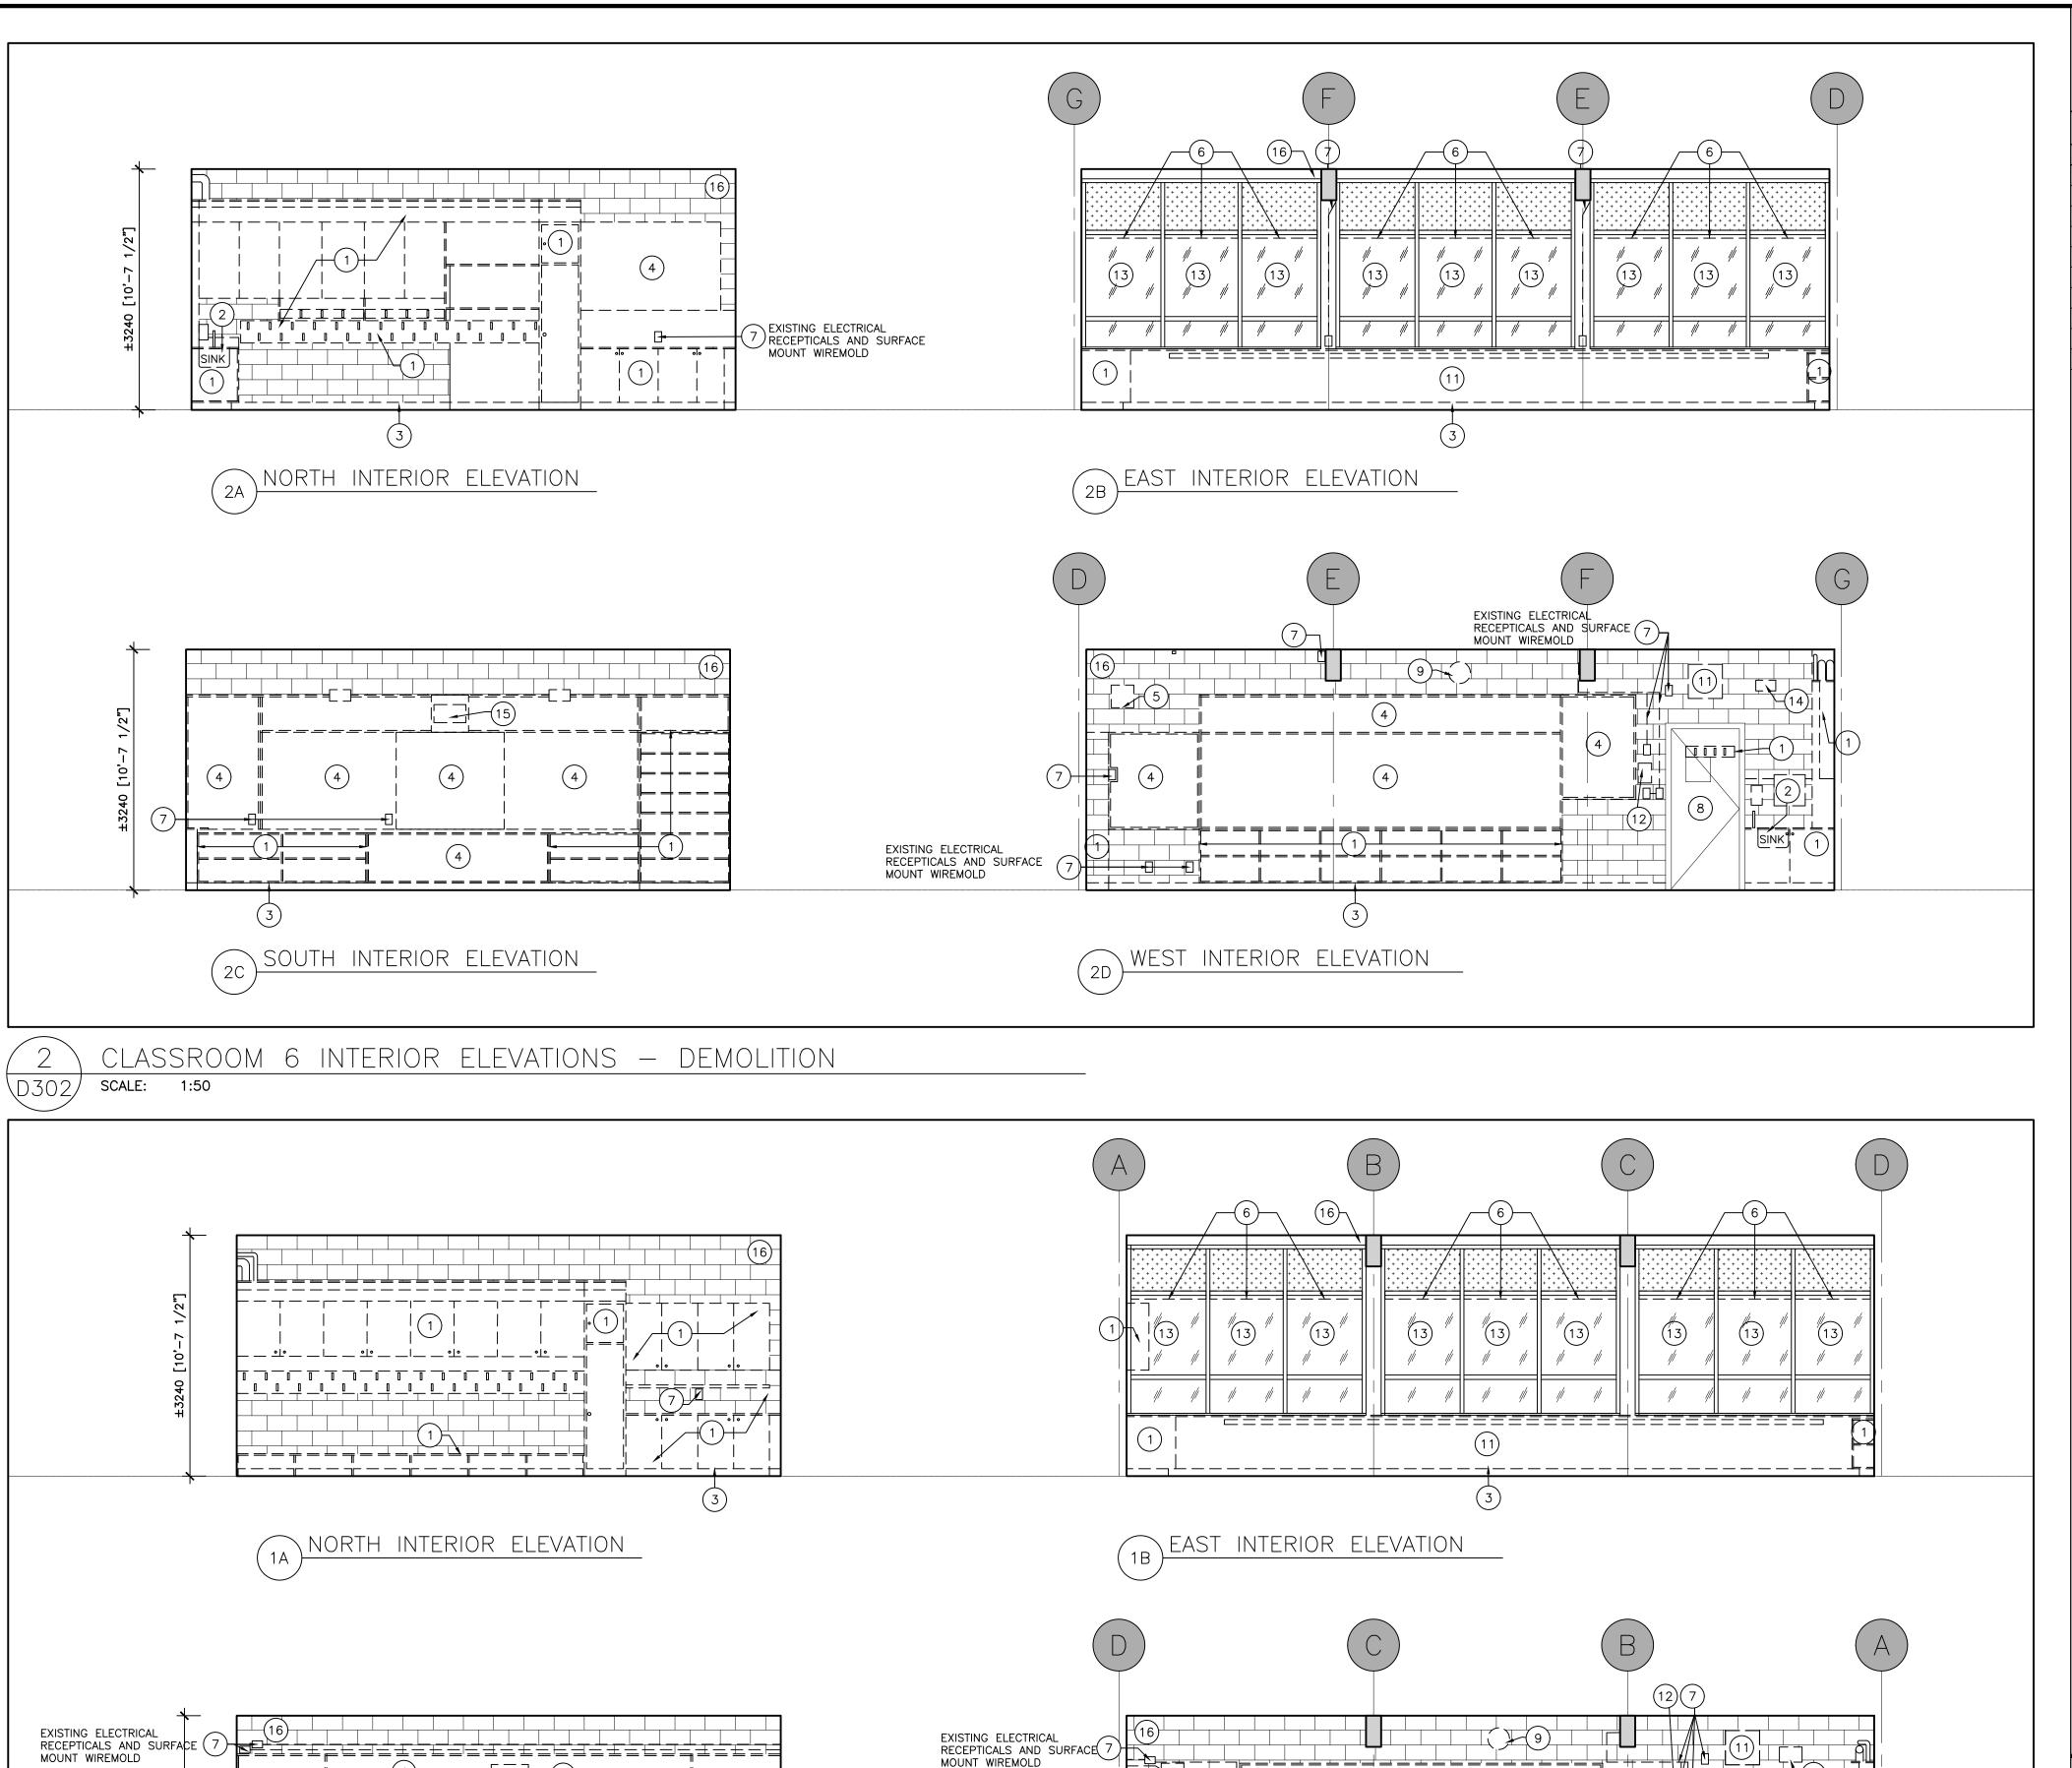
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SOUTH INTERIOR ELEVATION

CLASSROOM 7 INTERIOR ELEVATIONS - DEMOLITION



WEST INTERIOR ELEVATION

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KAWARTHA HEIGHTS P.S. CLASSROOMS 4, 5, 6, & 7 RENOVATIONS

KAWARTHA PINE RIDGE DISTRICT SCHOOL BD 11 KAWARTHA HEIGHTS BOULEVARD PETERBOROUGH ONTARIO

## DEMOLITION INTERIOR ELEVATIONS

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DEMOLITION LEGEND AND NOTES



NEW WALL-MOUNTED HVAC GRILLE TO MATCH EXIST., SEE MECH DWGS.

- EXISTING LIGHT SWITCH, SEE ELEC.
- EXISTING RECEPTACLE TO REMAIN,

EXISTING SURFACE MOUNTED CONDUIT (SITE VERIFY USE AND EXTENT)

EXISTING SURFACE MOUNTED PIPING (SITE VERIFY USE AND EXTENT)

NOTE: ALL HOLES IN THE ENCLOSING WALLS TO BE PATCHED AND SEALED (FIRE STOPPED OR CAULKING) TO CREATE A CONTINUOUS FIRE RESISTANT RATING AND MAINTAIN THE REQUIRED FIRE SEPARATION THROUGHOUT.

ARCHITECTURAL DRAWINGS AND NOTES TO BE READ IN CONJUNCTION WITH SPECIFICATION, AND FULL SETS OF ARCHITECTURAL, MECHANICAL AND ELECTRICAL DRAWINGS.


SEE PROPOSED FLOOR PLAN AND REFLECTED CEILING PLAN DRAWINGS.

DEPICTION OF RECEPTACLES, CONDUITS AND PIPING IS GRAPHICAL ONLY AND DOES NOT ILLUSTRATE THE COMPLETE EXISTING CONDITIONS. SITE VERIFY EXTENTS, LOCATIONS AND QUANTITIES.

CLEAN ALL GRILLES AT COMPLETION OF CONSTRUCTION. ALSO SEE MECHANICAL DRAWINGS.


- PROVIDE NEW WALL-MOUNTED WHITEBOARD (MARKERBOARD) MANUFACTURED BY ARCHITECTURAL SCHOOL PRODUCTS OR EQUIVALENT PRODUCTS AS SUPPLIED BY GLOBAL SCHOOL PRODUCTS INC. PROVIDE SUPPORTS. C/W CLEAR ANODIZED ALUMINUM FRAME, MAP RAIL WITH CORK INSERT, REQ'D DIVIDER STRIP AND MARKER CHALK TRAY. SUBMIT SD.
- PROVIDE NEW MILLWORK. SEE A500 SERIES DETAILS AND SPECIFICATIONS. PROVIDE SHOP DRAWINGS AND MOCK UP.
- PROVIDE NEW WALL RUBBER BASE. SEE ROOM FINISH SCHEDULE AND SPECIFICATION. "TIGHTLOCK" [102MM X 3MM THICK "TRADITIONAL" RUBBER COVE BASE BY JOHNSONITE SUBMIT THE TEST FOR ASTM F 1861 SPECIFICATION FOR RESILIENT WALL BASE. COLOUR BY CONSULTANT.
- PROVIDE NEW WALL-MOUNTED INTERACTIVE WHITEBOARD AND NEW ELECTRICAL RECEPTACLES AT HIGH LEVEL FOR OWNER-PROVIDED WALL-MOUNTED PROJECTOR. SEE ELECTRICAL DRAWINGS. SEE ALSO DETAIL 9/A801.
- SUPPLY AND INSTALL NEW SCHOOL CONTROL PANEL, SEE DETAILS. GC TO INSTALL IN NEW CONTROL PANEL NEW CLOCK, THERMOSTAT, VOICE /DATA, LIGHT SWITCHES, PA CALL SWITCH. PA SPEAKER, DUPLEXES, FIRE ALARM AND PROVISION FOR SPACE SENSOR. STANDARD COLOUR CHOSEN BY ARCHITECT. PROVIDE SHOP DWG SEE ALSO ELECTRICAL DRAWINGS. CLOCKS TO BE BATTERY OPERATED, ROUND, SIMPLEX, TO FIT WITHIN THE SPACE
- PROVIDE NEW DOOR & HARDWARE IN EXISTING WOOD FRAME. PROVIDE NEW DOOR NUMBER SIGN AND ROOM NAME SIGN, PLAM FINISH ON DOOR AND PAINT EXISTING WOOD FRAME, PT-2 (RACCOON FUR) ON BOTH SIDES. (CONFIRM DIMENSIONS ON SITE PRIOR TO ORDERING). SEE DOOR SCHEDULE, SIGN DETAIL AND SPECIFICATION.
- WHERE REMOVALS LEAVE DAMAGE TO EXISTING CONCRETE BLOCK WALLS, PATCH AND MAKE GOOD BY REPLACING ENTIRE EXISTING DAMAGED BLOCK WITH NEW FULL BLOCK. NEW BLOCK TO MATCH EXISTING IN SIZE. MAKE GOOD SURROUNDING MORTAR TO MATCH EXISTING JOINT SIZE, COURSING AND TOOLING. SITE VERIFY SIZE AND EXTENT OF BLOCK REPLACEMENTS. (NOTE THAT ALL LOCATIONS ARE NOT SHOWN GRAPHICALLY ON DRAWINGS - SITE VERIFY.)
- PROVIDE NEW PAINT FINISH ON ALL INTERIOR PAINTABLE SURFACES, INCLUDING BUT NOT LIMITED TO WALLS, ELECTRICAL BOXES AND CONDUITS, AND SPANDREL PANELS. SEE FINISH SCHEDULE AND SPECIFICATION.
- PROVIDE NEW WALL-MOUNTED TACKBOARD MANUFACTURED BY ARCHITECTURAL SCHOOL PRODUCTS OR EQUIVALENT PRODUCTS AS SUPPLIED BY GLOBAL SCHOOL PRODUCTS INC. PROVIDE SUPPORTS. C/W CLEAR ANODIZED ALUMINUM FRAME. SUBMIT
- (10) PLAM BACKSPLASH ON BACK AND SIDE WALL, SEE DETAILS.
- CHARGING TOWER SUPPLIED BY KPRDSB AND INSTALLED BY GC. NO SERVICES, INCLUDING SURFACE MOUNTED CONDUIT, ARE TO BE RUN BEHIND SPACE WHERE CHARGING TOWER IS
- LUXURY VINYL TILE FLOORING: SLIP RETARDANT LUXURY VINYL TILE(LVT) FLOORING, THROUGH COLOUR, ASBESTOS FREE, 250MM X 1000MM X 4.5mm IN SIZE. CONFORMING TO CSA A126.1, INTERFACE FLOORING OR EQUIVALENT. COLOURS BY CONSULTANT. R11 SLIP RESISTANCE RATING. SUBMIT A COPY OF CAN/ULC-S102.2 STANDARD METHOD OF TEST FOR SURFACE BURNING CHARACTERISTICS OF FLOORING,
- SUB-FLOOR SHALL COMPLY TO ASTM F 710 STANDARD PRACTICE FOR PREPARING CONCRETE FLOORS TO RECEIVE RESILIENT FLOORING
- WINDOWS: REMOVE DIRT AND DEBRIS FROM WINDOW FRAME AND GLAZING, WASH, CLEAN, REMOVE OXIDATION FROM ALUMINUM FRAME. PROVIDE NEW BLINDS TO KPRDSB STANDARDS. PROVIDE CUTSHEET & SAMPLES. PATCH AND PAINT EXISTING DRYWALL SPANDREL PANELS IN UPPER PORTION OF ALL WINDOWS
- CLEAN EXISTING HEATING UNITS. REMOVE GRILLES AND CLEAN ALL DEBRIS OUT OF THE INTERNALS. SEE MECH.
- NEW GYPSUM BOARD BULKHEAD IN FRONT OF EXISTING WINDOWS AND FOR HYDRONIC PIPING TO RADIATORS. PAINT
- NEW PAINT FINISH ON EXISTING PRECAST CONCRETE COLUMNS. FILL ALL HOLES PRIOR TO PAINTING.
- NEW ACOUSTIC TILE AND T-BAR CEILING, SEE REFLECTED CEILING PLANS AND SPECS.
- PROVIDE NEW WALL-MOUNTED STUDENT COAT & HAT RACK WITH HOOKS MANUFACTURED BY ARCHITECTURAL SCHOOL PRODUCTS OR EQUIVALENT AS SUPPLIED BY GLOBAL SCHOOL PRODUCTS INC. MODEL SCR 1001 C/W TUBE SHELF, BRACKETS, CHANNEL MOUNT AND COAT HOOKS, BLACK FINISH.
- NEW PAINT FINISH ON EXISTING PRECAST CONCRETE BEAMS. FILL ALL HOLES PRIOR TO PAINTING. FILL ALL HOLES PRIOR TO PAINTING.

PROPOSED LEGEND AND NOTES SCALE: NTS

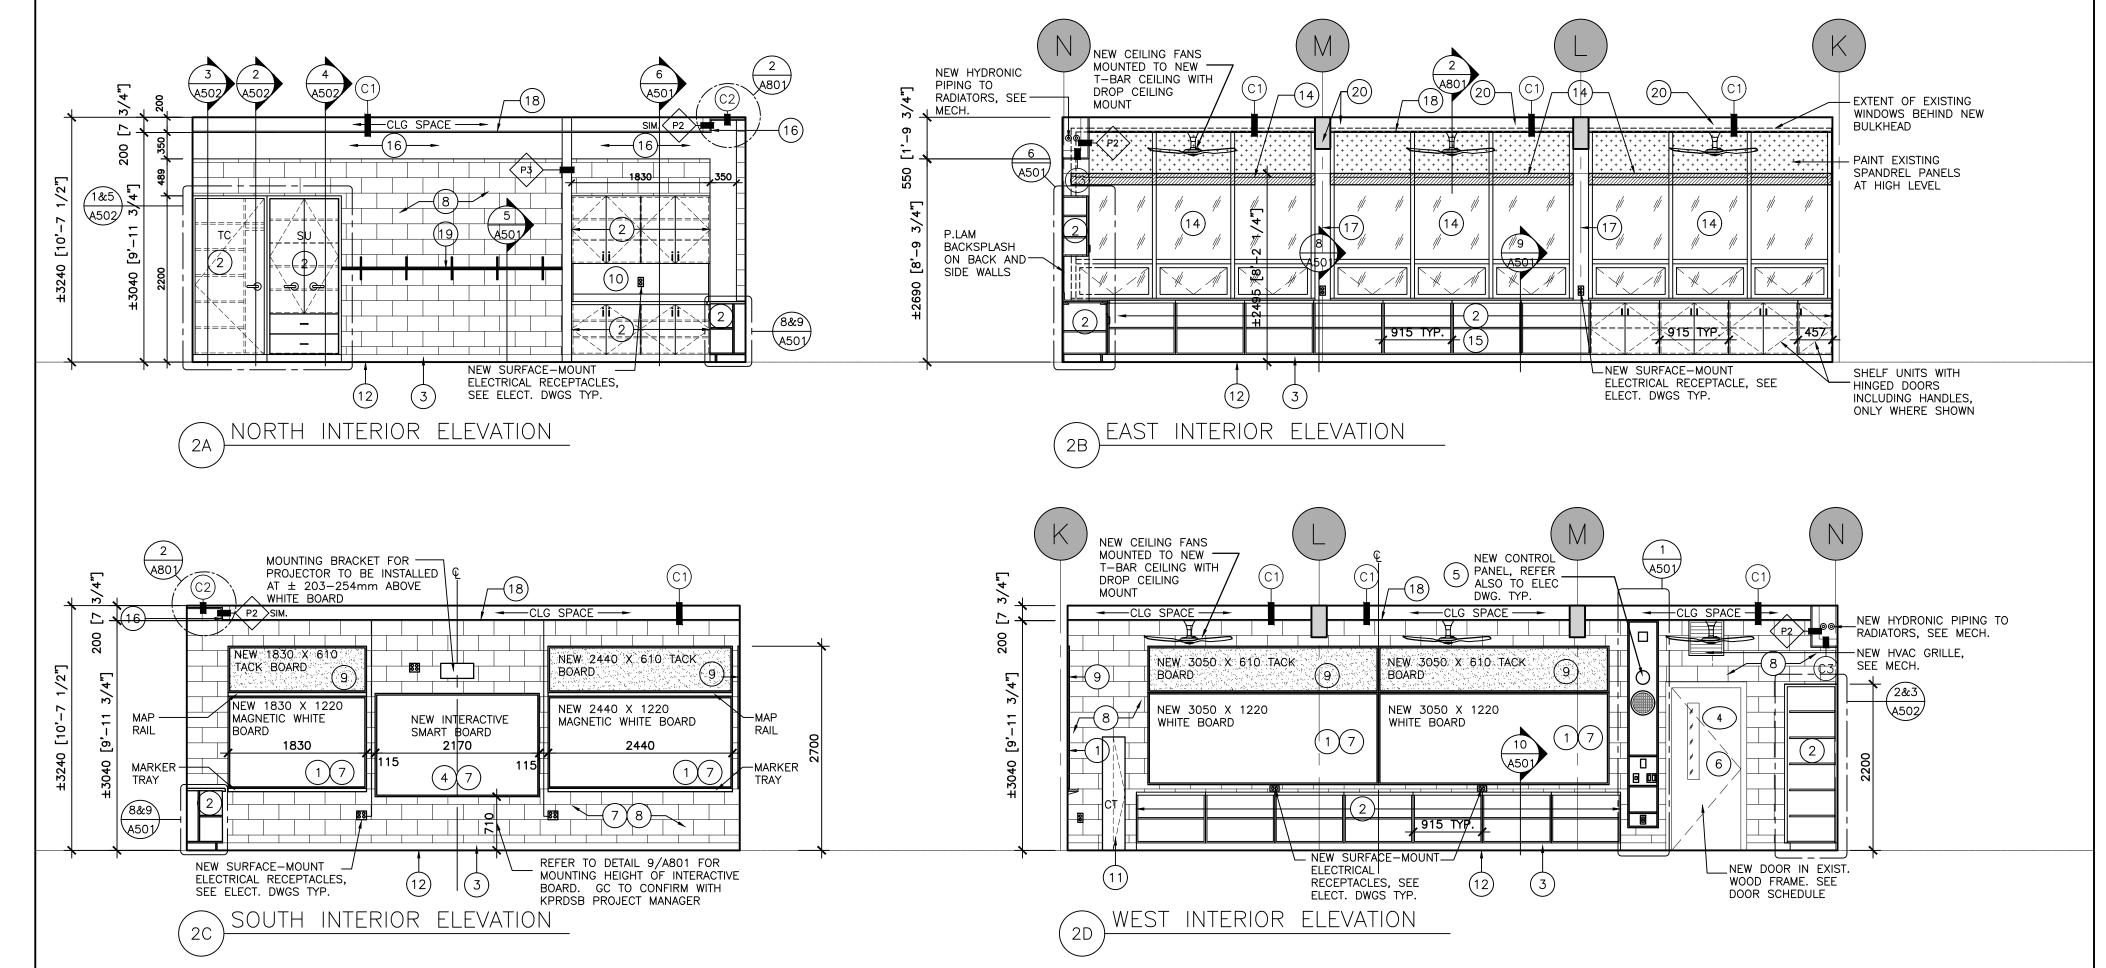

CLASSROOM 4 PROPOSED INTERIOR ELEVATIONS \A301,

SCALE: 1:50

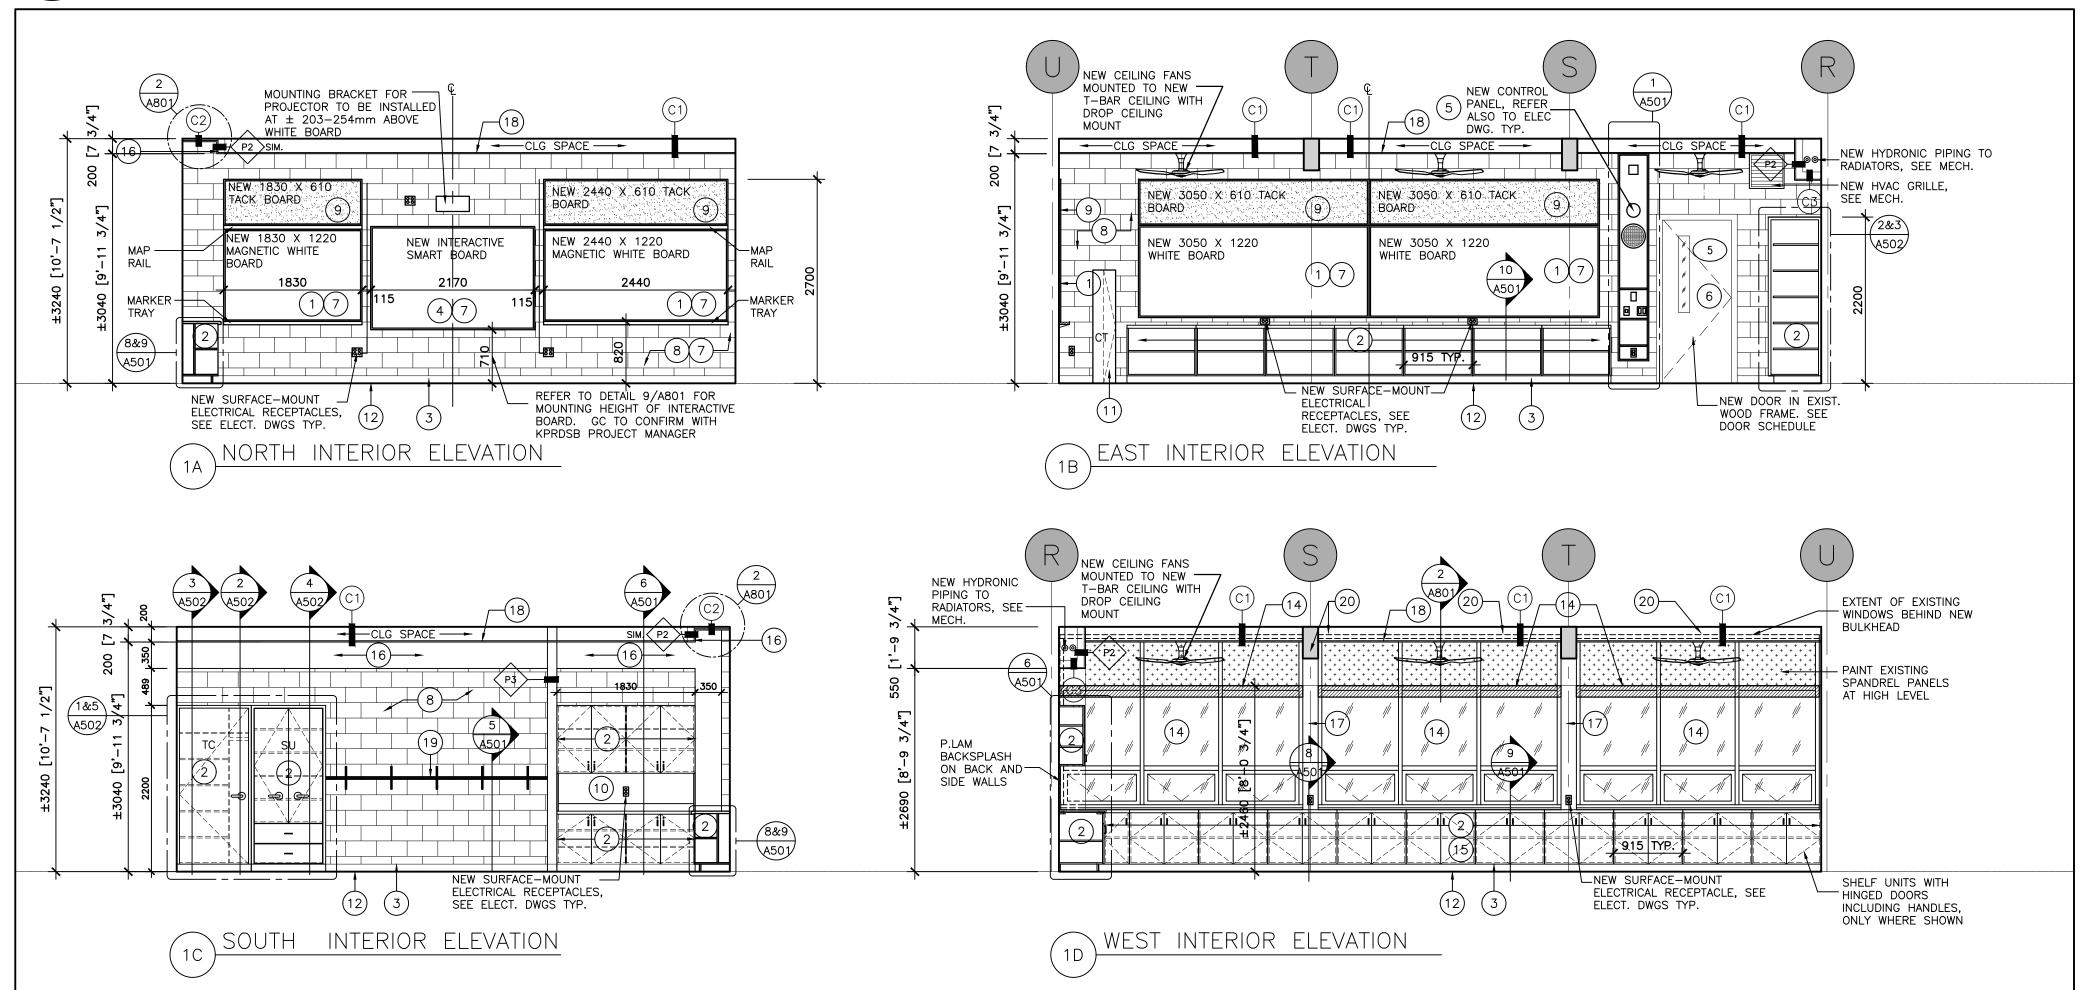

CLASSROOM 5 PROPOSED INTERIOR ELEVATIONS SCALE: 1:50

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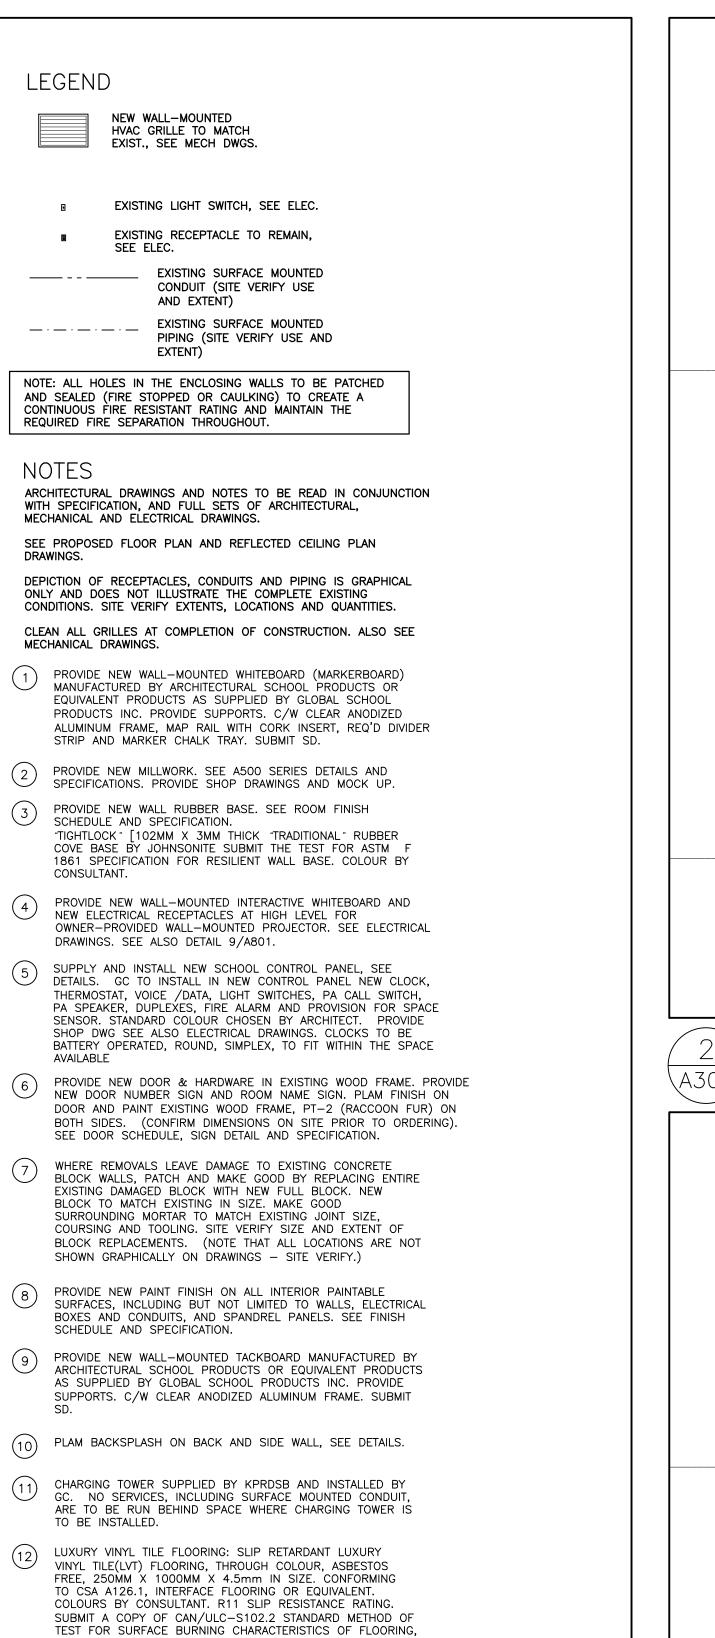
KAWARTHA HEIGHTS P.S. CLASSROOMS 4, 5, 6, & 7 RENOVATIONS

KAWARTHA PINE RIDGE DISTRICT SCHOOL BD 11 KAWARTHA HEIGHTS BOULEVARD **PETERBOROUGH** ONTARIO

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SUB-FLOOR SHALL COMPLY TO ASTM F 710 STANDARD

RESILIENT FLOORING

PORTION OF ALL WINDOWS

FILL ALL HOLES PRIOR TO PAINTING.

FILL ALL HOLES PRIOR TO PAINTING.

SCALE: NTS

CEILING PLANS AND SPECS.

PRACTICE FOR PREPARING CONCRETE FLOORS TO RECEIVE

WINDOWS: REMOVE DIRT AND DEBRIS FROM WINDOW FRAME AND GLAZING, WASH, CLEAN, REMOVE OXIDATION FROM

STANDARDS. PROVIDE CUTSHEET & SAMPLES. PATCH AND

PAINT EXISTING DRYWALL SPANDREL PANELS IN UPPER

CLEAN EXISTING HEATING UNITS. REMOVE GRILLES AND CLEAN ALL DEBRIS OUT OF THE INTERNALS. SEE MECH.

NEW GYPSUM BOARD BULKHEAD IN FRONT OF EXISTING

WINDOWS AND FOR HYDRONIC PIPING TO RADIATORS. PAINT

NEW PAINT FINISH ON EXISTING PRECAST CONCRETE COLUMNS.

NEW ACOUSTIC TILE AND T-BAR CEILING, SEE REFLECTED

PROVIDE NEW WALL-MOUNTED STUDENT COAT & HAT RACK

PRODUCTS OR EQUIVALENT AS SUPPLIED BY GLOBAL SCHOOL

BRACKETS, CHANNEL MOUNT AND COAT HOOKS, BLACK FINISH.


PROPOSED LEGEND AND NOTES

WITH HOOKS MANUFACTURED BY ARCHITECTURAL SCHOOL


PRODUCTS INC. MODEL SCR 1001 C/W TUBE SHELF,

NEW PAINT FINISH ON EXISTING PRECAST CONCRETE BEAMS. FILL ALL HOLES PRIOR TO PAINTING.

ALUMINUM FRAME. PROVIDE NEW BLINDS TO KPRDSB

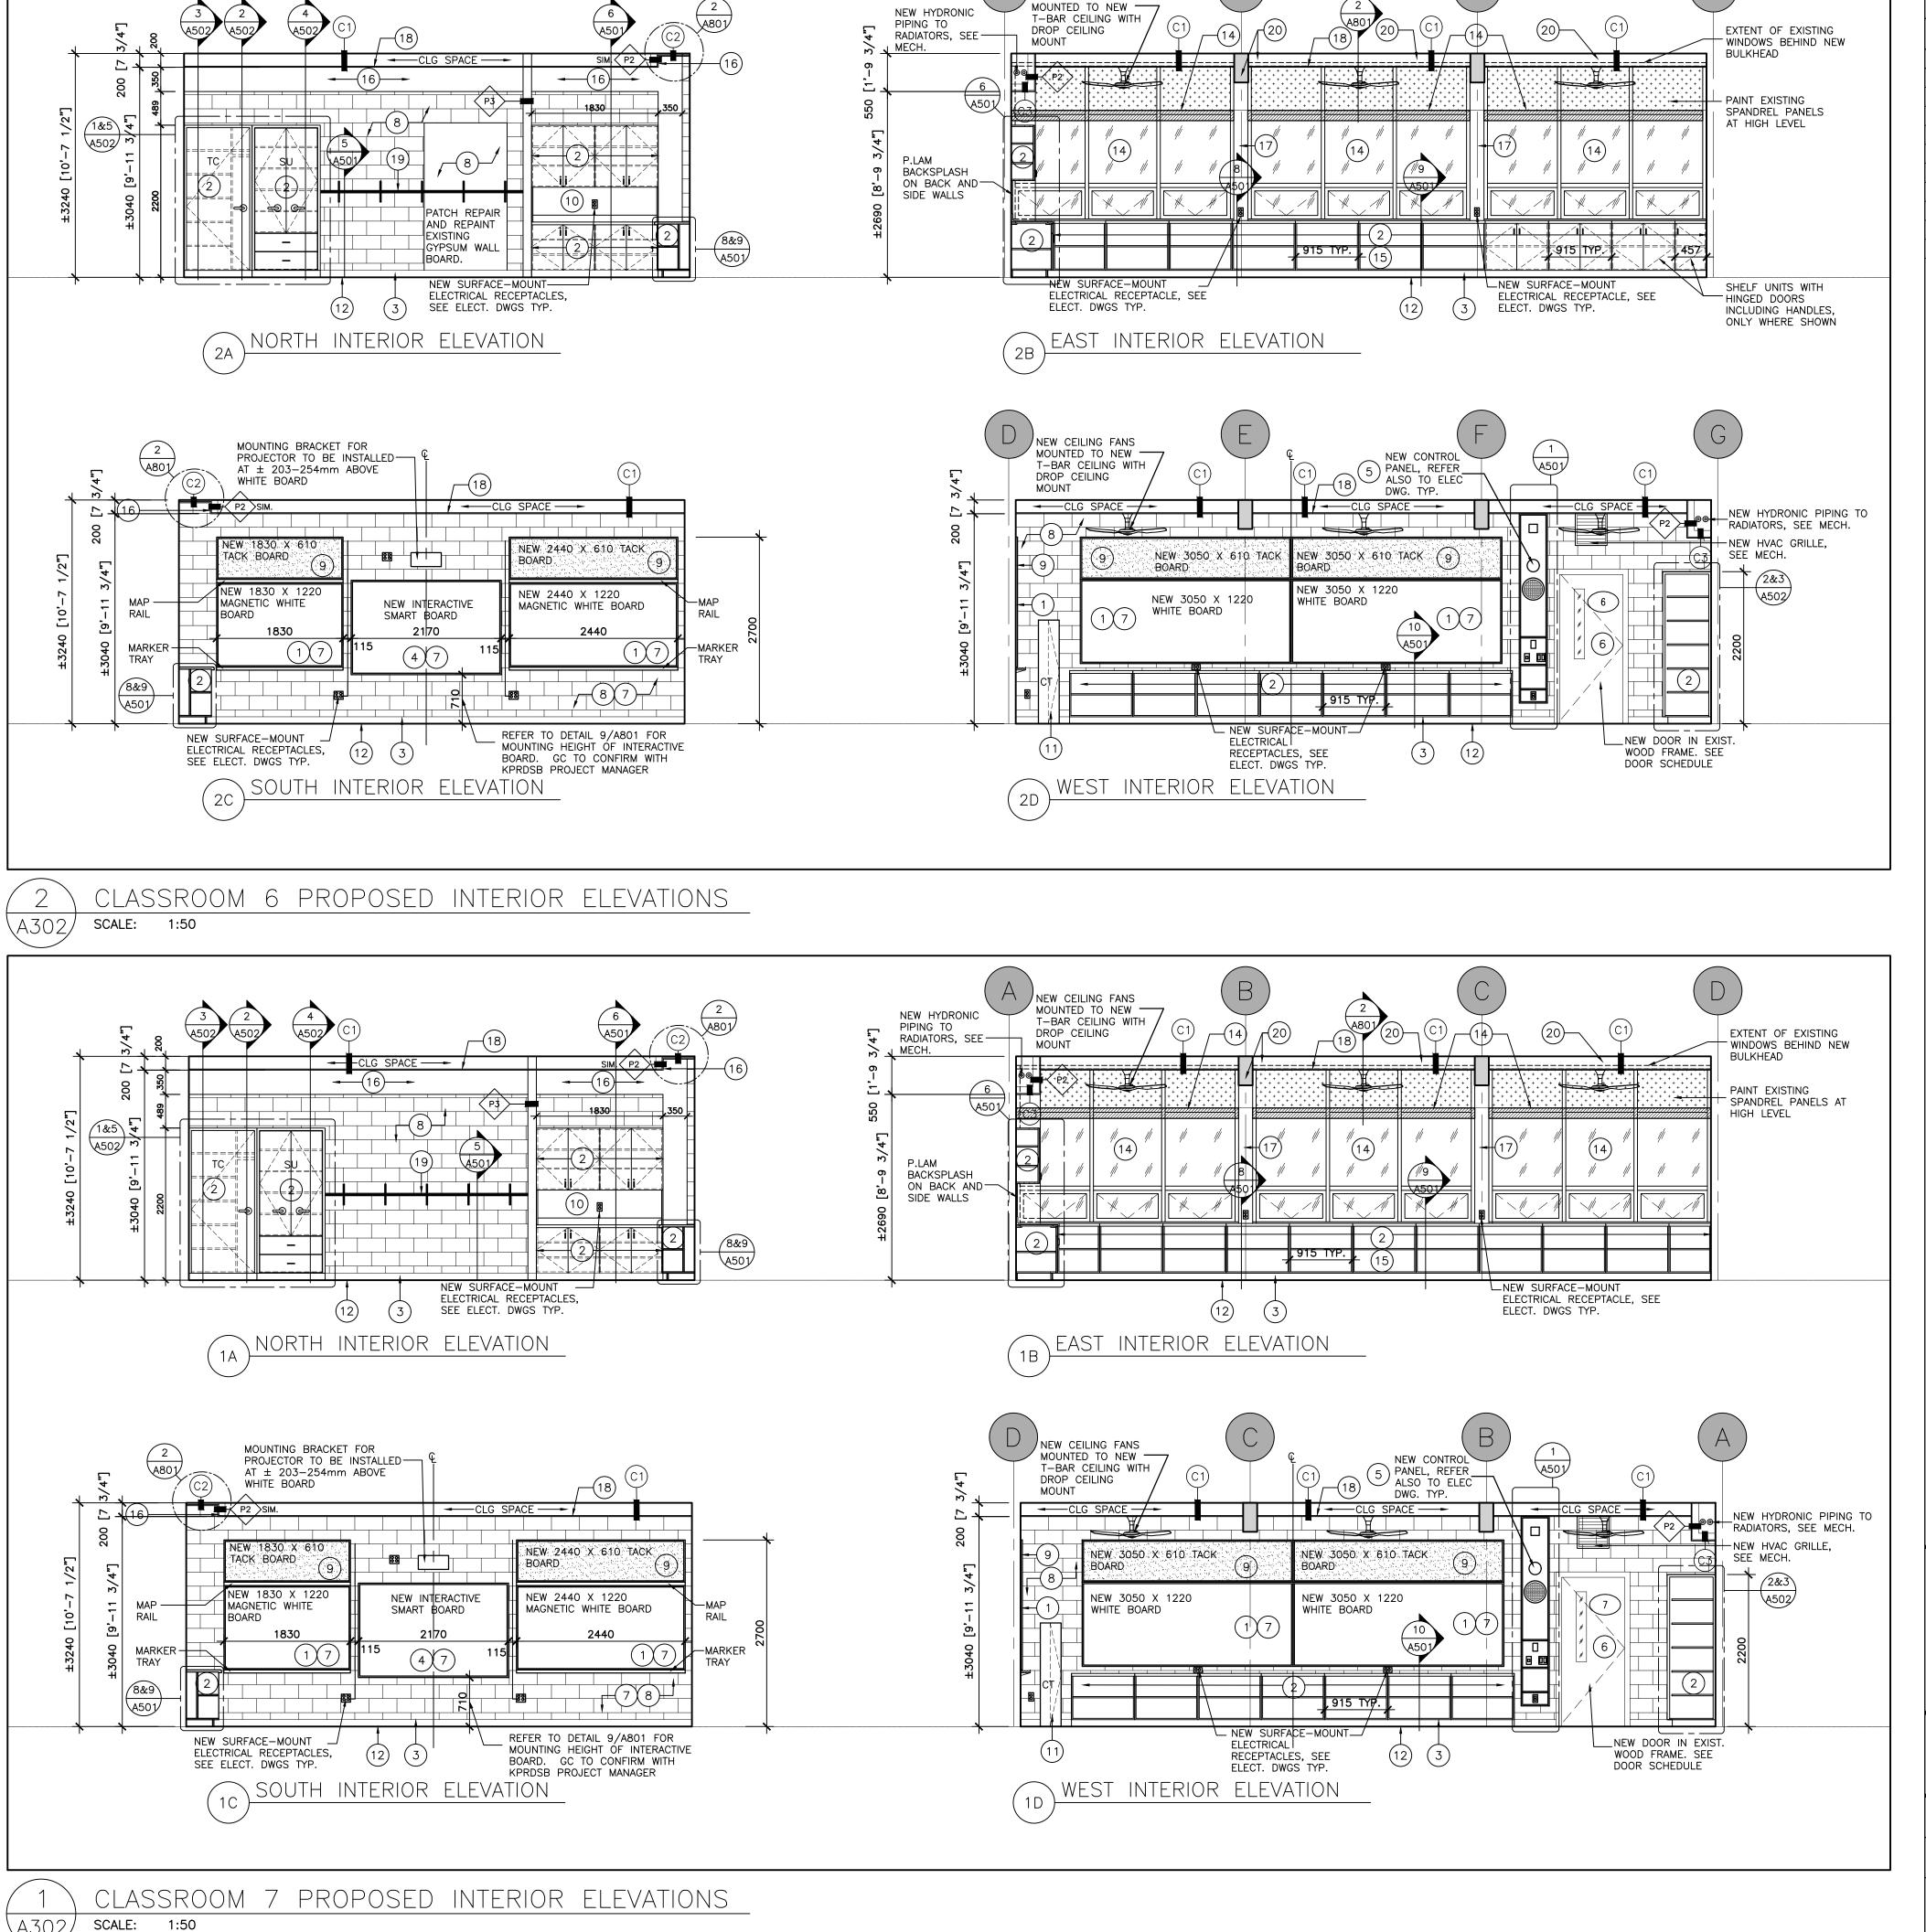

NEW CEILING FANS

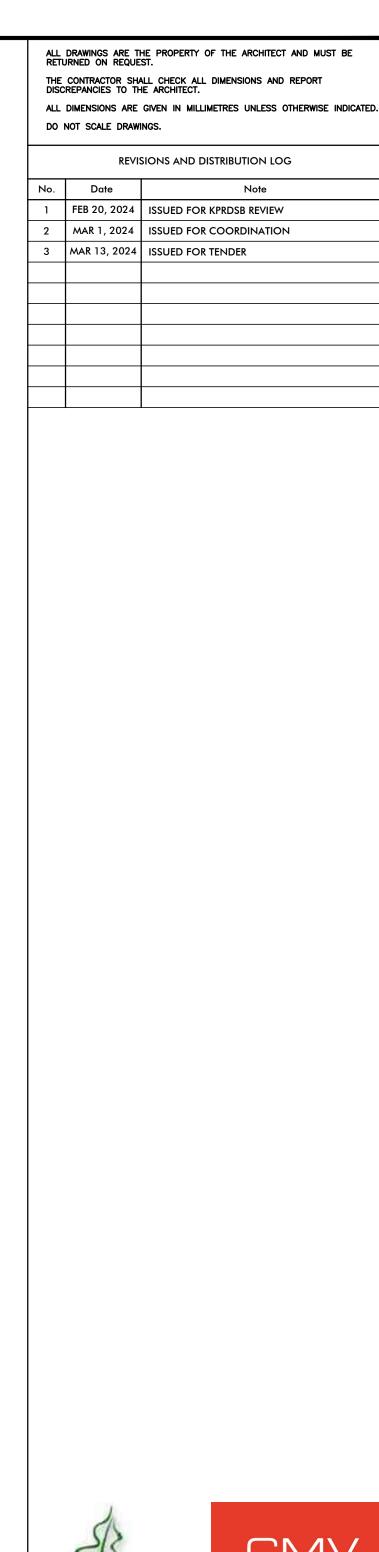





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### KAWARTHA HEIGHTS P.S. CLASSROOMS 4, 5, 6, & 7 RENOVATIONS

KAWARTHA PINE RIDGE DISTRICT SCHOOL BD 11 KAWARTHA HEIGHTS BOULEVARD **PETERBOROUGH** ONTARIO

### PROPOSED **INTERIOR ELEVATIONS**

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#### TYPICAL MILLWORK & HARDWARE NOTES:

GENERAL: CASEWORK SHOULD CARRY FSC CERTIFICATION, AWI PREMIUM GRADE. FINISHING SYSTEM SHALL COMPLY WITH AWI QUALITY STANDARDS AND SEFA-8. PRESSURE LAMINATED 19mm PLYWOOD CONFORM TO CSA 0115 AND AWMAC, AND PRESSURE LAMINATED 19mm WATERPROOF PLYWOOD AT 100 HIGH BASE MILLWORK. SITE VERIFY ALL DIMENSIONS FROM FLOOR PLANS & ELEVATIONS DRAWINGS PRIOR TO FABRICATION OF MILLWORK.

MATERIALS: ALL-PLYWOOD OR HARDWOOD. THE USE OF PARTICLE BOARD IS NOT ACCEPTABLE ON ANY PART OF MILLWORK. ALL WOOD MUST BE STRAIGHT AND TRUE, DRESSED 4 SIDES AND CONFORM TO DETAILS. STAIN WOOD AND PLYWOOD MUST BE SELECTED FOR COLOUR AND GRAIN CONFORMITY. PROVIDE CUTOUTS AS REQUIRED FOR INSERTS, GRILLES, OUTLET BOXES AND OTHER FIXTURES. RADIUS THE INTERNAL CORNERS, CHAMFER THE EDGES, AND SEAL THE CORE. PROVIDE FACE FINISH TO MATCH PANEL MATERIAL AT CUTOUTS. SOLID FINISHED EDGES SHALL HAVE A 1/16 INCH RADIUS.

COUNTERTOP: COUNTERTOPS & BACK SPLASH SHALL BE 25mm POST-FORMED PLAM WITH DOUBLE-RADIUS FRONT EDGE. MAXIMUM CLEARANCE BETWEEN COUNTER TOP AND ADJACENT WALL IS 6mm. CLEAR SILICONE SEALANT BETWEEN WALL AND COUNTER TOP - TYPICAL. ALL COUNTERTOPS SHALL BE CONTINUOUS. CONTRACTOR TO PROVIDE A CONTINUOUS COUNTERTOP AT ALL CORNERS. END UNITS AT CORNERS TO HAVE CLOSURE GABLES.

FRAMING: FULL STRETCHER FRAME PROVIDE 19mmX100mm TOP FRAME/TOP RAILS/ I BEAMS, PROVIDE 19mmX64mm SOLID HARDWOOD FACE FRAME /FRONT TO MATCH CABINET SPECIES FINISH. PROVIDE SOLID HARDWOOD FULL TOP FRAME, RAILS SHALL BE SOLID HARDWOOD TO MATCH CABINET SPECIES. THERE SHALL NOT BE ANY EXPOSED BACK. TYPICAL ON ALL CABINETS, INCLUDING, BOOK SHELVES & FULL HEIGHT CABINETS/CLOSETS. FULLY-CAPTURED DADO JOINTS ON TOE-KICKS. FULL DEPTH EDGE BANDING IF NOT SPECIFIED SHALL BE MIN 3/8" (10mm) SOLID WOOD STICK BANDING. PROVIDE INTERMEDIATE RAILS FOR LOCKS. APPLY MOLD AND MOISTURE RESISTANT SEALER ON UNEXPOSED AND CONCEALED ENDS.

CABINET BASE: WATERPROOF PLYWOOD BASE, COVERED WITH RUBBER BASE.

CABINET BODY: 19mm MIN. 9 PLY CLEAR BIRCH VENEER CORE PLYWOOD, FACE GRADE AA, WITH 3/8" (10mm) SOLID BIRCH EDGE BANDING ON EXPOSED EDGES.

DOORS: 19mm MIN. 9 PLY CLEAR BIRCH VENEER CORE PLYWOOD, FACE GRADE AA, WITH 3/8" (10mm) SOLID BIRCH EDGE BANDING ON EXPOSED EDGES.


DRAWERS: DRAWER FRONTS: 19mm MIN. 9 PLY CLEAR BIRCH VENEER CORE PLYWOOD, FACE GRADE AA, WITH 3/8" (10mm) SOLID BIRCH EDGE BANDING ON EXPOSED EDGES, VERTICAL GRAIN TO MATCH DOORS. DRAWER BOX CONSTRUCTION: DOVETAIL JOINERY ON ALL FOUR JOINTS. DRAWER BACK, SUB-FRONT AND SIDES TO BE OF 1/2" (12mm) BIRCH VENEER CORE PLYWOOD (9 PLY) C/W SOLID BIRCH EDGE BANDING 3/8" (10 mm). DRAWER BOTTOM TO BE 1/4" (8mm) BIRCH VENEER CORE PLYWOOD (1/2" [12 mm]) FOR DRAWERS OVER 24" WIDE)

SHELVING: ADJUSTABLE FULL DEPTH SHELF, 19mm MIN. 9 PLY CLEAR BIRCH VENEER CORE PLYWOOD, FACE GRADE AA, WITH 3/8" (10mm) SOLID BIRCH EDGE BANDING ON EXPOSED FDGES. SHELVING TO BE ADJUSTABLE ON 1-1/4" (32mm) INCREMEN (10mm) SOLID BIRCH EDGE BANDING ON EXPOSED EDGES. SHELVING TO BE ADJUSTABLE ON 1-1/4" (32mm) INCREMENTS VÍA TWÌN PIN SEISMIC CLIPS (SEE SPECS). SHELVING AT 36" WIDE CABINET SHALL BE 1" (25mm) THICK CLEAR BIRCH PLYWOOD.

FINISH: ALL EXPOSED FACES INCLUDING INNER AND OUTER FACES OF EACH DOOR AND DRAWER PANEL ALONG WITH THE CABINET ARE FINISHED WITH CATALYZED VINYL, FINISHING SYSTEM 7 AS PER WOOD LABORATORY CASEWORK FINISH RECOMMENDED BY THE ARCHITECTURAL WOODWORK STANDARDS AWS MANUAL. SEE SPECIFICATIONS.

SEE SPECIFICATIONS SECTION 06 40 00, PART 2.6. PROVIDE LOCKS AT ALL DRAWERS AND DOORS AS INDICATED ON DRAWINGS. DRAWER PULLS TO BE MOUNTED HORIZONTALLY AND CENTERED. DOOR PULLS TO BE MOUNTED VERTICALLY.

M&E: HORIZONTAL AND VERTICAL VENTILATION AIR GRILLS AT TOP AND BOTTOM OF BOOK SHELVES WHERE SHOWN. SEE MECHANICAL DWGS. AND SPEC. SUBMIT CUTSHEETS. LOCATION OF ALL MECHANICAL, PLUMBING, AND ELECTRICAL ROUGH-INS SHALL BE COORDINATED WITH MILLWORK SHOP DWG BEFORE INSTALLATION. PROVIDE SHOP DRAWINGS FOR UTILITY ROUGH-INS AND OPENINGS. PROVIDE NEW ACCESS DOORS/PANELS ON NEW MILLWORK FOR EXISTING PLUMBING AND SANITARY CLEAN-OUTS AND ELECTRICAL COVERS. SITE VERIFY EXISTING LOCATIONS.

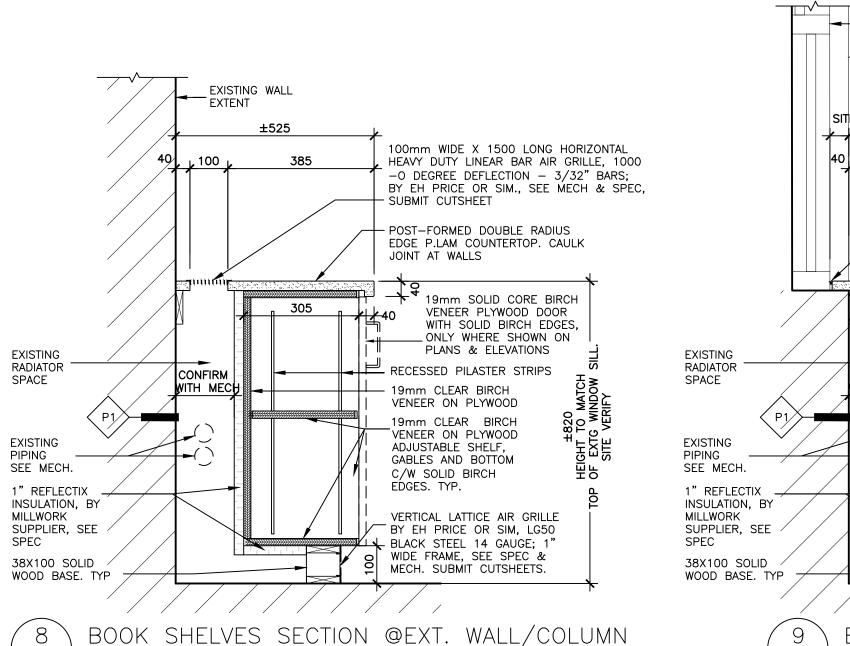

25mm THICK PLAM

ر A501

COUNTERTOP

19mmX 45mm TOP RAIL-

19mmX 89mm WOOD

NAILER STRIPS

19mmX 89mm

4 SIDES (TYP.)

**RESILIENT -**

SILENCERS

POST-FORMED DOUBLE

RADIUS FRONT EDGE

SCALE: 1:10

STRETCHER RAILS AT

SECTION AT COUNTERTOP EDGE

SILICONE JOINT AT FULL EXTENT

OF PERIMETER AT WALL

25 mm THICK PLAM

6mm BACK PANEL


SECTION AT BACKSPLASH/WALL

PLYWOOD

\A501/

SCALE: 1:10

BACKSPLASH

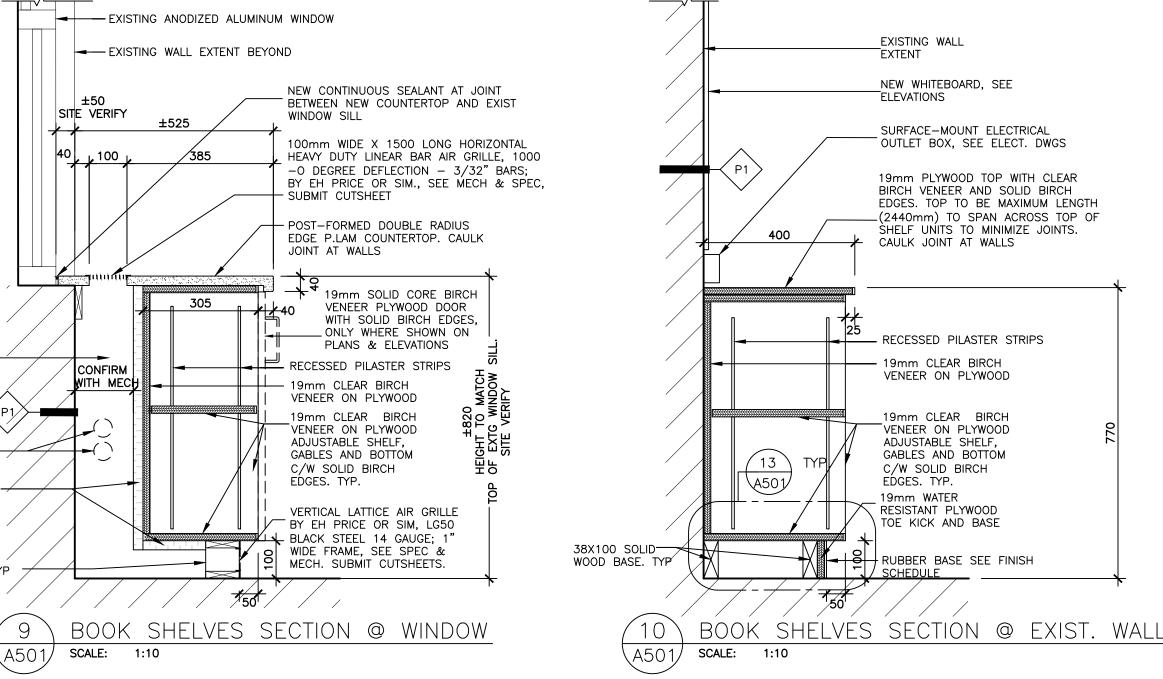

SOLID BIRCH

19mm CLEAR SOLID

CORE BIRCH VENEER -

DOOR DRAWER FRONT

SCALE:

PLYWOOD

(A501/

SOLID BIRCH

EDGING (TYP.)

EDGING (TYP) \_\_

19mmX38mn

JAMB AT WALL

SPACER SCRIBE TO

∠6mm BACK PANEL

NAILER STRIPS

38mmX100mm —

BASE FRAMING

19mmX89mm WOOD

100mm HIGH BASE

SCALE: 1:10

PLYWOOD

\A501/


ON 19mm WATERPROOF

19mm BIRCH

BOTTOM GABLE

PLYWOOD SIDE AND


TYPICAL CABINET BASE

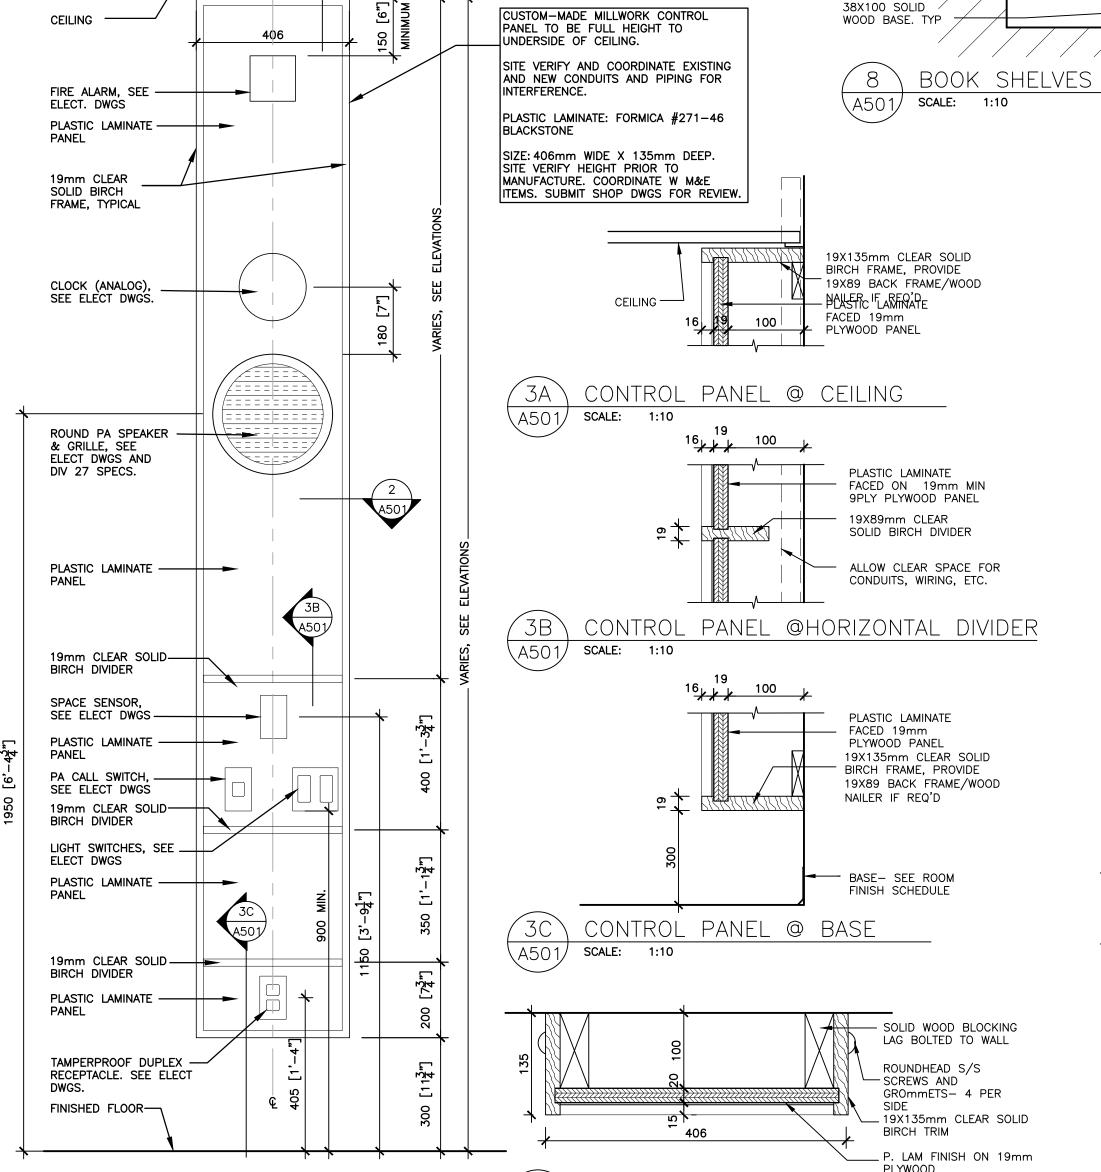


\A501<sub>/</sub>

SCALE:

CONTROL PANEL SECTION DETAIL

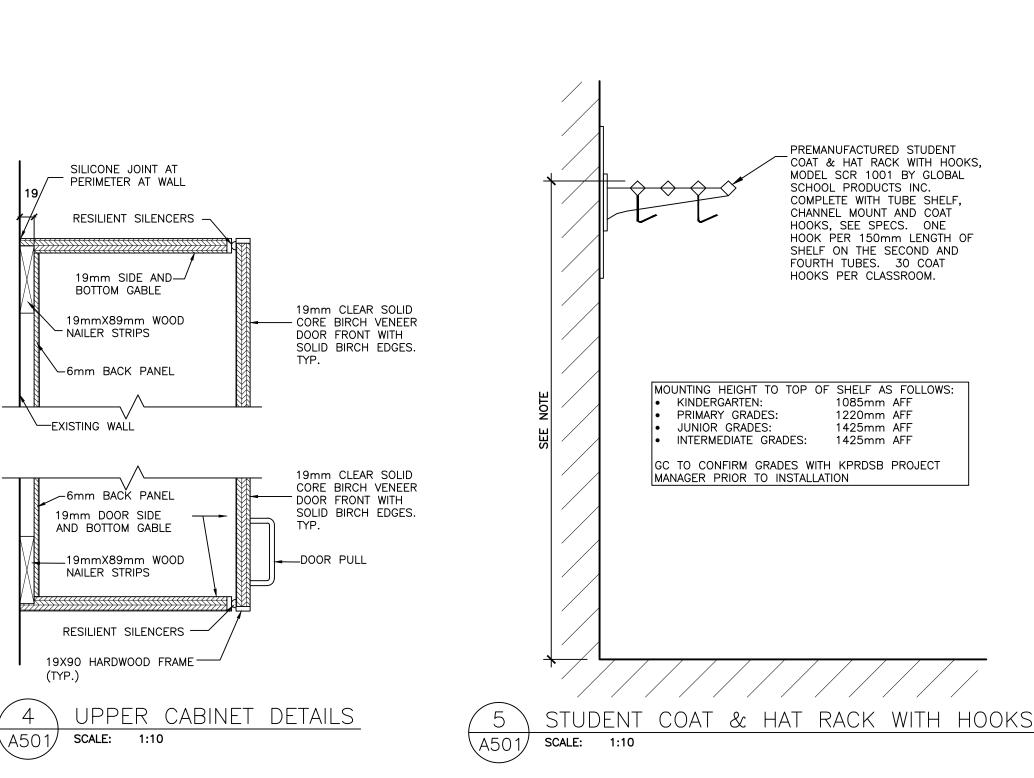

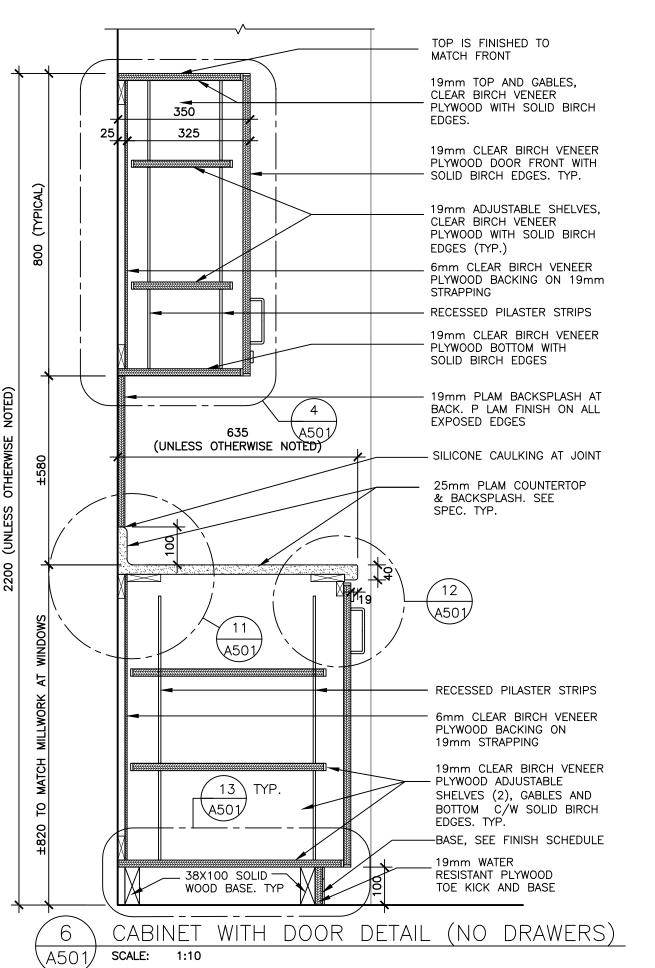

ALL DRAWINGS ARE THE PROPERTY OF THE ARCHITECT AND MUST BE RETURNED ON REQUEST.

SILICONE JOINT AT

PERIMETER AT WALL

SCRIBE GABLE TO

- 19mm END GABLE

19mmX89mm WOOD

6mm BACK PANEL

NAILER STRIP

TYP. GABLE AT WALL

SCALE:

SUIT WALL

THE CONTRACTOR SHALL CHECK ALL DIMENSIONS AND REPORT DISCREPANCIES TO THE ARCHITECT. ALL DIMENSIONS ARE GIVEN IN MILLIMETRES UNLESS OTHERWISE INDICATED.

DO NOT SCALE DRAWINGS.

REVISIONS AND DISTRIBUTION LOG Date FEB 20, 2024 | ISSUED FOR KPRDSB REVIEW MAR 1, 2024 | ISSUED FOR COORDINATION MAR 13, 2024 ISSUED FOR TENDER

#### TYPICAL NOTES:

PROVIDE SHOPDWG. PROVIDE SAMPLES AND PROVIDE MOCK UP BEFORE START FABRICATION.

#### SEE SPECIFICATION. TYPICAL

MATERIALS AND FINISHES TO BE AS SPECIFIED. FOR LOCATION AND NUMBER OF DOORS, DRAWERS AND SHELVES REFER TO INTERIOR ELEVATIONS.

MILLWORK NOTES ON A501 APPLY TO ALL MILLWORK DRAWINGS.

#### DEMOLITION OF HAZARDOUS MATERIALS TYPICAL:

G.C. TO REVIEW ABATEMENT CONSULTANTS REPORT AND RECOmmENDATIONS REGARDING THE REMOVAL OF HAZARDOUS BUILDING MATERIALS. REFER TO HAZARDOUS BUILDING MATERIALS ASSESSMENT REPORT ALONG WITH SPECIFICATIONS AND CONTRACT DOCUMENTS PREPARED BY PINCHIN REGARDING THE REMOVAL AND DEMOLITION OF HAZARDOUS MATERIALS





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#### KAWARTHA HEIGHTS P.S. CLASSROOMS 4, 5, 6, & 7 RENOVATIONS

KAWARTHA PINE RIDGE DISTRICT SCHOOL BD 1 KAWARTHA HEIGHTS BOULEVARD **PETERBOROUGH** ONTARIO

### MILLWORK DETAILS

	61 1 15	5 . 6	5
Drawn By:	Checked By:	Date Checked:	Project No.
TJ/LR	ОМ		23A123
Date Plotted:		Scale:	
Mar 20, 2	AS NOTED		
Drawing No.:	Revision No.:		
	3		

ARCH D

CONTROL PANEL DETAIL

(A501) SCALE: 1:10

TOP IS FINISHED TO MATCH FRONT SOLID CLEAR BIRCH WOOD RAIL AT HEAD & JAMBS 604 19mm CLEAR BIRCH PLYWOOD AND . 38X70mm SOLID WOOD NOSING 19mm CLEAR BIRCH PLYWOOD GABLE AND SOLID EDGES 4- 19mm CLEAR BIRCH VENEER PLYWOOD ADJUSTABLE SHELVES WITH SOLID BIRCH PILASTER STRIPS STORAGE UNIT DOOR HARDWARE TO BE SUPPLIED BY HARDWARE SUPPLIER, COORDINATE INSTALLATION W/ MILLWORK SUPPLIER. PROVIDE LEVER HARDWARE SAME AS DOOR, SEE HARDWARE GROUP. - 38mm SOLID CORE BIRCH VENEER WOOD DOORS 6mm CLEAR BIRCH PLYWOOD BACKING ON 19mm ON 19mm STRAPPING --- PULL OUT DRAWER 19mm CLEAR BIRCH PLYWOOD DOOR FRONT AND 12mm CLEAR BIRCH PLYWOOD DRAWER FRAME WITH SOLID EDGES. TYP. PULL OUT DRAWER

RESISTANT PLYWOOD

TOE KICK AND BASE

STORAGE UNIT FRONT ELEVATION

A502 SCALE: 1:10

SEE SCHEDULE


— 38X100 SOLID—

STORAGE UNIT SECTION DETAIL

WOOD BASE

(A502)

SCALE: 1:10

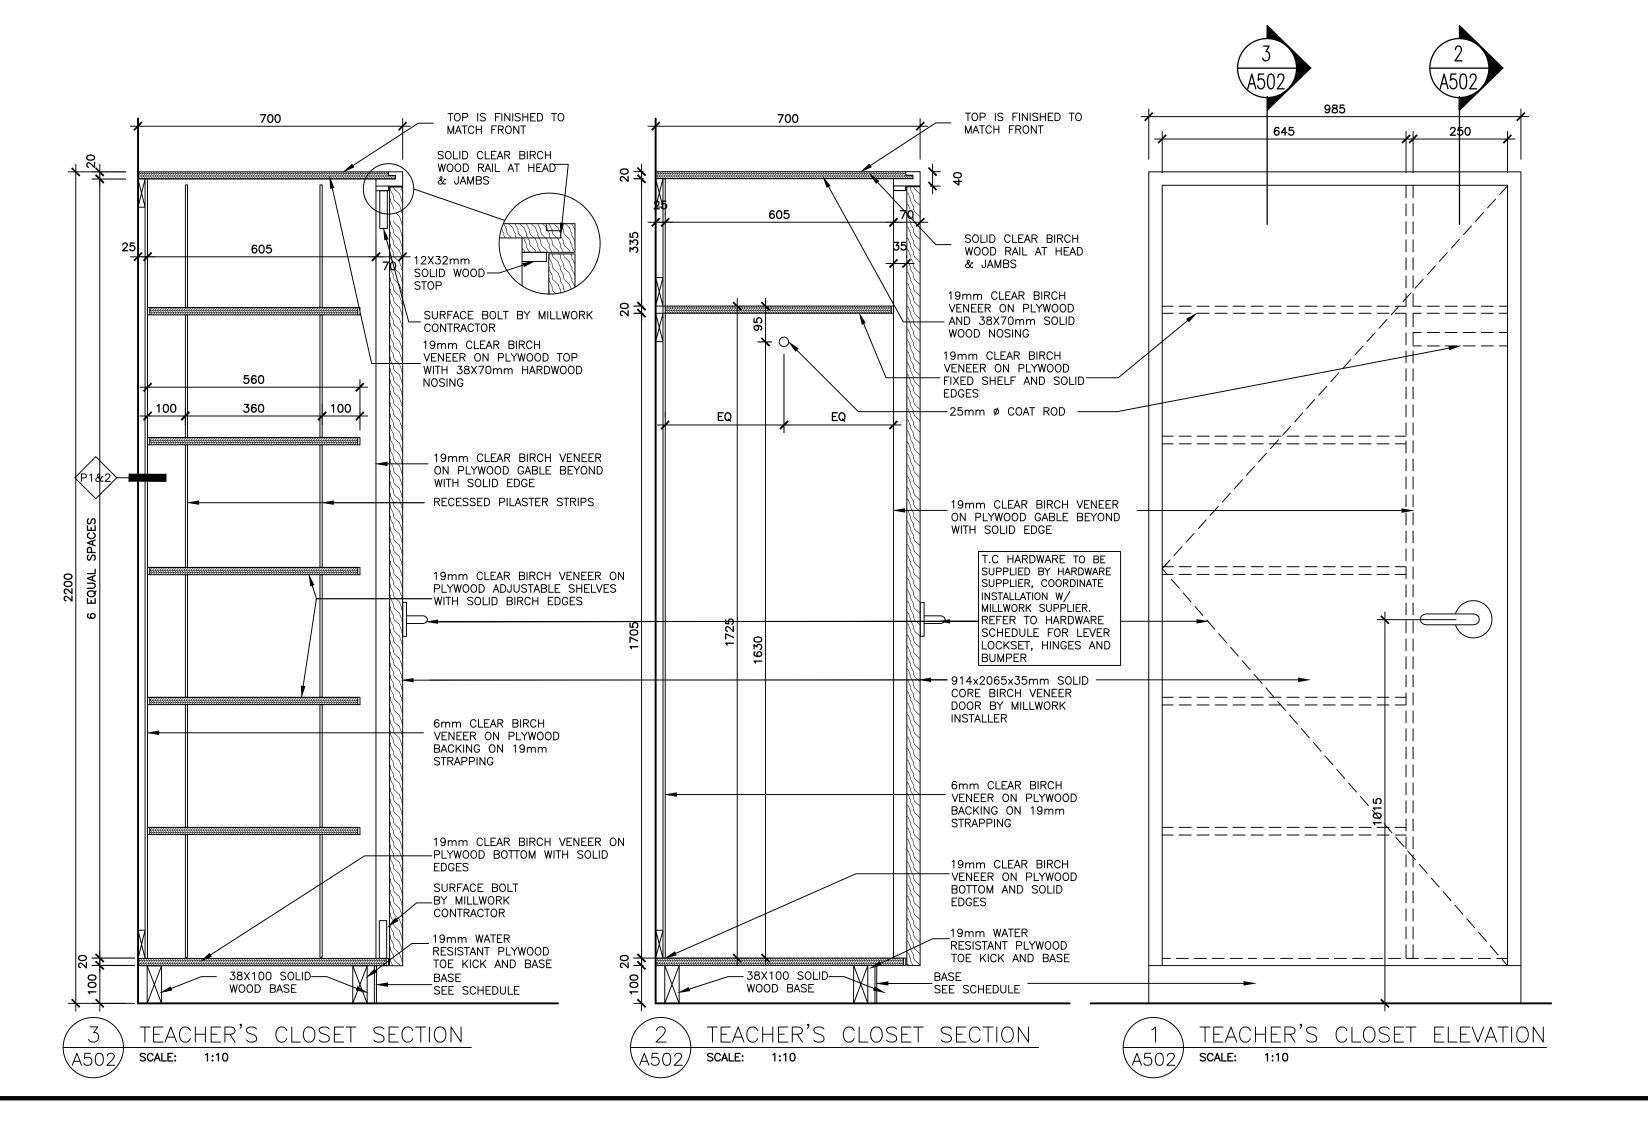

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ALL DIMENSIONS ARE GIVEN IN MILLIMETRES UNLESS OTHERWISE INDICATED.

DO NOT SCALE DRAWINGS.

	REVISIONS AND DISTRIBUTION LOG					
No.	Date	Note				
1	FEB 20, 2024	ISSUED FOR KPRDSB REVIEW				
2	MAR 1, 2024	ISSUED FOR COORDINATION				
3	MAR 13, 2024	ISSUED FOR TENDER				

#### TYPICAL NOTES:

PROVIDE SHOPDWG.
PROVIDE SAMPLES AND
PROVIDE MOCK UP BEFORE
START FABRICATION.

#### SEE SPECIFICATION. TYPICAL

MATERIALS AND FINISHES TO BE AS SPECIFIED. FOR LOCATION AND NUMBER OF DOORS, DRAWERS AND SHELVES REFER TO INTERIOR ELEVATIONS.

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# KAWARTHA HEIGHTS P.S. CLASSROOMS 4, 5, 6, & 7 RENOVATIONS

KAWARTHA PINE RIDGE DISTRICT SCHOOL BD

11 KAWARTHA HEIGHTS BOULEVARD
PETERBOROUGH
ONTARIO

### MILLWORK DETAILS

Drawn By:	Drawn By: Checked By: Date Checked:		Project No.
TJ/LR	ОМ		23A123
Date Plotted:	Scale:		
Mar 20, 2	AS NOTED		
Drawing No.:	Revision No.:		
	3		

INTERIOR FINISHES SCHEDULE MANUFACTURER/ PRODUCT NUMBER, COLOUR MATERIAL TYPE REMARKS IATION LVT INTERFACE STUDIO SET A00703 250 X 1000 LUXURY VINYL TILE (LVT) FLOORING LVT-1 COLOUR TO BE CONFIMRED BY KPRDSB PROJECT MANAGER INTERFACE DURACOVE DC, BLACK (TO MATCH RESILIENT RUBBER BASE BASE-1 JOHNSONITE EXISTING) MIN 3.0mm THICK REDUCER STRIP FROM TERRAZZO FLOOR TO 7.1mm TRANS-1 JOHNSONITE COLOUR TO BE SELECTED FROM FULL RANGE RESILIENT TRANSITION STRIF THICK FLOORING PLAM-1 FORMICA 271-58 BLACKSTONE, MATTE CONTROL PANEL, COUNTERTOPS PLAM-2 FORMICA 346-58 NATURAL OAK, MATTE DOORS TERRAZZO COVE BASE BASE-3 TO MATCH EXISTING IN PROFILE, COLOUR AND PATTERN ±100mm HIGH **EPOXY TERRAZZO ARMSTRONG** PROVIDE NEW CEILING TILES AND GRID, SEE SPEC ACOUSTIC TILE CEILING FIRE-RATED SCHOOL ZONE, SEE SPEC. 610x1220x16 TERRAZO FLOORING (CORRIDOR) TERR STONEHARD PAINT SCHEDULE PAINT ALL WALL COMPONENTS INCLUDING ELECTRICAL CONDUITS, PAINT: TYPICAL WALL | BENJAMIN MOORE | BM960 DOVE WHITE, SEMI-GLOSS PIPE, RADIATORS, ETC. ONLY ON TEACHING WALLS IN THE CLASSROOMS PAINT: ACCENT WALL BENJAMIN MOORE BM2126-20 RACCOON FUR, SEMI-GLOSS PAINT: DOOR FRAMES PT-2 BENJAMIN MOORE BM2126-20 RACCOON FUR, SEMI-GLOSS BOTH SIDES OF FRAMES CLASSROOM FINISH SCHEDULE ROOM ROOM NAME CEILINGS REMARKS NORTH EAST SOUTH WEST MAT. |FINISH | MAT. | FINISH MAT. | FINISH MAT. |FINISH MAT. | FINISH HEIGHT

PICTOGRAM

NOTES

BRAILLE

Χ

X

Х

BASE-1 EX CB GWB PT-1 EX CB PT-1 EX CB PT-2 EX CB PT-2 EX CB PT-1 EX CB PT-2 EX CB PT-1 ACT-1 PREFIN ±3040 TEACHING WALL PAINTED ACCENT COLOUR PT-2, TYPICAL GWB PT-1 ±2690 PAINT EXTG CONCRETE BEAMS PT-1

BASE-1 EX CB PT-2 EX CB PT-1 EX CB GWB PT-1 EX CB CONC. PT-1 ACT-1 PREFIN ±3040 TEACHING WALL PAINTED ACCENT COLOUR PT-2, TYPICAL GWB PT-1 ±2690 PAINT EXTG CONCRETE BEAMS PT-1

BASE-1 EX CB GWB PT-1 EX CB PT-1 EX CB PT-2 EX CB PT-2 EX CB PT-1 EX CB PT-2 EX CB PT-1 ACT-1 PREFIN ±3040 TEACHING WALL PAINTED ACCENT COLOUR PT-2, TYPICAL. PAINT EXTG CONCRETE BEAMS PT-1


BASE-1 EX CB GWB PT-1 EX CB PT-1 EX CB PT-2 EX CB PT-2 EX CB PT-1 ACT-1 PREFIN ±3040 TEACHING WALL PAINTED ACCENT COLOUR PT-2, TYPICAL GWB PT-1 ±2690 PAINT EXTG CONCRETE BEAMS PT-1 FINISH SCHEDULE \A801/ SCALE:

4 CLASSROOM

5 CLASSROOM

6 | CLASSROOM

CLASSROOM

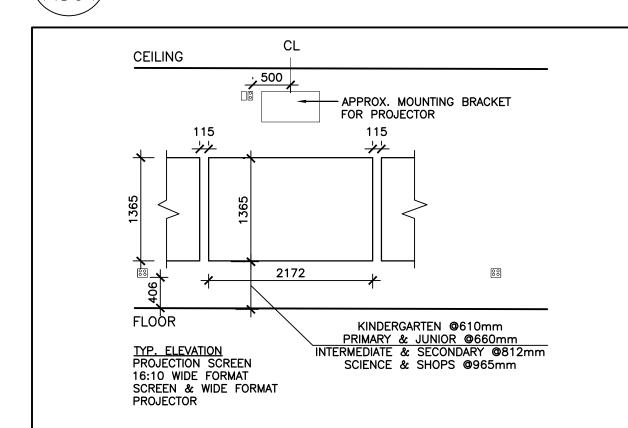

#### PROJECTION SCREEN

- CENTERLINE OF PROJECTION SCREEN • CENTERED BETWEEN TACK AND/OR MARKER BOARDS • DO NOT INSTALL ANY SURFACE MOUNTED CONDUIT BEHIND THE SCREENS.
- MOUNTING BRACKET FOR PROJECTOR

   INSTALLED AT CEILING HEIGHT ON THE WALL

ADJOINING TACKBOARDS OR WHITEBOARDS.

SCALE: 1:50

SIGNAGE SCHEDULE

ROOM USE

CLASSROOM

LASSROOM

CLASSROOM

CLASSROOM

SIGN TYPE B

8

\A801

ARCH D

SIGN TYPE A

ROOM SIGNAGE

SCALE: 1:5

\A801,

- +/- 203-254mm ABOVE WHITE BOARD ALLOW 762mm X 406mm @ CENTERLINE (DO NOT INSTALL ANY SERVICES @ THIS LOCATION) LOCATION OF ELECTRICAL & DATA FOR PROJECTOR

  • AT CEILING HEIGHT TO A MAXIMUM OF 3048mm AFF
- 500mm AWAY FROM CENTER TO ALLOW FOR INSTALLATION OF MOUNTING BRACKET
- POWER & DATA

   DUPLEX RECEPTACLE INSTALLED AT HIGH LEVEL ON THE WALL FOR PROJECTOR DATA REQUIRED FOR PROJECTOR QUAD RECEPTACLE AT BOTH LEFT & RIGHT CORNERS OF TEACHING WALLS BELOW ANY
- GENERAL

  BLOCKING AS REQUIRED AT NEW WALL TYPES WITH DRYWALL ON THE INTERIOR WALL SURFACE.

INTERACTIVE BOARD DETAILS

SIGN TYPE A SIGN TYPE B ENGLISH

5

6

SIGNAGE SPECIFICATIONS:

SIGNAGE AS PER SIGN SCHEDULE

FONT - HELVETICA MEDIUM

SIGNS SHALL HAVE GRADE 2 BRAILLE

APPLIED VINYL LETTERS AND BRAILLE BEADS,
FINISH: WHITE LETTERS ON BLACK BACKGROUND


ALL SYMBOLS, LETTERS AND NUMBERS SHALL BE RAISED TACTILE

16mm RADIUS CORNERS AT SIGN TYPE B, 6mm AT SIGN TYPE A


MATERIAL - MIN 6mm ACRYLIC WITH MINIMUM 0.8mm THICK


INSTALLATION - ROBERTSON STAINLESS STEEL SCREWS


CO-ORDINATE EXACT LOCATIONS WITH ARCHITECTURAL ELEVATIONS.

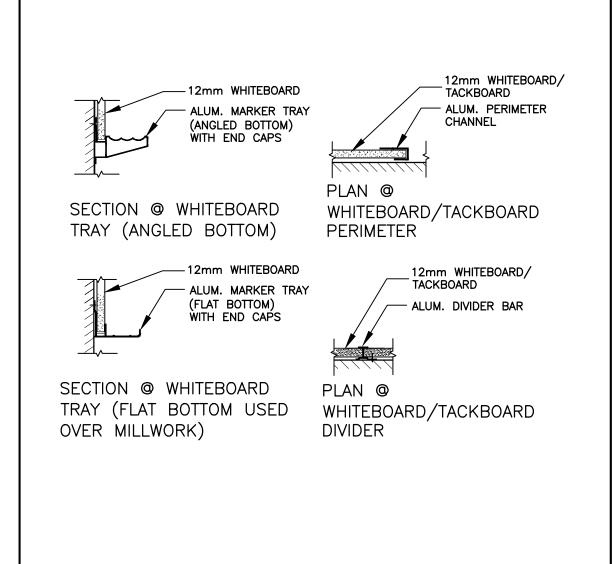

WHITEBOARD/TACKBOARD DETAILS \A801 SCALE:

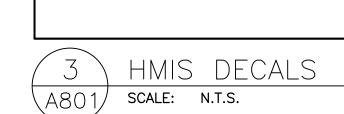


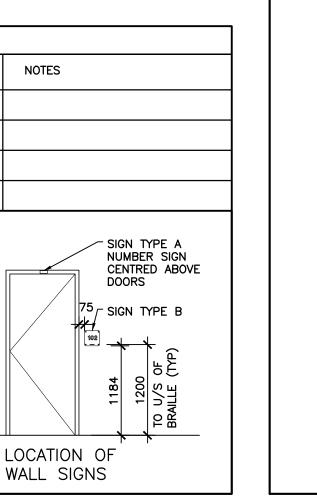

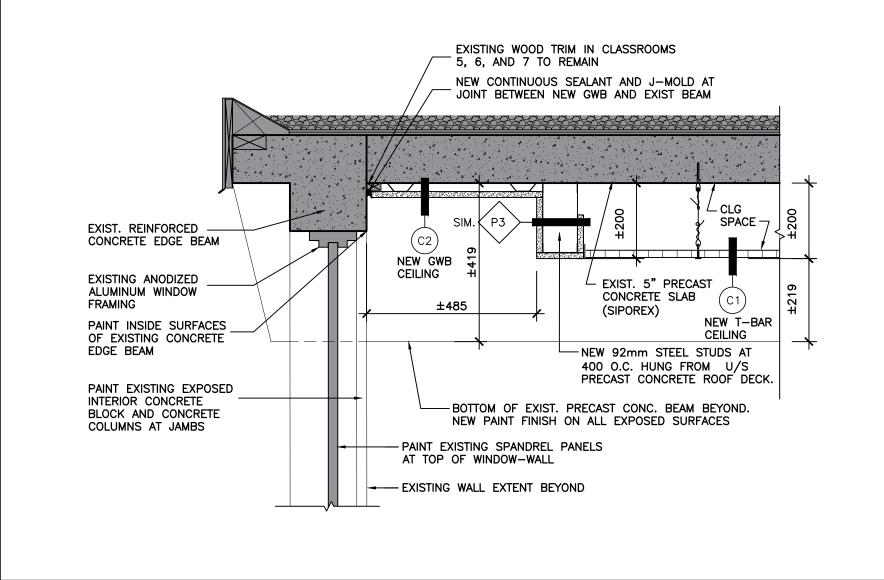

SECTION DETAIL AT NEW BULKHEAD (A801) SCALE: 1:10

FRAME TYPES SCHEDULE L TYPE 'F1' WOOD FRAME W/ TRIM, PAINT FINISH

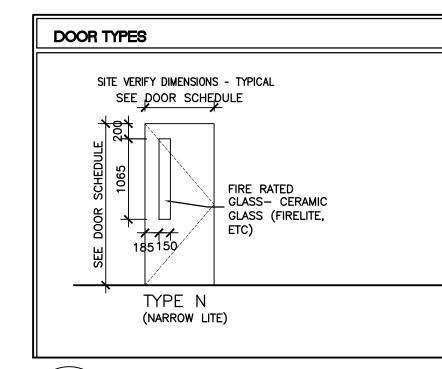

(A801 SCALE:

DOOR SCHEDULE DOORS **FRAMES** DETAIL ROOM NAME LEAF SIZE (mm) NEW DOOR & HARDWARE IN EXISTING WD FRAME. DOOR TO BE PLAM CORRIDOR H3 TO CLASSROOM 4 NEW 914 x 2032 X 45 20 MIN <u> FORMICA #346–58 NATURAL OAK . DOOR SIZE TO FIT EXIST. WD FRAME</u> NEW DOOR & HARDWARE IN EXISTING WD FRAME. DOOR TO BE PLAM CORRIDOR H3 TO CLASSROOM 5 NEW 914 x 2032 X 45 <u> FORMICA #346–58 NATURAL OAK . DOOR SIZE TO FIT EXIST. WD FRAME</u> NEW DOOR & HARDWARE IN EXISTING WD FRAME. DOOR TO BE PLAM NEW 914 x 2032 X 45 20 MIN FORMICA #346-58 NATURAL OAK . DOOR SIZE TO FIT EXIST. WD FRAME NEW DOOR & HARDWARE IN EXISTING WD FRAME. DOOR TO BE PLAM NEW 914 x 2032 X 45 20 MIN FORMICA #346-58 NATURAL OAK . DOOR SIZE TO FIT EXIST. WD FRAME LOCKS TO BE KEYED TO CLASSROOM DOOR. TEACHERS' CLOSET - 4 REQUIRED. 35mm THICK SCW (CLEAR BIRCH VENEER) DOOR BY MILLWORK SUPPLIER LOCKS TO BE KEYED TO CLASSROOM DOOR. STORAGE UNIT - 8 REQUIRED. 35mm THICK SCW (CLEAR BIRCH VENEER) DOOR BY MILLWORK SUPPLIER

SCALE:

DOOR SCHEDULE A801 SCALE: NTS

NOTE 1: REFER TO DOOR HARDWARE SCHEDULE 7/A801 FOR HARDWARE GROUPS

Doors: TC & SU

3 Hinge, Full Mortise

1 Surf Overhead Stop

Doors: 4, 5, 6, and 7

1 Cylinder

\A801/

3 Hinge, Full Mortise

1 Entry/Office Lock

1 Surf Overhead Stop

SCALE:

Storeroom/Closet Lock

Description: Teachers Closet and Storage Unit

Description: Single x SC x Office x CPS x KP

Note - Verify compatibility of hardware with millwork supplier.

TA2714 89 x 89

LC 1 28 7G04 LL

BY OWNER

Note - Closet doors opening to an adjacent wall - replace surface overhead stop 55-336 with wall stop 401.

TA2714 114 x 114

LC 28 10XG05 LL

K1050 200mm x WIDTH CSK

S773BL 1WIDTH x 2HEIGHT

BY OWNER

DOOR HARDWARE SCHEDULE

55-336

55-336

US26D

US26D

US26D

US26D

US26D


SA


OT


MK


(A801)

SA

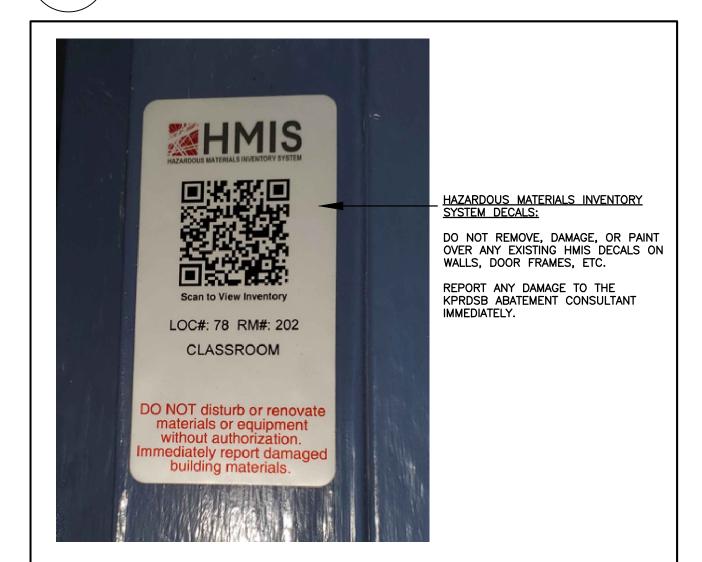

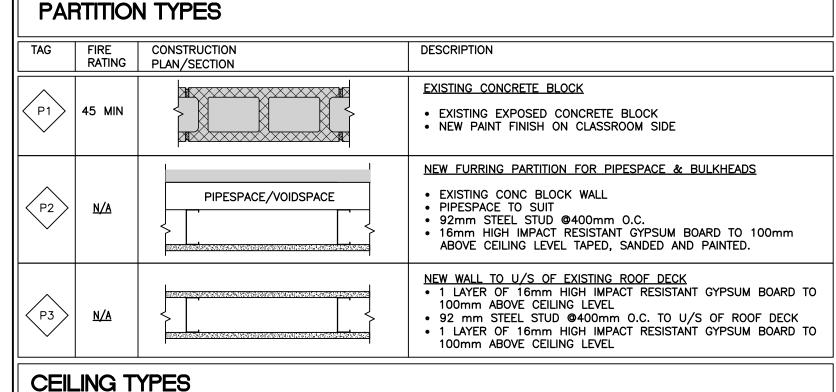

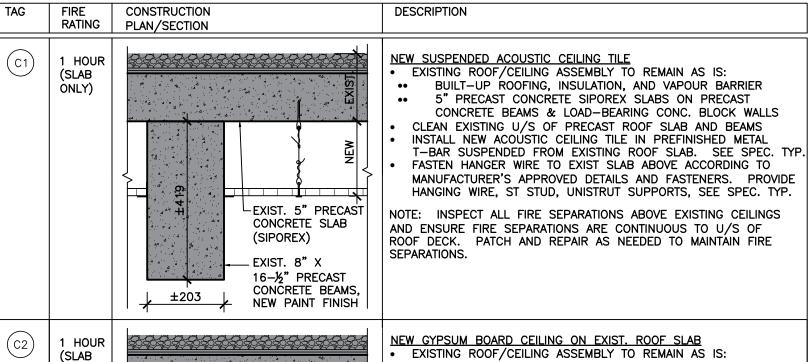

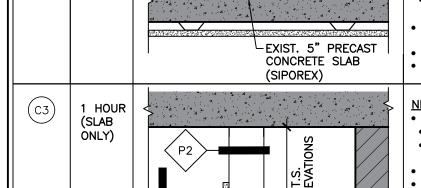

EXIST. CONCRETE -

ONLY)

•• BUILT-UP ROOFING, INSULATION, AND VAPOUR BARRIER •• 5" PRECAST CONCRETE SIPOREX SLABS ON PRECAST CONCRETE BEAMS & LOAD-BEARING CONC. BLOCK WALLS INSTALL NEW STEEL HAT CHANNELS AT 400mm O.C MAX TO U/S OF EXISTING ROOF SLAB. SEE SPEC. TYP.

PAINT FINISH PER SCHEDULE AND SPECS

PAINT FINISH PER SCHEDULE AND SPECS

NEW 1 LAYER OF 16mm HIGH IMPACT RESISTANT GYPSUM BOARD


NEW GYPSUM BOARD BULKHEAD BELOW EXIST. ROOF SLAB EXISTING ROOF/CEILING ASSEMBLY TO REMAIN AS IS: BUILT-UP ROOFING, INSULATION, AND VAPOUR BARRIER 5" PRECAST CONCRETE SIPOREX SLABS ON PRECAST CONCRETE BEAMS & LOAD-BEARING CONC. BLOCK WALLS NEW 92mm STEEL STUDS AT 400mm O.C MAX. SEE SPEC. TYP NEW 1 LAYER OF 16mm HIGH IMPACT RESISTANT GYPSUM BOARD

BLOCK FLOOR TYPES CONSTRUCTION DESCRIPTION RATING EXTG CONCRETE FLOOR SLAB EXTG CONCRETE FLOOR SLAB TO REMAIN PROVIDE LEVELLING COMPOUND AS REQ'D (TYP. NEW AND EXTG SLAB) COORDINATE WITH FLOOR FINISH MANUFACTURER FOR SUB-FLOOR CONDITION. MAKE SLAB READY TO ACCEPT FINAL FINISH PRODUCTS.

CONSTRUCTION ASSEMBLY SCHEDULE \A801/ SCALE: 1:10

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KAWARTHA HEIGHTS P.S. CLASSROOMS 4, 5, 6, & 7 RENOVATIONS

KAWARTHA PINE RIDGE DISTRICT SCHOOL BD 11 KAWARTHA HEIGHTS BOULEVARD **PETERBOROUGH** ONTARIO

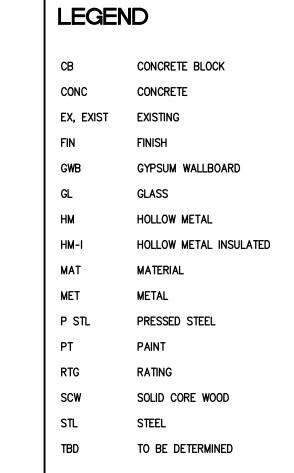ROOM FINISH, DOOR, AND

CONST. ASSEMBLY SCHED.

TJ/LR OM 23A123 Cate Plotted: Mar 20, 2024 - 10:07am **AS NOTED** evision No. A801

YMBOL	DESCRIPTION	SYMBOL	DESCRIPTION
$\bowtie$	GATE VALVE	— ю	PIPE UP
$\bowtie$	GLOBE VALVE	—— <del>I</del> Э	PIPE DOWN
ιбι	BALL VALVE		CAPPED PIPE
<b>N</b>	CHECK VALVE	<b></b>	DIRECTION OF FLOW
M	FLOAT VALVE		PIPE SLEEVE
MII	HOSE-END DRAIN VALVE	<i>→ 1</i>	CONTINUOUS PIPE
<b>₩</b> ]	VALVED AND CAPPED PROVISION	<b>──</b>	UNION
一	BUTTERFLY VALVE		STRAINER
$\overline{\mathbb{A}}$	LOCKSHIELD VALVE	BFP	BACKFLOW PREVENTER
M	PRESSURE REDUCING VALVE	WFA	WATER FEEDER ASSEMBLEY
×	FLOW SWITCH	XXXXX	FLEXIBLE PIPE CONNECTION
	SOLENIOD VALVE	0	PUMP
<ul><li>S</li><li>S</li></ul>	CIRCUIT BALANCING VALVE	<b>\$</b>	PRESSURE GAUGE WITH COCK
	PRESSURE DIFFERENTIAL VALVE	Ù	THERMOMETER
0x 4-	SAFETY RELIEF VALVE		STARTER
<u> </u>	2 WAY AUTOMATIC CONTROL VALVE	CTE	CONNECT TO EXISTING
· ·	3 WAY AUTOMATIC CONTROL VALVE	AP	ACCESS PANEL
=	VALVE IN RISER	AD	ACCESS DOOR
X↔	PRESSURE REGULATING VALVE	ETC	ELECTRIC TRACING CABLE
<b>GPR</b>	GAS PRESSURE REGULATOR	AFF	ABOVE FINISHED FLOOR
		U/S	UNDERSIDE

SYMBOL	DESCRIPTION	SYMBOL	DESCRIPTION
— HWS —	HOT WATER SUPPLY	FCU-2.0	EXISTING CEILING MOUNTED FAN COIL UNIT
— HWR — —	HOT WATER RETURN	<b>│</b>	WITH ELECTRIC DUCT HEATER
— CHWS —	CHILLED WATER SUPPLY	====	SINGLE LINE DUCT WITH EXTERNAL INSULATION
— CHWR — —	CHILLED WATER RETURN	****	SINGLE LINE DUCT WITH ACOUSTIC LINING
— cs —	CONDENSER WATER SUPPLY		SINGLE LINE FLEXIBLE DUCT
— CR — —	CONDENSER WATER RETURN		SUPPLY AIR DIFFUSER
s	STEAM MAIN (PRESSURE AS INDICATED)		RETURN OR EXHAUST AIR GRILLE
		6"Ø A	DIFF NECK SIZE/DIFF TYPE
—-CD-	CONDENSATE DRAIN	200	SUPPLY AIR CFM
— GS ——	GLYCOL SUPPLY	—— FD	FIRE DAMPER
— GR — —	GLYCOL RETURN	<b>───</b> MD	MOTORIZED DAMPER
X	PIPE ANCHOR	—— вр	MANUAL BALANCING DAMPER
=	PIPE GUIDE	O O	THERMOSTAT
	SUPPLY AIR OR FRESH AIR DUCT	<u> </u>	TEMPERATURE SENSOR
	RETURN AIR OR EXHAUST AIR DUCT	Θ	HUMIDISTAT
[×]	SUPPLY AIR OR FRESH AIR DUCT DOWN	DG	DOOR GRILLE
	RETURN AIR DUCT DOWN	S/A	SUPPLY AIR
9	ROUND DUCT UP	R/A	RETURN AIR
$\bigoplus$	ROUND DUCT DOWN	E/A	EXHAUST AIR
	DUCT WITH ACOUSTIC LINING	F/A	FRESH AIR
	DOUBLE LINE DUCT	<u> </u>	DOOD ORWE
<b>\</b> ///\}	DUCT SILENCER	DR DR	DOOR GRILLE
FCU	EXISTING CEILING MOUNTED FAN COIL UNIT	FCU-2.0	NEW CEILING MOUNTED FAN COIL UNIT

	AIR TERMINAL SCHEDULE								
TAG	DESCRIPTION	MANUFACTURER	MODEL	MATERIAL	FINISH	MOUNTING	COMMENTS		
А	LOUVERED GRILLE	EH PRICE	LBPH	STEEL	SEE NOTE 1	MILLWORK	1/4" BLADE SPACING, STEEL CONSTRUCTION, 0° DEFLECTION, FRONT BLADE PARALLEL TO LONG DIMENSION, COUNTERSUNK SCREW HOLE MOUNTING. COORDINATE FACE SIZE WITH ARCHITECT.		
В	LATTICE GRILLE	EH PRICE	LG75	STEEL	SEE NOTE 1	MILLWORK	COORDINATE FACE SIZE WITH ARCHITECT.		
С	LOUVERED GRILLE	EH PRICE	530D	STEEL	SEE NOTE 1	WALL	3/4" BLADE SPACING, STEEL CONSTRUCTION, DOUBLE DEFLECTION, FRONT BLADE PARALLEL TO LONG DIMENSION, COUNTERSUNK SCREW HOLE MOUNTING. PROVIDE OPPOSED BLADE BALANCING DAMPER. FACE SIZE NOTED ON PLANS.		
				-			1		

NOTES: 1. COORDINATE FINISH WITH ARCHITECT.

2. PROVIDE OPTIONAL 0-10V CONTROLLER AND UNIVERSAL MOUNT.

						FA	N SCF	HEDULI	E					
TAG	SERVICE	LOCATION	MANUFACTURER	MODEL	TYPE	FAN	VFD	BYPASS	VARIABLE	ELECTRICAL	EMERGENCY	WEI	GHT	COMMENTS
						'		ON VFD	FLOW		POWER			
						(RPM)	(Y/N)	(Y/N)	(Y/N)	V/P/Hz	(Y/N)	(LBS)	(Kg)	
CF-1	CLASSROOM	CEILING	BIG ASS FANS	HAIKU (60in)	CEILING FAN	200	N	N	N	120/1/60	N	15	7	COORDINATE FINISH WITH ARCHITECTURAL

SYMBOL	DESCRIPTION	SYMBOL	DESCRIPTION	
	EXISTING DUCTS, PIPES OR EQUIPMENT	<b>IIII</b> SD	SCUPPER DRAIN	
	DUCTS & EQUIPMENT TO BE REMOVED	<b>■</b> CB	CATCHBASIN	
	PIPES TO BE REMOVED	<b>⊜</b> RD	ROOF DRAIN	
SAN -	SANITARY DRAIN	VTR	VENT THROUGH ROOF	
— SAN — —	BURIED SANITARY DRAIN	RWL	RAINWATER LEADER	
(C) CAN	BURIED SANITARY CARRYING GREASE FROM	F	FIRE LINE	
— (G) SAN — —	KITCHENS IN FOOD COURT CRU'SDRAIN	SP	- SPRINKLER LINE (WET)	
2 (C) CAN 2 2	ELECTRICALLY TRACED BURIED SANITARY	—— DSP ——	- SPRINKLER MAIN (DRY)	
<del>~</del> (G) SAN <del>~</del> <del>~</del>	DRAIN	——— GSP ———	SPRINKLER MAIN (GLYCOL)	
ST	STORM DRAIN		WET ALARM CHECK VALVE	
— st — —	BURIED STORM DRAIN		DRY ALARM CHECK VALVE	
— wr — —	WEEPING TILE	E	DELUGE SYSTEM VALVE ASSEMBLY	
— PD —	PUMPED DRAIN	M	CHECK VALVE WITH BALLDRIP	
— PD — —	PUMPED DRAIN UNDER FLOOR	<b>Ø</b>	PENDENT SPRINKLER HEAD	
V	VENT PIPE	Ø	DRY PENDENT SPRINKLER HEAD	
	DRAIN WITH CLEANOUT	0	UPRIGHT SPRINKLER HEAD	
<b>——</b> •	DRAIN WITH CLEANOUT UP TO FLOOR	•	CONCEALED SPRINKLER HEAD	
O <sub>CO</sub>	DRAIN WITH CLEANOUT UP TO FLOOR	◁	SIDEWALL SPRINKLER HEAD	
<del>-</del>	RUNNING TRAP WITH CLEANOUT	0	WINDOW SPRINKLER HEAD	
	EXISTING WATERMAIN	0	EXISTING SPRINKLER HEAD TO REMAIN	
	DOMESTIC COLD WATER	o <sub>R</sub>	EXISTING SPRINKLER HEAD TO BE REMOVE	
	DOMESTIC HOT WATER	<b>₩</b>	SIAMESE PUMPER CONNECTION	
	DOMESTIC HOT WATER RECIRC	☐ FEC	FIRE EXTINGUISHER CABINET	
G	GAS PIPE	<b>I</b> FHC	FIRE HOSE CABINET	
НВ WH	HOSE BIBB/WALL HYDRANT	<b>G</b> FHV	FIRE HOSE VALVE	
<b>⊜</b> FD	FLOOR DRAIN	FSP	FIRE STANDPIPE	

	DRAWING LIST
DWG NO	DRAWING TITLE
M0-001	LEGEND, DRAWING LIST AND SCHEDULES
M1-101	FLOOR PLAN MECHANICAL DEMOLITION
M1-201	FLOOR PLAN MECHANICAL NEW

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No. Date Note

1 FEB 20, 2024 ISSUED FOR COORDINATION
2 MAR 13, 2024 ISSUED FOR TENDER



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23-1111-000





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KAWARTHA HEIGHTS P.S. CLASSROOMS 4, 5, 6, & 7 RENOVATIONS

KAWARTHA PINE RIDGE DISTRICT SCHOOL BD
11 KAWARTHA HEIGHTS BOULEVARD
PETERBOROUGH ONTARIO

Drawing Title:
LEGEND, DRAWING LIST
AND SCHEDULES

Drawn By: Checked By: Date Checked: Project No.

CAD AF

Date Plotted: Scale:


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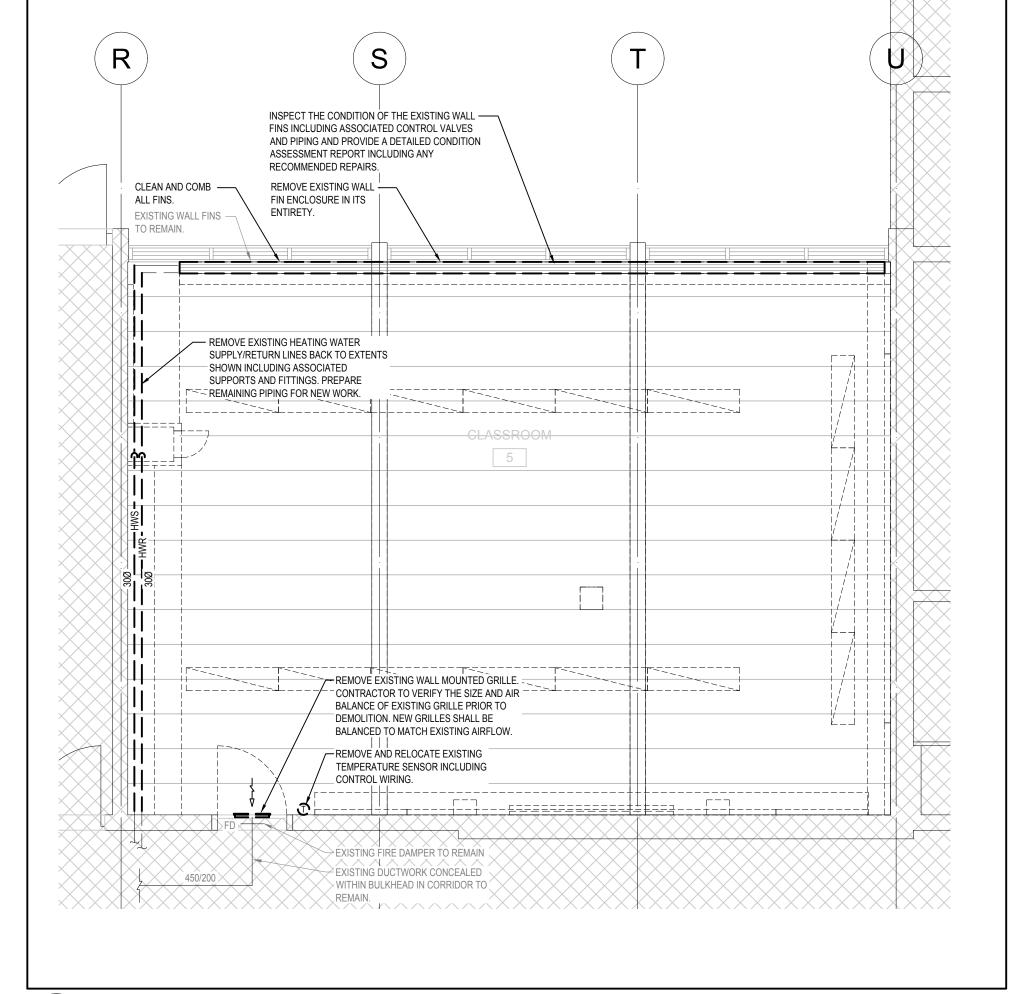
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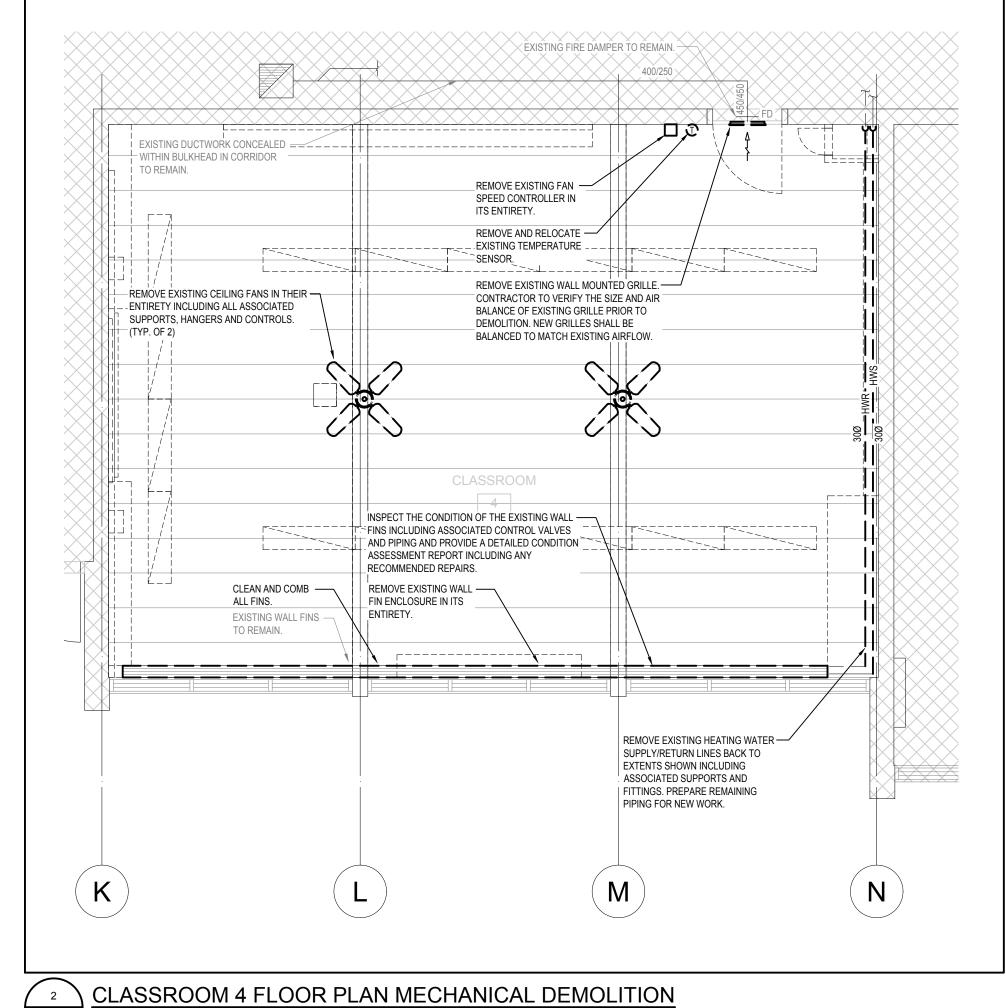
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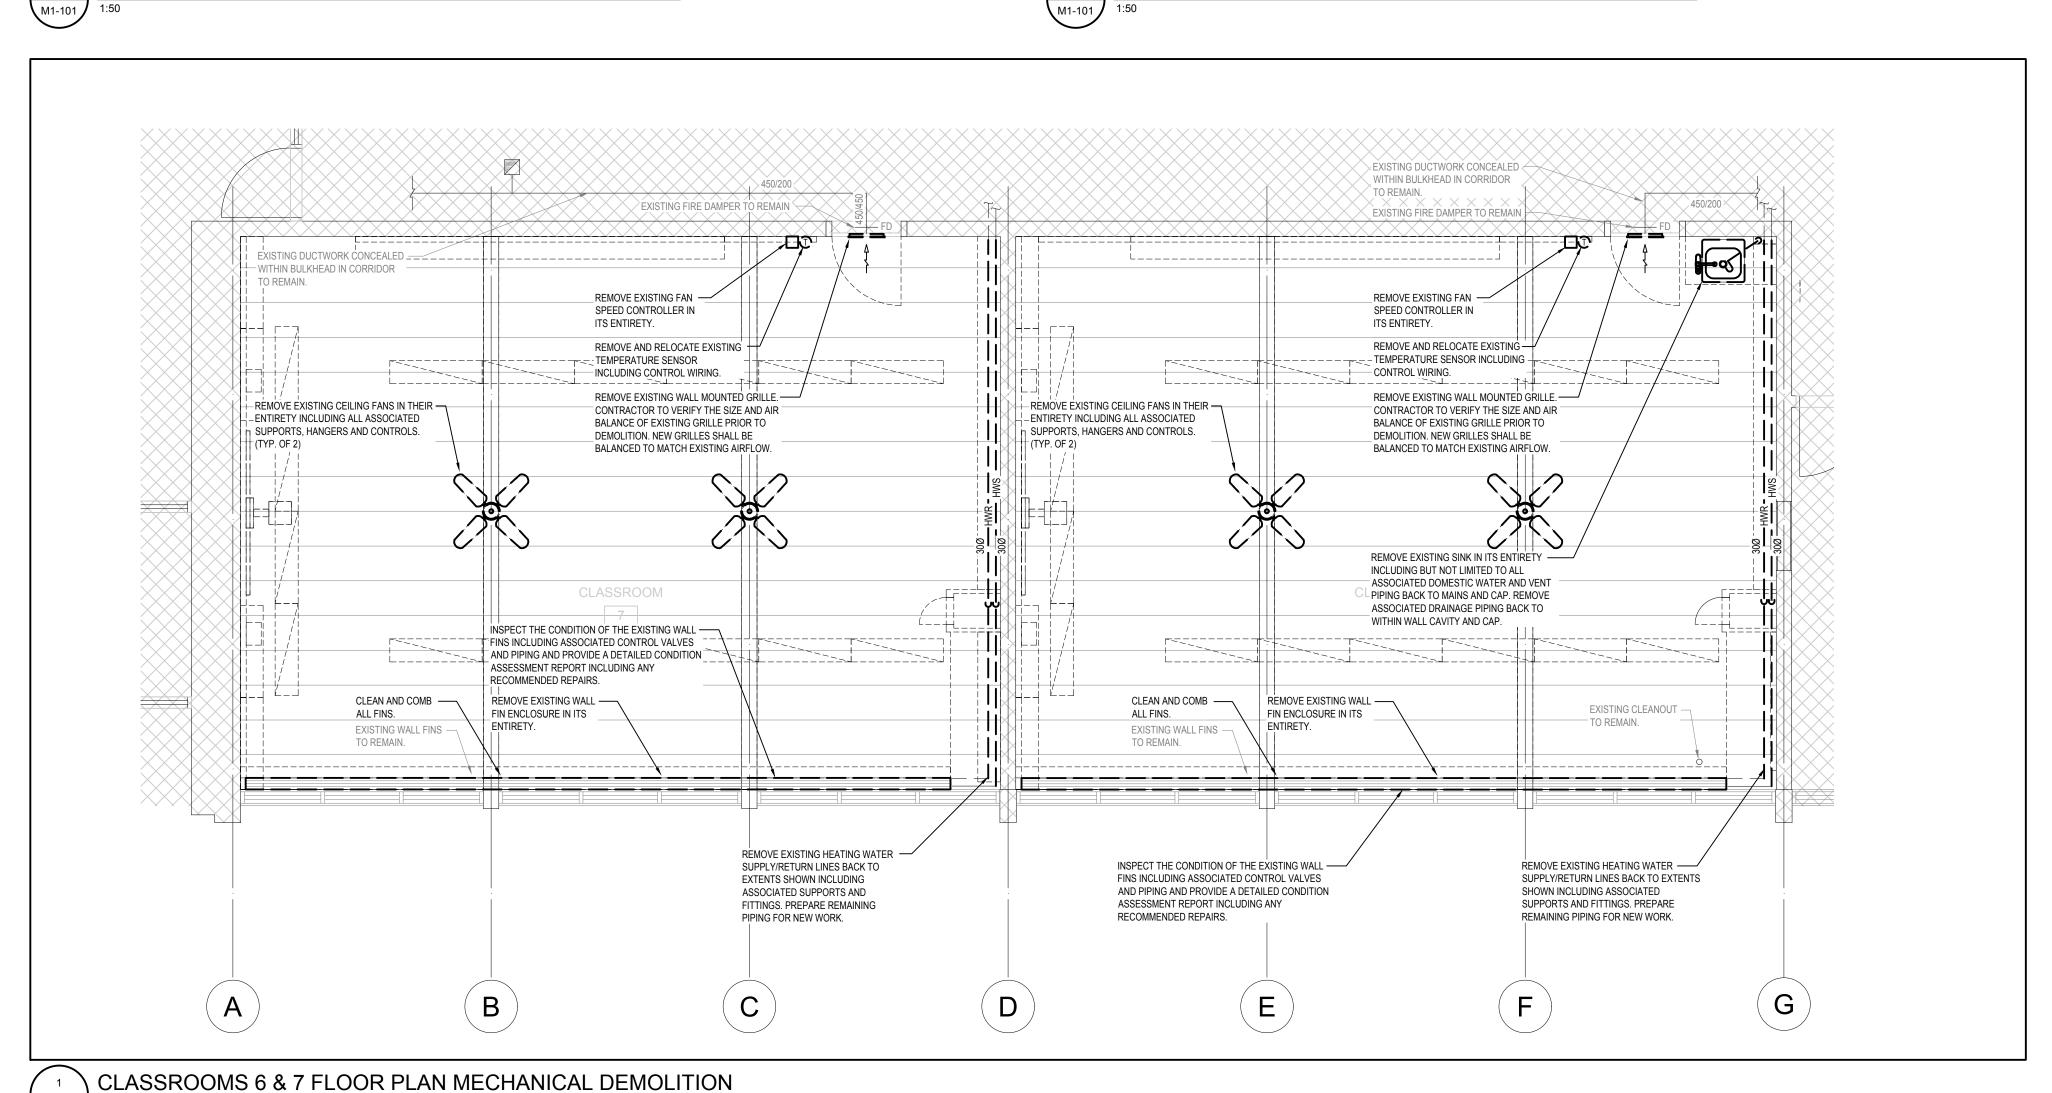
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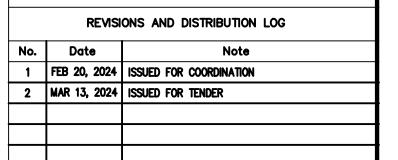




**CLASSROOM 5 FLOOR PLAN MECHANICAL DEMOLITION** 





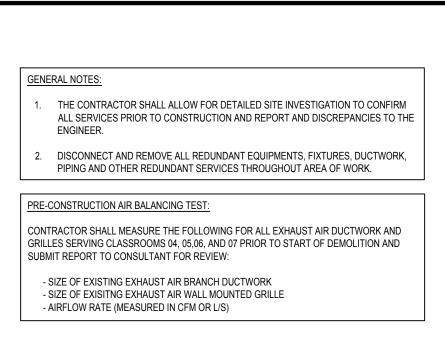

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Project: KAWARTHA HEIGHTS P.S. CLASSROOMS 4, 5, 6, & 7 RENOVATIONS

KAWARTHA PINE RIDGE DISTRICT SCHOOL BD 11 KAWARTHA HEIGHTS BOULEVARD PETERBOROUGH

FLOOR PLAN MECHANICAL DEMOLITION


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GENERAL NOTES:

THE CONTRACTOR SHALL INVESTIGATE AND CONFIRM

SERVICES ON SITE PRIOR TO CONSTRUCTION AND

REPORT ANY DISCREPANCIES TO CONSULTANT.

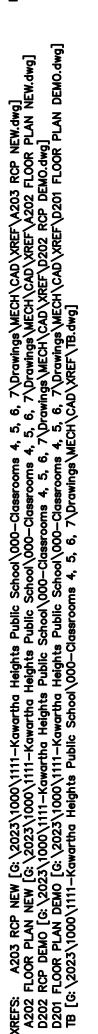

EXISTING FIRE DAMPER TO REMÂIN. RELOCATE EXISTING ROOM —  $\stackrel{\scriptscriptstyle{<}}{\scriptscriptstyle{\perp}}$  TEMPERATURE SENSOR HERE  $\stackrel{\scriptscriptstyle{<}}{\scriptscriptstyle{\leftarrow}}$ PROVIDE NEW TYPE 'A' SUPPLY REGISTER COORDINATE WITH MILLWORK TRADE — WITHIN BULKHEAD IN CORRIDOR AT THE TOP AND TYPE 'B' REGISTER AT THE TO PROVIDE ADEQUATE ACCESS TO BOTTOM OF THE NEW MILLWORK ALONG ALL VALVES. CLASSROOM PERIMETER. REFER TO PROVIDE NEW WALL MOUNTED WIRED FAN SPEED -EXISTING WALL FINS ARCHITECTURAL PLANS FOR SIZING. CONTROLLER CONTROLLED BY 0-10V DIMMER SWITCH (SIMILAR TO LIGHTING DIMMER SWITCH) LOCATED TO REMAIN. (TYPICAL) WITHIN NEW CLASSROOM CONTROL PANEL. SINGLE SWITCH SHALL CONTROL ALL THREE CEILING FANS. FANS SHALL OPERATE IN A STAND-ALONE CAPACITY WITHOUT THE NEED FOR WIRELESS CONNECTION. PROVIDE NEW RETURN GRILLE AT WALL. SIZE OF -NEW GRILLE SHALL MATCH EXISTING. PROVIDE CHAIN CEILING FANS TO CEILING BALANCING DAMPERS AS NEEDED TO ACHIEVE SLAB ABOVE. (TYP. OF 3) PROVIDE NEW 30Ø HEATING WATER AIR BALANCE INDICATED ON PLANS. SUPPLY/RETURN PIPING INCLUDING FITTINGS, SUPPORTS AND INSULATION. MOUNT AS HIGH AS POSSIBLE TO STRUCTURE ABOVE. INCLUDE FOR PIPE FREEZING TO MAKE NEW CONNECTION TO PROVIDE NEW CEILING FAN. CHAIN CEILING FANS TO CEILING SLAB ABOVE. (TYP. PROVIDE NEW TYPE 'A' SUPPLY REGISTER — AT THE TOP AND TYPE 'B' REGISTER AT THE  $\_$ BOTTOM OF THE NEW MILLWORK ALONG CLASSROOM PERIMETER. REFER TO ARCHITECTURAL PLANS FOR SIZING. COORDINATE WITH MILLWORK TRADE TO PROVIDE ADEQUATE ACCESS TO PROVIDE NEW RETURN GRILLE AT WALL. ALL VALVES. SIZE OF NEW GRILLE SHALL MATCH EXISTING WALL FINS -EXISTING. PROVIDE BALANCING DAMPERS TO REMAIN. AS NEEDED TO ACHIEVE AIR BALANCE PROVIDE INSPECTION OF EXISTING FIRE DAMPER AND REPORT FINDINGS TO CONSULTANT. CLEAN FIRE DAMPER IF APPLICABLE. PROVIDE NEW 300 HEATING WATER — -RELOCATE EXISTING ROOM SUPPLY/RETURN PIPING INCLUDING FITTINGS, TEMPERATURE SENSOR HERE SUPPORTS AND INSULATION. MOUNT AS HIGH INCLUDING CONTROL WIRING. AS POSSIBLE TO STRUCTURE ABOVE. INCLUDE FOR PIPE FREEZING TO MAKE NEW CONNECTION TO EXISTING PIPING. PROVIDE NEW WALL MOUNTED WIRED FAN SPEED CONTROLLER CONTROLLED BY 0-10V DIMMER SWITCH (SIMILAR) TO LIGHTING DIMMER SWITCH) LOCATED WITHIN NEW CLASSROOM CONTROL PANEL. SINGLE SWITCH SHALL EXISTING DUCTWORK CONCEALED CONTROL ALL THREE CEILING FANS. FANS SHALL OPERATE IN A > WITHIN BULKHEAD IN CORRIDOR TO 🔵 STAND-ALONE CAPACITY WITHOUT THE NEED FOR WIRELESS CLASSROOM 4 FLOOR PLAN MECHANICAL NEW **CLASSROOM 5 FLOOR PLAN MECHANICAL NEW** M1-201 PROVIDE INSPECTION OF EXISTING FIRE DAMPER AND REPORT FINDINGS TO CONSULTANT. CLEAN EXISTING DUCTWORK CONCEALED FIRE DAMPER IF APPLICABLE. WITHIN BULKHEAD IN CORRIDOR EXISTING FIRE DAMPER TO REMAIN S EXISTING DUCTWORK CONCEALER WITHIN BULKHEAD IN CORRIDOR CONTROLLED BY 0-10V DIMMER SWITCH (SIMILAR TO LIGHTING TO REMAIN. PROVIDE NEW WALL MOUNTED WIRED FAN SPEED CONTROLLER DIMMER SWITCH) LOCATED WITHIN NEW CLASSROOM CONTROL CONTROLLED BY 0-10V DIMMER SWITCH (SIMILAR TO LIGHTING PANEL. SINGLE SWITCH SHALL CONTROL ALL THREE CEILING DIMMER SWITCH) LOCATED WITHIN NEW CLASSROOM CONTROL FANS. FANS SHALL OPERATE IN A STAND-ALONE CAPACITY PANEL. SINGLE SWITCH SHALL CONTROL ALL THREE CEILING FANS. FANS SHALL OPERATE IN A STAND-ALONE CAPACITY WITHOUT THE NEED FOR WIRELESS CONNECTION. WITHOUT THE NEED FOR WIRELESS CONNECTION. - RELOCATE EXISTING ROOM TEMPERATURE SENSOR HERE -RELOCATE EXISTING ROOM TEMPERATURE SENSOR INCLUDING CONTROL WIRING. HERE INCLUDING CONTROL WIRING. PROVIDE NEW CEILING FAN.

PROVIDE INSPECTION OF EXISTING FIRE DAMPER AND REPORT FINDINGS TO CONSULTANT. CLEAN FIRE DAMPER IF APPLICABLE. PROVIDE NEW RETURN GRILLE AT WALL. SIZE OF NEW -PROVIDE NEW RETURN GRILLE AT WALL. SIZE OF NEW CHAIN CEILING FANS TO CEILING GRILLE SHALL MATCH EXISTING. PROVIDE BALANCING GRILLE SHALL MATCH EXISTING. PROVIDE BALANCING SLAB ABOVE. (TYP. OF 3) DAMPERS AS NEEDED TO ACHIEVE AIR BALANCE PROVIDE NEW CEILING FAN. DAMPERS AS NEEDED TO ACHIEVE AIR BALANCE INDICATED ON PLANS. CHAIN CEILING FANS TO CEILING INDICATED ON PLANS. SLAB ABOVE. (TYP. OF 3) PROVIDE NEW TYPE 'A' SUPPLY REGISTER -PROVIDE NEW TYPE 'A' SUPPLY REGISTER — AT THE TOP AND TYPE 'B' REGISTER AT THE .
BOTTOM OF THE NEW MILLWORK ALONG AT THE TOP AND TYPE 'B' REGISTER AT THE  $\_$ BOTTOM OF THE NEW MILLWORK ALONG CLASSROOM PERIMETER. REFER TO CLASSROOM PERIMETER. REFER TO ARCHITECTURAL PLANS FOR SIZING. ARCHITECTURAL PLANS FOR SIZING. COORDINATÉ WITH MILLWORK TRADE — COORDINATE WITH MILLWORK TRADE — TO PROVIDE ADEQUATE ACCESS TO TO PROVIDE ADEQUATE ACCESS TO TO REMAIN. ALL VALVES. ALL VALVES. EXISTING WALL FINS -EXISTING WALL FINS -\_TO REMAIN. TO REMAIN. ENSURE EXISTING CLEANOUT — REMAINS ACCESSIBLE. PROVIDE NEW 30Ø HEATING WATER -PROVIDE NEW 30Ø HEATING WATER — SUPPLY/RETURN PIPING INCLUDING FITTINGS, SUPPLY/RETURN PIPING INCLUDING FITTINGS, SUPPORTS AND INSULATION. MOUNT AS HIGH SUPPORTS AND INSULATION. MOUNT AS HIGH AS POSSIBLE TO STRUCTURE ABOVE. INCLUDE AS POSSIBLE TO STRUCTURE ABOVE. INCLUDE FOR PIPE FREEZING TO MAKE NEW FOR PIPE FREEZING TO MAKE NEW CONNECTION TO EXISTING PIPING. CONNECTION TO EXISTING PIPING.

CLASSROOMS 6 & 7 FLOOR PLAN MECHANICAL NEW

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PROVIDE INSPECTION OF EXISTING

FINDINGS TO CONSULTANT. CLEAN

FIRE DAMPER AND REPORT

FIRE DAMPER.

1 FEB 20, 2024 ISSUED FOR COORDINATION 2 MAR 13, 2024 ISSUED FOR TENDER



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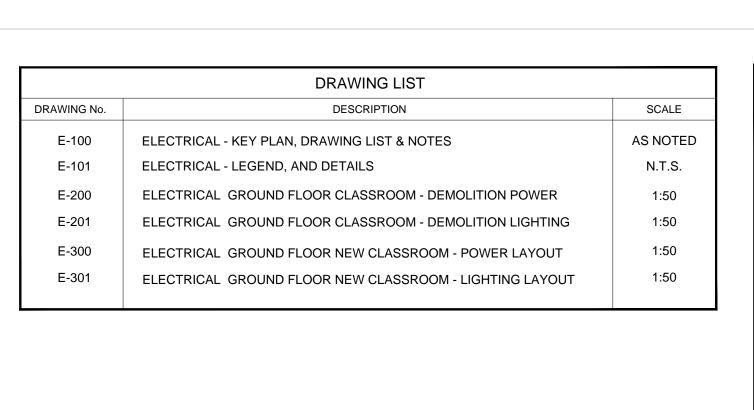
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KAWARTHA HEIGHTS P.S. CLASSROOMS 4, 5, 6, & 7 RENOVATIONS

KAWARTHA PINE RIDGE DISTRICT SCHOOL BD 11 KAWARTHA HEIGHTS BOULEVARD PETERBOROUGH

FLOOR PLAN MECHANICAL Drawn By: Checked By: Date Checked: Project No.

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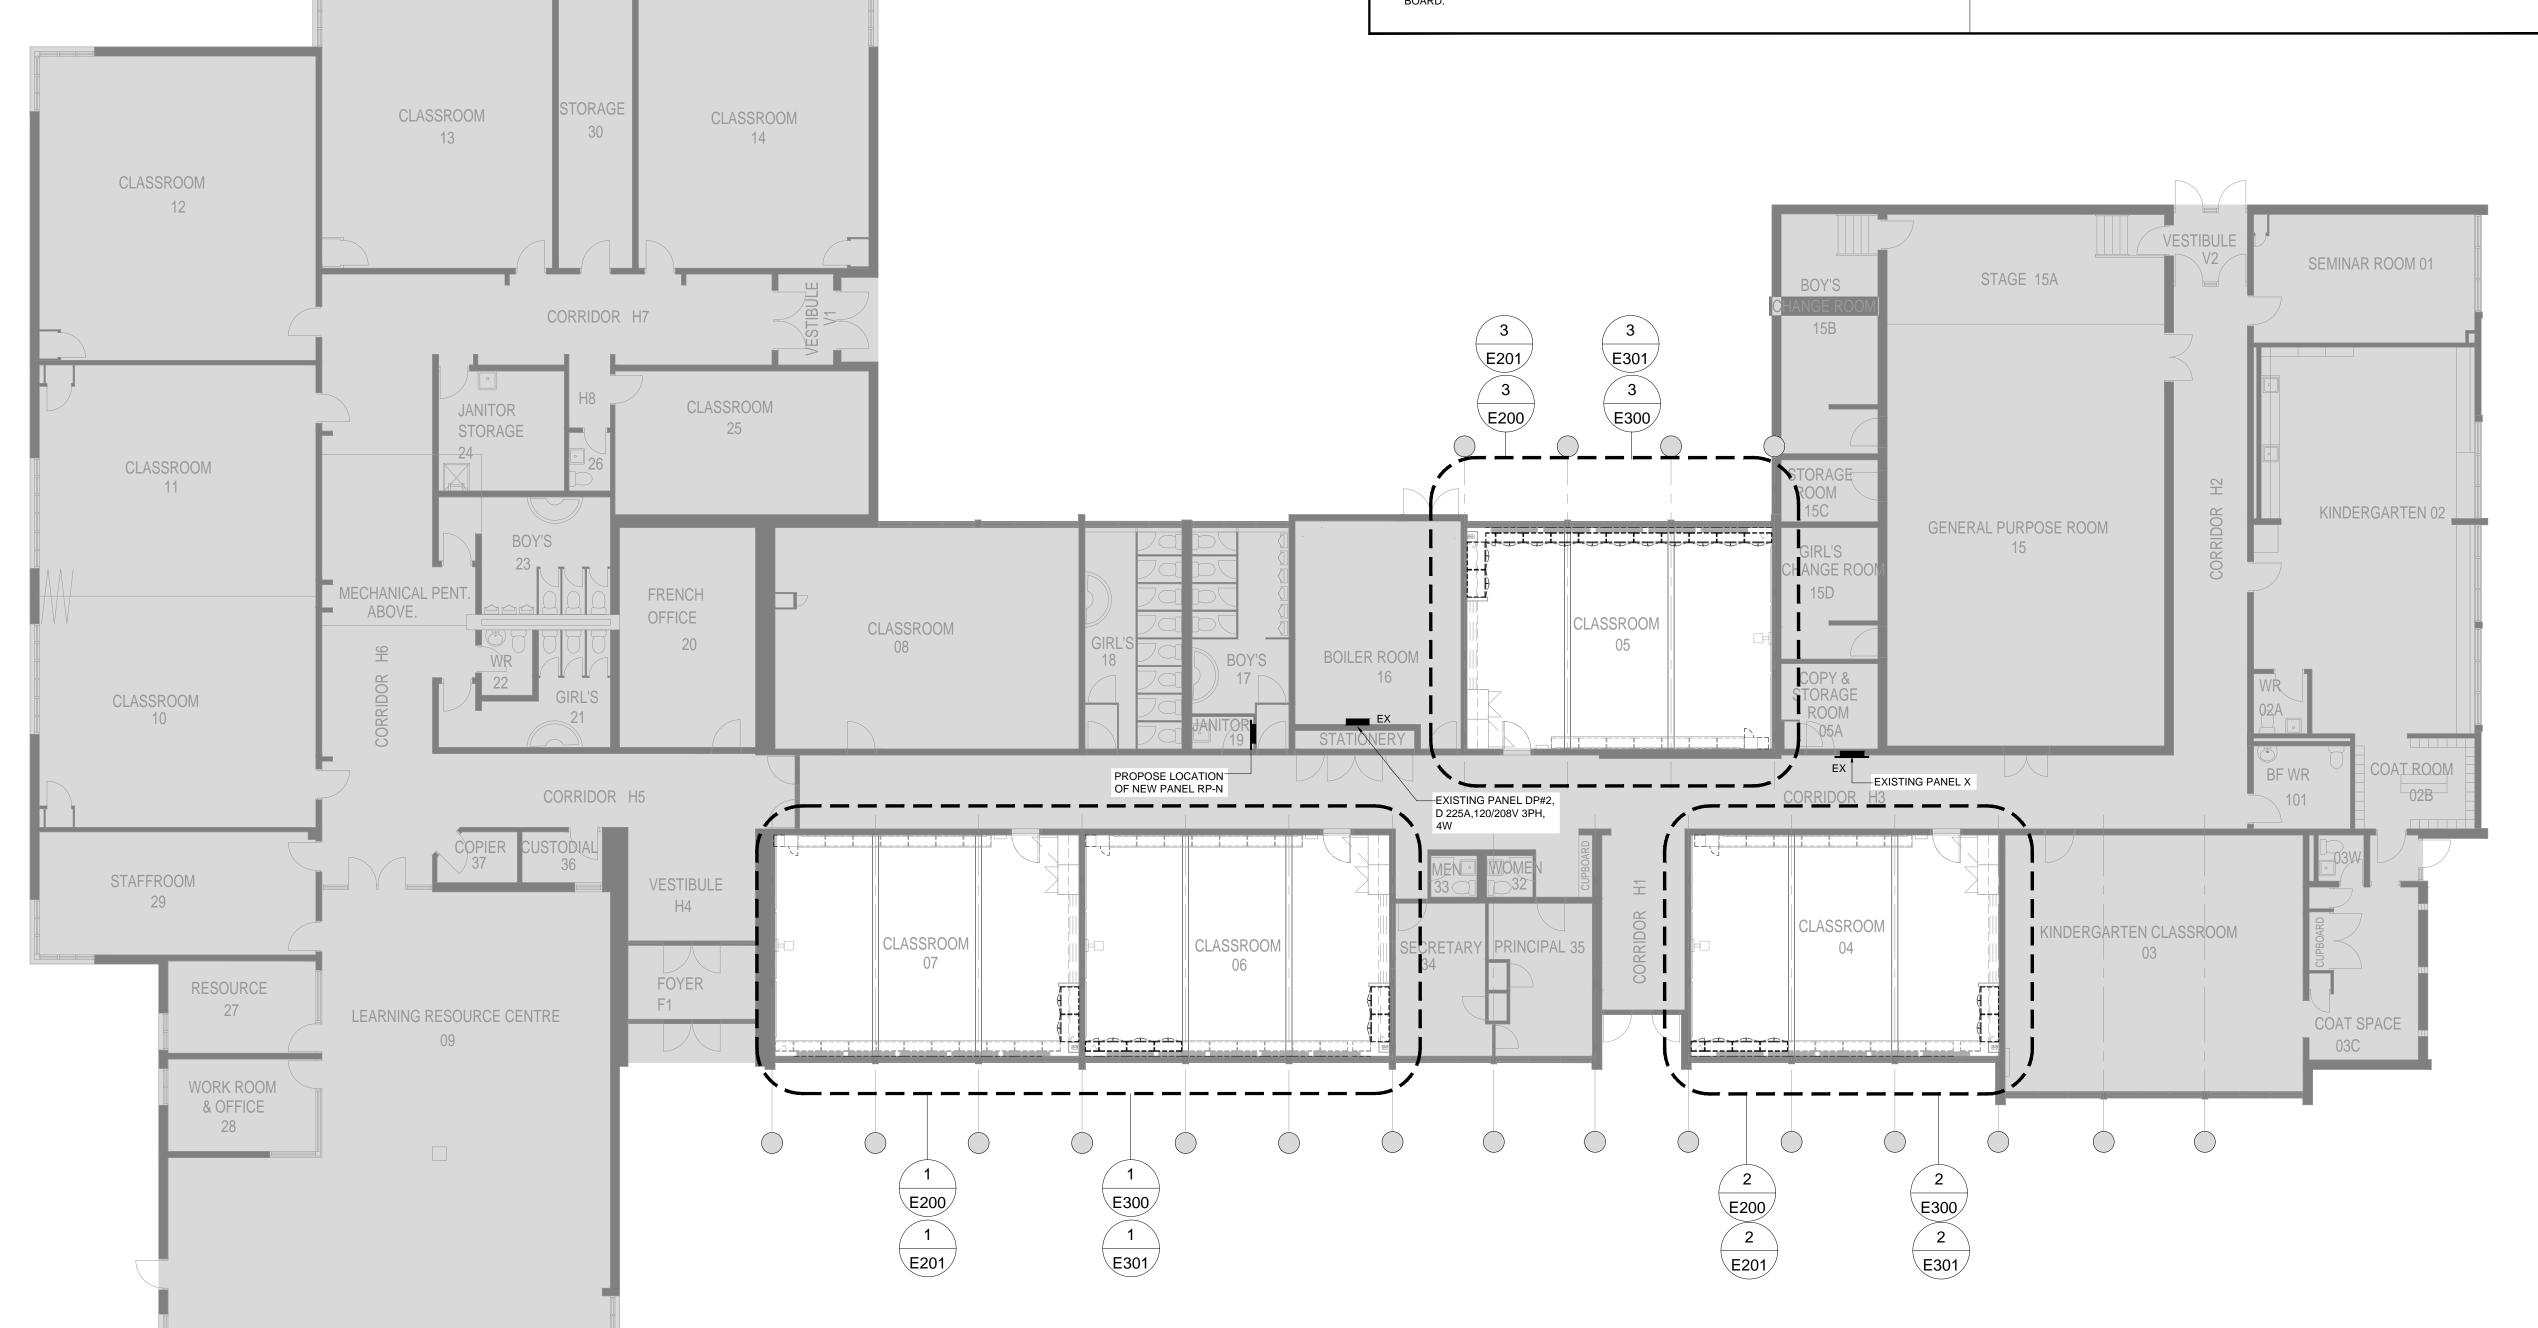
#### GENERAL NOTES (APPLY TO ALL DRAWINGS)

- ELECTRICAL DRAWINGS TO BE READ IN CONJUNCTION WITH ARCHITECTURAL DRAWINGS AND
- FOR EXACT LOCATION OF LIGHTING FIXTURES REFER TO ARCHITECTURAL DRAWINGS.
- FOR EXACT LOCATION OF ALL A/C UNITS, PUMPS, MOTORS, HEATERS, EXHAUST FANS ETC..., SEE MECHANICAL DRAWINGS. CO-ORDINATE ALL WORK WITH MECHANICAL CONTRACTOR.
- ALL EXISTING EQUIPMENT AND DEVICES SHALL REMAIN UNLESS OTHERWISE NOTED.
- EXACT LOCATION FOR ALL RECEPTACLES AND OUTLETS SHALL BE DETERMINED BY THE ARCHITECT OR OWNER PRIOR TO ROUGHING-IN. CONTRACTOR TO VERIFY.
- ELECTRICAL CONTRACTOR SHALL CO-ORDINATE THEIR WORK TO SUIT THE PROJECT PHASE
- ALL CUTTING, PATCHING AND PAINTING SHALL BE DONE BY THIS ELECTRICAL CONTRACTOR.
- DRILLING OF FLOORS, WALLS AND CEILINGS SHALL BE BY THIS CONTRACTOR, WHO SHALL OBTAIN WRITTEN APPROVAL FOR THE LOCATIONS OF THE DRILLING FROM THE GENERAL CONTRACTOR.
- CUTTING EFFECTING STRUCTURAL INTEGRITY OF THE BUILDING SHALL NOT BE ALLOWED WITHOUT PRIOR APPROVAL FROM THE STRUCTURAL ENGINEER.
- 0. X-RAY OF EXISTING FLOOR SLAB SHALL BE REQUIRED PRIOR TO ANY CORE DRILL OR SAW-CUT TRENCH AND SHALL BE BY THIS CONTRACTOR. CO-ORDINATE X-RAYING SCHEDULE WITH THE LANDLORD PRIOR TO PROCEEDING.
- 1. CO-ORDINATE LIGHTING LAYOUT ON SITE WITH OTHER TRADES TO AVOID CONFLICTS WITH SPRINKLERS, PIPES, DUCTS, ETC...
- 12. REFER TO ACCESS POINT DEVICE SCOPE ON DRAWING E-101 FOR FURTHER DETAIL.
- 3. THIS ELECTRICAL CONTRACTOR SHALL ALLOW IN CONTRACT TO PROVIDE REQUIRED DOCUMENTS TO SUPPORT THE LIGHTING INCENTIVE PROGRAM AS FOLLOW. COORDINATE WORKS WITH SCHOOL

- 13.1 EXISTING FIXTURES: THE BELOW INFORMATION SHALL BE PROVIDED BY THE CONTRACTOR AFTER AWARDING THE CONTRACT.
- TYPE
- LAMP WATTAGE
- LAMPS/FIXTURE
- 13.2. PHOTOS OF EACH FIXTURE BEING REMOVED ARE REQUIRED. THE REQUIRED PHOTOS ARE AS FOLLOWS: - PICTURE OF THE TYPICAL ROOM FOR EACH TYPE OF FIXTURE
  - PICTURE OF THE TYPICAL FIXTURE BEING REMOVED, (FOR EACH TYPE OF FIXTURE)
- ACTUAL LAMP IS NOT ACCESSIBLE). 13.2. PHOTOS OF THE NEW FIXTURES BEING INSTALLED ARE REQUIRED. THE REQUIRED PHOTOS ARE AS FOLLOWS:

- CLOSEUP SHOWING THE WATTAGE, (EITHER OF LAMP INSTALLED, OR THE BOX OF REPLACEMENT LAMPS IF

- PICTURE OF THE TYPICAL ROOM FOR EACH TYPE OF FIXTURE - PICTURE OF THE TYPICAL FIXTURE BEING REMOVED, (FOR EACH TYPE OF FIXTURE)
- CLOSEUP OF THE NAMEPLATE TO VERIFY THE MODEL NUMBER. 13.4. WASTE DISPOSAL DOCUMENTATION IS REQUIRED FROM THE WASTE DISPOSAL COMPANY. A RECEIPT, CERTIFICATE ORINVOICE FROM THE WASTE DISPOSAL COMPANY SHOULD INDICATE THE NUMBER OF LAMPS
- AND TYPE OF LAMPS DISPOSED-OF, (SOMETIMES LISTED AS # FT). 14. ALL RECEPTACLES WITHIN RENOVATION AREAS SHALL BE TAMPER-PROOF.
- 15. CIRCUITS NUMBER SHOWN ON DRAWINGS ARE FOR REFERENCE / CIRCUITING ONLY. THIS ELECTRICAL CONTRACTOR SHALL VERIFY EXISTING PANEL ON SITE TOR REUSE EXISTING CIRCUIT, SPARE BREAKERS OR PROVIDE NEW ONES AS REQUIRED.



1 GROUND FLOOR - KEY PLAN E-101 SCALE: 1:125

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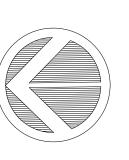
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No. Date

DISCREPANCIES TO THE ARCHITECT.

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KAWARTHA HEIGHTS P.S. CLASSROOMS 4-5-6-7 RENOVATION KAWARTHA PINE RIDGE DISTRICT SCHOOL BOARD

11 KAWARTHA HEIGHTS BOULEVARD PETERBOROUGH ONTARIO

Drawing Title:

ELECTRICAL - KEY PLAN, LEGEND DRAWING LIST & NOTES

Drawn By:	Checked By:	Date Checked:	Project No.
MT	QV		24-018-005
Date Plotted:		Scale:	
Mar 11, 2024 - 12:01pm			AS NOTED
Drawing No.:			Revision No.:

E-100

	LIGHT FIXTURE SCHEDULE							
ITEM	MANUFACTURER/CATALOG NUMBER	VOLTAGE	LAMP	MOUNTING	DESCRIPTION			
LA	COOPER LIGHTING CAT.# METALUX 2X4FP LED SERIES OR APPROVED EQUAL.	120V	LED 4500 LUMENS 4000K	RECESSED	2'X4' RECESSED T-BAR CEILING MOUNTED, LED LIGHTING FIXTURE, ACRYLIC LENS, 0-10V DIMMING DRIVERS.			
	NOTES:							

- 1 FOR FURTHER INFORMATION REGARDING LIGHT FIXTURES REFER TO SPECIFICATION.
- (2) LED LUMEN VALUES QUOTED FOR FIXTURES ARE TO BE CONSIDERED MINIMUM, AND AS ABSOLUTE OR DELIVERED LUMENS. LUMEN VALUES SHOULD NOT EXCEED MORE THAN 10% OF SPECIFIED OUTPUT.
- EQUAL MANUFACTURERS / SUPPLIERS MUST CONFIRM THE PROPOSED FIXTURE BY EMAIL WITH CONSULTANTS OFFICE A MINIMUM OF 10 DAYS PRIOR TO TENDER CLOSE.
- CONFIRM REQUIRED FIXTURE VOLTAGE ON SITE PRIOR TO SUBMITTING SHOP DRAWINGS.
- 5 ALL LIGHTING FIXTURES SHALL BE QUALIFIED SCHOOL LIGHTING INCENTIVE PROGRAM.

#### NOTES RE. TO WIRELESS DEVICES:

THIS ELECTRICAL CONTRACTOR SHALL COORDINATE WORK WITH GENERAL CONTRACTOR AND PROVIDE WORKS FOR WIRELESS AS FOLLOW:

- ALL EXISTING WIRELESS DEVICES SHALL BE IDENTIFIED TO BE ASSOCIATED WITH PARTICULAR ROOM NAME/NUMBER THAT DEVICE IS BEING INSTALLED.
- PRIOR TO CONSTRUCTION, CONTRACTOR SHALL REMOVE WIRELESS DEVICES FROM CEILING AND STORE IN SECURE AREA FOR LATER USE.
- WIRELESS DEVICES SHALL BE IDENTIFIED AND MARKED CAREFULLY. ENSURE THAT DEVICES WILL NOT MIXUP TO OTHER ROOM. EACH DEVICE WILL HAVE SPECIFIC NUMBER. OBTAIN THE LIST OF NUMBER FROM CONSULTANT.
- RE-INSTALL WIRELESS DEVICES AND PROVIDE REQUIRED TESTING, VERIFICATION TO PROVIDE A COMPLETE SYSTEM.
- 5. REFER TO STOCKDALE COMMUNICATION EQUIPMENT / WORKS.

#### NOTES RE. TO PUBLIC ADRESS (PA) SYSTEM:

- P.A. SYSTEM SHALL BE PROVIDED BY THIS CONTRACTOR
- 1. REFER TO FLOOR PLAN FOR EXACT LOCATION AND NUMBER OF DEVICES. ALL PA SPEAKERS SHOWN ON NEW LAYOUT SHALL BE NEW.
- 2. VERIFY ON SITE FOR EXACT LOCATION OF P.A. PANEL PRIOR TO ROUGHING-IN.
- 3. PROVIDE ALL P.A. DEVICES AS SHOWN ON DRAWINGS COMPLETE WITH REQUIRED CONDUIT/WIRING AND HOME RUN FROM INDIVIDUAL DEVICE TO EXISTING P.A. PANEL.
- 4. CONTRACTOR SHALL VERIFY ON SITE TO PROVIDE REQUIRED MODIFICATION OR /AND NEW EQUIPMENT TO SUIT NEW LAYOUT.
- 5. REFER TO P.A. SPECIFICATIONS / STOCKDALE COMMUNICATION EQUIPMENT / WORKS.

#### NOTES RE. TO VOICE/DATA SYSTEM:

VOICE/DATA SYSTEM SHALL BE PROVIDED BY THIS CONTRACTOR 1. REFER TO FLOOR PLAN FOR EXACT LOCATION AND NUMBER OF DEVICES.

- .. VERIFY ON SITE FOR EXACT LOCATION OF VOICE/DATA PATCH PANELS PRIOR TO ROUGHING-IN
- 3. PROVIDE ALL VOICE/DATA DEVICES AS SHOWN ON DRAWINGS COMPLETE WITH REQUIRED CONDUIT/WIRING AND HOME RUN FROM INDIVIDUAL DEVICE TO EXISTING VOICE/DATA PATCH PANEL.
- 4. CONTRACTOR SHALL VERIFY ON SITE TO PROVIDE REQUIRED MODIFICATION OR /AND NEW EQUIPMENT TO SUIT NEW LAYOUT.
- 5. REFER TO COMMUNICATION SPECIFICATIONS.

#### **EMERGENCY BATTERY UNIT SPECIFICATIONS**

#### **BATTERY UNITS**

BATTERY UNIT SHALL BE LUMACELL CAT.#RGS SERIES WITH CAPACITY AS INDICATED ON DRAWING OR EQUAL BY BENGELI OR LUXNET.

UNITS SHALL BE FOR OPERATION ON 120VAC VOLT - 10 YEARS LIFE BATTERY - WITH NUMBER OF HEADS INDICATED ON THE DRAWINGS. UNITS SHALL BE PLUG-IN TYPE WITH SEALED PURE LEAD BATTERIES. THE CHARGER SHALL BE COMPLETELY AUTOMATIC, SOLID STATE TYPE BROWN OUT FEATURE, CAPABLE OF FULLY RECHARGING DISCHARGED BATTERY IN 24 HOURS. TRANSFER DEVICE SHALL AUTOMATICALLY SWITCH LOAD ON AT POWER FAILURE AND OFF ON RETURN OF NORMAL POWER. UNITS SHALL HAVE LOW VOLTAGE DISCONNECT FEATURE.

#### REMOTE HEADS 'EM1'

I. SINGLE AND DOUBLE REMOTE HEADS SHALL BE MICRO-QUARTZ 12V, DC 6W, EMERGENCY LIGHTING REMOTE HEADS SHALL BE WHITE. LUMACELL CAT.# MQM SERIES OR APPROVED EQUAL.

SINGLE FACE OR DOUBLE FACE AS PER DRAWING, UNIVERSAL MOUNTED LED SIGN,GREEN RUNNING MAN SIGN, WHITE FINISH, 2W LED LAMPS, 120VAC, AND 12VDC INPUT. 6W LED REMOTE HEADS, BUILT IN BATTERY UNIT 80W.

#### LUMACELL CAT.# LSC SERIES OR APPROVED EQUAL.

BATTERY UNITS, REMOTE HEADS AND EXIT SIGNS SHALL BE FROM EMERGI-LITE, BEGHALLI AND LUXNET


#### OCCUPANCY SENSOR SCHEDULE

OS 1 FLUSH WALL MOUNTED ULTRASONIC/PASSIVE INFRARED OCCUPANCY SENSOR SWITCH:

- AUTO-ON WITH MANUAL OFF SWITCH. - FITS A STANDARD SWITCH BOX WITH DECORA COVER PLATE. - ADJUSTABLE TIME DELAY BETWEEN 30 SECONDS AND 30 MINUTES. - IVORY FINISH. - ADJUSTABLE INTEGRATED NATURAL LIGHT LEVEL SENSOR BETWEEN 2 AND 200 FOOT CANDLES. - 5 YEAR WARRANTY.


#### WATT-STOPPER CAT. DWS-347/277-I.

- 1. ADJUST SENSITIVITY OF SENSORS TO SUIT ROOM/CUBICLE SIZE AND CONFIGURATION TO PREVENT SENSORS FROM "SEEING" OUTSIDE THE ROOM/CUBICLE.
- WITH THE EXCEPTION OF TYPE 1 SENSORS, ALL OTHER TYPES REQUIRE POWER PACK(S) AND SLAVE PACKS TO CONTROLLED LOADS. PROVIDE ALL REQUIRED POWER PACKS AND SLAVE PACKS.
- 3. ADJUST LIGHT LEVEL SENSORS TO 65 FOOT CANDLES. ADJUST TIME DELAY TO 30 MINUTES.
- LOCATE POWER PACKS/SLAVE PACKS AND JUNCTION BOXES IN CEILING SPACE WITH
- 6. FINAL LOCATIONS OF SENSORS SHALL BE AS RECOMMENDED BY MANUFACTURERS. AVOID CLOSE PROXIMITY TO DIFFUSERS.
- 7. ALLOW IN CONTRACT LABOUR TO ADJUST SENSORS A SECOND TIME TO OWNER'S
- 8. CONTACT WATTSTOPPERS, MR. RAFAEL EVANGELISTA AT 647-220-8077 FOR PRICING.

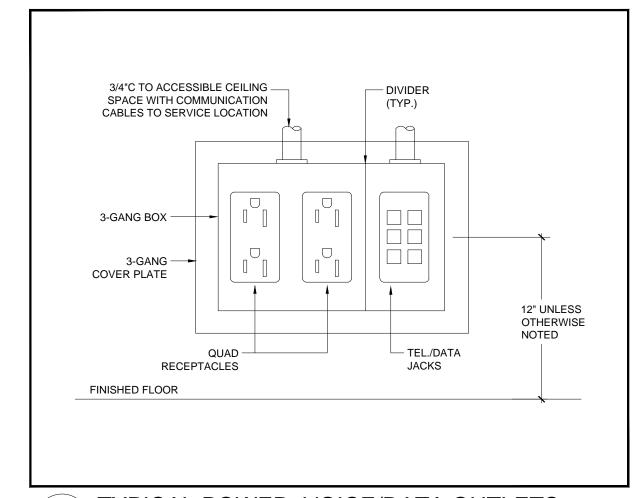


1 TYPICAL POWER, VOICE/DATA OUTLETS

E-101 / SCALE: N.T.S.

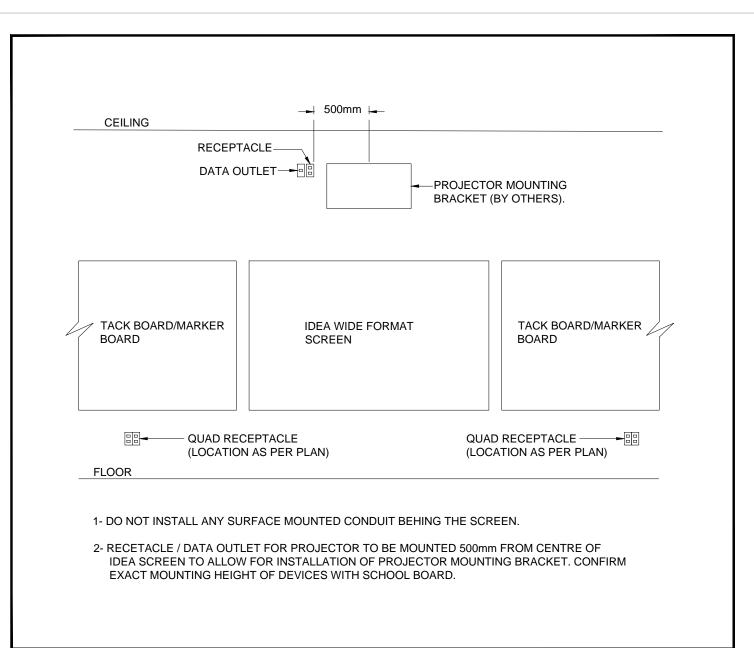


2 IWB BOARD ELEVATION

E-101 SCALE: N.T.S.

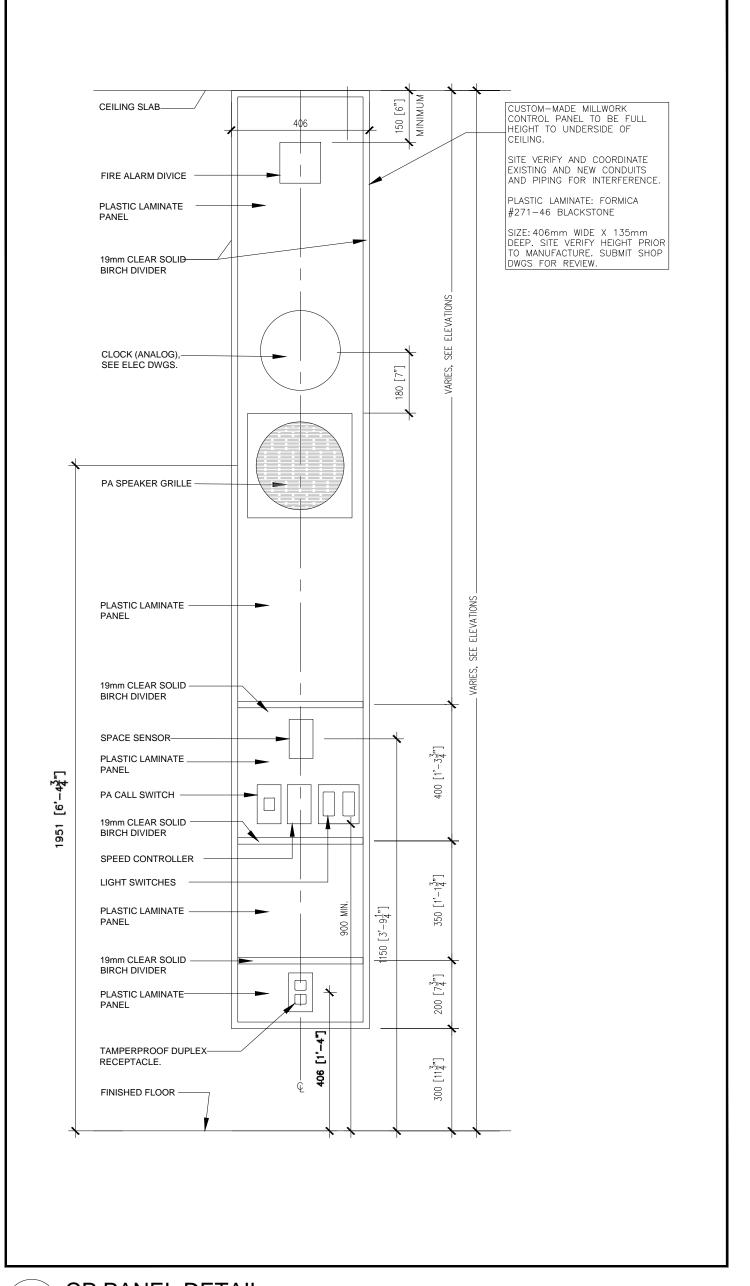

CP PANEL DETAIL

E-101/ SCALE: N.T.S.

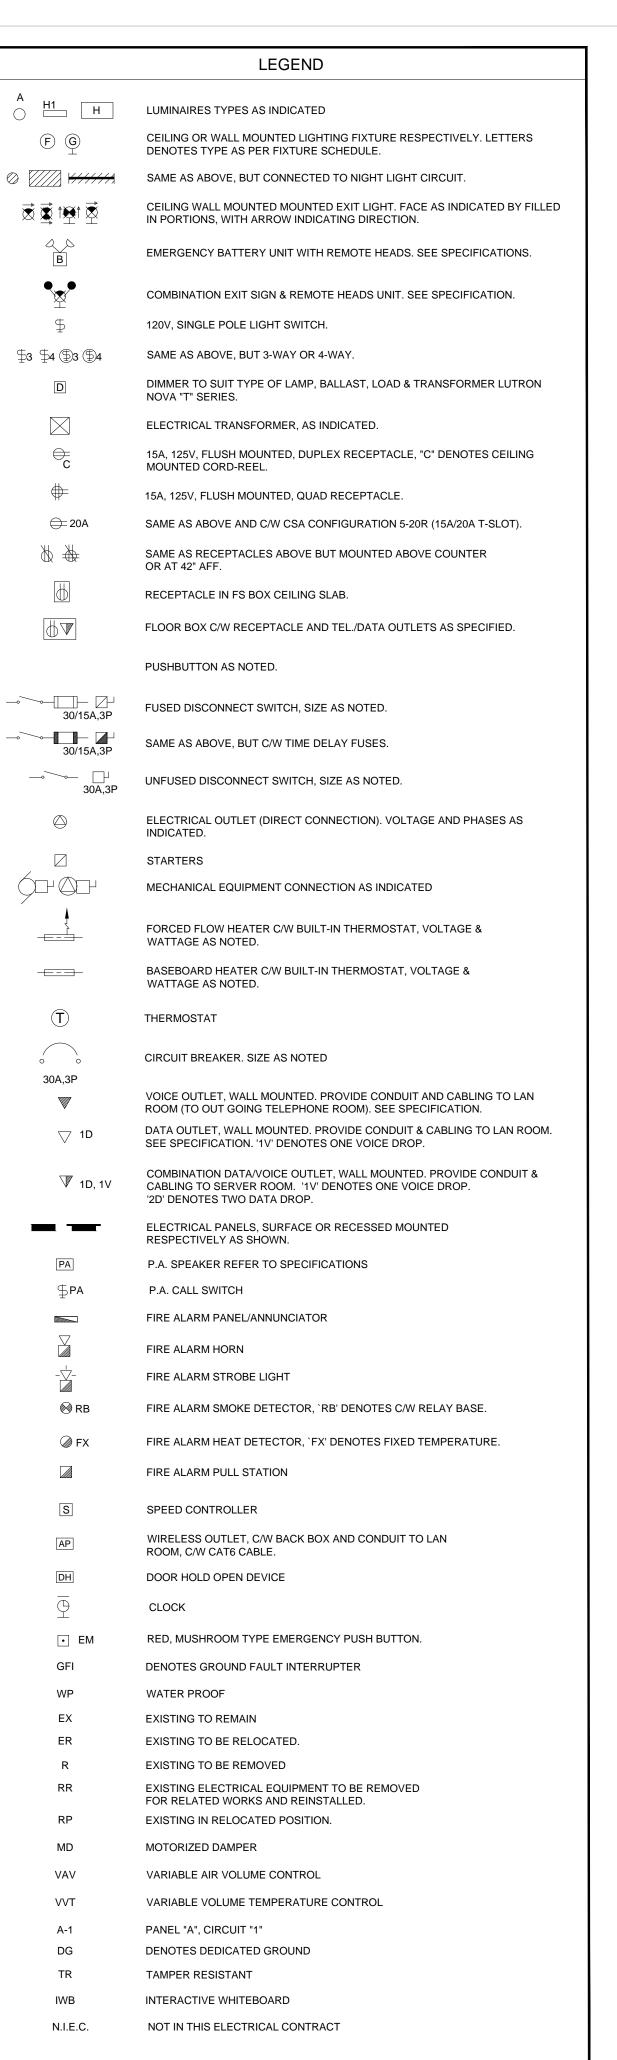

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E: dwg@hamjof.com





KAWARTHA HEIGHTS P.S. CLASSROOMS 4-5-6-7 RENOVATION


KAWARTHA PINE RIDGE DISTRICT SCHOOL BOARD

11 KAWARTHA HEIGHTS BOULEVARD PETERBOROUGH **ONTARIO** 

Drawing Title:

**ELECTRICAL - LEGEND & DRAWING LIST & NOTES** 

Drawn By: Checked By: Date Checked: Project No. 24-018-005 ΜT QV Date Plotted: Mar 11, 2024 - 12:01pm AS NOTED Revision No.:

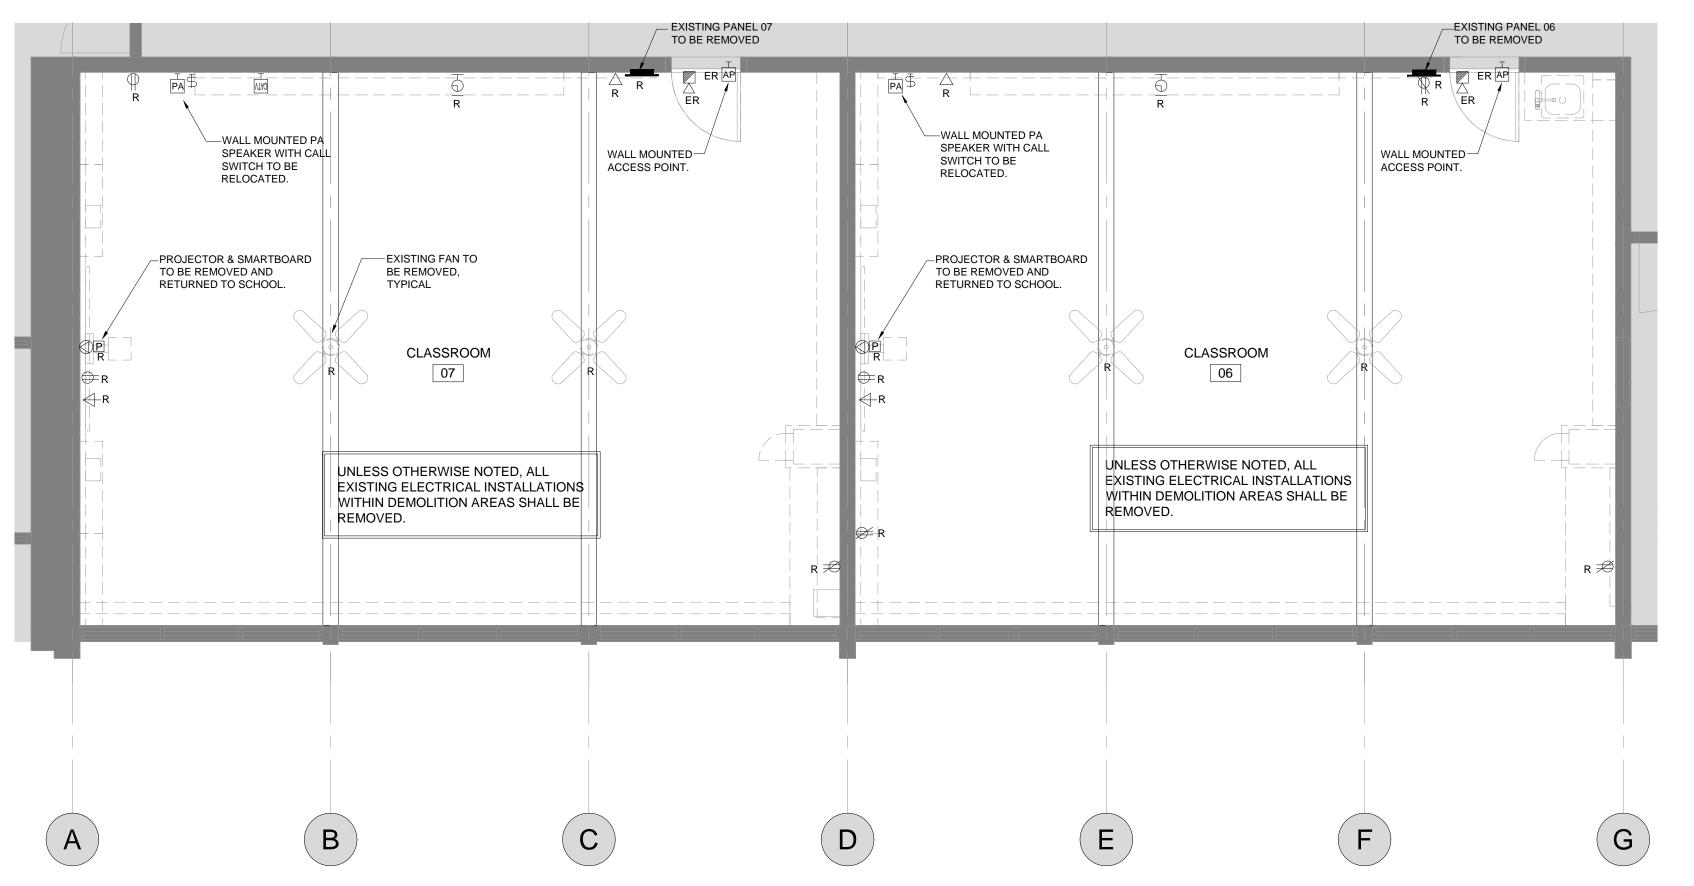

DEMOLITION NOTES (APPLY TO ALL DEMO DRAWINGS)

THIS DRAWING IS TO BE READ IN CONJUNCTION WITH ARCHITECTURAL, STRUCTURAL AND MECHANICAL DEMOLITION DRAWINGS.

EXISTING ELECTRICAL LAYOUT SHOWN IS FOR PRICING PURPOSE ONLY. CONTRACTOR TO VISIT SITE TO ASCERTAIN QUANTITY OF EXISTING FIXTURES/DEVICES/WIRING, ETC..

UNLESS OTHERWISE NOTED, REMOVE ALL EXISTING ELECTRICAL INSTALLATION SHOWN ON FLOOR

DEMOLITION OF EXISTING MATERIALS AND/OR EQUIPMENT AS SHOWN ON DRAWINGS IS BY DIV. 16.

DISCONNECT, MAKE SAFE AND REMOVE ALL EQUIPMENT DESIGNATED FOR REMOVAL. ACTIVE SERVICES TO THE EXISTING FACILITY SHALL BE PROTECTED AND MAINTAINED WITHOUT

FOR ALL EXISTING ELECTRICAL EQUIPMENT/DEVICES INDICATED TO BE REUSED, RELOCATED OR TO REMAIN. ELECTRICAL CONTRACTOR SHALL ENSURE THAT THEY ARE GOOD OPERATING CONDITION. NOTIFY ARCHITECT/CONSULTANT ALL DEFECTIVE DEVICES PRIOR TO RE-INSTALLATION. EXTEND

ALL MATERIALS AND/OR EQUIPMENT DESIGNATED FOR SALVAGE SHALL BE TURNED OVER TO THE OWNER. ALL OTHER MATERIALS AND/OR EQUIPMENT FOR REMOVAL BECOMES THE PROPERTY OF THE ELECTRICAL CONTRACTOR AND SHALL PROMPTLY BE REMOVED FROM THE SITE.

CONTACT THE OWNER PRIOR TO ANY DEMOLITION WORK. THE OWNER WILL DESIGNATE WHICH EQUIPMENT AND/OR MATERIAL TO BE SALVAGED. DEMOLITION WORK IS TO PROCEED ONLY AFTER OWNER'S APPROVAL IS OBTAINED.

FOR EXACT LOCATION AND QUANTITY OF EXISTING MECHANICAL EQUIPMENT WHICH SHALL BE REMOVED, COORDINATE WITH MECHANICAL DRAWINGS AND MECHANICAL CONTRACTOR.

PROVIDE TEMPORARY LIGHTING IN AREA AFTER DEMOLITION. PROVIDE 5 FC MINIMUM. MAINTAIN ILLUMINATED EXIT SIGNS AT EXIT DOORS. PROVIDE TEMPORARY SUPPORTS FOR TEMPORARY

UNLESS OTHERWISE NOTED ALL EXISTING LOOSE BX CABLES WITHIN CEILING SPACE SHALL BE CLEANED UP REWIRE THEM IN CONDUITS AND PAINTED TO MATCH EXPOSED CEILING FINISH EXISTING LIGHT SWITCH TO BE REPLACED WITH NEW ONE AND INSTALL IN CONTROL PANEL.

 $\langle 13 \rangle$  EXISTING PA CALL SWITCH TO BE RELOCATED TO CONTROL PANEL.


SEE NEW LAYOUT.

CONDUIT/WIRING FOR RELOCATED EQUIPMENT/DEVICES.

(14) EXISTING FIRE ALARM HORN TO BE RELOCATED TO CONTROL PANEL.


CLASSROOM 06/07 FLOOR PLAN - POWER DEMOLITION

E-200 SCALE: 1:50

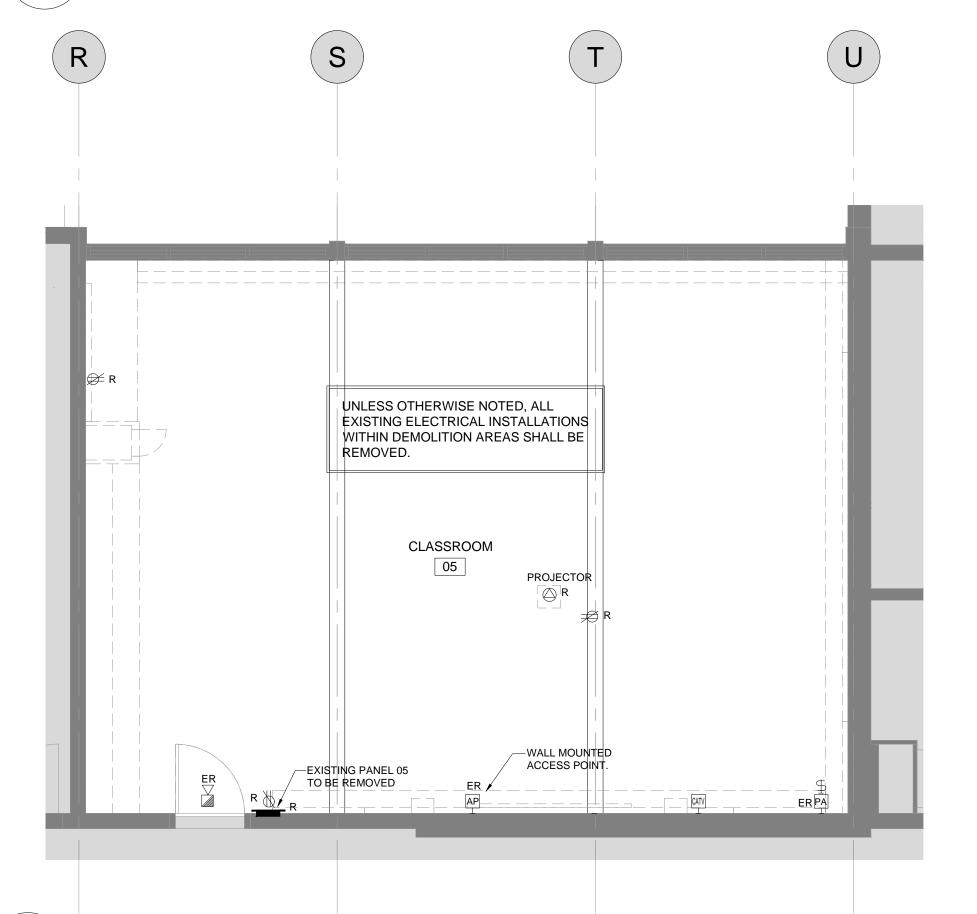

CLASSROOM 05 FLOOR PLAN - POWER DEMOLITION

E-200 SCALE: 1:50

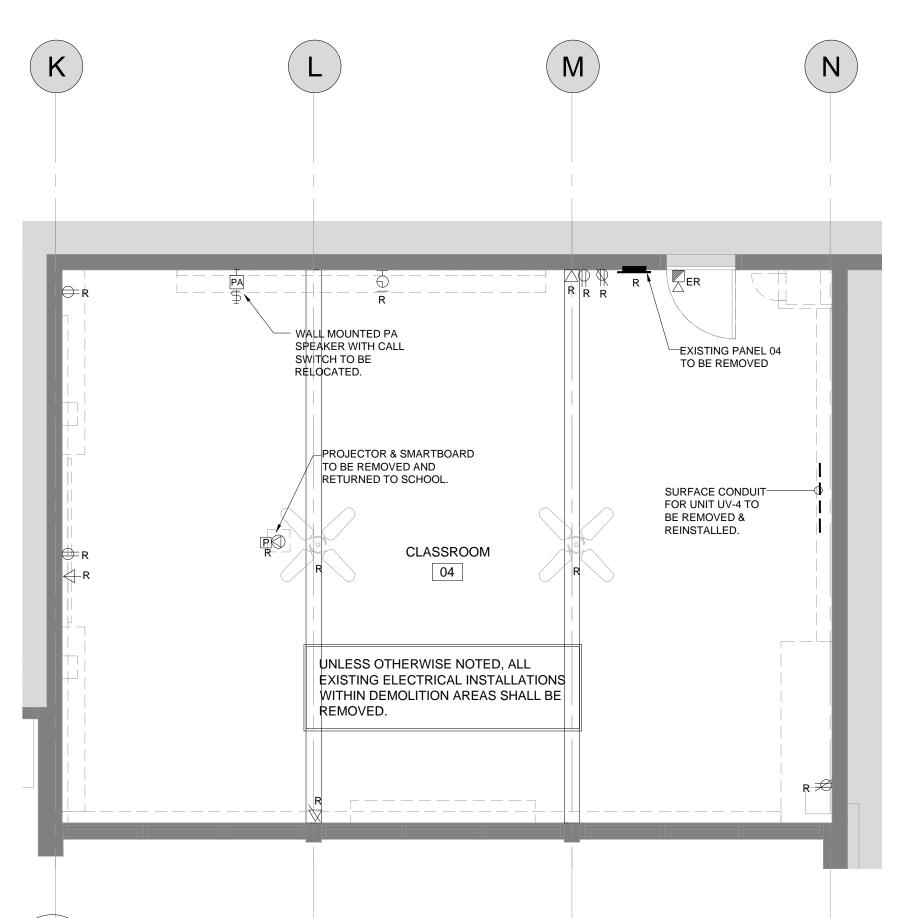

CLASSROOM 04 FLOOR PLAN - POWER DEMOLITION

E-200 SCALE: 1:50

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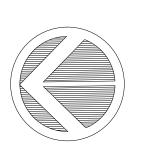
DO NOT SCALE DRAWINGS.

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KAWARTHA HEIGHTS P.S. CLASSROOMS 4-5-6-7 RENOVATION

KAWARTHA PINE RIDGE DISTRICT SCHOOL BOARD


11 KAWARTHA HEIGHTS BOULEVARD PETERBOROUGH

Drawing Title:

**ELECTRICAL - GROUND FLOOR CLASSROOM - DEMOLITION POWER** 

Drawn By: Checked By: Date Checked: 24-018-005 QV AS NOTED Mar 11, 2024 - 12:01pm

E-200

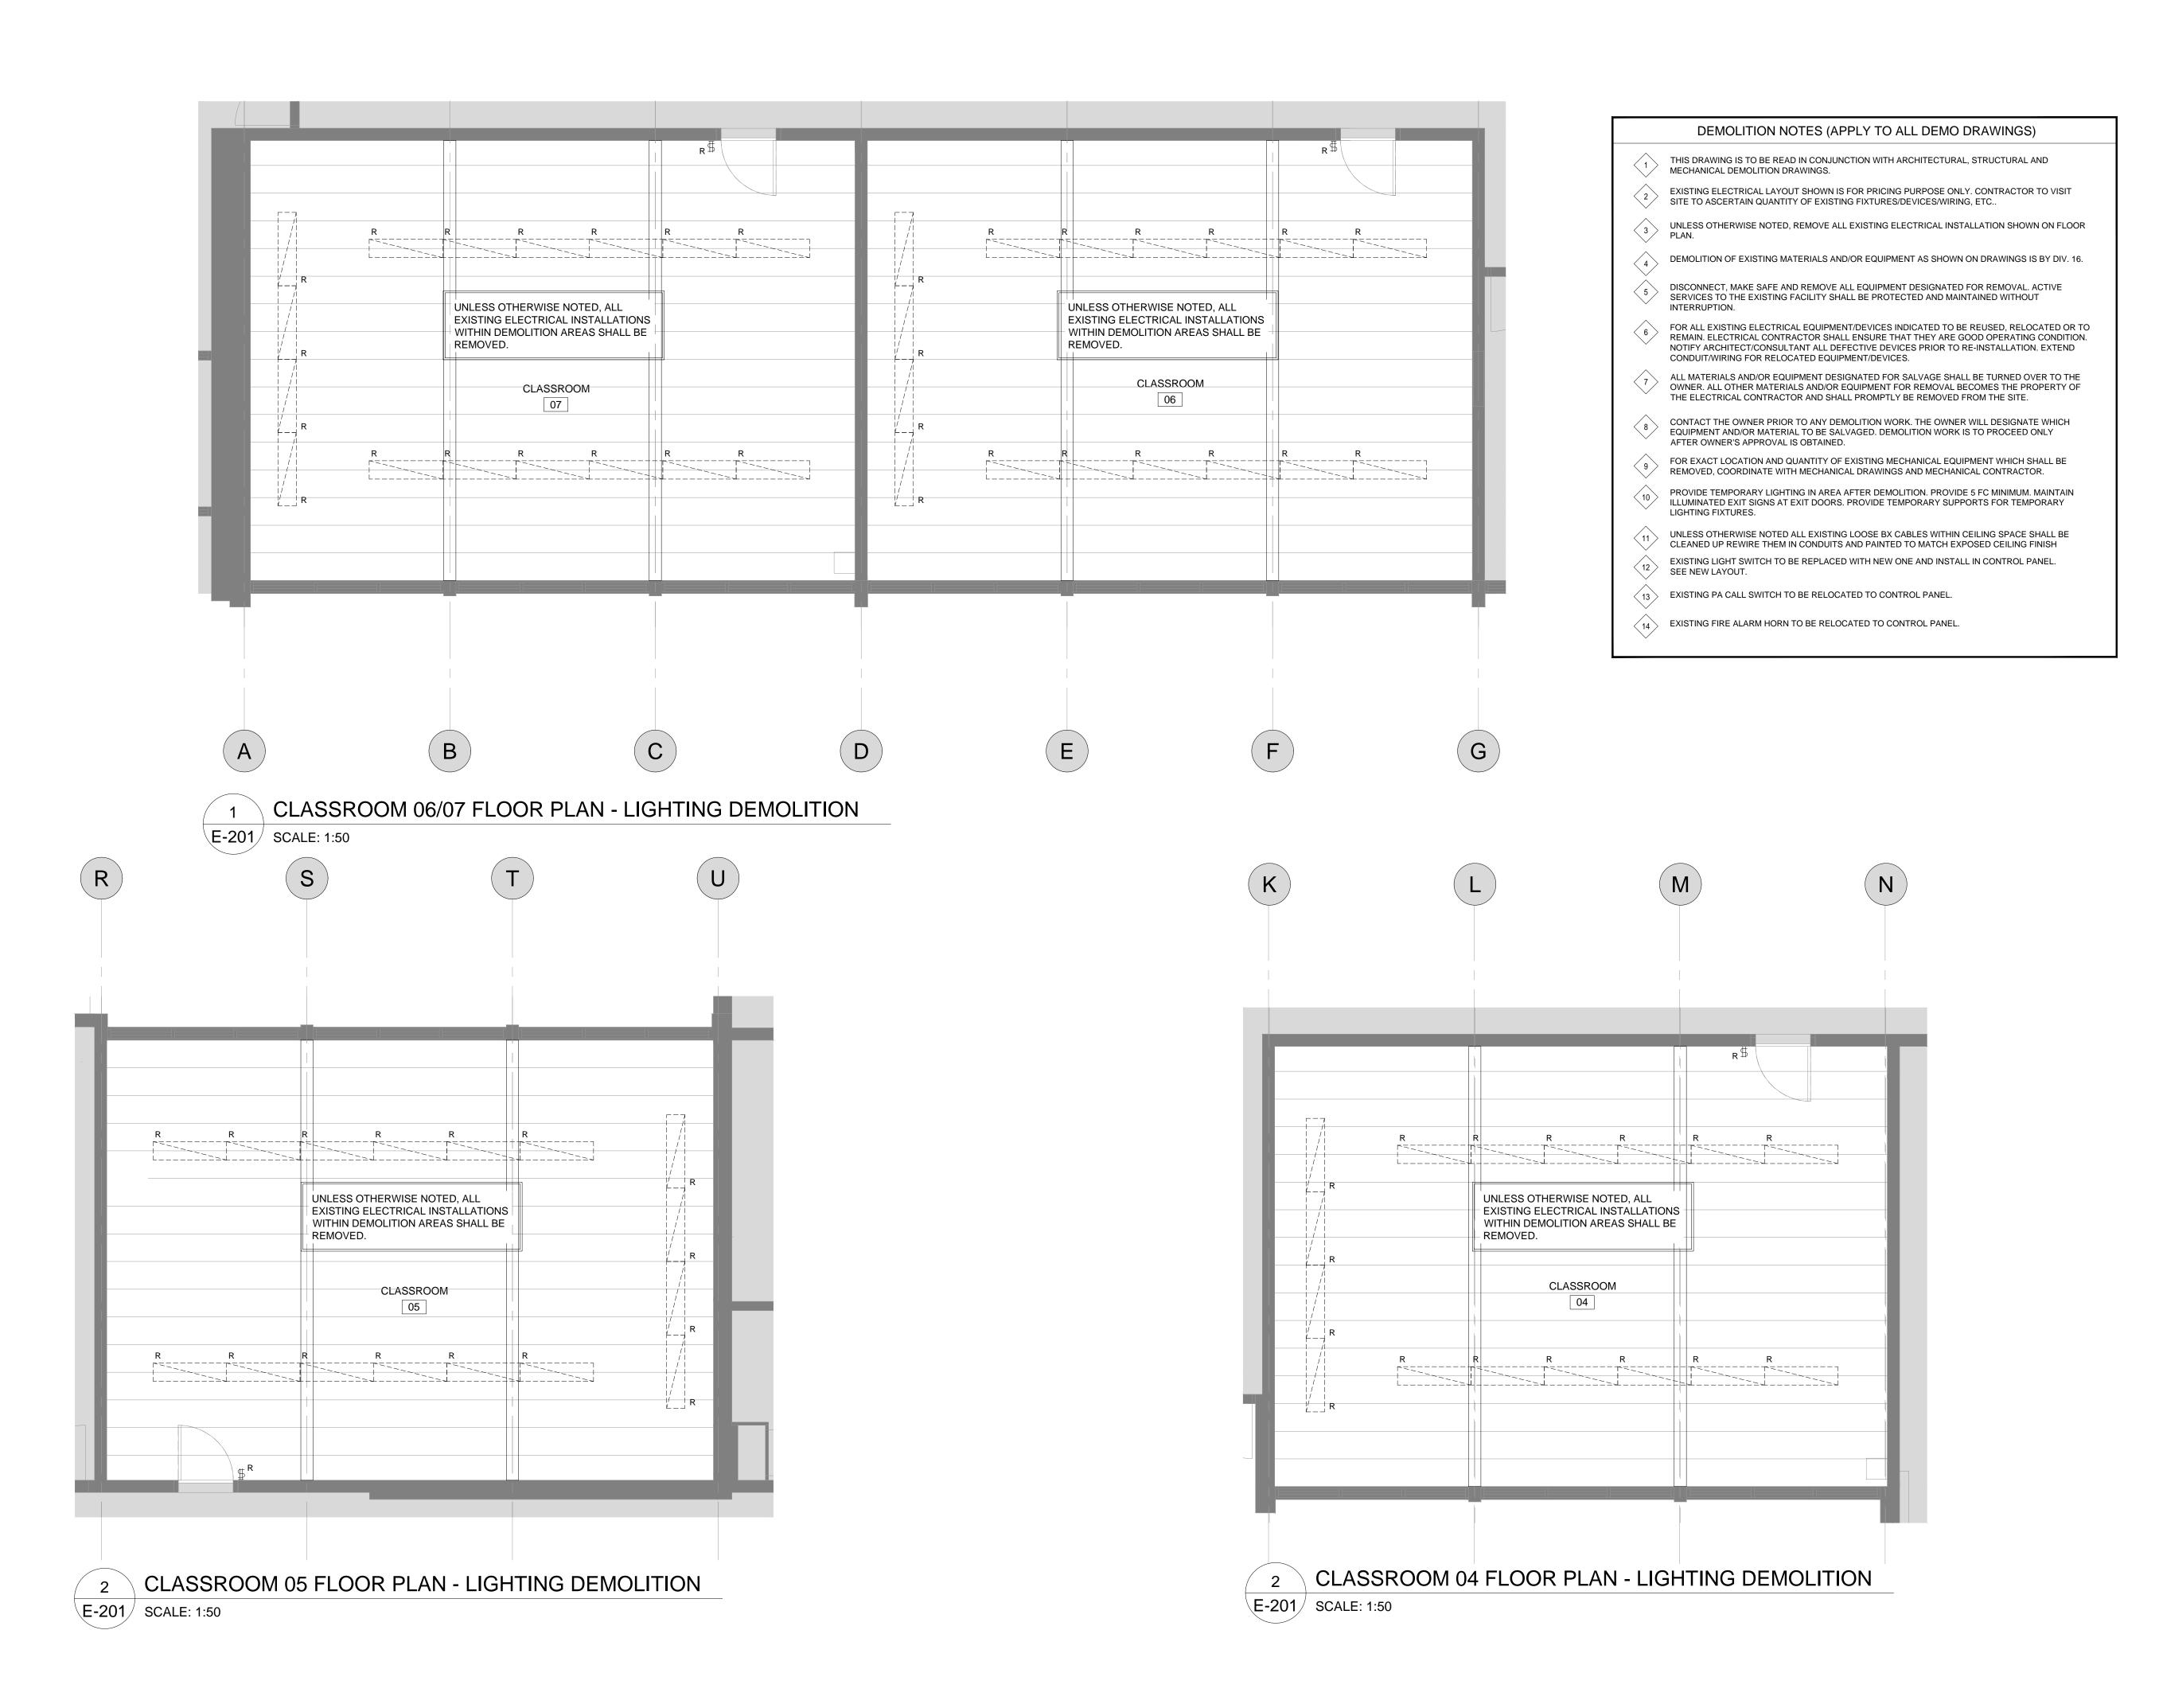

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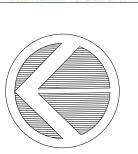
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KAWARTHA HEIGHTS P.S. CLASSROOMS 4-5-6-7 RENOVATION


KAWARTHA PINE RIDGE DISTRICT SCHOOL BOARD

11 KAWARTHA HEIGHTS BOULEVARD PETERBOROUGH


Drawing Title: ELECTRICAL - GROUND FLOOR **CLASSROOM - DEMOLITION** LIGHTING

•			
Drawn By:	Checked By:	Date Checked:	Project No.
MT	QV		24-018-005
Date Plotted:			Scale:
Mar 11, 2	AS NOTED		

E-201

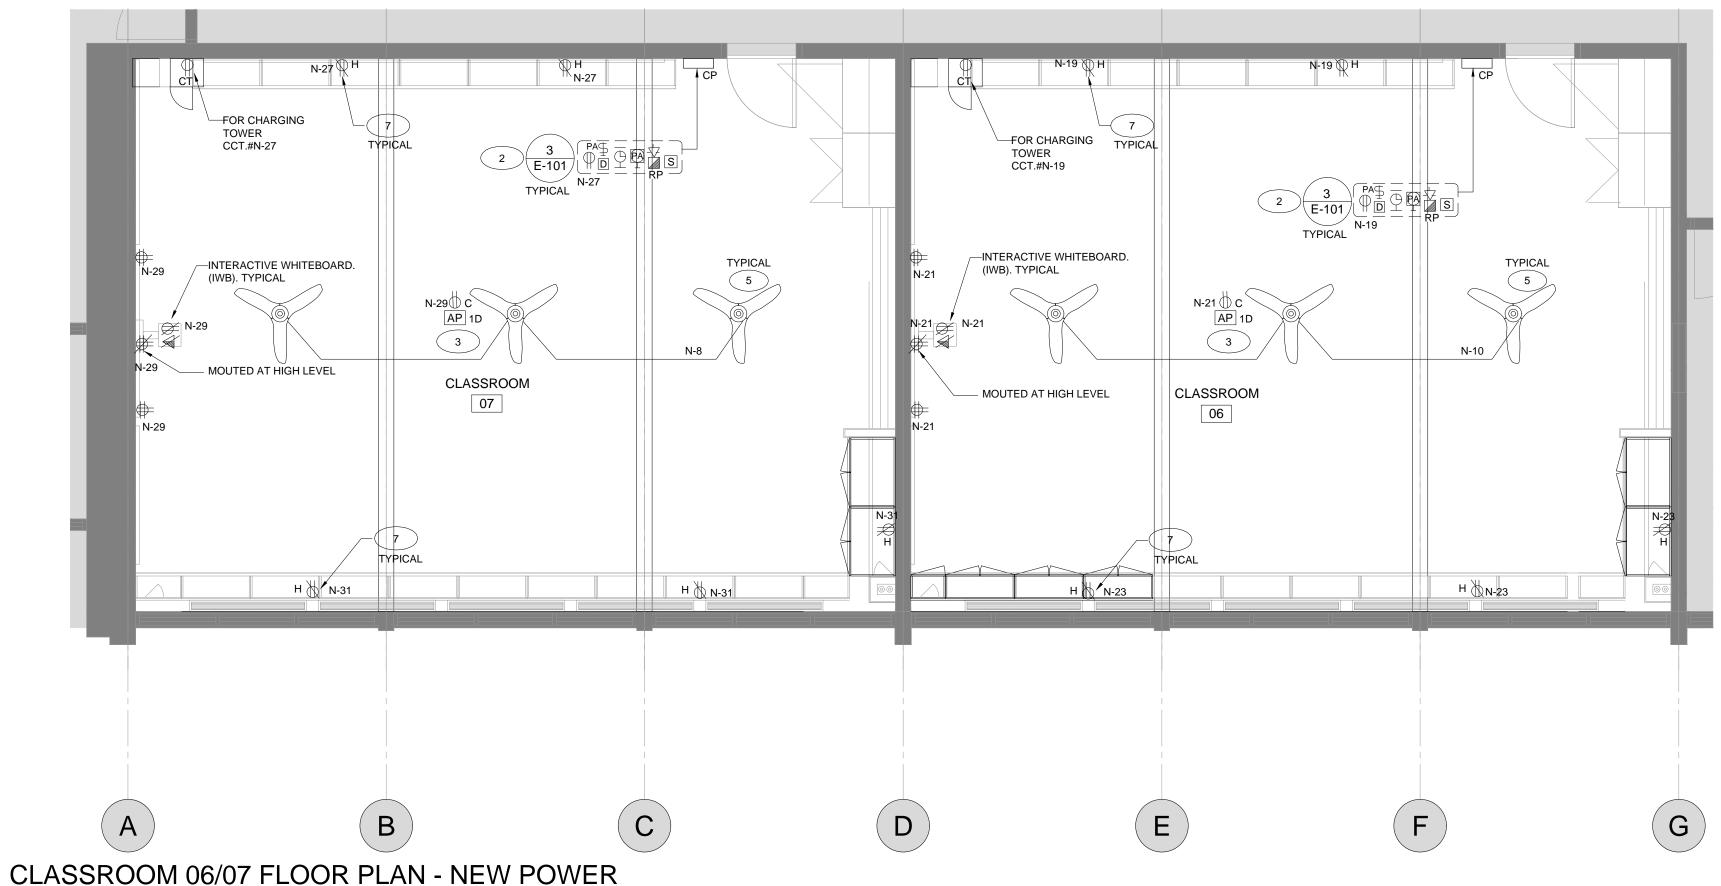


E-300 SCALE: 1:50

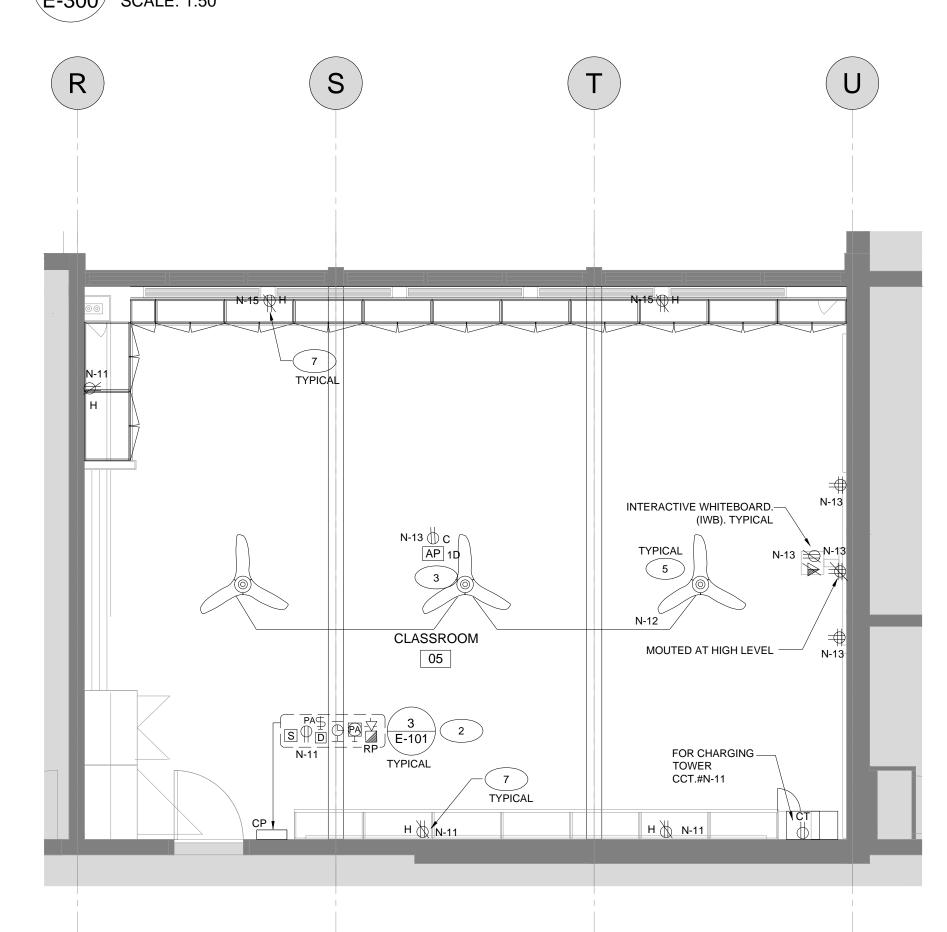

CLASSROOM 05 FLOOR PLAN - NEW POWER

E-300 SCALE: 1:50

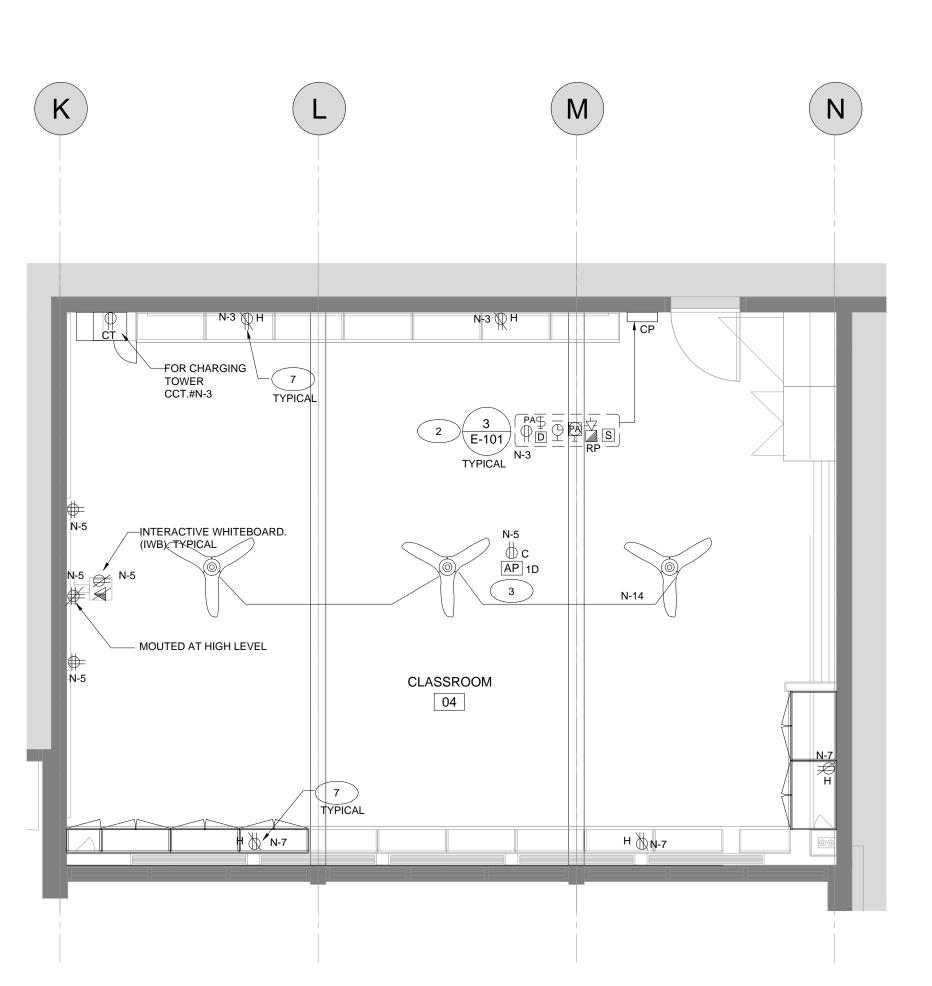

CLASSROOM 04 FLOOR PLAN - NEW POWER

E-300 SCALE: 1:50

- PROVIDE WALL MOUNTED DIMMERS TO BE COMPATIBLE TO LIGHTING FIXTURES AND OCCUPANCY SENSORS. DIMMER SHALL BE 0-10V DIMMER, GREENGATE CAT.#WBS207-010M-C1. SWITCH PACK - SP20MV. CEILING SENSOR - DUAL TECH-0AC-DT-2000. CONTACT ANDREI IANOS AT 289-589-0435. ALL DIMMERS SHALL BE MOUNTED IN CONTROL PANEL. REFER TO ARCHITECTURAL DRAWINGS FOR MORE DETAILS
- REFER TO LIGHTING LAYOUT FOR NUMBER OF DIMMER SWITCHES. RECEPTACLE, PA CALL SWITCH, PA SPEAKER, FIRE ALARM HORN... ETC AND NEW CLOCK ARE IN THE CONTROL PANEL AS SHOWN. PROVIDE PA CALL SWITCH, PA SWITCH, PA SPEAKER, CLOCK.... ETC. REFER TO CONTROL LAYOUT FOR MORE DETAILS.
- PROVIDE WIRELESS ACCESS POINT WITH DATA OUTLET AND WIRE BACK TO DATA HUB. SEE NOTES REGARD
- 4 UNLESS OTHERWISE NOTED, ALL ELECTRICAL WALL MOUNTED DEVICES SHALL BE SURFACE MOUNTED ON EXISTING BLOCK WALL, PROVIDE SURFACE BOXES AND RACEWAY . WIREMOLE CAT# AL2000 RACEWAY WITH COMPATIBLE BOXES, PAINT-ABLE TO MATCH EXISTING WALL FINISH.
- 5 CEILING FAN SUPPLIED BY MECHANICAL, INSTALLED AND WIRED BY ELECTRICAL. PROVIDE SPEED CONTROLLER AND MOUNT CONTROLLER IN CONTROL PANEL.
- CIRCUITS NUMBER SHOWN ON DRAWINGS ARE FOR REFERENCE / CIRCUITING ONLY. THIS ELECTRICAL CONTRACTOR SHALL VERIFY EXISTING PANEL ON SITE TOR REUSE EXISTING CIRCUIT, SPARE BREAKERS OR PROVIDE NEW ONES AS REQUIRED.
- 7 PROVIDE HORIZONTAL MOUNTING RECEPATCLE AT ABOVE THE CABINET AND UNDER TACK BOARD.

#### RETROFIT PROGRAM

hoto Best Practices

The following best practices will help to ensure that all photos meet technical requirements and will reduce the risk that further photos are requested by the technical reviewer, which may delay approval of your application.

Please note that photos are required if your application meets the criteria as outlined in the QA/QC guideline. Note that some applications may be selected at random for QA/QC. In this instance, technical reviewers will request further documentation to support your application which will include photos. Therefore, it is advisable as a best practice to always take photos prior to starting your project.

#### **Best Practices:**

- Take extra photos to fully document the scope of work and make sure that you will not have to return to the facility site if more photos are required
- No people should be visible in the pictures
- Pictures that are supposed to capture numbers or words need to be in focus and legible (i.e., model numbers, performance specs)
- Double check the legibility of photos on your camera (by zooming in on the pictures) before leaving the site
- Be careful of shadows and bright reflections in the pictures. Try using different camera angles or enabling/disabling flash to fix these types of issues
- The exposure lock function of some phones/cameras can sometimes help to get a good exposure for the picture. Check your device's camera instructions for how to use this common



## RETROFIT PROGRAM

hoto Requirements

Type of photos required for each type of equipment\*\* being replaced and installed

lype of photos required	tor	е
Photos Required	De	eta
Close-up	•	N E F
	•	_
Long-shot	•	A A
Nameplate***	•	N N F
	•	Δ

- Must contain the entire piece of equipment, including where the equipment meets the ground or wall
- For lighting, the number of lamps per fixture must be identifiable and photos for each type of fixture are required
- A time-stamp for the photo indicating the date it was taken\*
- application
- Must show spread of equipment in facility to verify quantity in A time-stamp for the photo indicating the date it was taken\*
- Must include the model number
  - Must include the equipment specifications (i.e., wattage, horsepower)
  - For lighting, a nameplate photo is required for each type of lamp if the wattage for the lamps are different between fixtures
  - A time-stamp for the photo indicating the date it was taken\*

\*If a time-stamp cannot be provided, the photos can be supplemented with confirmation by the participant identifying the date the photos were taken

\*\*Only one set of photos is required for each type of equipment being replaced. For example, if there are 100 of the same lamps existing in a facility, then only one set of close-ups, long-shot and nameplate pictures would be required. There is no need to provide photos of every single lamp

\*\*\*If the equipment is difficult or expensive to access, you may defer providing nameplate pictures. Ensure you collect the nameplate photographs during the decommissioning of the existing equipment and submit them during the Post-Project





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AS NOTED

KAWARTHA HEIGHTS P.S.

CLASSROOMS 4-5-6-7 RENOVATION KAWARTHA PINE RIDGE DISTRICT SCHOOL BOARD


11 KAWARTHA HEIGHTS BOULEVARD PETERBOROUGH ONTARIO

Drawing Title: ELECTRICAL - GROUND FLOOR NEW CLASSROOM POWER LAYOUT

Drawn By: Checked By: Date Checked: 24-018-005 MT QV Date Plotted:


E-300

Mar 11, 2024 - 12:01pm

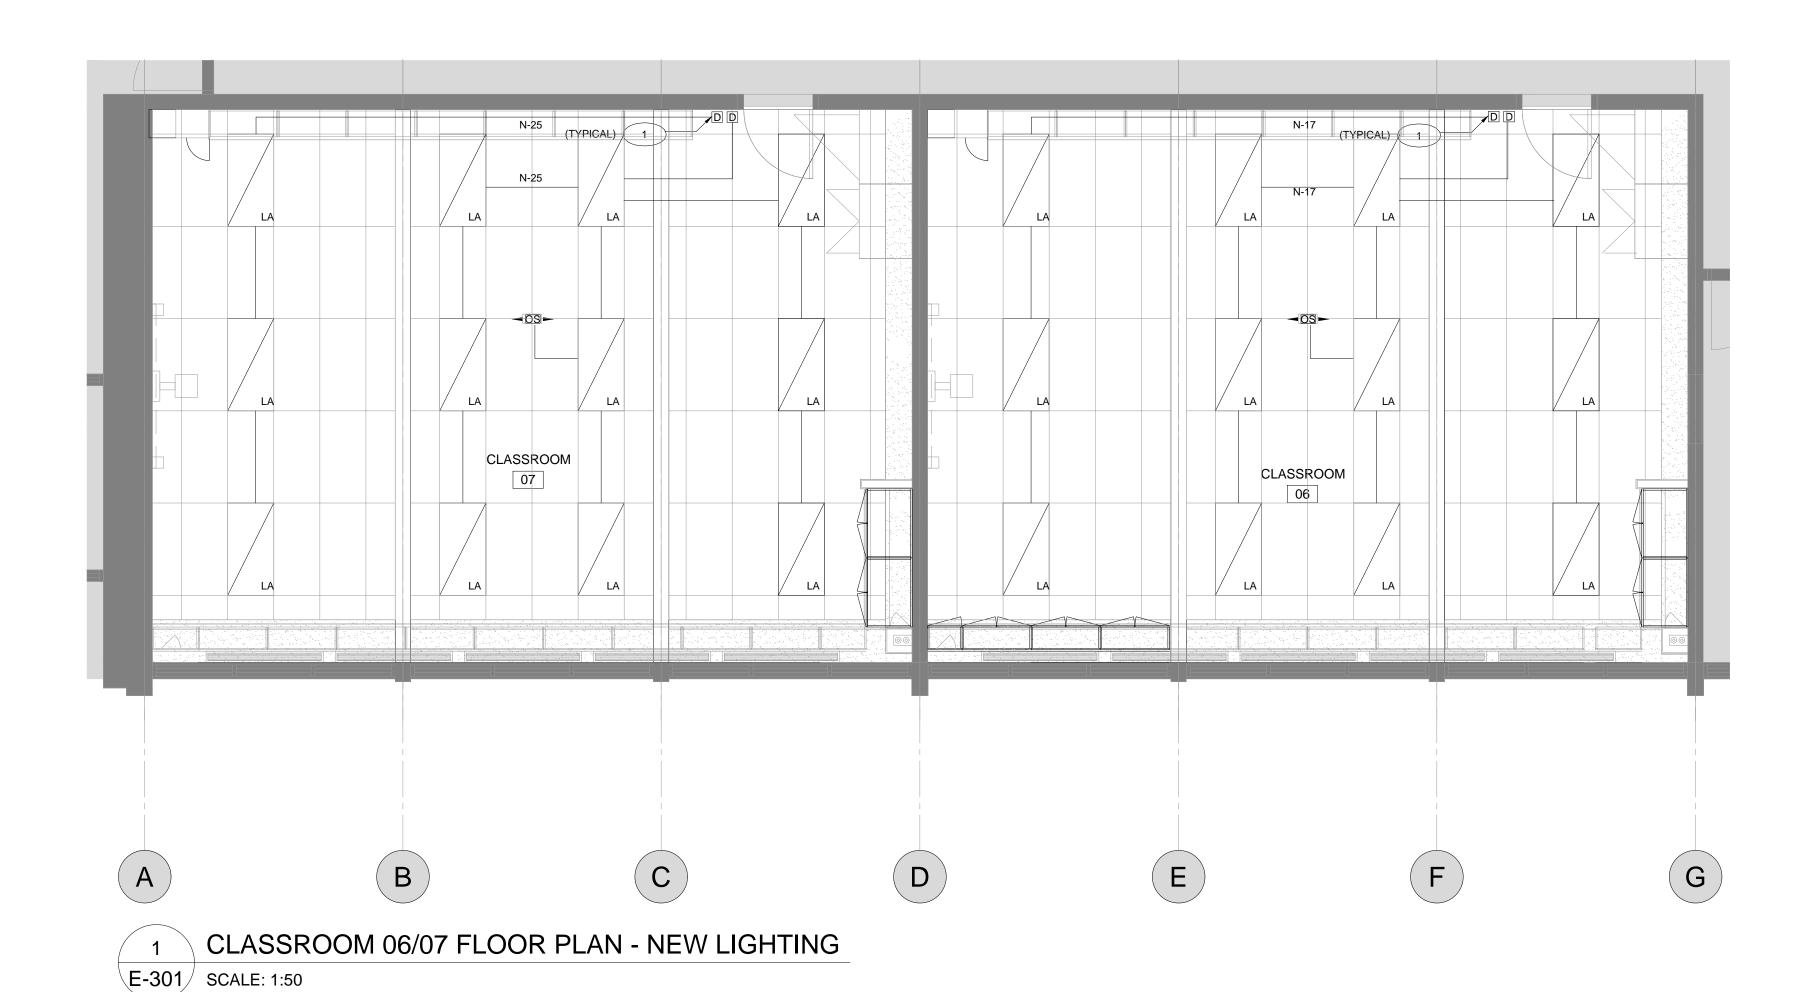

CLASSROOM


CLASSROOM 05 FLOOR PLAN - NEW LIGHTING E-301 SCALE: 1:50

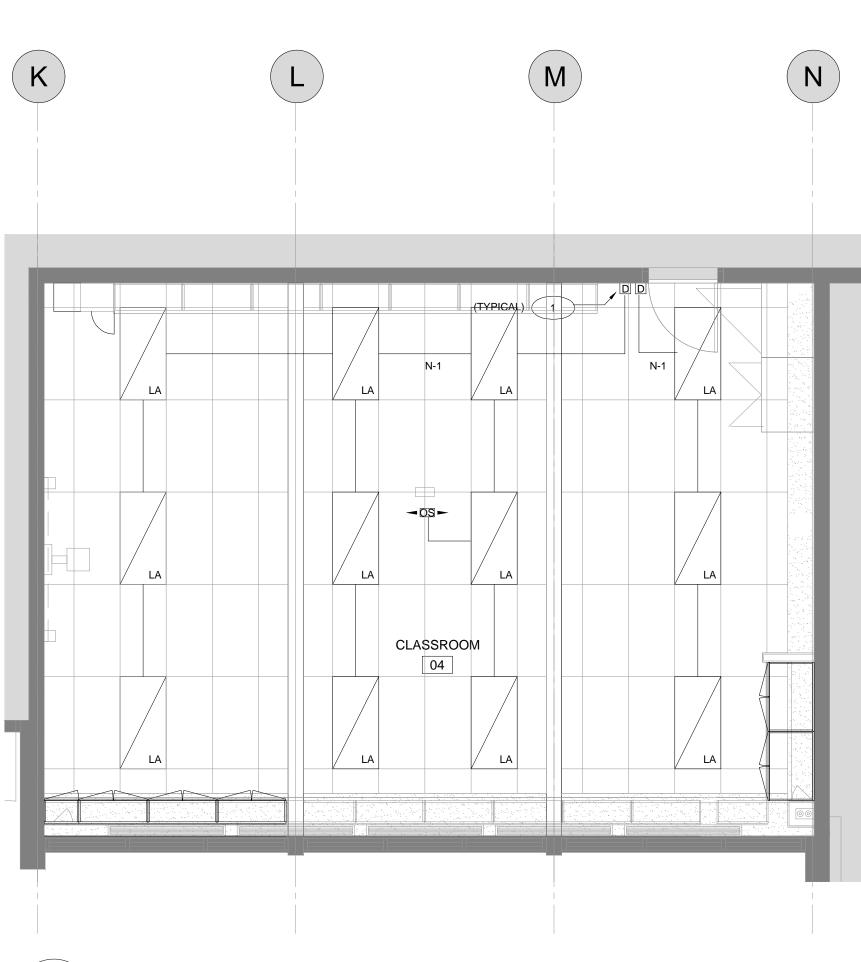

CLASSROOM 04 FLOOR PLAN - NEW LIGHTING E-301 SCALE: 1:50

- PROVIDE WALL MOUNTED DIMMERS TO BE COMPATIBLE TO LIGHTING FIXTURES AND OCCUPANCY SENSORS. DIMMER SHALL BE 0-10V DIMMER, GREENGATE CAT.#WBS207-010M-C1. SWITCH PACK - SP20MV. CEILING SENSOR - DUAL TECH-0AC-DT-2000. CONTACT ANDREI IANOS AT 289-589-0435. ALL DIMMERS SHALL BE MOUNTED IN CONTROL PANEL. REFER TO ARCHITECTURAL DRAWINGS FOR MORE DETAILS
- REFER TO LIGHTING LAYOUT FOR NUMBER OF DIMMER SWITCHES. RECEPTACLE, PA CALL SWITCH, PA SPEAKER, FIRE ALARM HORN... ETC AND NEW CLOCK ARE IN THE CONTROL PANEL AS SHOWN. PROVIDE PA CALL SWITCH, PA SWITCH, PA SPEAKER, CLOCK.... ETC. REFER TO CONTROL LAYOUT FOR MORE DETAILS.
- PROVIDE WIRELESS ACCESS POINT WITH DATA OUTLET AND WIRE BACK TO DATA HUB. SEE NOTES REGARD TO WIRELESS POINT DEVICES TO WIRELESS POINT DEVICES.
- UNLESS OTHERWISE NOTED, ALL ELECTRICAL WALL MOUNTED DEVICES SHALL BE SURFACE MOUNTED ON EXISTING BLOCK WALL INDICATE SURFACE BOYES AND BASELY OF THE SURFACE MOUNTED ON EXISTING BLOCK WALL, PROVIDE SURFACE BOXES AND RACEWAY. WIREMOLE CAT# AL2000 RACEWAY WITH COMPATIBLE BOXES, PAINT-ABLE TO MATCH EXISTING WALL FINISH.
- CEILING FAN SUPPLIED BY MECHANICAL, INSTALLED AND WIRED BY ELECTRICAL. PROVIDE SPEED CONTROLLER AND MOUNT CONTROLLER IN CONTROL PANEL.
- CIRCUITS NUMBER SHOWN ON DRAWINGS ARE FOR REFERENCE / CIRCUITING ONLY. THIS ELECTRICAL CONTRACTOR SHALL VERIFY EXISTING PANEL ON SITE TOR REUSE EXISTING CIRCUIT, SPARE BREAKERS OR PROVIDE NEW ONES AS REQUIRED.
- PROVIDE HORIZONTAL MOUNTING RECEPATCLE AT ABOVE THE CABINET AND UNDER TACK BOARD. (LOCATE ON COLUMNS. TYPICAL)

DESCRIPTION	LOAD	BRKR	CCT No	PH	CCT No	BRKR	LOAD	DESCRIPTION
LIGHTING - CLASSROOM 04		15	1	Α	2	15		EXISTING CIRCUIT TO BE TRANSFEREI
RECEPTACLES - CLASSROOM 04		15	3	В	4	15		EXISTING CIRCUIT TO BE TRANSFEREI
RECEPTACLES - CLASSROOM 04		15	5	С	6	15		EXISTING CIRCUIT TO BE TRANSFEREI
RECEPTACLES - CLASSROOM 04		15	7	Α	8	15		CEILING FANS - CLASSROOM 07
LIGHTING - CLASSROOM 05		15	9	В	10	15		CEILING FANS - CLASSROOM 06
RECEPTACLES - CLASSROOM 05		15	11	С	12	15		CEILING FANS - CLASSROOM 05
RECEPTACLES - CLASSROOM 05		15	13	Α	14	15		CEILING FANS - CLASSROOM 04
RECEPTACLES - CLASSROOM 05		15	15	В	16			SPACE
LIGHTING - CLASSROOM 06			17	С	18			
RECEPTACLES - CLASSROOM 06			19	Α	20			
RECEPTACLES - CLASSROOM 06			21	В	22			
RECEPTACLES - CLASSROOM 06			23	С	24			
LIGHTING - CLASSROOM 07			25	Α	26			
RECEPTACLES - CLASSROOM 07			27	В	28			
RECEPTACLES - CLASSROOM 07			29	С	30			
RECEPTACLES - CLASSROOM 07			31	Α	32			
SPARE			33	В	34			
			35	С	36			
			37	Α	38			
			39	В	40			
•		•	41	С	42			<b>†</b>
PANEL: PANEL RP-N		NOTES	S:					
VOLTS: 120/208V	TYP	'E: E	BOLT-C	ON				FLUSH
PHASE: 3Ø CC		CONN.LOAD(KW):						SURFACE   SURFACE
WIRE: 4W DE			)AD(Al	MPS):		SPRINKLERPROOF ⊠ FEED THRU' LUGS □		
		OCATION: SEE FLOOR PLAN ED FROM:						MAIN BRKR

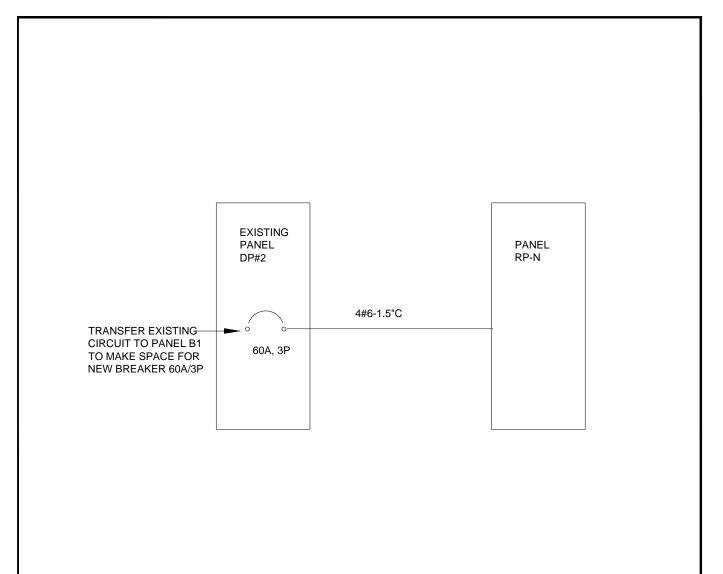



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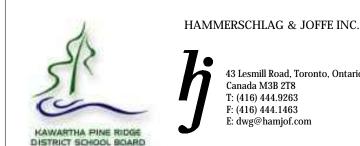
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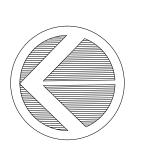
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KAWARTHA HEIGHTS P.S.

CLASSROOMS 4-5-6-7 RENOVATION KAWARTHA PINE RIDGE DISTRICT SCHOOL BOARD

11 KAWARTHA HEIGHTS BOULEVARD ONTARIO

PETERBOROUGH

**ELECTRICAL - GROUND FLOOR NEW** CLASSROOM LIGHTING LAYOUT

Drawn By: Checked By: Date Checked: 24-018-005 QV Mar 11, 2024 - 12:01pm AS NOTED

E-301