DR M.S. HAWKINS SR.PS **CLASSROOMS 233-235-244-245-246-247 RENOVATION**

KAWARTHA PINE RIDGE DISTRICT SCHOOL BOARD

130 HIGHLAND DRIVE PORT HOPE, ONTARIO

DRAWING LIST

ARCHITECTURAL


<u>No.</u>	Drawing Name	<u>No.</u>
A000	DRAWING LIST AND OBC MATRIX	M0-0
A100	OVERALL FLOOR PLANS	M0-0
A200	PARTIAL FLOOR PLAN	M1-1
D201	CLASSROOM 244 TO 247 DEMOLITION FLOOR PLAN	M1-1
D202	CLASSROOMS 233 AND 235 DEMOLITION FLOOR PLAN	M1-2
D203	CLASSROOMS 244 TO 247 DEMOLITION REFLECTED CEILING PLAN	M1-2
D204	CLASSROOMS 233 AND 235 DEMOLITION REFLECTED CEILING PLAN	
D300	DEMOLITION INTERIOR ELEVATIONS	
D301	DEMOLITION INTERIOR ELEVATIONS	
A201	CLASSROOM 244 TO 247 PROPOSED	

- FLOOR PLAN CLASSROOM 233 AND 235 PROPOSED A202 FLOOR PLAN CLASSROOMS 244 TO 247 PROPOSED
- A203 REFLECTED CEILING PLAN CLASSROOMS 233 AND 235 PROPOSED A204 REFLECTED CEILING PLAN
- A300 PROPOSED INTERIOR ELEVATIONS
- A301 PROPOSED INTERIOR ELEVATIONS
- A500 MILLWORK DETAILS
- A501 MILLWORK AND FLOOR FINISH PATTERN DETAILS A800 CONSTRUCTION ASSEMBLIES AND DETAILS
- A801 DETAILS AND SCHEDULES

MECHANICAL

<u>No.</u>	Drawing Name	<u>No.</u>	Drawing Name
M0-001	LEGEND, DRAWING LIST, DETAILS AND SCHEDULES	E-100	ELECTRICAL - KEY PLAN, LEGEND, DRAWING LIST & NOTES
M0-002	PLUMBING CUTSHEETS	E-101	ELECTRICAL - LEGEND & DRAWING LIST & NOTES
M1-101	CLASSROOMS 244 TO 247 MECHANICAL DEMOLITION	E-200	ELECTRICAL - SECOND FLOOR CLASSROOM - DEMOLITION POWER
M1-102	CLASSROOMS 233 AND 235 MECHANICAL DEMOLITION	E-201	ELECTRICAL - SECOND FLOOR CLASSROOM - DEMOLITION LIGHTING
M1-201	CLASSROOMS 244 TO 247 MECHANICAL NEW	E-202	ELECTRICAL - SECOND FLOOR - DEMOLITION LIGHTING
M1-202	CLASSROOMS 233 AND 235 MECHANICAL NEW	E-300	ELECTRICAL - SECOND FLOOR CLASSROOM NEW POWER LAYOUT
		E-301	ELECTRICAL - SECOND FLOOR CLASSROOM NEW LIGHTING LAYOUT
		E-302	ELECTRICAL - SECOND FLOOR - NEW LIGHTING & POWER LAYOUT

ELECTRICAL

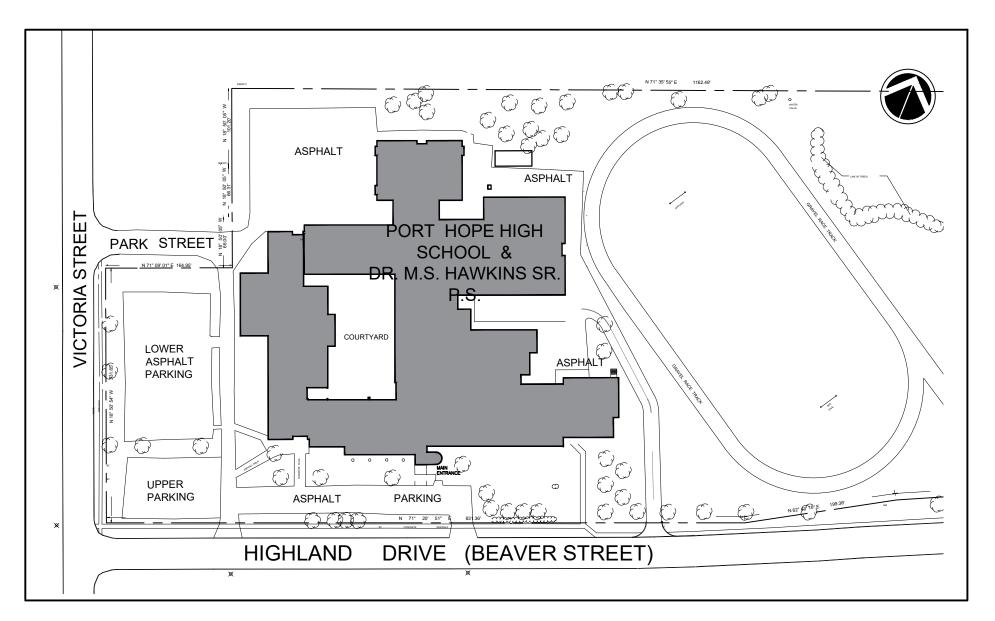




			ALL	DIMENSIONS ARE		ess otherwise indicati
			No.	REVIS	SIONS AND DISTRIBUTION	
			No.	MAR. 12, 2024	ISSUED FOR TENDER	e
me of Practice: AV Group architects						
it 101, 20 Camden Stre ronto, ON M5V 1V1	et					
ame of Project: R M.S. Hawkins SR.PS						
ocation: 0 HIGHLAND DRIVE DRT HOPE.ON						
ate: November 30, 20	23 Ontario Building Code Data Matrix Part 11 – Renovation of Existing Building	Building Code				
00 Ruilding Code		Reference 1				
I.00 Building Code Version:	<u>O. Reg. 332/12</u> Last Amendment <u>O. Reg. 89/23</u>	n and a state of the state of t				
.01 Project Type:	□ Addition	[A] 1.1.2.				
1.02 Major Occupancy	Description:	3.1.2.1.(1)				
Classification:	Group A, Division 2 Public School					
.03 Superimposed		3.2.2.7.				
Major Occupancie	Description:					
.04 Building Area (m ²)	Description: Existing New Total	[A] 1.4.1.2.				
	<u>Ground Floor</u> <u>10,400</u> <u>0</u> <u>10,400</u>					
	<u>Second Floor</u> <u>5,970</u> <u>0</u> <u>5,970</u>					
Insert additional lines as needed						
.05 Building Height	Storeys above grade (m) Above grade	[A] 1.4.1.2. & 3.2.1.1.				
	0 Storeys below grade					
.06 Number of Streets Firefighter access		3.2.2.10. & 3.2.5.				
.07 Building Size	□ Small □ Medium ⊠ Large □ > Large	T.11.2.1.1.B N.				
.08 Existing Building Classification:	Change in Major Occupancy: Yes Not Applicable (no change of major occupancy)	11.2.1.1.				
	Construction Index:	T 11.2.1.1A T 11.2.1.1B				
	Importance Category: Low Normal High Post-disaster	to N 4.1.2.1.(3),				
1.09 Renovation type:	☑ Basic Renovation □ Extensive Renovation	5.2.2.1.(2)				
1.10 Occupant Load	Floor Level/Area Occupancy Based On Occupant Load	11.3.3.2. 3.1.17.				
	Type (Persons) No Change					
Insert additional lines as needed	Ratio: Male to Female existing to remain, no change	3.7.4.				
Requirements	Ratio: <u>Male to Female existing to remain, no change</u> Floor Level/Area <u>Occupant OBC</u> Fixtures Fixtures	б.т.т.				
	Load <u>Reference</u> <u>Required</u> <u>Provided</u>					
	No Change					
				A		
Insert additional lines as neede				SK	C	
1.12 Barrier-free Desig	n: X Yes <u>Building Entrance</u>	11.3.3.2.(2)		in		BROUP architects
1.13 Reduction in Performance Leve	Structural: 🛛 No 🗆 Yes	11.4.2.1.		AWARTHA PINE BI	DARD	
Performance Leve	I: By Increase in occupant load: ⊠ No □ Yes By change of major occupancy: ⊠ No □ Yes	11.4.2.2. 11.4.2.3.			Seal:	
	Plumbing: No Yes	11.4.2.4.	20 Ca	mden Street, Suite 10	1	
	Extension of combustible construction:	11.4.2.5. 11.4.2.6.	Toron M5V	to, Ontario 1V1		
1.14 Compensating	⊠ No □ Yes	11.4.3.1,	www	.cmvarch.com		
Construction:	Structural: 🛛 No 🗆 Yes	11.4.3.2, 11.4.3.3,	T 416	5.506.1600 F 416.	506.0956	
	Increase in occupant load: ⊠ No □ Yes Change of major occupancy: ⊠ No □ Yes	11.4.3.4,	Projec			
	Plumbing: ⊠ No □ Yes Sewage systems: ⊠ No □ Yes	11.4.3.5, 11.4.3.6,				
	Extension of combustible construction:	11.4.3.7.			3-235-244-245-24 E RIDGE DISTRIC	
1.15 Compliance	Construction. ⊠ No ⊥ Yes ⊠ No □ Yes	11.5.1.				
Alternatives Proposed:			1 1) HIGHLANE RT HOPE	D DRIVE	
40		4151		ing Title:		ONTAR
1.16 Notes:		11.5.1.	1 1	-	g list ani	C
				BC MAI	TRIX	
		- T				
Insert additional lines as needed	C unless preceded by [A] for Division A and [C] for Division C.		Draw	n By: Checked	-	Project No.



2

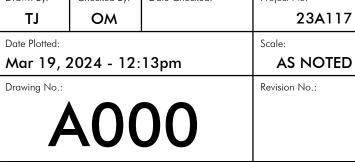

DEMOLITION AND CONSTRUCTION GENERAL NOTES

- NOTHING IN THIS SET OF DWG'S SHALL BE CONSTRUED TO RELIEVE PERSONS ENGAGED IN CONSTRUCTION OR DEMOLITION OPERATIONS FROM COMPLYING WITH OTHER APPLICABLE PROVISIONS OF LAW. NOR IS IT INTENDED TO ALTER OR DIMINISH ANY OBLIGATION OTHERWISE IMPOSED BY LAW ON THE OWNER/ PROJECT MANAGER.
- ALL WORK TO BE IN ACCORDANCE WITH THE ONTARIO BUILDING CODE AND THE OCCUPATIONAL HEALTH AND SAFETY ACT REGULATIONS FOR CONSTRUCTION PROJECTS
- DEMOLITION DRAWINGS ARE SCHEMATIC AND SHALL BE READ WITH REST OF ARCH. MECH. STR AND ELEC DRAWINGS. DEMO SCOPES SHOWN HERE ARE NOT COMPLETE AND ARE SHOWN ONLY FOR CONTRACTOR CONVENIENCE. CONTRACTOR NEEDS TO REVIEW COMPLETE DRAWING SET AND SPEC AND PROVIDE A LIST OF DEMO WORKS FOR PRICING.
- SEE ARCHITECTURAL SET AND COORDINATE FOR COMPLETE DEMOLITION WORKS SEE STR, MECH AND ELEC DRAWINGS AND COORDINATE FOR REQ'D DEMO WORKS
- WHENEVER SHOPDWG IS REQUIRED BY THE PROVISIONS OF THIS SET OF DWG'S SUCH SHOPDWG SHALL BE EXECUTED BY A REGISTERED DESIGN PROFESSIONAL IN ONTARIO WHO HIS OR HER SEAL AND SIGNATURE MUST BE AFFIXED TO ANY DRAWINGS OR SPECIFICATIONS THAT MAY BE REQUIRED FOR THE WORK.
- ALL ADJOINING AREAS AND OTHER COMMON AREAS SHALL BE PROTECTED FROM DAMAGE DURING CONSTRUCTION OR DEMOLITION
- CONTRACTOR TO CLEAN UP OPENED CEILING SPACE, EXPOSED CEILING DECK, EXPOSED STR. M&F MEMBERS CEILING AND WALLS AND SO ON. TAKE REQ'D PRECAUTIONS IN GENERAL AND SPECIALLY DURING DEMOLITION WORKS, PROVIDE PROPER DUST CONTROL, FOLLOW AUTHORITY HEALTH AND SAFETY REGULATIONS. REMOVE DUST. POSSIBLE MOLD, OR ANY OTHER HAZARDS. REFER TO PINCHIN REPORT
- DEMOLITION PLANS ARE INDICATIVE ONLY OF INTENT OF WORK. DEMOLITION TRADE TO INCLUDE, AND IS NOT LIMITED TO PROVIDING. THE REMOVAL FROM FIELD OF ALL MATERIALS AND EQUIPMENT AS NECESSARY TO PROVIDE BASE FOR THIS CONSTRUCTION PURPOSES.
- A SYSTEM OF DIAGRAMMATIC SYMBOLS AND NOTATIONS IS USED IN THESE DRAWINGS. REVIEW NOTATION CAREFULLY AND NOTIFY ARCHITECT AND REQUEST FOR CLARIFICATION OF ANY UNCLEAR NOTATION OR DISCREPANCY PRIOR TO COMMENCING WORK.
- ALL SYMBOLS ARE SHOWN DIAGRAMMATICALLY ILLUSTRATING APPROXIMATE LOCATION OF EXISTING AND PROPOSED MATERIALS. ANY DISCREPANCIES OR CONFLICTS BETWEEN EXISTING AND PROPOSED CONDITIONS SHALL BE REPORTED TO THE ARCHITECT.
- CONTRACTOR IS TO VERIFY ALL QUANTITIES. IN CASE OF ANY DISCREPANCIES. GRAPHICALLY SHOWN MATERIALS QUANTITIES SHALL TAKE PRECEDENCE.
- 13. DO ALL WORK IN CONFORMANCE WITH GOVERNING CODES AND AUTHORITIES. INCLUDING HAULING, RECYCLING AND DISPOSAL
- REMOVE, STORE, AND PROTECT DESIGNATED MATERIALS AND EQUIPMENT FOR REINSTALLATION AND COORDINATE WITH OWNER/ PROJECT MANAGER.
- SUBMIT DETAIL SCHEDULE AND PHASE PLANS FOR REMOVAL AND INSTALLATION WORK
- CONTRACTOR TO COORDINATE WITH OWNER/ PROJECT MANAGER. ARCHITECT AND ALL SUB-CONTRACTORS PRIOR TO THE COMMENCEMENT OF ANY DEMOLITION ACTIVITY
- CONTRACTOR TO FIELD REVIEW LAYOUT & NOTIFY ARCHITECT OF ANY CONFLICTS W/ EXISTING ITEMS PRIOR TO THE COMMENCEMENT OF DEMOLITION OR CONSTRUCTION ACTIVITIES.
- THE ARCHITECT IS NOT RESPONSIBLE FOR THE CONSTRUCTION MEANS, METHODS, TECHNIQUES, SEQUENCE OR SAFETY PRECAUTIONS OR PROCEDURES UTILIZED IN CONNECTION WITH THE WORK AND WILL NOT BE RESPONSIBLE FOR THE CONTRACTORS' FAILURE TO CARRY OUT THE WORK IN ACCORDANCE WITH THE CONTRACT DOCUMENTS.
- CONTRACTORS ARE RESPONSIBLE FOR REMOVING AND PRESERVING ITEMS AS INDICATED BY THE OWNER/ PROJECT MANAGER
- 20. COMPLETE ALL DEMOLITION WORK NECESSARY TO COMPLETE THE RENOVATIONS AS SHOWN AND AS REQUIRED. DEMOLITION OF BUILDING ELEMENTS INCLUDES COMPLETE REMOVAL OF ALL ASSOCIATED FIXTURES, FITTING, HARDWARE, FASTENERS, EQUIPMENT AND ACCESSORIES UNLESS NOTED OTHERWISE
- DEMOLITION TO INCLUDE, AND IS NOT LIMITED TO PROVIDING, THE REMOVAL FROM SITE OF ALL MATERIALS AND EQUIPMENT AS NECESSARY TO PROVIDE EXPOSED BASE FLOOR AND CEILING INTENT OF THIS WORK. COORDINATE WITH OWNER/ PROJECT MANAGER FOR NEW LOCATION AND OR STORAGE
- 22. IT IS CONTRACTOR'S SOLE RESPONSIBILITY TO DETERMINE THE EXTENT OF DEMOLITION REQUIRED IN ORDER TO PERFORM THE CONTRACT WORK FOR THIS PROJECT. THE FOLLOWING SHOWN OF ASSEMBLIES REQUIRING DEMOLITION IS INCLUDED FOR CONTRACTOR'S CONVENIENCE ONLY. CONTRACTORS ARE REQUIRED TO FAMILIARIZE THEMSELVES WITH ITEMS TO BE DEMOLISHED AND REMOVAL, TURNOVER, OR STORAGE OF REQUIRED EXISTING ASSEMBLIES, FURNITURE, MILLWORKS, CABINETS, FINISHES, FEATURES, UTILITIES, HARDWARE, ELEC AND MECH SERVICES ON SITE AND EXAMINE ALL THE INFORMATION WITHIN THESE DOCUMENTS.
- 23. CONTINUOUS ACCESS SHALL BE MAINTAINED FOR EXITS AT ALL TIMES.
- ALL SITE SIGN LOCATION AND DIMENSIONS

ARE TO BE COORDINATED WITH OWNER/ PROJECT MANAGER.

- 25. THE DRAWINGS INDICATING EXISTING CONDITIONS ARE PROVIDED FOR THE CONTRACTOR'S CONVENIENCE. IT IS THE CONTRACTOR'S RESPONSIBILITY TO VISIT THE EXISTING CONDITION AND ENSURE THAT THE SCOPE OF WORK INDICATED ON THE DRAWINGS IS INTERPRETED IN CONJUNCTION WITH THE FIELD CONDITIONS.
- 26. IT IS THE CONTRACTOR'S RESPONSIBILITY TO ENSURE THAT THE INFORMATION PROVIDED ON THE DRAWINGS AND DURING THEIR FIELD VISIT IS CLEAR AND FULLY UNDERSTOOD PRIOR TO SUBMITTING THEIR TENDER.
- 27. ARCHITECTURAL, STRUCTURAL, MECHANICAL AND ELECTRICAL DEMOLITION AND PROPOSED DRAWINGS ARE COMPLEMENTARY AND SHALL BE READ TOGETHER.
- 28. PROVIDE ALL SHORING AS REQUIRED. SHORING SHALL BE DESIGNED BY A REGISTERED PROFESSIONAL ENGINEER.
- 29. NOTIFY CONSULTANT OF LOAD BEARING MEMBERS OR ASSEMBLIES IDENTIFIED OR DISCOVERED DURING WORK AND NOT INDICATED ON DRAWINGS. DO NOT PROCEED WITH REMOVALS WITHOUT PRIOR REVIEW BY THE CONSULTANT.
- 30. PROVIDE TEMPORARY SUPPORT OF PIPES, DUCTS AND ELECTRICAL CHASES AS REQUIRED FOR SAFE REMOVAL. EXISTING AND PROPOSED SUPPORTS ARE TO BE REVIEWED BY THE CONSULTANT PRIOR TO REMOVAL OF ANY COMPONENTS WHICH MAY FALL OR CAUSE OTHERS TO FALL.
- 31. DEMOLITION INCLUDES ALL ASSOCIATED MECHANICAL AND ELECTRICAL SERVICES, EQUIPMENT. FITTINGS. FIXTURES. HANGERS. BRACKETS, TRIM AND ACCESSORIES AS REQUIRED TO COMPLETE THE WORK.
- 32. SAWCUT, BREAK OUT AND MAKE GOOD ALL EXISTING FLOOR SLABS WHERE REQUIRED TO INSTALL NEW UNDERGROUND PLUMBING AND OTHER BURIED SERVICES AS INDICATED ON MECHANICAL AND ELECTRICAL DRAWINGS
- 33. MAINTAIN EXISTING FIRE HOSE CABINETS AND FIRE RATINGS
- 34. REMOVAL OF DOORS AND FRAMES IS TO INCLUDE REMOVAL OF ALL HARDWARE
- 35. CLEAN AND REPAIR ALL EXISTING SURFACES TO REMAIN, AS NECESSARY TO RECEIVE NEW FINISHES
- 36. DISCONNECT AND CAP OFF ALL SERVICES PRIOR TO DEMOLITION, COORDINATE WITH M&E CONSULTANTS.
- 37. DISPOSE OF ALL MATERIALS OFF SITE. COORDINATE ITEMS FOR SALVAGE /HANDOVER WITH OWNER
- 38. IT IS THE CONTRACTOR'S RESPONSIBILITY TO REPORT ANY DISCREPANCIES BETWEEN THE DRAWINGS AND FIELD CONDITIONS TO THE ARCHITECT
- 39. THE CONTRACTOR IS RESPONSIBLE FOR COORDINATING AND SCHEDULING ALL WORK WITH THE OWNER/ PROJECT MANAGER PRIOR TO COMMENCEMENT OF ANY WORK.
- 40. REPAIR AND MAKE GOOD ANY EXISTING SURFACES AND MATERIALS TO REMAIN THAT ARE DAMAGED BY THIS WORK (TYPICAL).
- 41. PATCH AND REPAIR THE PERIMETER WALLS DUE TO THE DEMOLITION AND REMOVAL OF EXISTING FINISHES.
- 42. REMOVAL OF EXISTING FLOOR FINISHES IS TO INCLUDE COMPLETE REMOVAL OF BASE AND ALL MORTAR AND ADHESIVES AND PREPARATION OF EXISTING SUBSTRATE TO RECEIVE NEW FLOORING. SATISFACTORY TO THE MANUFACTURER OF NEW FLOOR FINISHES. ALLOW FOR EXCESSIVE LEVELING OF SLAB. REMOVE ALL EXISTING FINISHES WHERE SHOWN ON THE DRAWINGS, INCLUDING ADHESIVES & RESIDUE. ENSURE A SOUND, SMOOTH & FLUSH CONTINUOUS SURFACE WITHIN ALLOWABLE TOLERANCES (CAN 3-A21.1-M90) THROUGHOUT THE ÈNTIRE AREA. LEVELS OF FINISHED CONCRETE AND FLOORS UNDER FINISHED FLOORING APPLICATIONS SHALL BE SUFFICIENTLY EVEN .
- 43. TO RECEIVE NEW FLOOR FINISHES, REPAIR & MAKE GOOD ANY DAMAGE TO THE EXISTING CONCRETE FLOOR SLAB
- 44. ALL EXISTING LIGHT FIXTURES AT INDICATED AREAS ARE TO BE REMOVED AND DISPOSED. (REFER TO ELECTRICAL DRAWINGS)
- 45. COORDINATE BASE BUILDING SERVICES SHUT DOWNS WITH OWNER/ PROJECT MANAGER PRIOR TO COMMENCEMENT OF ANY DEMOLITION. (REFER TO MECHANICAL AND ELECTRICAL DRAWINGS)
- 46. THE CONTRACTOR SHALL TAKE PRECAUTIONARY MEASURES NECESSARY TO PROTECT EXISTING ITEMS & ASSEMBLIES. ALL SUCH ASSEMBLIES DAMAGED BY THE CONTRACTOR'S OPERATIONS SHALL BE REPAIRED OR RECONSTRUCTED SATISFACTORY TO THE ARCHITECT AND OWNER / PROJECT MANAGER AT NO ADDITIONAL COST TO THE OWNER.
- 47. SEE MECH AND ELEC DWG'S FOR REMOVAL/RELOCATION OF EXISTING FIXTURES AND ASSOCIATED CONTROLS, SMOKE CONTROLS, ETC.
- 48. THE ARCHITECT ASSUMES NO RESPONSIBILITY FOR THE MECH AND ELEC INFO SHOWN ON THE ARCHITECTURAL DRAWINGS. SEE MECH & ELEC DRAWINGS. CONTRACTOR SHALL USE REQUIRED CAUTION WHEN WORKING OVER OR NEAR EXISTING SERVICE MAINS AND ELECTRICAL LINES. CONTRACTOR IS TO VERIFY HORIZONTAL AND VERTICAL LOCATION OF ALL EXISTING SERVICES AND UTILITIES , ABOVE AND BELOW GRADE ON SITE. NOTIFY CONSULTANTS OF ANY DISCREPANCIES OR CONFLICTS. DAMAGE SHALL BE REPAIRED BY THE CONTRACTOR W/O ADDITIONAL COST TO THE OWNER.
- 49. THE CONTRACTOR IS RESPONSIBLE FOR COORDINATING THE DISCONNECTION OF EXISTING SERVICES CRITICAL TO OPERATION OF SCHOOL SPACES.
- 50. MAINTAIN THE SECURITY OF THE WORK AREA AT ALL TIMES.

- 51. THE CONTRACTOR IS RESPONSIBLE FOR COORDINATING WITH GOVERNING CODES AND AUTHORITIES IN ORDER TO MAINTAIN THE INTEGRITY OF THE FIRE DETECTION AND ANNUNCIATION SYSTEMS IN THE DEMOLISHED SPACE.
- 52. ENSURE THE PREMISES IS LEFT FREE OF ANY DEBRIS AND IN BROOM CLEAN CONDITION.
- 53. ALL R.W.L. TO REMAIN UNDISTURBED BY THIS WORK UNLESS OTHERWISE NOTED.
- REMOVE AT ALL INDICATED AREAS (UNLESS NOTED OTHERWISE): PREVIOUS FINISHES INCLUDING FLOORING, FLOOR FASTENING AND ADHESIVES. FLOOR LEVELING & PATCHING MATERIALS, CEILING, CEILING FINISHES, CEILING ATTACHMENTS, WALL FINISHES, LIGHT FIXTURES, FURNITURE, FIXTURES, EDUCATIONAL FEATURES. MECH AND ELEC EQUIPMENT, CABINETS, MILLWORKS, AUDIO AND VIDEO SYSTEM, EQUIPMENT AND SUPPLIES AND ALL OTHER ITEMS AS WILL BE INDICATED BY OWNER/ PROJECT MANAGER.
- 55. EXISTING FIRE SAFETY OF BUILDING, MEANS OF EGRESS AND FIRE RESISTANCE RATING OF ASSEMBLIES TO REMAIN UNDAMAGED AND SHALL NOT BE AFFECTED BY ANY PROPOSED OR DEMOLITION WORKS.
- AT INDICATED AREA, REMOVE EXISTING 56. CEILING, BULKHEADS, AND ACOUSTIC CEILING TILES. EXPOSED CEILING STRUCTURE TO BE CLEAN AND FREE OF DIRT OR OTHER CONSTRUCTION RESIDUE.
- 57. MAKE GOOD ON ALL FINISHES, TYPICAL. 58. SEE MECHANICAL AND ELECTRICAL DRAWINGS.
- 59. ALL INDICATED AREAS REMOVE AND CAP ALL EXISTING MECHANICAL AND ELECTRICAL SERVICES TO BASE BUILDING CONDITIONS CAP ALL EXISTING PLUMBING AT THE FLOOR WHICH WILL NOT CONFORM TO THE NEW REQUIREMENTS, C/W CONCRETE PATCHING.
- MODIFY AND/OR CAP EXISTING BACK TO 60. MAIN DROP. REMOVE AND CAP ALL REDUNDANT GAS PIPING. ETC. COORDINATE WITH MECH CONSULTANT.
- 61. MODIFY AND/OR CAP EXISTING ELECTRICAL BACK TO BASE BUILDING CONDITIONS. REMOVE ALL REDUNDANT LIGHTING. RECEPTACLES, WIRING, ETC. COORDINATE WITH MECH CONSULTANT.
- 62. PATCH AND REPAIR ANY DAMAGE TO BUILDING COMPONENTS RESULTING FROM THIS WORK, TYPICAL.
- 63. EXISTING AREAS. WALL ASSEMBLIES, STEEL STRUCTURE. ROOF ASSEMBLIES, FLOORS AND CEILING AREAS EXCEPT AS INDICATED ON DWG'S ARE EXISTING TO REMAIN AND SHALL NOT BE AFFECTED BY ANY PROPOSED OR DEMOLITION WORKS.
- 65. PATCH AND REPAIR, MAKE GOOD ROOFING

153H CORRIDORROOM NUMBER AND NAME1 (1202)153DOOR NUMBER4 (1202)153DOOR NUMBER4 (1202)153PARTITION TYPE10 (1000)P1PARTITION TYPE10 (1000)ACT AFF ALUM ALUM CONC CONC CONCRETE CONC BLK CONCRETE BLOCK CONCRETE BLOCK MAX C/W COMPLETE WITH NIC DEMO DEMOLITION DEMO DEMOLITION DEMO DEMOLITION DEMO DEMOLITION DEMO DEMOLITION DEMO DEMOLITION DEMO DEMOLITION DEMO DEMOLITION DEMO DEMOLITION DEMO DEMOLITION DEMOLITION DEMOLITION DEMOLITION DIG DEMOLITION DIG CONT <th></th> <th></th> <th></th>			
153 DOOR NUMBER P1 PARTITION TYPE P1 PARTITION TYPE 10 A302 10 A302 11 10 ACT ACOUSTIC CEILING TILE AFF ABOVE FINISHED FLOOR ALUM ALUMINIUM ALUM ALUMINIUM CONC CONCRETE CONC BLK CONCRETE BLOCK CONC CLEAN OUT MIN CONT CONTINUOUS CONT CONTINUOUS C/W COMPLETE WITH DEMO DEMOLITION DWG DRAWING O/C ELEC ELEC ELECTRICAL EXT EXISTING EXT EXISTING F EX F FIRE EXTINGUISHER AND SIGN FIN FINISH FIN FIRE RESISTANCE RATING FIR FIRE RESISTANCE RATING			
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ACT ACOUSTIC CEILING TILE GC AFF ABOVE FINISHED FLOOR HM ALUM ALUMINIUM HR CONC CONCRETE INT CONC BLK CONCRETE BLOCK MAX CB CONCRETE BLOCK MAX CB CONCRETE BLOCK MECH CO CLEAN OUT MIN CONT CONTINUOUS MM C/W COMPLETE WITH NIC DEMO DEMOLITION NTS DWG DRAWING O/C ELEC ELECTRICAL PREF EXIST EXISTING RB EXP EXPOSED ST EXT EXTERIOR STRU FD FLOOR DRAIN F Ex FIRE EXTINGUISHER AND SIGN TYP FIN FINISH U/S FRR FIRE RESISTANCE RATING W/	P1	PARTITION TYPE	(<u> </u>
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AFFABOVE FINISHED FLOORHMALUMALUMINIUMHRCONCCONCRETEINTCONCBLKCONCRETEBLOCKCOCLEAN OUTMINCONTCONTINUOUSMMC/WCOMPLETE WITHNICDEMODEMOLITIONNTSDWGDRAWINGO/CELECELECTRICALPREFEXISTEXISTINGPTEXEXISTINGSTEXTEXTERIORSTRUFDFLOOR DRAINTYPFINFIRE EXTINGUISHER AND SIGNTYPFINFIRE RESISTANCE RATINGW/GLASSW/			ĨĊ
	AFF ALUM CONC CONC BLK CB CO CONT C/W DEMO DWG ELEC EXIST EX EXP EXT FD F Ex FIN FRR	ABOVE FINISHED FLOOR ALUMINIUM CONCRETE CONCRETE BLOCK CONCRETE BLOCK CLEAN OUT CONTINUOUS COMPLETE WITH DEMOLITION DRAWING ELECTRICAL EXISTING EXISTING EXISTING EXISTING EXTERIOR FLOOR DRAIN FIRE EXTINGUISHER AND SIGN FINISH FIRE RESISTANCE RATING GLASS	HM HR INT MAX MECH MM NIC NTS O/C PREF PT RB ST C VP U/S W/



taMat Page Page Page

12-Part 11_Dc DataMatrix DataMatrix DataMatrix DataMatrix

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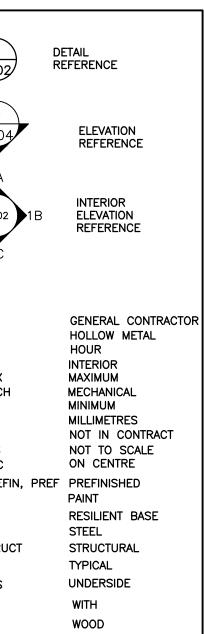
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ARCH D

SYS TO MATCH EXTG AT NEW ROOF OPENINGS (AIR VENT/PIPING PENETRATIONS, NEW EXHAUST FAN AND SO ON) TYP.


- 66. CONDUCT OF CONSTRUCTION OR DEMOLITION OPERATIONS SHALL NOT AFFECT THE EXISTING FIRE PREVENTION AND FIRE FIGHTING OF THE BUILDING. ACCESS TO FIRE FIGHTING EQUIPMENT, LOCATED ON MAIN STREETS AND EXIT CORRIDORS, SHALL BE MAINTAINED FREE OF ANY OBSTRUCTION, ALL THE TIME DURING THE CONSTRUCTION OR DEMOLITION PHASE.
- 67. COORDINATE WITH OWNER/ PROJECT MANAGER FOR WASTE DUMPING PATH.
- 68. REQUIRED EXITS ELEMENTS, FIRE PROTECTION DEVICES AND SANITARY SAFEGUARDS SHALL BE MAINTAINED AT ALL TIMES DURING RENOVATION OR CONSTRUCTION
- 69. DEMOLITION WORK SHALL BE CONSISTENT WITH EXTG SMOKE MANAGEMENT SYSTEM ZONING.
- 70. FIRE PREVENTIVE, SANITARY, OR OTHER FACILITIES THAT HAVE BEEN PROVIDED FOR THE PROTECTION OF LIFE, HEALTH, AND PROPERTY SHALL BE CONTINUOUSLY MAINTAINED AND PROTECTED PROPERLY
- 71. CONTRACTOR TO REMOVE, PACKAGE & DISPOSE HAZARDOUS CONTAINING MATERIAL INCLUDING MECH AND ELECT ITEMS
- 72. LOCATION OF STORAGE MATERIAL, WASTE DUMPSTERS, DEBRIS BOXES AND SKIP BOXES WILL BE DETERMINED ON SITE BY PROJECT MANAGER AND CONTRACTORS TO CONFIRM WITH OWNER FOR LOCATION BEFORE SUBMITTING FEE PROPOSALS.
- 73. ALL DEBRIS SHALL BE CLEANED OFF FLOORS DAILY. GC TO CONDUCT A DAILY INSPECTION FOR CONSTRUCTION OR DEMOLITION DEBRIS
- 74. COMBUSTIBLE WASTE MATERIAL OR COMBUSTIBLE DEBRIS SHALL NOT BE PERMITTED TO ACCUMULATE, AND SHALL BE REMOVED FROM THE SITE WITH THE REQUIREMENTS OF THE LAW OR AS REQUESTED BY OWNER/PROJECT MANAGER
- 75. THE CONTRACTOR IS RESPONSIBLE FOR COORDINATING THE DISCONNECTION OF EXISTING SERVICES CRITICAL TO THE OPERATION OF OTHER SPACES.
- 76. ALL PLUMBING TO BE REMOVED. SHALL BE REMOVED AND CAPPED OFF BENEATH THE FINISHED FLOOR & CONCRETE PATCHED. ALL PLUMBING AND VENT LINES ARE TO BE CUT BACK TO THE ORIGINAL SOURCE AND CAPPED OFF. (REFER TO MECHANICAL DRAWINGS.)
- 77. ALL EXISTING ELECTRICAL CONDUIT, TELEPHONE, CABLES, ETC, REDUNDANT ELECTRICAL, DUCTING, V.A.V. BOXES ETC. TO BE REMOVED AND CAPPED OFF SAFELY. REFER TO ELECTRICAL DRAWINGS




- 78. ALL EXISTING SEWERS, PIPING AND UTILITIES SHOWN ARE NOT TO BE INTERPRETED AS THE EXACT LOCATION, OR AS THE ONLY OBSTACLES THAT MAY OCCUR ON THE SITE VERIFY EXISTING CONDITIONS AND PROCEED WITH CAUTION AROUND ANY ANTICIPATED FEATURES. GIVE NOTICE TO ALL UTILITY COMPANIES REGARDING DESTRUCTION AND REMOVAL OF ALL SERVICE LINES AND CAP ALL LINES BEFORE PROCEEDING WITH THE WORK.
- 79. COORDINATE WITH OWNER FOR UTILIZING THE EXISTING PUBLIC PARKING LOT FOR THE DURATION OF CONSTRUCTION FOR PARKING ONLY. THE GENERAL CONTRACTOR IS TO KEEP THIS AREA ORGANIZED AND FREE FROM DEBRIS AT ALL TIMES. ANY DAMAGE TO THIS AREA DUE TO ITS OCCUPATION AND USE BY THE GENERAL CONTRACTOR AND SUBCONTRACTORS IS TO BE REPAIRED AND MADE GOOD BEFORE CONSTRUCTION IS COMPLETED.
- 80. THE GENERAL CONTRACTOR IS TO KEEP THE EXISTING DRIVEWAYS, DRIVE AISLES, PARKING LOT, SIDEWALKS AND WALKWAYS AT THE PERIMETER OF THE SITE, FREE FROM DEBRIS AND OBSTRUCTIONS AT ALL TIMES
- 81. PROVIDE TEMPORARY DUST SCREENS WITH SEALED EDGES AT ALL AIR RETURNS IN THE CONSTRUCTION AREA TO PREVENT THE SPREAD OF CONSTRUCTION DUST AND ODOURS. REMOVE AFTER COMPLETION OF CONSTRUCTION.
- 82. MAKE ALL NECESSARY REPAIRS TO THE SITE WHERE AREAS ARE DAMAGED. REINSTATE ALL DAMAGED ITEMS (SIGNAGE, CURBS, LIGHT STANDARDS, DRIVEWAY PAVEMENTS, SODDED AREAS, SIDEWALK, PAINTED LINES, ETC.) DURING CONSTRUCTION AND RESTORE TO AS NEW CONDITION.
- 84. THE TEMPORARY EXTERIOR CONSTRUCTION FENCING, THE INTERIOR HOARDING PARTITIONS AND DUST SCREENS AND GATES ARE TO BE REMOVED ONCE THE PROPOSED NEW WORK IS IN PLACE
- 85. OWNER ENERGY INCENTIVE APPLICATIONS DOCUMENTATION
- CONTRACTOR IS REQUIRED TO PROVIDE DOCUMENTATION TO SUPPORT THE APPLICATION AS FOLLOWS FOR LIGHTING AND LIGHTING CONTROLS:
- EXISTING FIXTURES A.TYPE B.LAMP WATTAGE C.LAMPS/FIXTURE
- PHOTOS OF EACH FIXTURE BEING REMOVED ARE REQUIRED. THE REQUIRED PHOTOS ARE AS FOLLOWS:
- A.PICTURE OF THE TYPICAL ROOM FOR EACH TYPE OF FIXTURE
- B.PICTURE OF THE TYPICAL FIXTURE BEING REMOVED, (FOR EACH TYPE OF FIXTURE) C.CLOSEUP SHOWING THE WATTAGE. (EITHER
- OF LAMP INSTALLED, OR THE BOX OF REPLACEMENT LAMPS IF ACTUAL LAMP IS NOT ACCESSIBLE).
- PHOTOS OF THE NEW FIXTURES BEING INSTALLED ARE REQUIRED. THE REQUIRED PHOTOS ARE AS FOLLOWS:


A.PICTURE OF THE TYPICAL ROOM FOR EACH TYPE OF FIXTURE B.PICTURE OF THE TYPICAL FIXTURE BEING REMOVED, (FOR EACH TYPE OF FIXTURE) C.CLOSEUP OF NAMEPLATE TO VERIFY THE MODEL NUMBER.

- WASTE DISPOSAL DOCUMENTATION IS REQUIRED FROM THE WASTE DISPOSAL COMPANY. A RECEIPT, CERTIFICATE OF INVOICE FROM THE WASTE DISPOSAL COMPANY SHOULD INDICATE THE NUMBER OF LAMPS AND TYPE OF LAMPS DISPOSED-OF, (SOMETIMES LISTED AS # FT). ALSO SEE SPECIFICATIONS.
- ITEMIZED LIST OF FIXTURES INSTALLED IS REQUIRED. INCLUDE THE MODEL NUMBER AND QUANTITY.
- LUMINAIRE MUST BE DLC LISTED.
- DOCUMENTATION FOR ESTIMATED COST OF SUPPLY AND INSTALLATION IS REQUIRED.
- PROOF OF PAYMENT DOCUMENTS ARE REQUIRED.
- APPROVED SHOP DRAWINGS ARE REQUIRED.

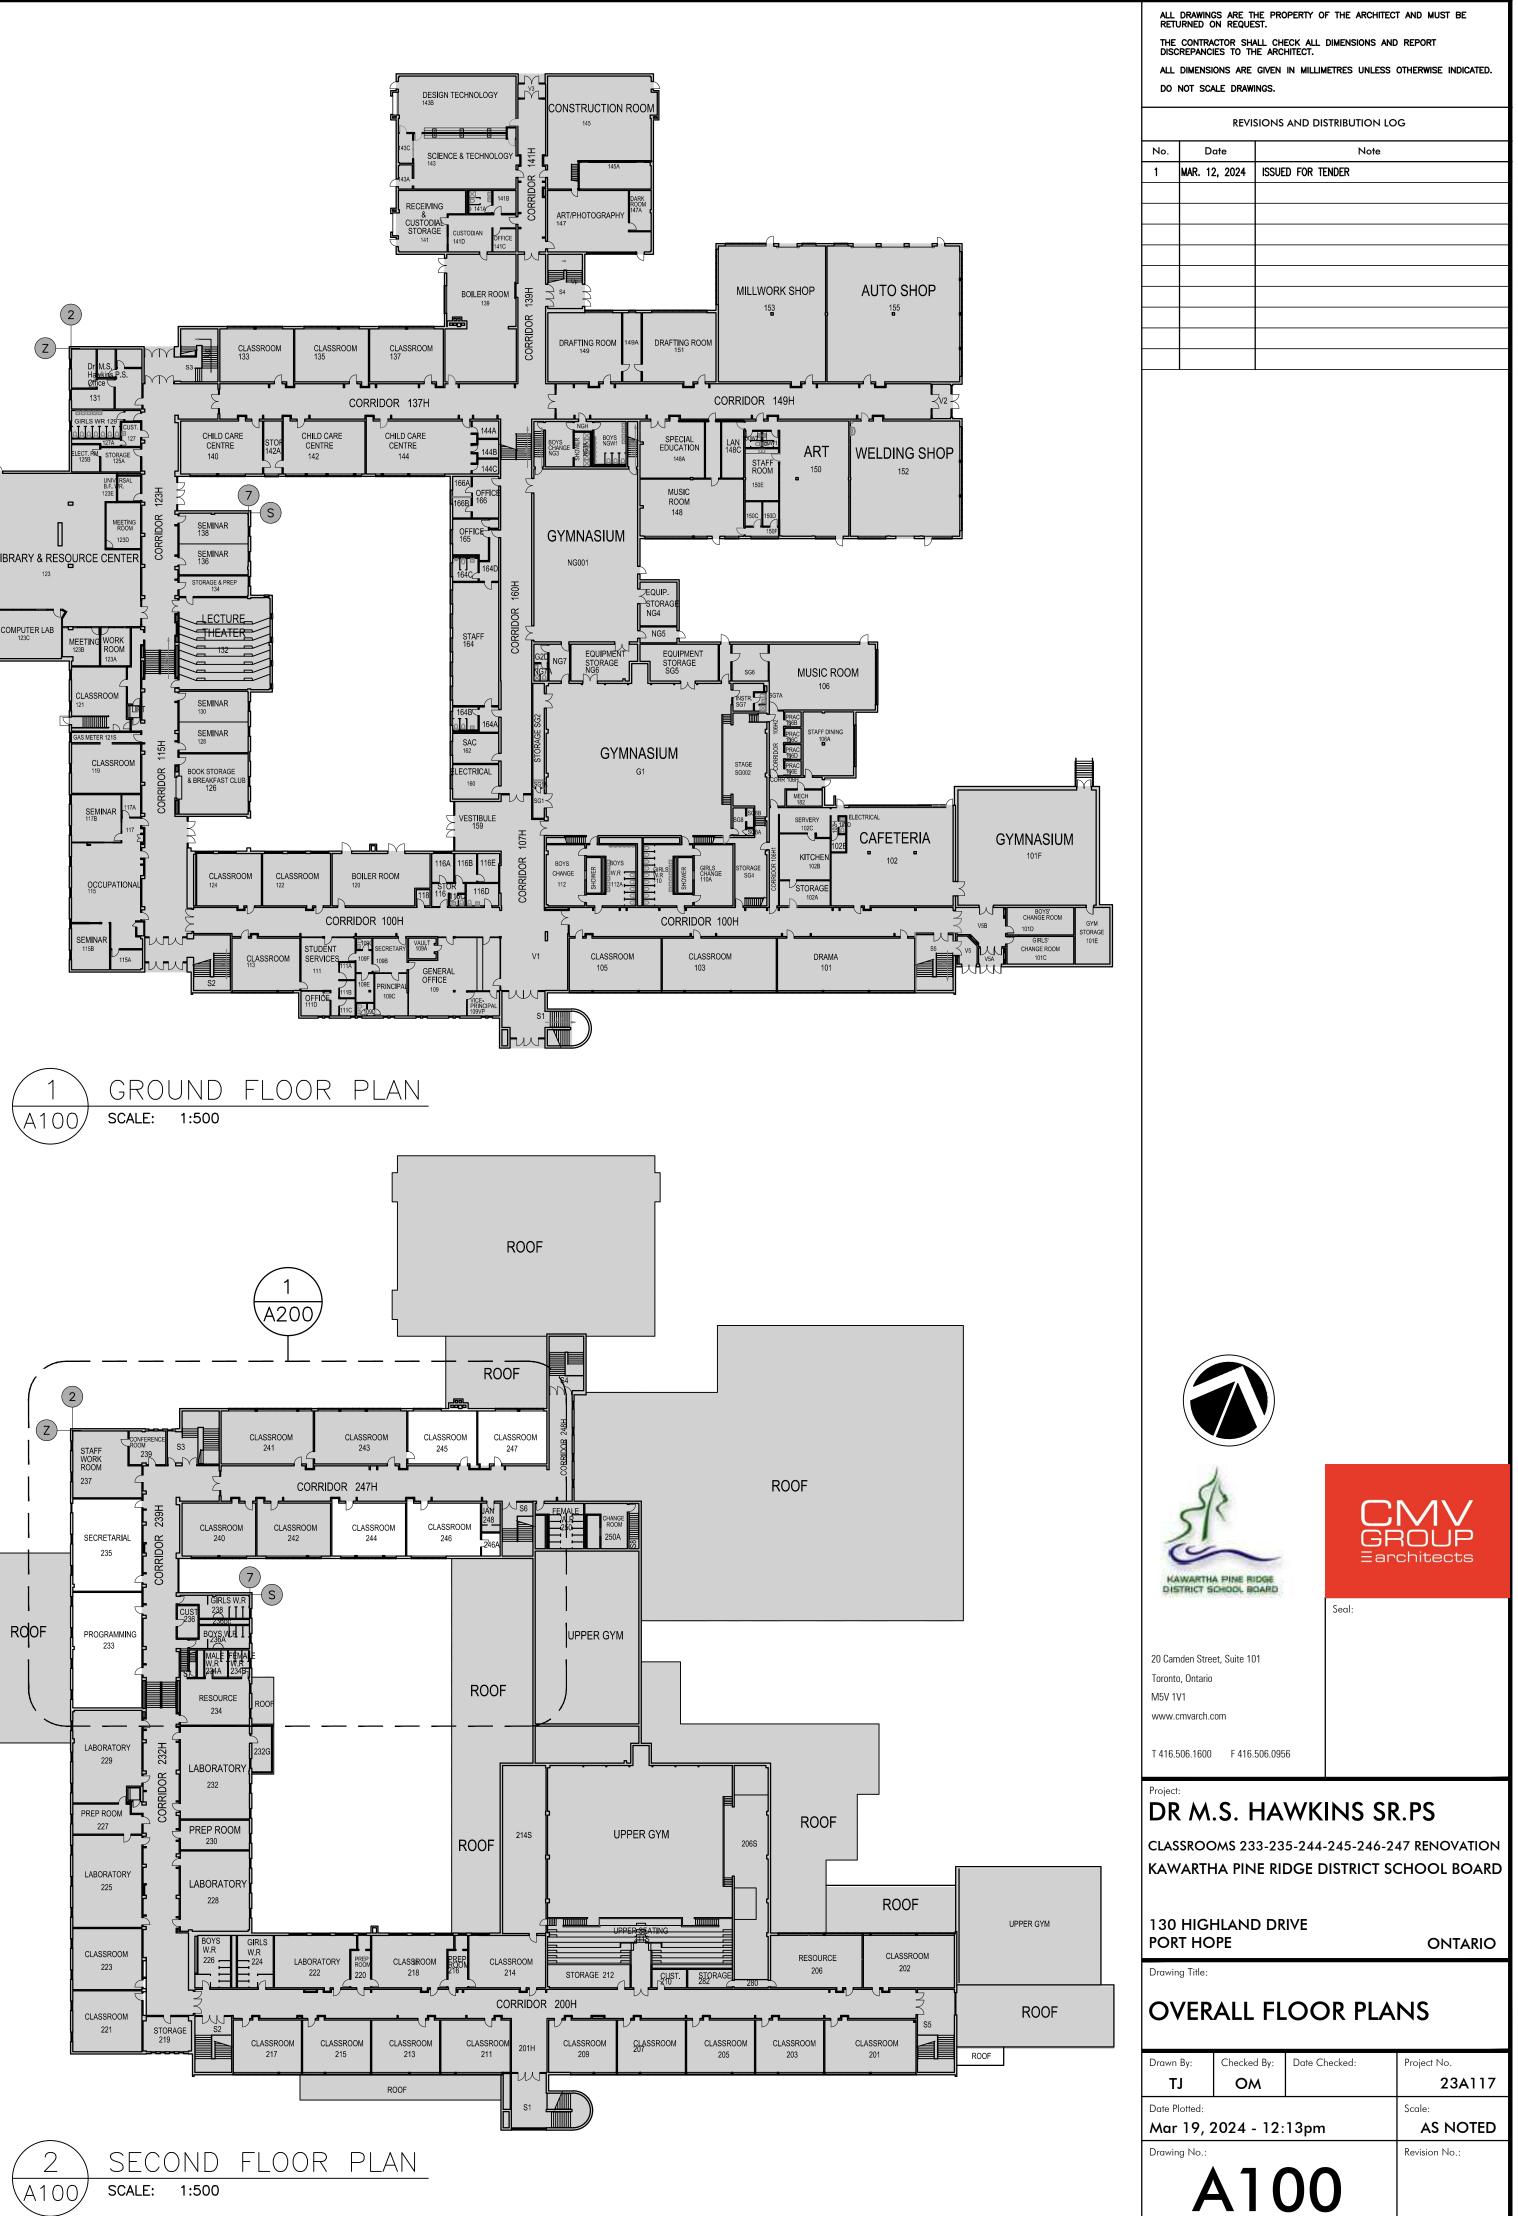



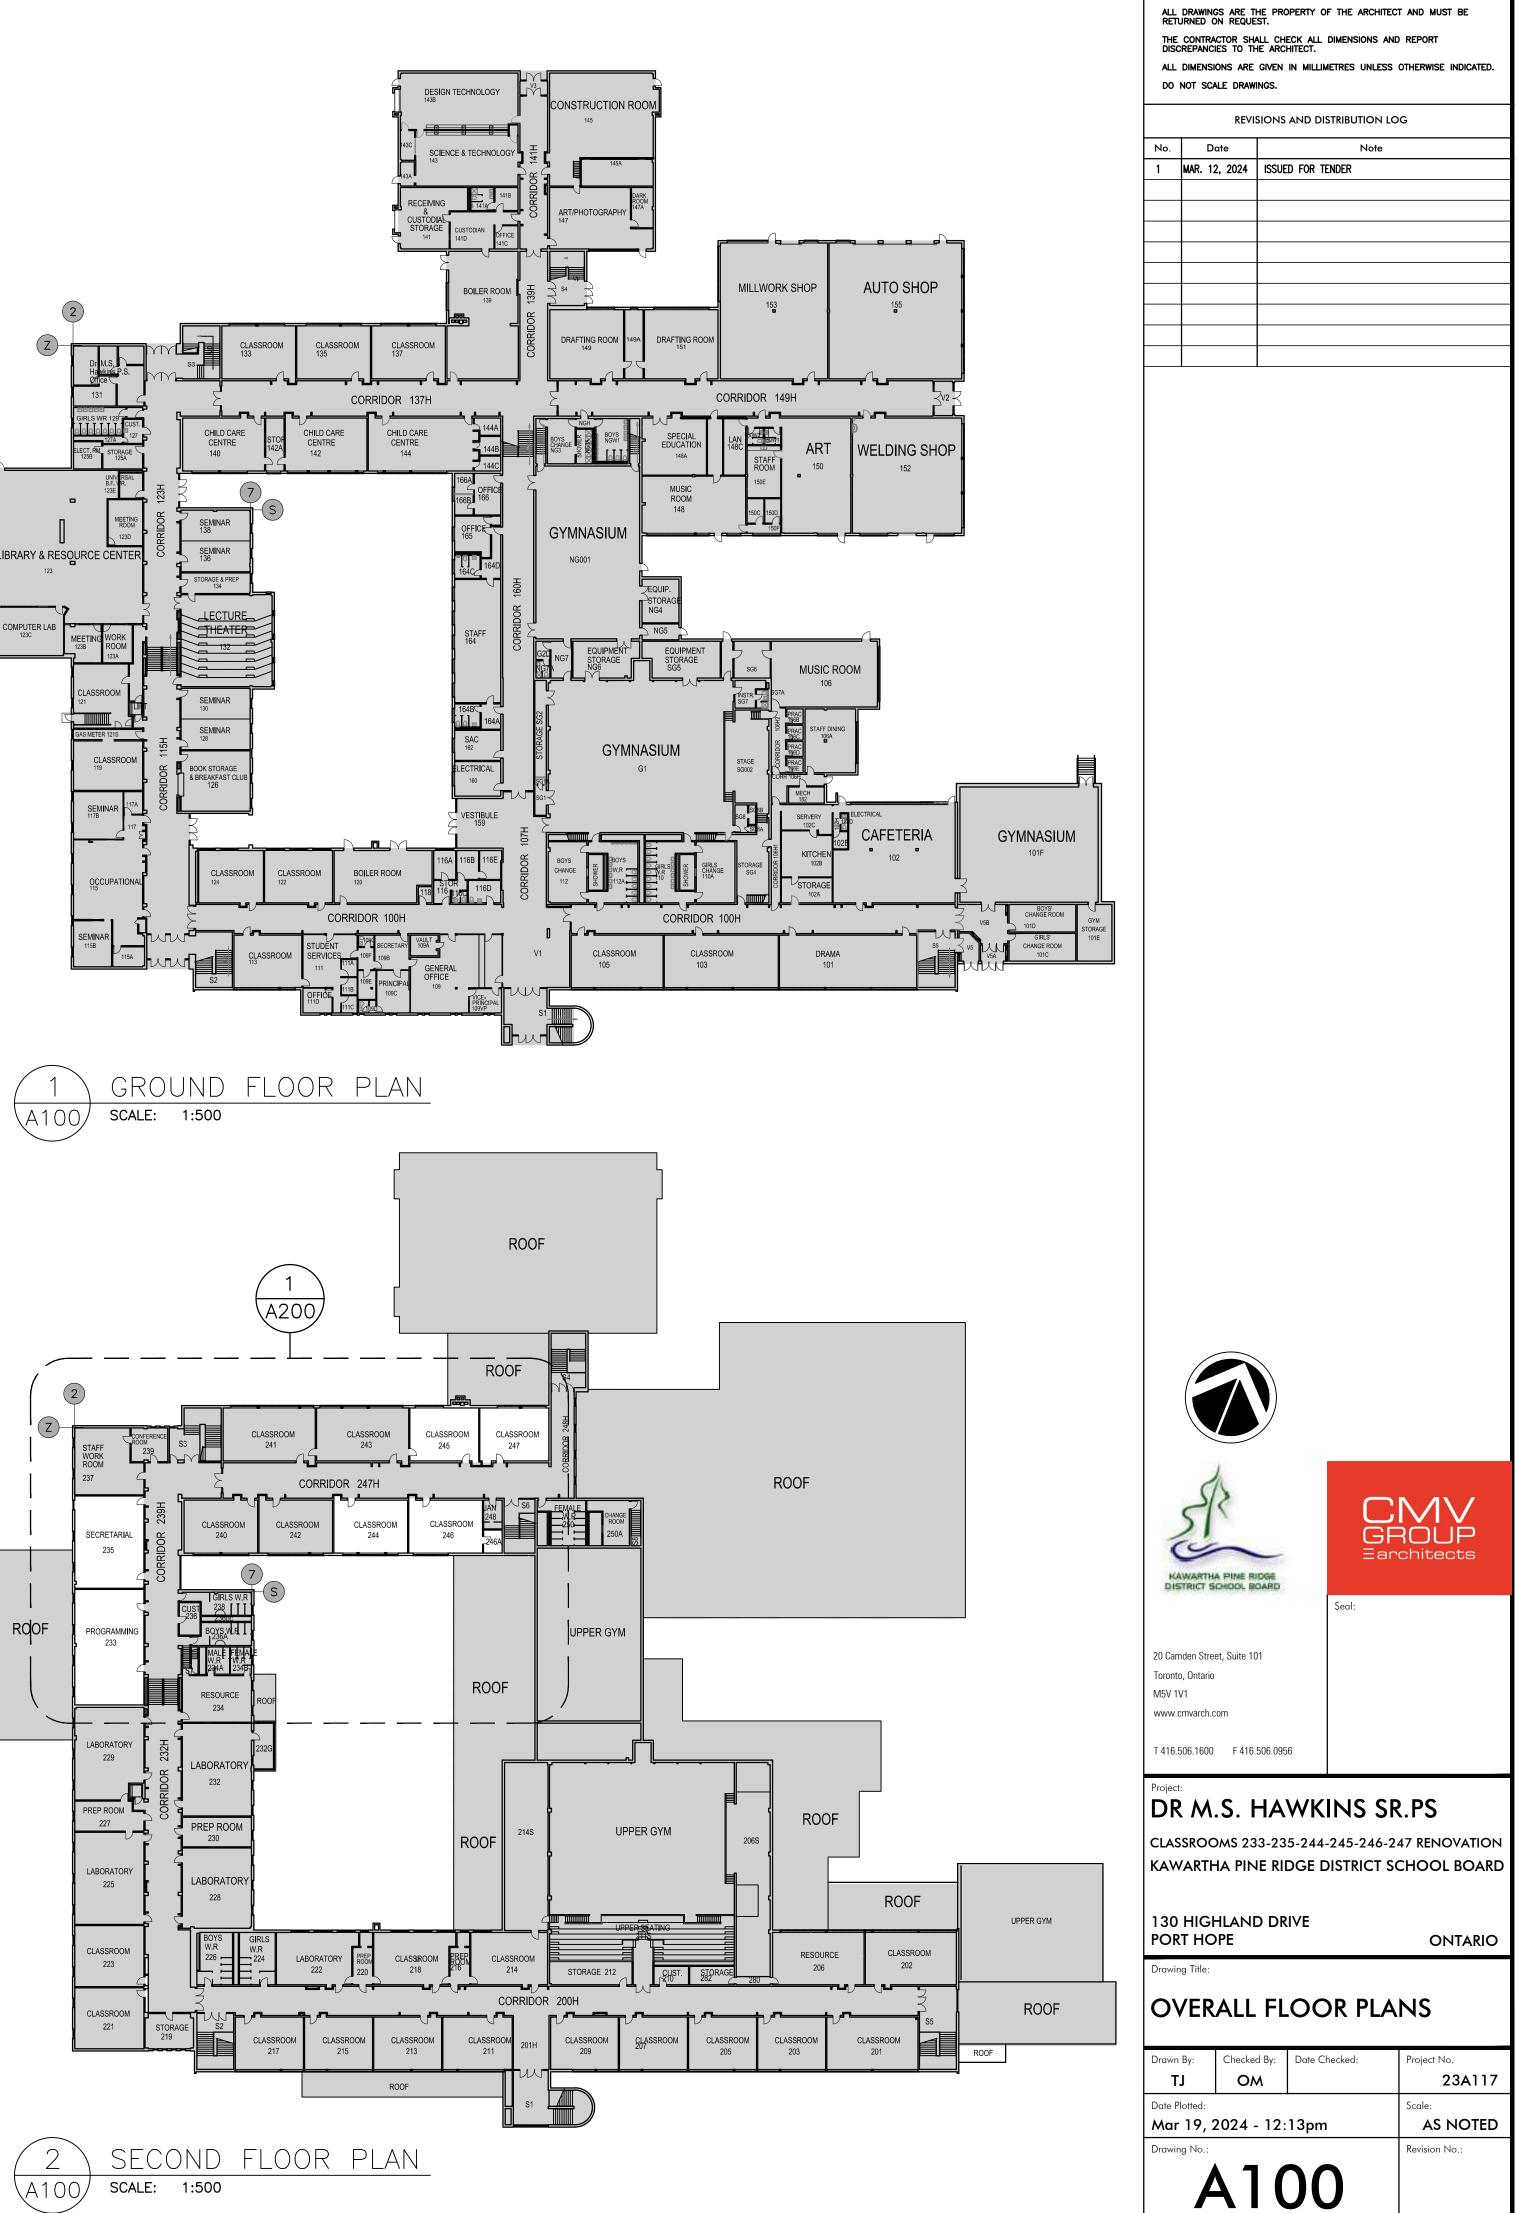

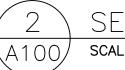


$\underbrace{(1,)}_{i}$ ALL FURNITURE TO BE REMOVED BY OWNER.	(25) NEW LVT FLOORING: HIGH PERFORMANCE LUXURY VINYL TILE (LVT) FLO INTERFACE STUDIO SET, CLASS III PRIMED, COMMERCIAL GRADE, FINISH
(2.) REMOVE AND DISPOSE OF EXISTING FLOOR TILES AND RESILIENT WALL BASE INCLUDING ALL ADHESIVES. PATCH AND MAKE GOOD CONCRETE SLAB AND WALLS TO RECEIVE NEW FLOORING AND NEW WALL BASE. PROVIDE	CERAMOR, SLIP RETARDANT, 250MM X 1000MM X 4.5MM. PROVIDE AC BAND & NEW RESILIENT TRANSITION STRIP. PROVIDE SELF-LEVELING UNDERLAYMENT AS REQUIRED. MEET OR EXCEED SUBSTRATE REQUIREM
SELF-LEVELING UNDERLAYMENT AS REQUIRED. MEET OR EXCEED SUBSTRATE REQUIREMENTS FOR CONCRETE SLAB AND WALLS AND PARTITIONS AS SPECIFIED IN THE FLOORING AND WALL BASE	FOR CONCRETE SLAB AS SPECIFIED IN THE FLOORING SPECIFICATION SI SUB-FLOOR SHALL COMPLY TO ASTM F 710 STANDARD PRACTICE FOR PREPARING CONCRETE FLOORS TO RECEIVE RESILIENT FLOORING. LVT
SPECIFICATION SECTIONS. SEE PINCHIN REPORT.	FLOORING SHALL BE EXTENDED BELOW BOOKSHELVES/CABINETS MILLWO CLOSET AND EXTG RADIATORS. GC TO SUBMIT 3 SAMPLES FOR ACCENT
(2A) GC TO REMOVE EXISTING METAL CAP AND EMBEDDED PIPE IN ORDER TO PROVIDE FLUSH SURFACE FOR NEW FLOORING. TYPICAL OF 36 LOCATIONS. PATCH AND REPAIR CONCRETE SLAB WITH SELF LEVELLING COMPOUND.	STRIPE/BORDER AND 3 SAMPLES FOR FLOORING, GC TO PROVIDE INSTALLATION METHODS MOCK UP FOR REVIEW & APPROVAL. PROVIDE YEAR STANDARD LVT WARRANTY- REFER TO A501 FOR FLOOR PATTERN
SEE SPECIFICATIONS. MAKE CONCRETE SLAB READY FOR NEW FLOORING AS PER MANUFACTURERS REQUIREMENTS. TYPICAL	A801 FOR FINISH SCHEDULE AND SPECIFICATION (26) EXISTING WINDOW FRAME TO REMAIN. PATCH, SAND REPAIR, AND PAIN
(3.) REMOVE & DISPOSE EXISTING WALL-MOUNTED WHITEBOARDS, CHALKBOARDS AND TACKBOARDS. PATCH AND MAKE GOOD WALLS BEHIND READY FOR PAINT. SEE PINCHIN REPORT.	FRAMES REMOVE DIRT AND DEBRIS FROM THE WINDOW FRAME AND GL WASH, CLEAN, AND REMOVE OXIDATION FROM FRAME. REMOVE EXTG CAULKING, RE-CAULK AROUND FRAMES. MAKE GOOD FRAMES SO THAT
(4.) REMOVE AND DISPOSE OF EXISTING DOOR AND HARDWARE. EXISTING FRAME TO REMAIN. SAND, REPAIR AND REPAINT. REMOVE ROOM/DOOR	GLASS AND FRAME LOOK AS NEW.
SIGNS. REMOVE AND REPLACE EXTG CAULKING ON DOOR FRAME. PATCH, MAKE GOOD SURROUNDING CONC BLOCK WALL, OR PARTITIONS TO MATCH	(27) NEW RUBBER BASE, 102MM X 3MM THICK RUBBER COVE BASE SEE SPECIFICATION. PROVIDE SELF-LEVELLING UNDERLAYMENT AS REQUIRED.
EXTG CONDITION, READY FOR PAINT, SEE PAINT SCHEDULE.	OR EXCEED SUBSTRATE REQUIREMENTS FOR WALLS AND PARTITIONS AS SPECIFIED IN THE WALL BASE SPECIFICATION SECTION.
6. REMOVE AND DISPOSE OF EXISTING MILLWORK, SHELVING AND CABINETS. PATCH AND MAKE GOOD WALLS TO RECEIVE NEW WALL PAINT & WALL	(28) EXISTING DUCTWORK TO REMAIN. THOROUGHLY CLEAN THE SURFACES THE EXISTING DUCTWORK TO REMOVE ANY DUST, DIRT OR LOOSE PAR SAND AND PAINT ALL THE SURFACES. SEE MECHANICAL DRAWINGS.
BASE. $(7.)$ EXISTING PROJECTOR & SCREEN: WALL/CEILING MOUNTED PROJECTOR AND	(29) 1HR FIRE SEPARATION ENCLOSURE, EXTG CONC BLOCK WALL OR EXTG, DW PARTITION: ENCLOSING WALLS ARE REQUIRED TO HAVE A MIN 1HR
CONTROLS TO BE REMOVED BY OWNER'S IT REPRESENTATIVE PRIOR TO SCOPE OF THIS WORK. THIS SCOPE TO PATCH AND MAKE GOOD WALLS, CEILING, SLAB AND FLOORING. SEE ELECTRICAL DRAWINGS.	FIRE-RESISTANCE RATING. EXISTING & NEW HOLES SHALL BE PATCHED REPAIRED AND SEALED WITH MIN 1HR FRR FIRE STOPPED / CAULKING
8.) EXTG CONC BLOCK WALL. REMOVE ABANDONED/OLD CONDUITS, ELEC.	THAT THE INTEGRITY OF THE FIRE SEPARATIONS IS MAINTAINED THROUG APPLY FIRESTOP BELOW THE ROOF DECK AT TOP OF EXTG CONC BLOO WALL ALONGSIDE OF THE CORRIDOR. DETAILS TO COMPLY WITH ULC
ITEMS, OLD CLOCKS, BRACKETS, SUPPORTS, RAILS, HOOKS, PINS AND ALL REMAINING EXTRA ITEMS. FIX & REPAIR CRACKS & JOINTS. FILL EXTG. HOLES, REPAINT THE WALL OVER EXISTING OLD PAINT, SEE PINCHIN	STANDARDS, PROVIDE SHOPDWG. FILL EXTG & NEW OPENINGS TO MAIN EXTG FIRE SEPARATION, COMPLY TO ULC RELATED DESIGN NO. AND TO SATISFY BUILDING INSPECTION.
REPORT, EPOXY, GLUE, ADHESIVE & ETC FROM WALLS. PREPARE WALL SURFACE TO ACCEPT NEW PAINT. PATCH & REPAIR ANY DAMAGES CAUSED BY DEMOLITION. MAINTAIN EXISTING FIRE RATING SEPARATION.	30) RESERVED.
TYPICAL 9.) EXISTING UNIT VENTILATORS TO REMAIN, AND TO BE CLEANED PRIOR TO	(31) NEW PAINT/ REPAINT INTERIOR WALLS, BULKHEADS, DOOR FRAMES, WAI COVERS, UNIT VENTILATOR COVERS, OLD AND NEW METAL CAPS. PROVID PAINT FINISH ON ALL INTERIOR PAINTABLE SURFACES, MAKE ALL THE FI
PAINTING. EXISTING FLOORING AND WALL BASE TO BE REMOVED UNDER AND AROUND UNIT VENTILATORS AND TO DOOR THRESHOLDS. TYP.	GOOD. SEE FINISH ON ALL INTERIOR PAINTABLE SURFACES, MAKE ALL THE FI GOOD. SEE FINISH SCHEDULE AND SPECIFICATION. PRIME AND PAINT AL SURFACES OVER THE OLD PAINTING. SEE PINCHIN REPORT.
REPAINT EXTG UNIT VENTILATORS ENCLOSURE.	32) RESERVED.
MILLWORK CABINET, PAPER TOWEL DISPENSER HAND SOAP DISPENSERS, AND OTHER ACCESSORIES. SEE MECHANICAL DRAWINGS FOR REMOVALS/MODIFICATIONS TO PLUMBING. WHERE WALLS AND SLABS ARE	(33) PATCH, REPAIR AND PAINT EXISTING FRAME OVER THE OLD PAINT. SEE PINCHIN REPORT. SUPPLY & INSTALL NEW DOOR WITH NEW HARDWARE DOOR NUMBER/ROOM NAME SIGN. (CONFIRM DIMENSIONS ON SITE PRIC
DAMAGED BY THE REMOVALS, PATCH AND MAKE GOOD WITH LIKE ASSEMBLIES, MATERIALS AND FINISHES. FLOOR SLAB AND WALL PATCHES TO BE SMOOTH, LEVEL AND PLUMB. SEE PINCHIN REPORT.	ORDERING). SEE DOOR SCHEDULE, SIGNS DETAIL AND SPECIFICATION. G REMOVE AND REPLACE EXTG CAULKING ON DOOR FRAME
1. REMOVE AND DISPOSE CLOSETS ENTIRELY INCLUDING DOORS, FRAMES SHELVES AND HARDWARE GC TO REMOVE EXTG CAULKING ON DOOR	34 SUPPLY AND INSTALL NEW DOOR AND FRAME AND HARDWARE. CONFIRM DIMENSIONS ON SITE. SEE DOOR SCHEDULE AND SPECIFICATION. GC TO
FRAME. (12.) EXISTING ELECTRICAL PANEL, REPAINT OR PROVIDE NEW COVER. REFER TO	PROVIDE NEW CAULKING ON DOOR FRAME (35) WINDOWS AND NEW BLINDS: REMOVE DIRT AND DEBRIS FROM WINDOW
ELEC. DWG.	AND GLASSES, WASH, CLEAN, REMOVE OXIDATION FROM ALUMINUM FRAM CHECK OPENING HARDWARE AND REPLACE IT. REMOVE EXTG CAULKING, RE-CAULK AROUND FRAMES INTERIOR SIDE ONLY. MAKE GOOD ALUMINU
(13.) REMOVE AND DISPOSE OF EXISTING PA SPEAKER PHONE, CALL SWITCH, AND BACKBOARD. SEE ELECTRICAL DRAWINGS.	WINDOWS & FRAME SO THAT GLASS AND FRAME LOOK AS NEW. SUPPL' INSTALL NEW BLINDS TO KPRDSB STANDARDS. PROVIDE CUTSHEET & SAMPLES.
(14) FOR HEAT AND SMOKE DETECTORS REFER TO MECH. AND ELEC. DRAWINGS.	(36) EXISTING HM/SCW DOOR, FRAME AND HARDWARE TO REMAIN. EXERCISE CAUTION TO AVOID ANY DAMAGE TO DOOR AND ITS COMPONENTS. IN EV
(15.) REMOVE TRIM AT WINDOW SILL AND REPLACE WITH NEW. (16.) REMOVE AND DISPOSE EX. LIGHT FIXTURES, EX. MECH. VENTS, DIFFUSERS,	OF ANY DAMAGE, GC TO PROMPTLY PATCH, PAINT AND REPAIR ANY DAM DONE TO THE DOOR OR ITS COMPONENTS AND RESTORE THEM TO THE
AIR SUPPLY GRILLES AND ALL CEILING MOUNTED ITEMS. EXISTING CONDUITS OR PIPING SUSPENDED FROM CEILING SLAB AT HIGH LEVEL TO REMAIN UNLESS NOTED OTHERWISE. SEE MECH. & ELEC. DRAWINGS. SITE	ORIGINAL CONDITION AT THEIR OWN COST. (37) PROVIDE NEW VENTILATION GRILLE CONTINUES AT TOP & BASE OF MIL
VERIFY QUANTITIES AND EXTENT.	\sim REFER TO SPEC & MECH. DWG. SUBMIT CUTSHEET FOR APPROVAL.
SYSTEM INCLUDING TILES, GYPSUM BOARD, FURRING CHANNELS, HANGERS AND EX. LIGHT FIXTURES, MECH DIFFUSERS, VENT AND ALL CEILING	INCLUDING TEACHER CLOSETS, BOOKCASE UNITS, SHELVING UNITS, CABIL AND SO ON c/w 19MM ADJUSTABLE SHELVES. GC TO REVIEW EXISTING RADIATOR & PLUMBINGS CONTROLS. LOCATE CONTROL AND COORDINATE
MOUNTED ITEMS UNLESS NOTED OTHERWISE. SEE MECH. AND ELEC. DRAWINGS. SEE PINCHIN REPORT.	MILLWORK. PROVIDE AN ACCESS PANEL IN THE MILLWORK IN ORDER TO ACCESS TO CONTROL FOR FURTHER MAINTENANCE. PNEUMATIC VALVE REMOVAL BY APS, NEW ELECTRIC CONTROLS CONNECTED TO BAS, SEE
(18.) REMOVE AND REPLACE WOODEN WINDOW VALENCE & SILL BOARDS. SEE A800 DRAWING.	AND ELECT. DWGS.SEE A500 SERIES DRAWING, SEE SPEC, PROVIDE SHO & MOCK UP.
(19.) EXISTING WI-FI APS TO BE REMOVED BY THIS CONTRACTOR, PRIOR TO DEMOLITION, AND KEEP SAFE UNTIL END OF CONSTRUCTION AND REINSTALLED IN THE EXACT SAME ROOM TO NEW LAYOUT CENTERED IN	(39) ARCHITECTURAL MILLWORK: NEW COAT HOOKS. SEE A800 SERIES SEE PROVIDE SHOPDWG.
NEW CEILING. GC ELECTRICIAN TO COORDINATE WITH ELEC CONSULTANT.	(40) NEW SINK, COUNTERTOP & MILLWORK CABINETS, SEE A300 & A500 S SEE SPECIFICATIONS.
(20) REMOVE EXTG WALL/TRIM AT LOCATION OF EXTG UNIT VENTILATORS. PROVIDE CLEAR SPACE FOR INSTALLATION OF NEW MILLWORK WITH NEW AIR GRILLES. CLOSE ADJACENT OPENINGS & HOLES. INSTALL 16MM	41) NEW 1HR FFR T-BAR CEILING c/w NEW LIGHT FIXTURES, DIFFUSERS, S MECH & ELEC DWGS. 1HR FIRE RATED CEILING TO COMPLY WITH ULC
DRYWALL ENCLOSURE ON 92MM ST STUD IF REQ'D.	 – 610MM X 1220MM, MIN. NRC OF .70, CAC MIN. 40, FIRE GUARD; C RADAR HIGH NRC/CAC PANELS 22541 OR ARMSTRONG SCHOOL ZONE F
(21) EXISTING DUCTWORK AND ACCESS PANELS TO REMAIN. REFER TO MECHANICAL DRAWING.	FISSURED 1811. LAY IN EXPOSED TEE SYSTEM "DX" 24MM WIDE FACED T-BAR BY CGC OR SUSPENSION SYSTEM EQUIVALENT GRID BY CHICAGO METALLIC, OR ARMSTRONG WITH COMPATIBILITY CEILING TILES. GRID IS
(22) EXISTING GLASS AND HOLLOW METAL FRAME TO REMAIN.	ALL TILE AND SUSPENSION SYSTEMS SHALL BE FIRE RATED TO CONFOR U.L.C. DETAIL P210. SOUND ABSORPTIVE PREFABRICATED ACOUSTICAL UI SHALL COMPLY TO CAN/CGSB 92.1. PROVIDE LAYOUT SHOPDWG AND
23) EXISTING RADIATOR TO REMAIN, AND TO BE CLEANED PRIOR TO PAINTING.	SAMPLES. (42) NEW DW BULKHEAD & CEILING- PAINTED, INSTALLED ON SHAFTWALL S
AROUND RADIATOR AND TO DOOR THRESHOLDS. TYP. REPAINT EXTG RADIATOR ENCLOSURE.	SUPPORTS. GC TO PROVIDE MINIMUM 1 HOUR FIRE SEPARATION c/w FIRESTOPS, CAULKING & SMOKE SEAL. PROVIDE P-ENG STAMPED SHOP FOR STEEL STUD FRAME. TYP.
(24) EXISTING DRYWALL TO REMAIN. REMOVE ABANDONED/OLD CONDUITS, ELEC ITEMS, OLD CLOCKS BRACKETS, SUPPORTS, RAILS HOOKS. GC TO PATCH,	(43) RESERVED.
REPAIR ANY DAMAGES AND HOLES CAUSED BY DEMOLITION AND PAINT THE DRYWALL OVER EXISTING PAINT TO MAKE IT GOOD AS NEW. MAINTAIN EXTG. FIRE RATING THROUGHOUT THE WALL. TYPICAL. SEE PINCHIN	44) CLEAN CEILING AREA THROUGHOUT INCLUDING STRUCTURE, DECKING, AND MECH ITEMS. REMOVE DIRT, DUST AND AIRBORNE CONTAMINANTS,
REPORT.	POSSIBLE MOLD AND MILDEW. PAY CLOSE ATTENTION TO ELECTRICAL CONDUITS, CONNECTIONS AND FIXTURES. REPAIR CEILING AND DECK OP AFTER REMOVAL OF OLD ELECTRICAL & MECHANICAL, LIGHT FIXTURES,
	DUCTWORK, DIFFUSERS, PLUMBING PENETRATIONS. PROVIDE FIRE STOP OPENINGS TO MAINTAIN 1HR FIRE SEPARATION.
	SPECIALTIES, EQUIPMENT & ACCESSORIES
	(45) SUPPLY AND INSTALL SCHOOL CONTROL PANEL C/W CLOCK, THERMOS LIGHT SWITCHES, PA CALL SWITCH, PA SPEAKER, DUPLEXES, FIREALARM PROVISION FOR SPACE SENSOR. STANDARD COLOUR CHOSEN BY ARCHIT
	PROVIDE SHOPDWG. SEE ELECTRICAL DRAWINGS. CLOCKS TO BE BATTER OPERATED, RO UND, SIMPLEX, TO FIT WITHIN THE SPACE AVAILABLE. CONTROL PANEL TO BE SUPPLIED AND INSTALLED BY ELEC CONTRACTO
	(46) SUPPLY AND INSTALL NEW WALL-MOUNTED INTEGRATED INTERACTIVE BC
	 DA-LITE IDEA SCREEN COMBINATION PROJECTION SCREEN AND WRITABLE MARKER BOARDS AS MANUFACTURED BY DA-LITE (1800-622-3737). 1 (H) X 2170 (W) C/W CONTROLS. INSTALL ON STEEL BRACKETS BOLTED
	PROVIDE SUPPORTS PER MANUFACTURER GUIDELINE. OWNER WILL REMO EXISTING INTEGRATED INTERACTIVE BOARDS, GC TO SUPPLY AND INSTALL SEE SPECIFICATION. SEE ARCH FLOOR PLAN & ELECTRICAL DRAWINGS.
	TYPICAL.
	(47.) NEW WALL-MOUNTED MAGNETIC WHITE BOARD MANUFACTURED BY ARCHITECTURAL SCHOOL PRODUCTS OR EQUIVALENT PRODUCTS AS SUP BY GLOBAL SCHOOL PRODUCTS INC. PROVIDE SUPPORTS. C/W CLEAR
	· · ·
	ANODIZED ALUMINUM FRAME. MAP RAIL WITH CORK INSERT, REQ'D DIV STRIP AND MARKER/CHALK TRAY. INSTALL MAP RAIL OVER MARKER BOA SUBMIT SD.

- (49) CABINET UNIT HEATER: CLEAN AND COMB EXISTING CABINET UNIT HEATER, WALLFIN AND COVERS. REPAIR DAMAGED/DEFORMED CABINET UNIT HEATER COVERS OR PROVIDE NEW COVERS, GC TO SITE VERIFY CONDITIONS. FIX & FLOORING, FASTEN LOOSE COVER PARTS. REPAIR DENTS & SCRATCHES, APPLY NEW PAINT ON ENTIRE CABINET UNIT HEATER COVERS. PANT COLOUR TO MATCH ACCENT BIRCH MILLWORK. GC TO COORDINATE WITH MILLWORK SUPPLIER TO PROVIDE ACCESS DOOR TO ALL VALVES & CONTROLS AND MATCHING PAINT COLOUR. REMENTS PROVIDE 3 SAMPLE COLOURS FOR REVIEW& APPROVAL. ALL CONTROLS SHALL SECTION. TIE INTO THE BAS. SEE MECH DWG. 50) UNIT VENTILATORS: CLEAN AND COMB EXISTING UNIT VENTILATORS, WALLFIN AND COVERS. REPAIR DAMAGED/DEFORMED UNIT COVERS OR PROVIDE NEW COVERS, GC TO SITE VERIFY CONDITIONS. FIX & FASTEN LOOSE COVER PARTS. REPAIR DENTS & SCRATCHES, APPLY NEW PAINT ON ENTIRE UNIT ERN , AND COVERS. PANT COLOUR TO MATCH BIRCH MILLWORK. GC TO COORDINATE WITH MILLWORK SUPPLIER TO PROVIDE ACCESS DOOR TO ALL VALVES & CONTROLS AND MATCHING PAINT COLOUR. PROVIDE 3 SAMPLES COLOUR FOR REVIEW& PAINT ALL APPROVAL. ALL CONTROLS SHALL TIE INTO THE BAS. SEE MECH DWG. GLASSES, (51.) RADIATOR: CLEAN AND COMB EXISTING RADIATOR, WALLFIN AND COVERS. REPAIR DAMAGED/ DEFORMED RADIATOR COVERS OR PROVIDE NEW COVERS. GC TO SITE VERIFY CONDITIONS. FIX & PAINT ON ENTIRE RADIATOR. PAINT COLOUR TO MATCH BIRCH MILLWORK. GC TO COORDINATE WITH MILLWORK SUPPLIER TO PROVIDE ACCESS DOOR TO ALL VALVES & CONTROLS AND MATCHING PAINT COLOUR. PROVIDE 3 SAMPLE COLOURS FOR REVIEW & RED. MEET APPROVAL. ALL CONTROLS SHALL TIE INTO THE BAS. SEE MECH. DWGS. (52) ALL EXISTING LIGHT FIXTURES TO REMAIN. SEE ELECTRICAL DRAWINGS.
- PARTICLES. (53) NEW LIGHT FIXTURE SHALL COMPLY TO REQUIREMENT OF INCENTIVE PROGRAM. ROWS OF LIGHTS. COORDINATE W ELEC ENG.
 - (54) NEW MECH DIFFUSER AND GRILLE SEE MECH DWG
 - (55) PROVIDE S.S. CUSTOM SIZED COVER PLATE ON ABANDONED ELEC OUTLET OPENING, AND AROUND DIFFUSES. ALL LOCATIONS NOT SHOWN ON THIS DWG. GC TO SITE VERIFY, TYPICAL.
 - (56) RESERVED.

- WALL FIN (57) PROVIDE NEW ACCESS PANEL, CONFIRM SIZES WITH MECH & ELEC. NOT SHOWN ON THIS DRAWING SET GC TO SITE VERIFY EXACT LOCATION. PAINTED OVIDE NEW FINISHES (58) PROVIDE NEW FIRE EXTINGUISHER, NOT SHOWN IN ARCH DWGS. SEE MECH DWG's
 - (59) COMPREHENSIVE FIRST AID KIT, SUPPLIED BY OWNER, INSTALLED BY GC. NOT SHOWN IN THIS SET. GC TO COORDINATE WITH OWNER FOR NO. & LOCATIONS.
 - 60, EXISTING COVER PLATES TO REMAIN. PROVIDE NEW LVT FLOORING IN AND AROUND THE EXISTING COVER PLATES. TYPICAL OF 6 COVER PLATES.

TYPICAL NOTES: (APPLY TO ALL DEMO & PROPOSED DWGS.)

- CONTRACTOR TO MAKE GOOD ALL FINISHES DISTURBED TO INSTALL ALL COMPONENTS UNDER THIS CONTRACT. REFER TO ARCH, STR, MECH & ELEC DRAWINGS.
- PROVIDE TEMPORARY HOARDING & DUST SCREENS AS REQUIRED TO COMPLETE WORK. MAINTAIN FIRE EXITS WHERE REQUIRED.
- 3. GC. TO ENSURE CONTINUITY OF VAPOUR BARRIER ON ANY HOLES OCCURRING THRU SUCH CEILING / WALL, VAPOUR BARRIERS FOR WIRES, PIPES, DUCTWORK, OR ELECTRICAL BOXES, VAPOUR BARRIER MUST BE TIGHTLY SEALED WITH TAPE, CAULKING OR OTHER SUITABLE MATERIAL. CONSULTANT TO REVIEW PRIOR TO INSTALLATION OF CEILING AND WALL BOARD.
- FIRE STOPPING OF SERVICE PENETRATIONS PIPING, TUBING, DUCTS, WIRING, CONDUIT, ELECTRICAL OUTLET BOXES THAT PENETRATE FIRE SEPARATIONS SHALL BE TIGHTLY FITTED AND SEALED WITH MINERAL WOOL, GYPSUM PLASTER OR PORTLAND CEMENT MATERIAL, AS PER APPROVED ULC DESIGN COMPONENTS. SUBMIT ULC RELATED DESIGN FOR CONSULTANT TO REVIEW PRIOR TO INSTALLATION AT FLOOR, CEILING OR WALL.
- MAINTAIN CONTINUITY OF FIRE SEPARATION BEHIND ALL RECESSED ELECTRICAL PANELS, AND F.E.C.
- 6. REMOVE & RESTORE OR REPLACE ALL CEILINGS AFFECTED BY ACCESS TO MECH. & SERVICES. SEE & ELECT. DWGS FOR EXTENT OF WORK.
- DISCONNECT OR RELOCATE ALL MECH. & ELECT. SERVICES LOCATED IN EXISTING CEILING, WHICH WILL BE COVERED BY NEW T-BAR OR DRYWALL CEILING.
- 8. PROVIDE STEEL ANGLE LINTELS OVER ALL NEW MECHANICAL DUCTS & GRILLES THAT PENETRATE EXISTING & NEW MASONRY WALLS.
- 9. WHERE EXISTING FLOORING FINISHES ARE REMOVED, ALLOW FOR PREPARATION OF SUBSTRATE SUITABLE FOR INSTALLATION OF NEW FINISHES AS PER MANUFACTURES REQUIREMENTS.

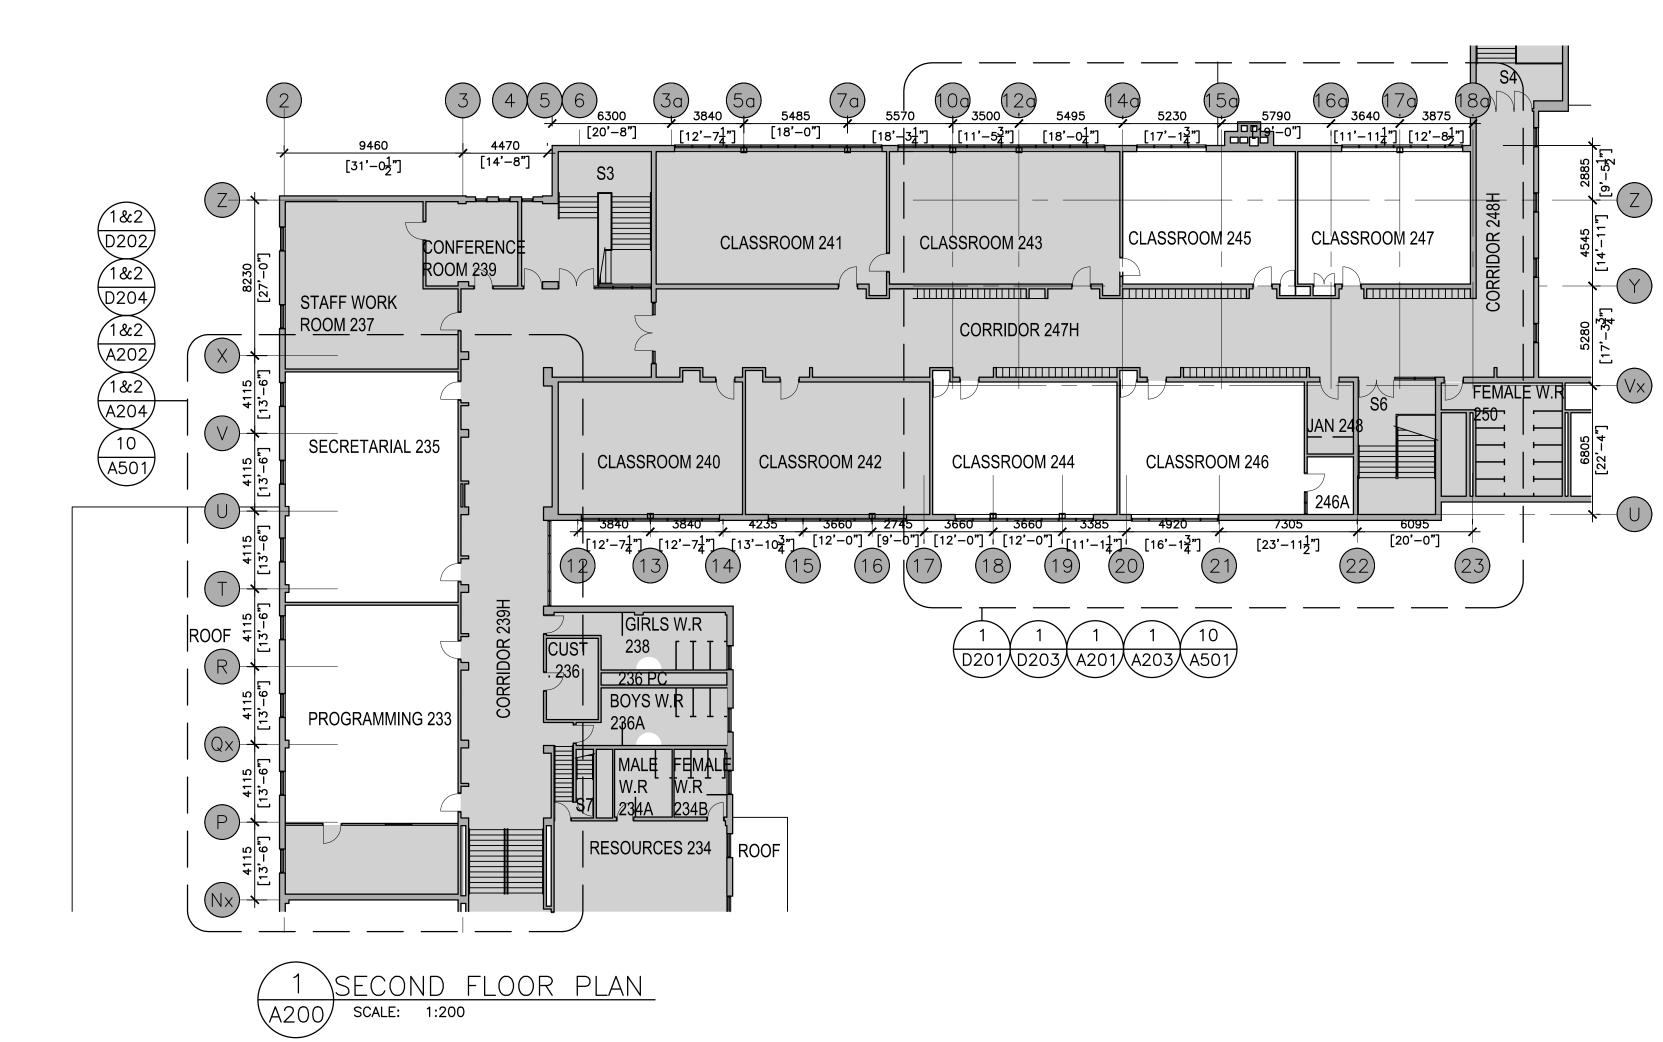

& PROPOSED DWG's:

- A. REFER TO SPECIFICATION
- B. THERE IS A TIMETABLE FOR THIS PROJECT. CONSTRUCTION MAY NEED TO BE SCHEDULED WITH ROTATIONAL SHIFTS, NIGHT SHIFTS AND OVER TIME WORK TO AVOID DISRUPTION TO SCHOOL TIME LIMIT. DEADLINES ARE STRICTLY ENFORCED. CONTRACTORS TO CONFIRM WITH PROJECT MANAGER/SCHOOL FOR
- START AND END OF EACH ACTIVITY BEFORE SUBMITTING THEIR PRICING PROPOSAL ACCURATE EXTENT OF DEMOLITION AND PATCH & REPAIR AREA TO BE SITE VERIFIED. SIZES SHOWN ON DWGS ARE ONLY GRAPHICS.
- CONTRACTORS TO SITE VISIT, EXAMINE CONDITIONS BEFORE PRICING. SEE SPECIFICATION AND SEPARATE REPORTS FOR SITE
- CONDITIONS & IDENTIFICATION INCLUDING HAZARDOUS BUILDING MATERIALS WITHIN THE PROJECT AREA, NOTES PROVIDED IN THIS SET OF DRAWINGS ARE FOR GENERAL REFERENCES ONLY. THE CONTRACTORS SHALL FULFILL THE REQUIREMENTS OF THE ONTARIO OCCUPATIONAL HEALTH AND SAFETY ACT AND OTHER REGULATIONS. CONTRACTOR SHALL READ AND FULLY UNDERSTAND ABOVE SPEC AND REPORTS PRIOR TO REMOVAL AND DISPOSAL OR DECONTAMINATION OF ALL MATERIALS
- PROVIDE DUST CONTROL MEASURES, SEAL ALL EXTG DUCTWORKS AND OPENINGS AND PROVIDE TEMPORARY EXHAUST PRIOR TO DEMOLITION & CONSTRUCTION.
- G. GC MUST SUPPORT THE OWNERS EFFORTS TO PURSUE THE INCENTIVE PROGRAM. TYPICAL AVAILABLE INCENTIVE LIST IS AS FOLLOWS: LIGHTING RETROFITS, LIGHTING CONTROLS, VFDS, COOLING, BOILER RETROFITS, DEMAND-CONTROLLED VENTILATION (CO2 SENSORS), DOMESTIC HOT WATER, HEAT/ENERGY RECOVERY EQUIPMENT, CONDENSING MAKEUP AIR UNITS. CONTRACTORS MUST PROVIDE THE REQUIRED INFORMATION, RECEIPTS, ETC. GC TO CONFIRM THAT SPECIFIED LIGHTING QUALIFIES FOR THE INCENTIVE, PROVIDE CUT-SHEETS.

GENERAL NOTES APPLY TO ALL DEMO

- H. PAINTING & REPAINTING: PREPARE SUBSTRATES 1 PAINT, INCLUDING SANDING, CLEANING, PATCHING, REMOVE, SCRAPE OFF, SAND OLD PAINT COATINGS CRACKS, SAND AND MAKE GOOD DAMAGED, DENT SCRATCHES. TEST OVER-COATABILITY/ RE-COATAB PRIME AND PAINT EXISTING AND NEW WALL. CEILIN FRAME SURFACES AS INDICATED, CLEAN UP. ON OLD STAIN COATING SHALL BE REMOVED COMPLE COATS OF URETHANE VARNISH OVER SEMI-TRANS ON WOOD DOOR. PAINT PREVIOUSLY PAINTED COM PIPING. PAINT FINISHES TO MATCH EXTG. PROVIDE MOCK UP /SAMPLES FOR BOTH WALL & DOOR PA
- PROVIDE SIGNAGE FOR EACH DOOR AND ROOM. ALL SIG WITH OWNER/SCHOOL CRITERIA & OBC. SUBMIT SIGNAGE PRIOR TO MANUFACTURE. SEE DETAIL A801.
- J. EXTEND FLOORING INTO ENTRY DOORS. PROVIDE FLUSH TRANSITION STRIP LOCATED AT LINE OF ENTRY DO
- LOCATION OF ALL MECHANICAL, PLUMBING, AND EI Κ. ROUGH-INS SHALL BE COORDINATED WITH MILLWO BEFORE INSTALLATION OF MECHANICAL, PLUMBING AND FABRICATION OF MILLWORK. PROVIDE SHOPDW ROUGH-INS /OPENINGS LAYOUT
- GENERAL CONTRACTOR TO INSTALL PAPER TOWEL FIRST AID KITS. CONFIRM LOCATION ON SITE WITH M. SUPPLY AND INSTALL NEW FLOOR FINISH BELOW UNITS. TYP.

O ACCEPT NEW	ALL DRAWINGS ARE THE PROPERTY OF THE ARCHITECT AND MUST BE RETURNED ON REQUEST. THE CONTRACTOR SHALL CHECK ALL DIMENSIONS AND REPORT
AND CAULKING. S. FILL, REPAIR SURFACES &	DISCREPANCIES TO THE ARCHITECT. ALL DIMENSIONS ARE GIVEN IN MILLIMETRES UNLESS OTHERWISE INDICATED.
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NDUITS AND E MULTIPLE	No. Date Note 1 MAR. 12, 2024 ISSUED FOR TENDER
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E SHOP DRAWING	
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WG FOR OTEMES	
DISPENSER & I OWNER.	LEGEND
NEW MILLWORK	(GRID)— EXISTING GRID TO REMAIN. (SHOWN TONED)
	EXISTING CONSTRUCTION TO REMAIN.
	NOTES APPLY TO ALL DEMOLITION & PROPOSED DRAWINGS INCLUDING
	MECHANICAL AND ELECTRICAL DRAWINGS.
	MECH & ELEC TRADES SHALL READ THE
	WHOLE SET TOGETHER BEFORE PRICING. GC
	REFER TO A100 FOR GENERAL NOTES.
	REFER TO A100 FOR REFERENCE/TAGS BEEER TO D201 D203 A201 A203 A500
	REFER TO D201, D203, A201, A203, A500 A800, FOR NOTES
	& A800 FOR NOTES • REFER TO A501 FOR FLOORING FINISH
	• REFER TO ASOT FOR FLOORING FINISH PATTERN
	DEMOLITION OF HAZARDOUS
	MATERIALS TYPICAL:
	G.C. TO REFER TO HAZARDOUS BUILDING MATERIALS
	ASSESSMENT REPORT ALONG WITH SPECIFICATIONS AND CONTRACT DOCUMENTS PREPARED BY PINCHIN REGARDING THE REMOVAL AND DEMOLITION OF
	HAZARDOUS MATERIALS.
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,	An
	GROUP Earchitects
)	KAWARTHA PINE RIDGE
	Seal:
	20 Camden, Suite 101
	Toronto, Ontario
	M5V 1V1 www.cmvarch.com
	T 416.506.1600 F 416.506.0956
	Project:
	DR MS HAWKINS SR.PS
	CLASSROOMS 233-235-244-245-246-247 RENOVATION
	KAWARTHA PINE RIDGE DISTRICT SCHOOL BOARD
	130 HIGHLAND DRIVE
	PORT HOPE ONTARIO
	Drawing Title: PARTIAL FLOOR PLAN
	Drawn By: Checked By: Date Checked: Project No. TJ OM 23A117

Date Plotted:


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A200


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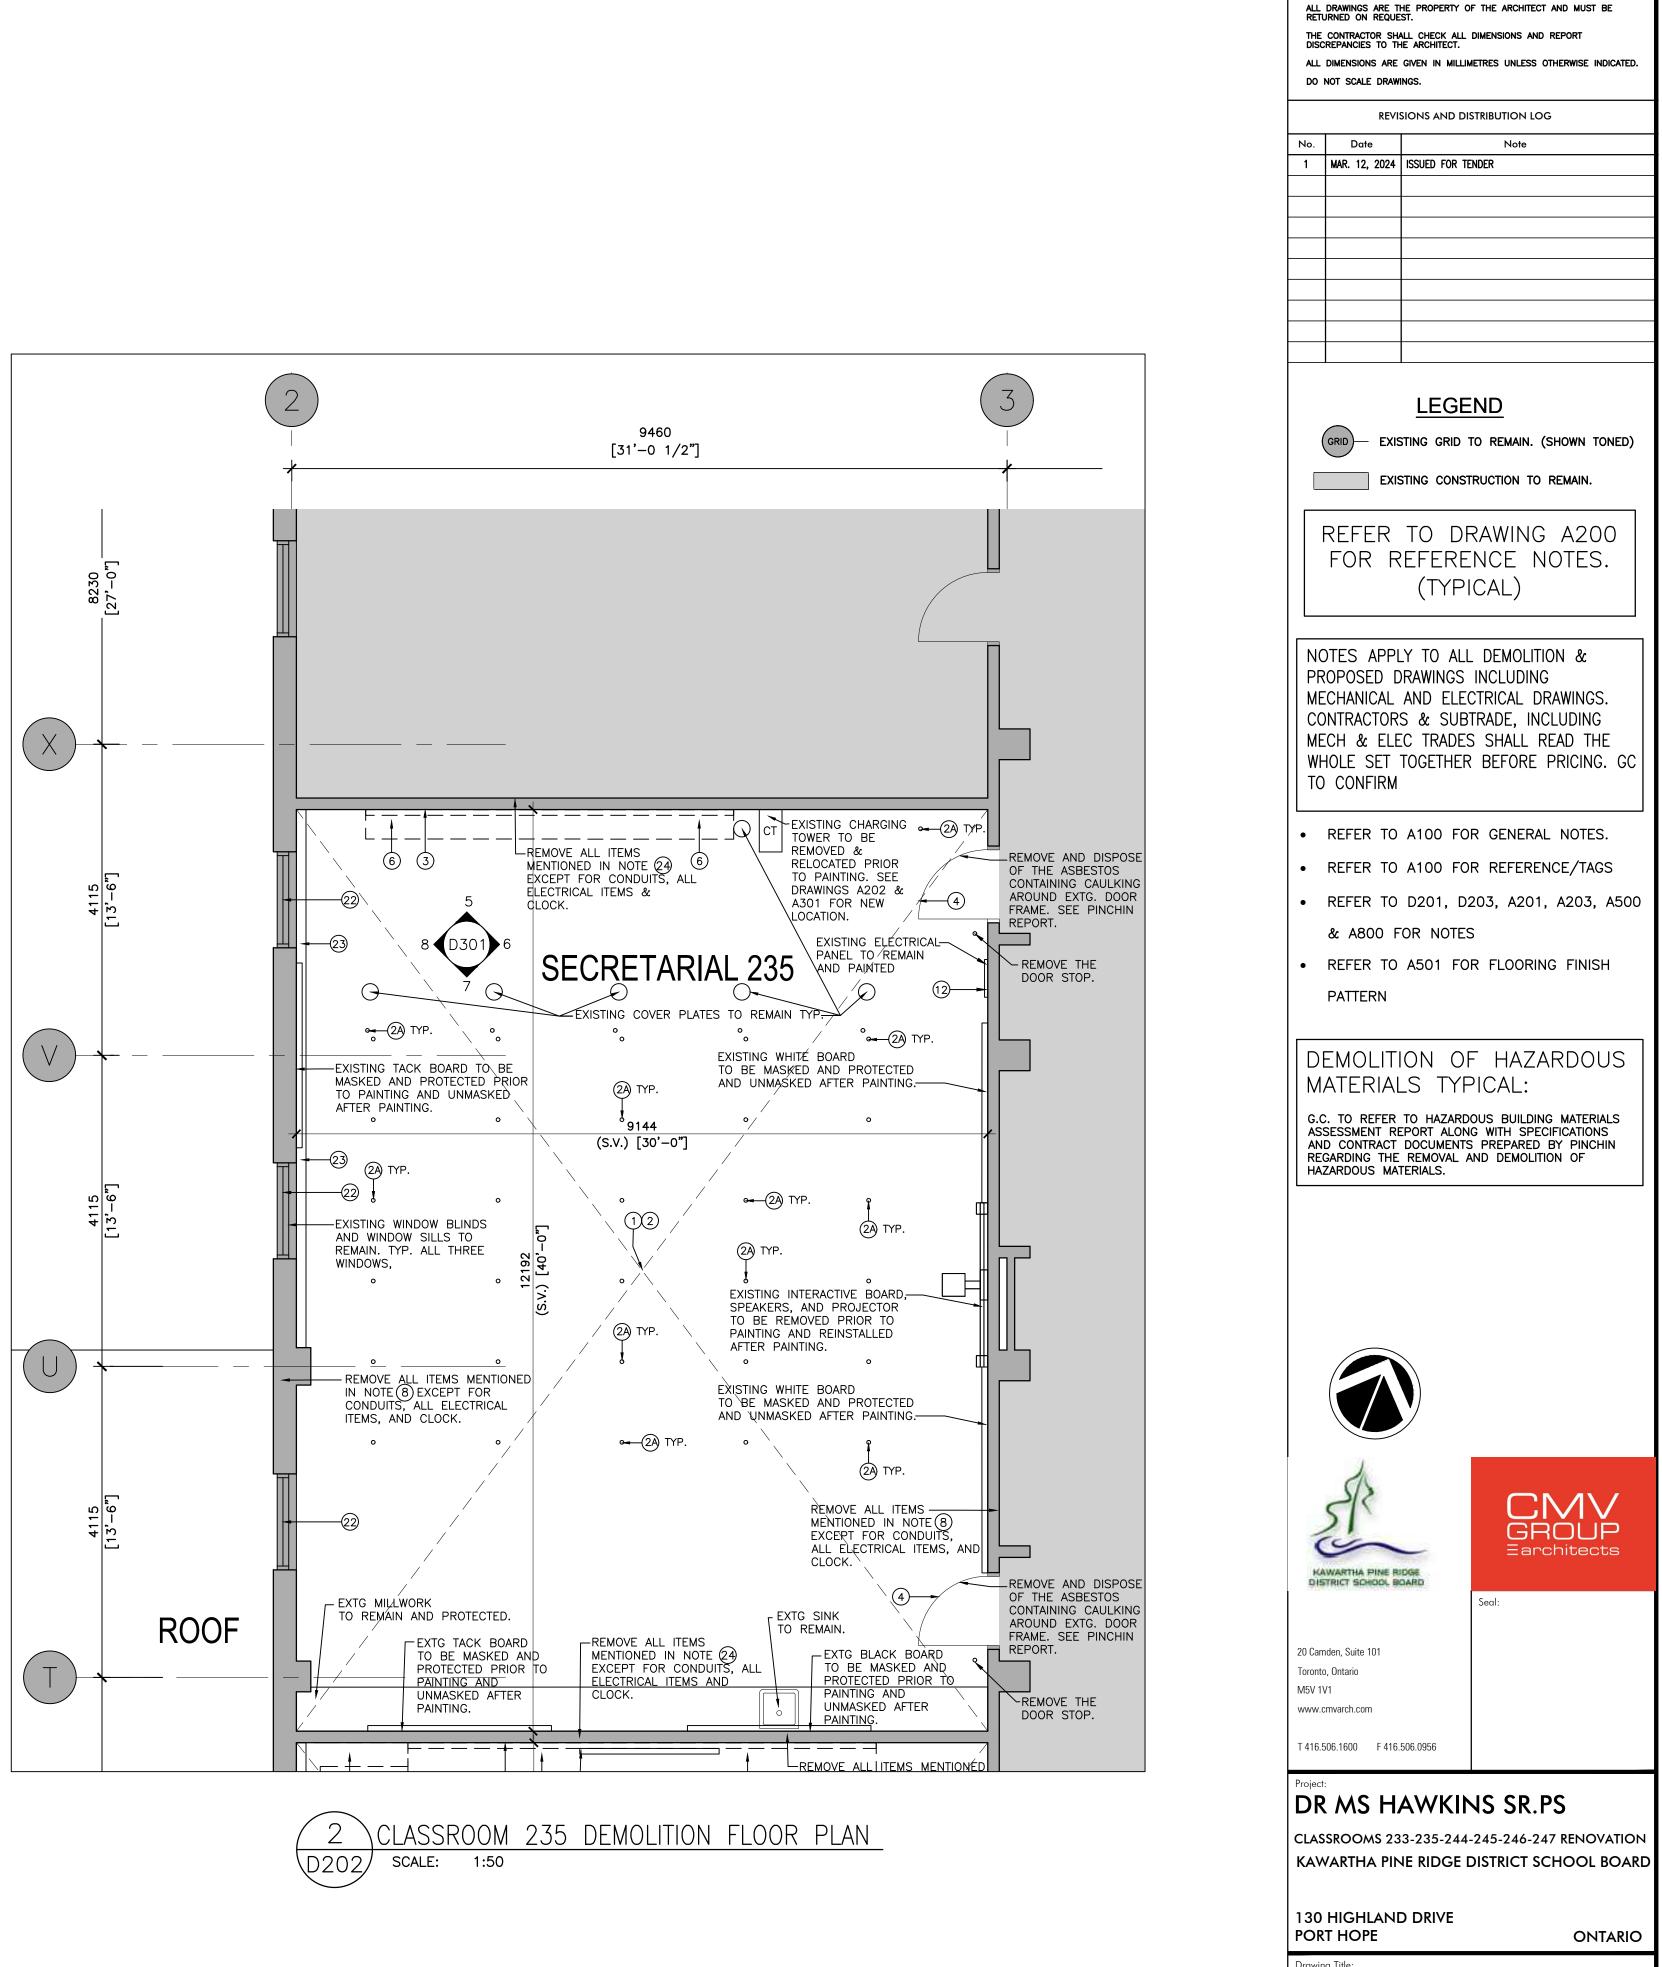
Revision No.:








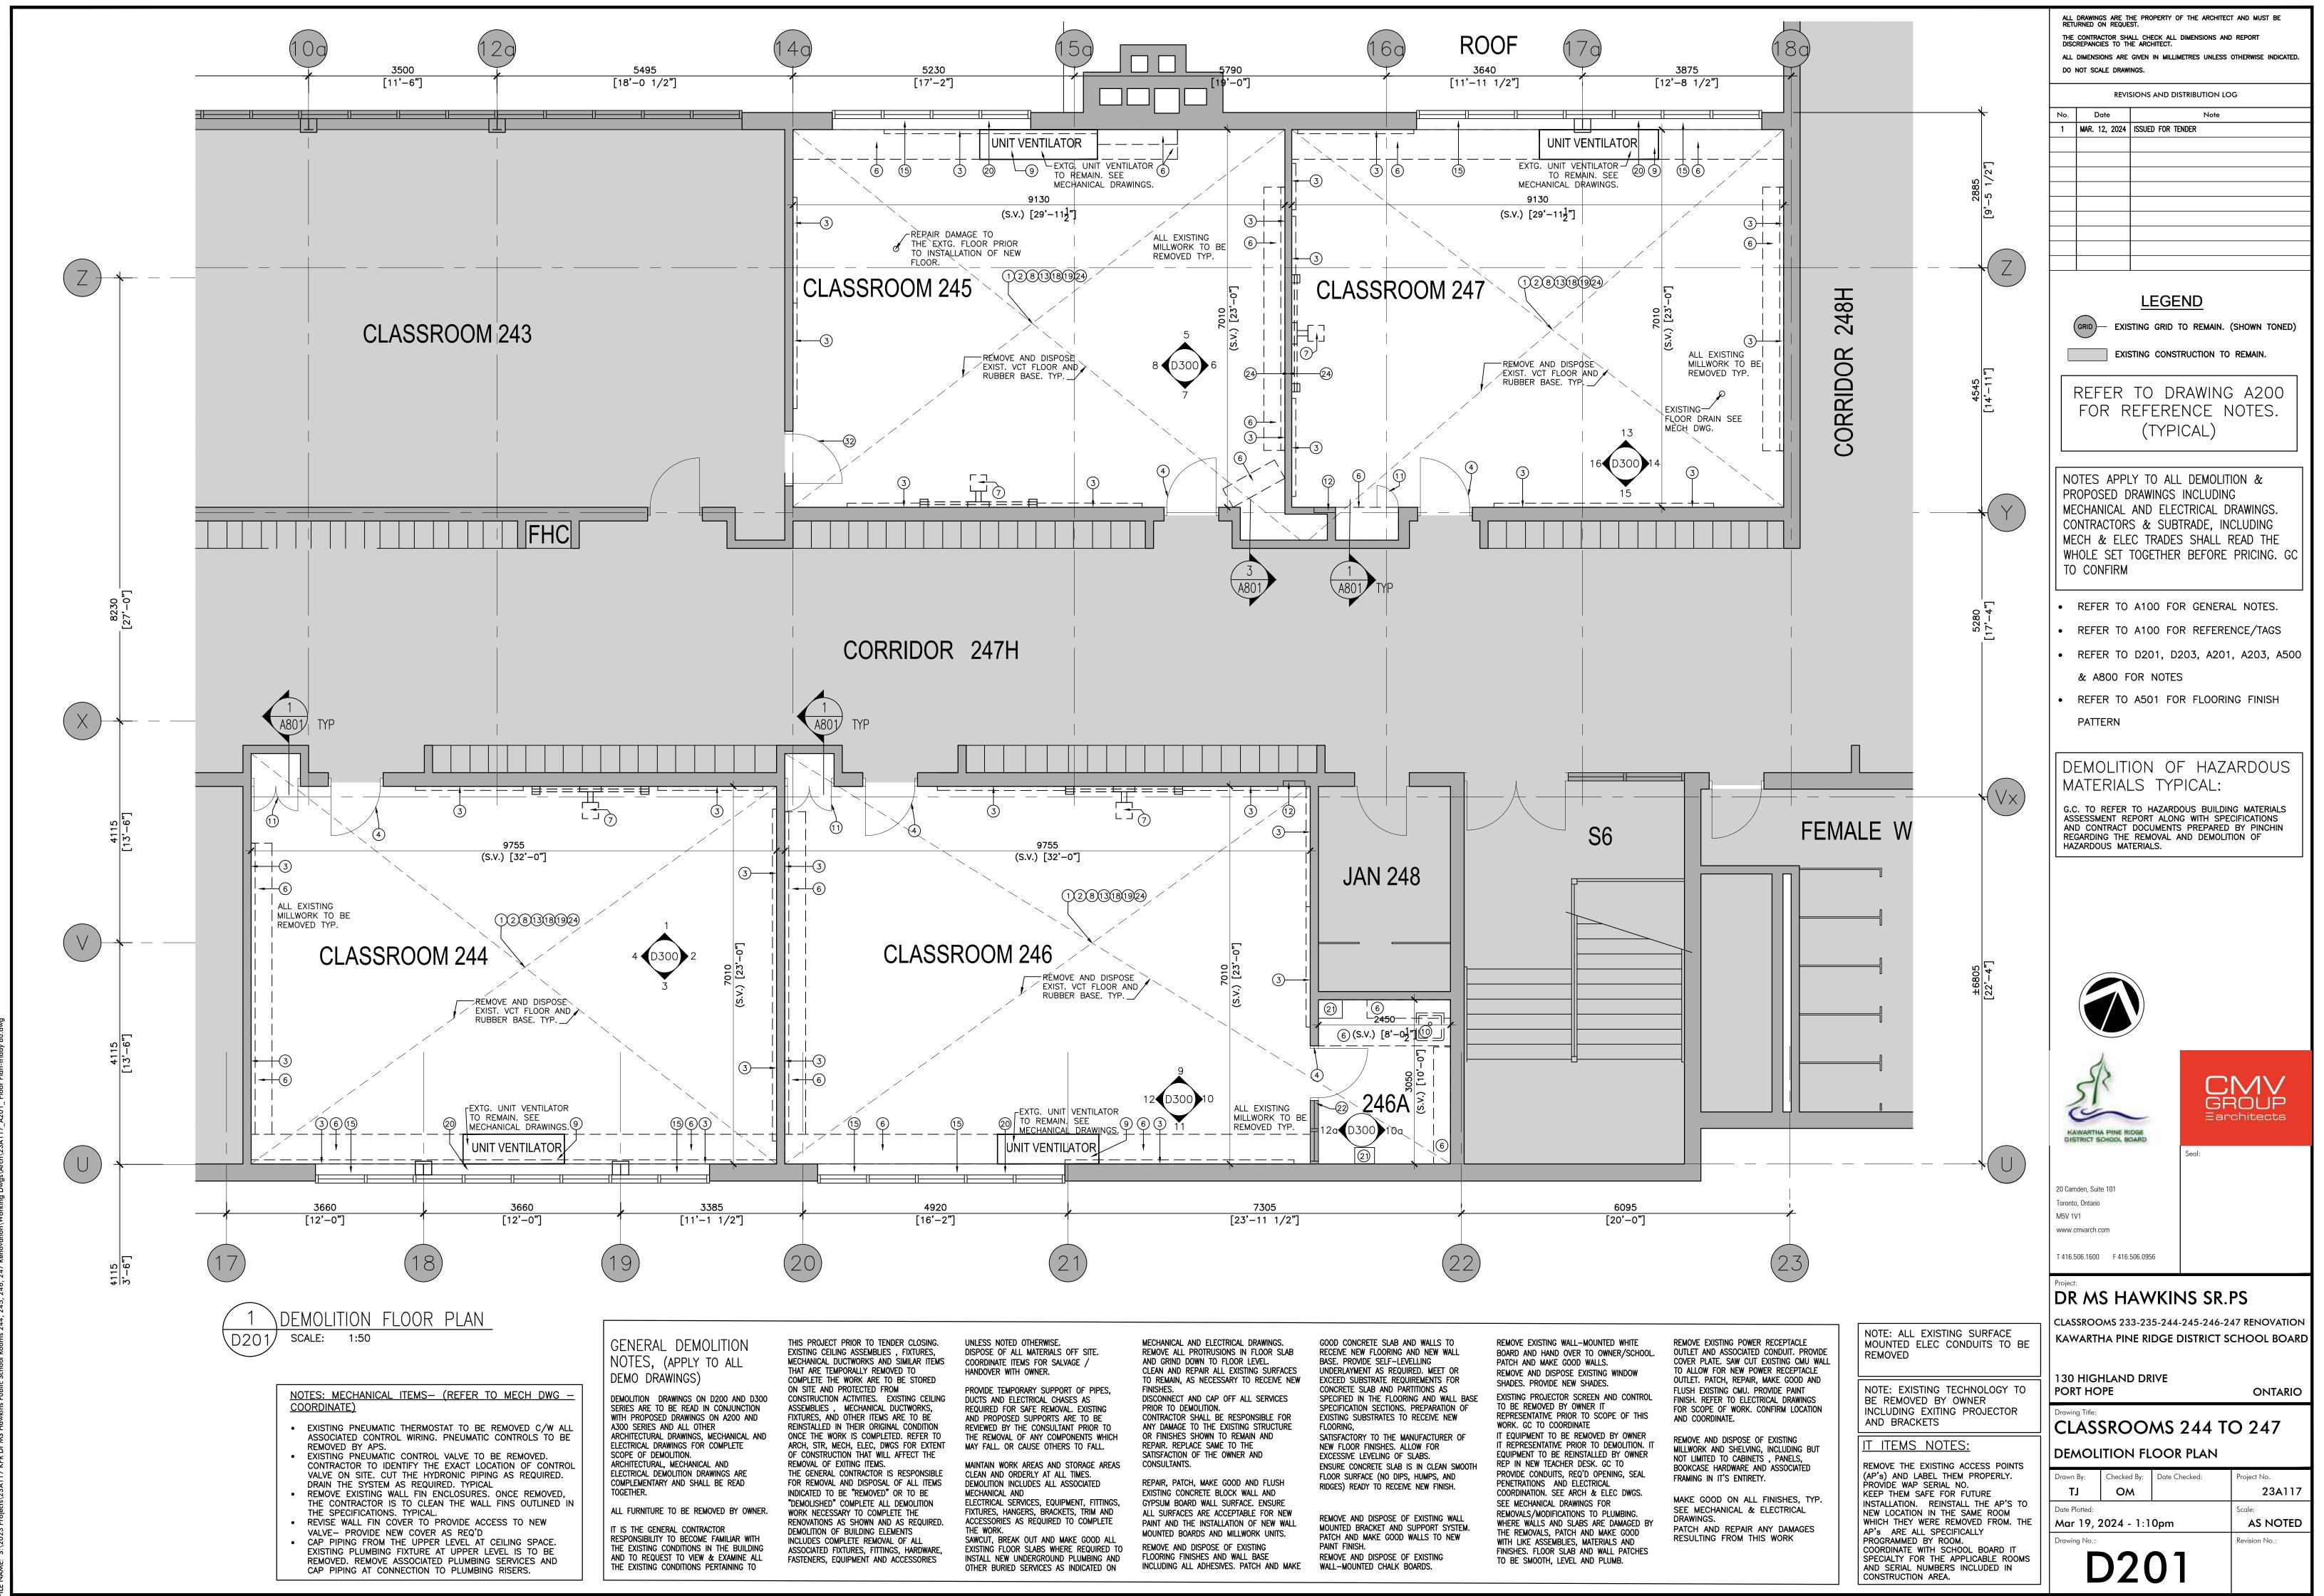

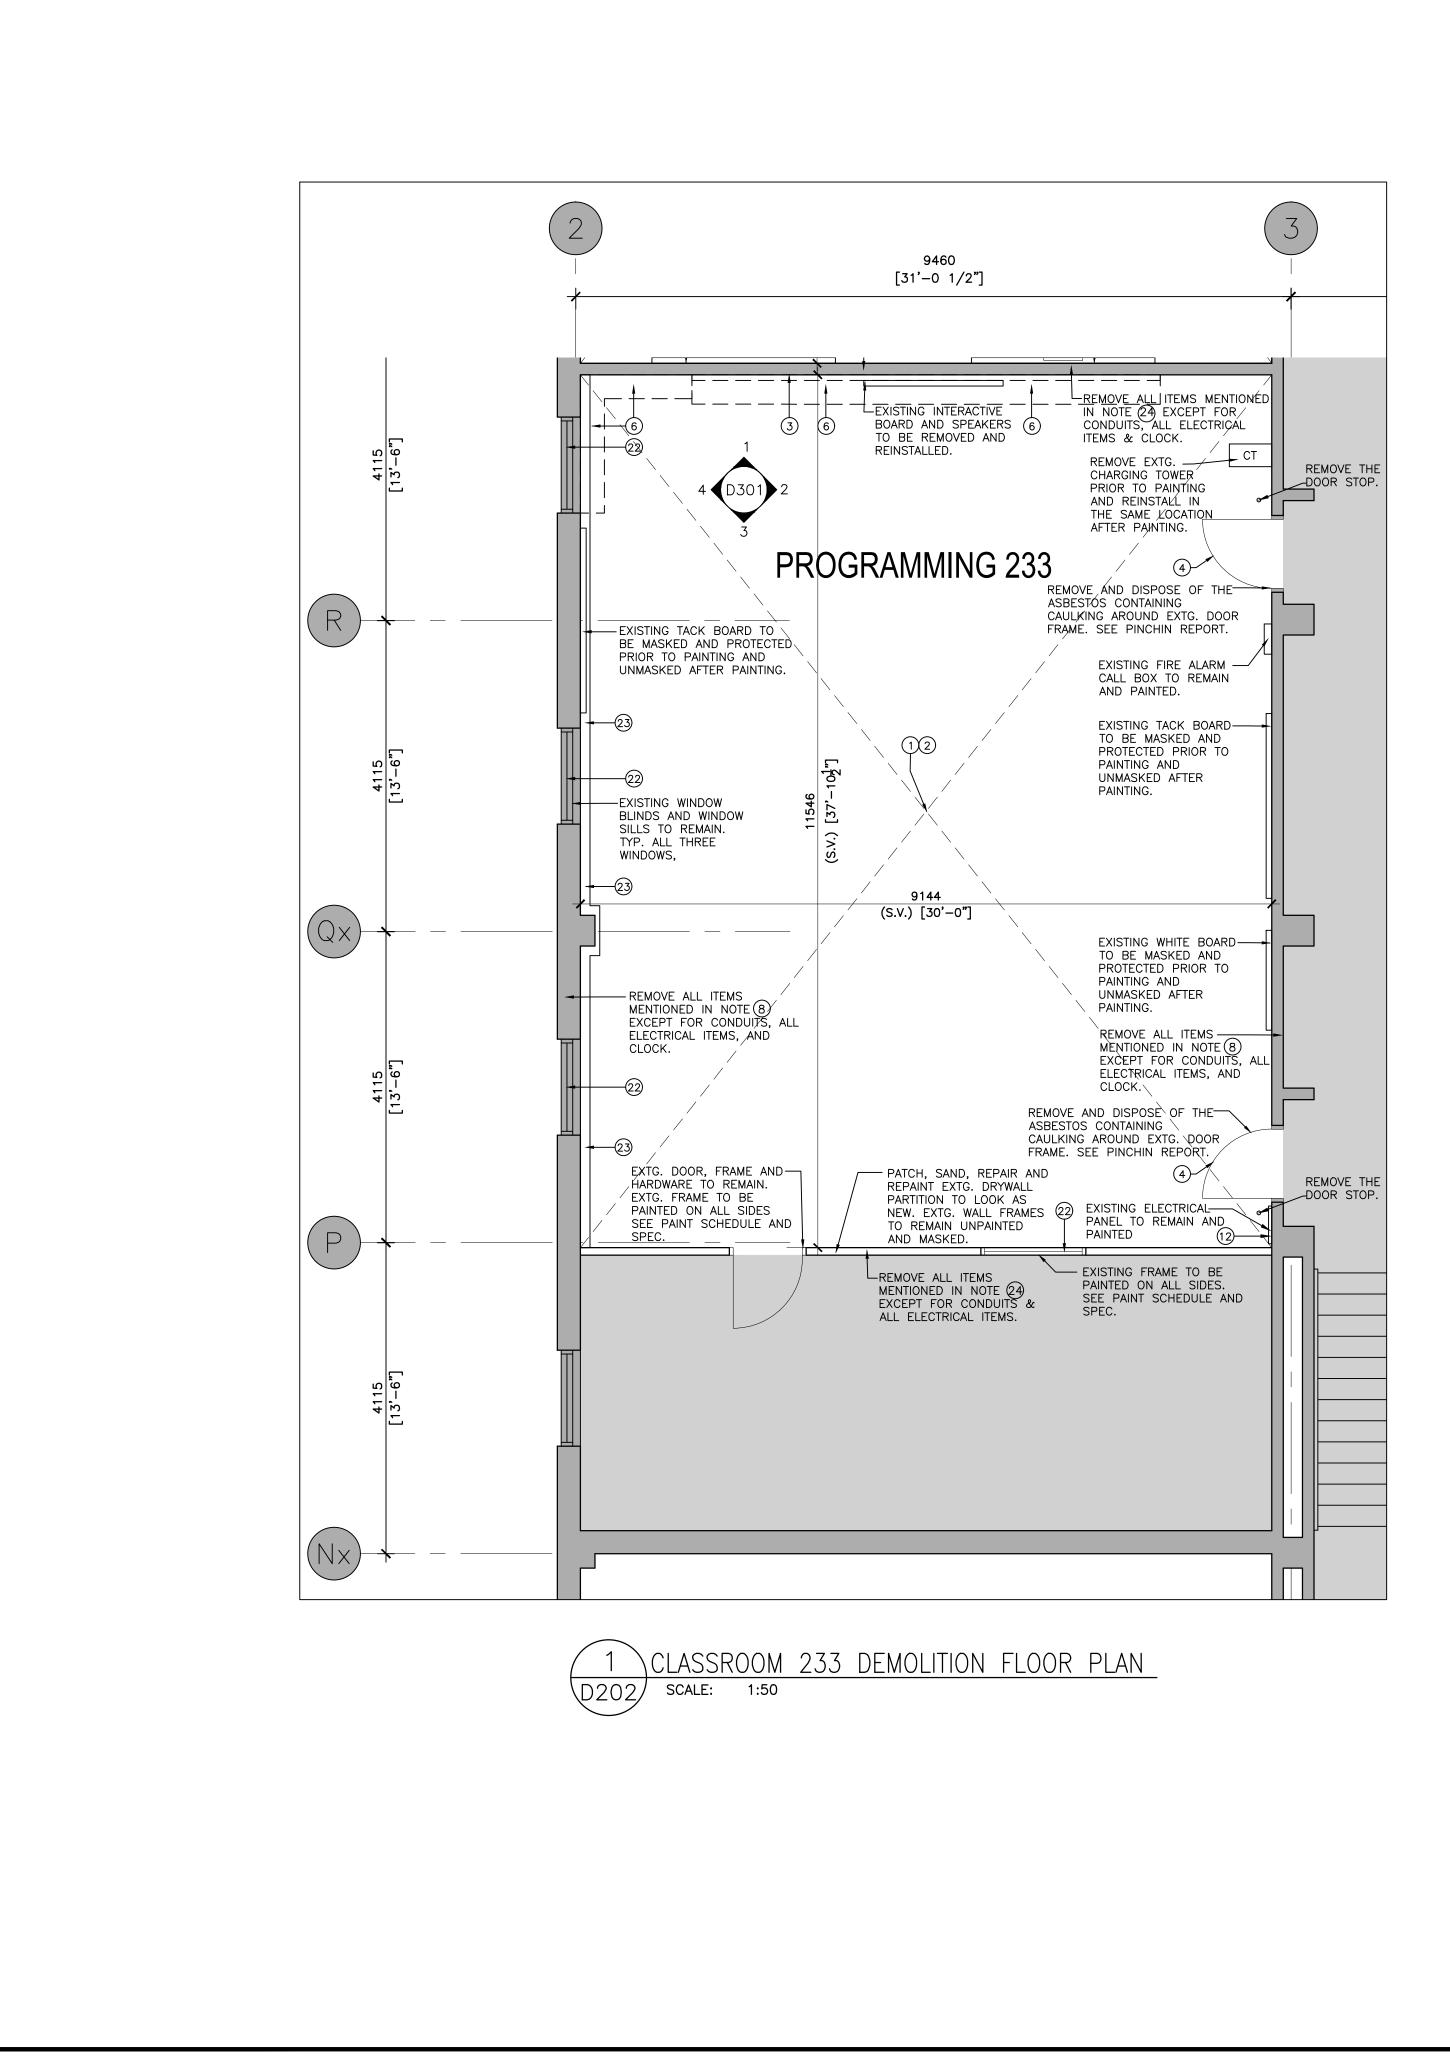


rawing Title: CLASSROOMS 233 AND 235 DEMOLITION FLOOR PLAN Drawn By: Checked By: Date Checked: roject No. ΤJ ОM 23A117 Date Plotted: Mar 19, 2024 - 1:10pm **AS NOTED** Revision No.: awing No.


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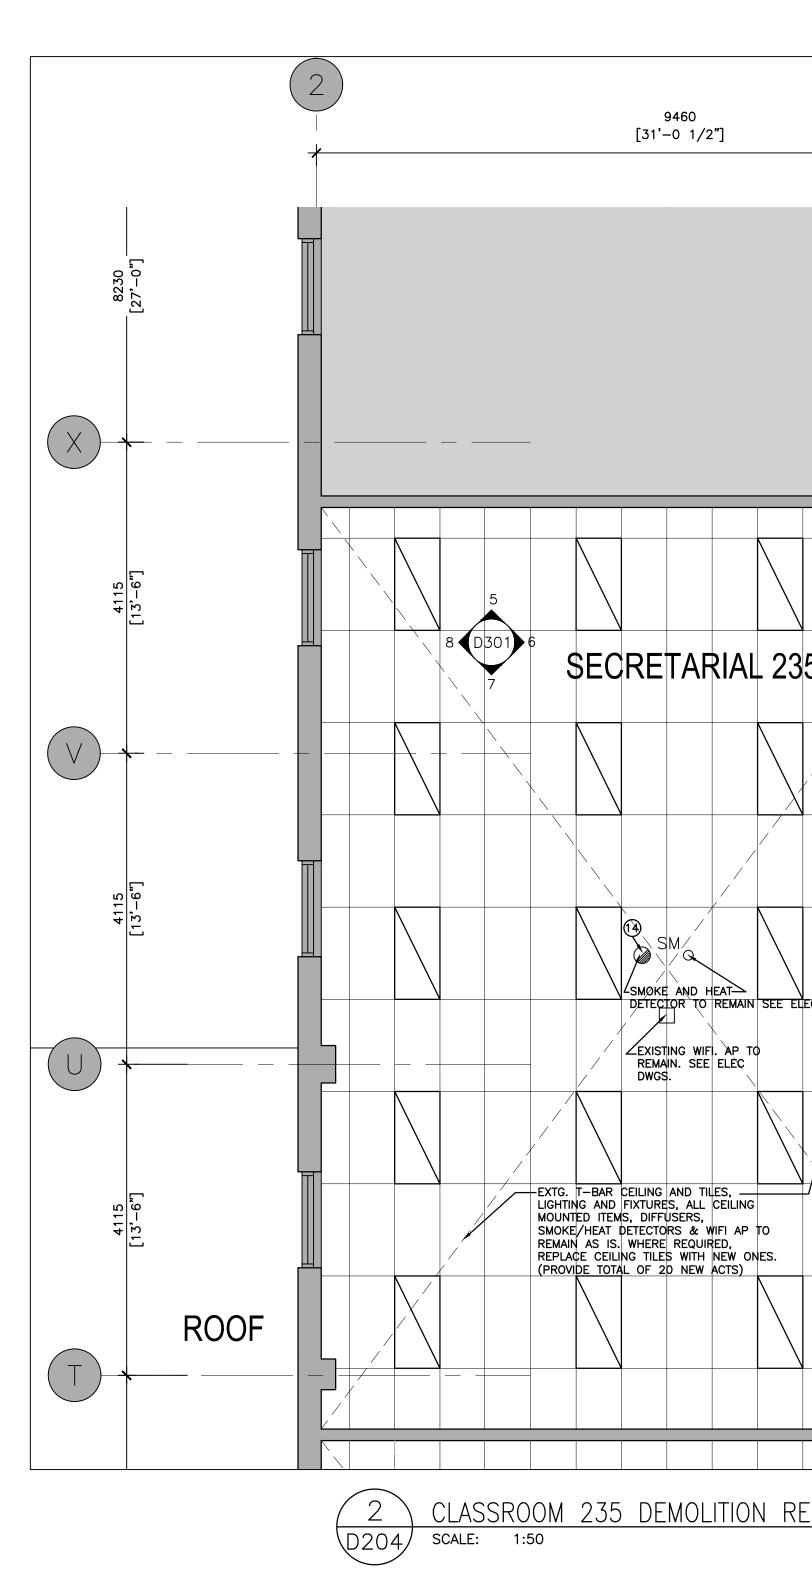

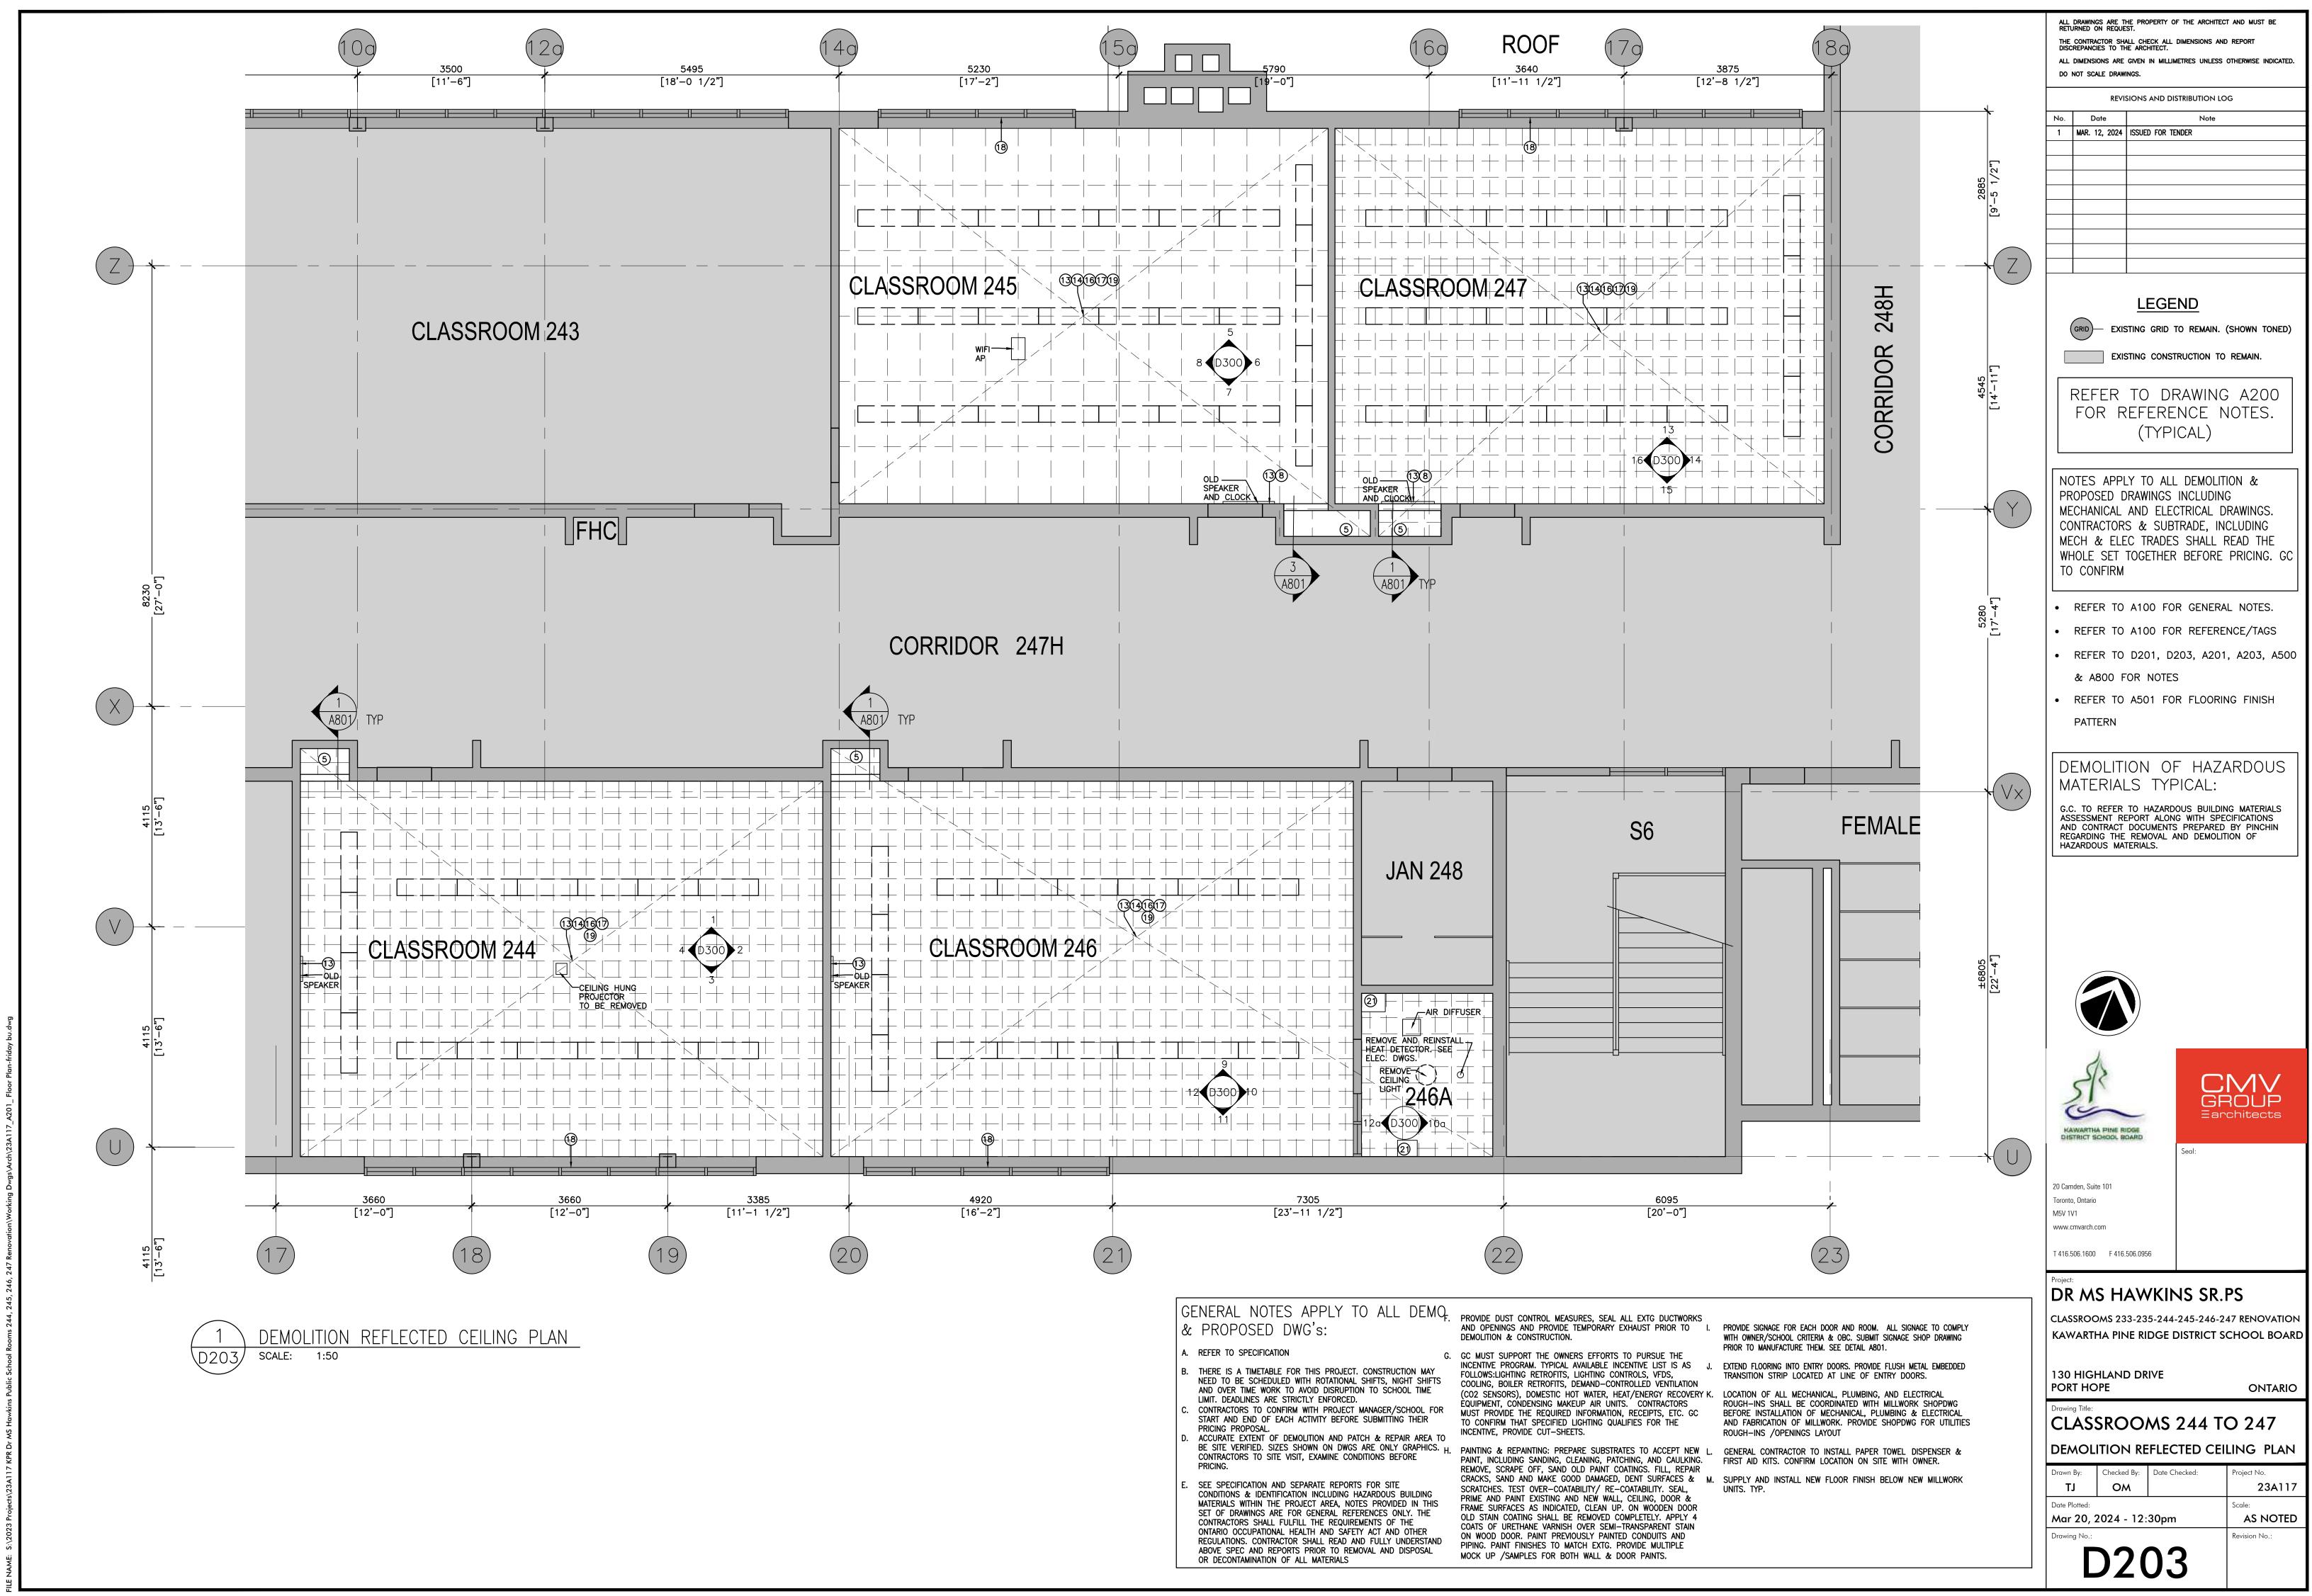
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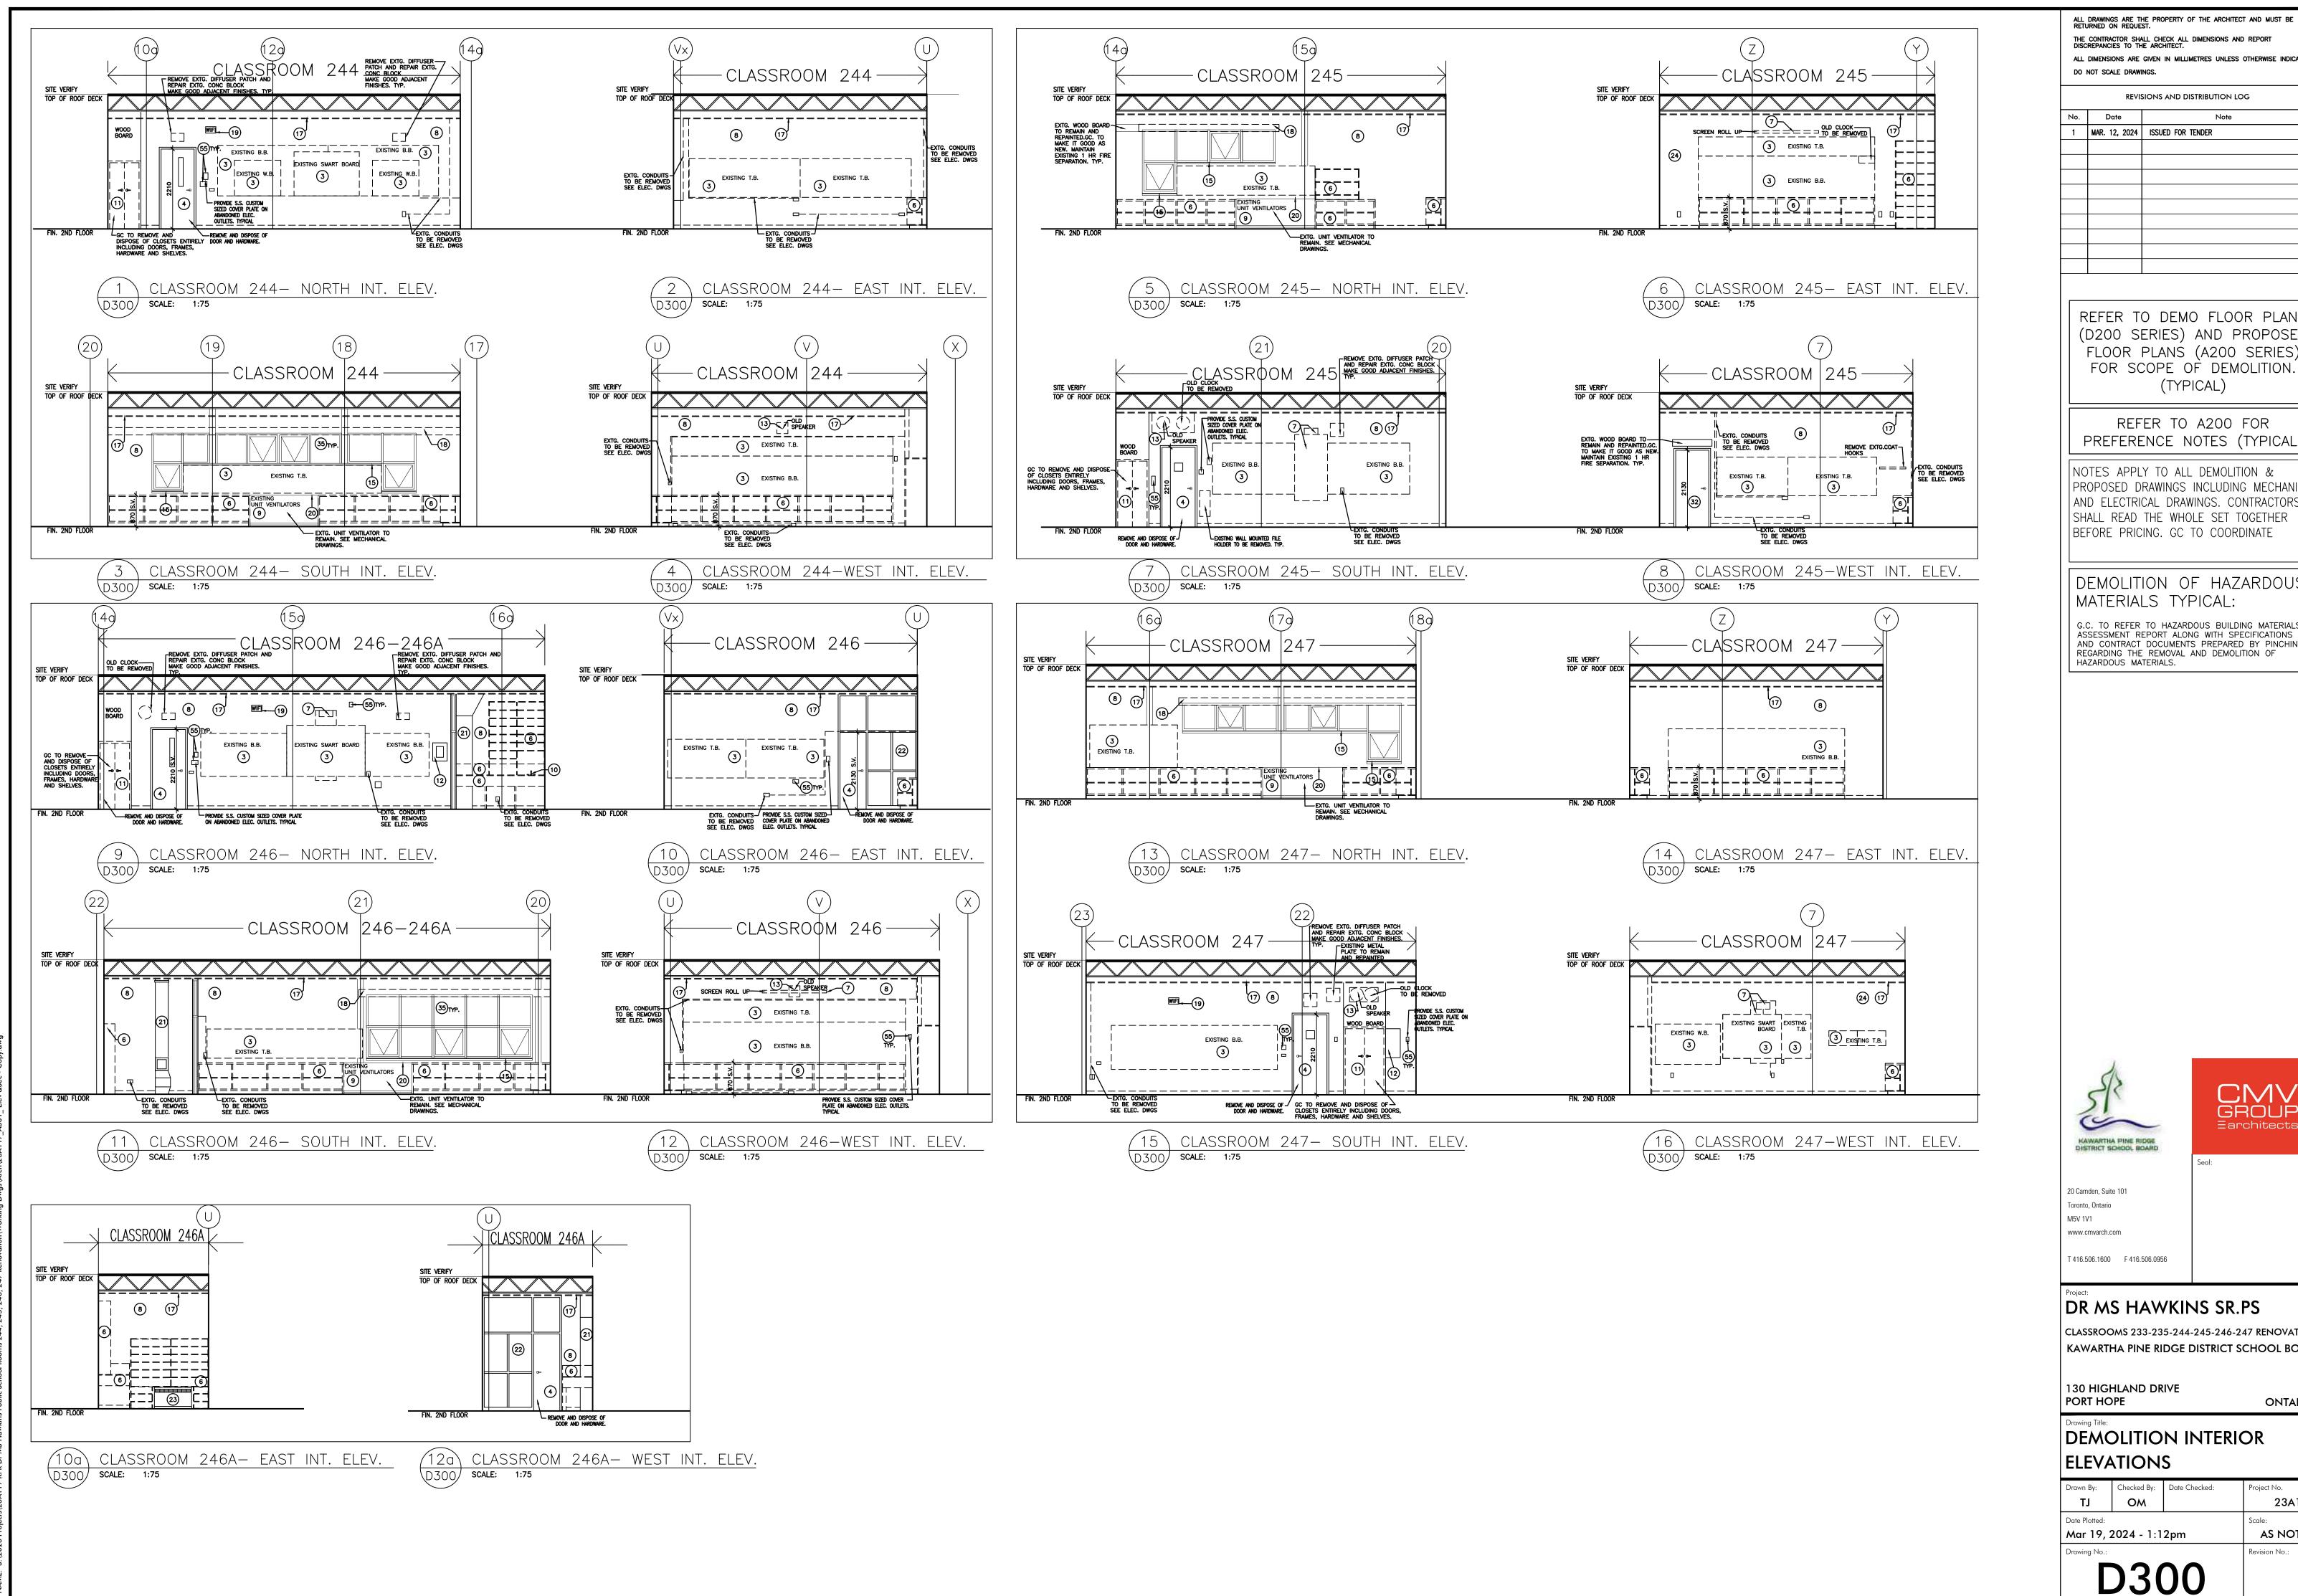







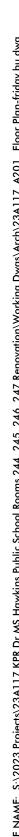

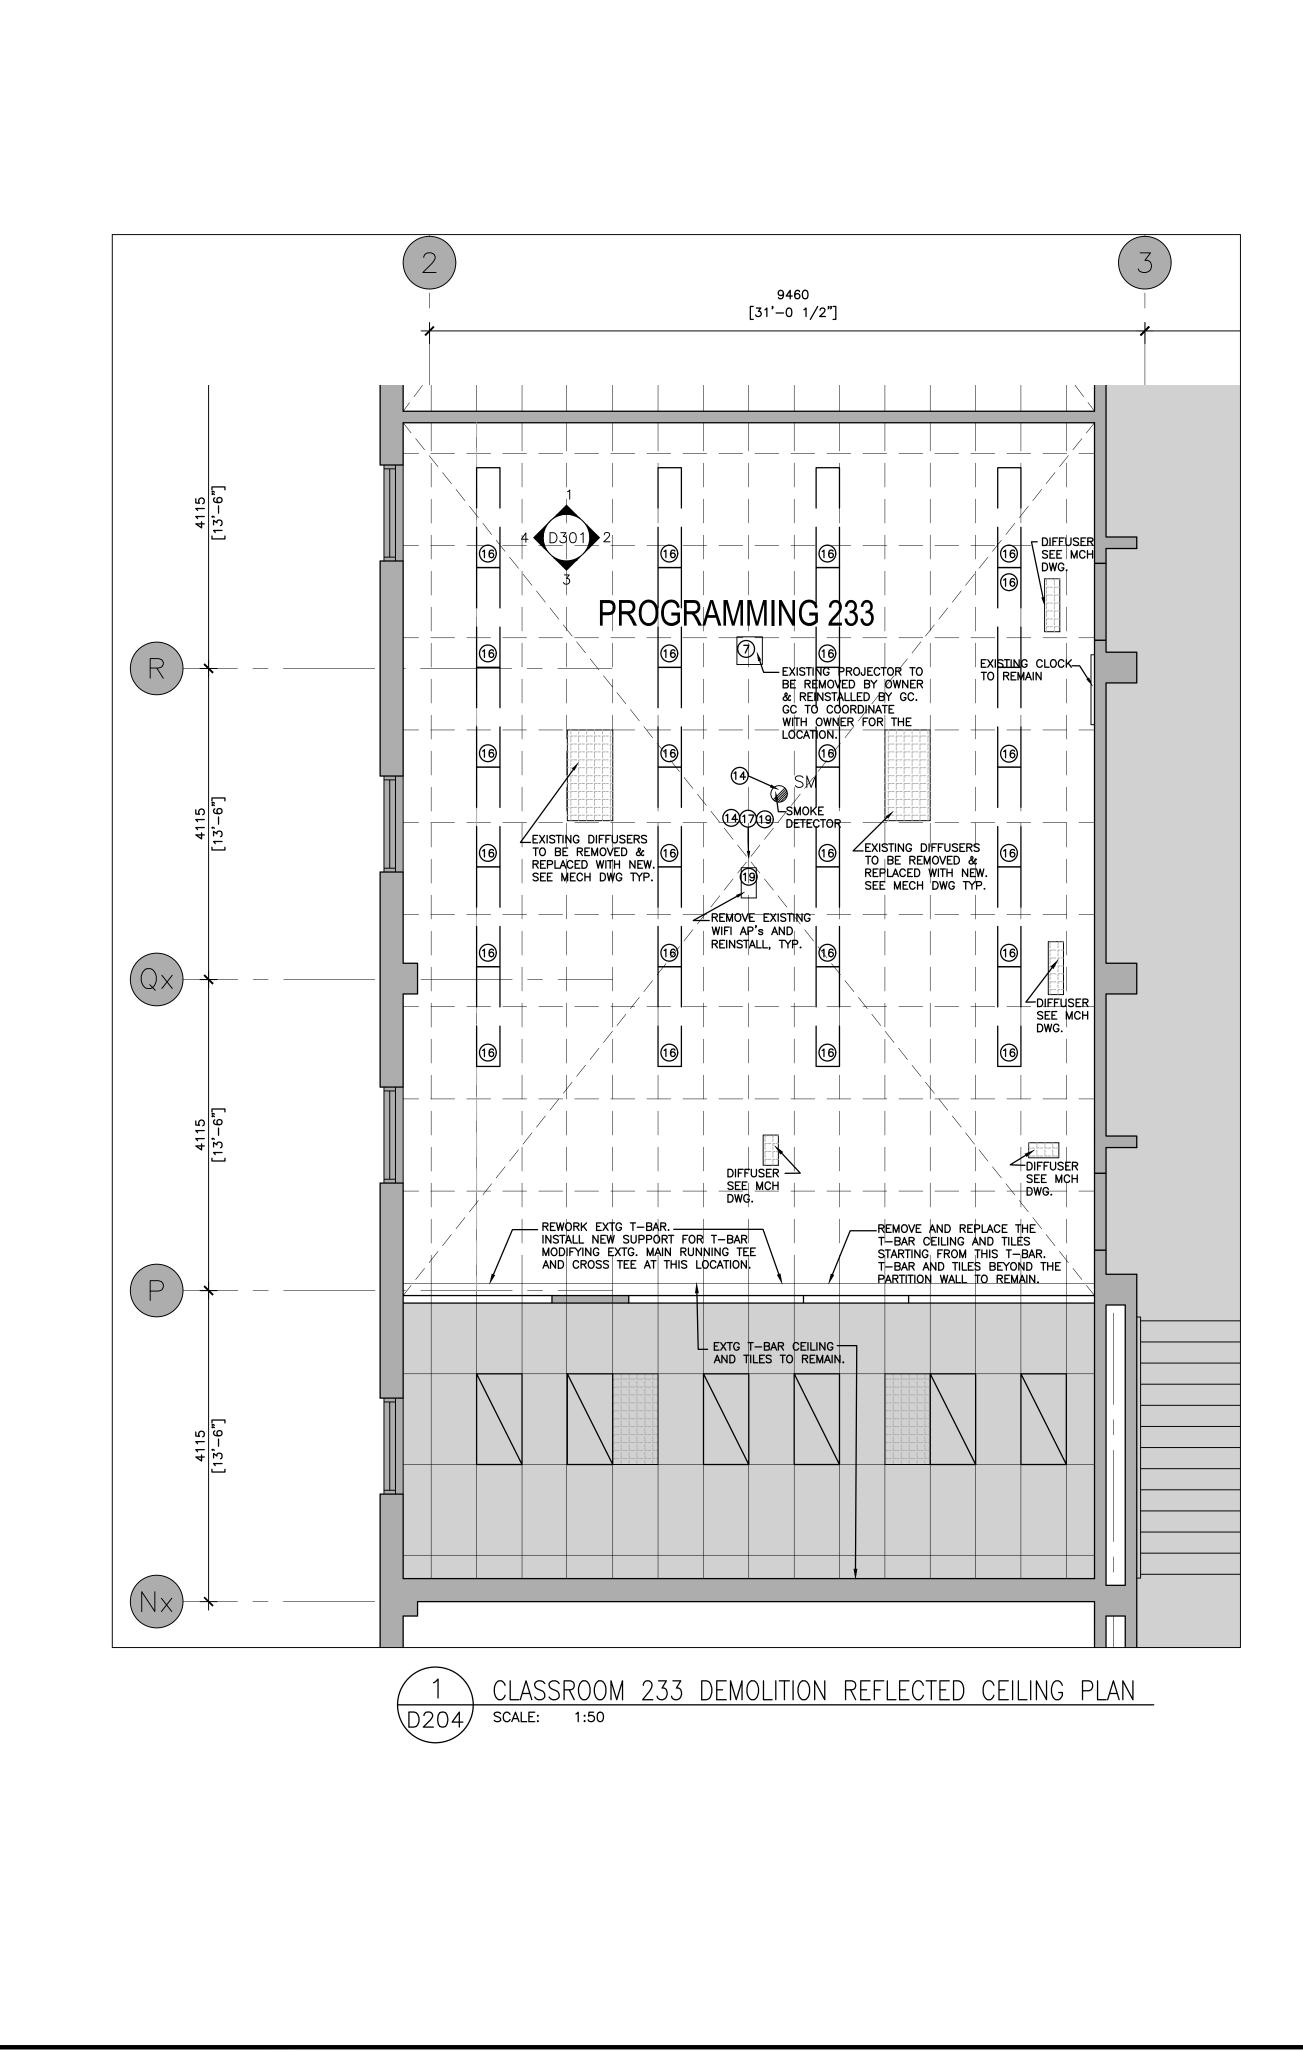
	ALL DRAWINGS ARE THE PROPERTY OF THE ARCHITECT AND MUST BE RETURNED ON REQUEST. THE CONTRACTOR SHALL CHECK ALL DIMENSIONS AND REPORT DISCREPANCIES TO THE ARCHITECT. ALL DIMENSIONS ARE GIVEN IN MILLIMETRES UNLESS OTHERWISE INDICATED. DO NOT SCALE DRAWINGS.
	REVISIONS AND DISTRIBUTION LOG
	No. Date Note 1 MAR. 12, 2024 ISSUED FOR TENDER
	LEGEND
	GRID EXISTING GRID TO REMAIN. (SHOWN TONED)
	REFER TO DRAWING A200 FOR REFERENCE NOTES. (TYPICAL)
	NOTES APPLY TO ALL DEMOLITION &
	PROPOSED DRAWINGS INCLUDING MECHANICAL AND ELECTRICAL DRAWINGS. CONTRACTORS & SUBTRADE, INCLUDING MECH & ELEC TRADES SHALL READ THE WHOLE SET TOGETHER BEFORE PRICING. GC TO CONFIRM
	REFER TO A100 FOR GENERAL NOTES.
	REFER TO A100 FOR REFERENCE/TAGSREFER TO D201, D203, A201, A203, A500
	& A800 FOR NOTES • REFER TO A501 FOR FLOORING FINISH
5 EXISTING DIFFUSER TO RÉMAIN. SEE MECH	PATTERN
EXISTING CLOCK	DEMOLITION OF HAZARDOUS MATERIALS TYPICAL:
EXISTING DIFFUSERS TO REMAIN. SEE	G.C. TO REFER TO HAZARDOUS BUILDING MATERIALS ASSESSMENT REPORT ALONG WITH SPECIFICATIONS AND CONTRACT DOCUMENTS PREPARED BY PINCHIN REGARDING THE REMOVAL AND DEMOLITION OF HAZARDOUS MATERIALS.
EXISTING PROJECTOR AND SPEAKERS TO BE REMOVED	
SPEAKERS TO BE REMOVED PRIOR TO PAINTING AND REINSTALLED AFTER PAINTING.	
EXISTING DIFFUSERS TO REMAIN. SEE MECH 'DWG TYP.	KAWARTHA PINE RIDGE DISTRICT SCHOOL BOARD
EXISTING DIFFUSERS	Seal:
	20 Camden, Suite 101 Toronto, Ontario M5V 1V1
	www.cmvarch.com T 416.506.1600 F 416.506.0956
	Project: DR MS HAWKINS SR.PS
FLECTED CEILING PLAN	CLASSROOMS 233-235-244-245-246-247 RENOVATION KAWARTHA PINE RIDGE DISTRICT SCHOOL BOARD
	130 HIGHLAND DRIVE PORT HOPE ONTARIO
	Drawing Title: CLASSROOMS 233 AND 235
	DEMOLITION REFLECTED CEILING PLAN Drawn By: Checked By: Date Checked: Project No.
	TJ OM 23A117 Date Plotted: Scale: Mar 19, 2024 - 1:11pm AS NOTED
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THE CONTRACTOR SHALL CHECK ALL DIMENSIONS AND DISCREPANCIES TO THE ARCHITECT. ALL DIMENSIONS ARE GIVEN IN MILLIMETRES UNLESS					
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KAWARTHA PINE RIDGE DISTRICT SCHOOL ROARD Seal:	ROUP chitects				
D Camden, Suite 101 pronto, Ontario ISV 1V1 www.cmvarch.com					
416.506.1600 F 416.506.0956					
DR MS HAWKINS SR.PS LASSROOMS 233-235-244-245-246-247 RENOVATION AWARTHA PINE RIDGE DISTRICT SCHOOL BOARD					
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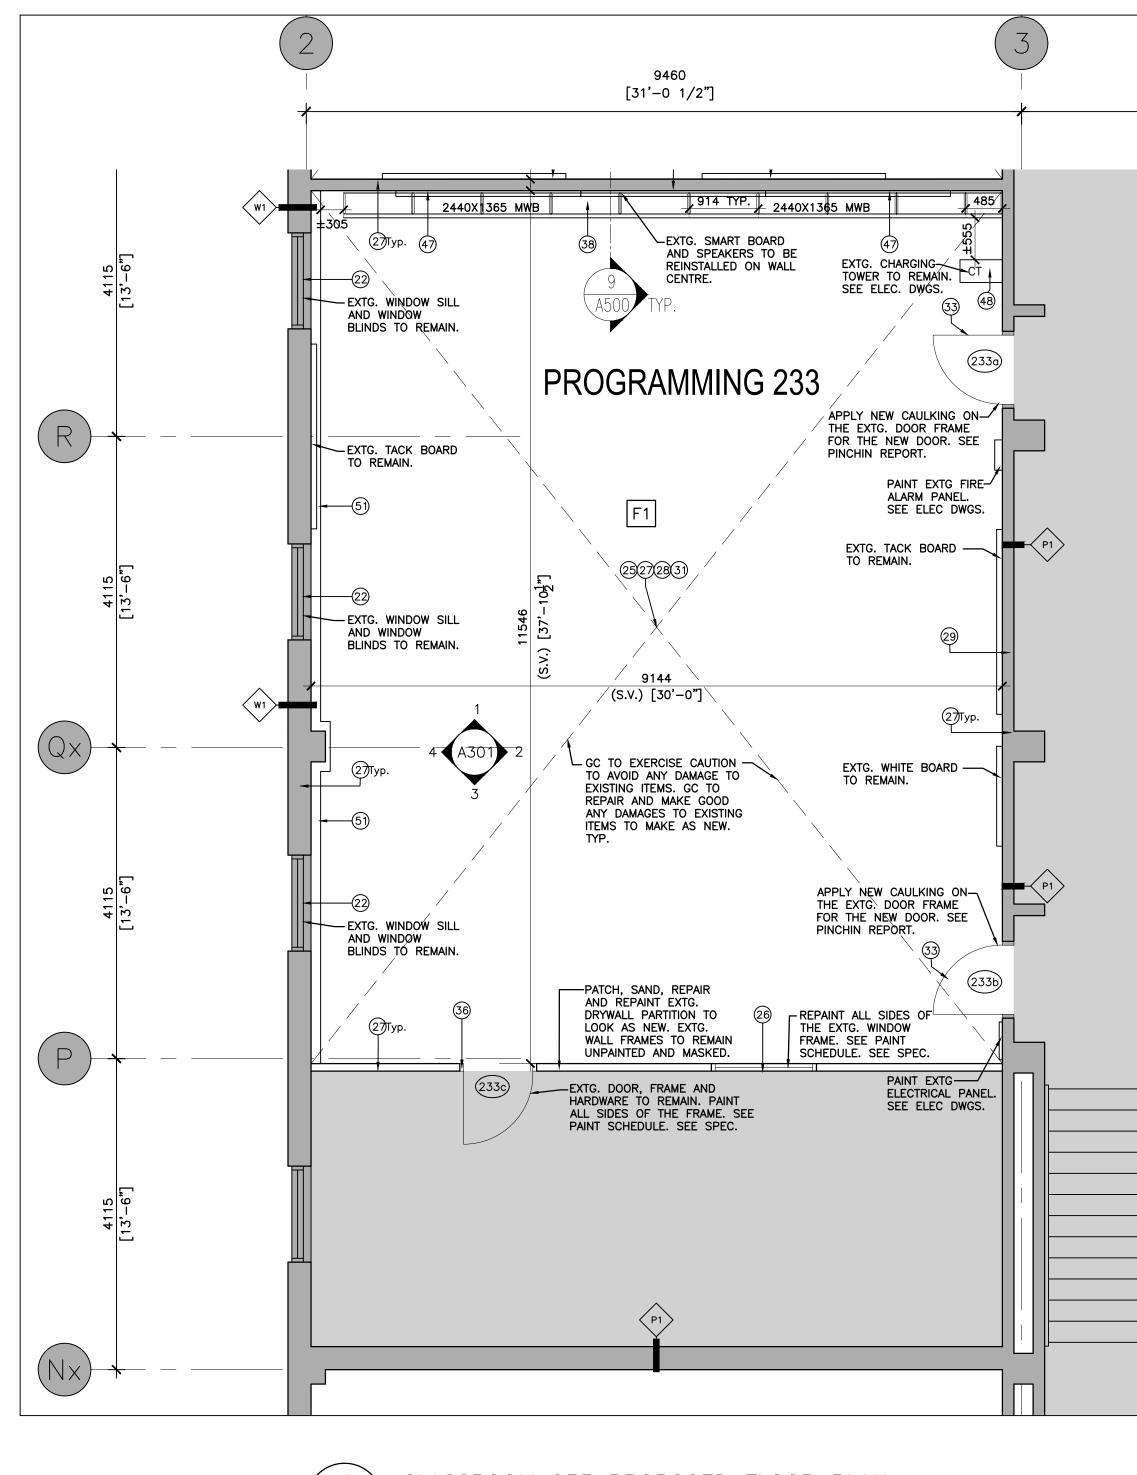


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HAZARDOUS MATERIALS.	
	/
GROUP Earchitect	D JS
KAWARTHA PINE RIDGE DISTRICT SCHOOL BOARD Seal:	
20 Camden, Suite 101 Toronto, Ontario M5V 1V1	
20 Camden, Suite 101 Toronto, Ontario M5V 1V1 www.cmvarch.com	
20 Camden, Suite 101 Toronto, Ontario	
Seal: 20 Camden, Suite 101 Toronto, Ontario M5V 1V1 www.cmvarch.com T 416.506.1600 F 416.506.0956 Project: DR MS HAWKINS SR.PS CLASSROOMS 233-235-244-245-246-247 RENOV	
Image: Construct School Board Seal: 20 Camden, Suite 101 Toronto, Ontario M5V 1V1 www.cmvarch.com T 416.506.1600 F 416.506.0956 Project: DR MSS HAWKINS SR.PS CLASSROOMS 233-235-244-245-246-247 RENOV KAWARTHA PINE RIDGE DISTRICT SCHOOLE 130 HIGHLAND DRIVE	BOAR
MAWARTHA PINE RIDGE DISTRICT SCHOOL BOARD Seal: 20 Carnden, Suite 101 Toronto, Ontario M5V 1V1 www.cmvarch.com T 416.506.1600 F 416.506.0956 Project: DARAS HAEWKINS SR.PS CLASSROOMS 233-235-244-245-246-247 RENOVE CLASSROOMS 233-235-244-245-246-247 RENOVE CLASSROOMS 233-235-244-245-246-247 RENOVE CLASSROOMS 233-235-244-245-246-247 RENOVE CLASSROOMS TRICT SCHOOL E CLASSROOMS TRICT SCHOOL	BOAR
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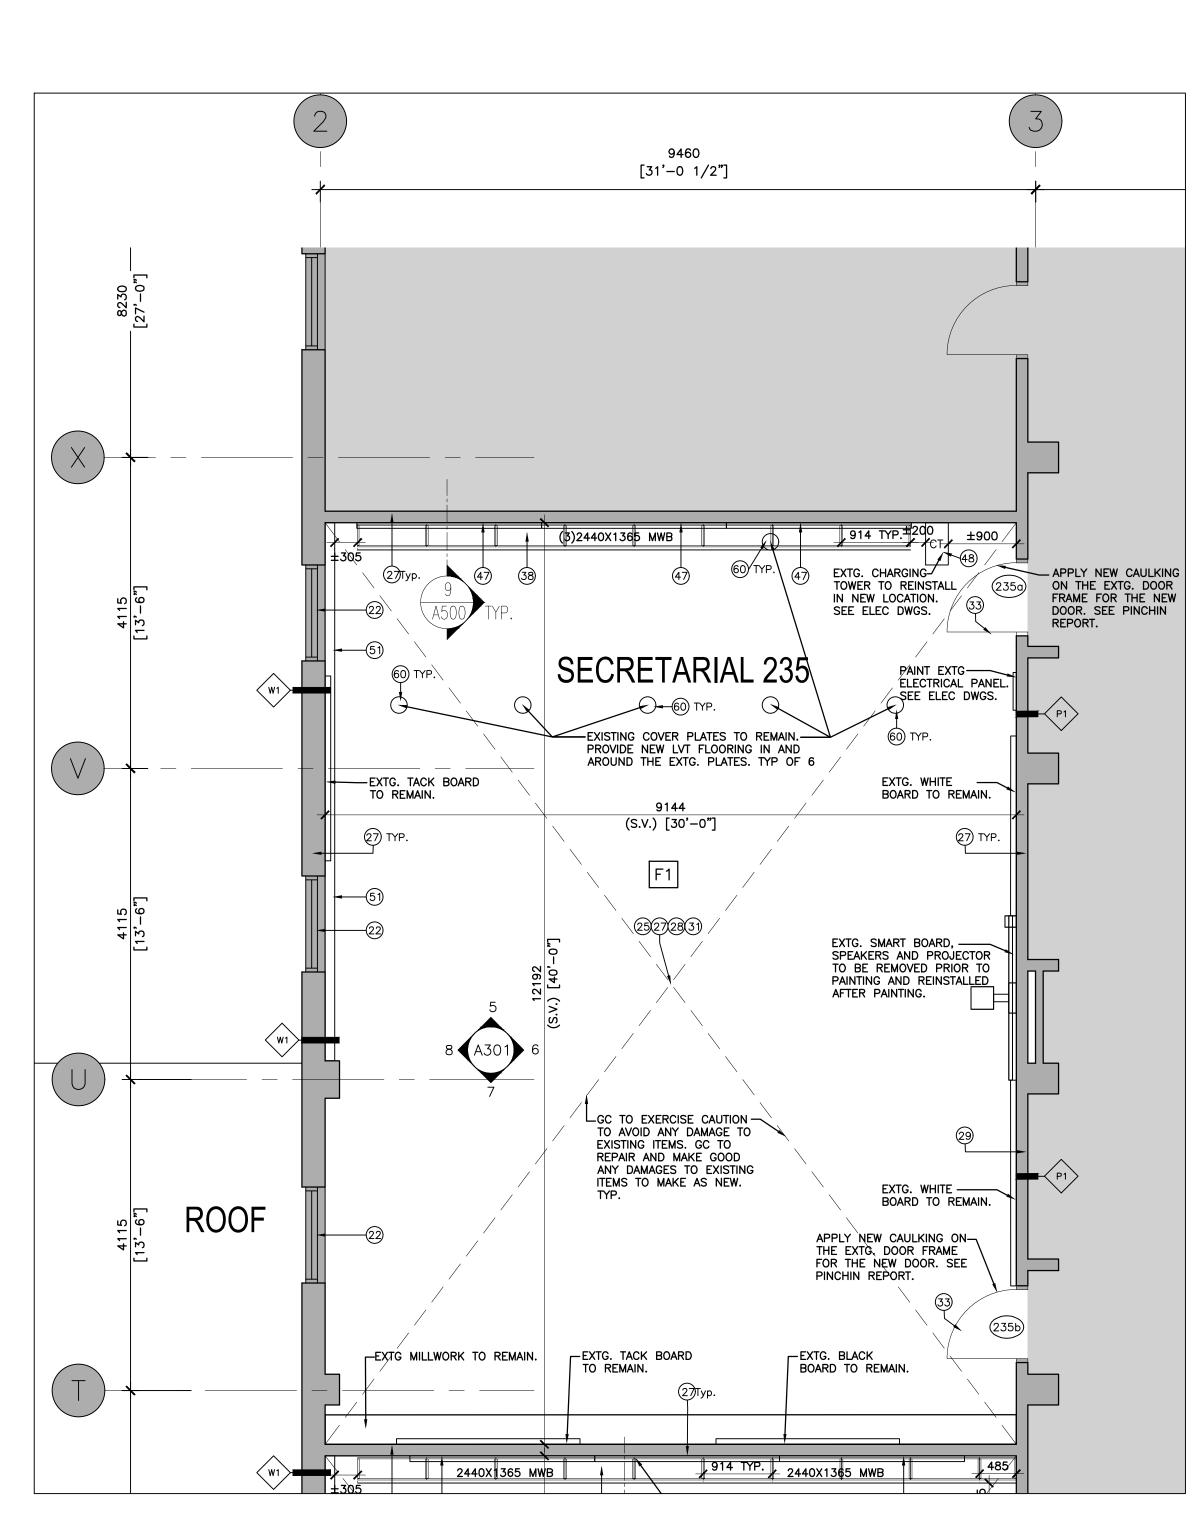


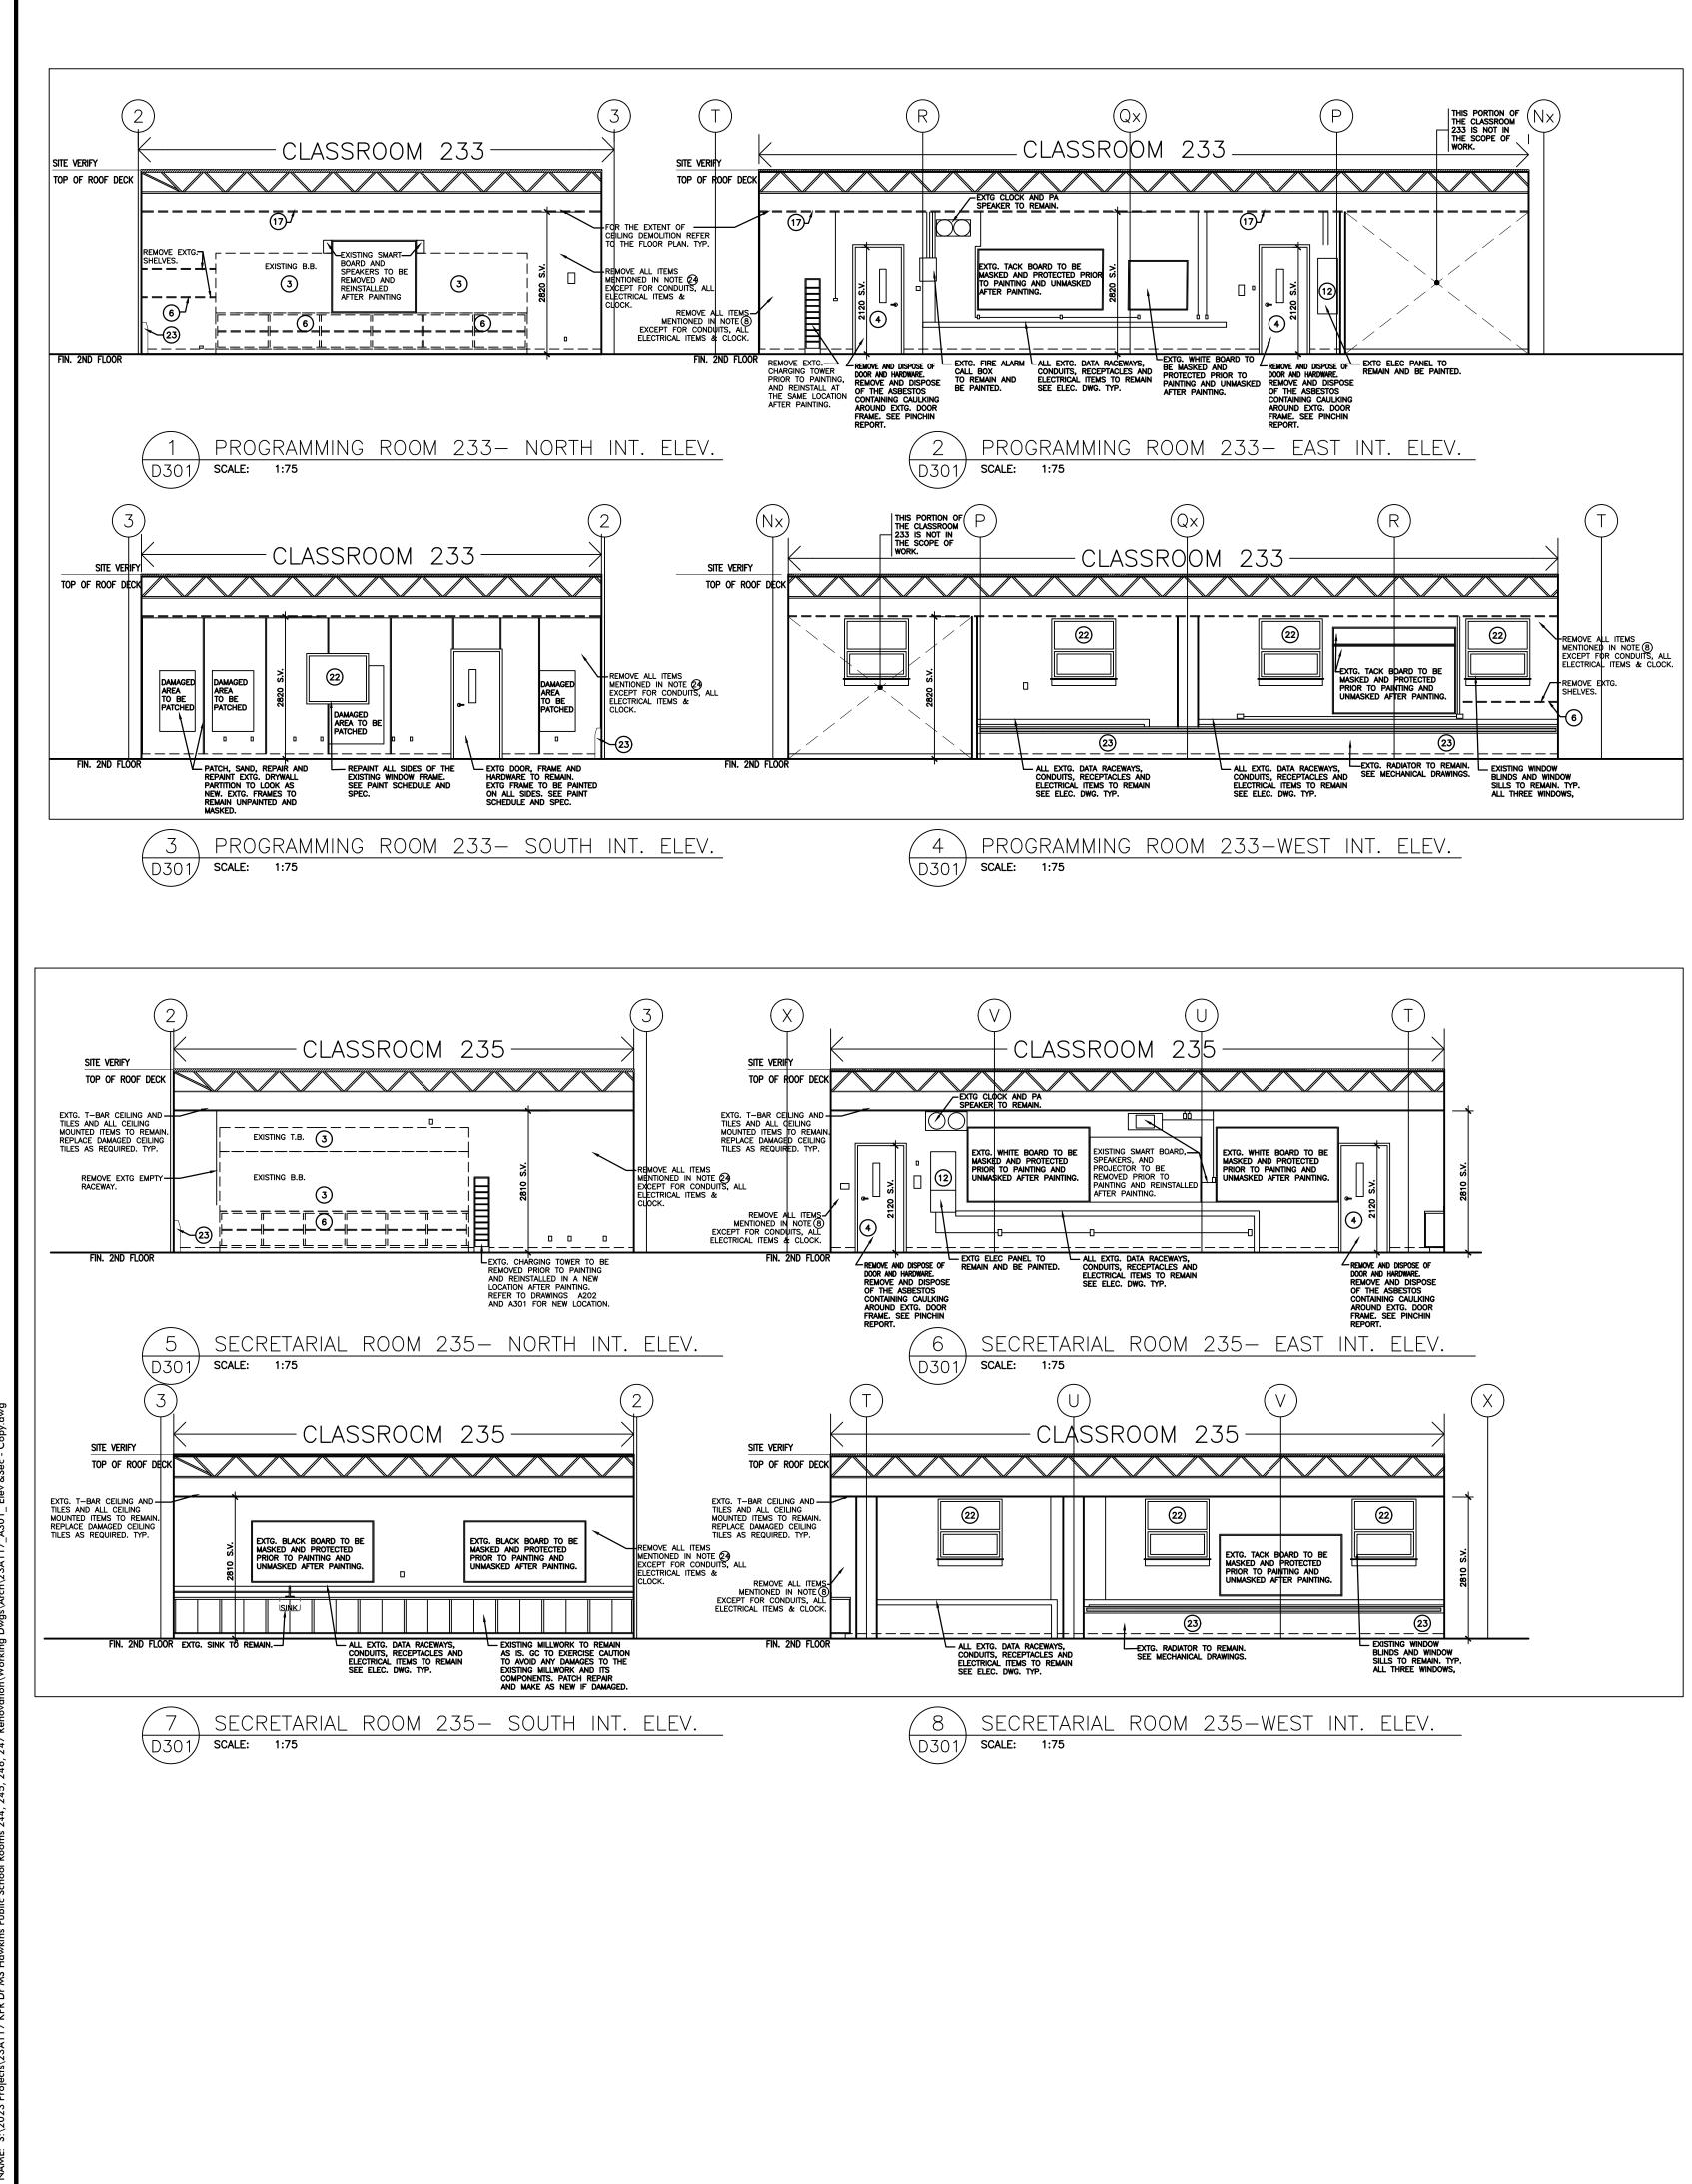

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SCALE: 1:50


CLASSROOM 233 PROPOSED FLOOR PLAN

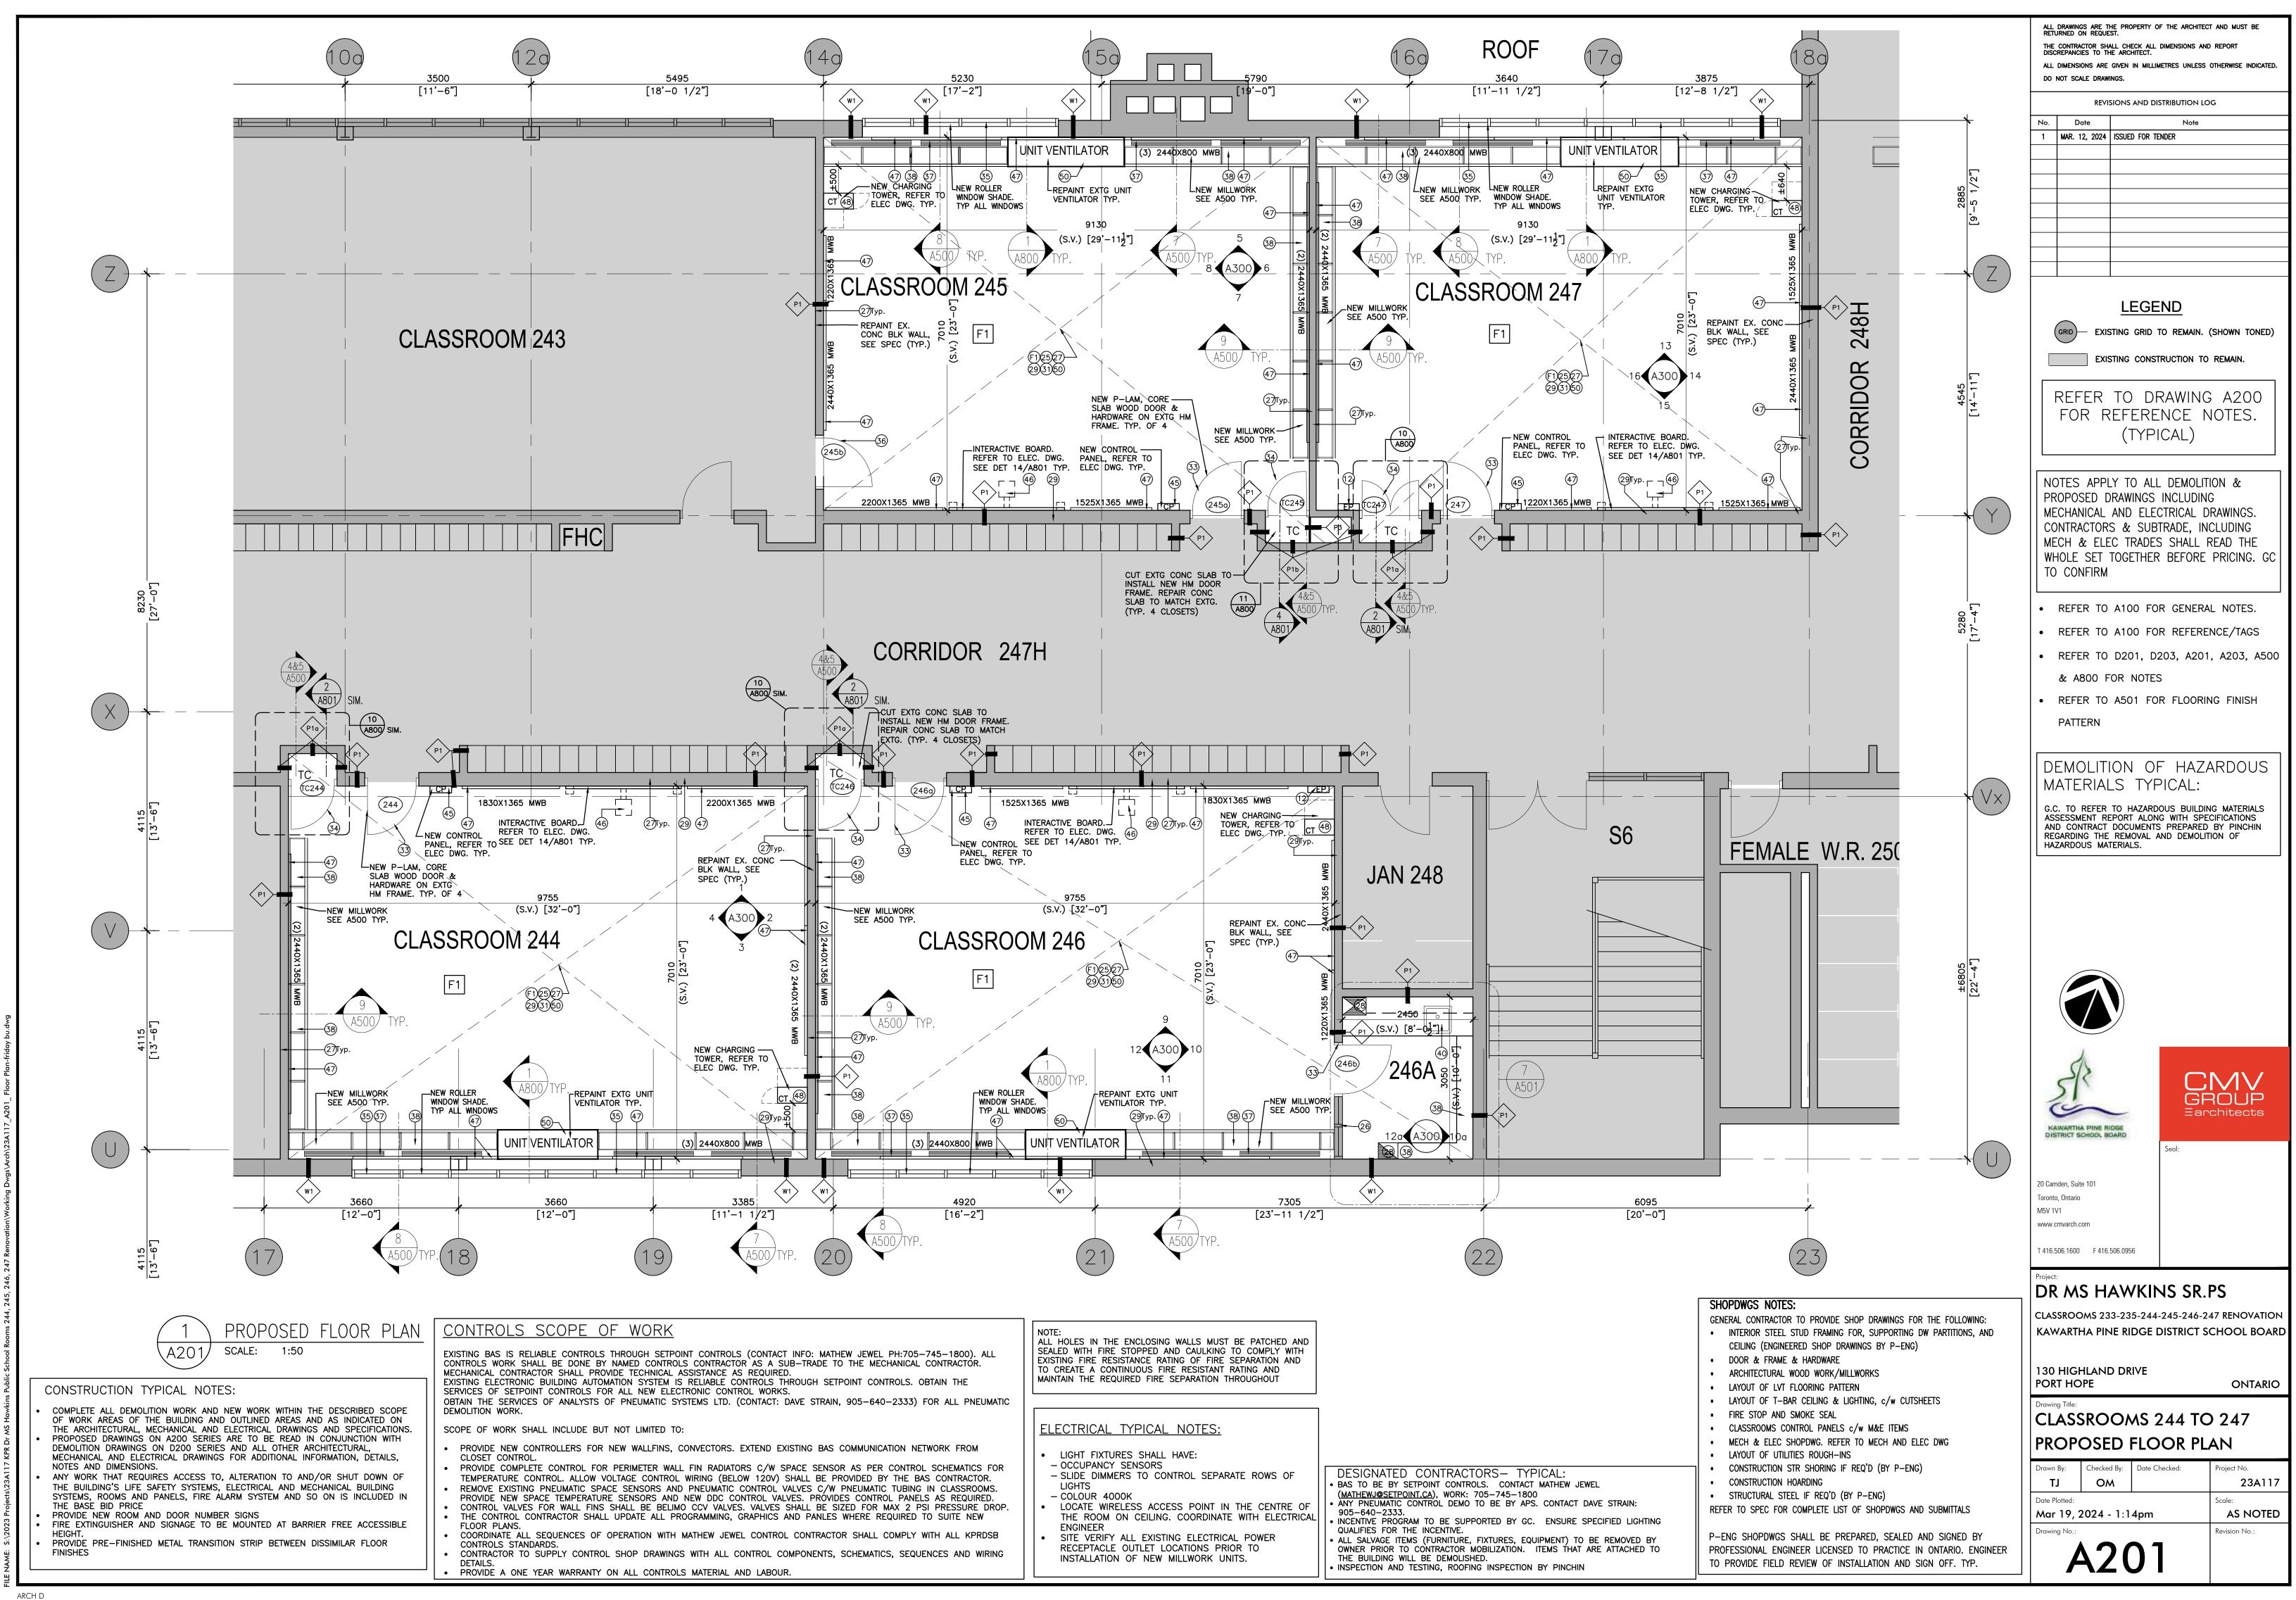




CLASSROOM 235 PROPOSED FLOOR PLAN SCALE: 1:50


ALL DRAWINGS ARE THE PROPERTY OF THE ARCHITEC RETURNED ON REQUEST. THE CONTRACTOR SHALL CHECK ALL DIMENSIONS AN DISCREPANCIES TO THE ARCHITECT. ALL DIMENSIONS ARE GIVEN IN MILLIMETRES UNLESS DO NOT SCALE DRAWINGS.	d report
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LEGEND GRID EXISTING GRID TO REMAIN.	
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 & A800 FOR NOTES REFER TO A501 FOR FLOORI PATTERN 	
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G.C. TO REFER TO HAZARDOUS BUILDIN ASSESSMENT REPORT ALONG WITH SPE AND CONTRACT DOCUMENTS PREPARED REGARDING THE REMOVAL AND DEMOLIT HAZARDOUS MATERIALS.	CIFICATIONS BY PINCHIN
	NV
Seal: 20 Camden, Suite 101 Toronto, Ontario M5V 1V1	
www.cmvarch.com T 416.506.1600 F 416.506.0956	
Project: DR MS HAWKINS SR. CLASSROOMS 233-235-244-245-246-2 KAWARTHA PINE RIDGE DISTRICT S	47 RENOVATION
130 HIGHLAND DRIVE PORT HOPE	ONTARIO
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Drawn By: Checked By: Date Checked: TJ OM	Project No. 23A117
Date Plotted: Mar 19, 2024 - 1:15pm Drawing No.:	Scale: AS NOTED Revision No.:
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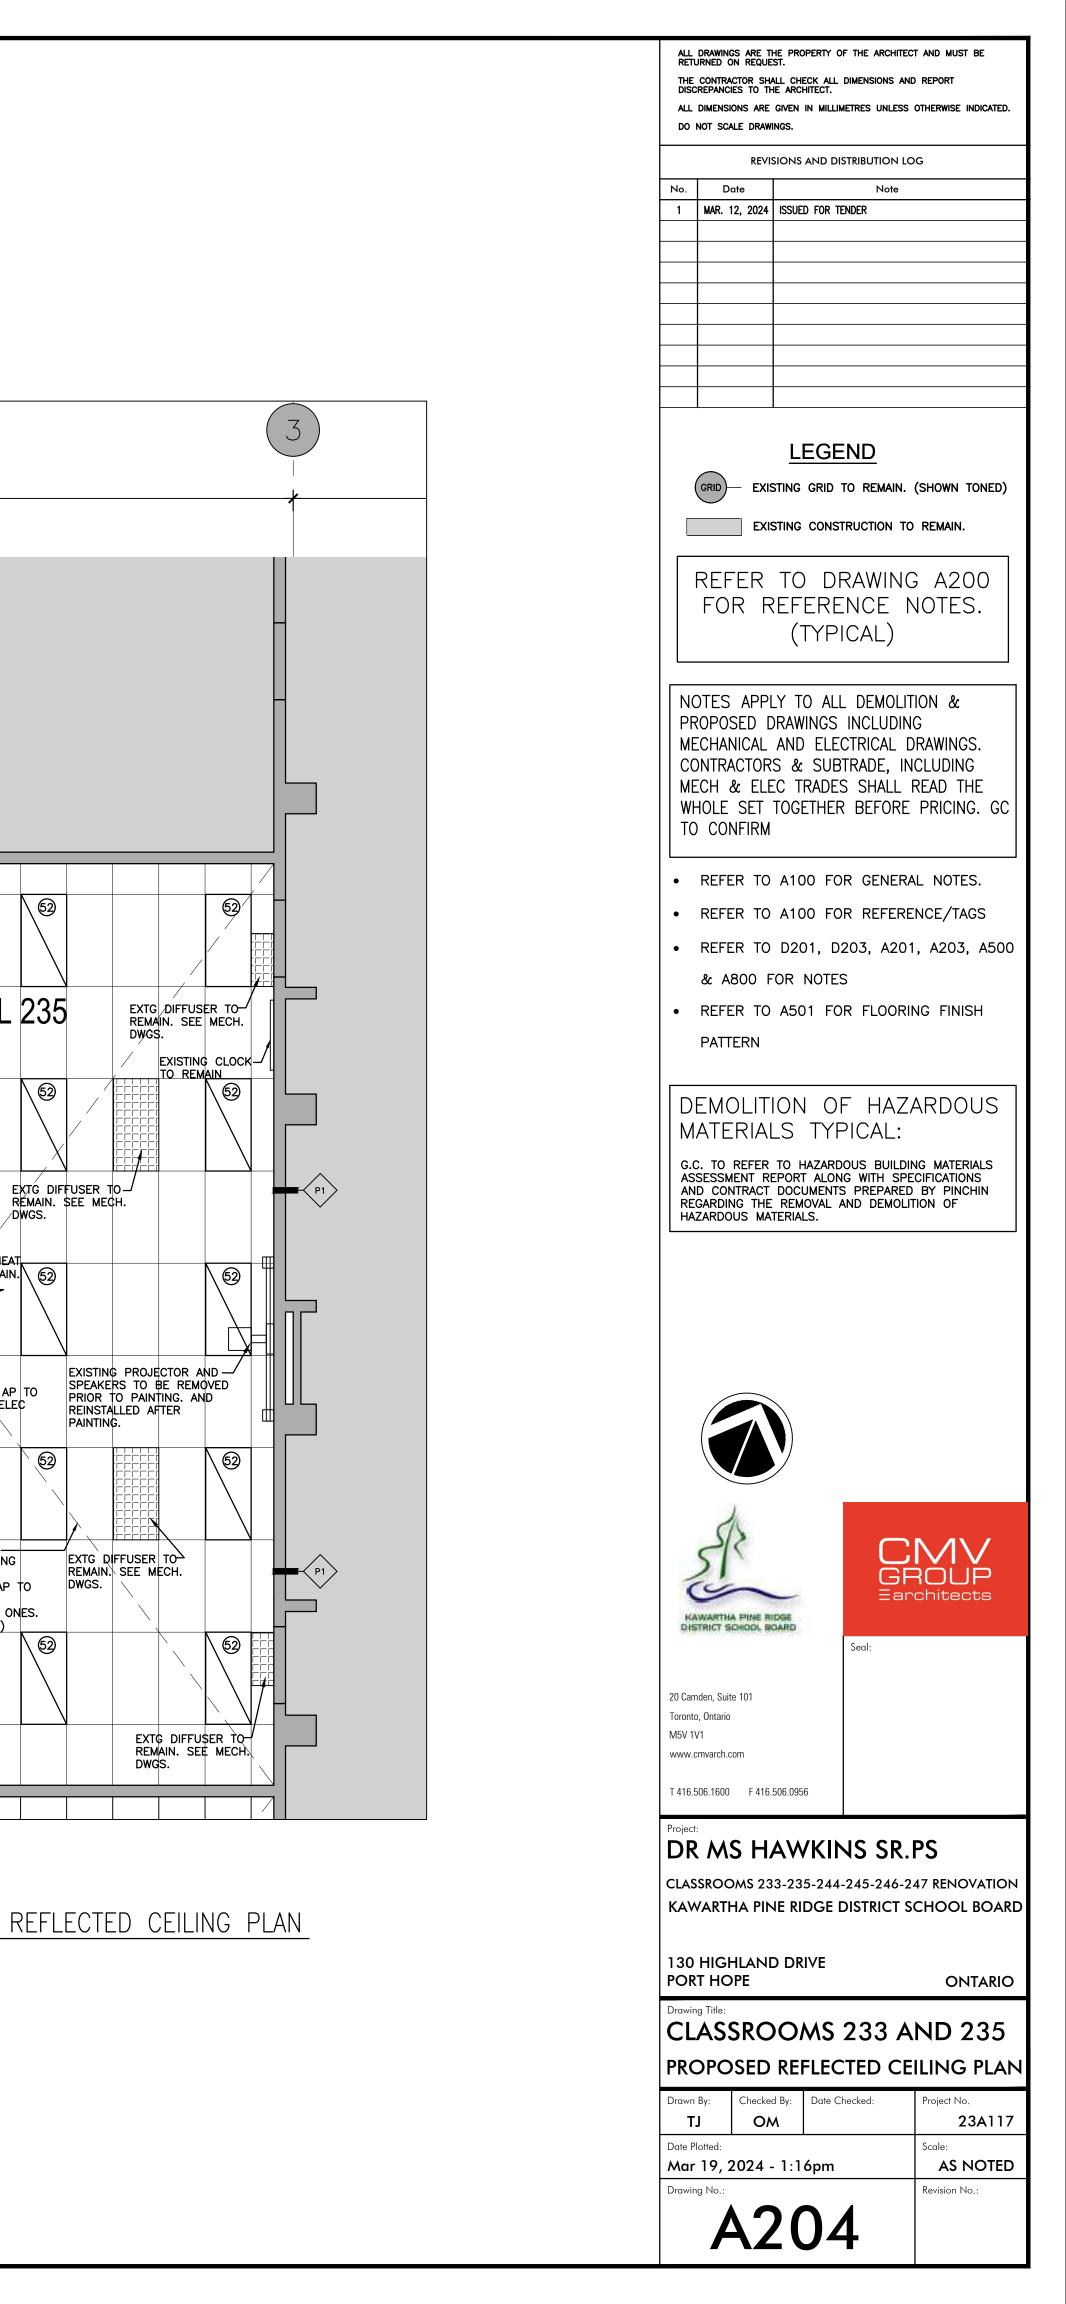


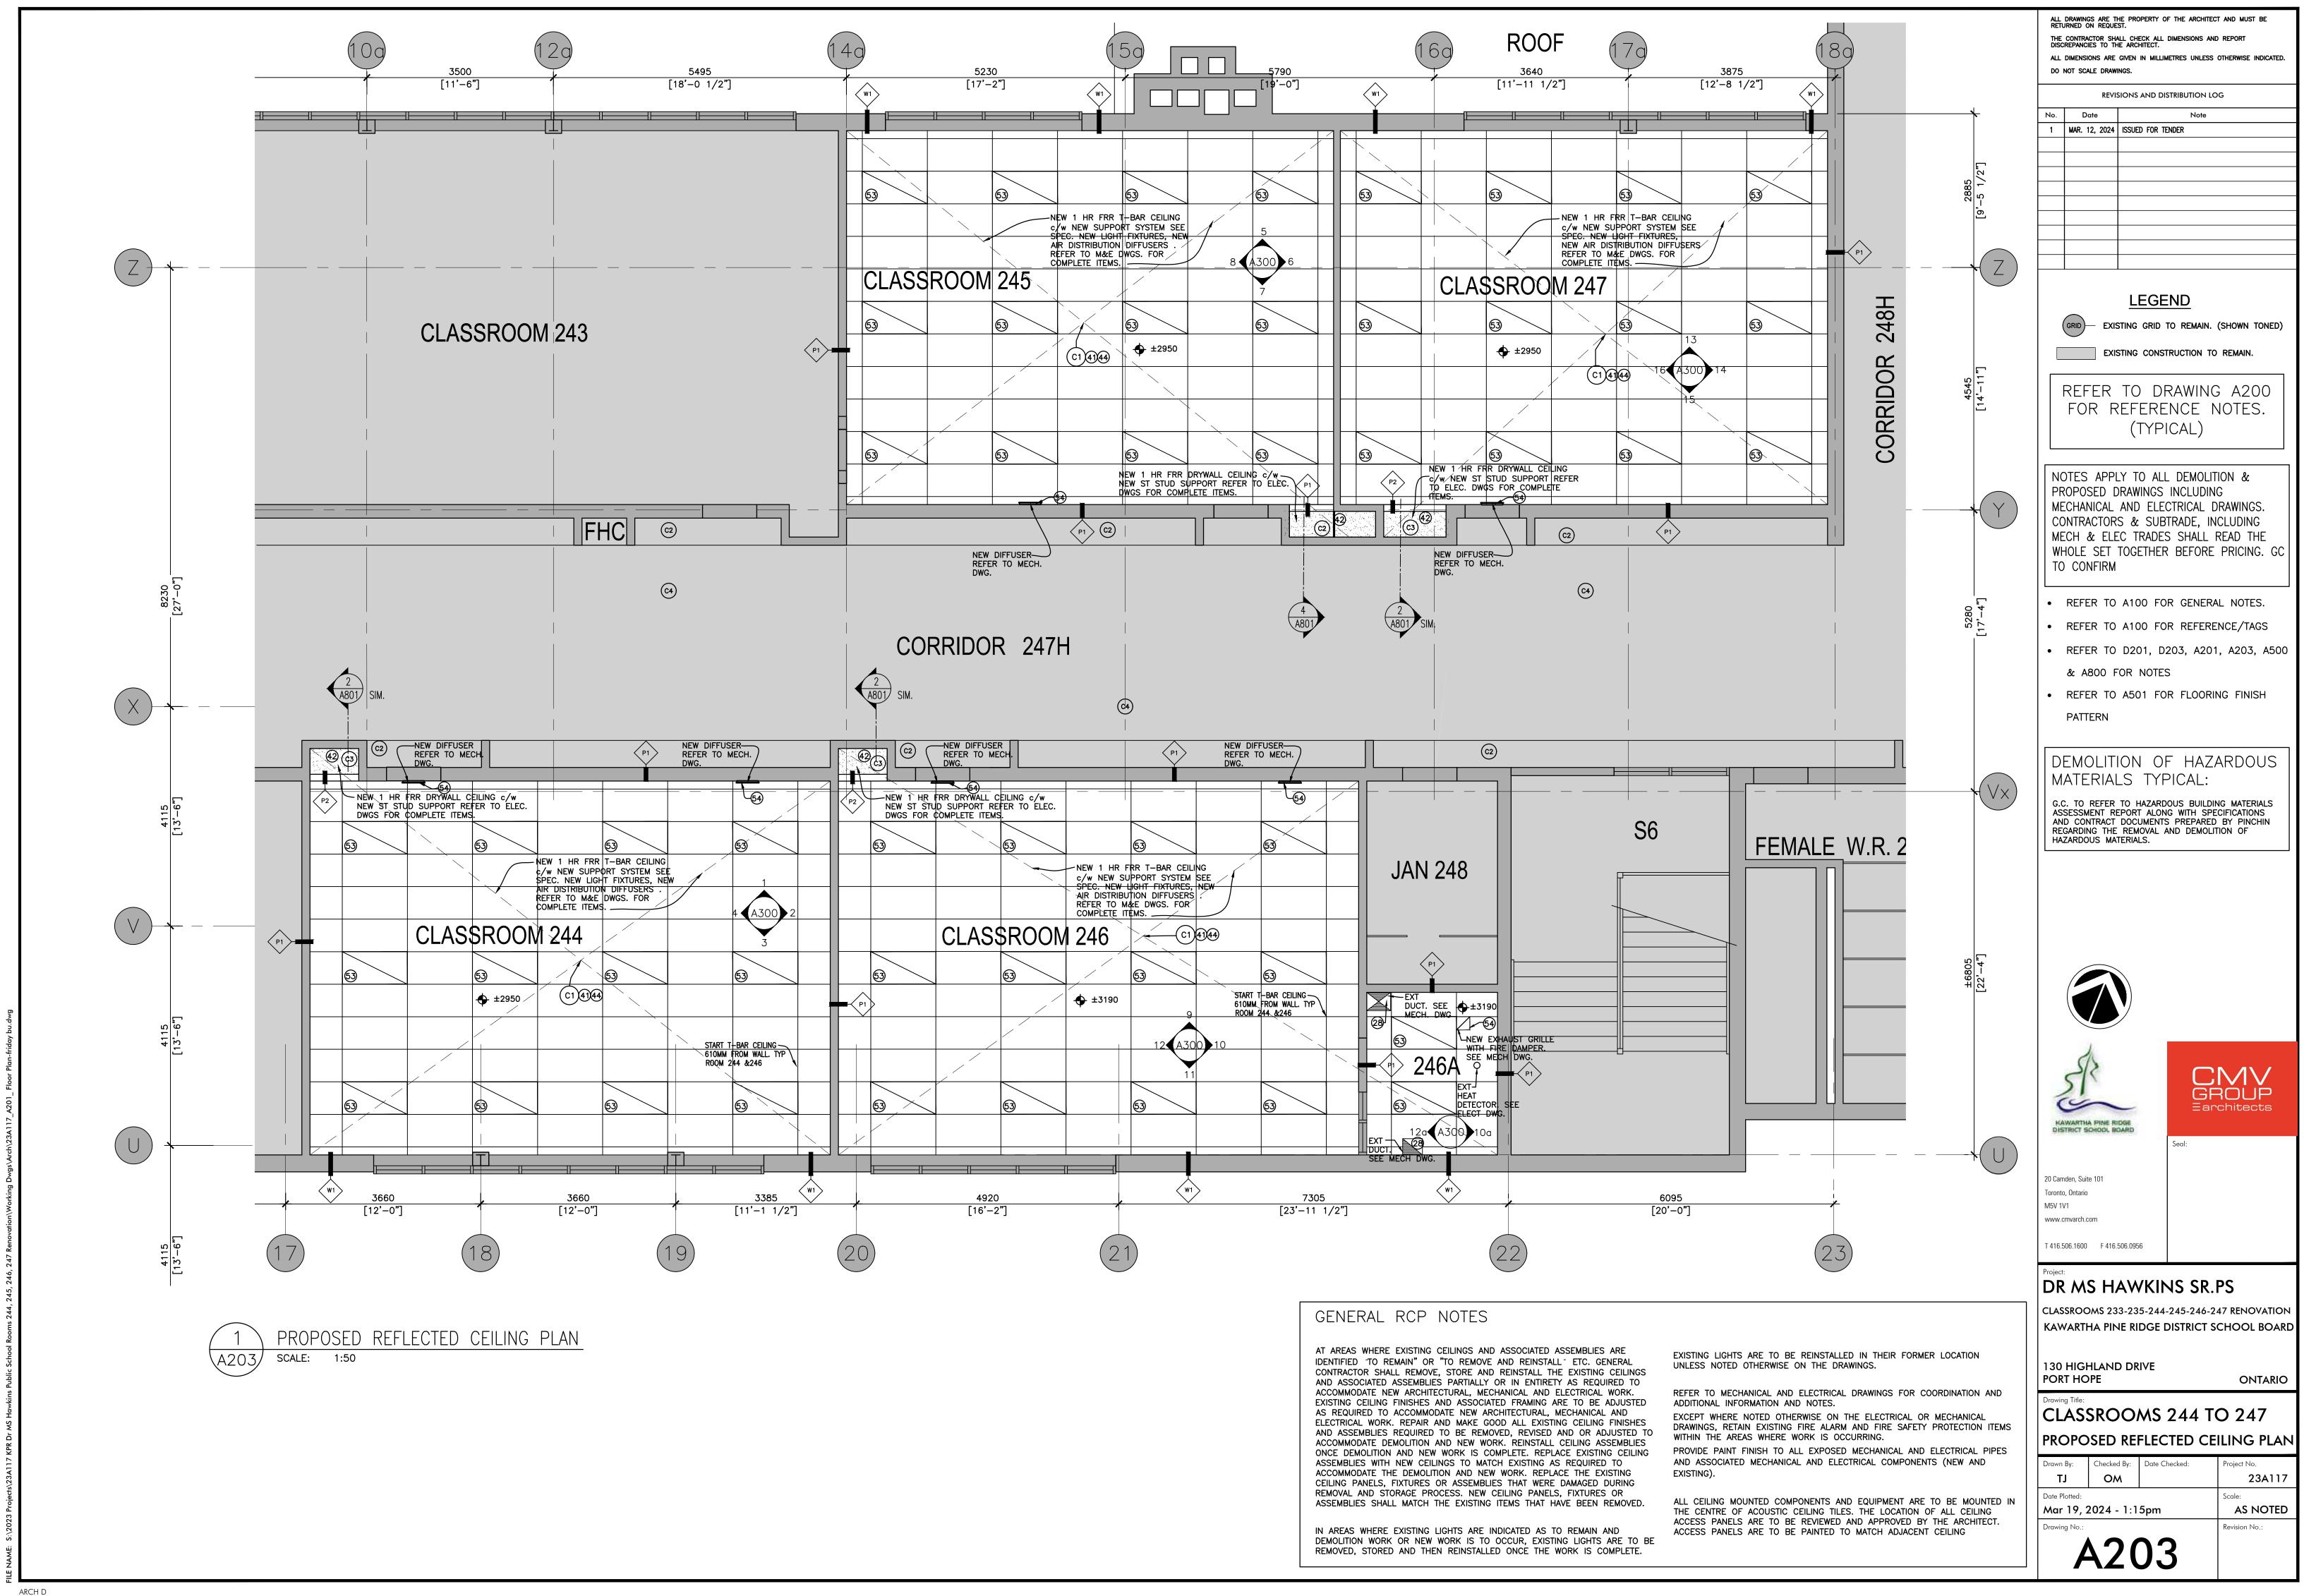







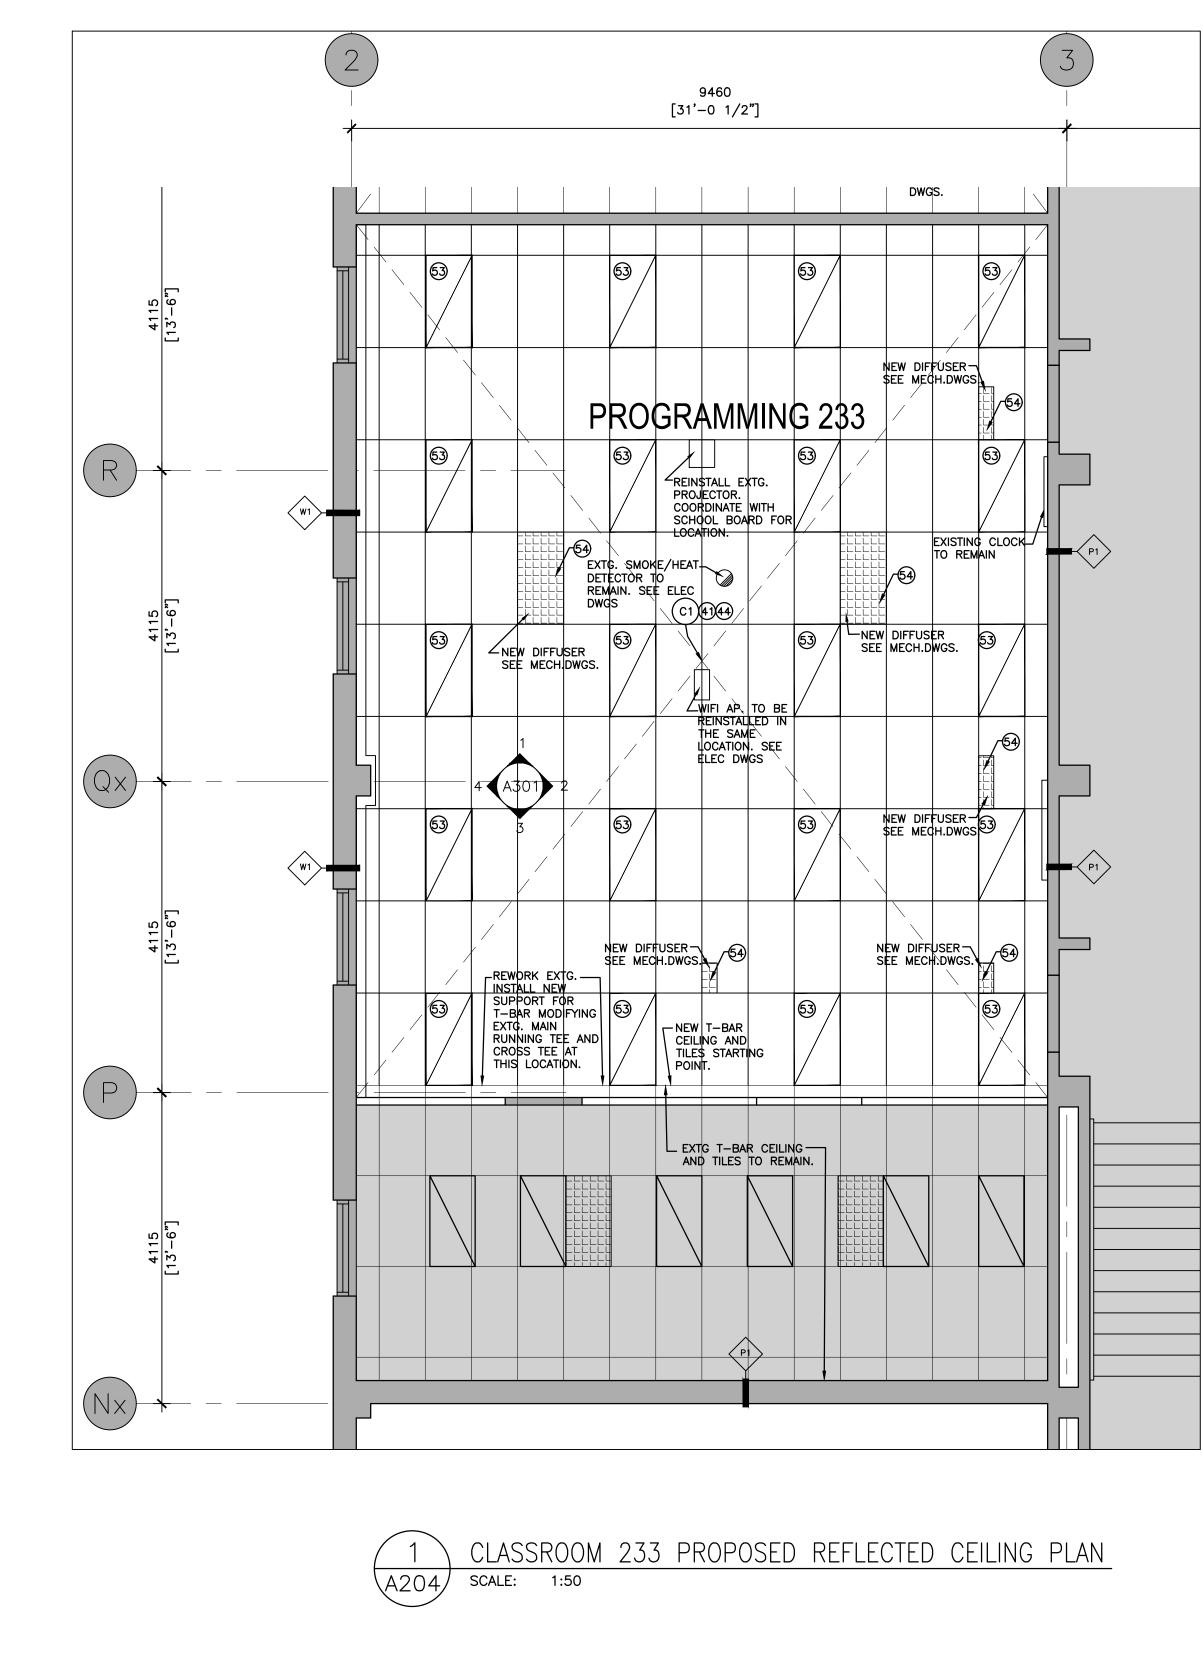


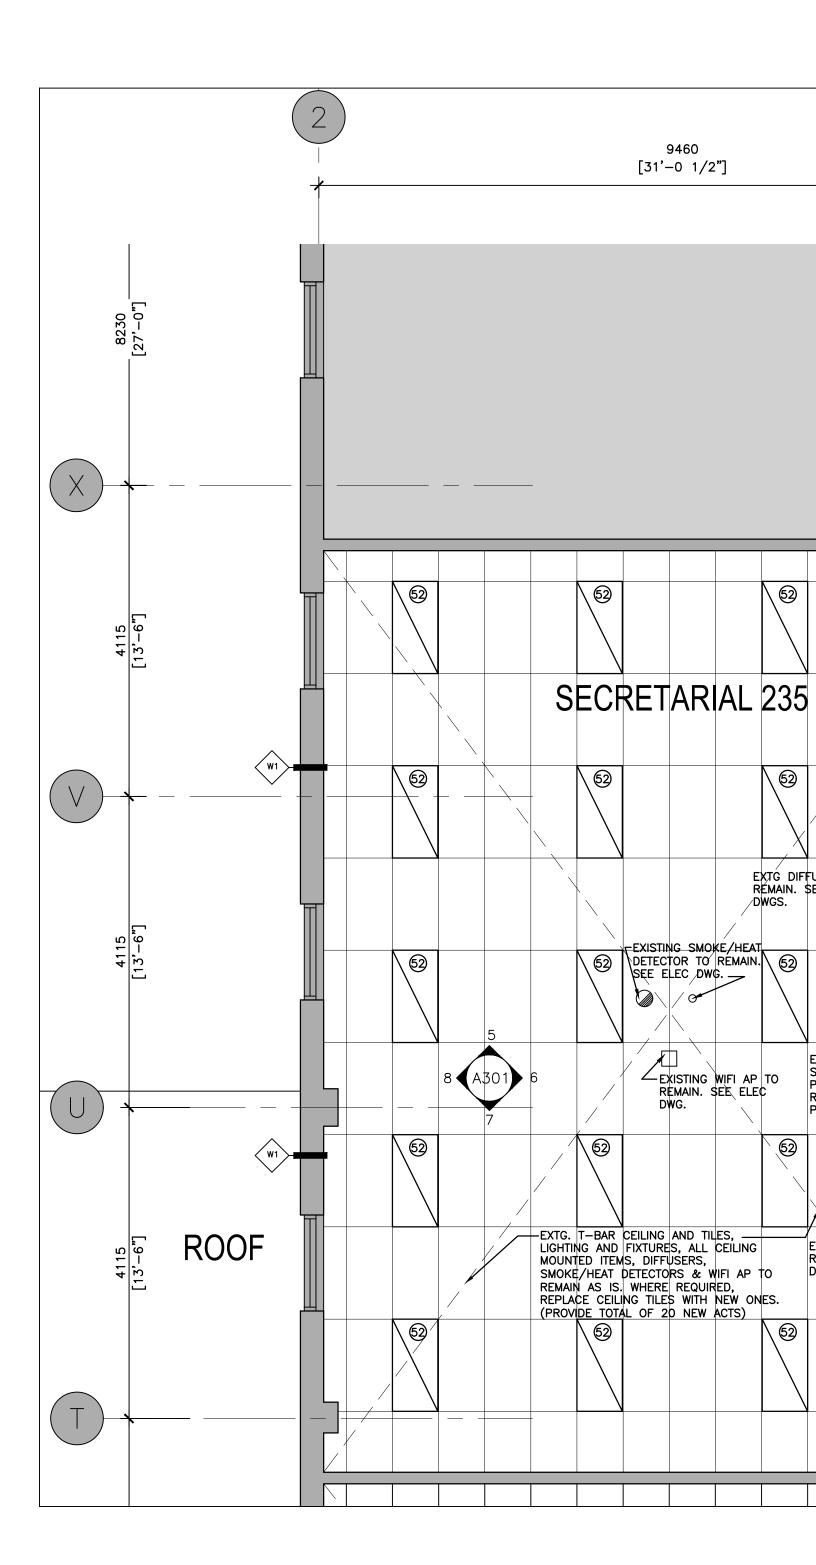

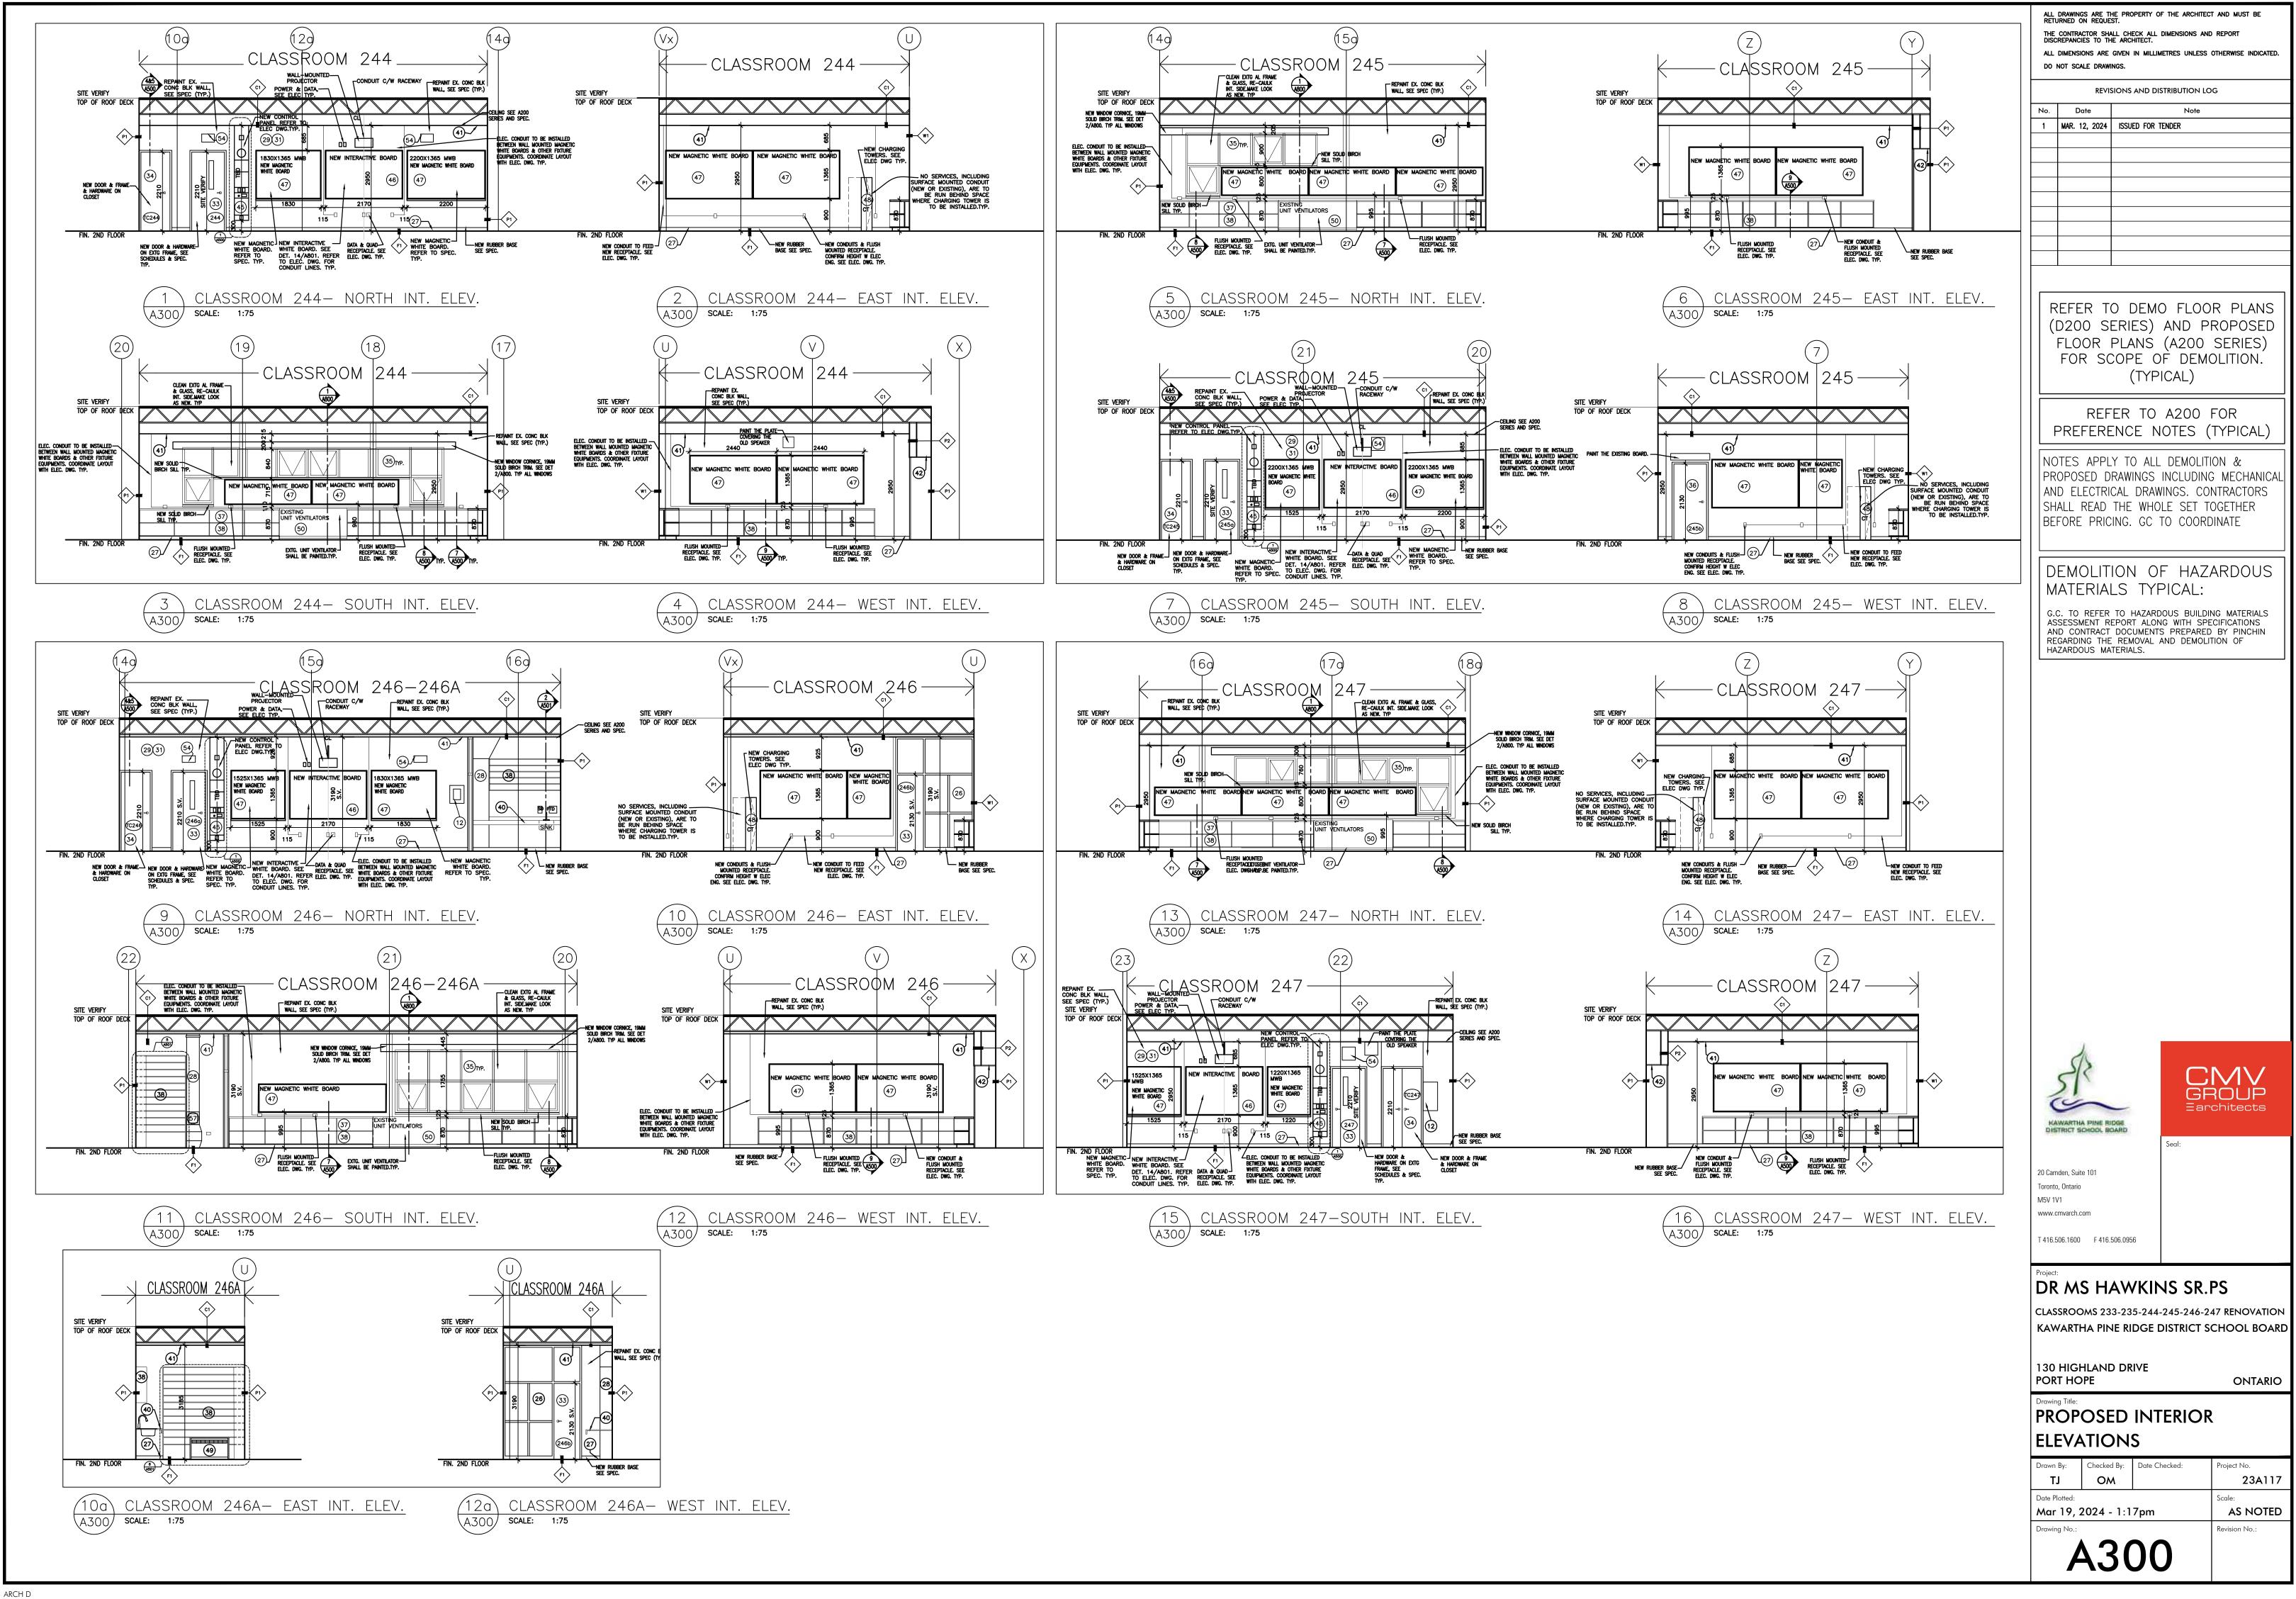

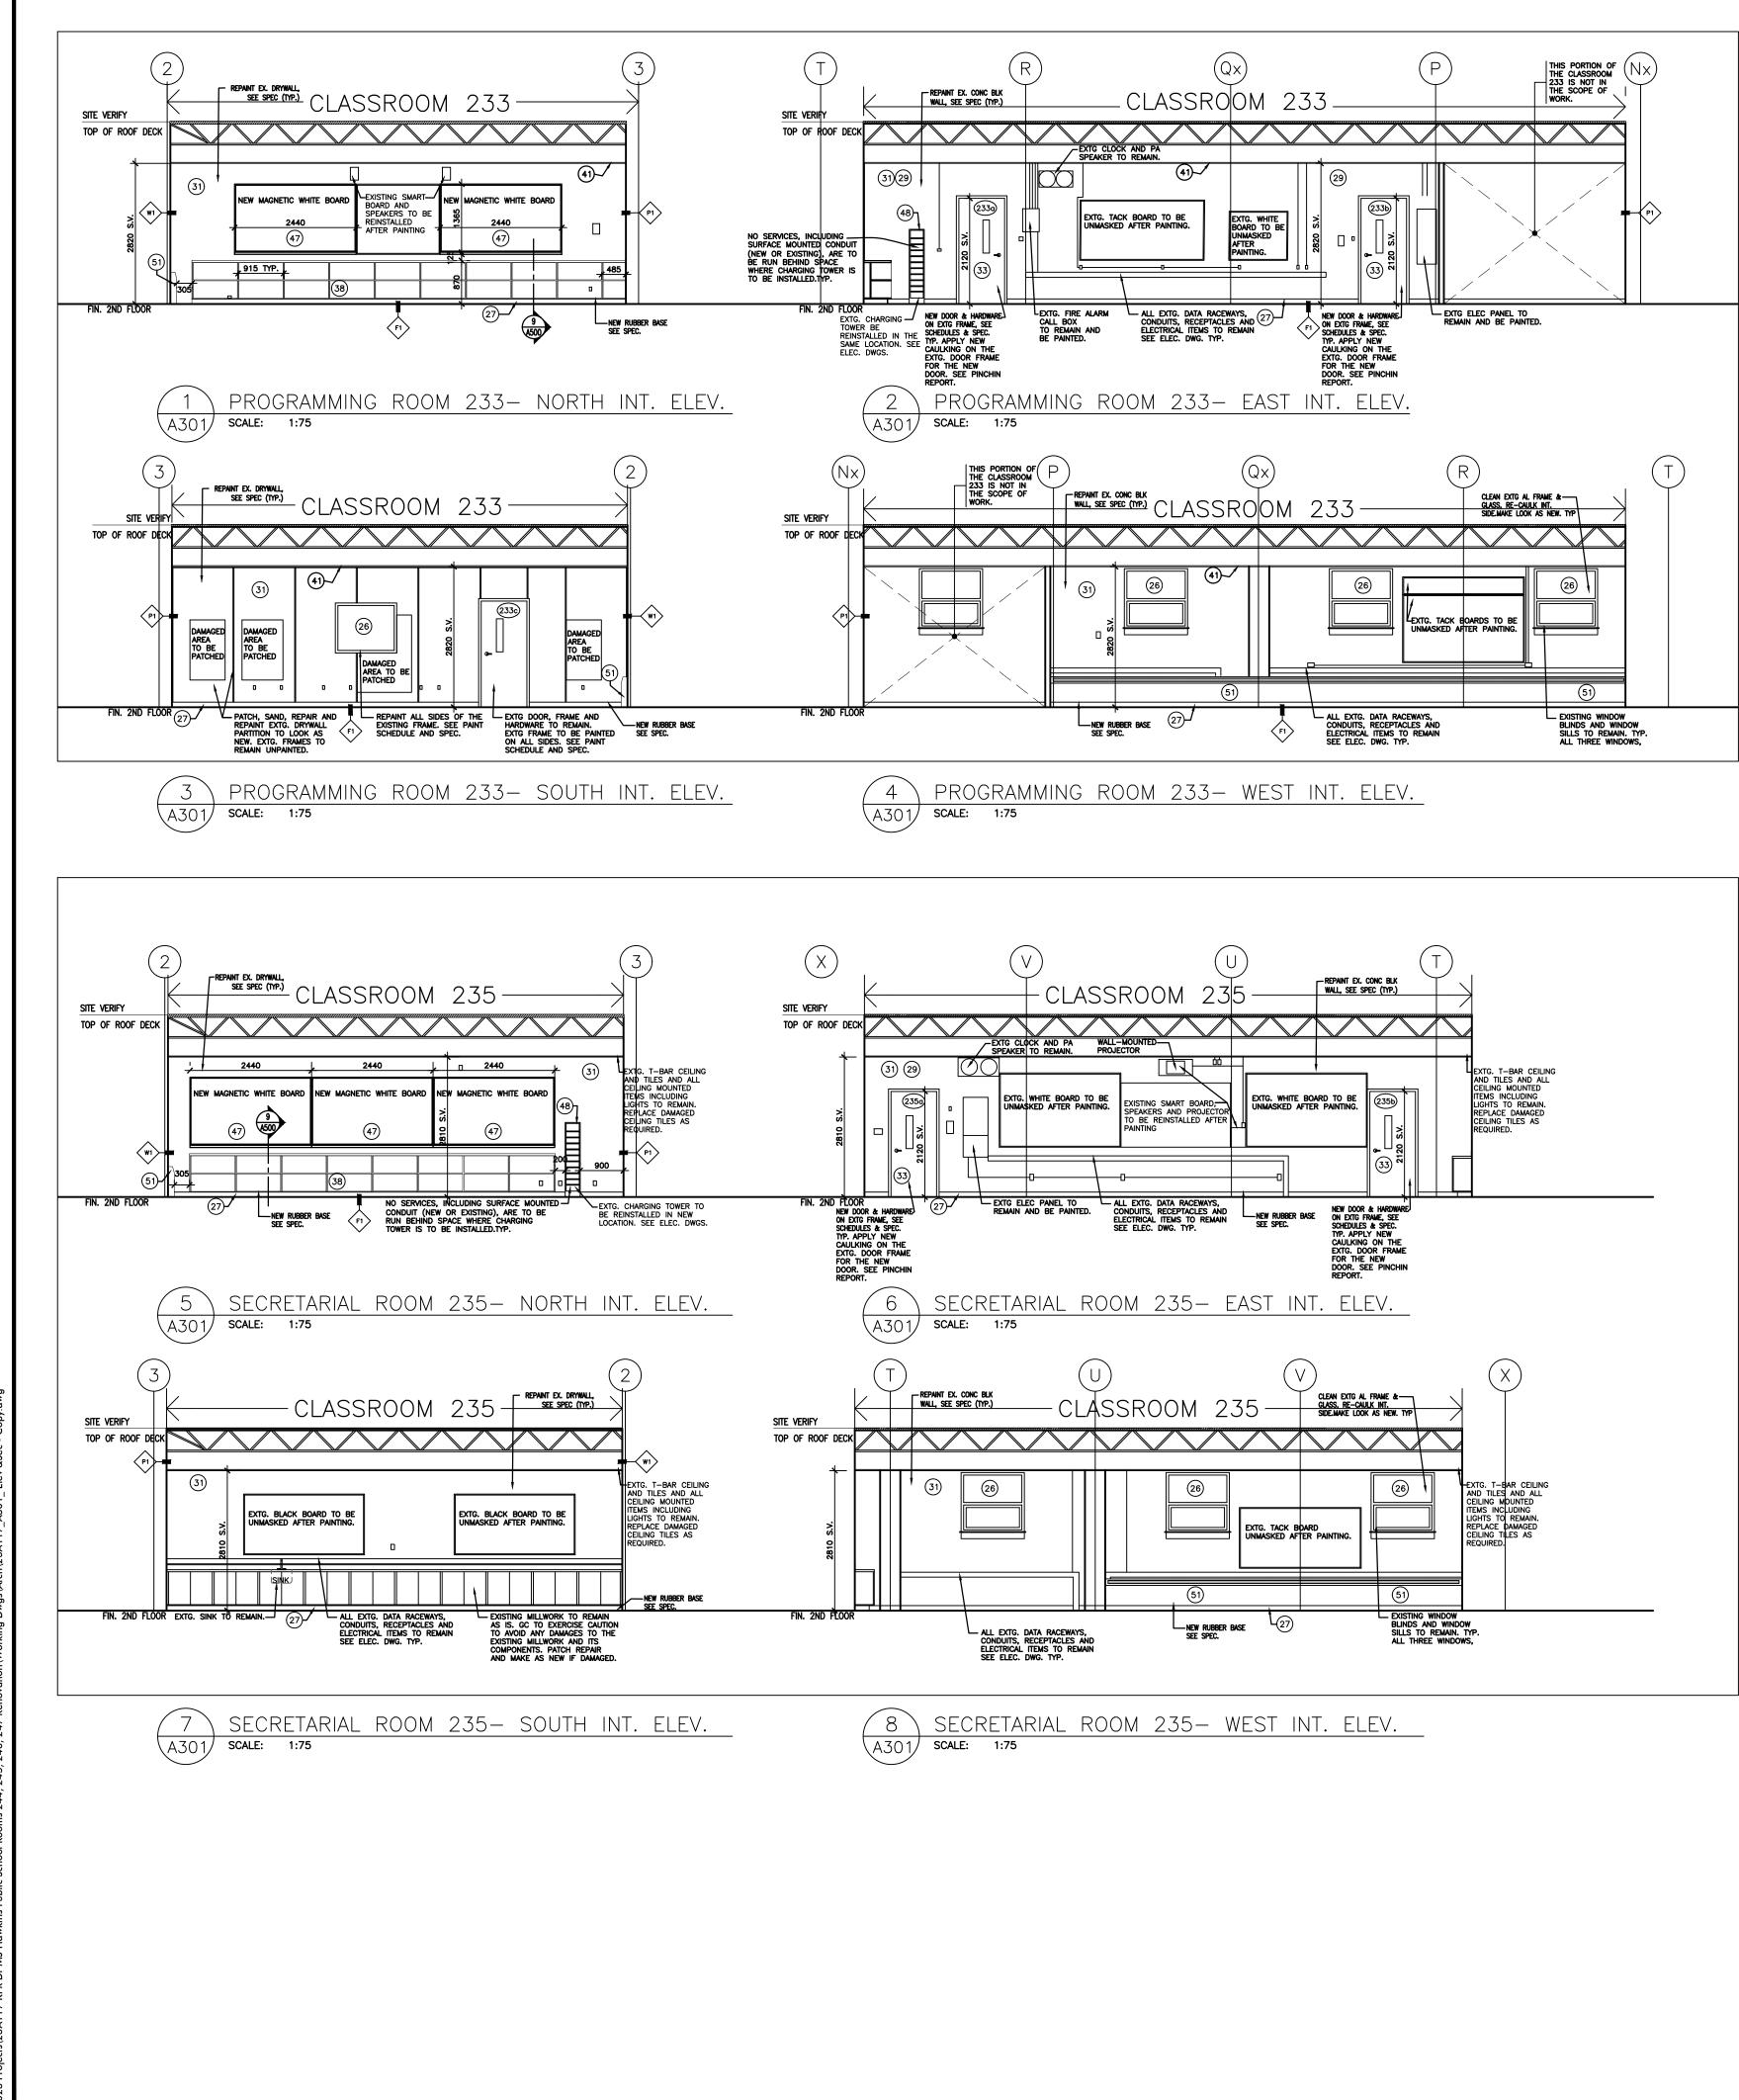



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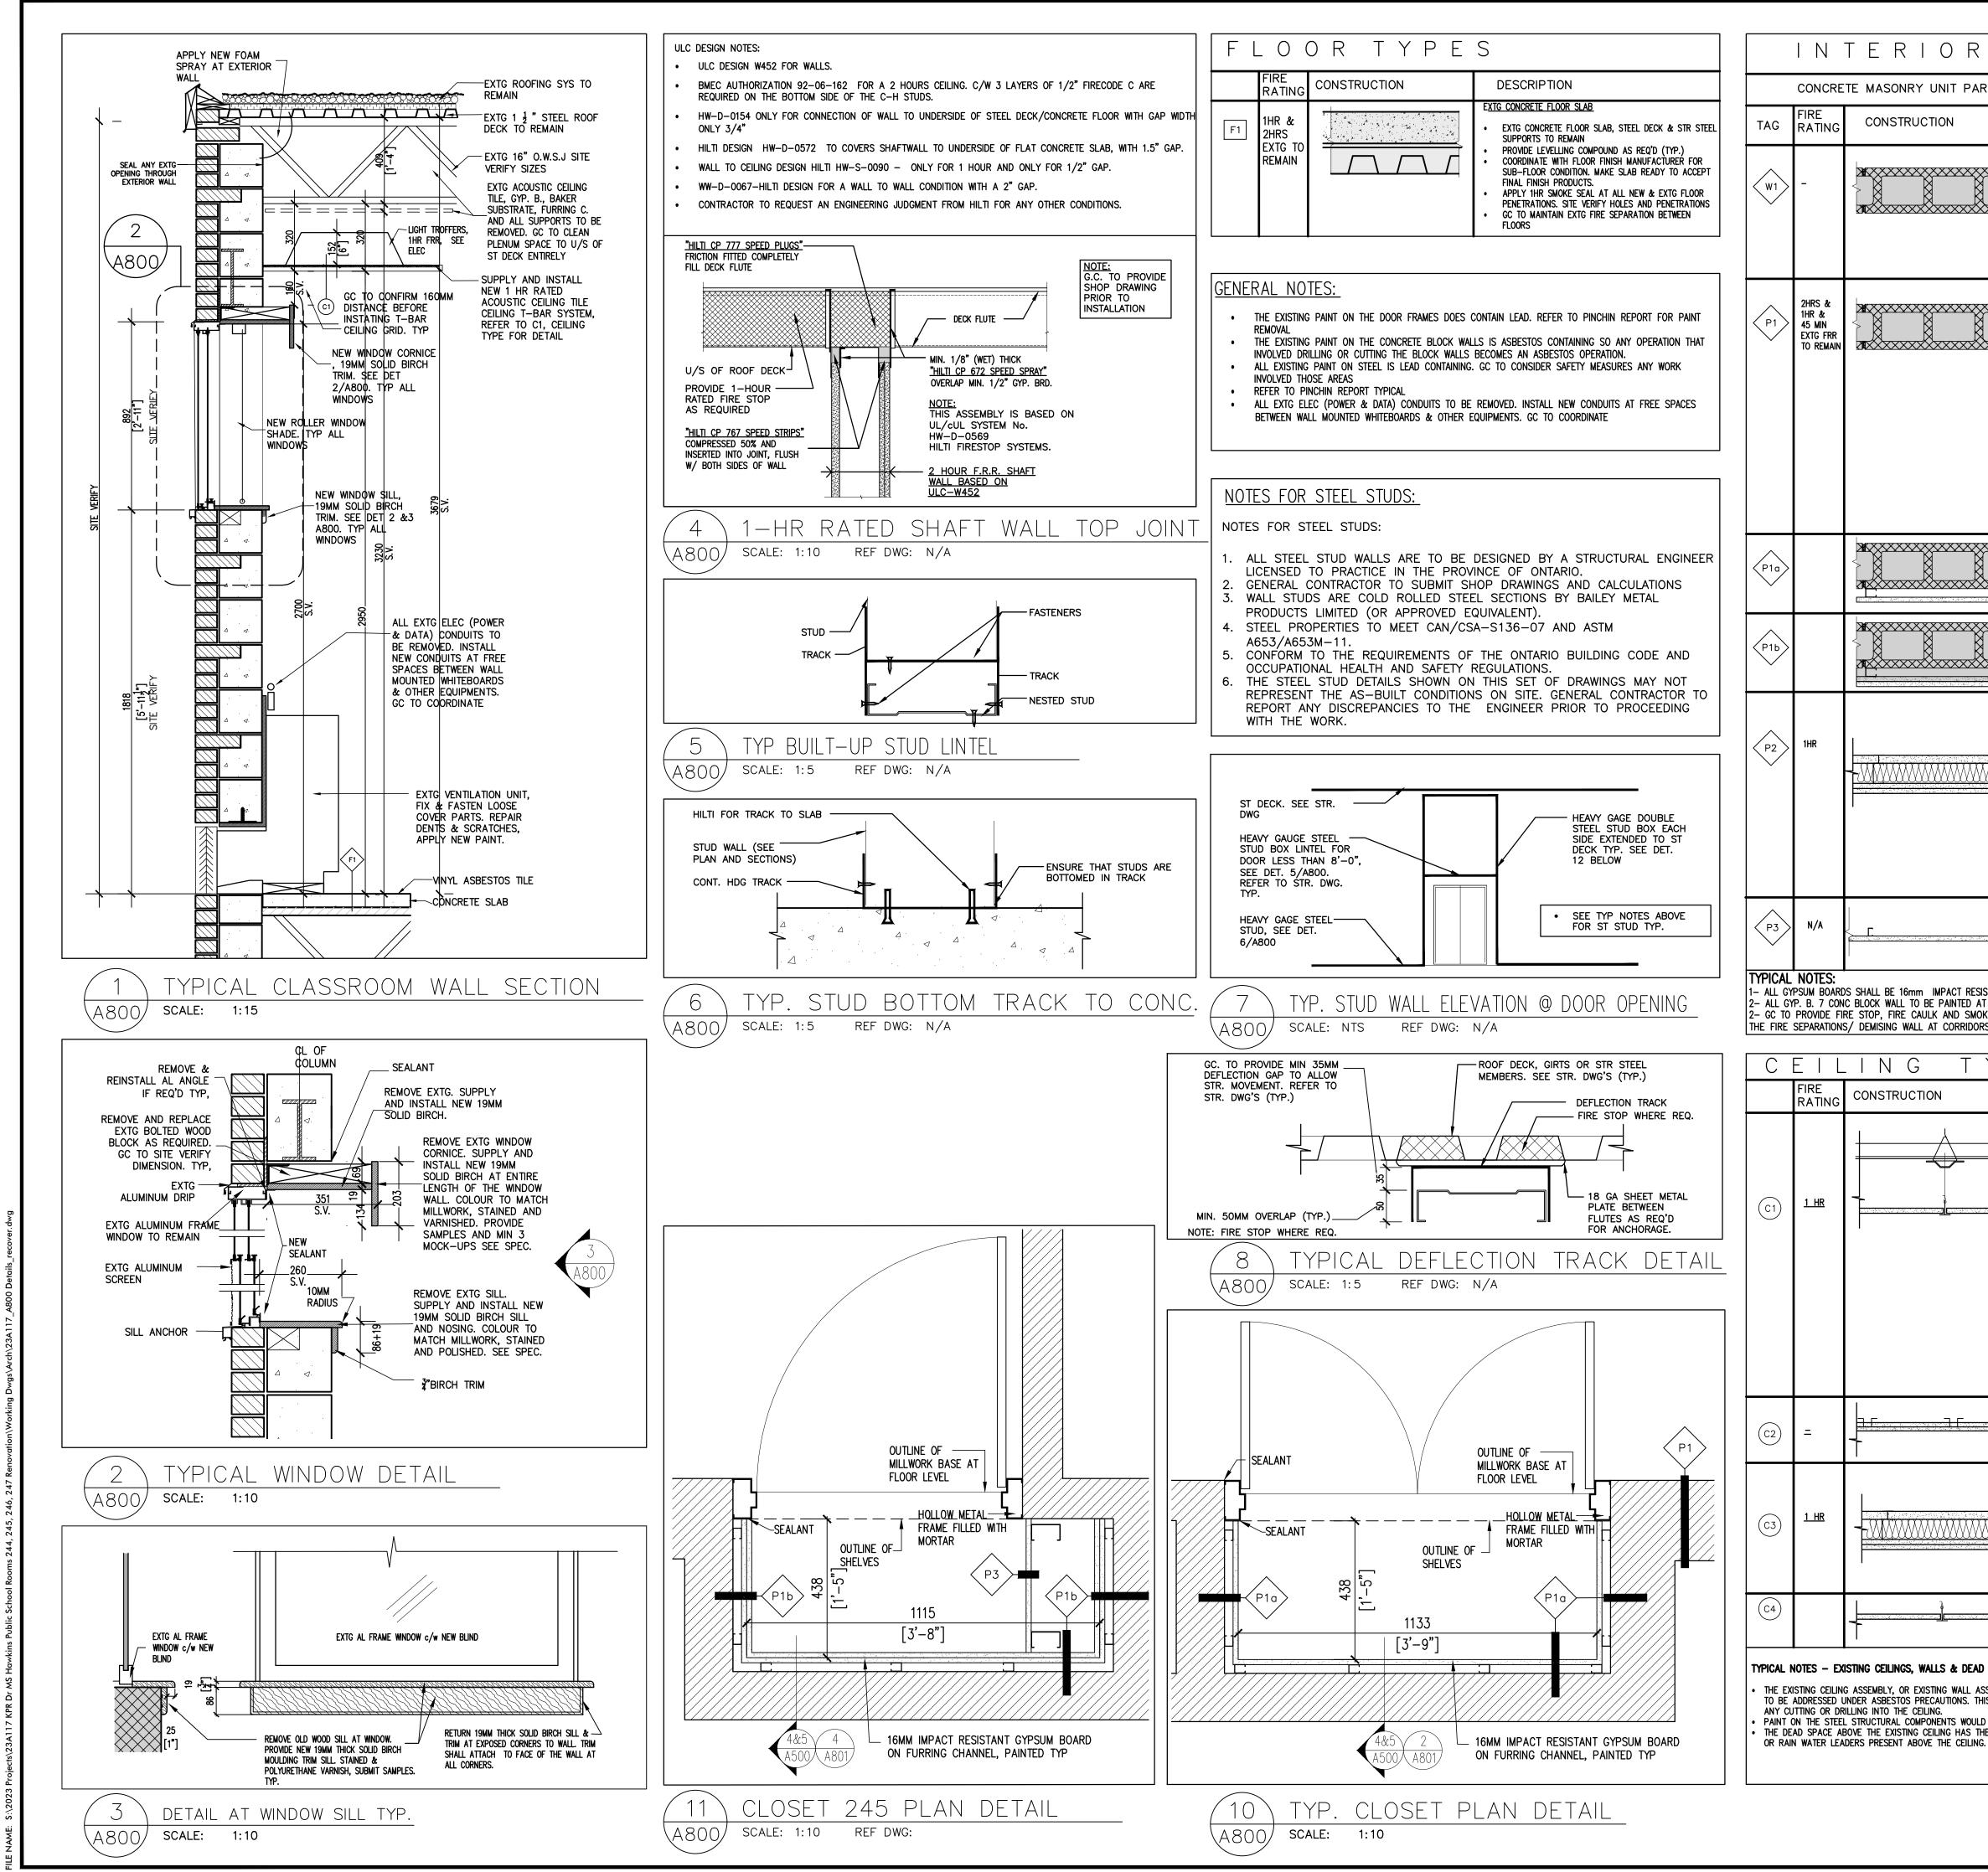
100H BASE MILLWORK MATERIAL: ALL-PLYWOOD OR HARDWOOD. THE USE OF PARTICLE BOARD IS NOT ACCEPTABLE ON ANY PART OF MILLWORK.

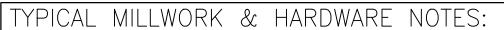- DRAWERS.
- LOCKS : KEYED ALIKE



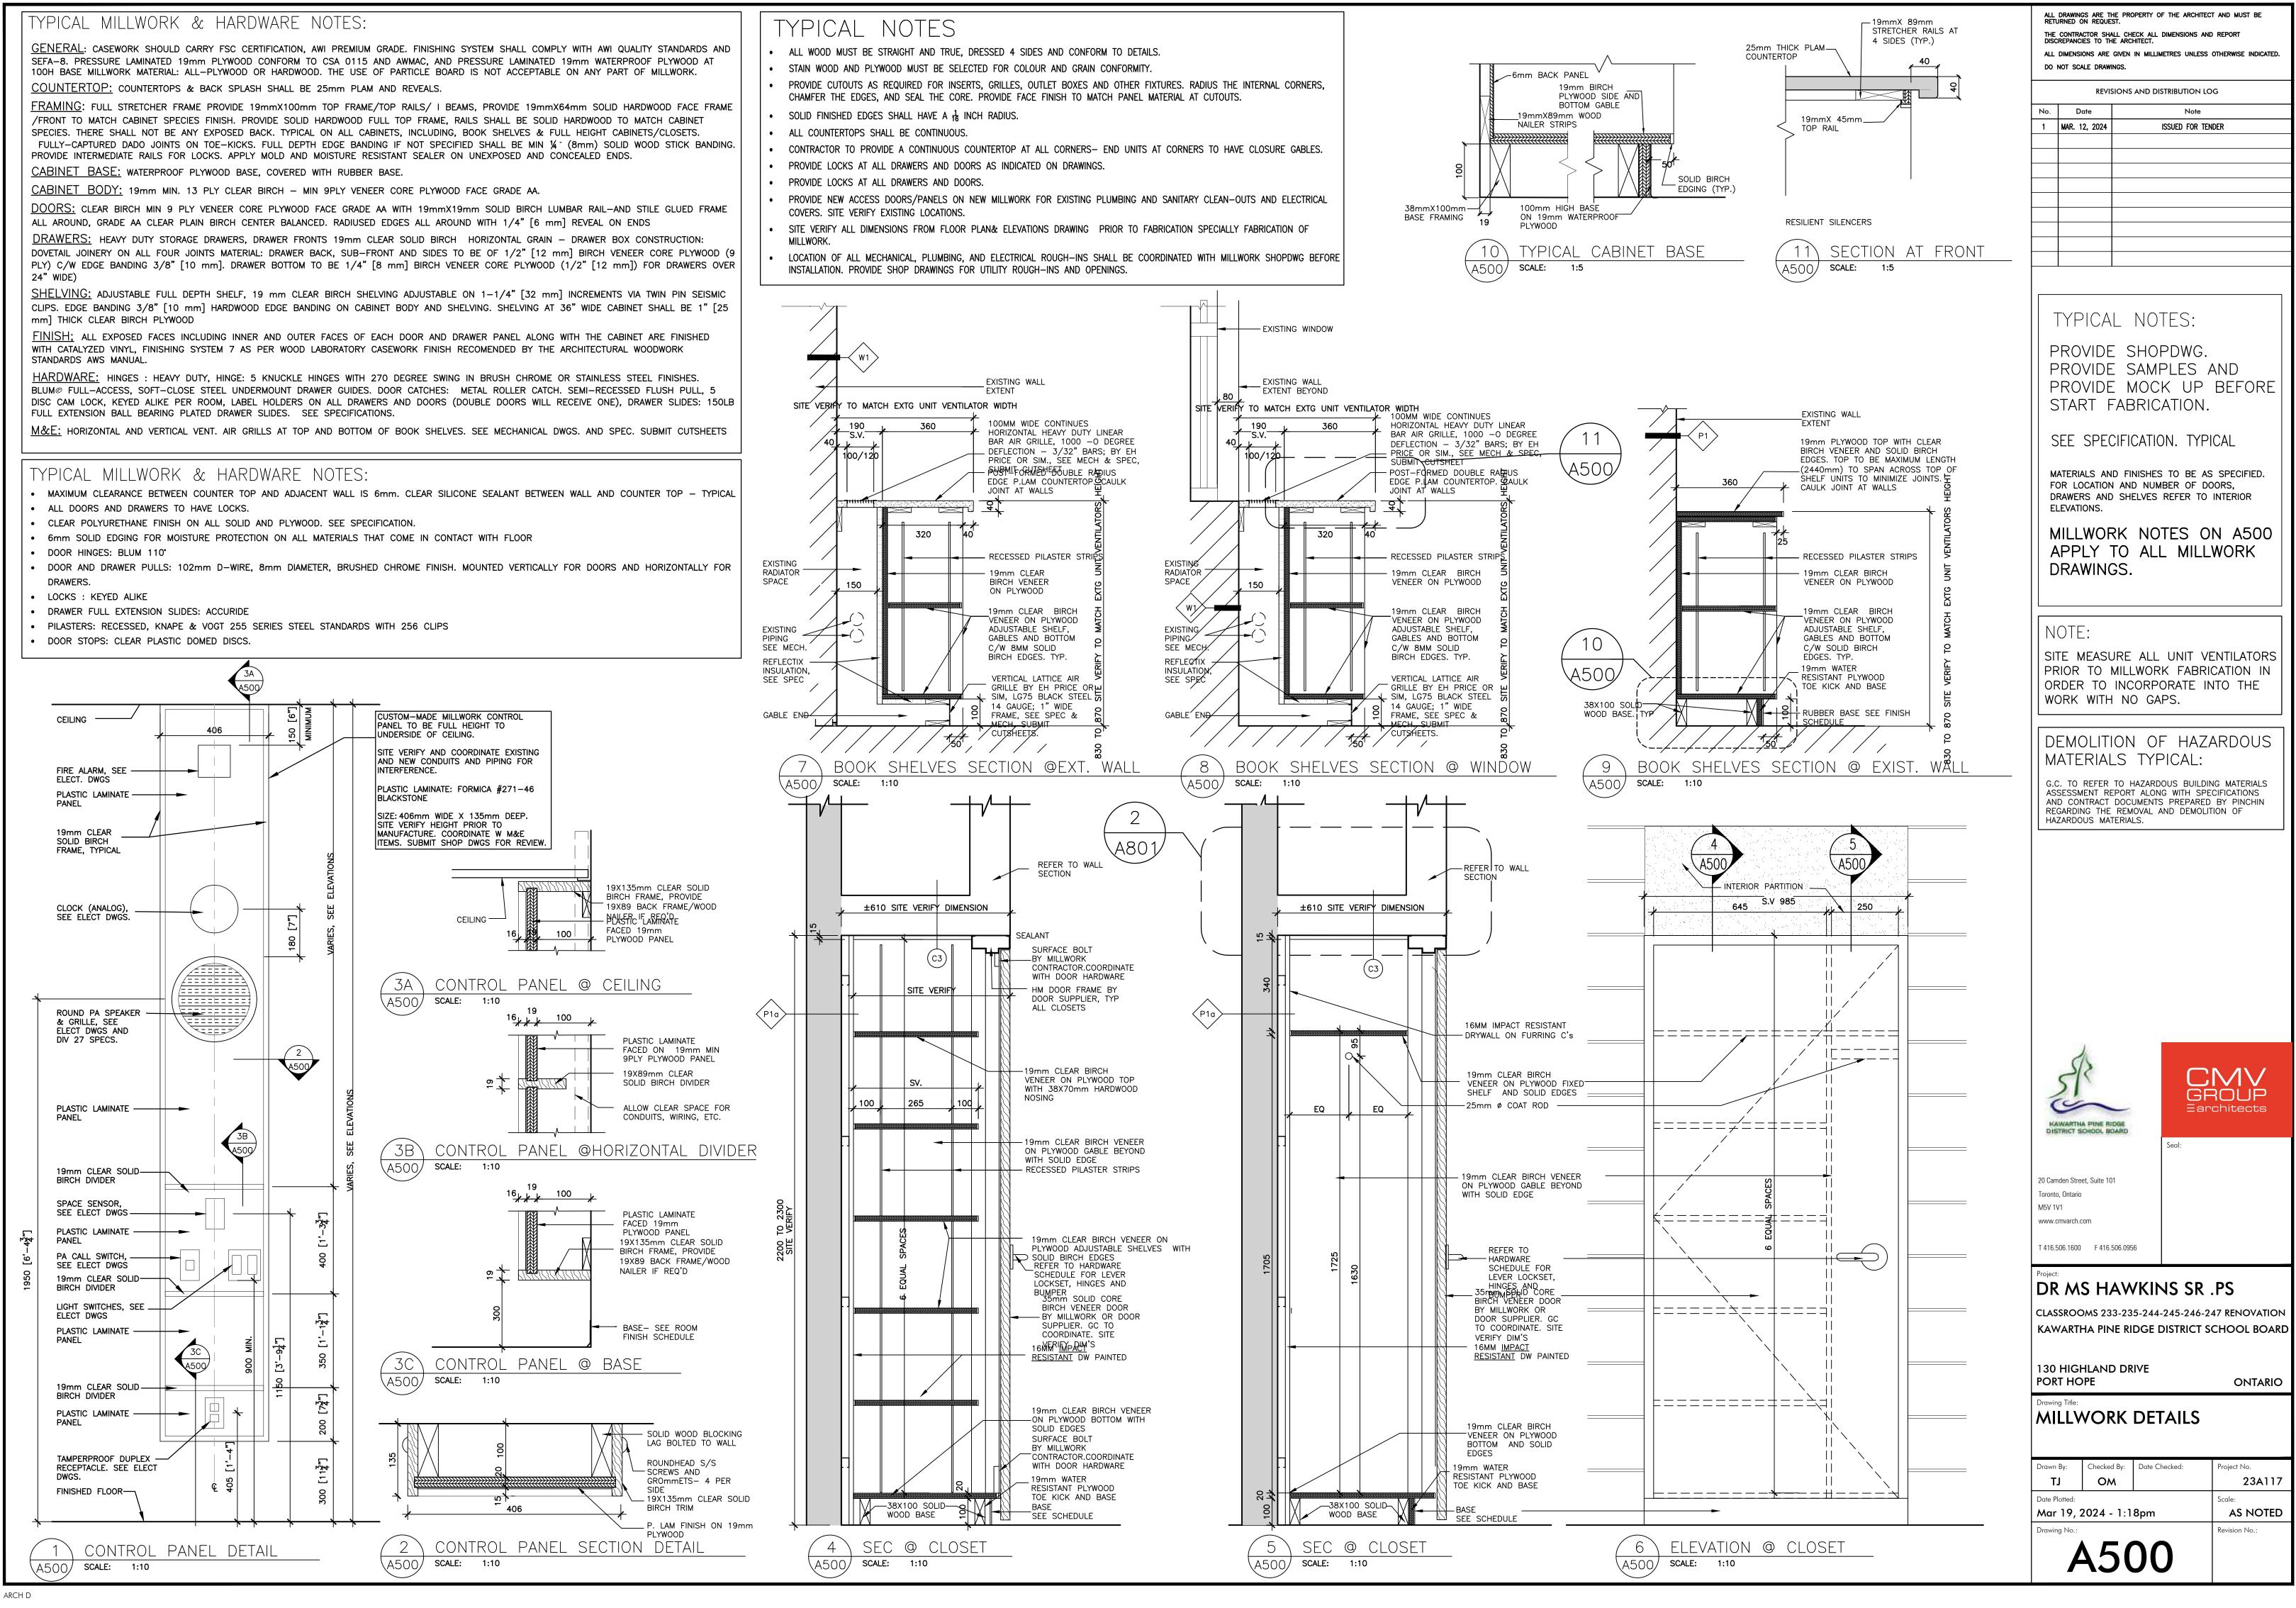

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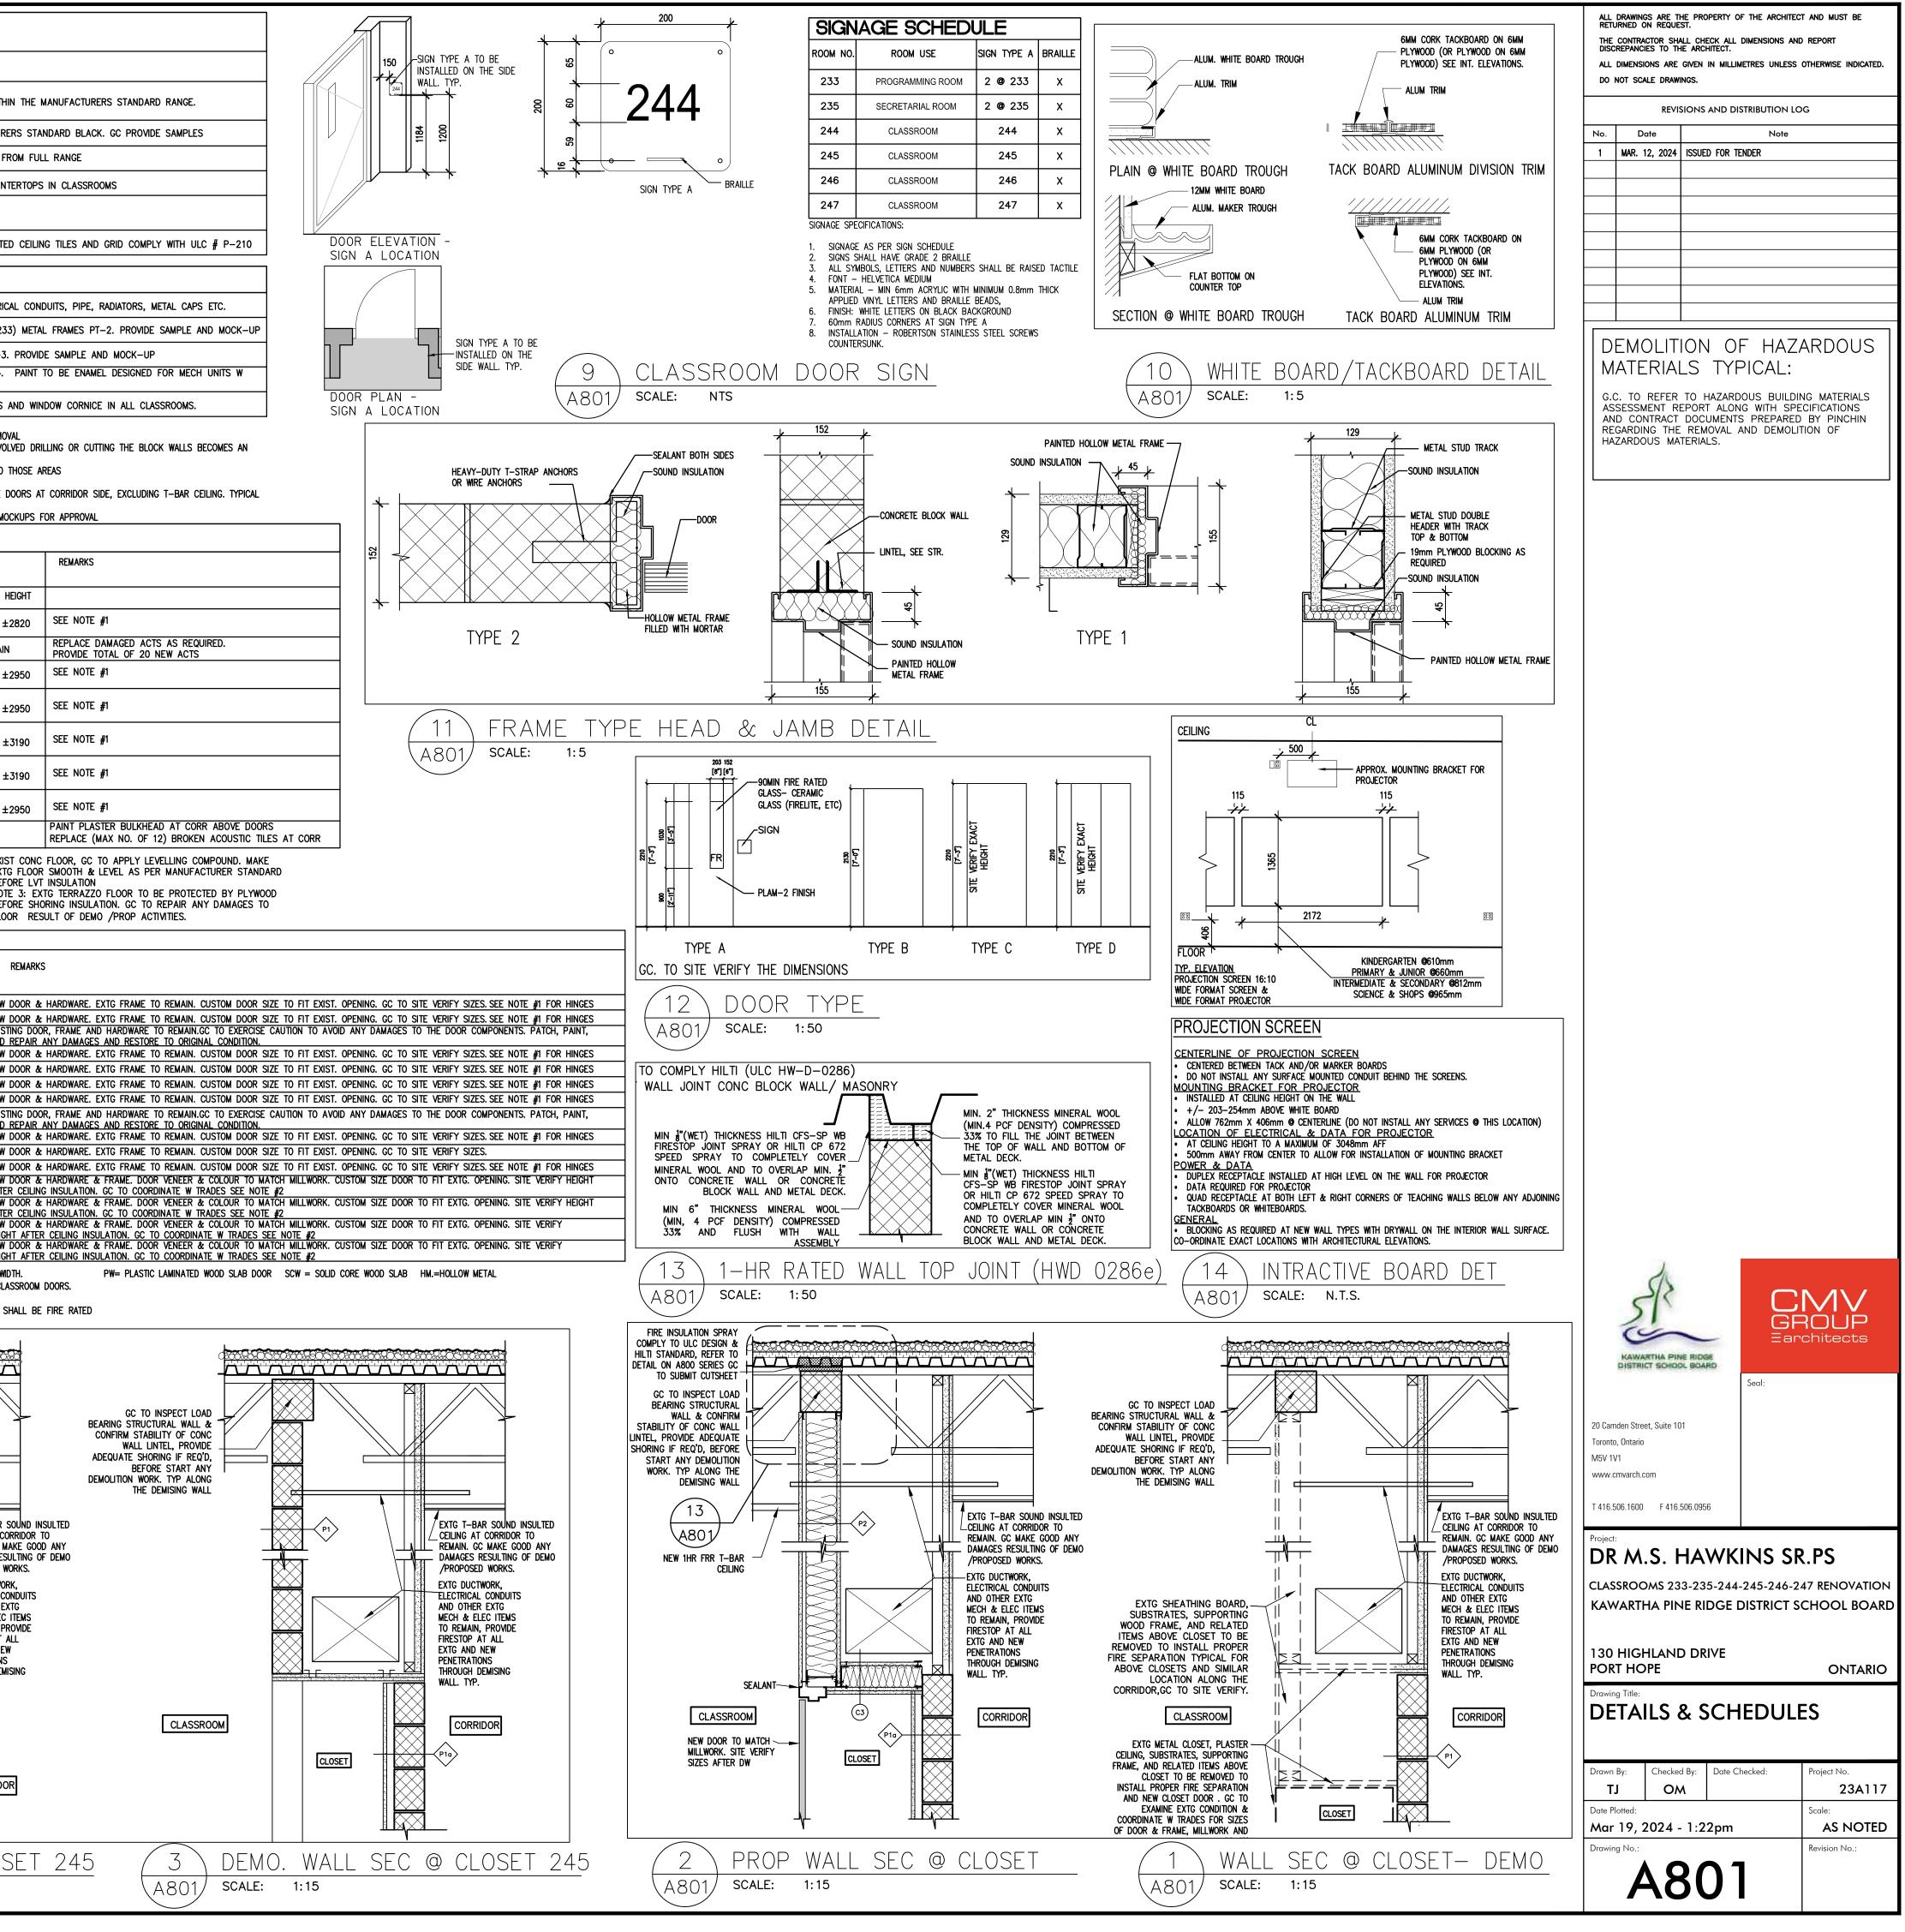

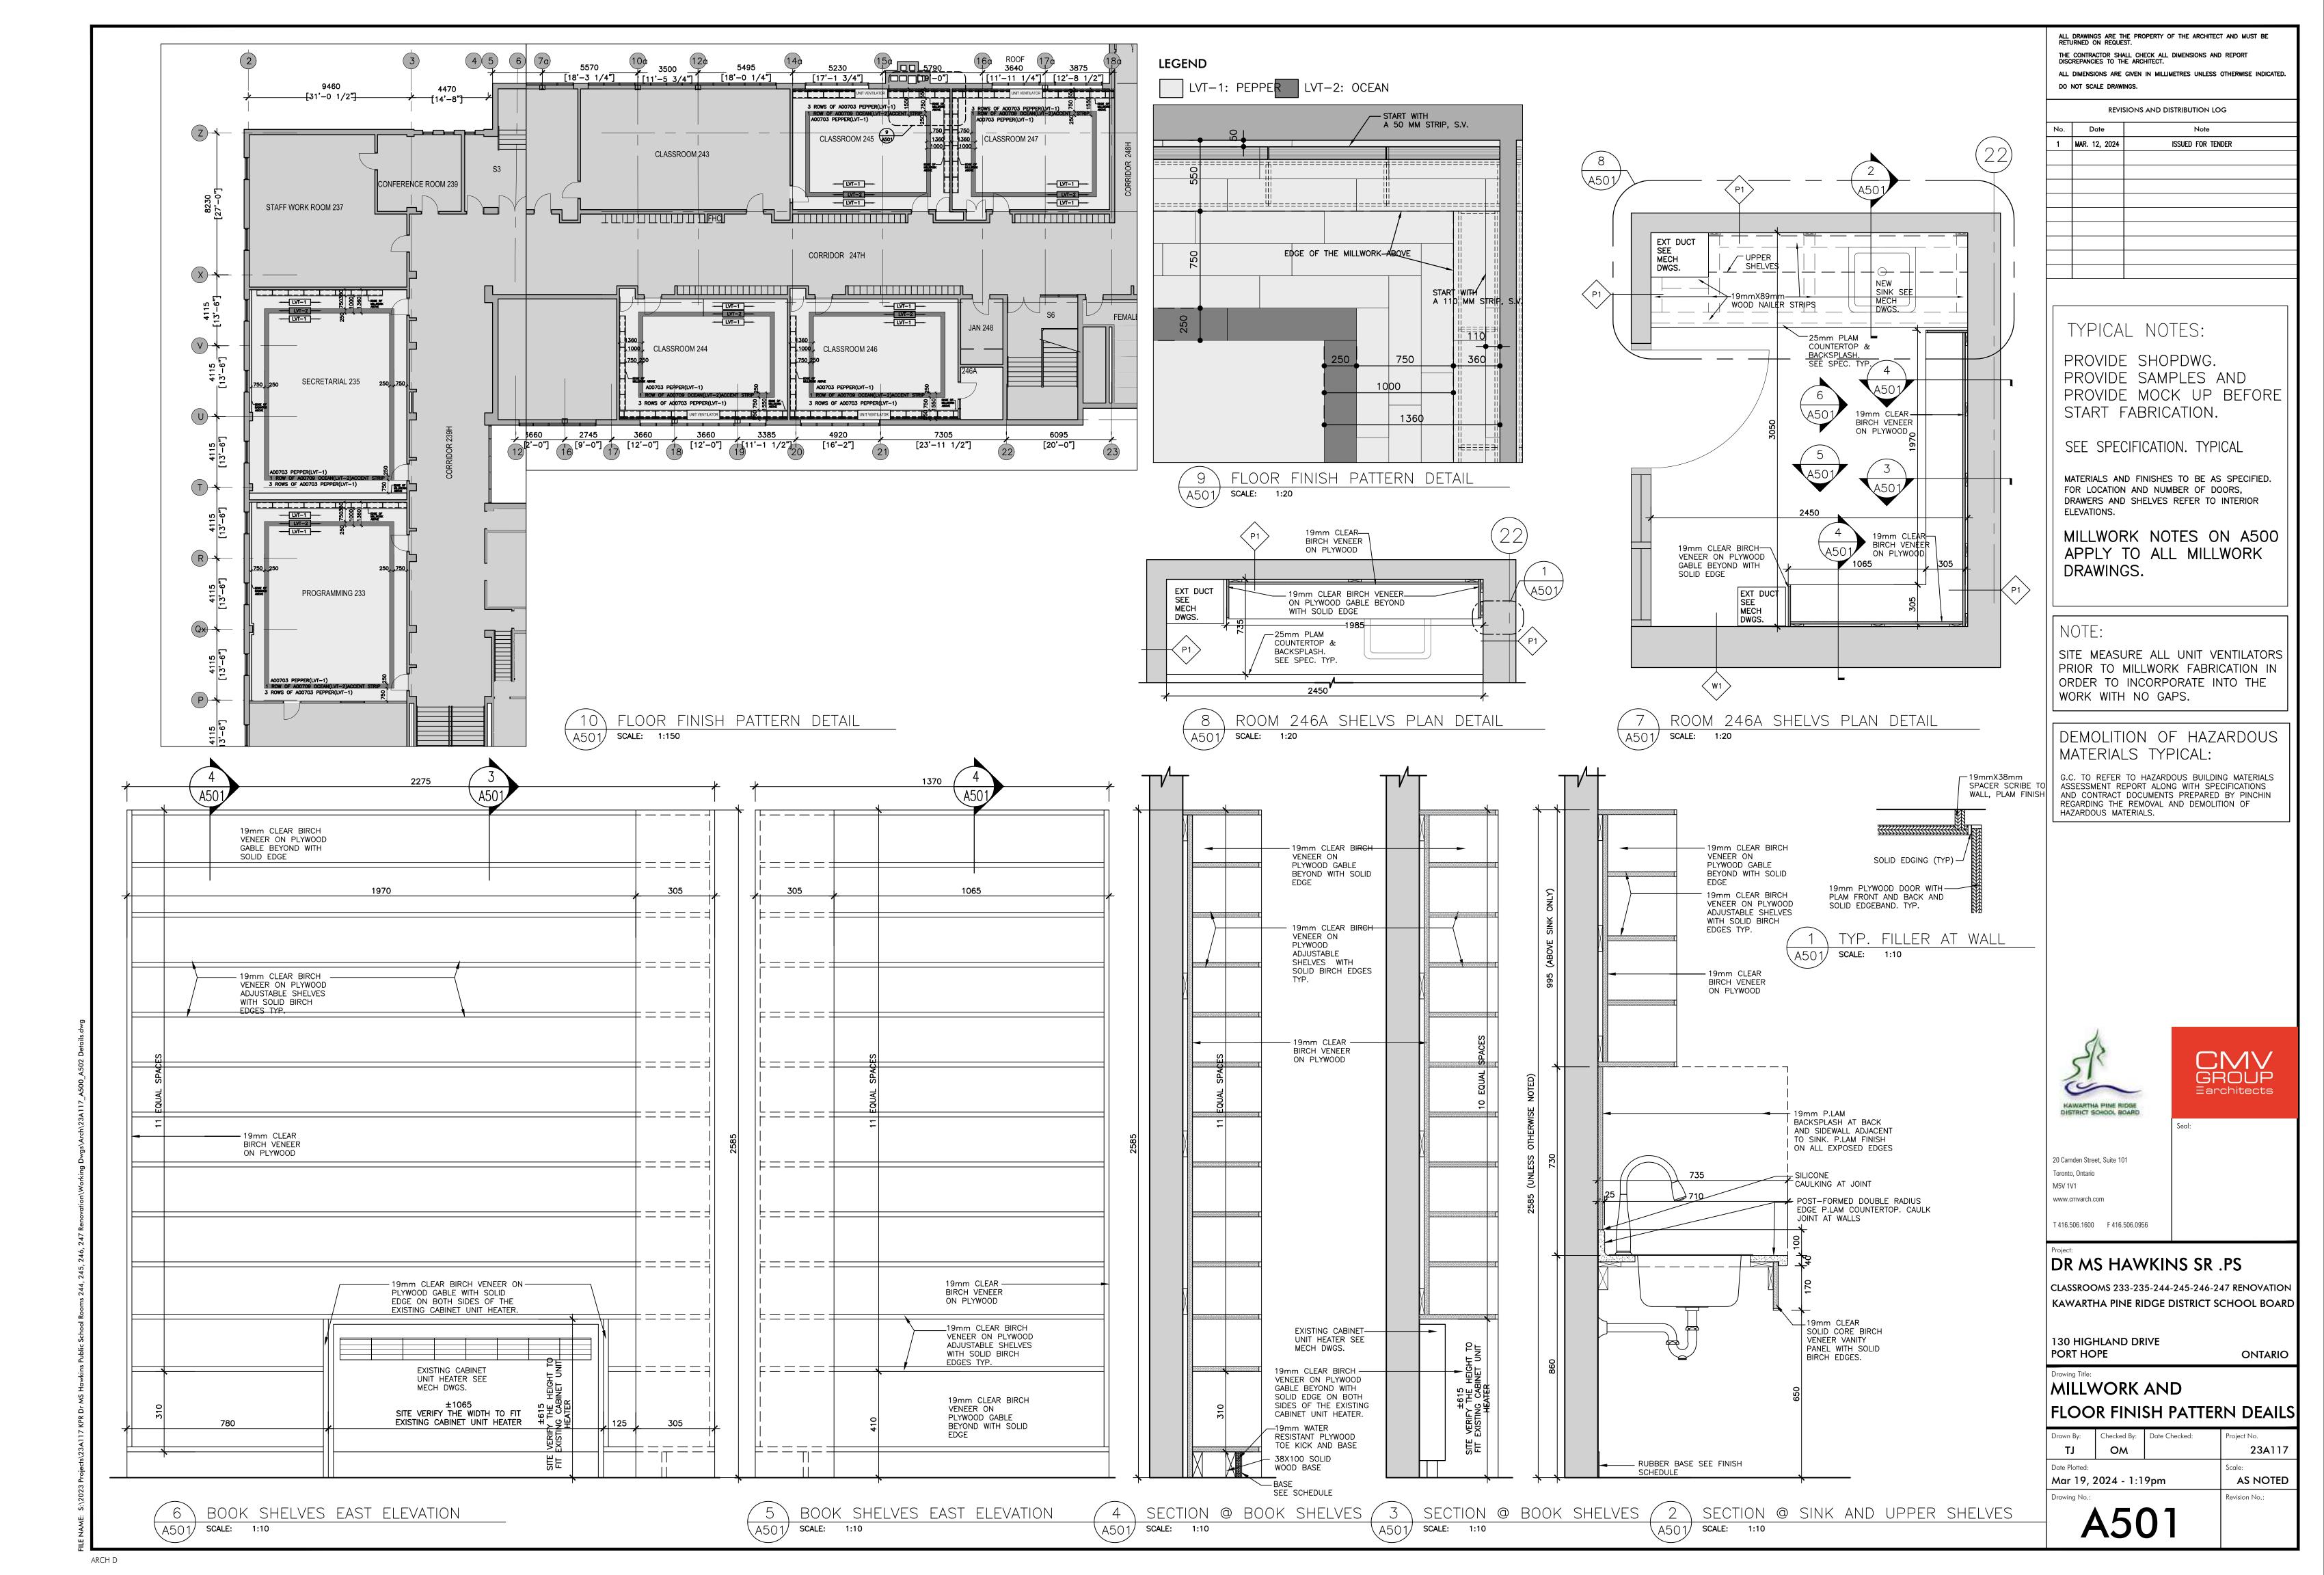
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	 EXISTING EXTERIOR CONCRETE BLOCK WALL EXISTING EXPOSED CONCRETE BLOCK TO REMAIN REMOVE OLD CEILING & EQUIPMENT ATTACHMENTS & SUPPORTS FROM THE WALL APPLY FOAM SPRY INSULATION AT TOP OF WALL, AND SEAL ALL EXTG OPENINGS, SITE VERIFY. PATCH & REPAIR BROKEN BLOCKS, SPECIALLY AT CORNERS, MAKE GOOD FINISHES REMOVE & STRIP OFF EXTG PAINT, SAND AND APPLY NEW PAINT FINISH ON ALL CONC BLOCK AND DRYWALL EXPOSED SURFACES TO ABATEMENT SPECIFICATION REQUIREMENTS PROVIDE NEW SEALANT AROUND THE WINDOWS FRAMES 				
	 EXISTING CONCRETE BLOCK DEMISING INTERIOR WALL EXISTING EXPOSED CONCRETE BLOCK TO REMAIN REMOVE EXTG GYP B. AND SUPPORTS INSTALL NEW SHAFT WALL P2 AT OPENINGS. FIRESTOP TOP OF WALL, AND ALL EXTG PENETRATIONS, SITE VERIFY. SEE CEILING NOTE PATCH & REPAIR BROKEN BLOCKS, SPECIALLY AT CORNERS, MAKE GOOD FINISHES REMOVE & STRIP OFF EXTG PAINT, SAND AND APPLY NEW PAINT FINISH ON ALL CONC BLOCK AND DRYWALL EXPOSED SURFACES NOTES: THERE ARE SOME EXTG OPENINGS THROUGH THIS WALL (ABOVE CLOSETS, ABOVE DOORS FRAME, AROUND DUCTWORKS, ELEC J-BOXES AND SO ON) WHICH HAD BEEN COVERED WITH WOOD STUD FRAME AND GYP. BD. GC TO REMOVE ALL GYP, BD & SUPPORTS AT THOSE AREAS, PROVIDE NEW SHAFT WALL "P2", COVER SMALL OPENINGS WITH 2 LAYERS OF 16MM GYP BD. TYPE X AND APPLY FIRESTOP TO PROVIDE & MAINTAIN 1HR / 2HRS FIRE SEPARATION AT DEMISING WALLS TO SATISFACTION OF BUILDING INSPECTORS. TRADES TO SITE VISIT EXTG SITUATIONS BEFORE PRICING . REINSTALL NEW BLOCK WALLS TO MATCH EXTG AT OPENINGS AROUND NEW DIFFUSERS & DUCTWORK, SEE DETAILS A800 SERIES 	G. AS AN RE	LATERIA C. TO REFER SSESSMENT R ND CONTRACT	ION OF HAZA S TYPICAL: to hazardous buildin eport along with spec documents prepared removal and demolit terials.	IG MATERIALS CIFICATIONS BY PINCHIN
	EXISTING CONCRETE BLOCK DEMISINGWALL AT CLOSETS SAME AS P1, EXCEPT ADD • FURRING CHANNELS ATTACHED TO EXTG CONC BLOCK OR DRYWALL WALL • 16MM IMPACT RESISTANT DW, TAPED, SANDED & PAINTED • BIRCH PLYWOOD SHELVING BY MILLWORK SUPPLIER, GC TO COORDINATE EXISTING CONCRETE BLOCK DEMISINGWALL AT CLOSETS SAME AS P1a, EXCEPT ADD • LAMINATED 16MM IMPACT RESISTANT DW, TAPED, SANDED & PAINTED				
	 BIRCH PLYWOOD SHELVING BY MILLWORK SUPPLIER, GC TO COORDINATE BIRCH PLYWOOD SHELVING BY MILLWORK SUPPLIER, GC TO COORDINATE 1-HR FIRE RATED NEW SHAFT WALL WITH NEW ULC(ULC# W453)TO U/S OF DECK 2 LAYERS 16mm IMPACT RESISTANT GYPSUM BOARD TYPE-X 152mm C-H STUD FOR SHAFT WALL @400MM O.C. ACOUSTIC ROXUL MINERAL FIBRE SOUND INSULATION TO FIIL VOID 25mm GYPSUM BOARD TYPE-X APPLY NEW PAINT ON ALL EXPOSED AREA. MAKE GOOD ADJACENT FINISHES AT BOTH SIDES OF CLASSROOMS AND CORRIDOR NOTES- COMPLY TO ULC W453 AND UPDATED VERSION OF UL DESIGN ST STUD TO BE ATTACHED TO EXISTING ADJACENT WALL CONSTRUCTION & OWSJ. PROVIDE DEFLECTION TRACK U/S OF CEILING. PROVIDE FIRE STOP/FIRE CAULK ALL AROUND THE JOINTS & OPENINGS. CONTRACTORS/BIDDERS TO ESTIMATE & PRICE FOR 10 SQM EXTRA SHAFTWALL "P2' TO COVER POSSIBLE OPENINGS AT CORRIDOR WALL TO MAINTAIN THE REQ'D FIRE SEPARATIONS, c/w REQ'D FIRE STOPS AS PERT OF SCOPE OF WORK INSTALL HILTI DESIGN TO COVERS SHAFTWALL @ UNDERSIDE OF ST DECK, CONTRACTOR TO CONFIRM W HILTI REQUEST AN ENGINEERING JUDGMENT FROM HILTI TO ADDRESS THE EXACT CONDITION IF REQ'D 				
BLOCK WALL TO BE PAINTED AT EXPOSED S STOP, FIRE CAULK AND SMOKE SEAL AL	 NEW FURRING PARTITION 92mm STEEL STUD @400mm O.C. 16mm HIGH IMPACT RESISTANT GYPSUM BOARD TO U/S OF DECK, TAPED, SANDED AND PAINTED. SUM BOARD, AND TYPE X AT FRR PARTITIONS, SURFACES. TYP. L AROUND THE JOINTS WITH ADJACENT WALL & OPENINGS THROUGHOUT OF 				
DEMISING WALL AT CORRIDORS					
ING TYP	ES				
CONSTRUCTION	DESCRIPTION				
	 NEW 1HR FIRE—RATED SUSPENDED ACOUSTIC CEILING TILE (ULC #P210) REMOVE ALL EXISTING ACOUSTIC TILE AND SUBSTRATE AND SUPPORTS CLEAN PLENUM SPACE, METAL DECK AND STRUCTURE APPLY NEW 1HR HILT FIRESTOP FOAM SPRY O TOP OF WALL BELOW STEEL DECK TO FILL THE VOID COMPLETELY, TYPICAL AT DEMISING WALLS AT CORRIDORS AND BETWEEN CLASSROOMS, APPLY INSULATION FOAM SPRAY AT TOP OF EXTERIOR WALLS NEW FIRE—RATED ACOUSTIC CEILING TILE IN PREFINISHED METAL T—BAR SUSPENDED COMPLETE SYSTEM SUPPORTED FROM FURRING CHANNELS. FIRE RATED ENCLOSURE ON LIGHT FIXTURES, PENETRATIONS AND JOINT CONNECTION TO WALLS, COMPLY TO ULC P210, SEE SPEC. TYP PROVIDE HANGING WIRE, ST STUD, UNISTRUTS SUPPORTS, FIRE RATED ENCLOSURE ON LIGHT FIXTURES AND PENETRATIONS PERIMETER SEALED WITH FIRESTOP SEALANT. COORDINATE PLACEMENT OF FURRING WITH T—BAR GRID. INSTALL NEW 1—1/2" METAL FURRING HAT CHANNELS 610MM (24") O.C. TO U/S OF EXISTING STEEL JOISTS TO FASTEN HANGER WIRE, IF REQUIRED AS PER MANUFACTURER'S APPROVED DETAILS AND FASTENERS. REFER TO SPECIFICATIONS. NOTE: INSPECT ALL FIRE SEPARATIONS ABOVE EXISTING CEILINGS AND ENSURE FIRE SEPARATIONS ARE CONTINUOUS TO U/S OF ROOF DECK. PROVIDE NEW FIRESTOP. PATCH AND REPAIR AS NEEDED TO MAINTAIN FIRE SEPARATIONS. 	20 Car	WWARTHA PINE FOR TRICT SCHOOL BO	Seal:	NIV ROUP chitects
	EXTG LATH & PLASTER CEILING • EXTG LATH& PLASTER CEILING & BULKHEAD ON EXTG FURRING C'S TO REMAIN. MAKE GOOD FINISHES IF REQ'D	Toront M5V 1 www.	to, Ontario IV1 .cmvarch.com		
	 1-HR FIRE RATED GYPSUM BOARD CEILING SHAFT (ULC# W453) 2 LAYERS 16mm IMPACT RESISTANT GYPSUM BOARD TYP-X 92 mm C-H STUD FOR CEILING @400MM O.C. ATTACHED TO ADJACENT WALLS ACOUSTIC ROXUL MINERAL FIBRE BATT INSULATION TO FIIL VOID 25mm GYPSUM BOARD TYPE-X APPLY NEW PAINT ON ALL EXPOSED AREA. MAKE GOOD ADJACENT FINISHES AT BOTH SIDES CLASSROOM AND CLOSET. PERIMETER SEALED WITH FIRESTOP SEALANT, COORDINATE ATTACHMENT WITH SHAFT WALL, EXTG PERIMETER WALL AND DOOR FRAME NOTES COMPLY TO ULC # W453 DESIGN. 		R M.S. I SSROOMS 23	HAWKINS SR 3-235-244-245-246-24 NE RIDGE DISTRICT SC	7 RENOVATION
	 EXTG SUSPENDED ACOUSTIC CEILING TILE AT CORR EXTG T-BAR CEILING AT CORRIDORS TO REMAIN. REPLACE BROKEN TILE TO MATCH EXTG SOUND INSULATED TILE IF REQ'D, CONTRACTORS/BIDDERS TO PRICE FOR SUPPLY/REPLACING 10 TILES 	POF	HIGHLANI RT HOPE	D DRIVE	ONTARIO
DER ASBESTOS PRECAUTIONS. THIS WOULD IN ING INTO THE CEILING. STRUCTURAL COMPONENTS WOULD NEED TO E	Y CONTAIN ASBESTOS. ANY DEMOLITION OR OTHER WORK AT THIS AREA WOULD NEED ICLUDE THE REMOVAL OF THE EXISTING LIGHTS AND MECHANICAL VENTS, AS WELL AS	CO		ON ASSEMBLIES A	ND DETAILS


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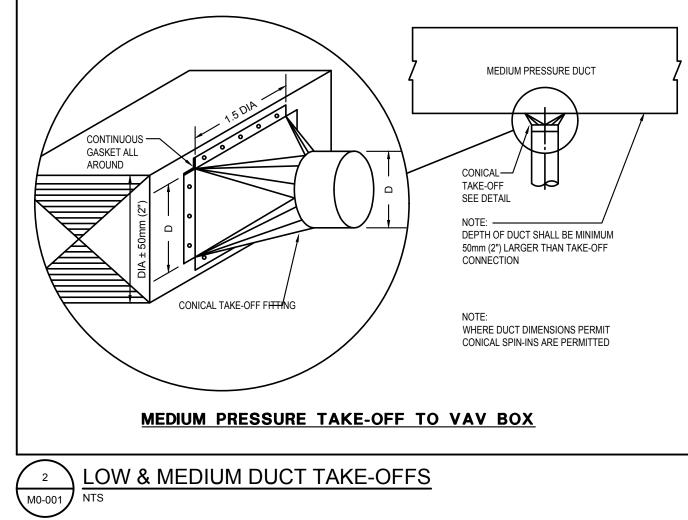
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ABO1 NEW IHR FRR T-BAR CELING SEALANT PATCH, PAINT AND MAXE GOOD EXTG. GYPSUM BOARD CELING. NEW DOOR TO MATCH MILLWORK STE VERFY SZES AFTER DW CLASSROOM 16 MM IMPACT RESISTANT CYPSUM BOARD CELING. NEW DOOR TO MATCH EXISTING CIPSUM BOARD WALL PAINT ALL NEW LAMINATED BOARDS INSIDE THE CLOSET 4 PROP WALL SEC @ C	6			<u>HEDL</u>					NO	DTE 3: SEE DTE 4: GC 1 D MATCH FII CO HILL DET. ST LINTI SHO	SPECIFICA O REMOV RE SEPAR FIRE INSUI MPLY TO I TI STANDA AIL ON A8 TO SUB GC TO I BEARING GC TO I BEARING WAL ABILITY OI EL, PROVII RING IF R START AN WORK. TY	E AND RE ATION. SEI ATION SPF JLC DESIGN RD, REFER 00 SERIES MIT CUTSHI NSPECT LI STRUCTUI L & CONF F CONC W DE ADEQU EQ'D, BEFI Y DEMOLIT P ALONG	PLACE EX E PINCHIN RAY TO GC EET DAD RAL TRM ALL ATE ORAL ATE ON THE	tg Caul Repor	KING ON A T AND SPEC	LL DOOR FRA	(P.		
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SEALANT ALL SEC OCC	6			<u>HEDL</u>	<u>JL</u>				NO	DTE 3: SEE DTE 4: GC 1 D MATCH FII CO HILL DET. ST LINTI SHO	SPECIFICA O REMOV RE SEPAR FIRE INSUI MPLY TO U II STANDA AIL ON A8 TO SUBI GC TO I BEARING WAL ABILITY O EL, PROVI RING IF R START AN WORK. TY	E AND RE ATION. SEI ATION SPF JLC DESIGN RD, REFER 00 SERIES WIT CUTSHI NSPECT LO STRUCTUL L & CONF F CONC W DE ADEQU EQ'D, BEFI P ALONG EMISING W	PLACE EX E PINCHIN RAY & TO GC GC T DAL CET DAL TIRM ALLE ALLE ALLE	tg Caul Repor	KING ON A T AND SPEC		(P.		EXTG
PATCH, PAINT AND MAKE CODE EXTG. GYPSUM BOARD CELLING. NEW DOOR TO MATCH MILLWORK. STE VERIFY SIZES AFTER DW CLASSROOM 16 MM IMPACT RESISTANT GYPSUM BOARD LAMINATED TO THE EXISTING GYPSUM BOARD WALL PAINT ALL NEW LAMINATED BOARDS INSIDE THE CLOSET	6			<u>HEDl</u>					NO	DTE 3: SEE DTE 4: GC 1 D MATCH FII CO HILL DET. ST LINTI SHO	SPECIFICA O REMOV RE SEPAR FIRE INSUI MPLY TO U II STANDA AIL ON A8 TO SUBI GC TO I BEARING WAL ABILITY O EL, PROVI RING IF R START AN WORK. TY	E AND RE ATION. SEI ATION SPF JLC DESIGN RD, REFER 00 SERIES WIT CUTSHI NSPECT LA STRUCTUL L & CONF F CONC W DE ADEQU EQ'D, BEFI P ALONG EMISING W	PLACE EX E PINCHIN RAY & TO GC EET DAD EET DAT EET DAT EET DAT EET DAT EET DAT EET DAT EET DAT EET DAT EET DAT EET DAT EET EET EET EET EET EET EET E	tg Caul Repor	KING ON A T AND SPEC		(P.		
SEALANT PATCH, PAINT AND MAKE GOOD EXTG. GYPSUM BOARD CELING. NEW DOOR TO MATCH MILLWORK. STE VERIFY SIZES AFTER DW CLASSROOM 16 MM IMPACT RESISTANT GYPSUM BOARD LAMINATED TO THE EXISTING GYPSUM BOARD WALL PAINT ALL NEW LAMINATED BOARD SINSIDE THE CLOSET 4 PROP WALL SEC © C	6			<u>HEDL</u>	<u>JL</u>				NO	DTE 3: SEE DTE 4: GC 1 D MATCH FII CO HILL DET. ST LINTI SHO	SPECIFICA O REMOV RE SEPAR FIRE INSUI MPLY TO U II STANDA AIL ON A8 TO SUBI GC TO I BEARING WAL ABILITY O EL, PROVI RING IF R START AN WORK. TY	E AND RE ATION. SEI ATION SPF JLC DESIGN RD, REFER 00 SERIES WIT CUTSHI NSPECT LA STRUCTUL L & CONF F CONC W DE ADEQU EQ'D, BEFI P ALONG EMISING W	PLACE EX E PINCHIN RAY & TO GC EET DAD EET DAT EET DAT EET DAT EET DAT EET DAT EET DAT EET DAT EET DAT EET DAT EET DAT EET EET EET EET EET EET EET E	tg Caul Repor	KING ON A T AND SPEC		(P.		EXTG CEILIN REMA DAMA /PRO EXTG ELECT
ALANT AND PATCH, PAINT AND MAKE GOOD EXTG. GYPSUM BOARD CEILING. NEW DOOR TO MATCH MILLWORK. SITE VERIFY SIZES AFTER DW CLASSROOM 16 MM IMPACT RESISTANT GYPSUM BOARD LAMINATED TO THE EXISTING GYPSUM BOARD WALL. PAINT ALL NEW LAMINATED BOARDS INSIDE THE CLOSET 4 PROP WALL SEC @ C	6			<u>HEDL</u>	<u>JL</u>				NO	DTE 3: SEE DTE 4: GC 1 D MATCH FII CO HILL DET. ST LINTI SHO	SPECIFICA O REMOV RE SEPAR FIRE INSUI MPLY TO U II STANDA AIL ON A8 TO SUBI GC TO I BEARING WAL ABILITY O EL, PROVI RING IF R START AN WORK. TY	E AND RE ATION. SEI ATION SPF JLC DESIGN RD, REFER 00 SERIES WIT CUTSHI NSPECT LA STRUCTUL L & CONF F CONC W DE ADEQU EQ'D, BEFI P ALONG EMISING W	PLACE EX E PINCHIN RAY & TO GC EET DAD EET DAT EET DAT EET DAT EET DAT EET DAT EET DAT EET DAT EET DAT EET DAT EET DAT EET EET EET EET EET EET EET E	tg Caul Repor	KING ON A T AND SPEC		(P.		EXTG EXELECT AMECH FIRES
MAKE GOOD EXTG. GYPSUM BOARD CEILING. NEW DOOR TO MATCH MILLWORK. SITE VERIFY SIZES AFTER DW CLASSROOM 16 MM IMPACT RESISTANT GYPSUM BOARD LAMINATED TO THE EXISTING GYPSUM BOARD WALL PAINT ALL NEW LAMINATED BOARDS INSIDE THE CLOSET 4 PROP WALL SEC OC	6			<u>HEDL</u>	<u>JL</u>				NO	DTE 3: SEE DTE 4: GC 1 D MATCH FII CO HILL DET. ST LINTI SHO	SPECIFICA O REMOV RE SEPAR FIRE INSUI MPLY TO U II STANDA AIL ON A8 TO SUBI GC TO I BEARING WAL ABILITY O EL, PROVI RING IF R START AN WORK. TY	E AND RE ATION. SEI ATION SPF JLC DESIGN RD, REFER 00 SERIES WIT CUTSHI NSPECT LA STRUCTUL L & CONF F CONC W DE ADEQU EQ'D, BEFI P ALONG EMISING W	PLACE EX E PINCHIN RAY TO GC GC ALL ALL BAR BAR JUING		KING ON A T AND SPEC				EXTG CEILIN RDAMA /PRO EXTG FIRES EXTG FIRES EXTG PENE
MILLWORK. SITE VERIFY SIZES AFTER DW CLASSROOM 16 MM IMPACT RESISTANT GYPSUM BOARD LAMINATED TO THE EXISTING GYPSUM BOARD WALL. PAINT ALL NEW LAMINATED BOARDS INSIDE THE CLOSET 4 PROP WALL SEC @ C	6			<u>HEDL</u>	<u>JL</u>				NO	DTE 3: SEE DTE 4: GC 1 D MATCH FII CO HILL DET. ST LINTI SHO	SPECIFICA TO REMOV RE SEPAR FIRE INSUI MPLY TO U TI STANDA AIL ON A8 TO SUBI GC TO I BEARING WAL ABILITY O EL, PROVI RING IF R START AN WORK. TY	E AND RE ATION. SEI ATION SPF ILC DESIGN RD, REFERS WIT CUTSHI NSPECT LI STRUCTUI L & CONF F CONC W DE ADEQU EQ'D, BEFF P ALONG EMISING W 13 801 HR FRR T- CE	PLACE EX PINCHIN AT TO GC CET DAD CET DAD ATE ORE TIME ATE ORE ATE ORE ATE ORE ATE ORE ATE ATE ORE ATE ATE ATE ATE ATE ATE ATE AT		KING ON A T AND SPEC				EXTG CEILIN REMA DAMA /PRO ELECT FIRES EXTG FIRES EXTG FIRES
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TO MM IMPACT RESISTANT GYPSUM BOARD LAMINATED TO THE EXISTING GYPSUM BOARD WALL. PAINT ALL NEW LAMINATED BOARDS INSIDE THE CLOSET	6			<u>HEDL</u>	<u>JL</u>				NO	DTE 3: SEE DTE 4: GC 1 D MATCH FII CO HILL DET. ST LINTI SHO	SPECIFICA TO REMOV RE SEPAR FIRE INSUI MPLY TO U TI STANDA AIL ON A8 TO SUBI GC TO I BEARING WAL ABILITY O EL, PROVI RING IF R START AN WORK. TY	E AND RE ATION. SEI ATION SPF ILC DESIGN RD, REFER MIT CUTSHI NSPECT LI STRUCTUL L & CONF F CONC W DE ADEQU EQ'D, BEFT P ALONG EMISING W 13 801 HR FRR T- CE PATCH, P MAKE GOI GYPSUM B	PLACE EX PINCHIN RAY TO GC FET DAD CC CC CC CC CC CC CC CC CC C		KING ON A T AND SPEC				EXTG EXTGLE EXTGLE ELECT AND C HECK FIRES EXTG FIRES EXTG FIRES EXTG FIRES
EXISTING GYPSUM BOARD WALL. PAINT ALL NEW LAMINATED BOARDS INSIDE THE CLOSET	6			<u>HEDL</u>	<u>JL</u>				NO	DTE 3: SEE DTE 4: GC 1 D MATCH FII CO HIL DET, STO STO STO STO STO STO STO STO STO STO	SPECIFICA TO REMOV RE SEPAR FIRE INSUL MPLY TO U II STANDA AIL ON A8 TO SUBI GC TO I BEARING GC TO I BEARING I BEARING I BEARING I BEARING I BEARING WORK. TY D NEW 1	E AND RE ATION. SEI ATION SPF JLC DESIGN RD, REFER 00 SERIES WIT CUTSHI NSPECT LG STRUCTUL L & CONF F CONC W DE ADEQU P ALONG EMISING W 13 801 HR FRR T- CE PATCH, P MAKE GOI GYPSUM F NEW DOOI MILLWORK SIZES AF	PLACE EX PINCHIN RAY TO GC GC CET DAD CET CET DAD CET CET DAD CET CET DAD CET CET CON THE ALL CET CET CET CET CET CET CET CET		KING ON A T AND SPEC				EXTG EXTGLIII REMAA /PRC ELLECT AND HETRES PENEC FINES PENEC FINES
4 PROP WALL SEC @ C	6			<u>HEDL</u>					NO	DTE 3: SEE DTE 4: GC 1 D MATCH FII CO HIL DET, STO STO STO STO STO STO STO STO STO STO	SPECIFICA TO REMOV RE SEPAR FIRE INSUL MPLY TO U II STANDA AIL ON A8 TO SUBI GC TO I BEARING GC TO I BEARING I BEARING I BEARING I BEARING I BEARING WORK. TY D NEW 1	E AND RE ATION. SEI ATION SPF JLC DESIGN RD, REFER 00 SERIES WIT CUTSHI NSPECT LG STRUCTUL L & CONF F CONC W DE ADEQU P ALONG EMISING W 13 801 HR FRR T- CE PATCH, P MAKE GOI GYPSUM F NEW DOOI MILLWORK SIZES AF	PLACE EX PINCHIN RAY TO GC FINA TO GC CC TO AD CC CC CC CC CC CC CC CC CC C	ANT					EXTG EXTG CELLIN REMA DAMA /PRO EXTG FIRES EXTG FIRES PENE THROU WALL
	6			<u>HEDL</u>					NO	DTE 3: SEE DTE 4: GC 1 D MATCH FII CO HIL DET, STO STO STO STO STO STO STO STO STO STO	SPECIFICA TO REMOV RE SEPAR FIRE INSUL MPLY TO U II STANDA AIL ON A8 TO SUBI GC TO I BEARING GC TO I BEARING I BEARING I BEARING I BEARING I BEARING WORK. TY D NEW 1	E AND RE ATION. SEI ATION SPF JLC DESIGN RD, REFER 00 SERIES WIT CUTSHI NSPECT LG STRUCTUL L & CONF F CONC W DE ADEQU P ALONG EMISING W 13 801 HR FRR T- CE PATCH, P MAKE GOI GYPSUM F NEW DOOI MILLWORK SIZES AF	PLACE EX PINCHIN RAY TO GC FET DAD CC CC CC CC CC CC CC CC CC C	ANT		LL DOOR FRA CIFICATION. TY CONSTRUCTION P1 P1 CLOSET CLOSET CLOSET CLOSET			EXTG CEILIN REMAI DAMA /PRO ELECT FIRES EXTG PENET THROL WALL.
	6			<u>HEDL</u>					NO	DTE 3: SEE DTE 4: GC 1 D MATCH FII CO HIL DET, STO STO STO STO STO STO STO STO STO STO	SPECIFICA TO REMOV RE SEPAR FIRE INSUL MPLY TO U II STANDA AIL ON A8 TO SUBI GC TO I BEARING GC TO I BEARING I BEARING I BEARING I BEARING I BEARING WORK. TY D NEW 1	E AND REATION. SEI ATION SPE ATION SPE ILC DESIGN RD, REFER 00 SERIES WIT CUTSHI NSPECT LO STRUCTUL L & CONF F CONC W DE ADEQU EQ'D, BEFI P ALONG EMISING W 13 801 HR FRR T- CE PATCH, P MAKE GOU GYPSUM F NEW DOOI MILLWORK SIZES AF	PLACE EX PINCHIN AT TO GC CC CC CC CC CC CC CC CC CC	ANT	RESISTANT THE CLOSE	CLOSET CLOSET CQYPSUM CCLOSET			EXTG EXTG CEILIN PRO ELECT ELECT EXTG PENET THROU WALL



	LEGEND -	GENERAL			LEGEND	- HVAC	
SYMBOL	DESCRIPTION	SYMBOL	DESCRIPTION	SYMBOL	DESCRIPTION	SYMBOL	DESCRIPTION
\bowtie	GATE VALVE		PIPE UP	HWS	HOT WATER SUPPLY	FCU-2.0	EXISTING CEILING MOUNTED FAN
	GLOBE VALVE	с+—	PIPE DOWN	— — HWR — —	HOT WATER RETURN	╡┊┟╧╋┙	WITH ELECTRIC DUCT HEATER
ıбı	BALL VALVE		CAPPED PIPE	CHWS	CHILLED WATER SUPPLY	=====	SINGLE LINE DUCT WITH EXTERN
N	CHECK VALVE		DIRECTION OF FLOW	— — CHWR — —	- CHILLED WATER RETURN	*****	SINGLE LINE DUCT WITH ACOUST
\sim	FLOAT VALVE	—	PIPE SLEEVE	cs	CONDENSER WATER SUPPLY		SINGLE LINE FLEXIBLE DUCT
<u> </u>	HOSE-END DRAIN VALVE		CONTINUOUS PIPE	— — CR — —	CONDENSER WATER RETURN		SUPPLY AIR DIFFUSER
₩3	VALVED AND CAPPED PROVISION	ıı	UNION	s	STEAM MAIN (PRESSURE AS INDICATED)		RETURN OR EXHAUST AIR GRILLE
=	BUTTERFLY VALVE	└── ₩──	STRAINER	1			DIFF NECK SIZE/DIFF TYPE
	LOCKSHIELD VALVE	BFP	BACKFLOW PREVENTER	CD	CONDENSATE DRAIN	6"Ø A 200	SUPPLY AIR CFM
	PRESSURE REDUCING VALVE	WFA	WATER FEEDER ASSEMBLEY	GS	- GLYCOL SUPPLY	FD	FIRE DAMPER
	FLOW SWITCH		FLEXIBLE PIPE CONNECTION	— — GR — —	GLYCOL RETURN	MD	MOTORIZED DAMPER
Š	SOLENIOD VALVE	\bigcirc	PUMP		PIPE ANCHOR	BD	MANUAL BALANCING DAMPER
- Â	CIRCUIT BALANCING VALVE	<u> </u>	PRESSURE GAUGE WITH COCK		PIPE GUIDE	Ū	THERMOSTAT
X0	PRESSURE DIFFERENTIAL VALVE	Π Π	THERMOMETER		SUPPLY AIR OR FRESH AIR DUCT	6	TEMPERATURE SENSOR
 	SAFETY RELIEF VALVE		STARTER		RETURN AIR OR EXHAUST AIR DUCT	B	HUMIDISTAT
	2 WAY AUTOMATIC CONTROL VALVE	CTE	CONNECT TO EXISTING		SUPPLY AIR OR FRESH AIR DUCT DOWN	DG	DOOR GRILLE
	3 WAY AUTOMATIC CONTROL VALVE	AP	ACCESS PANEL		RETURN AIR DUCT DOWN	S/A	SUPPLY AIR
<u>₽</u>	VALVE IN RISER	AD	ACCESS DOOR		ROUND DUCT UP	R/A	RETURN AIR
R۷	PRESSURE REGULATING VALVE	ETC	ELECTRIC TRACING CABLE		ROUND DUCT DOWN	E/A	EXHAUST AIR
GPR	GAS PRESSURE REGULATOR	AFF	ABOVE FINISHED FLOOR		DUCT WITH ACOUSTIC LINING	F/A	FRESH AIR
		U/S	UNDERSIDE		DOUBLE LINE DUCT	_4	
					DUCT SILENCER		DOOR GRILLE
				FCU	EXISTING CEILING MOUNTED FAN COIL UNIT	FCU-2.0	NEW CEILING MOUNTED FAN COIL

				AIR T	ERMINAL SC	CHEDULE	
TAG	DESCRIPTION	MANUFACTURER	MODEL	MATERIAL	FINISH	MOUNTING	COMMENTS
A	LOUVERED GRILLE	EH PRICE	530D	STEEL	SEE NOTE 1	WALL	3/4" BLADE SPACING, STEEL CONSTRUCTION, DOUBLE DEFLECTION, FRONT BLADE PARALLEL TO LONG DIMENSION, COUNTERSUNK SCREW HOLE MOUNTING. PROVIDE OPPOSED BLADE BALANCING DAMPER. FACE SIZE NOTED ON PLANS.
В	LOUVERED RETURN GRILLE C/W FIRE DAMPER	EH PRICE	530-FR	STEEL	SEE NOTE 1	CEILING	FACE SIZE NOTED ON PLANS.
С	EGGCRATE RETURN GRILLE	E.H. PRICE	80	STEEL	B12	CEILING	FACE SIZE TO MATCH EXISTING.
	NOTES:	1. COORDINATE FINISH	WITH ARCHITE	CT.			



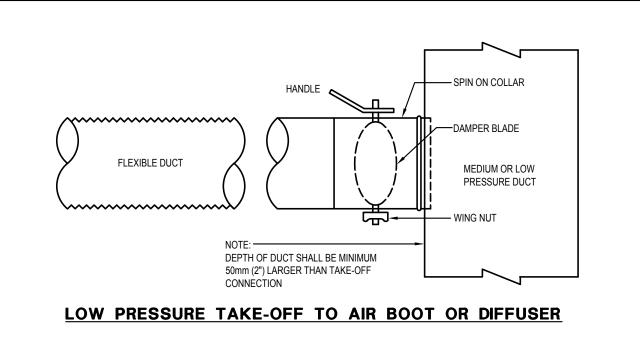

	DESCRIPTION	SYMBOL	DESCRIPTION
	EXISTING DUCTS, PIPES OR EQUIPMENT	IIII SD	SCUPPER DRAIN
	DUCTS & EQUIPMENT TO BE REMOVED	СВ	CATCHBASIN
	PIPES TO BE REMOVED	🖨 RD	ROOF DRAIN
- SAN	SANITARY DRAIN	VTR	VENT THROUGH ROOF
<u> </u>	BURIED SANITARY DRAIN	RWL	RAINWATER LEADER
	BURIED SANITARY CARRYING GREASE FROM	——— F ———	FIRE LINE
— (G) SAN — —	KITCHENS IN FOOD COURT CRU'SDRAIN	SP	- SPRINKLER LINE (WET)
	ELECTRICALLY TRACED BURIED SANITARY	DSP	- SPRINKLER MAIN (DRY)
ر (G) SAN حر کر	DRAIN	GSP	- SPRINKLER MAIN (GLYCOL)
— ST —	STORM DRAIN	Ŵ	WET ALARM CHECK VALVE
— st — —	BURIED STORM DRAIN		DRY ALARM CHECK VALVE
— WT — —	WEEPING TILE	E	DELUGE SYSTEM VALVE ASSEMBLY
- PD	PUMPED DRAIN	<u>الأل</u>	CHECK VALVE WITH BALLDRIP
- PD	PUMPED DRAIN UNDER FLOOR	0	PENDENT SPRINKLER HEAD
V	VENT PIPE	Ø	DRY PENDENT SPRINKLER HEAD
	DRAIN WITH CLEANOUT	0	UPRIGHT SPRINKLER HEAD
 0	DRAIN WITH CLEANOUT UP TO FLOOR	۲	CONCEALED SPRINKLER HEAD
––– 0 ⁰	DRAIN WITH CLEANOUT UP TO FLOOR	4	SIDEWALL SPRINKLER HEAD
	RUNNING TRAP WITH CLEANOUT	0	WINDOW SPRINKLER HEAD
	EXISTING WATERMAIN	\bigcirc	EXISTING SPRINKLER HEAD TO REMAIN
	DOMESTIC COLD WATER	© _R	EXISTING SPRINKLER HEAD TO BE REMOVE
	DOMESTIC HOT WATER	Ń	SIAMESE PUMPER CONNECTION
	DOMESTIC HOT WATER RECIRC	L FEC	FIRE EXTINGUISHER CABINET
G	GAS PIPE	C FHC	FIRE HOSE CABINET
нв 🔲 WH	HOSE BIBB/WALL HYDRANT	C FHV	FIRE HOSE VALVE
₽ FD	FLOOR DRAIN	FSP	FIRE STANDPIPE
_	HUB DRAIN	SV	SUPERVISED VALVE
🖨 HD			

DRAWING TITLE
LEGEND, DRAWING LIST, DETAILS AND SCHEDULES
PLUMBING CUTSHEETS
CLASSROOMS 244 TO 247 MECHANICAL DEMOLITION
CLASSROOMS 244 TO 247 MECHANICAL NEW
CLASSROOMS 233 AND 235 MECHANICAL DEMOLITION
CLASSROOMS 233 AND 235 MECHANICAL NEW

M0-001

M0-002

M1-101

M1-201

M1-102

M1-202

SINK -

	PLU	JMBING FIXT	JRES SIZING	TABL	E		TMP:00-001-03
FIXT	URE DESCRIPT	ΓΙΟΝ	DRAIN	VE	NT	CW	HW
1 COMPAR	TMENT		40mm 1 ¹ /2"		mm 1⁄4"	15mm 1/2"	15mm 1⁄2"
	IMPER	IAL TO METRI	C SIZING CO	NVER	SION		
3"	3mm	1"	25mm		3	3"	75mm
1	6mm	1 ¹ ⁄4"	30mm		31/	2"	90mm
3"	10mm	1 ¹ /2"	40mm		4	."	100mm
2	15mm	2"	50mm		5	5"	125mm
4	20mm	21/2"	65mm		6)"	150mm

¹ PLUMBING FIXTURES SIZING TABLE M0-001 NTS

ALL DRAWINGS ARE THE PROPERTY OF THE ARCHITECT AND MUST BE RETURNED ON REQUEST. THE CONTRACTOR SHALL CHECK ALL DIMENSIONS AND REPORT DISCREPANCIES TO THE ARCHITECT. ALL DIMENSIONS ARE GIVEN IN MILLIMETRES UNLESS OTHERWISE INDICATED. DO NOT SCALE DRAWINGS. REVISIONS AND DISTRIBUTION LOG No. Date Note 1. FEB. 06, 2024 ISSUED FOR COORDINATION 2. MAR. 08, 2024 ISSUED FOR COORDINATION 3. MAR. 12, 2024 ISSUED FOR TENDER 23-1109-000






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DR MS HAWKINS SR.PS
CLASSROOMS 233-235-244-245-246-247 RENOVATION KAWARTHA PINE RIDGE DISTRICT SCHOOL BOARD

130 HIGH PORT HO	iland Dri Pe	VE	ONTARIO
	ND, DR	AWING LIS D SCHEDU	•
Drawn By: CAD	Checked By: AF	Date Checked:	Project No.
Date Plotted:			Scale:
Mar 12	, 2024	— 11:01am	N.T.S.
Drawing No.:			Revision No.:
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CLASSROOMS	233–235–	244-245-	-246–247	7
RENOVATION				
KAWARTHA F	PINE RIDGE	DISTRICT	SCHOOL	BOAR


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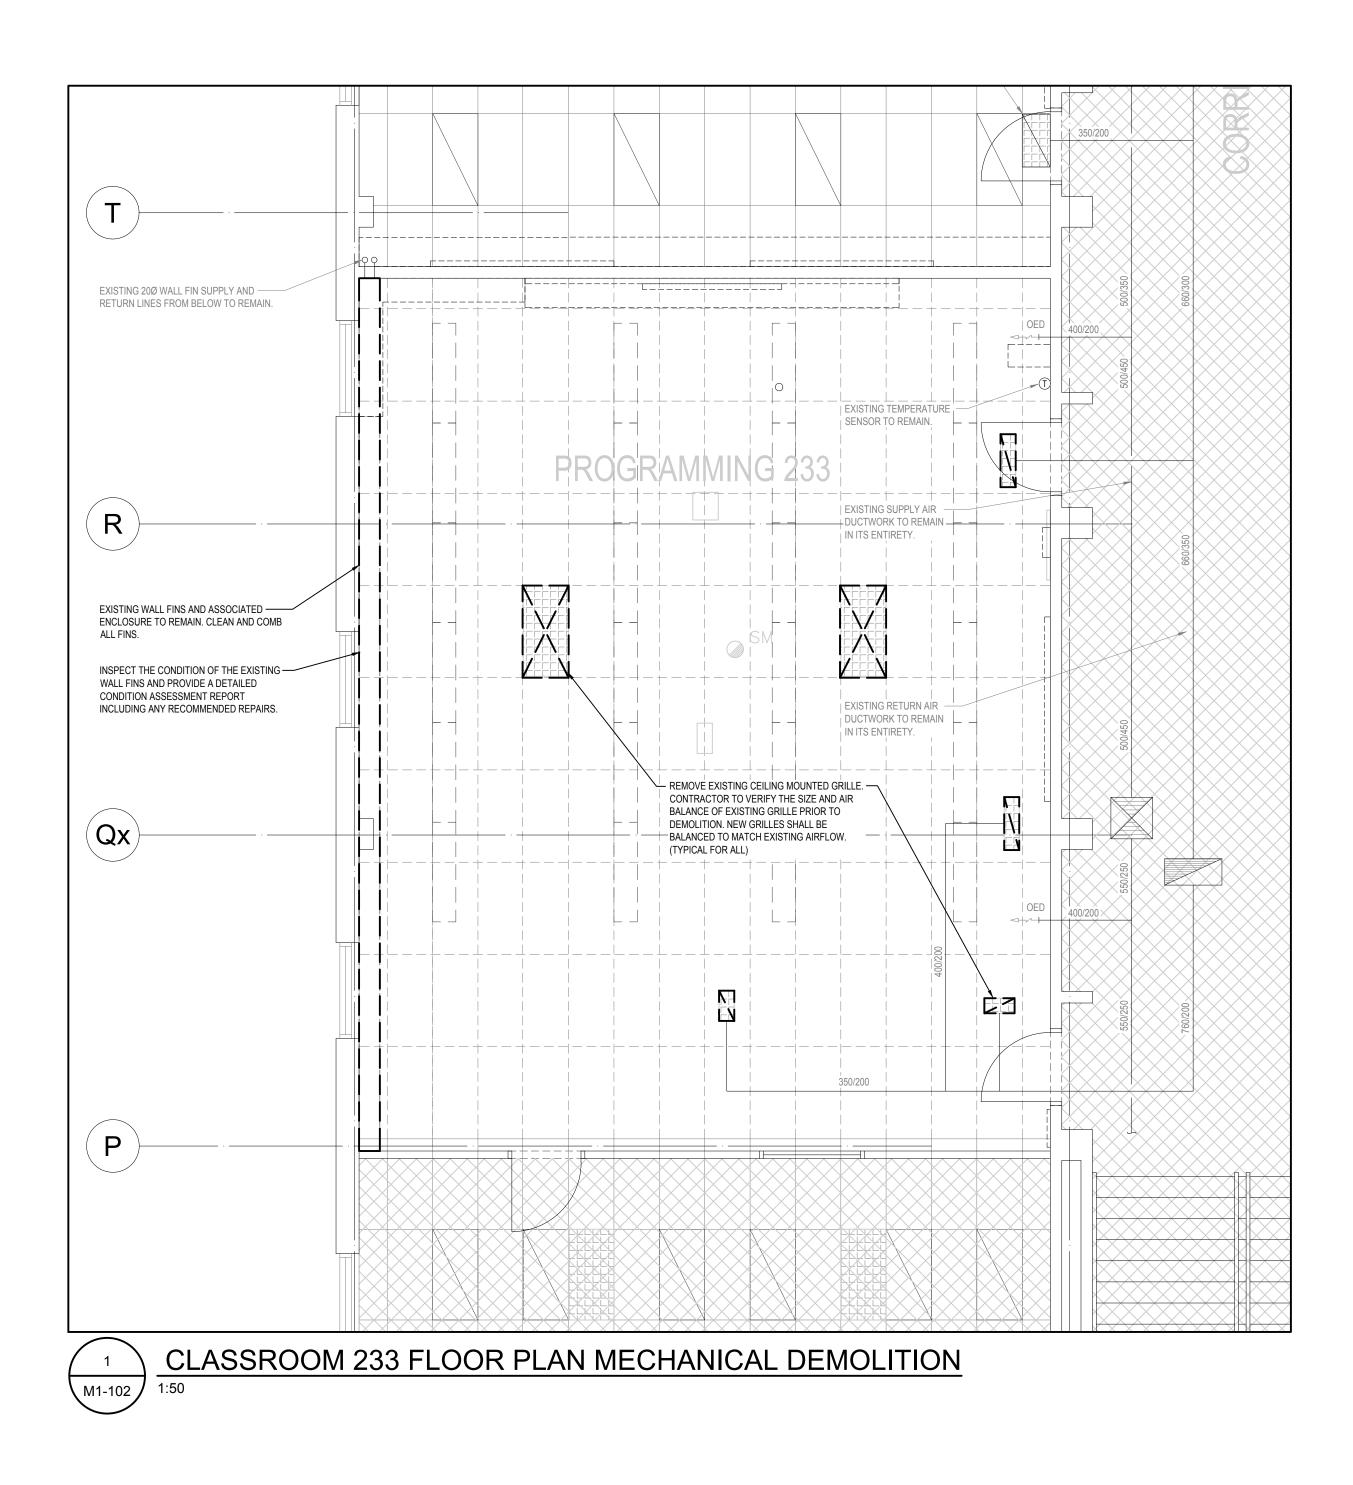
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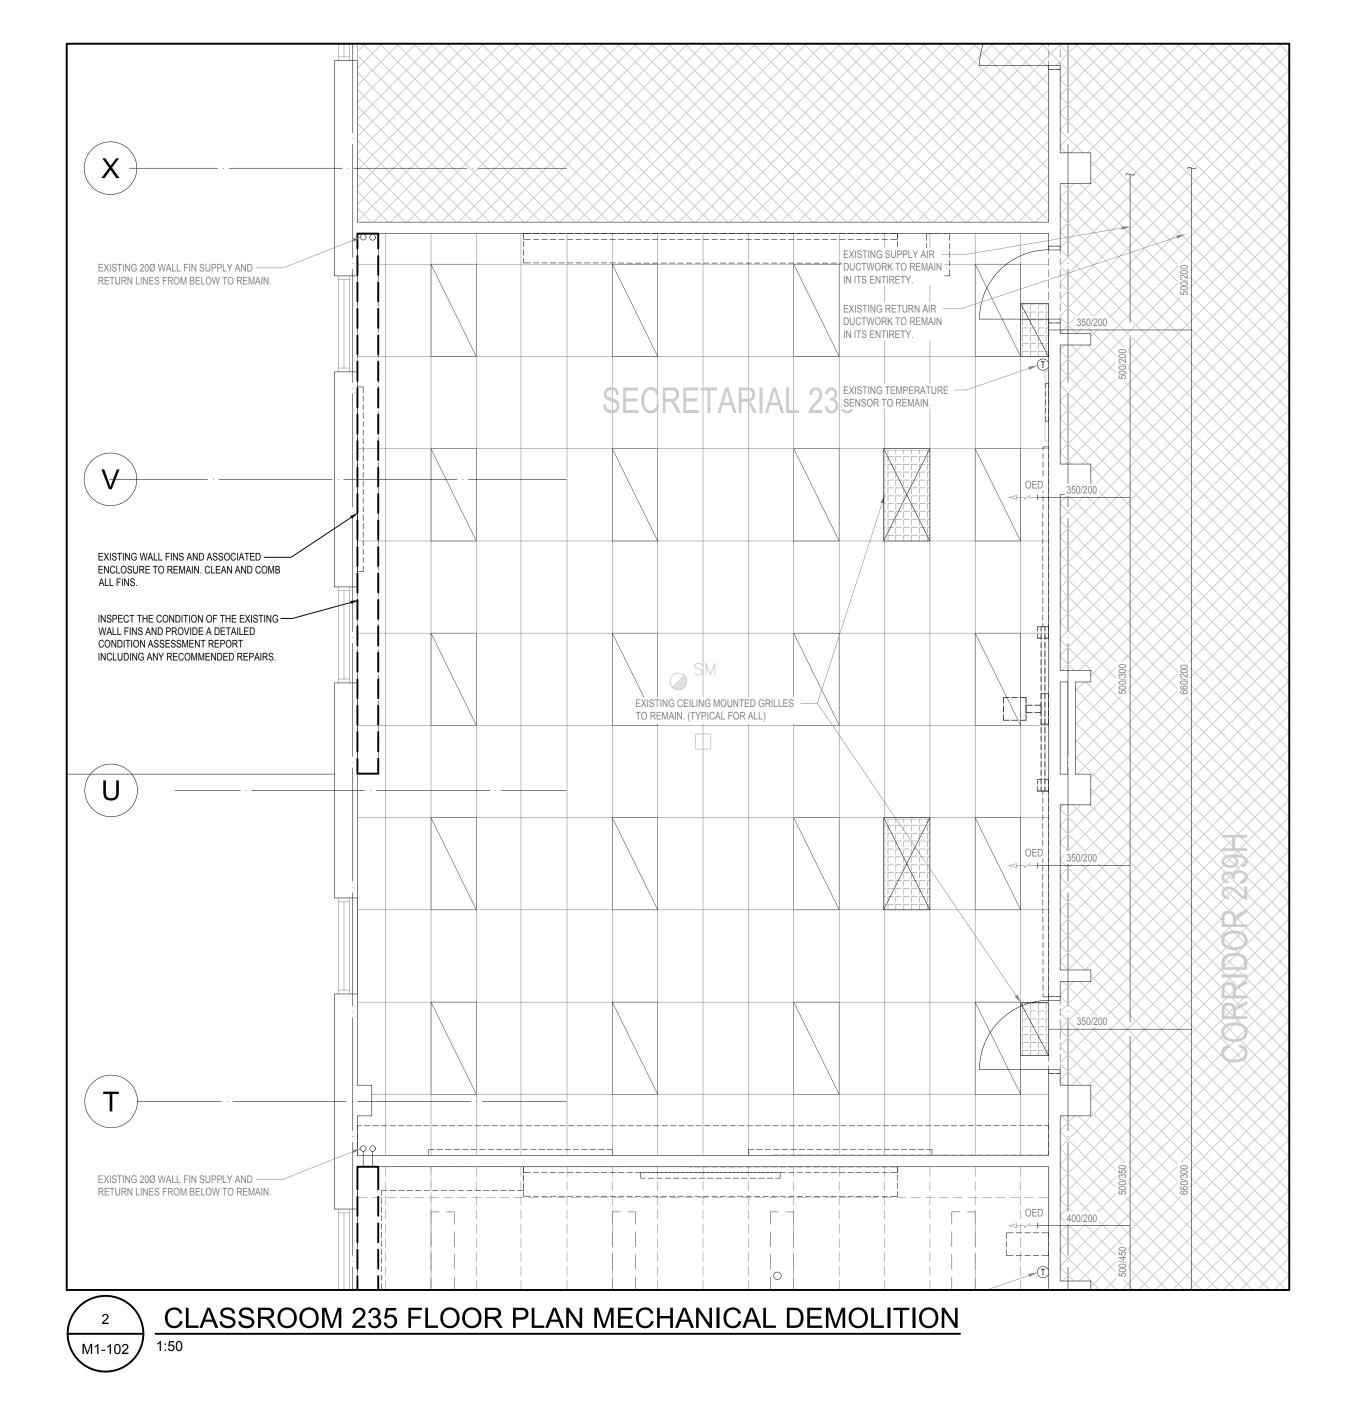
Drawing No.:

Date Plotted: Mar 12, 2024 — 11:01am

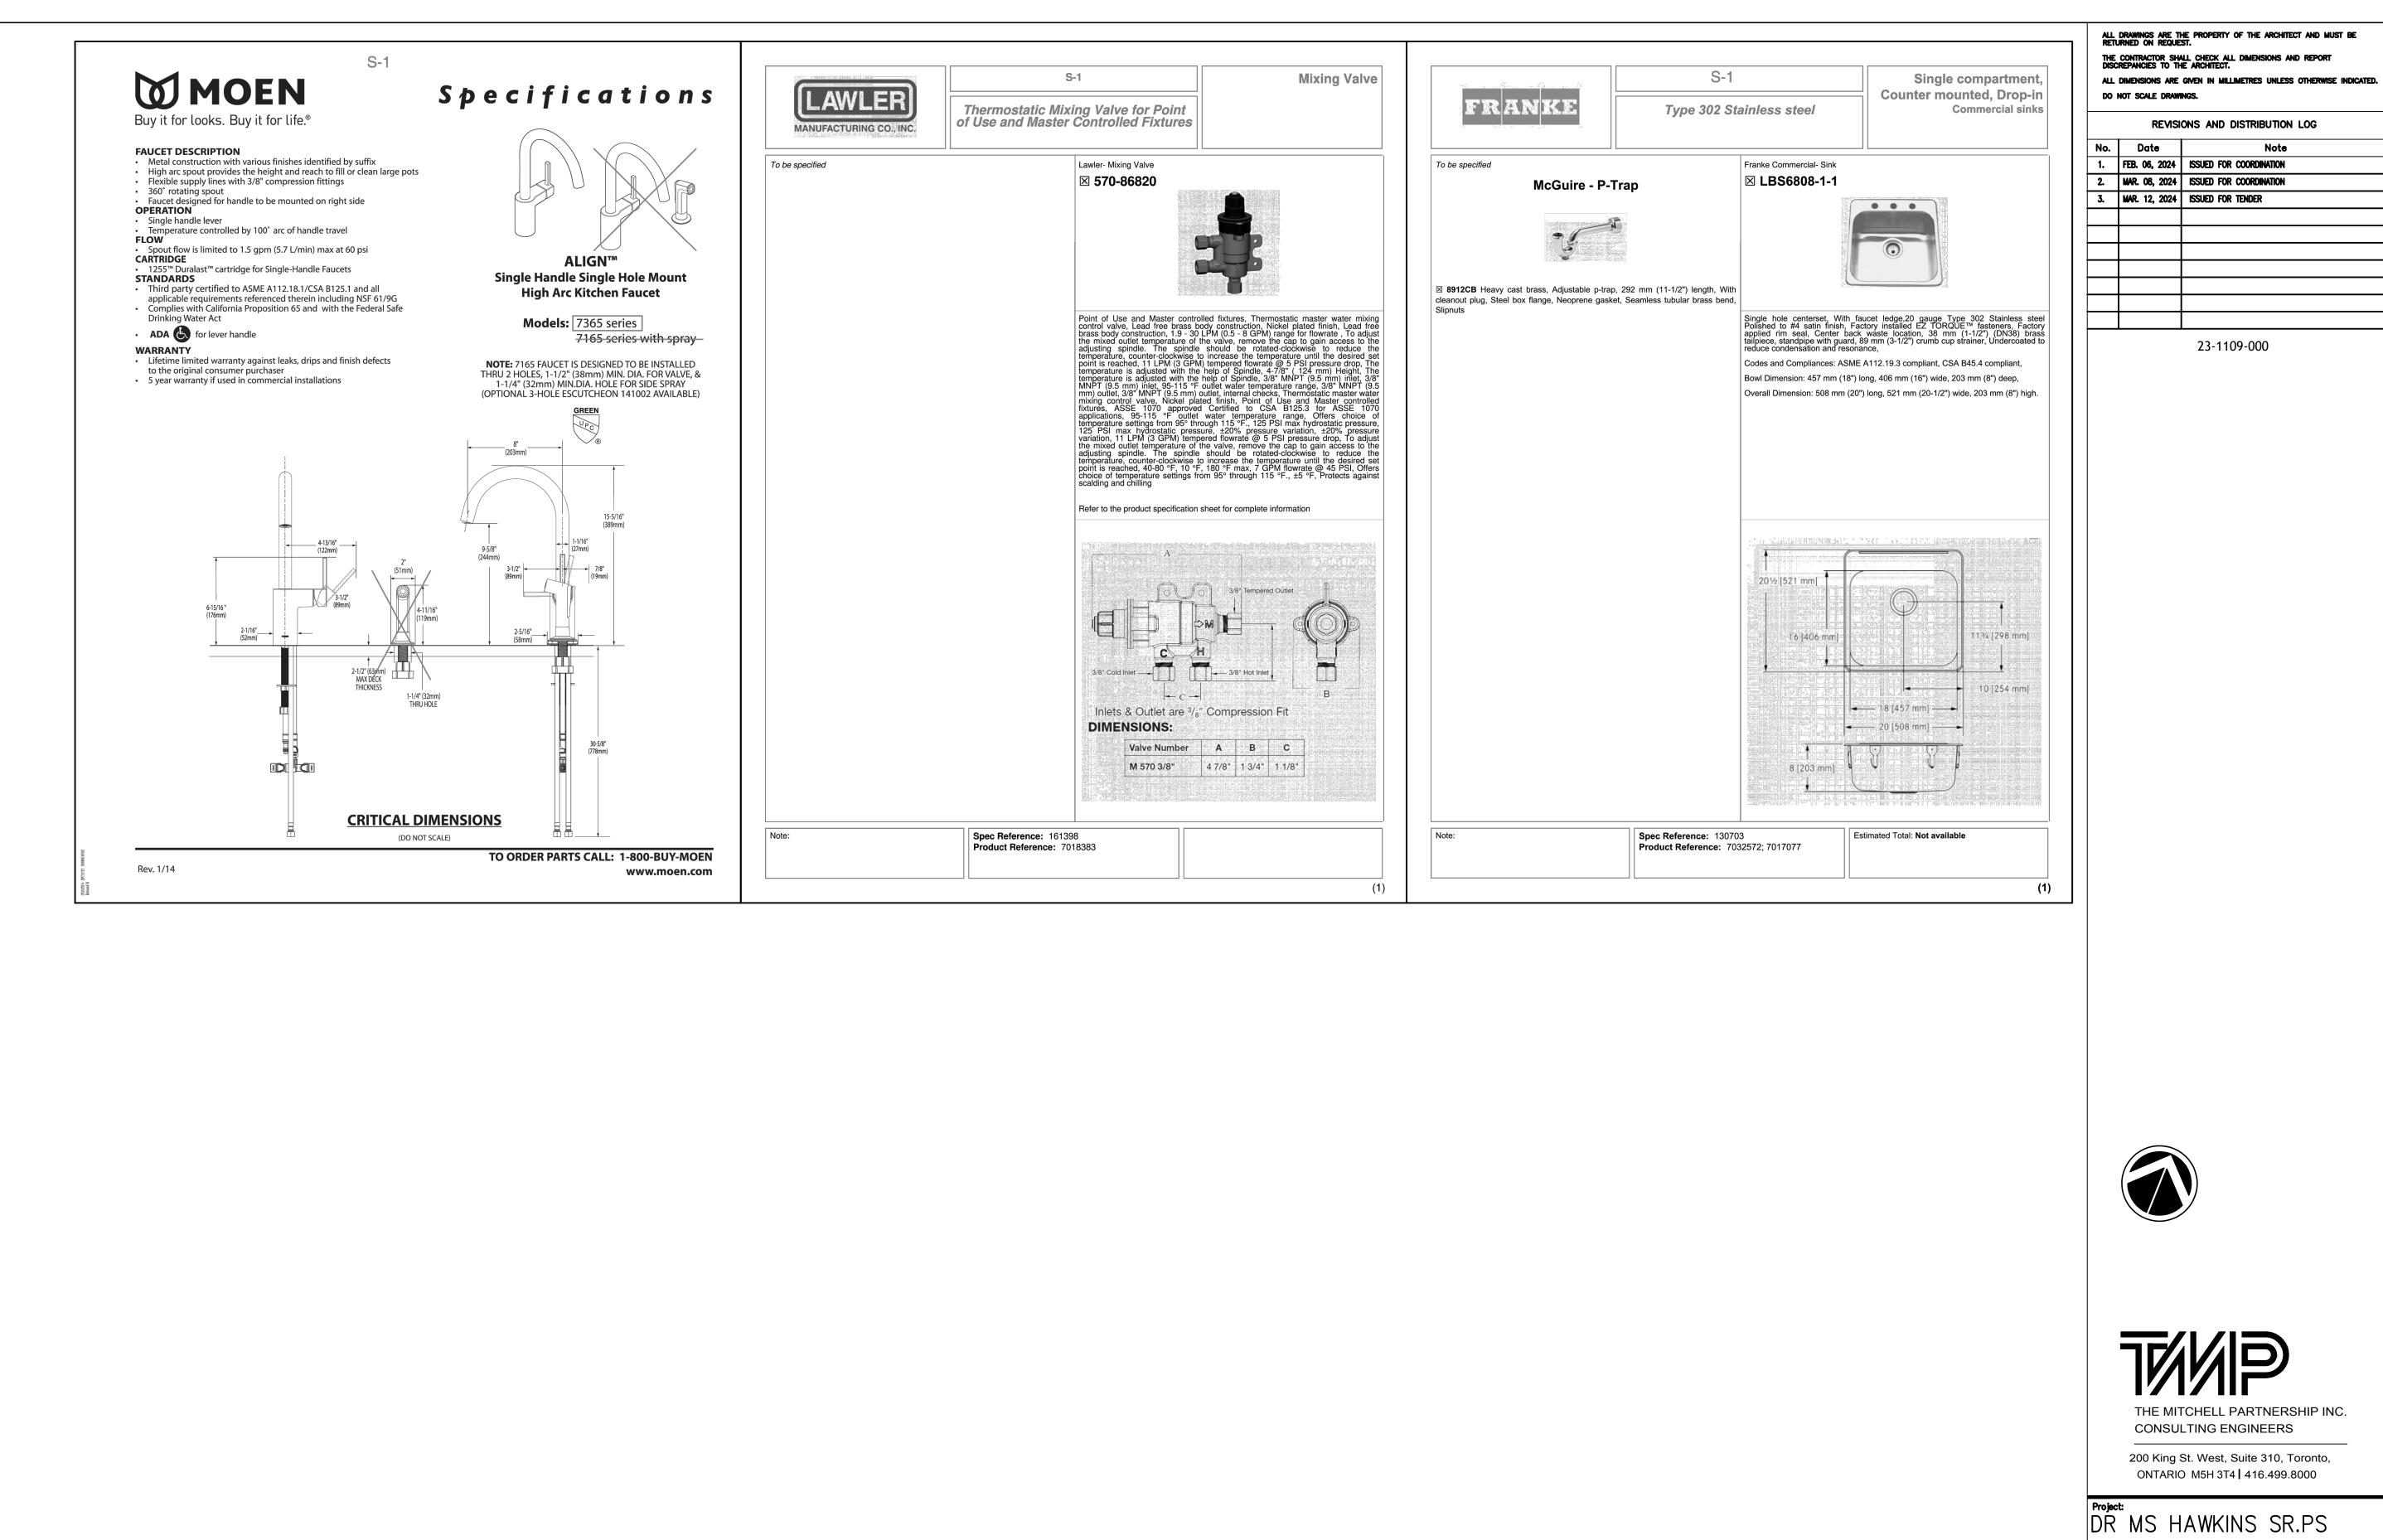

No. Date Note 1 FR. 64, 2024 ISSID FR. CORROWNINK 2 WR. 12, 2024 ISSID FR. CORROWNINK 3 WR. 12, 2024 ISSID FR. CORROWNINK 4 4 5 4 4 5 4 4 6 5 5 7 7 7 7 7 7 7 8 4 7 7 7 7 7 7 7 7 7 7 7	No.	NOT SCALE DRAW REVISI	IONS AND DISTRIBUTION LOG
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POJECT DISTANCE POTOTION CLASSROOMS 233-235-244-245-246-247 ROUVATION RAWARTHA PINE RIDGE DISTRICT SCHOOL BOAR 130 HIGHLAND DRIVE ONTARIO PORT HOPE ONTARIO Drowing Titler CLASSROOMS 2444 TO 247 CAD AF Ontel Polito Drowing Titler CLASSROOMS 2444 TO 247 CAD AF Distonce Drowing Titler CLASSROOMS 2444 TO 247 Machanical DEMOLITION AF Diston Foltate: Mar Mar 12, 2024 - 11:01am Ediet	3.	-	
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Drawing Title: CLASSROOMS 244 TO 247 MECHANICAL DEMOLITION Drawn By: Checked By: Date Checked: Project No. CAD AF Date Plotted: Scale: Mar 12, 2024 - 11:01am 1:50	DR CLAS REN	THE MI CONSU 200 King ONTARIO MS H SSROOMS 2 OVATION	TCHELL PARTNERSHIP INC. LTING ENGINEERS St. West, Suite 310, Toronto, O M5H 3T4 416.499.8000 IAWKINS SR.PS 33–235–244–245–246–247
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Drawn By: CADChecked By: AFDate Checked: Project No.Date Plotted: Mar 12, 2024Scale: 11:01am	DR CLAS RENG KAW 130 POR	THE MIT CONSU 200 King ONTARIO MS H SSROOMS 2 OVATION ARTHA PIN HIGHLAND T HOPE	TCHELL PARTNERSHIP INC. LTING ENGINEERS St. West, Suite 310, Toronto, 0 M5H 3T4 416.499.8000 IAWKINS SR.PS 33–235–244–245–246–247 IE RIDGE DISTRICT SCHOOL BOARD
CADAFDate Plotted:Scale:Mar 12, 202411:01am1:50	DR CLAS RENG KAW 130 POR	THE MI CONSU 200 King ONTARIO MS H SSROOMS 2 OVATION ARTHA PIN HIGHLAND T HOPE	TCHELL PARTNERSHIP INC. LTING ENGINEERS St. West, Suite 310, Toronto, O M5H 3T4 416.499.8000 IAWKINS SR.PS 33–235–244–245–246–247 IE RIDGE DISTRICT SCHOOL BOARD DRIVE
Date Plotted: Scale: Mar 12, 2024 – 11:01am 1:50	DR CLAS REN KAW 130 POR Drawin CL	THE MITCONSU 200 King ONTARIO MS H SSROOMS 2 OVATION ARTHA PIN HIGHLAND T HOPE	TCHELL PARTNERSHIP INC. LTING ENGINEERS St. West, Suite 310, Toronto, D M5H 3T4 416.499.8000 IAWKINS SR.PS 33–235–244–245–246–247 IE RIDGE DISTRICT SCHOOL BOARD DRIVE ONTARIO
Mar 12, 2024 - 11:01am 1:50	DR CLAS RENG KAW 130 POR Drawin CL Drawn	THE MITCONSU 200 King ONTARIO MS H SSROOMS 2 OVATION ARTHA PIN HIGHLAND T HOPE Ng Title: ASSRO CHANIO	TCHELL PARTNERSHIP INC. LTING ENGINEERS St. West, Suite 310, Toronto, D M5H 3T41 416.499.8000 IAWKINS SR.PS 33–235–244–245–246–247 IE RIDGE DISTRICT SCHOOL BOARE DRIVE ONTARIO OMS 244 TO 247 CAL DEMOLITION d By: Date Checked: Project No.
	DR CLAS RENG KAW 130 POR Drawin CL Drawin CL	THE MITCONSU 200 King ONTARIO MS H SSROOMS 2 OVATION ARTHA PIN HIGHLAND T HOPE NG TITLE: ASSRO CHANIO	TCHELL PARTNERSHIP INC. LTING ENGINEERS St. West, Suite 310, Toronto, D M5H 3T4 416.499.8000 IAWKINS SR.PS 33–235–244–245–246–247 IE RIDGE DISTRICT SCHOOL BOARE DRIVE ONTARIO OMS 244 TO 247 CAL DEMOLITION d By: Date Checked: Project No.
Drawing No.: Revision No.:	DR CLAS RENG KAW 130 POR Drawin CL Drawin C/ Drawin	THE MITCONSU 200 King ONTARIO MS H SSROOMS 2 OVATION ARTHA PIN HIGHLAND THOPE Ng Title: ASSRO CHANIO By: Checke AD AF Plotted:	TCHELL PARTNERSHIP INC. LTING ENGINEERS St. West, Suite 310, Toronto, D M5H 3T41 416.499.8000 IAWKINS SR.PS 33–235–244–245–246–247 IE RIDGE DISTRICT SCHOOL BOARE DRIVE ONTARIO OMS 244 TO 247 CAL DEMOLITION OMS Date Checked: Project No. Scale:



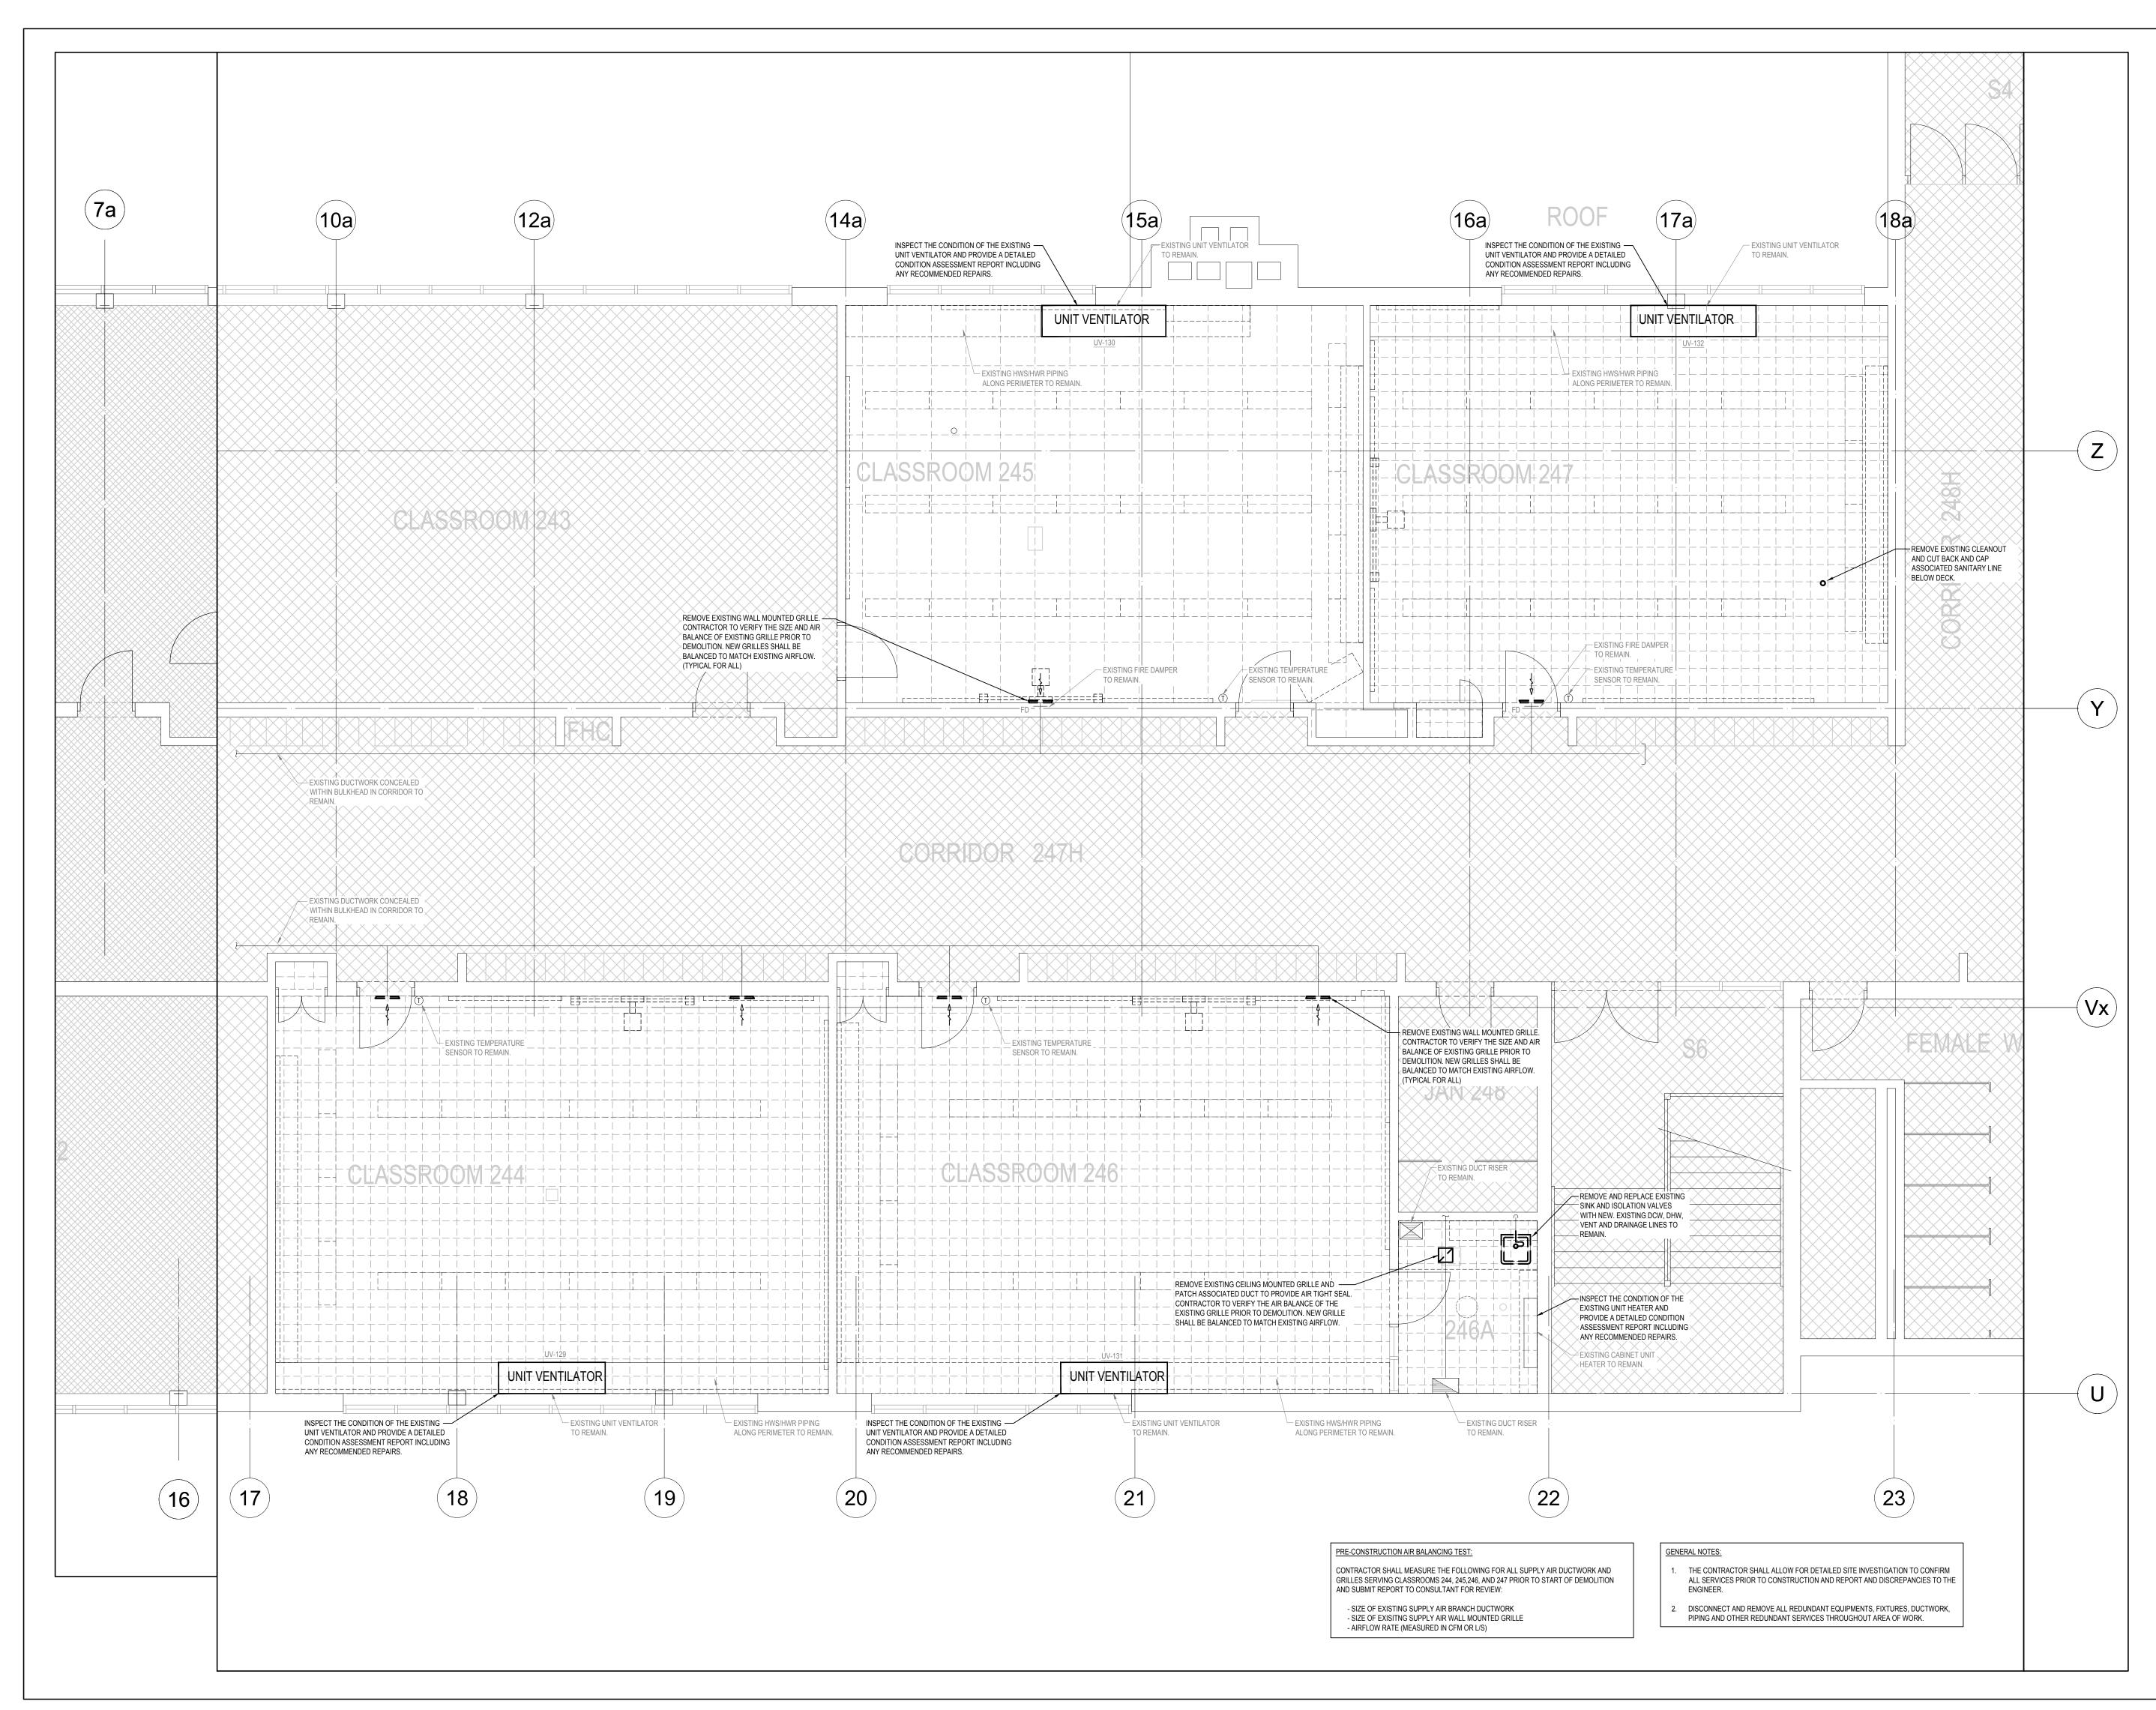

 PRE-CONSTRUCTION AIR BALANCING TEST:

 CONTRACTOR SHALL MEASURE THE FOLLOWING FOR ALL SUPPLY AIR DUCTWORK AND

 GRILLES SERVING CLASSROOMS 233 AND 235 PRIOR TO START OF DEMOLITION AND SUBMIT

 REPORT TO CONSULTANT FOR REVIEW:

 - SIZE OF EXISTING SUPPLY AIR BRANCH DUCTWORK

 - SIZE OF EXISITING SUPPLY AIR WALL MOUNTED GRILLE

 - AIRFLOW RATE (MEASURED IN CFM OR L/S)

DISC	REPANCIES TO TH	GIVEN IN MILLIMETRES UNLESS OTHERWISE INDICATED.
	REVISI	ONS AND DISTRIBUTION LOG
No.	Date	Note
1.	FEB. 06, 2024	ISSUED FOR COORDINATION
2.	MAR. 08, 2024	ISSUED FOR COORDINATION
3.	MAR. 12, 2024	ISSUED FOR TENDER
		23-1109-000

GENERAL NOTES:

- . THE CONTRACTOR SHALL ALLOW FOR DETAILED SITE INVESTIGATION TO CONFIRM ALL SERVICES PRIOR TO CONSTRUCTION AND REPORT AND DISCREPANCIES TO THE ENGINEER.
- DISCONNECT AND REMOVE ALL REDUNDANT EQUIPMENTS, FIXTURES, DUCTWORK, PIPING AND OTHER REDUNDANT SERVICES THROUGHOUT AREA OF WORK.






THE MITCHELL PARTNERSHIP INC. CONSULTING ENGINEERS

200 King St. West, Suite 310, Toronto, ONTARIO M5H 3T4 | 416.499.8000


Project: DR MS HAWKINS SR.PS CLASSROOMS 233-235-244-245-246-247 RENOVATION KAWARTHA PINE RIDGE DISTRICT SCHOOL BOARD


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No. 1.	Date FEB. 06, 2024	Note ISSUED FOR COORDINATION	
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DR CLAS	THE MIT CONSUL 200 King S ONTARIC SSROOMS 2	CHELL PARTNERS LTING ENGINEERS St. West, Suite 310, 1 D M5H 3T4 416.499.	S Foronto, 8000 R.PS
DR CLAS RENG	THE MIT CONSUL 200 King S ONTARIC MS H SSROOMS 23 OVATION	CHELL PARTNERS LTING ENGINEERS St. West, Suite 310, T D M5H 3T4 416.499. AWKINS SR 33–235–244–245–	S Foronto, 8000 R.PS -246–247
DR CLAS REN((AW	THE MIT CONSUL 200 King S ONTARIC MS H SSROOMS 23 OVATION ARTHA PIN	CHELL PARTNERS LTING ENGINEERS St. West, Suite 310, T D M5H 3T4 416.499. AWKINS SR 33–235–244–245– E RIDGE DISTRICT	S Foronto, 8000 R.PS -246–247
DR CLAS RENG (AW	THE MIT CONSUL 200 King S ONTARIC MS H SSROOMS 23 OVATION	CHELL PARTNERS LTING ENGINEERS St. West, Suite 310, T D M5H 3T4 416.499. AWKINS SR 33–235–244–245– E RIDGE DISTRICT	S Foronto, 8000 R.PS -246–247
DR CLAS RENG (AW 130 POR	THE MIT CONSUL 200 King S ONTARIC MS H SSROOMS 23 OVATION ARTHA PIN HIGHLAND T HOPE	CHELL PARTNERS LTING ENGINEERS St. West, Suite 310, T D M5H 3T4 416.499. AWKINS SR 33–235–244–245– E RIDGE DISTRICT DRIVE	S Foronto, 8000 C.PS -246–247 SCHOOL BOARD ONTARIO
DR CLAS RENG (AW 130 POR Drowin CL	THE MIT CONSUL 200 King S ONTARIC MS H SSROOMS 23 OVATION ARTHA PIN HIGHLAND T HOPE	CHELL PARTNERS LTING ENGINEERS St. West, Suite 310, T D M5H 3T4 416.499. AWKINS SR 33–235–244–245– E RIDGE DISTRICT DRIVE	S Foronto, 8000 C.PS -246–247 SCHOOL BOARD ONTARIO
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No.	Date	Note							
1.	FEB. 06, 2024	ISSUED FOR COORDINATION							
2.	MAR. 08, 2024	Issued for coordination							
3.	MAR. 12, 2024	Issued for tender							
		23-1109-000							

GENERAL NOTES:

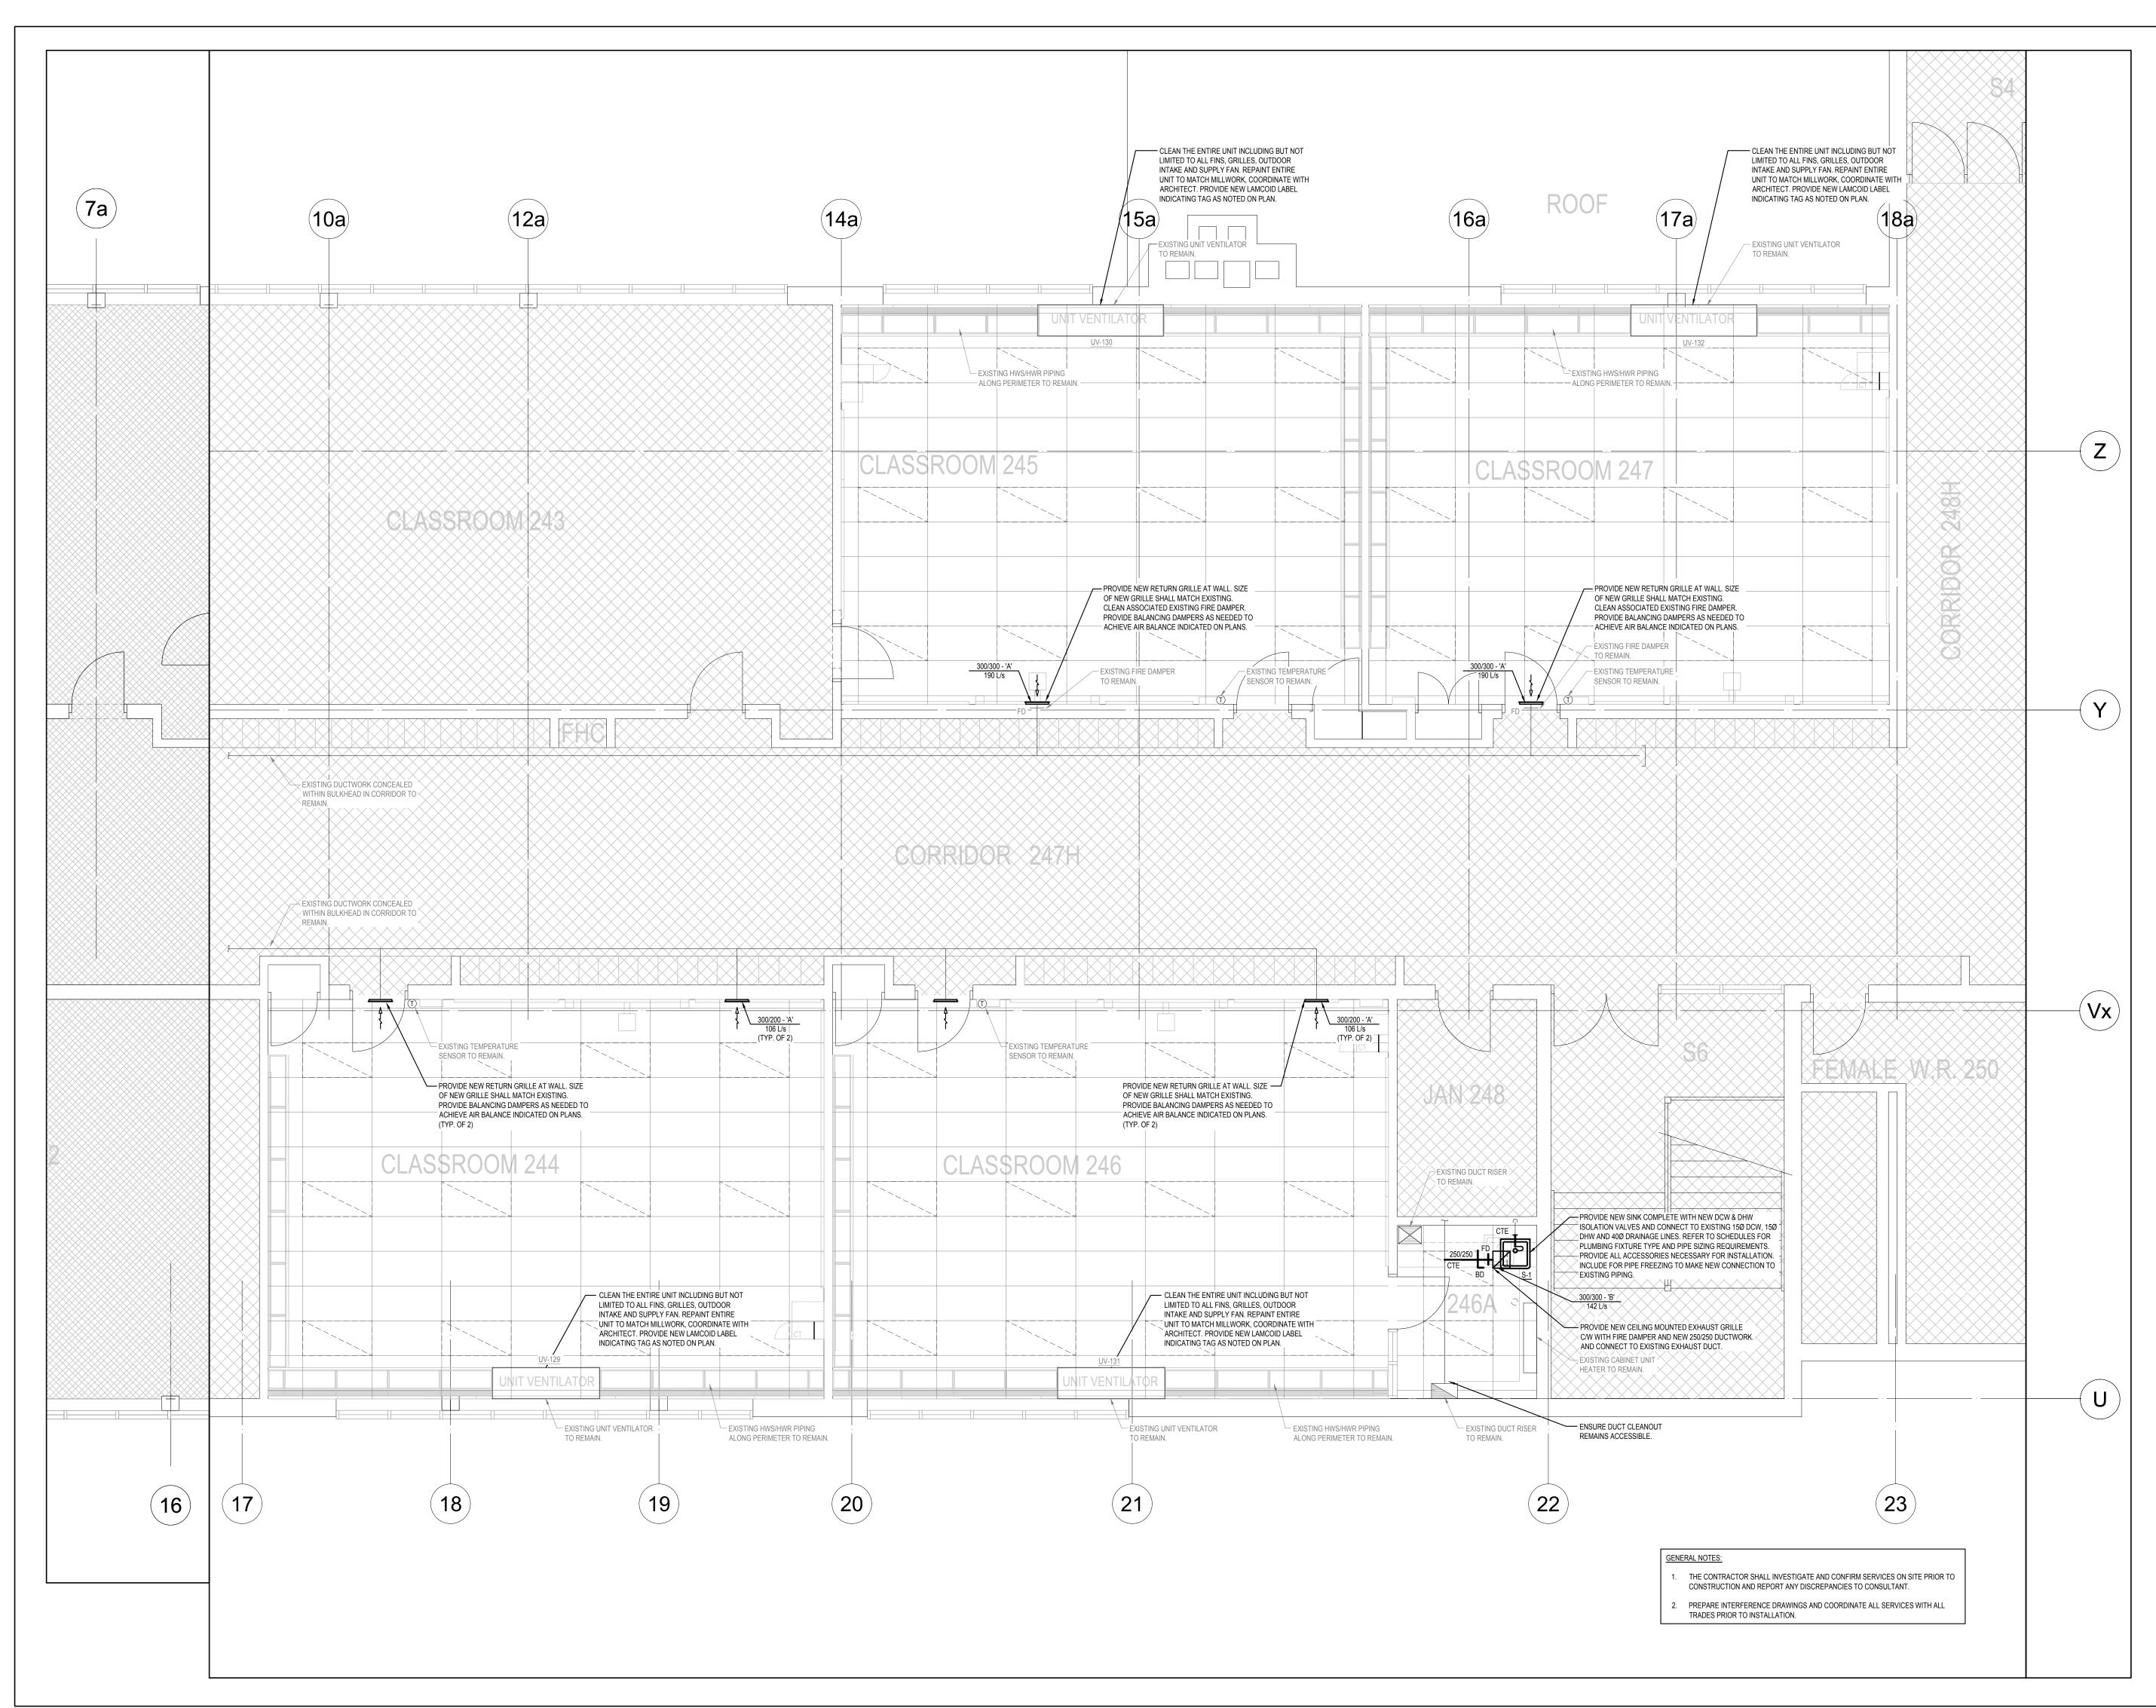THE CONTRACTOR SHALL INVESTIGATE AND CONFIRM SERVICES ON SITE PRIOR TO CONSTRUCTION AND REPORT ANY DISCREPANCIES TO CONSULTANT.

PREPARE INTERFERENCE DRAWINGS AND COORDINATE ALL SERVICES WITH ALL TRADES PRIOR TO INSTALLATION.

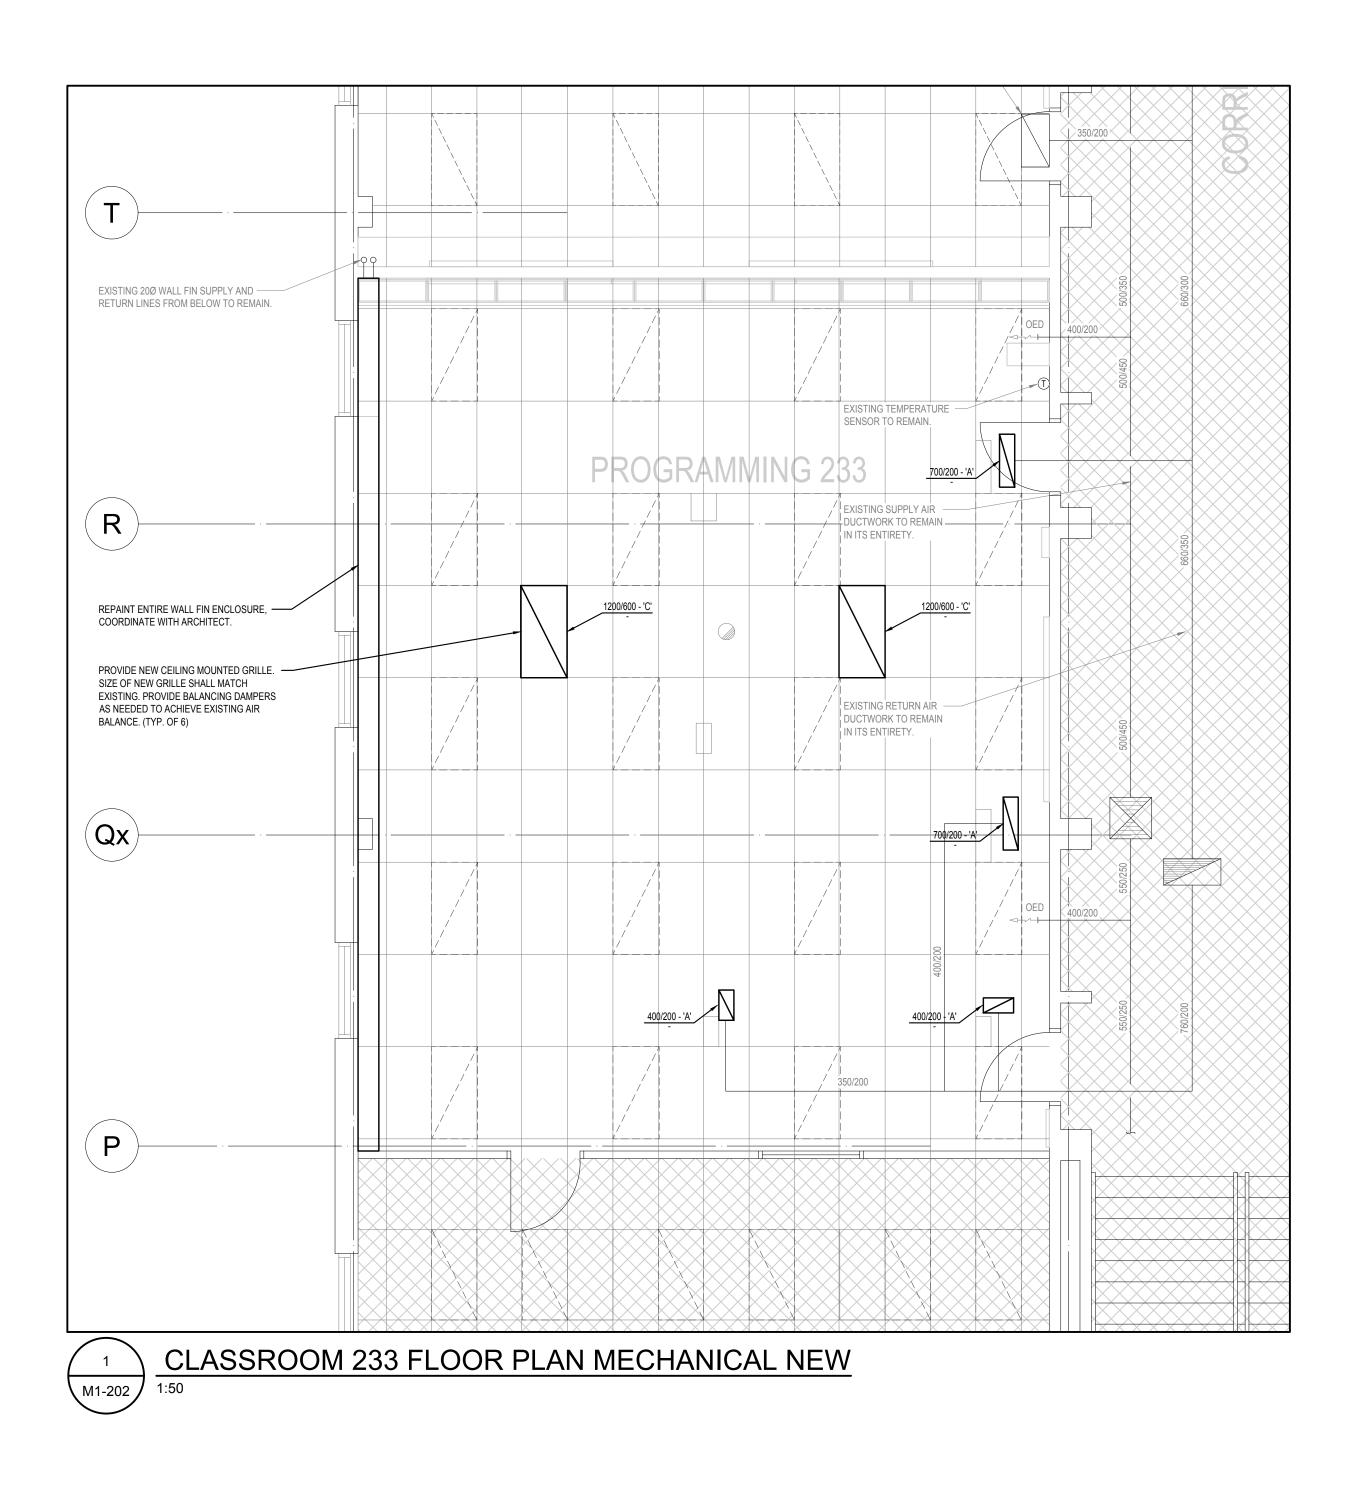

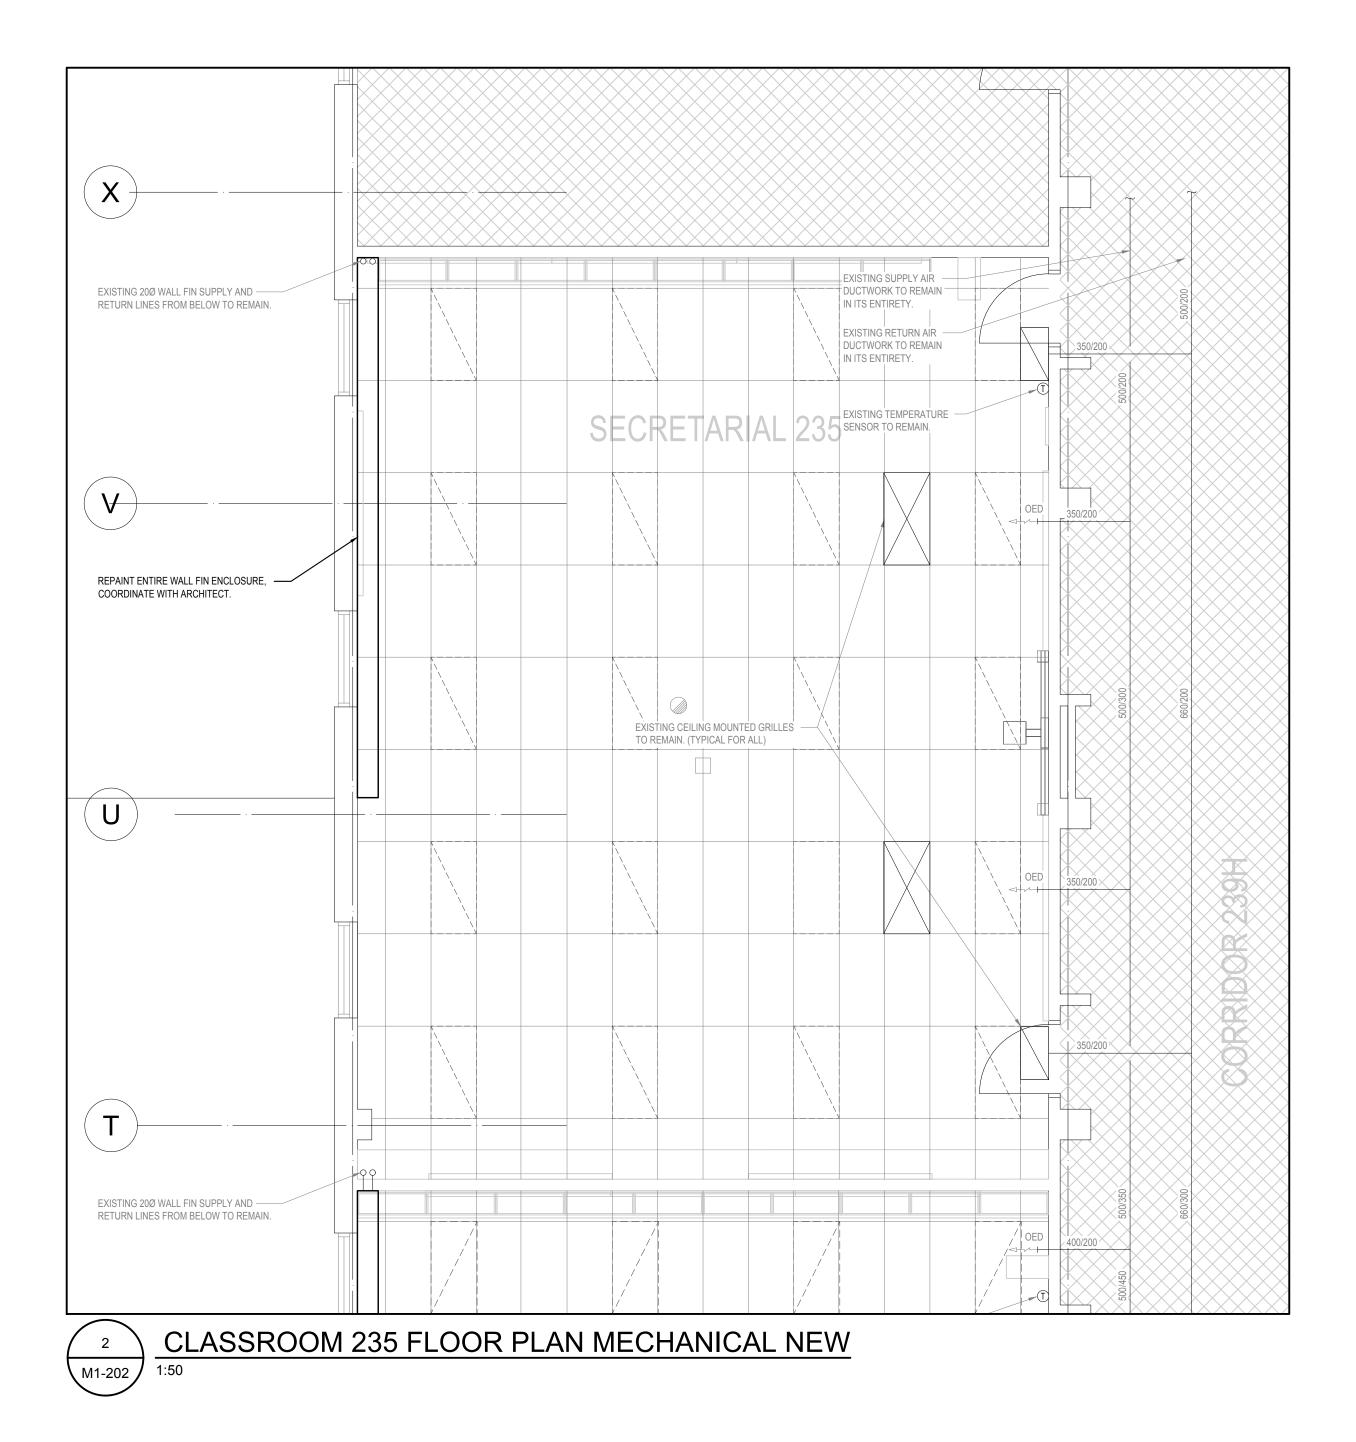


THE MITCHELL PARTNERSHIP INC

200 King St. West, Suite 310, Toronto, ONTARIO M5H 3T4 | 416.499.8000

Project: DR MS HAWKINS SR.PS CLASSROOMS 233-235-244-245-246-247 RENOVATION KAWARTHA PINE RIDGE DISTRICT SCHOOL BOARD

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GENERAL NOTES (APP	Y TO ALL DRAWINGS)	
BE READ IN CONJUNCTION WITH ARCHITECTURAL DRAWINGS AND GHTING FIXTURES REFER TO ARCHITECTURAL DRAWINGS. LL A/C UNITS, PUMPS, MOTORS, HEATERS, EXHAUST FANS ETC, SEE O-ORDINATE ALL WORK WITH MECHANICAL CONTRACTOR. AND DEVICES SHALL REMAIN UNLESS OTHERWISE NOTED. RECEPTACLES AND OUTLETS SHALL BE DETERMINED BY THE ARCHITECT	 13.1 EXISTING FIXTURES : THE BELOW INFORMATION SHALL BE PROVIDED BY THE CONTRACTOR AFTER AWARDING THE CONTRACT. LAMP WATTAGE LAMPS/FIXTURE 13.2. PHOTOS OF EACH FIXTURE BEING REMOVED ARE REQUIRED. THE REQUIRED PHOTOS ARE AS FOLLOWS: PICTURE OF THE TYPICAL ROOM FOR EACH TYPE OF FIXTURE 	RETROFIT PROC Photo Best Pract The following best pract
GHING-IN. CONTRACTOR TO VERIFY. SHALL CO-ORDINATE THEIR WORK TO SUIT THE PROJECT PHASE	 PICTURE OF THE TYPICAL FIXTURE BEING REMOVED, (FOR EACH TYPE OF FIXTURE) CLOSEUP SHOWING THE WATTAGE, (EITHER OF LAMP INSTALLED, OR THE BOX OF REPLACEMENT LAMPS IF ACTUAL LAMP IS NOT ACCESSIBLE). 13.2. PHOTOS OF THE NEW FIXTURES BEING INSTALLED ARE REQUIRED. THE REQUIRED PHOTOS ARE AS FOLLOWS: 	and will reduce the risk t delay approval of your a Please note that photos
ID PAINTING SHALL BE DONE BY THIS ELECTRICAL CONTRACTOR. IS AND CEILINGS SHALL BE BY THIS CONTRACTOR, WHO SHALL OBTAIN HE LOCATIONS OF THE DRILLING FROM THE GENERAL CONTRACTOR. CTURAL INTEGRITY OF THE BUILDING SHALL NOT BE ALLOWED WITHOUT IE STRUCTURAL ENGINEER.	 PICTURE OF THE TYPICAL ROOM FOR EACH TYPE OF FIXTURE PICTURE OF THE TYPICAL FIXTURE BEING REMOVED, (FOR EACH TYPE OF FIXTURE) CLOSEUP OF THE NAMEPLATE TO VERIFY THE MODEL NUMBER. 13.4. WASTE DISPOSAL DOCUMENTATION IS REQUIRED FROM THE WASTE DISPOSAL COMPANY. A RECEIPT, CERTIFICATE ORINVOICE FROM THE WASTE DISPOSAL COMPANY SHOULD INDICATE THE NUMBER OF LAMPS 	<u>QA/QC guideline</u> . Note this instance, technical r application which will in take photos prior to star
SLAB SHALL BE REQUIRED PRIOR TO ANY CORE DRILL OR SAW-CUT THIS CONTRACTOR. CO-ORDINATE X-RAYING SCHEDULE WITH THE EEDING. YOUT ON SITE WITH OTHER TRADES TO AVOID CONFLICTS WITH S, ETC EVICE SCOPE ON DRAWING E-101 FOR FURTHER DETAIL. ETOR SHALL ALLOW IN CONTRACT TO PROVIDE REQUIRED DOCUMENTS INCENTIVE PROGRAM AS FOLLOW. COORDINATE WORKS WITH SCHOOL	 AND TYPE OF LAMPS DISPOSED-OF, (SOMETIMES LISTED AS # FT). 14. ALL RECEPTACLES WITHIN RENOVATION AREAS SHALL BE TAMPER-PROOF. 15. CIRCUITS NUMBER SHOWN ON DRAWINGS ARE FOR REFERENCE / CIRCUITING ONLY. THIS ELECTRICAL CONTRACTOR SHALL VERIFY EXISTING PANEL ON SITE TOR REUSE EXISTING CIRCUIT, SPARE BREAKERS OR PROVIDE NEW ONES AS REQUIRED. 	 Best Pra Take e sure the photo
		No pePicture

RETROFIT PROGRAM noto Requirements os Required Close-up Long-shot Nameplate*** the date the photos were taken

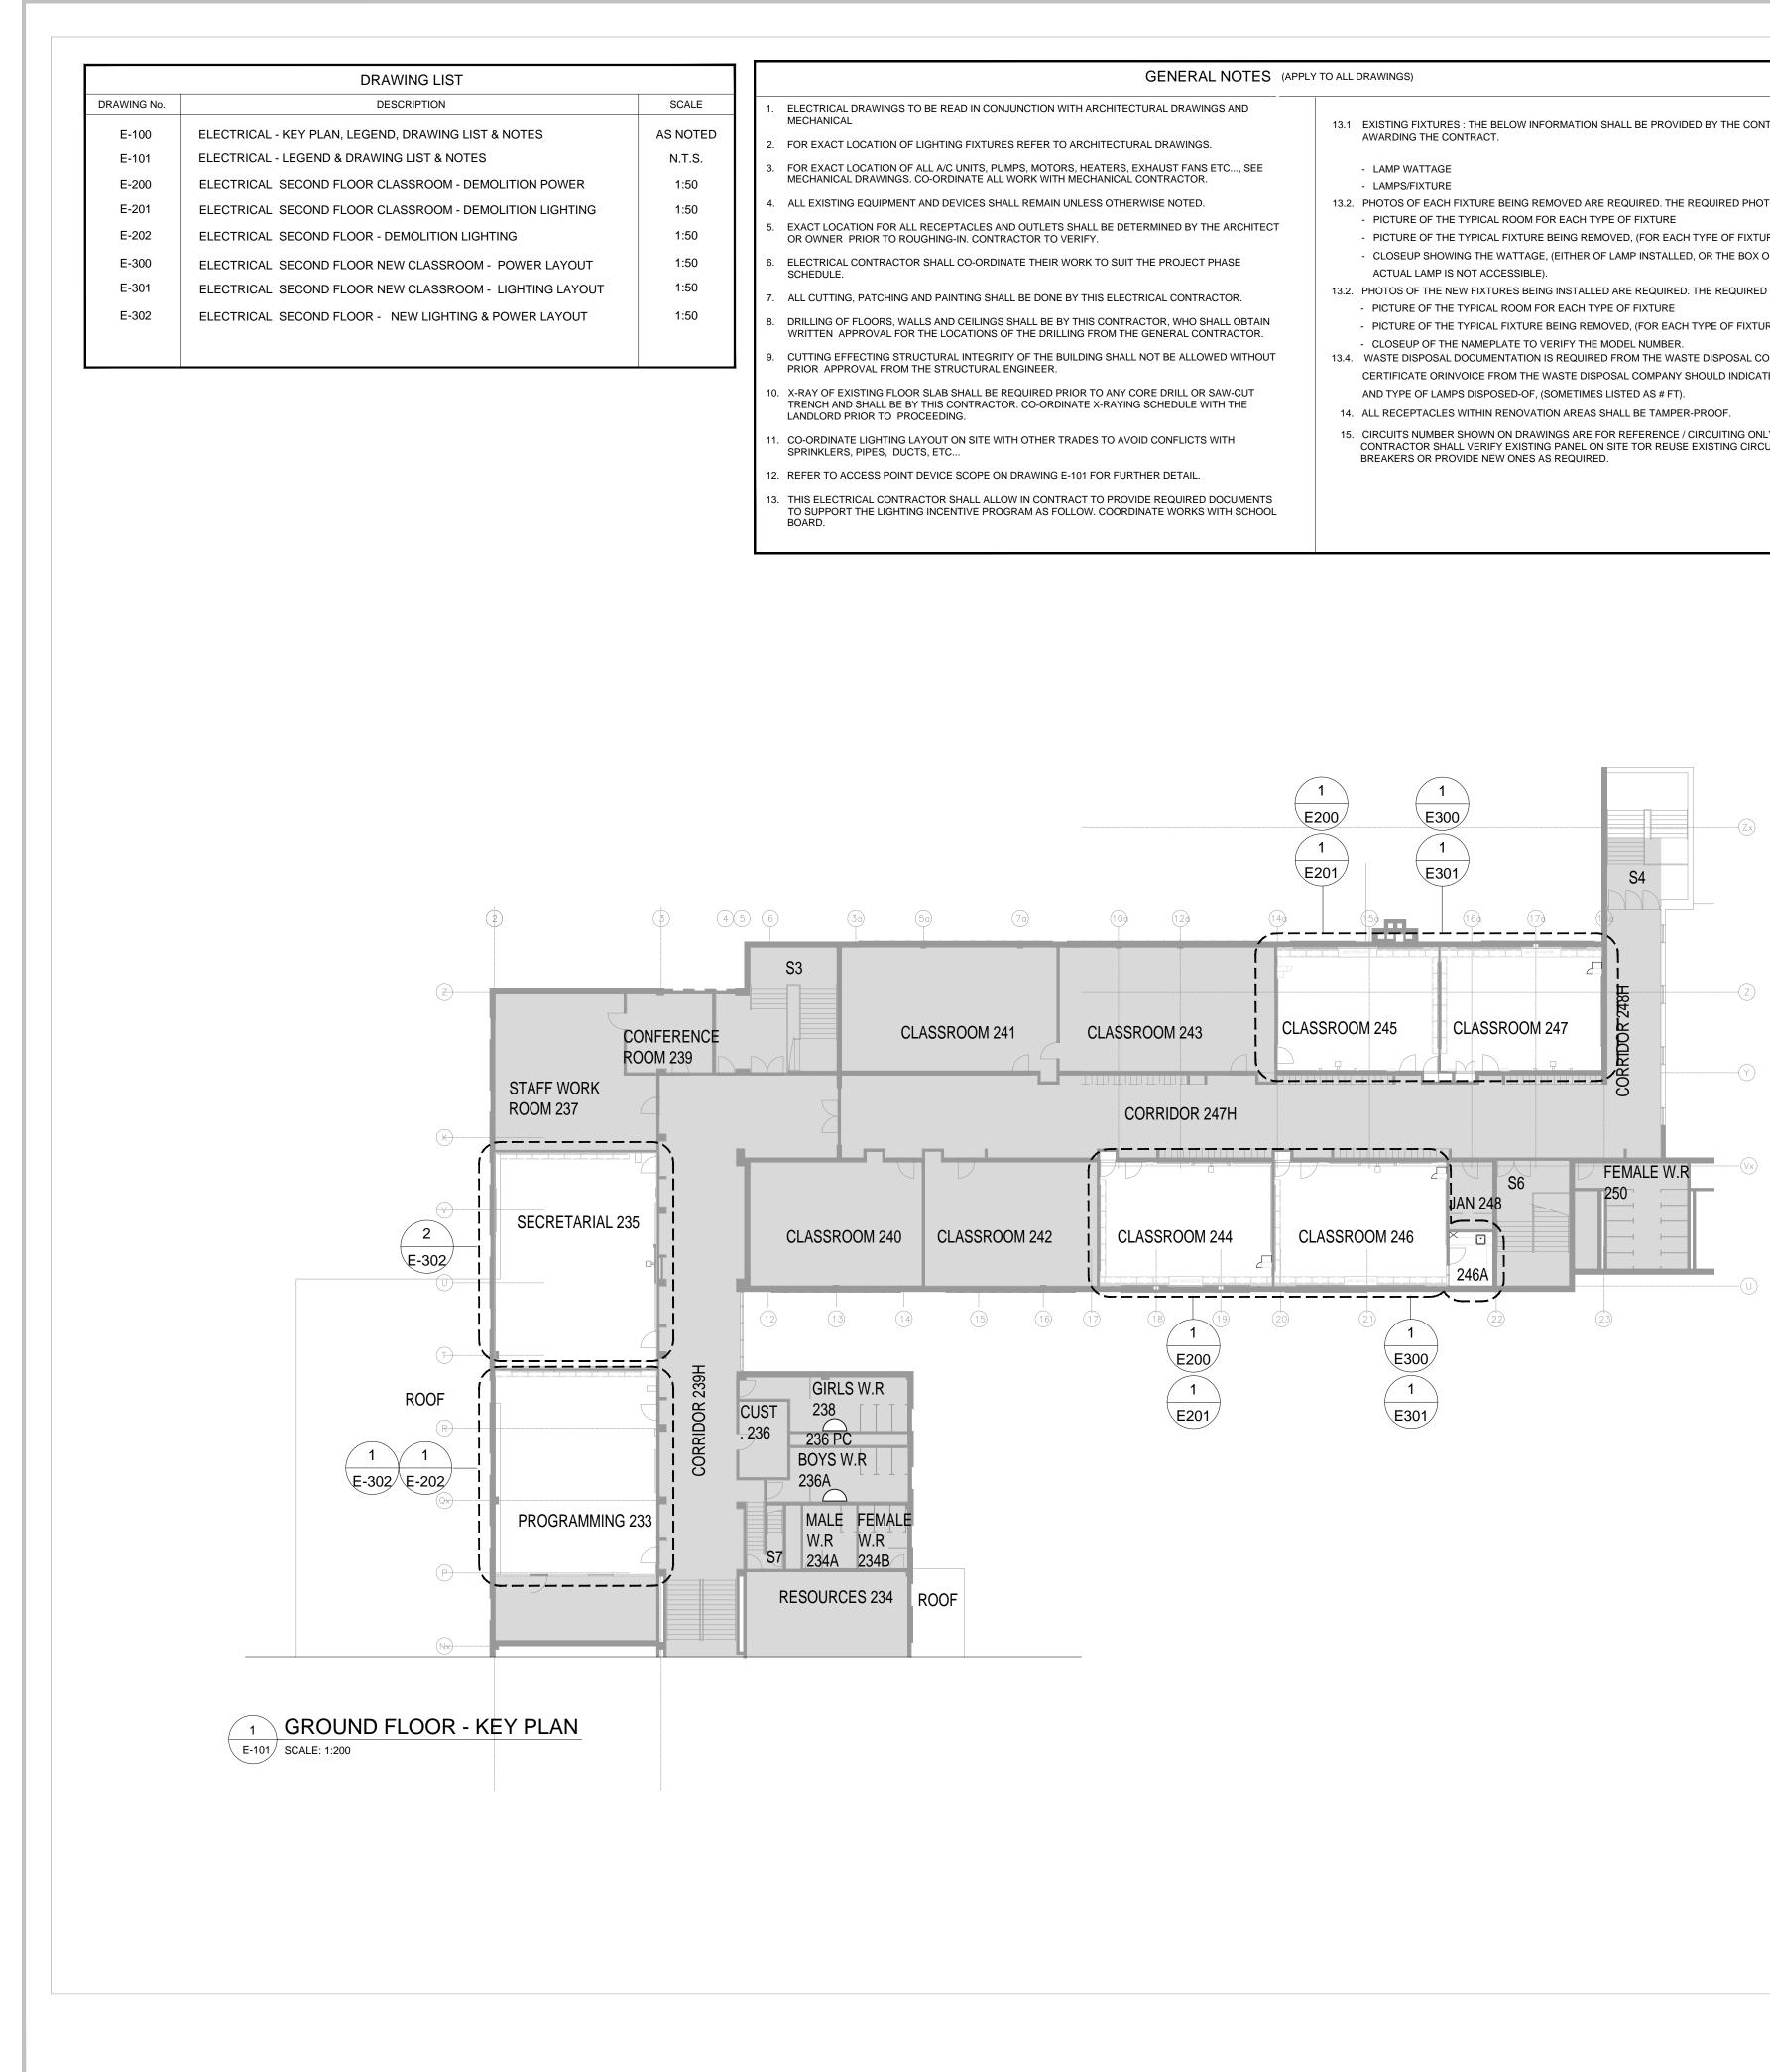**Only one set of photos is required for each type of equipment being replaced. For example, if there are 100 of the same lamps existing in a facility, then only one set of close-ups, long-shot and nameplate pictures would be required. There is no need to provide photos of every single lamp

stage.

GRAM

actices will help to ensure that all photos meet technical requirements isk that further photos are requested by the technical reviewer, which may r application.

tos are required if your application meets the criteria as outlined in the Note that some applications may be selected at random for QA/QC. In al reviewers will request further documentation to support your l include photos. Therefore, it is advisable as a best practice to always starting your project.

Practices:

e extra photos to fully document the scope of work and make e that you will not have to return to the facility site if more otos are required

people should be visible in the pictures

ctures that are supposed to capture numbers or words need to be in focus and legible (i.e., model numbers, performance specs) • Double check the legibility of photos on your camera (by

zooming in on the pictures) before leaving the site

• Be careful of shadows and bright reflections in the pictures. Try using different camera angles or enabling/disabling flash to fix these types of issues

• The exposure lock function of some phones/cameras can

sometimes help to get a good exposure for the picture. Check your device's camera instructions for how to use this common feature



Type of photos required for each type of equipment** being replaced and installed

- Must contain the entire piece of equipment, including where the
- equipment meets the ground or wall
- For lighting, the number of lamps per fixture must be identifiable and photos for each type of fixture are required
- A time-stamp for the photo indicating the date it was taken*
- Must show spread of equipment in facility to verify quantity in
- application
- A time-stamp for the photo indicating the date it was taken*
- Must include the model number
- Must include the equipment specifications (i.e.,wattage, horsepower)
- For lighting, a nameplate photo is required for each type of lamp if the wattage for the lamps are different between fixtures
- A time-stamp for the photo indicating the date it was taken*

*If a time-stamp cannot be provided, the photos can be supplemented with confirmation by the participant identifying

***If the equipment is difficult or expensive to access, you may defer providing nameplate pictures. Ensure you collect the nameplate photographs during the decommissioning of the existing equipment and submit them during the Post-Project



ALL DRAWINGS ARE THE PROPERTY OF THE ARCHITECT AND MUST BE RETURNED ON REQUEST.
THE CONTRACTOR SHALL CHECK ALL DIMENSIONS AND REPORT DISCREPANCIES TO THE ARCHITECT.
ALL DIMENSIONS ARE GIVEN IN MILLIMETRES UNLESS OTHERWISE INDICATED.
DO NOT SCALE DRAWINGS.
REVISIONS AND DISTRIBUTION LOG

No.	Date	Note
01	12/MAR/2024	ISSUED FOR TENDER







DR MS HAWKINS SR.PS

CLASSROOMS 233-235-244-245-246-247 RENOVATION

Drawing Title:

KAWARTHA PINE RIDGE DISTRICT SCHOOL BOARD


130 HIGHLAND DRIVE PORT HOPE ONTARIO

ELECTRICAL - KEY PLAN, LEGEND DRAWING LIST & NOTES

Drawn By: Checked By: Date Checked: Project No. 24-018-002 MT QV Date Plotted: Scale: Mar 13, 2024 - 9:20am AS NOTED Revision No.: Drawing No.


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LA COOPER LIGHTING CAT.# METALUX 2X4FP 120V LED RECESSED 2'X4' RECESSED T-		LIGHT FIX	TURE SCHE	DULE	
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INTELECTOR CONTRACTOR SHALL COORDINATE WORK WITH GENERAL CONTRACTOR AND PROVIDE WORKS FOR WIRELESS AS FOLLOW: 1 ALL EXISTING WIRELESS AND FOLLOW: BATTERY UNITS 2 PROR TO CONSTRUCTION, CONTRACTOR SHALL REDIGNITIED TO BE ASSOCIATED WITH PRATICULAR ROOM NAMENUMBER THAT DEVICE IS BEING INSTALLED. BATTERY UNITS 3. WIRELESS DEVICES SHALL BE IDENTIFIED TO BE ASSOCIATED WITH DEVICES WILL NOT MURCH TO OTHER ROOM. EACH DEVICE WILL HAVE SPECIFIC NUMBER. OBTAIN THE UST OF THE ROOM. EACH DEVICE MULL HAVE SPECIFIC NUMBER. OBTAIN THE UST OF THE ROOM. EACH DEVICE WILL HAVE SPECIFIC NUMBER. BATTERY UNITS 4. RE-INST LINE INSTEMDES AND DEVICES AND PROVIDE REQUIRED TESTING, VERIFICATION TO PROVIDE A COMPLETE SYSTEM. REMOTE HEADS EMIL 5. REFERT TO STOCKDALE - COMMUNICATION EQUIPMENT / WORKS. SINCLE FACE AS PER DRAVED BE EXIT SIGNY X SUBJECT TO STOCKDALE - COMMUNICATION EQUIPMENT / WORKS. SINCLE FACE AS PER DRAVED SIGNY MITH AND AND PROVIDE REQUIRED TESTING, VERIFICATION TO PROVIDE ALL DE LOCKS SIGNY AND NUMBER OF DEVICES. ALL PA SPEAKERS SHOWN ON NEW LAYOUT SHALL BE NEW. VIENTS ON X 9 NOTEL ALL PLAY DEVICES AS PORTO DRAVINGS COMPLETE WITH REQUIRED CONDUMWIRING AND HOME RUN PROVIDE REQUIRED TO STUDIES AND DRAVED EXCLUSATION NEW EQUIPMENT TO SUTT RECORD SHOWS SOME AND REVIT HERE ORDER TO DOWN TO MANNES COMPLETE WITH REQUIRED CONDUMWIRING AND HOME RUN PROVIDE REQUIRED MODIFICATION OR AND NEW EQUIPMENT TO SUTT NEW LAYOUT. SINCLE FACE AS PER DRAVINGS SOME HERE TO PLOOP AND PROVIDE REQUIRED MODIFICATION OR AND NEW EQUIPMENT TO SUTT NEW LAYOUT SHALL BE NEW. SINCLE FACE AS PER DRAVINGS SOME HERE STOR SUTT AS STANA	 FOR FURTHER INFORMATION REGARDING LIGHT FIX TO SPECIFICATION. LED LUMEN VALUES QUOTED FOR FIXTURES ARE TO CONSIDERED MINIMUM, AND AS ABSOLUTE OR DELIN LUMENS. LUMEN VALUES SHOULD NOT EXCEED MORE 	BE /ERED		PROPO MINIMU CONFIF SUBMIT SUBMIT S	DEED FIXTURE BY EMAIL IM OF 10 DAYS PRIOR TO RM REQUIRED FIXTURE V ITING SHOP DRAWINGS.
 P.A. SYSTEM SHALL BE PROVIDED BY THIS CONTRACTOR 1. REFER TO FLOOR PLAN FOR EXACT LOCATION AND NUMBER OF DEVICES. ALL PA SPEAKERS SHOWN ON NEW LAYOUT SHALL BE NEW. 2. VERIFY ON SITE FOR EXACT LOCATION OF P.A. PANEL PRIOR TO ROUGHING-IN. 3. PROVIDE ALL P.A. DEVICES AS SHOWN ON DRAWINGS COMPLETE WITH REQUIRED CONDUIT/WIRING AND HOME RUN FROM INDIVIDUAL DEVICE TO EXISTING P.A. PANEL. 4. CONTRACTOR SHALL VERIFY ON SITE TO PROVIDE REQUIRED MODIFICATION OR /AND NEW EQUIPMENT TO SUIT NEW LAYOUT. 5. REFER TO P.A. SPECIFICATIONS / STOCKDALE - COMMUNICATION EQUIPMENT / WORKS. I. REFER TO P.A. SPECIFICATIONS / STOCKDALE - COMMUNICATION EQUIPMENT / WORKS. MOTES RE. TO VOICE/DATA SYSTEM: VOICE/DATA SYSTEM SHALL BE PROVIDED BY THIS CONTRACTOR 1. REFER TO FLOOR PLAN FOR EXACT LOCATION AND NUMBER OF DEVICES. YEREFY ON SITE FOR EXACT LOCATION AND NUMBER OF DEVICES. YEREFY ON SITE FOR EXACT LOCATION AND NUMBER OF DEVICES. YEREFY ON SITE FOR EXACT LOCATION AND NUMBER OF DEVICES. YEREFY ON SITE FOR EXACT LOCATION OF VOICE/DATA PATCH PANELS PRIOR TO ROUGHING-IN. S. PROVIDE ALL VOICEDATA DEVICES AS SHOWN ON DRAWINGS COMPLETE WITH REQUIRED CONDUIT/WIRING AND HOME RUN FROM INDIVIDUAL DEVICE TO EXISTING VOICE/DATA PATCH PANEL. CONTRACTOR SHALL VERIFY ON SITE TO PROVIDE REQUIRED MODIFICATION OR /AND NEW EQUIPMENT TO SUIT NEW LAYOUT. 	 THIS ELECTRICAL CONTRACTOR SHALL COORDINATE WORK WITH GENERA PROVIDE WORKS FOR WIRELESS AS FOLLOW: 1. ALL EXISTING WIRELESS DEVICES SHALL BE IDENTIFIED TO BE ASSOU PARTICULAR ROOM NAME/NUMBER THAT DEVICE IS BEING INSTALLE 2. PRIOR TO CONSTRUCTION, CONTRACTOR SHALL REMOVE WIRELESS CEILING AND STORE IN SECURE AREA FOR LATER USE. 3. WIRELESS DEVICES SHALL BE IDENTIFIED AND MARKED CAREFULLY. DEVICES WILL NOT MIXUP TO OTHER ROOM. EACH DEVICE WILL HAVE OBTAIN THE LIST OF NUMBER FROM CONSULTANT. 4. RE-INSTALL WIRELESS DEVICES AND PROVIDE REQUIRED TESTING, V PROVIDE A COMPLETE SYSTEM. 5. REFER TO STOCKDALE - COMMUNICATION EQUIPMENT / WORKS. 	CIATED WITH D. DEVICES FROM ENSURE THAT SPECIFIC NUMBER.	BATTE EQUA UNITS INDIC. THE C OF FL SWITC VOLT. REM 1. SIN REMC LUMA EXIT SINGE SIGN, BATT LUMA NOT BATT	TERY UNITS ERY UNIT SHALL BE L BY BENGELI OR LI S SHALL BE FOR OPI ATED ON THE DRAV CHARGER SHALL BE JLLY RECHARGING I CH LOAD ON AT POV AGE DISCONNECT F OTE HEADS 'EM GLE AND DOUBLE R DTE HEADS SHALL B CELL CAT.# MQM SE SIGN `X' LE FACE OR DOUBLL WHITE FINISH, 2W I ERY UNIT 80W. GELL CAT.# LSC SE ERY UNITS, REMOT	LUMACELL CAT.#RGS S UXNET. ERATION ON 120VAC VO VINGS. UNITS SHALL BE COMPLETELY AUTOMA DISCHARGED BATTERY I WER FAILURE AND OFF O FEATURE. 11' EEMOTE HEADS SHALL B E WHITE. ERIES OR APPROVED EC E FACE AS PER DRAWIN LED LAMPS, 120VAC, AN ERIES OR APPROVED EC
 NOTES RE. TO VOICE/DATA SYSTEM: VOICE/DATA SYSTEM SHALL BE PROVIDED BY THIS CONTRACTOR REFER TO FLOOR PLAN FOR EXACT LOCATION AND NUMBER OF DEVICES. VERIFY ON SITE FOR EXACT LOCATION OF VOICE/DATA PATCH PANELS PRIOR TO ROUGHING-IN. PROVIDE ALL VOICE/DATA DEVICES AS SHOWN ON DRAWINGS COMPLETE WITH REQUIRED CONDUIT/WIRING AND HOME RUN FROM INDIVIDUAL DEVICE TO EXISTING VOICE/DATA PATCH PANEL. CONTRACTOR SHALL VERIFY ON SITE TO PROVIDE REQUIRED MODIFICATION OR /AND NEW EQUIPMENT TO SUIT NEW LAYOUT. 	 REFER TO FLOOR PLAN FOR EXACT LOCATION AND NUMBER OF DEVIC SPEAKERS SHOWN ON NEW LAYOUT SHALL BE NEW. VERIFY ON SITE FOR EXACT LOCATION OF P.A. PANEL PRIOR TO ROUG PROVIDE ALL P.A. DEVICES AS SHOWN ON DRAWINGS COMPLETE WITH CONDUIT/WIRING AND HOME RUN FROM INDIVIDUAL DEVICE TO EXIST CONTRACTOR SHALL VERIFY ON SITE TO PROVIDE REQUIRED MODIFIC NEW EQUIPMENT TO SUIT NEW LAYOUT. 	HING-IN. I REQUIRED NG P.A. PANEL. CATION OR /AND		S 1 FLUSH WALL SENSOR SWI - AUTO-ON W - FITS A STAH - ADJUSTABL - IVORY FINIS - ADJUSTABL 200 FOOT C - 5 YEAR WAI	MOUNTED ULTRASONIC ITCH: /ITH MANUAL OFF SWITC NDARD SWITCH BOX WIT E TIME DELAY BETWEE SH. E INTEGRATED NATURA ANDLES. RRANTY.
	 VOICE/DATA SYSTEM SHALL BE PROVIDED BY THIS CONTRACTOR REFER TO FLOOR PLAN FOR EXACT LOCATION AND NUMBER OF DEVICE VERIFY ON SITE FOR EXACT LOCATION OF VOICE/DATA PATCH PANELS ROUGHING-IN. PROVIDE ALL VOICE/DATA DEVICES AS SHOWN ON DRAWINGS COMPLE CONDUIT/WIRING AND HOME RUN FROM INDIVIDUAL DEVICE TO EXISTING VOICE/DATA PATCH PANEL. CONTRACTOR SHALL VERIFY ON SITE TO PROVIDE REQUIRED MODIFIC/ EQUIPMENT TO SUIT NEW LAYOUT. 	PRIOR TO TE WITH REQUIRED		ADJUST SE PREVENT SE AND SLAVI SLAVE PAC ADJUST LI ADJUST TI LOCATE PC ACCESS. FINAL LOC CLOSE PR ALLOW IN DIRECTIVE	SENSORS FROM "SEEIN EXCEPTION OF TYPE 1 S E PACKS TO CONTROLL CKS. GHT LEVEL SENSORS TO ME DELAY TO 30 MINUTI OWER PACKS/SLAVE PA ATIONS OF SENSORS SI OXIMITY TO DIFFUSERS CONTRACT LABOUR TO S.
			1 E-101	TYPICA SCALE: N.T.S.	L POWER,

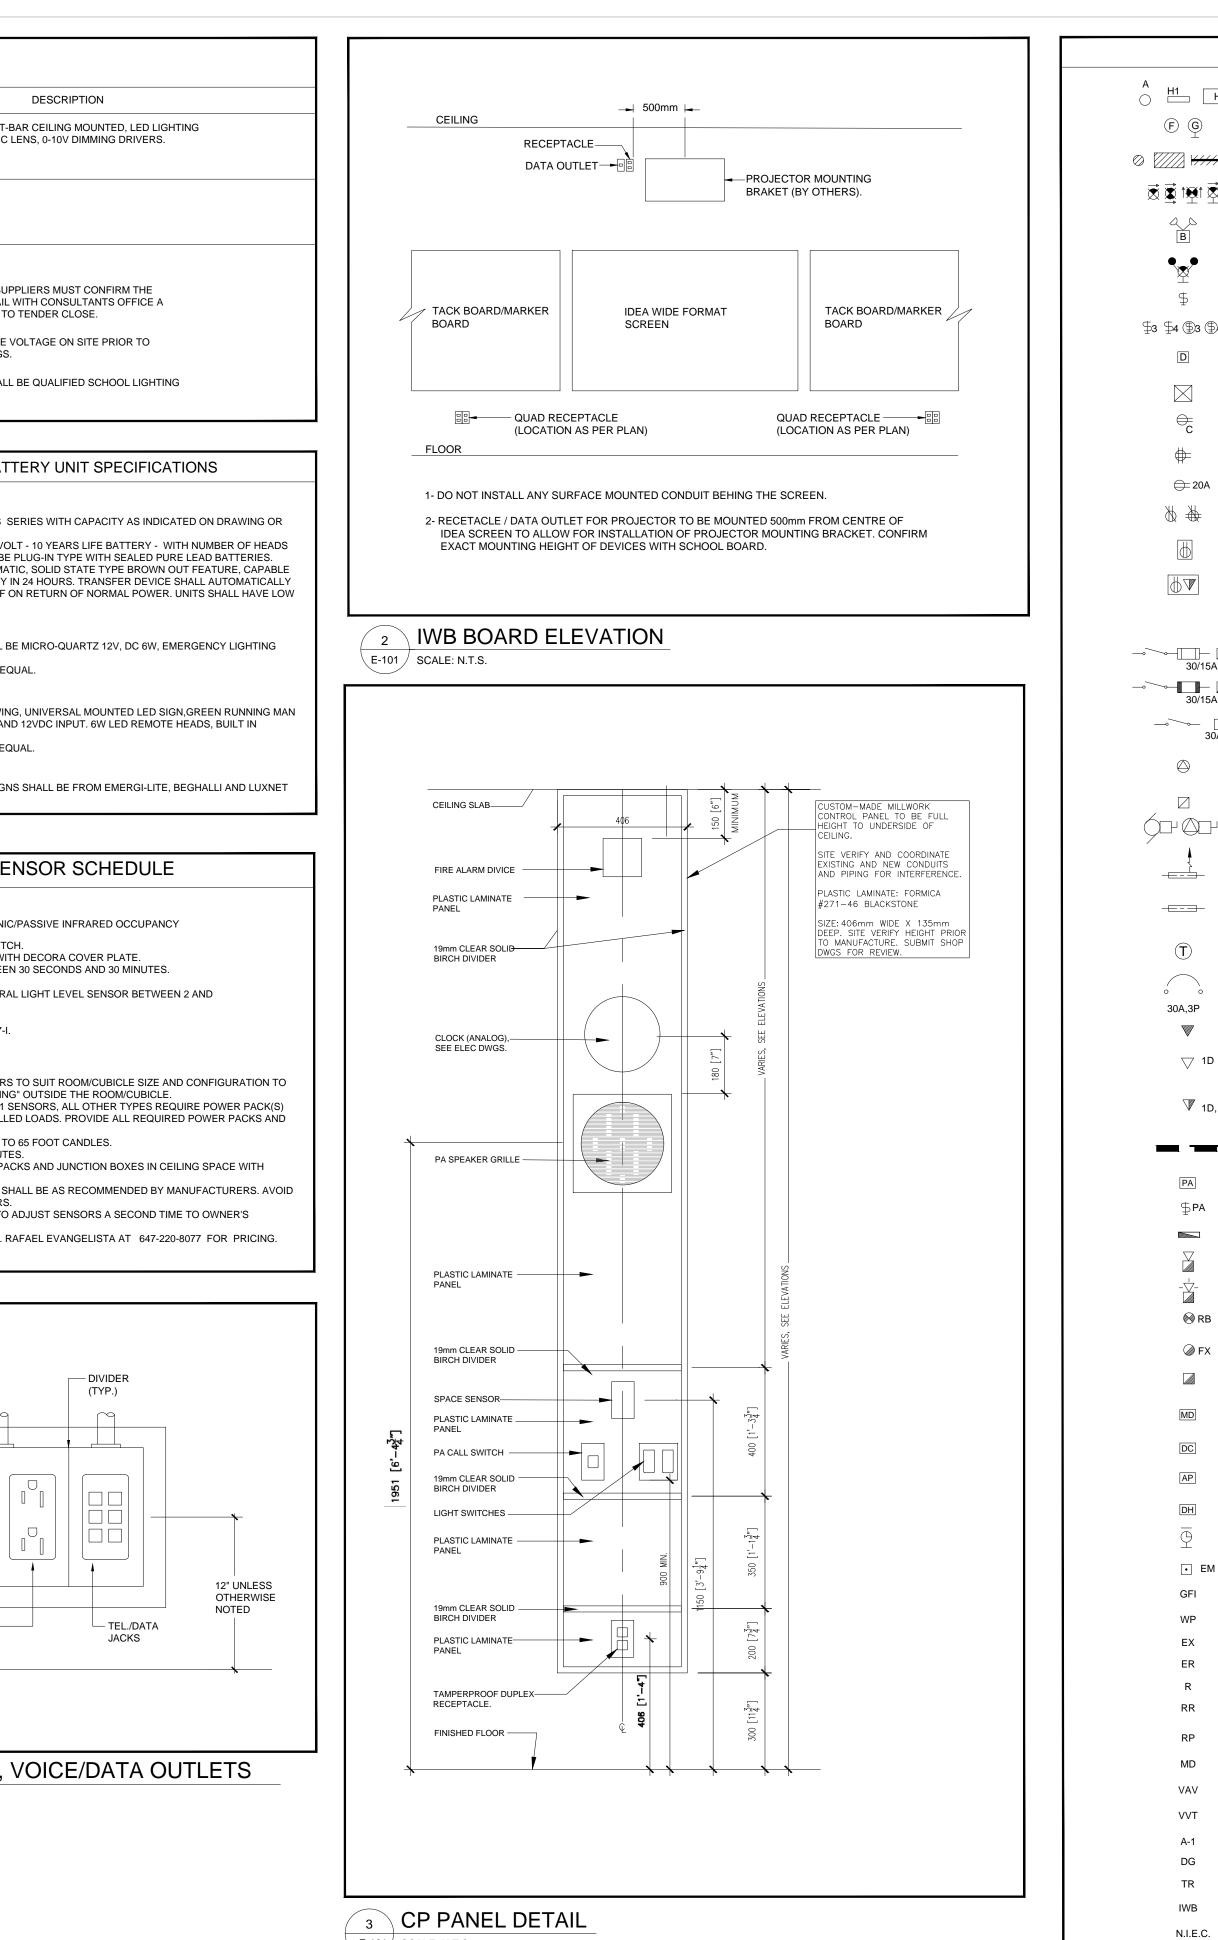



E-101 SCALE: N.T.S.

			THE	JRNED ON REQUES	ST. LL CHECK ALL DI		AND MUST BE
	LEGEND		DISC ALL [REPANCIES TO THI	E ARCHITECT.		HERWISE INDICATED.
			DO N	IOT SCALE DRAWIN	IGS.		
	LUMINAIRES TYPES AS INDICATED CEILING OR WALL MOUNTED LIGHTING FIXTURE RESPECTIVELY. LETTERS DENOTES TYPE AS PER FIXTURE SCHEDULE.		No. 01	REVI Date 12/MAR/2024		Note	ILOG
	SAME AS ABOVE, BUT CONNECTED TO NIGHT LIGHT CIRCUIT.						
	CEILING WALL MOUNTED MOUNTED EXIT LIGHT. FACE AS INDICATED BY FILLED IN PORTIONS, WITH ARROW INDICATING DIRECTION.						
	EMERGENCY BATTERY UNIT WITH REMOTE HEADS. SEE SPECIFICATIONS.						
	COMBINATION EXIT SIGN & REMOTE HEADS UNIT. SEE SPECIFICATION.						
	120V, SINGLE POLE LIGHT SWITCH.						
	SAME AS ABOVE, BUT 3-WAY OR 4-WAY.						
	DIMMER TO SUIT TYPE OF LAMP, BALLAST, LOAD & TRANSFORMER LUTRON NOVA "T" SERIES.						
	ELECTRICAL TRANSFORMER, AS INDICATED.						
	15A, 125V, FLUSH MOUNTED, DUPLEX RECEPTACLE, "C" DENOTES CEILING						
	MOUNTED CORD-REEL. 15A, 125V, FLUSH MOUNTED, QUAD RECEPTACLE.						
	SAME AS ABOVE AND C/W CSA CONFIGURATION 5-20R (15A/20A T-SLOT).						
	SAME AS RECEPTACLES ABOVE BUT MOUNTED ABOVE COUNTER						
	OR AT 42" AFF. RECEPTACLE IN FS BOX CEILING SLAB.						
	FLOOR BOX C/W RECEPTACLE AND TEL./DATA OUTLETS AS SPECIFIED.						
	TEOR BOX OW RECEPTAGE AND TELIDATA COTLETS AS SECONED.						
_	PUSHBUTTON AS NOTED.						
子 3P	FUSED DISCONNECT SWITCH, SIZE AS NOTED.						
3P	SAME AS ABOVE, BUT C/W TIME DELAY FUSES.						
) , 3P	UNFUSED DISCONNECT SWITCH, SIZE AS NOTED.						
	ELECTRICAL OUTLET (DIRECT CONNECTION). VOLTAGE AND PHASES AS INDICATED.						
	STARTERS MECHANICAL EQUIPMENT CONNECTION AS INDICATED						
	FORCED FLOW HEATER C/W BUILT-IN THERMOSTAT, VOLTAGE & WATTAGE AS NOTED.						
	BASEBOARD HEATER C/W BUILT-IN THERMOSTAT, VOLTAGE & WATTAGE AS NOTED.						
	THERMOSTAT						
	CIRCUIT BREAKER. SIZE AS NOTED						
	VOICE OUTLET, WALL MOUNTED. PROVIDE CONDUIT AND CABLING TO LAN						
	ROOM (TO OUT GOING TELEPHONE ROOM). SEE SPECIFICATION. DATA OUTLET, WALL MOUNTED. PROVIDE CONDUIT & CABLING TO LAN ROOM. SEE SPECIFICATION. '1V' DENOTES ONE VOICE DROP.						
V	COMBINATION DATA/VOICE OUTLET, WALL MOUNTED. PROVIDE CONDUIT & CABLING TO SERVER ROOM. '1V' DENOTES ONE VOICE DROP. '2D' DENOTES TWO DATA DROP.						
	ELECTRICAL PANELS, SURFACE OR RECESSED MOUNTED RESPECTIVELY AS SHOWN.						
	P.A. SPEAKER REFER TO SPECIFICATIONS						
	P.A. CALL SWITCH						
	FIRE ALARM HORN FIRE ALARM STROBE LIGHT						
	FIRE ALARM SMOKE DETECTOR, `RB' DENOTES C/W RELAY BASE.						
	FIRE ALARM HEAT DETECTOR, `FX' DENOTES FIXED TEMPERATURE.						
	FIRE ALARM PULL STATION			de		HAMMERS	CHLAG & JOFFE INC
	SECURITY OUTLET, MOTION DETECTOR.			SR			smill Road, Toronto, Ontar
	SECURITY SYSTEM DOOR CONTACT		1	in the second		Cana T: (41	da M3B 2T8 6) 444.9263 6) 444.1463
	WIRELESS OUTLET, C/W BACK BOX AND CONDUIT TO LAN			AWARTHA PINE I			g@hamjof.com
	ROOM, C/W CAT6 CABLE.				and a second second		
	CLOCK			ANTINIA			ROFESSIONAL
	RED, MUSHROOM TYPE EMERGENCY PUSH BUTTON.					LICENSED	B.J. BELL REF
	DENOTES GROUND FAULT INTERRUPTER				\mathbb{Y}		09.FEB.2024
	WATER PROOF				/	1.20	NCE OF ONTAR
	EXISTING TO REMAIN EXISTING TO BE RELOCATED.			+.			
	EXISTING TO BE REMOVED		^{rojec}	["] MS F	IAWK	INS S	R.PS
	EXISTING ELECTRICAL EQUIPMENT TO BE REMOVED FOR RELATED WORKS AND REINSTALLED.	С	LA	SSROOMS			
	EXISTING IN RELOCATED POSITION.			OVATION ARTHA PIN			
						אופועאוניו	SCHOOL BOARD
	VARIABLE AIR VOLUME CONTROL			HIGHLAN RT HOPE	D DRIVE		ONTARIC
	PANEL "A", CIRCUIT "1"			ng Title:			
	DENOTES DEDICATED GROUND			-	TRICA	L - LEG	END &
				DRAV	VING L	IST & M	NOTES
	INTERACTIVE WHITEBOARD	D	Irawn	By: Check	ed By: Date	Checked:	Project No.
	NOT IN THIS ELECTRICAL CONTRACT		Μ	T Q			24-018-00
				Plotted: 13, 2024 -	9·20am		Scale: AS NOTED
		I N	/10-				- AO NOTE

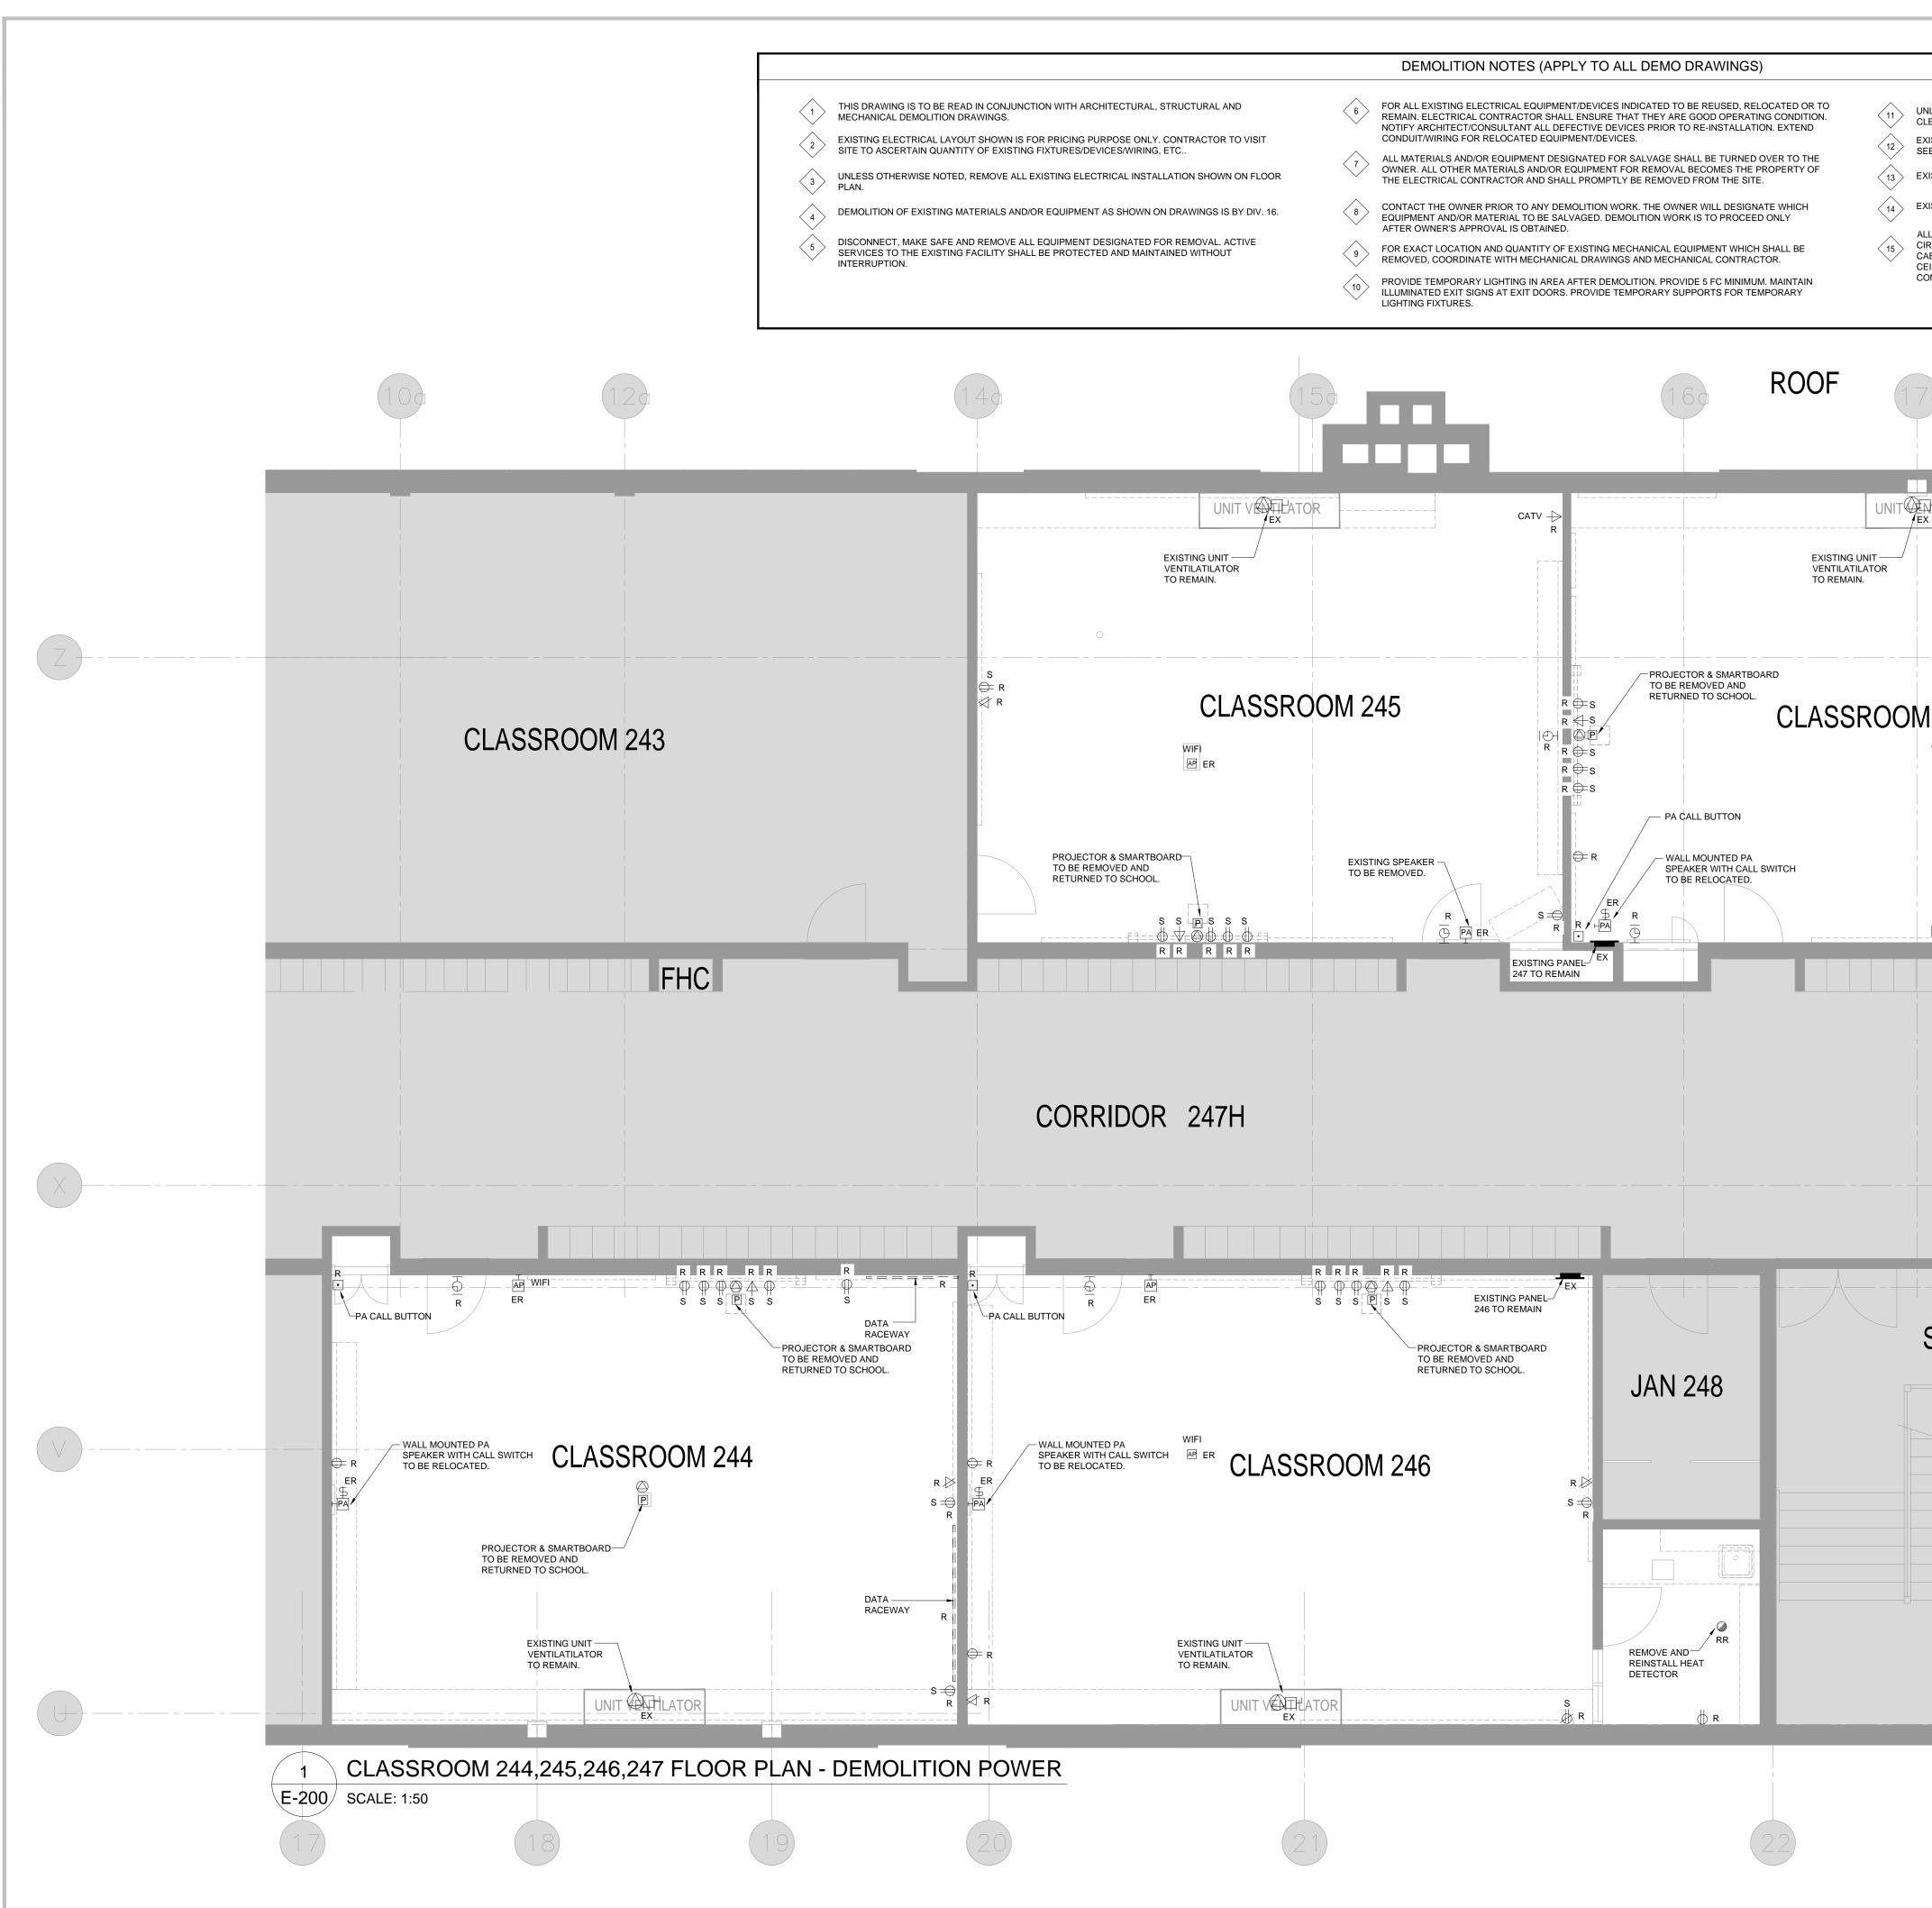

		ALL DRAWINGS ARE THE PROPERTY OF THE ARCHITECT AND MUST BE RETURNED ON REQUEST. THE CONTRACTOR SHALL CHECK ALL DIMENSIONS AND REPORT DISCREPANCIES TO THE ARCHITECT. ALL DIMENSIONS ARE GIVEN IN MILLIMETRES UNLESS OTHERWISE INDICATED. DO NOT SCALE DRAWINGS.
ED UP REWIRE THEM IN COI NG LIGHT SWITCH TO BE RE W LAYOUT.	XISTING LOOSE BX CABLES WITHIN CEILING SPACE SHALL NDUITS AND PAINTED TO MATCH EXPOSED CEILING FINISH PLACED WITH NEW ONE AND INSTALL IN CONTROL PANEL. RELOCATED TO CONTROL PANEL.	REVISIONS AND DISTRIBUTION LOG
STING CONDUITS / WIRING , LIGHTING CIRCUIT, VOICE ETC WITHIN EXISTING CE , IN CEILING SPACE BETWE	E RELOCATED TO CONTROL PANEL. AND JUNCTION BOXES INCLUDING FIRE ALARM, RECEPTA E / DATA CABLES, PA CABLES, WI-FI CABLES, LOW VOLTAGE LING SPACE, SHALL BE RELOCATED TO BELOW FIRE RATE EEN NEW FIRE RATED CEILING AND NEW T-BAR CEILING. EX . PROVIDE NEW JUNCTION BOXES.	E D D D D D D D D D D D D D D D D D D D
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TOR		
47	 H8F	
ER	CORRIDOR 248H	
	FEMALE W.R	HAMMERSCHLAG & JOFFE INC. 43 Lesmil Road, Toronto, Ontari Canada M3B 2T8 T: (416) 444.9263 F: (416) 444.1463 E: dwg@hamjof.com
		PROFESSIONAL BJ. BELL BJ. BELL BJ. BELL BJ. C. C. BJ. BELL BJ. C. C. BJ. C. C. B. C. C. C. C. C. C. C. C. C. C. C. C. C. C. C. C. C. C
		Project: DR MS HAWKINS SR.PS CLASSROOMS 233-235-244-245-246-247 RENOVATION KAWARTHA PINE RIDGE DISTRICT SCHOOL BOARD 130 HIGHLAND DRIVE PORT HOPE ONTARIO
		Drawing Title: ELECTRICAL - SECOND FLOOR CLASSROOM - DEMOLITION POWER
	23	Drawn By: Checked By: Date Checked: Project No. MT QV Date Checked: Project No. Date Plotted: Scale: Scale: Mar 13, 2024 - 9:20am AS NOTED Drawing No.: Revision No.:
		E-200

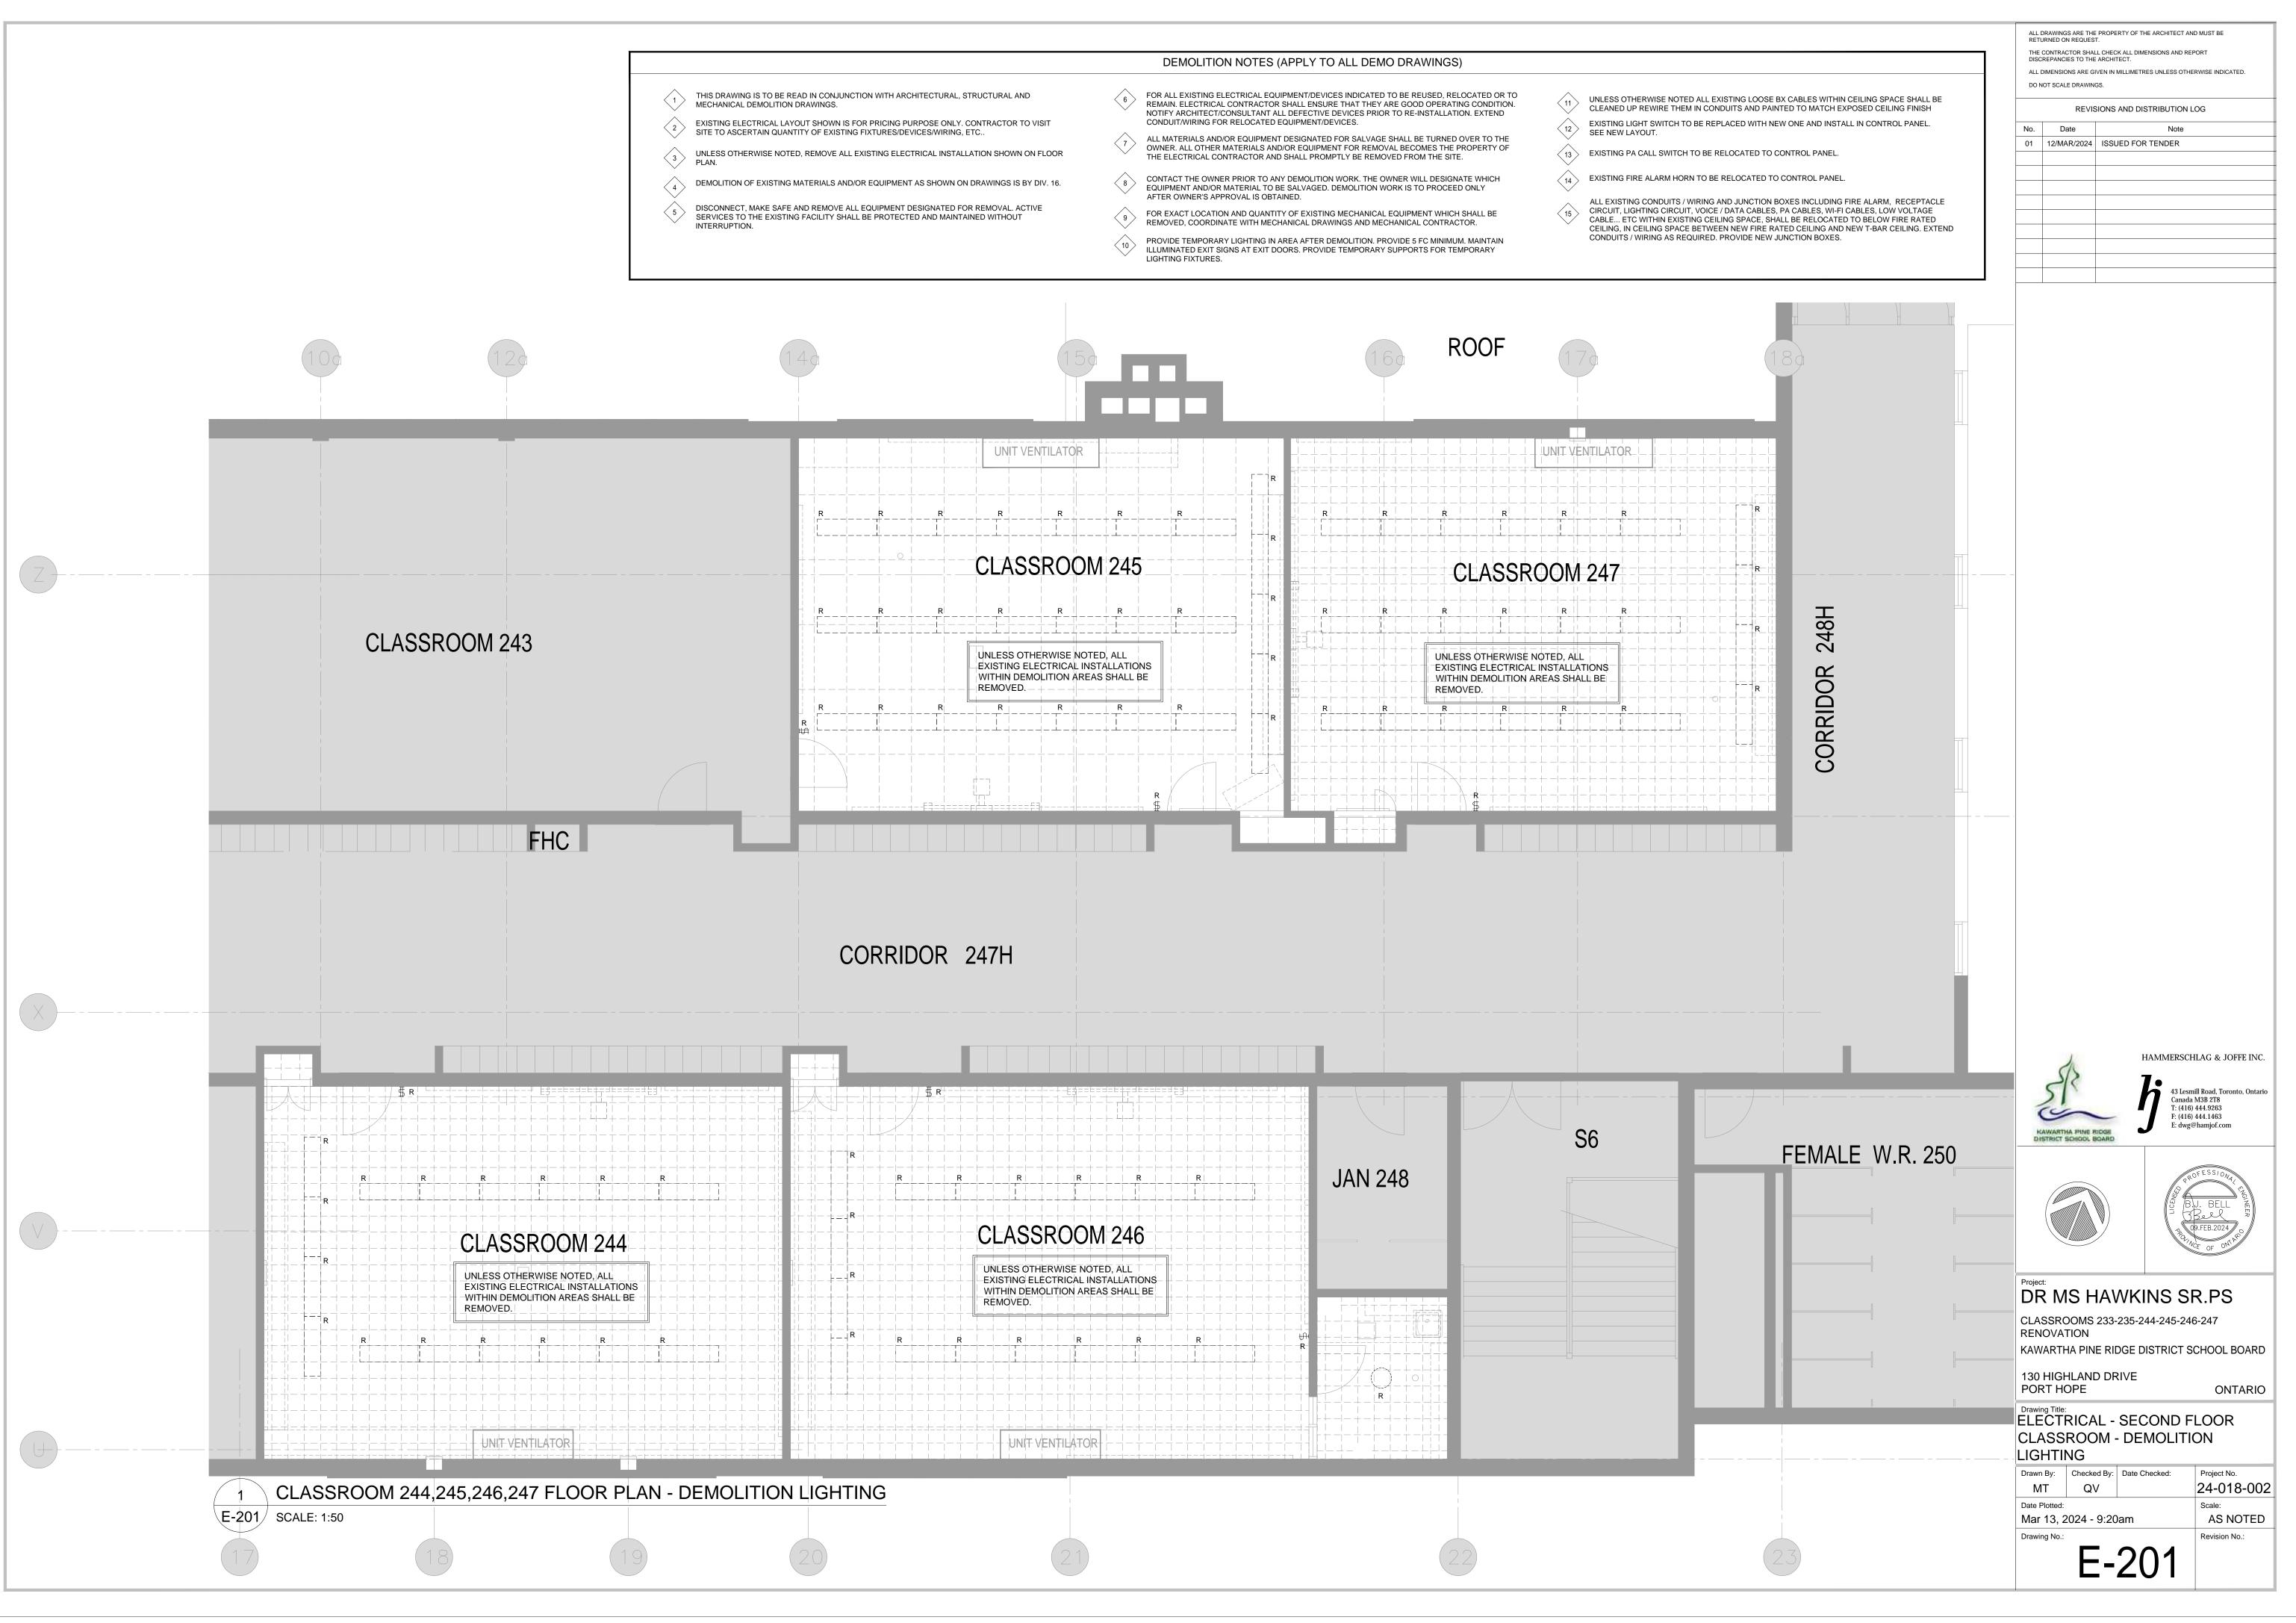

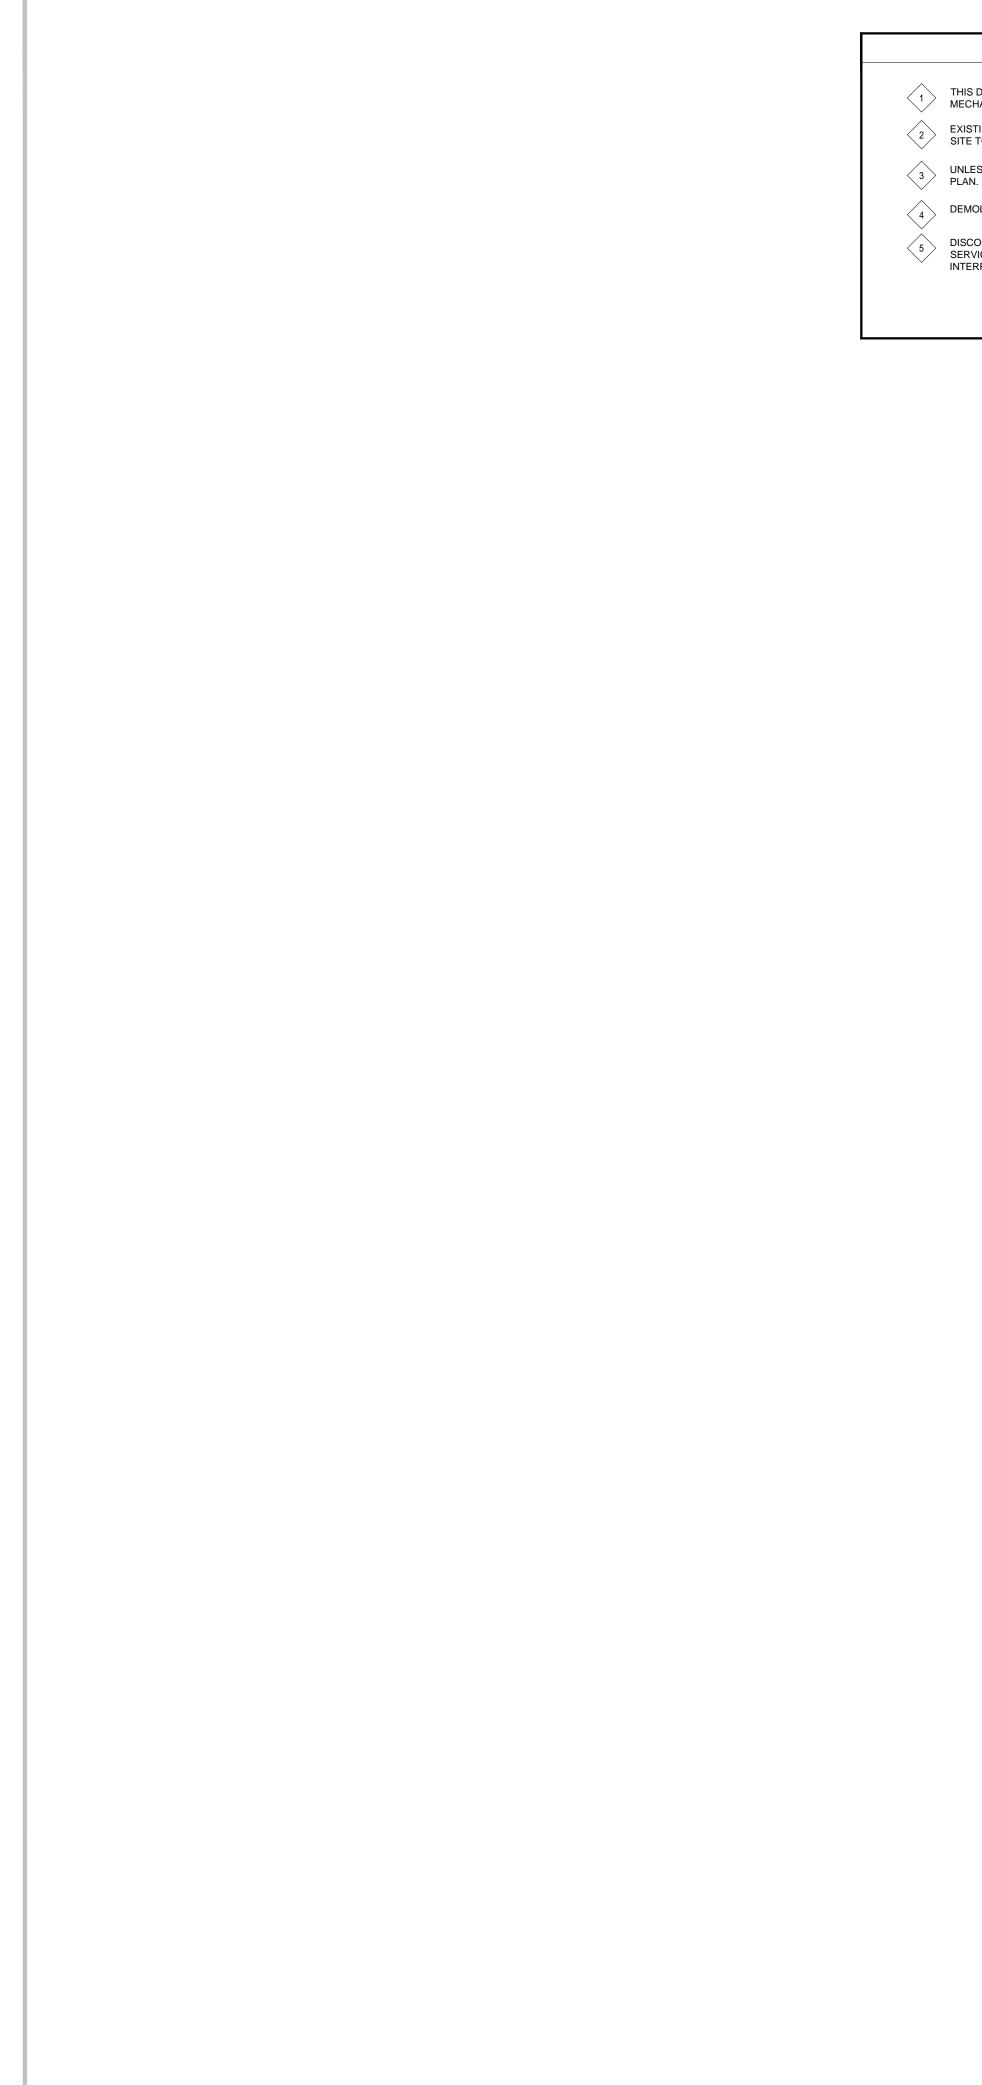

THIS DRAWING IS TO BE READ IN CONJUNCTION WITH ARCHITECTURAL, STRUCTURAL AND MECHANICAL DEMOLITION DRAWINGS. EXISTING ELECTRICAL LAYOUT SHOWN IS FOR PRICING PURPOSE ONLY. CONTRACTOR TO VISIT SITE TO ASCERTAIN QUANTITY OF EXISTING FIXTURES/DEVICES/WIRING, ETC.. UNLESS OTHERWISE NOTED, REMOVE ALL EXISTING ELECTRICAL INSTALLATION SHOWN ON FLOOR 4 DEMOLITION OF EXISTING MATERIALS AND/OR EQUIPMENT AS SHOWN ON DRAWINGS IS BY DIV. 16. DISCONNECT, MAKE SAFE AND REMOVE ALL EQUIPMENT DESIGNATED FOR REMOVAL. ACTIVE SERVICES TO THE EXISTING FACILITY SHALL BE PROTECTED AND MAINTAINED WITHOUT INTERRUPTION.

DEMOLITION NOTES (APPLY TO ALL DEMO DRAWINGS)

FOR ALL EXISTING ELECTRICAL EQUIPMENT/DEVICES INDICATED TO BE REUSED, RELOCATED OR TO

< 11

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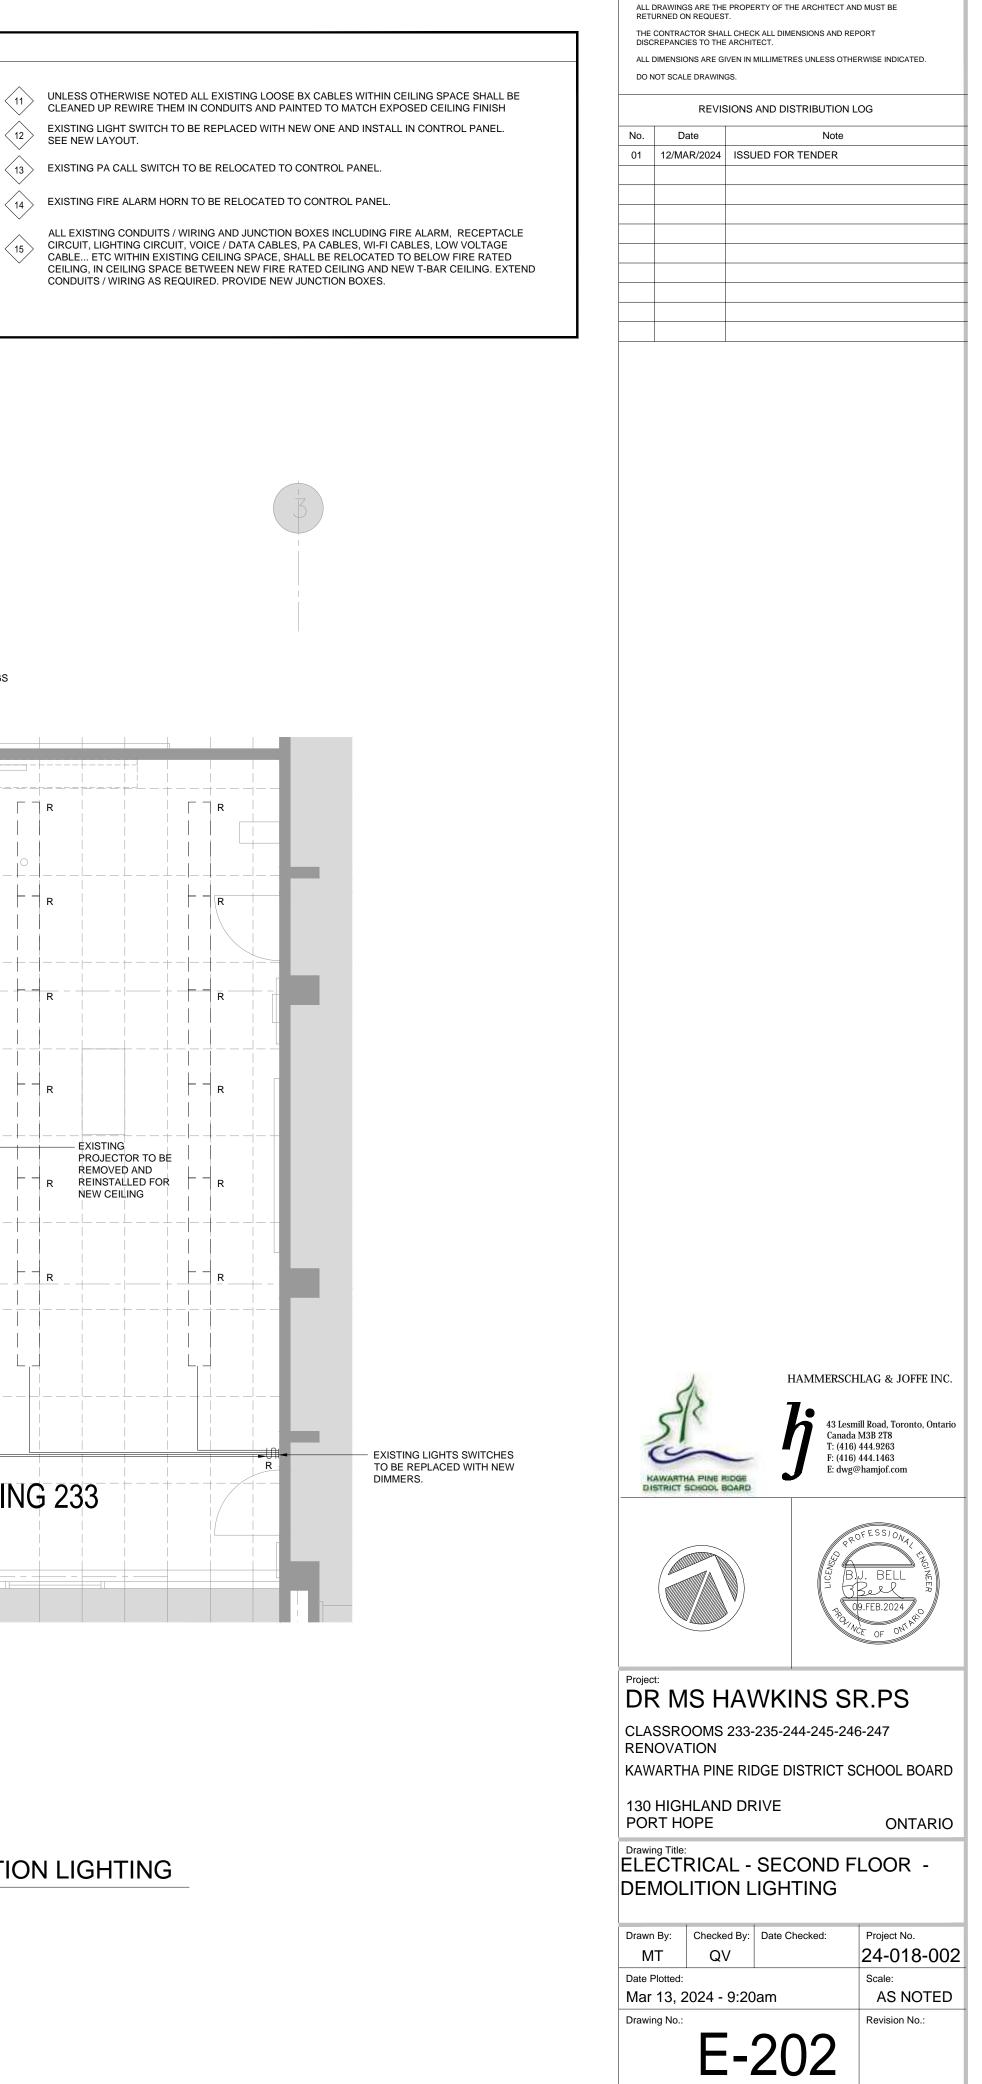
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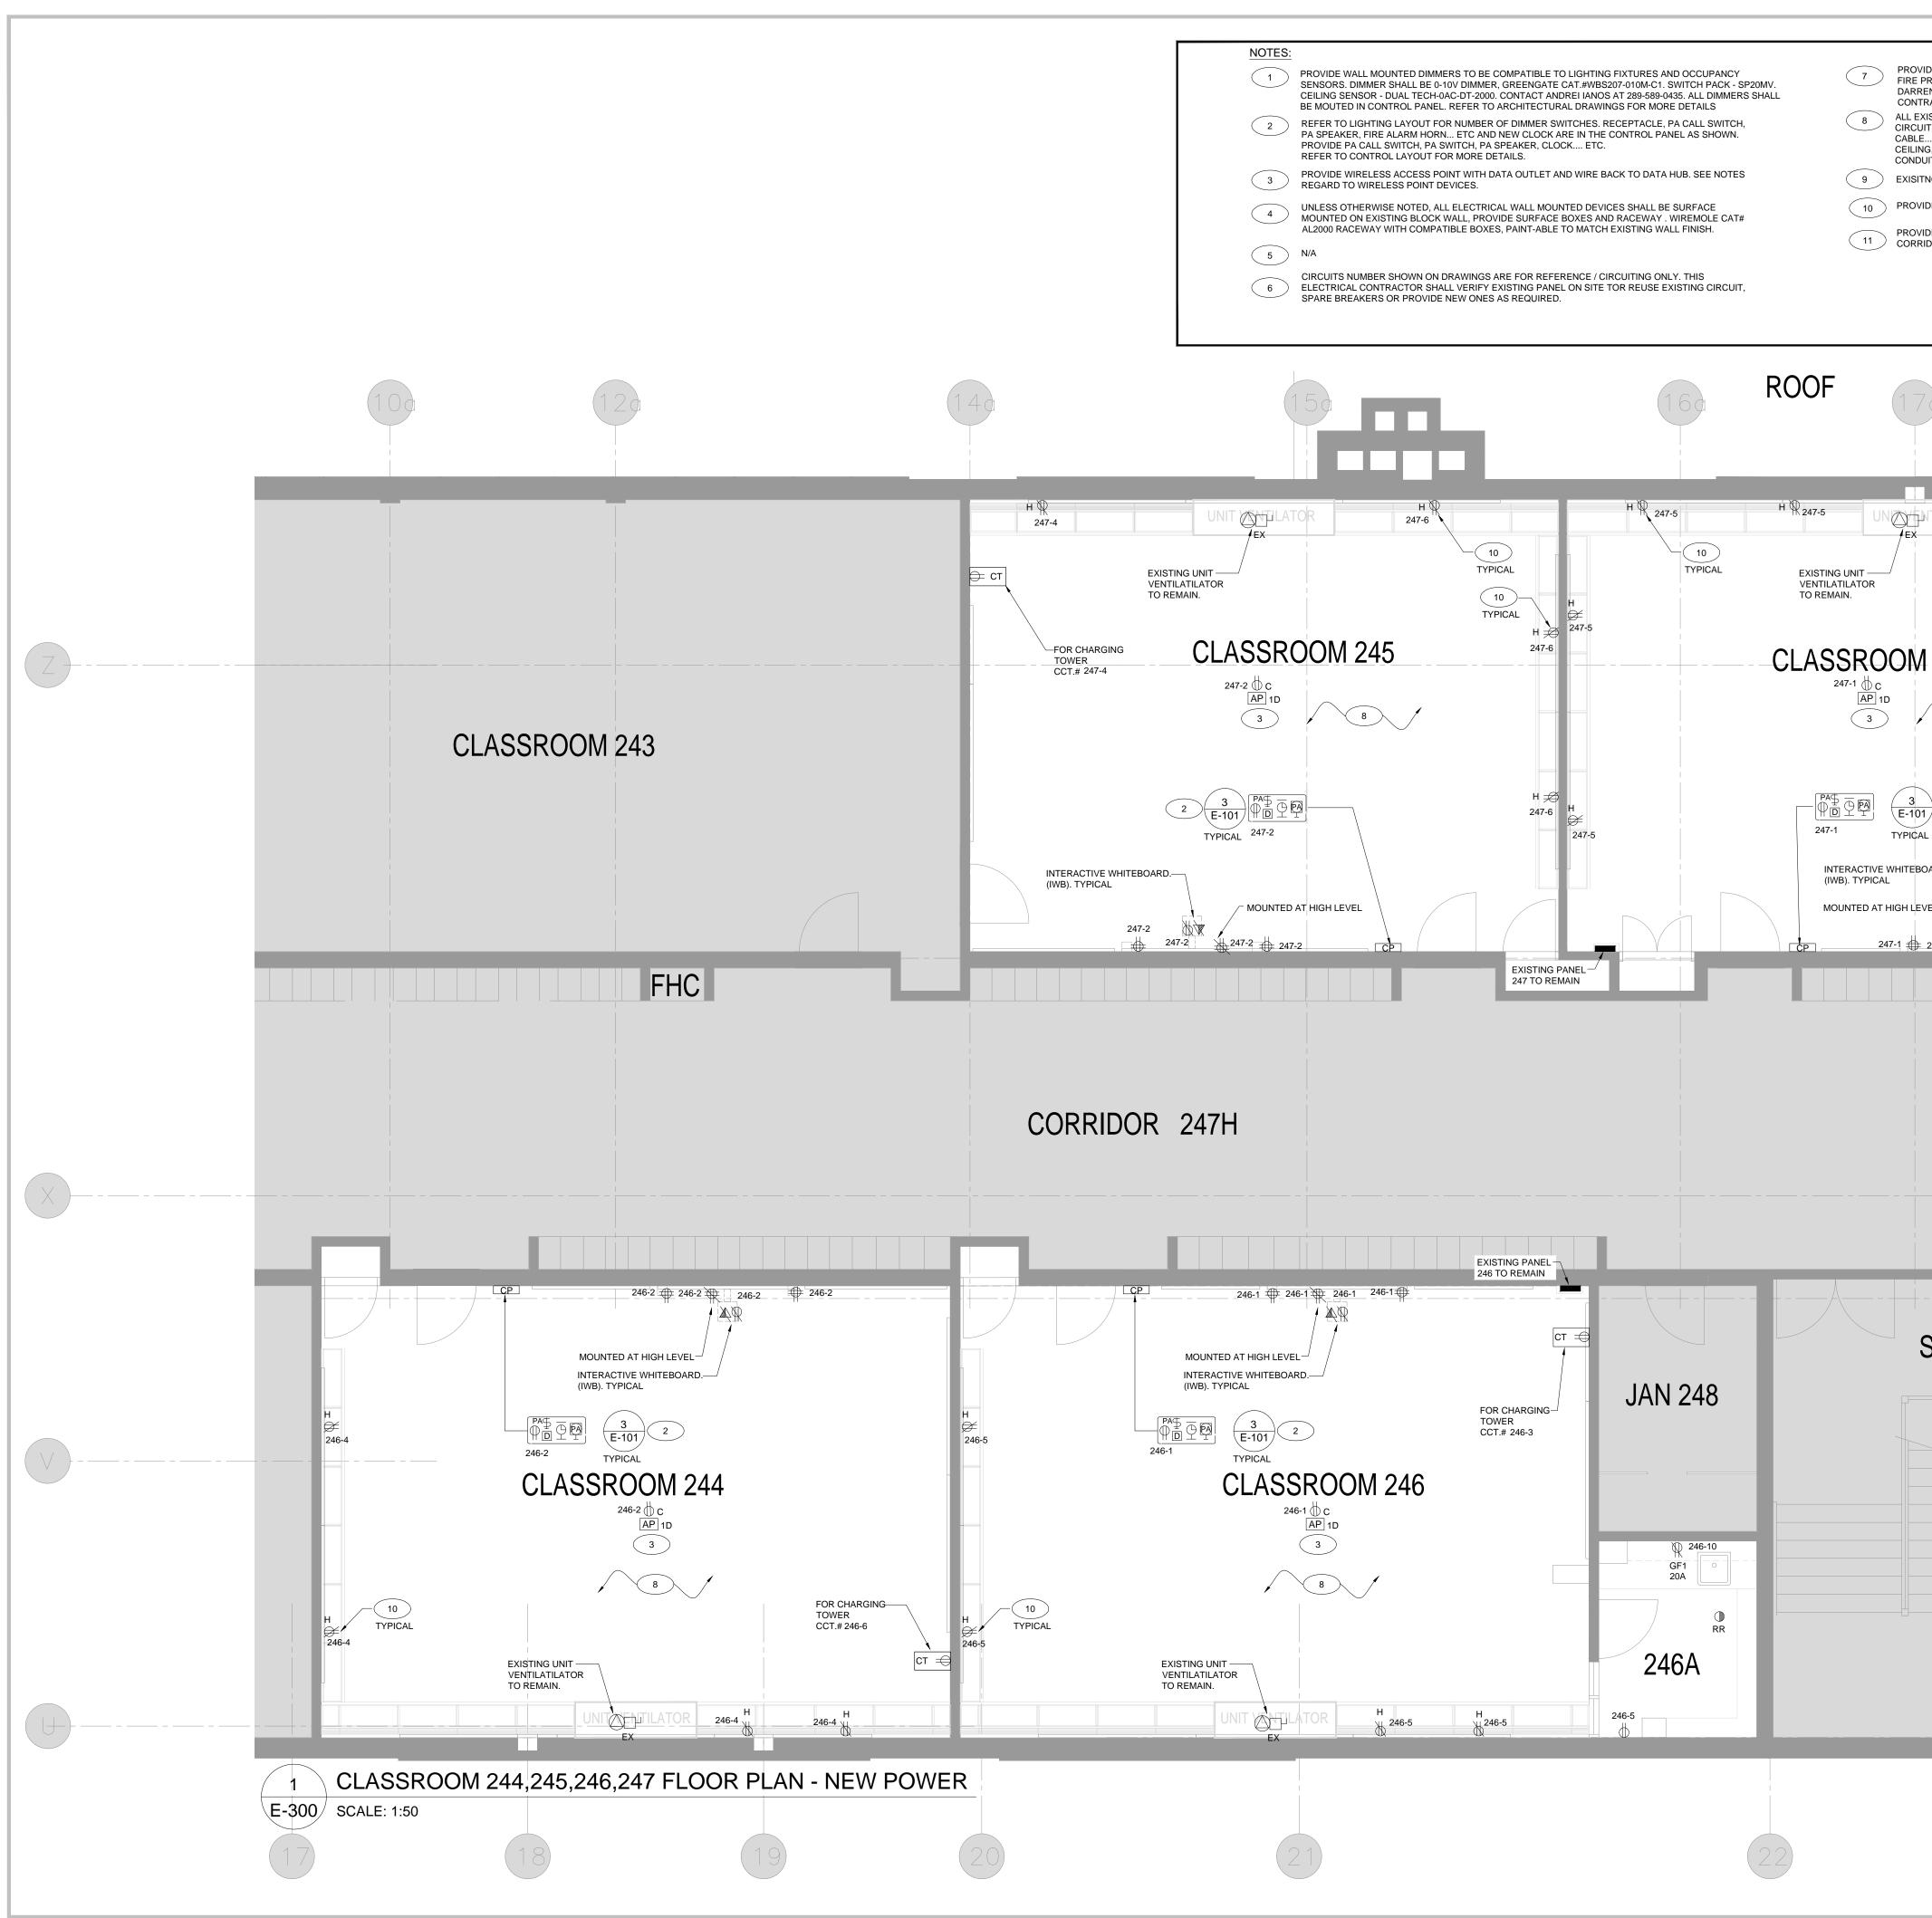
- $\langle 6$ REMAIN. ELECTRICAL CONTRACTOR SHALL ENSURE THAT THEY ARE GOOD OPERATING CONDITION. NOTIFY ARCHITECT/CONSULTANT ALL DEFECTIVE DEVICES PRIOR TO RE-INSTALLATION. EXTEND CONDUIT/WIRING FOR RELOCATED EQUIPMENT/DEVICES.
- ALL MATERIALS AND/OR EQUIPMENT DESIGNATED FOR SALVAGE SHALL BE TURNED OVER TO THE OWNER. ALL OTHER MATERIALS AND/OR EQUIPMENT FOR REMOVAL BECOMES THE PROPERTY OF <7> THE ELECTRICAL CONTRACTOR AND SHALL PROMPTLY BE REMOVED FROM THE SITE.
- 8 CONTACT THE OWNER PRIOR TO ANY DEMOLITION WORK. THE OWNER WILL DESIGNATE WHICH
- EQUIPMENT AND/OR MATERIAL TO BE SALVAGED. DEMOLITION WORK IS TO PROCEED ONLY AFTER OWNER'S APPROVAL IS OBTAINED.
- FOR EXACT LOCATION AND QUANTITY OF EXISTING MECHANICAL EQUIPMENT WHICH SHALL BE 9 REMOVED, COORDINATE WITH MECHANICAL DRAWINGS AND MECHANICAL CONTRACTOR. PROVIDE TEMPORARY LIGHTING IN AREA AFTER DEMOLITION. PROVIDE 5 FC MINIMUM. MAINTAIN < 10 ILLUMINATED EXIT SIGNS AT EXIT DOORS. PROVIDE TEMPORARY SUPPORTS FOR TEMPORARY


LIGHTING FIXTURES.


- EXISTING CONDUIT / WIRINGS AND JUNCTION BOXES ARE EXISTING TO REMAIN. NOTE #15 IS NOT APPLICABLE. R ⊢ ⊣ R - - R | R $- \vdash - + - +$ +-+-|-R R R ⊢ ∣ R _____ R R **PROGRAMMING 233**

> PROGRAMMING 233 - DEMOLITION LIGHTING Í 1 🔿 E-202 SCALE: 1:50






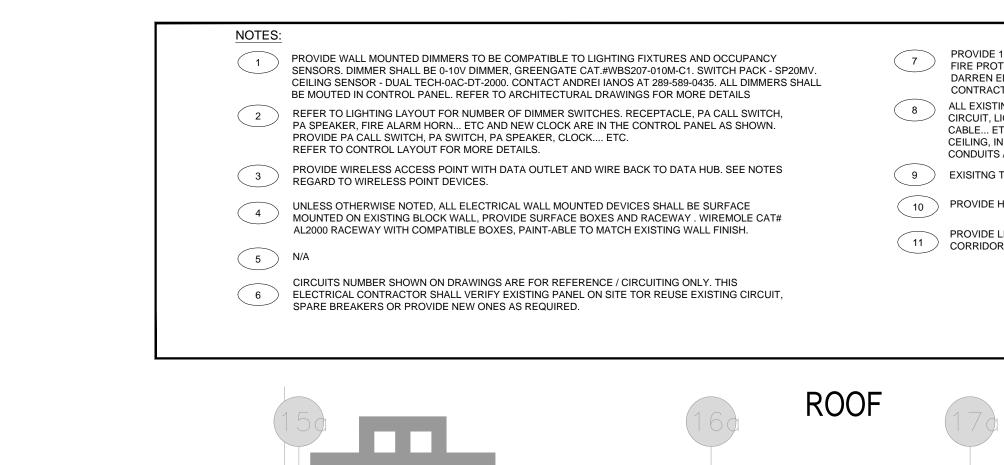


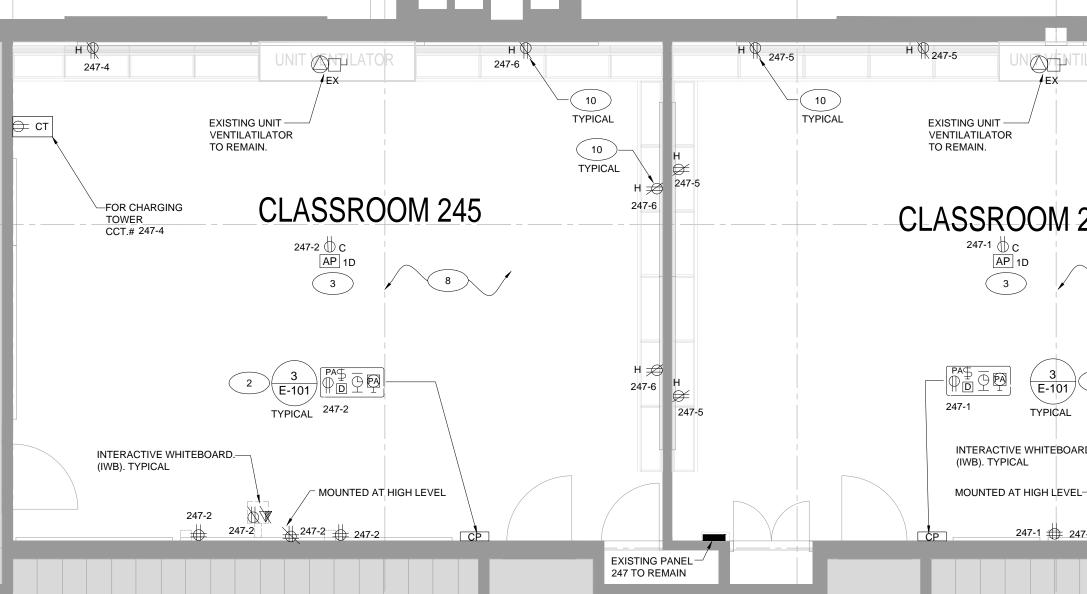



HOUR FIRE RATED PROTECTION FOR ALL FIXTURES IN CLASSROOM AS SHOWN, TENMAT TECTION SOLUTION CAT.#FF130-2'X4' UL FIRE RATED TROFFER COVER. CONTACT MR, DWARDS AT 613-799-9216. TOR MUST PROVIDE COORDINATION ON SITE WITH CEILING SUB-TRADE FOR INSTALATION. NG CONDUITS / WIRING AND JUNCTION BOXES INCLUDING FIRE ALARM, RECEPTACLE GHTING CIRCUIT, VOICE / DATA CABLES, PA CABLES, WI-FI CABLES, LOW VOLTAGE 'C WITHIN EXISTING CEILING SPACE, SHALL BE RELOCATED TO BELOW FIRE RATED I CEILING SPACE BETWEEN NEW FIRE RATED CEILING AND NEW T-BAR CEILING. EXTEND / WIRING AS REQUIRED. PROVIDE NEW JUNCTION BOXES. TO REMAIN, UNLESS OTHERWISE NOTED. HORIZONTAL MOUNTING RECEPATCLE AT ABOVE THE CABINET AND UNDER TACK BOARD. ED EMERGENCY REMOTE HEADS AND CONNECT TO EXISTING AC/DC CIRCUITS IN THE to.	ALL DRAWINGS ARE THE PROPERTY OF THE ARCHITECT AND MUST BE RETURNED ON REQUEST. THE CONTRACTOR SHALL CHECK ALL DIMENSIONS AND REPORT DISCREPANCIES TO THE ARCHITECT. ALL DIMENSIONS ARE GIVEN IN MILLIMETRES UNLESS OTHERWISE INDICATED. DO NOT SCALE DRAWINGS. REVISIONS AND DISTRIBUTION LOG No. Date Note 01 12/MAR/2024 ISSUED FOR TENDER I Image: Colspan="2">Image: Colspan="2" Image: Colspan="2">Image: Colspan="2" Image: Colspan="2" Image: Colspan="2" Image: Colspan="2"
АТОК H 2 2473 СТ СТ РОК СНАКСИИСА- ССТ.#247.3 В В В В В В В В В В В В В	
FEMALE W.R. 250	HAMMERSCHLAG & JOFFE INC.
	Project: DR MS HAWKINS SR.PS CLASSROOMS 233-235-244-245-246-247 RENOVATION KAWARTHA PINE RIDGE DISTRICT SCHOOL BOARD 130 HIGHLAND DRIVE PORT HOPE ONTARIO Drawing Title: ELECTRICAL - SECOND FLOOR CLASSROOM NEW POWER LAYOUT Drawing Title: ELECTRICAL - SECOND FLOOR CLASSROOM NEW POWER LAYOUT Drawing Title: MT QV Date Plotted: Mar 13, 2024 - 9:20am Crawing No: Cala: Mar 13, 2024 - 9:20am Crawing No: CLASSROOM Revision No:

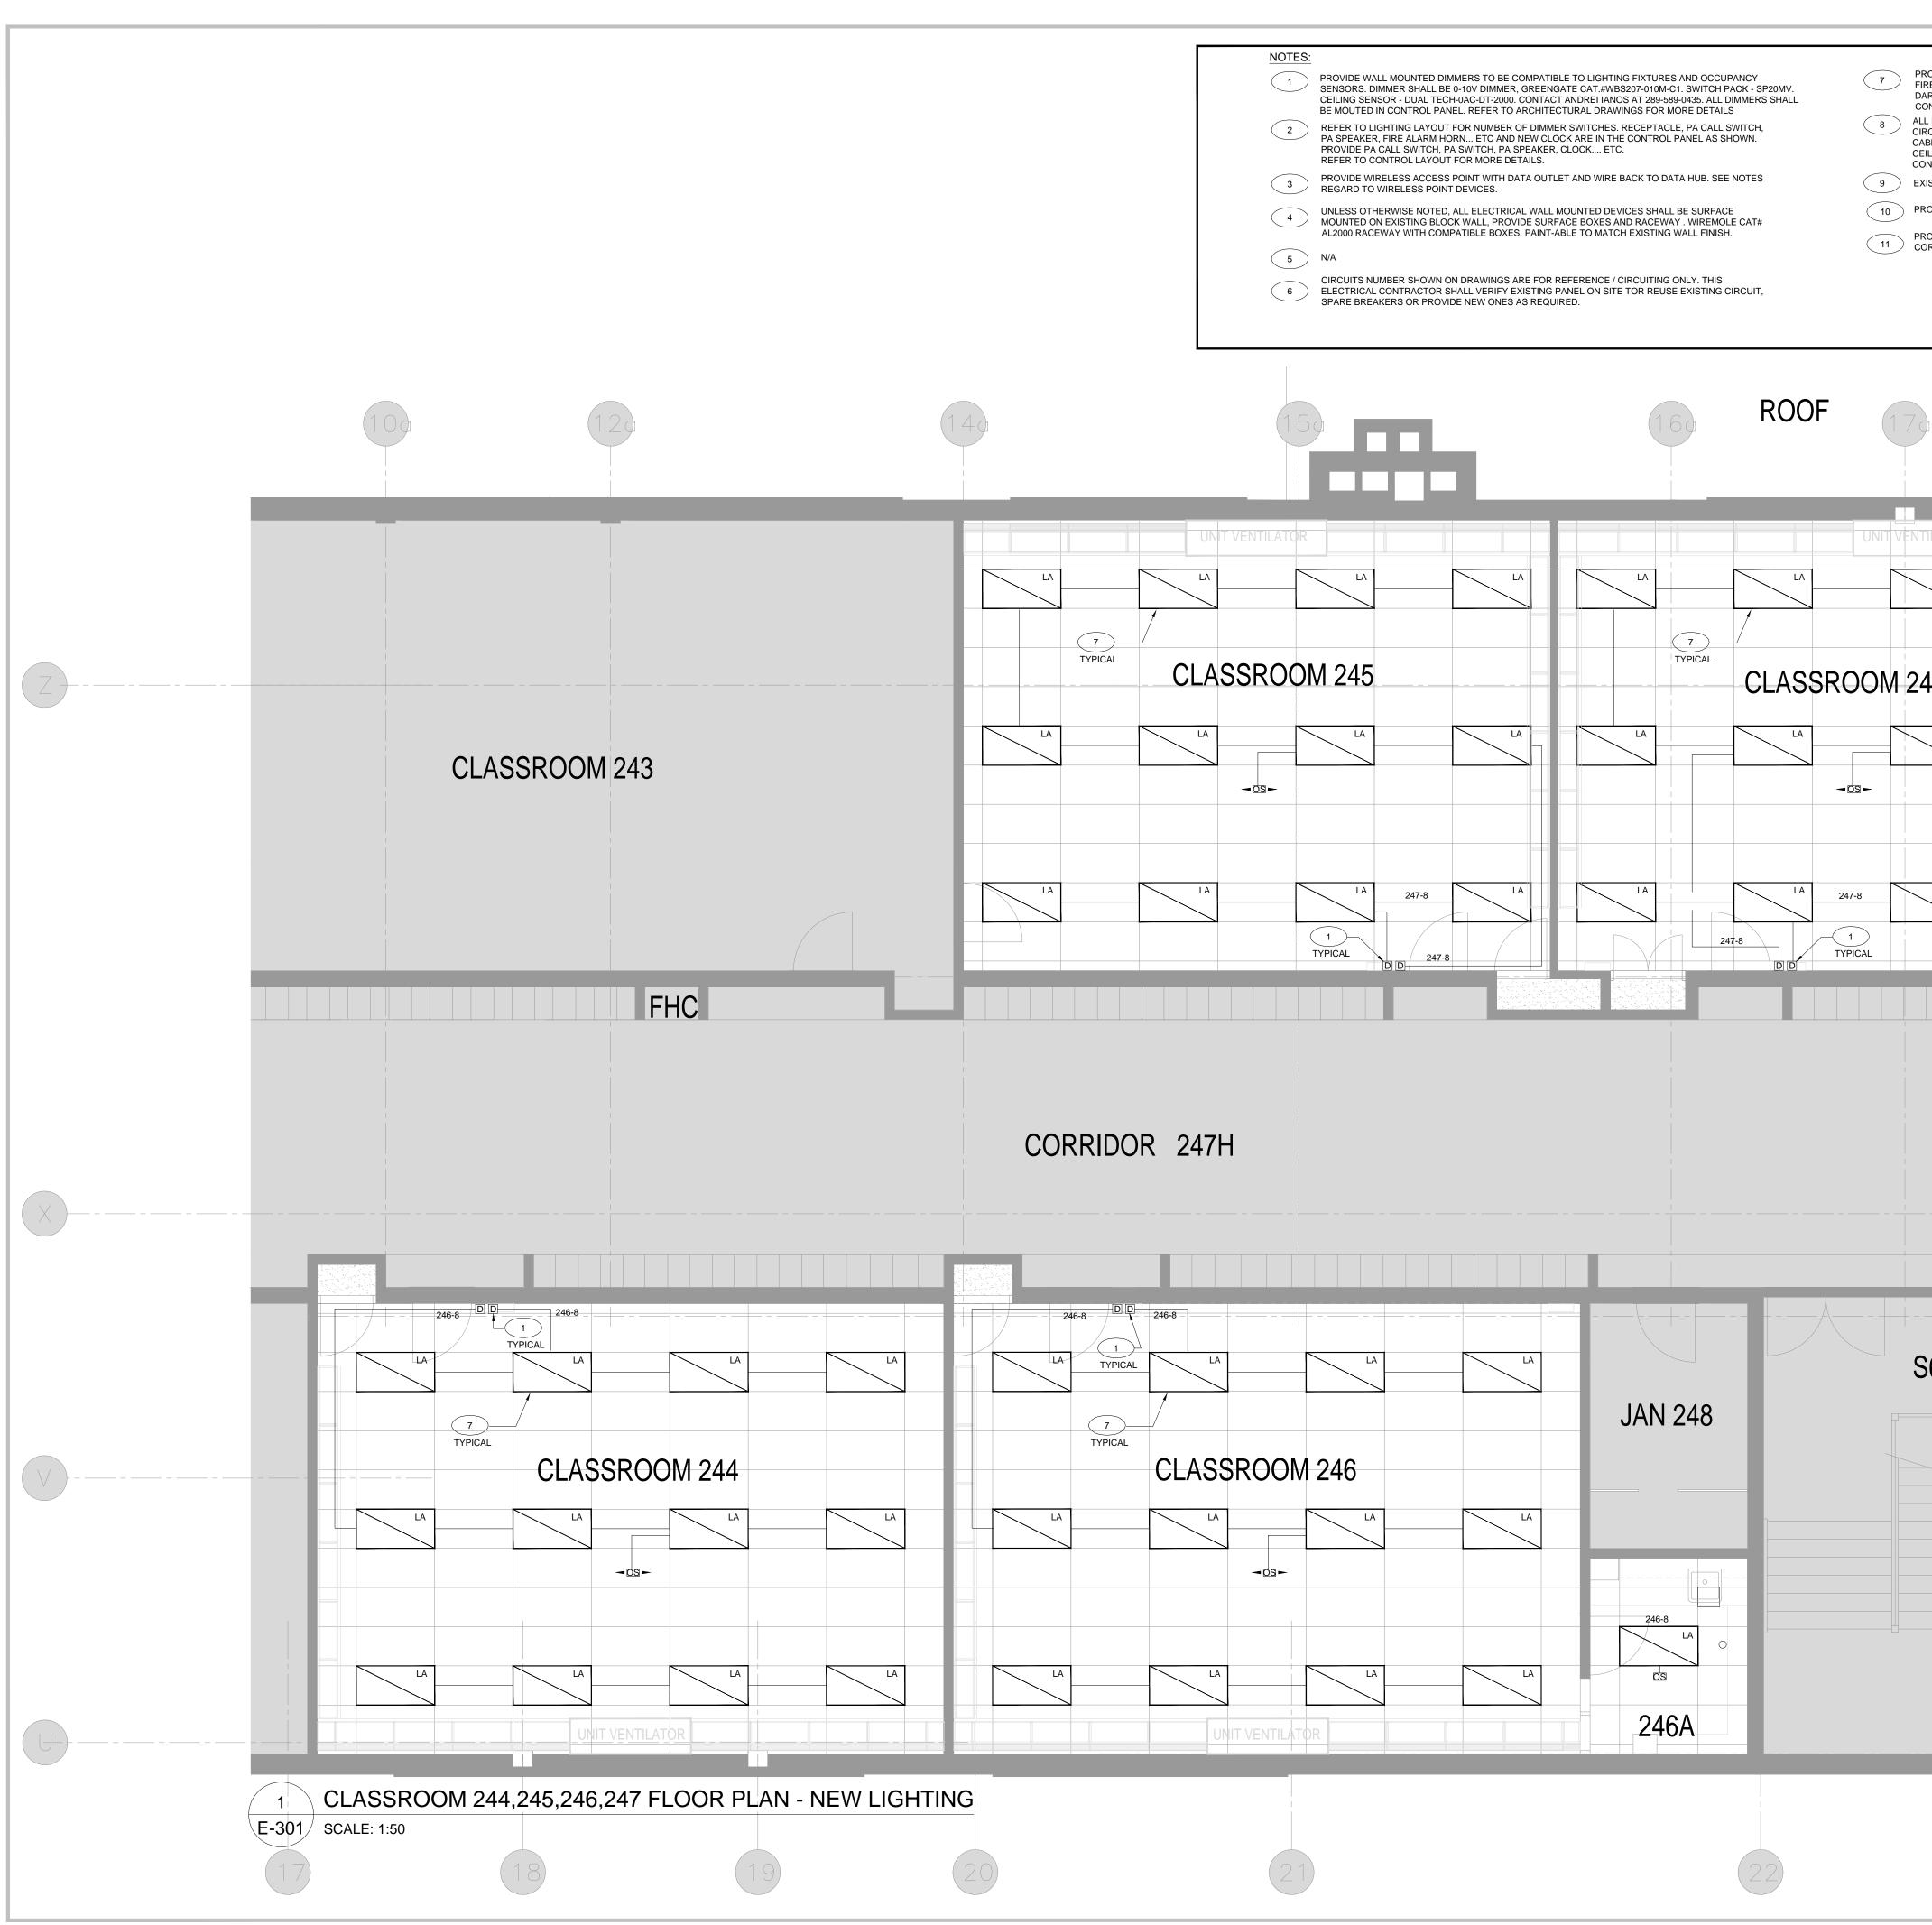

DVIDE 1 HOUR FIRE RATED PROTECTION FOR ALL FIXTURES IN CLASSROOM AS SHOWN, TENMAT E PROTECTION SOLUTION CAT.#FF130-2'X4' UL FIRE RATED TROFFER COVER. CONTACT MR, IREN EDWARDS AT 613-799-9216. ITRACTOR MUST PROVIDE COORDINATION ON SITE WITH CEILING SUB-TRADE FOR INSTALATION. EXISTING CONDUITS / WIRING AND JUNCTION BOXES INCLUDING FIRE ALARM, RECEPTACLE JUIT, LIGHTING CIRCUIT, VOICE / DATA CABLES, PA CABLES, WI-FI CABLES, LOW VOLTAGE LE ETC WITHIN EXISTING CEILING SPACE, SHALL BE RELOCATED TO BELOW FIRE RATED ING, IN CEILING SPACE BETWEEN NEW FIRE RATED CEILING AND NEW T-BAR CEILING. EXTEND DUITS / WIRING AS REQUIRED. PROVIDE NEW JUNCTION BOXES. STING TO REMAIN, UNLESS OTHERWISE NOTED.	RETI THE DISC ALL	JRNED ON REQUES CONTRACTOR SHA REPANCIES TO THE DIMENSIONS ARE G IOT SCALE DRAWIN	LL CHECK ALL DIMENSIONS AND REPORT : ARCHITECT. IVEN IN MILLIMETRES UNLESS OTHERWISE INDICATED. GS. SIONS AND DISTRIBUTION LOG Note	
WIDE HORIZONTAL MOUNTING RECEPTICLE AT ABOVE THE CABINET AND UNDER TACK BOARD. WIDE LED EMERGENCY REMOTE HEADS AND CONNECT TO EXISTING AC/DC CIRCUITS IN THE RIDOR.				
CORRIDOR 248H				
FEMALE W.R. 250		AVVARTHA PINE P STRICT SDIRDOL P		Intario
	CLA REN KAW 130 POF Drawin ELE CLA	R MS H SSROOMS OVATION ARTHA PIN HIGHLANI THOPE	AWKINS SR.PS 233-235-244-245-246-247 E RIDGE DISTRICT SCHOOL BOA	٩RD
23	Drawr M Date F Mar	By: Checker T Q ¹ Plotted: 13, 2024 - ng No.: 1	V 24-018-0 Scale:	

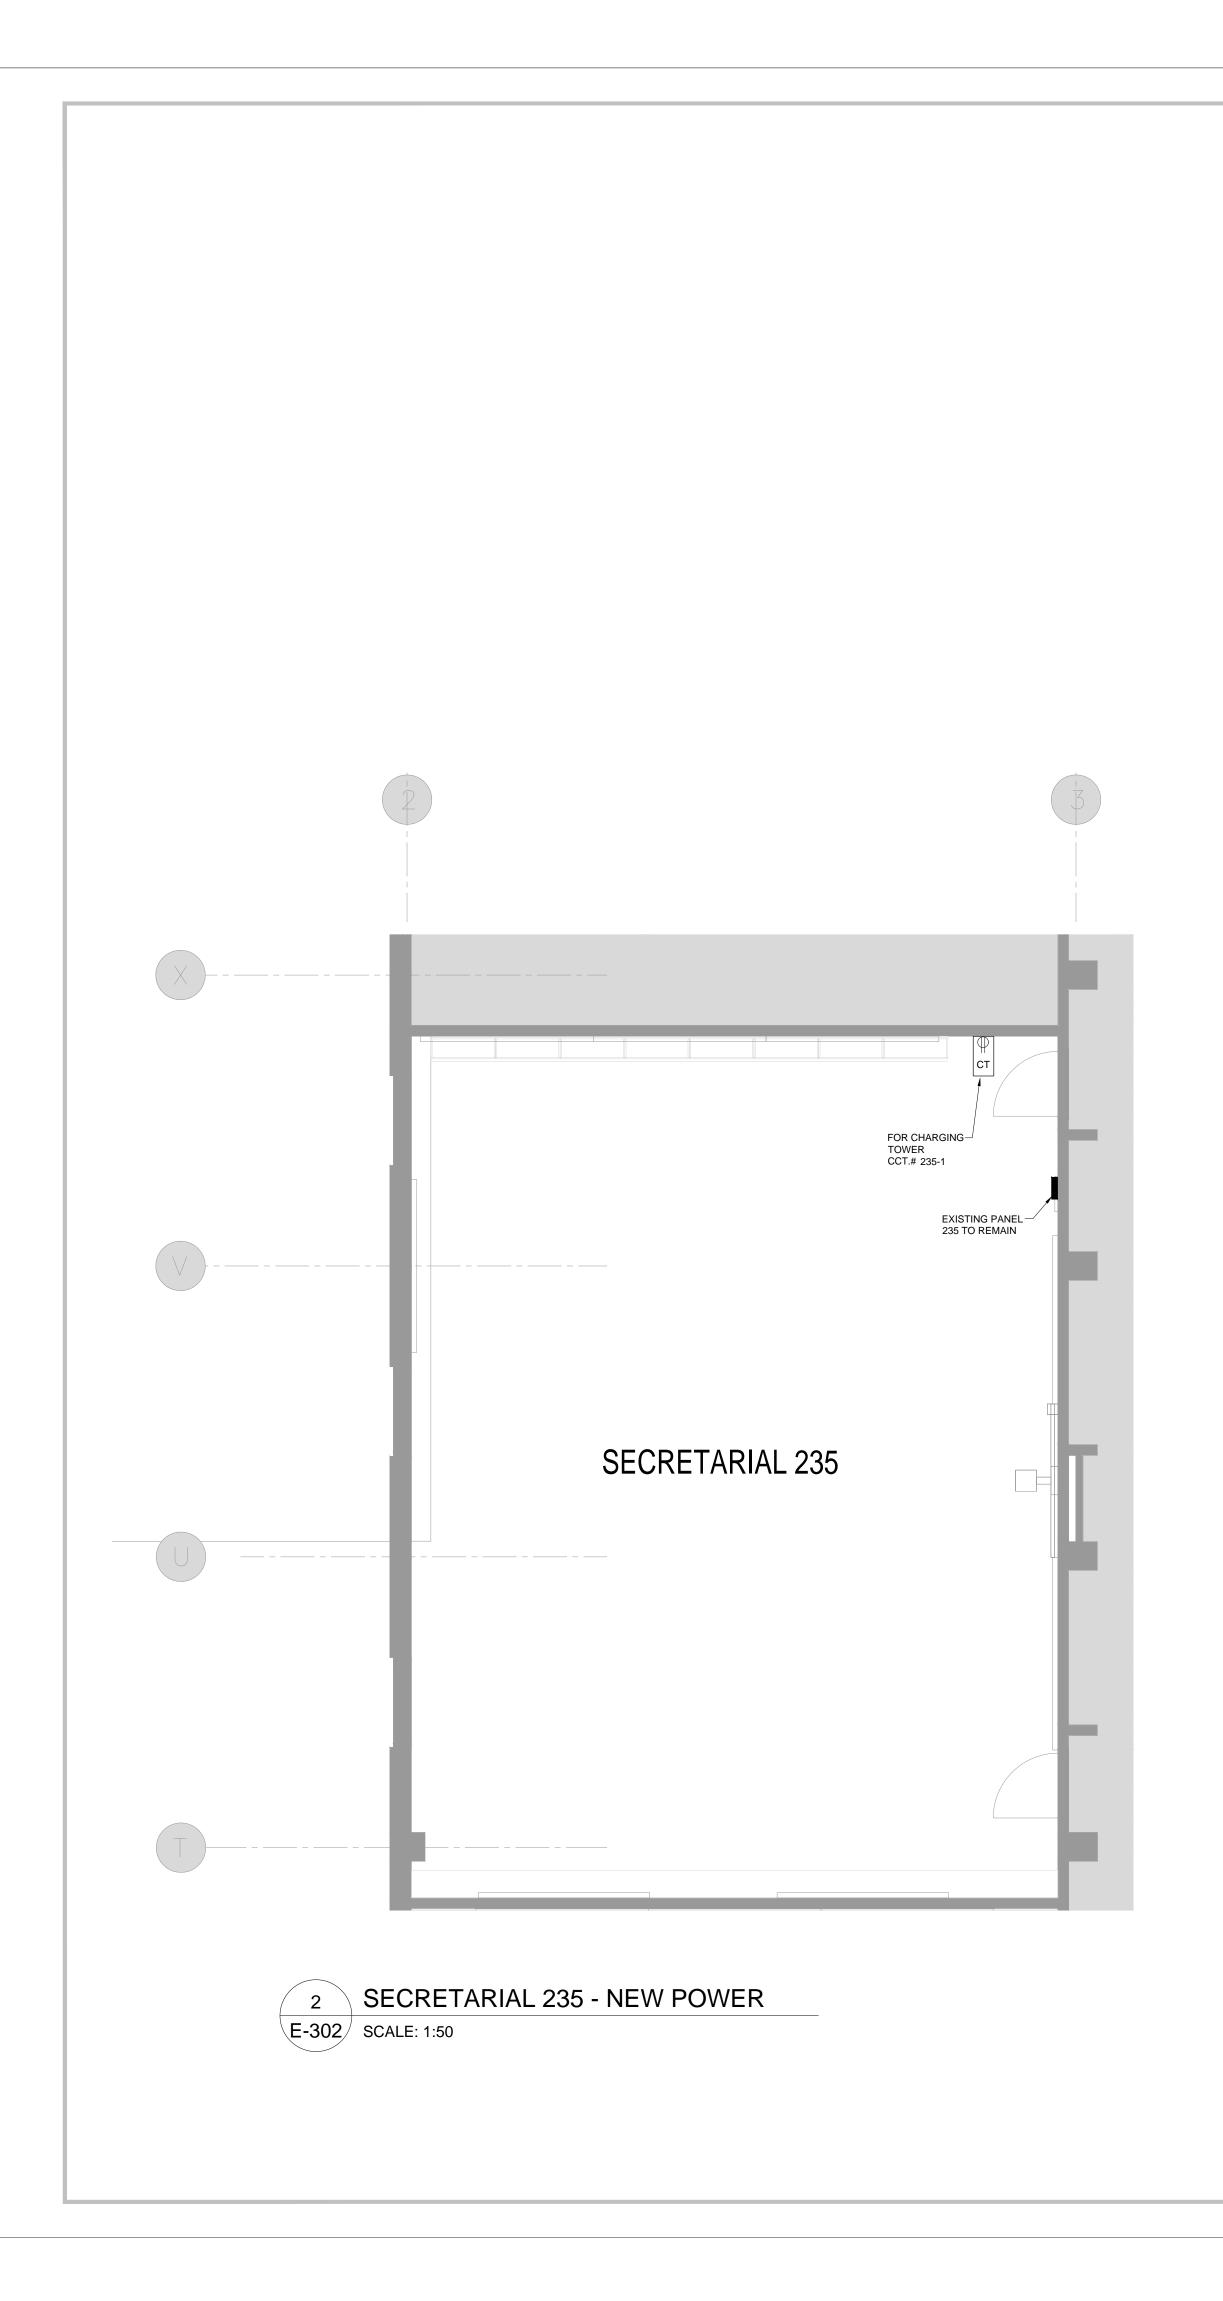

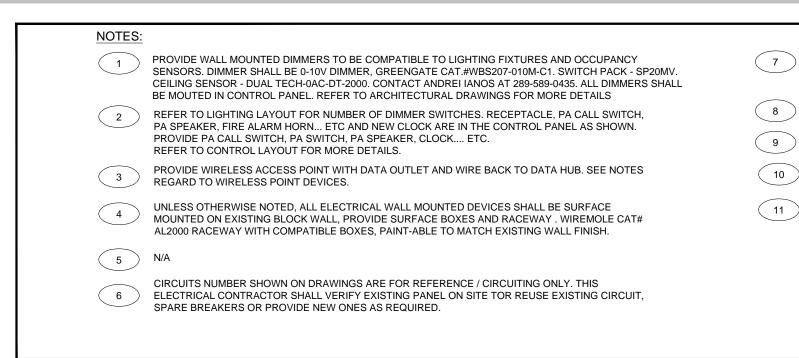

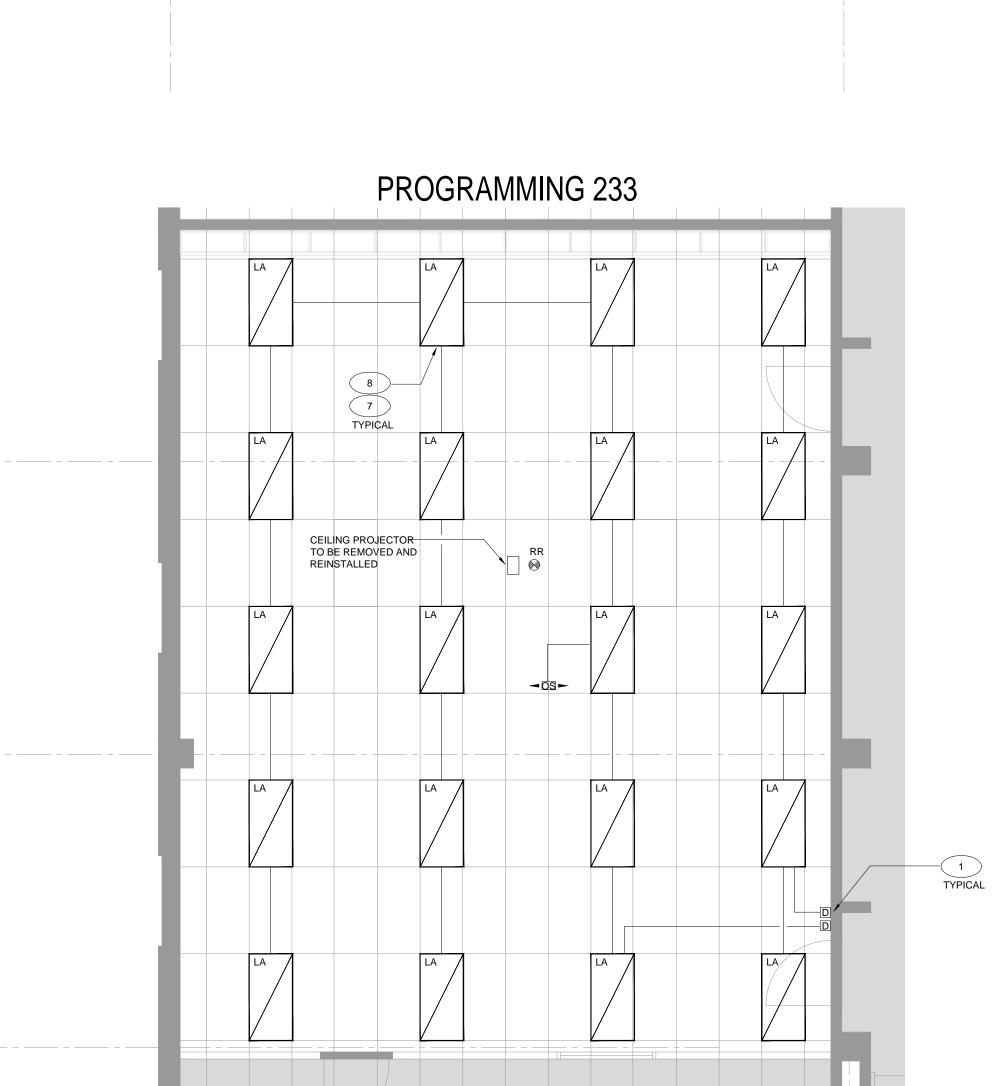


PROVIDE 1 HOUR FIRE RATED PROTECTION FOR ALL FIXTURES IN CLASSROOM AS SHOWN, TENMAT FIRE PROTECTION SOLUTION CAT.#FF130-2'X4' UL FIRE RATED TROFFER COVER. CONTACT MR, DARREN EDWARDS AT 613-799-9216. CONTRACTOR MUST PROVIDE COORDINATION ON SITE WITH CEILING SUB-TRADE FOR INSTALATION. (8) CONNECT LIGHTING FIXTURES TO EXISITNG LIGHTING CIRCUIT. TYPICAL.

(9) EXISITNG TO REMAIN, UNLESS OTHERWISE NOTED.

10 PROVIDE HORIZONTAL MOUNTING RECEPATCLE AT ABOVE THE CABINET AND UNDER TACK BOARD.

11 PROVIDE LED EMERGENCY REMOTE HEADS AND CONNECT TO EXISTING AC/DC CIRCUITS IN THE CORRIDOR.

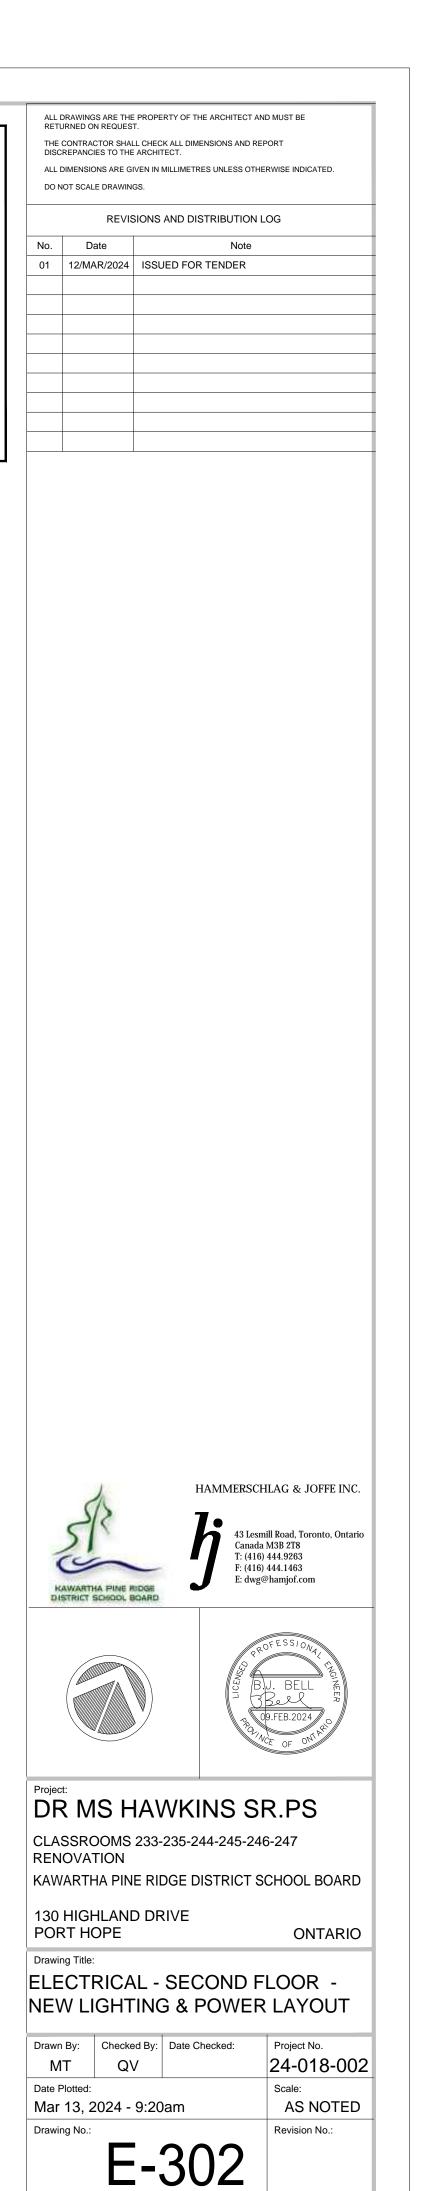



PROGRAMMING 233 - NEW LIGHTING

E-302 SCALE: 1:50