SUMMARY OF WORK

POOL DEMOLITION AND INTERIOR ALTERATIONS AS PER DRAWINGS AND SPECIFICATIONS

DRAWINGS LIST

ARCHITECTURAL

A01	GENERAL NOTES, OBC MATRIX, EXISTING SITE PLAN &	STRUCT	URAL
A02	CONSTRUCTION ASSEMBLIES SURVEY PLAN	DS-1	FOUNDATION & GR
A100	DEMOLITION PART, SITE PLAN & STANDARD SITE SIGNAGE	DS-2	SECOND FLOOR F
A101	PARTIAL DEMOLITION SITE PLAN	DS-3	ROOF FRAMING PL
A102	PROPOSED PARTIAL SITE PLAN & SITE DETAILS	DS-4	SECTIONS
A200	EXISTING / DEMOLITION KEY PLANS & ROOF PLAN	DS-5	GENERAL NOTES &
A201	BASEMENT PARTIAL PLANS		
A202	FIRST FLOOR PARTIAL PLANS		
A203	DEMOLITION POOL BALCONY LEVEL & PART. ROOF PLANS		
A300	REFLECTED CEILING PLANS		
A400	BUILDING ELEVATIONS		
A401	BUILDING ELEVATIONS		
A600	WALL SECTIONS & DETAILS		
A601	WALL SECTIONS & DETAILS		
A602	WALL SECTIONS & DETAILS		
A603	WALL SECTIONS & DETAILS		
A604	WALL SECTIONS & DETAILS		
A605	WALL SECTIONS		
A606	WALL SECTIONS		

A606 WALL SECTIONSA607 PLAN SECTION DETAILSA900 ROOM FINISH & DOOR SCHEDULES

NOTES

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APPENDIX G - DRAWINGS

GLENFOREST SECONDARY SCHOOL POOL DEMOLITION

3575 FIELDGATE DR, MISSISSAUGA, ON L4X 2J6

GROUND FLOOR PLAN R FRAMING PLAN PLAN

S & TYPICAL DETAILS

MECHANICAL

- M1 MECHANICAL LEGEND, NOTES, SCHEDULES & SCHEMATICS
- M2 POOL TUNNEL & FIRST FLOOR KEY PLAN
- M3 SECOND FLOOR KEY PLAN
- M4 ROOF KEY PLAN
- M5 DEMOLITION PLANS
- M6 DEMOLITION PLANS
- M7 SITE SERVICING DEMOLITION PLAN
- M8 NEW WORK PLANS
- M9 SCHEDULES & SCHEMATICS

ISSUED FOR TENDER APRIL 10, 2024 ITTMA24-5030



5650 Hurontario Street, Mississauga, Ont., L5R 1C6 Tel: (905) 890-1099, Fax: (905) 890-9453

ELECTRICAL

E1	ELECTRICAL LEGEND AND NOTES
E2	POOL TUNNEL & FIRST FLOOR KEY PLAN
E3	SECOND FLOOR KEY PLAN
E4	ROOF KEY PLAN
E5	DEMOLITION PLANS
E6	DEMOLITION PLANS
E7	NEW WORK PLANS



STANDARD ABBREVIATIONS

ABBREVIATED WORDS ON DRAWINGS ARE LISTED IN THIS SECTION. REFER TO STRUCTURAL, SITE SERVICES, MECHANICAL & ELECTRICAL DRAWINGS FOR OTHER ABBREVIATIONS USED.

ACM	ALUMINUM COMPOSITE MATERIAL	М	MIRROR
AFF	ABOVE FINISHED FLOOR	М.	MEN'S
ALUM.	ALUMINUM	MACH.	MACHINE
ARCH.	ARCHITECTURAL	MCP	MODULAR
AWP	ACOUSTIC WALL PANEL	MECH.	MECHANIC
BD.	BOARD	MIN.	MINIMUM
BF	BARRIER FREE	MISC.	MISCELLA
BLDG.	BUILDING	MM	MILLIMETE
BLK.	BLOCK	N/A	NOT APPL
СВ	CHALKBOARD	NIC	NOT IN CO
СН	COAT HOOKS	NO.	NUMBER
CJ	CONTROL JOINT	NTS	NOT TO SO
CONC.	CONCRETE	NFHB	NON-FREE
CR+S	COAT RACK AND SHELF	O.C.	ON CENTE
CS	CONVENIENCE SHELF	O.W.S.J.	OPEN WEI
СТ	CERAMIC TILE	P. TILE	PORCELA
C/W	COMPLETE WITH	PA	PUBLIC AD
DC	DOOR CONTACT	РВ	PUSH BUT
DF	DRINKING FOUNTAIN		DOOR OP
DWG.	DRAWING	PREF	PREFERRI
EQ.	EQUAL	PROP.	PROPOSE
EQUIP.	EQUIPMENT	PT.	PAINT
ELECT.	ELECTRICAL	PTD	PAPER TO
ELEV.	ELEVATOR	REV.	REVISED
EXIST.	EXISTING	SB	SMARTBO
EXT.	EXTERIOR	S.C	SOLID CO
FD	FLOOR DRAIN	SD	SOAP DISI
FE	FIRE EXTINGUISHER	SECT.	SECTION
FEC	FIRE EXTINGUISHER CABINET	SND	SANITARY
FL	FLOOR		DISPOSAL
GB	GRAB BAR	SPEC.	SPECIFIC/
GBF	FOLDING GRAB BAR	SNDISP	SANITARY
GBL	GRAB BAR "L" SHAPE		DISPENSE
GYP.	GYPSUM	ST. ST.	STAINLES
GW	GEORGIAN WIRED GLASS	STL.	STEEL
H/C	HANDICAP	STRUC.	STRUCTU
HD	HAND DRYER	STOR.	STORAGE
НМ	HOLLOW METAL	тв	TACKBOA
HR	HOUR	TD	TOILET TI
HVT	HOMOGENEOUS VINYL TILE	TDD	PAPER TO
INSUL.	INSULATION		DISPOSAL
INT.	INTERIOR	TG	TEMPERE
JAN	JANITOR	ТМ	TILTED MI
LAP	LAY-IN ACOUSTIC PANEL	TWF	THRU WAI
LAV.	LAVATORY	TYP	TYPICAL
LH	LEFT HAND	VCT	VINYL CO
LHR	LEFT HAND REVERSE	VEST.	VESTIBUL
LWB	LIGHT WEIGHT CONCRETE	W.	WOMEN'S
		WB	WHITE BO

	MEN'S
н.	MACHINE
	MODULAR CONTROL PANEL
н.	MECHANICAL
	MINIMUM
	MISCELLANEOUS
	MILLIMETERS
	NOT APPLICABLE
	NOT IN CONTRACT
	NUMBER
	NOT TO SCALE
3	NON-FREEZE HOSE BIB
	ON CENTER
S.J.	OPEN WEB STEEL JOIST
.E	PORCELAIN TILE
	PUBLIC ADDRESS SYSTEM
	PUSH BUTTON FOR AUTOMATIC
	DOOR OPERATOR
=	PREFERRED
∍.	PROPOSED
	PAINT
	PAPER TOWEL DISPENSER
	REVISED
	SMARTBOARD
	SOLID CORE
	SOAP DISPENSER
г.	SECTION
	SANITARY NAPKIN & TAMPON
	DISPOSAL
C .	SPECIFICATIONS
SP	SANITARY NAPKIN & TAMPON
	DISPENSER
эΤ.	STAINLESS STEEL
	STEEL
JC.	STRUCTURAL
२.	STORAGE
	TACKBOARD
	TOILET TISSUE DISPENSER
	PAPER TOWEL DISPENSER &
	DISPOSAL
	TEMPERED GLASS
	TILTED MIRROR
	THRU WALL FLASHING
	TYPICAL
_	VINYL COMPOSITE TILE
Γ.	VESTIBULE
	WOMEN'S
	WHITE BOARD

FLOOR PLAN NOTES

1. GENERAL CONTRACTOR (G.C.) TO VERIFY ALL DIMENSIONS AT SITE. VERIFY ALL SITE CONDITIONS & REPORT ANY DISCREPANCIES TO THE CONSULTANT. DO NOT SCALE THESE DRAWINGS.

- ALL WORK TO BE CARRIED OUT IN ACCORDANCE WITH THE LATEST EDITION OF THE LOCAL, PROVINCIAL AND FEDERAL CONSTRUCTION AND BUILDING CODES, THE NATIONAL FIRE CODE, THE OCCUPATIONAL HEALTH AND SAFETY ACT, AND ANY OTHER AUTHORITIES HAVING JURISDICTION.
- 3. REFER TO STRUCTURAL, SITE SERVICES, MECHANICAL AND ELECTRICAL DWGS AND WHERE APPLICABLE LANDSCAPE DRAWINGS FOR ADDITIONAL INFORMATION. REFER ALSO TO PARTITION SCHEDULE & ROOM FINISH SCHEDULE FOR ADDITIONAL INFORMATION ON PARTITION TYPES AND FINISHES/DETAILS.
- 4. ALL MASONRY DIMENSIONS FOR OPENINGS, ETC. ARE ACTUAL FOR ALL DRAWINGS.
- 5. GENERAL CONTRACTOR TO COORDINATE ALL SUB CONTRACTORS TO ACCOMMODATE ALL OPENINGS IN EXISTING AND NEW PARTITIONS AND FOUNDATION WALLS FOR ALL SERVICE CONNECTIONS.
- 6. ALL INTERIOR WALLS TO BE LWB (LIGHT WEIGHT BLOCK) OR CONCRETE BLOCK AS NOTED EXTEND TO UNDERSIDE OF DECK, SLAB OR STRUCTURE ABOVE AND PROVIDE CONTINUOUS SOUND SEALS AT TOP (ULC LISTED FIRE STOP MATERIAL REQUIRED AT ALL RATED WALLS). UNLESS OTHERWISE NOTED.
- 7. PROVIDE 90MM / 140MM OR 190MM LWB FURRING AROUND ALL PIPE AND DUCT DROPS WITH BULLNOSE CORNERS AS REQUIRED. NO GYPSUM BOARD FURRING ALLOWED UNLESS OTHERWISE NOTED. CO-ORDINATE WITH MECH. DWGS.

ASBESTOS NOTES

1. G.C. TO REVIEW ASBESTOS MANAGEMENT PROGRAM MANUAL AVAILABLE FROM THE HEAD CARETAKER AND DESIGNATED SUBSTANCES REPORTS ISSUED FOR THIS PROJECT. FOLLOW PDSB PROCEDURE FOR ASBESTOS CONTAINING MATERIAL AS INDICATED IN TENDER DOCUMENTS.


SCHEDULE OF CASH ALLOWANCES

1. REFER TO TENDER FORM FOR CASH ALLOWANCE VALUE.


2. REFER TO SCOPE OF WORK FOR SCHEDULE OF CASH ALLOWANCES.

PARTITION NOTES

- 1. FIRE RATED BLOCK WALLS AND GYP. BD PARTITIONS TO BE CARRIED TO UNDERSIDE OF STRUCTURAL DECK OR CONCRETE SLAB AND SEALED WITH ULC LISTED FIRE STOPPING MATERIAL AS PER SPECIFICATIONS, WHERE MASONRY WALLS ENCOUNTER STRUCTURAL MEMBERS, CLOSURES ARE TO BE PROVIDED AS REQUIRED BY O.B.C.
- 2. ALL MASONRY WALLS, WHETHER LOADBEARING OR NON-LOADBEARING ARE TO HAVE BLOCK LINTELS IN ACCORDANCE WITH MASONRY LINTEL SCHEDULE ON STRUCTURAL DRAWINGS.
- 3. ALL WALLS TO EXTEND TO U/S OF FLOOR OR STRUCTURE ABOVE UNLESS NOTED THERWISE. ENSURE AIR-TIGHT SEAL AT ALL INTERSECTIONS WITH FLOOR/STRUCTURE ABOVE AND AT ALL PENETRATIONS - TYP.
- 4. FOR ALL ACOUSTIC PARTITIONS & FURRING PARTITIONS, CAULK W/ ACOUSTICAL SEALANT AT ALL PENETRATIONS, 10MM JOINT AT U/S STRUCTURAL DECK, 5MM JOINT AT FLOOR AND VERTICAL JOINTS AND ABUTTING DISSIMILAR CONSTRUCTION.
- 5. ALL CORNER CONCRETE BLOCK(S) TO HAVE BULLNOSE EXCEPT FIRST CONCRETE BLOCK

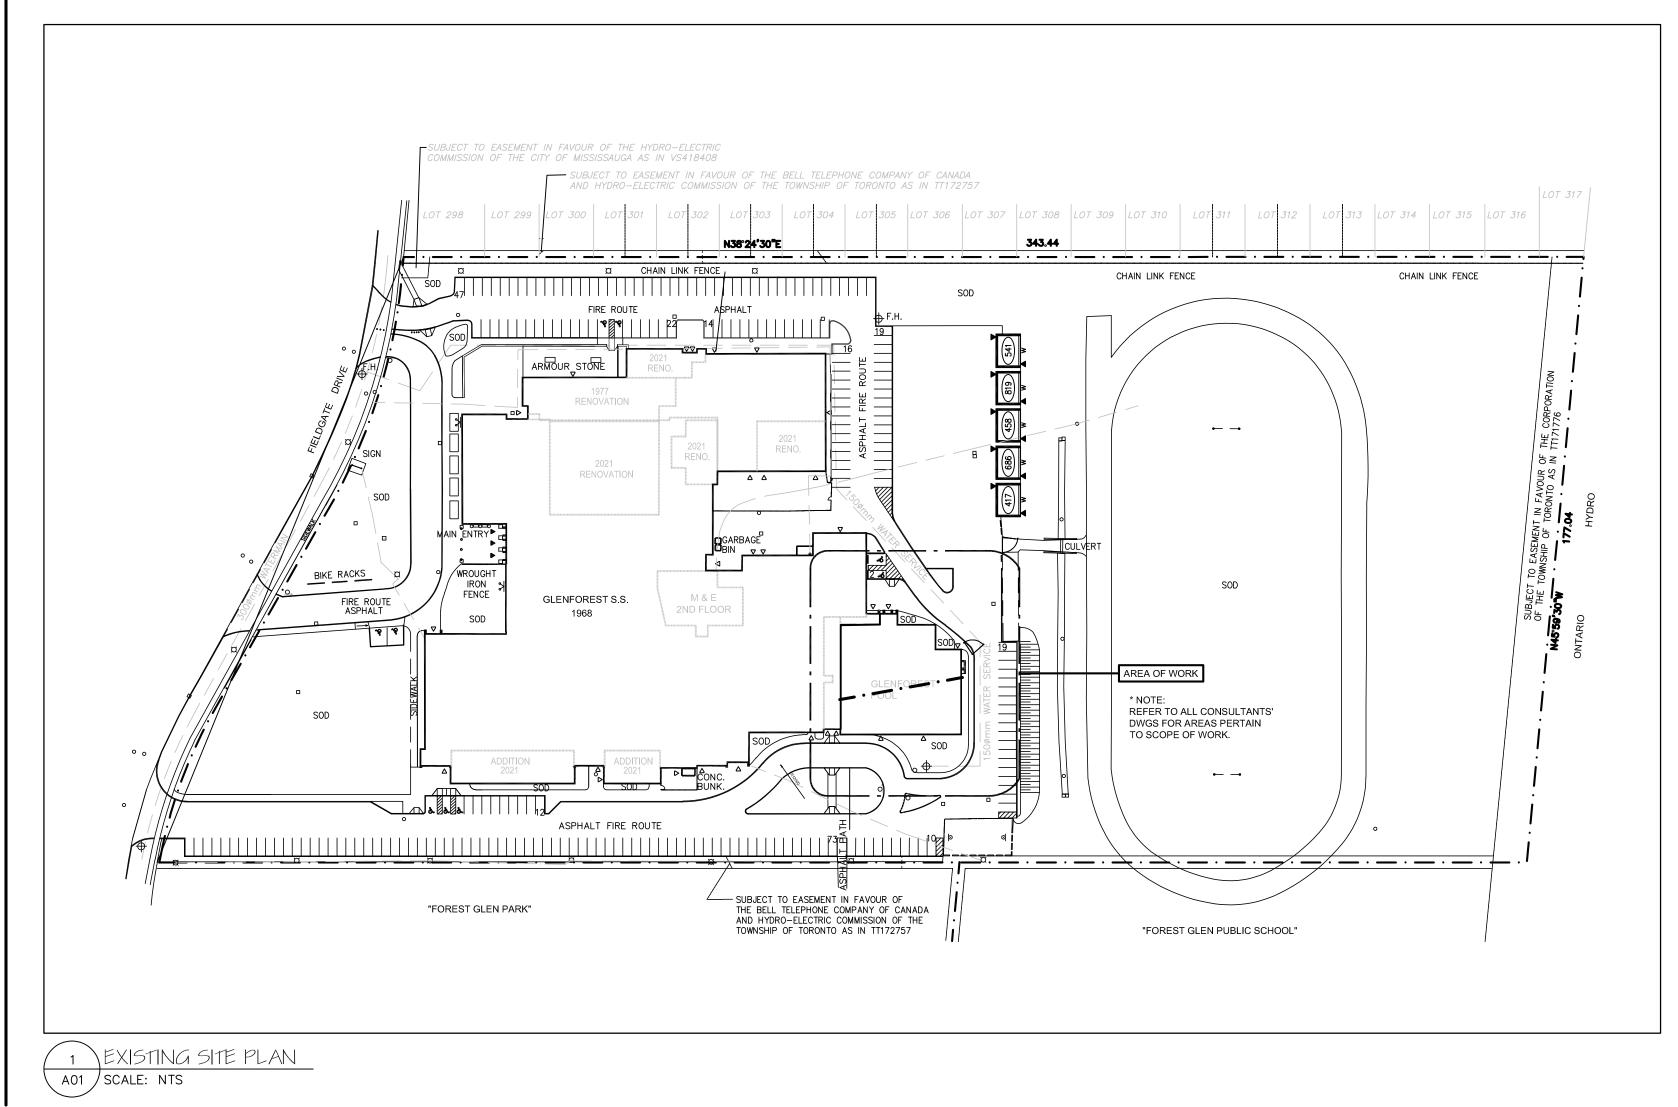

DRAWING SYMBOL LEGEND

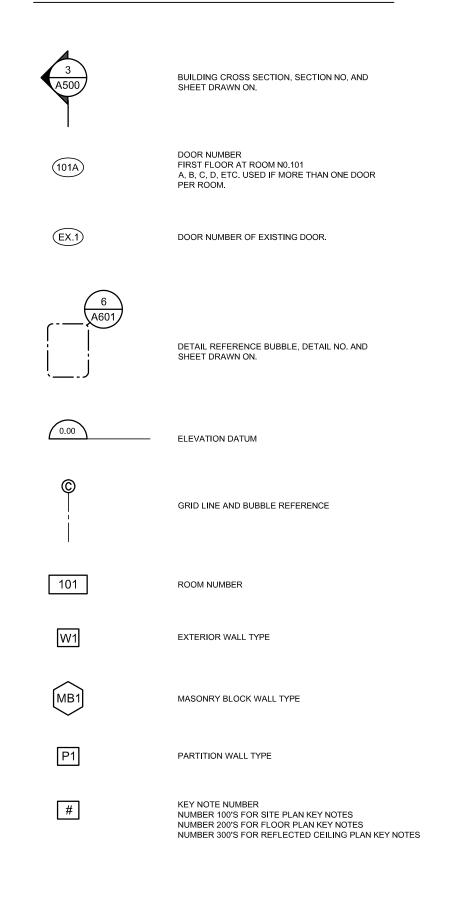

DEMOLITION NOTES 1. ALL DEMOLISHED MATERIALS & DEBRIS ARE TO BE DISPOSED BY GENERAL CONTRACTOR UNLESS OTHERWISE NOTED. 2. OWNER WILL SALVAGE ANY WANTED MATERIAL, EQUIPMENT, ETC. PRIOR TO CONSTRUCTION START. GENERAL CONTRACTOR TO REPAIR, PATCH & MAKE GOOD IN A WORKMANLIKE AND WHOLE CONDITION TO THE LIKE OF PRIOR OWNER SALVAGE. 3. REMOUNT ALL EXISTING TO REMAIN WALL PANELS, FE, FEC & ELECTRICAL PANELS, ETC. TO NEW FINISHED WALL FACE AS INDICATED ON CONTRACT DOCUMENTS, ETC. REPAIR, PATCH & MAKE GOOD ALL EXISTING STRUCTURE AND BUILDING FINISHES THAT IS DAMAGED AS A RESULT OF CONSTRUCTION. 5. ALL EXISTING ACOUSTIC TILE CEILING/GYP. BD. OR PLASTER CEILING DAMAGED DURING ALTERATIONS TO BE RETURNED TO A CONDITION EQUIVALENT TO BEFORE DISTURBANCE. ALL DAMAGED CEILING TILES TO BE REPLACED WITH MATCHING TILES INCLUDING FR. 6. ALL REQUIRED CUTTING & FITTING (INCLUDING ALL STRUCTURAL, ELECTRICAL AND MECHANICAL) TO BE CONNECTED TO EXISTING WORK WITH NEW WORK TO BE PERFORMED AS PART OF THIS CONTRACT AND TO FINISH THE ENTIRE WORK IN A WORKMANLIKE AND WHOLE CONDITION. PROVIDE ALL OPENINGS IN EXISTING WALLS, FLOOR SLABS AND ROOF DECK AS REQUIRED FOR THE INSTALLATION OF NEW STRUCTURAL, MECHANICAL AND ELECTRICAL WORK IN THE EXISTING BUILDING. REFER TO STRUCTURAL, MECHANICAL AND ELECTRICAL DRAWINGS FOR ALL NEW WORK IN THE EXISTING BUILDING 8. ALL WORK TO MAKE GOOD EXISTING; SHALL MATCH EXISTING IN MATERIAL, CONSTRUCTION AND FINISH INCLUDING PAINT COLOUR BEHIND REMOVED FITMENTS / MILLWORK UNLESS OTHERWISE SPECIFIED. 9. GENERAL CONTRACTOR TO PERFORM ALL NECESSARY DEMOLITION, ALTERATIONS AND MAKE GOOD ALL FINISHES AS REQUIRED TO MAKE THIS WORK AS A COMPLETE JOB (INCLUDING BUT NOT LIMITED TO WORK SHOWN IN DRAWINGS AND SPECIFICATIONS). 10. ALL OPENINGS IN FIRE RATED WALLS, CEILINGS AND FLOORS TO BE RETURNED TO EQUIVALENT CONDITION BEFORE THE OPENING AND ALL ELECTRICAL AND MECHANICAL PENETRATIONS TO BE SEALED WITH FIRE STOP MATERIAL AS REQUIRED BY THE O.B.C. 11. ALL EXPOSED ELECTRICAL CONDUITS AND MECHANICAL DUCTS AND PIPES TO BE PAINT FINISH. COLOURS TO BE SELECTED BY CONSULTANT. 12. CONTRACTOR TO CONTACT ALL AUTHORITIES RESPONSIBLE/ INVOLVED TO DISCONNECT EXISTING SERVICES (EG. HYDRO, BELL, GAS ETC.) 13. ALL EXPOSED EDGES OF CONCRETE BLOCK WALLS BEING MODIFIED FOR PERMANENT ALTERATIONS SHALL BE BULLNOSED (WHERE APPLICABLE) 14. WHEN REMOVING EXISTING DOOR/ WINDOW FRAMES AND CLOSING IN EXISTING OPENINGS FOR PERMANENT ALTERATIONS, CONTRACTOR TO REMOVE EXISTING BLOCK WITH BULLNOSE JAMBS AND SILLS AND REPLACE WITH NEW CONCRETE BLOCK (NO BULLNOSE) FLUSH WITH WALL FACE UNLESS INDICATED OTHERWISE. 15. G.C. IS RESPONSIBLE FOR ANY TEMPORARY SUPPORTS, BRACING AND SHORING REQUIRED. REFER TO STRUCTURAL DRAWING AND SPECIFICATIONS FOR SUPPORT PROCEDURES PRIOR TO REMOVAL OF ANY LOAD-BEARING SUPPORTS. 16. MAINTAIN EXISTING BUILDING SECURE FROM UNAUTHORIZED ENTRY DURING DEMOLITION PROCEDURES AND CONSTRUCTION ACTIVITIES. 17. PROVIDE INTERIOR AND/OR EXTERIOR HOARDING AS REQUIRED TO FACILITATE ACCESS TO WORK AREAS. RECONFIGURE HOARDING AS REQUIRED AT COMPLETION OR START OF WORK STAGING. REFER TO SPEC. 18. CONTRACTOR RESPONSIBLE FOR ALL TEMPORARY PROTECTION OF ALL FINISHES AND MATERIALS TO REMAIN. PROVIDE FULL PROTECTION TO EXISTING FLOORING AND OTHER FLOOR FINISHES TO PREVENT DAMAGE 19. REMOVE, PROTECT AND STORE ALL MATERIALS TO BE SALVAGED FOR REUSE ON THIS PROJECT WHERE INDICATED ON THE DRAWINGS MATERIAL LEGEND 1. POURED CONCRETE 9. UNDISTURBED SOIL 5. GRANULAR "A" FILL OR PRECAST CONCRETE 4 4 4 4 2. CONCRETE BLOCK 6. GRANULAR "B" FILL 10. EXISTING CONSTRUCTION 3. BRICK 7. RIGID INSULATION 11. STEEL


W1 <u>+515 TO +540</u> EXTERIOR WALL CONSTRUCTION 92mm FACE BRICK DJUSTABLE GALV. BRICK TIES. (REFER TO STRUCTURAL) 38mm AIR SPACE INTERIOR EXTERIOR 80 mm (2x40mm STAGGERED) POLYISO CAVITY WALL INSULATION W/ TAPED SEAMS. (TYP.) VAPOUR BARRIER OVER ±305 TO ±330 EXIST. OR NEW TO MATCH EXIST. MASONRY ±305 TO ±330 ____/

8. SPRAY FOAM INSULATION


12. WOOD BLOCK


4. (SAND) OR GYPSUM BOARD

2 WALL TYPE DETAIL - WI A01 / SCALE: NTS

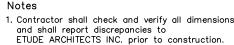

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6 LOCATION MAP

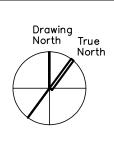
A01

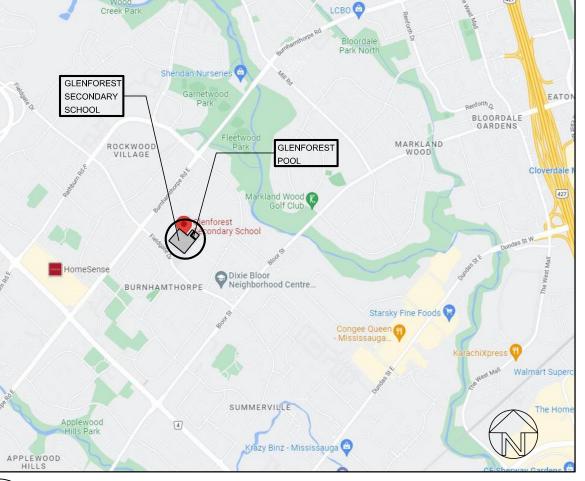Name of Project: GLENFOREST SECONDARY SCHOOL

POOL DEMOLITION


POOL DEMOLITION Location: 3575 FIELDGATE DR, MISSISSAUGA, ON L4X 2J6						
Ontario	o Building Code 2012 Data Matrix-E	Division B-Part 11-Renovation of Existing	g Building		OBC Reference	
11.1	Existing Building classification: Group "A" Division 2	Existing Use: : Construction Index: Hazard Index: Not Applicable (no change of major o	School Exist. Exist. occupancy)		11.2.1 T 11.2.1.1A T 11.2.1.1(C)	
11.2	Alteration to Existing Building is:	Basic Renovation Extensive Renovation	√		11.3.3.1 11.3.3.2	
11.3	Reduction in Performance Level:	Structural: By Increase in occupant load: By change of major occupancy: Plumbing: Sewage-system:	 No No No No No 	□ Yes □ Yes □ Yes □ Yes □ Yes	11.4.2 11.4.2.1 11.4.2.2 11.4.2.3 11.4.2.4 11.4.2.5	
11.4	Compensating Construction:	Structural Increase in occupant load: Change of major occupancy: Plumbing: Sewage System:	 No No No No No No No No 	 Yes (explain) Yes (explain) Yes (explain) Yes (explain) Yes (explain) Yes (explain) 	11.4.3 11.4.3.2 11.4.3.3 11.4.3.4 11.4.3.5 11.4.3.6	
11.5	Compliance Alternatives Proposed:	✓ No □ Yes (give number(s))			11.5.1	
5	OBC MATRIX					

5 VOBC MATRIX A01 /

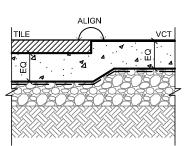

TYPICAL DEPRESSED SLAB ON GRADE DETAIL DEPRESS SLAB IN AREAS OF TILE INSTALLATION. INSTALL TRANSITION STRIP AS PER SPEC. REFER TO STRUCTURAL DWG + SPEC FOR SLAB SURFACE TREATMENT AND SLAB REINFORCING. COORDINATE WITH ROOM FINISH SCHEDULE

4 TYPICAL DEPRESSED SLAB DETAIL A01 / SCALE: NTS

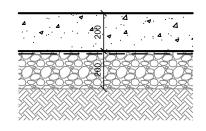

TYPICAL SLAB-ON-GRADE CONSTRUCTION 200 MM POURED CONCRETE SLAB (MATCH STRUCTURAL DWG) ON 15MIL (0.38MM THICK), CLASS A, STÈGO WRAP VAPOUR BARRIÉR ON 200MM COMPACTED CLEAR 19MM STONE ON GRANULAR SUB-BASE ON ENGINEERED FILL (SEE STRUCTURAL DWGS.) REFER TO DWGS. AND SPECIFICATIONS FOR SLAB SURFACE TREATMENT AND SLAB REINFORCING. INSTALL 50MM THICK AND 1200MM WIDE RIGID INSULATION BELOW THE CONCRETE SLAB AND VAPOUR BARRIER AT EXTERIOR PERIMETER OF CONCRETE SLAB (TYP.)


3 TYPICAL CONC, SLAB ON GRADE DETAIL A01 / SCALE: NTS

		I	
5	ISSUED FOR TENDER	APRIL 10, 2024	
4	ISSUED FOR PRE-TENDER REVIEW	MARCH 26, 2024	
3	ISSUED FOR SPA	JANUARY 05, 2024	
2	ISSUED FOR BUILDING PERMIT	NOVEMBER 03, 2023	
1	ISSUED FOR CLIENT REVIEW	FEBRUARY 06, 2023	
NO.	DESCRIPTION	DATE	
REV	REVISIONS / ISSUES		



5650 Hurontario Street, Mississauga, Ont., L5R 1C6 Tel: (905) 890—1099, Fax: (905) 890—9453

다고 ETUDE ARCHITECTS INC. 30 KERN ROAD, SUITE 106, TORONTO, ONTARIO M3B 1T1 T: 416.226.5779 F: 416.226.9844 E: info@etudearchitect.com

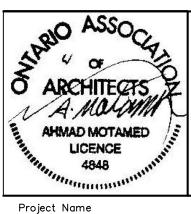

GLENFOREST POOL


GLENFOREST SECONDARY SCHOOL 2575 FIELDGATE DR., MISSISSAUGA, ON L4X 2J6

POOL DEMOLITION

Drawing Title

GENERAL NOTES, OBC MATRIX, EXISTING SITE PLAN


Graphic Scale AS SHOWN	Sheet no.	
Drawn AK / VSP	Checked AM	A01
CAD File AS NOTED	Scale AS NOTED	
Date DECEMBER 2022	Project No. 222113	Revision No.

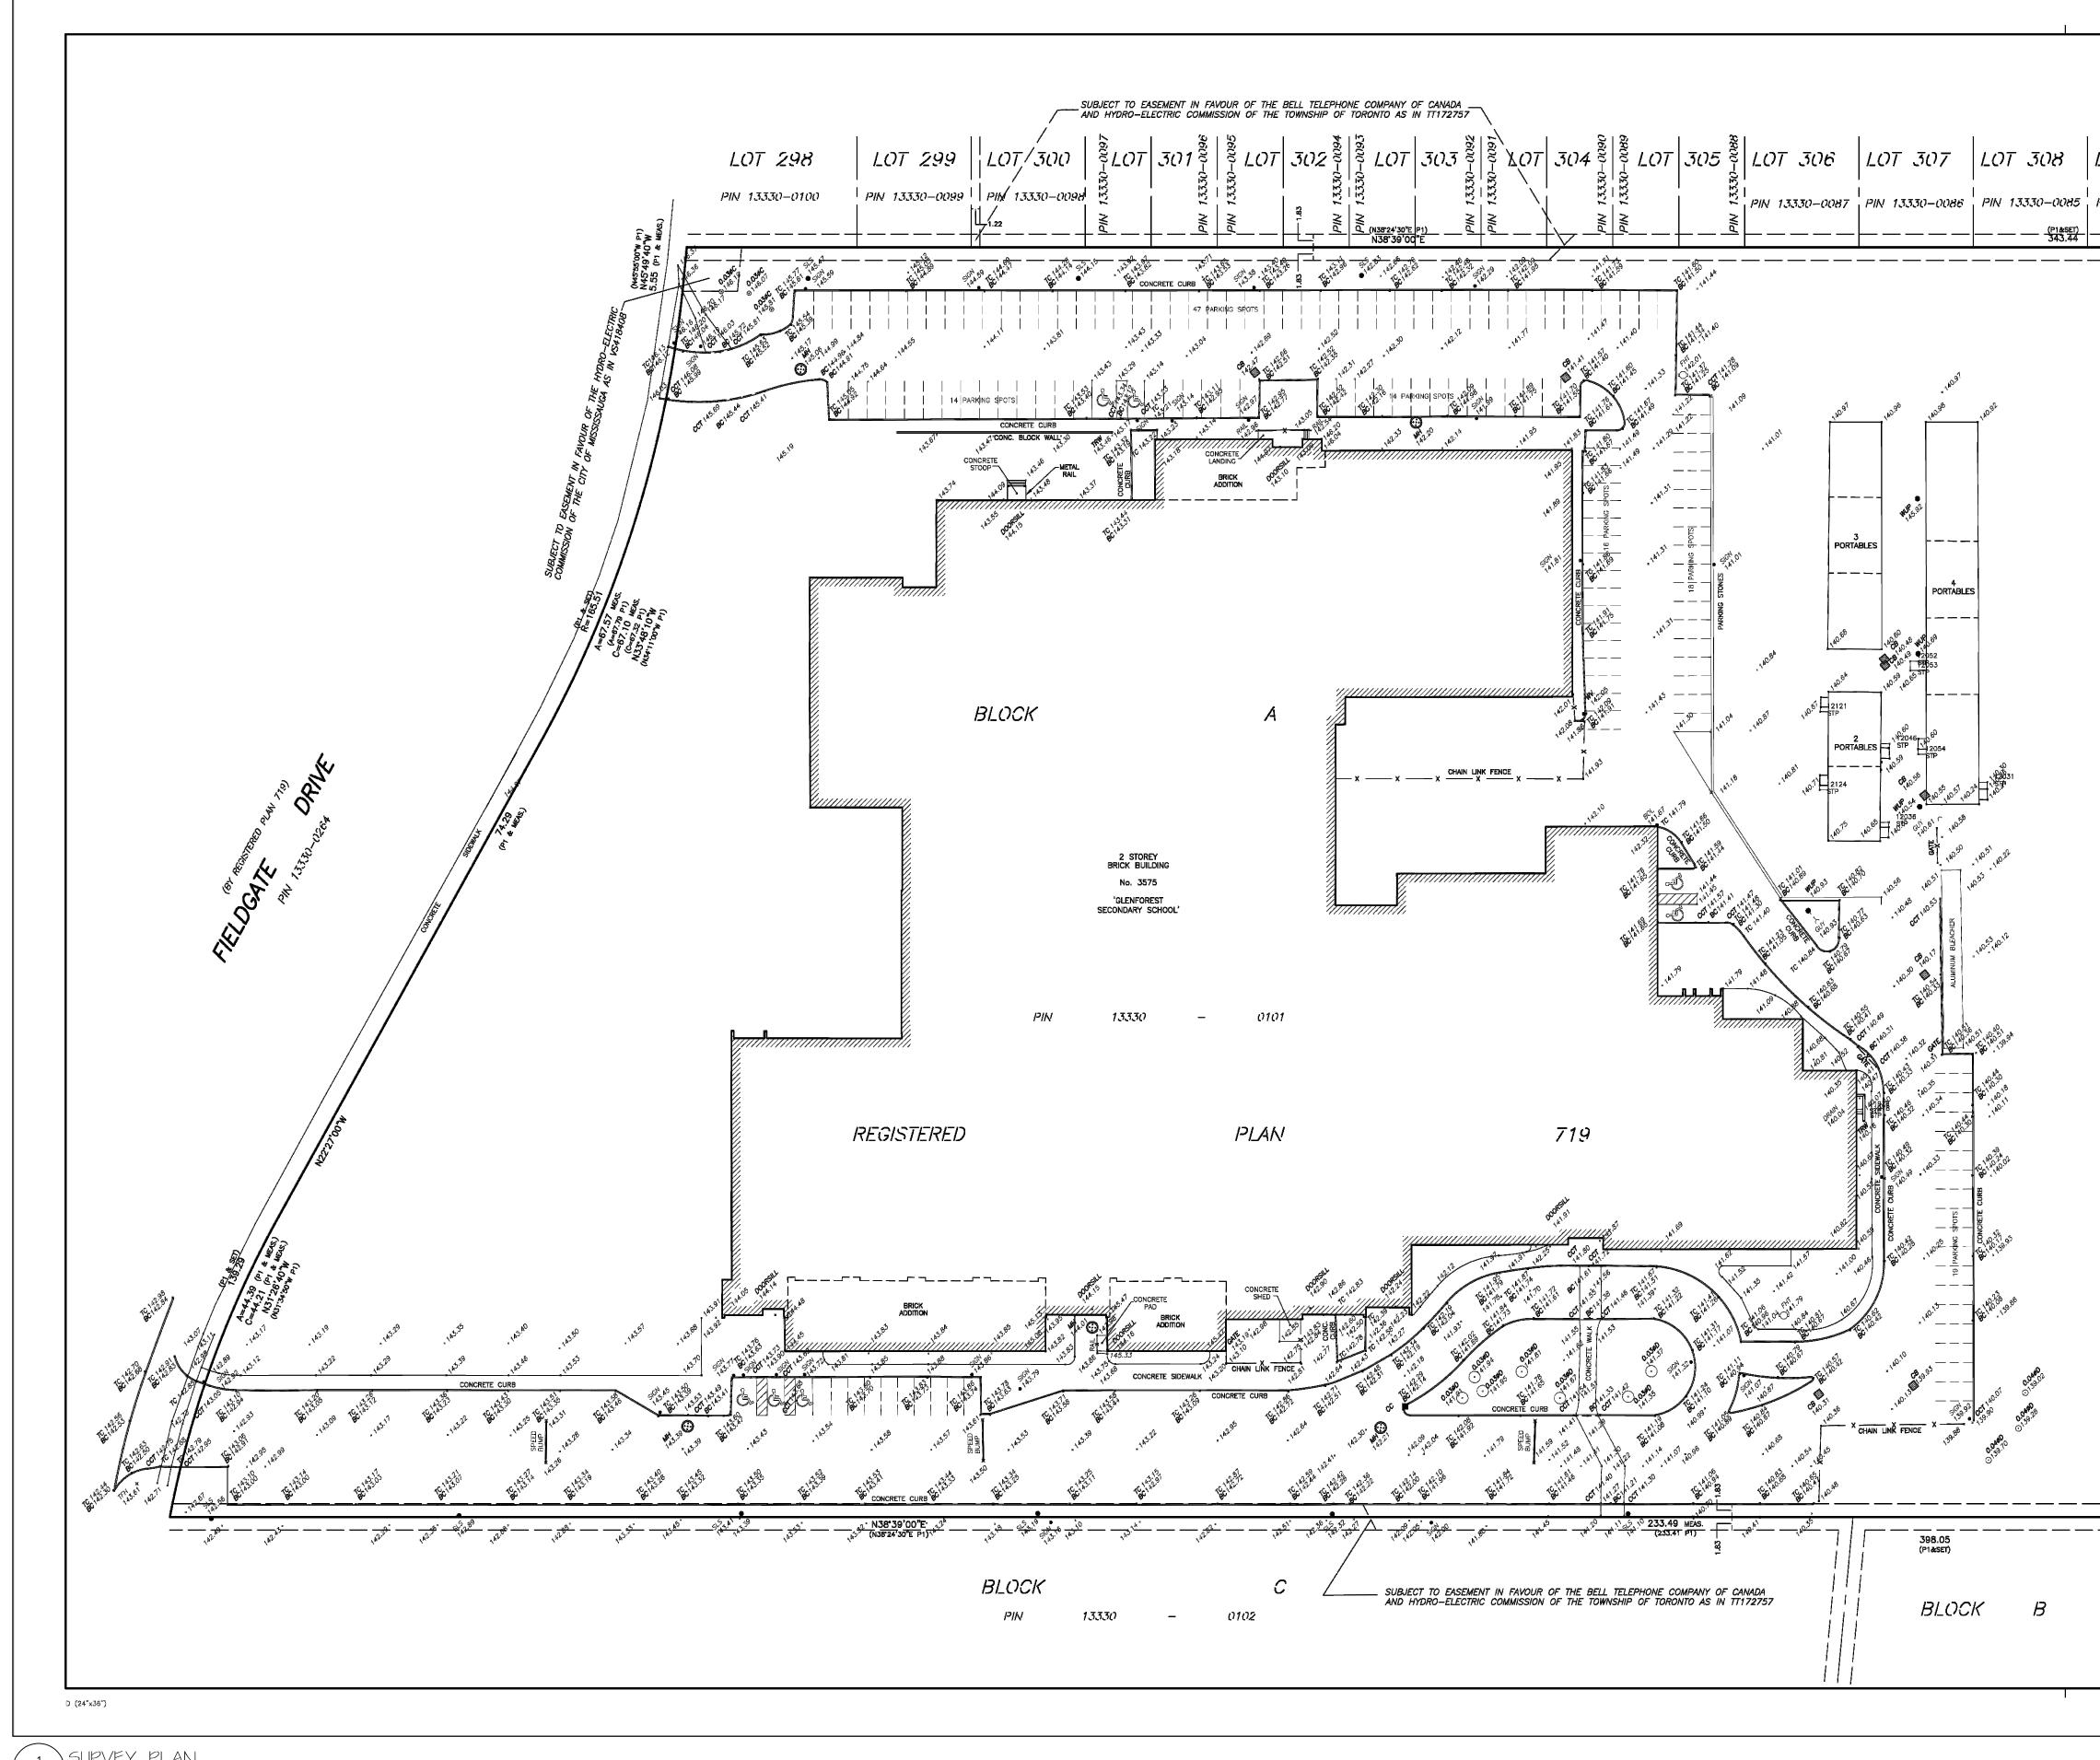

1 SURVEY PLAN A02 SCALE: NTS

VIXX0-0000 BALE 1:400						
	0T 309	PART OF BLOCK A REGISTERED PLAN 719 CITY OF MISSISSAUGA REGIONAL MUNICIPALITY OF PEEL				
	- <u> </u>	10 0 10 20 metres				
		C COPYRIGHT, 2021				
		DISTANCES SHOWN ON THIS PLAN ARE IN METRES AND				
		ELEVATIONS ARE REFERRED TO CANADIAN GEODETIC VERTICAL DATUM-1928, AND WERE DERIVED FROM CITY OF MISSISSAUGA BENCHMARK No. 686,				
		BEARINGS ARE ASTRONOMIC AND ARE REFERRED TO THE EASTERLY LIMIT OF FIELDGATE DRIVE AS SHOWN ON PLAN 719, HAVING A				
		■ DENOTES SURVEY MONUMENT FOUND IB DENOTES IRON BAR SIB DENOTES STANDARD IRON BAR TC DENOTES STOP OF CURB BC DENOTES BOTTOM OF CURB CCT DENOTES CURB CUT MH DENOTES CATCH BASIN FHT DENOTES WOD UTILITY POLE WV DENOTES STEEL VV DENOTES STER INV. DENOTES SILIGHT BOL DENOTES BOLLARD				
	i	• 0.200 DENOTES DECIDUOUS TREE WITH TRUNK DIAMETER				
	(0.200C DENOTES CONIFEROUS TREE WITH TRUNK DIAMETER				APRIL 15, 2024
No. DESCRIPTION DATE SUMPTOR'S CENTIFICATE SUMPTOR'S CENT		TREE CANOPIES ARE DRAWN TO SCALE.				MARCH 26, 2024 NOVEMBER 03, 20
SURVEYOR'S CERTIFICATE I. definition of the second of the secon			1 IS	SUED FOR CLIENT	REVIEW	FEBRUARY 06, 20
SUMMEYOR'S CONTRICATE I 416-200.5779 E 416-200.944 E: Introductoronited I 416-200.5779 E: 416-200.944 E: Introductoronited I 416-200.5779 E: 416-200.944 E: Introductoronited I 416-200.944 E: Introductoro			NO.	DESCRIPTION		DATE
SURVEYOR'S CERTIFICATE I CERTIFY THAT : 1. THE FIELD SURVEY REPRESENTED ON THIS PERFORMATION FED ON JANUARY 11, 2022 JANUARY 12, 2022 DATE JANUARY 12, 2022 DATE DATE ONTARIO LAND SURVEYORS 4181 SLADEVIEW CRESCENT, UNIT 42, MISSISSAUGA, ONTARIO LSL 5R2 TEL: (905) 569-3849 FAIL: office@tmksurveyors.com DRAWN BY: A.G. FILE No. 5814-AS BUILT-21			5650 Tel: (/ Hurontario S (905) 890-10	Street, Mississo 099, Fax: (905	auga, Ont., L5R 1C6
SURVEYOR'S CERTIFICATE I CERTIFY THAT : 1. THE FIELD SURVEY REPRESENTED ON THIS PRIVATION FED ON JANUARY 12, 2022 DATE JANUARY 12, 2022 DATE						
1. THE FIELD SURVEY REPRESENTED ON THIS PROVIDED ON THIS PROVIDED ON JANUARY 11, 2022 3575 FIELDGATE DR., MISSISSAUGA, ON L4X 2J JANUARY 12, 2022 JANUARY 12, 2022 DITUTUTUTUTUTUTUTUTUTUTUTUTUTUTUTUTUTUTU						
JANUARY 12, 2022 Diversion of the provided of th		1. THE FIELD SURVEY REPRESENTED ON THIS PLANNINGS PROMPLETED				
TARASICK McMILLAN KUBICKI LIMITED ONTARIO LAND SURVEYORS 4181 SLADEVIEW CRESCENT, UNIT 42, MISSISSAUGA, ONTARIO L5L 5R2 FAX: (905) 569-8849 TEL: (905) 569-8849 FAX: (905) 569-3160 E-MAIL: office@tmksurveyors.com DRAWN BY: A.G. FILE No. 5814-AS BUILT-21		JANUARY 12, 2022 DATE BORYS SUBACK)LITION	
4181 SLADEVIEW CRESCENT, UNIT 42, MISSISSAUGA, ONTARIO L5L 5R2 TEL: (905) 569–8849 FAX: (905) 569–3160 E-MAIL: office@tmksurveyors.com Graphic Scale Sheet no. DRAWN BY: A.G. FILE No. 5814–AS BUILT–21 Drawn Checked AO22		TARASICK MCMILLAN KUBICKI LIMITED			/ey plai	Ν
A02		4181 SLADEVIEW CRESCENT, UNIT 42, MISSISSAUGA, ONTARIO L5L 5R2 TEL: (905) 569–8849 FAX: (905) 569–3160	Graphic	Scale		Sheet no.
CAD File Scale		DRAWN BY: A.G. FILE No. 5814-AS BUILT-21	Drawn		Checked	
			CAD File	, :	Scale	
Date Project No. Revision No.						

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5	ISSUED FOR TENDER	APRIL 10, 2024
4	ISSUED FOR PRE-TENDER REVIEW	MARCH 26, 2024
3 2	ISSUED FOR SPA	JANUARY 05, 2024 NOVEMBER 03, 2023
1	ISSUED FOR CLIENT REVIEW	FEBRUARY 06, 2023
N0.	DESCRIPTION	DATE
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	peel District School Bo	oard
	50 Hurontario Street, Mississauga, Ont. : (905) 890—1099, Fax: (905) 890—94	
		FS INC.
30 KI	ERN ROAD, SUITE 106, TORONTO, ONTA 226.5779 F: 416.226.9844 E: info@etudo	RIO M3B 111
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	ENFOREST POOL	
	ENFOREST SECONDAR FIELDGATE DR., MISSISSAUGA, ON	

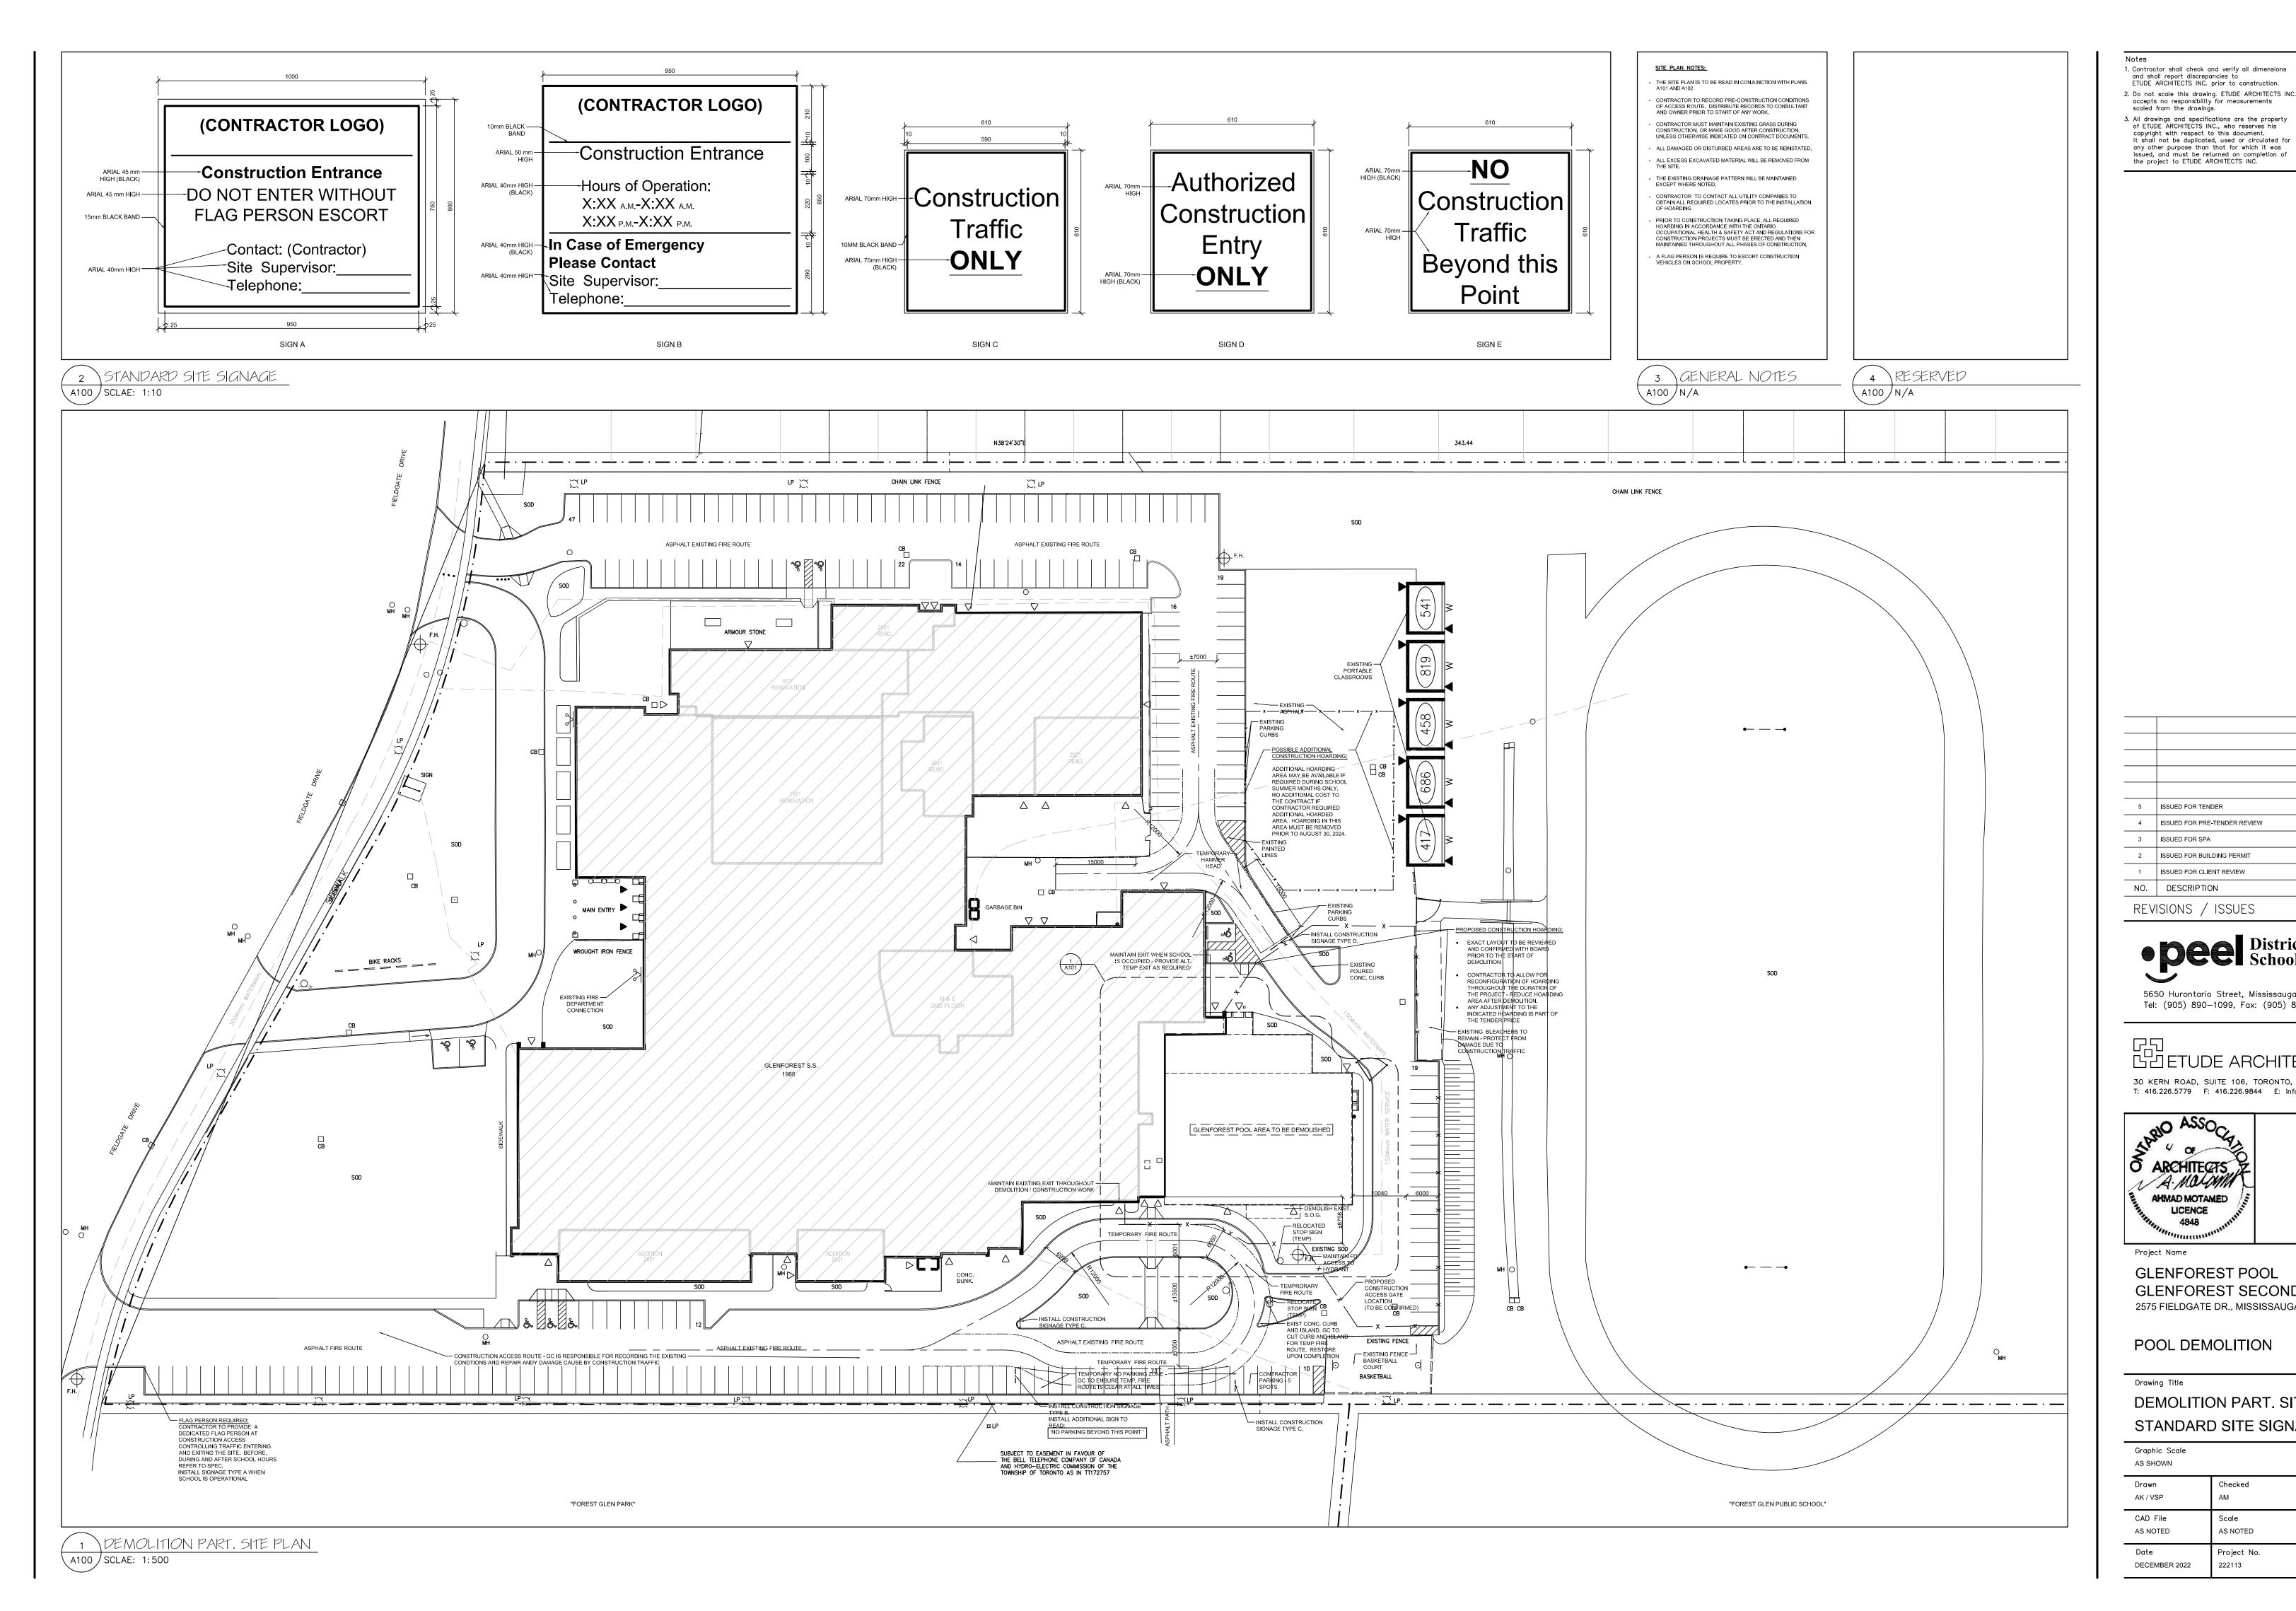Notes

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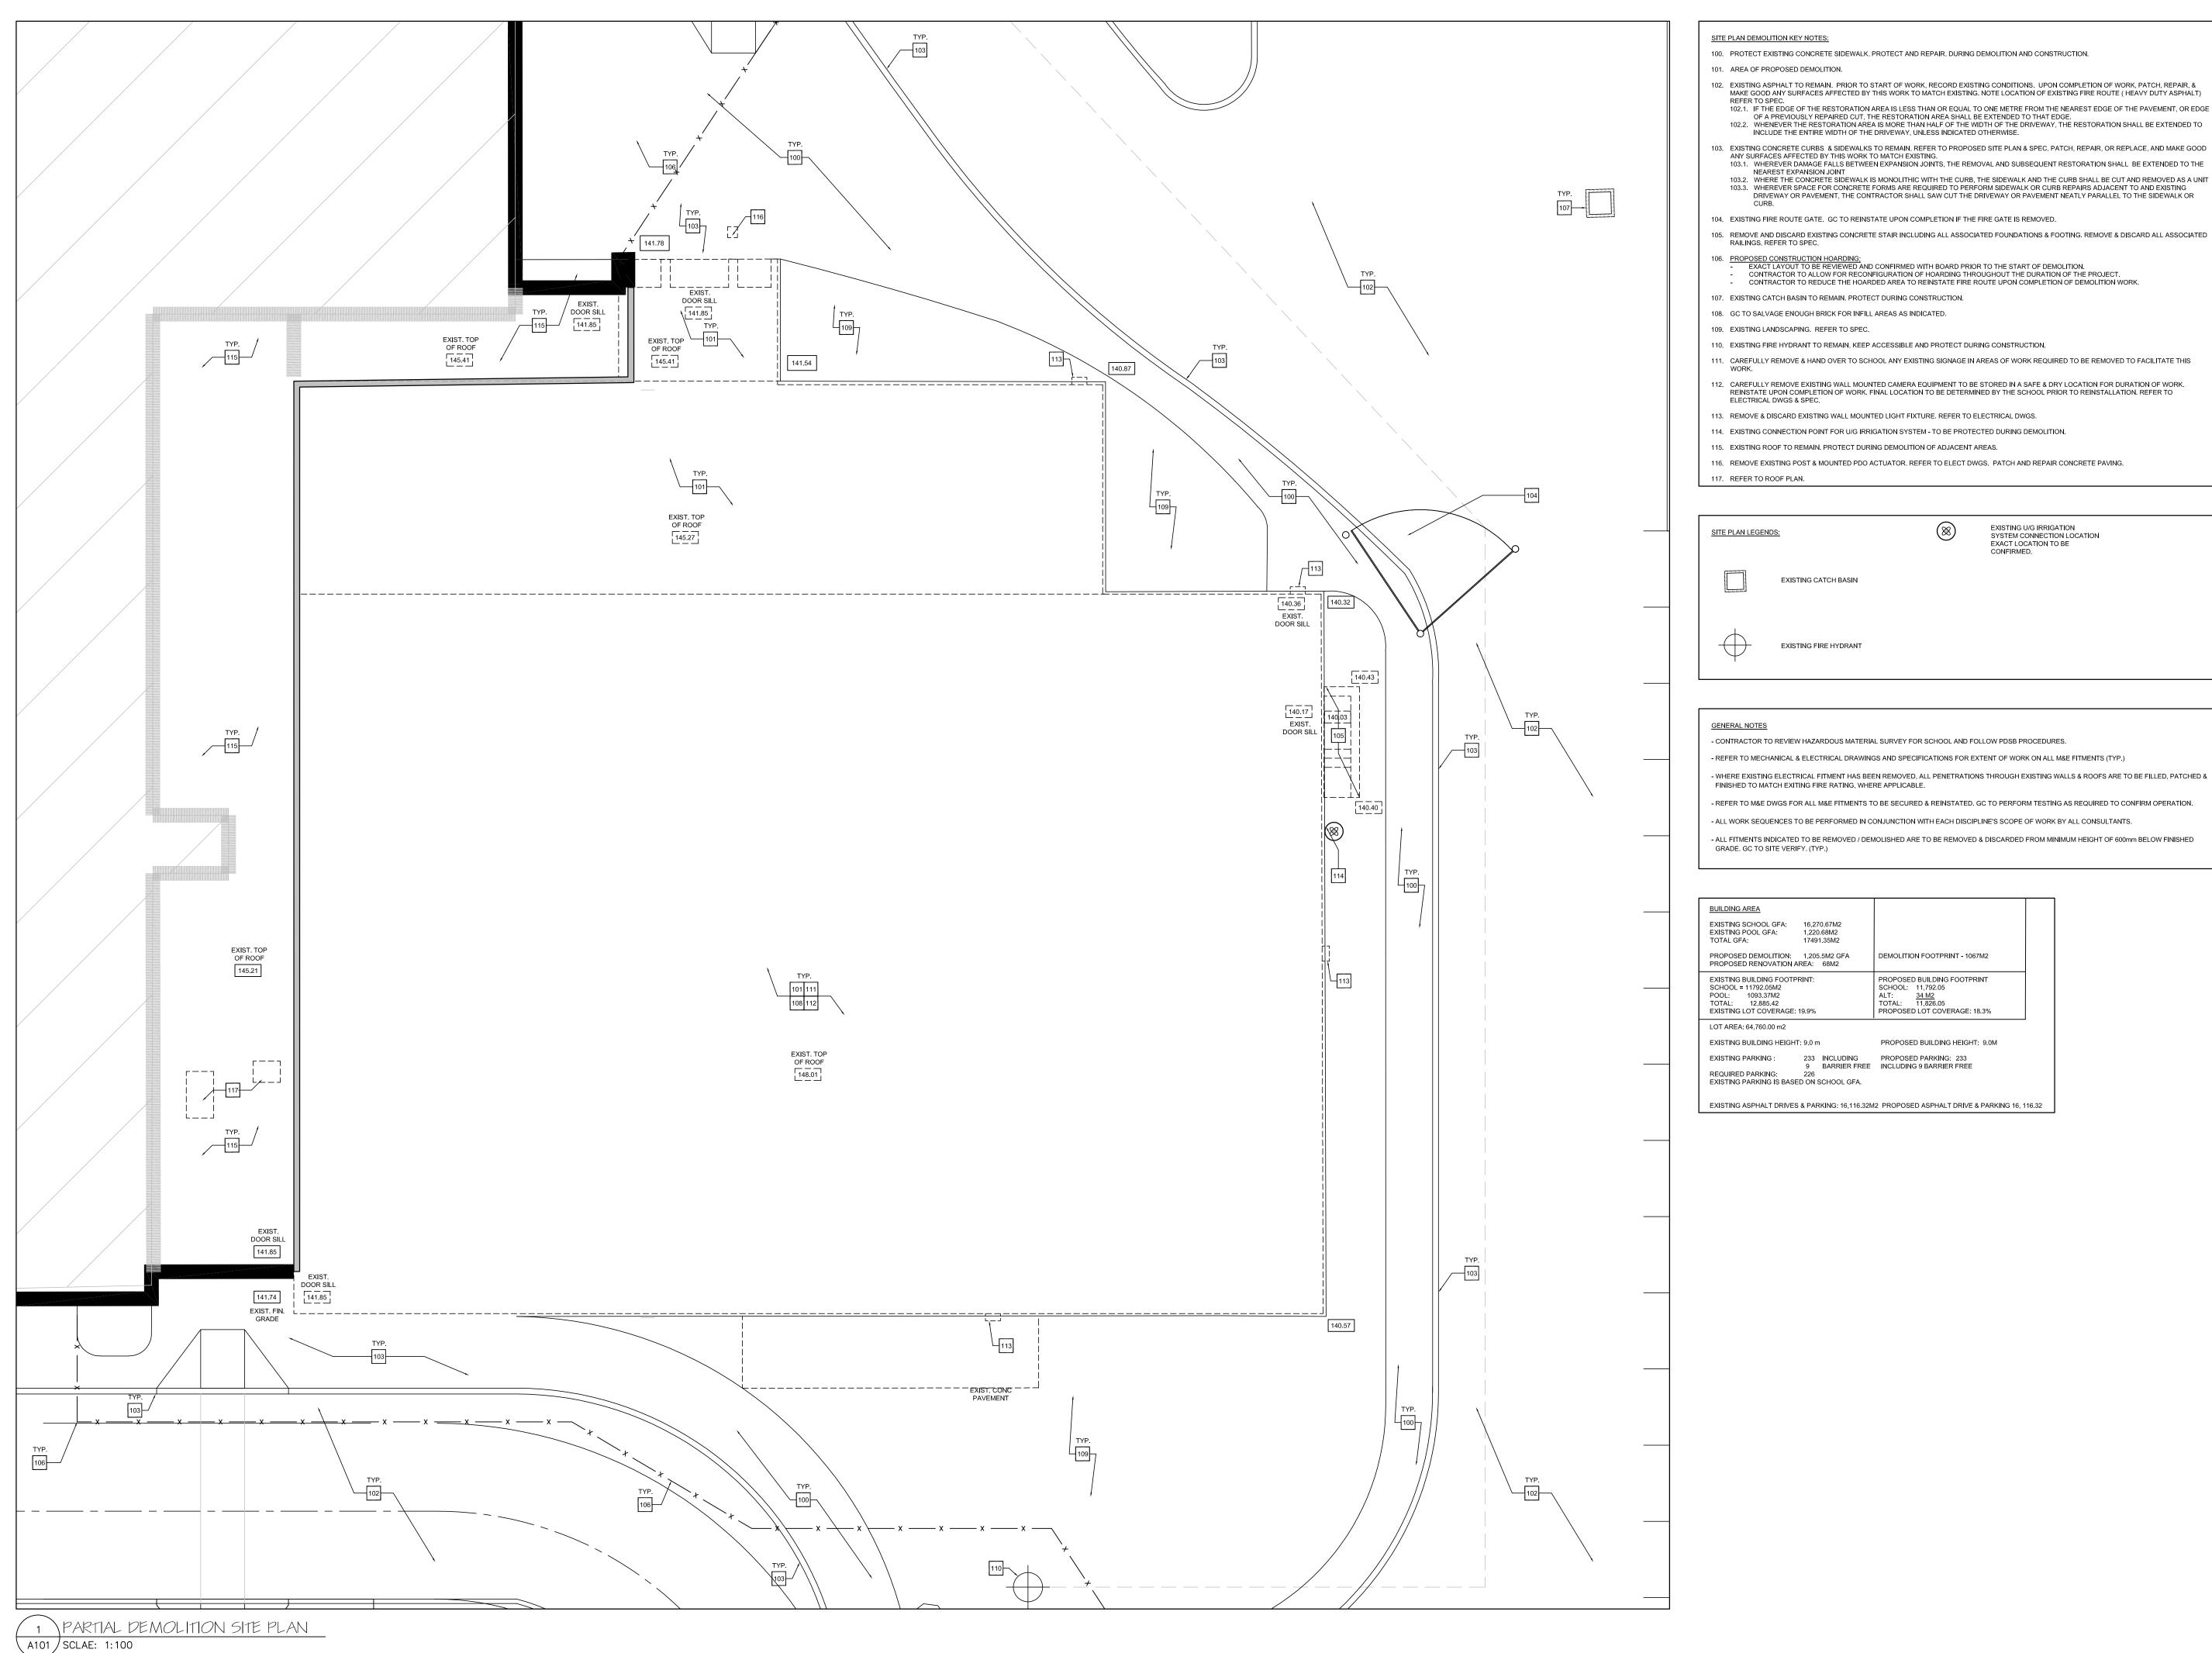
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Drawing North True

North

POOL DEMOLITION


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STANDARI	STANDARD SITE SIGNAGE				
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AS NOTED	AS NOTED				
Date	Project No.	Revision No.			
DECEMBER 2022	222113				



1. Contractor shall check and verify all dimensions and shall report discrepancies to ETUDE ARCHITECTS INC. prior to construction.

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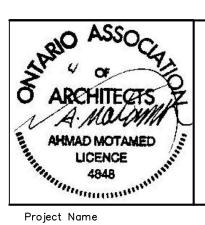
5	ISSUED FOR TENDER	APRIL 10, 2024	
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1	ISSUED FOR CLIENT REVIEW	FEBRUARY 06, 2023	
NO.	DESCRIPTION DATE		
REVISIONS / ISSUES			

 $\mathsf{REVISIONS} / \mathsf{ISSUES}$

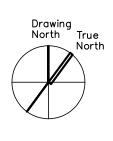

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GLENFOREST POOL GLENFOREST SECONDARY SCHOOL 2575 FIELDGATE DR., MISSISSAUGA, ON L4X 2J6


POOL DEMOLITION

Drawing Title

PARTIAL DEMOLITION SITE PLAN


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Drawn AK / VSP	Checked AM	A101
CAD File AS NOTED	Scale AS NOTED	
Date DECEMBER 2022	Project No. 222113	Revision No.

REFER TO M&E DWGS FOR ALL M&E FITMENTS TO BE SECURED & REINSTATED. GC TO PERFORM TESTING AS REQUIRED TO CONFIRM OPERATION.

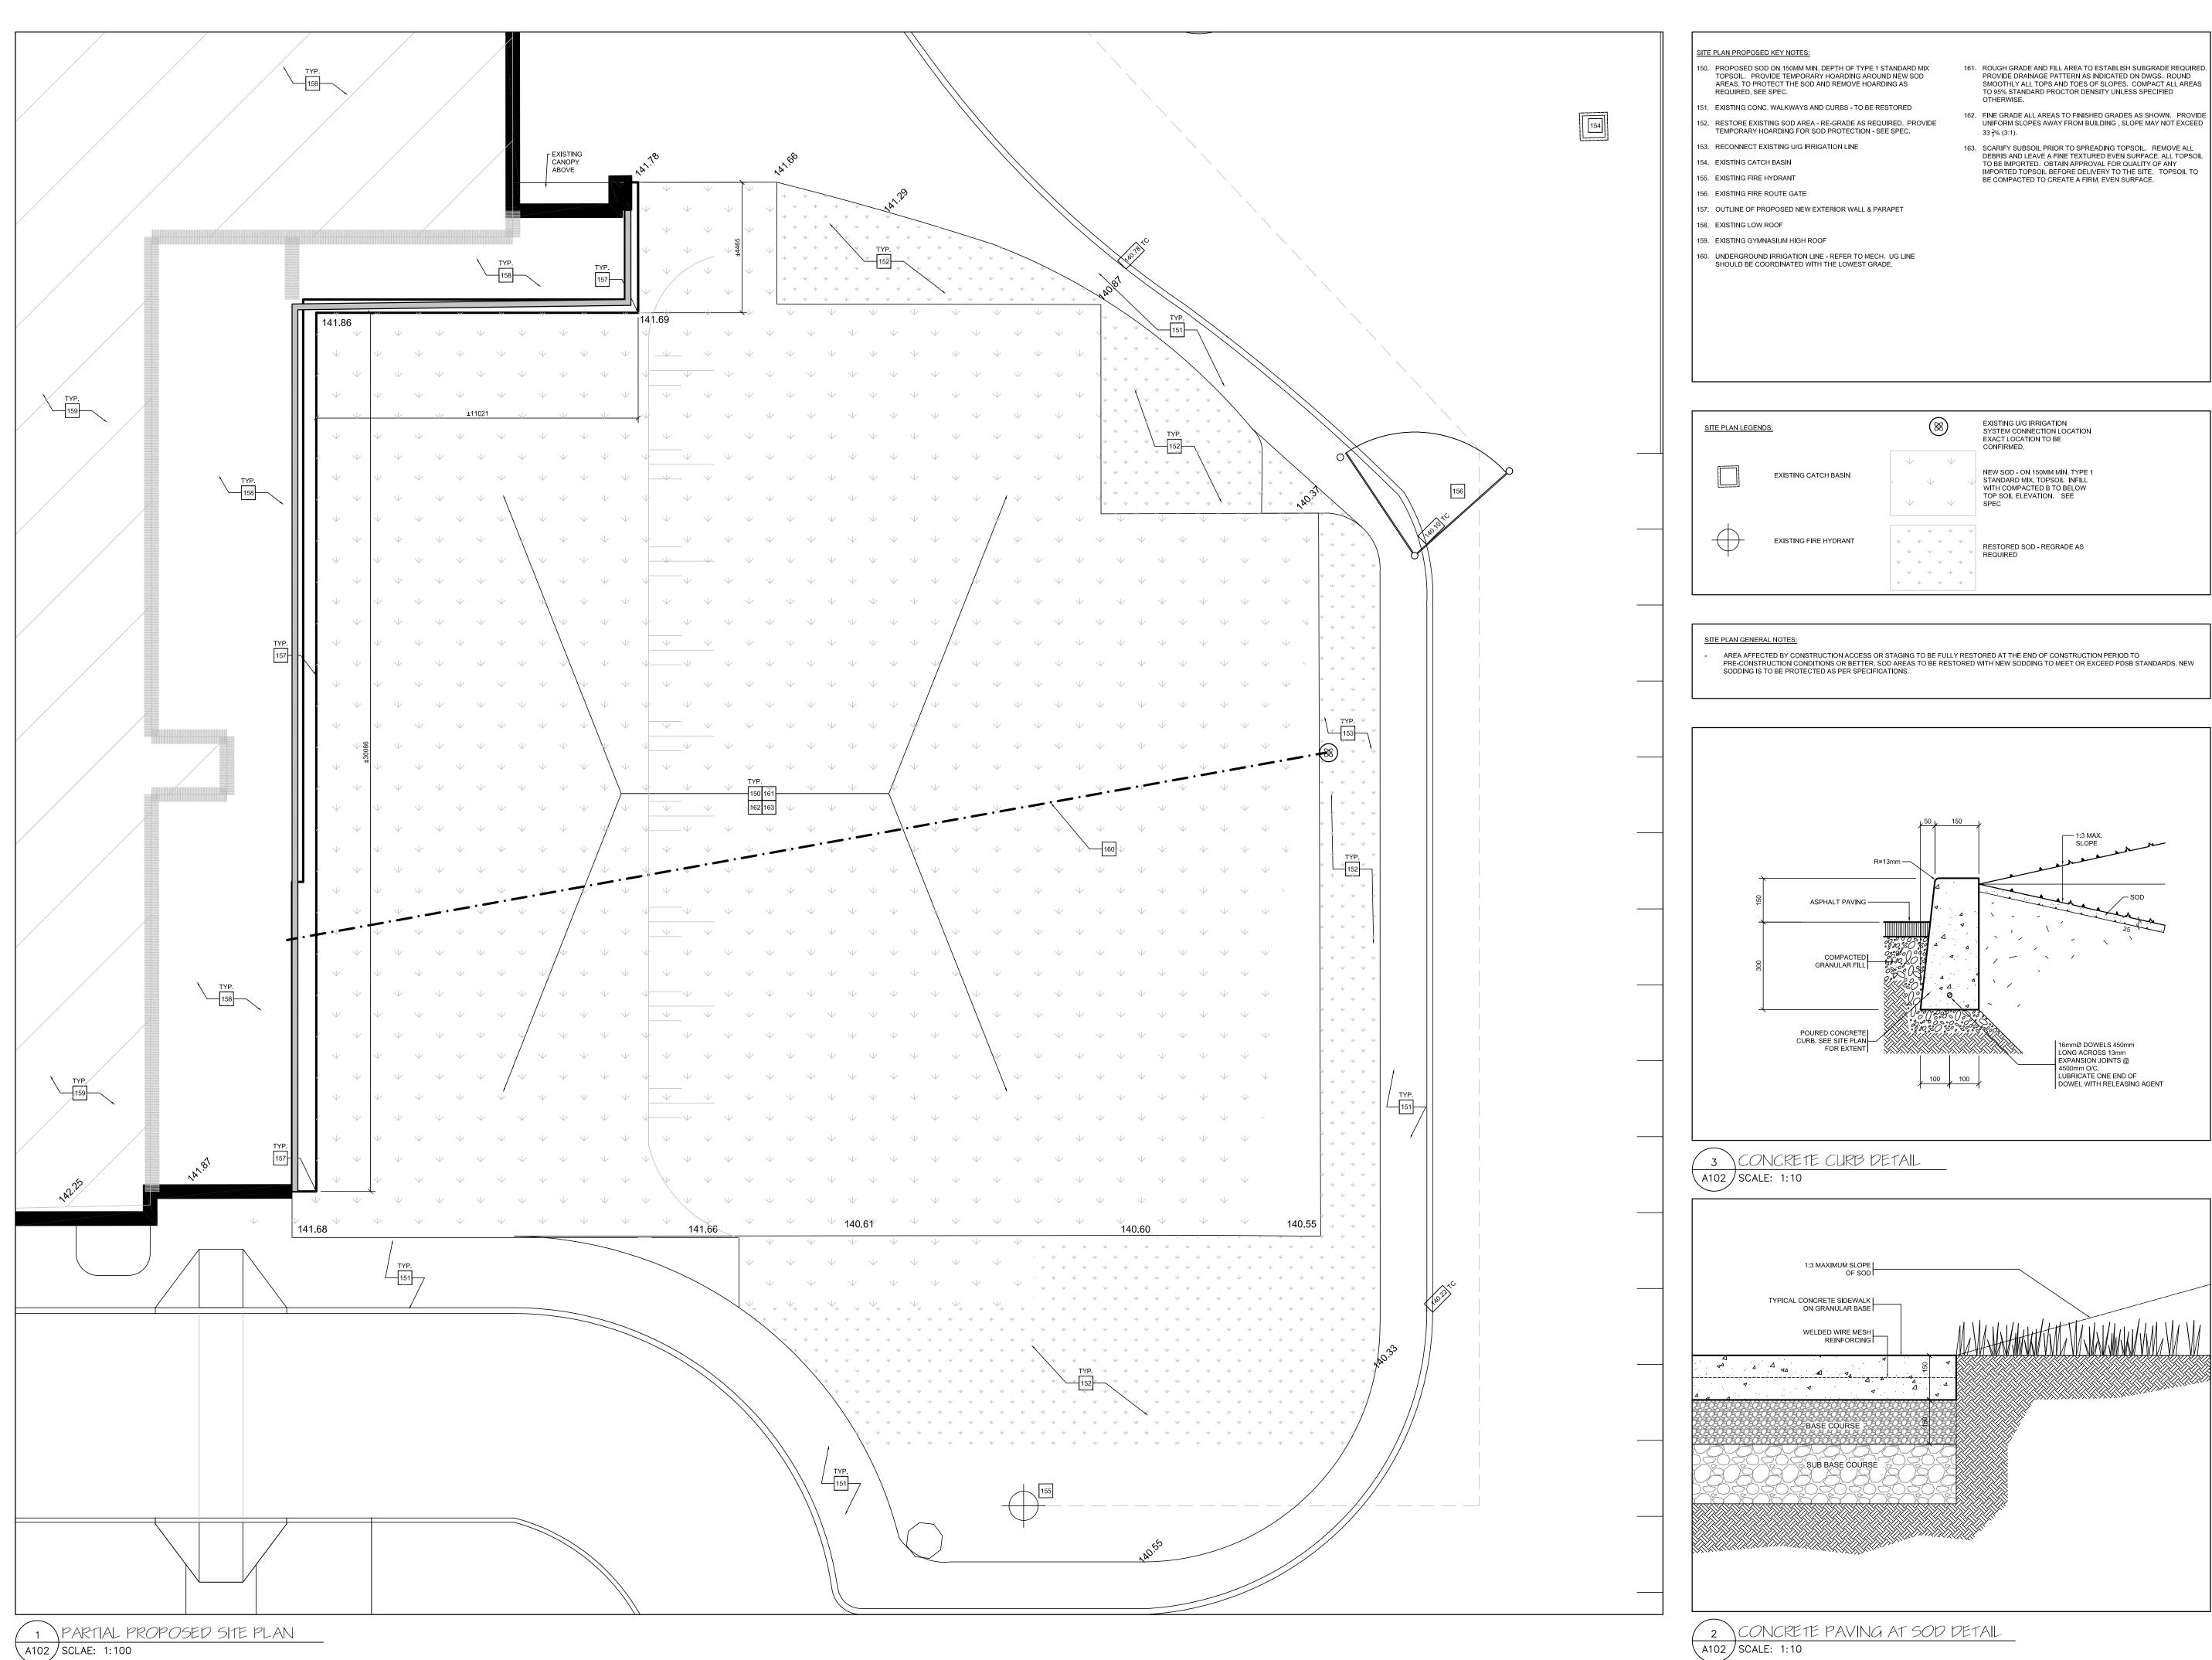

A102 SCLAE: 1:100

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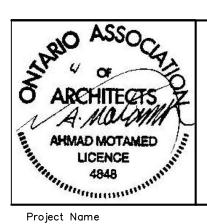

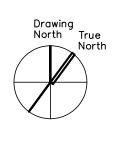
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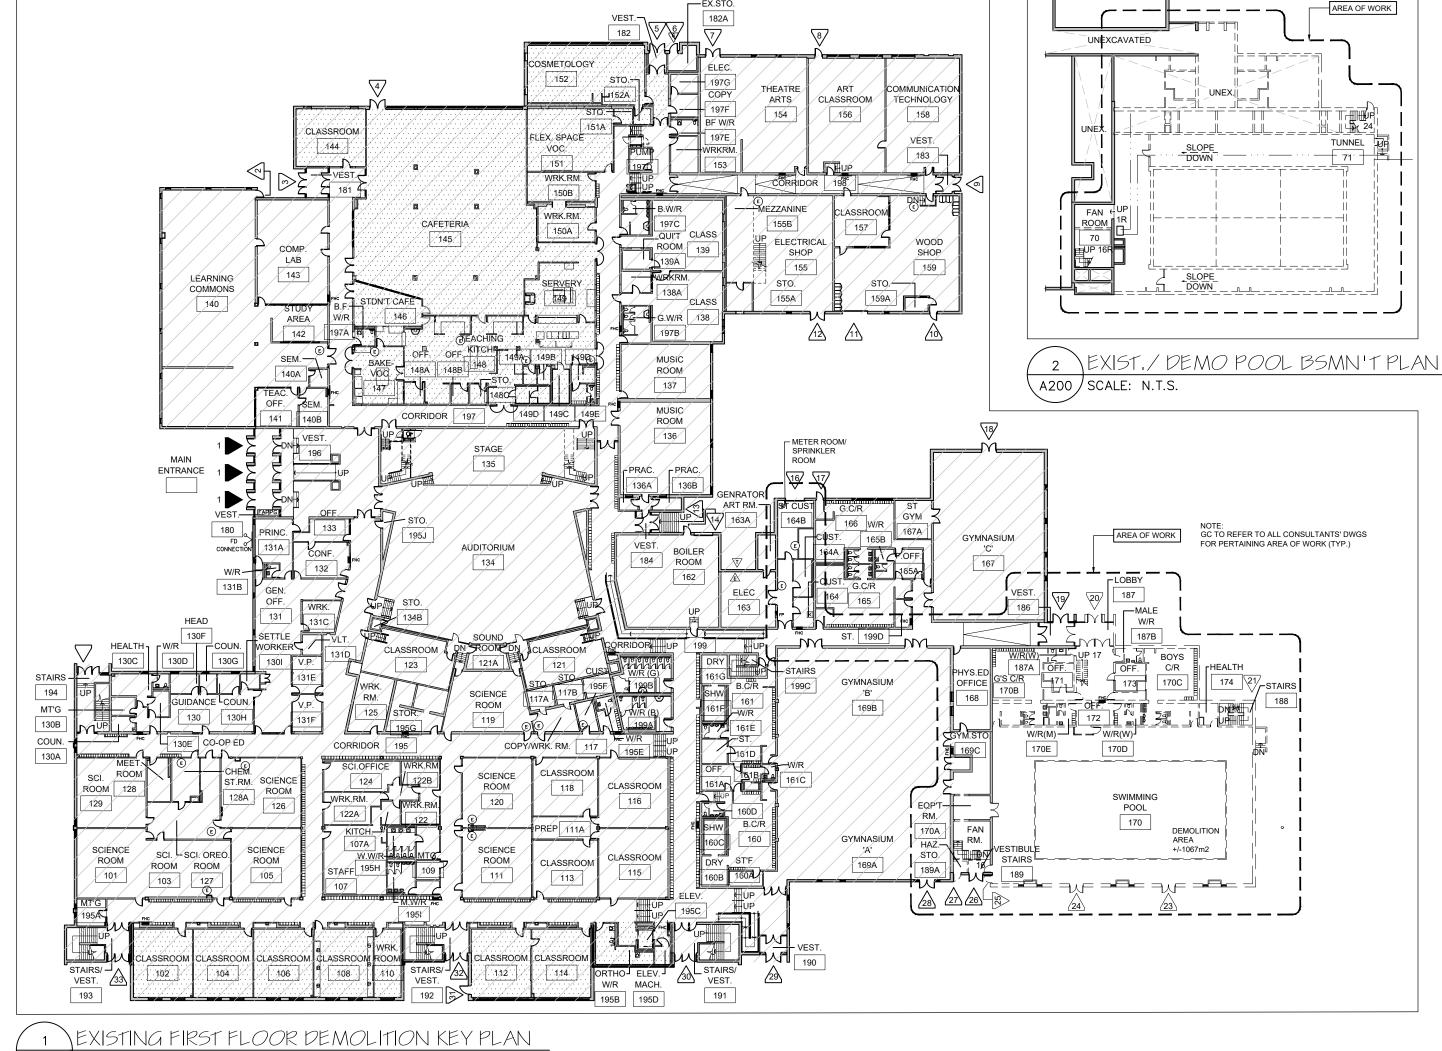


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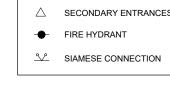
POOL DEMOLITION


Drawing Title PROPOSED PARTIAL SITE PLAN & SITE DETAILS Graphic Scale Sheet no.

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Drawn AK / VSP	Checked AM	A102
CAD File AS NOTED	Scale AS NOTED	
Date DECEMBER 2022	Project No. 222113	Revision No.



A200 SCALE: N.T.S.



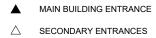

- TRANSFORMER VAULT
- KEY BOX
- FIRE PROTECTION CONTROL VALVES \otimes
- Intersection Control Contro
- A MAIN ELECTRICAL PANEL
- FIRE ALARM ANNUNCIATOR PANEL and GRAPHIC FA FIRE ALARM CONTROL PANEL


LEGEND


AREA OUTSIDE OF SCOPE OF WORK

AREA OUTSIDE OF

SCOPE OF WORK



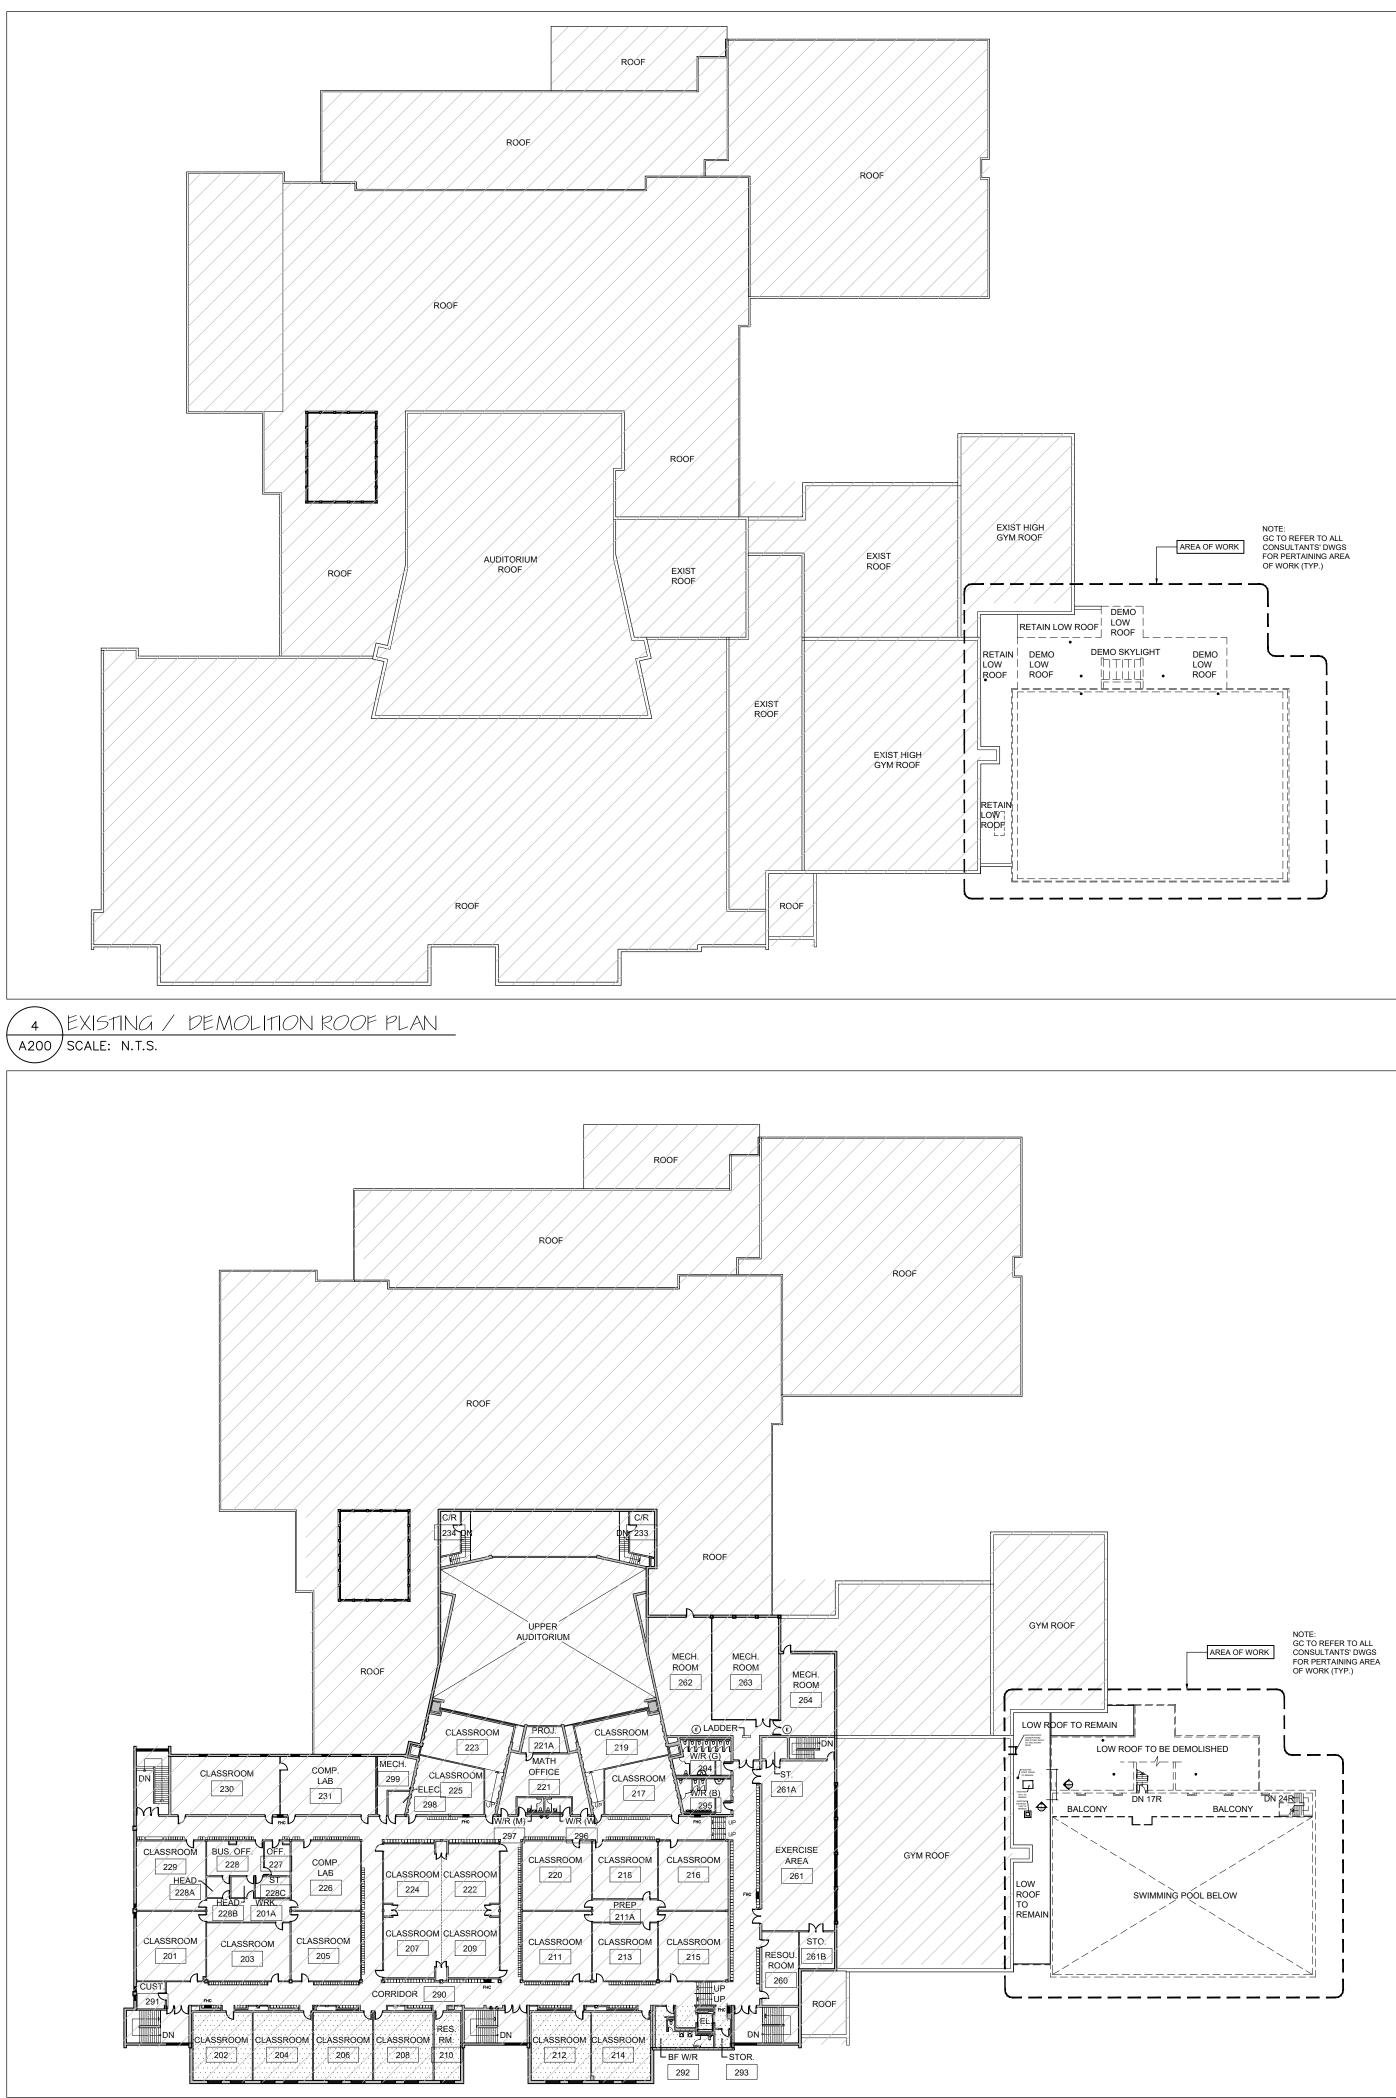

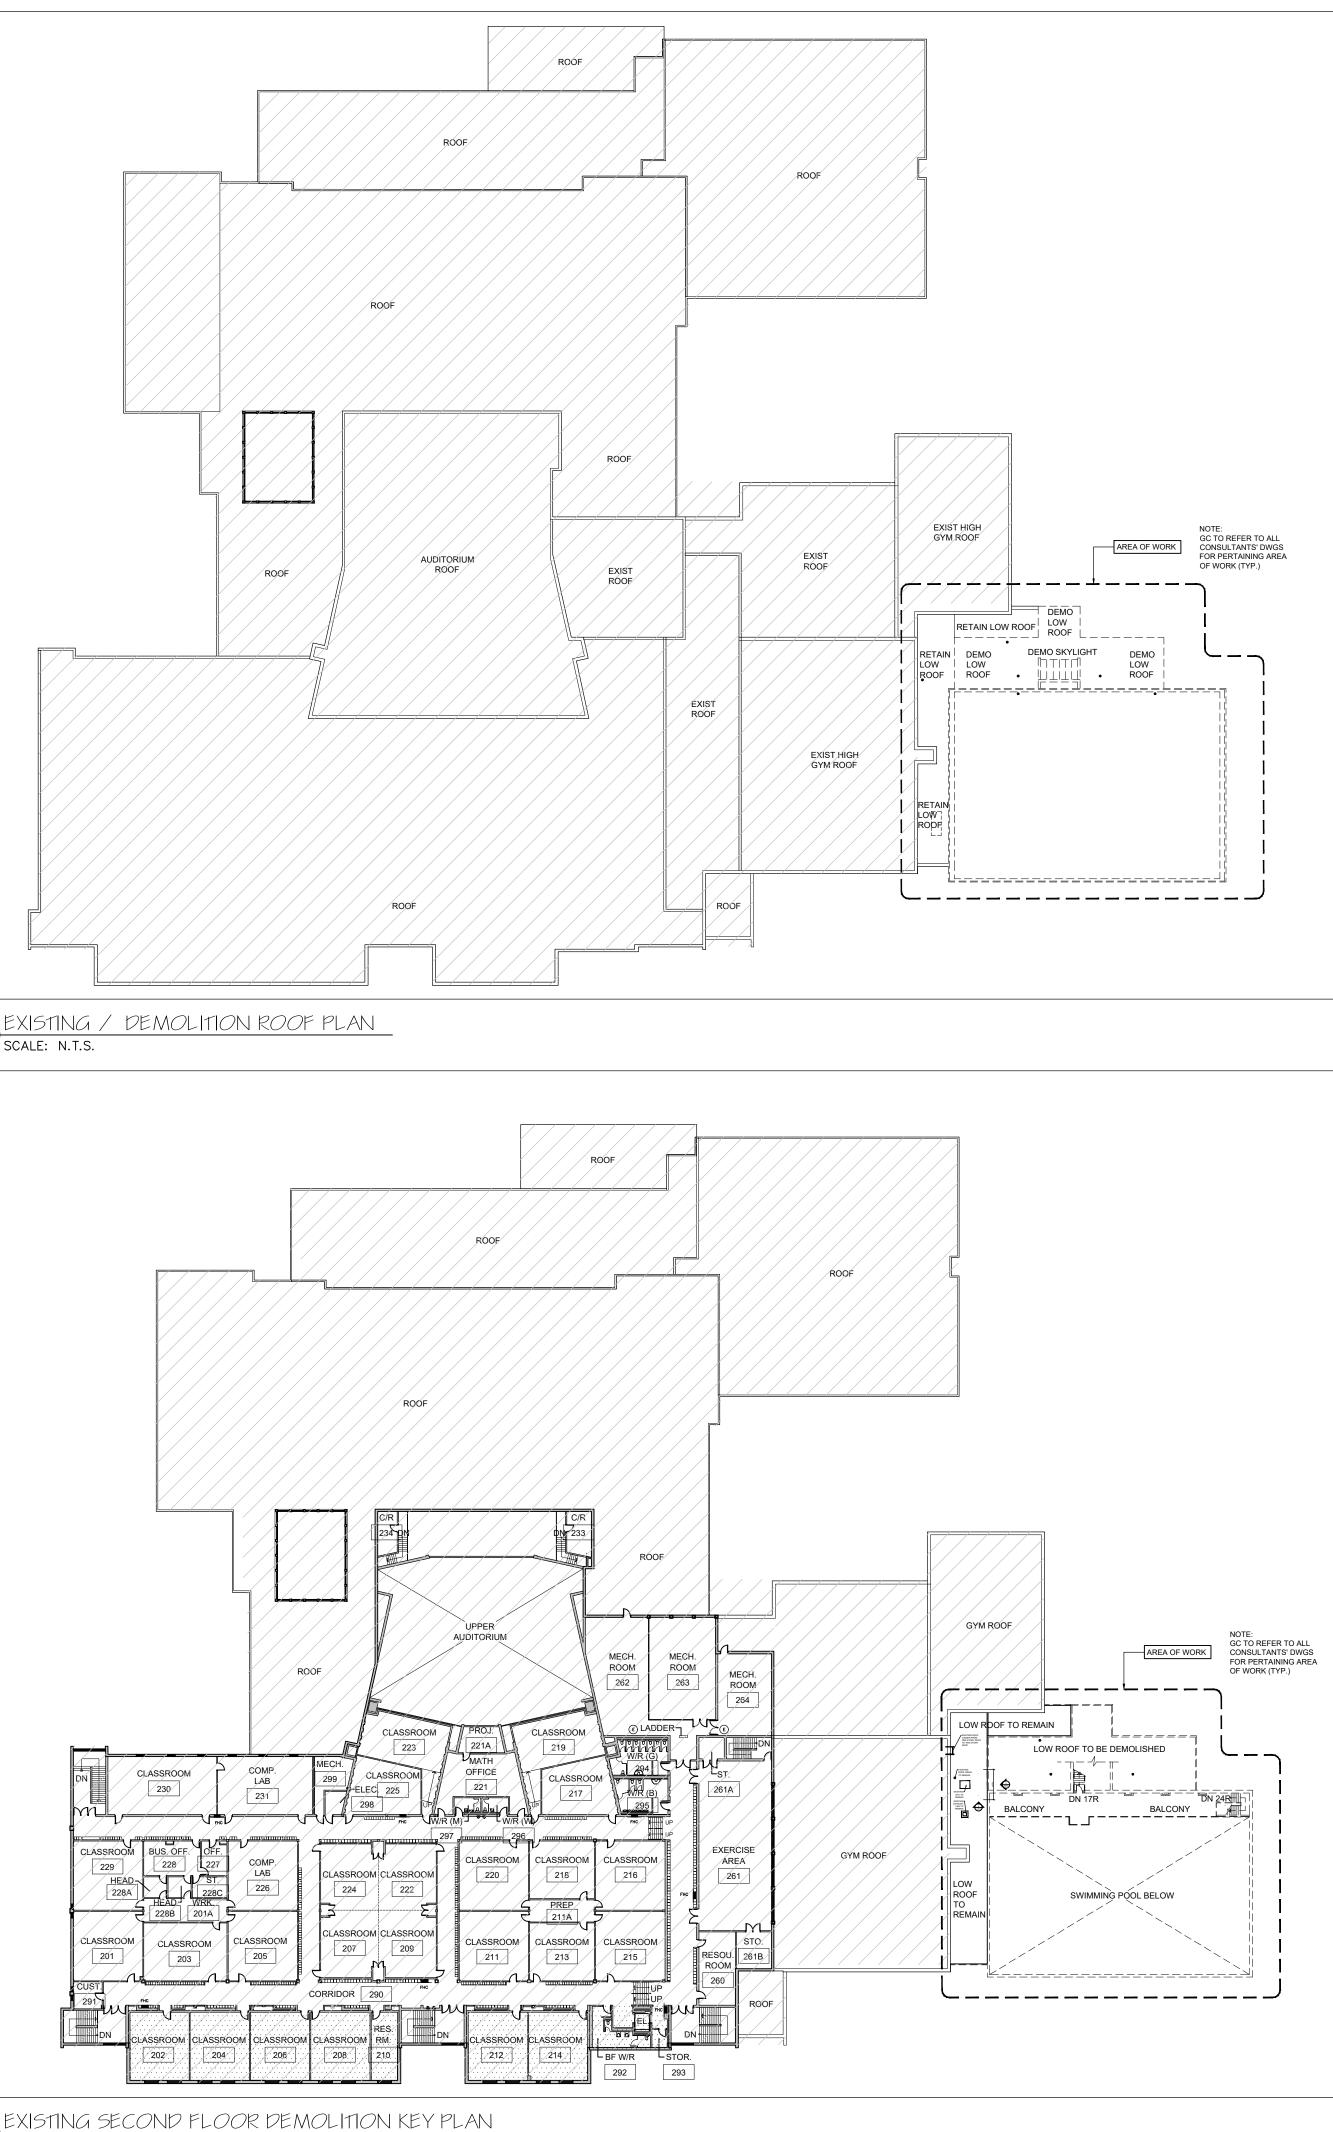

3 A200 SCALE: N.T.S. Notes 1. Contractor shall check and verify all dimensions and shall report discrepancies to ETUDE ARCHITECTS INC. prior to construction.

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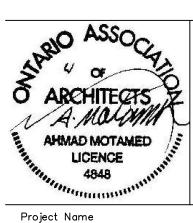
Drawing North True North

5	ISSUED FOR TENDER	MARCH 26, 2024
4	REISSUED FOR FIRE DEPARTMENT REVIEW	MARCH 19, 2024
3	ISSUED FOR SPA	JANUARY 05, 2024
2	ISSUED FOR BUILDING PERMIT	NOVEMBER 03, 202
1	ISSUED FOR CLIENT REVIEW	FEBRUARY 06, 202
NO.	DESCRIPTION	DATE



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GLENFOREST POOL

GLENFOREST SECONDARY SCHOOL 3575 FIELDGATE DR., MISSISSAUGA, ON L4X 2J6

POOL DEMOLITION


Drawing Title

EXISTING / DEMOLITION KEY PLANS & ROOF PLAN

Graphic Scale Sheet no. AS SHOWN Drawn Checked A200 AK / VSP AM _____ CAD File Scale AS NOTED AS NOTED Date Project No. Revision No. DECEMBER 2022 222113

DEMOLITION BASEMENT PLAN KEY NOTES

- 200. REFER TO ABATEMENT SCOPE OF WORK. PERFORM ABATEMENT WORK PRIOR TO OTHER DEMOLITION SCOPE.
- 201. EXISTING WALL/ COLUMN/ STRUCTURE TO REMAIN. PROTECT DURING CONSTRUCTION AS REQUIRED. REFER TO STRUCTURAL DWGS.
- 202. REMOVE ALL DECOMMISSIONED EQUIPMENT IN THE POOL TUNNELS AND FAN ROOM AREA. REFER TO MECHANICAL & ELECTRICAL DRAWINGS.
- EXISTING CONCRETE FOOTING TO REMAIN. SAWCUT TO INTERRUPT CONTINUOUS SECTIONS. PROTECT & PREPARE WHERE REQUIRED, TO RECEIVE NEW / ADDITIONAL FOUNDATION WALL, IF INDICATED. REFER TO 203. STRUCTURAL DRAWINGS.
- EXISTING POOL FOUNDATION WALL TO BE DEMOLISHED AND REMOVED . 204.
- 205. EXIST. POOL, C/R, LOBBY, BALCONY, OFFICE, W/R, STAIRS AREA TO BE DEMOLISHED AS INDICATED. FOUNDATION WALLS TO BE DEMOLISHED TO MIN. 600mm BELOW FIN. GRADE UNLESS NOTED OTHERWISE.
- 206. REMOVE & DISCARD ALL STRUCTURES MINIMUM OF 600mm BELOW FINISHED GRADE. SITE VERIFY. (TYP.)
- EXISTING STAIRS, RAILING, FDN. WALLS AND FOOTINGS ASSEMBLIES TO BE DEMOLISHED & DISCARDED. ALL FITMENTS TO BE REMOVED TO MINIMUM OF 600mm BELOW FINISHED GRADE. SITE VERIFY. (TYP.) 207.
- 208. PREPARE EXISTING SUMP PUMP PIT TO BE INFILLED. SEE MECHANICAL & STRUCTURAL DWG.
- 209. CUTBACK EXIST. SLAB & FLOORING ABOVE AT CORRIDOR AS REQ'D TO INSTALL NEW FOUNDATION WALL AND FOOTING AS INDICATED. DEPTH OF SLAB CUTBACK TO BE ESTIMATED IN CONJUNCTION WITH AREA REQUIRED TO PERFORM NEW PROPOSED FOUNDATION WALL INSTALLATION SUPPORTING NEW EXTERIOR WALL ABOVE. REFER TO STRUCTURAL DRAWINGS.
- 210. EXISTING IRRIGATION SYSTEM CONTROL BOX. MARK LOCATION AND PROTECT PIPING FOR FUTURE CONNECTION.
- CAREFULLY DISASSEMBLE, REMOVE & DISPOSE OF EXIST. STEEL STAIRS & RAILINGS ASSEMBLIES IN EXIST. FAN ROOM AS INDICATED. PATCH, REPAIR & MAKE GOOD ALL AFFECTED SURFACES TO MATCH EXIST. CONDITION. 211.
- UPON COMPLETION OF ALL REQUIRED REMOVAL, REROUTING / RECONNECTION, PATCH AND/OR REPAIR WORKS PERFORMED, GC TO INFILL EXIST. FAN ROOM AS INDICATED AND PREPARE TO RECEIVE NEW FLOORING ABOVE TO 212. BE CONNECTED TO ADJACENT FLOORING AT GROUND FLOOR LEVEL. REFER TO ALL CONSULTANTS' DWGS & SPEC.
- 213. EXISTING 200MM REINFORCED CONC. POOL BOTTOM SLAB TO BE DEMOLISHED AND REMOVED.

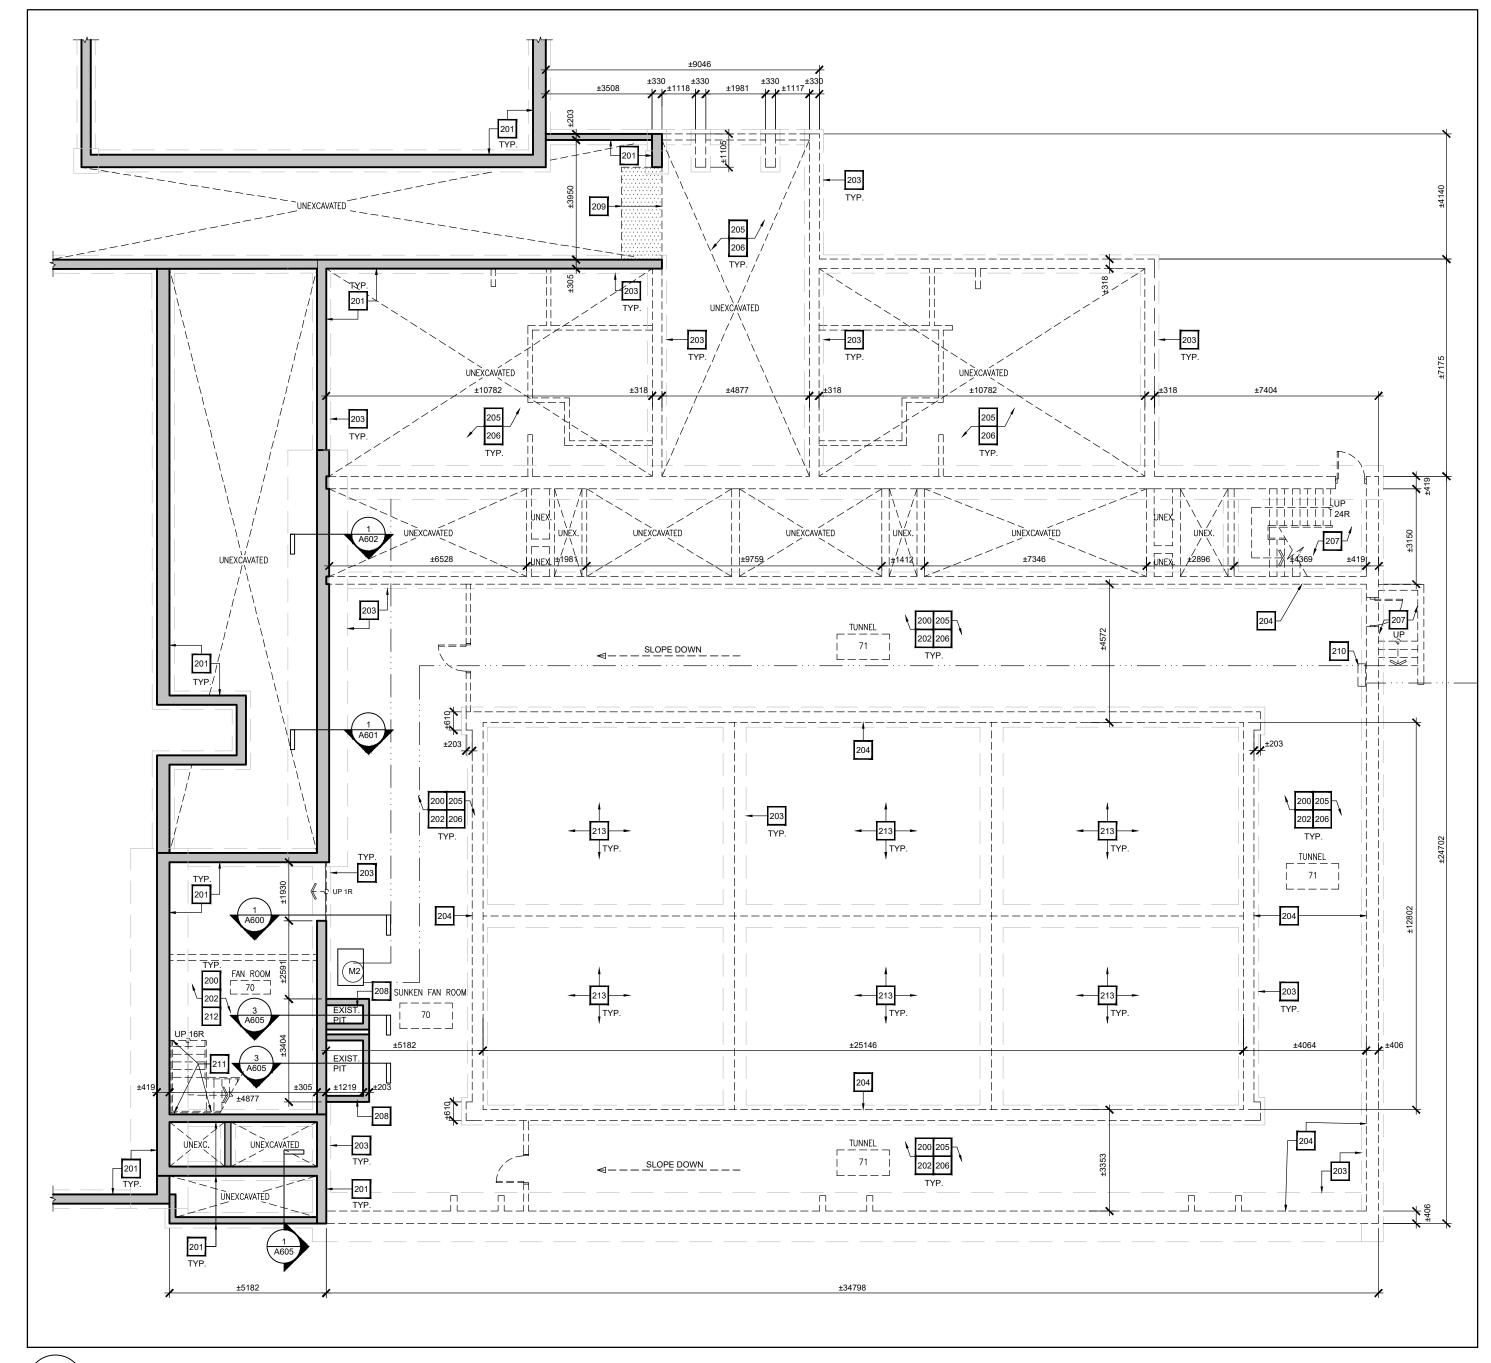

GENERAL NOTES

- CONTRACTOR TO REVIEW HAZARDOUS MATERIAL SURVEY FOR SCHOOL AND FOLLOW PDSB PROCEDURES.

- REFER TO MECHANICAL & ELECTRICAL DRAWINGS AND SPECIFICATIONS FOR EXTENT OF WORK ON ALL M&E FITMENTS (TYP.)

- GC TO REMOVE GYP. BD. CEILING TO ALLOW FOR M&E RENOVATION WORK AS REQUIRED.

REPAIR CEILING AT COMPLETION OF WORK TO MATCH EXISTING.

- CONFIRM CEILING LAYOUT & HEIGHT ON SITE. ENSURE EXISTING FIRE RATED CEILING IS MAINTAINED WHERE EXISTING.

- WHERE SPRAY APPLIED FIREPROOFING IS ENCOUNTERED. GC TO ENSURE THAT ANY DISTURBED AREAS ARE RESTORED PRIOR TO CLOSING CEILINGS. PROVIDE INSPECTION REPORT.

- WHERE EXIST. ELEC. FITMENT HAS BEEN REMOVED, ALL PENETRATIONS THROUGH EXIST. WALLS & CEILINGS ARE TO BE FILLED, PATCHED & FINISHED TO MATCH EXIT. FIRE RATING WHERE APPLICABLE.

- PROPOSED CEILING HEIGHTS TO MATCH EXISTING UNLESS OTHERWISE NOTED. (TYP.)

- SECURE & REINSTATE ALL M&E FITMENTS AS INDICATED. GC TO PERFORM TESTING AS REQUIRED TO CONFIRM OPERATION. REFER TO M&E DRAWINGS.

- INSTALL TRANSITION STRIPS AT LOCATIONS WHERE THERE IS A CHANGE IN FLOORING. (TYP.) - ALL WORK SEQUENCES TO BE PERFORMED IN CONJUNCTION WITH EACH DISCIPLINE'S SCOPE

OF WORK BY ALL CONSULTANTS.

- ALL FITMENTS INDICATED TO BE REMOVED / DEMOLISHED ARE TO BE REMOVED & DISCARDED FROM MINIMUM DEPTH OF 900mm BELOW FINISHED GRADE. GC TO SITE VERIFY. (TYP.)

DEMO. BASEMENT PLAN LEGEND EXISTING TO BE DEMOLISHED _ _ _ _ _ _ _ _ UNLESS OTHERWISE NOTED EXISTING FOOTING TO REMAIN UNLESS NOTED OTHERWISE EXISTING WALLS TO REMAIN OUTLINE OF FLOORING ABOVE ····· TO BE DEMOLISHED. SEE STRUCTURAL.




PROPOSED NEW FOUNDATION WALL AND FOOTING. REFER TO STRUCTURAL DWGS. & SPECS. 250.

- PROPOSED NEW CONCRETE LEDGE. REFER TO STRUCTURAL DWGS. & SPECS. 251.
- 252. PROPOSED NEW CONC. FOUNDATION WALL ON EXISTING CONC. FOOTING. SEE STRUCTURAL.
- 253. INFILLED EXISTING SUMP PUMP PIT UNDER PROPOSED NEW CONC. FOUNDATION WALL. REFER TO STRUCT.
- OUTLINE OF REINSTATED FLOORING ABOVE. REFER TO STRUCTURAL DRAWINGS & SPECS. 254.

PREP & INFILL EXISTING OPENING WITH MATCHING CONC. BLOCK TOOTH-IN NEW BLOCK, TO PROVIDE SMOOTH & CONTINUOUS 255. SUBSTRATE SURFACE TO NEW FOUNDATION.


256. BACKFILL EXISTING FAN ROOM TO RECEIVE NEW FLOORING AT STORAGE ROOM LEVEL AS INDICATED. REFER TO SLAB ON GRADE DETAIL 3/A01 & SPECS. ELEVATE NEW FLOOR LEVEL TO MATCH WITH ADJACENT EXIST. 1ST FLOOR ROOM LEVELS. SEE STRUCTURAL DWGS. & SPEC. GC TO ENSURE ALL FITMENTS REMOVAL/ RELOCATION/ INSTALLATION & ABATEMENT WORKS ARE PERFORMED IN CONJUNCTION WITH ALL DISCIPLINES PRIOR TO BACKFILL.

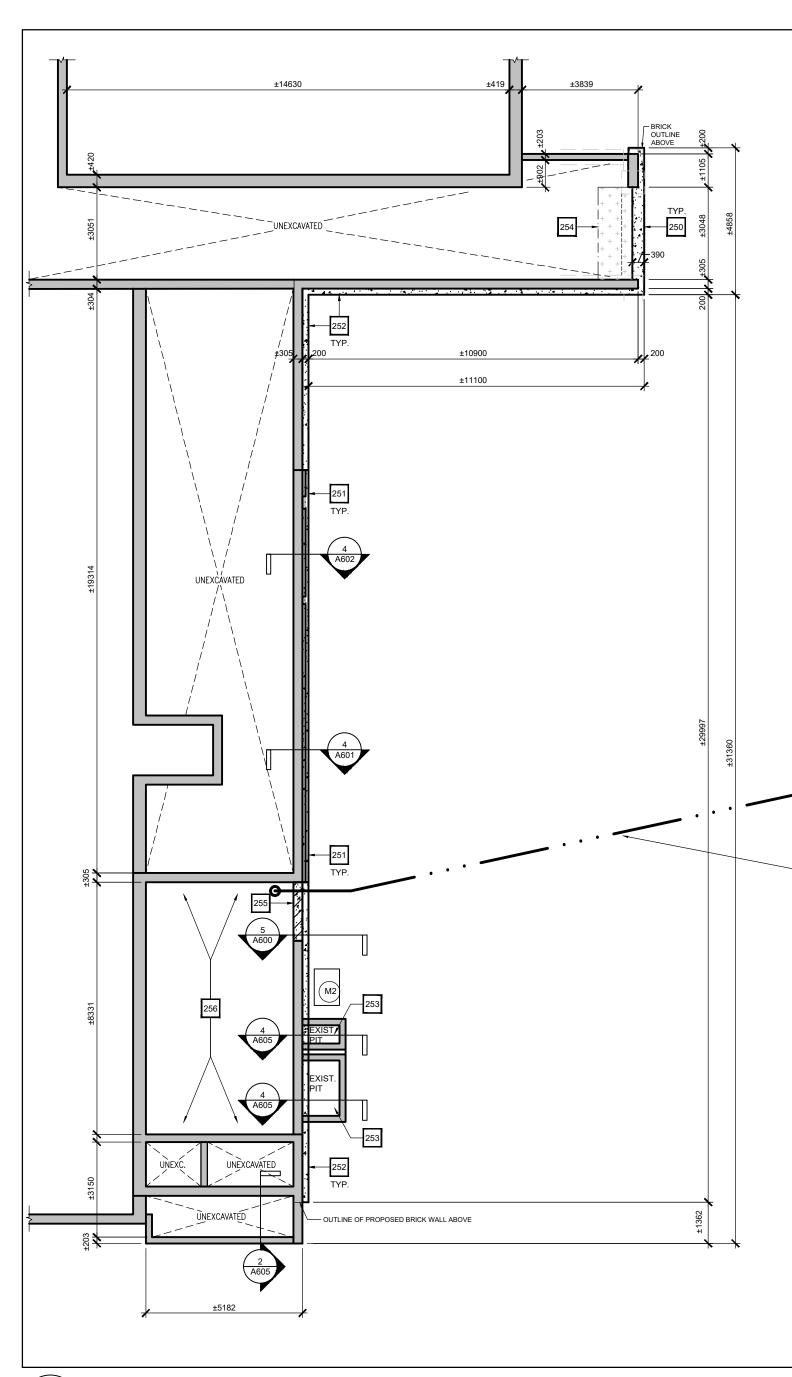

RUN NEW UG IRRIGATION LINE FROM

CONTROLLER TO EXISTING LINE TO FIELD REFER TO MECH. DRAWINGS.

PROPOSED E	BASEMENT LEGEND
UNEXCAVATED	UNEXCAVATED AREA TO REMAIN UNLESS OTHERWISE NOTED
	EXISTING WALLS / PARTITIONS TO REMAIN
	EXISTING FOOTING TO REMAIN UNLESS NOTED OTHERWISE
	PROPOSED CONC. WALL & FOOTING. SEE STRUCTURAL.
774745	PROPOSED CONC. BLOCK WALL. REFER TO STRUCTURAL.
<u>+</u> + + + + + +	OUTLINE OF REINSTATED FLOORING ABOVE

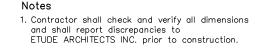

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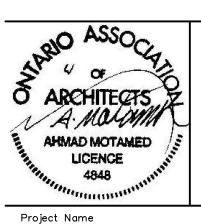
Drawing North True

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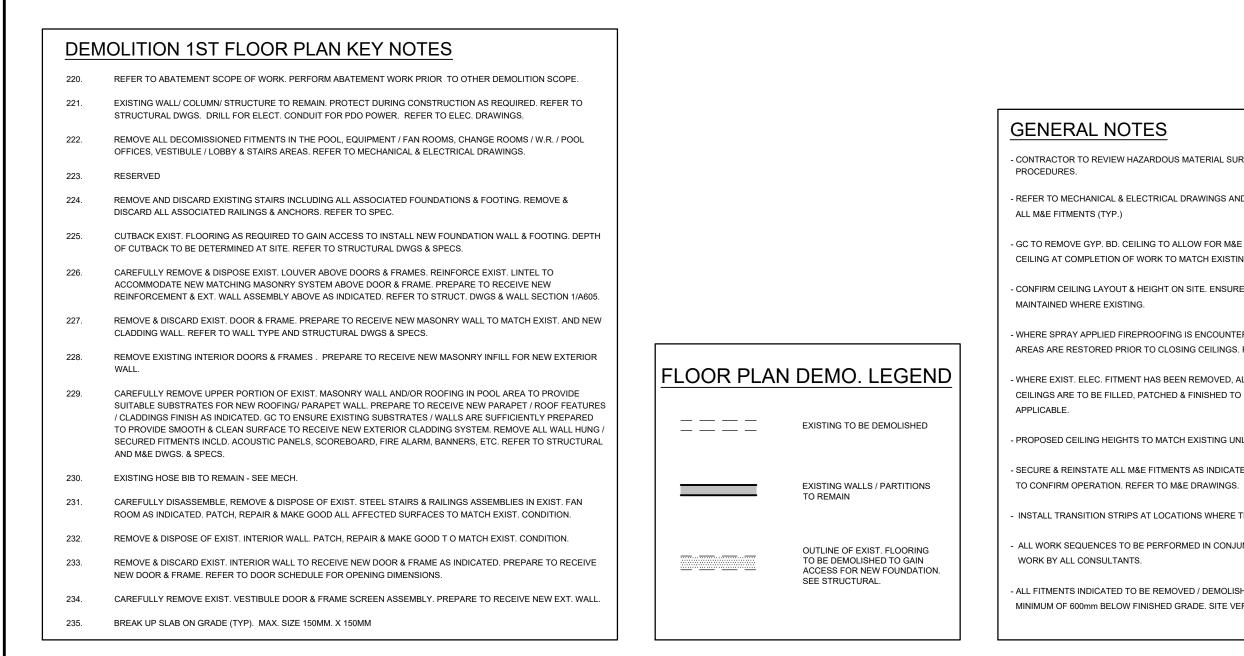
GLENFOREST POOL GLENFOREST SECONDARY SCHOOL 2575 FIELDGATE DR., MISSISSAUGA, ON L4X 2J6


POOL DEMOLITION

Drawing Title

BASEMENT PARTIAL PLANS

Graphic Scale AS SHOWN		Sheet no.
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CAD File AS NOTED	Scale AS NOTED	
Date DECEMBER 2022	Project No. 222113	Revision No.



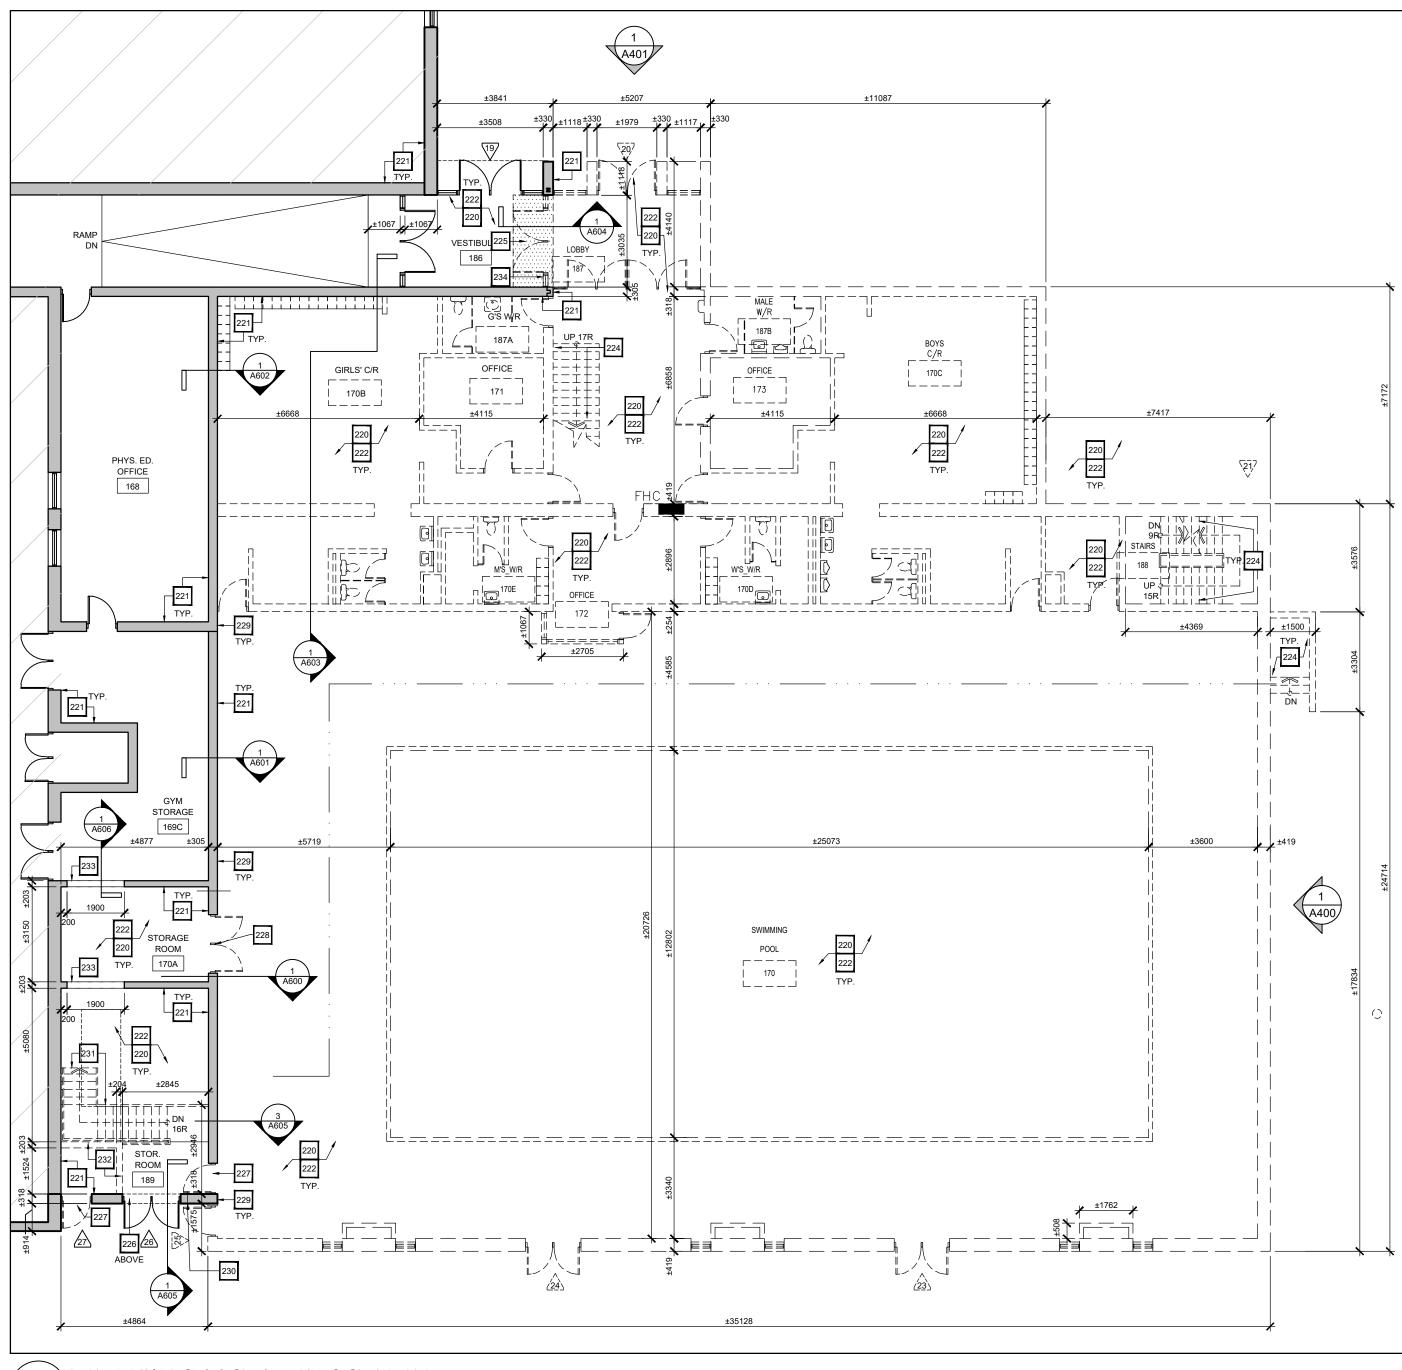




- CONTRACTOR TO REVIEW HAZARDOUS MATERIAL SURVEY FOR SCHOOL AND FOLLOW PDSB

- REFER TO MECHANICAL & ELECTRICAL DRAWINGS AND SPECIFICATIONS FOR EXTENT OF WORK ON
- GC TO REMOVE GYP. BD. CEILING TO ALLOW FOR M&E RENOVATION WORK AS REQUIRED. REPAIR CEILING AT COMPLETION OF WORK TO MATCH EXISTING.
- CONFIRM CEILING LAYOUT & HEIGHT ON SITE. ENSURE EXISTING FIRE RATED CEILING IS
- WHERE SPRAY APPLIED FIREPROOFING IS ENCOUNTERED, GC TO ENSURE THAT ANY DISTURBED AREAS ARE RESTORED PRIOR TO CLOSING CEILINGS. PROVIDE INSPECTION REPORT.
- WHERE EXIST. ELEC. FITMENT HAS BEEN REMOVED, ALL PENETRATIONS THROUGH EXIST. WALLS & CEILINGS ARE TO BE FILLED, PATCHED & FINISHED TO MATCH EXIT. FIRE RATING WHERE
- PROPOSED CEILING HEIGHTS TO MATCH EXISTING UNLESS OTHERWISE NOTED. (TYP.)
- SECURE & REINSTATE ALL M&E FITMENTS AS INDICATED. GC TO PERFORM TESTING AS REQUIRED
- INSTALL TRANSITION STRIPS AT LOCATIONS WHERE THERE IS A CHANGE IN FLOORING. (TYP.)
- ALL WORK SEQUENCES TO BE PERFORMED IN CONJUNCTION WITH EACH DISCIPLINE'S SCOPE OF
- ALL FITMENTS INDICATED TO BE REMOVED / DEMOLISHED ARE TO BE REMOVED & DISCARDED FROM MINIMUM OF 600mm BELOW FINISHED GRADE. SITE VERIFY. (TYP.)

PROPOSED 1ST FLOOR PLAN KEY NOTES

- 270. PROPOSED NEW WINDOW. SEE WINDOW TYPE ON A900.
- 271. PROPOSED NEW EXTERIOR WALL ABOVE NEW CONCRETE LEDGE / FOUNDATION. REFER TO WALL TYPES, SECTIONS AND DETAILS. SEE STRUCTURAL DWGS. & SPECS.
- 272. OUTLINE OF REINSTATED FLOORING. FLOOR FINISH AND BASE TO MATCH EXISTING. REFER TO ROOM FINISH SCHEDULE.
- EXISTING DOORS, FRAMES AND SCREENS TO REMAIN. PROTECT DURING CONSTRUCTION. COORDINATE FOR NEW KEYING. MODIFY FOR NEW PDO. 273.
- 274. PROPOSED NEW DOORS & FRAMES. REFER TO DOOR SCHEDULE. SUPPLY AND INSTALL NEW LINTEL FOR EXISTING MASONRY WALL. SEE STRUCTURAL.
- INFILL EXISTING OPENING W/ MATCHING CONC. TOOTH-IN NEW CONCRETE BLOCK, TO TO PROVIDE CONTINUOUS & SMOOTH SUBSTRATE SURFACES AT BOTH SIDES. 275. REFER TO WALL TYPES. PAINT FINISH ON THE INTERIOR SIDE.
- REINFORCE ABOVE EXISTING DOORS & FRAMES AND INSTALL PROPOSED EXTERIOR CLADDING AS INDICATED. REFER TO WALL TYPES AND STRUCTURAL DWG. & SPEC. 276. 277.
- PROPOSED NFHB REFER TO MECH.
- 278. REPLACE EXISTING HM DOORS. VERIFY SOUNDNESS OF EXISTING FRAMES TO RECEIVE NEW DOORS. EXISTING SLAB ON GRADE - PATCH FLOOR WHERE EXISTING WALLS ARE REMOVED. 279.
- PROPOSED SLAB ON GRADE. SEE STRUCT.
- 280. PROPOSED NEW OPENING. PROVIDE LINTEL. SEE STRUCTURAL DWGS.
- 281.
- 282. INFILL EXIST. OPENING WITH NEW EXTERIOR WALL ASSEMBLY, MASONRY TO MATCH EXISTING SIZE AND SHAPE. PROVIDE MASONRY SAMPLE FOR CONSULTANT'S REVIEW ON COLOUR SELECTION. TOOTH-IN NEW MASONRY TO MATCH EXISTING PATTERN.
- 283. EXISTING DOORS TO REMAIN. PREP. DOORS, FRAMES, SIDELITES FOR NEW PAINT.
- 284. PROPOSED POWER DOOR OPERATOR. REFER TO ELECTRICAL DWG. & SPEC.

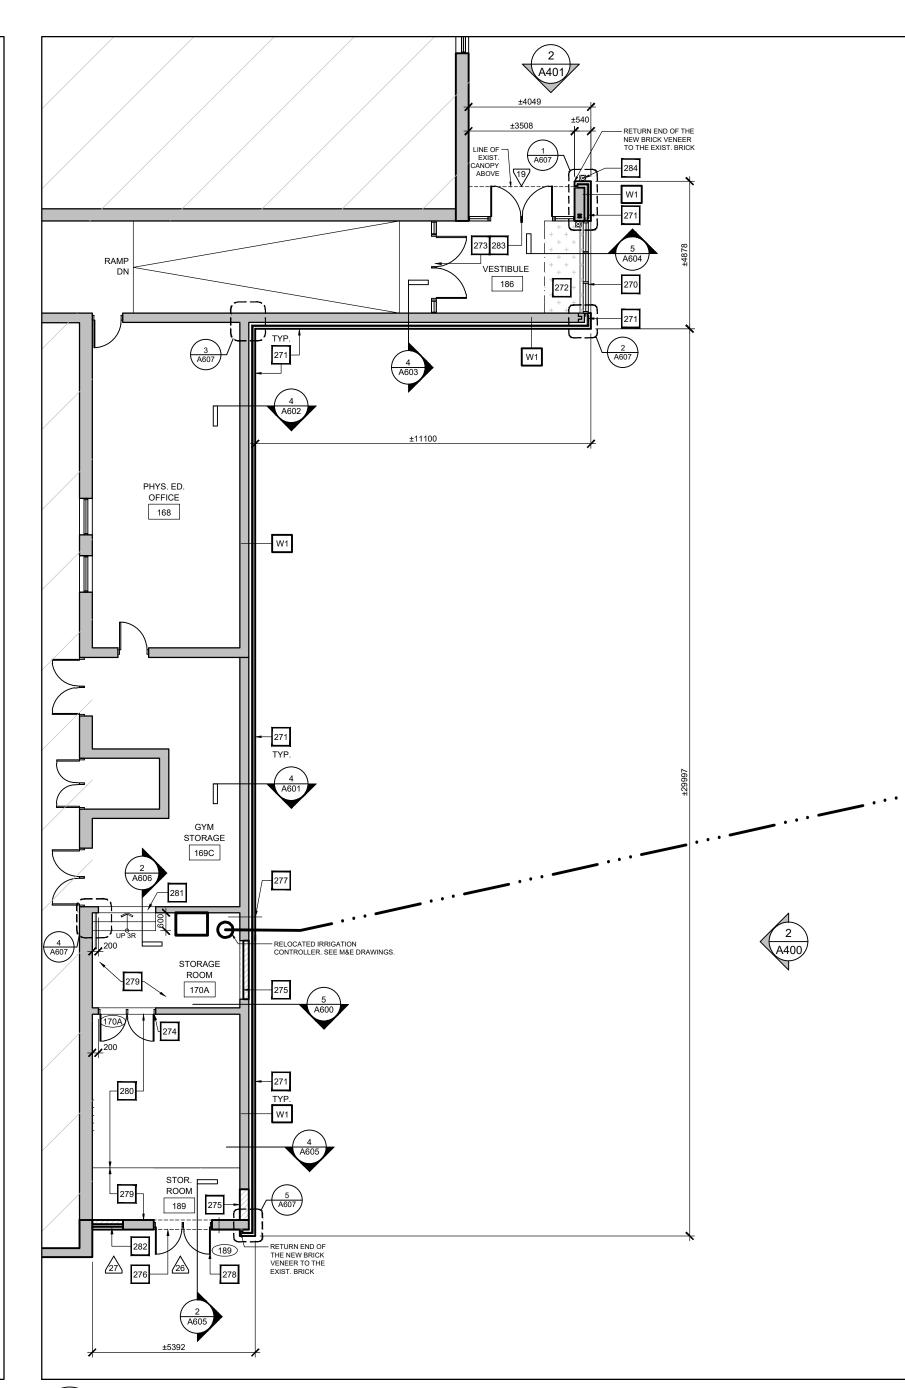


2 PART, PROPOSED IST FLOOR PLAN A202/SCALE: 1:125

ROPOSED FI	LOOR PLAN LEGEND
_	EXISTING WALLS / PARTITIONS TO REMAIN
<u></u>	PROPOSED NEW WALL
<u>-+</u> ,+ <u>+</u> ,+ <u>+</u>	OUTLINE OF REINSTATED FLOORING

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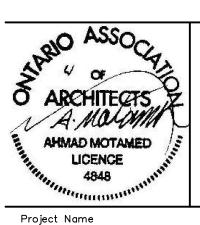


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GLENFOREST POOL GLENFOREST SECONDARY SCHOOL 2575 FIELDGATE DR., MISSISSAUGA, ON L4X 2J6

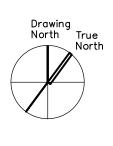POOL DEMOLITION


Drawing Title

FIRST FLOOR PARTIAL PLANS

Sheet no. Graphic Scale AS SHOWN Drawn Checked A202 AK / VSP AM CAD File Scale AS NOTED AS NOTED Date Project No. Revision No. DECEMBER 2022 222113

DEMOLITION POOL BALCONY LEVEL & PART. ROOF PLAN KEY NOTES

- REFER TO ABATEMENT SCOPE OF WORK. PERFORM ABATEMENT WORK PRIOR TO OTHER DEMOLITION SCOPE. 240.
- 241. REMOVE ALL DECOMISSIONED FITMENTS IN THE BALCONY, POOL, LOBBY, STAIRS AND ROOF AREAS AS INDICATED. REFER TO STRUCTURAL & M&E DRAWINGS FOR COMPLETE SCOPE OF REMOVALS / RELOCATIONS. 242. ALL DEMOLISHED STRUCTURES & FITMENTS TO BE REMOVED & DISCARDED MIN. 600mm BELOW EXISTING FINISHED ELEVATION/GRADE.
- REMOVE AND DISCARD EXIST. STAIRS INCLD. ALL ASSOCIATED RAILINGS, ANCHORS, FOOTINGS AND FOUNDATIONS. 243.
- 244. CAREFULLY REMOVE UPPER PORTION OF EXIST. MASONRY WALL AND/OR ROOFING TO PROVIDE SUITABLE SUBSTRATES FOR NEW ROOFING / PARAPET WALL. PREPARE TO RECEIVE NEW PARAPET / ROOF FEATURES / CLADDINGS FINISH AS INDICATED. GC TO ENSURE EXISTING SUBSTRATES / WALLS ARE SUFFICIENTLY PREPARED TO PROVIDE SMOOTH & CLEAN SURFACE TO RECEIVE NEW EXTERIOR CLADDING SYSTEM AS PROPOSED BY REMOVING ALL WALL HUNG / SECURED FITMENTS INCLD. ACOUSTIC PANELS, SCOREBOARD, FIRE ALARM, BANNERS, ETC. REFER TO STRUCTURAL AND M&E DWGS. & SPECS.
- REMOVE / RELOCATE / REPOUTE EXISTING ROOF DRAIN ASSEMBLY. INFILL EXISTING OPENINGS TO MATCH EXISTING ROOFING ASSEMBLY,. REFER TO MECHANICAL DWG. & SPEC. 245.
- 246. PROTECT EXISTING ROOF DRAIN TO REMAIN.
- CAREFULLY REMOVE EXISTING ROOFING & FLASHING. PREPARE TO RECEIVE NEW PARAPET & ROOFING AS INDICATED. 247.
- CAREFULLY REMOVE & REPLACE EXIST. ROOFING/ FLASHING ABOVE ENTRANCE WITH NEW ROOFING/ FLASHING TO MATCH EXIST. UPON COMPLETION OF ADJACENT NEW PARAPET WALL & ROOFING INSTALLATION. MAKE 248. GOOD ALL AFFECTED AREA TO MATCH EXISTING. REFER TO SPEC.

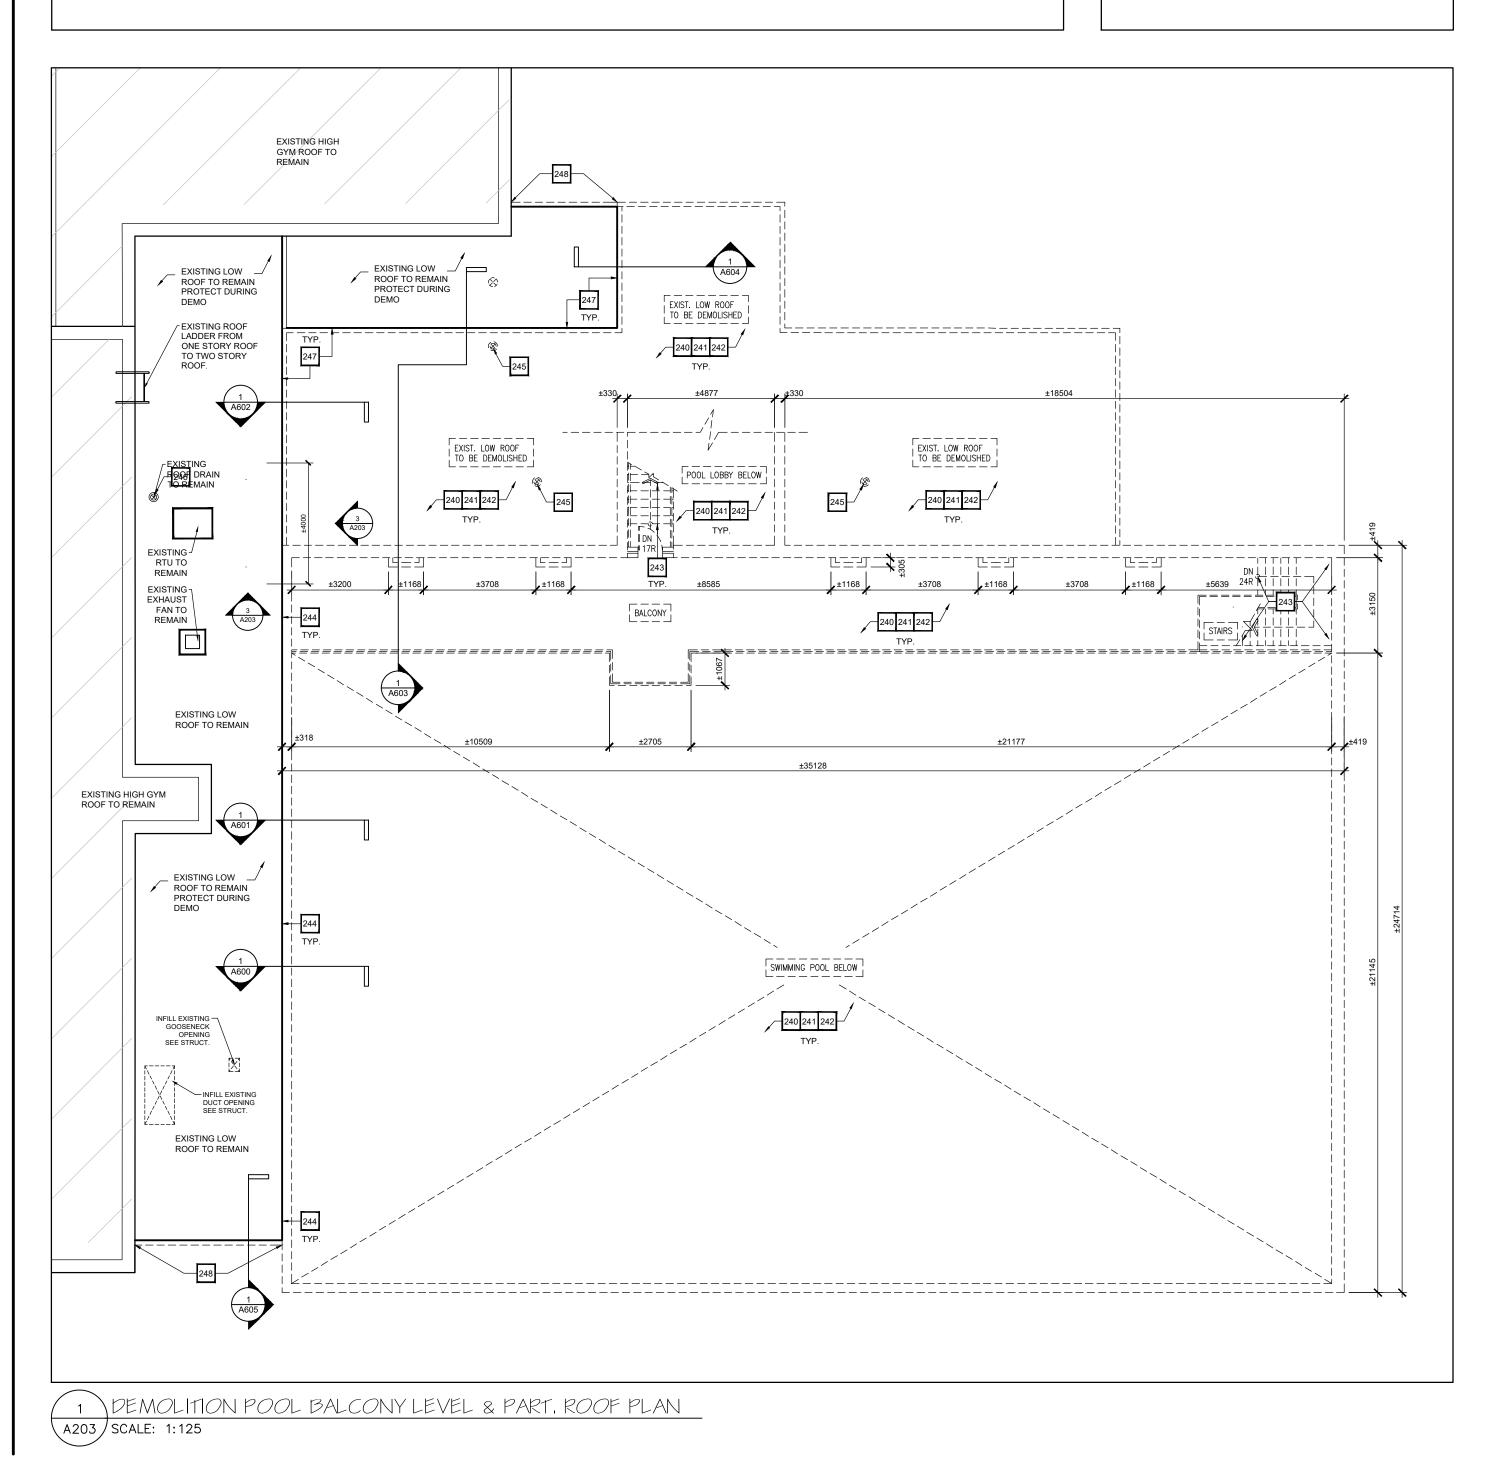

GENERAL NOTES

290.

- CONTRACTOR TO REVIEW HAZARDOUS MATERIAL SURVEY FOR SCHOOL AND FOLLOW PDSB PROCEDURES.

- REFER TO MECHANICAL & ELECTRICAL DRAWINGS AND SPECIFICATIONS FOR EXTENT OF WORK ON ALL M&E FITMENTS (TYP.)

- GC TO REMOVE GYP. BD. CEILING TO ALLOW FOR M&E RENOVATION WORK AS REQUIRED. REPAIR CEILING AT COMPLETION OF WORK TO MATCH EXISTING.

- CONFIRM CEILING LAYOUT & HEIGHT ON SITE. ENSURE EXISTING FIRE RATED CEILING IS MAINTAINED WHERE EXISTING.

PROPOSED ROOF PLAN KEY NOTES

PROPOSED NEW OUTLINE OF ROOF PARAPET.

- WHERE SPRAY APPLIED FIREPROOFING IS ENCOUNTERED, GC TO ENSURE THAT ANY DISTURBED AREAS ARE RESTORED PRIOR TO CLOSING CEILINGS. PROVIDE INSPECTION REPORT.

- WHERE EXIST. ELEC. FITMENT HAS BEEN REMOVED, ALL PENETRATIONS THROUGH EXIST. WALLS & CEILINGS ARE TO BE FILLED, PATCHED & FINISHED TO MATCH EXIT. FIRE RATING WHERE APPLICABLE.

- PROPOSED CEILING HEIGHTS TO MATCH EXISTING UNLESS OTHERWISE NOTED. (TYP.)

AS REQUIRED TO CONFIRM OPERATION. REFER TO M&E DRAWINGS.


INSTALL TRANSITION STRIPS AT LOCATIONS WHERE THERE IS A CHANGE IN FLOORING. (TYP.)


- ALL WORK SEQUENCES TO BE PERFORMED IN CONJUNCTION WITH EACH DISCIPLINE'S SCOPE OF WORK BY ALL CONSULTANTS.


BALCONY PLAN DEMO. LEGEND

ALL EXISTING TO BE DEMOLISHED _ _ _ _ _ _ _ _ UNLESS OTHERWISE NOTED EXISTING ROOF PARAPET/ _____ FEATURES TO REMAIN

> RELOCATE EXIST. ROOF DRAIN. REFER TO MECHANICAL.

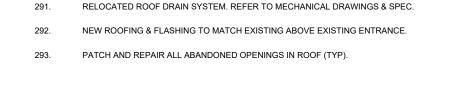

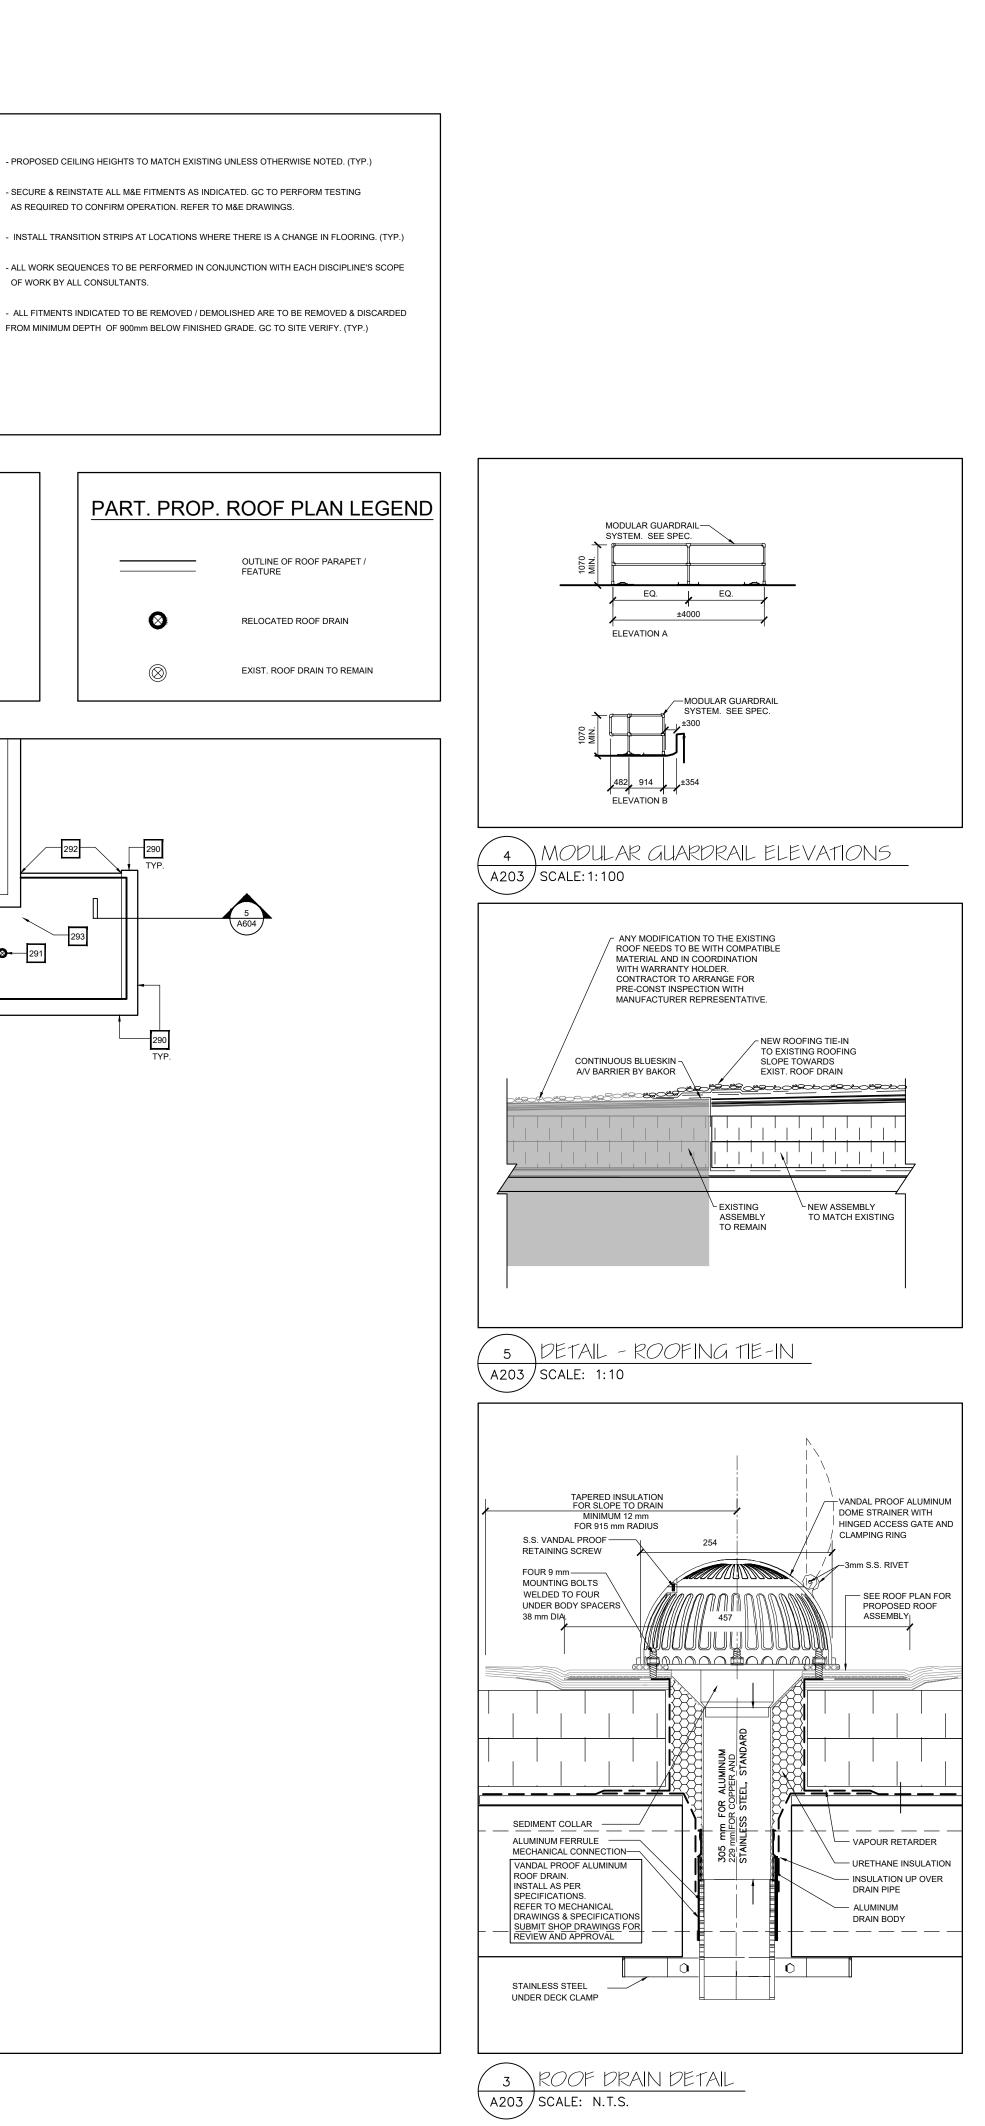

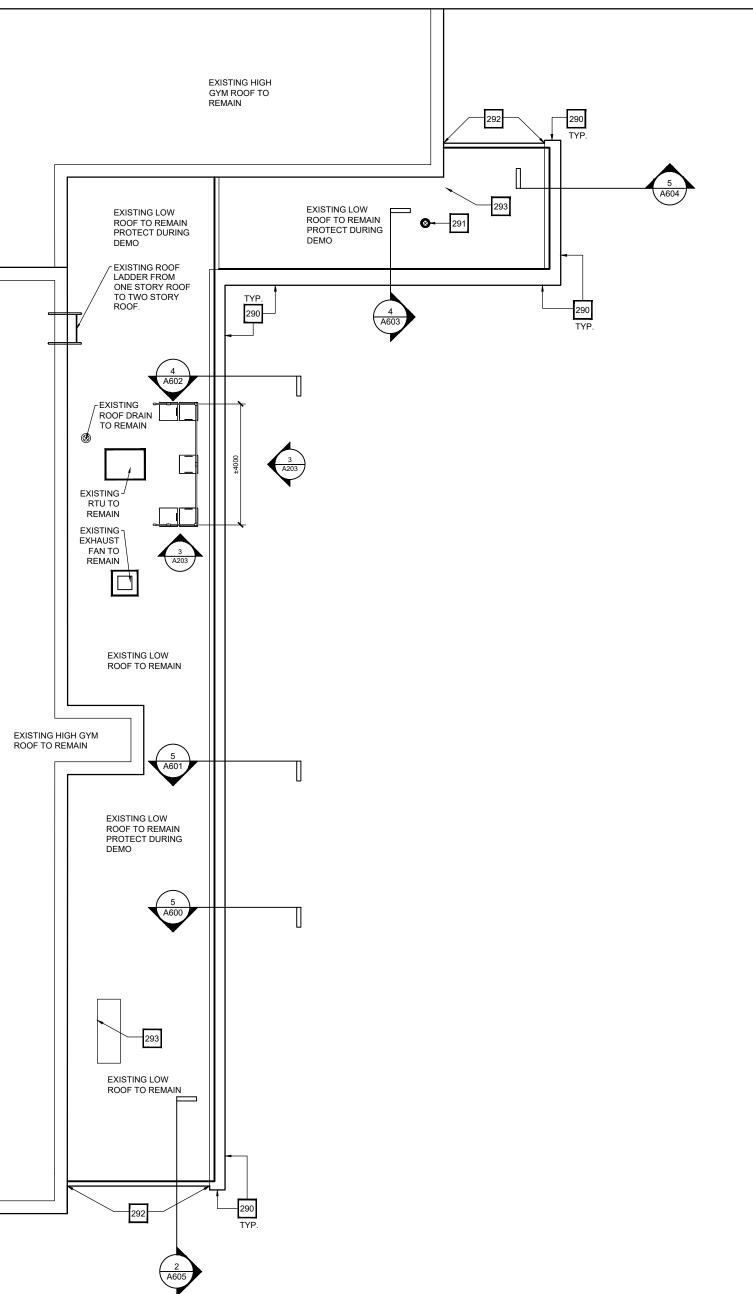

2 PART. PROPOSED ROOF PLAN A203 SCALE: 1:125

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2. Do not scale this drawing. ETUDE ARCHITECTS INC


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1	ISSUED FOR CLIENT REVIEW	FEBRUARY 06, 2023
NO.	DESCRIPTION	DATE



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GLENFOREST POOL GLENFOREST SECONDARY SCHOOL 2575 FIELDGATE DR., MISSISSAUGA, ON L4X 2J6

POOL DEMOLITION


Drawing Title

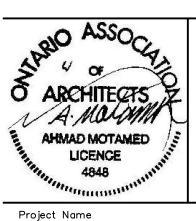DEMOLITION POOL BALCONY LEVEL & PART. ROOF PLANS

Graphic Scale Sheet no. AS SHOWN Drawn Checked A203 AK / VSP AM CAD File Scale AS NOTED AS NOTED Date Project No. Revision No. DECEMBER 2022 222113

REFLECTED CEILING PLAN KEY NOTES

- 300. REFER TO ABATEMENT SCOPE OF WORK. PERFORM ABATEMENT WORK PRIOR TO OTHER DEMOLITION SCOPE.
- REMOVE ALL DECOMISSIONED FITMENTS IN THE BALCONY, POOL, LOBBY AND STAIRS AREAS AS INDICATED. REFER TO STRUCTURAL & M&E DRAWINGS. 301 302. PROPOSED OUTLINE OF NEW ROOF PARAPET / FLASHING.
- OPEN EXISTING CEILING TO TRUNCATE AND TERMINATE MECHANICAL, PLUMBING, ELECTRICAL, FIRE ALARM, SPRINKLER AND ALL OTHER SERVICES FEEDING THE POOL. 303.
- 304. PROVIDE CEILING ACCESS FOR REDIRECTION OF IRRIGATION LINE AND MECHANICAL WORK.
- 305. PROVIDE CEILING ACCESS FOR REDIRECTION OF IRRIGATION LINE AND MECHANICAL WORK- RESTORE EXISTING FIRE RATED CEILING.
- 306. REMOVE DUCT PENETRATING ROOF. PATCH AND REPAIR SIPOREX ROOF PANEL AND CEILING. REFER TO MECH. AND STRUCT. DRAWINGS
- 307. PROVIDE CEILING ACCESS FOR RELOCATED ROOF DRAIN WORK AND STRUCTURAL WORK AT NEW EXTERIOR WALL.

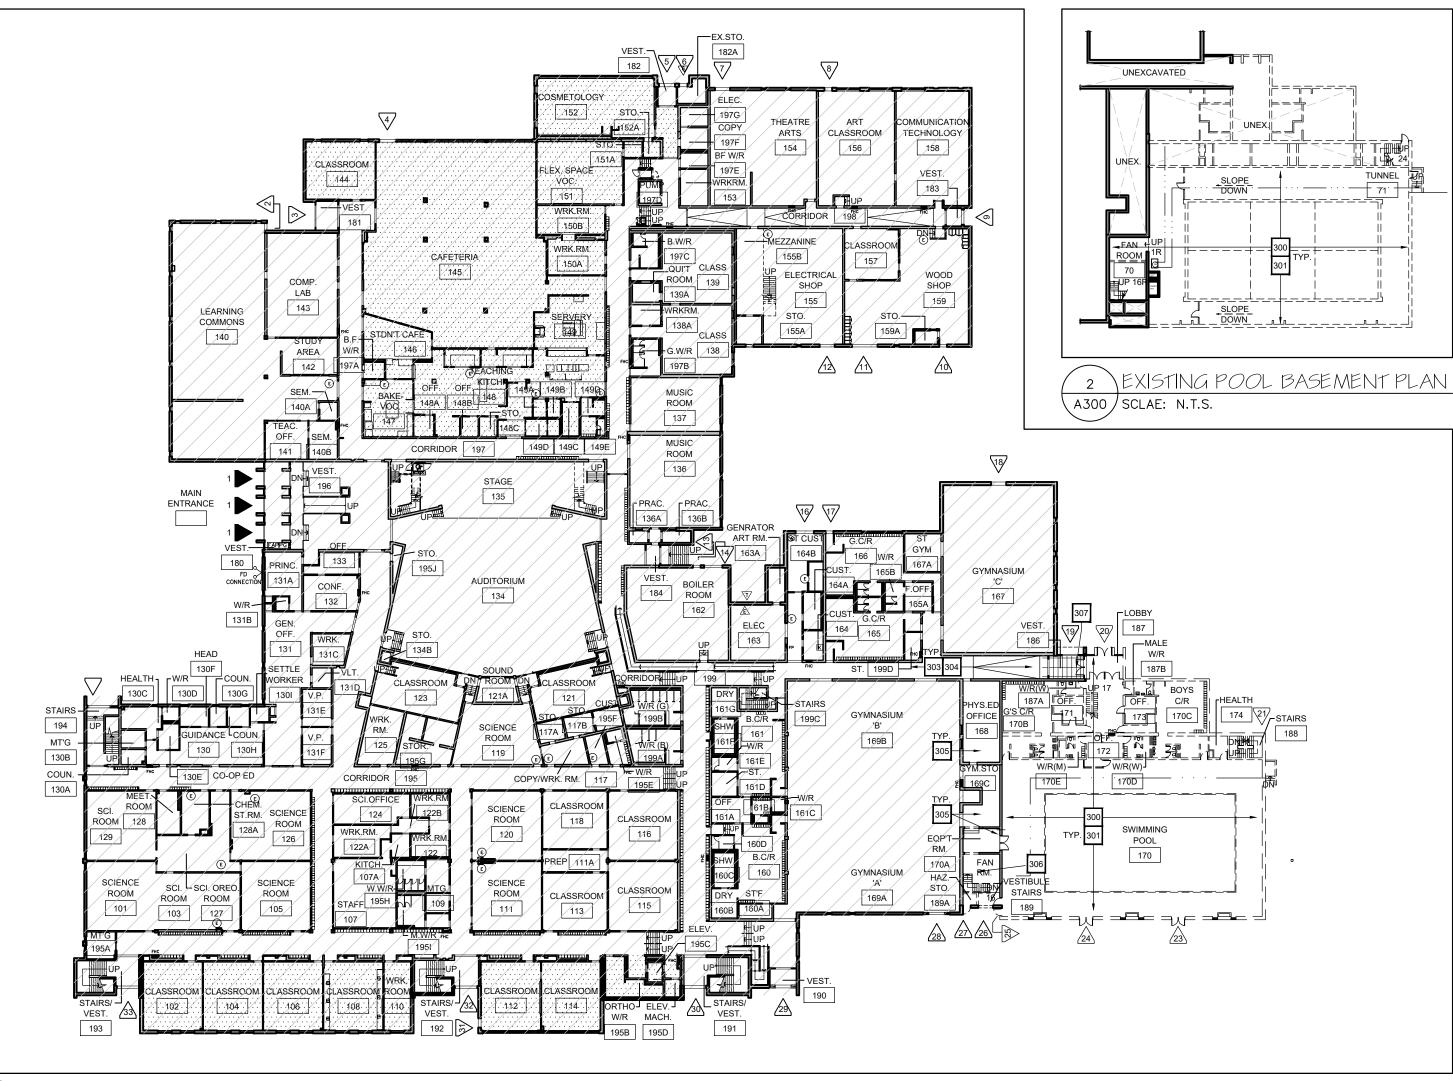

(1) EXISTING FIRST FLOOR REFLECTED CEILING DEMO PLAN A300 SCLAE: N.T.S.



GENERAL NOTES

- CONTRACTOR TO REVIEW HAZARDOUS MATERIAL SURVEY FOR SCHOOL AND FOLLOW PDSB PROCEDURES.

- REFER TO MECHANICAL & ELECTRICAL DRAWINGS AND SPECIFICATIONS FOR EXTENT OF WORK ON ALL M&E FITMENTS (TYP.)

- GC TO REMOVE GYP. BD. CEILING TO ALLOW FOR M&E RENOVATION WORK AS REQUIRED. REPAIR CEILING AT COMPLETION OF WORK TO MATCH EXISTING.

MAINTAINED WHERE EXISTING.

- WHERE SPRAY APPLIED FIREPROOFING IS ENCOUNTERED, GC TO ENSURE THAT ANY DISTURBED AREAS ARE RESTORED PRIOR TO CLOSING CEILINGS. PROVIDE INSPECTION REPORT.


- ALL WORK SEQUENCES TO BE PERFORMED IN CONJUNCTION WITH EACH DISCIPLINE'S SCOPE

- ALL FITMENTS INDICATED TO BE REMOVED / DEMOLISHED ARE TO BE REMOVED & DISCARDED

FROM MINIMUM HEIGHT OF 600mm BELOW FINISHED GRADE. SITE VERIFY. (TYP.)

OF WORK BY ALL CONSULTANTS.


- WHERE EXIST. ELEC. FITMENT HAS BEEN REMOVED, ALL PENETRATIONS THROUGH EXIST. WALLS & CEILINGS ARE TO BE FILLED, PATCHED & FINISHED TO MATCH EXIT. FIRE RATING WHERE APPLICABLE.

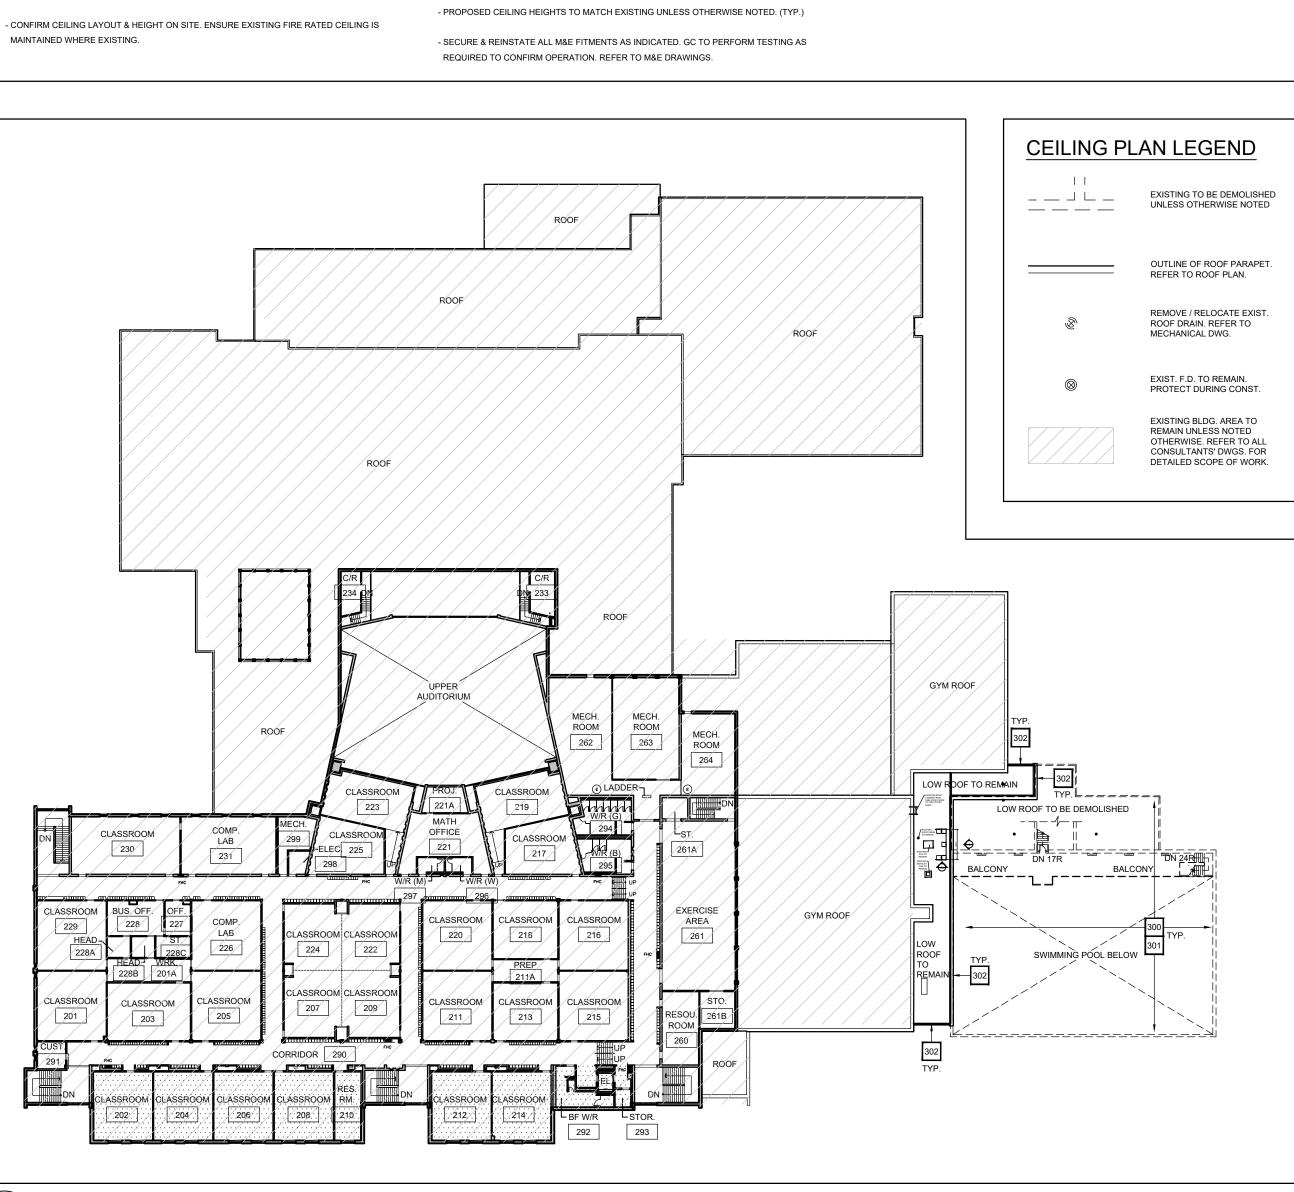

3 EXISTING GROUND FLOOR CEILING KEY PLAN A300 SCLAE: N.T.S.



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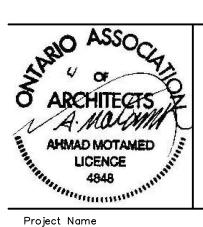

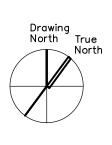
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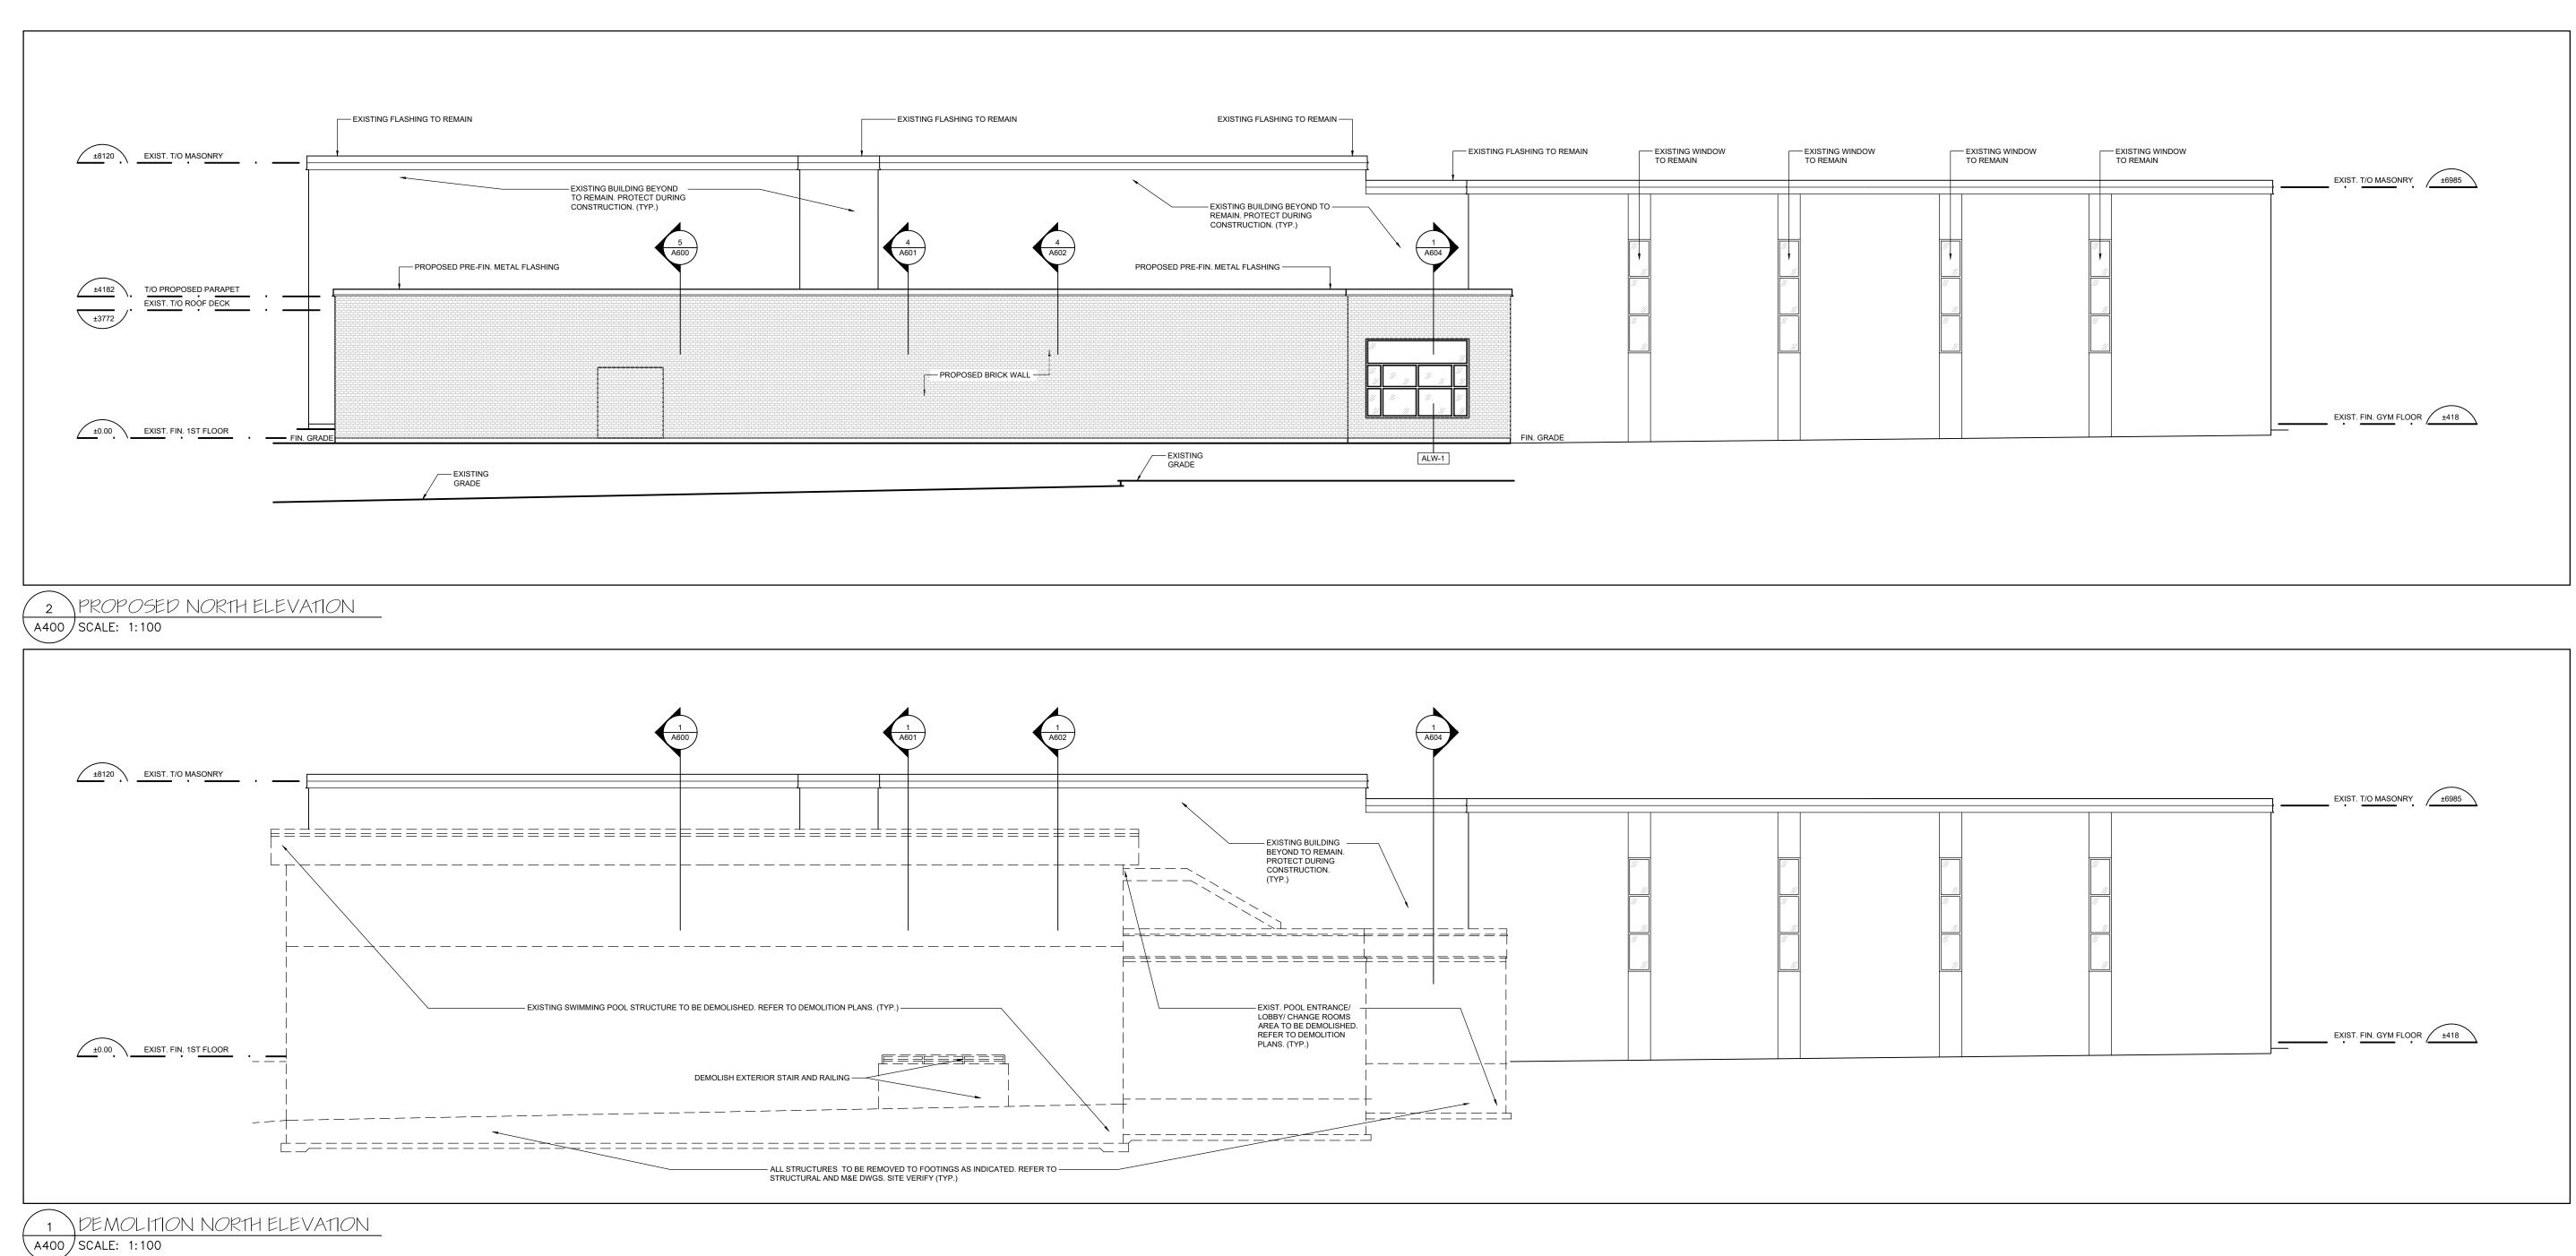
GLENFOREST POOL GLENFOREST SECONDARY SCHOOL 2575 FIELDGATE DR., MISSISSAUGA, ON L4X 2J6


POOL DEMOLITION

Drawing Title

REFLECTED CEILING PLANS

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CAD File AS NOTED	Scale AS NOTED	
Date DECEMBER 2022	Project No. 222113	Revision No.



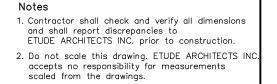


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GLENFOREST POOL GLENFOREST SECONDARY SCHOOL 2575 FIELDGATE DR., MISSISSAUGA, ON L4X 2J6

POOL DEMOLITION


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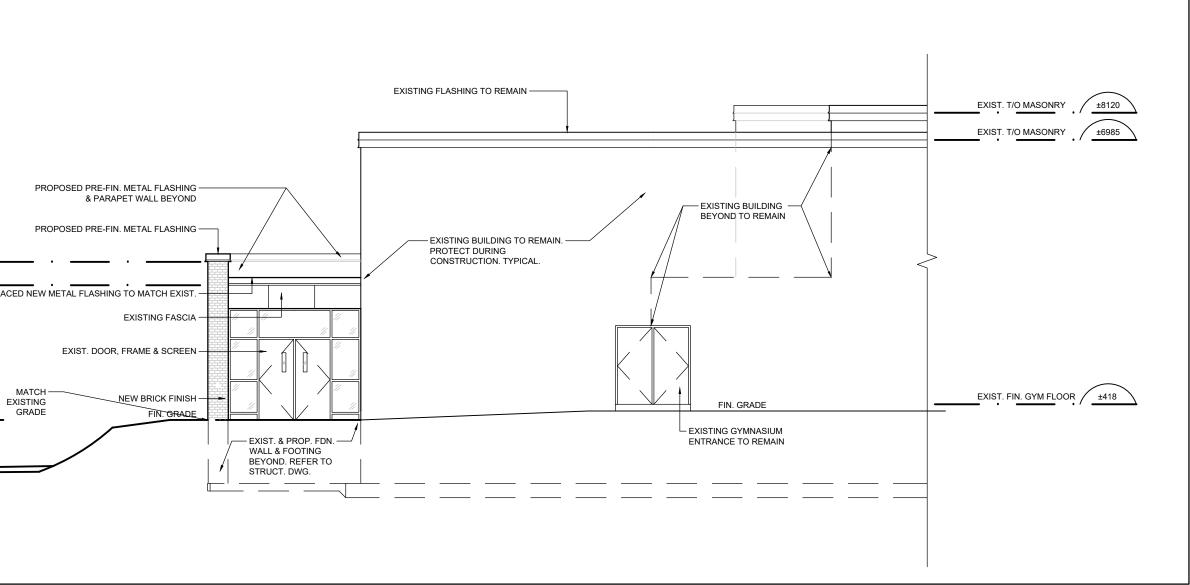
BUILDING ELEVATIONS

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CAD File AS NOTED	Scale AS NOTED		
Date DECEMBER 2022	Project No. 222113	Revision No.	

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A401 SCALE: 1:100

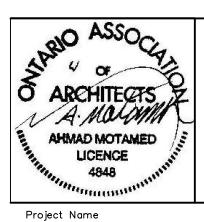

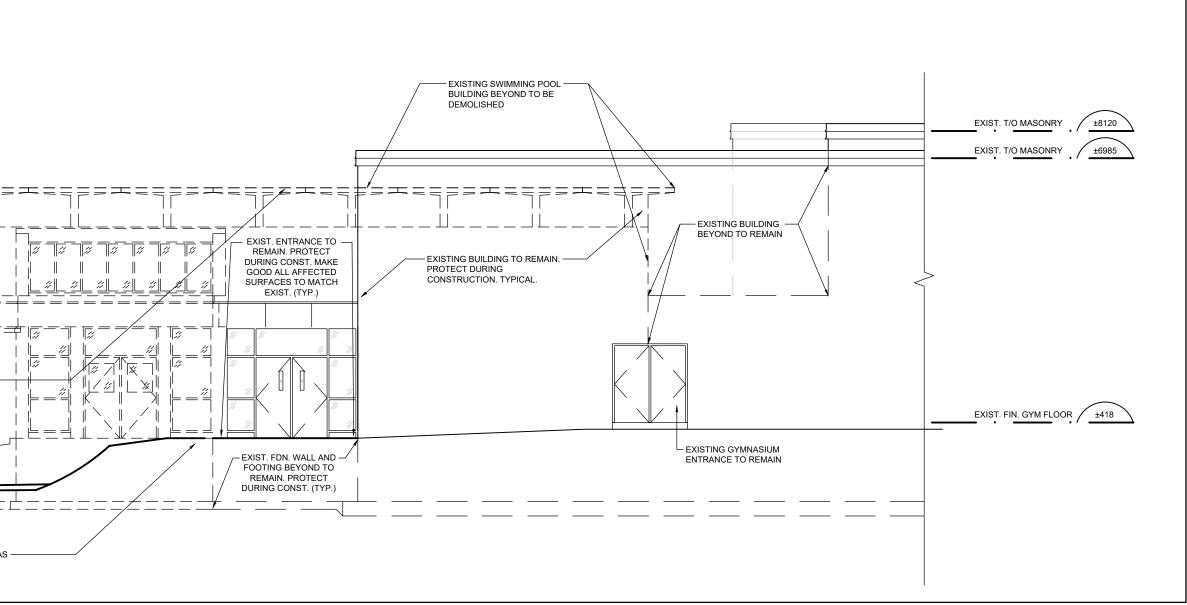

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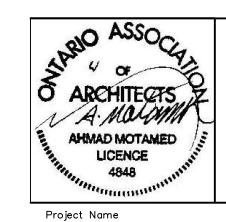
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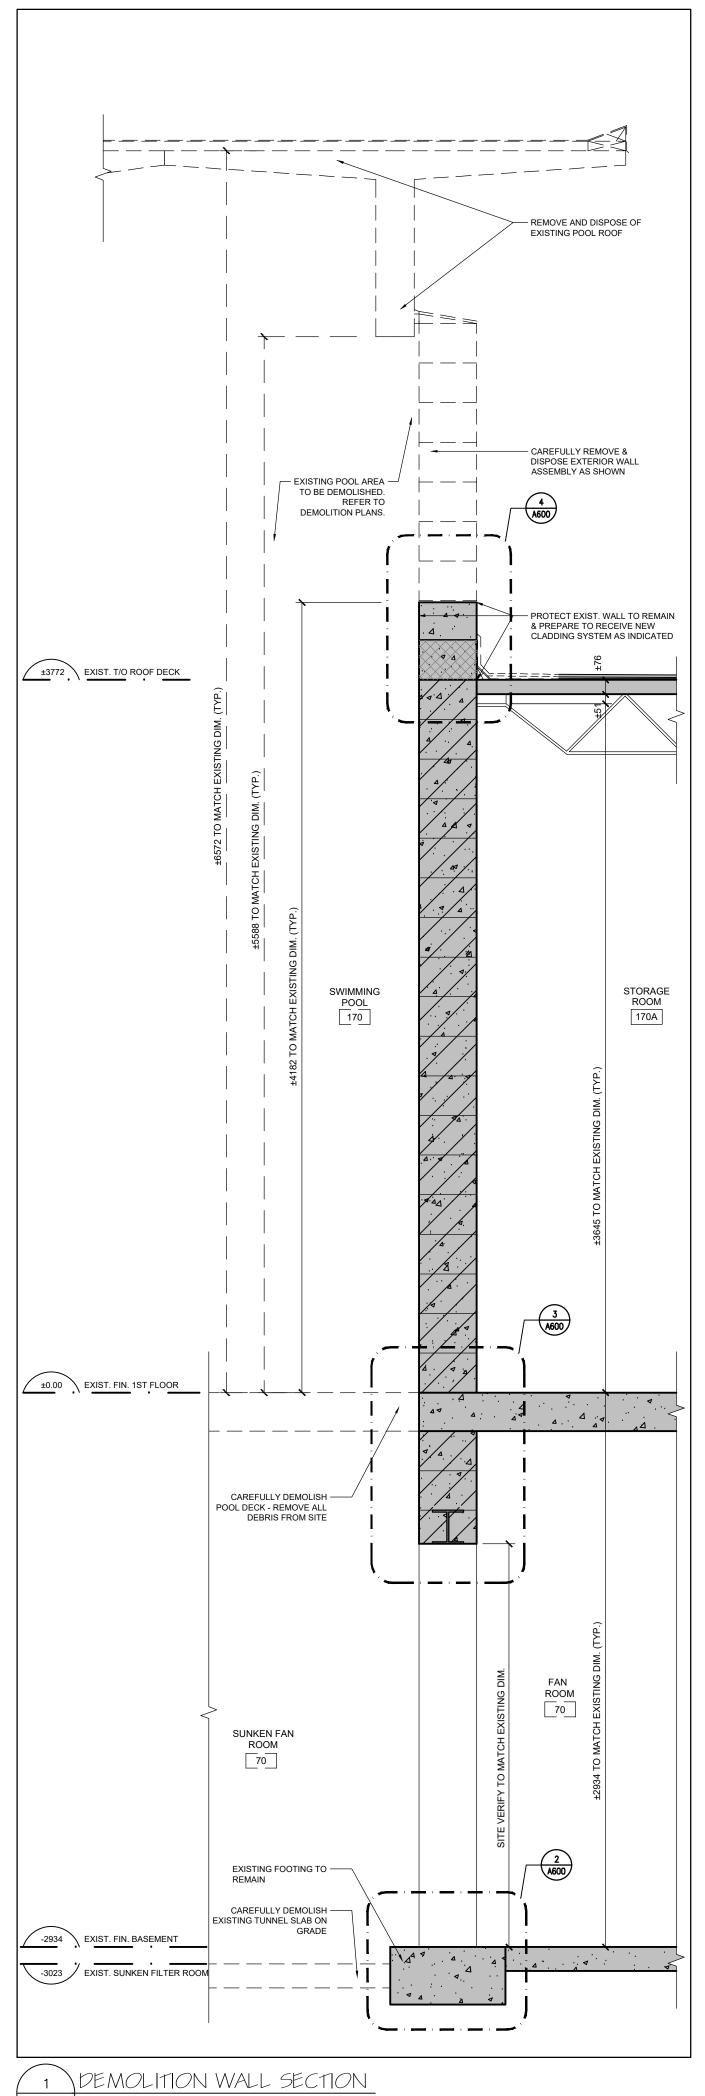
GLENFOREST POOL GLENFOREST SECONDARY SCHOOL 2575 FIELDGATE DR., MISSISSAUGA, ON L4X 2J6


POOL DEMOLITION

Drawing Title

BUILDING ELEVATIONS

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A600 / SCALE: 1:20

A600 / SCALE: 1:20

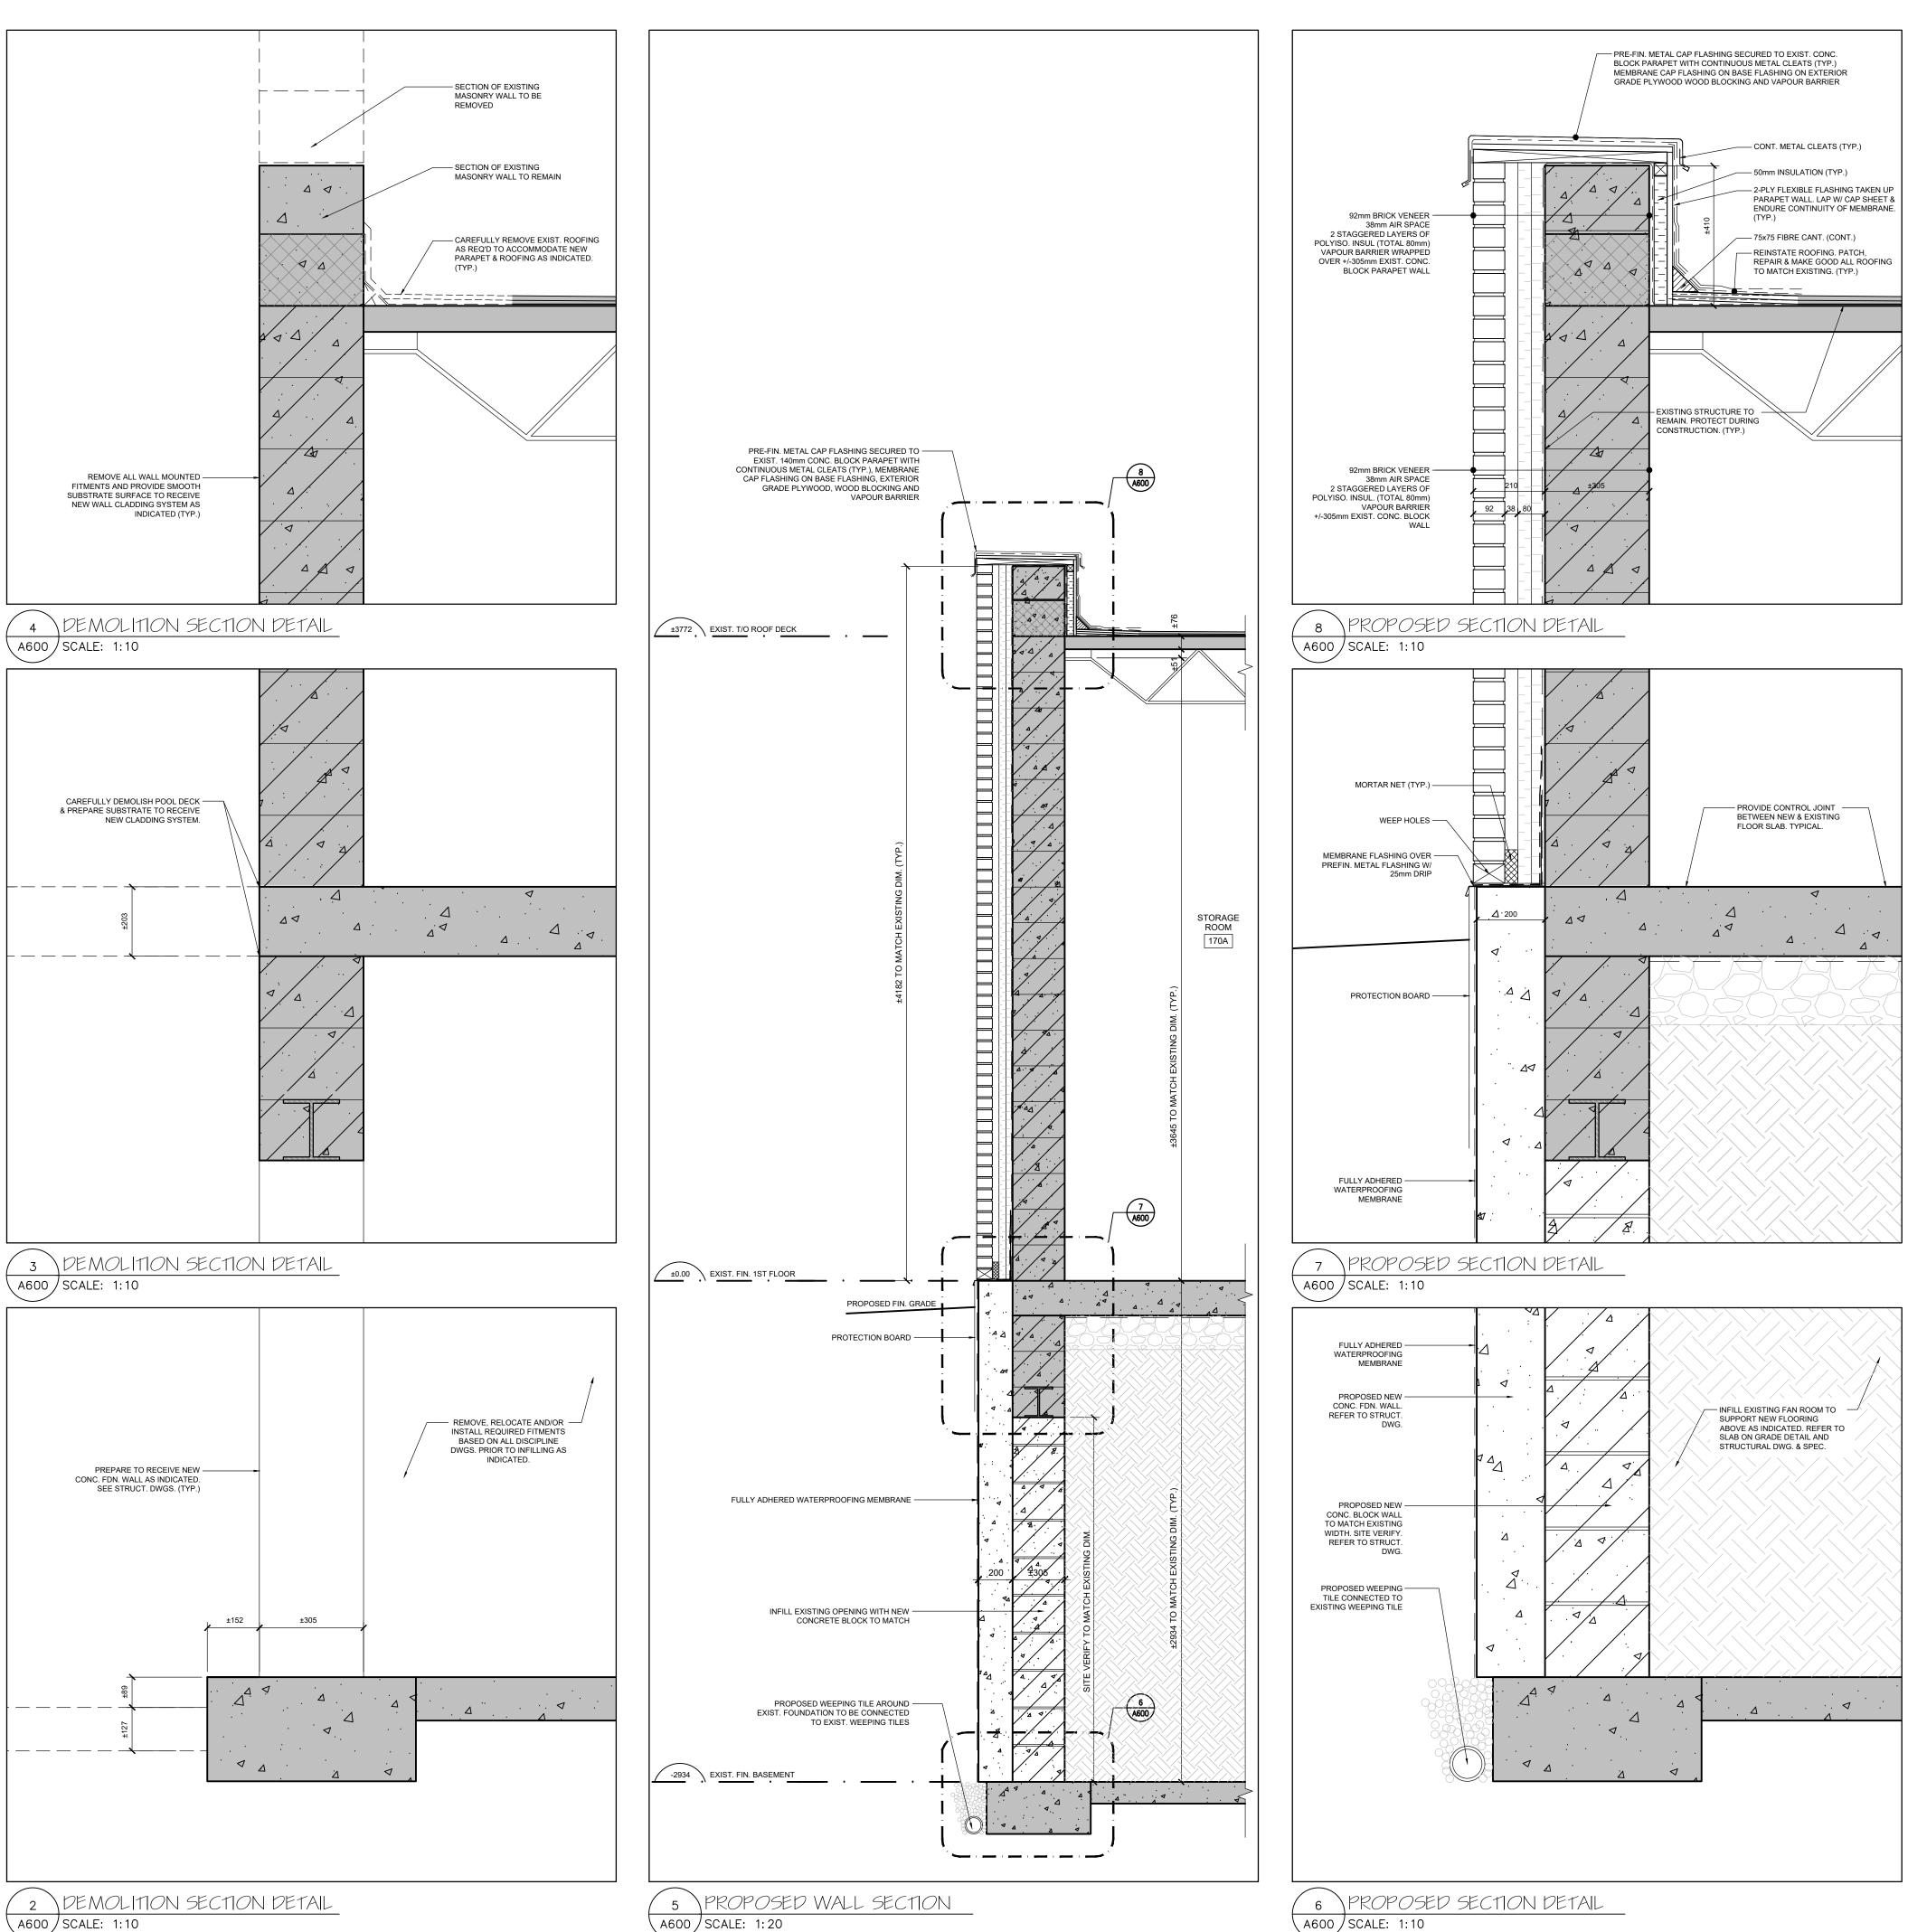A600 SCALE: 1:10


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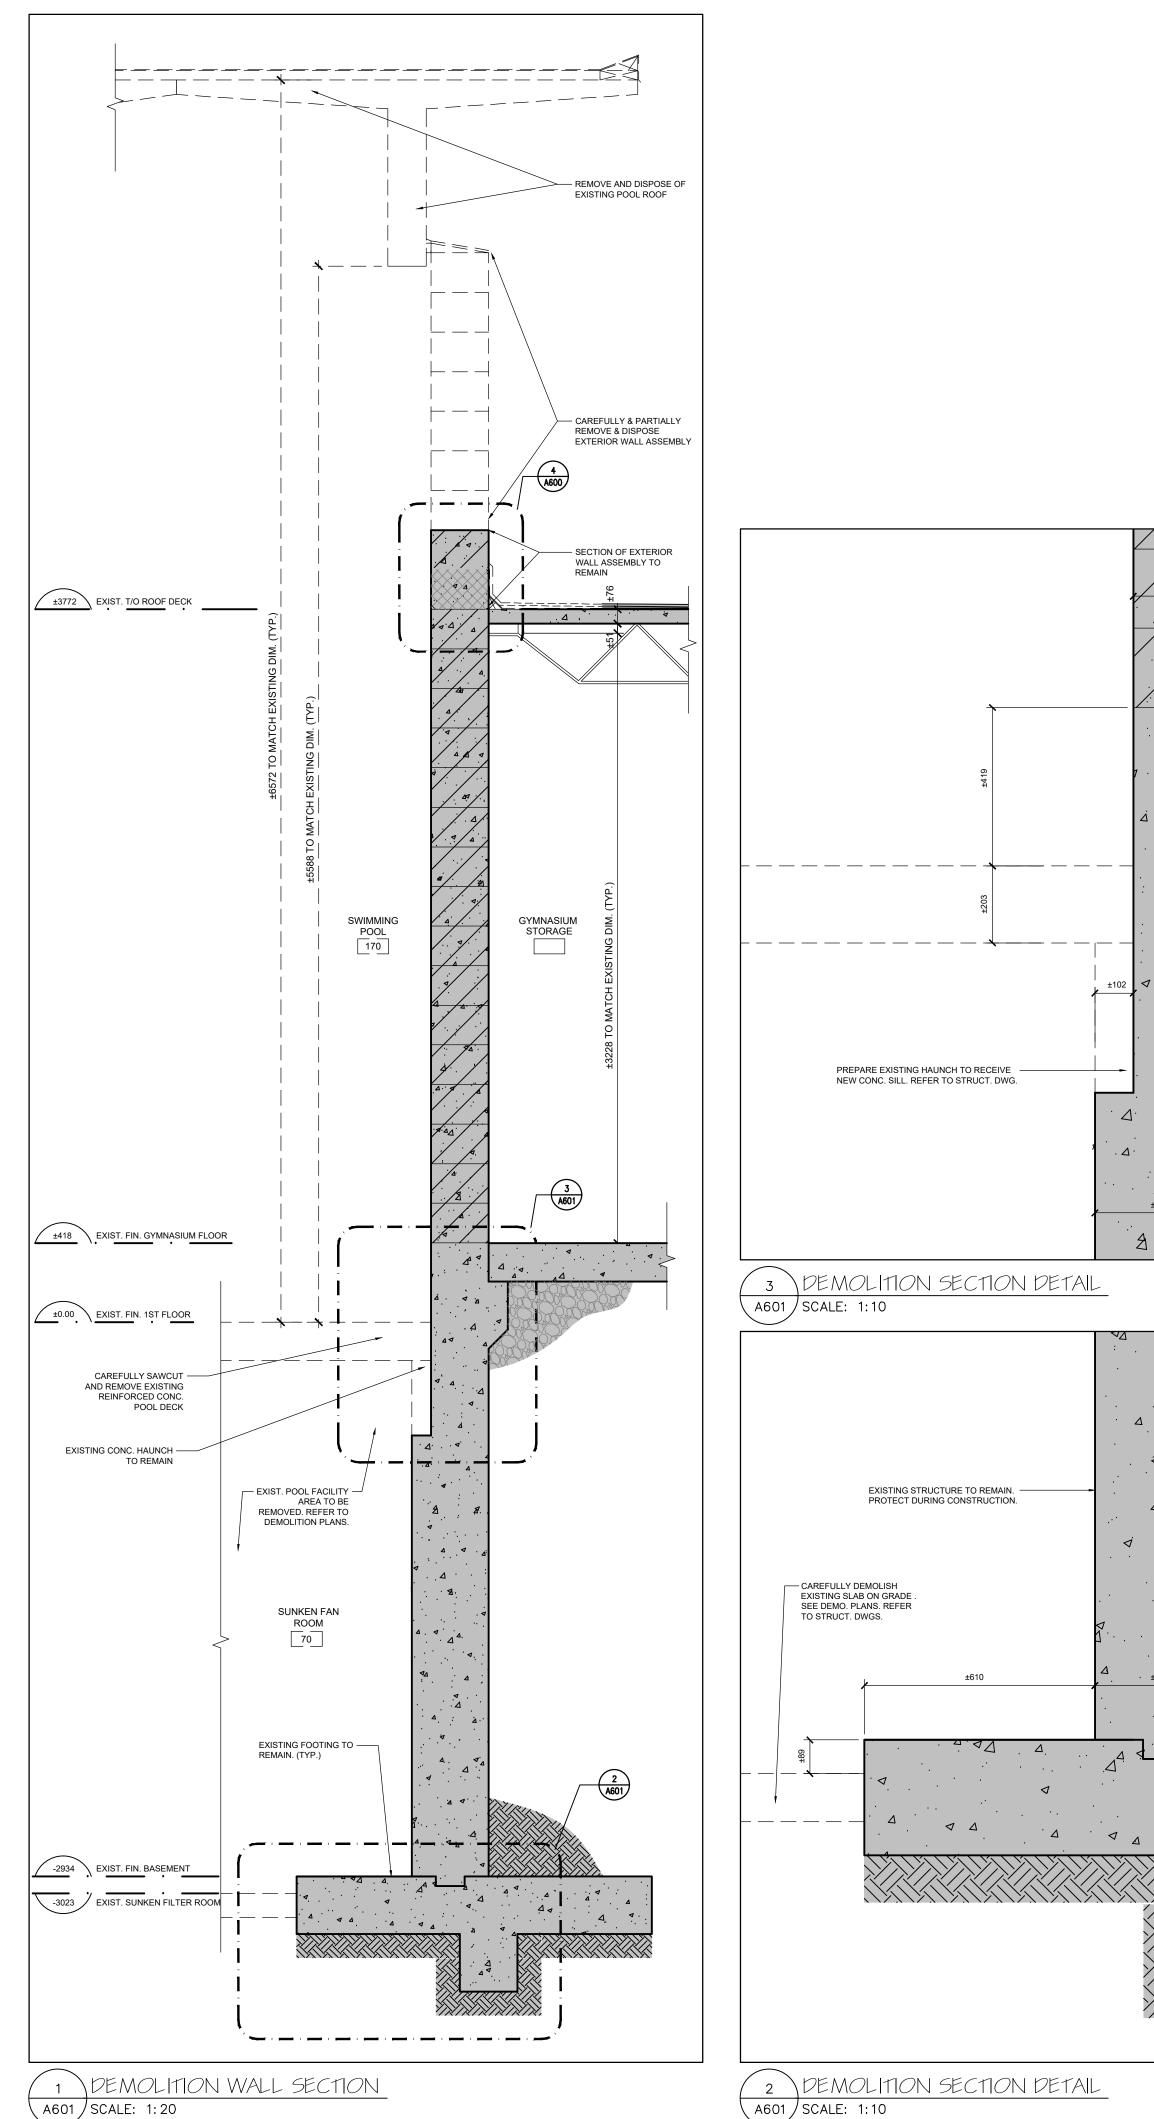


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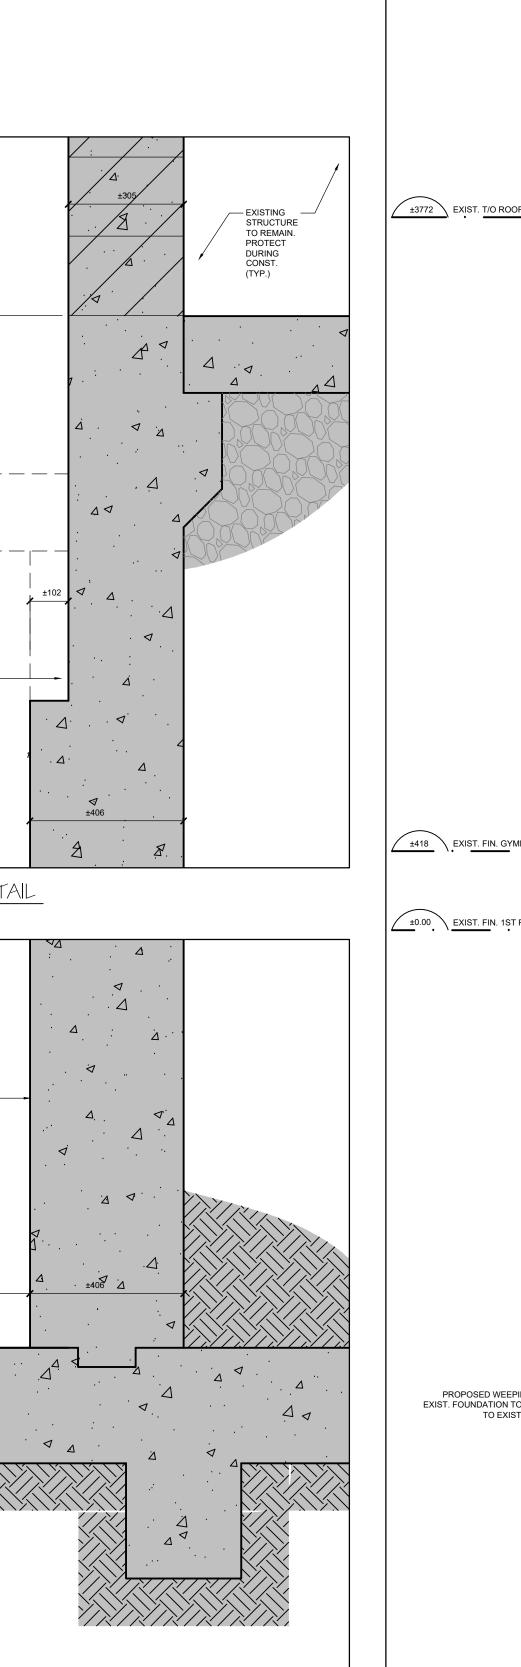
POOL DEMOLITION


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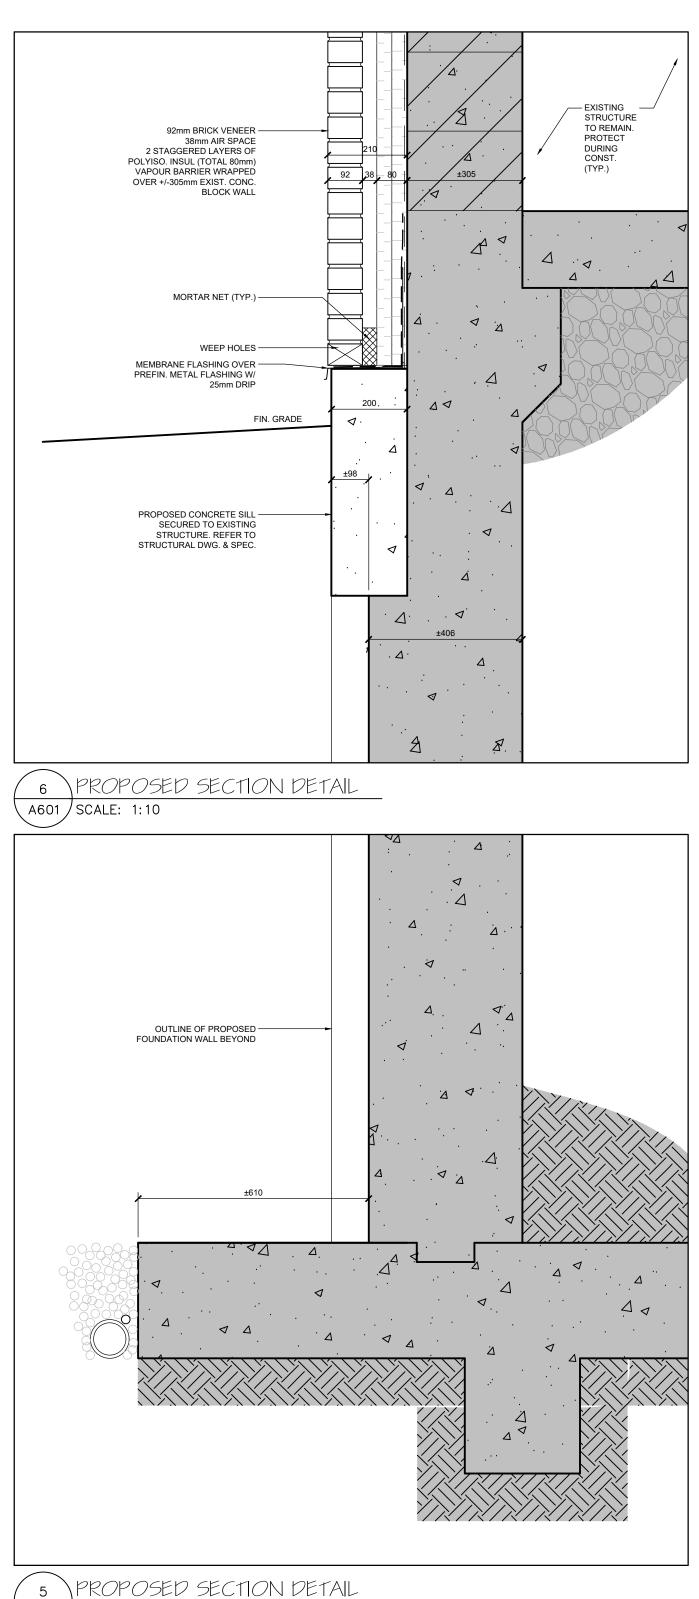


A601 SCALE: 1:20



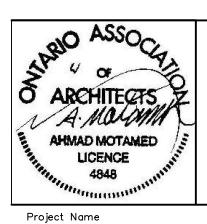

4 PROPOSED WALL SECTION A601 / SCALE: 1:20

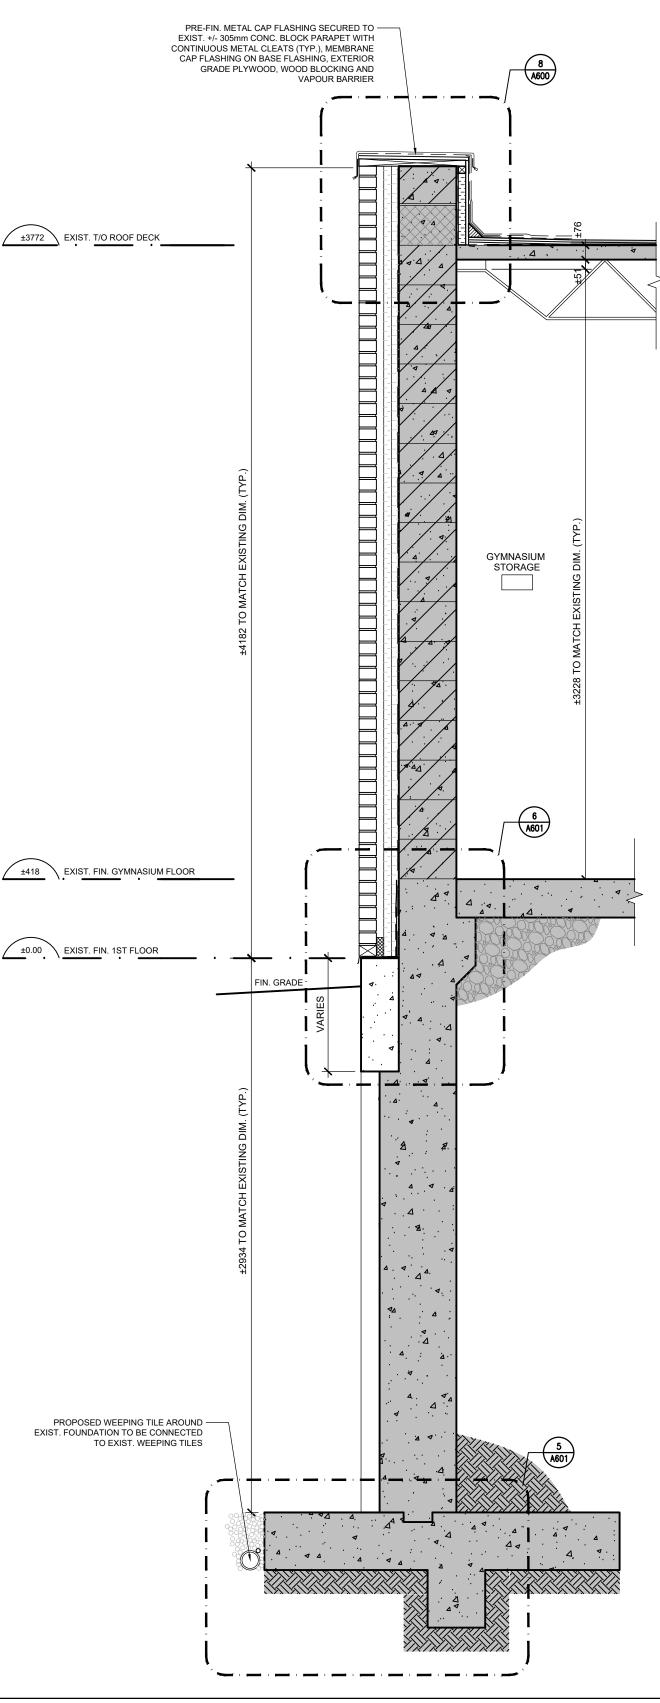


A601 SCALE: 1:10


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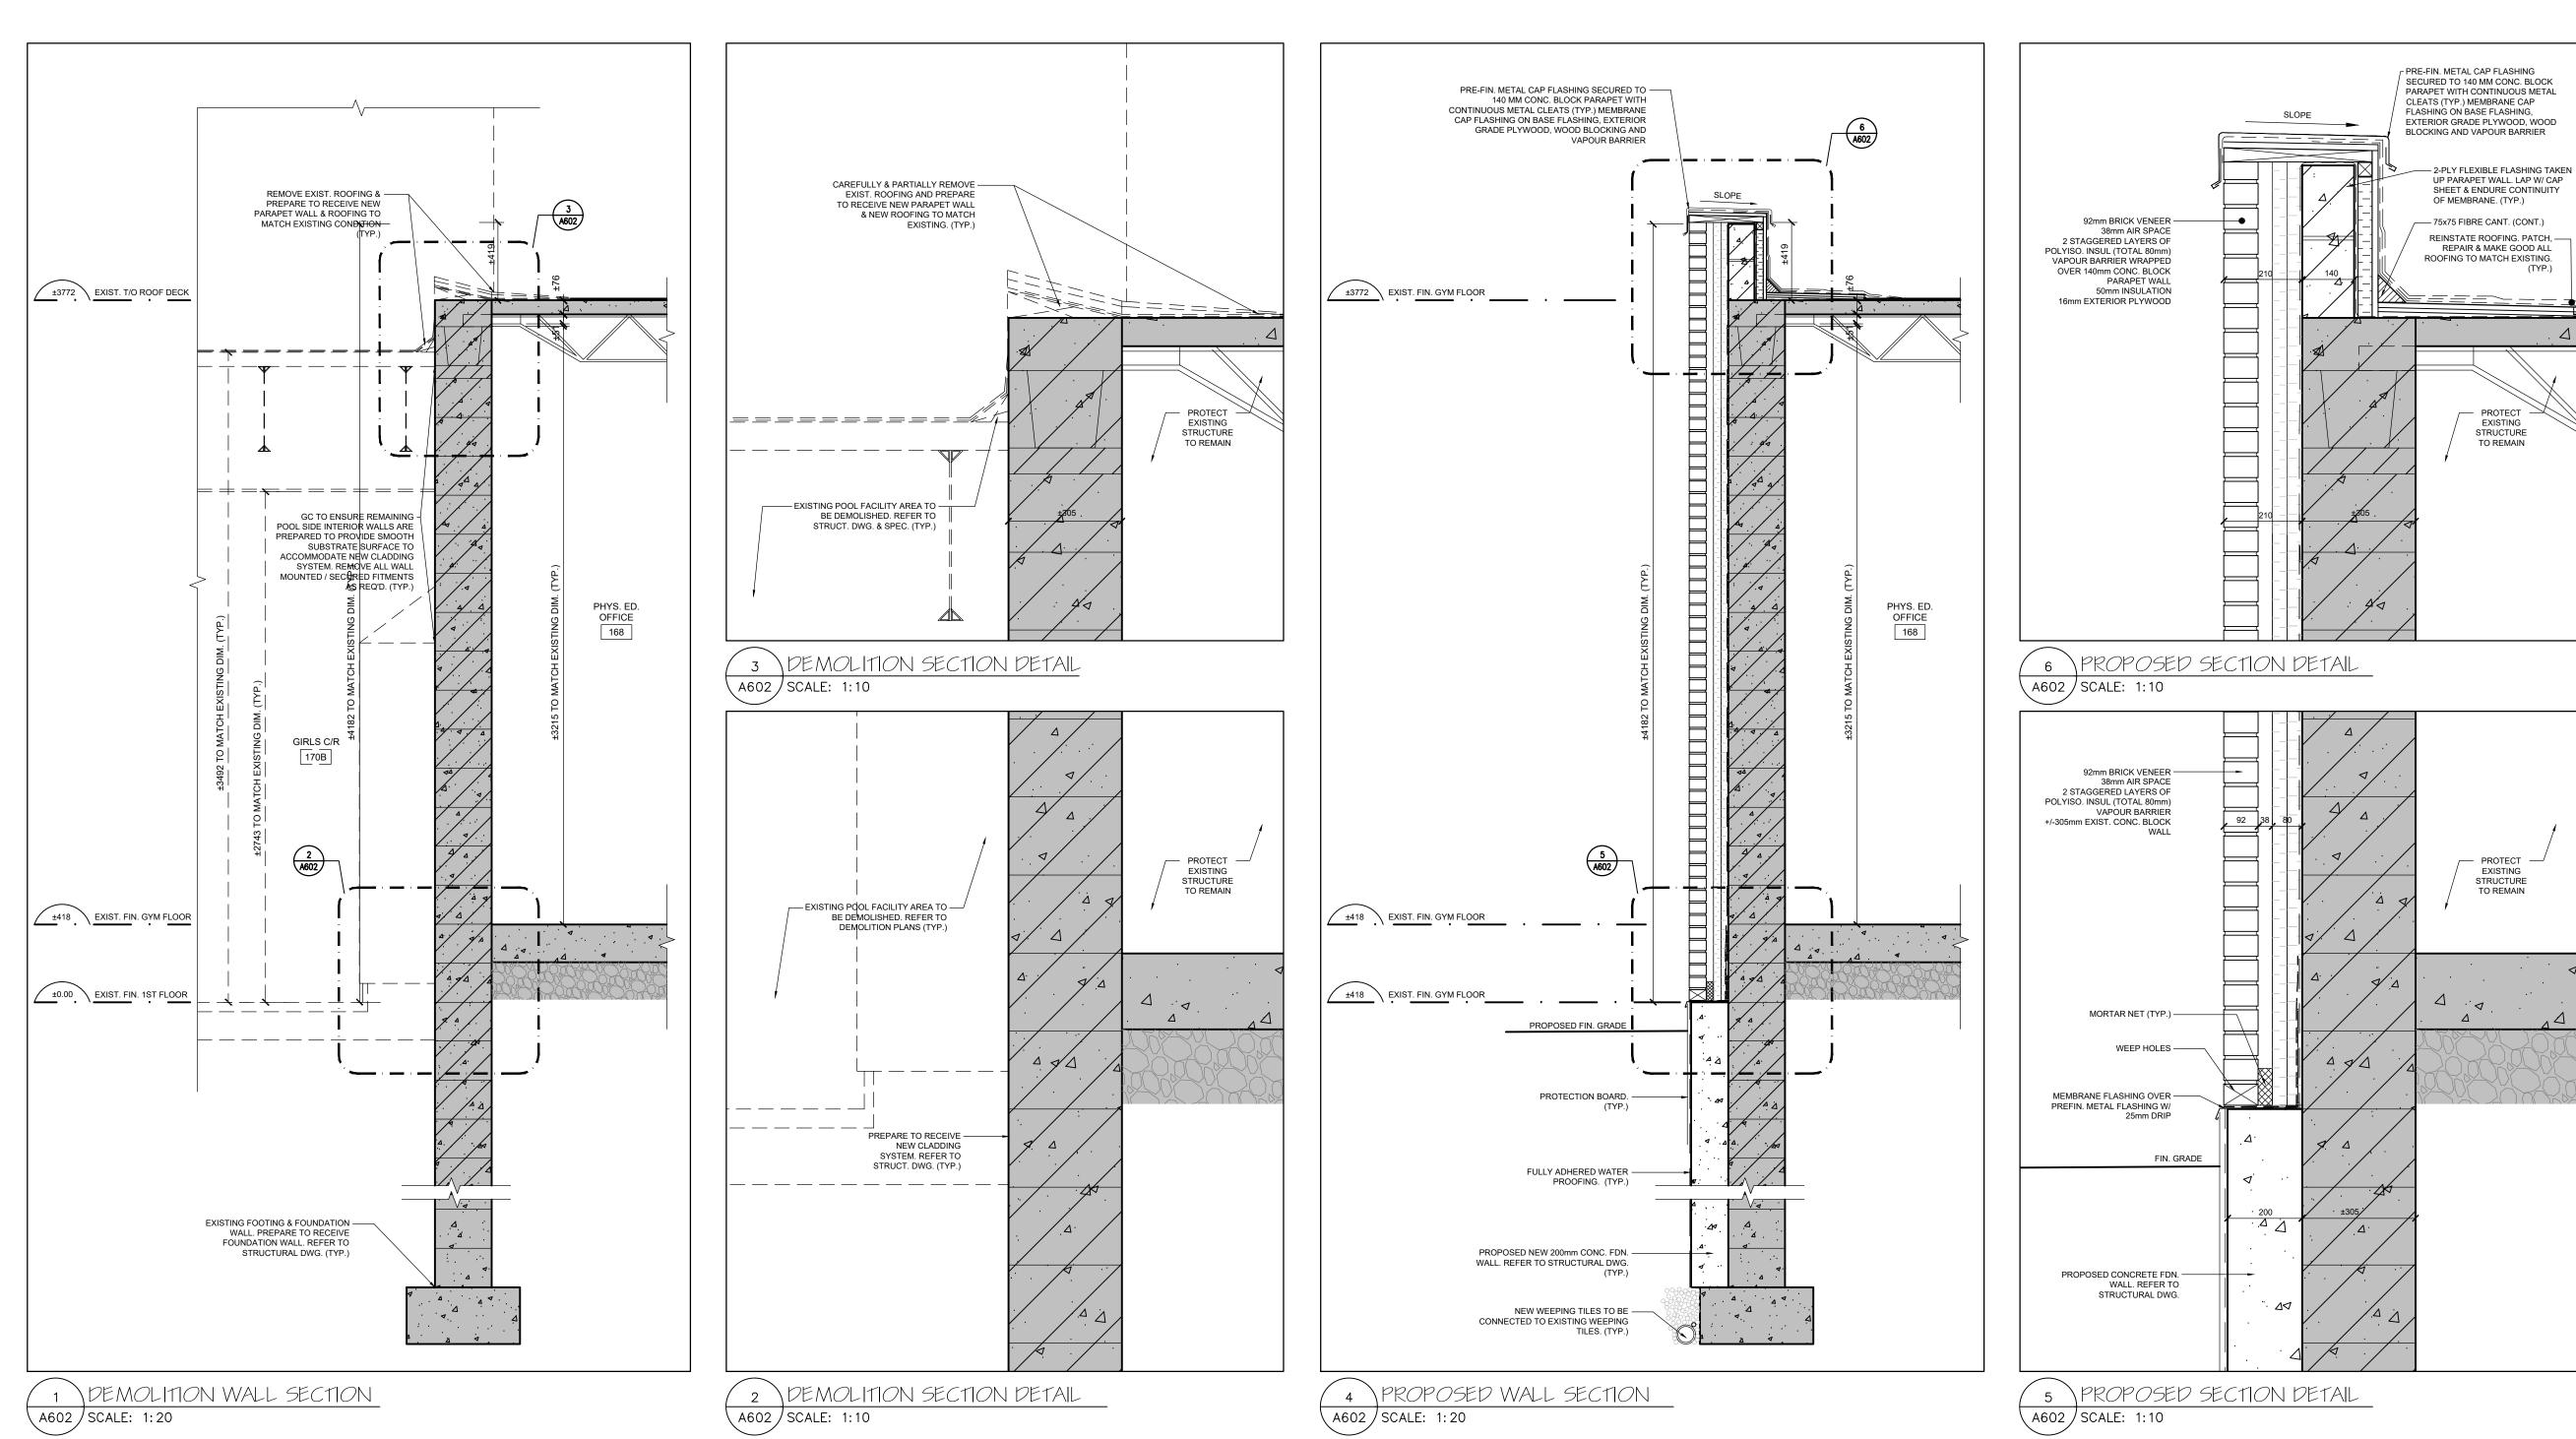


GLENFOREST POOL GLENFOREST SECONDARY SCHOOL 2575 FIELDGATE DR., MISSISSAUGA, ON L4X 2J6

POOL DEMOLITION

Drawing Title
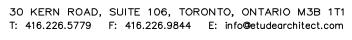
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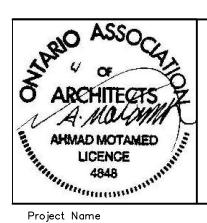
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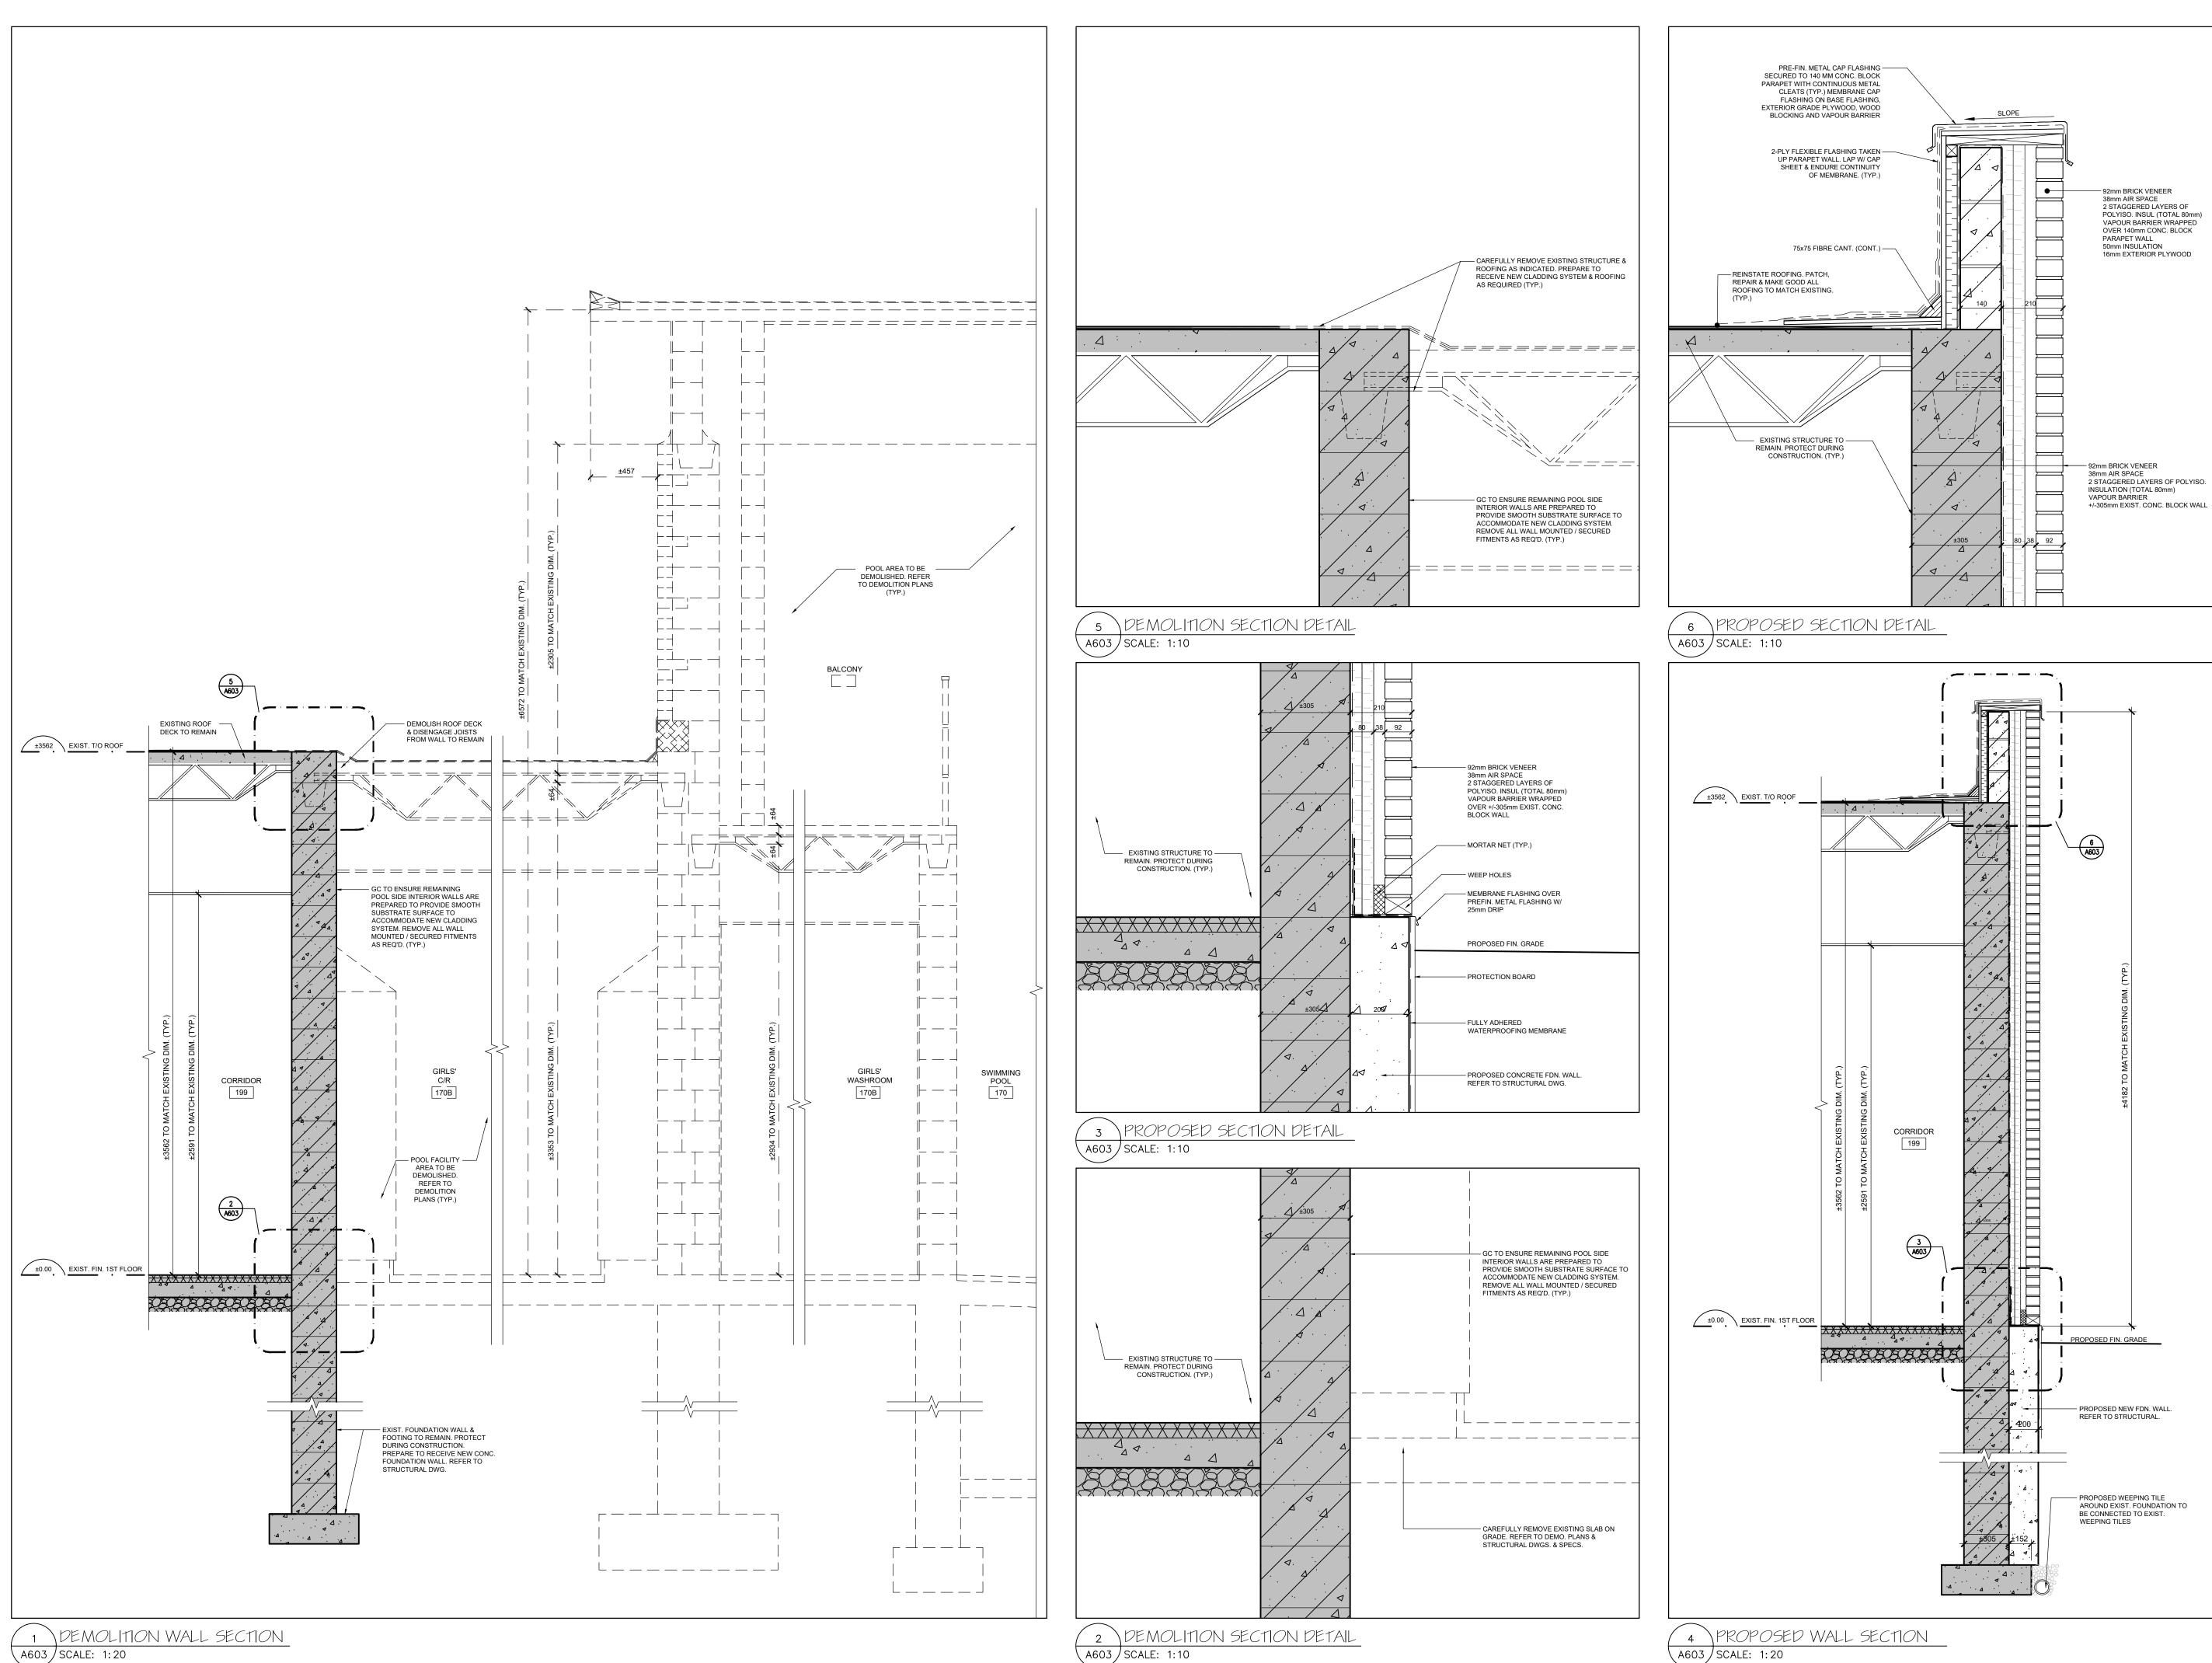


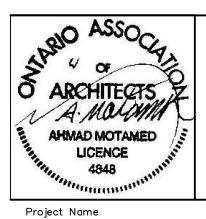GLENFOREST POOL GLENFOREST SECONDARY SCHOOL 2575 FIELDGATE DR., MISSISSAUGA, ON L4X 2J6

POOL DEMOLITION

Drawing Title

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CAD File AS NOTED	Scale AS NOTED		
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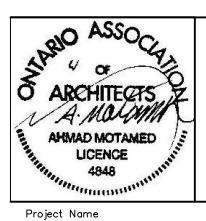
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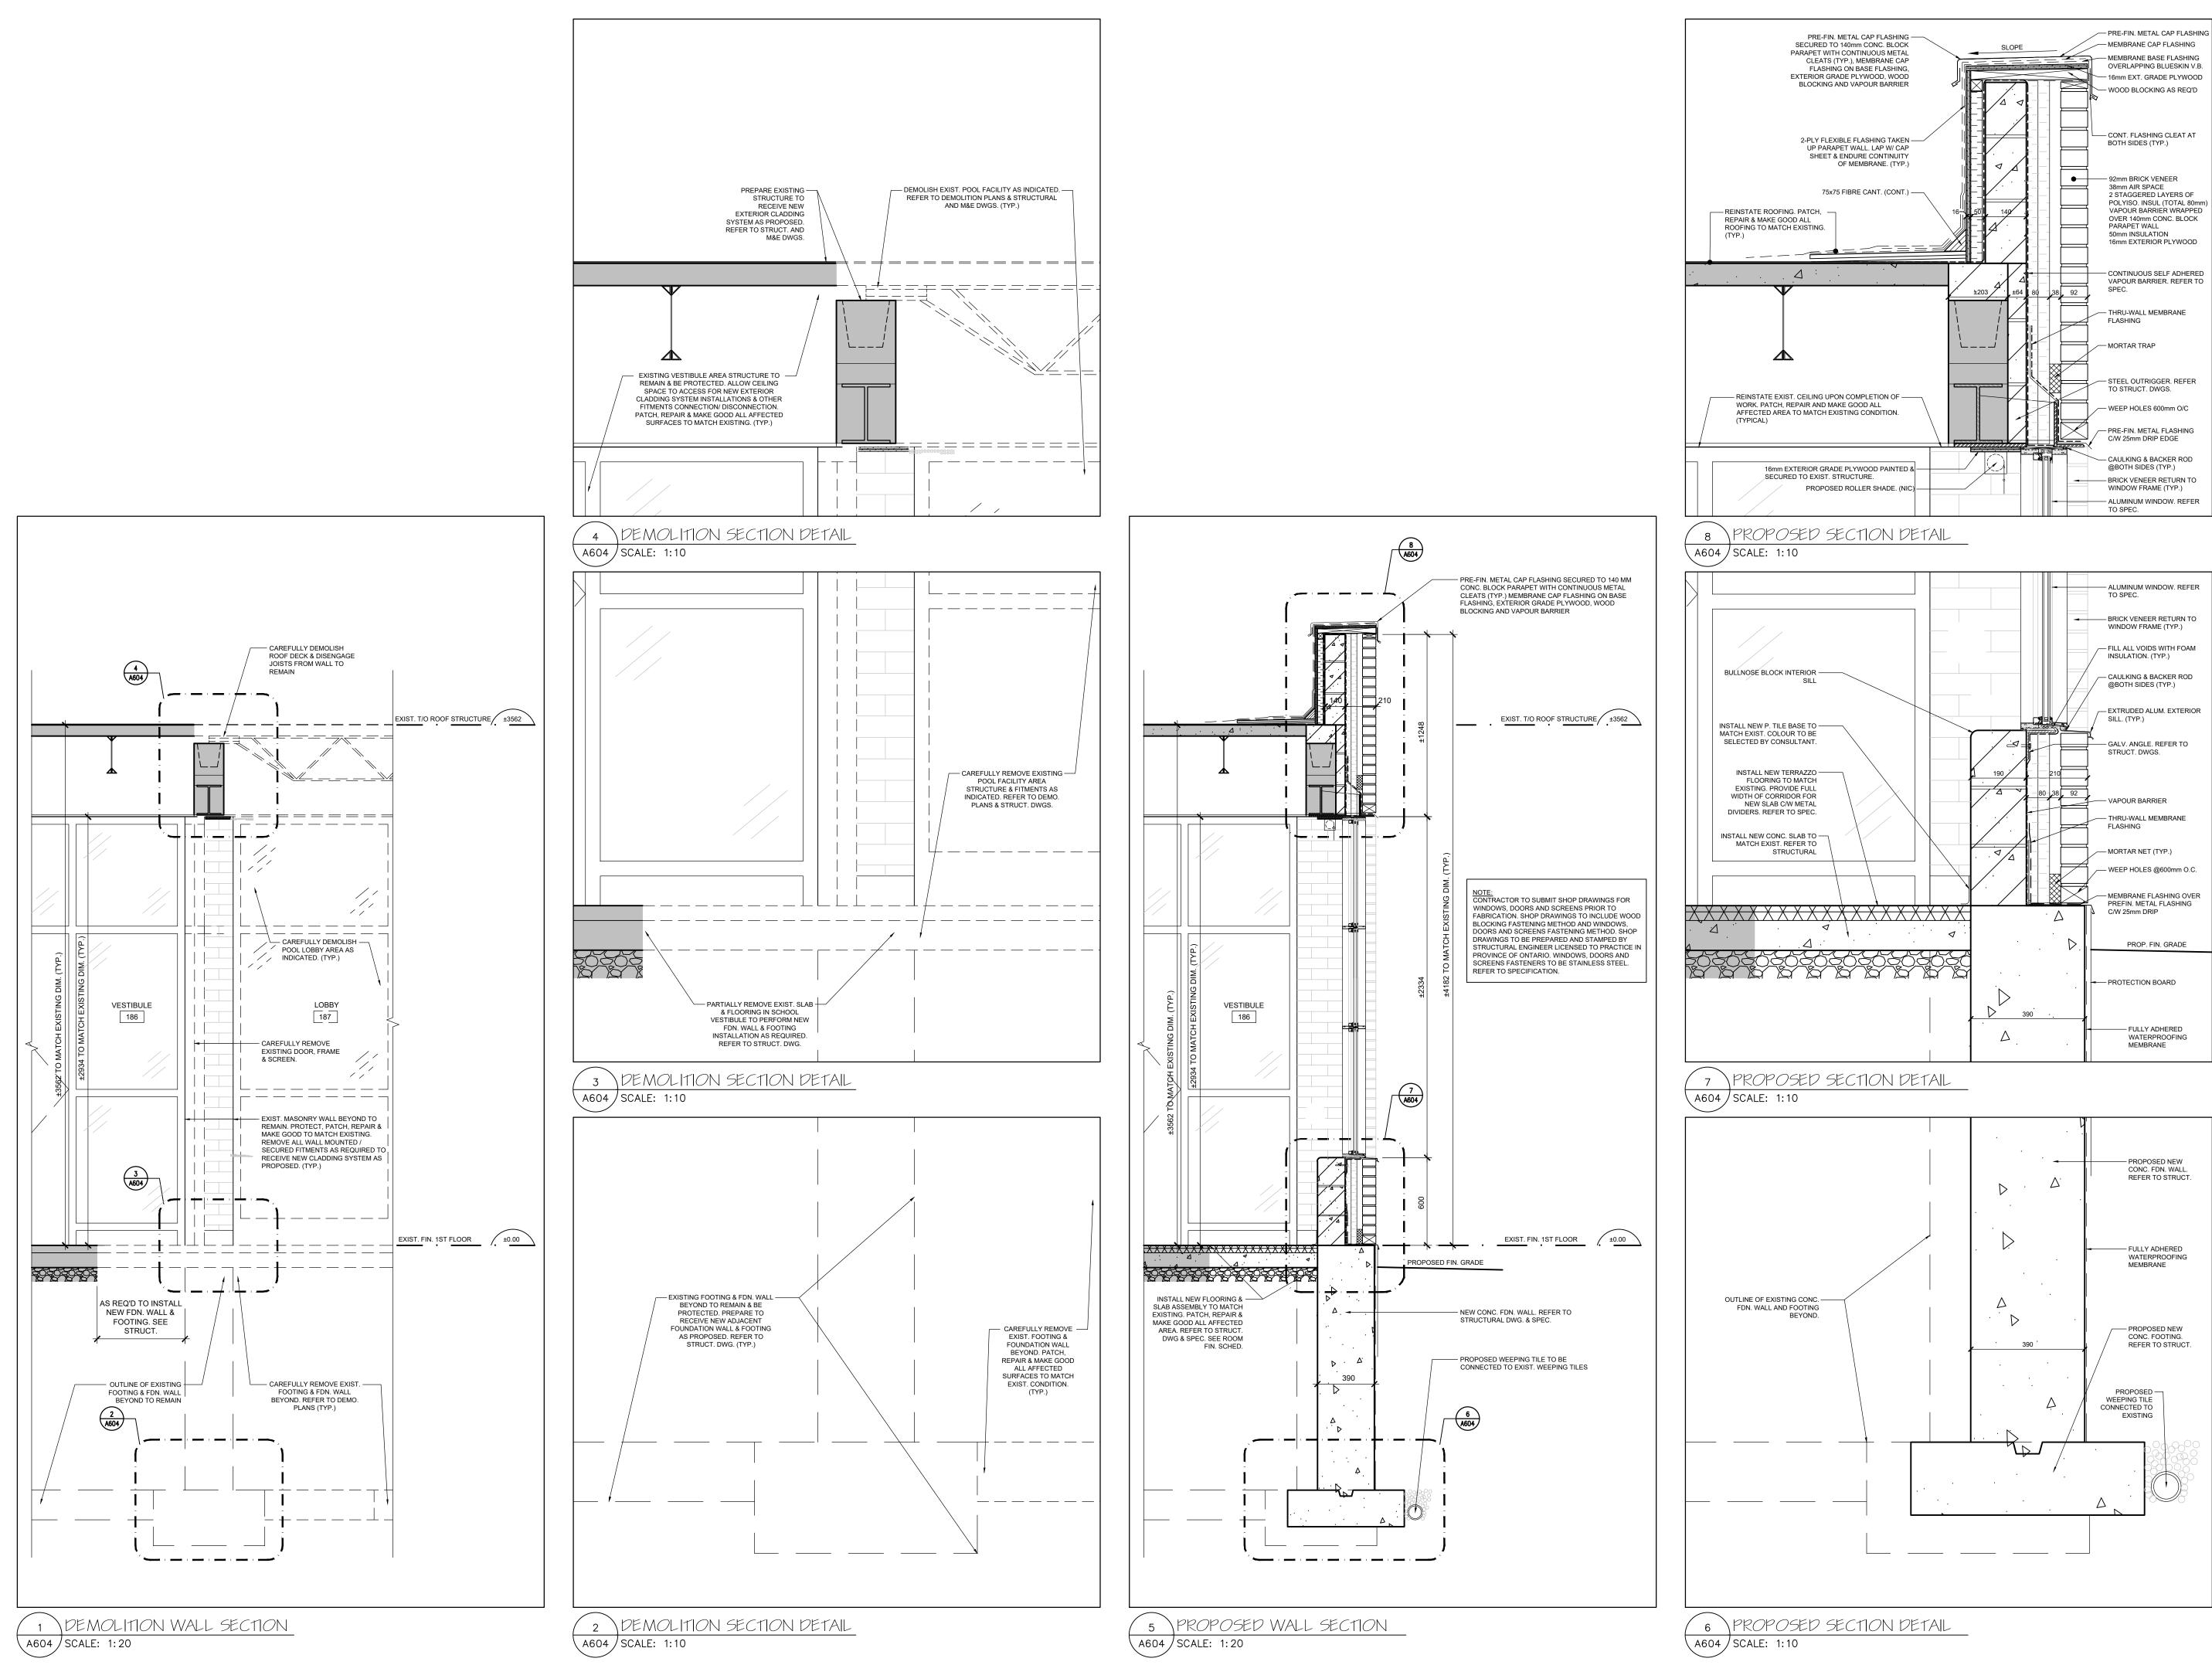


GLENFOREST POOL GLENFOREST SECONDARY SCHOOL 2575 FIELDGATE DR., MISSISSAUGA, ON L4X 2J6

POOL DEMOLITION

Drawing Title

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CAD File AS NOTED	Scale AS NOTED					
Date DECEMBER 2022	Project No. 222113	Revision No.				




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5	ISSUED FOR TENDER	APRIL 10, 2024
4	ISSUED FOR PRE-TENDER REVIEW	MARCH 26, 2024
3	ISSUED FOR SPA	JANUARY 05, 2024
2	ISSUED FOR BUILDING PERMIT	NOVEMBER 03, 2023
1	ISSUED FOR CLIENT REVIEW	FEBRUARY 06, 2023
NO.	DESCRIPTION	DATE
REV	ISIONS / ISSUES	



5650 Hurontario Street, Mississauga, Ont., L5R 1C6 Tel: (905) 890—1099, Fax: (905) 890—9453

30 KERN ROAD, SUITE 106, TORONTO, ONTARIO M3B 1T1 T: 416.226.5779 F: 416.226.9844 E: info@etudearchitect.com

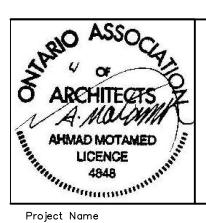



GLENFOREST POOL GLENFOREST SECONDARY SCHOOL 2575 FIELDGATE DR., MISSISSAUGA, ON L4X 2J6


POOL DEMOLITION

Drawing Title

Graphic Scale AS SHOWN		Sheet no.				
Drawn AK / VSP	Checked AM	A604				
CAD File AS NOTED	Scale AS NOTED					
Date DECEMBER 2022	Project No. 222113	Revision No.				

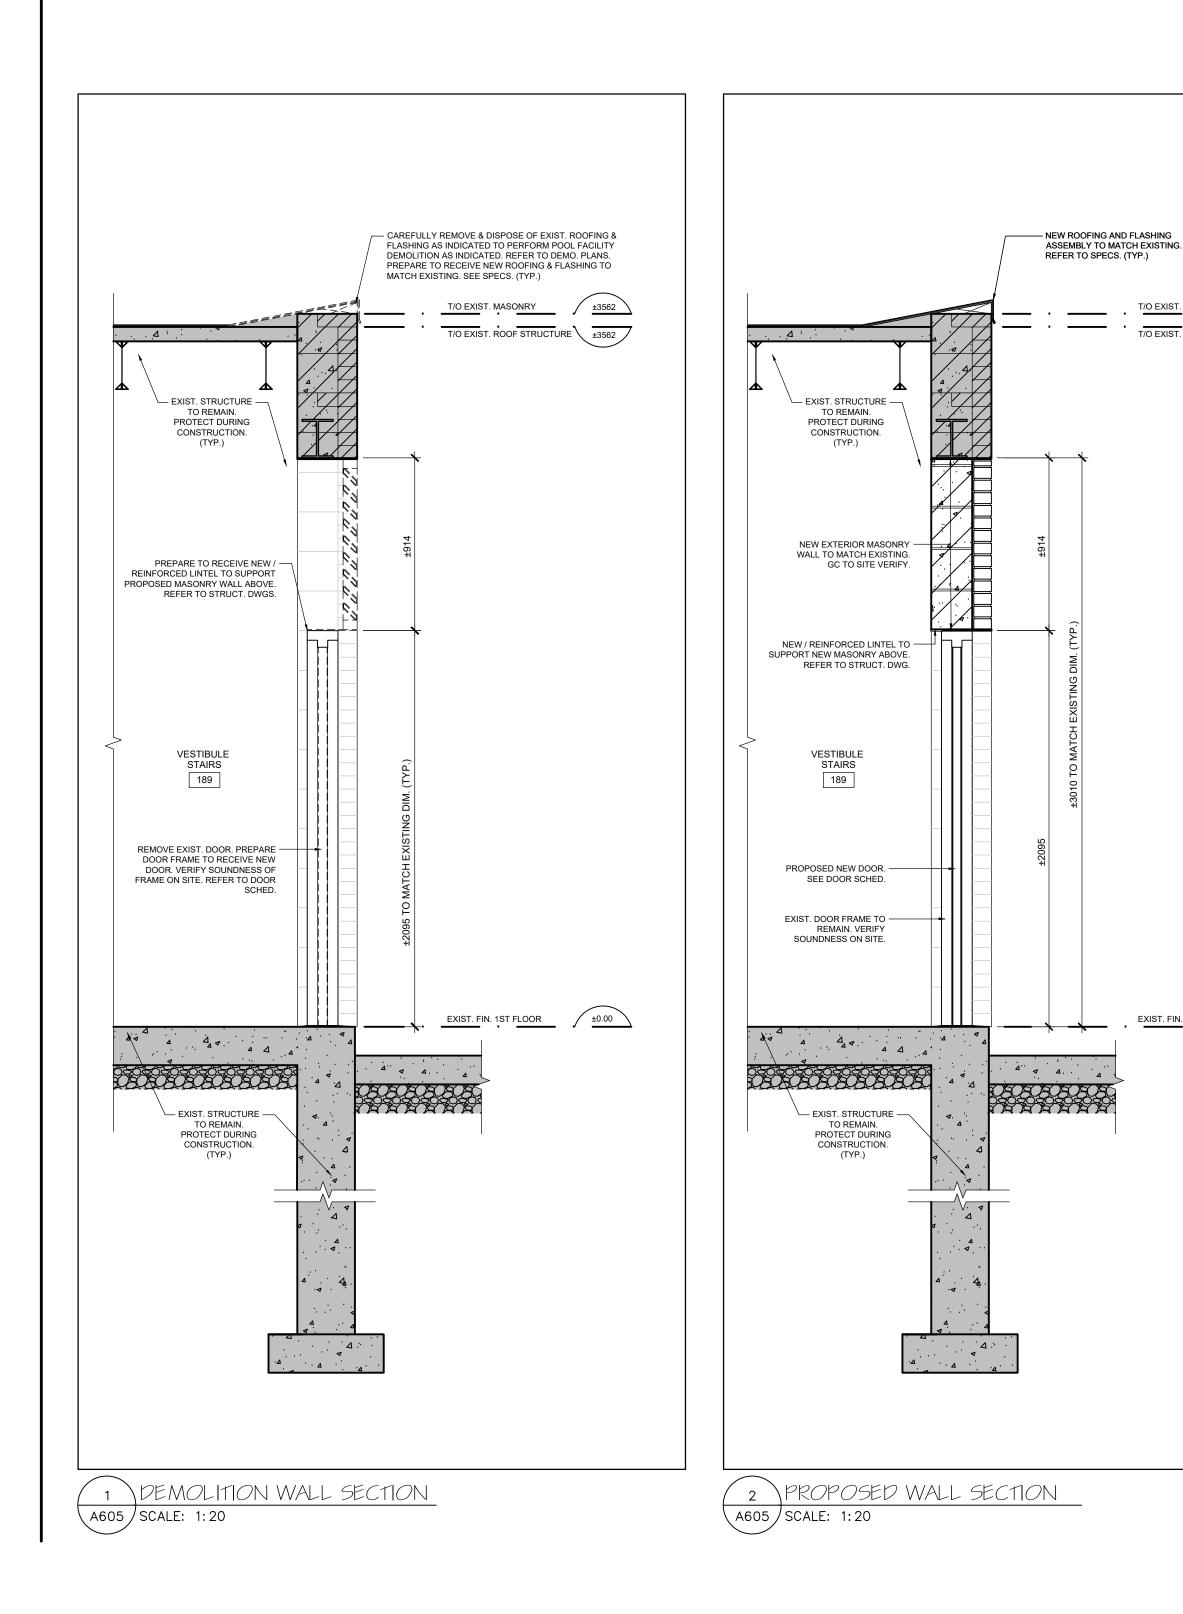

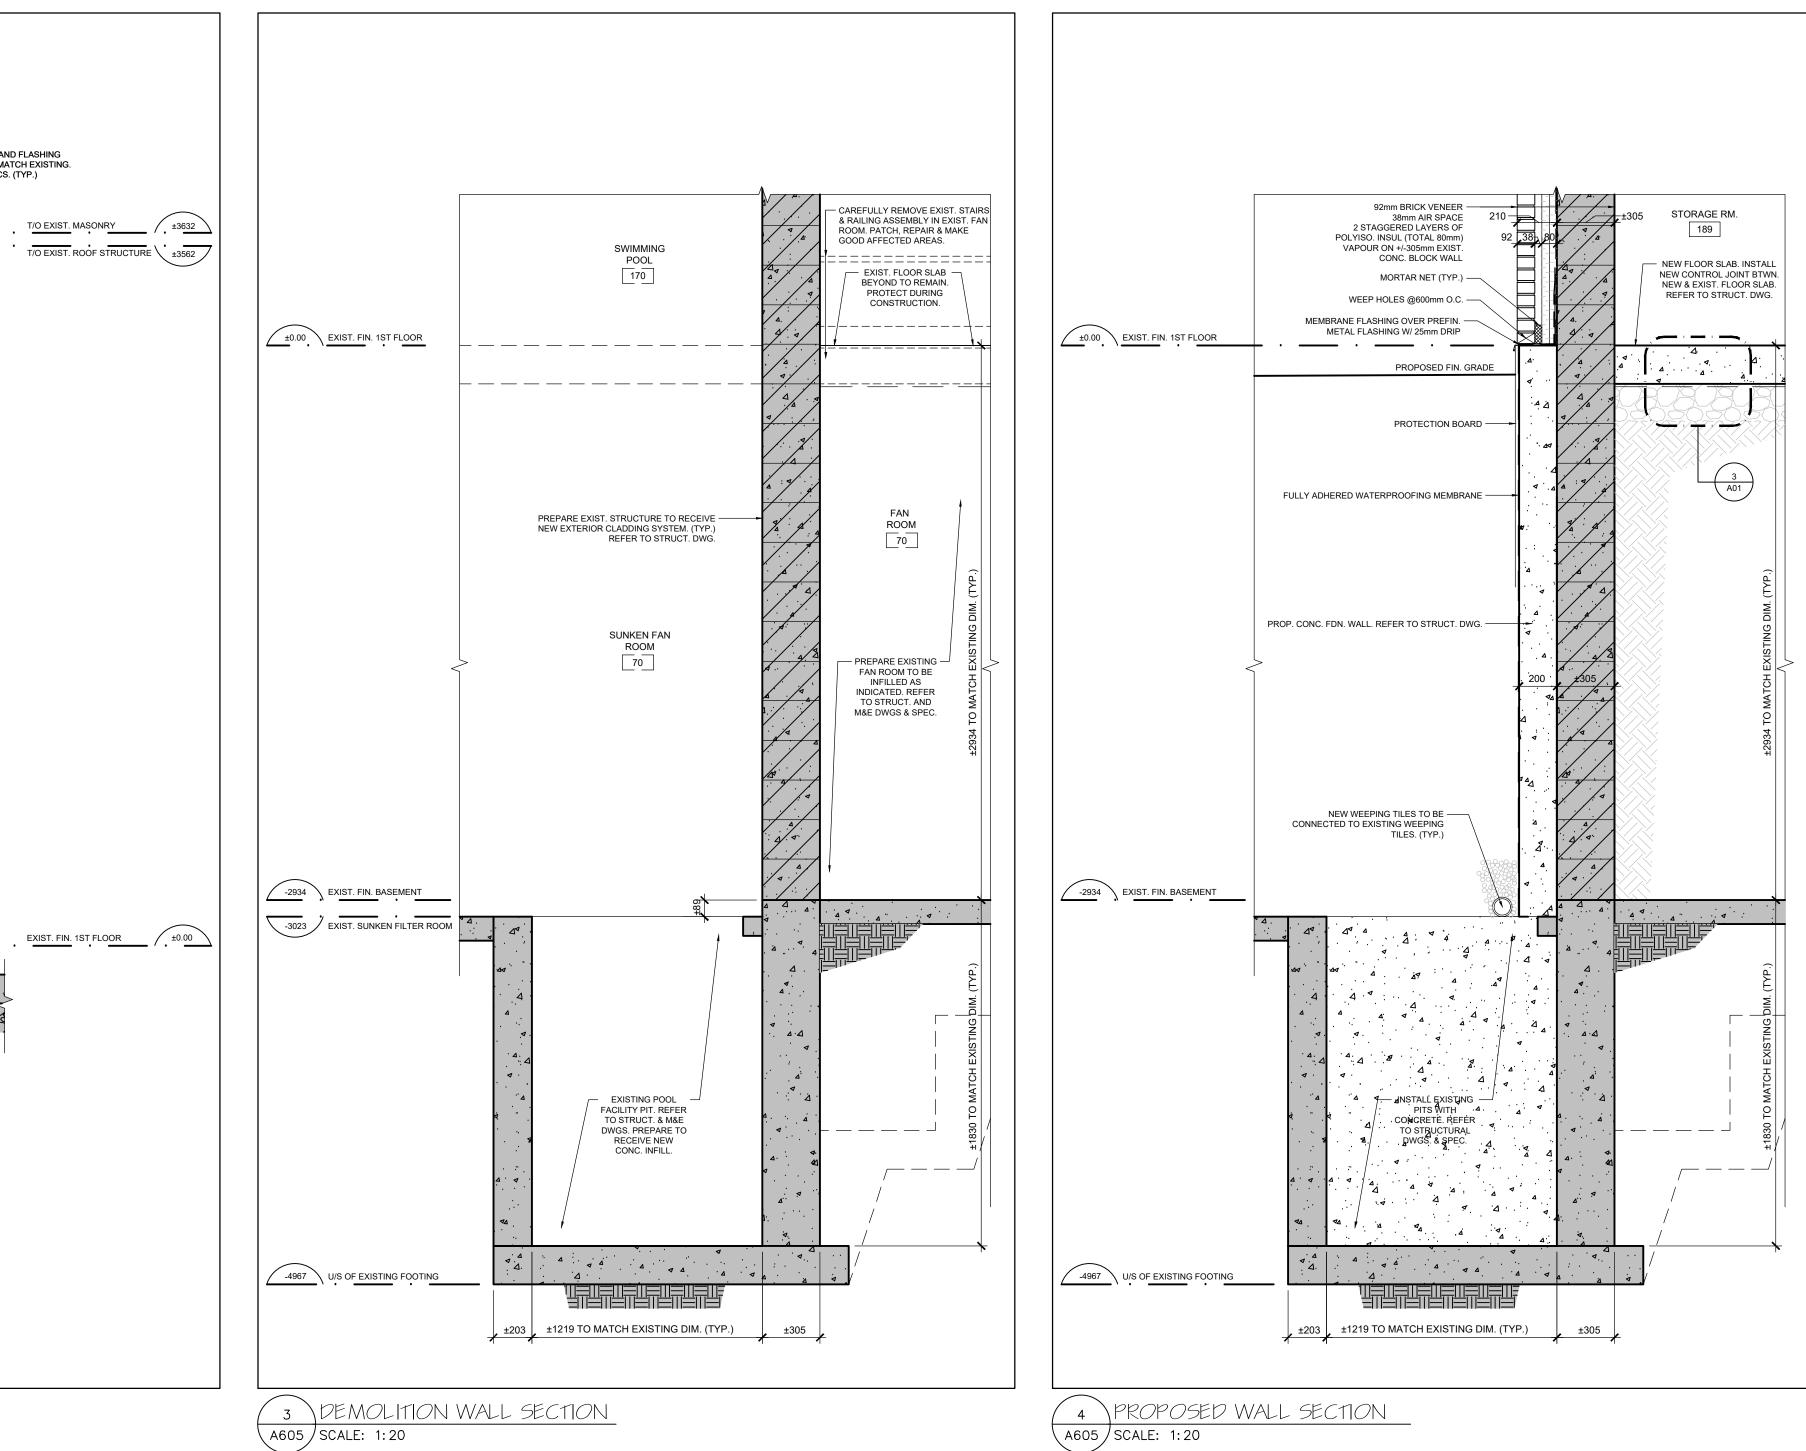

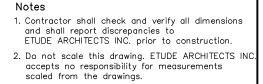


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REV	ISIONS / ISSUES	



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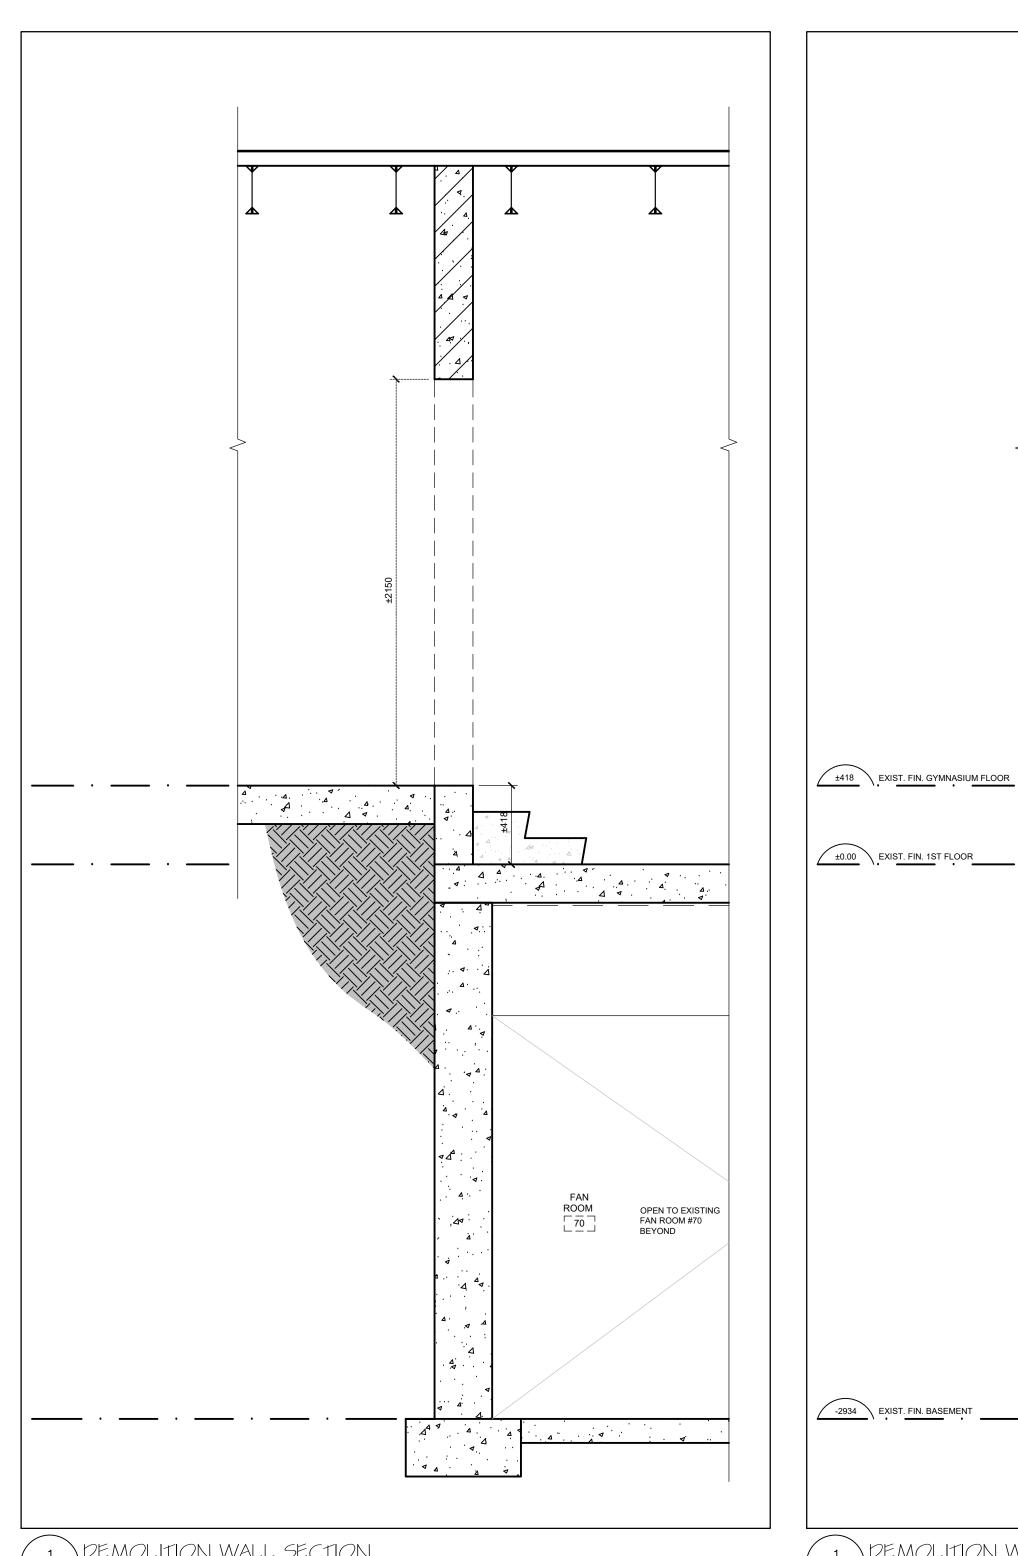


GLENFOREST POOL GLENFOREST SECONDARY SCHOOL 2575 FIELDGATE DR., MISSISSAUGA, ON L4X 2J6

POOL DEMOLITION

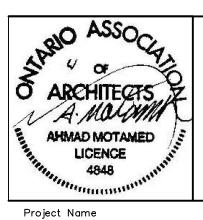
- Drawing Title
- WALL SECTIONS


Graphic Scale AS SHOWN		Sheet no.				
Drawn AK / VSP	Checked AM	A605				
CAD File AS NOTED	Scale AS NOTED					
Date DECEMBER 2022	Project No. 222113	Revision No.				



1 DEMOLITION WALL SECTION A606 SCALE: 1:20

1 DEMOLITION WALL SECTION A606 SCALE: 1:20

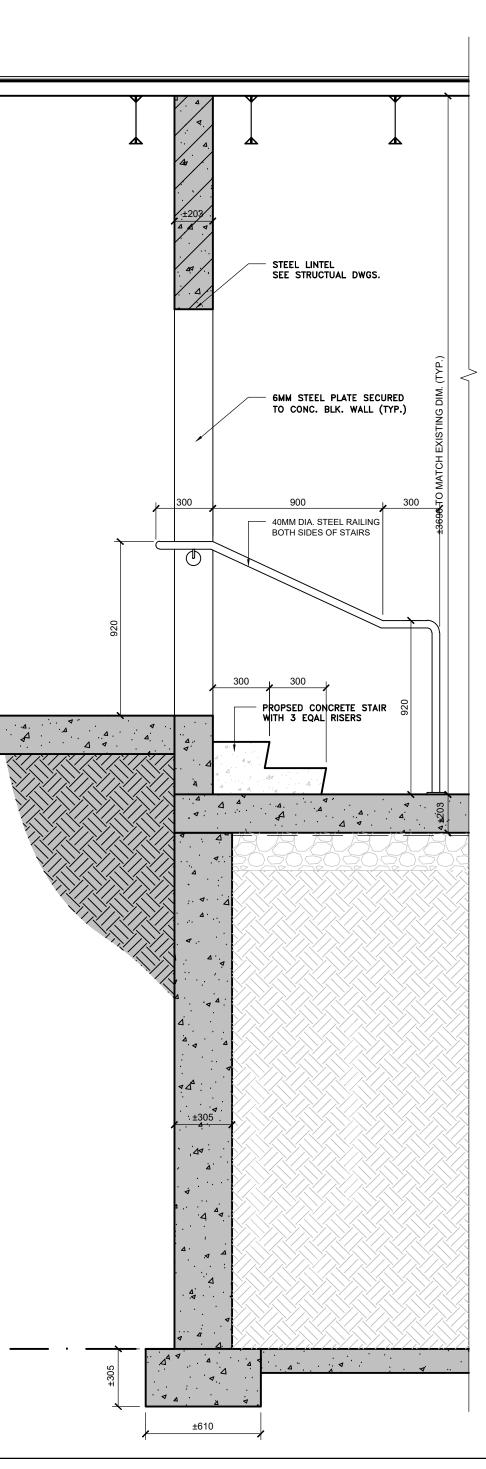

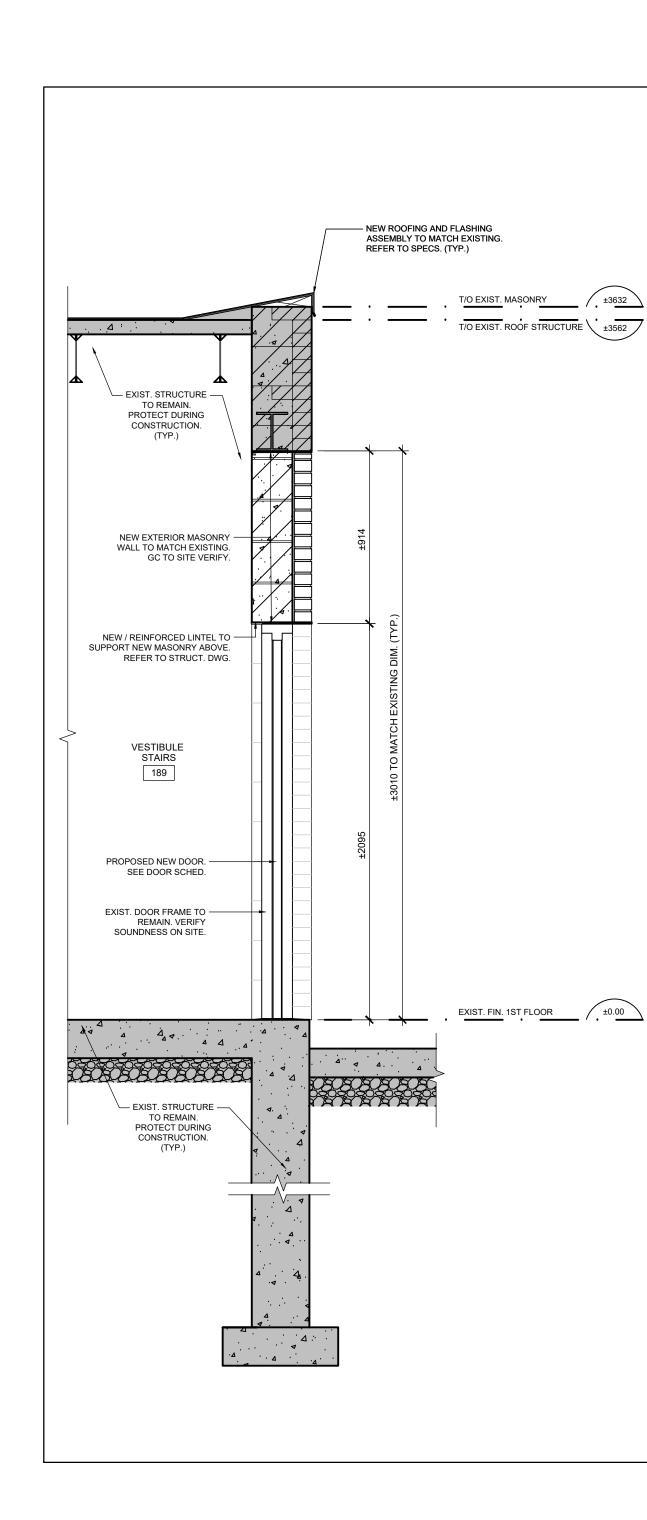

Notes
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ETUDE ARCHITECTS INC. prior to construction.
2 Do not scale this drawing FTUDE ARCHITECTS INC


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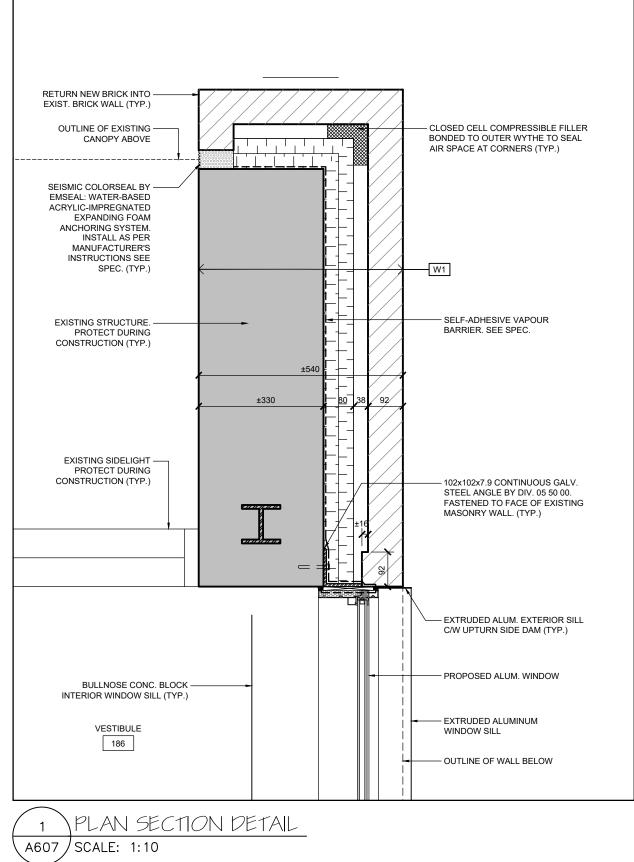
GLENFOREST POOL GLENFOREST SECONDARY SCHOOL 2575 FIELDGATE DR., MISSISSAUGA, ON L4X 2J6


POOL DEMOLITION

Drawing Title

WALL SECTIONS

Graphic Scale Sheet no. AS SHOWN Drawn Checked A606 AK / VSP AM CAD File Scale AS NOTED AS NOTED Project No. Revision No. Date DECEMBER 2022 222113

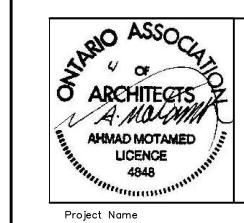

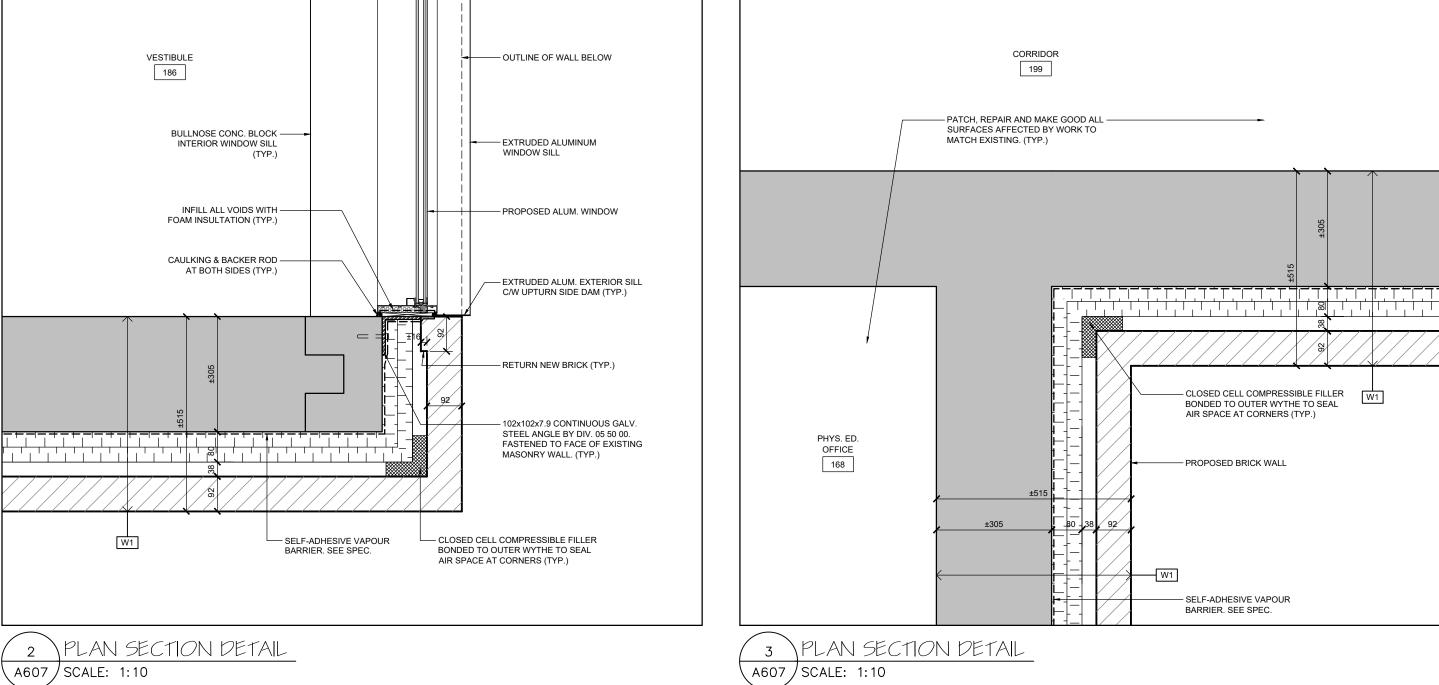


2 PLAN SECTION DETAIL A607 SCALE: 1:10




GYMNASIUM

'A' 169A

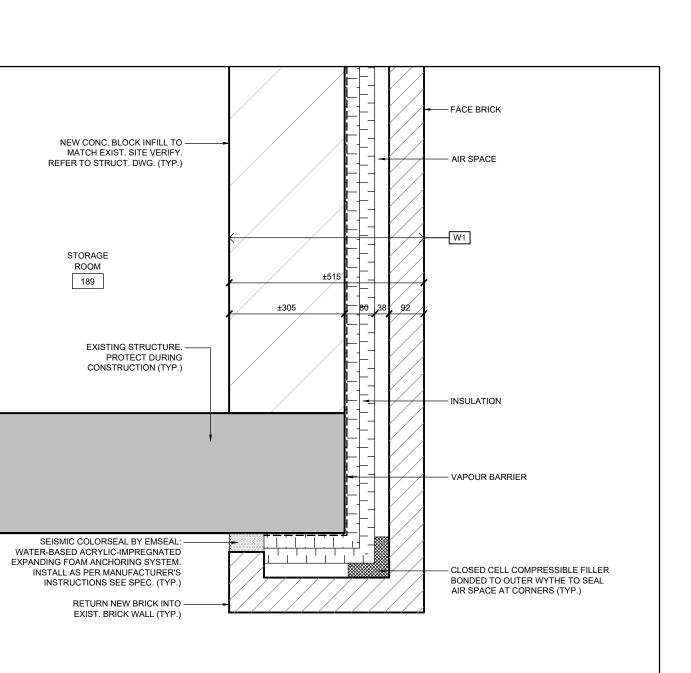

5 PLAN SECTION DETAIL A607 SCALE: 1:10

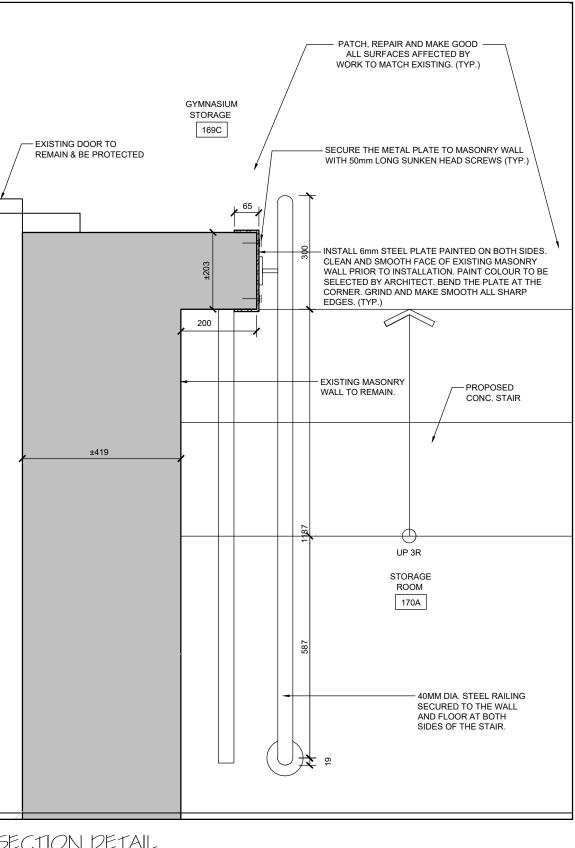


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GLENFOREST POOL GLENFOREST SECONDARY SCHOOL 2575 FIELDGATE DR., MISSISSAUGA, ON L4X 2J6

POOL DEMOLITION

Drawing Title

PLAN SECTION DETAILS

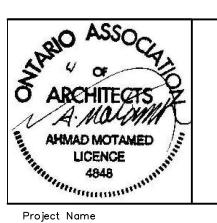Graphic Scale AS SHOWN		Sheet no.			
Drawn AK / VSP	Checked AM	A607			
CAD File AS NOTED	Scale AS NOTED				
Date DECEMBER 2022	Project No. 222113	Revision No.			

	DOOR SCHEDULE	
A900		

															DOC	DR SCH	HEDUL	E								
			DOORS									FRAMES AND SCREENS						HARDWARE								R
DOOR NO.	FROM	то	SWING	ТҮРЕ	НЕІСНТ	MDTH	THICKNESS	MATERIAL	FINISH	GLAZING	ТҮРЕ	MATERIAL	FINISH	JAMB TYPE	THRESHOLD TYPE	FIRE RATING LABEL	LOCK SET	PRIVACY SET	PASSAGE SET	CLOSER	STOP PANIC PENIC	PIII / PISH	WEATHER STRIPPING	STAINLESS STEEL KICKPLATE	AUTOMATIC DOOR	DOOR SWINGS L.F. TG : TEMPERED PLATE GLASS SU : DOUBLE GLAZED SEALED UNITS FG : FIRE RATED GLASS FG : FIRE RATED GLASS ALUM.: ALUMINUM PT. : PAINT F.C. : FOAM CORE G. : GLAZE S.W.C.: SOLID WOOD CORE ST. : STEE H.M. : HOLLOW METAL ST. : STEE
-	-	-	-	-	-	-	-	-	-	-	-	-	-	-	-	-	-	. -	-	-	- .	- -	- -	-	-	
170A	STORAGE ROOM #170A	STORAGE ROOM #189	RH/LH	D1	2150	950 X 2	45	нм	РТ	-	F1	нм	РТ	J1	-	-	Δ		-	Δ	Δ			Δ	-	
186	EXISTING VESTIBULE	EXTERIOR	RH/LH	EX	EX	EX	EX	нм	РТ	-	EX	нм	РТ	EX	EX	-	EX		-	Δ		<u>م</u> د	Δ	Δ	-	CLEAN AND PAINT DOORS AND FRAMES, INCLU
189	STORAGE ROOM #189	EXTERIOR	RH / LH	D1	±2032 x 2	±915 x 2	45	нм	РТ	-	EX	EX	PT	EX	ALUM	1	Δ		-	Δ	Δ	- Δ	Δ	Δ	-	GC TO VERIFY SOUNDNESS OF FRAME ON SITE
- COI	ES:TYPICAL NTRACTOR TO VERIFY ALL I SITE (DOOR OPENINGS, ET(INGS								ES TO I DR AND						KING	SYST	EM.	<u> </u>						- KICK PLATE TO BE STAINLESS STEEL. - HANDLES TO BE LEVER STYLE.
	1 POOR 5	CHEDULE																								

A900

NO.

169C

170A

2 ROOM FINISH SCHEDULE

186	VESTIBULE	EXISTING / CONCRETE	EXIST. / NEW TERRAZZO TO MATCH EXIST.	EXISTING / NEW TILE TO MATCH EXIST.	EXIST. / NEW CONC. BLOCK &/OR GYP. / PLASTER	PT	EXISTING	EXISTING	EXISTING	PATCH, REPAIR & MAKE GOOD ALL AFFECTED SURFACES TO MATCH EXISTING (TYPICAL)
189	STORAGE ROOM	EXISTING / CONCRETE	EPOXY	RUBBER	EXISTING / NEW CONC BLOCK	PT	EXISTING	EXISTING	EXISTING	PATCH, REPAIR & MAKE GOOD ALL AFFECTED SURFACES TO MATCH EXISTING (TYPICAL)
- MAKI - WHE INCL	NOTES: TYPICAL E GOOD ALL DISTURBED RE RENOVATING OR MAH UDING ALL WALLS, DOOF ING FINISH IS PAINT). COI	KING CHANGES TO EXIST S & FRAMES (NEW & EX	FING BUILDING, PAINT EI IST. @ BOTH SIDES), CE	NTIRE AREA	FLOOR PLANS A	ND/OR INTERIOR	AD IN CONJUNCTION WITH I R ELEVATIONS. (TYPICAL) . WALLS, BULKHEADS AND (ICATIONS.		,	WHERE RENOVATING OR MARKING CHANGES TO EXIST. CEILING, REPLACE & MAKE GOOD AN DAMAGED CEILING AREA TO MATCH EXIST. GC TO MAINTAIN EXIST. FIRE RATING OF ASSEMBL TO MATCH EXIST.

WALLS

FINISH

PT

MATERIAL

EXISTING

— EXISTING

ROOM FINISH SCHEDULE

MATERIAL

EXISTING

CEILING

FINISH

EXISTING

HEIGHT

EXISTING

A900 SCALE: 1:50

6 WINDOW TYPE

ROOM

NAME

GYM STORAGE

STORAGE ROOM

		/	±30)48	
260		//			//
±2336 683 .				// //	
803			<i>" </i> <i> </i>		
600 A.F.F	⋞	, 474	, 1050	, 1050	474

FLOOR

FINISH

EPOXY


SUB-FLOOR

-

EXISTING

BASE


RUBBER

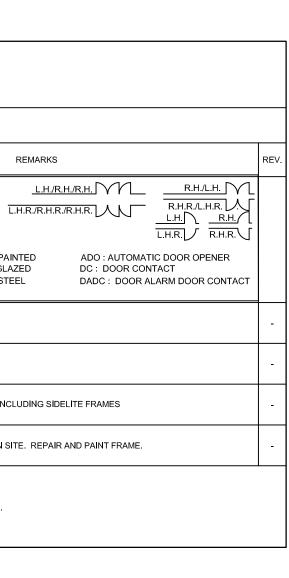



REMARKS

PATCH, REPAIR & MAKE GOOD ALL AFFECTED SURFACES TO MATCH EXISTING (TYPICAL)

PATCH, REPAIR & MAKE GOOD ALL AFFECTED SURFACES TO MATCH EXISTING (TYPICAL)

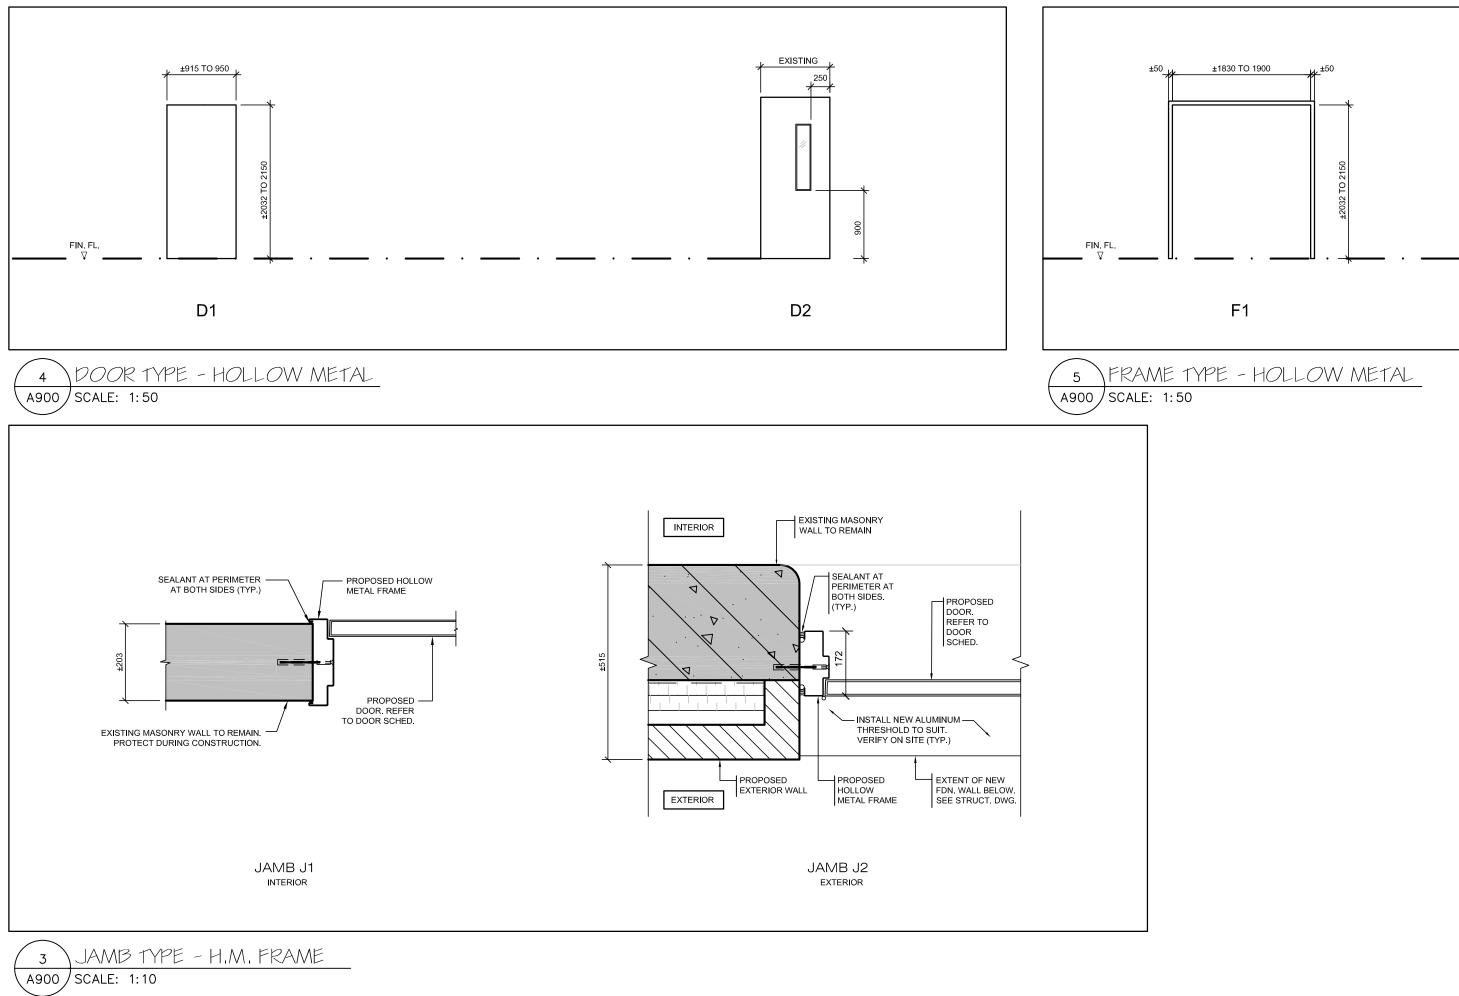

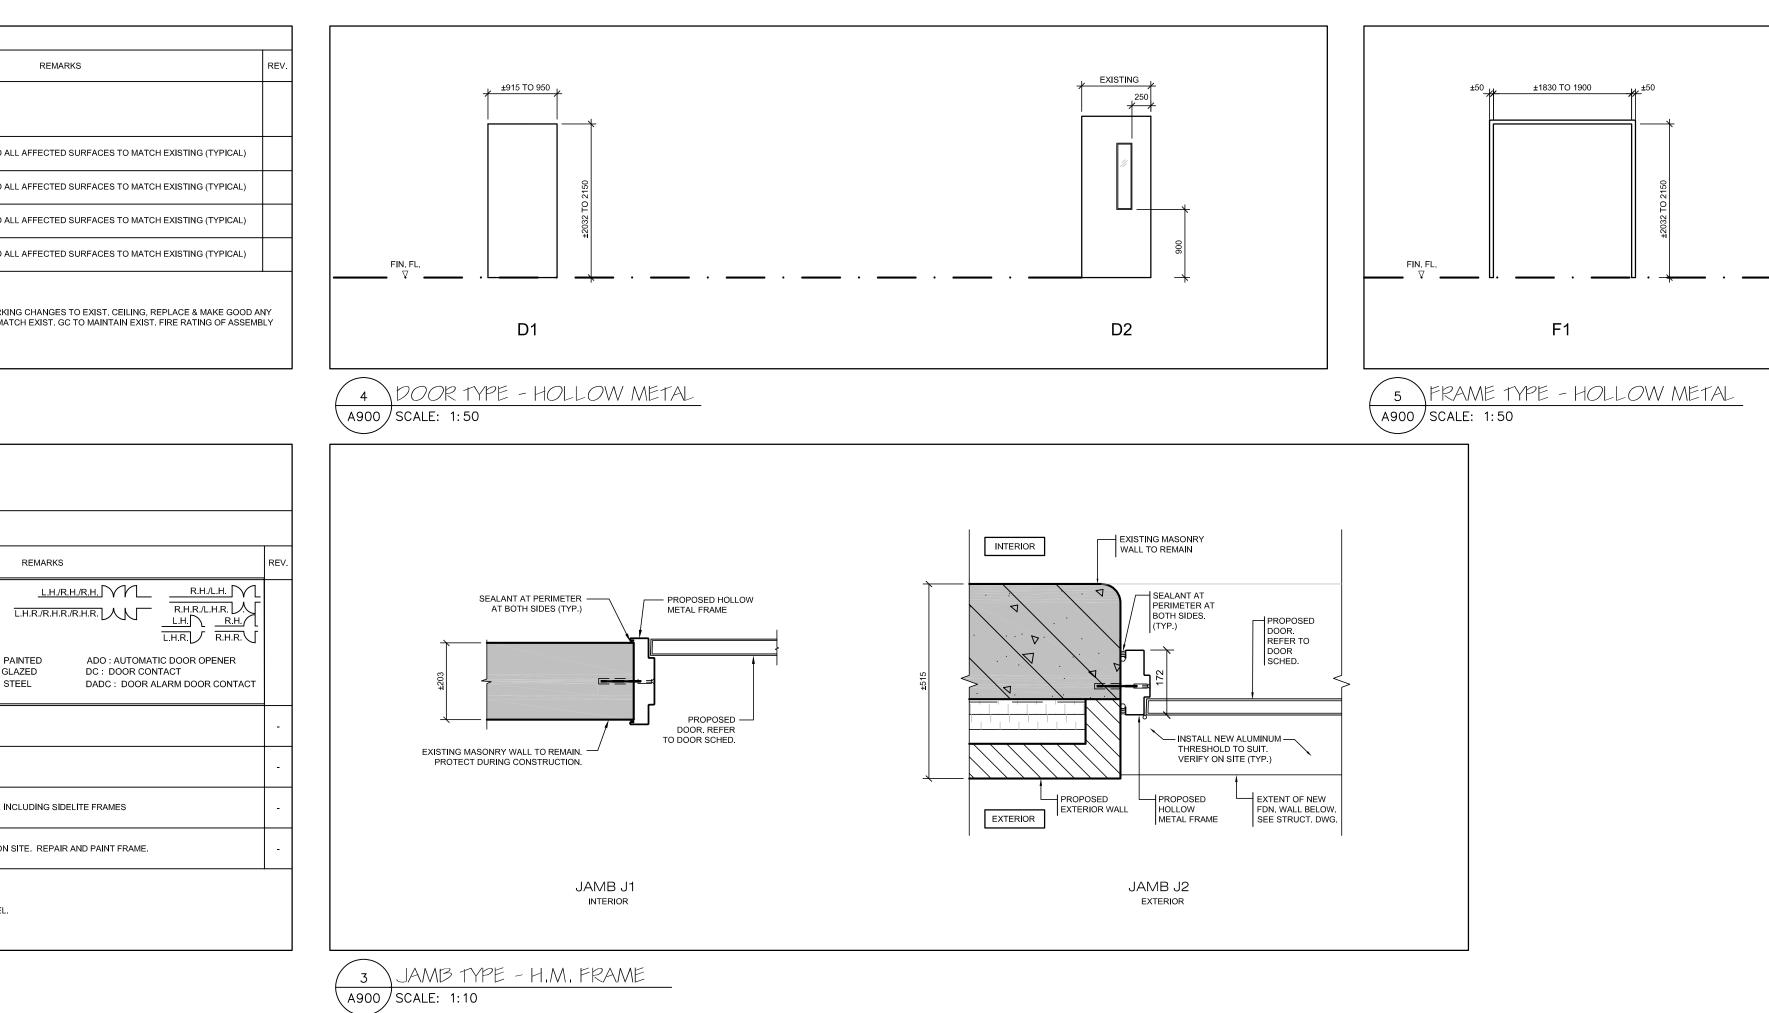

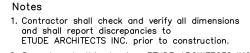


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REV	REVISIONS / ISSUES		



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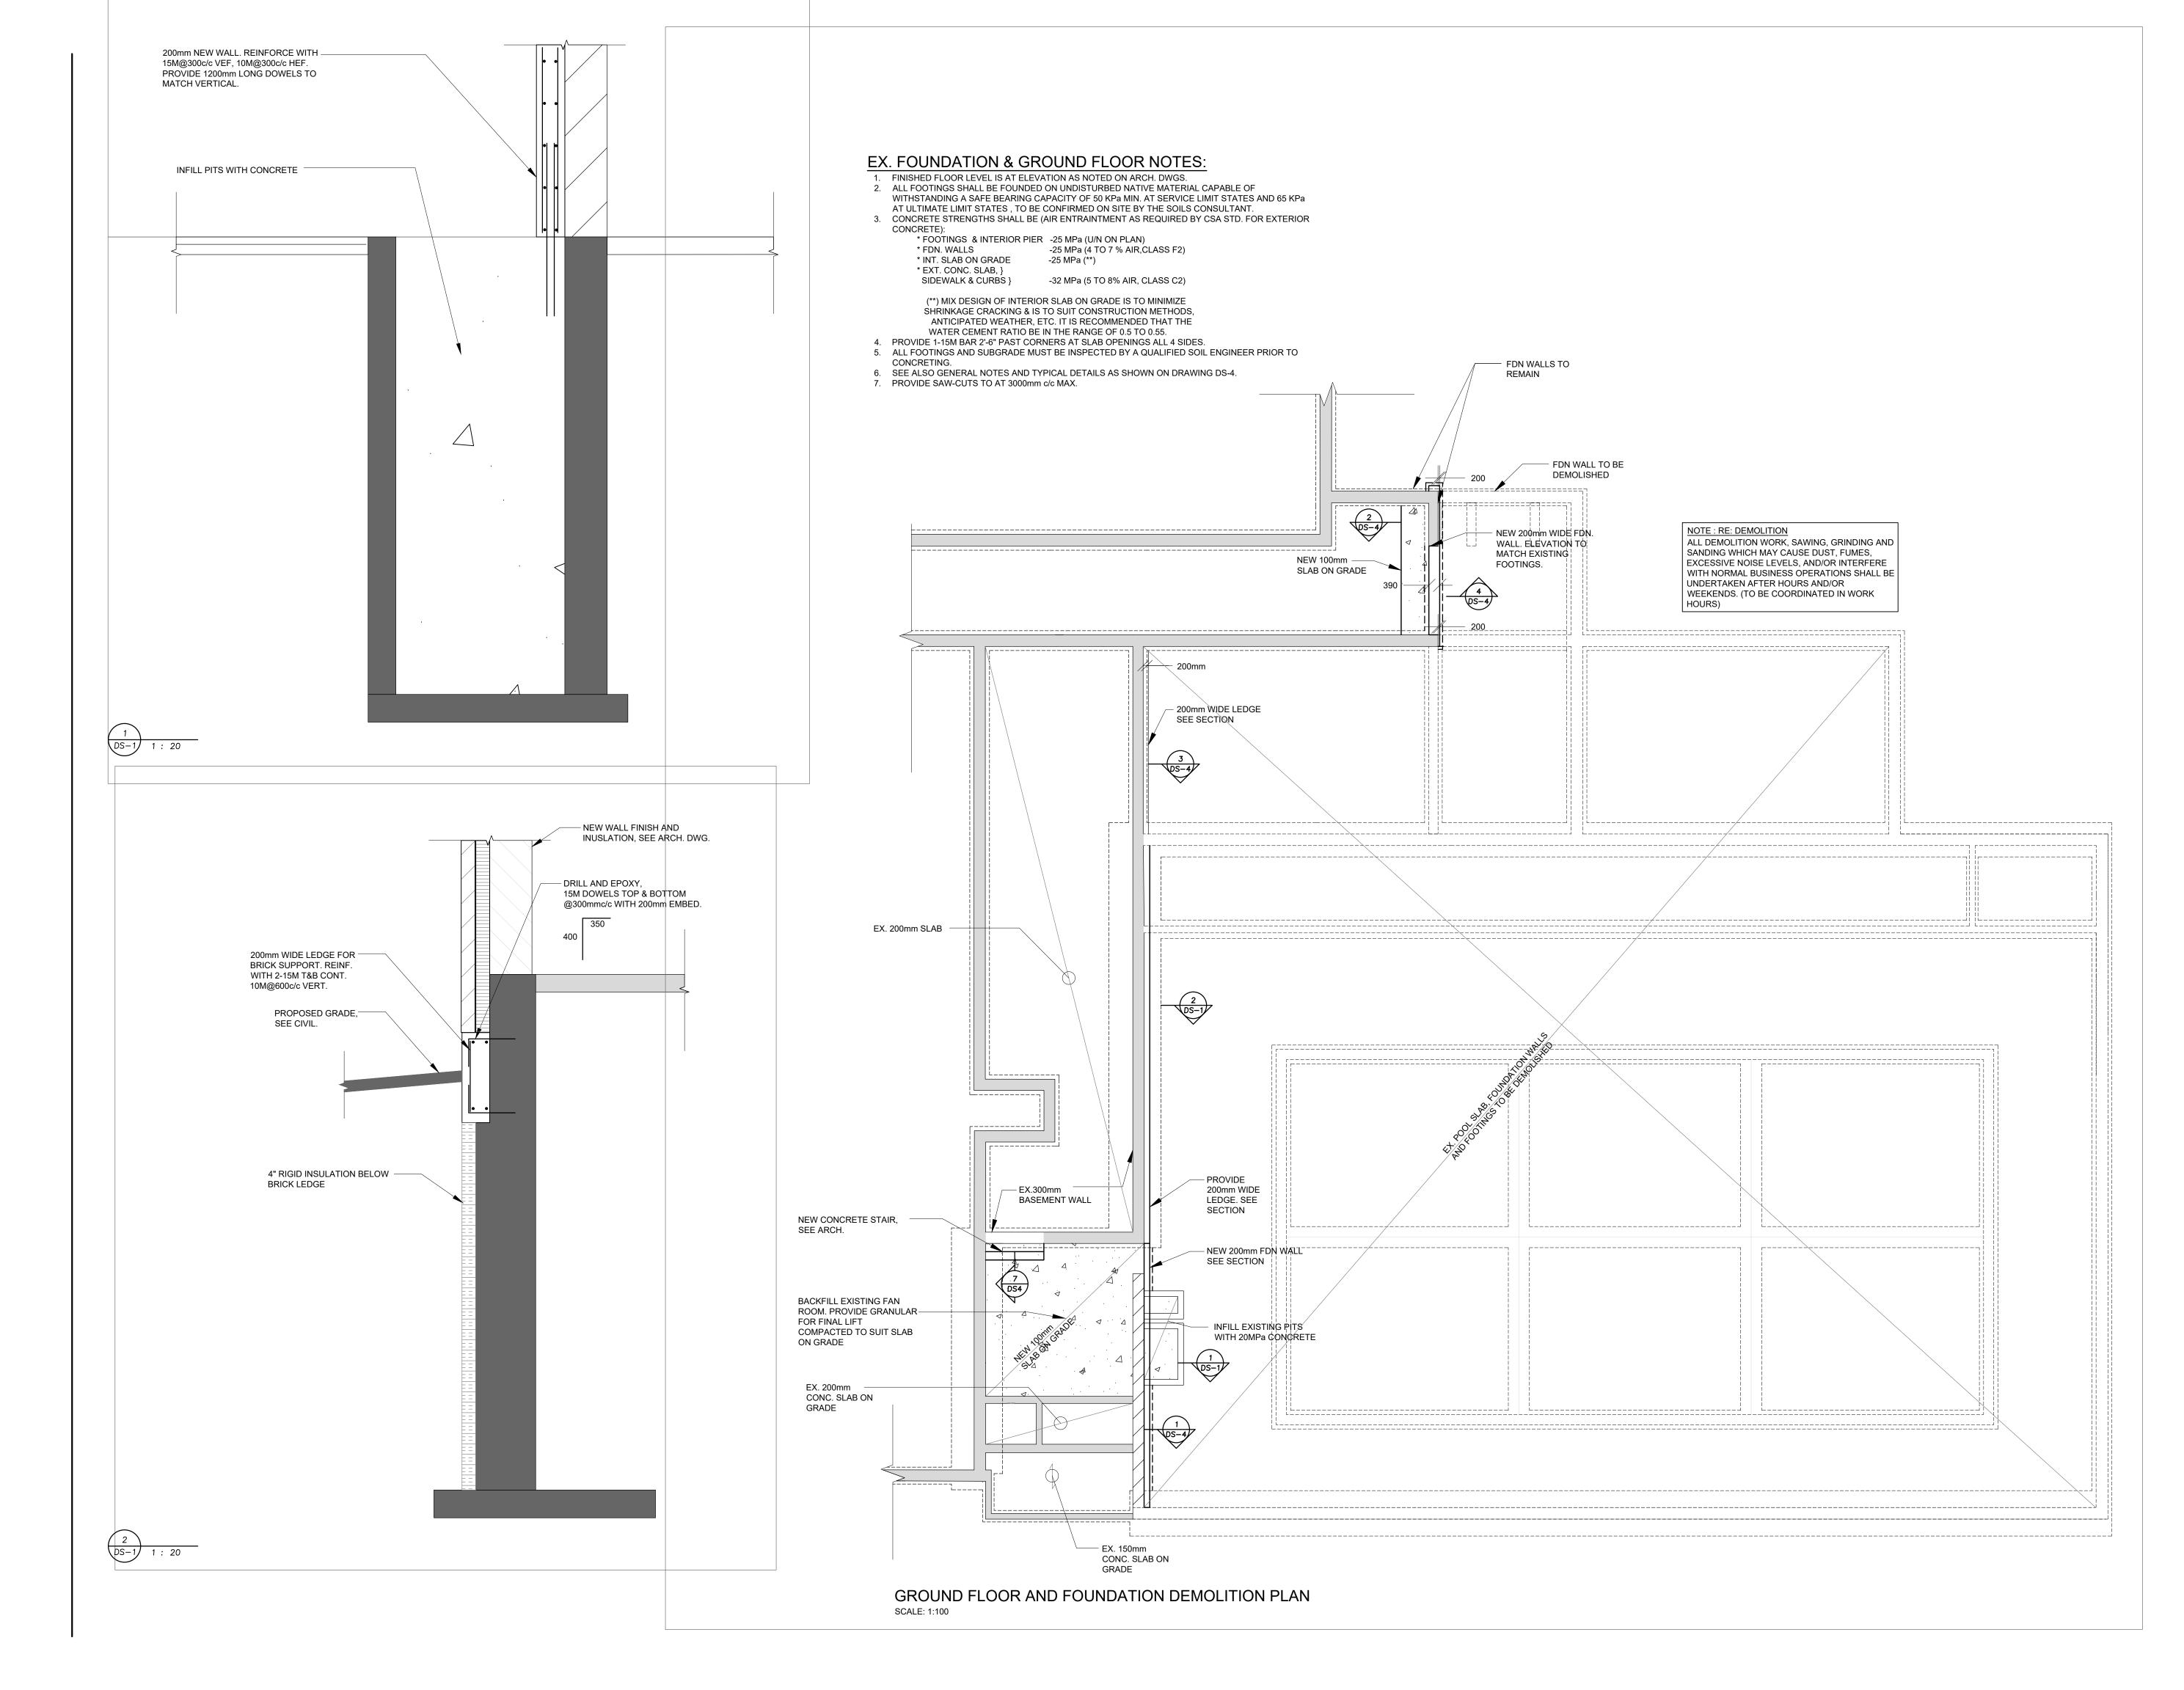
GLENFOREST POOL GLENFOREST SECONDARY SCHOOL 3575 FIELDGATE DR., MISSISSAUGA, ON L4X 2J6

POOL DEMOLITION

Drawing Title

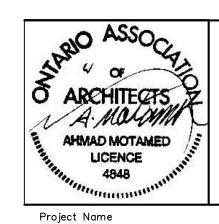ROOM FINISH & DOOR SCHEDULE

Graphic Scale AS SHOWN		Sheet no.
Drawn AK / VSP	Checked AM	A900
CAD File AS NOTED	Scale AS NOTED	
Date DECEMBER 2022	Project No. 222113	Revision No.



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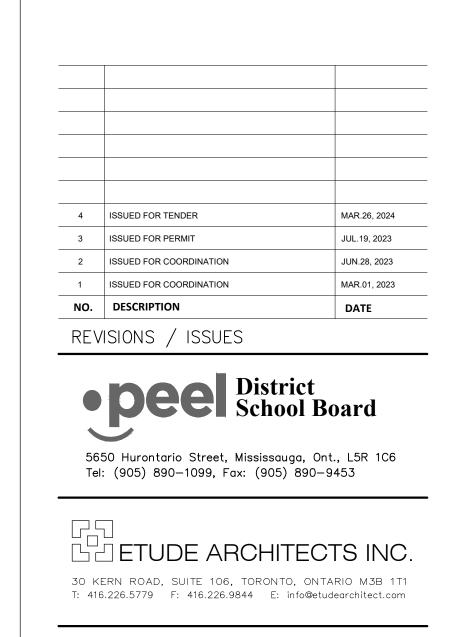
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GLENFOREST POOL

Project Name


GLENFOREST SECONDARY SCHOOL 2575 FIELDGATE DR., MISSISSAUGA, ON L4X 2J6


POOL DEMOLITION

Drawing Title


FOUNDATION & GROUND FLOOR PLAN

Drawn SVJ	Checked RT	Sheet no.
Date JAN,2023	scale As Shown	DS-1
	Project No. 220132	

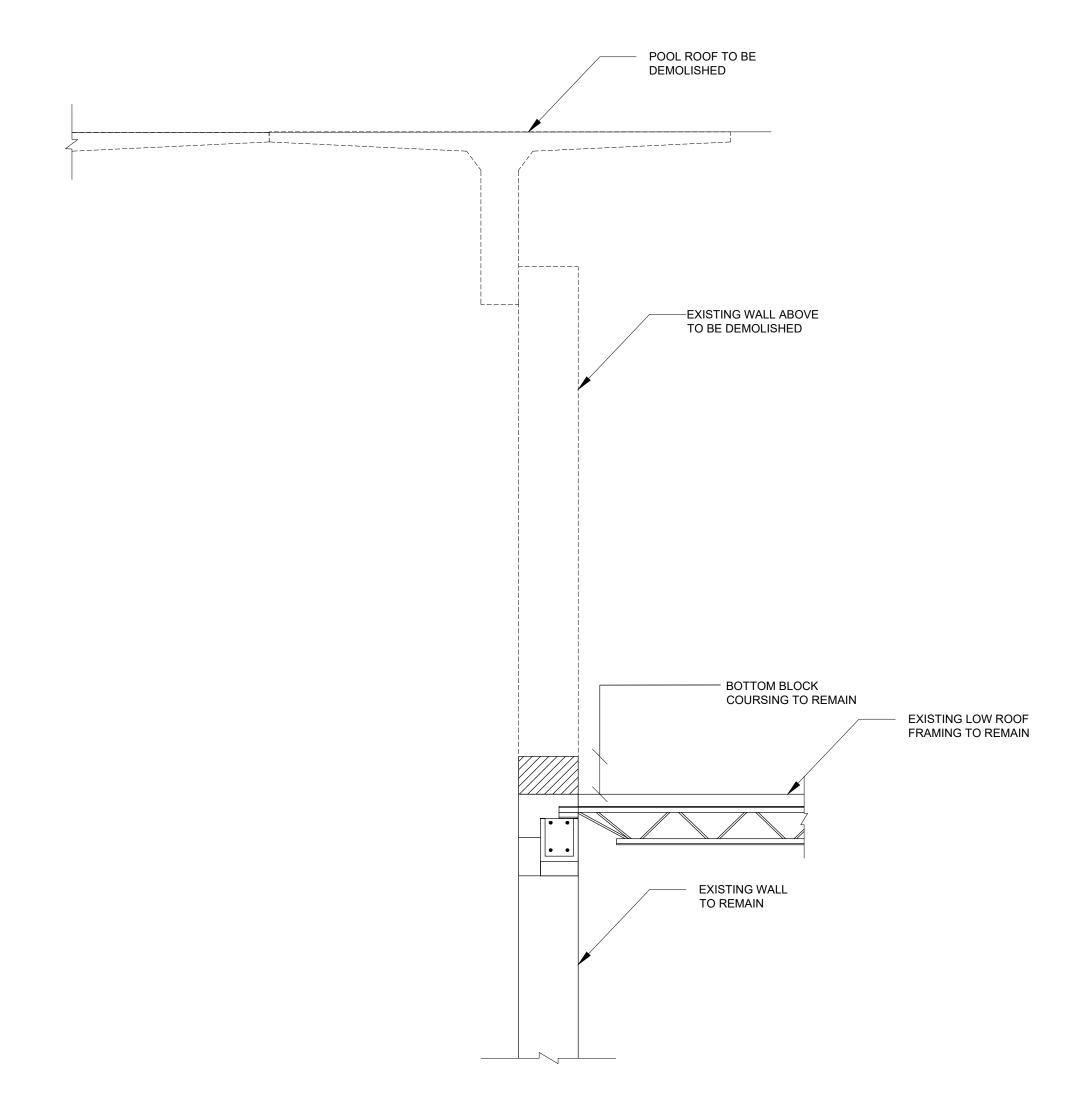

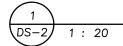

REMAIN

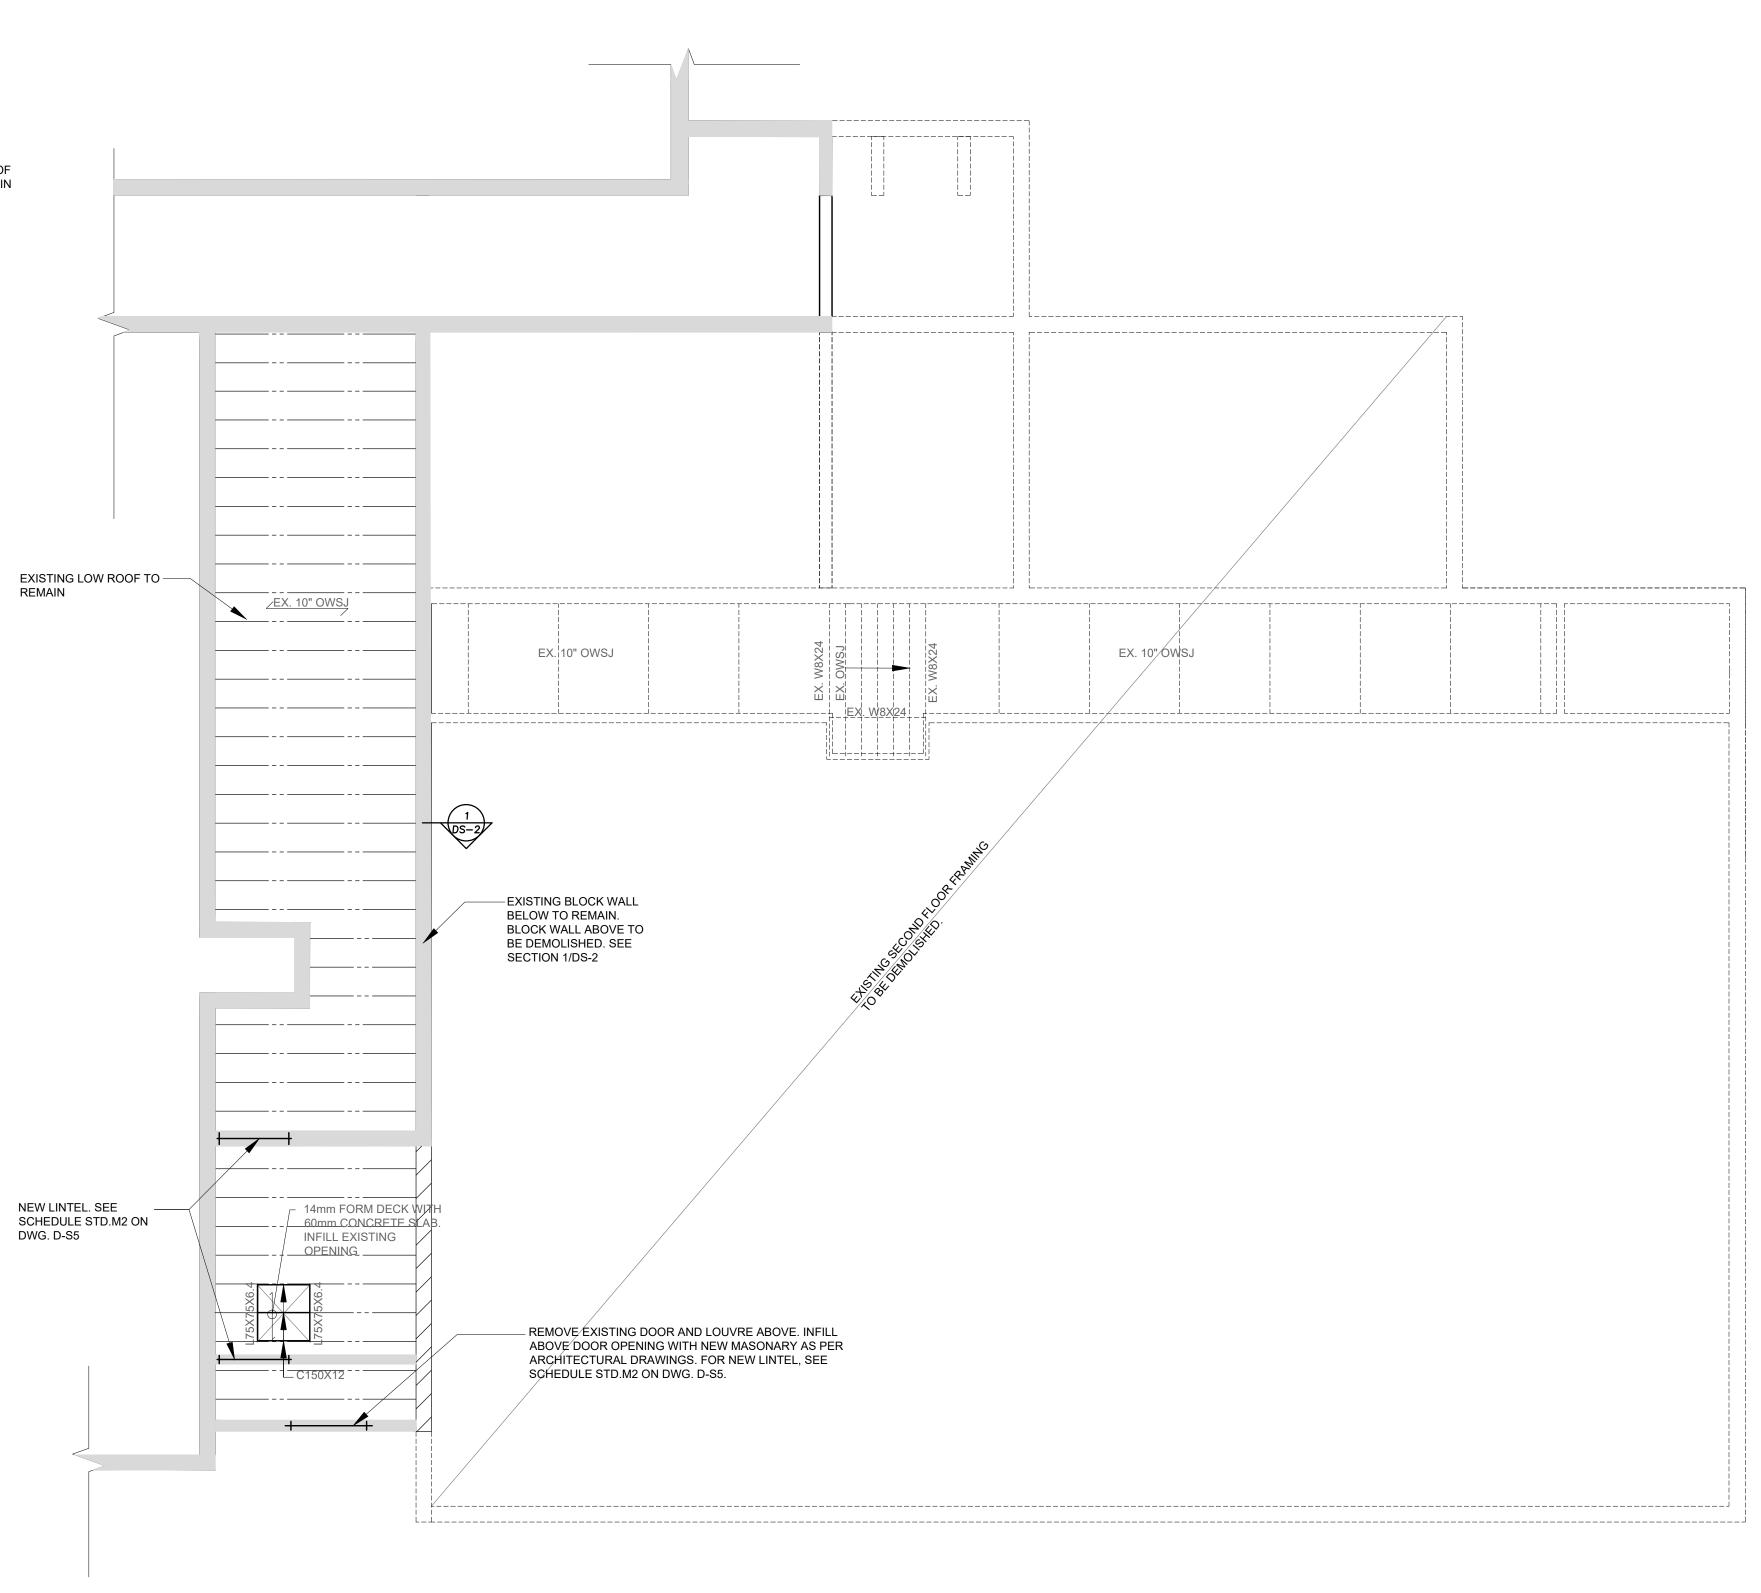

SECOND FLOOR FRAMING DEMOLITION PLAN SCALE: 1:100

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4	ISSUED FOR TENDER	MAR.26, 2024
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2	ISSUED FOR COORDINATION	JUN.28, 2023
1	ISSUED FOR COORDINATION	MAR.01, 2023
NO.	DESCRIPTION	DATE
REV	ISIONS / ISSUES	

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Project Name


GLENFOREST POOL GLENFOREST SECONDARY SCHOOL 2575 FIELDGATE DR., MISSISSAUGA, ON L4X 2J6

POOL DEMOLITION

Drawing Title

SECOND FLOOR FRAMING PLAN

Drawn SVJ	Checked RT	Sheet no.
Date JAN,2023	scale As Shown	DS-2
	Project No. 220132	

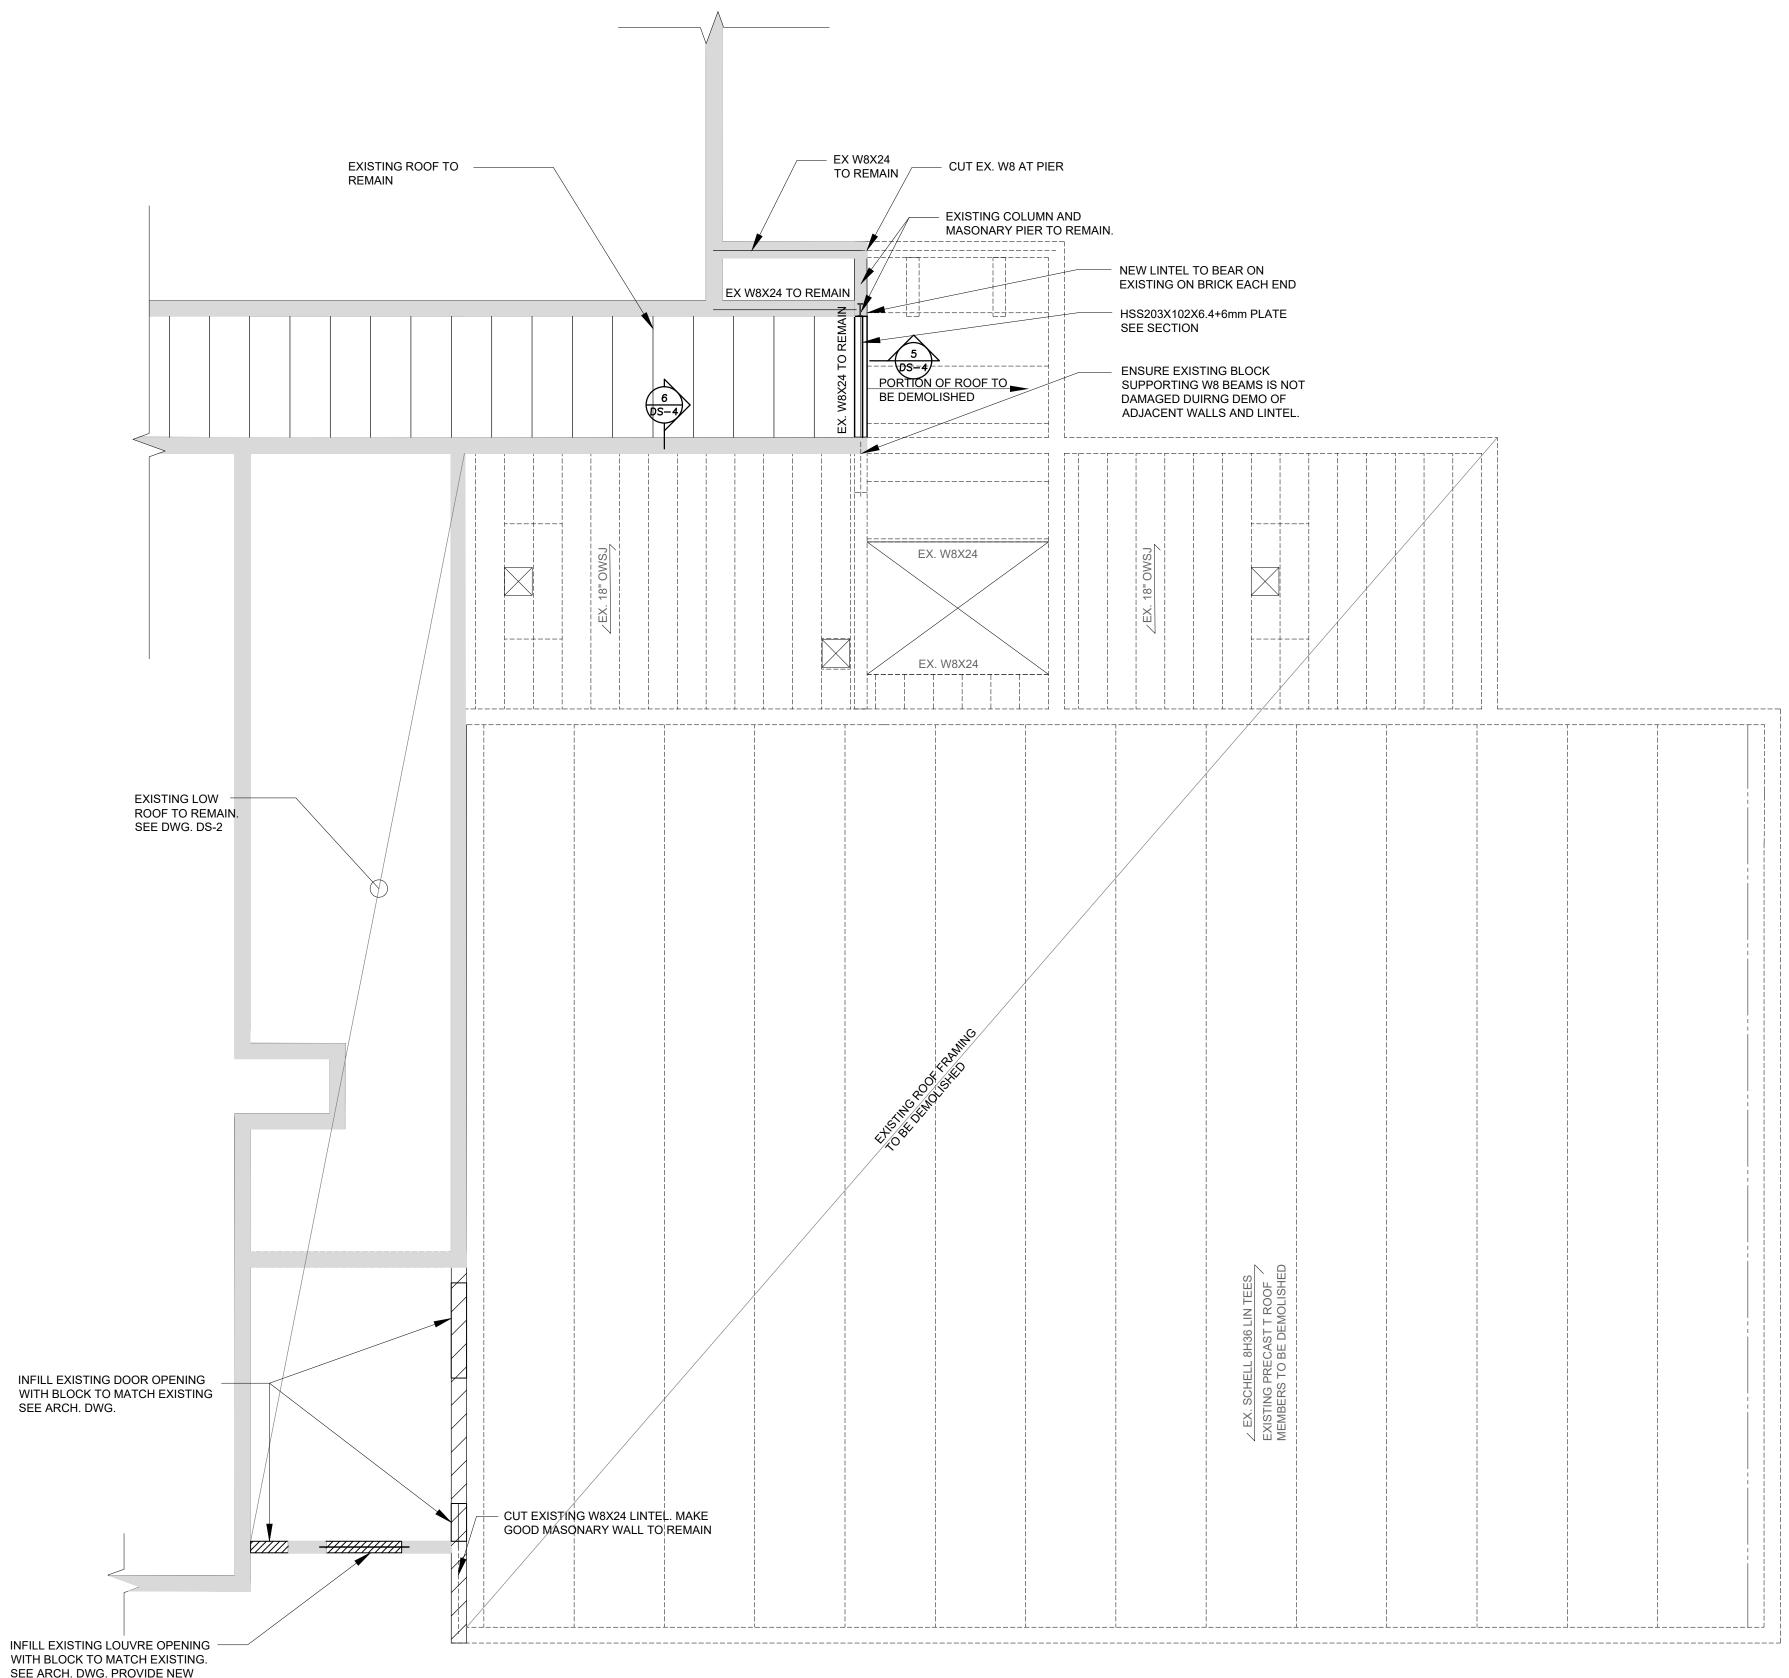

SEE ARCH. DWG. PROVIDE NEW LINTEL OVER DOOR OPENING AS PER STD.M2 ON DWG. DS-4

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Project Name

GLENFOREST POOL GLENFOREST SECONDARY SCHOOL 2575 FIELDGATE DR., MISSISSAUGA, ON L4X 2J6


POOL DEMOLITION

Drawing Title


ROOF FRAMING PLAN


Drawn	SVJ	Checked RT	Sheet no.
Date JAN,	2023	scale As Shown	DS-3
		Project No. 220132	


ROOF FRAMING DEMOLITION PLAN SCALE: 1:100

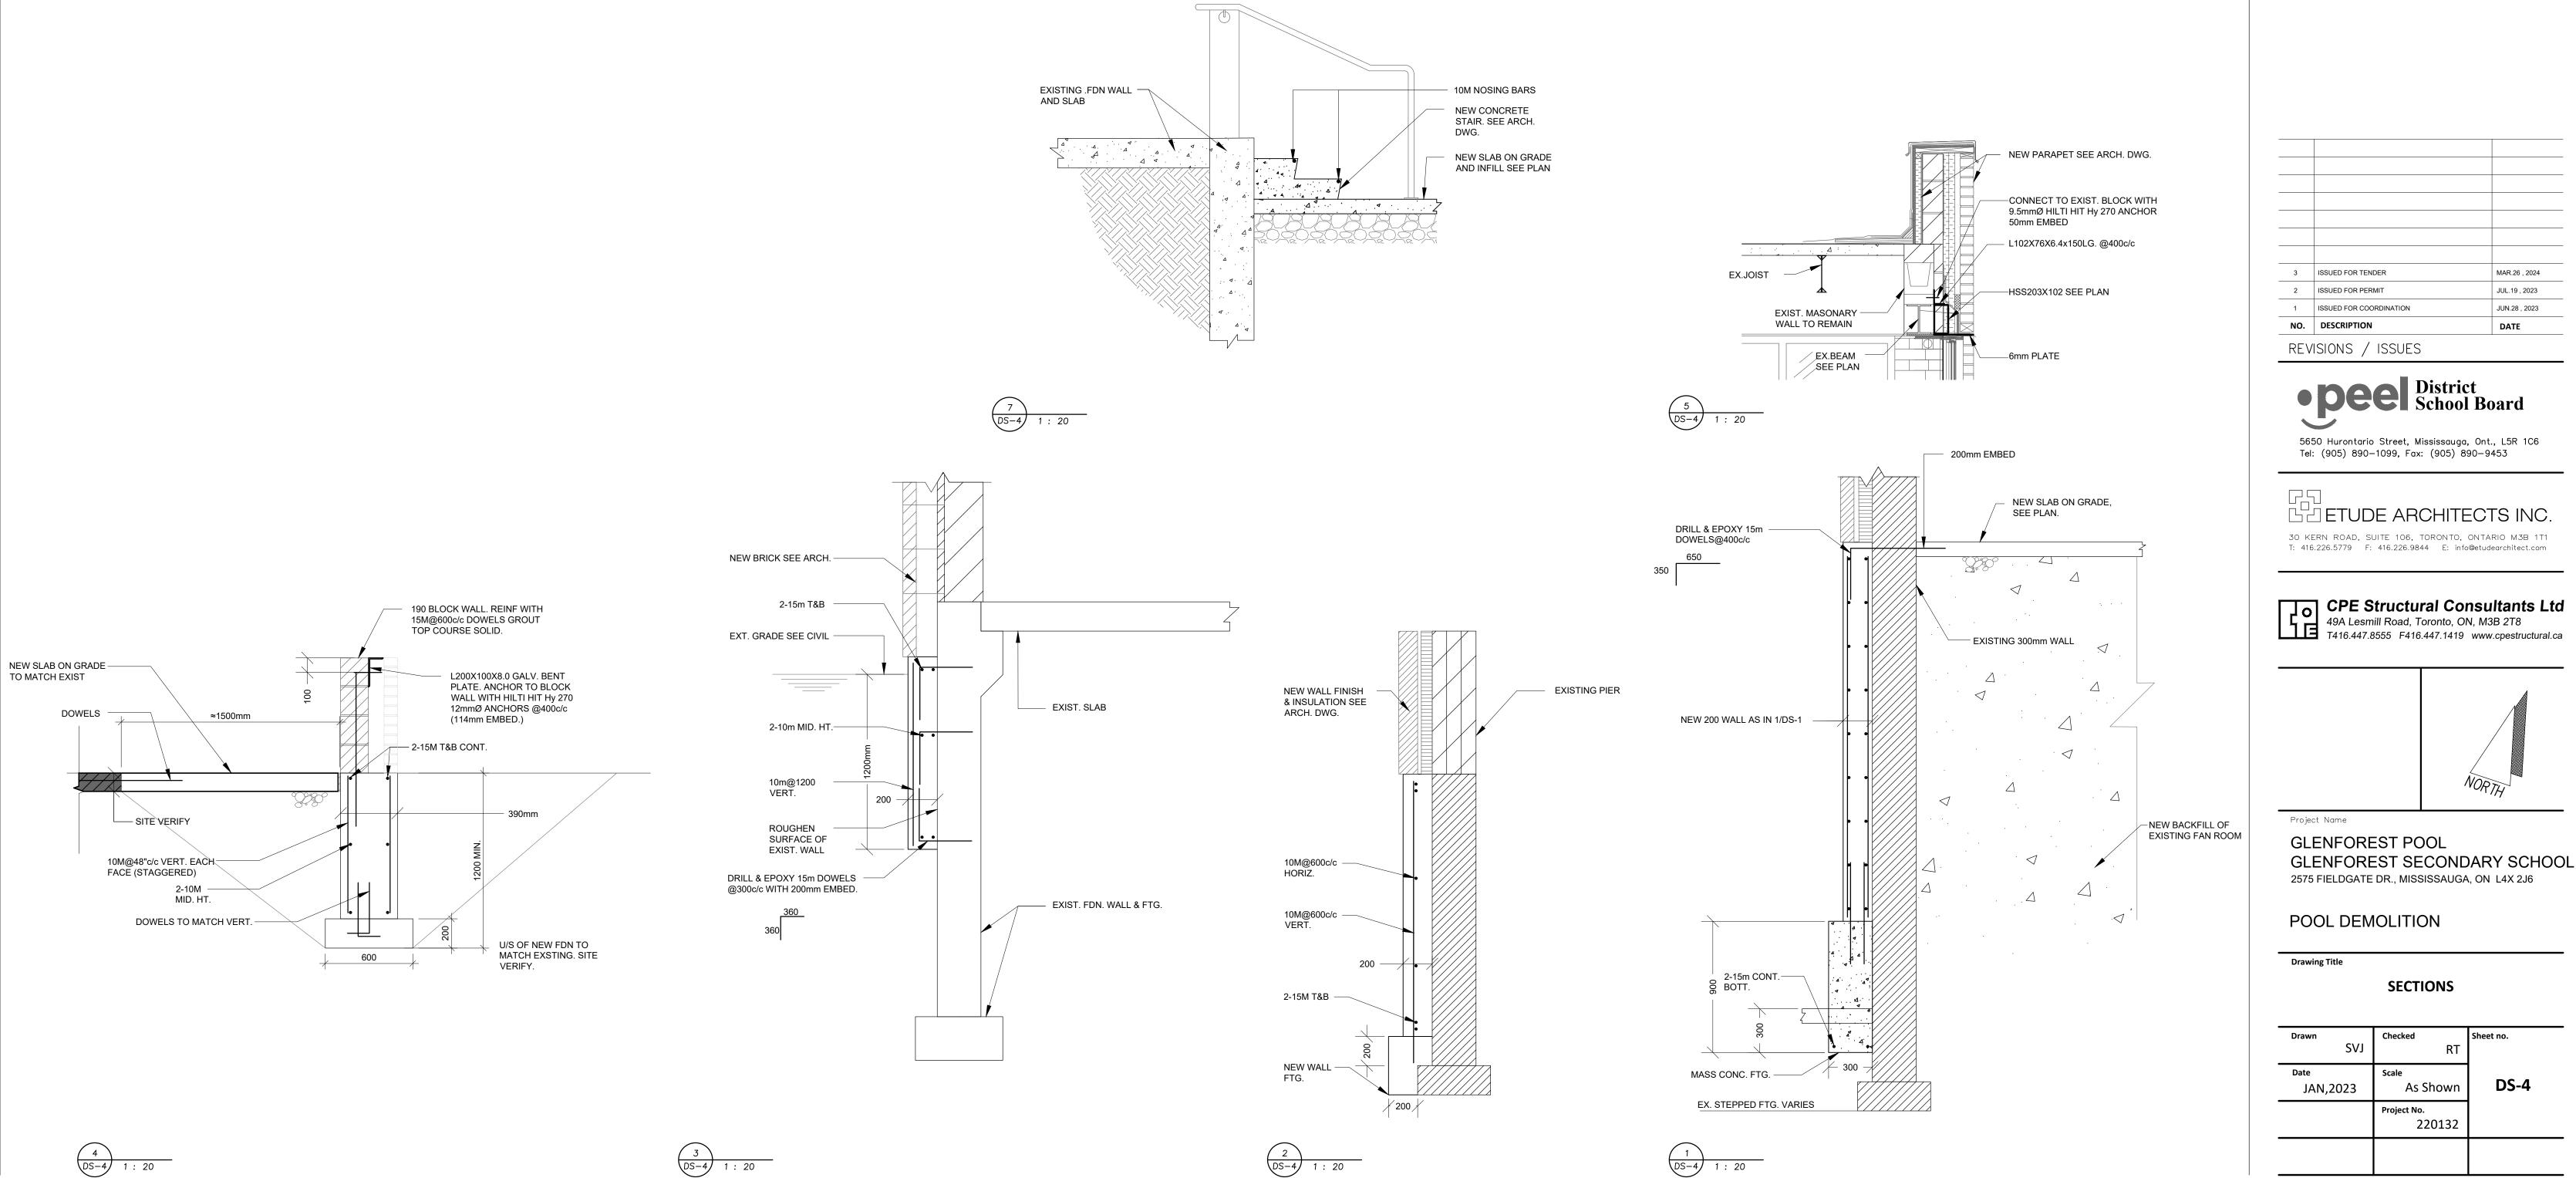



3 DS-4 1 : 20

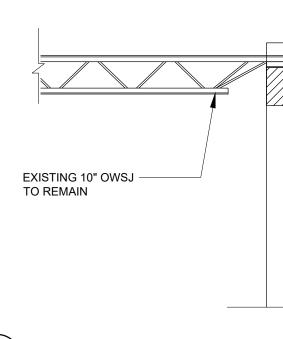


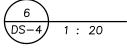

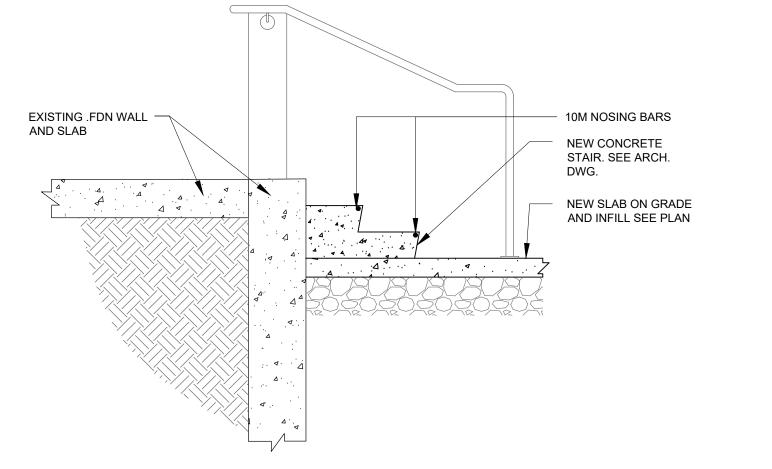

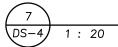

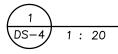

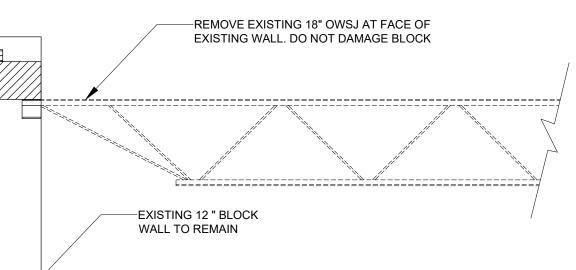

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GENERAL NOTES

- . GENERAL
- . ALL DIMENSION MUST BE VERIFIED ON SITE AND WITH PROJECT MANAGER BEFORE PROCEEDING WITH THE WORK . DO NOT SCALE DRAWINGS.
- REPORT ALL DISCOVERIES OF ERRORS, OMISSIONS OR DISCREPANCIES TO THE ARCHITECT / DESIGN ENGINEER AS APPLICABLE.
- . ALL WORK TO BE COMPLETED IN ACCORDANCE WITH THE REQUIREMENTS OF THE 2012 ONTARIO BUILDING CODE AND ALL APPLICABLE PROVINCIAL, LOCAL AND MUNICIPAL REQUIEMENTS.
- . SPECIAL PROVISIONS:
- NO SUBSTITUTIONS ALLOWED UNLESS THE FOLLOWING ARRANGEMENTS ARE
- . WRITTEN PERMISSION OBTAINED FROM CONSULTANT. 2. CONTRACTOR ENSURES THAT SUBSTITUTIONS CAN BE BOTH PHYSICALLY AND DIMENSIONALLY INCORPORATED IN THE WORK WITH NO LOSS OF INTENDED FUNCTION OR CONSTRUCTION TIME AND AT NO ADDITIONAL COST TO THE
- 3. REFERENCE STANDARDS
- . NATIONAL BUILDING CODE 2015 . ONTARIO BUILDING CODE 2012 AND ALL AMENDMENTS AS OF JAN. 2020
- ALL CSA CODES AND ASTM STANDARDS REFERENCED BELOW REFER TO THOSE EDITIONS AND REVISIONS OF CODES/STANDARDS REFERENCED IN ONTARIO BUILDING CODE 2012.
- 4. COMPLY WITH LOCAL BY-LAWS, CANADIAN CONSTRUCTION SAFETY CODE AND ALL REGULATIONS SET BY AUTHORITIES HAVING JURISDICTION. IN CASE OF CONFLICT OR DISCREPANCY, THE MORE STRINGENT REQUIREMENTS SHALL
- 4. LOADS: . EXAMINE ALL DRAWINGS, SPECIFICATIONS AND REMAINING CONTRACT
- DOCUMENTS TO OBTAIN ALL APPLICABLE LOADINGS. REPORT DISCREPANCIES O THE CONSULTAN ALL DESIGN LOADINGS GIVEN ON THE DRAWINGS ARE SPECIFIED SERVICE
- LOADS, UNLESS NOTED. . ESTIMATING, CONTRACTUAL

ARRANGEMENTS ETC.

- . VISIT THE SITE AND EXAMINE IT FOR ALL CHARACTERISTIC FEATURES
- AFFECTING NEW CONSTRUCTION. . COMPARE EXISTING GRADE ELEVATIONS WITH THOSE SHOWN ON THE
- OBTAIN ALL DETAILS AND DIMENSIONS OF EXISTING WORK IN FIELD AND INCORPORATE SAME INTO NEW CONSTRUCTION.
- CHECK ALL DIMENSIONS, LEVELS AND DETAILS SHOWN ON STRUCTURAL DRAWINGS AGAINST ARCHITECTURAL, MECHANICAL, ELECTRICAL, LANDSCAPING
- AND OTHER RELEVANT DRAWINGS. REPORT ANY DISCREPANCIES TO THE CONSULTANT BEFORE SUBMITTING THE
- TENDER PRICE . NO ALLOWANCE WILL BE MADE FOR DIFFICULTIES ENCOUNTERED OR EXPENSES INCURRED RESULTING FROM (KNOWN AT THE TIME THE TENDERS ARE SUBMITTED.

6. DESIGN:

- . ALL STRUCTURAL MEMBERS ARE DESIGNED IN ACCORDANCE WITH THE ONTARIO BUILDING CODE, 2012.
- ALL CONCRETE MEMBERS ARE DESIGNED IN ACCORDANCE WITH CSA A23.3-04 DESIGN OF CONCRETE STRUCTURES USING LIMIT STATES DESIGN. 3. ALL STRUCTURAL STEEL MEMBERS ARE DESIGNED IN ACCORDANCE WITH CSA
- S16-09 " DESIGN OF STEEL STRUCTURES" ALL CONCRETE BEAMS AND SLABS HAVE BEEN DESIGNED IN ACCORDANCE WITH ONTARIO BUILDING CODE WITH DEFLECTION CRITERIA CONFORMING TO SECTION 9.8 OF CSA A23.3 - "CONTROL OF DEFLECTIONS" TABLE 9.3. CONTRACTOR MUST ALLOW FOR SUCH DEFLECTIONS IN THE CONSTRUCTION OF ALL MASONRY WALLS

7. CAST-IN-PLACE CONCRETE

- ALL CONCRETE WORK SHALL CONFORM TO C.S.A. STANDARDS A23.1-14, A23.2-14, & A23 3-14 2. NO SLEEVES, DUCTS, PIPES OR OTHER OPENINGS SHALL PASS THROUGH BEAMS OR COLUMNS, EXCEPT WHERE DETAILED ON DRAWINGS OR APPROVED BY
- CONSULTANT 3. DETAIL, FABRICATE AND PLACE ALL REINFORCEMENT IN CONFORMITY TO THE LATEST EDITION OF "REINFORCING STEEL MANUAL OF STANDARD PRACTICE", BY
- REINFORCING INSTITUTE OF CANADA. 4. ALL REINFORCEMENT SHALL BE DEFORMED BARS CONFORMING TO C.S.A. G30.18
- LATEST EDITION WITH MIN. YIELD STRENGTH OF 400 MPa. WELDED FABRIC SHALL CONFORM TO C.S.A G30.5-LATEST EDITION (MIN. YIELD STRENGTH OF 440 MPa) . SEE PLAN AND SPECIFICATION FOR CONCRETE STRENGTH, AIR ENTRAINMENT
- AND MIX DESIGN REQUIREMENTS. 6. AT OPENINGS IN ALL CONCRETE PROVIDE 2-15M TRIMMER BARS IN HEAD, JAMBS AND SILLS UNLESS NOTED OTHERWISE. REBAR TO EXTEND 750mm(30") PAST
- THE EDGE OF OPENING . HOUSEKEEPING PADS, EQUIPMENT BASES, LIGHT POLE BASES ETC., WHICH ARE DETAILED IN MECHANICAL AND ELECTRICAL DRAWINGS SHALL BE INCLUDED IN THIS SECTION CO-ORDINATE WITH GENERAL CONTRACTOR FOR EXACT DETAILS.

3. PROVIDE CONCRETE COVER TO REINFORCEMENT AS FOLLOWS:

LOCATION		EXPOSUR	E CLASS OF CONCRET	E
	INTERIOR CLASS N	F-1,F-2, S-1,S-2	C1 CON. WITHIN PARKING \$TRUCTURES (PROTECTED BY MEMBRANE)	C-XL,C-1, C-3, A-1, A-2,A-3 (NOT PROTECTED BY MEMBRANE)
CAST AGAINST EARTH (NOT FORMED, INCLUDES UNLINED CAISSONS)	75mm	75mm		75mm
BEAMS,GIRDERS, SLABS	30mm (32mm FOR 3h FIRE RATING)	40mm	40mm SEE NOTE (5)	60mm
WALLS	40mm TO HOR. 50mmTO VERT.	40mm TO HOR. 50mmTO VERT.	40mm TO HOR. 50mm TO VERT.	60mm
COLUMNS	40mm TO HOR. 50mmTO VERT.	40mm TO HOR. 50mmTO VERT.	40mm TO HØR. 50mmTO VERT.	60mm

3. STRUCTURAL STEEL

- ALL STRUCTURAL STEEL SHALL CONFORM TO STANDARDS (LATEST EDITIONS) AS FOLLOWS a) ROLLED WF, WWF:CSA G40.21 GRADE 350W OR ASTM A572 OR A992 GRADE 50
- b) CHANNELS, ANGLES: CSA G40.21 GRADE 300W c) HSS:CSA G40.21 GRADE 350W (CLASS C) OR ASTM A500 GRADE C FABRICATION AND ERECTION SHALL CONFORM TO C.S.A. STANDARDS CSA
- . ALL WELDING SHALL BE DONE BY QUALIFIED WELDERS IN COMPLIANCE WITH
- CSA STANDARD W47.1 LATEST EDITION AND IN ACCORDANCE WITH CSA STANDARD W59 LATEST EDITION . PROVIDE WELDED OR BOLTED CONNECTIONS TO RESIST THE REACTIONS
- PRODUCED BY THE FRAMING AND LOAD CONDITIONS. ALL BOLTS EXCEPT HIGH STRENGTH COMPLYING WITH ASTM F3125 - GRADE
- A325M OR GRADE A490M BOLTS EXCEPT CSA G40.21 GRADE 300W OR ASTM A36 FOR ANCHOR RODS. . TO ALL NEW STRUCTURAL STEEL, PROVIDE ONE SHOP COAT OF PRIME PAINT
- COMPLYING WITH CISC/CPMA STANDARD 1-73a. SUBMIT ERECTION AND DETAIL DRAWINGS FOR REVIEW BEFORE FABRICATION.
- PROVIDE ADJUSTABLE MASONRY ANCHORS WELDED TO STEEL COLUMNS WHERE MASONRY TIES INTO COLUMNS, AS PER TYPICAL DETAILS. . VERIFY ALL DIMENSIONS ON SITE BEFORE COMMENCING FABRICATION OF STEEL
- 10. CLEAN ALL FIELD WELDS AFTER ERECTION, AND TOUCH UP WITH PRIME PAINT.
- 1. PROVIDE ZINC-RICH PAINT CONFORMING TO CAN/CGSB 1.181-99 TO ALL STEEL EXPOSED TO WEATHER UNLESS GALVANIZING NOTED ON DRAWINGS. GALVANIZING, IF USED, SHALL BE IN COMPLIANCE WITH C.S.A. STANDARDS
- CAN/CSA G164" HOT DIP GALVANIZING OF IRREGULARLY SHAPED ARTICLES 2. DO NOT PAINT STEEL WHICH IS TO BE ENCASED IN CONCRETE OR TO RECEIVE
- SPRAY FIREPROOFING, REMOVE PAINT FROM EXISTING STEEL SURFACES WHICH ARE TO BE FIELD WELDED. 3. INSPECTION OF STRUCTURAL STEEL SHALL BE DONE BY A QUALIFIED TESTING COMPANY IN ACCORDANCE WITH THE SPECIFICATIONS.
- 9. TEMPORARY SUPPORTS & STRUCTURE:
- I. THE CONTRACTOR SHALL HAVE THE SOLE RESPONSIBILITY FOR THE DESIGN ERECTION, OPERATION, MAINTENANCE AND REMOVAL OF TEMPORARY SUPPORTS, TEMPORARY BRACINGS, SHORING SYSTEM, AND FACILITIES AND THE
- DESIGN AND EXECUTION OF CONSTRUCTION METHODS REQUIRED IN THEIR USE THE CONTRACTOR SHALL ENGAGE AND PAY FOR REGISTERED PROFESSIONAL
- ENGINEERING PERSONNEL SKILLED IN THE APPROPRIATE DISCIPLINES TO PERFORMTHOSE FUNCTIONS REFERRED TO IN PARAGRAPH ABOVE OR AND IN ALL CASES WHERE SUCH TEMPORARY SUPPORTS STRUCTURES, AND FACILITIES
- AND THEIR METHOD OF CONSTRUCTION ARE OF SUCH A NATURE THAT PROFESSIONAL ENGINEERING SKILL IS REQUIRED TO PRODUCE SAFE AND SATISFACTORY RESULTS.

10. TEMPORARY WORK: . PROVIDE ALL ADEQUATE SHORING FOR THE SAFE COMPLETION OF THE WORK.

- ASSUME RESPONSIBILITY TO DESIGN AS WELL AS TO ERECT, MAINTAIN AND EVENTUALLY REMOVE ALL THE TEMPORARY WORKS NECESSARY FOR CARRYING OUT OF THIS CONTRACT
- . MAKE ADEQUATE PROVISIONS FOR CONSTRUCTION STRESSES AND FOR SUFFICIENT TEMPORARY BRACING TO KEEP THE STRUCTURE PLUMB AND IN
- TRUE ALIGNMENT AT ALL PHASES OF WORK UNTIL COMPLETION (INCLUDING MASONRY WALLS, FLOOR AND ROOF DECKS, ETC.). ANY BRACING MEMBERS
- SHOWN ON PLANS ARE THOSE REQUIRED FOR THE FINISHED STRUCTURE AND MAY NOT BE SUFFICIENT FOR ERECTION PURPOSES.
- 3. TRUCKS, CRANES, HOISTS OR ANY HEAVY EQUIPMENT OR MATERIALS ARE NOT ALLOWED TO ENTER ANY STRUCTURAL FLOOR OR ROOF AREA UNLESS SPECIFICALLY DESIGNED AND DESIGNATED FOR THIS PURPOSE. INSTALL TEMPORARY BARRIERS TO PREVENT ACCIDENTAL OVERLOADING DURING CONSTRUCTION, DESIGN, INSTALL AND MAINTAIN ADEQUATE SHORING SYSTEM AS REQUIRED TO CARRY ANY SUCH TEMPORARY LOADING FROM

CONSTRUCTION MATERIALS AND/OR EQUIPMENT

11. SHOP DRAWING:

- SUBMIT SHOP DRAWINGS IN ACCORDANCE WITH SPECIFICATIONS. OBTAIN REVIEWED SHOP DRAWINGS BEFORE PROCEEDING WITH FABRICATION. 2. EACH OF THE FOLLOWING SHOP DRAWINGS MUST BEAR THE SIGNATURE AND STAMP OF QUALIFIED PROFESSIONAL ENGINEER REGISTERED IN THE PROVINCE OF PROJECT LOCATION. DRAWINGS FOR ANY TEMPORARY WORK.
- DRAWINGS FOR ANY STRUCTURAL PARTS DESIGNED BY THE CONTRACTOR'S FORCES. ALL STRUCTURAL STEEL ERECTION AND DETAIL FABRICATION SHOP DRAWINGS. 3 EVERY SHOP DRAWING AND BAR LIST MUST BE CHECKED IN DETAILING OFFICE BEFORE IT IS ISSUED FOR REVIEW BY THE CONSULTANT. SHEETS THAT ARE NOT
- SIGNED BY THE CHECKER WILL NOT BE REVIEWED **12. POST INSTALLED ANCHORS**
- ANCHOR CAPACITY USED IN DESIGN SHALL BE BASED ON THE TECHNICAL DATA PUBLISHED BY HILTI OR SUCH OTHER METHOD AS APPROVED BY THE STRUCTURAL ENGINEER OF RECORD. SUBSTITUTION REQUESTS FOR ALTERNATE PRODUCTS MUST BE APPROVED IN WRITING BY THE STRUCTURAL ENGINEER OF RECORD PRIOR O USE. CONTRACTOR SHALL PROVIDE CALCULATIONS DEMONSTRATING THAT THE SUBSTITUTED PRODUCT IS CAPABLE OF ACHIEVING THE PERFORMANCE VALUES OF THE SPECIFIED PRODUCT. SUBSTITUTIONS WILL BE EVALUATED FOR COMPLIANCE WITH THE RELEVANT BUILDING CODE FOR SEISMIC USES, LOAD RESISTANCE,
- INSTALLATION CATEGORY, AND AVAILABILITY OF COMPREHENSIVE INSTALLATION INSTRUCTIONS. ADHESIVE ANCHOR EVALUATION WILL ALSO CONSIDER CREEP, **N-SERVICE TEMPERATURE AND INSTALLATION TEMPERATURE.** 2. INSTALL ANCHORS PER THE MANUFACTURER INSTRUCTIONS, AS INCLUDED IN THE ANCHOR PACKAGING. THE CONTRACTOR SHALL ARRANGE AN MANUFACTURER'S REPRESENTATIVE TO
- PROVIDE ONSITE INSTALLATION TRAINING FOR ALL OF THEIR ANCHORING PRODUCTS SPECIFIED. THE STRUCTURAL ENGINEER OF RECORD MUST RECEIVE DOCUMENTED CONFIRMATION THAT ALL OF THE CONTRACTOR'S PERSONNEL WHO INSTALL ANCHORS ARE TRAINED PRIOR TO THE COMMENCEMENT OF INSTALLING ANCHORS.
- ANCHOR CAPACITY IS DEPENDANT UPON SPACING BETWEEN ADJACENT ANCHORS AND PROXIMITY OF ANCHORS TO EDGE OF CONCRETE. INSTALL ANCHORS IN ACCORDANCE WITH SPACING AND EDGE CLEARANCES INDICATED ON THE
- 5. EXISTING REINFORCING BARS IN THE CONCRETE STRUCTURE MAY CONFLICT WITH SPECIFIC ANCHOR LOCATIONS. UNLESS NOTED ON THE DRAWINGS THAT THE BARS CAN BE CUT. THE CONTRACTOR SHALL REVIEW THE EXISTING STRUCTURAL DRAWINGS AND SHALL UNDERTAKE TO LOCATE THE POSITION OF THE REINFORCING BARS AT THE LOCATIONS OF THE CONCRETE ANCHORS, BY HILTI FERROSCAN, HILTI PS 1000, GPR, X-RAY, CHIPPING OR OTHER MEANS. CONTACT CPE FOR ANY CONDITIONS WHERE ANCHORS MUST BE RELOCATED TO CLEAR EXISTING REBAR.
- 6. EXCEPT WHERE INDICATED ON THE DRAWINGS, POST-INSTALLED ANCHORS SHALL CONSIST OF THE FOLLOWING ANCHOR TYPES AS PROVIDED BY HILTI (CANADA) CORPORATION. CONTACT HILTI AT (800) 363-4458 FOR PRODUCT RELATED QUESTIONS.
- A. <u>REBAR DOWELING INTO CONCRETE</u> 1. ADHESIVE ANCHORS FOR CRACKED AND UNCRACKED CONCRETE USE: (1) HILTI ANCHORS AS INDICATED ON DRAWING. CONTACT CPE FOR ANY CONDITIONS NOT SPECIFIED ON DRAWING ANCHORAGE TO SOLID GROUTED MASONRY 1. ADHESIVE ANCHORS USE:
- (1) HILTI HIT-HY270 MASONRY ADHESIVE ANCHORING SYSTEM
- STEEL ANCHOR ELEMENT SHALL BE HILTI HAS-E CONTINUOUSLY THREADED ROD OR CONTINUOUSLY DEFORMED STEEL BAR. MECHANICAL ANCHORS USE: (1) HILTI ANCHORS AS INDICATED ON DRAWING. CONTACT CPE FOR ANY CONDITIONS NOT SPECIFIED ON DRAWING
- ANCHORAGE TO HOLLOW / MULTI-WYTHE MASONRY 1. ADHESIVE ANCHORS USE:
- (1) HILTI HIT-HY 270 MASONRY ADHESIVE ANCHORING SYSTEM (2) STEEL ANCHOR ELEMENT SHALL BE HILTI HAS-E CONTINUOUSLY THREADED ROD OR CONTINUUSLY DEFORMED STEEL REBAR
- THE APPROPRIATE SIZE SCREEN TUBE SHALL BE USED PER ADHESIVE MANUFACTURER'S RECOMMENDATION 13. MASONRY:
- ALL MASONRY WORK SHALL CONFORM TO ONTARIO BUILDING CODE LATEST EDITION AND C.S.A. STANDARDS 304.1-04- "DESIGN OF MASONRY STRUCTURES" ALL CONCRETE MASONRY UNITS SHALL CONFORM TO C.S.A.STANDARDS A165
- SERIES-04 EXCEPT WHERE OTHERWISE SPECIFIED. PROVIDE MASONRY BLOCK WITH MINIMUM COMPRESSIVE STRENGTH OF 2170 PSI (15 MPa). REFER TO ARCH. DWG. & SPECIFICATION FOR BRICK REQUIREMENTS.MINIMUM IS
- CONFORMANCE TO CAN/CSA A82.1. 4. ALL LOAD BEARING MASONRY AND FOUNDATION WALLS SHALL HAVE YPE 'S' MORTAR CONFORMING TO CSA STANDARD A179.
- 5. THE CONTRACTOR SHALL NOT CUT ADDITIONAL HOLES THROUGH MASONRY BEARING WALLS OTHER THAN THE HOLES SHOWN ON THE STRUCTURAL DRAWINGS UNLESS APPROVED BY THE CONSULTANT
- BEARING OF BEAMS ON MASONRY WALLS: CONCRETE OR STEEL BEAMS BEARING ON MASONRY WALLS SHALL HAVE A MINIMUM BEARING OF 200 mm (8") UNLESS OTHERWISE NOTED. A. BRICK WALLS: BEARING SHALL BE ON BRICK LAID INCEMENT MORTAR. BLOCK WALLS: BEARING SHALL BE ON 100% SOLID UNITS LAID IN CEMEN MORTAR WITH LENGTH EQUAL TO TWICE THE LENGTH OF BEARING CONCRETE SLAB NOT GREATER THAN 50mm (6") TO HAVE A MINIMUM BEARING OF 120mm (4-3/4"). SLABS EXCEEDING 150mm (6") IN THICKNESS SHALL HAVE A MINIMUM BEARING OF 200mm(8").
- FILL ALL CELLS CONTAINING ANCHORS OR REINFORCEMENT WITH 20 MPa CONCRETE. PROVIDE 150mm (6") MIN. BEARING FOR LINTELS.
- PROVIDE MASONRY TIES & LATERAL REINFORCEMENT IN ACCORDANCE WITH REFERENCE STANDARD AND/OR AS SHOWN ON DRAWING 10. <u>LINTELS</u> • OVER ALL OPENINGS IN MASONRY WALLS, UNLESS OTHERWISE SHOWN ON
- STRUCTURAL DRAWINGS, PROVIDE LINTELS AS SHOWN ON STD-M2. 11 BUILD MASONRY TIGHT TO BEAM WEB AT BEAM BEARINGS 12. PROVIDE FULL MORTAR BEDS, INCLUDING FACE SHELL AND CROSS WEBS AT ALL 13. PROVIDE MASONRY REINFORCEMENT OF GALVANIZED LADDER TYPE 50mm (2")
- NARROWER THAN WALL THICKNESS, FABRICATED FROM WIRE, AND CONFORMING TO CSA STANDARD CSA A370-04. PROVIDE REINFORCEMENT AS NOTED IN ON DWGS., AND IN THE FIRST AND SECOND BED JOINTS IMMEDIATELY ABOVE AND BELOW WALL OPENINGS, AND EXTENDING 200mm (8"). DO NOT EXTEND REINFORCEMENT THROUGH CONTROL JOINTS. USE PREFABRICATED CORNER

PIECES. PROVIDE 1-15M VERTICAL AT ALL WALL INTERSECTIONS. 14. DEMOLITION WORK:

- AFTER EXISTING STRUCTURAL STEEL ELEMENTS HAVE BEEN REMOVED, ALL EXISTING CONNECTION DETAILS (ANGLES, CLIPS, ETC) MUST BE REMOVED, GRIND SMOOTH, AND REPAINTED TO OWNER'S APPROVAL. CONTRACTOR MUST PROVIDE ALL NECESSARY AND ADEQUATE TEMPORARY
- BRACING TO MAINTAIN STABILITY OF EXISTING BUILDING UNTIL NEW WORK SHOWN ON THESE DRAWINGS IS COMPLETED. THE CONTRACTOR SHALL HAVE THE SOLE RESPONSIBILITY FOR THE DESIGN, ERECTION, OPERATION, MAINTENANCE, AND REMOVAL OF TEMPORARY SUPPORTS TEMPORARY BRACINGS AND SHORING SYSTEM STRUCTURES AND FACILITIES AND
- HE DESIGN AND EXECUTION OF CONSTRUCTION METHODS REQUIRED IN THEIR USE IN ORDER TO CARRY OUT THIS WORK 4. THE CONTRACTOR SHALL ENGAGE AND PAY FOR REGISTERED PROFESSIONAL ENGINEERING PERSONNEL SKILLED IN THE APPROPRIATE DISCIPLINES TO PERFOR THOSE FUNCTIONS REFERRED TO IN PARAGRAPH '3' ABOVE AND IN ALL CASES
- WHERE SUCH TEMPORARY SUPPORTS, STRUCTURES, AND FACILITIES AND THEIR METHOD OF CONSTRUCTION ARE OF SUCH A NATURE THAT PROFESSIONAL ENGINEERING SKILL IS REQUIRED TO PRODUCE SAFE AND SATISFACTORY RESULTS THIS SPECIFICATION IS PRIMARILY FOR DEMOLITION OF STRUCTURAL WORK ONLY. IN CASE OF DISCREPANY WITH ARCHITECTURAL SPECIFICATIONS/DRA
- ARCHITECTURAL GOVERNS EXCEPT WHERE STRUCTURAL SAFETY IS IN DOUBT THEN THE ENGINEER MUST BE CONSULTED BEFORE PROCEEDING WITH WORK. PERFORM DEMOLITION WORK IN ACCORDANCE WITH REQUIREMENTS OF CSA STANDARD S350-M. CODE OF PRACTICE FOR SAFETY IN DEMOLITION OF STRUCTURES; AND HEALTH AND SAFETY ACT, OF THE PROVINCE OF ONTARIO; AND
- AS OTHERWISE REQUIRED BY, JURISDICTIONAL AUTHORITIES TO SAVE PERSONS AND PROPERTY FROM HARM RESULTING FROM WORK OF THIS SECTION. EXAMINE ALL EXISTING CONDITIONS AND ASSUME RESPONSIBILITY FOR PARTIAL DEMOLITION OF STRUCTURES.
- BEFORE COMMENCING WORK, ENSURE IN EXAMINATION OF THE SITE AND WORK TO BE DEMOLISHED THAT ALL POSSIBLE FACTORS CONCERNING DEMOLITION ARE INVESTIGATED.


CLIMATIC DESIGN DATA (MISSISSAUGA, ON)				
WIND PRESSURE	q ₅₀ = 0 kPa			
SEISMIC DATA	$\begin{split} S_{a}(0.2) &= 0\\ S_{a}(0.5) &= 0\\ S_{a}(1.0) &= 0\\ S_{a}(2.0) &= 0\\ S_{a}(5.0) &= 0\\ PGA &= 0 \end{split}$			
SNOW	S₅ = kPa Sr = kPa			
1 DAY RAIN	mm			

- A. DESIGN THESE NOTES AND DRAWINGS APPLY SPECIFICALLY TO THE METAL STUD FRAMING COMPONENT OF THE EXTERIOR WALLS. THESE NOTES MUST BE READ IN CONJUNCTION WITH ARCHITECTURAL DRAWINGS AND SPECIFICATIONS ALL STEEL FRAMING SYSTEM TO CONFORM WITH ASTM A653/A653M-13, HOT DIP GALVANIZED. THE DESIGN WIND LOADING IS AS DETERMINED BY O.B.C. REQUIREMENTS, AND SHOULD BE A MINIMUM OF 1.0 KN/m²
- OF STUD UNDER DESIGN WIND LOADS. THE MINIMUM BASE METAL THICKNESS FOR ALL EXTERIOR METAL WALL COMPONENTS, EXCLUDING COATINGS ARE AS
- NOTED ON DRAWINGS AND SPECIFICATION. THE CONTRACTOR SHALL SUBMIT SHOP DRAWINGS BEARING THE SEAL OF A PROFESSIONAL ENGINEER REGISTERED IN THE PROVINCE OF PROJECT LOCATION FOR ALL STEEL STUD WALLS TO CONSULTANT FOR REVIEW.

AND SPECIFICATIONS.

CESSORIES

B. MATERIALS STUD SECTION:

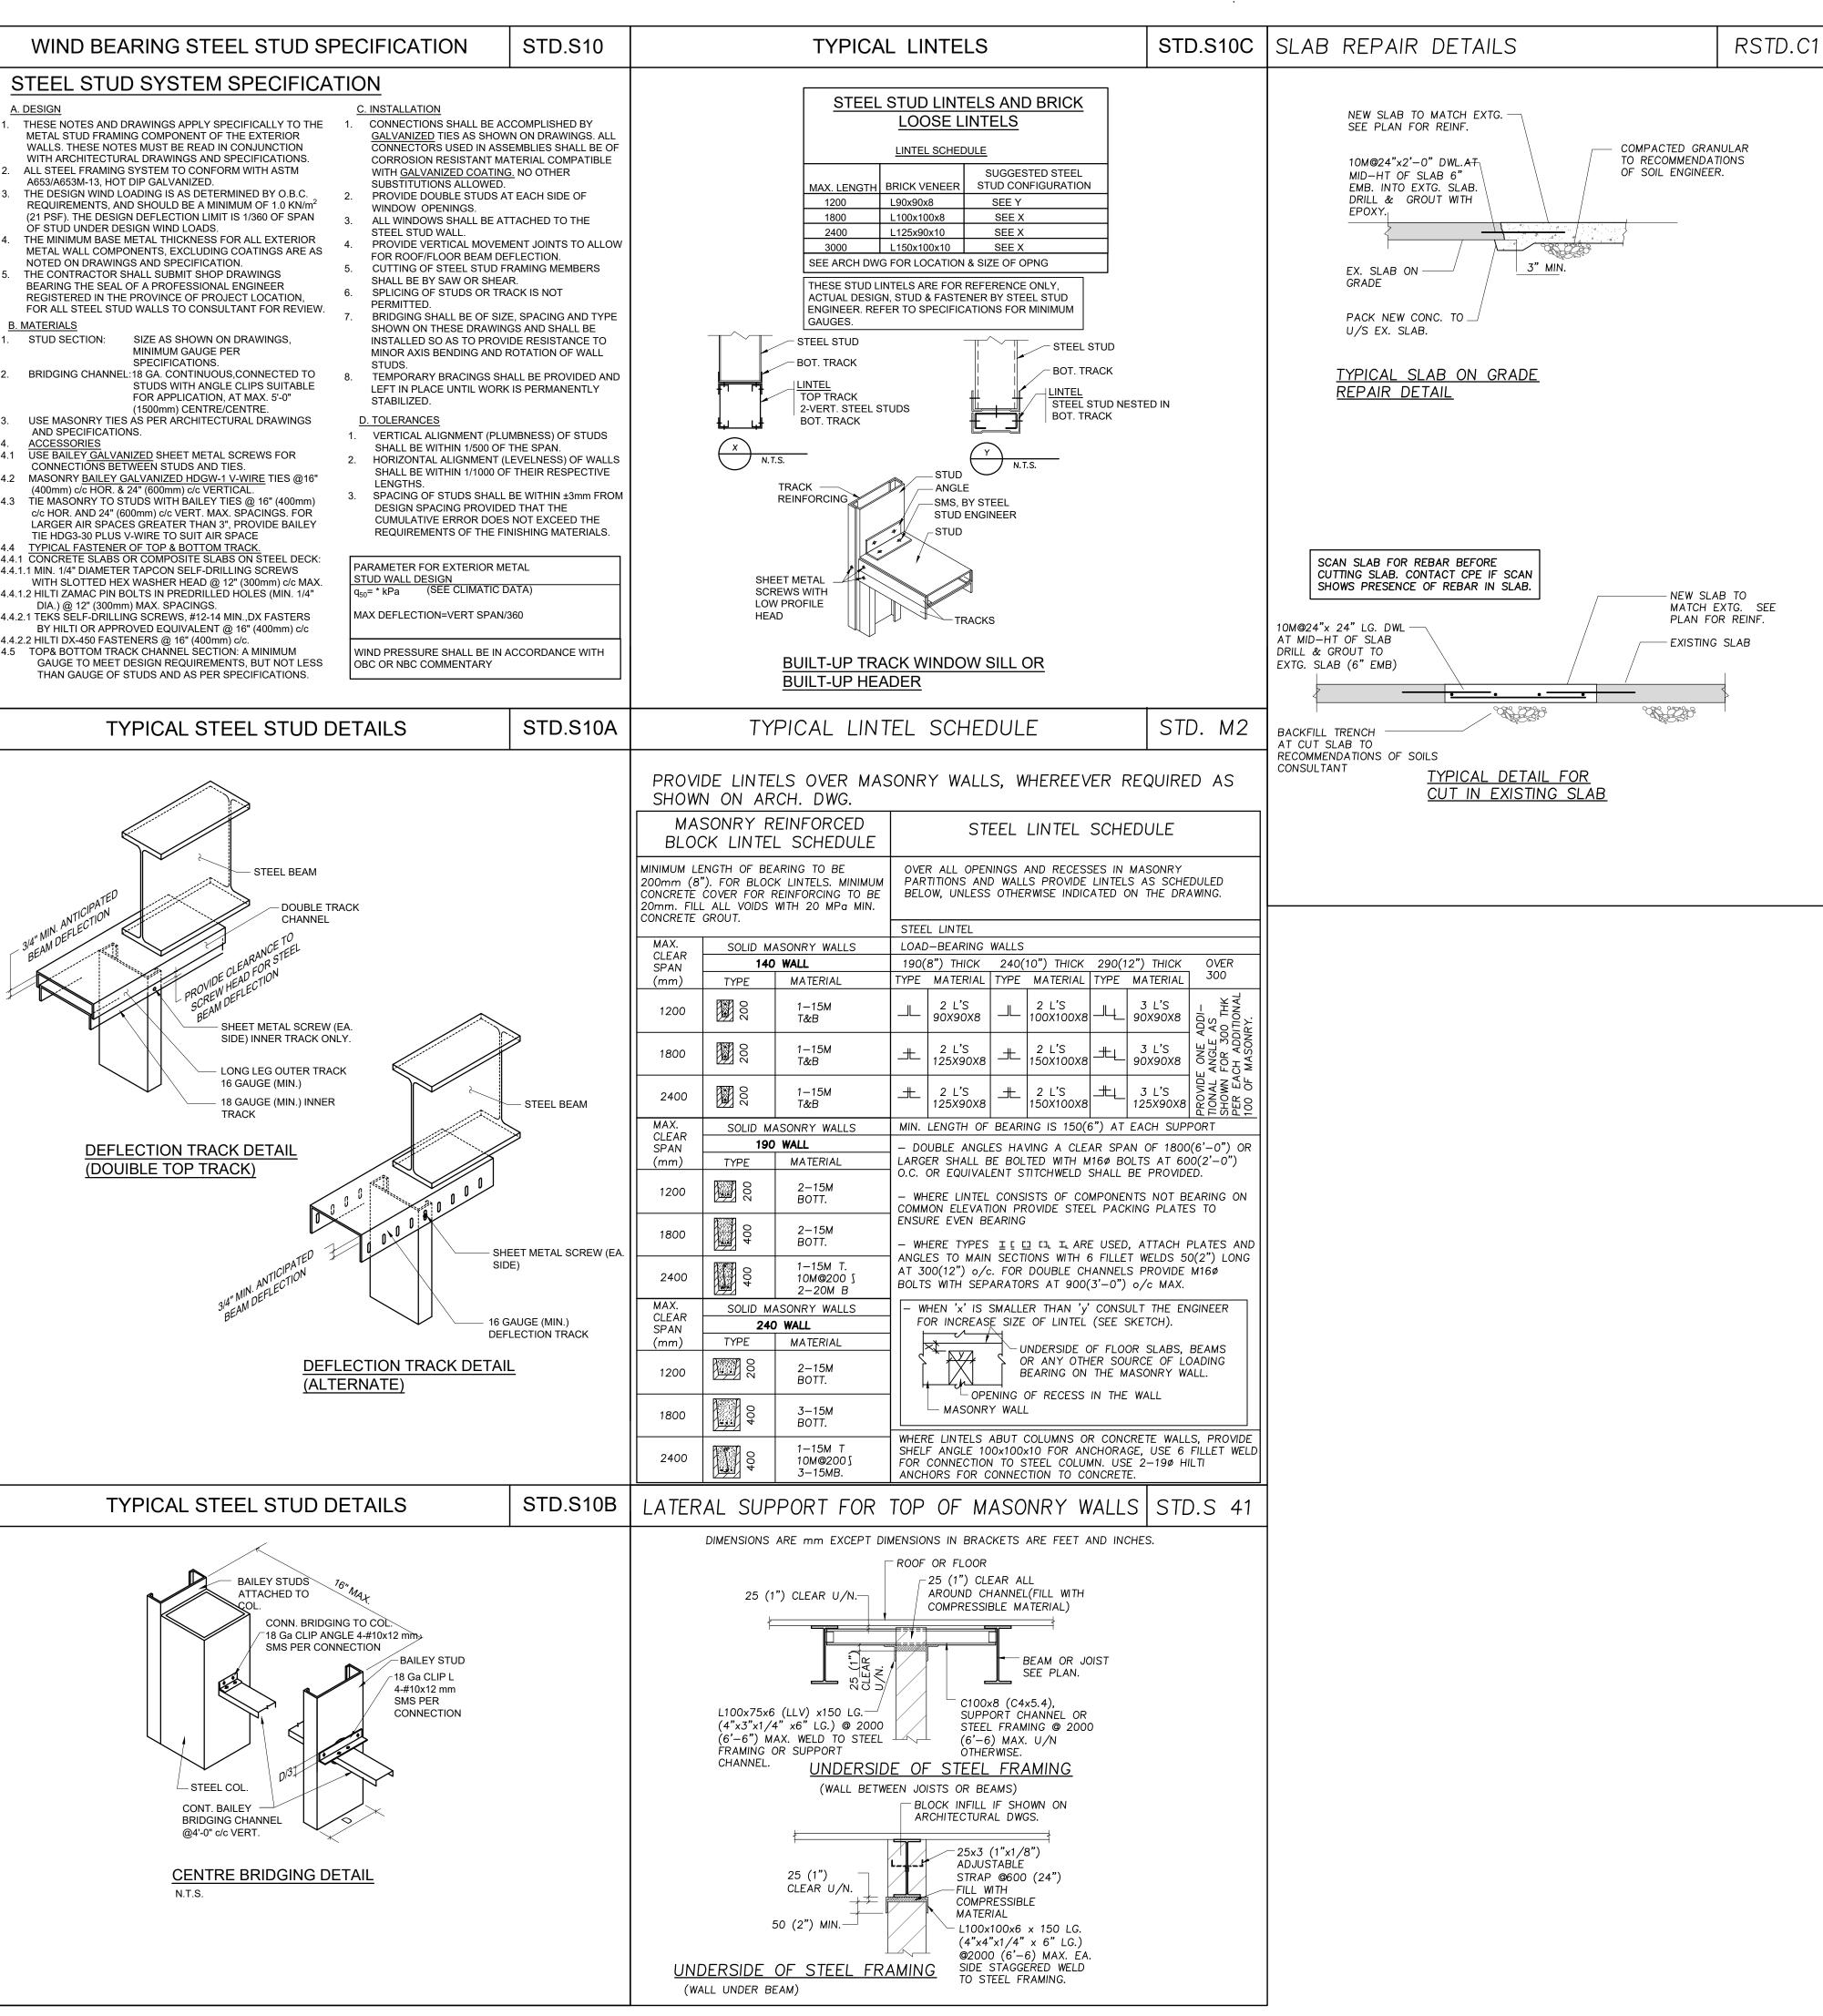

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The drawing is not to be scaled. The engineer is not responsible for the accuracy of survey, architectural, mechanical, electrical, etc., information shown on this drawing. Refer to the with appropriate consultant's drawings before proceeding with the

Construction must conform to all applicable codes and requirements of authorities having jurisdiction. The contractor working with drawings not specifically marked 'For

Construction' must assume full responsibility and bear costs for any corrections or damages resulting from his work.

4	ISSUED FOR TENDER	MAR.26, 2024
3	ISSUED FOR PERMIT	JUL.19, 2023
2	ISSUED FOR COORDINATION	JUN.28, 2023
1	ISSUED FOR COORDINATION	MAR.01, 2023
NO.	DESCRIPTION	DATE
REV	ISIONS / ISSUES	

• **Deel** District School Board 5650 Hurontario Street, Mississauga, Ont., L5R 1C6 Tel: (905) 890-1099, Fax: (905) 890-9453





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Project Name

GLENFOREST POOL GLENFOREST SECONDARY SCHOOL 2575 FIELDGATE DR., MISSISSAUGA, ON L4X 2J6

POOL DEMOLITION

Drawing Title

GENERAL NOTES & TYPICAL DETAILS

Drawn	SVJ	Checked RT	Sheet no.
Date JAN,2	2023	s _{cale} As Shown	DS-5
		Project No. 220132	

	MECHANICAL LEGEND		MECHANICAL LEGEND	GENERAL NOTES	<u>.</u>
HEATING, VENTIL	ATION AND AIR CONDITIONING (HVAC)	HEATING, VENTI	LATION AND AIR CONDITIONING (HVAC)	1. ALL DEMOLI	- FION AND NEW WORK SHALL BE COORDINATED WITH ALL TRADE
	RIGID DUCTWORK		WALL FIN HEATER CV-A DENOTES TYPE	EQUIPMENT	N SITE. CONSTRUCT NEW SERVICES AND LOCATE NEW IN SUCH A WAY THAT IT DOES NOT CONFLICT WITH WORK OF HONS AND/OR THE OPERATION/MAINTENANCE OF
	ACOUSTICALLY LINED DUCTWORK	CV-A 7000 0.15	7000 DENOTES HEAT OUTPUT IN WATTS 0.15 DENOTES FLOW RATE IN L/S		RIAL SUPPLIED BY OTHER DIVISIONS.
NMM	FLEXIBLE ROUND DUCTWORK		FORCED FLOW HEATER FFH-A DENOTES TYPE		TORY FOR THE MECHANICAL CONTRACTOR TO VISIT THE SITE IDDING AND REVIEW EXISTING CONDITIONS AND DEMOLITION
\square	SUPPLY DUCTWORK RISER UP	FFH—A	REFER TO FORCED FLOW HEATER SCHEDULE FOR HEAT OUTPUT AND FLOW RATE	SCOPE OF V	NORK TO SUIT EXISTING ARCHITECTURAL, ELECTRICAL, AND MECHANICAL SITE CONDITIONS, DRAWINGS, SPECIFICATION:
	EXHAUST/RETURN DUCTWORK RISER UP	RTU-1-2 D	VAV BOX 'RTU-1-2' DENOTES BOX NAME/NUMBER; 'D' DENOTES VAV TYPE	AND ALL CC	NTRACT DOCUMENTS. NO EXTRA WILL SUBSEQUENTLY BE O COVER ANY SUCH ERROR, OMISSION AND/OR OVERSIGHT FOF
\boxtimes	SUPPLY DUCTWORK RISER DOWN	100 200	(SEE SCHEDULE); '100' DENOTES MINIMUM FLOW; '200' DENOTES MAXIMUM FLOW	NOT HAVING CONDITIONS,	MADE A THOROUGH INSPECTION OF THE GROUNDS, EXISTING DRAWINGS, SPECIFICATION AND DESIGN INTENT. THE
	EXHAUST/RETURN DUCTWORK RISER DOWN	PLUMBING AND		ELECTRICAL REMAIN IN C	CONTRACTOR SHALL NOTE THAT THE EXISTING BUILDING WILL DPERATION THROUGHOUT DEMOLITION/CONSTRUCTION. ALLOW
BD	BALANCING DAMPER	STM	ABOVE-GROUND STORM	SUPPLY AND	ORK REQUIRED TO BE DONE WHICH MAY AFFECT POWER
•SD	SPLITTER DAMPER	<u> </u>	UNDERGROUND STORM	PROVIDE TEN	AT A TIME CONVENIENT TO THE BUILDING MANAGEMENT. MPORARY SERVICES AS REQUIRED TO ENSURE CONTINUED
→ = U/C	DOOR UNDERCUT	SAN /	ABOVE-GROUND SANITARY		AT ALL TIMES.
→甘 D/G	DOOR GRILLE	<u></u>	UNDERGROUND SANITARY		EXAMINE OTHER EXISTING UTILITY LINES SUCH AS GAS, WATER TO STARTING ANY WORK.
CAP [CAPPED DUCTWORK	PUMPED SAN	PUMPED SANITARY		VINGS SHALL BE READ & PRICED IN CONJUNCTION WITH ALL ND SPECIFICATIONS FORMING THE CONTRACT AS WELL AS ALL
T a BD	SPIN-ON FITTING WITH BALANCING DAMPER		RUNNING TRAP	OTHER DOCU	JMENTS FORMING THIS BID. NO EXTRA COST WILL BE ACCEPTE TO OBTAINING AND/OR REVIEW OF SUCH DOCUMENTS. REFER
\overline{X}	SUPPLY AIR DIFFUSER	<u>ه</u>	PLUMBING TRAP	TO ARCHITE	CTURAL, ELECTRICAL, FIRE PROTECTION STRUCTURAL AND LAYOUTS IN CONJUNCTION FOR EXACT LOCATION OF ALL
	RETURN/EXHAUST AIR GRILLE	V/	SANITARY VENT	EQUIPMENT.	REPORT ANY DISCREPANCIES TO THE MECHANICAL ENGINEER OMMENCING WORK. NO EXTRA WILL BE PROVIDED AS A RESUL
	FLEXIBLE CONNECTION	/	SANITARY CLEANOUT IN ACCESSIBLE CEILING SPACE	OF A FAILUF	RE TO DO SO.
	SUPPLY AIR GRILLE – WALL-MOUNTED	CO a ⊢∕	SANITARY CLEANOUT IN SLAB	AND, BASE	TORY THAT ALL WORK COMPLY WITH ALL APPLICABLE CODES BUILDING (BOARD) STANDARDS, AND THE STANDARDS SET BY
+	RETURN AIR GRILLE – WALL-MOUNTED	//	DOMESTIC COLD WATER		L LOCAL AUTHORITIES HAVING JURISDICTION.
		// TW	DOMESTIC TEMPERED HOT WATER	JURISDICTION	OR ALL INSPECTIONS REQUIRED BY AUTHORITIES HAVING N AS MANDATED BY CODES OR THE REQUIREMENTS OF THE ATTEND ALL INSPECTIONS AND FURNISH ALL MATERIALS AND
₹ BD	FLEXIBLE DUCT CONNECTION TO RIGID DUCTWORK	// TWR	DOMESTIC TEMPERED HOT WATER RECIRCULATION		. ATTEND ALL INSPECTIONS AND FURNISH ALL MATERIALS AND QUIRED TO COMPLETE THE INSPECTIONS TO THE SATISFACTION HORITIES
		BFP //	BACKFLOW PREVENTER - SUITABLE FOR SERVICE INTENDED		PARTITIONS ARE BEING CONSTRUCTION, ALL NEW SERVICES
	SQUARE ELBOW WITH AIR TURNING VANES	//	WATER METER	SHALL BE C	ONCEALED IN SUCH PARTITIONS WHERE FEASIBLE AND BY CODE. ALL SERVICES SPECIFIED TO BE INSULATED SHALL B
, D FD		∎нв	HOSE BIBB	CONCEALED	WITH INSULATION.
	FUSIBLE LINK FIRE DAMPER WITH ACCESS DOOR IN DUCT	T NFHB	NON-FREEZE HOSE BIBB	AND SPECIF	NT OF ANY DISCREPANCY BETWEEN THE MECHANICAL DRAWINGS ICATIONS, ALLOW FOR THE HIGHEST-PRICED OPTION IN THE
, D MD		O VTR	VENT THROUGH ROOF	TENDER PRI	CE.
	MOTORIZED DAMPER	O RWL	RAIN WATER LEADER	CONTRACTOR	ENT AND SERVICES SHALL BE STARTED-UP BY THE AND BY THE APPROPRIATE AGENCIES REQUIRED FOR
BDD		Ø FD	FLOOR DRAIN	DAYS NOTICE	SUCH START-UPS. PROVIDE A MINIMUM OF 10 BUSINESS TO THE MECHANICAL ENGINEER OF NEW EQUIPMENT/
	BACK DRAFT DAMPER	Ø FFD	FUNNEL FLOOR DRAIN	SERVICES S	
, T BD		RD	ROOF DRAIN		L MATERIAL AND EQUIPMENT AS SPECIFIED, EXCEPT WHERE PROVAL FOR SUBSTITUTION IS GIVEN IN WRITING BY THE
	BALANCING DAMPER	CONTROLS			THERE ARE SEVERAL NEW SERVICES TO BE ROUTED THROUGH
т ' т			BAS – TEMPERATURE SENSOR – IN PIPING	THE EXISTIN	G SCHOOL. PATH OF SERVICES IS FOR GENERAL INTENT PRIOR TO PRICING, EXAMINE ALL EXPOSED CONDITIONS BELOW
	BRANCH TAKE-OFF WITH ADJUSTABLE SPLITTER DAMPER IN SUPPLY DUCT		BAS – CURRENT SENSOR	AND ABOVE	THE EXISTING CEILINGS TO BETTER UNDERSTAND THE EXTENT AND EXISTING SERVICES PRESENT IN THE SCHOOL. INCLUDE FC
		P/S	BAS – PRESSURE SWITCH	CONDITIONS:	Y AND INSTALLATION OF NEW SERVICES BASED ON EXISTING INCLUDE FOR ALL NECESSARY OFFSETS AND CHANGE IN
F OED	OPEN ENDED DUCT WITH BALANCING DAMPER AND BELLMOUTH		BAS – FLOW SWITCH	CEILING. ALL	OF NEW SERVICES WITHIN THE AVAILABLE SPACE ABOVE THE . NEW SERVICES IN THE EXISTING SCHOOL SHALL BE RUN
			BAS - ANALOG INPUT	ABOVE THE	
SL-AHU1-2	AIR HANDLING UNIT SILENCER AS PER SILENCER SCHEDULE	AO	BAS - ANALOG OUTPUT	SERVICES AS	R PIPE FREEZING AS A METHOD OF ISOLATION OF EXISTING 5 THE EXISTING ISOLATION VALVES MIGHT NOT BE PRESENT OR
		DI	BAS - DIGITAL INPUT	MIGHT NOT	BE FUNCTIONING.
A-84 25	— DENOTES DIFFUSER TYPE – DENOTES AIRFLOW (IN L/S) — DENOTES NECK SIZE. DUCTWORK TO MATCH.	DO	BAS – DIGITAL OUTPUT	L	
T	THERMOSTAT TIED TO THE BAS SYSTEM	FIRE PROTECTIO			DRAWING LIST
Т	STANDALONE THERMOSTAT	FE	FIRE EXTINGUISHER IN ENCLOSURE C/W MOUNTING BRACKET		
//	PUMP	FE	FIRE EXTINGUISHER C/W MOUNTING BRACKET	DRAWING NUMBER	DESCRIPTION
/ / /HWS/			FIRE BLANKET	M1	MECHANICAL LEGEND, NOTES, SCHEDULES & SCHEMATICS
/ — HWR — →	HOT WATER RETURN - HEATING	ACRONYMS		M2	POOL TUNNEL & FIRST FLOOR KEY PLAN
/				M3	SECOND FLOOR KEY PLAN
← — RI — →			RIPTION	M4	ROOF KEY PLAN
← — RL — → ← _ RG — →		AC AIR C	SS DOOR CONDITIONER	M5	DEMOLITION PLANS
		BDD BACK	NCING DAMPER DRAFT DAMPER	M6	DEMOLITION PLANS
← CD ← ∕		CD COND	EXISTING SERVICE ENSATE	M7	DEMOLITION PLANS
∠ G/		CUT CUT		M8	NEW WORK PLAN
ć GV∕		EA EXHA	(ING FOUNTAIN UST AIR	M9	SCHEDULES & SCHEMATICS
	ISOLATION VALVE. TYPE AS PER SPECIFICATION		DAMPER		
	BALANCING VALVE	FS FLOW	EXTINGUISHER SWITCH —HELD SHOWER		
	STRAINER	LV LAVA			
	PRESSURE REDUCING VALVE	NO NORM	ALLY OPEN IALLY CLOSED		
	AUTOMATIC 2-WAY CONTROL VALVE	OA OUTD	OOR AIR SURE GAUGE		
<u> </u>	AUTOMATIC 3-WAY CONTROL VALVE	RWL RAIN REM REMC	WATER LEADER VE		
	CHECK VALVE	RP REPL. RA RETU	ACE RN AIR		
	UNION	SV SUPE	LY AIR RVISED VALVE		
×/	MANUAL AIR VENT	TYP TYPIC UV UNIT	AL VENTILATOR		
<u> </u>	DENOTES EXISTING PIPING TO BE REMOVED	WD WASH	THROUGH ROOF IER-DRYER UNIT		
//	DENOTES EXISTING PIPING TO REMAIN	WC WATE	R CLOSET		
·/	DENOTES NEW PIPING	L		L	
	GAS METER				
0	PROPANE METER				
/G/ /P/ //					
	PROPANE METER				
/P/	PROPANE METER ELECTRIC HEAT TRACING; DIVISION 22 UNLESS OTHERWISE NOTED				
/P/ /PG #	PROPANE METER ELECTRIC HEAT TRACING; DIVISION 22 UNLESS OTHERWISE NOTED PRESSURE GAUGE				

Notes Contractor shall check and verify all dimensions and shall report discrepancies to ETUDE ARCHITECTS INC. prior to construction. Drawing North True North Do not scale this drawing. ETUDE ARCHITECTS INC. accepts no responsibility for measurements scaled from the drawings. All drawings and specifications are the property of ETUDE ARCHITECTS INC., who reserves his copyright with respect to this document. It shall not be duplicated, used or circulated for any other purpose than that for which it was issued, and must be returned on completion of the project to ETUDE ARCHITECTS INC. MECHANICAL & ELECTRICAL CONSULTANT: SURI & ASSOCIATES LTD. ENGINEERING CONSULTANTS 1022 WHITE CLOVER WAY MISSISSAUGA, ONTARIO ELECTRICAL MECHANICAL LIGHTING L5V 1C8 T (905)-290-7861 COMMUNICATION

F (289)-327-3420

3.	ISSUED FOR TENDER	MAR. 27/24				
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NO.	DESCRIPTION	DATE				
REVISIONS / ISSUES						



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Project Name

GLENFOREST POOL GLENFOREST SECONDARY SCHOOL 2575 FIELDGATE DR., MISSISSAUGA, ON L4X 2J6

POOL DEMOLITION

Drawing Title

MECHANICAL LEGEND, NOTES, SCHEDULES & SCHEMATICS

-----Graphic Scale AS SHOWN _____ Drawn RS

CAD File

-


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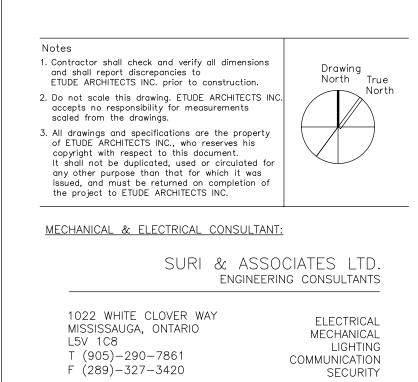
M1

Sheet no.

Revision No.

Date DECEMBER 2022



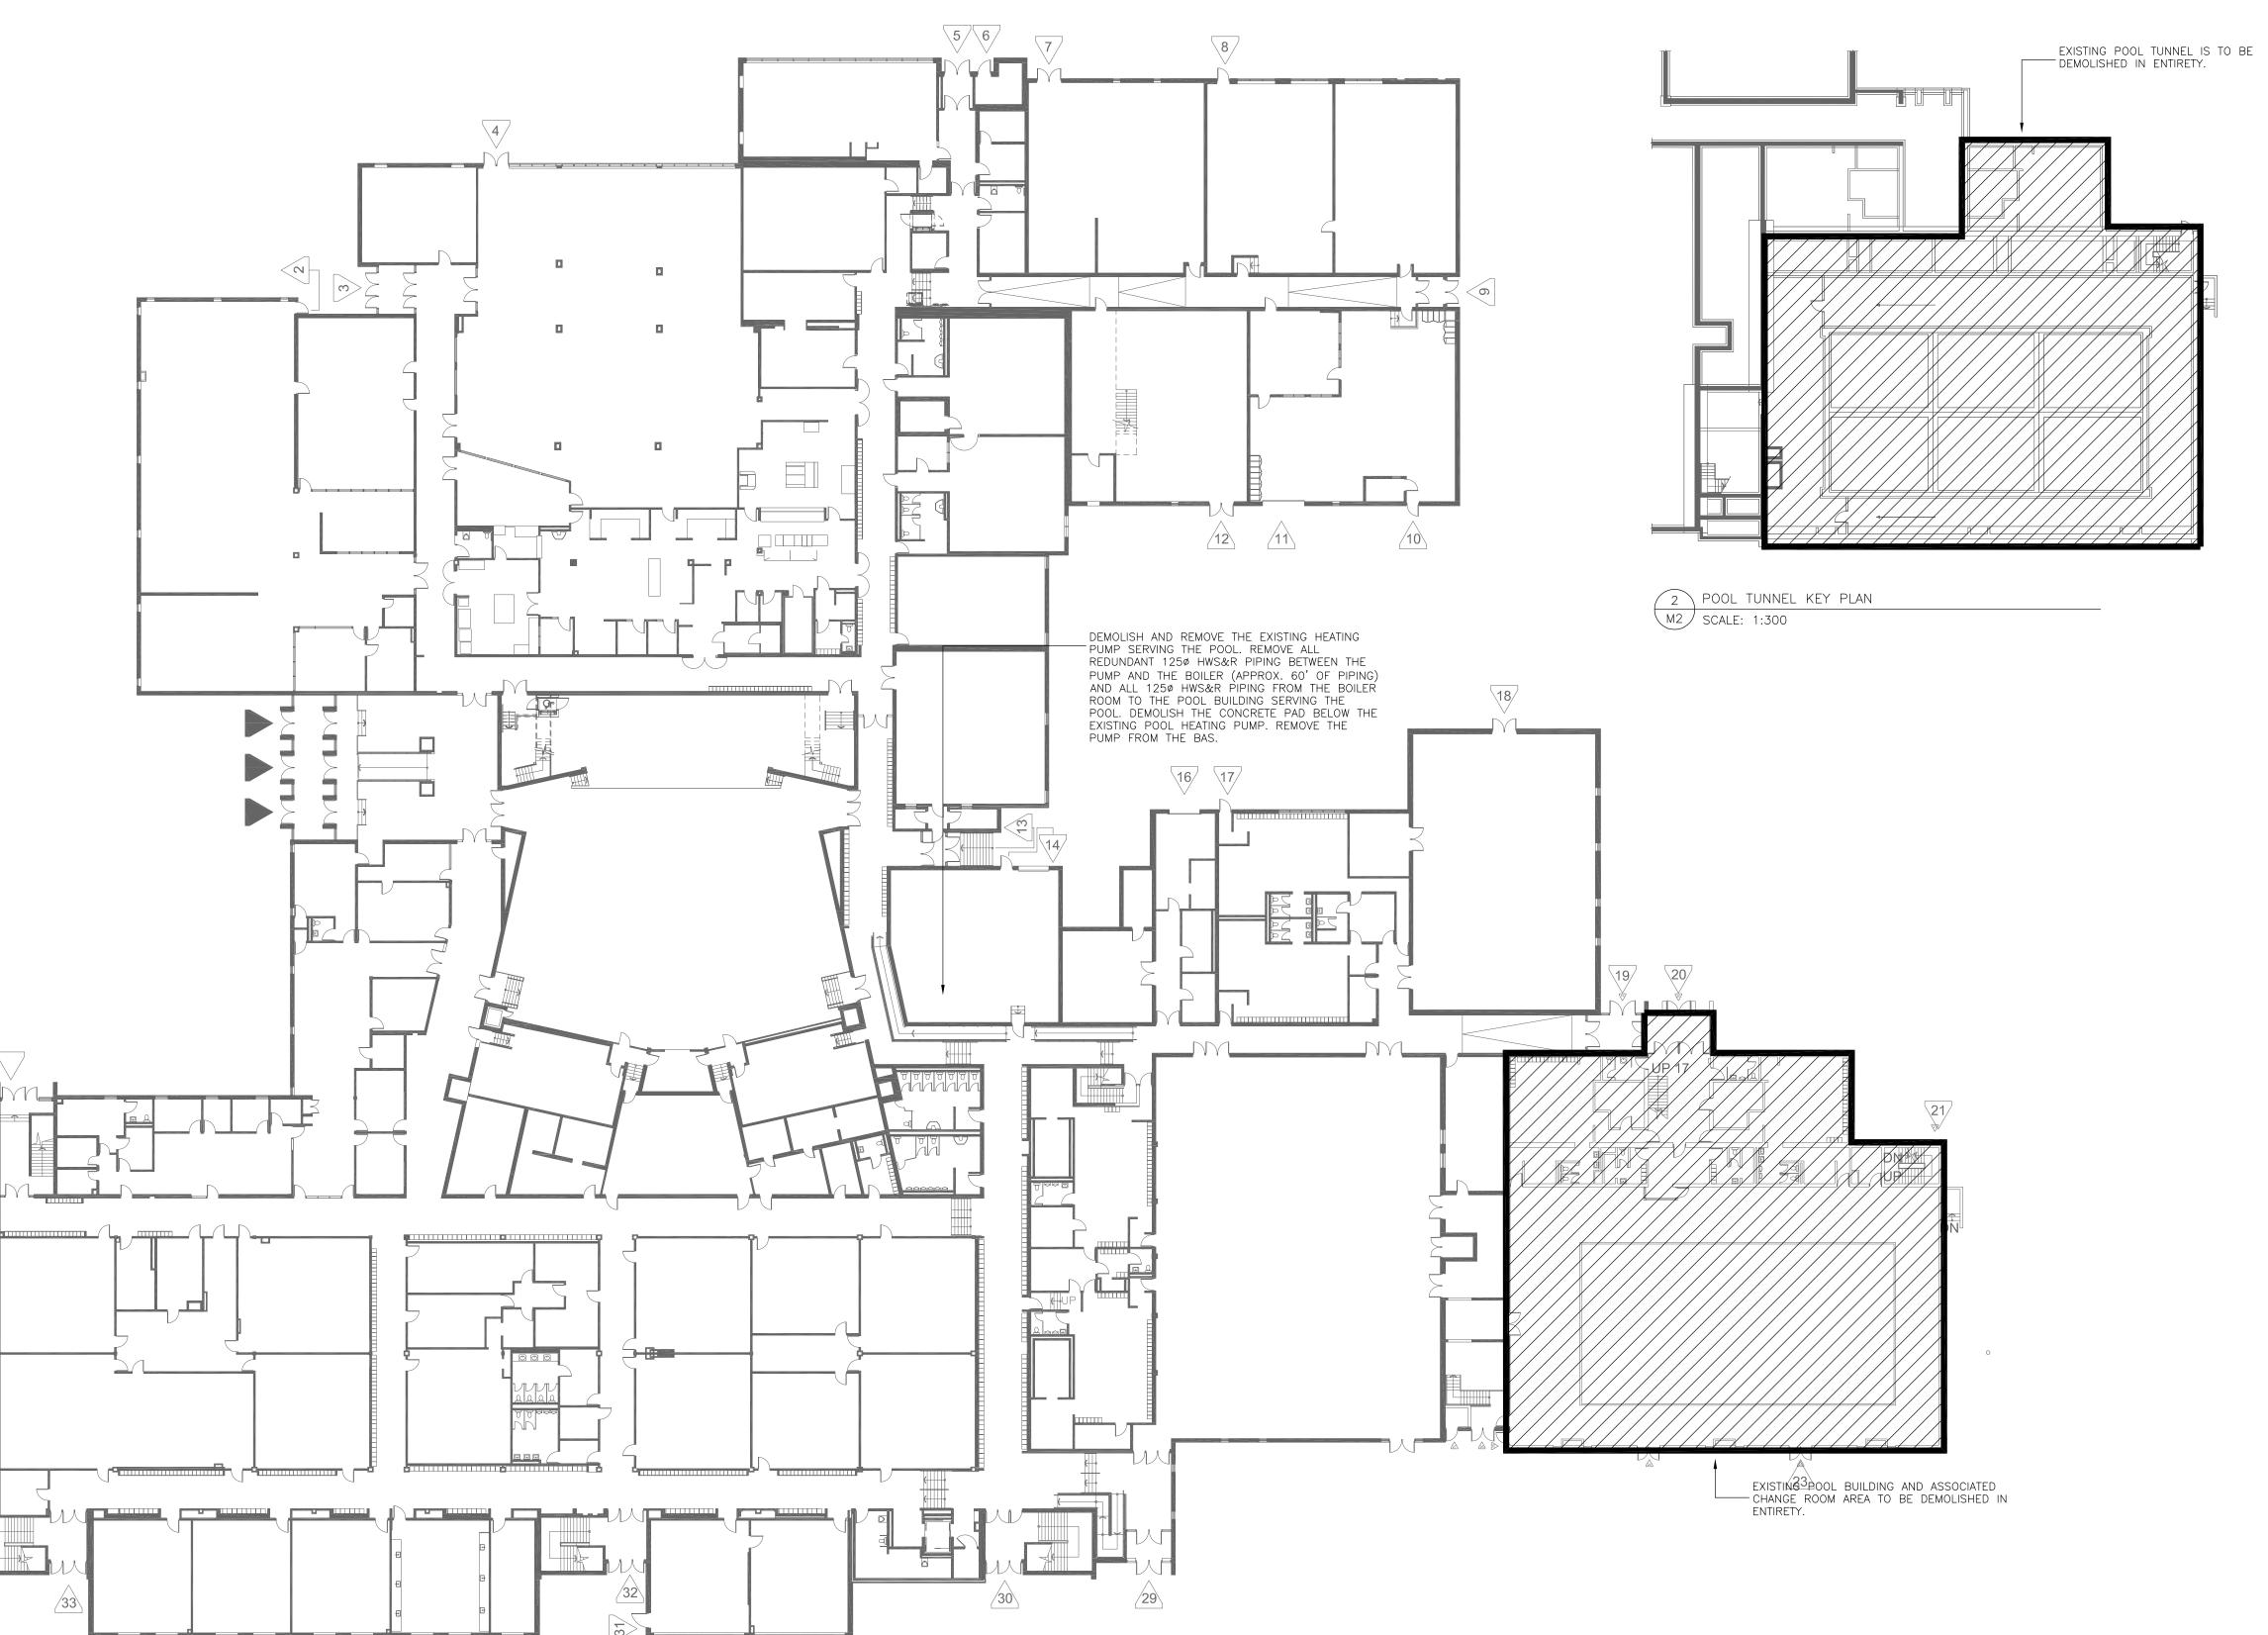

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Project Name

GLENFOREST POOL GLENFOREST SECONDARY SCHOOL 2575 FIELDGATE DR., MISSISSAUGA, ON L4X 2J6

POOL DEMOLITION

Drawing Title

POOL TUNNEL & FIRST FLOOR KEY PLAN

Graphic Scale AS SHOWN

Drawn RS _____

CAD File

-_____

Checked SS Scale AS NOTED


M2

Sheet no.

Project No. 23-124


Date DECEMBER 2022


Revision No.

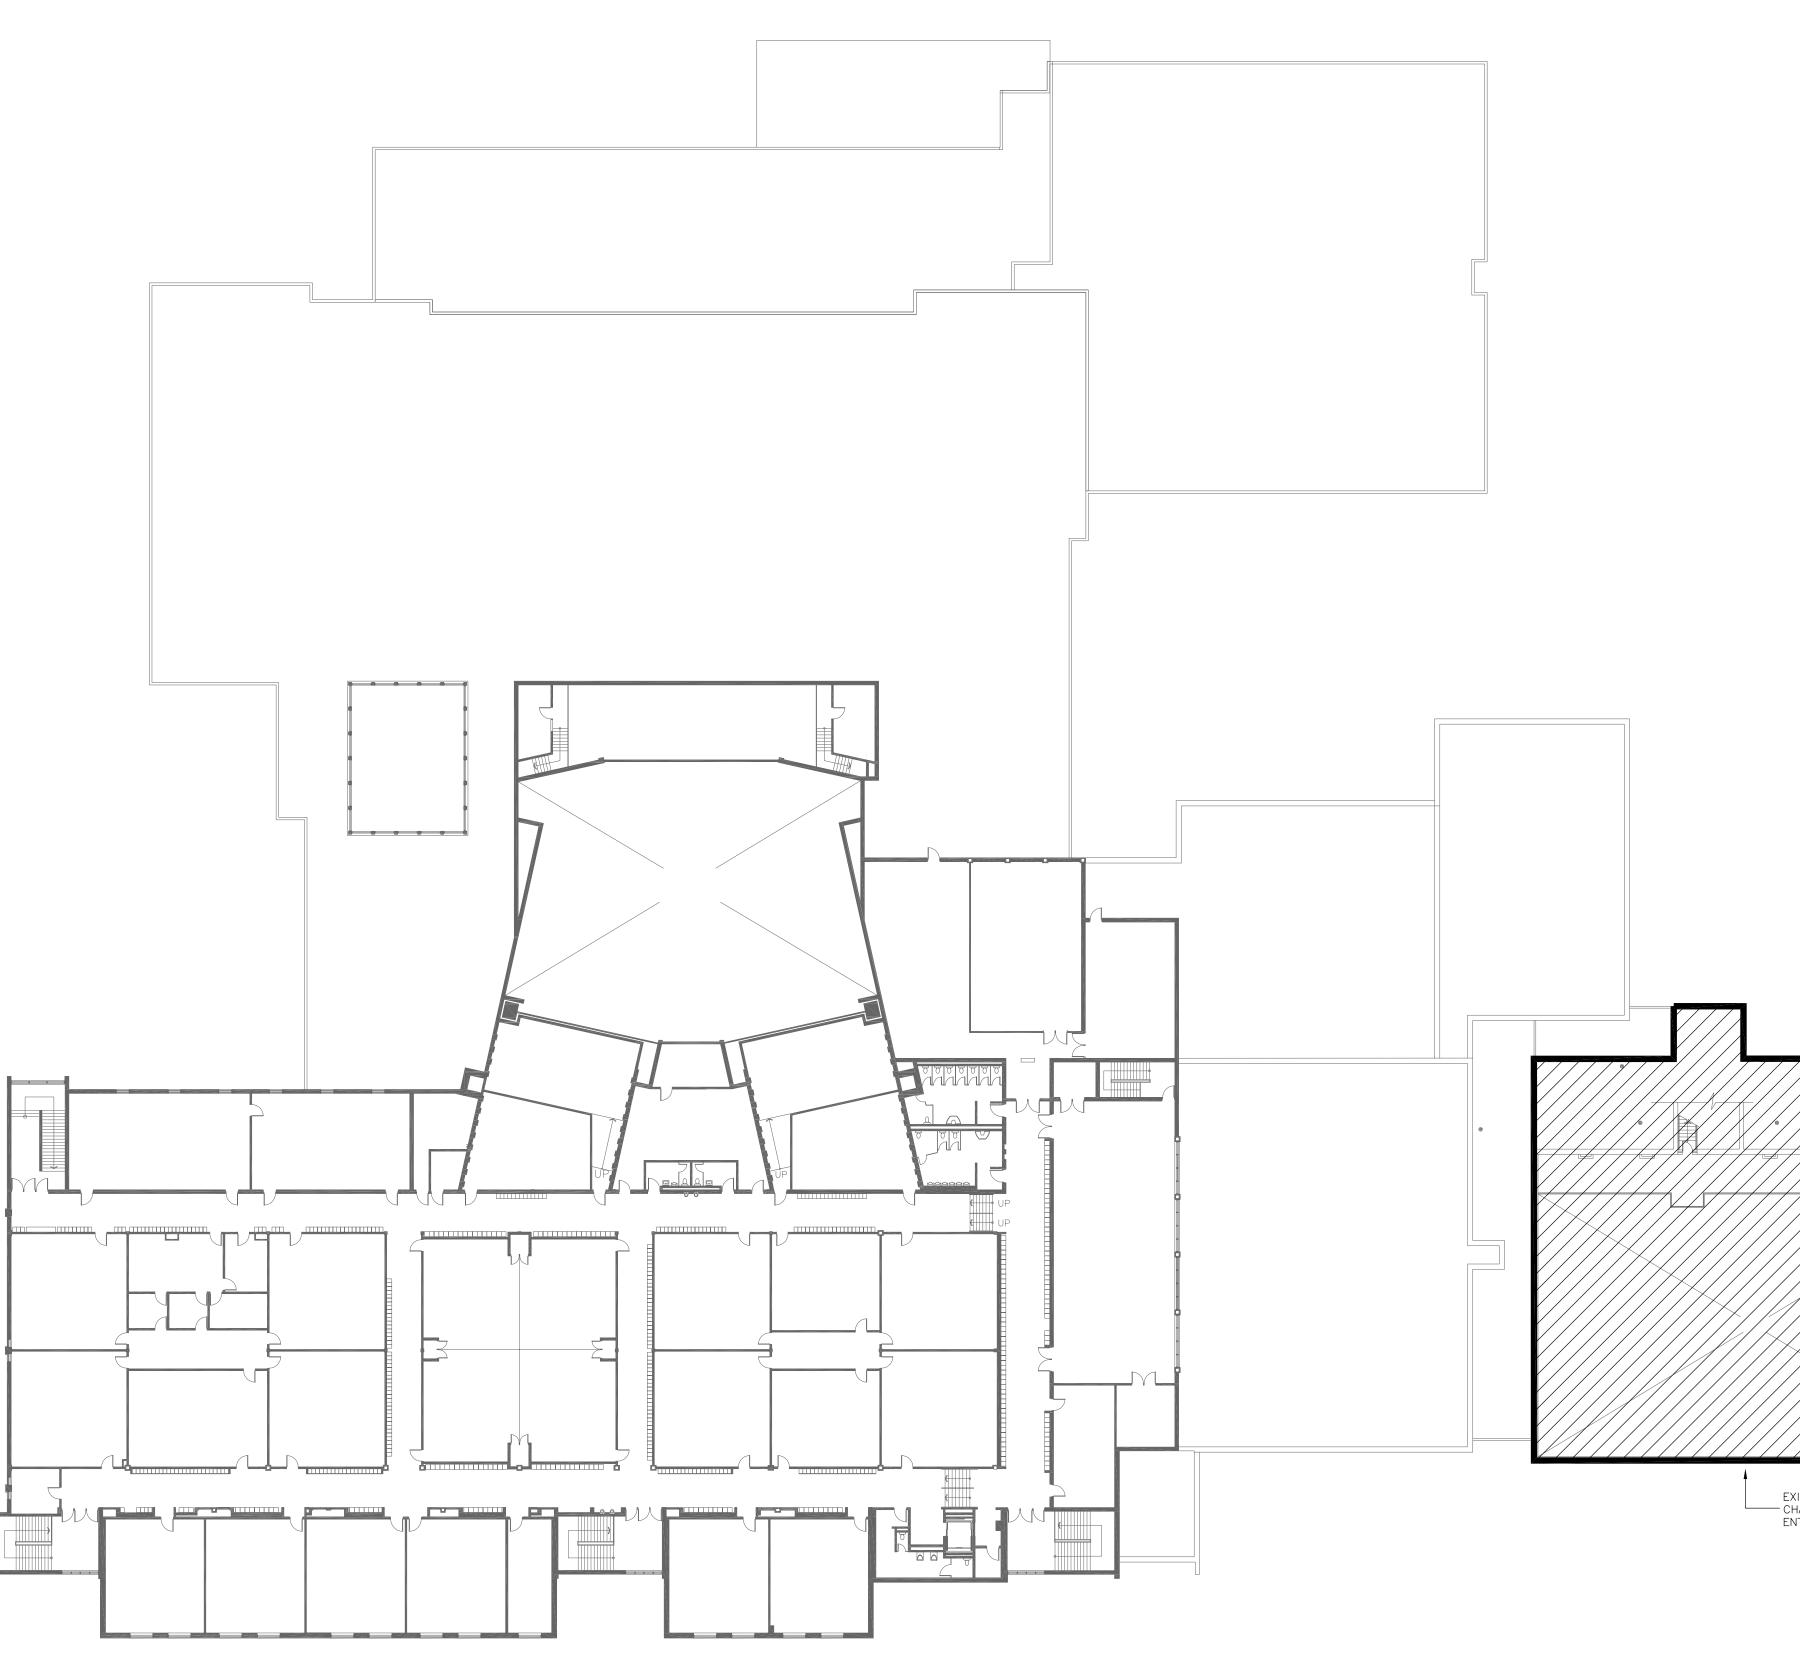

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EXISTING POOL BUILDING AND ASSOCIATED — CHANGE ROOM AREA TO BE DEMOLISHED IN ENTIRETY.

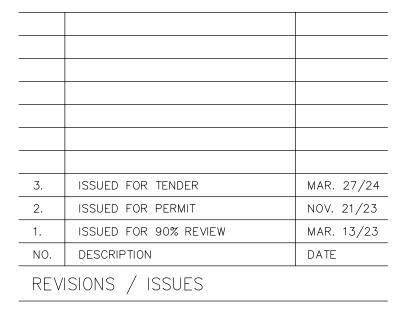

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Project Name

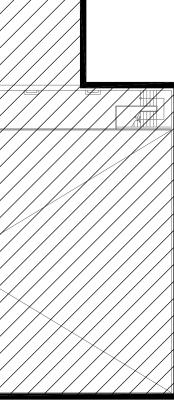GLENFOREST POOL GLENFOREST SECONDARY SCHOOL 2575 FIELDGATE DR., MISSISSAUGA, ON L4X 2J6

POOL DEMOLITION

Drawing Title

SECOND FLOOR KEY PLAN

Graphic Scale

AS SHOWN _____ Drawn RS _____ CAD File

-_____

Checked SS Scale AS NOTED

Project No.

23-124

M3

Sheet no.


Revision No.

Date

DECEMBER 2022




1 ROOF KEY PLAN M4 SCALE: 1:300

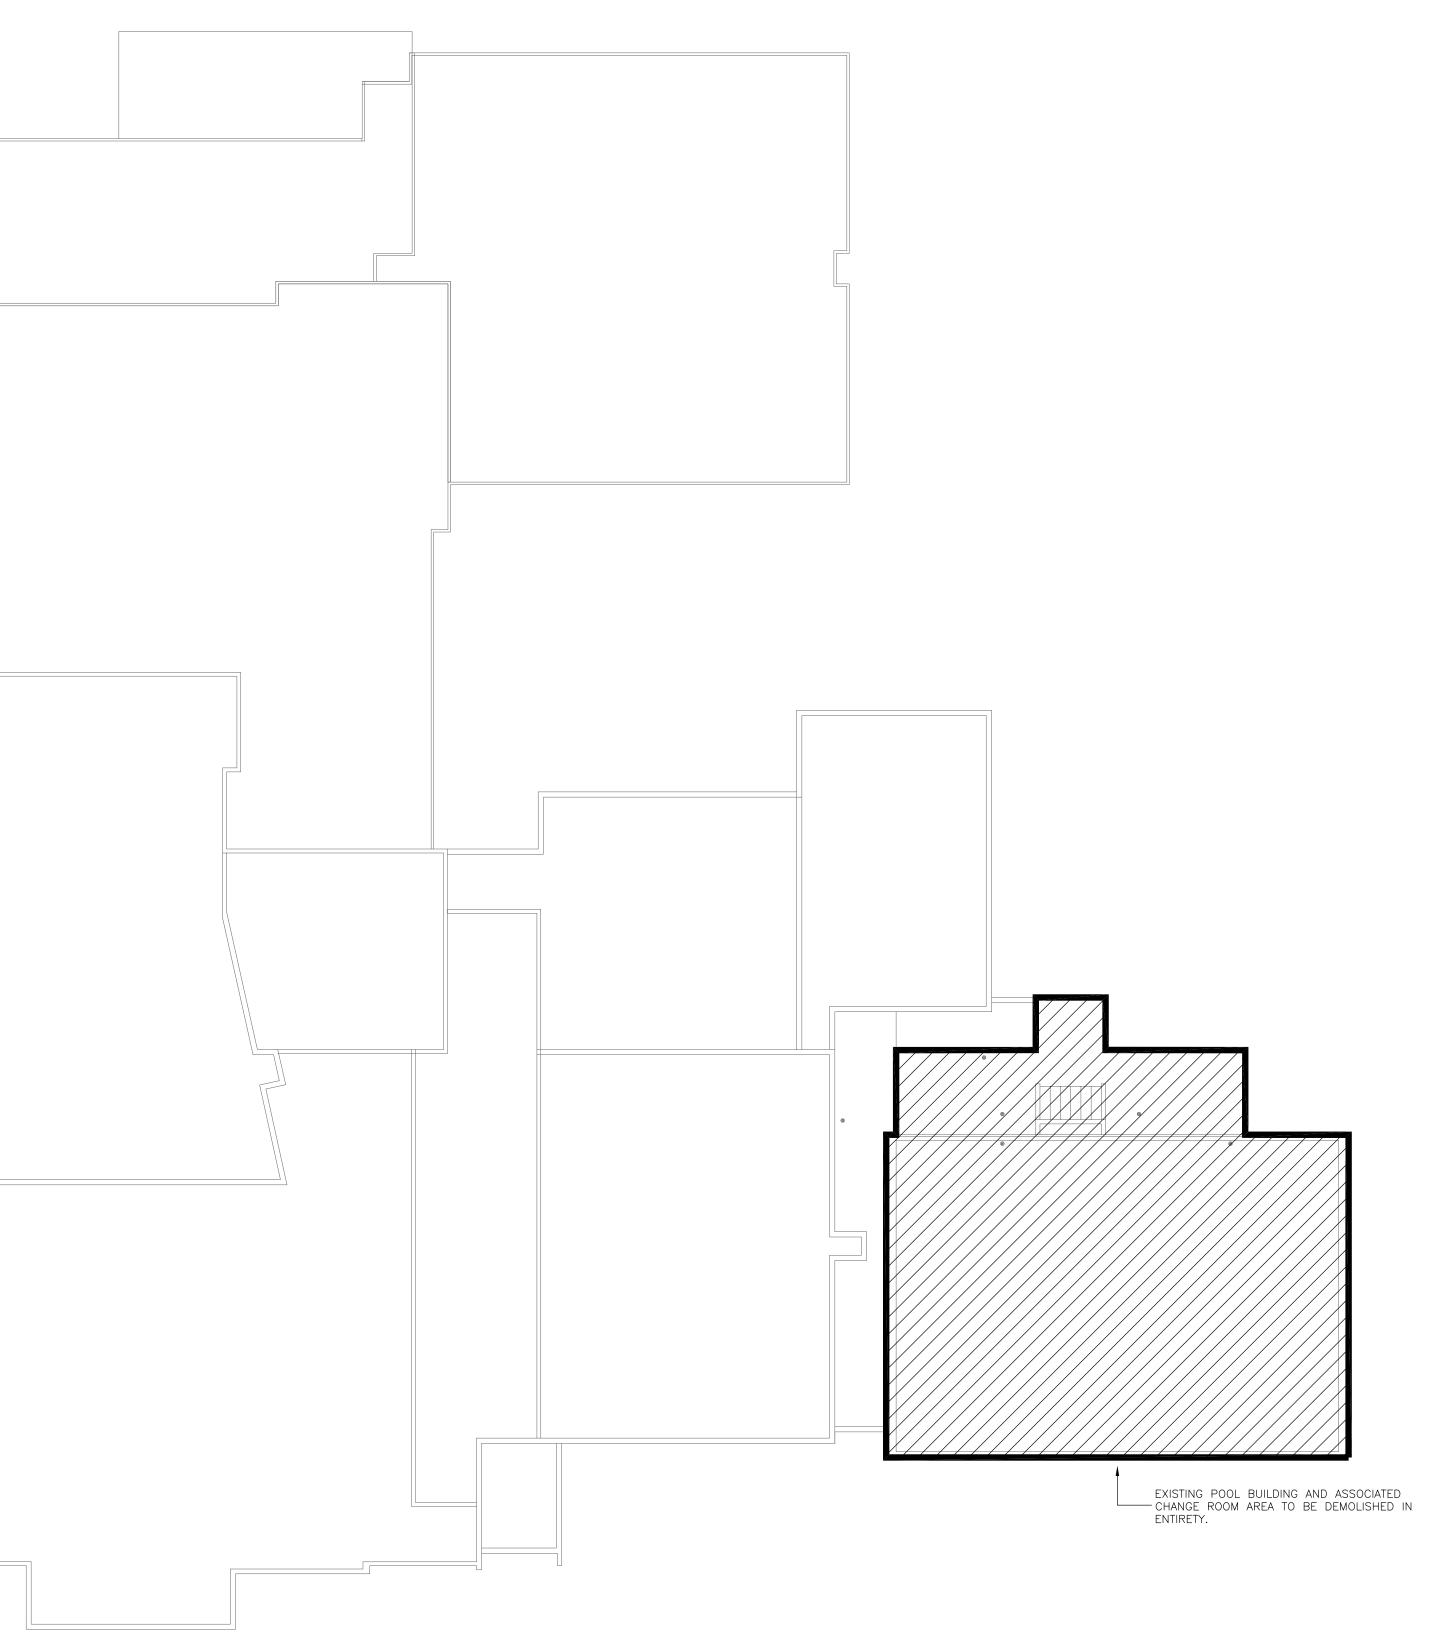

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• **pee** District School Board

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Project Name

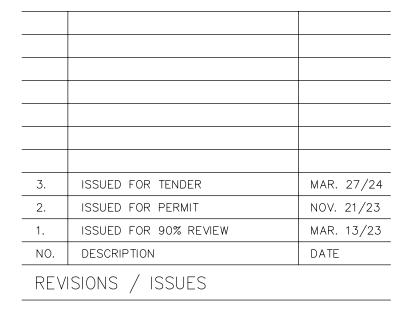GLENFOREST POOL GLENFOREST SECONDARY SCHOOL 2575 FIELDGATE DR., MISSISSAUGA, ON L4X 2J6

POOL DEMOLITION

Drawing Title ROOF KEY PLAN

Graphic Scale

AS SHOWN Drawn RS -----CAD File

-

Checked SS Scale AS NOTED

Project No.

23-124


Sheet no.

M4

Revision No.

Date

DECEMBER 2022

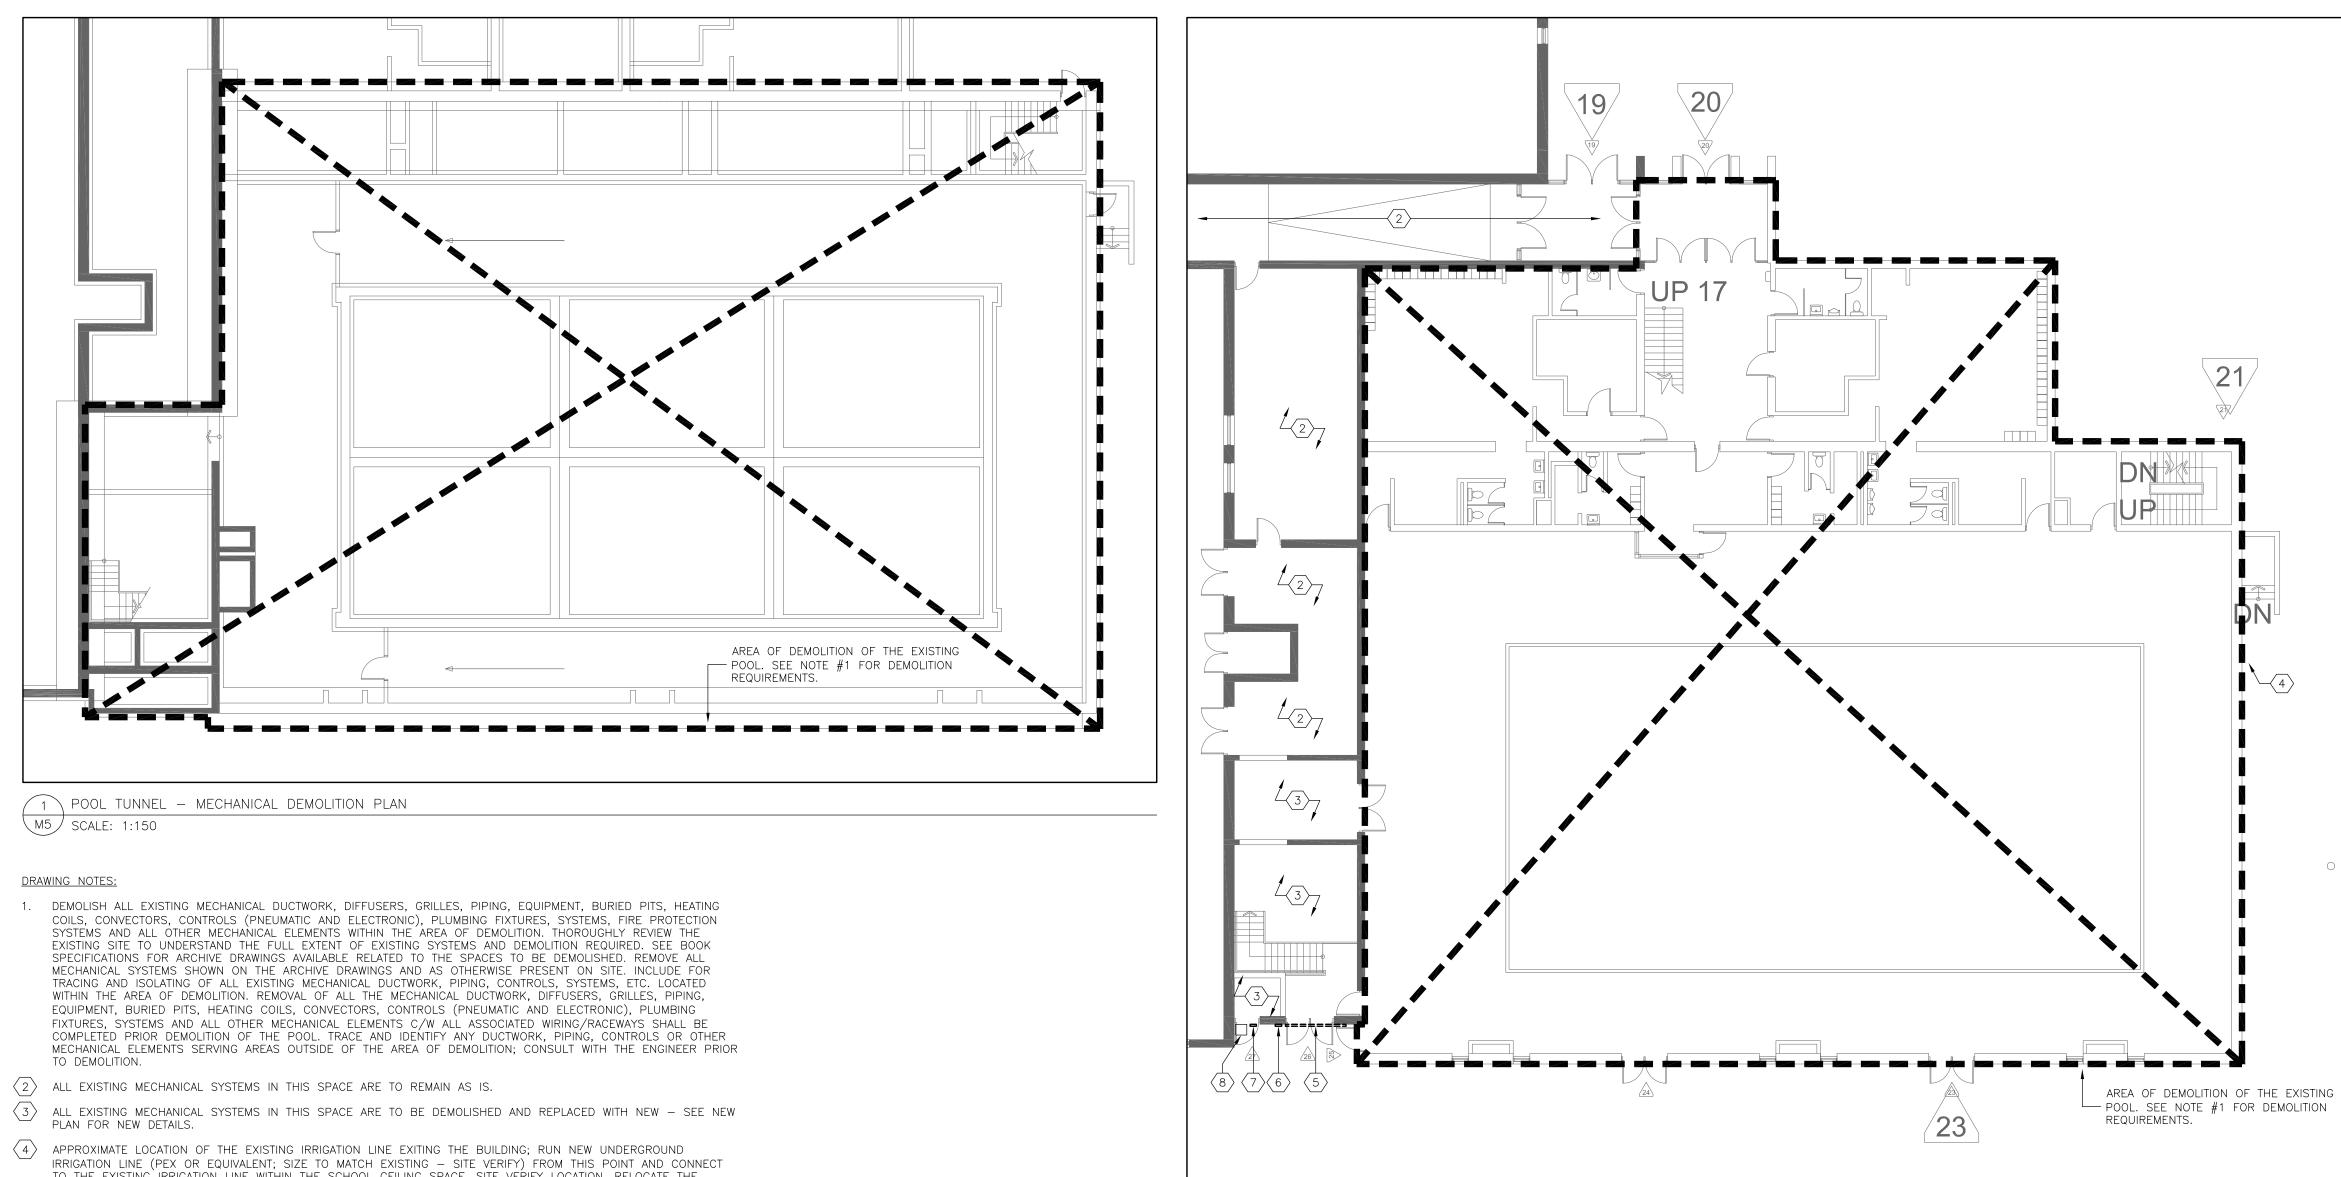

- APPROXIMATE LOCATION OF THE EXISTING IRRIGATION LINE EXITING THE BUILDING; RUN NEW UNDERGROUND IRRIGATION LINE (PEX OR EQUIVALENT; SIZE TO MATCH EXISTING SITE VERIFY) FROM THIS POINT AND CONNECT TO THE EXISTING IRRIGATION LINE WITHIN THE SCHOOL CEILING SPACE. SITE VERIFY LOCATION. RELOCATE THE SPRINKLER CONTROL BOX FROM ITS CURRENT LOCATION TO THE NEW STORAGE ROOM (170A).
- $\langle 5 \rangle$ remove the existing 2400x900 louver see architectural and structural drawings for infill detail.
- 6 REMOVE THE EXISTING 300x300 LOUVERS AT HIGH AND LOW LEVEL SEE ARCHITECTURAL AND STRUCTURAL DRAWINGS FOR INFILL DETAIL.
- 7 REMOVE THE EXISTING 300x300 DUCT THROUGH THE WALL IN ENTIRETY SEE ARCHITECTURAL AND STRUCTURAL DRAWINGS FOR INFILL DETAIL.
- 8 REMOVE THE EXISTING SIDE-WALL EXHAUST FAN IN ENTIRETY C/W ALL DUCTWORK SEE ARCHITECTURAL AND STRUCTURAL DRAWINGS FOR INFILL DETAIL.
- 9. PRIOR TO DEMOLITION, THE CONTRACTOR SHALL DISCONNECT, REMOVE AND HANDOVER THE EXISTING MIXING VALVE SERVING THE CHANGE ROOM SHOWERS LOCATED IN THE POOL OFFICE AREA TO THE PDSB MAINTENANCE DEPARTMENT.

2 FIRST FLOOR – MECHANICAL DEMOLITION PLAN M5 SCALE: 1:150

0

Notes 1. Contractor shall check and verify all dimensions Drawing North True and shall report discrepancies to ETUDE ARCHITECTS INC. prior to construction. North 2. Do not scale this drawing. ETUDE ARCHITECTS INC. accepts no responsibility for measurements scaled from the drawings. All drawings and specifications are the property of ETUDE ARCHITECTS INC., who reserves his copyright with respect to this document. It shall not be duplicated, used or circulated for any other purpose than that for which it was issued, and must be returned on completion of the project to ETUDE ARCHITECTS INC. MECHANICAL & ELECTRICAL CONSULTANT: SURI & ASSOCIATES LTD. ENGINEERING CONSULTANTS 1022 WHITE CLOVER WAY ELECTRICAL

MECHANICAL

COMMUNICATION

LIGHTING

SECURITY

MISSISSAUGA, ONTARIO

T (905)-290-7861

F (289)-327-3420

L5V 1C8

3.	ISSUED FOR TENDER	MAR. 27/24				
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Project Name

GLENFOREST POOL GLENFOREST SECONDARY SCHOOL 2575 FIELDGATE DR., MISSISSAUGA, ON L4X 2J6

POOL DEMOLITION

Drawing Title

DEMOLITION PLANS

Graphic Scale

AS SHOWN Drawn RS CAD File AS NOTED

Sheet no.

M5


Revision No.


Date DECEMBER 2022

Checked SS Scale

Project No.

23-124

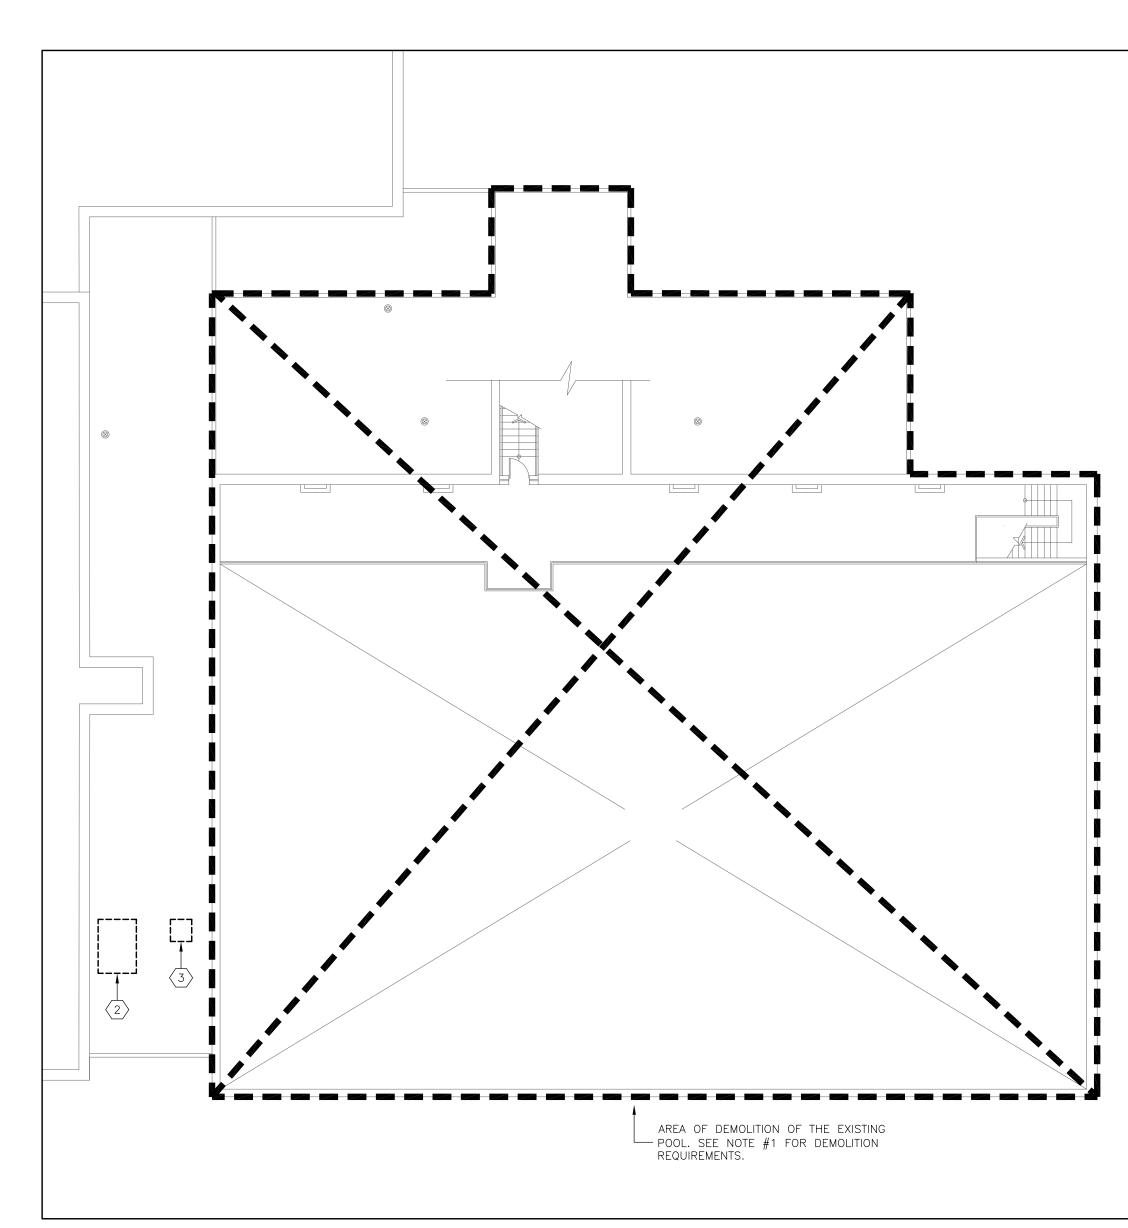

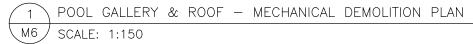

DRAWING NOTES:

1. DEMOLISH ALL EXISTING MECHANICAL DUCTWORK, DIFFUSERS, GRILLES, PIPING, EQUIPMENT, BURIED PITS, HEATING COILS, CONVECTORS, CONTROLS (PNEUMATIC AND ELECTRONIC), PLUMBING FIXTURES, SYSTEMS, FIRE PROTECTION SYSTEMS AND ALL OTHER MECHANICAL ELEMENTS WITHIN THE AREA OF DEMOLITION. THOROUGHLY REVIEW THE EXISTING SITE TO UNDERSTAND THE FULL EXTENT OF EXISTING SYSTEMS AND DEMOLITION REQUIRED. SEE BOOK SPECIFICATIONS FOR ARCHIVE DRAWINGS AVAILABLE RELATED TO THE SPACES TO BE DEMOLISHED. REMOVE ALL MECHANICAL SYSTEMS SHOWN ON THE ARCHIVE DRAWINGS AND AS OTHERWISE PRESENT ON SITE. INCLUDE FOR TRACING AND ISOLATING OF ALL EXISTING MECHANICAL DUCTWORK, PIPING, CONTROLS, SYSTEMS, ETC. LOCATED WITHIN THE AREA OF DEMOLITION. REMOVAL OF ALL THE MECHANICAL DUCTWORK, DIFFUSERS, GRILLES, PIPING, EQUIPMENT, BURIED PITS, HEATING COILS, CONVECTORS, CONTROLS (PNEUMATIC AND ELECTRONIC), PLUMBING FIXTURES, SYSTEMS AND ALL OTHER MECHANICAL ELEMENTS C/W ALL ASSOCIATED WIRING/RACEWAYS SHALL BE COMPLETED PRIOR DEMOLITION OF THE POOL. TRACE AND IDENTIFY ANY DUCTWORK, PIPING, CONTROLS OR OTHER MECHANICAL ELEMENTS SERVING AREAS OUTSIDE OF THE AREA OF DEMOLITION; CONSULT WITH THE ENGINEER PRIOR TO DEMOLITION.

 $\langle 2 \rangle$ REMOVE THE EXISTING 750W x 1500L x 750H FRESH AIR INTAKE PENTHOUSE. SEE ARCHITECTURAL AND STRUCTURAL DRAWINGS FOR INFILL AND ROOF REPAIR DETAIL. REMOVE ALL ASSOCIATED DUCTWORK.

 $\langle 3 \rangle$ REMOVE THE EXISTING 450x300 EXHAUST GOOSENECK IN ENTIRETY C/W ALL DUCTWORK.

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Project Name
GLENFOREST POOL

GLENFOREST SECONDARY SCHOOL 2575 FIELDGATE DR., MISSISSAUGA, ON L4X 2J6

POOL DEMOLITION

Drawing Title

DEMOLITION PLANS

Graphic Scale

AS SHOWN Drawn RS CAD File

_____ Date

DECEMBER 2022

Checked SS Scale AS NOTED


Project No.

23-124

Sheet no.

M6

Revision No.

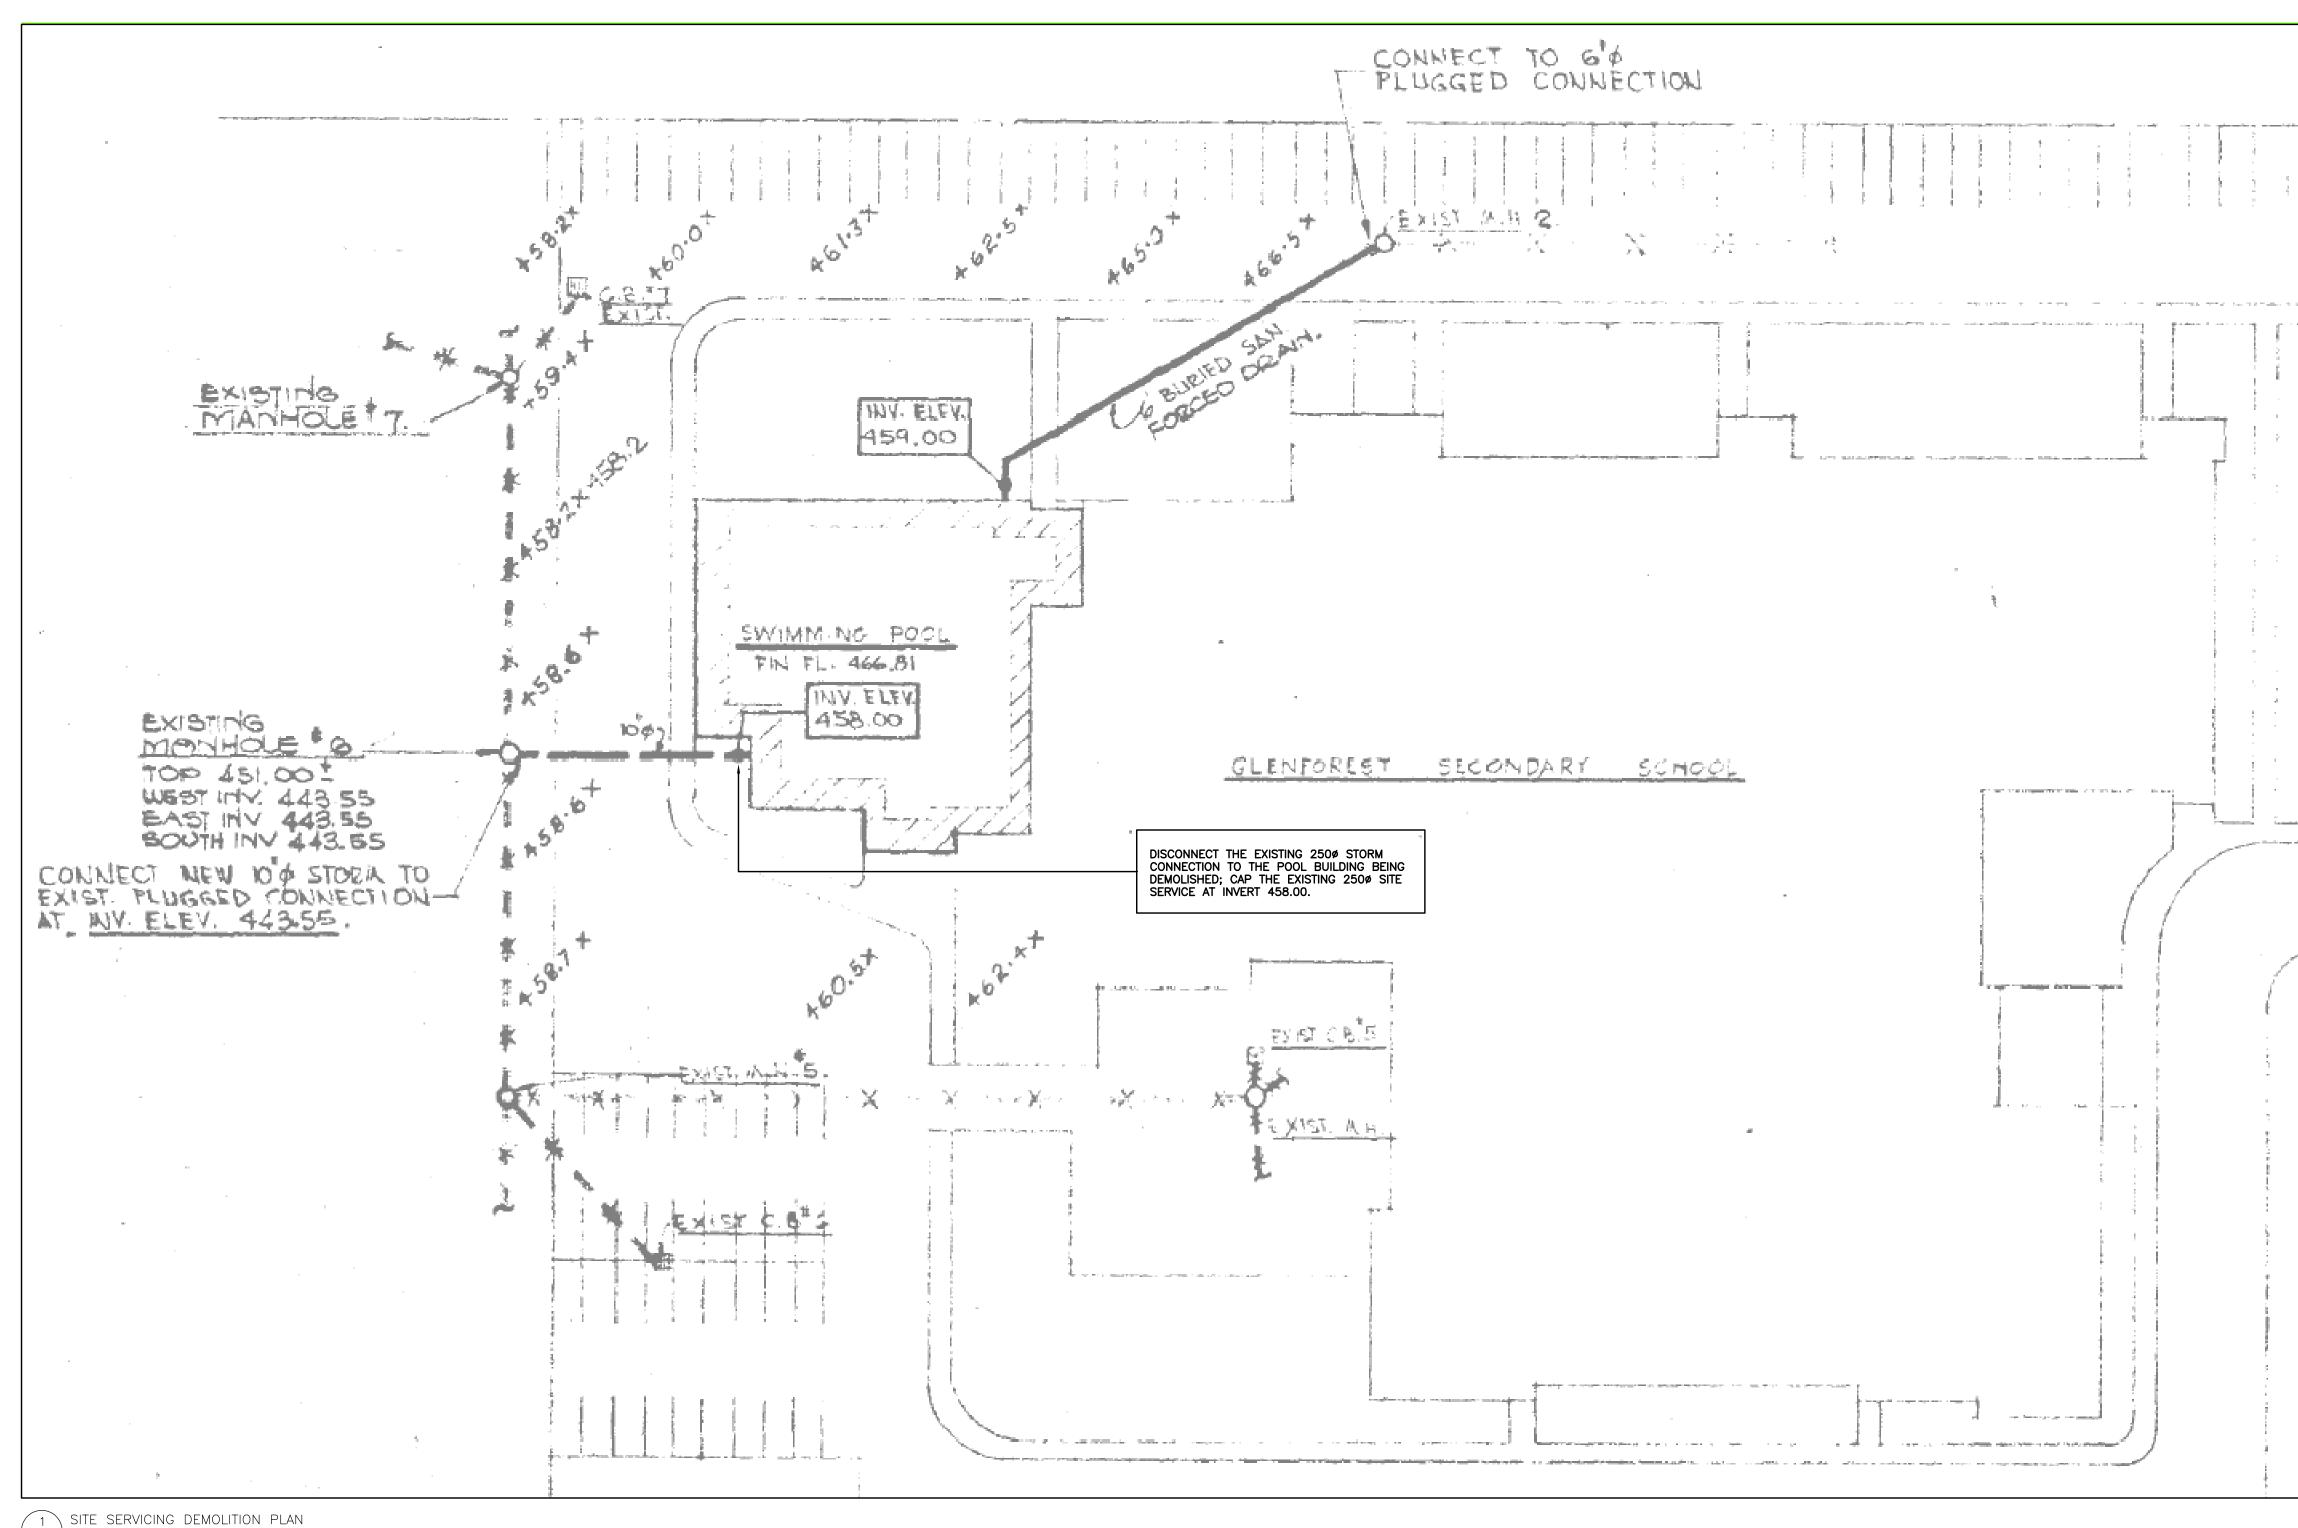

M7 SCALE: 1:400

THE DRAWING DEPICTED ON THIS DRAWING IS FROM THE ARCHIVE INFORMATION AVAILABLE FROM A DRAWING BY HANKS, IRWIN & PERSON ARCHITECT DATED AUGUST 1968 AND IS MEANT TO ILLUSTRATE THE AVAILABLE INFORMATION FOR THE SITE SERVICING FOR THIS BUILDING AND THE INTENDED DEMOLITION SCOPE OF WORK.

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COMMUNICATION SECURITY

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REV	REVISIONS / ISSUES					



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Project Name

GLENFOREST POOL GLENFOREST SECONDARY SCHOOL 2575 FIELDGATE DR., MISSISSAUGA, ON L4X 2J6

POOL DEMOLITION

Drawing Title

SITE SERVICING DEMOLITION PLAN

Graphic Scale AS SHOWN

_____ Drawn RS _____ CAD File

-_____

Scale AS NOTED

Revision No.

DECEMBER 2022

Date


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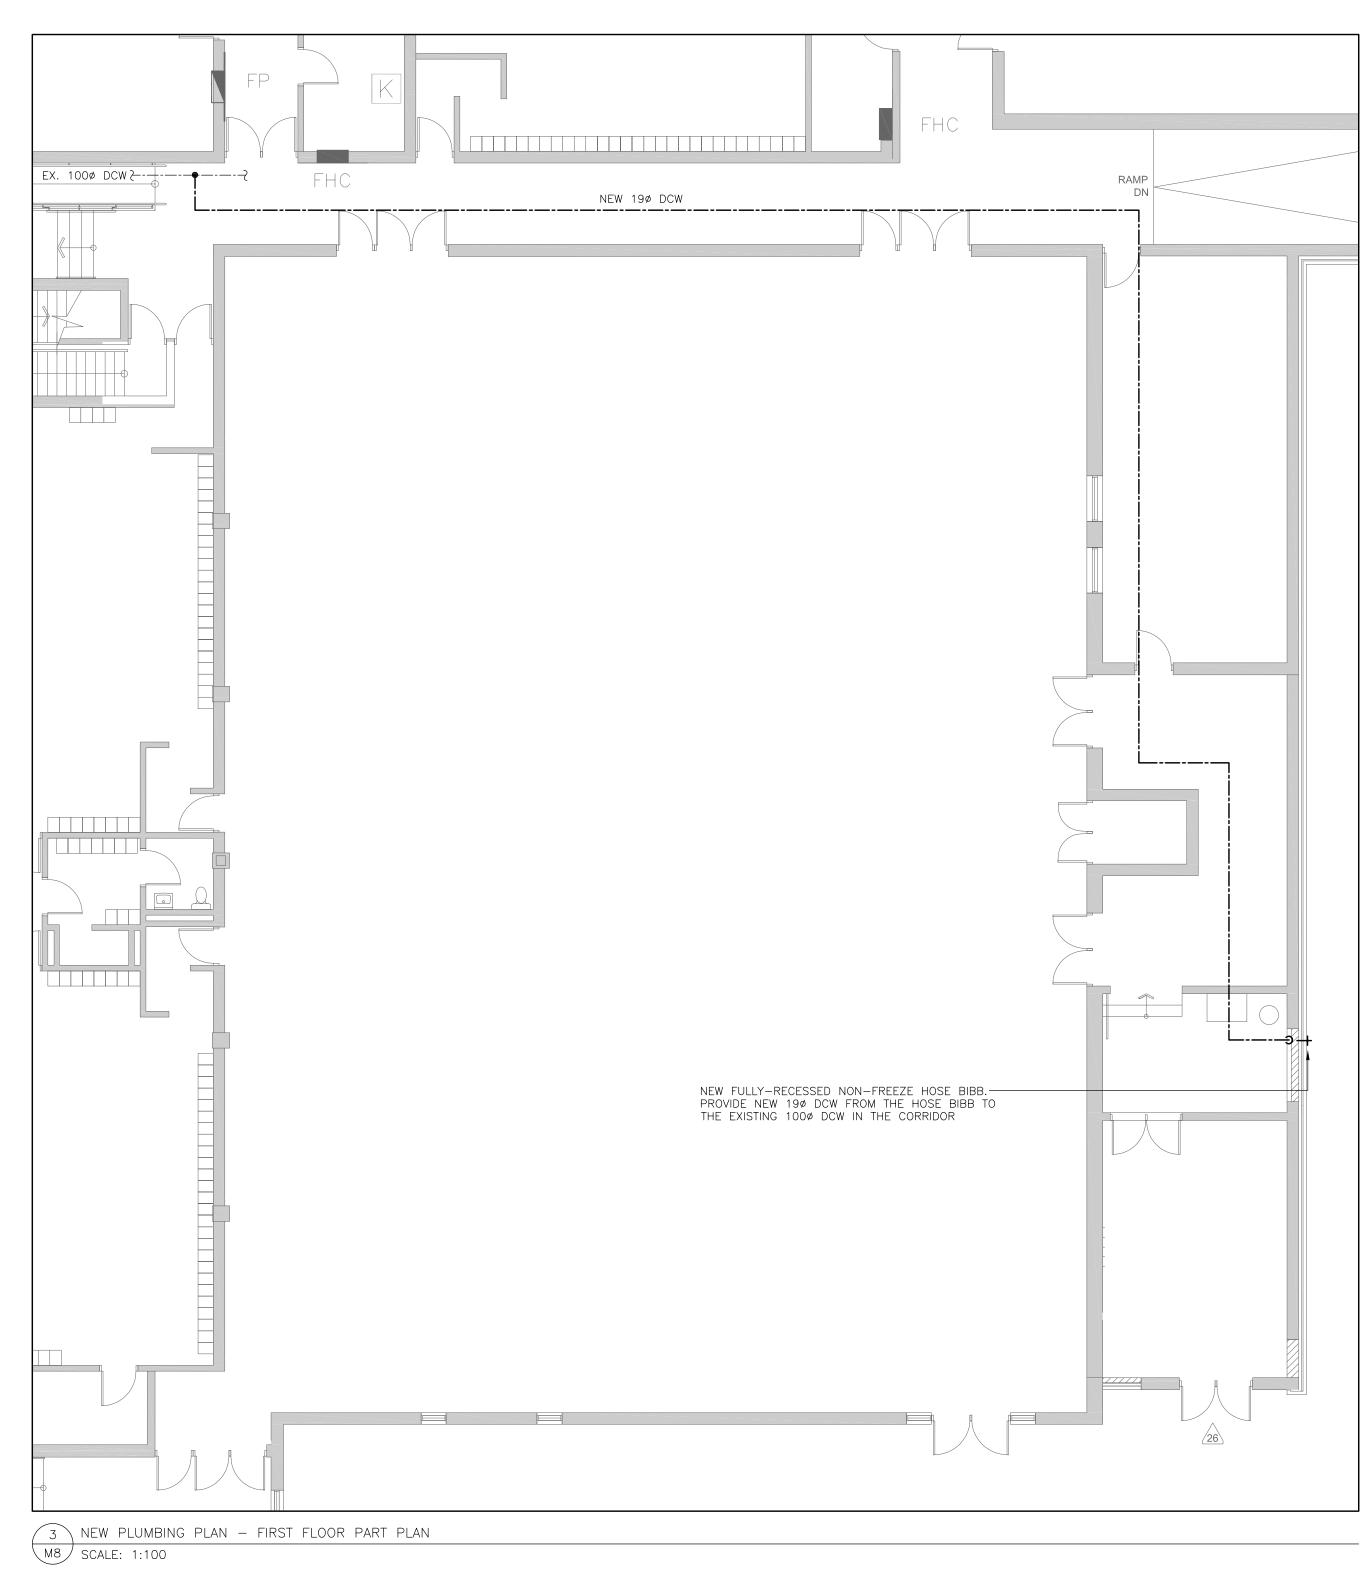
23-124


M7


Sheet no.



- DRAWING NOTES:
- 1 PROVIDE A NEW SURFACE-MOUNTED FORCED FLOW HEATER AS SCHEDULED. PROVIDE HWS&R PIPING TO THE HEATER. INSULATE ALL PIPING. WHITE PVC WRAP ALL EXPOSED PIPING. COORDINATE WITH DIVISION 16 FOR POWER CONNECTION TO THE NEW HEATER. PROVIDE A NEW BAS TEMPERATURE SENSOR FOR THE NEW HEATER; NEW HEATER SHALL BE CONTROLLED BY THE BAS. RETAIN THE SCHOOL'S BAS CONTROLS CONTRACTOR FOR ALL CONTROLS-RELATED WORK.
- 2 PROVIDE A NEW HYDRONIC CONVECTOR HEATER AS SCHEDULED. PROVIDE HWS&R PIPING TO THE HEATER. INSULATE ALL PIPING. WHITE PVC WRAP ALL EXPOSED PIPING. COORDINATE WITH DIVISION 16 FOR POWER CONNECTION TO THE NEW HEATER. PROVIDE A NEW BAS TEMPERATURE SENSOR FOR THE NEW HEATER; NEW HEATER SHALL BE CONTROLLED BY THE BAS. RETAIN THE SCHOOL'S BAS CONTROLS CONTRACTOR FOR ALL CONTROLS-RELATED WORK.
- 3 CONNECT THE NEW 320 HWS&R PIPING TO THE EXISTING 500 HWS&R PIPING IN THE CORRIDOR CEILING SPACE. PROVIDE PIPE FREEZING AS A MEANS TO ISOLATE THE PIPING TO FACILITATE THE NEW TIE-INS. PROVIDE A NEW ISOLATION VALVE ON THE NEW HWS&R PIPING AS SHOWN.
- 4 PROVIDE A NEW CEILING-MOUNTED EXHAUST FAN EF-1 AS SHOWN COMPLETE WITH 200Ø DUCTWORK TO THE EXTERIOR LOUVER AS SHOWN. EXTERNALLY INSULATE THE FULL LENGTH OF THE NEW EXHAUST DUCTWORK.
- 5 provide a new ceiling-mounted exhaust fan ef-2 as shown complete with 2250ø ductwork to the exterior louver as shown. Externally insulate the full length of the new exhaust ductwork.
- $\langle 6 \rangle$ EXISTING 1000 ROOF DRAIN IS TO REMAIN AS IS.
- $\langle 7 \rangle$ EXISTING 1000 STORM PIPING IN THE CEILING IS TO REMAIN AS IS.
- $\langle 8 \rangle$ existing 1000 storm piping dn. to underground is to remain as is.
- $\left<9\right>$ provide a new 1000 conventional roof drain. Provide new 1000 storm piping routed as shown and connect to the existing 1000 storm piping in the ceiling space.

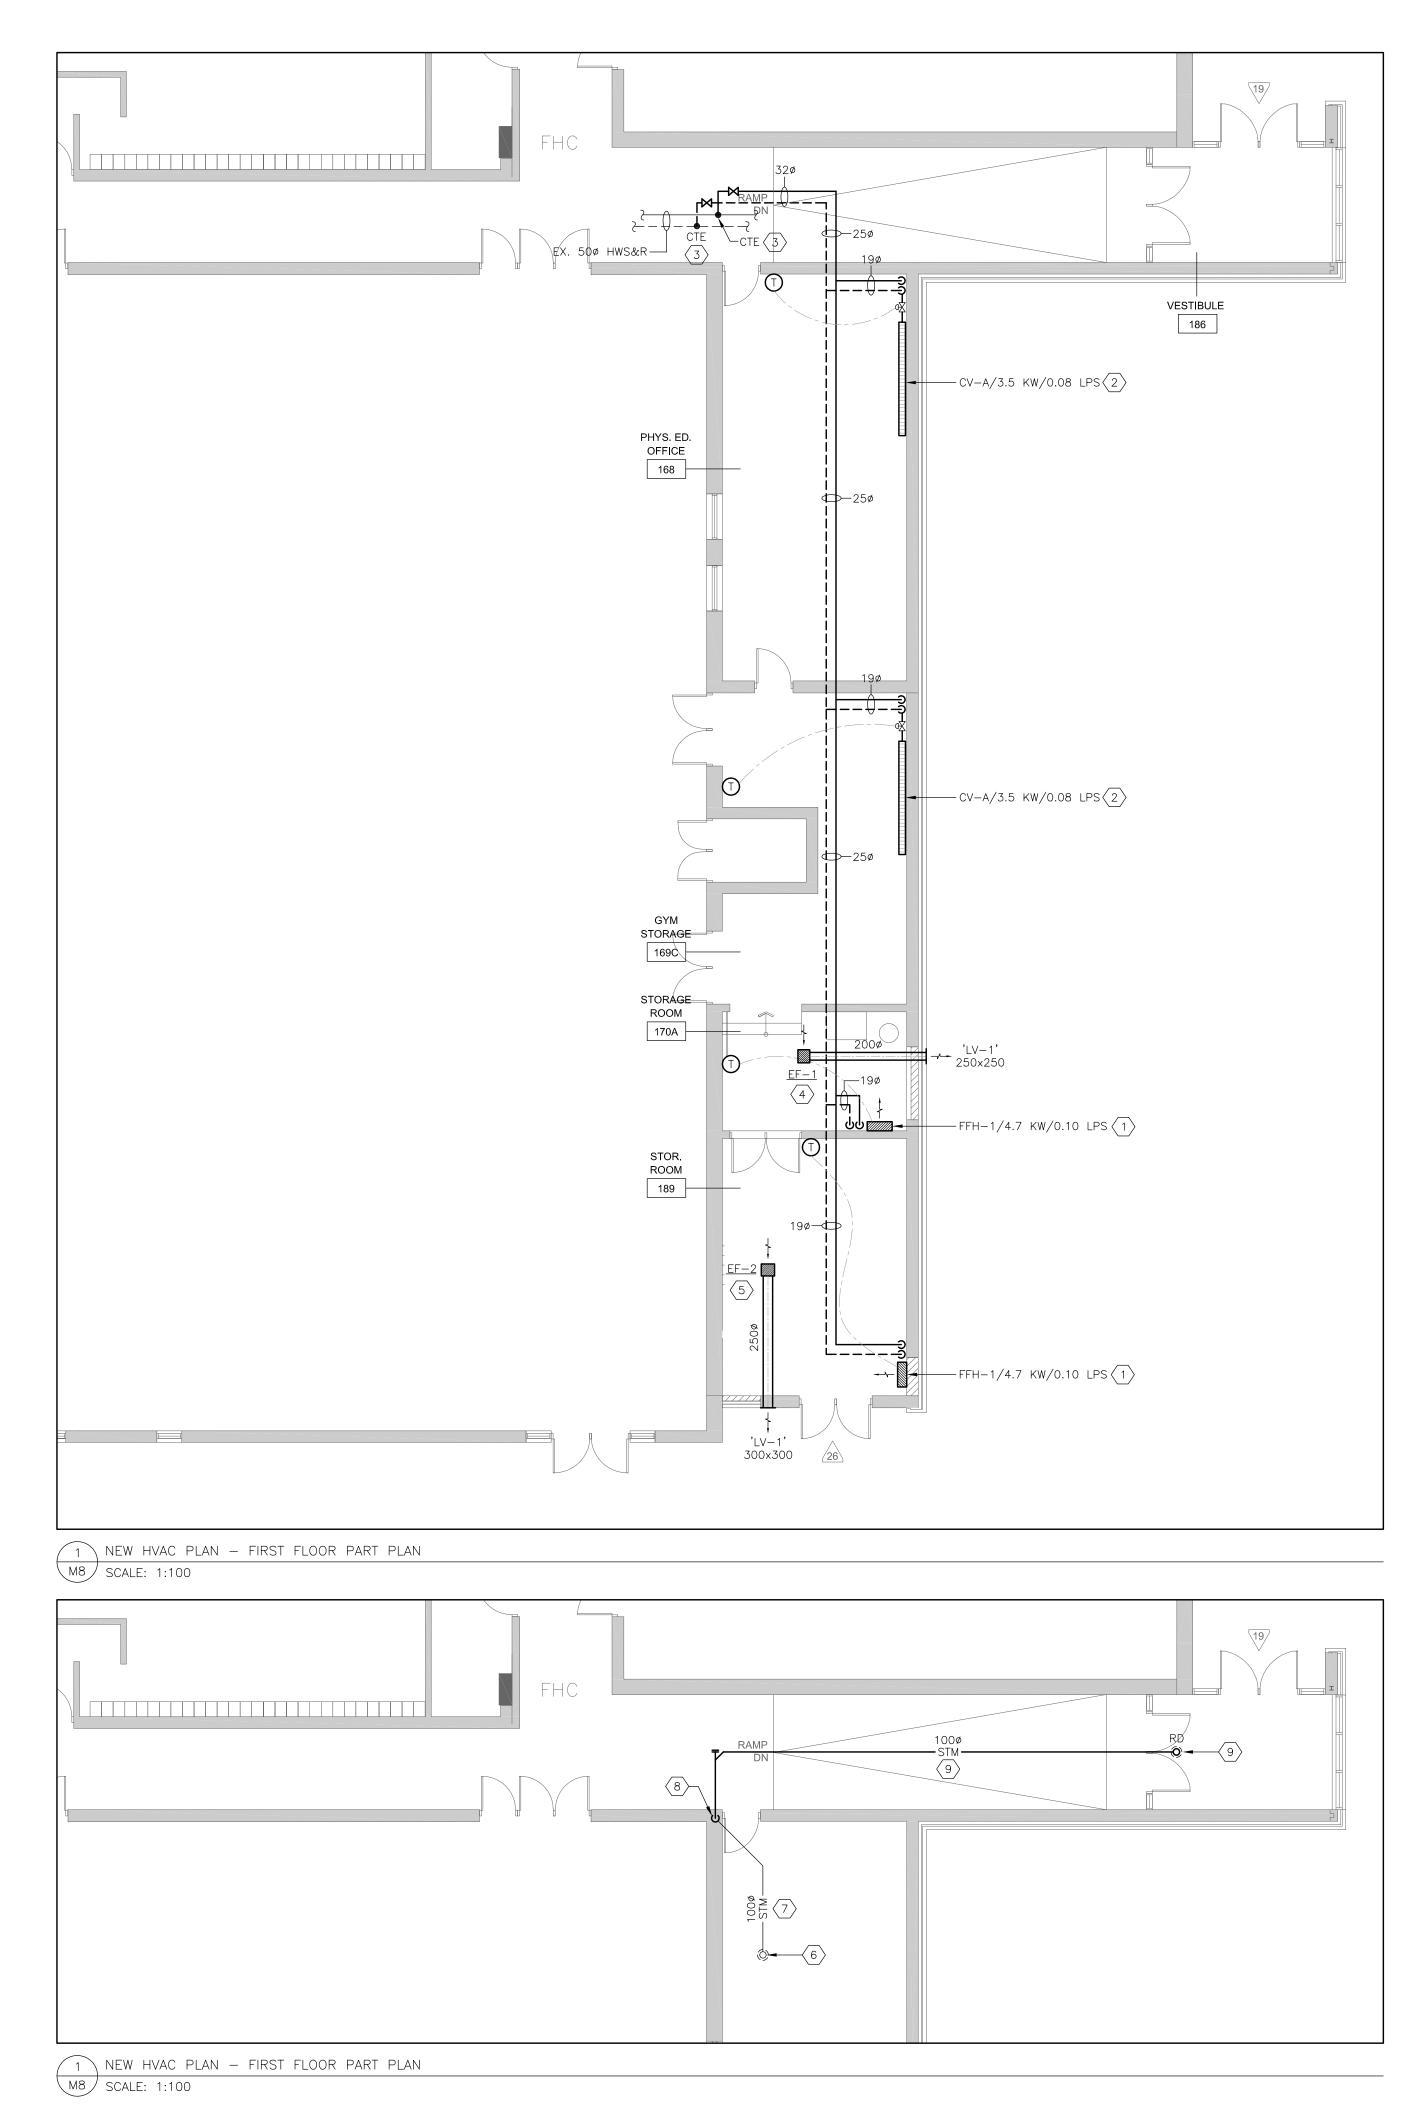

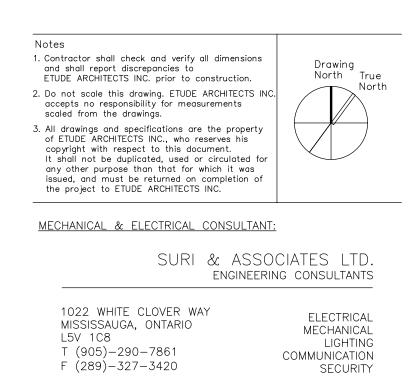

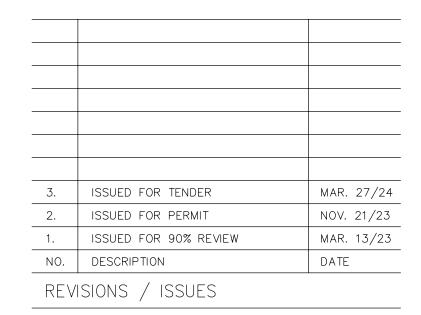



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Project Name **GLENFOREST POOL** GLENFOREST SECONDARY SCHOOL 2575 FIELDGATE DR., MISSISSAUGA, ON L4X 2J6

POOL DEMOLITION

Drawing Title

NEW WORK PLANS

Graphic Scale

AS SHOWN Drawn RS

-

Checked SS Scale AS NOTED

Project No.

23-124


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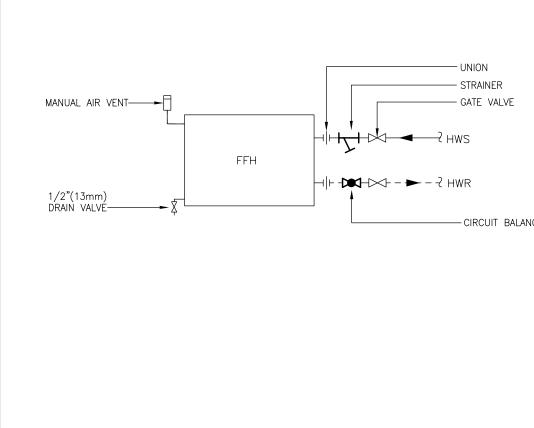
M8

Revision No.

Date DECEMBER 2022

CAD File



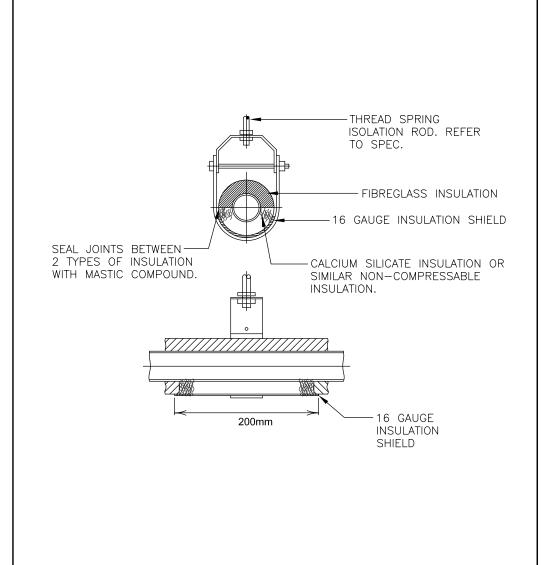

1 PIPE SUPPORT & HANGER DETAIL M9 SCALE: N.T.S.

2 FORCED FLOW HEATER PIPING DETAIL M9/ SCALE: N.T.S.

	FORCED FLOW HEATER SCHEDULE										
EQUIPMENT DESIGNATION	MANUFACTURER	MODEL	UNIT CONFIG.	UNIT SIZE (mm)	UNIT WEIGHT (KG)	HEATING CAPACITY (KW)	HEATING FLOW (L/S)	WPD (kPa)	AIRFLOW (L/S)	MOUNTING	I N
FFH-1	ENGINEERED AIR	CUH-1	4	660x711x241	34	4.7	0.10	6.35	87	WALL; SURFACE MOUNTED	
FFH-2	ENGINEERED AIR	CUH-4	4	965x711x241	50	8.9	0.19	4.30	175	WALL; SURFACE MOUNTED	

NOTES: 1. HEATERS SHALL BE CONTROLLED BY A WALL-MOUNTED THERMOSTAT (BY CONTROLS CONTRACTOR). BAS WILL ENABLE/DISABLE FAN AS REQUIRED. NO MODULATION OF WATER FI 2. COLOR/FINISH: COMPUTER WHITE (FINAL COLOUR SELECTION MAY CHANGE AT THE SHOP DRAWING STAGE BY THE ARCHITECT; ALTERNATE SELECTION WILL BE FROM THE ENGINE

					FAN SCHE	EDULE				
EQUIPMENT DESIGNATION	MANUFACTURER	MODEL NO.	SERVICE	FAN TYPE	AIRFLOW (L/S)	ESP (Pa)	UNIT SIZE (WxLxH) mm	UNIT WEIGHT (KG)	MOTOR RPM	SON
EF-1	GREENHECK	SP-A200	STORAGE ROOM (170A)	IN-CEILING; DIRECT DRIVE	94	62	356x302x286	11.0	900	3.0
EF-2	GREENHECK	SP-A250	STORAGE ROOM (189)	IN-CEILING; DIRECT DRIVE	141	62	356x302x286	11.0	900	3.0
2. EXHAUS	ST FAN SHALL COME	C/W VIBRATION ISC	NS C/W PERFORMANCE DAD DIATION KIT FROM THE MAN LL BE OF FLEXIBLE TYPE.	TA, FAN CURVES AND	OTHER DETAIL	.s as per	SHOP DRAWING SU	IBMITTAL REQUIR	EMENTS.	<u> </u>

r									
DIFFUSER, GRILLES AND LOUVER SCHEDULE									
DESIGNATION	MANUFACTURER	MODEL NO.	TYPE	SIZE	NECK SIZE	COLOUR/FINISH	FIRE RATED	VOLUME CONTROL	
'LV-1'	EH PRICE	DE439	EXTERIOR LOUVER	AS PER DRAWING	_	BRONZE	NO	_	SEE NO

NOTES: NOTES: 1. SUBMIT SHOP DRAWINGS FOR ALL DIFFUSERS, GRILLES AND LOUVERS PRIOR TO ORDERING. 2. PROVIDE A PHYSICAL COLOUR CHIP TO THE ARCHITECT DURING SHOP DRAWING SUBMISSION FOR APPROVAL PRIOR TO ORDERING. 3. LOUVER SHALL BE COMPLETE WITH ALUMINUM BIRDSCREEN.

										_
	WALL-FIN HYDRONIC CONVECTOR SCHEDULE									
EQUIPMENT DESIGNATION	MANUFACTURER	MODEL	HWS TEMP.	HWR TEMP.	HEAT OUTPUT	MOUNTING HEIGHT	ROW QTY	ENCLOSURE HEIGHT	FINISH	
CV-A	ENGINEERED AIR	WF-5A	82.2 DEGS. C	71.1 DEGS. C	1.42 kW/m	SEE BELOW	2 ROW (127mm CENTERS)	457mm	COMPUTER WHITE	
2. PROVIDE 3. COLOR/F	ALL NECESSARY ACT INISH: COMPUTER W	CESSORIES, INC 'HITE (FINAL CO	CLÚDING END CAP DLOUR SELECTION	S, CORNER PIECE MAY CHANGE AT	ES, ETC. AS RE THE SHOP DR	QUIRED. AWING STAGE B		ERNATE SELECTION WI	HE CONVECTOR) FOR AC	

	P.) DK (TYP.) RIC REDUCER (TYP.)	AI-SPACE TEMPERATURE HWS
3 HOT WATER PERIMETER M9 SCALE: N.T.S.	CONVECTOR PIPING DETAIL - SINGLE	- AI-SPACE TEMPERATURE
MOTOR HP OTOR RPMCONTROLLED BYVOLTAGE MOCP (A)1/25 1050 RPMBAS120V/10/60 15A1/20 1075 RPMBAS120V/10/60 15AFLOW REQUIRED. IEERED AIR STANDARD COLOUR PALETTE).		SEQUENCE OF OPERATION DURING THE HEATING SEASON AND WHEN HEATING PLANT IS ACTIVATE THE INDOOR SPACE SETPOINTS. THE OCCUPIED/UNOCCUPIED SETPOIN STANDARD. ALARMS: AN ALARM SHALL BE GENERATED VIA THE BAS IN THE FOLLOWING CO • SPACE TEMPERATURE IS 2°C BELOW THE SETPOINT. • SPACE TEMPERATURE IS 2°C ABOVE THE SETPOINT. GRAPHIC: THE FOLLOWING SHALL BE ILLUSTRATED ON THE BAS WORKSTATION G
NE CONTROLLED BY VOLTAGE MOCP 0 LOCAL SWITCH 120V/10/60 15A 0 LOCAL SWITCH 120V/10/60 15A		SPACE TEMPERATURE. THE DEFAULT POSITION (FAIL SITUATION) OF THE 2-WAY CONTROL VA
		5 PERIMETER CONVECTOR CONTROL SCHEMATIC M9 SCALE: N.T.S.

NOTES NOTES 1, 2, 3 BELOW

	CONTROLLED BY	NOTES							
	BAS	SEE NOTES BELOW							
CCESS TO ALL CONTROLS, VALVES, ETC.									
IEERED AIR STANDARD COLOUR PALETTE).									

}-	 	 	 	

ED, THE FORCED FLOW HEATER FAN SHALL BE ENABLED OW THE SETPOINT. THE FAN SHALL BE DISABLED ONCE THE /UNOCCUPIED SETPOINTS SHALL BE SET IN ACCORDANCE WITH IRED TO THE FORCED FLOW HEATER.

ONDITIONS/CIRCUMSTANCES:

GRAPHIC:

OINTS DO TOTAL .3

AO-HEATING VALVE MODULATION

AI-HEATING VALVE FEEDBACK

PERIMETER CONVECTOR

FED, THE 2-WAY CONTROL VALVE SHALL MODULATE TO MAINTAIN NTS SHALL BE SET IN ACCORDANCE WITH THE CURRENT PDSB

ONDITIONS/CIRCUMSTANCES:

GRAPHIC:

ALVE SHALL BE FULLY OPEN.

POINTS DO TOTAL .3

Notes Contractor shall check and verify all dimensions and shall report discrepancies to ETUDE ARCHITECTS INC. prior to construction. Drawing North True North Do not scale this drawing. ETUDE ARCHITECTS INC. accepts no responsibility for measurements scaled from the drawings. 3. All drawings and specifications are the property of ETUDE ARCHITECTS INC., who reserves his copyright with respect to this document. It shall not be duplicated, used or circulated for any other purpose than that for which it was issued, and must be returned on completion of the project to ETUDE ARCHITECTS INC. MECHANICAL & ELECTRICAL CONSULTANT: SURI & ASSOCIATES LTD. ENGINEERING CONSULTANTS

1022 WHITE CLOVER WAY	ELECTRICAL
MISSISSAUGA, ONTARIO	MECHANICAL
L5V 1C8	LIGHTING
T (905)-290-7861	COMMUNICATION
F (289)-327-3420	SECURITY

3.	ISSUED FOR TENDER	MAR. 27/24
2.	ISSUED FOR PERMIT	NOV. 21/23
1.	ISSUED FOR 90% REVIEW	MAR. 13/23
NO.	DESCRIPTION	DATE
REVI	ISIONS / ISSUES	



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Project Name

GLENFOREST POOL GLENFOREST SECONDARY SCHOOL 2575 FIELDGATE DR., MISSISSAUGA, ON L4X 2J6

POOL DEMOLITION

Drawing Title

SCHEDULES & SCHEMATICS

Graphic Scale AS SHOWN

Drawn RS

-

Checked SS

M9

Sheet no.

Revision No.

_____ Date DECEMBER 2022

CAD File 23-124

Scale AS NOTED Project No.

	LIGHTING LEGEND
A1	STANDARD TYPE 'A1' LIGHT FIXTURE AS SCHEDULED
A1//	TYPE 'A1' LIGHT FIXTURE AS SCHEDULED, CONNECTED TO THE EMERGENCY POWER SOURCE (INVERTER OR GENERATOR)
B1	WALL-MOUNTED TYPE 'B1' LIGHT FIXTURE AS SCHEDULED
\$	LOW-VOLTAGE, TOGGLE LIGHT SWITCH, AS SPECIFIED.
\$D	LOW-VOLTAGE, TOGGLE & DIMMER LIGHT SWITCH, AS SPECIFIED.
\$к	LOW-VOLTAGE, KEY-SWITCH TYPE LIGHT SWITCH, AS SPECIFIED.
\$MS	LOW-VOLTAGE, KEY-SWITCH TYPE, MASTER LIGHT SWITCH, AS SPECIFIED. CONTROLS ALL CORRIDOR, WASHROOM AND VESTIBULE LIGHTING
\$os	LOW-VOLTAGE LIGHT SWITCH COMPLETE WITH INTEGRAL OCCUPANCY SENSOR, AS SPECIFIED.
OS	CORNER/WALL-MOUNTED, LOW-VOLTAGE OCCUPANCY SENSOR, AS SCHEDULED
OS	CEILING-MOUNTED, LOW-VOLTAGE OCCUPANCY SENSOR, AS SCHEDULED
ОН	EXTERIOR-GRADE, WALL-MOUNTED LIGHT FIXTURE
o	EXTERIOR-GRADE, LIGHT STANDARD COMPLETE WITH CONCRETE BASE
	EMERGENCY LIGHTING BATTERY UNIT C/W NO REMOTE HEADS
	EMERGENCY LIGHTING BATTERY UNIT C/W DUAL-HEAD REMOTE HEADS
Q_0	EMERGENCY LIGHTING DUAL-HEAD REMOTE HEAD
$\overset{+}{\blacktriangleright}$	EMERGENCY LIGHTING, WALL-MOUNTED EXIT SIGN
	EMERGENCY LIGHTING, CEILING-MOUNTED EXIT SIGN

	SYSTEMS DEVICE & FOUNDMENT LECEND		SECURITY SYSTEM LEGEND
	SYSTEMS DEVICE & EQUIPMENT LEGEND		SECURITY SYSTEM LEGEND
	MODULAR CONTROL PANEL, SUPPLIED BY THE ARCHITECTURAL DIVISION		MOTION DETECTOR EMPTY CONDUIT & BACKBOX ROUGH-IN
•	DOOR OPERATOR ACTUATOR BUTTON	DC	MAGNETIC DOOR CONTACT EMPTY CONDUIT & BACKBOX ROUGH-IN
KS	KEY SWITCH, TIED TO THE DOOR OPERATOR SYSTEM	KP	KEYPAD EMPTY CONDUIT & BACKBOX ROUGH-IN
HD	HAND DRYER, SUPPLIED AND INSTALLED BY DIVISION 26	ES	ELECTRIC STRIKE
PL	PUSH-TO-LOCK BUTTON TIED TO THE WASHROOM DOOR OPERATOR SYSTEM		
ES	ELECTRIC STRIKE		CLOCK SYSTEM LEGEND
НО	HOLD OPEN DEVICE	<u> </u>	ANALOG CLOCK EMPTY CONDUIT & BACKBOX ROUGH-IN
(OH	'OCCUPIED-WHEN-LIT' LED ANNUNCIATOR TIED TO THE WASHROOM DOOR OPERATOR SYSTEM	← ᠿ→	BI-DIRECTION ANALOG CLOCK, EMPTY CONDUIT & BACKBOX ROUGH-IN
EH	VISUAL INDICATOR TIED TO THE CALL-FOR-ASSISTANCE SYSTEM	∲мс	ANALOG CLOCK TIED TO THE MASTER CLOCK SYSTEM - WALL-MOUNTED
E	EMERGENCY PUSH-BUTTON TIED TO THE CALL-FOR-ASSISTANCE SYSTEM	← () → MC	DUAL-FACE ANALOG CLOCK TIED TO THE MASTER CLOCK SYSTEM - WALL-MOUNTED
) E	AUDIBLE/VISUAL INDICATOR TIED TO THE CALL-FOR-ASSISTANCE SYSTEM	₿0	ANALOG CLOCK, BATTERY OPERATED - WALL-MOUNTED
		← (→)→B0	DUAL-FACE ANALOG CLOCK, BATTERY OPERATED - WALL-MOUNTED
	FIRE ALARM SYSTEM LEGEND	MC	MASTER CLOCK SYSTEM CONTROLLER
	RATE-OF-RISE HEAT DETECTOR		
	FIXED TEMPERATURE HEAT DETECTOR		AUDIO/VISUAL SYSTEM LEGEND
•	SMOKE DETECTOR	AV	EMPTY BACKBOX COMPLETE WITH BLANK COVERPLATE AND 25mmC UP TO THE ACCESSIBLE CEILING SPACE PROVISION FOR FUTURE AV CABLING
	PULL STATION C/W TAMPERPROOF, POLYCARBONATE COVER		
	FIRE ALARM SPEAKER		PUBLIC ADDRESS (P.A.) SYSTEM LEGEND
	FIRE ALARM SPEAKER/STROBE	S	P.A. SPEAKER – FLUSH CEILING–MOUNTED EMPTY CONDUIT & BACKBOX ROUGH–IN
	DUCT SMOKE DETECTOR	SH	P.A. SPEAKER – WALL–MOUNTED EMPTY CONDUIT & BACKBOX ROUGH–IN
TL	REMOTE TROUBLE INDICATOR		P.A. SPEAKER, DUAL-FACE TYPE - WALL-MOUNTED
FS	SPRINKLER/STANDPIPE FLOW SWITCH		EMPTY CONDUIT & BACKBOX ROUGH-IN
	SPRINKLER/STANDPIPE SUPERVISED VALVE	DSH	P.A. EXTERIOR HORN – WALL–MOUNTED EMPTY CONDUIT & BACKBOX ROUGH–IN
	FIRE ALARM ANNUNCIATOR		WEATHERPROOF PROGRAM BELL C/W ENCLOSURE
	FIRE ALARM CONTROL PANEL	HSH	P.A. HANDSET – WALL–MOUNTED EMPTY CONDUIT & BACKBOX ROUGH–IN
		HS	P.A. HANDSET – DESK-MOUNTED EMPTY CONDUIT & BACKBOX ROUGH-IN
	ACCESS CONTROL SYSTEM LEGEND	\$PC	P.A. PRIVACY CALL SWITCH EMPTY CONDUIT & BACKBOX ROUGH-IN
CR	CARD READER	, \$нs	P.A. HANDSET C/W INTEGRAL PRIVACY CALL SWITCH EMPTY CONDUIT & BACKBOX ROUGH-IN
ES	ELECTRIC STRIKE	ACC	P.A. ADMINISTRATIVE HANDSET
MS	AIPHONE MASTER STATION	NR	EMPTY CONDUIT & BACKBOX ROUGH-IN P.A. NIGHT RINGER
SMS	AIPHONE SUB-MASTER STATION		EMPTY CONDUIT & BACKBOX ROUGH-IN P.A. LOCKDOWN 'AMBER' STROBE
	AIPHONE DOOR STATION		EMPTY CONDUIT & BACKBOX ROUGH-IN P.A. INCOMING CALL 'BLUE' STROBE
	LOCAL DOOR CONTACT SUPPLIED AND INSTALLED BY DIVISION 16; TIED TO		EMPTY CONDUIT & BACKBOX ROUGH-IN P.A. WALL-MOUNTED VOLUME CONTROL SWITCH
	THE LOCAL DOOR ALARM SYSTEM AUDIBLE/VISUAL ANNUNCIATOR TIED TO THE LOCAL DOOR ALARM SYSTEM		EMPTY CONDUIT & BACKBOX ROUGH-IN P.A. RED LOCKDOWN BUTTON C/W POLYCARBONATE LIFT-ABLE COVER
	,		EMPTY CONDUIT & BACKBOX RÓUGH–IN P.A. SPEAKER C/W INTEGRATED CALL SWITCH EMPTY CONDUIT & BACKBOX ROUGH–IN
		Ţ Ţ Ţ	P.A. COMBINATION SPEAKER AND CLOCK UNIT – WALL-MOUNTED EMPTY CONDUIT & BACKBOX ROUGH-IN
		PA	P.A. HEAD-END EQUIPMENT RACK
		SR	P.A. SATELLITE EQUIPMENT RACK

	POWER DEVICES & EQUIPMENT LEGEND
Φ	SINGLE RECEPTACLE MOUNTED AT STANDARD HEIGHT; USE AND RATING FOR THE PURPOSE INTENDED
Ø	SINGLE RECEPTACLE MOUNTED AT HIGH LEVEL; USE AND RATING FOR THE PURPOSE INTENDED
Ф	15A, 120V DUPLEX RECEPTACLE MOUNTED AT STANDARD HEIGHT. 'T' DENOTES 20A, T–SLOT TYPE RECEPTACLE
Ø	15A, 120V DUPLEX RECEPTACLE MOUNTED AT HIGH LEVEL. 'T' DENOTES 20A, T–SLOT TYPE RECEPTACLE
Ø	15A, 120V, GFI DUPLEX RECEPTACLE MOUNTED AT HIGH LEVEL. 'T' DENOTES 20A, T–SLOT TYPE RECEPTACLE
۲	DIRECT POWER CONNECTION
	UNFUSED DISCONNECT SWITCH
\square	FUSED DISCONNECT SWITCH
	DIRECT POWER CONNECTION COMPLETE UNFUSED DISCONNECT SWITCH
	BLANK COVERPLATE COMPLETE WITH WIRING, CONDUIT, AND BACKBOX
U	ROUND JUNCTION BOX COMPLETE WITH COVERPLATE
J	SQUARE JUNCTION BOX COMPLETE WITH COVERPLATE
SC	FAN SPEED CONTROLLER
	RECESSED ELECTRICAL PANEL, AS SCHEDULED
	SURFACE-MOUNTED ELECTRICAL PANEL, AS SCHEDULED
CC-1	DEVICE/EQUIPMENT CONNECTED TO CIRCUIT #1 IN PANEL 'CC'

	SYSTEMS DEVICE & EQUIPMENT LEGEND		SECURITY SYSTEM LEGEND
	MODULAR CONTROL PANEL, SUPPLIED BY THE ARCHITECTURAL DIVISION		MOTION DETECTOR EMPTY CONDUIT & BACKBOX ROUGH-IN
•	DOOR OPERATOR ACTUATOR BUTTON		MAGNETIC DOOR CONTACT EMPTY CONDUIT & BACKBOX ROUGH-IN
 KS	KEY SWITCH, TIED TO THE DOOR OPERATOR SYSTEM	KP	KEYPAD EMPTY CONDUIT & BACKBOX ROUGH-IN
HD	HAND DRYER, SUPPLIED AND INSTALLED BY DIVISION 26	ES	ELECTRIC STRIKE
PL	PUSH-TO-LOCK BUTTON TIED TO THE WASHROOM DOOR OPERATOR		
ES	SYSTEM ELECTRIC STRIKE		CLOCK SYSTEM LEGEND
НО	HOLD OPEN DEVICE	•	ANALOG CLOCK EMPTY CONDUIT & BACKBOX ROUGH-IN
	OCCUPIED-WHEN-LIT' LED ANNUNCIATOR TIED TO THE WASHROOM DOOR	 Y → 	BI-DIRECTION ANALOG CLOCK, EMPTY CONDUIT & BACKBOX ROUGH-IN
	OPERATOR SYSTEM	Фмс	ANALOG CLOCK TIED TO THE MASTER CLOCK SYSTEM - WALL-MOUNTED
EH	VISUAL INDICATOR TIED TO THE CALL-FOR-ASSISTANCE SYSTEM		DUAL-FACE ANALOG CLOCK TIED TO THE MASTER CLOCK SYSTEM - WALL-MOUNTED
E	EMERGENCY PUSH-BUTTON TIED TO THE CALL-FOR-ASSISTANCE SYSTEM	·	WALL-MOUNTED
)Ét	AUDIBLE/VISUAL INDICATOR TIED TO THE CALL-FOR-ASSISTANCE SYSTEM	Фво	ANALOG CLOCK, BATTERY OPERATED - WALL-MOUNTED
	FIRE ALARM SYSTEM LEGEND	► ⊕ ► BO	DUAL-FACE ANALOG CLOCK, BATTERY OPERATED - WALL-MOUNTED
		MC	MASTER CLOCK SYSTEM CONTROLLER
	RATE-OF-RISE HEAT DETECTOR		AUDIO/VISUAL SYSTEM LEGEND
	FIXED TEMPERATURE HEAT DETECTOR		EMPTY BACKBOX COMPLETE WITH BLANK COVERPLATE AND 25mmC UP TO
•	SMOKE DETECTOR	AV	THE ACCESSIBLE CEILING SPACE PROVISION FOR FUTURE AV CABLING
	PULL STATION C/W TAMPERPROOF, POLYCARBONATE COVER		
	FIRE ALARM SPEAKER		PUBLIC ADDRESS (P.A.) SYSTEM LEGEND
	FIRE ALARM SPEAKER/STROBE	S	P.A. SPEAKER – FLUSH CEILING–MOUNTED EMPTY CONDUIT & BACKBOX ROUGH–IN
	DUCT SMOKE DETECTOR	SH	P.A. SPEAKER – WALL-MOUNTED EMPTY CONDUIT & BACKBOX ROUGH-IN
TL	REMOTE TROUBLE INDICATOR	← S→	P.A. SPEAKER, DUAL-FACE TYPE - WALL-MOUNTED
FS	SPRINKLER/STANDPIPE FLOW SWITCH		EMPTY CONDUIT & BACKBOX ROUGH-IN
SV	SPRINKLER/STANDPIPE SUPERVISED VALVE	DSH	P.A. EXTERIOR HORN – WALL–MOUNTED EMPTY CONDUIT & BACKBOX ROUGH–IN
	FIRE ALARM ANNUNCIATOR		WEATHERPROOF PROGRAM BELL C/W ENCLOSURE
	FIRE ALARM CONTROL PANEL	HSH	P.A. HANDSET – WALL–MOUNTED EMPTY CONDUIT & BACKBOX ROUGH–IN
		HS	P.A. HANDSET – DESK–MOUNTED EMPTY CONDUIT & BACKBOX ROUGH–IN
	ACCESS CONTROL SYSTEM LEGEND	\$ PC	P.A. PRIVACY CALL SWITCH EMPTY CONDUIT & BACKBOX ROUGH—IN
CR	CARD READER	\$нѕ	P.A. HANDSET C/W INTEGRAL PRIVACY CALL SWITCH EMPTY CONDUIT & BACKBOX ROUGH–IN
ES	ELECTRIC STRIKE	ACC	P.A. ADMINISTRATIVE HANDSET EMPTY CONDUIT & BACKBOX ROUGH-IN
MS	AIPHONE MASTER STATION	NR	P.A. NIGHT RINGER EMPTY CONDUIT & BACKBOX ROUGH-IN
SMS	AIPHONE SUB-MASTER STATION	A 🛓	P.A. LOCKDOWN 'AMBER' STROBE EMPTY CONDUIT & BACKBOX ROUGH–IN
DS	AIPHONE DOOR STATION	B B	P.A. INCOMING CALL 'BLUE' STROBE EMPTY CONDUIT & BACKBOX ROUGH-IN
LC	LOCAL DOOR CONTACT SUPPLIED AND INSTALLED BY DIVISION 16; TIED TO THE LOCAL DOOR ALARM SYSTEM	VC	P.A. WALL-MOUNTED VOLUME CONTROL SWITCH EMPTY CONDUIT & BACKBOX ROUGH-IN
	AUDIBLE/VISUAL ANNUNCIATOR TIED TO THE LOCAL DOOR ALARM SYSTEM	H	P.A. RED LOCKDOWN BUTTON C/W POLYCARBONATE LIFT-ABLE COVER EMPTY CONDUIT & BACKBOX ROUGH-IN
	1	SCH	P.A. SPEAKER C/W INTEGRATED CALL SWITCH EMPTY CONDUIT & BACKBOX ROUGH-IN
		<u> </u>	P.A. COMBINATION SPEAKER AND CLOCK UNIT – WALL-MOUNTED EMPTY CONDUIT & BACKBOX ROUGH-IN
		PA	P.A. HEAD-END EQUIPMENT RACK
		SR	P.A. SATELLITE EQUIPMENT RACK

\bigtriangledown	COMMUNICATIONS (VOICE/DATA) LEGEND
\bigtriangledown	DATA OUTLET MOUNTED AT STANDARD HEIGHT EMPTY CONDUIT & BACKBOX ROUGH—IN
▼	TELEPHONE OUTLET MOUNTED AT STANDARD HEIGHT EMPTY CONDUIT & BACKBOX ROUGH–IN
\bigtriangledown	DATA OUTLET MOUNTED AT HIGH LEVEL EMPTY CONDUIT & BACKBOX ROUGH—IN
*	TELEPHONE OUTLET MOUNTED AT HIGH LEVEL EMPTY CONDUIT & BACKBOX ROUGH-IN
WAP	WIRELESS ACCESS POINT EMPTY CONDUIT & BACKBOX ROUGH-IN

ACRONYM LEGEND

<u>ACRONYM</u>	DESCRIPTION
AFF CTE ER GFL LV NR RPT TPG WP	ABOVE FINISHED FLOOR CONNECT TO EXISTING DENOTES EXISTING DEVICE OR EQUIPMENT TO BE RELOCATED DENOTE EXISTING DEVICE OR EQUIPMENT TO REMAIN DENOTE DEVICE OR EQUIPMENT WITH GFI PROTECTION DENOTES DEVICE OR EQUIPMENT AT HIGH LEVEL LOW VOLTAGE DENOTES NEW DEVICE OR EQUIPMENT DENOTES NEW DEVICE OR EQUIPMENT TO BE REMOVED DENOTES NIGHT LIGHT FIXTURE DENOTES RELOCATED POSITION OF AN EXISTING DEVICE OR EQUIPMENT DENOTES RELOCATED POSITION OF AN EXISTING DEVICE OR EQUIPMENT DENOTES RELOCATED POSITION OF AN EXISTING DEVICE OR EQUIPMENT T-SLOT, 20A, DEVICE OR EQUIPMENT TO BE REPLACED DENOTES TAMPERPROOF DEVICE OR EQUIPMENT DENOTES DEVICE OR EQUIPMENT DENOTES DEVICE OR EQUIPMENT DENOTES DEVICE OR EQUIPMENT DENOTES DEVICE OR EQUIPMENT

- 1. IT IS MANDATORY FOR THE ELECTRICAL CONTRACTOR TO VISIT THE SITE <u>PRIOR</u> <u>TO BIDDING</u> AND REVIEW EXISTING CONDITIONS AND DEMOLITION SCOPE OF WORK TO SUIT EXISTING ARCHITECTURAL, STRUCTURAL AND MECHANICAL SITE CONDITIONS, DRAWINGS, SPECIFICATIONS AND ALL CONTRACT DOCUMENTS. NO EXTRA WILL SUBSEQUENTLY BE ALLOWED TO COVER ANY SUCH ERROR, OMISSION AND/OR OVERSIGHT FOR NOT HAVING MADE A THOROUGH INSPECTION OF THE GROUNDS, EXISTING CONDITIONS, DRAWINGS, SPECIFICATION AND DESIGN INTENT. THE ELECTRICAL CONTRACTOR SHALL NOTE THAT THE EXISTING BUILDING WILL REMAIN IN OPERATION THROUGHOUT DEMOLITION/CONSTRUCTION. ALLOW FOR ANY WORK REQUIRED TO BE DONE WHICH MAY AFFECT POWER SUPPLY AND OPERATION OF THE BUILDING TO BE CARRIED OUT AFTER HOURS OR AT A TIME CONVENIENT TO THE BUILDING MANAGEMENT. PROVIDE TEMPORARY SERVICES AS REQUIRED TO ENSURE CONTINUED OPERATION AT ALL TIMES.
- CAREFULLY EXAMINE OTHER EXISTING UTILITY LINES SUCH AS GAS, WATER ETC. PRIOR TO START THE ELECTRICAL CONSTRUCTION WORKS AND COORDINATE WITH OTHER TRADES AND REPORT OF ANY DISCREPANCY PRIOR TO PROCEEDING.
- THESE DRAWINGS SHALL BE READ & PRICED IN CONJUNCTION WITH ARCHITECTURAL, MECHANICAL, AND STRUCTURAL DRAWINGS AND SPECIFICATIONS AS WELL AS ALL OTHER DOCUMENTS FORMING THIS BID. INCLUDE FOR THE SUPPLY AND INSTALLATION OF POWER, SYSTEMS, AND LIGHTING AS PER THE COMPLETE CONSTRUCTION DOCUMENTS. NO EXTRA COST WILL BE ACCEPTED IN FAILURE TO OBTAINING AND/OR REVIEW OF SUCH DOCUMENTS. REFER TO ARCHITECTURAL, ELECTRICAL, STRUCTURAL AND MECHANICAL LAYOUTS IN CONJUNCTION FOR EXACT LOCATION OF ALL EQUIPMENT. REPORT ANY DISCREPANCIES TO THE ELECTRICAL ENGINEER PRIOR TO COMMENCING WORK. NO EXTRA WILL BE PROVIDED AS A RESULT OF A FAILURE TO DO SO.
- 4. IT IS MANDATORY THAT ELECTRICAL WORK CONFORM TO ALL APPLICABLE CODES (INCLUDING THE ONTARIO BUILDING, FIRE, AND ONTARIO ELECTRICAL SAFETY CODE), BASE BUILDING (BOARD) STANDARDS, AND THE STANDARDS SET BY ANY AND ALL LOCAL AUTHORITIES HAVING JURISDICTION.
- . LOCATIONS OF ALL NEW DISCONNECT SWITCHES AND STARTERS SHALL BE CONFIRMED WITH THE MECHANICAL CONTRACTOR PRIOR TO INSTALLATION. STARTERS FOR EXHAUST FANS SHALL BE SUPPLIED AND INSTALLED BY DIVISION 26.
- 6. ALL ELECTRICAL WORK SHALL BE INSPECTED BY THE ELECTRICAL SAFETY AUTHORITY (ESA). ARRANGE AND PAY FOR ALL INSPECTIONS REQUIRED FOR THE DURATION OF THE PROJECT.
- . THE ELECTRICAL CONTRACTOR IS RESPONSIBLE FOR HIRING A FIRE WATCH AS REQUIRED BY CODE, LOCAL AUTHORITIES HAVING JURISDICTION, AND DURING ANY ALTERATION OR DOWNTIME OF THE FIRE ALARM SYSTEM. FIRE WATCH SHALL BE PRESENT THROUGHOUT THE DOWNTIME DURATION.
- 8. DURING CONSTRUCTION, IT IS CRITICAL THAT THE ELECTRICAL CONTRACTOR COORDINATES ITS WORK WITH ALL OTHER TRADES. THE ELECTRICAL CONTRACTOR IS RESPONSIBLE FOR REVIEWING THE SCOPE OF WORK OF OTHER TRADES (INCLUDING, BUT NOT LIMITED TO, ARCHITECTURAL, MECHANICAL, STRUCTURAL, MILLWORK, ETC.) IN CONJUNCTION WITH THE PROPOSED ELECTRICAL SCOPE OF WORK. THE ELECTRICAL CONTRACTOR SHALL ESPECIALLY REVIEW MECHANICAL CONVECTOR AND NEW MILLWORK LOCATIONS AND IDENTIFY ANY POSSIBLE INTERFERENCES WITH THE PROPOSED ELECTRICAL WORK PRIOR TO ROUGH-IN (I.E. RECEPTACLE LOCATIONS SHALL BE SHIFTED FROM THE PROPOSED LOCATION TO ANOTHER LOCATION SHOULD THE CONTRACTOR FIND OUT DURING COORDINATION THAT MECHANICAL CONVECTORS ARE BEING INSTALLED IN A CERTAIN LOCATION. SIMILARLY, RECEPTACLE HEIGHTS SHALL BE ADJUSTED IN THE EVENT THAT NEW, PROPOSED MILLWORK MIGHT BLOCK PROPOSED RECEPTACLES. NO EXTRA WILL BE PERMITTED OF AN ERROR RELATED TO A LACK OF COORDINATION ON SITE.
- 9. THE ELECTRICAL CONTRACTOR SHALL LABEL ALL NEW AND EXISTING LIGHT SWITCHES, RECEPTACLES AND JUNCTION BOXES COVERPLATES WITH THE PANEL NAME AND BREAKER IT IS FED FROM. ALL LABELING OF ELECTRICAL DEVICES SHALL BE DONE SO WITH A LABELMAKER ONLY. NO HAND WRITTEN LABELS WILL BE PERMITTED.
- D. WHERE NEW PARTITIONS ARE BEING CONSTRUCTION, ALL WIRING AND RACEWAYS SHALL BE EMBEDDED IN THE CONSTRUCTION OF THE NEW WALLS AND ALL BACKBOXES SHALL BE RECESSED. WHERE NEW DEVICES/SYSTEMS ARE PROPOSED ON EXISTING BLOCK WALLS, UTILIZE WIREMOLD 500/700 SERIES AS RACEWAY FOR ALL NEW WIRING. PROVIDE WIREMOLD BACKBOXES FOR SURFACE MOUNTED, INTERIOR APPLICATIONS. THE USE OF SHEET METAL BOXES WILL NOT BE PERMITTED.
- 11. IN THE EVENT OF ANY DISCREPANCY BETWEEN THE ELECTRICAL DRAWINGS AND SPECIFICATIONS, ALLOW FOR THE HIGHEST-PRICED OPTION IN THE TENDER PRICE.
- 12. ALL WIRING USED ON THIS PROJECT SHALL BE RUN IN RACEWAYS. NO USE OF ARMOURED (BX) CABLE WILL BE PERMITTED WITH THE EXCEPTION OF RUNS NOT TO EXCEED 5' BETWEEN A LIGHT FIXTURE AND THE RESPECTIVE JUNCTION BOX.
- 13. FOR ALL NEW SERVICES RUN IN THE EXISTING SCHOOL, RUN ABOVE THE EXISTING DROP CEILING.

DRAWING LIST		
DRAWING NUMBER	DESCRIPTION	
E1	ELECTRICAL LEGEND AND NOTES	
E2	POOL TUNNEL & FIRST FLOOR KEY PLAN	
E3	SECOND FLOOR KEY PLAN	
E4	ROOF KEY PLAN	
E5	DEMOLITION PLANS	
E6	DEMOLITION PLANS	
E7	NEW WORK PLANS	

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LIGHTING

SECURITY

COMMUNICATION

L5V 1C8

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3.	ISSUED FOR TENDER	MAR. 27/24
2.	ISSUED FOR PERMIT	NOV. 21/23
1.	ISSUED FOR 90% REVIEW	MAR. 13/23
NO.	DESCRIPTION	DATE
REV	ISIONS / ISSUES	



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Project Name

GLENFOREST POOL GLENFOREST SECONDARY SCHOOL 2575 FIELDGATE DR., MISSISSAUGA, ON L4X 2J6

POOL DEMOLITION

Drawing Title

ELECTRICAL LEGEND AND NOTES

Graphic Scale AS SHOWN

Drawn RS

CAD File


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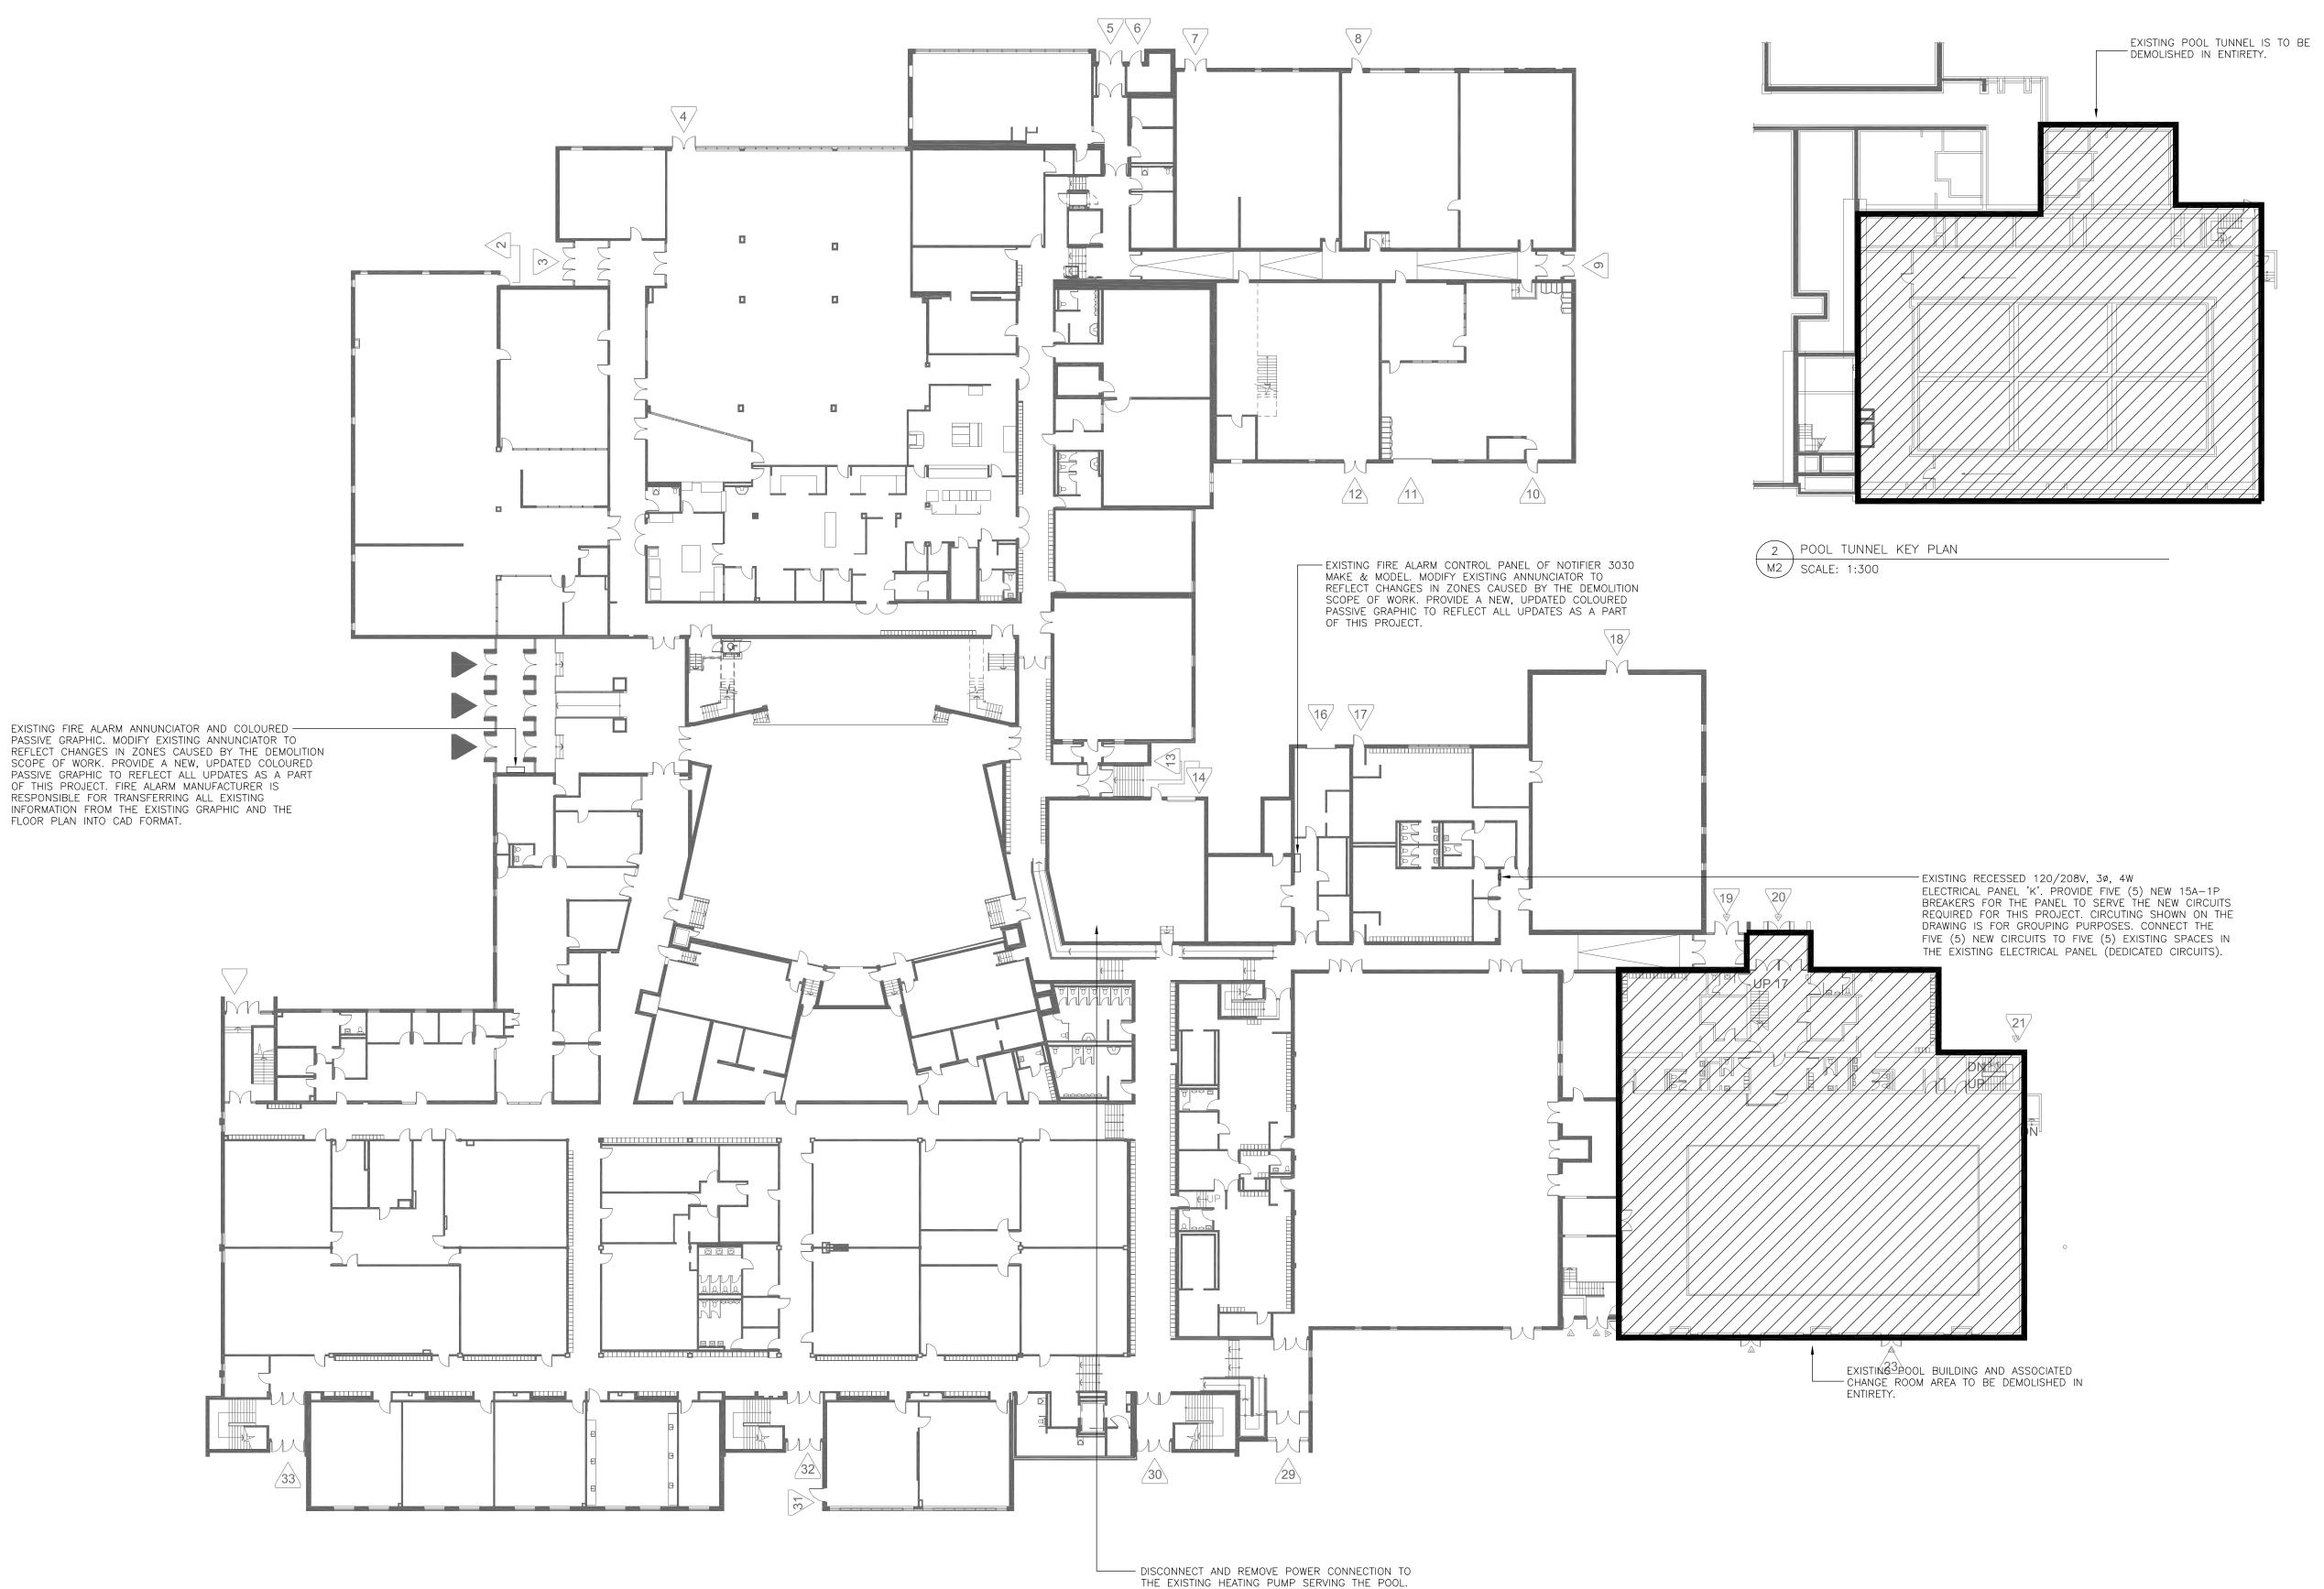
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Sheet no.


Revision No.

Date DECEMBER 2022



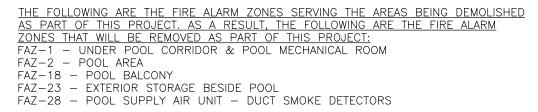

REMOVE ALL REDUNDANT WIRING/RACEWAYS. REMOVE THE EXISTING PUMP STARTER.

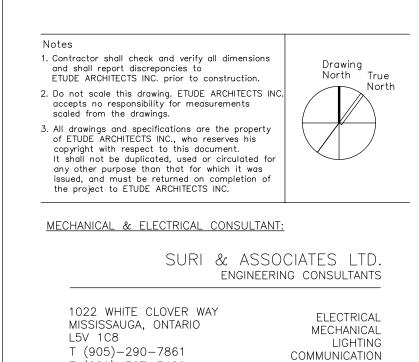

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DESCRIPTION	DATE
-	RESPONSE TO PERMIT COMMENTS ISSUED FOR PERMIT ISSUED FOR 90% REVIEW



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Project Name

GLENFOREST POOL GLENFOREST SECONDARY SCHOOL 2575 FIELDGATE DR., MISSISSAUGA, ON L4X 2J6

POOL DEMOLITION

Drawing Title

POOL TUNNEL & FIRST FLOOR KEY PLAN

Graphic Scale AS SHOWN

Drawn RS

CAD File

-


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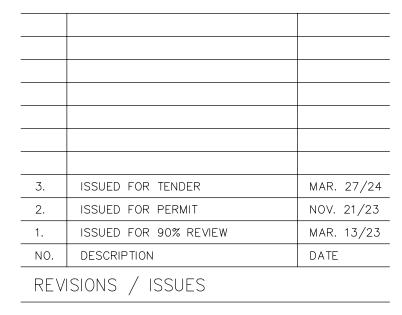
Revision No.


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EXISTING POOL BUILDING AND ASSOCIATED — CHANGE ROOM AREA TO BE DEMOLISHED IN ENTIRETY.



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Project Name

GLENFOREST POOL GLENFOREST SECONDARY SCHOOL 2575 FIELDGATE DR., MISSISSAUGA, ON L4X 2J6

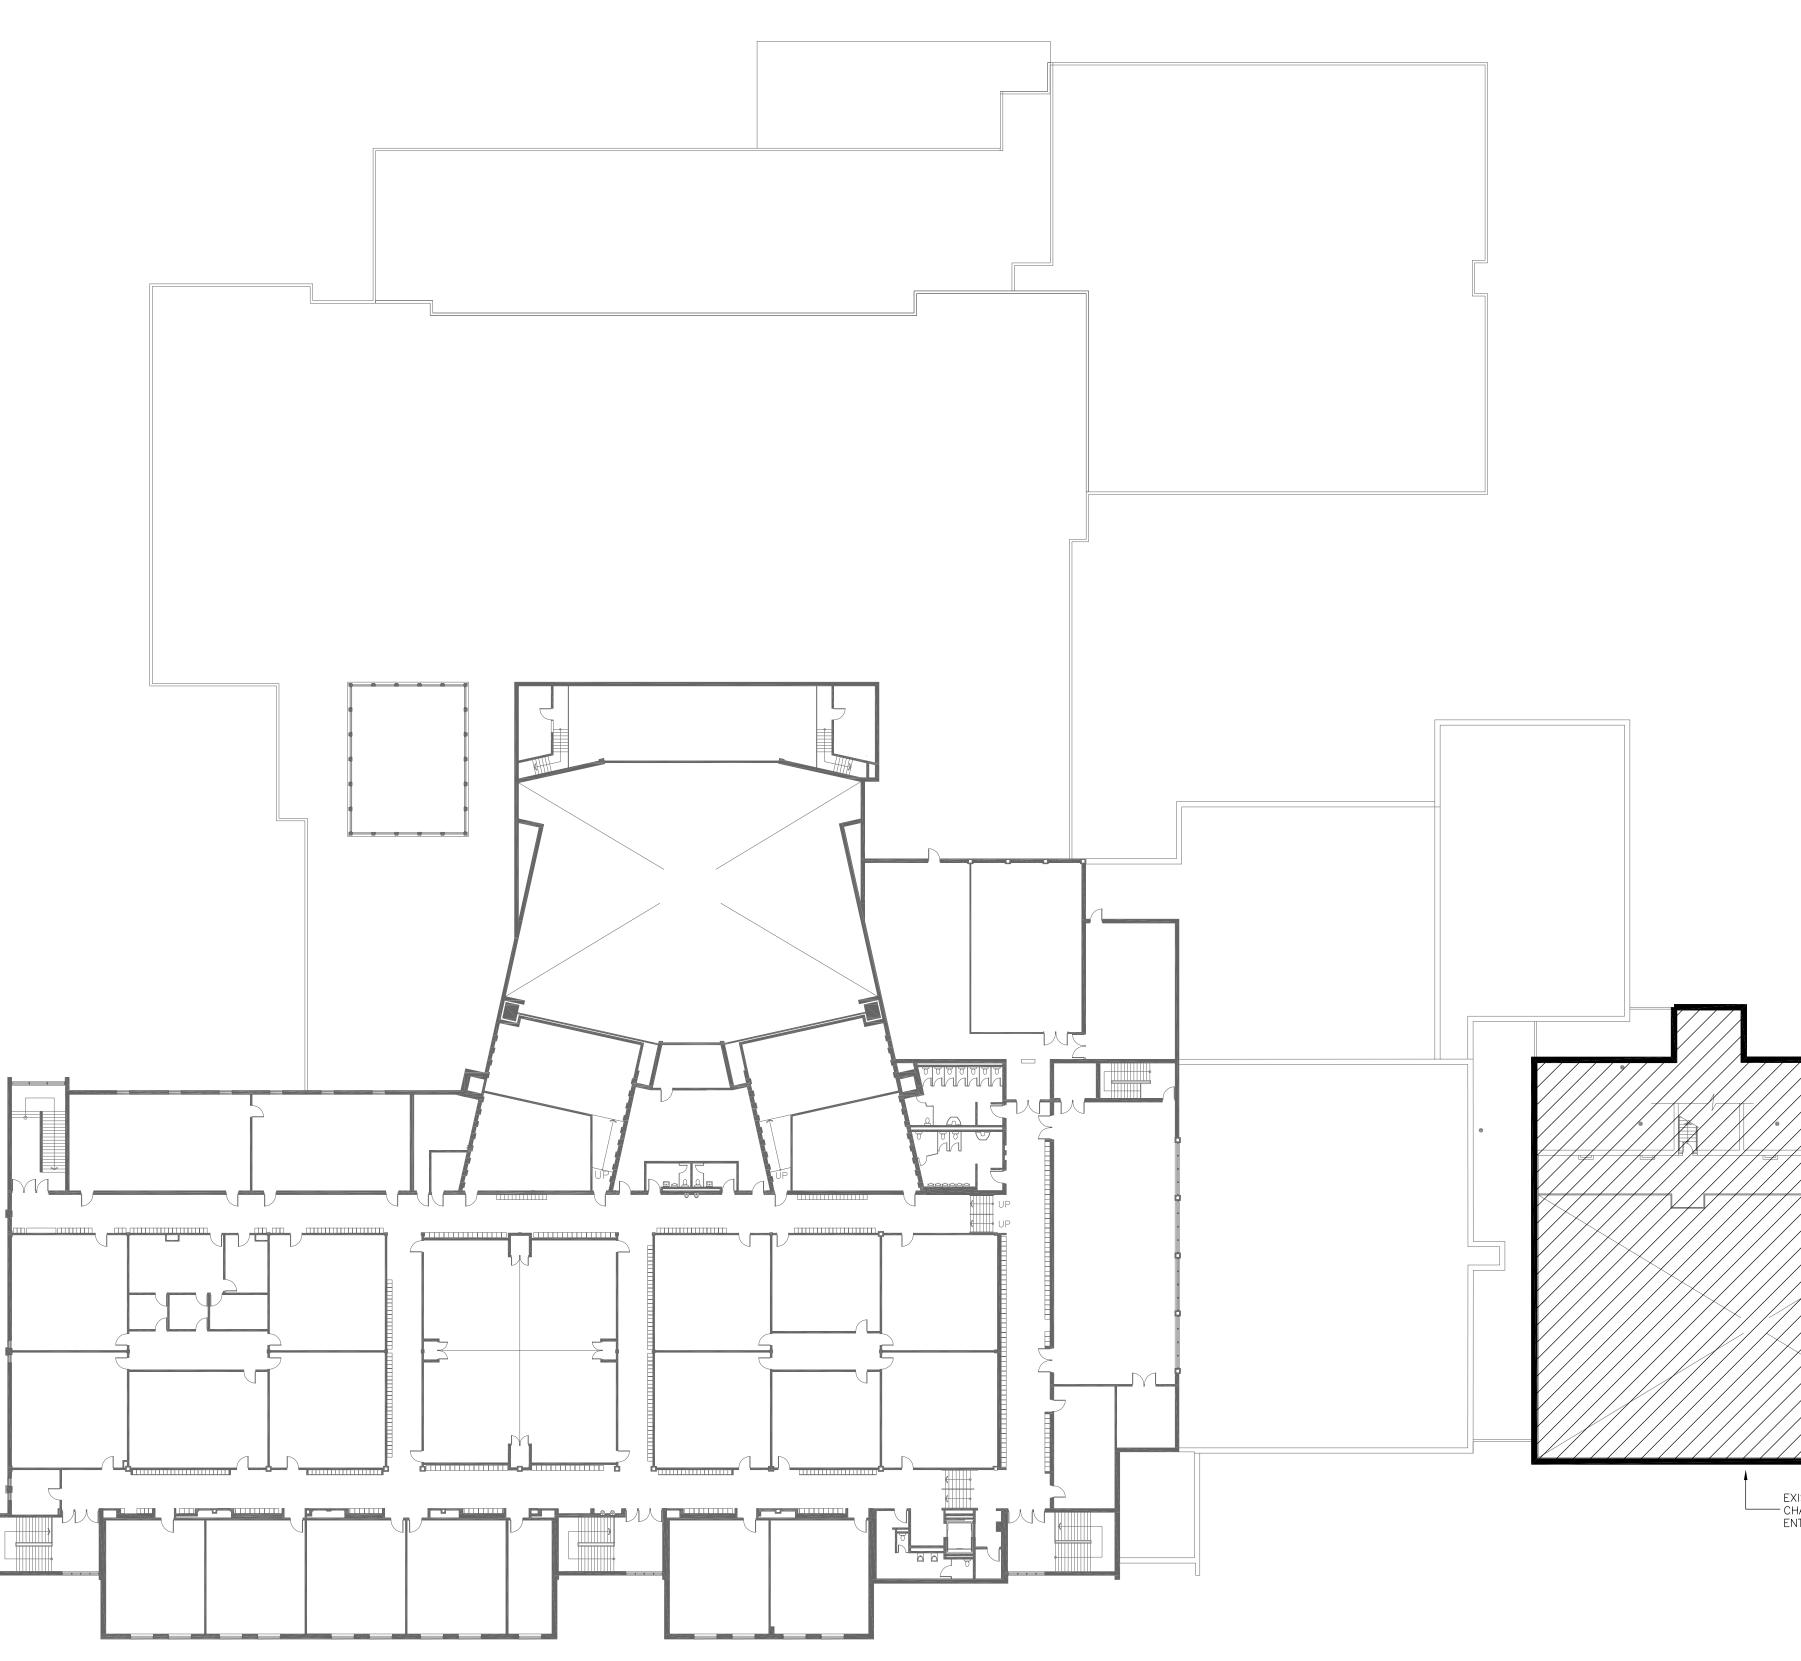POOL DEMOLITION

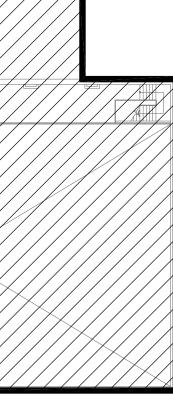Drawing Title

SECOND FLOOR KEY PLAN

Graphic Scale

AS SHOWN _____ Drawn RS _____ CAD File

-_____


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Revision No.

Date DECEMBER 2022



1 ROOF KEY PLAN E4 SCALE: 1:300

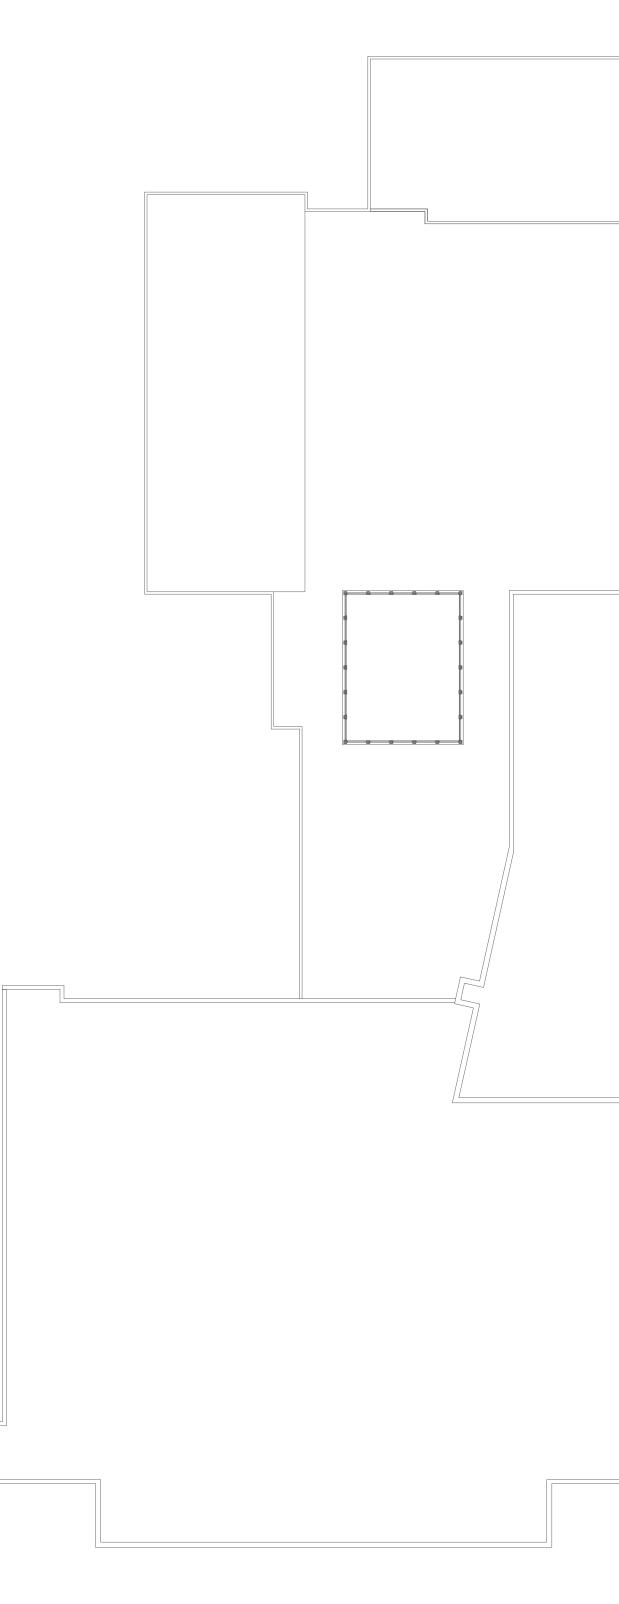


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Project Name

GLENFOREST POOL GLENFOREST SECONDARY SCHOOL 2575 FIELDGATE DR., MISSISSAUGA, ON L4X 2J6

POOL DEMOLITION

Drawing Title ROOF KEY PLAN

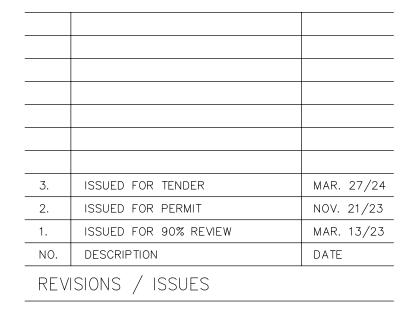Graphic Scale

AS SHOWN Drawn RS -----CAD File

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Checked SS Scale AS NOTED Sheet no.


E4

Revision No.

Date DECEMBER 2022

Project No. 23-124

EXISTING POOL BUILDING AND ASSOCIATED — CHANGE ROOM AREA TO BE DEMOLISHED IN ENTIRETY.

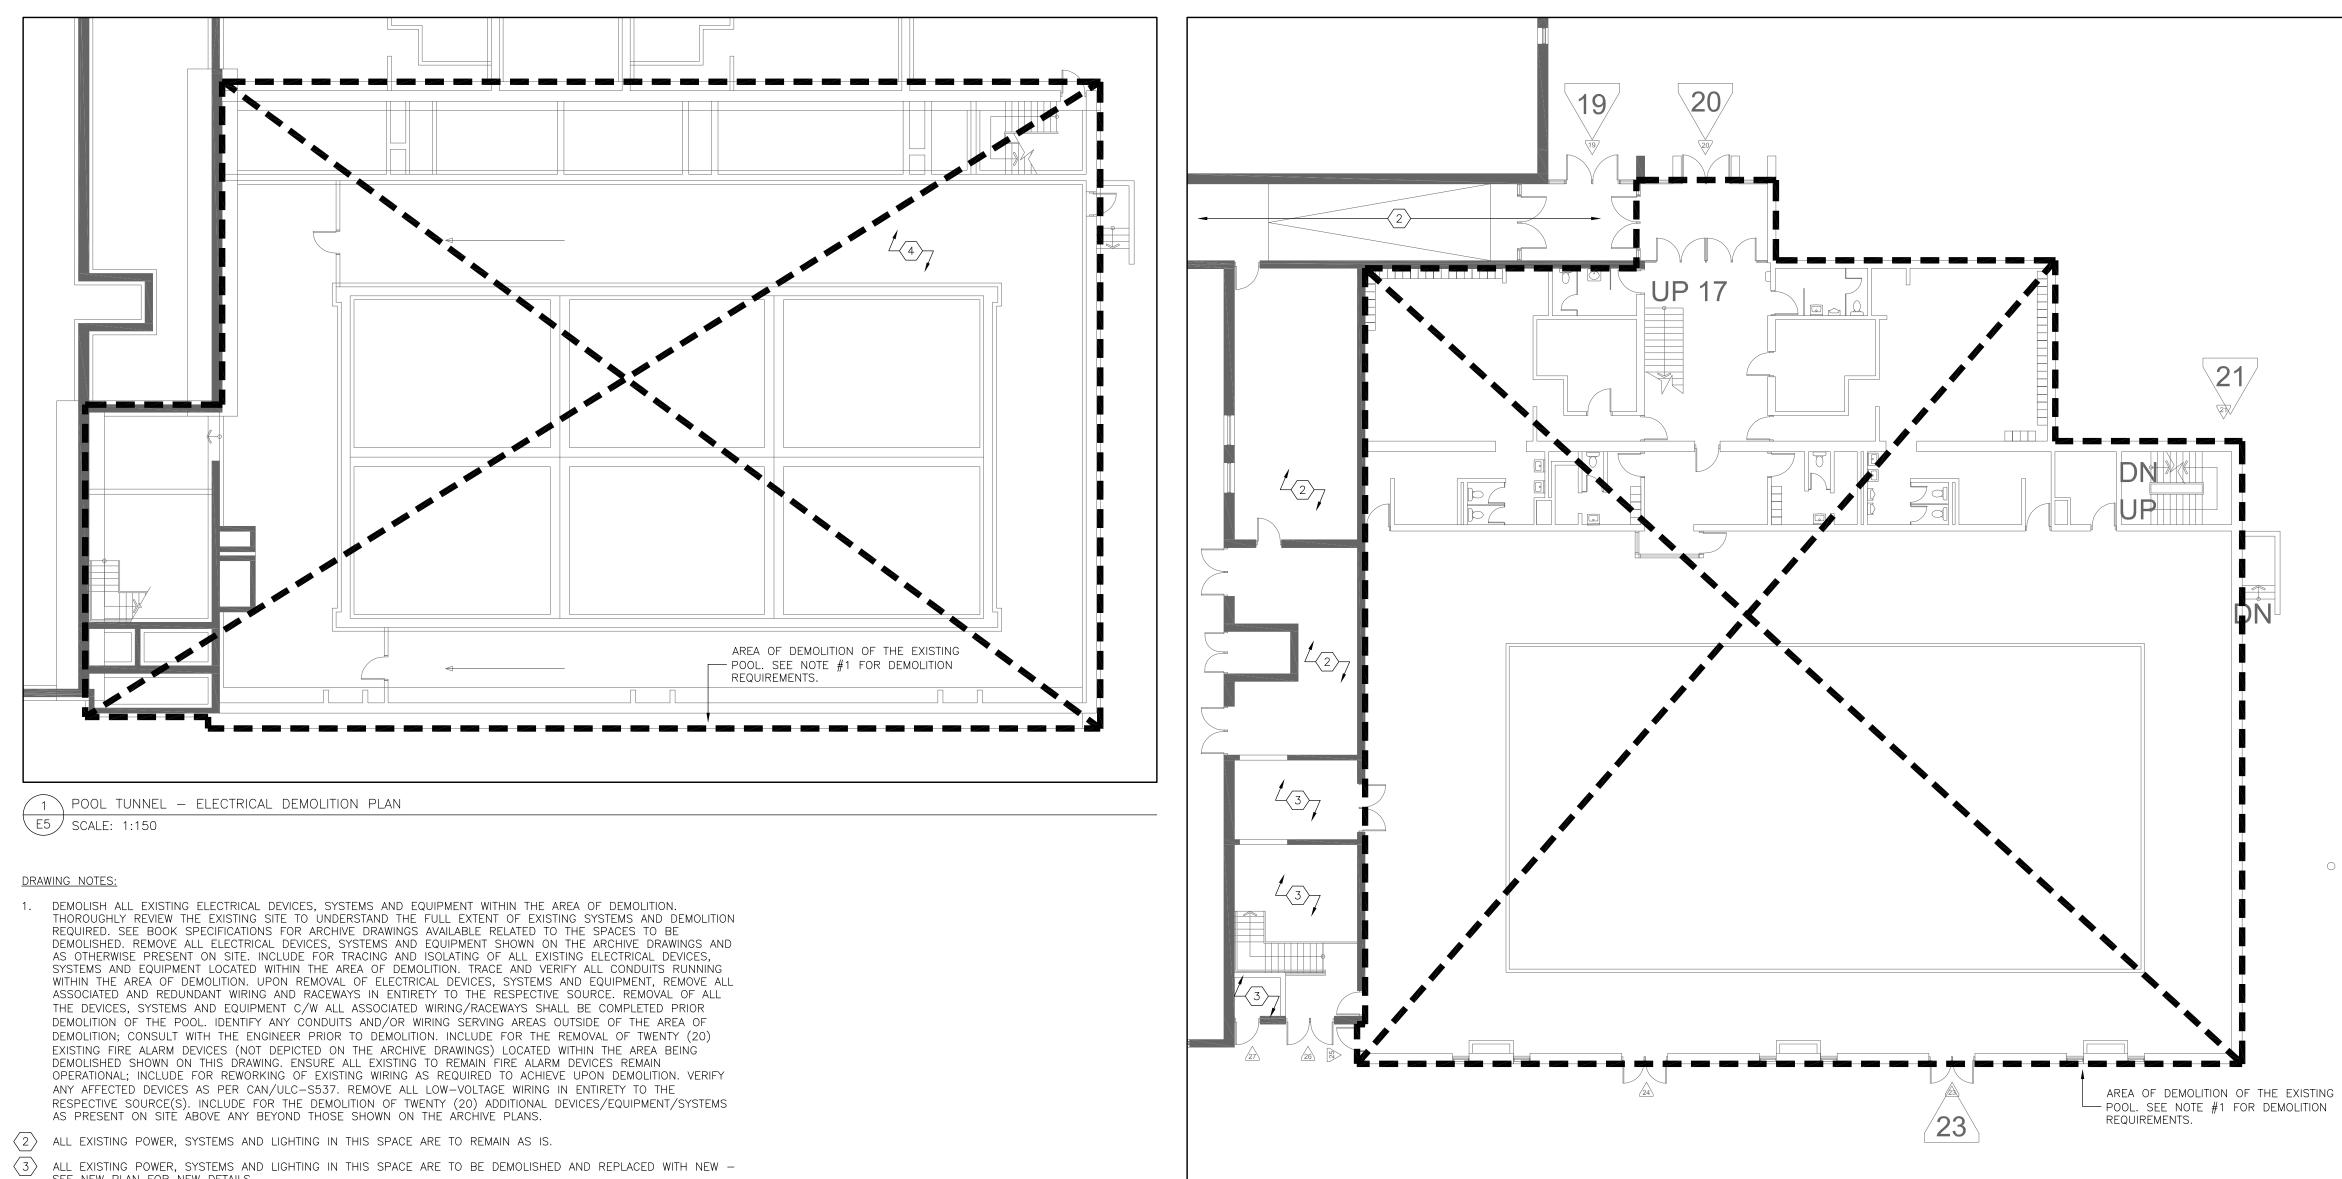

- SEE NEW PLAN FOR NEW DETAILS.
- 4 NOTE THAT THERE IS AN EXISTING GFI PLUG ON THE WALL THAT RESETS SELECT RECEPTACLES IN THE EXISTING GYM. RELOCATE THE EXISTING GFI PLUG AND ALL ASSOCIATED CONDUIT/WIRING TO THE PORTION OF THE SCHOOL BUILDING THAT IS TO REMAIN. RE-FEED RECEPTACLES IN THE GYM TO MAINTAIN CONTINUITY OF POWER IN THE GYM AFTER COMPLETION OF DEMOLITION OF THE POOL.

2 FIRST FLOOR – ELECTRICAL DEMOLITION PLAN E5 SCALE: 1:150

0

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LIGHTING

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COMMUNICATION

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Project Name

GLENFOREST POOL GLENFOREST SECONDARY SCHOOL 2575 FIELDGATE DR., MISSISSAUGA, ON L4X 2J6

POOL DEMOLITION

Drawing Title

DEMOLITION PLANS

Graphic Scale

AS SHOWN Drawn RS CAD File

-

Checked SS Scale AS NOTED




Sheet no.

Date DECEMBER 2022

Project No. 23-124

Revision No.

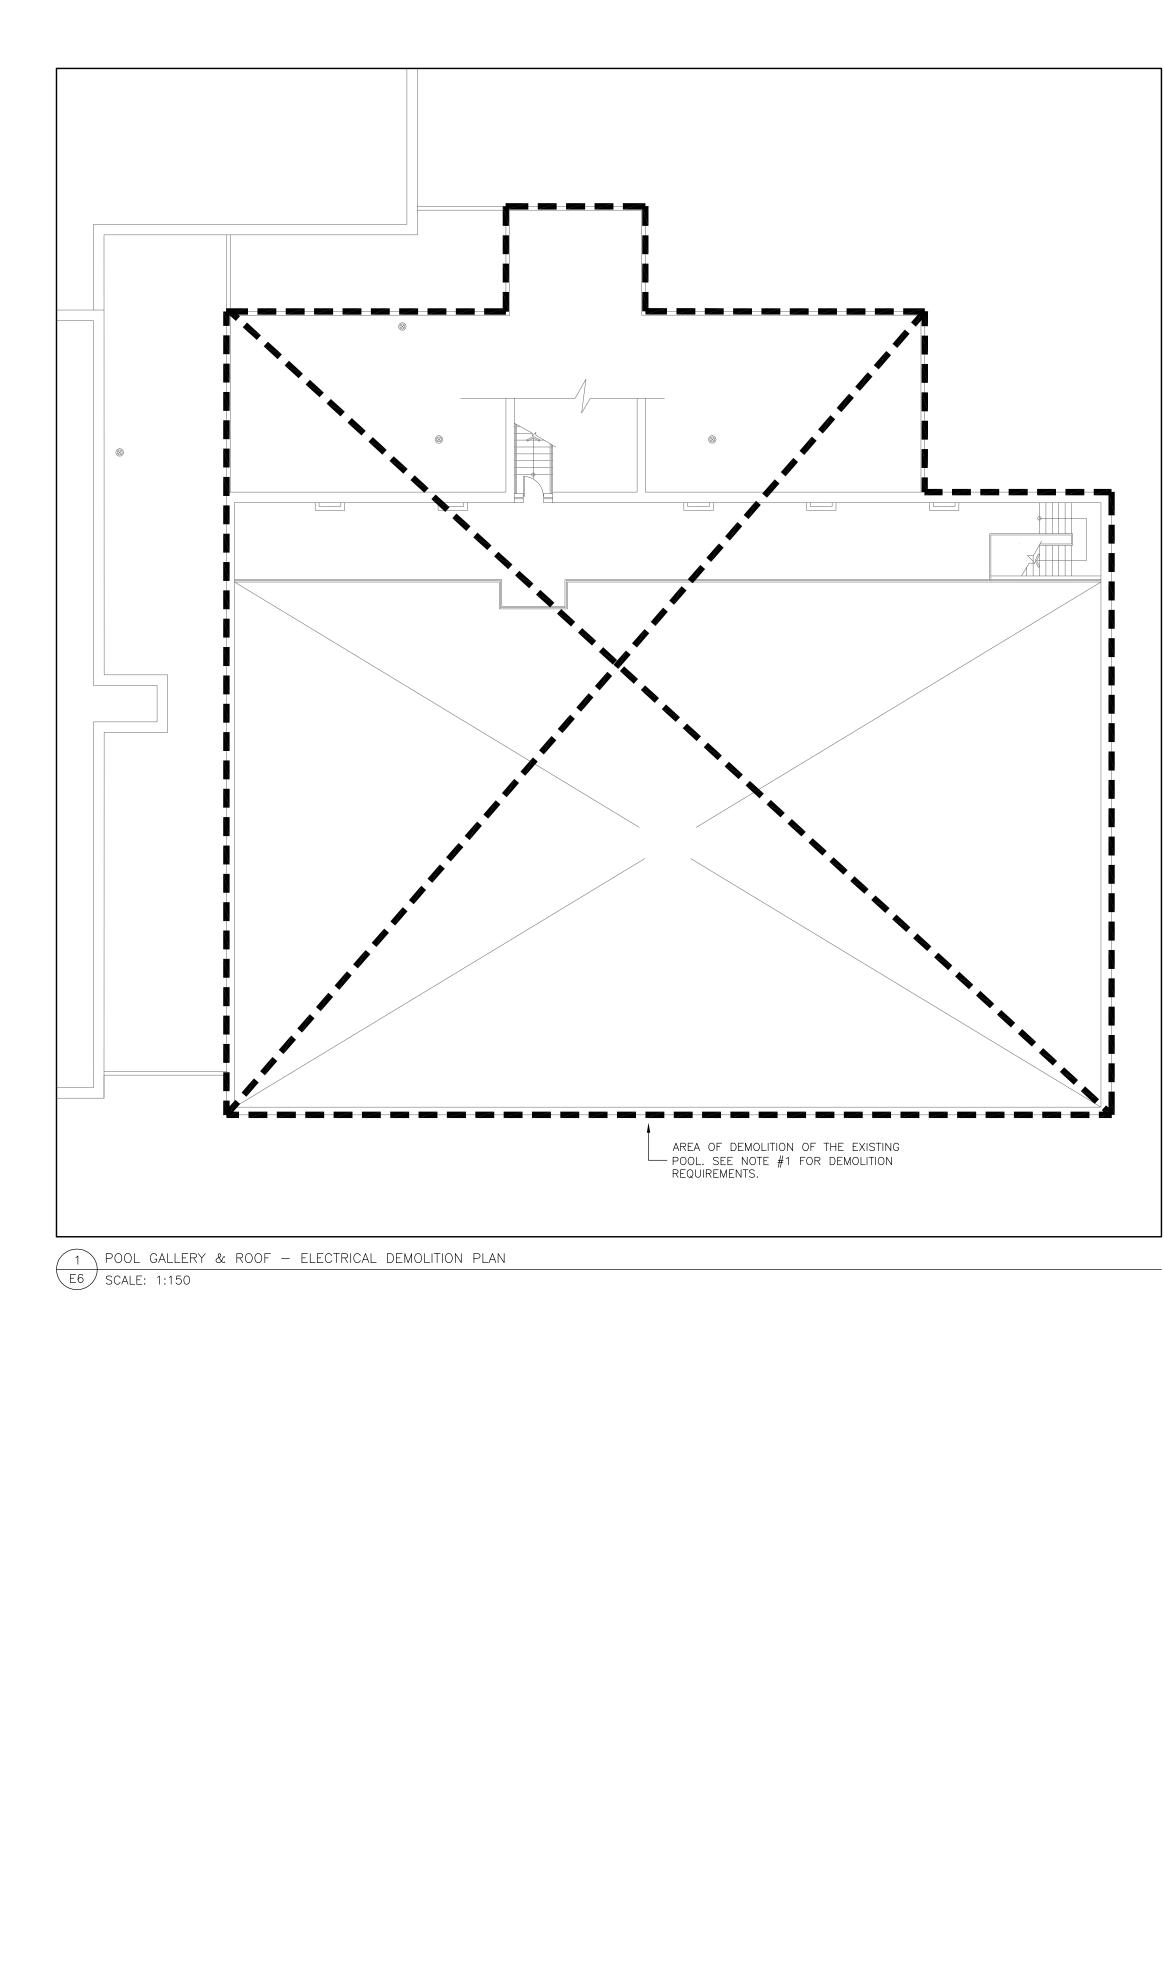

DRAWING NOTES:

1. DEMOLISH ALL EXISTING ELECTRICAL DEVICES, SYSTEMS AND EQUIPMENT WITHIN THE AREA OF DEMOLITION. THOROUGHLY REVIEW THE EXISTING SITE TO UNDERSTAND THE FULL EXTENT OF EXISTING SYSTEMS AND DEMOLITION REQUIRED. SEE BOOK SPECIFICATIONS FOR ARCHIVE DRAWINGS AVAILABLE RELATED TO THE SPACES TO BE DEMOLISHED. REMOVE ALL ELECTRICAL DEVICES, SYSTEMS AND EQUIPMENT SHOWN ON THE ARCHIVE DRAWINGS AND AS OTHERWISE PRESENT ON SITE. INCLUDE FOR TRACING AND ISOLATING OF ALL EXISTING ELECTRICAL DEVICES, SYSTEMS AND EQUIPMENT LOCATED WITHIN THE AREA OF DEMOLITION. TRACE AND VERIFY ALL CONDUITS RUNNING WITHIN THE AREA OF DEMOLITION. UPON REMOVAL OF ELECTRICAL DEVICES, SYSTEMS AND EQUIPMENT, REMOVE ALL ASSOCIATED AND REDUNDANT WIRING AND RACEWAYS IN ENTIRETY TO THE RESPECTIVE SOURCE. REMOVAL OF ALL THE DEVICES. SYSTEMS AND EQUIPMENT C/W ALL ASSOCIATED WIRING (RACEWAYS SHALL BE COMPLETED PRIOR THE DEVICES, SYSTEMS AND EQUIPMENT C/W ALL ASSOCIATED WIRING/RACEWAYS SHALL BE COMPLETED PRIOR DEMOLITION OF THE POOL. IDENTIFY ANY CONDUITS AND/OR WIRING SERVING AREAS OUTSIDE OF THE AREA OF DEMOLITION; CONSULT WITH THE ENGINEER PRIOR TO DEMOLITION. INCLUDE FOR THE REMOVAL OF TWENTY (20) EXISTING FIRE ALARM DEVICES (NOT DEPICTED ON THE ARCHIVE DRAWINGS) LOCATED WITHIN THE AREA BEING DEMOLISHED SHOWN ON THIS DRAWING. ENSURE ALL EXISTING TO REMAIN FIRE ALARM DEVICES REMAIN OPERATIONAL; INCLUDE FOR REWORKING OF EXISTING WIRING AS REQUIRED TO ACHIEVE UPON DEMOLITION. VERIFY ANY AFFECTED DEVICES AS PER CAN/ULC-S537. REMOVE ALL LOW-VOLTAGE WIRING IN ENTIRETY TO THE RESPECTIVE SOURCE(S). INCLUDE FOR THE DEMOLITION OF TWENTY (20) ADDITIONAL DEVICES/EQUIPMENT/SYSTEMS AS PRESENT ON SITE ABOVE ANY BEYOND THOSE SHOWN ON THE ARCHIVE PLANS.

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Project Name

GLENFOREST POOL GLENFOREST SECONDARY SCHOOL 2575 FIELDGATE DR., MISSISSAUGA, ON L4X 2J6

POOL DEMOLITION

Drawing Title

DEMOLITION PLANS

Graphic Scale AS SHOWN

_____ Drawn RS _____

CAD File

-_____

Checked SS Scale AS NOTED

Project No.

23-124


Sheet no.

E6

Revision No.

Date

DECEMBER 2022

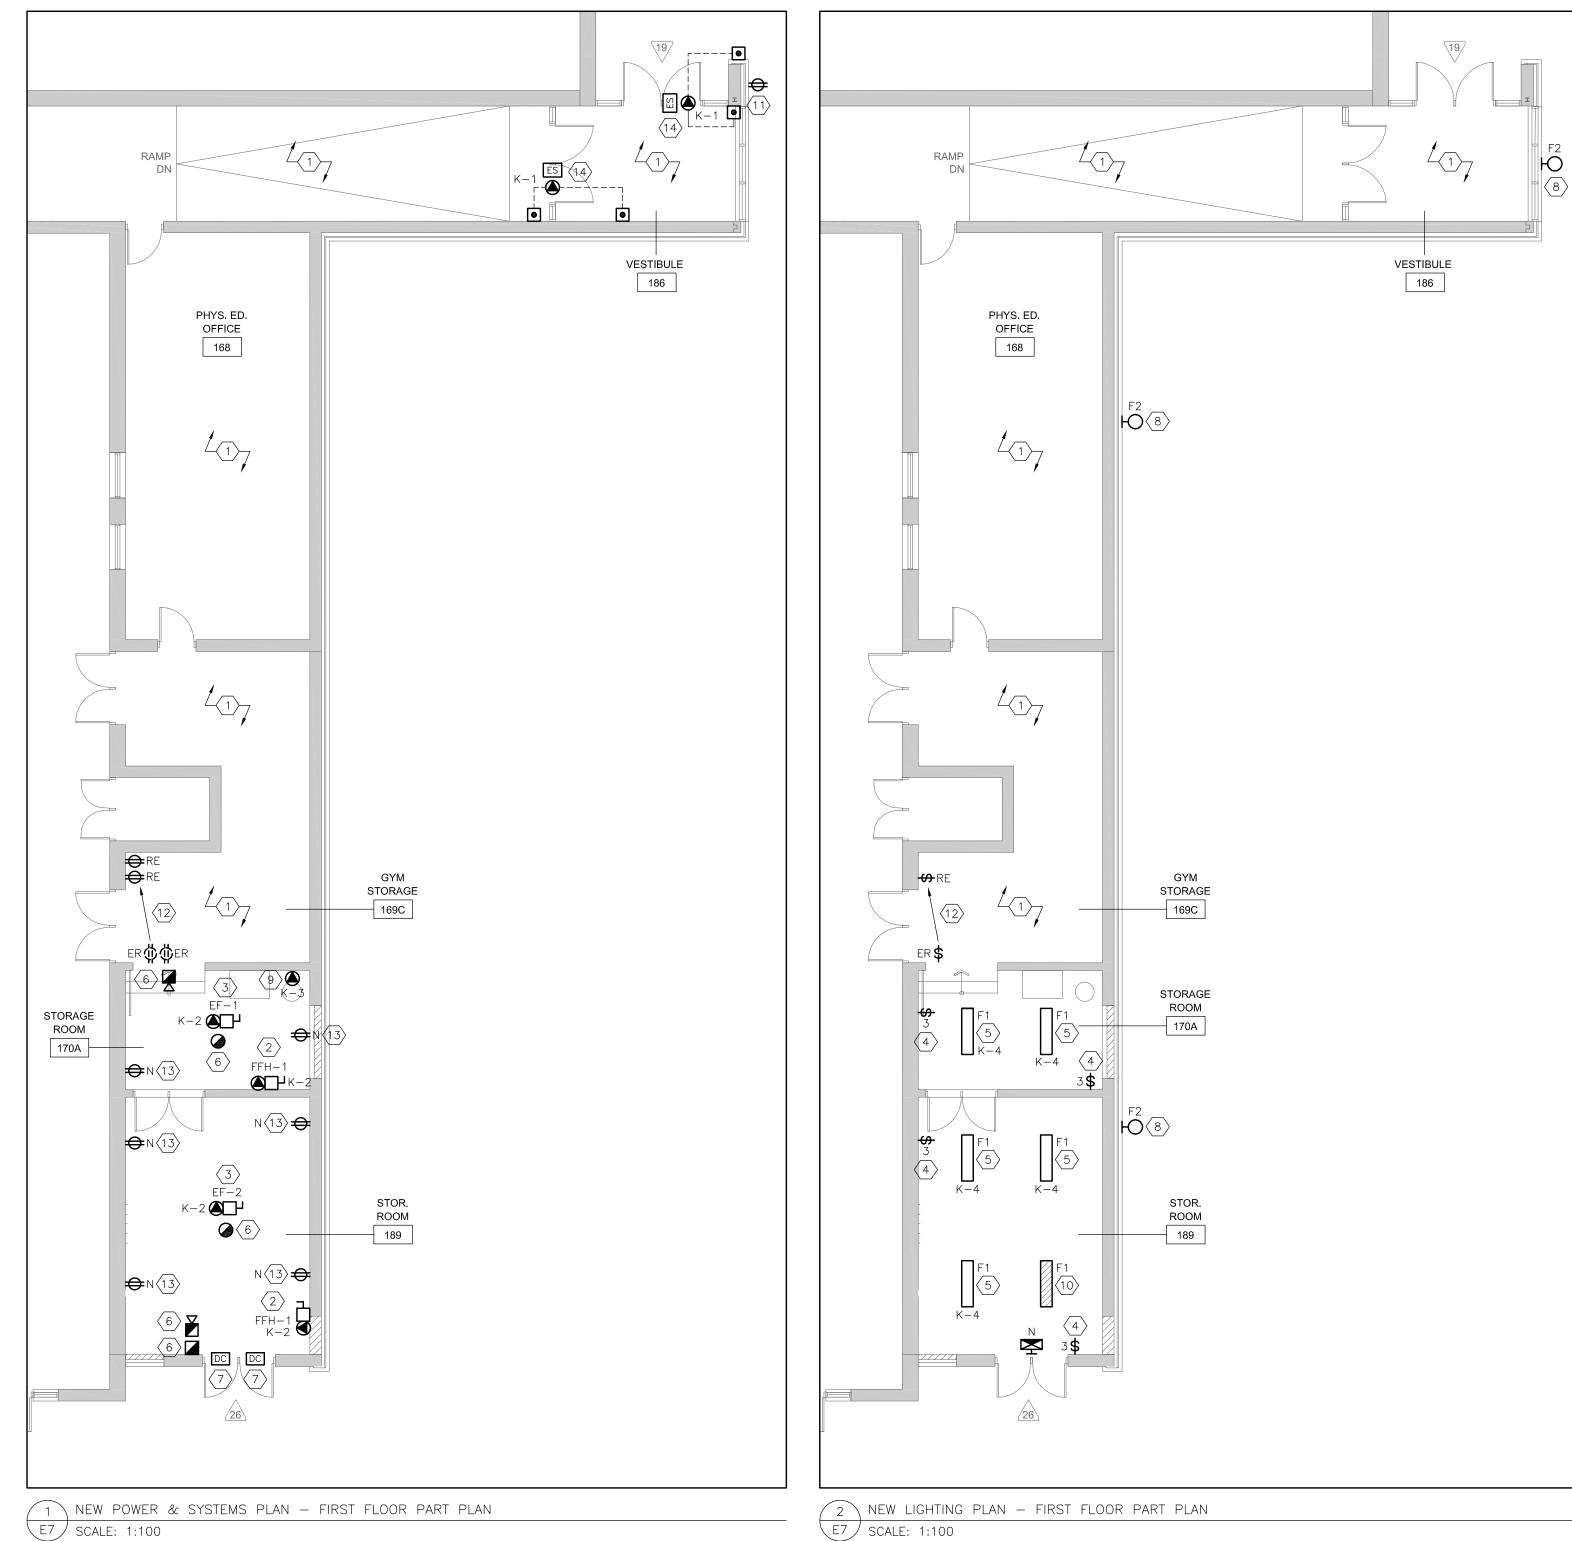

- DRAWING NOTES:
- $\langle 1 \rangle$ All existing power, systems & lighting in this area is to remain as is.
- 2 PROVIDE 120V POWER CONNECTION TO THE NEW FORCED FLOW HEATER. COORDINATE POWER CONNECTION WITH THE MECHANICAL CONTRACTOR. CONNECT TO THE NEAREST FORCED FLOW HEATER CIRCUIT SERVING THE AREA.
- 3 PROVIDE 120V POWER CONNECTION TO THE NEW EXHAUST FAN. COORDINATE POWER CONNECTION WITH THE MECHANICAL CONTRACTOR. FAN SHALL OPERATE BY THE LIGHT SWITCH SERVING THE ROOM.
- $\langle 4 \rangle$ provide New 3-way switches (with built-in occupancy sensors) for the New Storage rooms as shown.
- SENSORS SHALL BE ACUITY NWSX PDT LV-WH OR APPROVED EQUAL C/W nPP16 D POWER PACKS. 5 PROVIDE NEW LIGHT FIXTURES FOR THE NEW STORAGE ROOMS AS SHOWN AND SPECIFIED. CONNECT TO THE LIGHTING CIRCUIT SERVING THE EXISTING GYM STORAGE (CONFIRM SUFFICIENT AVAILABLE LOAD ON THE CIRCUIT PRIOR TO CONNECTION).
- FIXTURE TYPE 'F1' SHALL BE PLB14-40W-3CCT-WS-UD C/W PLS14-SK SURFACE-MOUNTING KIT. $\langle 6 \rangle$ provide a new fire alarm pull station, horn and heat detector in each storage room as shown. CONNECT TO THE EXISTING FIRE ALARM INITIATING ZONE SERVING THE GYM AREA (FAZ-3). CONNECT THE NEW SIGNALING DEVICES TO THE EXISTING SIGNALING CIRCUIT OF SUFFICIENT CAPACITY SERVING THE AREA. INSTALL ALL DEVICES AS PER CAN/ULC-S524 AND VERIFY AS PER CAN/ULC-S537. ALL DEVICES SHALL BE COMPATIBLE WITH THE EXISTING FIRE ALARM SYSTEM ON SITE.
- SIGNALING DEVICE SHALL BE C/W SURFACE-MOUNTING KIT/SKIRT. DEVICE AND BACKBOXES SHALL BE RED. TONE OF THE NEW SIGNALING DEVICES SHALL MATCH THAT OF THE EXISTING IN THE SCHOOL. VERIFY AT THE TIME OF PRICING.
- 7 PROVIDE NEW ROUGH-IN FOR A NEW DOOR CONTACT. DOOR CONTACT SUPPLY/INSTALL AND ALL CABLING IS TO BE COMPLETED BY THE LOW-VOLTAGE CONTRACTOR AS PART OF THE CASH ALLOWANCE.
- 8 PROVIDE NEW EXTERIOR WALL-MOUNTED LED LIGHT FIXTURES WHERE SHOWN. MOUNT 10' ABOVE GRADE. CONNECT TO THE EXISTING EXTERIOR WALL-MOUNTED LIGHTING CIRCUIT SERVING THE NEARBY WALL-MOUNTED EXTERIOR FIXTURES. FIXTURE TYPE 'F2' SHALL BE RAB AWL2S-LED80-VK-BRZ-DIM.
- 9 PROVIDE NEW 120V POWER CONNECTION/RECEPTACLE FOR THE EXISTING IRRIGATION SYSTEM CONTROLLER. CONNECT TO A DEDICATED CIRCUIT IN THE NEAREST ELECTRICAL PANEL WITH SUFFICIENT SPACE.
- (10) CONNECT SELECT FIXTURE TO THE EXISTING EMERGENCY LIGHTING CIRCUIT SERVING THE AREA. EMERGENCY LIGHT FIXTURE CIRCUIT IS BACKED UP BY THE EXISTING EMERGENCY GENERATOR SERVING THE SCHOOL.
- $\langle 11 \rangle$ NOTE THAT THERE IS AN EXISTING RECEPTACLE C/W SURFACE-MOUNTED CONDUIT/WIRING ON THIS WALL. TEMPORARILY REMOVE THE RECEPTACLE C/W SURFACE-MOUNTED CONDUIT/WIRING TO FACILITATE RECLADDING WORK OF THE COLUMN. RE-INSTATE THE RECEPTACLE AND CONCEAL ALL CONDUIT AND WIRING BEHIND THE NEW CLADDING.
- (12) RELOCATE THE EXISTING RECEPTACLES AND LIGHT SWITCHES AS SHOWN. EXTEND/MODIFY EXISTING WIRING/RACEWAYS AS REQUIRED.
- $\langle 13 \rangle$ provide new duplex receptacles as shown. Connect to the existing receptacle circuit serving the receptacles in the GYM storage room.
- PROVIDE 120V POWER CONNECTION TO THE NEW DOOR OPERATORS. PROVIDE NEW WIRING/RACEWAYS TO THE PUSH-TO-OPEN BUTTONS AND THE ELECTRIC STRIKE. CONNECT TO THE CIRCUIT NOTED. COORDINATE ALL WORK WITH THE DOOR OPERATOR SUPPLIER.

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1022 WHITE CLOVER WAY	ELECTRICAL
MISSISSAUGA, ONTARIO	MECHANICAL
L5V 1C8	LIGHTING
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F (289)-327-3420	SECURITY

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• **Deel** District School Board

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Project Name

GLENFOREST POOL GLENFOREST SECONDARY SCHOOL 2575 FIELDGATE DR., MISSISSAUGA, ON L4X 2J6

POOL DEMOLITION

Drawing Title

NEW WORK PLANS

Graphic Scale

AS SHOWN Drawn RS CAD File

-

Checked SS Scale AS NOTED

E7

Project No. 23-124

Revision No.

Date DECEMBER 2022

Sheet no.

