KAWARTHA PINE RIDGE DISTRICT SCHOOL BOARD PUR24-070-ITT

Dr M.S. Hawkins Public School Classroom Upgrades

ADDENDUM NO. 2

This addendum shall form an integral part of the bid documents for the above noted Bid and shall be read in conjunction therewith. This addendum shall, however, take precedence over all requirements as it pertains to the particular and specific items noted below.

ADDITIONAL INFORMATION

Add: Addendum No. 1, prepared by CMV Group architects, Project No. 23A117, (8

pages)

END OF ADDENDUM NO. 2



101 – 20 Camden Street Toronto, Ontario M5V 1V1

ADDENDUM

416.506.1600 416.506.0956

www.cmvarch.com

DATE April 12, 2024

ADDENDUM No 1

ATTENTION

.

Steven Altpeter

PROJECT Dr M.S. Hawkins Sr Public School Classroom Renovations

PROJECT No 23A117

Kawartha Pine Ridge District School Board1994 Fisher DrivePeterborough, ON K9J 6X6

- 01 This Addendum shall be attached to the form of the Specifications and shall form an integral part of the Contract Documents. The contents of this Addendum shall be brought to the attention of all concerned.
- 02 Receipt of the Addenda shall be acknowledged in the Tender Form.
- 03 All trades shall read the Addenda.
- 04 This addendum consists of 8 pages and attachments as noted.
 - Architectural drawings A200, D202, A202, D301, and A301revised:
 - Demolition and proposed notes have been updated to accurately reflect the modifications outlined in the Pinchin report 335495.027 regarding the removal of existing caulking around the existing door frames.
 - Architectural drawing D300 revised:
 - The arrow indicating the incorrect door has been revised to point to the correct door.
 - Architectural drawing A801 revised:
 - Note four (4) has been removed from the door schedule to align with the revisions outlined in the Pinchin report 335495.027 regarding the removal of existing caulking around the door frames.

Tala Jabbary	
PER CMV GROUP ARCHITECTS	

Rachel Northey (Pinchin Ltd.), Andrew Ferreira (TMP), Quan Vu (H&J)

DISTRIBUTION

(2A) GC TO REMOVE EXISTING METAL CAP AND EMBEDDED PIPE IN ORDER TO PROVIDE FLUSH SURFACE FOR NEW FLOORING. TYPICAL OF 36 LOCATIONS. PATCH AND REPAIR CONCRETE SLAB WITH SELE LEVELLING COMPOUND. SEE SPECIFICATIONS. MAKE CONCRETE SLAB READY FOR NEW FLOORING AS PER MANUFACTURERS REQUIREMENTS. TYPICAL

(3.) REMOVE & DISPOSE EXISTING WALL-MOUNTED WHITEBOARDS, CHALKBOARDS AND TACKBOARDS. PATCH AND MAKE GOOD WALLS BEHIND

READY FOR PAINT. SEE PINCHIN REPORT.

(4.) REMOVE AND DISPOSE OF EXISTING DOOR AND HARDWARE. EXISTING FRAME TO REMAIN. SAND, REPAIR AND REPAINT. REMOVE ROOM/DOOR SIGNS, PATCH, MAKE GOOD SURROUNDING CONC BLOCK WALL, OR PARTITIONS TO MATCH EXTG CONDITION, READY FOR PAINT, SEE PAINT SCHEDULE

(5.) REMOVE AND DISPOSE PART OF EXTG SOFFIT AND BULKHEAD. (6.) REMOVE AND DISPOSE OF EXISTING MILLWORK, SHELVING AND CABINETS. PATCH AND MAKE GOOD WALLS TO RECEIVE NEW WALL PAINT & WALL

(7.) EXISTING PROJECTOR & SCREEN: WALL/CEILING MOUNTED PROJECTOR AND CONTROLS TO BE REMOVED BY OWNER'S IT REPRESENTATIVE PRIOR TO SCOPE OF THIS WORK. THIS SCOPE TO PATCH AND MAKE GOOD WALLS, CEILING, SLAB AND FLOORING. SEE ELECTRICAL DRAWINGS.

8. EXTG CONC BLOCK WALL. REMOVE ABANDONED/OLD CONDUITS, ELEC. ITEMS, OLD CLOCKS, BRACKETS, SUPPORTS, RAILS, HOOKS, PINS AND ALL REMAINING EXTRA ITEMS. FIX & REPAIR CRACKS & JOINTS. FILL EXTG. HOLES. REPAINT THE WALL OVER EXISTING OLD PAINT, SEE PINCHIN REPORT, EPOXY, GLUE, ADHESIVE & ETC FROM WALLS. PREPARE WALL SURFACE TO ACCEPT NEW PAINT, PATCH & REPAIR ANY DAMAGES CAUSED BY DEMOLITION. MAINTAIN EXISTING FIRE RATING SEPARATION.

9. EXISTING UNIT VENTILATORS TO REMAIN, AND TO BE CLEANED PRIOR TO PAINTING. EXISTING FLOORING AND WALL BASE TO BE REMOVED UNDER AND AROUND UNIT VENTILATORS AND TO DOOR THRESHOLDS. TYP. REPAINT EXTG UNIT VENTILATORS ENCLOSURE.

(10) RREMOVE AND DISPOSE OF EXISTING SINKS INCLUDING COUNTERTOP, MILLWORK CABINET, PAPER TOWEL DISPENSER HAND SOAP DISPENSERS, AND OTHER ACCESSORIES. SEE MECHANICAL DRAWINGS FOR REMOVALS/MODIFICATIONS TO PLUMBING. WHERE WALLS AND SLABS ARE DAMAGED BY THE REMOVALS, PATCH AND MAKE GOOD WITH LIKE ASSEMBLIES, MATERIALS AND FINISHES. FLOOR SLAB AND WALL PATCHES TO BE SMOOTH, LEVEL AND PLUMB. SEE PINCHIN REPORT.

(11.) REMOVE AND DISPOSE CLOSETS ENTIRELY INCLUDING DOORS, FRAMES SHELVES AND HARDWARE GC TO REMOVE EXTG CAULKING ON DOOR

(12.) EXISTING ELECTRICAL PANEL, REPAINT OR PROVIDE NEW COVER. REFER TO ノ ELEC. DWG.

(13.) REMOVE AND DISPOSE OF EXISTING PA SPEAKER PHONE, CALL SWITCH, AND BACKBOARD, SEE ELECTRICAL DRAWINGS.

14. FOR HEAT AND SMOKE DETECTORS REFER TO MECH. AND ELEC. DRAWINGS.

(15.) REMOVE TRIM AT WINDOW SILL AND REPLACE WITH NEW.

(16.) REMOVE AND DISPOSE EX. LIGHT FIXTURES, EX. MECH. VENTS, DIFFUSERS, AIR SUPPLY GRILLES AND ALL CEILING MOUNTED ITEMS. EXISTING CONDUITS OR PIPING SUSPENDED FROM CEILING SLAB AT HIGH LEVEL TO REMAIN UNLESS NOTED OTHERWISE. SEE MECH. & ELEC. DRAWINGS. SITE VERIFY QUANTITIES AND EXTENT.

(17.) REMOVE AND DISPOSE OF EX. CEILING TILES AND CEILING SUPPORTING ✓ SYSTEM INCLUDING TILES, GYPSUM BOARD, FURRING CHANNELS, HANGERS AND EX. LIGHT FIXTURES, MECH DIFFUSERS, VENT AND ALL CEILING MOUNTED ITEMS UNLESS NOTED OTHERWISE. SEE MECH. AND ELEC. DRAWINGS. SEE PINCHIN REPORT.

(18) REMOVE AND REPLACE WOODEN WINDOW VALENCE & SILL BOARDS. SEE A800 DRAWING

(19.) EXISTING WI-FI APS TO BE REMOVED BY THIS CONTRACTOR, PRIOR TO DEMOLITION, AND KEEP SAFE UNTIL END OF CONSTRUCTION AND REINSTALLED IN THE EXACT SAME ROOM TO NEW LAYOUT CENTERED IN NEW CEILING. GC ELECTRICIAN TO COORDINATE WITH ELEC CONSULTANT.

(20) REMOVE EXTG WALL/TRIM AT LOCATION OF EXTG UNIT VENTILATORS. PROVIDE CLEAR SPACE FOR INSTALLATION OF NEW MILLWORK WITH NEW AIR GRILLES. CLOSE ADJACENT OPENINGS & HOLES. INSTALL 16MM DRYWALL ENCLOSURE ON 92MM ST STUD IF REQ'D.

(21) EXISTING DUCTWORK AND ACCESS PANELS TO REMAIN. REFER TO MECHANICAL DRAWING.

(22) EXISTING GLASS AND HOLLOW METAL FRAME TO REMAIN.

(23) EXISTING RADIATOR TO REMAIN, AND TO BE CLEANED PRIOR TO PAINTING. EXISTING FLOORING AND WALL BASE TO BE REMOVED UNDER AND AROUND RADIATOR AND TO DOOR THRESHOLDS. TYP. REPAINT EXTG RADIATOR ENCLOSURE.

(24) EXISTING DRYWALL TO REMAIN. REMOVE ABANDONED/OLD CONDUITS, ELEC ITEMS,OLD CLOCKS BRACKETS, SUPPORTS, RAILS HOOKS. GC TO PATCH, REPAIR ANY DAMAGES AND HOLES CAUSED BY DEMOLITION AND PAINT THE DRYWALL OVER EXISTING PAINT TO MAKE IT GOOD AS NEW. MAINTAIN EXTG. FIRE RATING THROUGHOUT THE WALL. TYPICAL. SEE PINCHIN

(25) NEW LVT FLOORING: HIGH PERFORMANCE LUXURY VINYL TILE (LVT) FLOORING, INTERFACE STUDIO SET. CLASS III PRIMED. COMMERCIAL GRADE, FINISH CERAMOR, SLIP RETARDANT, 250MM X 1000MM X 4.5MM. PROVIDE ACCENT BAND & NEW RESILIENT TRANSITION STRIP. PROVIDE SELF-LEVELING UNDERLAYMENT AS REQUIRED. MEET OR EXCEED SUBSTRATE REQUIREMENTS FOR CONCRETE SLAB AS SPECIFIED IN THE FLOORING SPECIFICATION SECTION. SUB-FLOOR SHALL COMPLY TO ASTM F 710 STANDARD PRACTICE FOR PREPARING CONCRETE FLOORS TO RECEIVE RESILIENT FLOORING. LVT FLOORING SHALL BE EXTENDED BELOW BOOKSHELVES/CABINETS MILLWORK CLOSET AND EXTG RADIATORS. GC TO SUBMIT 3 SAMPLES FOR ACCENT STRIPE/BORDER AND 3 SAMPLES FOR FLOORING, GC TO PROVIDE INSTALLATION METHODS MOCK UP FOR REVIEW & APPROVAL. PROVIDE 15 YEAR STANDARD LVT WARRANTY- REFER TO A501 FOR FLOOR PATTERN, AND A801 FOR FINISH SCHEDULE AND SPECIFICATION

(26) EXISTING WINDOW FRAME TO REMAIN. PATCH, SAND REPAIR, AND PAINT ALL FRAMES REMOVE DIRT AND DEBRIS FROM THE WINDOW FRAME AND GLASSES. WASH, CLEAN, AND REMOVE OXIDATION FROM FRAME, REMOVE EXTG CAULKING, RE-CAULK AROUND FRAMES. MAKE GOOD FRAMES SO THAT GLASS AND FRAME LOOK AS NEW.

27) NEW RUBBER BASE, 102MM X 3MM THICK RUBBER COVE BASE SEE SPECIFICATION. PROVIDE SELF-LEVELLING UNDERLAYMENT AS REQUIRED. MEET OR EXCEED SUBSTRATE REQUIREMENTS FOR WALLS AND PARTITIONS AS SPECIFIED IN THE WALL BASE SPECIFICATION SECTION.

(28) EXISTING DUCTWORK TO REMAIN. THOROUGHLY CLEAN THE SURFACES OF EXISTING DUCTWORK TO REMAIN. IHUKUUGHLT CLEAN THE SOLITORS OF THE EXISTING DUCTWORK TO REMOVE ANY DUST, DIRT OR LOOSE PARTICLES.

(53) NEW LIGHT FIXTURE SHALL COMPLY TO REQUIREMENT OF INCENTIVE PROGRAM. SAND AND PAINT ALL THE SURFACES. SEE MECHANICAL DRAWINGS.

29 1HR FIRE SEPARATION ENCLOSURE, EXTG CONC BLOCK WALL OR EXTG/NEW DW PARTITION: ENCLOSING WALLS ARE REQUIRED TO HAVE A MIN 1HR FIRE-RESISTANCE RATING. EXISTING & NEW HOLES SHALL BE PATCHED REPAIRED AND SEALED WITH MIN 1HR FRR FIRE STOPPED / CAULKING SO THAT THE INTEGRITY OF THE FIRE SEPARATIONS IS MAINTAINED THROUGHOUT. APPLY FIRESTOP BELOW THE ROOF DECK AT TOP OF EXTG CONC BLOCK WALL ALONGSIDE OF THE CORRIDOR. DETAILS TO COMPLY WITH ULC STANDARDS.. PROVIDE SHOPDWG. FILL EXTG & NEW OPENINGS TO MAINTAIN EXTG FIRE SEPARATION, COMPLY TO ULC RELATED DESIGN NO. AND TO SATISFY BUILDING INSPECTION.

(30) RESERVED.

(57) PROVIDE NEW ACCESS PANEL, CONFIRM SIZES WITH MECH & ELEC. NOT (31) NEW PAINT/ REPAINT INTERIOR WALLS, BULKHEADS, DOOR FRAMES, WALL FIN COVERS. UNIT VENTILATOR COVERS, OLD AND NEW METAL CAPS. PROVIDE NEW PAINT FINISH ON ALL INTERIOR PAINTABLE SURFACES, MAKE ALL THE FINISHES (58) PROVIDE NEW FIRE EXTINGUISHER, NOT SHOWN IN ARCH DWGS. SEE MECH GOOD. SEE FINISH SCHEDULE AND SPECIFICATION. PRIME AND PAINT ALL SURFACES OVER THE OLD PAINTING. SEE PINCHIN REPORT.

(32) RESERVED. (33) PATCH, REPAIR AND PAINT EXISTING FRAME OVER THE OLD PAINT. SEE PINCHIN REPORT. SUPPLY & INSTALL NEW DOOR WITH NEW HARDWARE AND DOOR NUMBER/ROOM NAME SIGN. (CONFIRM DIMENSIONS ON SITE PRIOR TO ORDERING). SÉE DOOR SCHEDULE, SIGNS DETAIL AND SPECIFICATION.

(34) SUPPLY AND INSTALL NEW DOOR AND FRAME AND HARDWARE. CONFIRM DIMENSIONS ON SITE. SEE DOOR SCHEDULE AND SPECIFICATION. GC TO PROVIDE NEW CAULKING ON DOOR FRAME

(35) WINDOWS AND NEW BLINDS: REMOVE DIRT AND DEBRIS FROM WINDOW FRAME AND GLASSES, WASH, CLEAN, REMOVE OXIDATION FROM ALUMINUM FRAME. CHECK OPENING HARDWARE AND REPLACE IT. REMOVE EXTG CAULKING. RE-CAULK AROUND FRAMES INTERIOR SIDE ONLY. MAKE GOOD ALUMINUM WINDOWS & FRAME SO THAT GLASS AND FRAME LOOK AS NEW. SUPPLY AND INSTALL NEW BLINDS TO KPRDSB STANDARDS. PROVIDE CUTSHEET &

(36) EXISTING HM/SCW DOOR, FRAME AND HARDWARE TO REMAIN. EXERCISE CAUTION TO AVOID ANY DAMAGE TO DOOR AND ITS COMPONENTS. IN EVENT OF ANY DAMAGE, GC TO PROMPTLY PATCH, PAINT AND REPAIR ANY DAMAGE DONE TO THE DOOR OR ITS COMPONENTS AND RESTORE THEM TO THEIR ORIGINAL CONDITION AT THEIR OWN COST.

(37) PROVIDE NEW VENTILATION GRILLE CONTINUES AT TOP & BASE OF MILLWORK. REFER TO SPEC & MECH. DWG. SUBMIT CUTSHEET FOR APPROVAL.

(38) ARCHITECTURAL MILLWORK: PROVIDE NEW ARCHITECTURAL MILLWORK INCLUDING TEACHER CLOSETS, BOOKCASE UNITS, SHELVING UNITS, CABINETS, AND SO ON c/w 19MM ADJUSTABLE SHELVES. GC TO REVIEW EXISTING RADIATOR & PLUMBINGS CONTROLS. LOCATE CONTROL AND COORDINATE WITH MILLWORK. PROVIDE AN ACCESS PANEL IN THE MILLWORK IN ORDER TO GAIN ACCESS TO CONTROL FOR FURTHER MAINTENANCE. PNFUMATIC VALVE REMOVAL BY APS, NEW ELECTRIC CONTROLS CONNECTED TO BAS, SEE MECH. AND ELECT. DWGS.SEE A500 SERIES DRAWING, SEE SPEC, PROVIDE SHOPDWG & MOCK UP.

NEW SINK, COUNTERTOP & MILLWORK CABINETS, SEE A300 & A500 SERIES.

(42) NEW DW BULKHEAD & CEILING- PAINTED, INSTALLED ON SHAFTWALL ST STUD SUPPORTS. GC TO PROVIDE MINIMUM 1 HOUR FIRE SEPARATION c/w FIRESTOPS, CAULKING & SMOKE SEAL. PROVIDE P-ENG STAMPED SHOPDWGS FOR STEEL STUD FRAME. TYP.

(43) RESERVED.

(44) CLEAN CEILING AREA THROUGHOUT INCLUDING STRUCTURE, DECKING, ELEC AND MECH ITEMS. REMOVE DIRT, DUST AND AIRBORNE CONTAMINANTS, REMOVE POSSIBLE MOLD AND MILDEW. PAY CLOSE ATTENTION TO ELECTRICAL CONDUITS, CONNECTIONS AND FIXTURES. REPAIR CEILING AND DECK OPENING AFTER REMOVAL OF OLD ELECTRICAL & MECHANICAL, LIGHT FIXTURES, DUCTWORK, DIFFUSERS, PLUMBING PENETRATIONS. PROVIDE FIRE STOP AT OPENINGS TO MAINTAIN 1HR FIRE SEPARATION.

45) SUPPLY AND INSTALL SCHOOL CONTROL PANEL C/W CLOCK, THERMOSTAT, LIGHT SWITCHES, PA CALL SWITCH, PA SPEAKER, DUPLEXES, FIREALARM AND PROVISION FOR SPACE SENSOR. STANDARD COLOUR CHOSEN BY ARCHITECT PROVIDE SHOPDWG. SEE ELECTRICAL DRAWINGS. CLOCKS TO BE BATTERY OPERATED, RO UND, SIMPLEX, TO FIT WITHIN THE SPACE AVAILABLE. CONTROL PANEL TO BE SUPPLIED AND INSTALLED BY ELEC CONTRACTOR.

(46) SUPPLY AND INSTALL NEW WALL-MOUNTED INTEGRATED INTERACTIVE BOARDS DA-LITE IDEA SCREEN COMBINATION PROJECTION SCREEN AND WRITABLE MARKER BOARDS AS MANUFACTURED BY DA-LITE (1800-622-3737). 1350 (H) X 2170 (W) C/W CONTROLS. INSTALL ON STEEL BRACKETS BOLTED. PROVIDE SUPPORTS PER MANUFACTURER GUIDELINE. OWNER WILL REMOVE EXISTING INTEGRATED INTERACTIVE BOARDS, GC TO SUPPLY AND INSTALL NEW. SEE SPECIFICATION. SEE ARCH FLOOR PLAN & ELECTRICAL DRAWINGS.

(47.) NEW WALL-MOUNTED MAGNETIC WHITE BOARD MANUFACTURED BY ARCHITECTURAL SCHOOL PRODUCTS OR EQUIVALENT PRODUCTS AS SUPPLIED BY GLOBAL SCHOOL PRODUCTS INC. PROVIDE SUPPORTS. C/W CLEAR ANODIZED ALUMINUM FRAME. MAP RAIL WITH CORK INSERT. REQ'D DIVIDER STRIP AND MARKER/CHALK TRAY. INSTALL MAP RAIL OVER MARKER BOARDS.

TYPICAL NOTES: (APPLY TO ALL DEMO & PROPOSED DWGS.

CONTRACTOR TO MAKE GOOD ALL FINISHES DISTURBED TO INSTALL ALL COMPONENTS UNDER THIS CONTRACT. REFER BIRCH MILLWORK. GC TO COORDINATE WITH MILLWORK SUPPLIER TO PROVIDE TO ARCH, STR, MECH & ELEC DRAWINGS. PROVIDE 3 SAMPLE COLOURS FOR REVIEW& APPROVAL. ALL CONTROLS SHALL

PROVIDE TEMPORARY HOARDING & DUST SCREENS AS REQUIRED TO COMPLETE WORK. MAINTAIN FIRE EXITS WHERE REQUIRED.

GC. TO ENSURE CONTINUITY OF VAPOUR BARRIER ON ANY HOLES OCCURRING THRU SUCH CEILING / WALL, VAPOUR BARRIERS FOR WIRES, PIPES, DUCTWORK, OR ELECTRICAL COVERS. PANT COLOUR TO MATCH BIRCH MILLWORK. GC TO COORDINATE WITH BOXES. VAPOUR BARRIER MUST BE TIGHTLY SEALED WITH MILLWORK SUPPLIER TO PROVIDE ACCESS DOOR TO ALL VALVES & CONTROLS TAPE, CAULKING OR OTHER SUITABLE MATERIAL. CONSULTANT TO REVIEW PRIOR TO INSTALLATION OF CEILING AND WALL BOARD.

> FIRE STOPPING OF SERVICE PENETRATIONS - PIPING, TUBING, DUCTS, WIRING, CONDUIT, ELECTRICAL OUTLET BOXES THAT PENETRATE FIRE SEPARATIONS SHALL BE TIGHTLY FITTED AND SEALED WITH MINERAL WOOL, GYPSUM PLASTER OR PORTLAND CEMENT MATERIAL, AS PER APPROVED ULC DESIGN COMPONENTS. SUBMIT ULC RELATED DESIGN FOR CONSULTANT TO REVIEW PRIOR TO INSTALLATION AT FLOOR, CEILING OR WALL.

MAINTAIN CONTINUITY OF FIRE SEPARATION BEHIND ALL PROVIDE WITH OCCUPANCY SENSORS, SLIDE DIMMERS TO CONTROL SEPARATE RECESSED ELECTRICAL PANELS, AND F.E.C.

> 6. REMOVE & RESTORE OR REPLACE ALL CEILINGS AFFECTED BY ACCESS TO MECH. & SERVICES. SEE & ELECT. DWGS FOR EXTENT OF WORK.

DISCONNECT OR RELOCATE ALL MECH. & ELECT. SERVICES LOCATED IN EXISTING CEILING, WHICH WILL BE COVERED BY NEW T-BAR OR DRYWALL CEILING.

PROVIDE STEEL ANGLE LINTELS OVER ALL NEW MECHANICAL DUCTS & GRILLES THAT PENETRATE EXISTING & NEW MASONRY WALLS.

WHERE EXISTING FLOORING FINISHES ARE REMOVED, ALLOW FOR PREPARATION OF SUBSTRATE SUITABLE FOR INSTALLATION OF NEW FINISHES AS PER MANUFACTURES REQUIREMENTS.

GENERAL NOTES APPLY TO ALL DEMO & PROPOSED DWG's:

. REFER TO SPECIFICATION

B. THERE IS A TIMETABLE FOR THIS PROJECT, CONSTRUCTION MAY NEED TO BE SCHEDULED WITH ROTATIONAL SHIFTS, NIGHT SHIFTS AND OVER TIME WORK TO AVOID DISRUPTION TO SCHOOL TIME LIMIT. DEADLINES ARE STRICTLY ENFORCED

START AND END OF EACH ACTIVITY BEFORE SUBMITTING THEIR PRICING PROPOSAL ACCURATE EXTENT OF DEMOLITION AND PATCH & REPAIR AREA TO BE SITE VERIFIED. SIZES SHOWN ON DWGS ARE ONLY GRAPHICS. CONTRACTORS TO SITE VISIT, EXAMINE CONDITIONS BEFORE

CONTRACTORS TO CONFIRM WITH PROJECT MANAGER/SCHOOL FOR

SEE SPECIFICATION AND SEPARATE REPORTS FOR SITE CONDITIONS & IDENTIFICATION INCLUDING HAZARDOUS BUILDING MATERIALS WITHIN THE PROJECT AREA, NOTES PROVIDED IN THIS SET OF DRAWINGS ARE FOR GENERAL REFERENCES ONLY. THE CONTRACTORS SHALL FULFILL THE REQUIREMENTS OF THE ONTARIO OCCUPATIONAL HEALTH AND SAFETY ACT AND OTHER REGULATIONS. CONTRACTOR SHALL READ AND FULLY UNDERSTAND ABOVE SPEC AND REPORTS PRIOR TO REMOVAL AND DISPOSAL OR DECONTAMINATION OF ALL MATERIALS

PROVIDE DUST CONTROL MEASURES, SEAL ALL EXTG DUCTWORKS AND OPENINGS AND PROVIDE TEMPORARY EXHAUST PRIOR TO DEMOLITION & CONSTRUCTION.

C. GC MUST SUPPORT THE OWNERS EFFORTS TO PURSUE THE INCENTIVE PROGRAM. TYPICAL AVAILABLE INCENTIVE LIST IS AS FOLLOWS: LIGHTING RETROFITS, LIGHTING CONTROLS, VFDS, COOLING, BOILER RETROFITS, DEMAND-CONTROLLED VENTILATION (CO2 SENSORS), DOMESTIC HOT WATER, HEAT/ENERGY RECOVERY EQUIPMENT, CONDENSING MAKEUP AIR UNITS. CONTRACTORS MUST PROVIDE THE REQUIRED INFORMATION, RECEIPTS, ETC. GC TO CONFIRM THAT SPECIFIED LIGHTING QUALIFIES FOR THE INCENTIVE, PROVIDE CUT-SHEETS.

PAINT, INCLUDING SANDING, CLEANING, PATCHING, AND CAULKING. REMOVE, SCRAPE OFF, SAND OLD PAINT COATINGS. FILL, REPAIR CRACKS, SAND AND MAKE GOOD DAMAGED, DENT SURFACES & SCRATCHES. TEST OVER-COATABILITY/ RE-COATABILITY. SEAL, PRIME AND PAINT EXISTING AND NEW WALL, CEILING, DOOR & FRAME SURFACES AS INDICATED, CLEAN UP. ON WOODEN DOOR OLD STAIN COATING SHALL BE REMOVED COMPLETELY. APPLY 4 COATS OF URETHANE VARNISH OVER SEMI-TRANSPARENT STAIN ON WOOD DOOR. PAINT PREVIOUSLY PAINTED CONDUITS AND PIPING. PAINT FINISHES TO MATCH EXTG. PROVIDE MULTIPLE MOCK UP /SAMPLES FOR BOTH WALL & DOOR PAINTS.

PROVIDE SIGNAGE FOR EACH DOOR AND ROOM. ALL SIGNAGE TO COMPLY PRIOR TO MANUFACTURE. SEE DETAIL A801.

EXTEND FLOORING INTO ENTRY DOORS. PROVIDE FLUSH METAL EMBEDDED

LOCATION OF ALL MECHANICAL, PLUMBING, AND ELECTRICAL ROUGH-INS SHALL BE COORDINATED WITH MILLWORK SHOPDWG BEFORE INSTALLATION OF MECHANICAL, PLUMBING & ELECTRICAL AND FABRICATION OF MILLWORK. PROVIDE SHOPDWG FOR UTILITIES ROUGH-INS /OPENINGS LAYOUT

FIRST AID KITS. CONFIRM LOCATION ON SITE WITH OWNER.

UNITS. TYP.

H. PAINTING & REPAINTING: PREPARE SUBSTRATES TO ACCEPT NEW THE CONTRACTOR SHALL CHECK ALL DIMENSIONS AND REPORT DISCREPANCIES TO THE ARCHITECT. ALL DIMENSIONS ARE GIVEN IN MILLIMETRES UNLESS OTHERWISE INDICATED DO NOT SCALE DRAWINGS.

WITH OWNER/SCHOOL CRITERIA & OBC. SUBMIT SIGNAGE SHOP DRAWING

TRANSITION STRIP LOCATED AT LINE OF ENTRY DOORS.

GENERAL CONTRACTOR TO INSTALL PAPER TOWEL DISPENSER &

M. SUPPLY AND INSTALL NEW FLOOR FINISH BELOW NEW MILLWORK

MAR. 12, 2024 ISSUED FOR TENDER APR. 12, 2024 | ADDENDUM #1

LEGEND

ALL DRAWINGS ARE THE PROPERTY OF THE ARCHITECT AND MUST BE RETURNED ON REQUEST.

REVISIONS AND DISTRIBUTION LOG



EXISTING CONSTRUCTION TO REMAIN.

EXISTING GRID TO REMAIN. (SHOWN TONED)

NOTES APPLY TO ALL DEMOLITION & PROPOSED DRAWINGS INCLUDING MECHANICAL AND ELECTRICAL DRAWINGS CONTRACTORS & SUBTRADE, INCLUDING MECH & ELEC TRADES SHALL READ THE WHOLE SET TOGETHER BEFORE PRICING. GC TO CONFIRM

REFER TO A100 FOR GENERAL NOTES.

REFER TO A100 FOR REFERENCE/TAGS

REFER TO D201, D203, A201, A203, A500 & A800 FOR NOTES

REFER TO A501 FOR FLOORING FINISH PATTERN

DEMOLITION OF HAZARDOUS MATERIALS TYPICAL:

G.C. TO REFER TO HAZARDOUS BUILDING MATERIALS ASSESSMENT REPORT ALONG WITH SPECIFICATIONS AND CONTRACT DOCUMENTS PREPARED BY PINCHIN REGARDING THE REMOVAL AND DEMOLITION OF HAZARDOUS MATERIALS.





20 Camden, Suite 101 Toronto, Ontario M5V 1V1 www.cmvarch.com

T 416.506.1600 F 416.506.0956

DR MS HAWKINS SR.PS

CLASSROOMS 233-235-244-245-246-247 RENOVATION KAWARTHA PINE RIDGE DISTRICT SCHOOL BOARD

130 HIGHLAND DRIVE PORT HOPE

PARTIAL FLOOR PLAN

OM 23A117 Date Plotted Apr 12, 2024 - 1:52pm **AS NOTED** evision No.

ONTARIO

ARCH D

(49) CABINET UNIT HEATER: CLEAN AND COMB EXISTING CABINET UNIT HEATER,

(50) UNIT VENTILATORS: CLEAN AND COMB EXISTING UNIT VENTILATORS, WALLFIN

APPROVAL. ALL CONTROLS SHALL TIE INTO THE BAS. SEE MECH DWG.

(51.) RADIATOR: CLEAN AND COMB EXISTING RADIATOR, WALLFIN AND COVERS.

COVERS, GC TO SITE VERIFY CONDITIONS. FIX & FASTEN LOOSE COVER

PARTS. REPAIR DENTS & SCRATCHES, APPLY NEW PAINT ON ENTIRE UNIT

TIE INTO THE BAS. SEE MECH DWG.

WALLFIN AND COVERS. REPAIR DAMAGED/DEFORMED CABINET UNIT HEATER

FASTEN LOOSE COVER PARTS, REPAIR DENTS & SCRATCHES, APPLY NEW

PAINT ON ENTIRE CABINET UNIT HEATER COVERS. PANT COLOUR TO MATCH

ACCESS DOOR TO ALL VALVES & CONTROLS AND MATCHING PAINT COLOUR.

AND COVERS. REPAIR DAMAGED/DEFORMED UNIT COVERS OR PROVIDE NEW

AND MATCHING PAINT COLOUR. PROVIDE 3 SAMPLES COLOUR FOR REVIEW&

REPAIR DAMAGED / DEFORMED RADIATOR COVERS OR PROVIDE NEW COVERS.

GC TO SITE VERIFY CONDITIONS. FIX & PAINT ON ENTIRE RADIATOR. PAINT

COLOUR TO MATCH BIRCH MILLWORK. GC TO COORDINATE WITH MILLWORK

SUPPLIER TO PROVIDE ACCESS DOOR TO ALL VALVES & CONTROLS AND

MATCHING PAINT COLOUR. PROVIDE 3 SAMPLE COLOURS FOR REVIEW &

APPROVAL. ALL CONTROLS SHALL TIE INTO THE BAS. SEE MECH. DWGS.

(55.) PROVIDE S.S. CUSTOM SIZED COVER PLATE ON ABANDONED ELEC OUTLET

OPENING, AND AROUND DIFFUSES. ALL LOCATIONS NOT SHOWN ON THIS DWG.

SHOWN ON THIS DRAWING SET GC TO SITE VERIFY EXACT LOCATION. PAINTED

(59.) COMPREHENSIVE FIRST AID KIT, SUPPLIED BY OWNER, INSTALLED BY GC. NOT

(60.) EXISTING COVER PLATES TO REMAIN. PROVIDE NEW LVT FLOORING IN AND

AROUND THE EXISTING COVER PLATES. TYPICAL OF 6 COVER PLATES.

SHOWN IN THIS SET. GC TO COORDINATE WITH OWNER FOR NO. & LOCATIONS

(52.) ALL EXISTING LIGHT FIXTURES TO REMAIN. SEE ELECTRICAL DRAWINGS.

ROWS OF LIGHTS. COORDINATE W ELEC ENG.

GC TO SITE VERIFY, TYPICAL.

(56,) RESERVED.

(54.) NEW MECH DIFFUSER AND GRILLE SEE MECH DWG

COVERS OR PROVIDE NEW COVERS, GC TO SITE VERIFY CONDITIONS. FIX &


39) ARCHITECTURAL MILLWORK: NEW COAT HOOKS. SEE A800 SERIES SEE SPEC, PROVIDE SHOPDWG.

SEE SPECIFICATIONS.

(41) NEW 1HR FFR T-BAR CEILING c/w NEW LIGHT FIXTURES, DIFFUSERS, SEE MECH & ELEC DWGS. 1HR FIRE RATED CEILING TO COMPLY WITH ULC #P210 - 610MM X 1220MM, MIN. NRC OF .70, CAC MIN. 40, FIRE GUARD; CGC RADAR HIGH NRC/CAC PANELS 22541 OR ARMSTRONG SCHOOL ZONE FINE FISSURED 1811. LAY IN EXPOSED TEE SYSTEM "DX" 24MM WIDE FACED T-BAR BY CGC OR SUSPENSION SYSTEM EQUIVALENT GRID BY CHICAGO METALLIC. OR ARMSTRONG WITH COMPATIBILITY CEILING TILES. GRID IS RATED. ALL TILE AND SUSPENSION SYSTEMS SHALL BE FIRE RATED TO CONFORM TO U.L.C. DETAIL P210. SOUND ABSORPTIVE PREFABRICATED ACOUSTICAL UNITS SHALL COMPLY TO CAN/CGSB 92.1. PROVIDE LAYOUT SHOPDWG AND


SPECIALTIES, EQUIPMENT & ACCESSORIES

(48.) CHARGING STATION, PROVIDED BY OWNER, GC TO COORDINATE FOR LAYOUT OF POWER RECEPTACLES & INSTALLATION. RELOCATE EXISTING TOWERS WHERE SHOWN ON DRAWINGS. SEE ELEC. DWG.

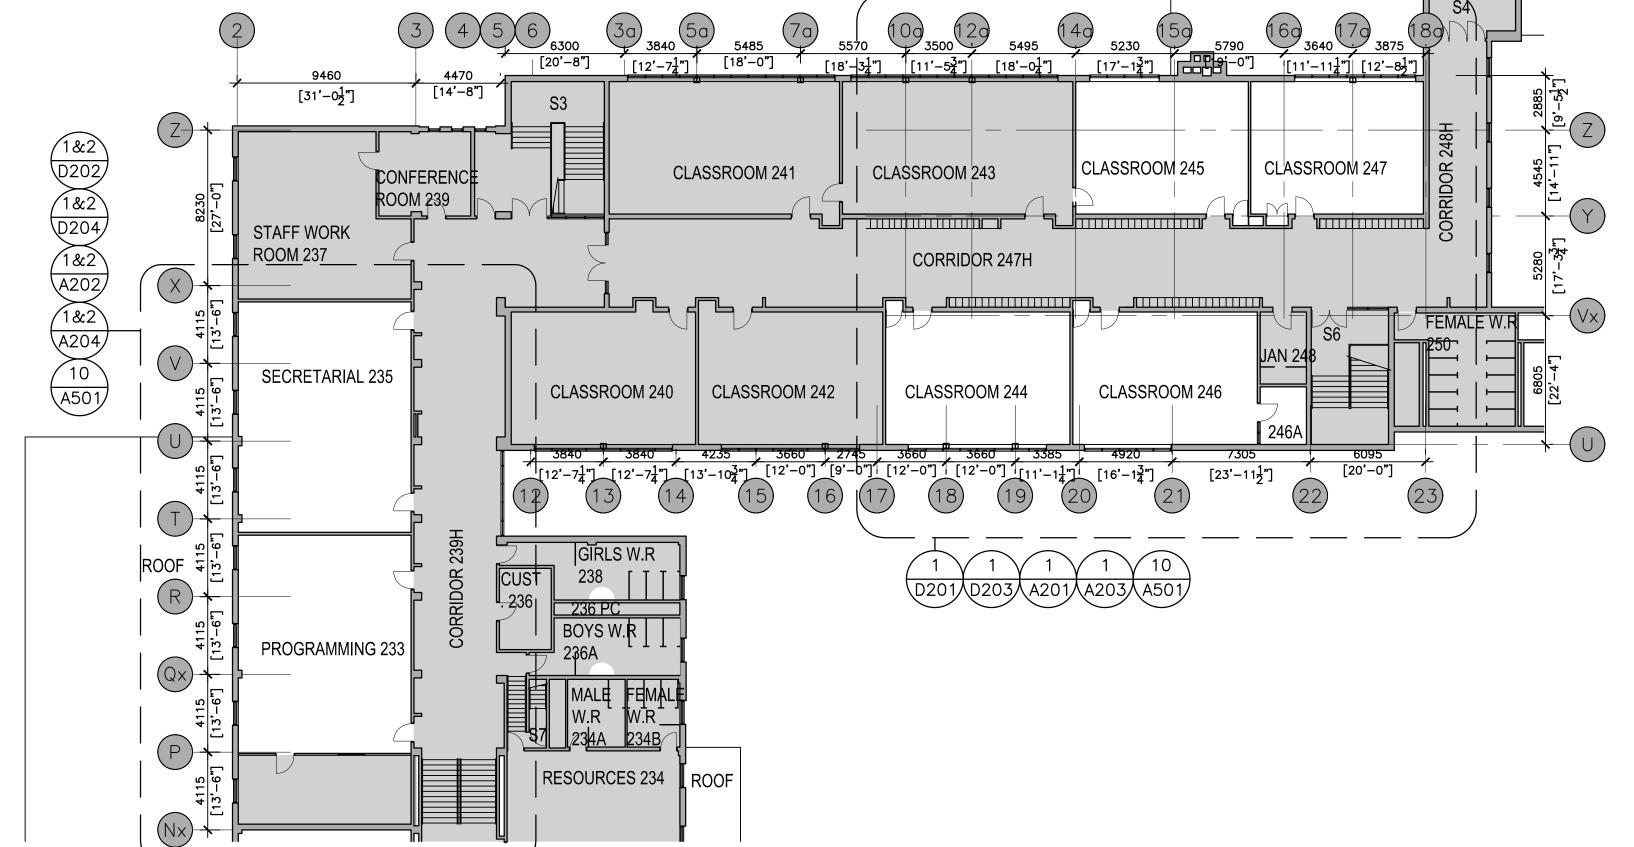

COND FLOOR PLAN

SCALE: 1:200

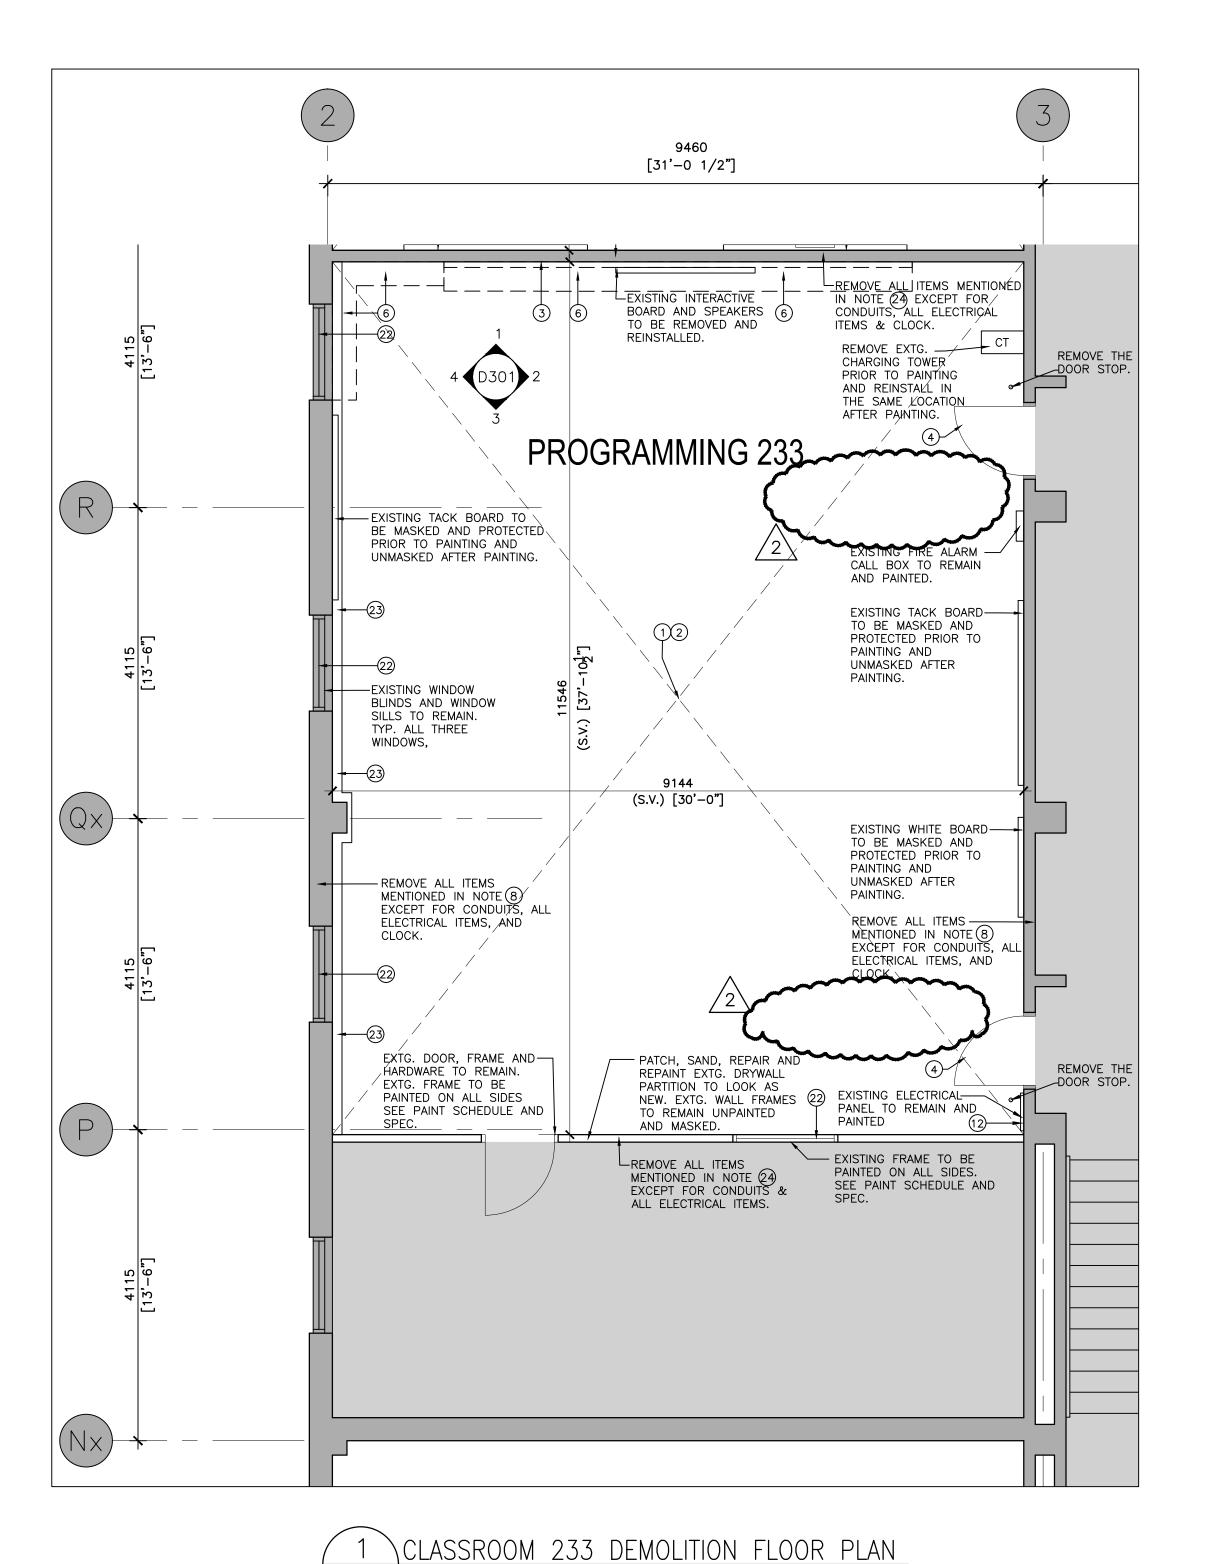

SCALE: 1:50

[31'-0 1/2"] EXISTING CHARGING (2) TYP TOWER TO BE REMOVE ALL ITEMS
MENTIONED IN NOTE (24) 6
EXCEPT FOR CONDUITS, ALL REMOVED & RELOCATED PRIOR TO PAINTING. SEE DRAWINGS A202 & ELECTRICAL ITEMS & A301 FOR NEW LOCATION. EXISTING ELÉCTRICAL PANEL TO REMAIN - REMOVE THE DOOR STOP. œ 2A TYP. °——(2A) TYP. EXISTING WHITE BOARD -EXISTING TACK BOARD TO BE TO BE MASKED AND PROTECTED MASKED AND PROTECTED PRIOR AND UNMASKED AFTER PAINTING. TO PAINTING AND UNMASKED AFTER PAINTING. (S.V.) [30'-0"] 23 (2) TYP. œ—②A TYP. -EXISTING WINDOW BLINDS AND WINDOW SILLS TO REMAIN. TYP. ALL THREE WINDOWS, EXISTING INTERACTIVE BOARD,-SPEAKERS, AND PROJECTOR TO BE REMOVED PRIOR TO PAINTING AND REINSTALLED AFTER PAINTING. — REMOVE ALL ITEMS MENTIONED IN NOTE (8) EXCEPT FOR CONDUITS, ALL ELECTRICAL EXISTING WHITE BOARD TO BE MASKED AND PROTECTED AND UNMASKED AFTER PAINTING.-ITEMS, AND CLOCK. ⊶—(2A) TYP. REMOVE ALL ITEMS — MENTIONED IN NOTE (8) EXCEPT FOR CONDUITS, ALL ELECTRICAL ITEMS, AND CLOCK. _ EXTG MILLWORK EXTG SINK TO REMAIN. TO REMAIN AND PROTECTED. ROOF REMOVE ALL ITEMS
MENTIONED IN NOTE (24)
EXCEPT FOR CONDUITS, ALL
ELECTRICAL ITEMS AND EXTG TACK BOARD TO BE MASKED AND EXTG BLACK BOARD PROTECTED PRIOR TO TO BE MASKED AND PROTECTED PRIOR
PAINTING AND PAINTING AND UNMASKED AFTER REMOVE THE PAINTING. UNMASKED AFTER DOOR STOP. <u>PAINTING</u>. <u>--REMOVE ALLIITEMS MENTIONÉ</u>

2 CLASSROOM 235 DEMOLITION FLOOR PLAN D202 SCALE: 1:50

ALL DRAWINGS ARE THE PROPERTY OF THE ARCHITECT AND MUST BE RETURNED ON REQUEST.

THE CONTRACTOR SHALL CHECK ALL DIMENSIONS AND REPORT DISCREPANCIES TO THE ARCHITECT.

DISCREPANCIES TO THE ARCHITECT.

ALL DIMENSIONS ARE GIVEN IN MILLIMETRES UNLESS OTHERWISE INDICATED.

DO NOT SCALE DRAWINGS.

No. Date Note

1 MAR. 12, 2024 ISSUED FOR TENDER

APR. 12 2024 ADDENDUM #1

<u>LEGEND</u>

GRID

EXISTING CONSTRUCTION TO REMAIN.

EXISTING GRID TO REMAIN. (SHOWN TONED)

REFER TO DRAWING A200 FOR REFERENCE NOTES. (TYPICAL)

NOTES APPLY TO ALL DEMOLITION & PROPOSED DRAWINGS INCLUDING MECHANICAL AND ELECTRICAL DRAWINGS. CONTRACTORS & SUBTRADE, INCLUDING MECH & ELEC TRADES SHALL READ THE WHOLE SET TOGETHER BEFORE PRICING. GC TO CONFIRM

- REFER TO A100 FOR GENERAL NOTES.
- REFER TO A100 FOR REFERENCE/TAGS
- REFER TO D201, D203, A201, A203, A500 & A800 FOR NOTES
- REFER TO A501 FOR FLOORING FINISH
 PATTERN

DEMOLITION OF HAZARDOUS MATERIALS TYPICAL:

G.C. TO REFER TO HAZARDOUS BUILDING MATERIALS ASSESSMENT REPORT ALONG WITH SPECIFICATIONS AND CONTRACT DOCUMENTS PREPARED BY PINCHIN REGARDING THE REMOVAL AND DEMOLITION OF HAZARDOUS MATERIALS.







20 Camden, Suite 101
Toronto, Ontario
M5V 1V1
www.cmvarch.com

T 416.506.1600 F 416.506.0956

Project:

DR MS HAWKINS SR.PS

CLASSROOMS 233-235-244-245-246-247 RENOVATION
KAWARTHA PINE RIDGE DISTRICT SCHOOL BOARD


130 HIGHLAND DRIVE PORT HOPE

ONTARIO

CLASSROOMS 233 AND 235
DEMOLITION FLOOR PLAN


Drawn By:	Checked By:	Date Checked:	Project No.
TJ	OM		23A117
Date Plotted:	•	Scale:	
Apr 12, 2024 - 1:53pm			AS NOTED
Drawing No.:			Revision No.:
D202 2			

ARCH D

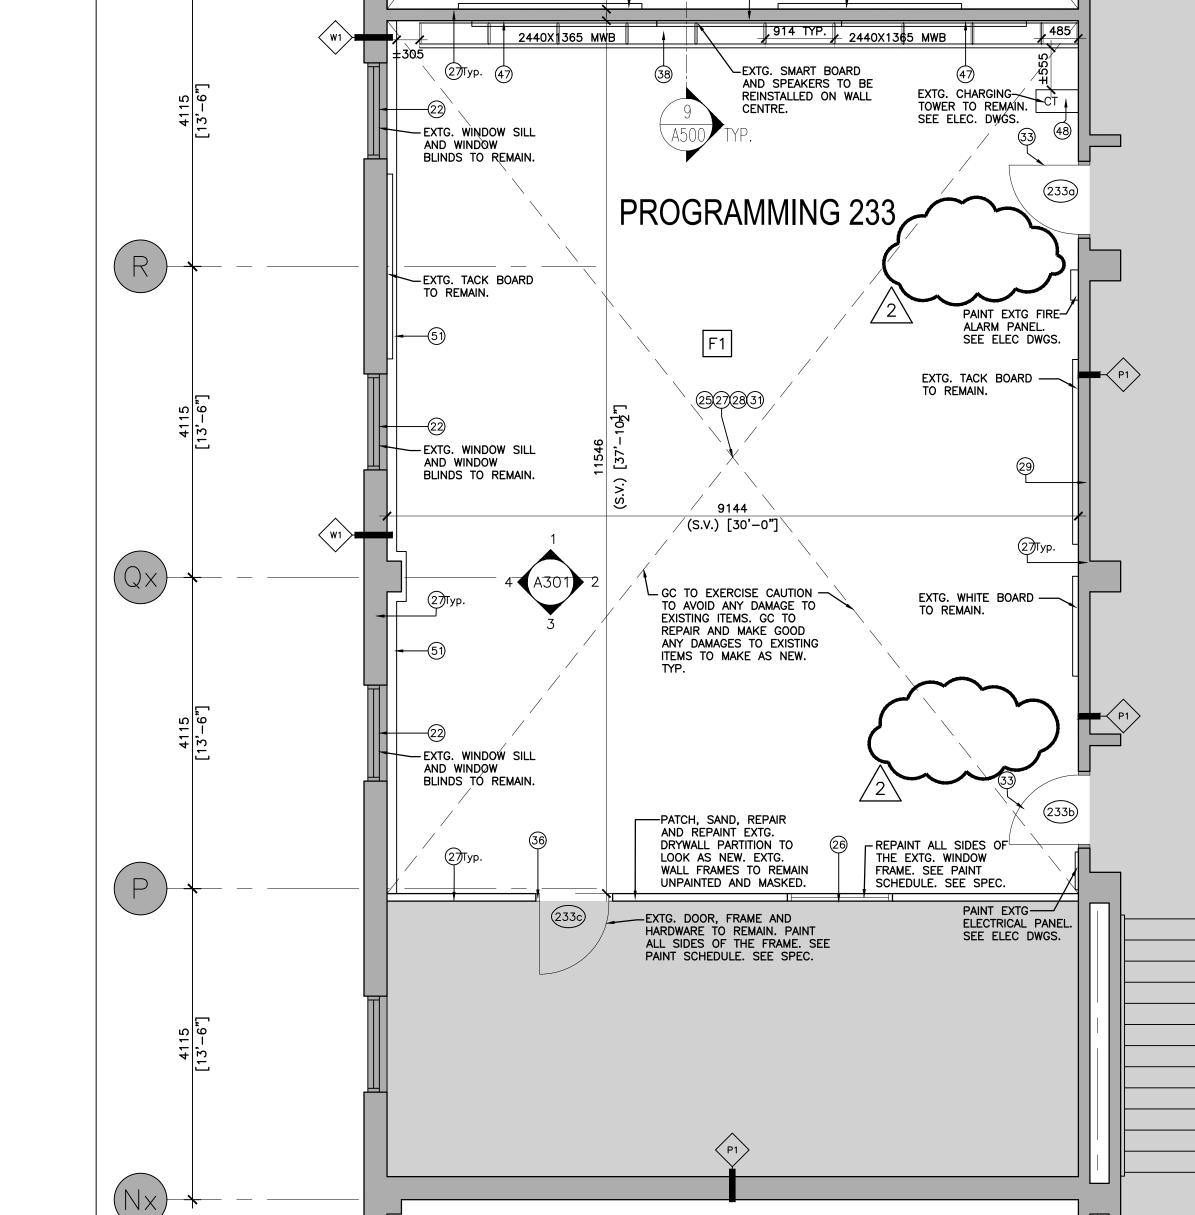

9460 [31'-0 1/2"]

CLASSROOM 233 PROPOSED FLOOR PLAN SCALE: 1:50

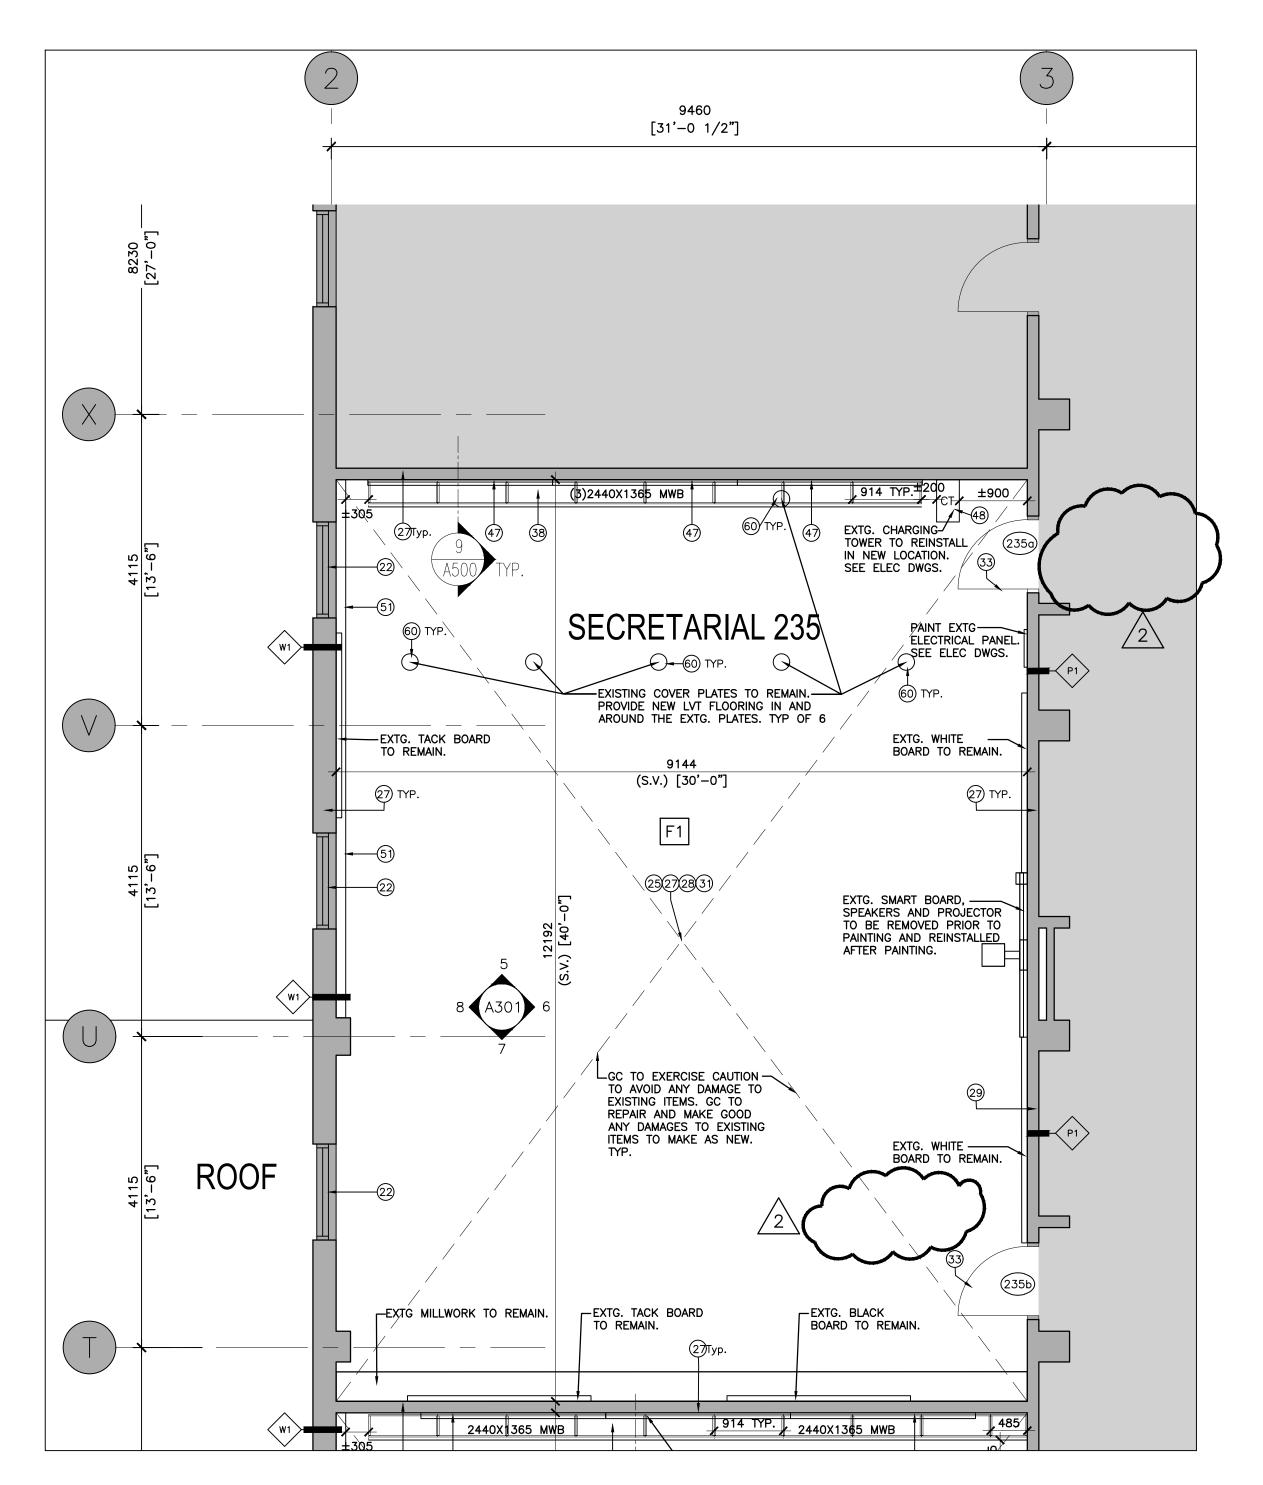

CLASSROOM 235 PROPOSED FLOOR PLAN SCALE: 1:50

ALL DRAWINGS ARE THE PROPERTY OF THE ARCHITECT AND MUST BE RETURNED ON REQUEST. THE CONTRACTOR SHALL CHECK ALL DIMENSIONS AND REPORT DISCREPANCIES TO THE ARCHITECT.

ALL DIMENSIONS ARE GIVEN IN MILLIMETRES UNLESS OTHERWISE INDICATED. DO NOT SCALE DRAWINGS.

REVISIONS AND DISTRIBUTION LOG

No. Date MAR. 12, 2024 ISSUED FOR TENDER 2 APR. 12, 2024 ADDENDUM #1

LEGEND



EXISTING CONSTRUCTION TO REMAIN.

EXISTING GRID TO REMAIN. (SHOWN TONED)

REFER TO DRAWING A200 FOR REFERENCE NOTES. (TYPICAL)

NOTES APPLY TO ALL DEMOLITION & PROPOSED DRAWINGS INCLUDING MECHANICAL AND ELECTRICAL DRAWINGS. CONTRACTORS & SUBTRADE, INCLUDING MECH & ELEC TRADES SHALL READ THE WHOLE SET TOGETHER BEFORE PRICING. GC TO CONFIRM

- REFER TO A100 FOR GENERAL NOTES.
- REFER TO A100 FOR REFERENCE/TAGS
- REFER TO D201, D203, A201, A203, A500 & A800 FOR NOTES
- REFER TO A501 FOR FLOORING FINISH PATTERN

DEMOLITION OF HAZARDOUS MATERIALS TYPICAL:

G.C. TO REFER TO HAZARDOUS BUILDING MATERIALS ASSESSMENT REPORT ALONG WITH SPECIFICATIONS AND CONTRACT DOCUMENTS PREPARED BY PINCHIN REGARDING THE REMOVAL AND DEMOLITION OF HAZARDOUS MATERIALS.





CMV GROUP Earchitects

20 Camden, Suite 101 Toronto, Ontario M5V 1V1 www.cmvarch.com

T 416.506.1600 F 416.506.0956

DR MS HAWKINS SR.PS

CLASSROOMS 233-235-244-245-246-247 RENOVATION KAWARTHA PINE RIDGE DISTRICT SCHOOL BOARD

130 HIGHLAND DRIVE PORT HOPE

ONTARIO


CLASSROOMS 233 AND 235 PROPOSED FLOOR PLAN

Drawn By:	Checked By:	Date Checked:	Project No.
TJ	ОМ		23A117
Date Plotted:			Scale:
Apr 12, 2024 - 1:55pm			AS NOTED
Drawing No.:			Revision No.:
	2		

ARCH D

(12a) CLASSROOM 246A- WEST INT. ELEV.

D300 SCALE: 1:75

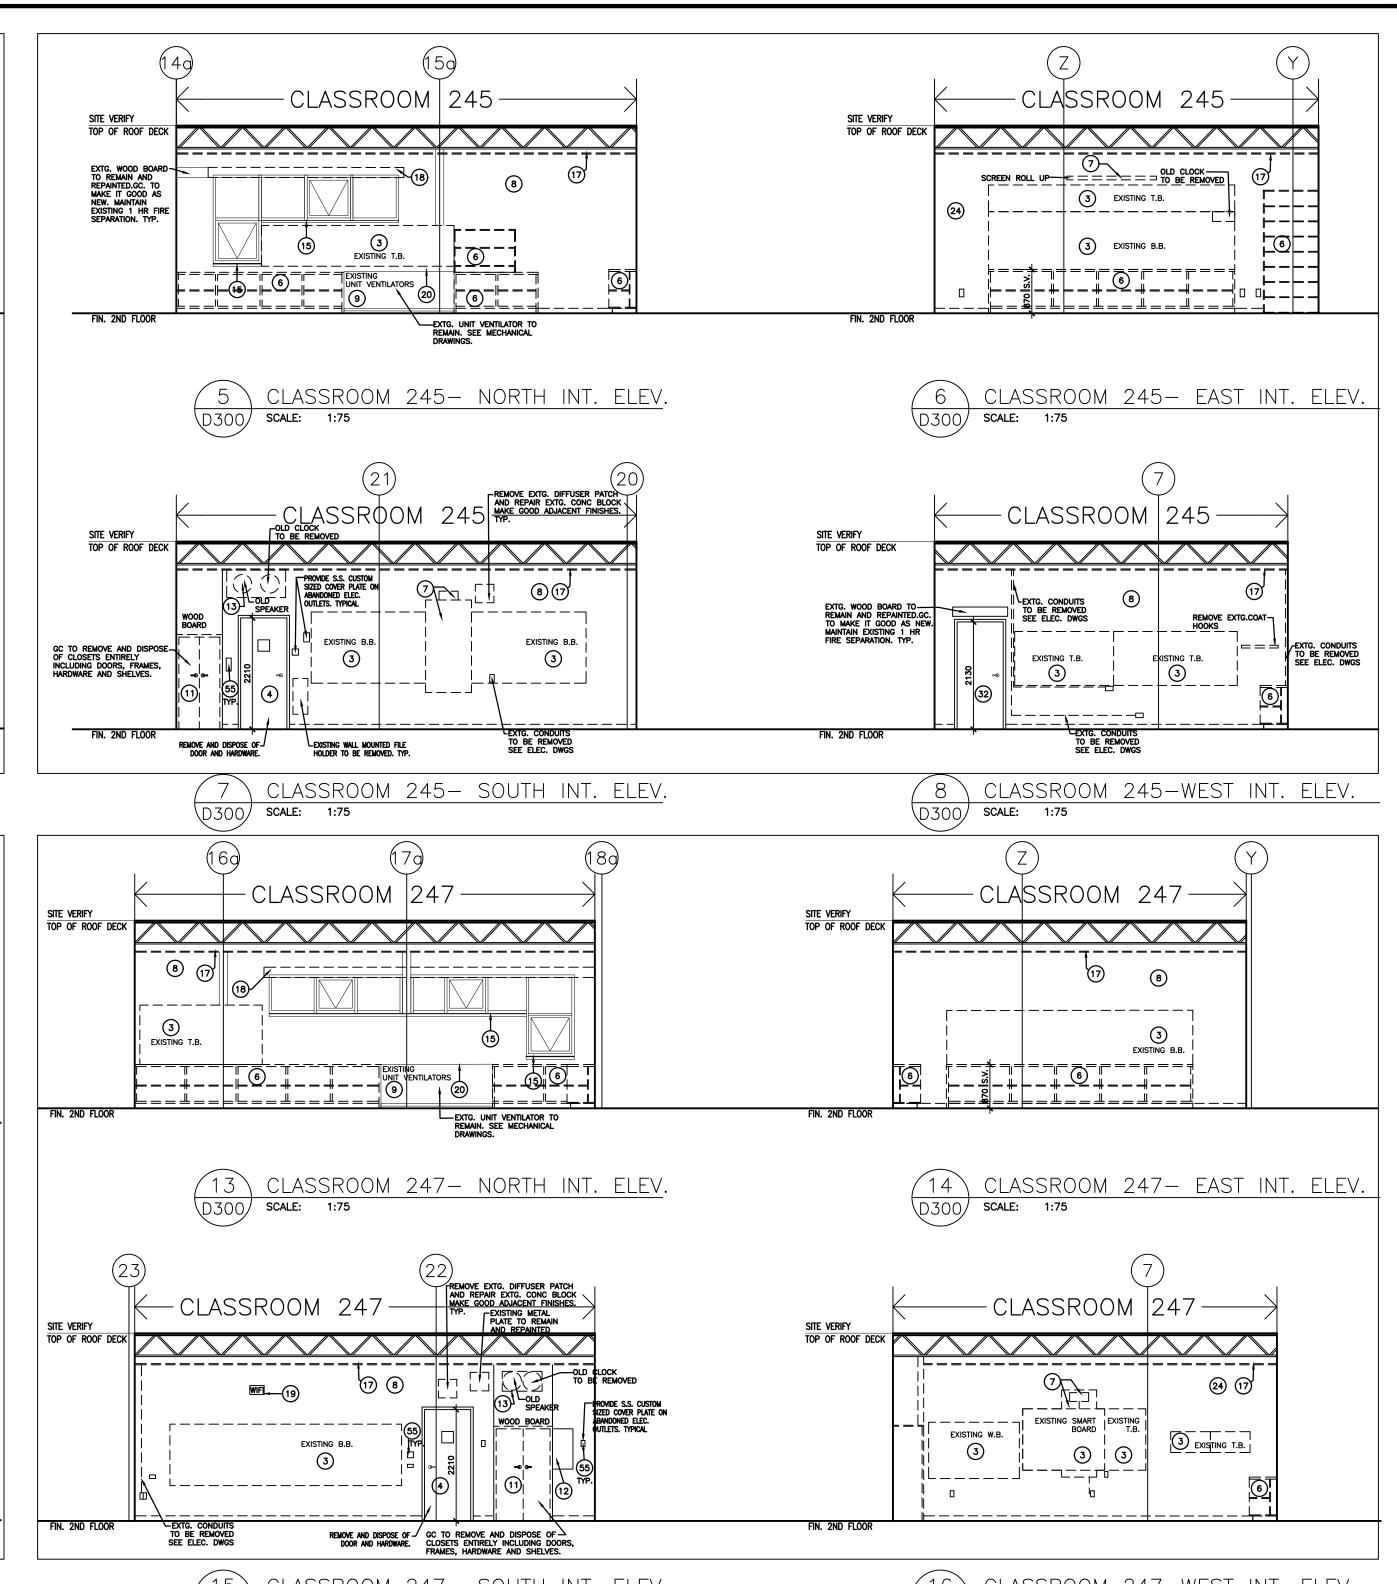

CLASSROOM 247- SOUTH INT. ELEV. SCALE: 1:75

16 CLASSROOM 247-WEST INT. ELEV. D300 SCALE: 1:75



20 Camden, Suite 101 Toronto, Ontario M5V 1V1 www.cmvarch.com

T 416.506.1600 F 416.506.0956

DR MS HAWKINS SR.PS

CLASSROOMS 233-235-244-245-246-247 RENOVATION KAWARTHA PINE RIDGE DISTRICT SCHOOL BOARD

CMV GROUP

ONTARIO

130 HIGHLAND DRIVE

PORT HOPE

DEMOLITION INTERIOR **ELEVATIONS**

Drawn By: Che	ecked By:	Date Checked:	Project No.
TJ (ОМ		23A117
Date Plotted:			Scale:
Apr 12, 2024 - 1:57pm			AS NOTED
Drawing No.:			Revision No.:
D	2		

(10a) CLASSROOM 246A— EAST INT. ELEV.

D300 SCALE: 1:75

ALL DRAWINGS ARE THE PROPERTY OF THE ARCHITECT AND MUST BE RETURNED ON REQUEST.

REVISIONS AND DISTRIBUTION LOG Date MAR. 12, 2024 | ISSUED FOR TENDER APR. 12, 2024 | ADDENDUM #1


REFER TO DEMO FLOOR PLANS (D200 SERIES) AND PROPOSED FLOOR PLANS (A200 SERIES) FOR SCOPE OF DEMOLITION. (TYPICAL)


REFER TO A200 FOR PREFERENCE NOTES (TYPICAL)

NOTES APPLY TO ALL DEMOLITION & PROPOSED DRAWINGS INCLUDING MECHANICA AND ELECTRICAL DRAWINGS. CONTRACTORS SHALL READ THE WHOLE SET TOGETHER BEFORE PRICING. GC TO COORDINATE

DEMOLITION OF HAZARDOUS MATERIALS TYPICAL:

G.C. TO REFER TO HAZARDOUS BUILDING MATERIALS ASSESSMENT REPORT ALONG WITH SPECIFICATIONS AND CONTRACT DOCUMENTS PREPARED BY PINCHIN REGARDING THE REMOVAL AND DEMOLITION OF HAZARDOUS MATERIALS.

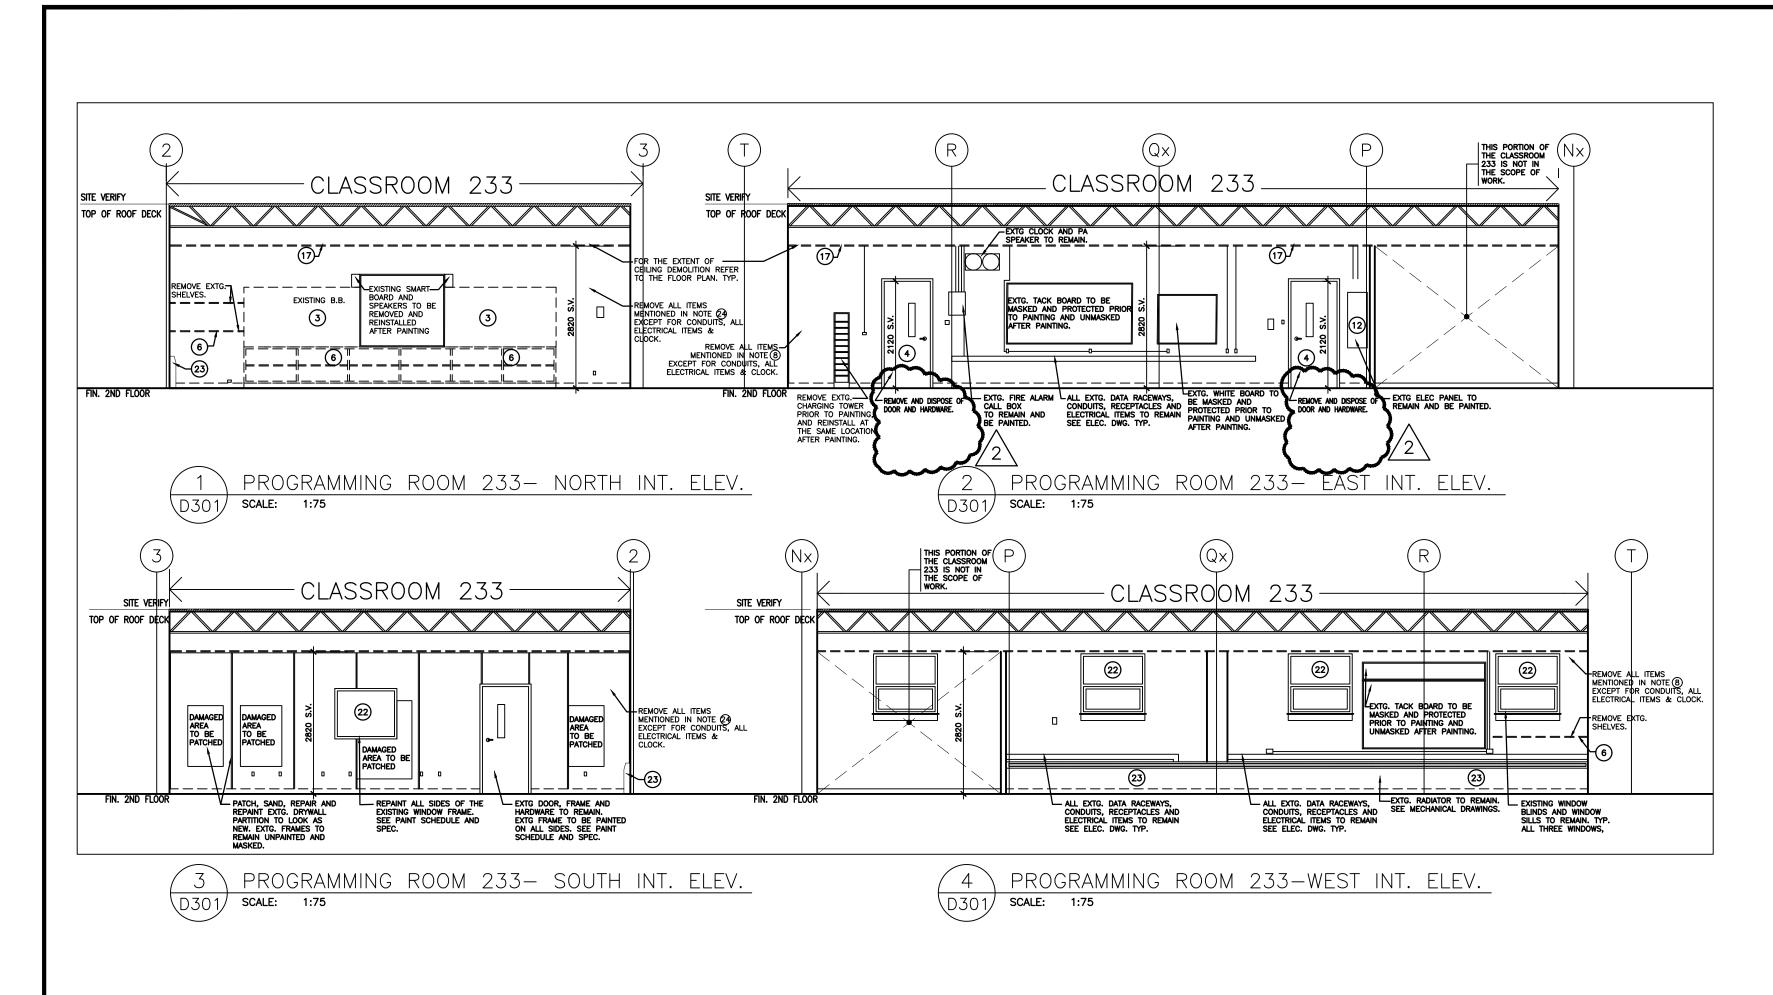

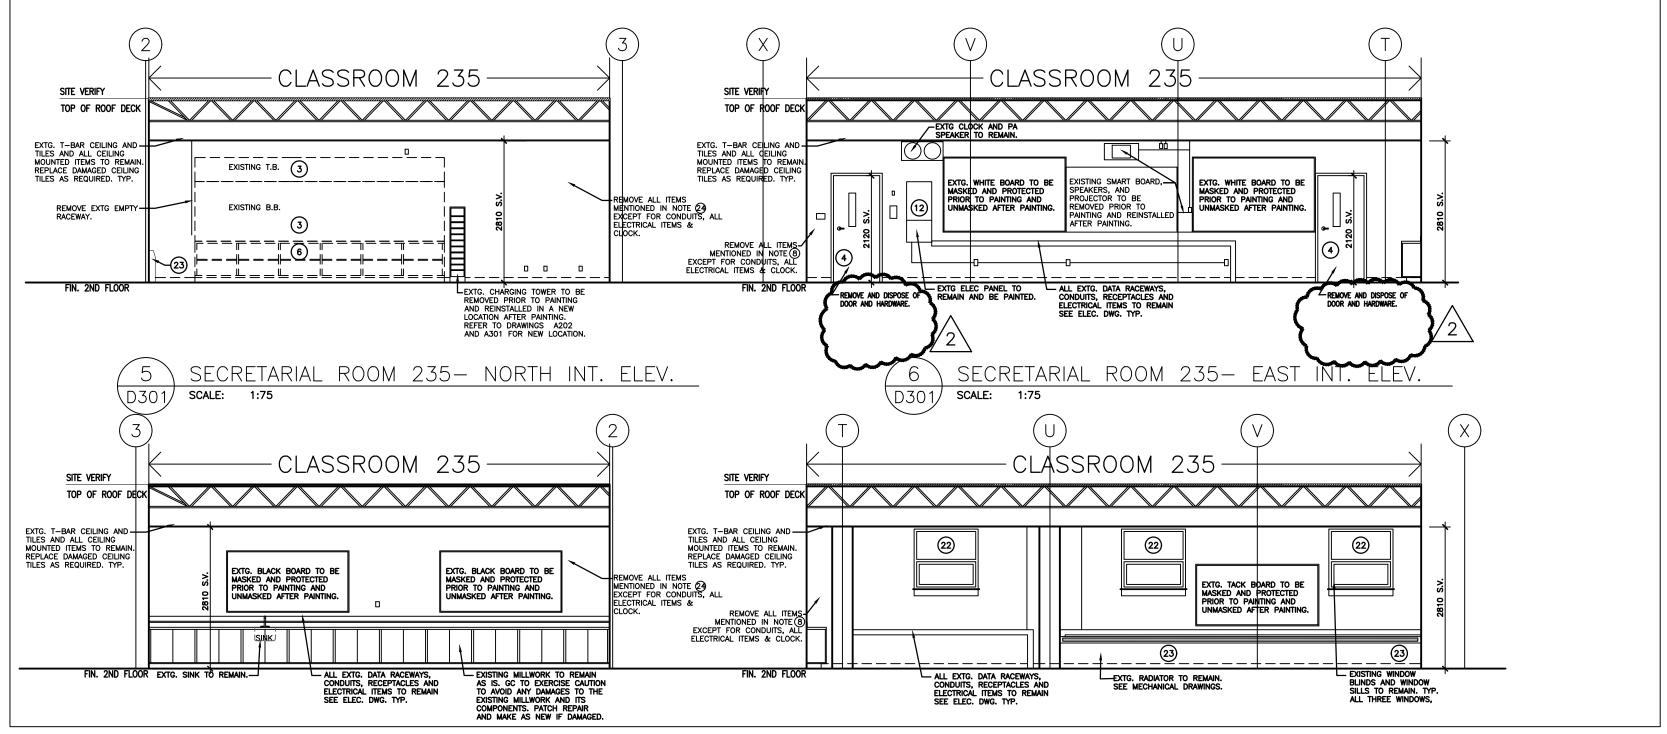

7 SECRETARIAL ROOM 235— SOUTH INT. ELEV. D301 SCALE: 1:75

8 SECRETARIAL ROOM 235-WEST INT. ELEV. D301 SCALE: 1:75

ALL DRAWINGS ARE THE PROPERTY OF THE ARCHITECT AND MUST BE RETURNED ON REQUEST.

THE CONTRACTOR SHALL CHECK ALL DIMENSIONS AND REPORT

THE CONTRACTOR SHALL CHECK ALL DIMENSIONS AND REPORT DISCREPANCIES TO THE ARCHITECT.

ALL DIMENSIONS ARE GIVEN IN MILLIMETRES UNLESS OTHERWISE INDICATED ON NOT SCALE DRAWINGS.

REVISIONS AND DISTRIBUTION LOG

No.	Date	Note
1	MAR. 12, 2024	ISSUED FOR TENDER
2	APR. 12, 2024	ADDENDUM #1

REFER TO DEMO FLOOR PLANS (D200 SERIES) AND PROPOSED FLOOR PLANS (A200 SERIES) FOR SCOPE OF DEMOLITION. (TYPICAL)

REFER TO A200 FOR PREFERENCE NOTES (TYPICAL)

NOTES APPLY TO ALL DEMOLITION & PROPOSED DRAWINGS INCLUDING MECHANICAL AND ELECTRICAL DRAWINGS. CONTRACTORS SHALL READ THE WHOLE SET TOGETHER BEFORE PRICING. GC TO COORDINATE

DEMOLITION OF HAZARDOUS MATERIALS TYPICAL:

G.C. TO REFER TO HAZARDOUS BUILDING MATERIALS ASSESSMENT REPORT ALONG WITH SPECIFICATIONS AND CONTRACT DOCUMENTS PREPARED BY PINCHIN REGARDING THE REMOVAL AND DEMOLITION OF HAZARDOUS MATERIALS.



CMV GROUP Earchitects

20 Camden, Suite 101
Toronto, Ontario
M5V 1V1
www.cmvarch.com

T 416.506.1600 F 416.506.0956

DR MS HAWKINS SR.PS

CLASSROOMS 233-235-244-245-246-247 RENOVATION
KAWARTHA PINE RIDGE DISTRICT SCHOOL BOARD

130 HIGHLAND DRIVE PORT HOPE

ONTARIO

DEMOLITION INTERIOR
ELEVATIONS

Drawn By: Checked By: Date Checked: Project No.

23A117


Date Plotted: Scale:

Apr 12, 2024 - 1:58pm AS NOTED

Drawing No.: Revision No.:

D301



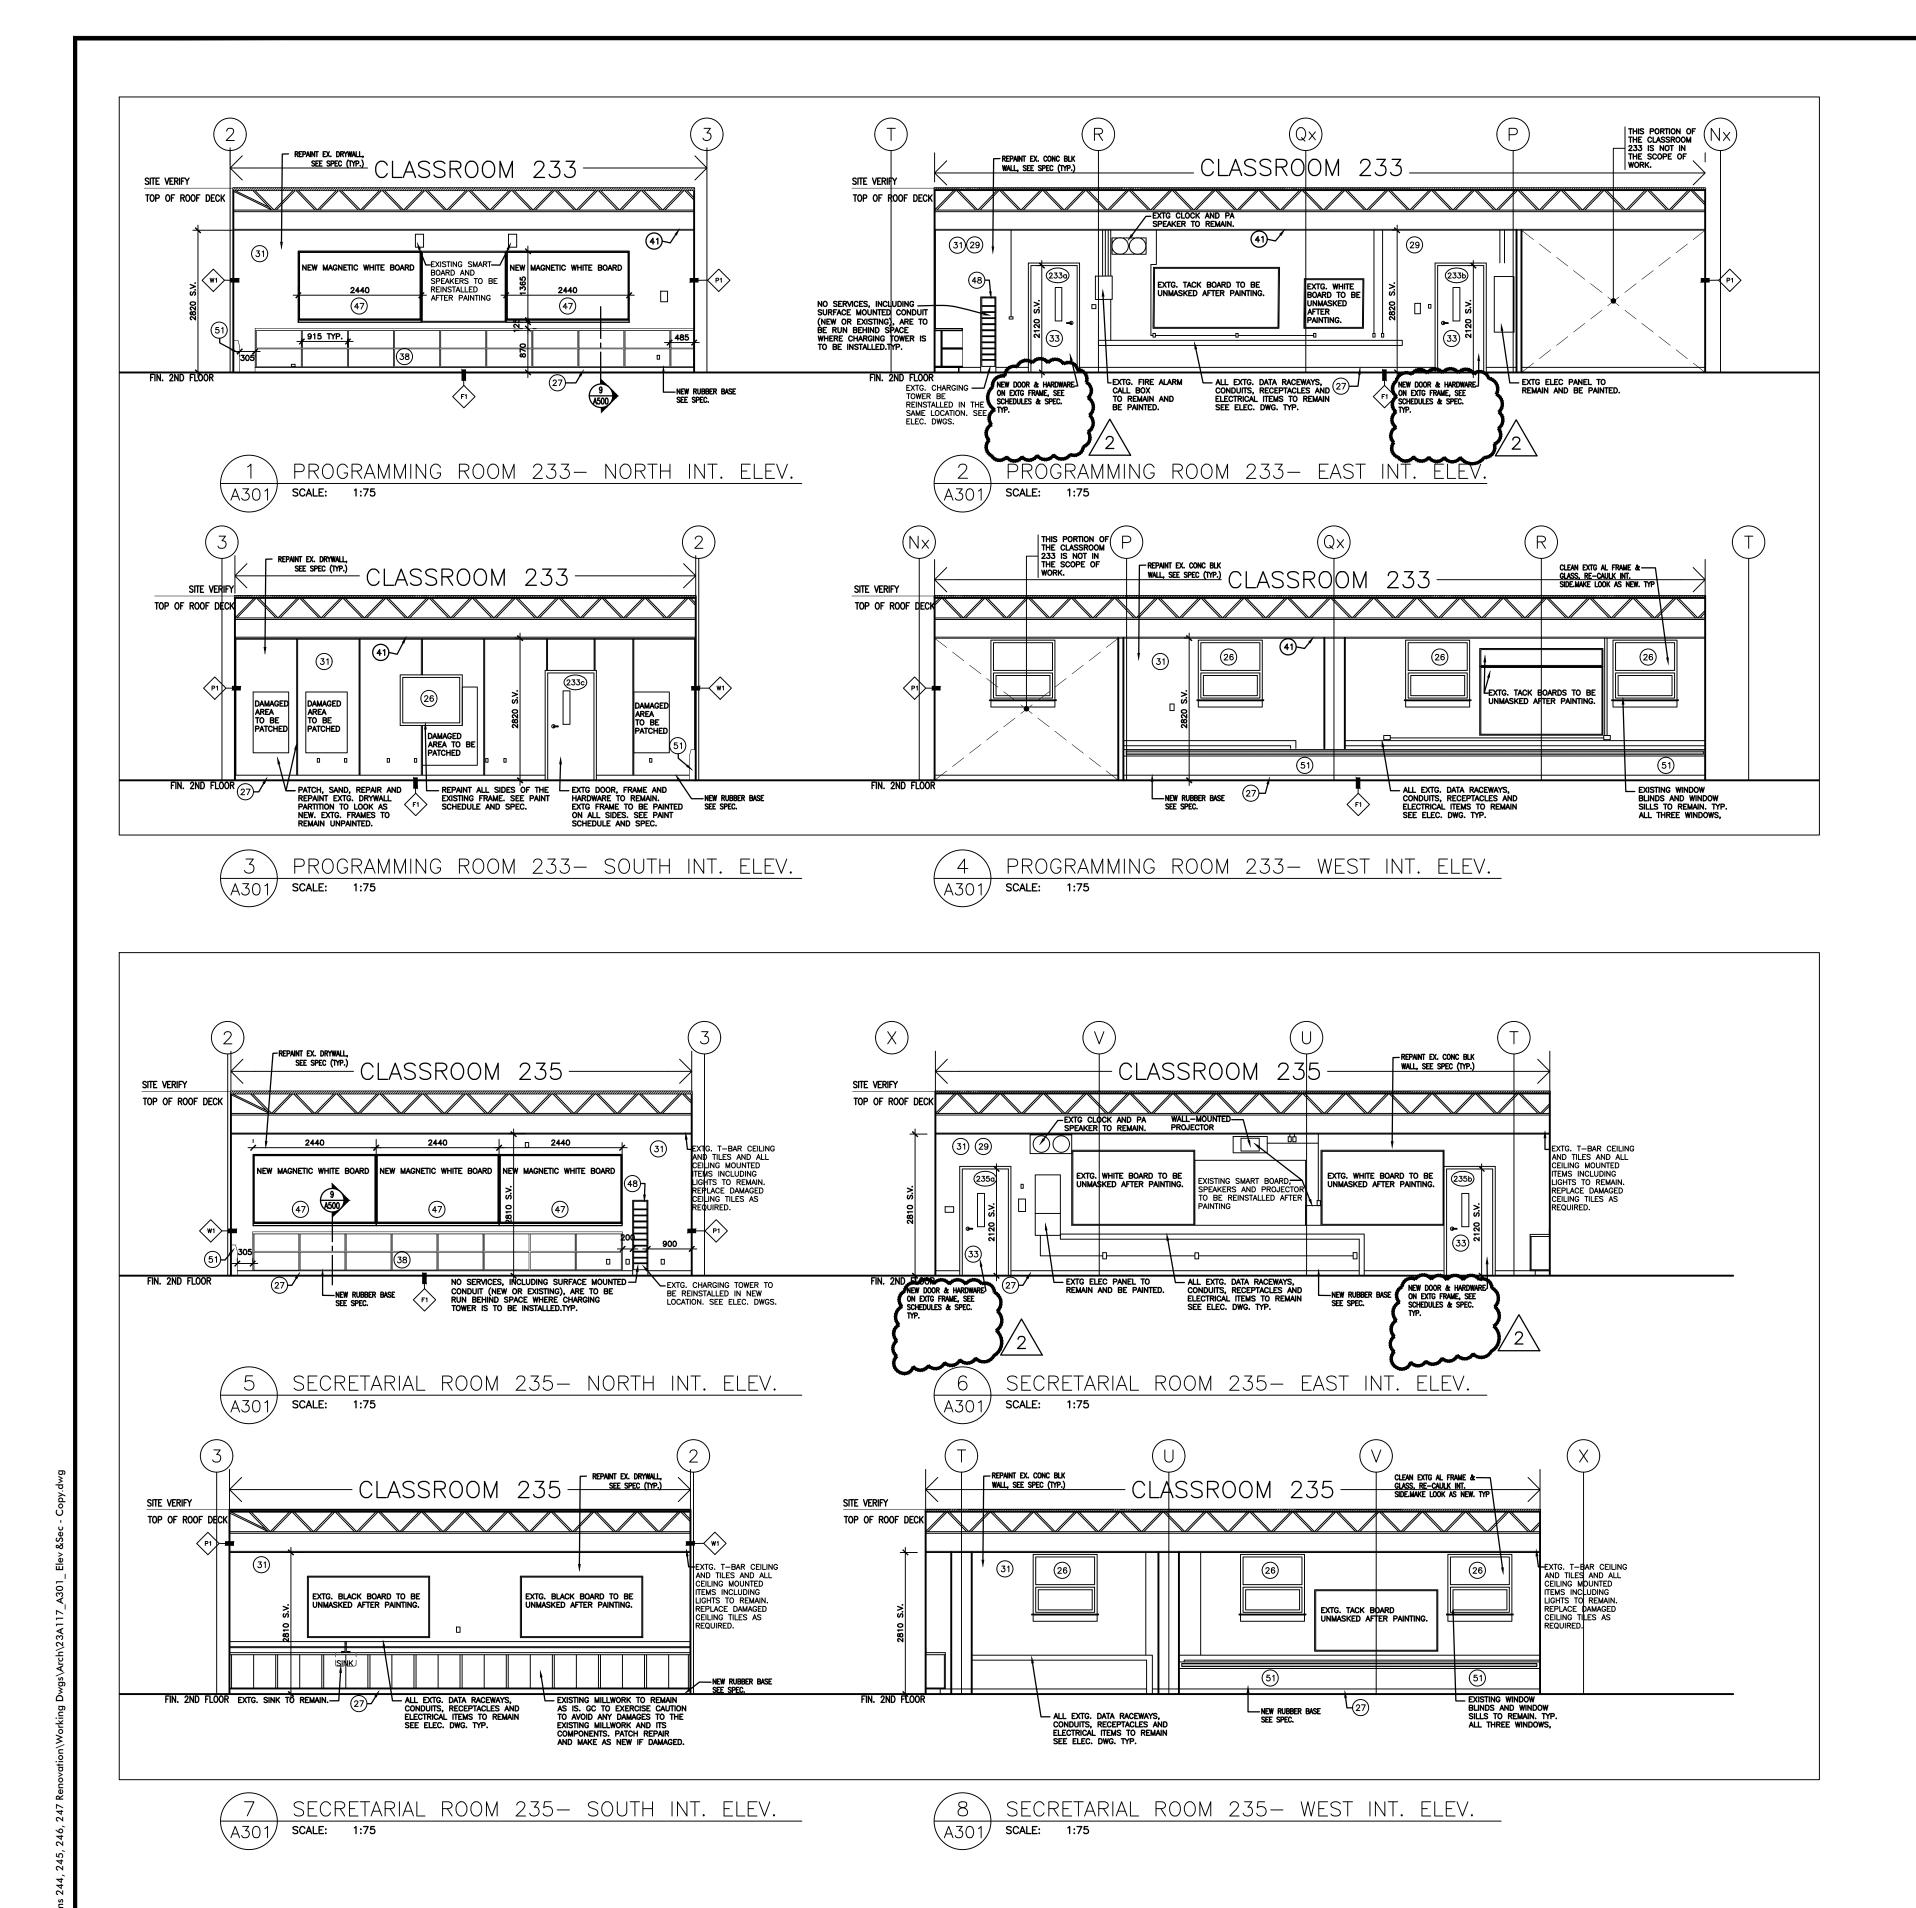

ALL DRAWINGS ARE THE PROPERTY OF THE ARCHITECT AND MUST BE RETURNED ON REQUEST.

THE CONTRACTOR SHALL CHECK ALL DIMENSIONS AND REPORT

DISCREPANCIES TO THE ARCHITECT.

ALL DIMENSIONS ARE GIVEN IN MILLIMETRES UNLESS OTHERWISE INDICATION NOT SCALE DRAWINGS.

REVISIONS AND DISTRIBUTION LOG

No.	Date	Note
1	MAR. 12, 2024	ISSUED FOR TENDER
2	APR. 12, 2024	ADDENDUM #1

REFER TO DEMO FLOOR PLANS (D200 SERIES) AND PROPOSED FLOOR PLANS (A200 SERIES) FOR SCOPE OF DEMOLITION. (TYPICAL)

REFER TO A200 FOR PREFERENCE NOTES (TYPICAL)

NOTES APPLY TO ALL DEMOLITION & PROPOSED DRAWINGS INCLUDING MECHANICAL AND ELECTRICAL DRAWINGS. CONTRACTORS SHALL READ THE WHOLE SET TOGETHER BEFORE PRICING. GC TO COORDINATE

DEMOLITION OF HAZARDOUS MATERIALS TYPICAL:

G.C. TO REFER TO HAZARDOUS BUILDING MATERIALS ASSESSMENT REPORT ALONG WITH SPECIFICATIONS AND CONTRACT DOCUMENTS PREPARED BY PINCHIN REGARDING THE REMOVAL AND DEMOLITION OF HAZARDOUS MATERIALS.



CMV GROUP Earchitects

20 Camden, Suite 101 Toronto, Ontario M5V 1V1 www.cmvarch.com

T 416.506.1600 F 416.506.0956

DR MS HAWKINS SR.PS


CLASSROOMS 233-235-244-245-246-247 RENOVATION
KAWARTHA PINE RIDGE DISTRICT SCHOOL BOARD

130 HIGHLAND DRIVE PORT HOPE

ONTARIO

PROPOSED INTERIOR ELEVATIONS

Drawn By:	Checked By:	Date Checked:	Project No.	
TJ	ОМ		23A117	
Date Plotted:	Date Plotted:			
Apr 12, 2	Apr 12, 2024 - 2:01pm			
Drawing No.:	Drawing No.:			
A301 2				

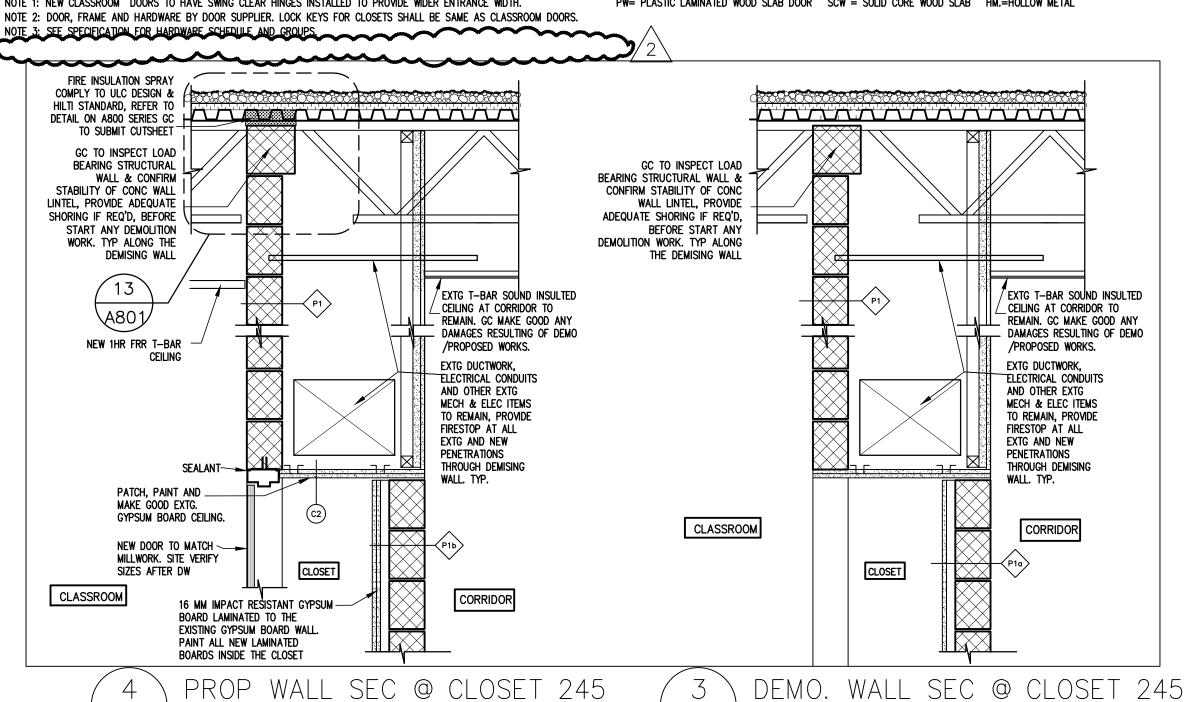


SCALE: 1:15

(A801)

SCALE: 1:15

SIGN TYPE A BRAILLE -ALUM. WHITE BOARD TROUGH — ALUM. TRIM PLAIN @ WHITE BOARD TROUGH ALUM. MAKER TROUGH ALL SYMBOLS, LETTERS AND NUMBERS SHALL BE RAISED TACTILE - FLAT BOTTOM ON COUNTER TOP MATERIAL - MIN 6mm ACRYLIC WITH MINIMUM 0.8mm THICK SECTION @ WHITE BOARD TROUGH \A801/ SCALE: PAINTED HOLLOW METAL FRAME -SOUND INSULATION -

TACK BOARD ALUMINUM TRIM WHITE BOARD/TACKBOARD DETAIL - METAL STUD TRACK —SOUND INSULATION METAL STUD DOUBLE HEADER WITH TRACK TOP & BOTTOM - 19mm PLYWOOD BLOCKING AS REQUIRED -SOUND INSULATION TYPE PAINTED HOLLOW METAL FRAME

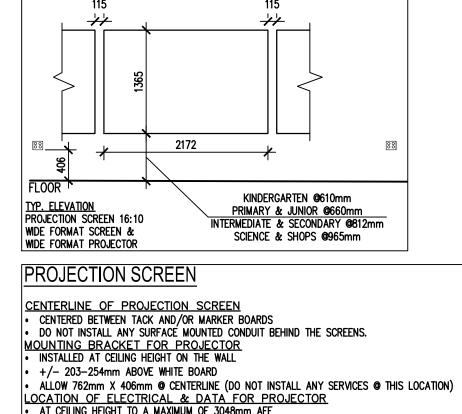

- APPROX. MOUNTING BRACKET FOR

PROJECTOR

LOCATION OF ELECTRICAL & DATA FOR PROJECTOR


• AT CEILING HEIGHT TO A MAXIMUM OF 3048mm AFF 500mm AWAY FROM CENTER TO ALLOW FOR INSTALLATION OF MOUNTING BRACKET POWER & DATA

• DUPLEX RECEPTACLE INSTALLED AT HIGH LEVEL ON THE WALL FOR PROJECTOR DATA REQUIRED FOR PROJECTOR QUAD RECEPTACLE AT BOTH LEFT & RIGHT CORNERS OF TEACHING WALLS BELOW ANY ADJOINING BLOCKING AS REQUIRED AT NEW WALL TYPES WITH DRYWALL ON THE INTERIOR WALL SURFACE.

CO-ORDINATE EXACT LOCATIONS WITH ARCHITECTURAL ELEVATIONS. INTRACTIVE BOARD DET SCALE: N.T.S.

WALL SEC @ CLOSET- DEMC

SCALE: 1:15

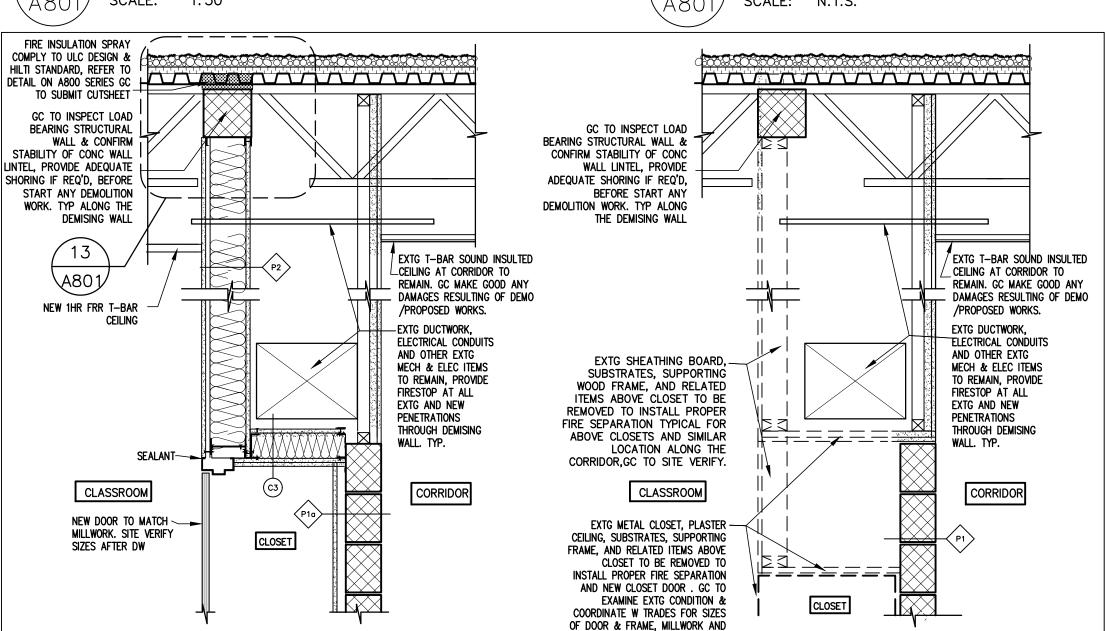

PROP WALL SEC @ CLOSET

SCALE: 1:15

TYPE D

ALL DRAWINGS ARE THE PROPERTY OF THE ARCHITECT AND MUST BE RETURNED ON REQUEST. 6MM CORK TACKBOARD ON 6MM - PLYWOOD (OR PLYWOOD ON 6MM ALL DIMENSIONS ARE GIVEN IN MILLIMETRES UNLESS OTHERWISE INDICATED DO NOT SCALE DRAWINGS. REVISIONS AND DISTRIBUTION LOG Date Note MAR. 12, 2024 | ISSUED FOR TENDER TACK BOARD ALUMINUM DIVISION TRIM APR. 12, 2024 | ADDENDUM #1

PLYWOOD) SEE INT. ELEVATIONS.

6MM CORK TACKBOARD ON

6MM PLYWOOD (OR

PLYWOOD ON 6MM

ELEVATIONS.

- ALUM TRIM

PLYWOOD) SEE INT.

ALUM TRIM

DEMOLITION OF HAZARDOUS MATERIALS TYPICAL G.C. TO REFER TO HAZARDOUS BUILDING MATERIALS ASSESSMENT REPORT ALONG WITH SPECIFICATIONS AND CONTRACT DOCUMENTS PREPARED BY PINCHIN

REGARDING THE REMOVAL AND DEMOLITION OF

HAZARDOUS MATERIALS.

Earchitects KAWARTHA PINE RIDGE HISTRICT SCHOOL BOARD

20 Camden Street, Suite 101 Toronto, Ontario M5V 1V1 www.cmvarch.com T 416.506.1600 F 416.506.0956

DR M.S. HAWKINS SR.PS

CLASSROOMS 233-235-244-245-246-247 RENOVATION KAWARTHA PINE RIDGE DISTRICT SCHOOL BOARD

ONTARIO

130 HIGHLAND DRIVE PORT HOPE

DETAILS & SCHEDULES

Checked By: Date Checked: OM 23A117 TJ Apr 12, 2024 - 2:02pm **AS NOTED** Revision No.

ARCH D

A801