
KAWARTHA PINE RIDGE DISTRICT SCHOOL BOARD HAMPTON Jr. PUBLIC SCHOOL INTERIOR RENOVATIONS

43 Ormiston St, Hampton, ON

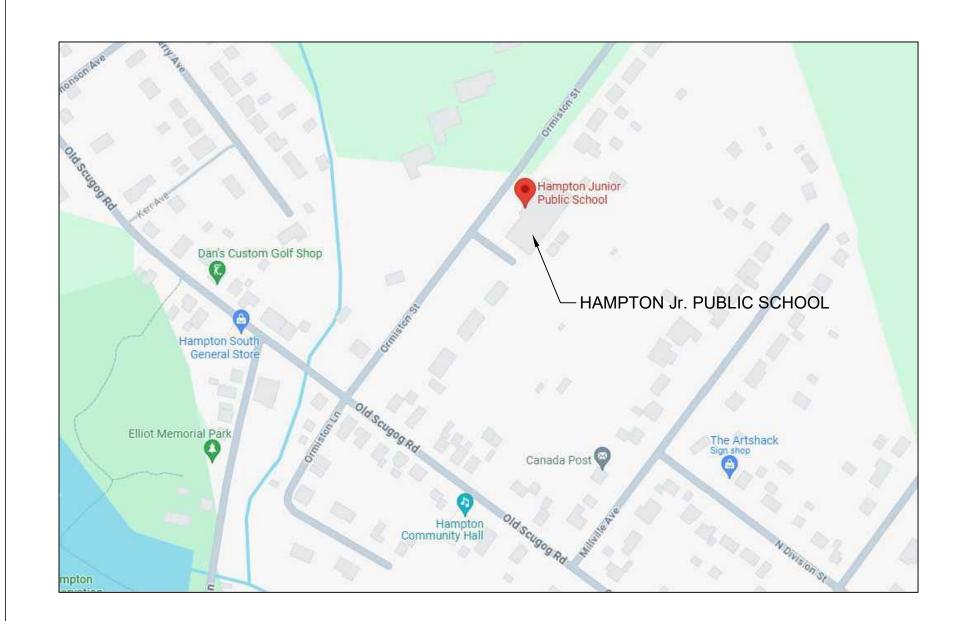

LIST OF DRAWINGS

LIST OF DRAWINGS, LOCATION MAP & OBC MATRIX

OVERALL GROUND FLOOR PLAN ENLARGED GROUND FLOOR DEMO PLAN + FLOOR PLAN ENLARGED GROUND FLOOR RCP PLANS INTERIOR ELEVATIONS

MILLWORK SECTIONS

MECHANICAL

KEYPLAN, LEGENDS, AND SCHEDULES PARTIAL PLANS DEMOLITION PARTIAL PLANS RENOVATION

ELECTRICAL

KEYPLAN, SCHI AREA OF WORK AREA OF WORK

EDULES, AND DETAILS K-LIGHTING DEMOLITION PLAN K-POWER AND SYSTEMS DEMOLITION PLAN	
ER AND SYSTEMS PLAN ND FLOOR - RENOVATION PLANS ND FLOOR - RENOVATION PLANS	

CONSULTANTS

ARCHITECTURAL/STRUCTURAL:

LOCATION MAP



MECHANICAL & ELECTRICAL:



	(905) - 666 - 5256 OF PROJECT:		
LOCAT	TON Jr. PUBLIC SCHOOL I	NTERIOR RENOVATIONS	
	MISTON St, FON, ON		
DATE : FEB. 2			
		Ontario Building Code Data Matrix Part 11 - Renovation of Existing Building	OBC Reference
11.00	Building Code Versio	n: Last Amendment:	
11.01	Project Type:	☐ Addition ☑ Renovation ☐ Addition and Renovation ☐ Change of use ☐ Description	[A] 1.1.2.
11.02	Major Occupancy Classification:	Occupancy Group A, Div. 2 School	3.1.2.1.(1)
11.03	Superimposed Major Occupancies:	☐ Yes ☑ No Description _	3.2.2.7
11.04	Building Area (m²)	Description Existing New Total GROUND FLOOR 1796.62m² N/A 1796.62m²	[A] 1.4.1.2.
	EXISTING NO CHANGE	Total= 1796.62m ² N/A 1796.62m ²	
11.05	Building Height	1 (One) Storeys above grade (m) Above grade O (zero) Storeys below grade	[A] 1.4.1.2 & 3.2.1.1
11.06	Number of streets/ fire fighter access:	1 street(s)	3.2.2.10 & 3.2.5
	Building Size:	☐ Small ☐ Medium ☑ Large ☐ > Large	T.11.2.1.1.BN.
11.08	Existing Building Classification:	Change in Major Occupancy:	11.2.1 T11.2.1.1A T11.2.1.1B to N, 4.2.1(3) & 5.2.2.1.(2)
		Importance Category: ☐ Low ☐ Normal ☐ High ☐ Post-disaster	
	Renovation Type: Occupant Load:	☑ Basic Renovation ☐ Extensive Renovation Floor Level/ Area Occupancy Type Based On Occup. Load	11.3.3.1 & 11.3.3.2 3.1.17
11.10	EXISTING NO	Floor Level/ Area Occupancy Type Based On Occup. Load	3.1.17
11 11	Plumbing Fixture	Ratio: Male/Female = 50:50 Except as noted otherwise	3.7.4
	Requipments:	Floor level / Area Occupant OBC Fixtures	J.7. 4
	EXISTING NO CHANGE	Fixtures Load Reference Required Provided	
11 12	Barrier-free Design:	✓ Yes Explanation	11.3.3.2.(2)
11.12	Damer-nee Design.	□ No	11.3.3.2.(2)
11.13	Reduction in Performance Level:	Structural ☑ No ☐ Yes By Increase in occupant load: ☑ No ☐ Yes	11.4.2.1 11.4.2.2
		By change of major occupancy: ☑ No ☐ Yes Plumbing ☑ No ☐ Yes	11.4.2.3 11.4.2.4
		Sewage - system: ☑ No ☐ Yes	11.4.2.5
11.14	Compensating Construction:	☐ Yes ☑ No ☐ Yes	11.4.2.1
		Structural	11.4.2.2 11.4.2.3 11.4.2.4
		Plumbing	11.4.2.5 11.4.2.6
		Extension of Combustible	11.4.2.7
11.15	Compliance Alternatives Proposed:	☑ No ☐ Yes	11.5.1.
11.16	Notes:	Project Description: Interior renovations to classroom.	11.5.1
		AREA OF WORK/RENOVATION: 108m ²	
		<u>BUILDING AREA</u> : 1797m ² EXISTING OCCUPANT LOAD + FIXTURES DOES NOT CHANGE.	
		THE FOLLOWING FIXTURES ARE ADDED: NEW WASHROOM — 1 TOILET AND 1 SINK	
		NEW WASHROOM - I TOILET AND I SHAK	
		NEW WASHROOM - I TOLLET AND I SINK	

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2	CLIENT REVIEW	FEB. 23 2024	BBA
3	ISSUED FOR TENDER	MAR. 1 2024	BBA

NO.	REVISIONS	DATE	BY
		·	

PROJECT:

HAMPTON Jr. PUBLIC SCHOOL INTERIOR RENOVATIONS

43 ORMISTON ST., HAMPTON, ON KPRDSB - HAMPTON Jr. PUBLIC SCHOOL

DRAWING:

LIST OF DRAWINGS, **LOCATION MAP & OBC MATRIX**




Engineers Project Managers 250 Water Street Suite 201 Whitby, Ontario L1N 0G5 Tel: (905) 666-5252

CHECKED BY: JAN. 2024 AS NOTED

PROJECT NO: 24004

Fax: (905) 666-5256 e-mail: bba@bba-archeng.com

> DRAWING NO: **A000**

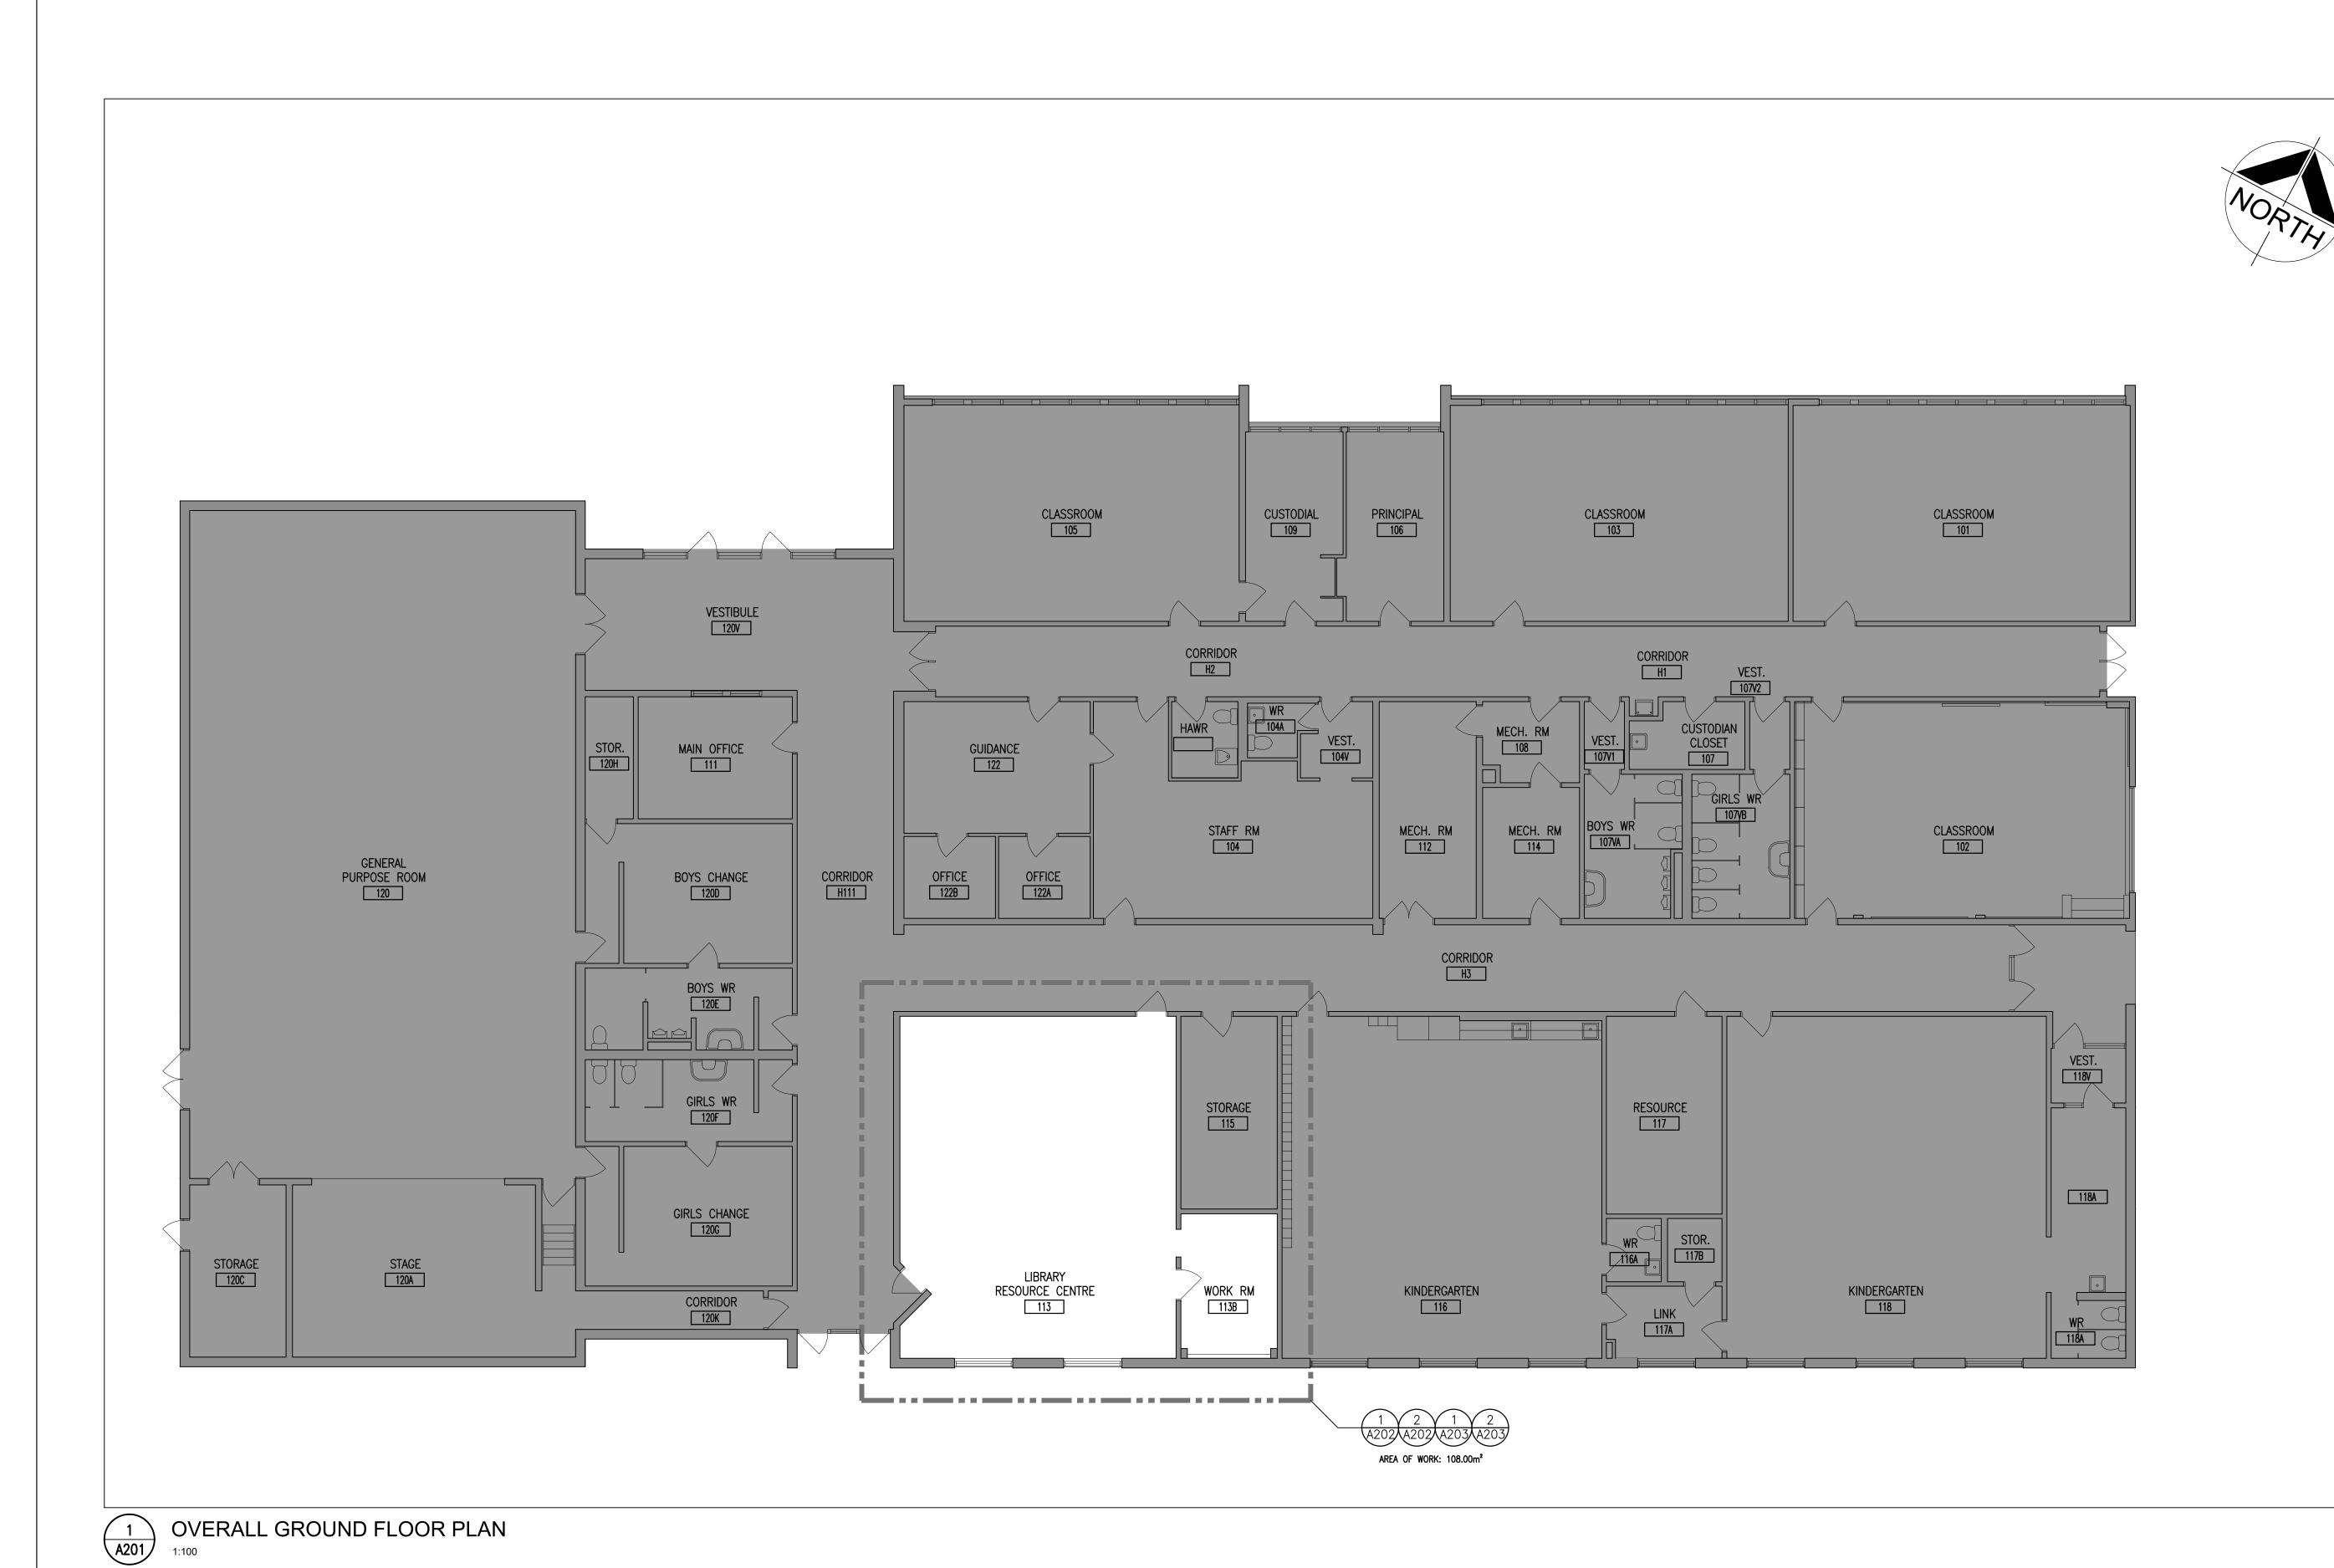

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PROJECT:

HAMPTON Jr. PUBLIC SCHOOL INTERIOR RENOVATIONS

43 ORMISTON ST. , HAMPTON, ON KPRDSB - HAMPTON Jr. PUBLIC SCHOOL

DRAWING:

OVERALL GROUND FLOOR PLAN




BARRY BRYAN ASSOCIATES Architects Engineers Project Managers 250 Water Street Suite 201 Whitby, Ontario L1N 0G5


DESIGN BY: BBA CHECKED BY: DATE: JAN. 2024

SCALE: AS NOTED Tel: (905) 666-5252 Fax: (905) 666-5256 e-mail: bba@bba-archeng.com 24004 A201.dwg

PROJECT NO:

DRAWING NO: 24004 **A201**

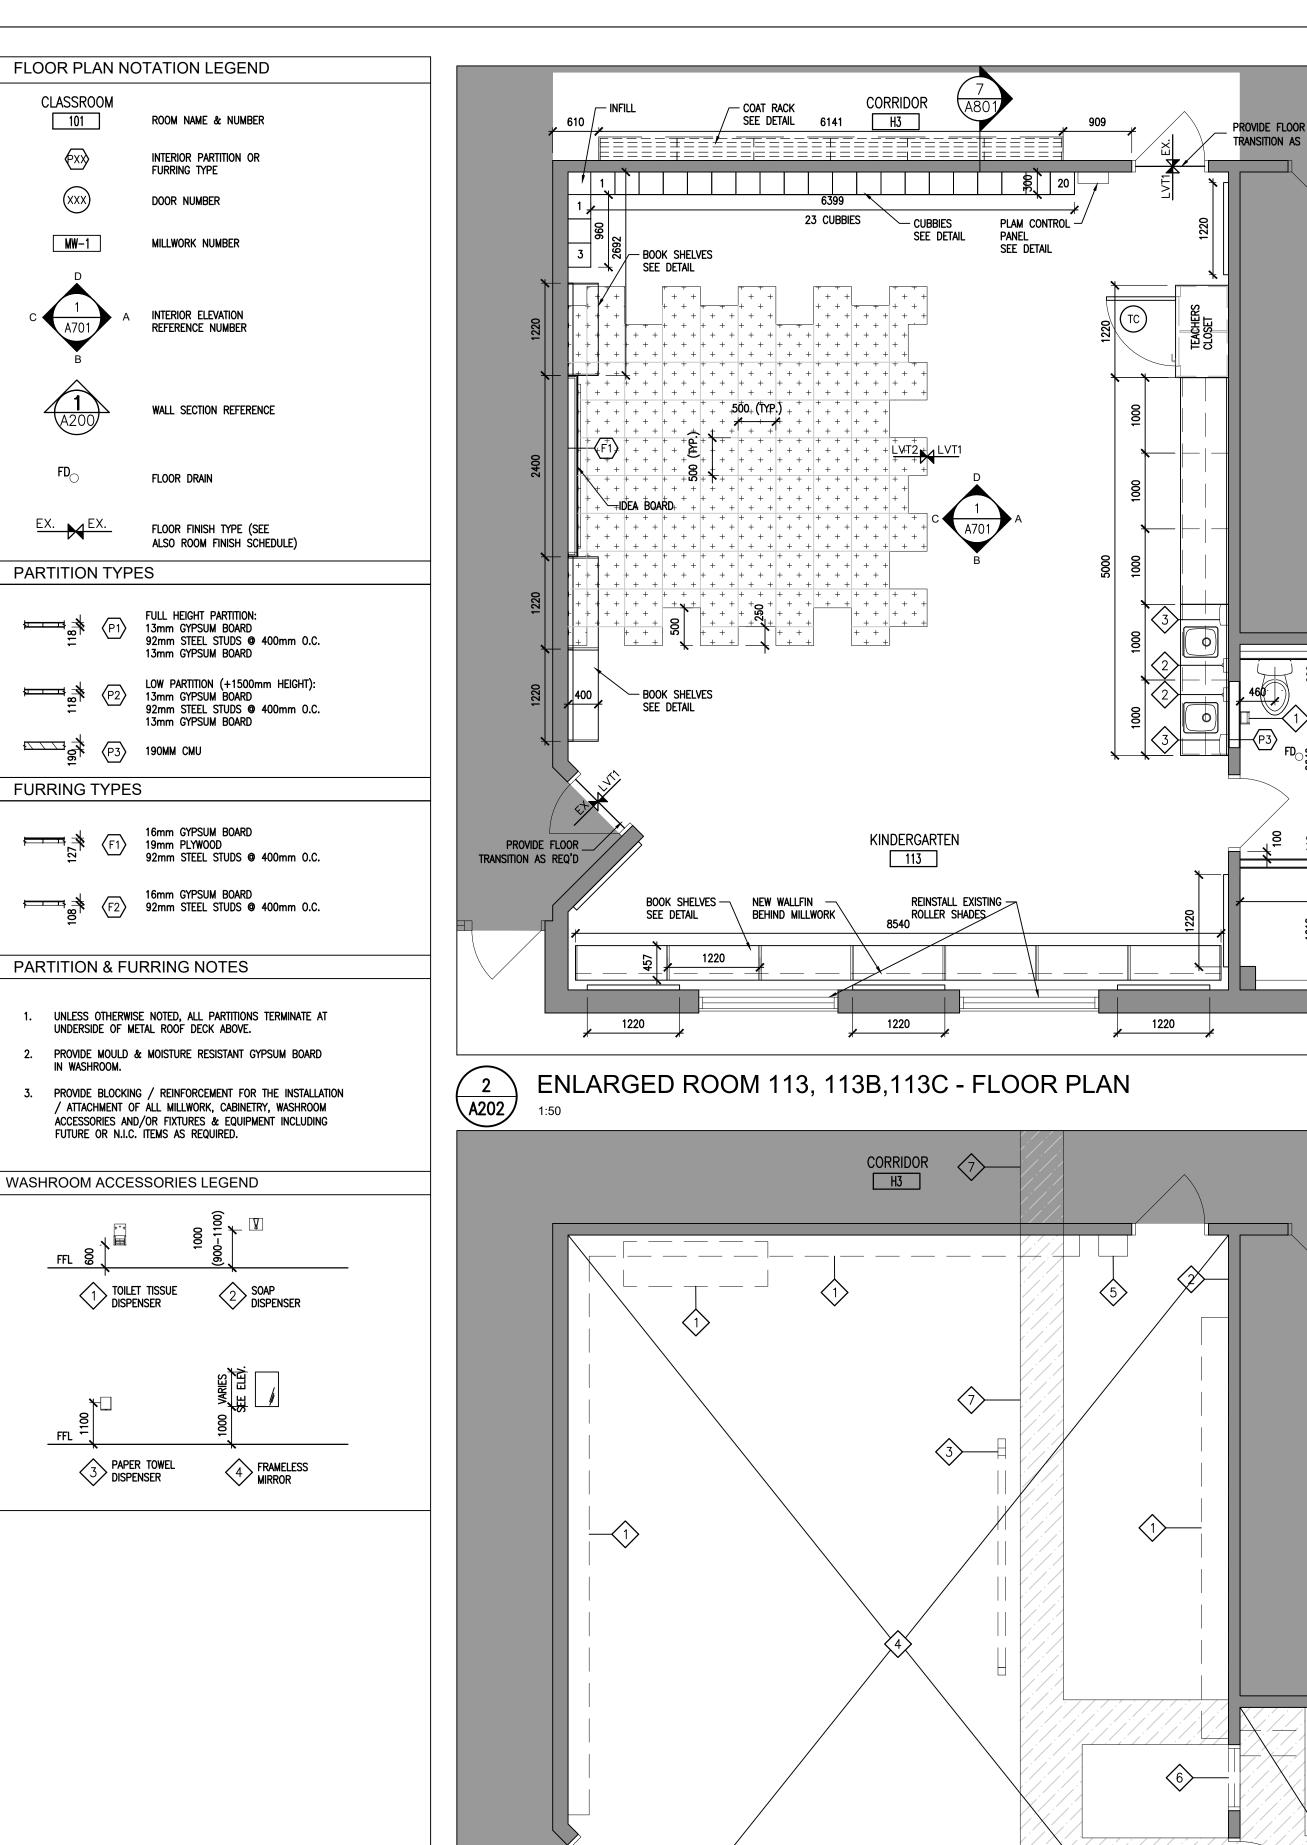

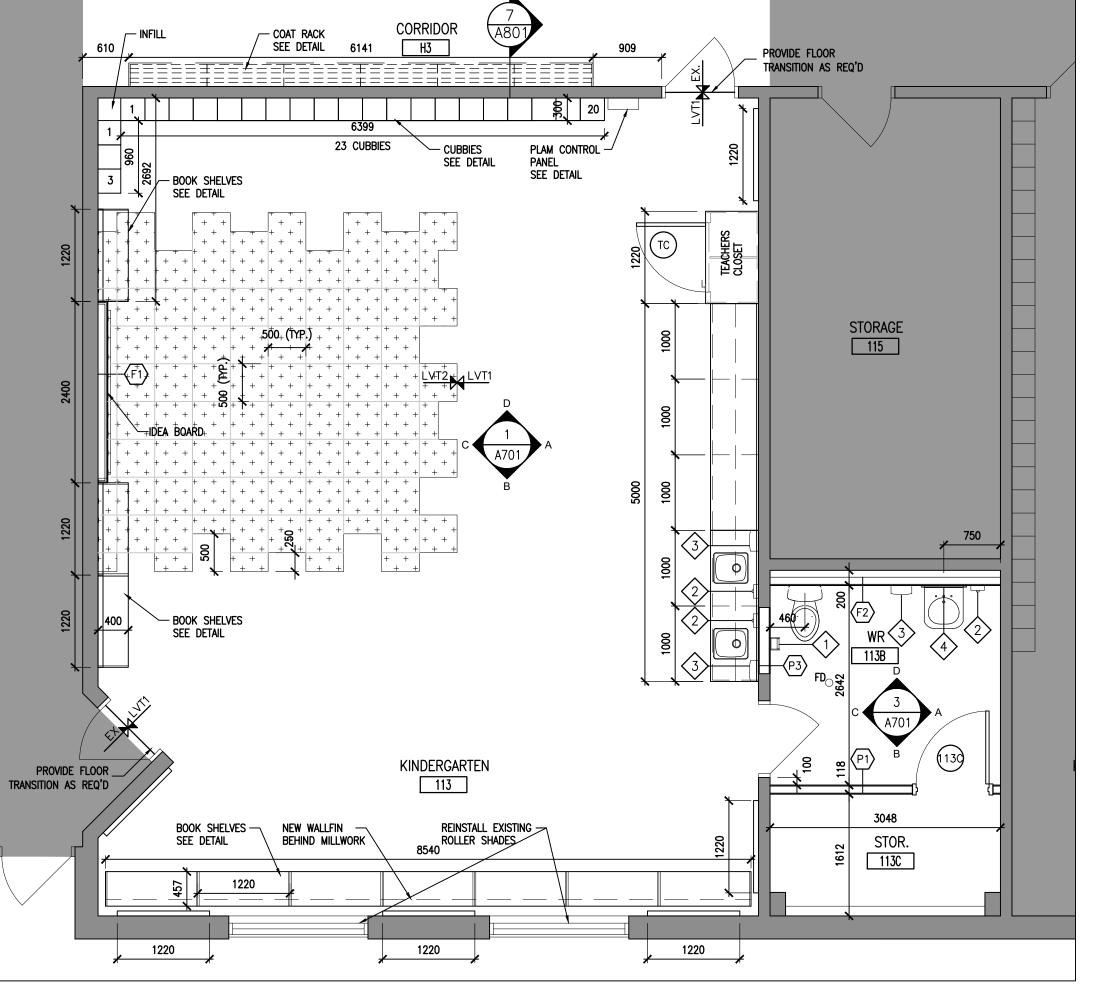

- 1. SITE VERIFY ALL DIMENSIONS AND CONDITIONS.
- 2. ALL WORK TO BE IN ACCORDANCE WITH THE ONTARIO BUILDING CODE.
- COMPLY WITH THE OCCUPATIONAL HEALTH AND SAFETY ACT REGULATIONS FOR
- CONSTRUCTION PROJECTS. PROVIDE PROTECTION IN LOCATIONS APPROVED BY THE OWNER AND CONSULTANT
- SO AS NOT TO DAMAGE EXISTING STRUCTURE, LANDSCAPE OR PART THEREOF. COMPLETE ALL DEMOLITION WORK NECESSARY TO COMPLETE THE RENOVATIONS AS

SHOWN AND AS REQUIRED. DEMOLITION OF BUILDING ELEMENTS INCLUDES BUT NOT LIMITED TO COMPLETE REMOVAL OF ALL ASSOCIATED FIXTURES, FITTINGS,

HARDWARE, FASTENERS, EQUIPMENT AND ACCESSORIES UNLESS NOTED OTHERWISE.

- PROVIDE ALL SHORING AS REQUIRED. SHORING SHALL BE DESIGNED BY A REGISTERED PROFESSIONAL ENGINEER.
- NOTIFY CONSULTANT OF LOAD BEARING MEMBERS OR ASSEMBLIES IDENTIFIED OR DISCOVERED DURING WORK AND NOT INDICATED ON DRAWINGS. DO NOT PROCEED WITH REMOVALS WITHOUT PRIOR REVIEW BY THE CONSULTANT.
- PROVIDE TEMPORARY SUPPORT OF PIPES, DUCTS AND ELECTRICAL CHASES AS REQUIRED FOR SAFE REMOVAL. EXISTING AND PROPOSED SUPPORTS ARE TO BE REVIEWED BY THE CONSULTANT PRIOR TO THE REMOVAL OF ANY COMPONENTS WHICH MAY FALL. OR CAUSE OTHERS TO FALL.

REMOVAL OF EXISTING FLOOR FINISHES IS TO INCLUDE COMPLETE REMOVAL OF

EQUIPMENT, FITTINGS, FIXTURES, HANGERS, BRACKETS, TRIM AND ACCESSORIES AS

- 10. MAINTAIN ALL WORK AREAS AND ALL STORAGE AREAS CLEAN AND ORDERLY AT ALL TIMES INCLUDING EXISTING AREAS THAT REMAIN IN OPERATION DURING CONSTRUCTION. DUST CONTROL MEASURES ARE TO BE IN PLACE AT ALL TIMES AND NOISY WORK SHALL BE COORDINATED AROUND PROGRAM EVENTS.
- BASE AND ALL MORTAR AND ADHESIVES AND PREPARATION OF EXISTING SUBSTRATES TO RECEIVE NEW FLOORING, SATISFACTORY TO THE MANUFACTURER OF NEW FLOOR FINISHES. ALLOW FOR EXCESSIVE LEVELING OF SLABS. 12. DEMOLITION INCLUDES ALL ASSOCIATED MECHANICAL AND ELECTRICAL SERVICES,
- 13. MAINTAIN EXISTING FIRE HOSE CABINETS AND FIRE RATINGS.

REQUIRED TO COMPLETE THE WORK.

- 14. REMOVAL OF DOORS AND FRAMES IS TO INCLUDE REMOVAL OF ALL HARDWARE.
- 15. REMOVE ALL PROTRUSIONS IN FLOOR SLAB AND GRIND DOWN TO FLOOR LEVEL.
- 16. CLEAN, PATCH / REPAIR ALL EXISTING SURFACES TO REMAIN TO RECEIVE NEW FINISHES. ALLOW FOR REMOVAL OR SCARIFICATION OF EXISTING PAINT FINISH ON WALLS THAT ARE TO RECEIVE NEW WALL TILE FINISH. REMOVE ALL MORTAR, ADHESIVES AND RUST AS REQUIRED TO PREPARE EXISTING SUBSTRATES TO RECEIVE NEW PAINT FINISHES.
- 17. DISCONNECT AND CAP OFF ALL SERVICES PRIOR TO DEMOLITION.
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- 20. BUILDING TO BE SECURED BY THE G.C. AT ALL TIMES.

DEMOLITION LEGEND

EXISTING WALL, PARTITION OR COLUMN DENOTES DEMOLITION OF BUILDING ELEMENT EXISTING DOOR, FRAME AND TRIM TO REMAIN

EXISTING DOOR, FRAME AND TRIM TO BE CAREFULLY REMOVED AND DISPOSED OF.

DENOTES NOT IN CONTRACT

DEMOLITION NOTES

STORAGE 115

WORK RM

113B

- REMOVE AND DISPOSE OF EXISTING MILLWORK (AND FLOOR MOUNTED MILLWORK WHERE APPLICABLE). MAKE GOOD AFFECTED AREA.
- REMOVE AND DISPOSE OF ALL WALL MOUNTED BOARDS, (CHALK BOARDS & TACK BOARDS). MAKE GOOD AFFECTED AREA.
- (2A) REMOVE EXISTING SMART BOARD AND ALL ASSOCIATED ELECTRICAL.
- 3 REMOVE EXISTING ELECTRICAL CONDUIT. REFER TO ELECTRICAL DRAWINGS.
- REMOVE AND DISPOSE OF EXISTING VCT FLOOR TILE AND RUBBER WALL 4 BASE. PREPARE EXISTING SURFACES TO RECEIVE NEW FLOORING AND BASE
- REMOVE EXIST. PAPER TOWEL DISPENSER AND REINSTALL AT THE END OF CONSTRUCTION WHERE NOTED IN THE ELECATIONS CONSTRUCTION WHERE NOTED IN THE ELEVATIONS.
- REMOVE & DISPOSE OF EXISTING WINDOW & FRAME. PREPARE WALL TO RECEIVE NEW PAINT AND BLOCK INFILL
- REMOVE CONCRETE FLOOR. PROVIDE TRENCHING. REFER TO MECHANICAL.
 REPAIR FLOOR AT LOCATION WHERE PIPING HAD PENETRATED FLOOR. PATCH, REPAIR AND MAKE GOOD AFFECTED SURFACES AS REQUIRED FOR NEW
- 8 CLEAR FULLY REMOVE, STORE AND REINSTALL EXISTING ROLLER SHADED FOR WINDOWS.

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Kawartha Pine Ridge

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DATE BY NO. REVISIONS

PROJECT:

HAMPTON Jr. PUBLIC SCHOOL INTERIOR RENOVATIONS

43 ORMISTON ST., HAMPTON, ON KPRDSB - HAMPTON Jr. PUBLIC SCHOOL

DRAWING:

ENLARGED GROUND FLOOR DEMO PLAN & FLOOR PLAN



BARRY BRYAN **ASSOCIATES** Architects Engineers Project Managers 250 Water Street Suite 201

e-mail: bba@bba-archeng.com

CHECKED BY: Whitby, Ontario L1N 0G5 Tel: (905) 666-5252 Fax: (905) 666-5256

JAN. 2024 SCALE: AS NOTED 24004 Enlarged Plans A202-A204.dwg

% COMPLETE:

DESIGN BY:

DRAWN BY:

PROJECT NO: 24004 **A202**




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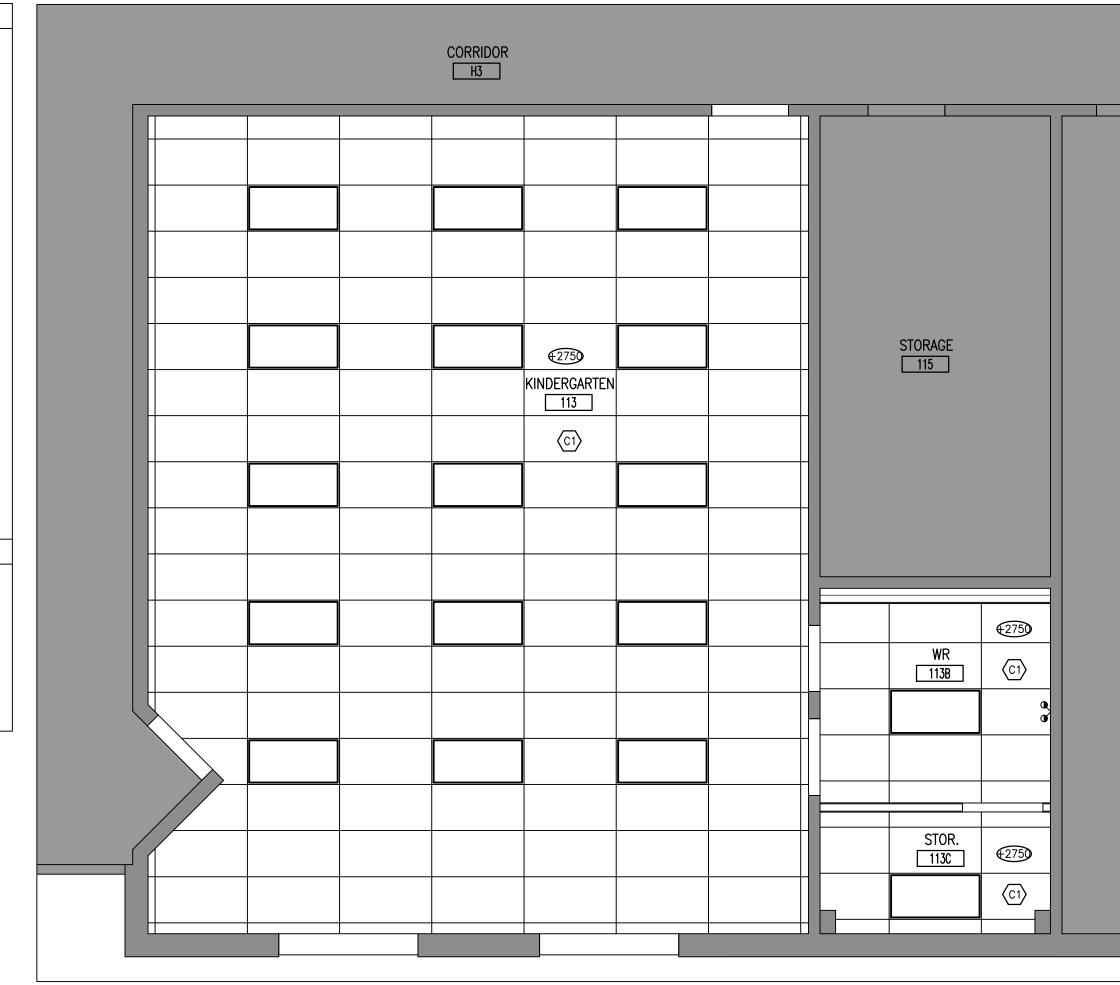
RESOURCE CENTRE

EX. WALLFIN HEATER -

REMOVED. REFER TO


113



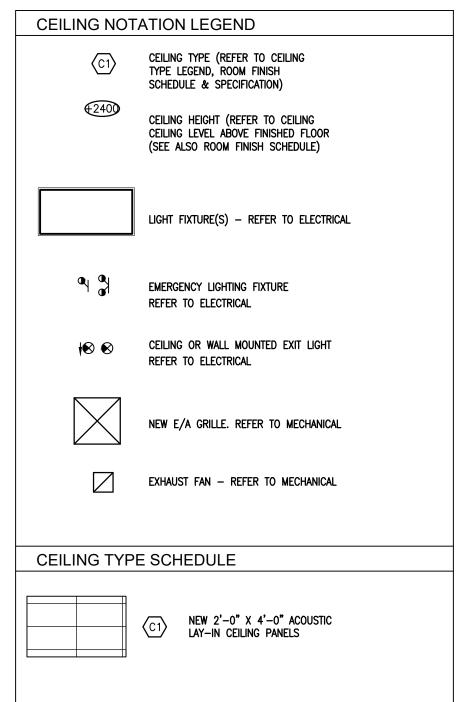

A203

ENLARGED ROOM 113, 113B,113C - RCP 1:50

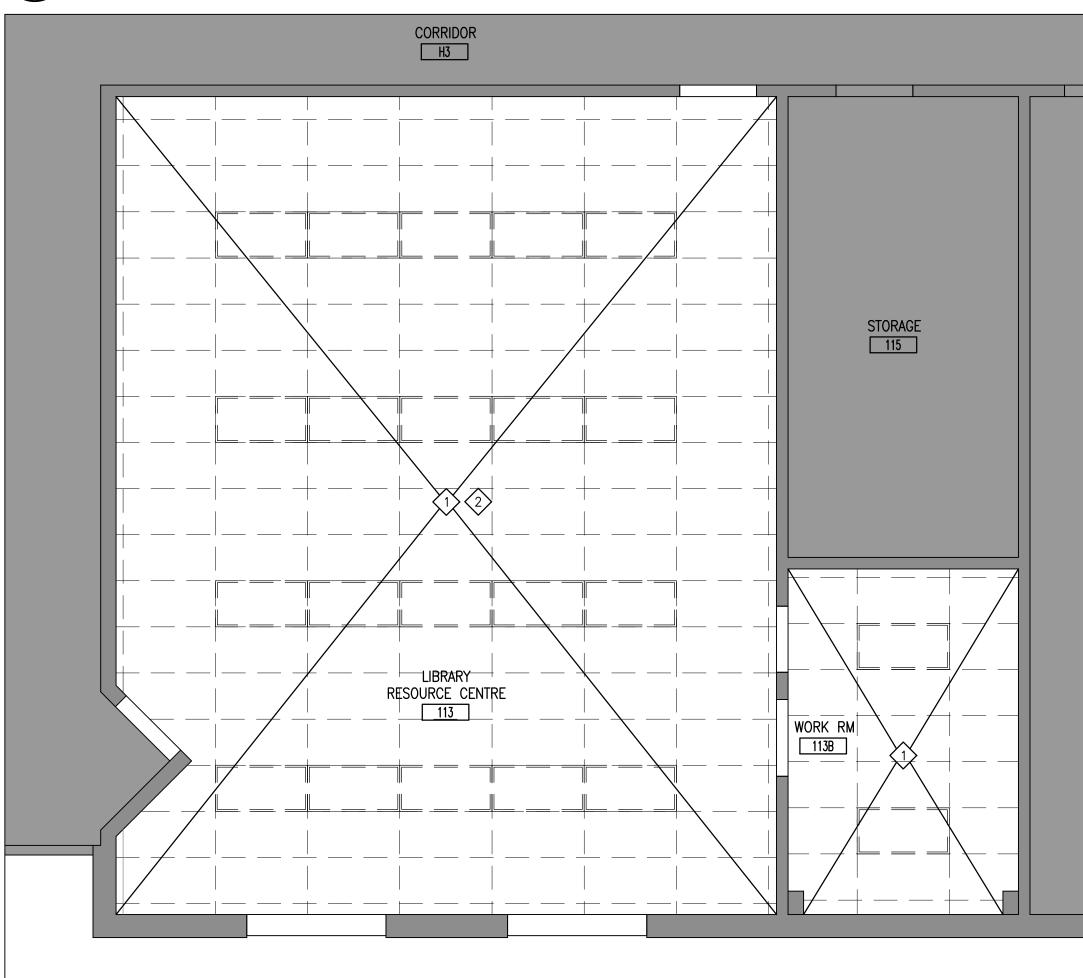

(1) A203

ENLARGED ROOM 113 + 113B - DEMO RCP

GENERAL DEMOLITION NOTES

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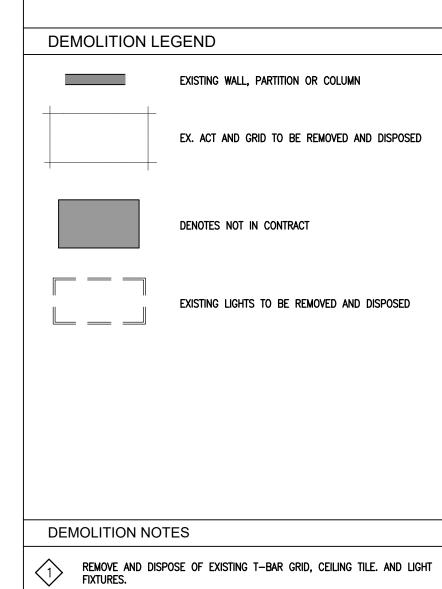
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2 REMOVE AND HANDOVER EXISTING PROJECTOR TO CLIENT.

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NO. REVISIONS

PROJECT:

HAMPTON Jr. PUBLIC SCHOOL INTERIOR RENOVATIONS

DATE BY

43 ORMISTON ST., HAMPTON, ON KPRDSB - HAMPTON Jr. PUBLIC SCHOOL

DRAWING:

ENLARGED GROUND FLOOR RCP PLANS



BARRY BRYAN **ASSOCIATES** Architects

Engineers Project Managers 250 Water Street Suite 201 Whitby, Ontario L1N 0G5

e-mail: bba@bba-archeng.com

JAN. 2024 Tel: (905) 666-5252 Fax: (905) 666-5256

AS NOTED 24004 Enlarged Plans A202-A204.dwg

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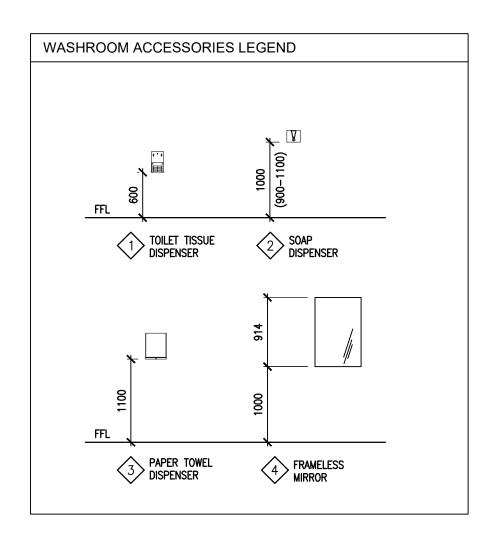
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DRAWN BY:

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PROJECT NO: 24004

A203




SEE PLAN

- GYPSUM BOARD PARTITION

DOOR FRAME AS PER SCHEDULE

TYP. HEAD DETAIL (H1)

- DOOR AS PER SCHEDULE

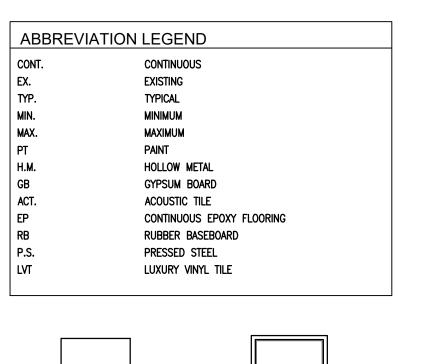

	LOXOITI	VIIVIL TILL		
M			F1	
DOOR 7	TYPE	<u> </u>	FRAME	TYPE

SEE PLAN


— GYPSUM BOARD PARTITION


DOOR FRAME AS PER SCHEDULE


DOOR AS PER SCHEDULE

	ROOM		EL OOD	DACE		WA	LLS		CEILING	CEILING	DE\/	DEMARKS
NO.	ROOM NAME		FLOOR	BASE	NORTH	EAST	SOUTH	WEST	CEILING	HEIGHT	REV.	REMARKS
	KINDERGARTEN	MAT.	CONC.	_	CMU	CMU	CMU	CMU/GB		-	_	EXISTING & NEW - PAINTED
113		FIN.	LVT	RB	PT	PT	PT	PT	ACT	2750	-	COUNTERTOP COLOUR TO BE SELECTED BY PRINCIPAL FROM OWNER STANDARD
		COL.	_	_	_	_	_	_		_	_	PALETTE
	WASHROOM	MAT.	CONC.	-	GB	CMU	GB	CMU	-	-	-	
113B		FIN.	LVT	RB	PT	PT	PT	PT	ACT	2750	-	
		COL.	_	_	_	_	_	-	_	_	_	
		MAT.	CONC.		GB	CMU	CMU	CMU				
113C	STORAGE	FIN.	LVT	RB	PT	PT	PT	PT	ACT	2750	-	
		COL.	_	_	_	_	_	-	_	-	_	

	DOOR AND FRAME SCHEDULE												
									DOOR HARDWARE				
	DOOR						FRAME				FIRE		REMARKS
NO.	SIZE AND THICKNESS	TYPE	MATERIAL	FINISH	GLASS	TYPE	DE	TAIL	MATERIAL	FINISH	RATING		REWARKS
113C	915x2135x45	М	НМ	PAINT	-	F1	H1	J1	PS	PAINT	-	REFER TO SPEC	

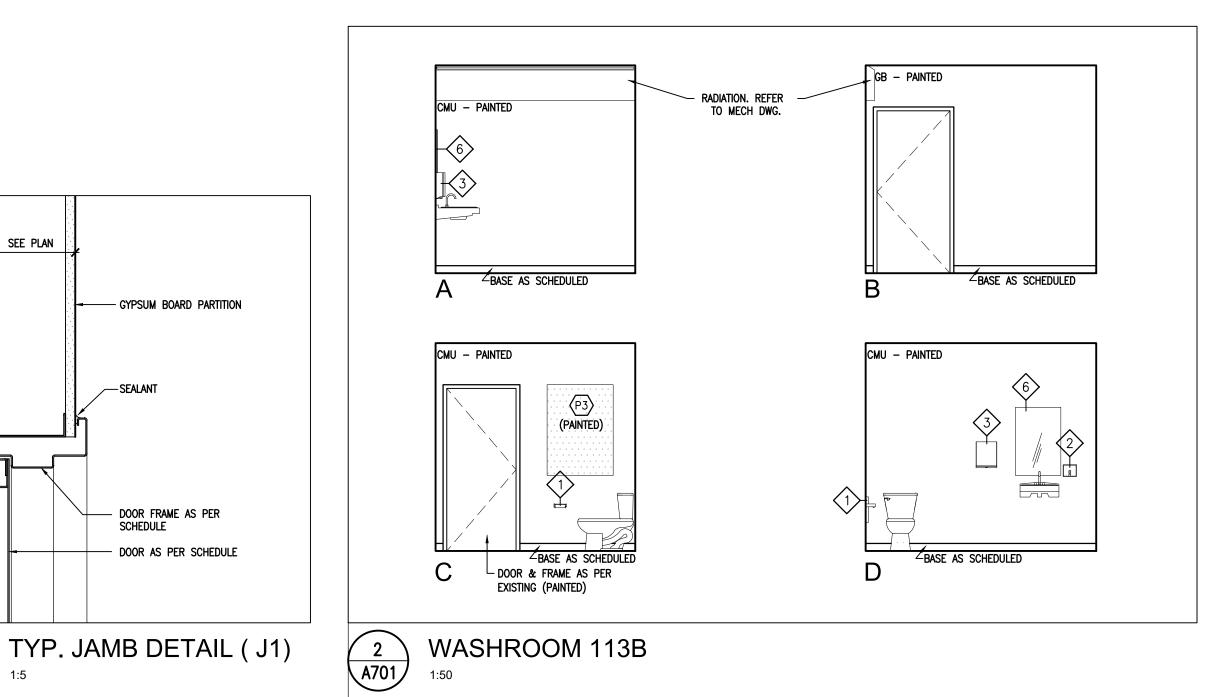

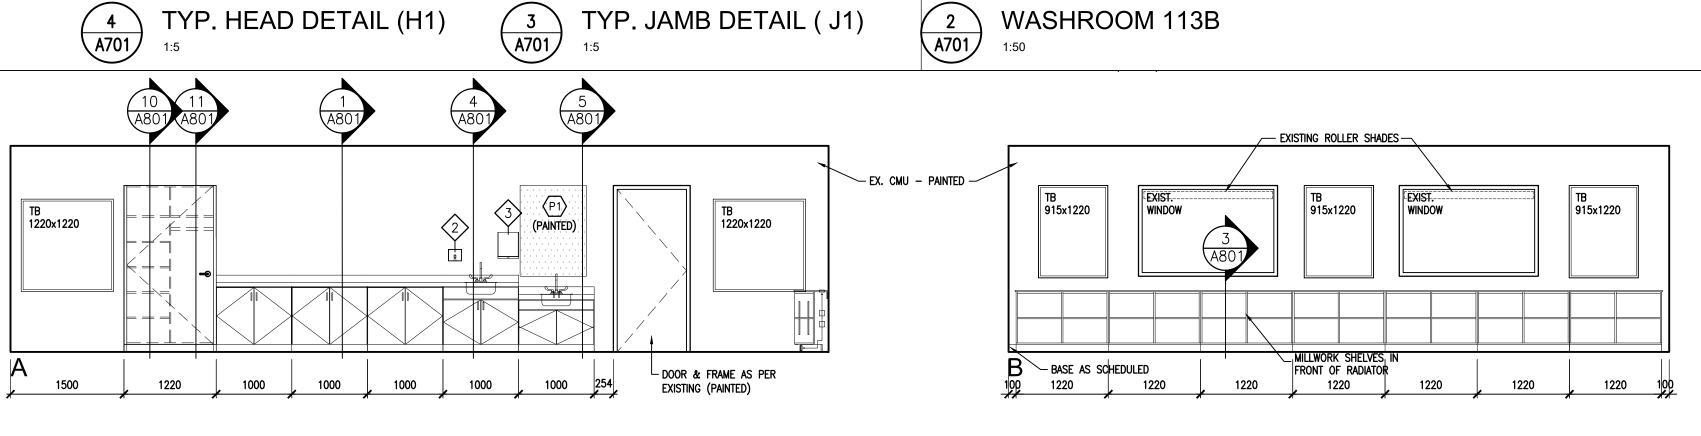

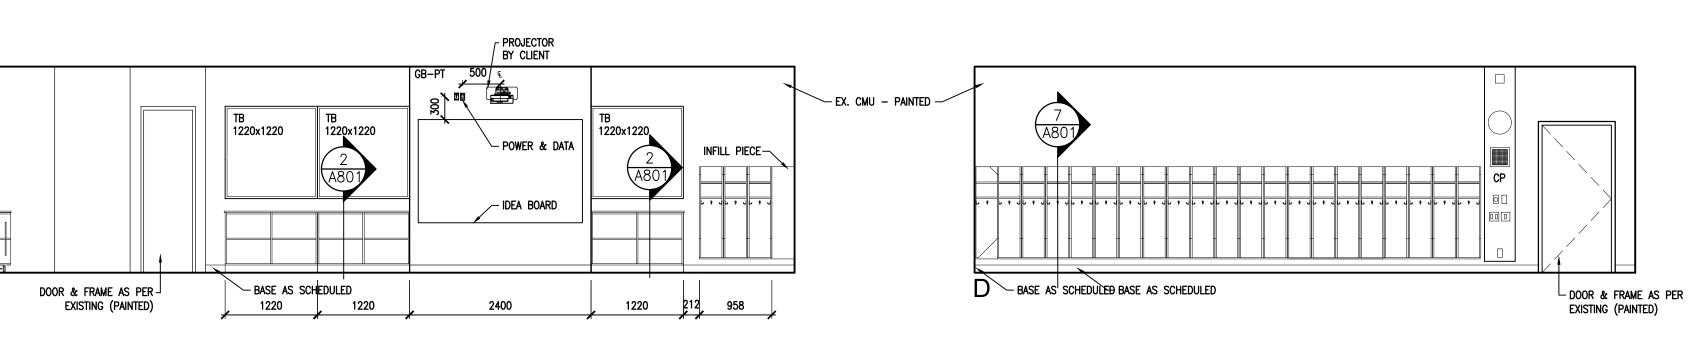




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PROJECT:

HAMPTON Jr. PUBLIC SCHOOL **INTERIOR RENOVATIONS**

43 ORMISTON ST. , HAMPTON, ON KPRDSB - HAMPTON Jr. PUBLIC SCHOOL

DRAWING:

INTERIOR ELEVATIONS

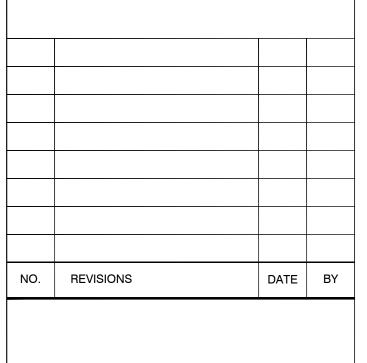


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Architects Engineers Project Managers
250 Water Street Suite 201 Whitby, Ontario L1N 0G5


% COMPLETE: DRAWN BY: CHECKED BY: JAN. 2024 SCALE: AS NOTED Tel: (905) 666-5252 Fax: (905) 666-5256 e-mail: bba@bba-archeng.com 24004 Interior Elevations A701.dwg

DESIGN BY: BBA

PROJECT NO: 24004


A701

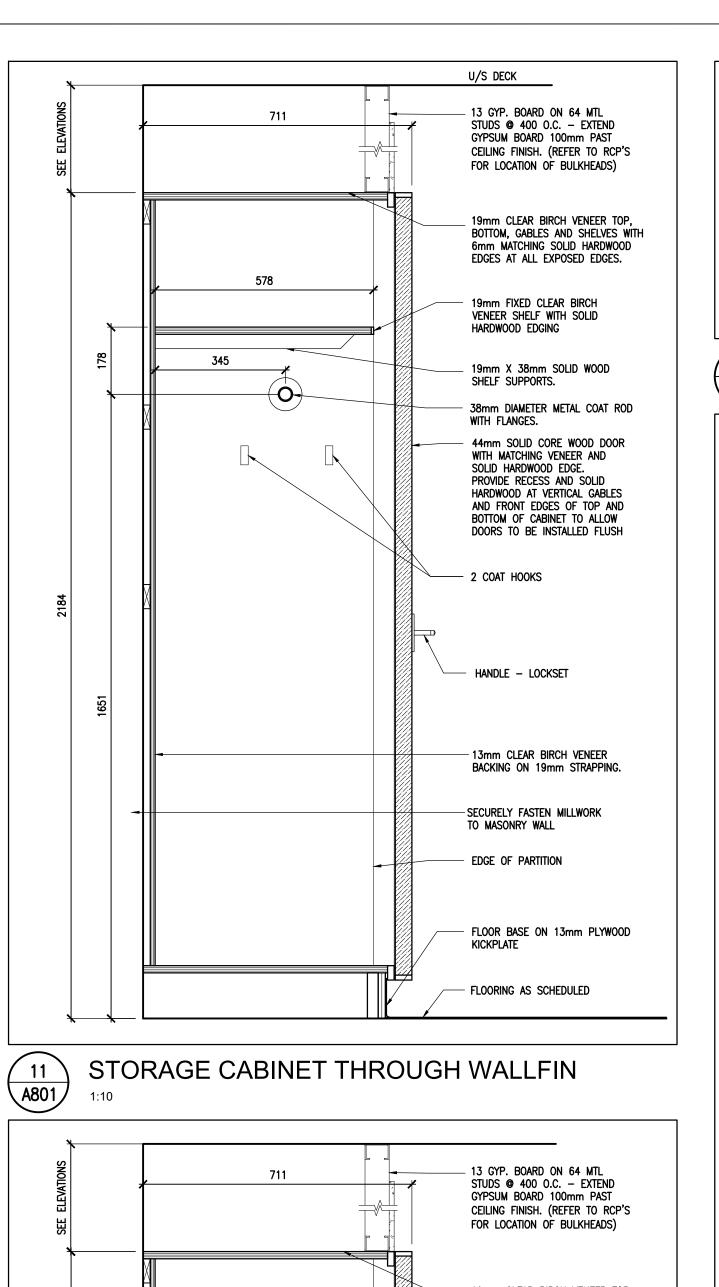


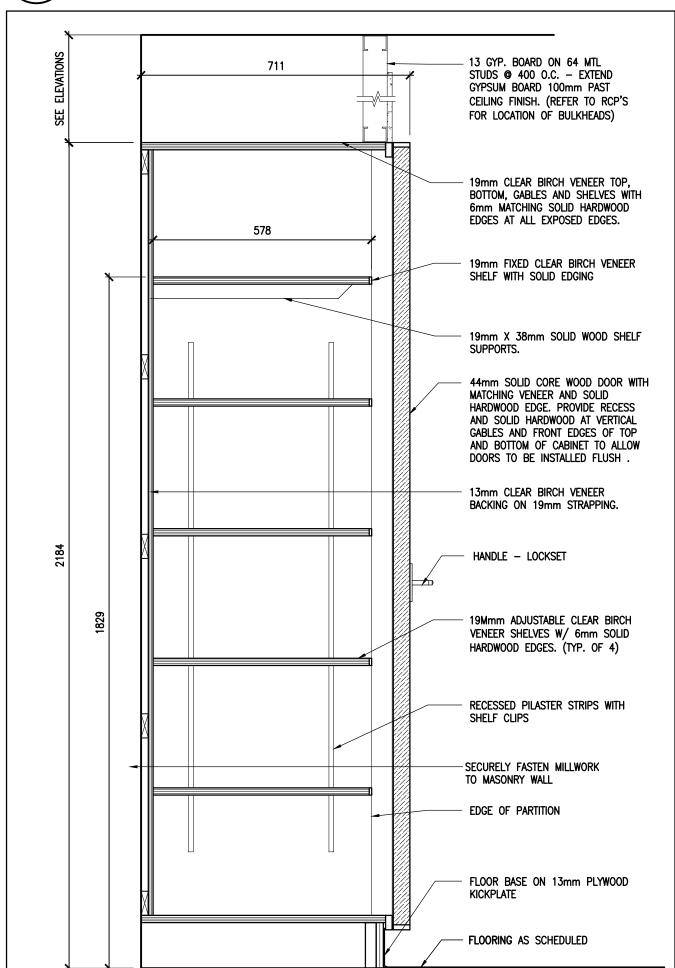


TEACHERS CLOSET THROUGH SHELVING

A801

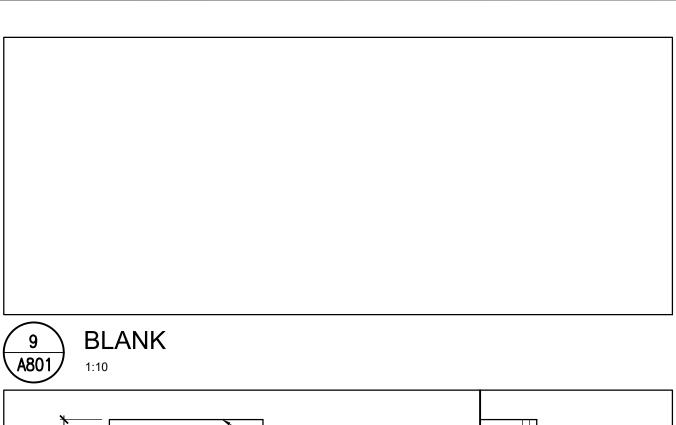


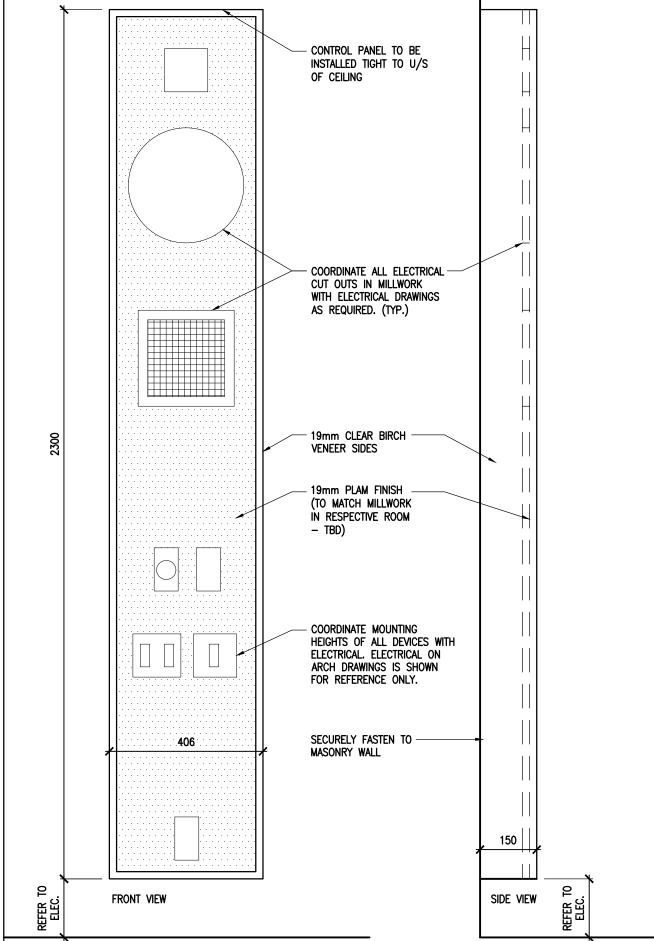


CONTROL PANEL SECTION AND ELEVATION

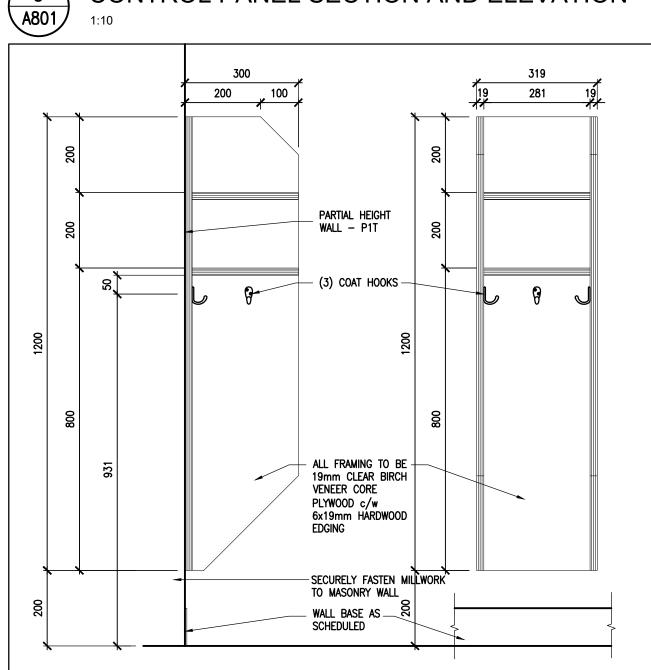


KINDERGARTEN CUBBIES A801

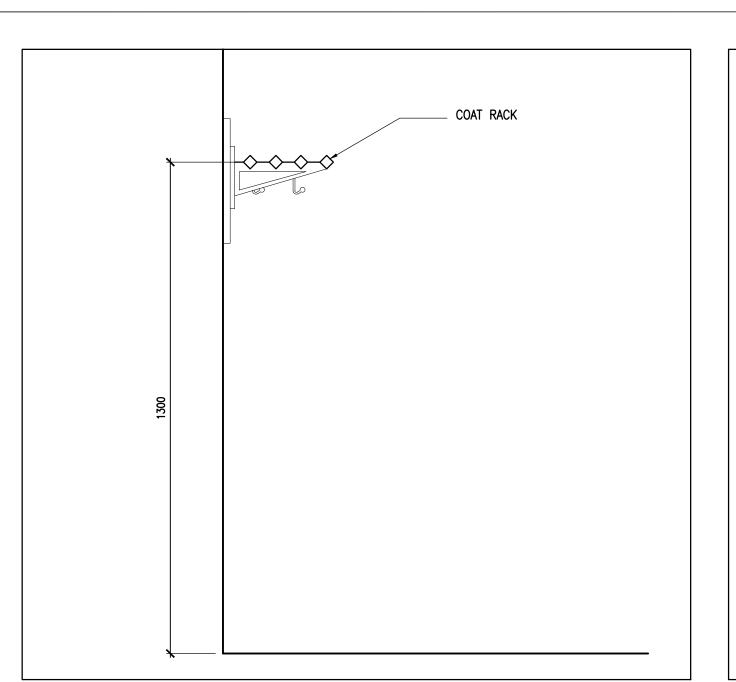


UPPER SHELVING WITH COAT RACK

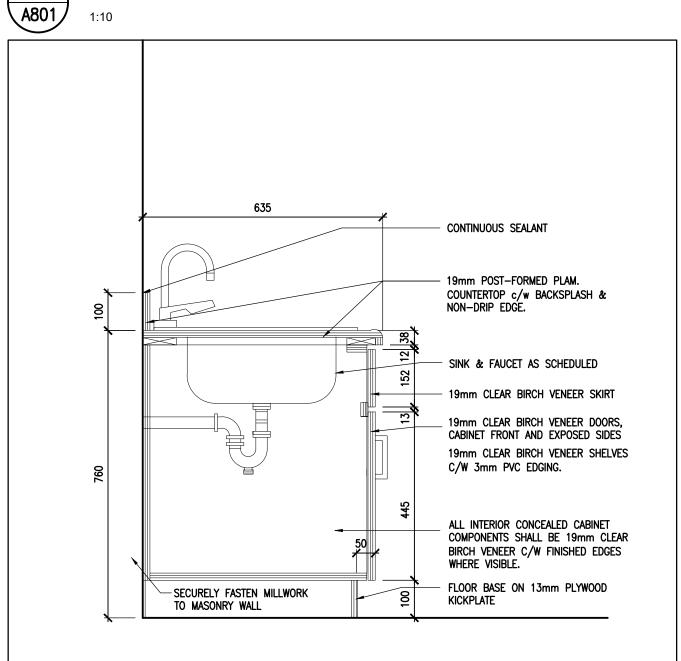


SINK BASE CABINET - 760H A801 1:10

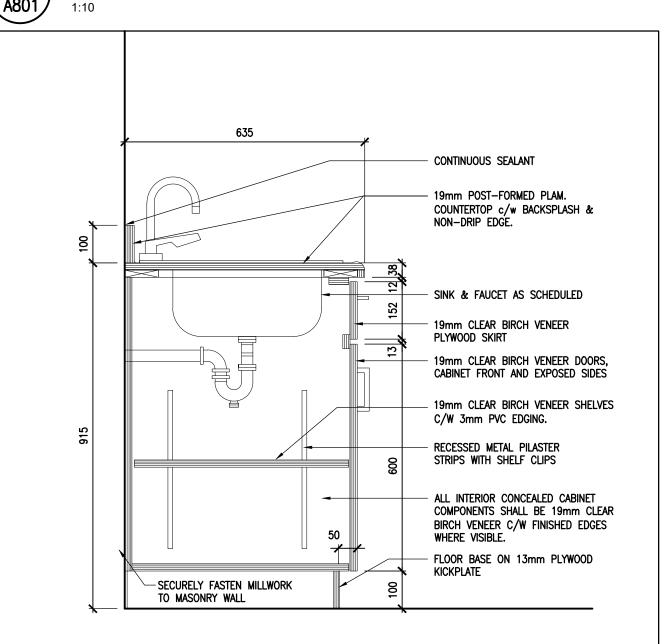


SINK BASE CABINET - 915H A801

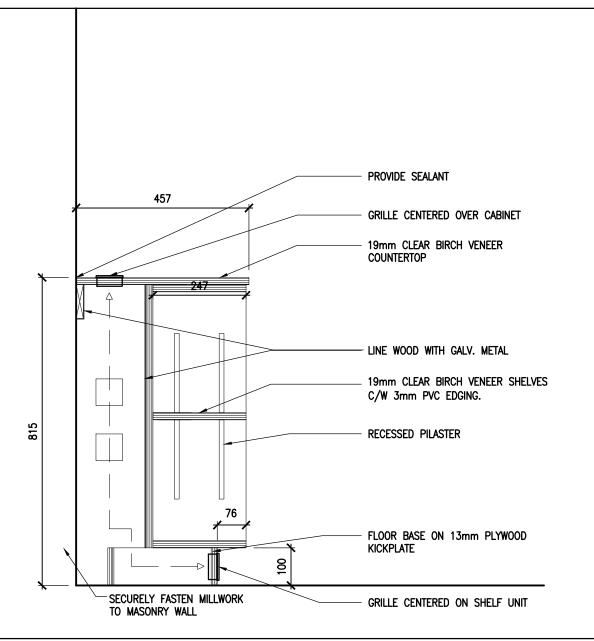

BOOK SHELVES THROUGH WALLFIN A801

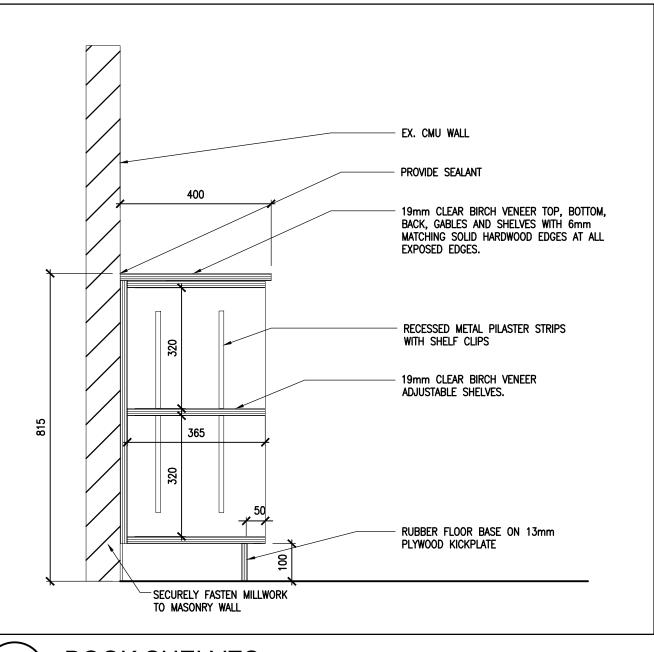

2 A801 **BOOK SHELVES**

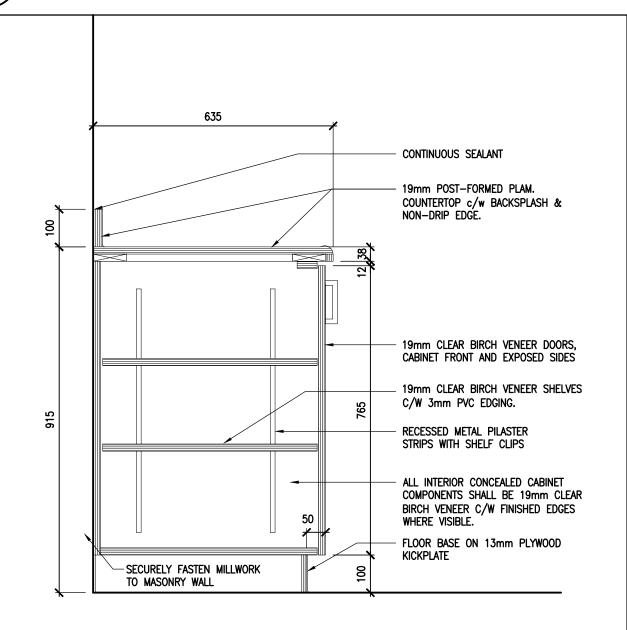

BASE CABINET - 915H A802

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CHECK AND VERIFY ALL DIMENSIONS AT THE SITE.

DO NOT SCALE THE DRAWINGS.

NO.	ISSUES	DATE	BY
1	CLIENT REVIEW	JAN. 19 2024	BBA
2	CLIENT REVIEW	FEB. 23 2024	BBA
3	ISSUED FOR TENDER	MAR. 1 2024	BBA

District School Board

NO.	REVISIONS	DATE	BY

PROJECT:

HAMPTON Jr. PUBLIC SCHOOL **INTERIOR RENOVATIONS**

43 ORMISTON ST., HAMPTON, ON KPRDSB - HAMPTON Jr. PUBLIC SCHOOL

DRAWING:

MILLWORK SECTIONS




BARRY BRYAN ASSOCIATES	DESIGN BY: BBA	DOC (
Architects Engineers	DRAWN BY: KW	% COI
Project Managers	CHECKED BY:	INITIAL
250 Water Street	-	
Suite 201	DATE:	
Whitby, Ontario L1N 0G5	JAN. 2024	
Tel: (905) 666-5252	SCALE: AS NOTED	

Fax: (905) 666-5256 e-mail: bba@bba-archeng.com FILE: 24004 Millwork A801.dwg

PROJECT NO: DRAWING NO: 24004

A801

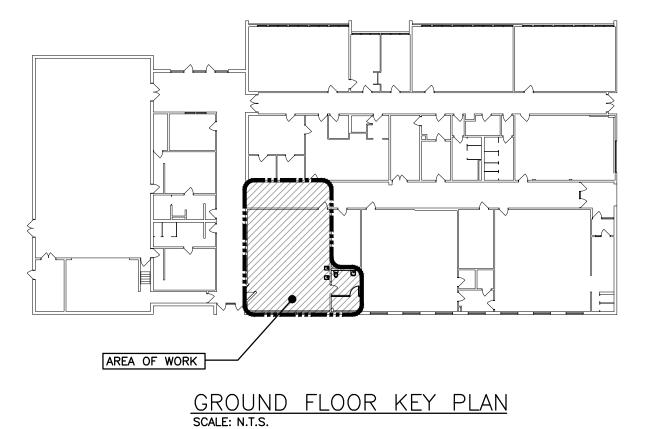

Manufacturer &

2 ROW, 18" HIGH CABINET BOTTOM MOUNTED AT 6"-8" AFF

2 ROW, SUSPENDED IN MILLWORK WITH ALL MOUNTING HARDWARE.

2 ROW, 18" HIGH CABINET, SLOPED TOP & BOTTOM FOR MOUNTING HIGH ON WALL

Model

HEATING COMPONENT SCHEDULE

H-1 RADIATION

RADIATION

RADIATION

FAN SCHEDULE

H-2 (MOUNTED HIGH)

H-3 (ELEMENT ONLY)

Capacity EWT MBH *F

AS NOTED | AS NOTED | 150 | 130

AS NOTED | AS NOTED | 150 | 130 | 70 | ENG AIR WF-1B

AS NOTED AS NOTED 150 130 70 ENG AIR ELEMENT

Exhaust Air Data
Capacity Size SP Voltage Manufacturer Model

GENERAL NOTES

- ALL DRAWINGS ARE TO BE READ IN CONJUNCTION WITH THE PREPARED SPECIFICATION.
- CONTRACTOR TO INCLUDE COST FOR CONSULTANT TO COMPLETE ELECTRONIC CAD AS-BUILT DWGS (ALL PAGES). REFER TO SPEC SECTION 15010/20 02 51 - RECORD DWGS.
- SANITARY VENT PIPING IS NOT SHOWN. PROVIDE ALL NECESSARY VENT PIPING FROM ALL FIXTURES FOR A COMPLETE SYSTEM TO ALL LOCAL PLUMBING CODE & LOCAL AUTHORITY REQUIREMENTS, CONNECTED TO EXISTING VENTS OR NEW VENTS AS REQUIRED. CO-ORDINATE VENT LOCATION(S) WITH GENERAL CONTRACTOR.
 MAINTAIN MIN 14'-0" FROM ANY AIR INLET. INSTALL VENT PIPING HIGH IN JOIST SPACE.
- WHERE DUCTWORK PENETRATES CORRIDOR WALL, CENTER DUCT(S) BETWEEN OWSJ.
- CO-ORDINATE WITH THE GENERAL CONTRACTOR ANY OWSJ BRIDGING/CROSS BRACING RELOCATION OR REMOVAL/REPLACEMENT REQUIRED FOR INSTALLATION OF DUCTWOŔK.

Remarks

- CONTRACTOR TO LOCATE ISOLATION VALVES / FREEZE PIPING / OR OTHERWISE DRAIN SYSTEMS TO ALLOW PROPOSED WORK TO PROCEED. REFILL SYSTEMS AS INDICATED.
- UPON COMPLETION OF THE PROJECT OR UPON COMPLETION OF EACH INDIVIDUAL PHASE OF THE PROJECT THE CONTRACTORS SHALL PROVIDE THE FOLLOWING CERTIFICATES BEFORE CONFORMANCE LETTERS ARE ISSUED BY THE CONSULTANT:
- POTABLE WATER TEST (SEE SPEC 15142/22 11 16 PART 3) ALL CERTIFICATES ARE TO BE SUBMITTED TOGETHER IN A SINGLE PACKAGE.

Item	Description	Item	Description	Item	Description
	- ITEM TO BE REMOVED		- UNION	TCV	2-WAY TEMPERATURE CONTROL VALVE
	CUT EXISTING & CONNECT NEW PIPING	 5 	- STRAINER	TCV	3-WAY TEMPERATURE CONTROL VALVE
-	- FLOW DIRECTION	₽vB	VACUUM BREAKER	_C D	THERMOSTAT (WITH GUARD WHERE INDICATED)
•	- POTABLE COLD WATER		SCREWED OR WELDED PIPE CAP	}}}}	TURNING VANES
	- POTABLE HOT WATER	NO	NORMALLY OPEN		SUPPLY AIR DUCT
	POTABLE HOT WATER RECIRC.	NC	NORMALLY CLOSED		RETURN/EXHAUST AIR DUCT
-SAN-EX-	- EXISTING SAN ABOVE FLOOR	RIC	RETURN IN CABINET	-	ACOUSTIC DUCT LINING
-SAN-EX-	- EXISTING SAN BELOW FLOOR	AFF	ABOVE FINISHED FLOOR		THERMAL INSULATION
- — SAN — -	- SANITARY ABOVE FLOOR	AFR	ABOVE FINISHED ROOF		BRANCH LINE SPIN-IN COL C/W BALANCING DAMPER
	- SANITARY BELOW FLOOR	<u>Ι</u> δι	- BALL VALVE		TRUNK MAIN BRANCH COLL C/W BALANCING DAMPER
—CD	- CONDENSATE DRAIN		BUTTERFLY VALVE	— BD	BALANCING DAMPER
— -V- — -	- VENT	A	- GATE VALVE	— OBD	OPPOSED BLADE DAMPER
FD O	FLOOR DRAIN	oco	FLOOR CLEANOUT	→ FF	FIRE FLAP
9-P-	TRAP PRIMER	1 CO	LINE CLEANOUT	 M	MOTORIZED DAMPER
	_ TEE CONNECTION	AD	ACCESS DOOR	FD	FIRE DAMPER
c —	PIPE DOWN	EXP W	EXPANSION JOINT	FSD	FIRE/SMOKE DAMPER
o —	PIPE UP	—— EX ——	EXISTING DUCT (SIZE AS INDICATED)	}	RECTANGULAR DUCTWORK
~	- FLEXIBLE CONNECTION	NO COMM	3-WAY MIXING VALVE		RIGID ROUND DUCT
	- REDUCER/INCREASER	≰ C	VALVE ON RISER		FLEXIBLE ROUND DUCT
N	- CHECK VALVE	BV	BALANCING VALVE	Type Size Capacity	DIFFUSER/GRILLE SIZE (im TYPE & CAPACITY (cfm)
				Type Size / cfm Capacity	HYDRONIC HEATING SIZE, TYPE & CAPACITY

<u>GRI</u>	GRILLE SCHEDULE							
Item	Туре	Manufacturer & Model	Finish	Remarks				
D1	SQUARE CEILING SUPPLY	KRUEGER 1400A	BKIIIZH MHIIF	ACCEPTABLE, C/W FIRE FLAP & FIRE BLANKET				
R1	CEILING RETURN	KRUEGER EGC5	BRITISH WHITE	ALUMINUM, C/W SCREWED FASTENING, C/W FIRE FLAP				
R2	TOE SPACE GRILLE	KRUEGER 1350	BRITISH WHITE	PAINTED PUNCH STEEL 1"x1" SPACING WITH 1/2"x1/2" HOLE				
S1	LINEAR BAR GRILLE	KRUEGER 1850	BRITISH WHITE	FIXED 0°, 7mm (1/4") SPACING, MILLWORK MOUNTED, SCREWED NARROW BORDER FASTENING WITH MITRED CORNERS. PROVIDE CONTINUOUS GRILLE WHERE NOTED				

		cfm		in. wc	O AW MIDDATION ICOLATION HANGEDS CREED CONTROLLED ALLIMINIMA	ODULE FOR NUMBER & I	COATION OF FANC	RI CEILING RETURN	EGC5	BRIIISH WHILE C	•
EF-101 CEILING MOUNTED EXHAUST	LOCAL EXHAUST	150	Fhp	0.125 120/1/60 PENN BARRY	Z5H C/W VIBRATION ISOLATION HANGERS, SPEED CONTROLLER, ALUMINUM REFER TO PLAN, C/W FIRE DAMPER			R2 TOE SPACE GRILL	KRUEGER 1350		PAINTED PUNCH STEEL 1"x1" SPACING WITH 1/2"x1/2" HOLE
CEILING MOUNTED EXHAUST	LOCAL EXHAUST	100	Fhp	0.125 120/1/60 PENN BARRY	Z5H C/W VIBRATION ISOLATION HANGERS, SPEED CONTROLLER, ALUMINUM REFER TO PLAN, C/W FIRE DAMPER	GRILLE. FOR NUMBER & L	LOCATION OF FANS	S1 LINEAR BAR GRILLE	KRUEGER 1850	BRITISH WHITE F	IXED 0°, 7mm (1/4") SPACING, MILLWORK MOUNTED, SCREWED NARROW BOR ASTENING WITH MITRED CORNERS. PROVIDE CONTINUOUS GRILLE WHERE NOTE
PLUMBING FIX	KTURE SCH	IEDU	<u>LE</u>								
	Connec	tion Size	es		Fixture			Trim			Accessories
Item Type	HW CW TW	V Drain	Vent	Acceptable Manufacturer	Fixture Description	Acceptable Manufacturer		Trim Description		Acceptable Manufacturer	Accessory Description
WC-1 WATER CLOSET F TANK ROUND BO		80	40	AMERICAN STANDARD CADET PRO 215DA-104 4188A-154 KOHLER ZURN	VITREOUS CHINA, TANK WITH LINER & FLAPPER TYPE VALVE ASS'Y, ROUND RIM, TWO PIECE (TANK & BOWL) CLOSE COUPLED, BOLT CAP, BOTTOM OUTLET, FLOOR-MOUNTED, CHROME LEVER HANDLE, 12" ROUGH-IN, MIN 2" TRAP WAY, MAXIMUM 6 itres (1.6 gal) PER FLUSH.					SEAT: BEMIS 7850TDG CENTOCO	SEAT: WHITE, ROUND, CLOSED FRONT WITH COVER, MOLDED SOLID ANTIMICROBIAL PLASTIC, STAINLESS STEEL CHECK HINGES, STAINLESS STEEL OR SOLID BRASS INSERT POST.
L-1 WALL HUNG LAV SINGLE HANDLE	FAUCET 15 15	5 32	32	AMERICAN STANDARD LUCERNE 355.012 KOHLER BRENHAM K-1997 ZURN Z5344	WALL-HUNG SINK, VITREOUS CHINA, WITH SPLASH LIP, SUPPLY OPENINGS ON 100 MM (4") CENTRES, OVERFLOW. SIZE: 557 MM X 502 MM (21 15/16" X 19 3/4").	MOEN COMMERCIAL	AERATOR & QUARTER TUP	ATED LEVER HANDLE, MIXING SPO RN CERAMIC DISC CARTRIDGE. PRO RATE TO 8.35 L/MIN (2.2 GPM) RES	OVIDE ACCESSORIES		INSULATION: INSULATE WASTE AND SUPPLIES WITH UL LISTED PREFORMED INSULATION SYSTEM COMPLETE WITH SEAMLESS JACKET. WASTE FITTING: INTEGRAL STAINLESS STEEL BASKET STRAINER/STOPPER, TAILPIECE, CHROME PLATED P—TRAP PROVIDE FLOOR MOUNTED WALL CARRIER
S-1 STAINLESS STEEL CLASSROOM SINGLE SINK	15 15	40	32	KINDRED LBS6808-1/3 NOVANNI 1017I	SINK: SINGLE COMPARTMENT, LEDGE-BACK. FROM 1.0 mm (20 GAUGE) THICK TYPE 302 POLISHED STAINLESS STEEL, SELF-RIMMING, UNDERCOATED, CLAMPS. OVERALL SIZES: 520 mm X 510 mm X 200 mm (20½" X 20" X 8").	DELTA 26T3944 ZURN Z871B4 MOEN COMMERCIAL 8285 & S0030	FAUCET: CHROME PLATED BRASS, HANDLES, WASHERLESS C TO 8.35 I/min (2.2 gpm	WITH GOOSENECK SWING SPOUT, CONTROLS, ACCESSORIES TO LIMIT h) AT 413 kPa (60 psi).	AERATOR, LEVER MAXIMUM FLOW RATE		WASTE FITTING: INTEGRAL STAINLESS STEEL BASKET STRAINER/STOPPER, TAILPIECE, CAST BRASS P—TRAP WITH CLEANOUT.
BF-1 PUSH BACK BOTTLE FILLER	15			T&S B-1210-01	BOTTLE FILLER: 10" HIGH DECK MOUNT GLASS FILLER, ADJUSTABLE FLOW OUTLET, DARK BLUE PUSH BACK ARM, INSTANTANEOUS SHUT OFF, PEDESTAL W/ ADJUSTABLE 2"Ø FLANGE, POLISHED CHROME PLATED BRASS BODY & PEDESTAL, CHROME PLATED METAL FLANGE AND THERMOPLASTIC ARM						
FD-1 FLOOR DRAIN		NOTEC		ZURN ZN415B MIFAB F1100-C CONTOUR C2000-R6 WATTS FD-100-C-A	CAST IRON BODY, ADJUSTABLE HEAD, NICKEL BRONZE STRAINER, INTEGRAL SEEPAGE PAN, AND CLAMPING COLLAR. USE SQUARE STRAINER IN TILED AREAS AND ROUND STRAINER ELSEWHERE. C/W TRAP PRIMER						
FFD-1 FUNNEL FLOOR [PRAIN	NOTED		ZURN ZN-415-BF MIFAB F1100-C-EG CONTOUR C2000-R5HNB WATTS FD-100-C-EG-1	COMBINATION FUNNEL FLOOR DRAIN CAST IRON BODY WITH INTEGRAL SEEPAGE PAN, CLAMPING COLLAR, NICKEL—BRONZE ADJUSTABLE HEAD STRAINER WITH INTEGRAL FUNNEL. C/W TRAP PRIMER.						

The contractor shall verify all dimensions and report all errors and discrepancies to the Consultant before commencement of and discrepancies to the Consultant before commencement of the work.

The drawings show general arrangement of services. Follow as closely as actual building construction will permit. Obtain approval for relocation of service from Consultant before commencement of the work.

The drawings do not indicate all offsets fitting and accessories which may be required. Provide the same to meet the required conditions which may be required. Provide the same to meet the required conditions.

Drawings and specifications, etc., prepared and issued by the consultant are the property of the consultant and must be returned at the completion of the project. These documents are not to be duplicated or copied without the consent of the Consultant. Do not scale this drawing.

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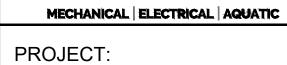


NO. ISSUES



DATE BY

2 ISSUED FOR TENDER REVIEW 23.02.24 MW 3 ISSUED FOR TENDER 01.03.24 MW	1	ISSUED FOR COORDINAT	ION 07.02	2.24 MW
	2	ISSUED FOR TENDER RE	23.02 23.02	2.24 MW
NO. REVISIONS DATE BY	3	ISSUED FOR TENDER	01.03	3.24 MW
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HAMPTON Jr. PUBLIC SCHOOL INTERIOR RENOVATIONS

Consulting Engineers

43 ORMISTON ST., HAMPTON, ON KPRDSB - HAMPTON Jr. PUBLIC SCHOOL

DRAWING:

KEYPLAN, LEGENDS, AND SCHEDULES





ARRY BRYAN SSOCIATES
rchitects ngineers roject Managers
0 Water Street lite 201 nitby, Ontario N 0G5


Tel: (905) 666-5252 Fax: (905) 666-5256 e-mail: bba@bba-archeng.com

CHECKED BY: MW FEB 2024 AS NOTED

DRAWN BY:

PROJECT NO: 24004

M101

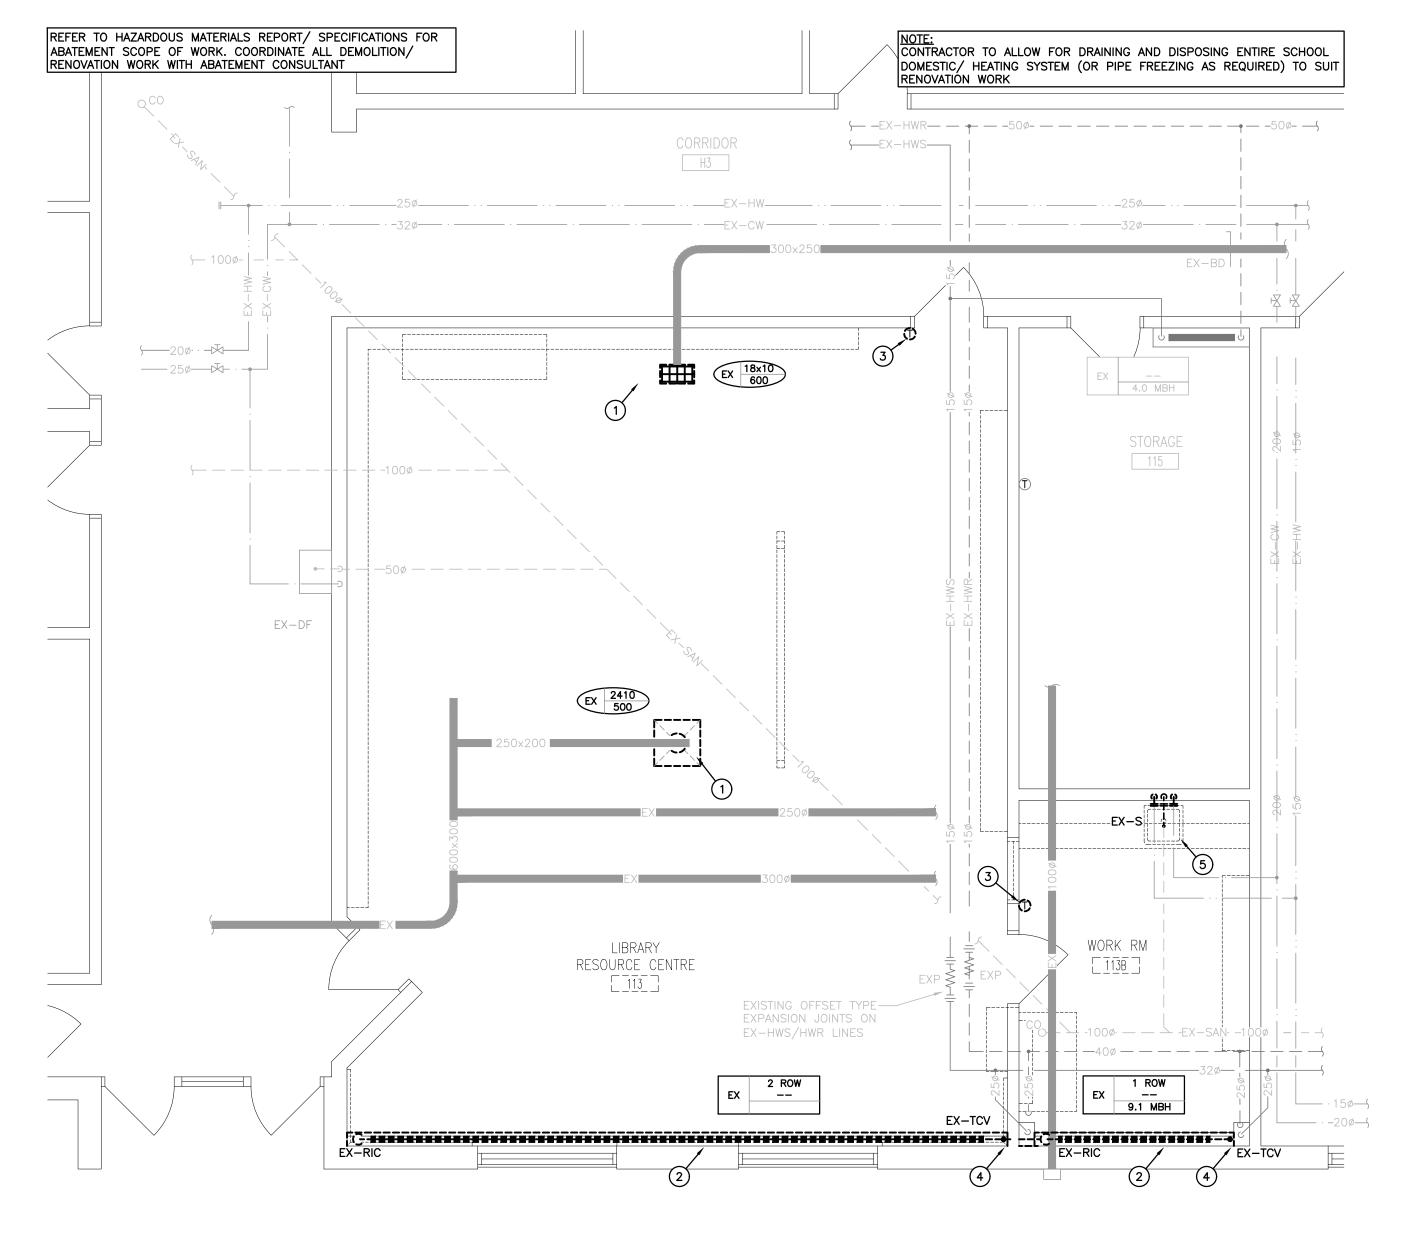

PART PLAN — DEMOLITION SCALE: 1:50

GENERAL DEMOLITION NOTES

- EXISTING MECHANICAL ITEMS NOT SHOWN SHALL REMAIN UNLESS NOTED OTHERWISE.
- EXISTING MECHANICAL ITEMS SHOWN BUT NOT NOTED AS BEING REMOVED OR RENOVATED SHALL REMAIN AS PRESENTLY INSTALLED AND OPERATING.
- THIS CONTRACTOR SHALL BE RESPONSIBLE FOR VERIFYING ON SITE ALL LOCATIONS AND SIZES OF ALL SERVICES & EQUIPMENT PRIOR TO THE COMMENCEMENT OF WORK.
- ALL OPENINGS THAT RESULT FROM THE REMOVAL OF EQUIPMENT OR SERVICES SHALL BE NEATLY PATCHED WITH SUITABLE NEW MATERIALS TO SUIT EXISTING CONSTRUCTION.
- PLUMBING VENTS ARE NOT INDICATED OR IDENTIFIED. REMOVE ALL REDUNDANT VENTS WHILE MAINTAINING INTEGRITY OF EXISTING
- REMOVAL OF EXISTING PIPING, OR DUCT SYSTEMS INCLUDES REMOVAL OF ALL HANGERS, INSULATION, FITTINGS, ETC.
- MAINTAIN INTEGRITY OF EXISTING SYSTEMS THAT ARE TO REMAIN OR BE MODIFIED.
- INSTALL NEW SYSTEM OR SERVICES WHERE REQUIRED TO MAINTAIN SYSTEM OPERATION PRIOR TO DEMOLITION OF EXISTING SERVICES.
- THIS CONTRACTOR IS TO REMOVE & REPLACE CEILINGS AS REQUIRED FOR REMOVAL/REPLACEMENT OF SERVICES.

- 1. EXISTING GRILLE/DIFFUSER TO BE REMOVED COMPLETE.
- 2. EXISTING WALL FIN, CABINET AND ALL ASSOCIATED PIPING AND VALVES TO BE REMOVED COMPLETE.
- EXISTING TCV, BALANCING AND ISOLATION VALVES TO BE REMOVED COMPLETE. COORDINATE REMOVAL OF EXISTING WIRING WITH BAS
- BE REMOVED COMPLETE. EXISTING H&CW AND SANITARY PIPING TO BE CUT, CAPPED BEHIND FINISHED SURFACE AND REMOVED BEYOND COMPLETE.

he contractor shall verify all dimensions and report all errors and discrepancies to the Consultant before commencement of and discrepancies to the Consultant before commencement of the work.

The drawings show general arrangement of services. Follow as closely as actual building construction will permit. Obtain approval for relocation of service from Consultant before commencement of the work.


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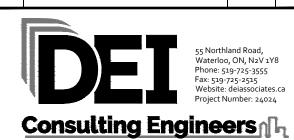
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		District S	School B	
NO.	ISSUES		DATE	BY
1	ISSUED FOR COORDI	NATION	07.02.24	MW
2	ISSUED FOR TENDER	REVIEW	23.02.24	MW
3	ISSUED FOR TENDER	?	01.03.24	MW





MECHANICAL | ELECTRICAL | AQUATIC

DATE BY

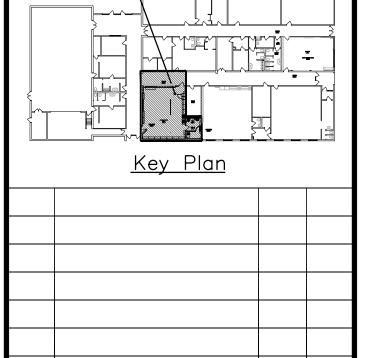PROJECT:

NO. REVISIONS


HAMPTON Jr. PUBLIC SCHOOL INTERIOR RENOVATIONS

43 ORMISTON ST., HAMPTON, ON KPRDSB - HAMPTON Jr. PUBLIC SCHOOL

DRAWING:

PARTIAL PLANS **DEMOLITION**



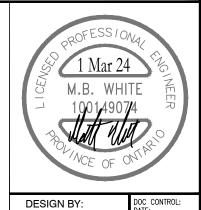

% COMPLETE:

BARRY BRYAN ASSOCIATES Architects Engineers Project Managers 250 Water Street Suite 201

Whitby, Ontario L1N 0G5 Tel: (905) 666-5252 Fax: (905) 666-5256

FEB 2024 AS NOTED e-mail: bba@bba-archeng.com FILE:

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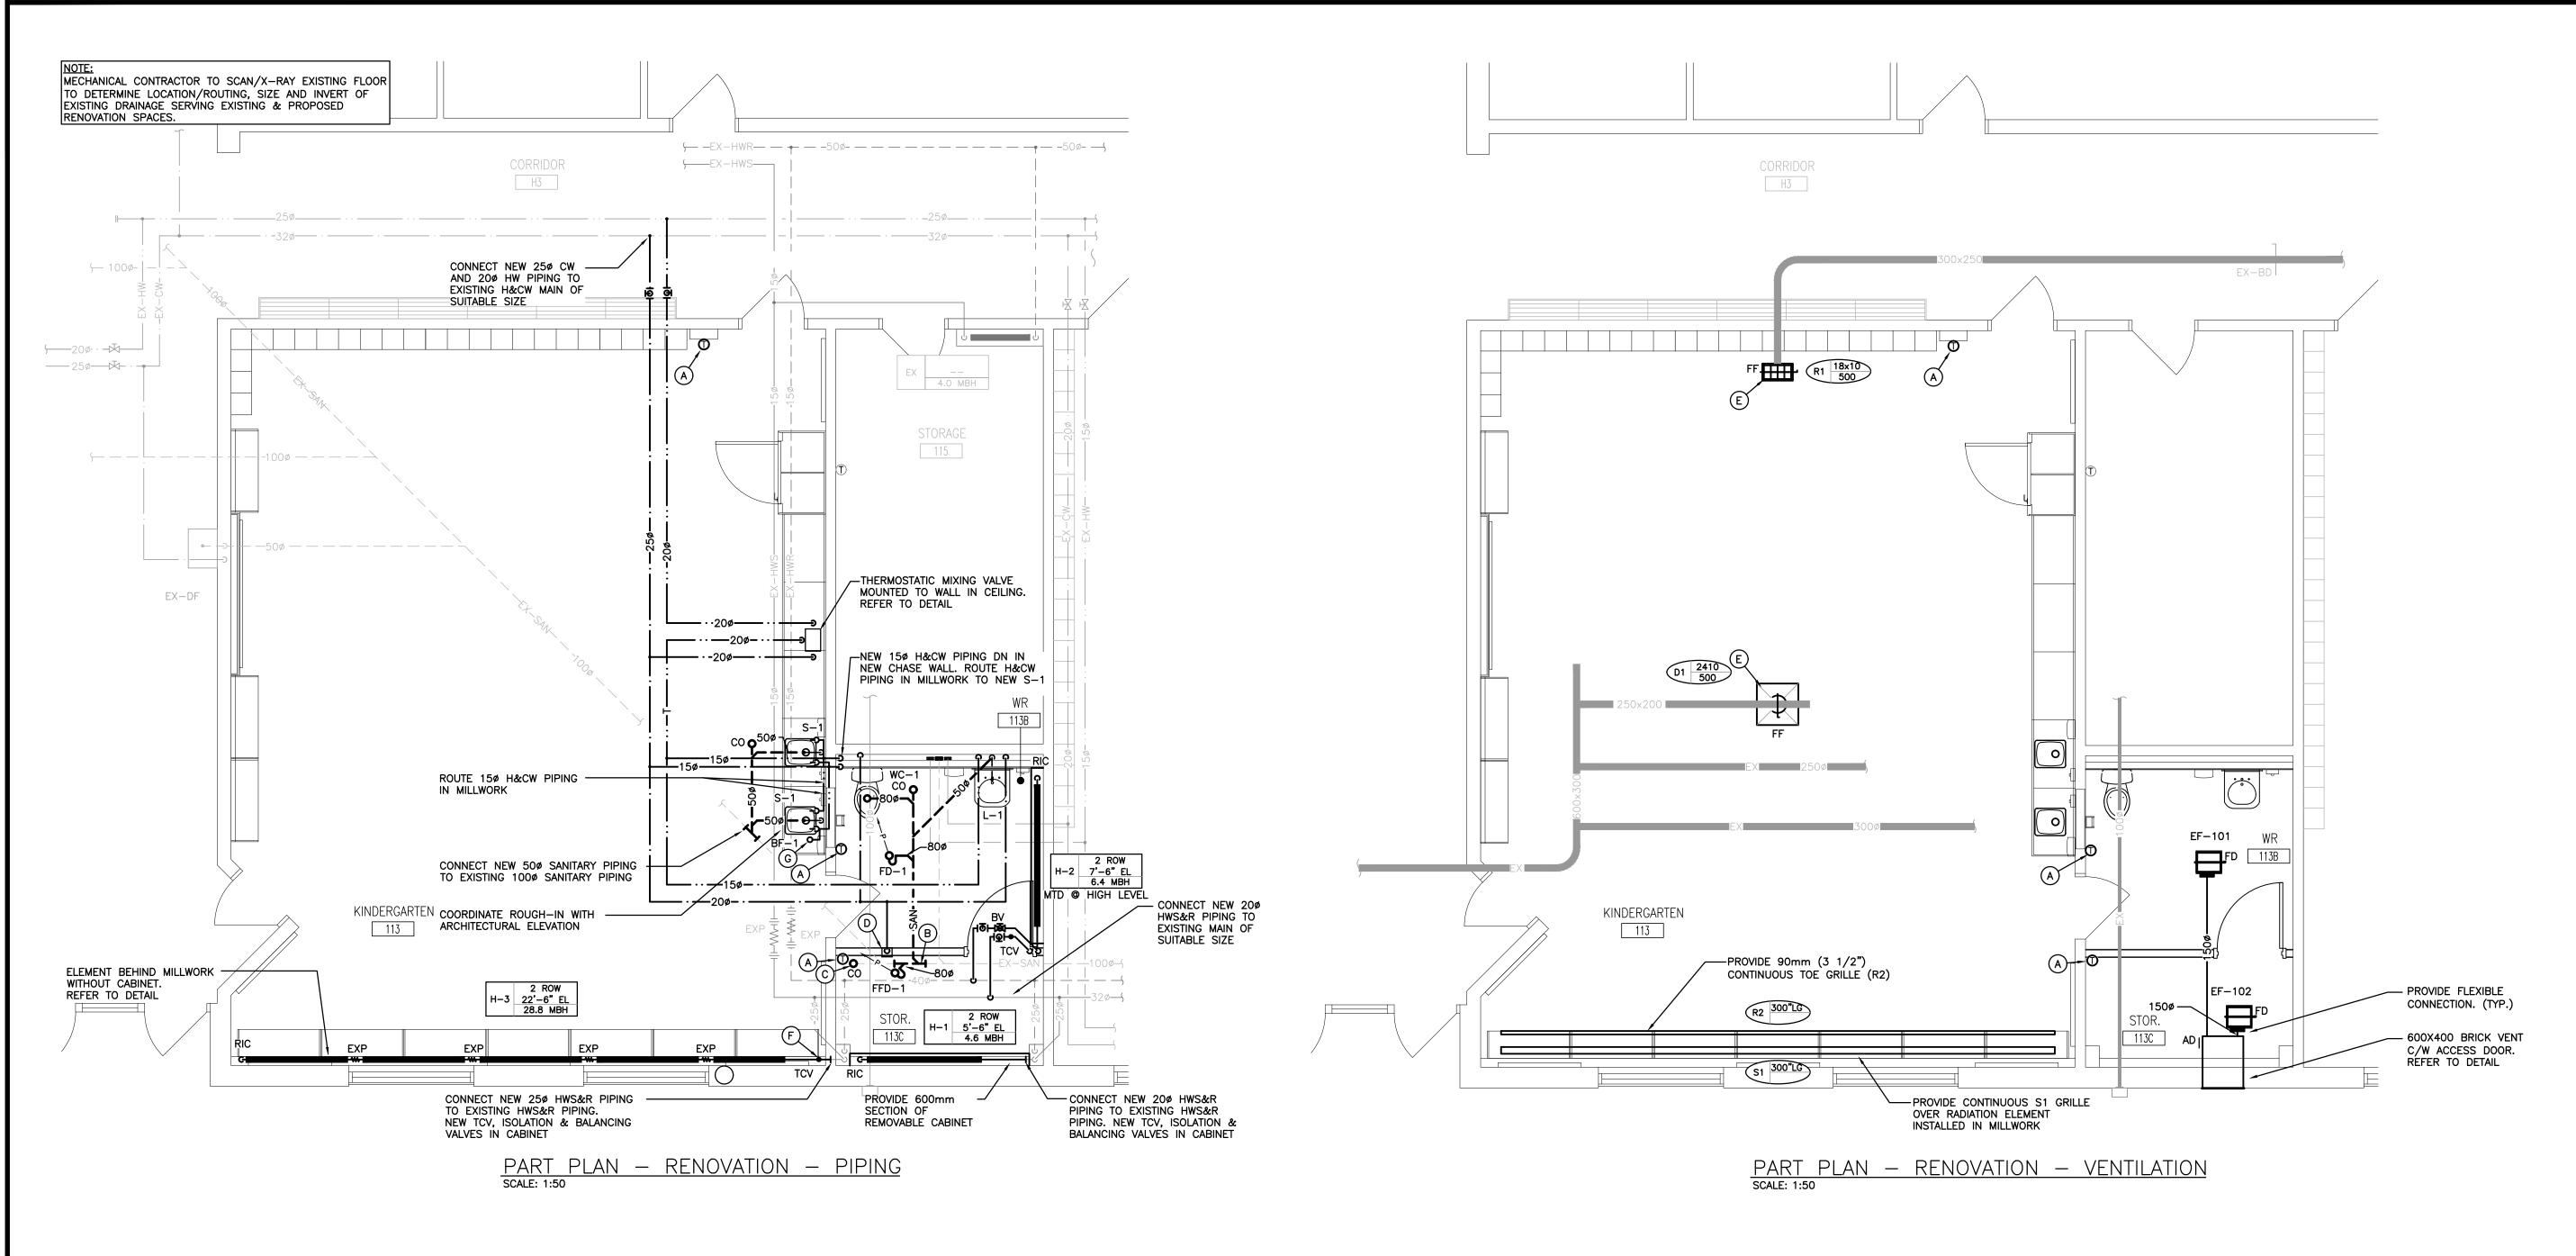
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24004 **M201**

SPECIFIC DEMOLITION NOTES

EXISTING THERMOSTAT/SENSOR TO BE REMOVED COMPLETE. COORDINATE REMOVAL OF EXISTING WIRING WITH BAS CONTRACTOR.

EXISTING PLUMBING FIXTURE AND ALL ASSOCIATED COMPONENTS TO



GENERAL RENOVATION NOTES

- REFER TO ARCHITECTURAL MILLWORK DRAWINGS FOR LOCATION OF
- COORDINATE UNDER FLOOR PIPE SLEEVES AND DRAINAGE PIPING.
- COORDINATE DRAINAGE PIPING WITH UNDER FLOOR ELECTRICAL PIPING. REFER TO ELECTRICAL DWGS.
- CO-ORDINATE ROUGH-IN AND MOUNTING HEIGHTS OF FIXTURES WITH MILLWORK AND ARCHITECTURAL DETAILS.
- PROVIDE VENTING FOR SANITARY FIXTURES TO OBC REQUIREMENTS. CO-ORDINATE VENTS THRU ROOF WITH GENERAL CONTRACTOR. MAINTAIN MINIMUM 3600MM (12'-0") BETWEEN SANITARY VENT AND ALL AIR INTAKE/EXHAUST OPENINGS.
- CO-ORDINATE ANY OWSJ BRIDGING RELOCATION OR REMOVAL/REPLACEMENT WITH THE GENERAL CONTRACTOR. PAY ALL COSTS REQUIRED TO MODIFY BRIDGING FOR INSTALLATION OF DUCTWORK.
- COORDINATE FINAL LOCATION OF GRILLES/DIFFUSERS ON SITE.
- THIS CONTRACTOR SHALL PROVIDE TIEWRAP TO WRAP 50 BUNDLES OF EXISTING LOOSE WIRES IN THE EXISTING CORRIDOR CEILING ON EACH FLOOR.
- REFER TO DEMOLITION DRAWINGS FOR EXTENT OF EXISTING PIPING ABOVE CEILINGS TO REMAIN.
- NOT ALL EXISTING PIPING, DUCTWORK, WIRING, ETC. IS INDICATED. 17 IS THE RESPONSIBILITY OF THIS CONTRACTOR TO REVIEW ALL EXISTING CONDITIONS ON SITE AND MAKE SURE ALL PIPING, DUCTWORK, WIRING, ETC, CAN BE INSTALLED AS INDICATED PRIOR TO SUBMITTING TENDER PRICE.
- ALL EXPOSED CONTROL WIRING IS TO BE IN WIREMOLD

SPECIFIC RENOVATION NOTES

- A. PROVIDE NEW DDC THERMOSTAT.
- B. CONNECT NEW 800 SANITARY PIPING TO EXISTING 1000 SANITARY
- C. CUT IN NEW CLEANOUT IN EXISTING LOCATION. FLUSH EXISTING SANITARY LINE.
- D. 200 CW PIPING DN TO TRAP PRIMER STATION. REFER TO DETAIL.
- E. CONNECT NEW DIFFUSER/GRILLE TO EXISTING DUCT. MODIFY EXISTING DUCTWORK AS REQUIRED TO SUIT. REBALANCE TO CAPACITY NOTED.
- PROVIDE SPACE IN CABINET FOR ISOLATION, TCV & BALANCING VALVE. C/W ACCESS DOOR.
- G. CONNECT NEW 150 CW PIPING TO NEW BF-1. MOUNT AND AIM BF-1 SUCH THAT BOTTLE FILLER WILL DISCHARGE INTO ADJACENT SINK IF NO BOTTLE IS PRESENT.

e contractor shall verify all dimensions and report all errors d discrepancies to the Consultant before commencement of The drawings show general arrangement of services. Follow as closely as actual building construction will permit. Obtain approval for relocation of service from Consultant before commencement of the work.

The drawings do not indicate all offsets fitting and accessories which may be required. Provide the same to meet the required conditions. conditions.


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NO.	ISSUES		DATE	BY
1	ISSUED FOR COORDI	NATION	07.02.24	MW
2	ISSUED FOR TENDER	REVIEW	23.02.24	MW
3	ISSUED FOR TENDER	!	01.03.24	MW
AREA	OF WORK _			





MECHANICAL | ELECTRICAL | AQUATIC

DATE BY

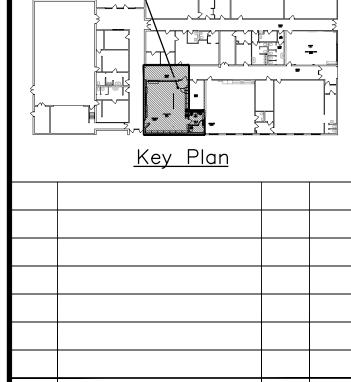PROJECT:

NO. REVISIONS


HAMPTON Jr. PUBLIC SCHOOL **INTERIOR RENOVATIONS**

43 ORMISTON ST., HAMPTON, ON KPRDSB - HAMPTON Jr. PUBLIC SCHOOL

DRAWING:

PARTIAL PLANS RENOVATION



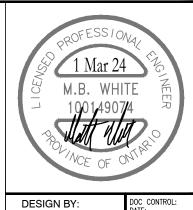

% COMPLETE:

BARRY BRYAN ASSOCIATES Architects Engineers Project Managers 250 Water Street Suite 201

Whitby, Ontario L1N 0G5 Tel: (905) 666-5252 Fax: (905) 666-5256

e-mail: bba@bba-archeng.com


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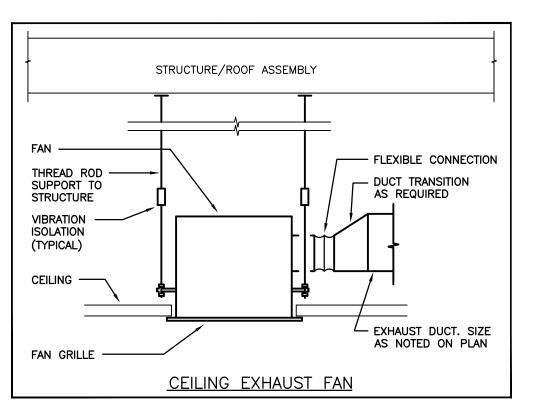
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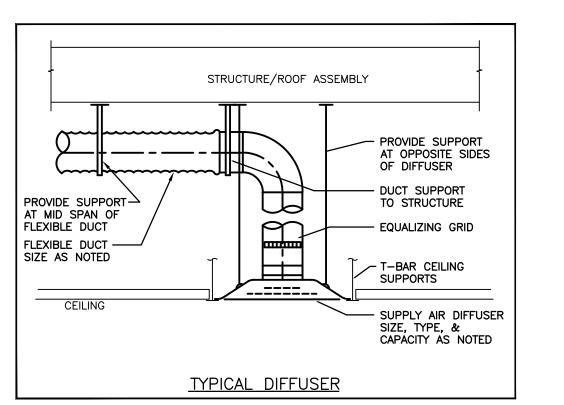
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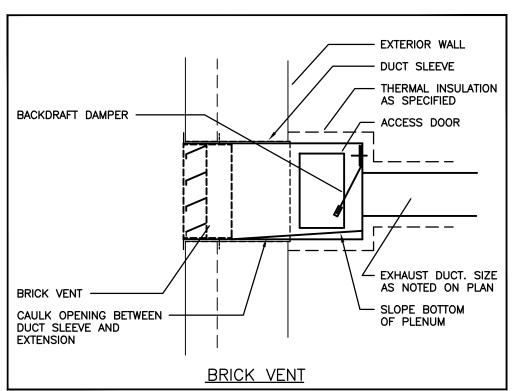
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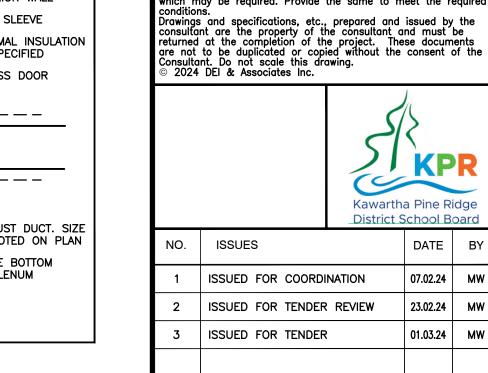
PROJECT NO: DRAWING NO: 24004 M301









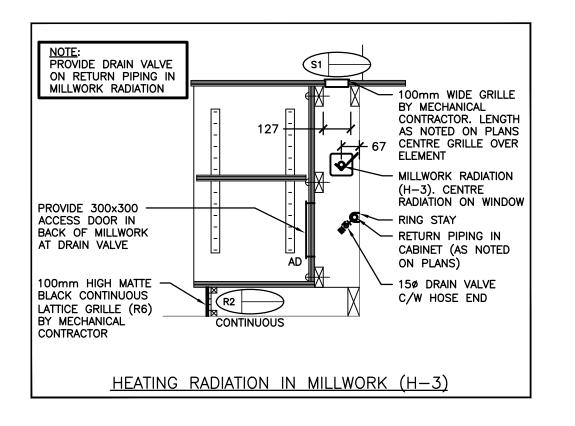

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The drawings do not indicate all offsets fitting and accessories which may be required. Provide the same to meet the required conditions.

DATE BY

07.02.24 MW

23.02.24 MW

01.03.24 MW

DATE BY

Waterloo, ON, N2V 1Y8 Phone: 519-725-3555


Fax: 519-725-2515 Website: deiassociates.ca


Consulting Engineers


MECHANICAL | ELECTRICAL | AQUATIC


HAMPTON Jr. PUBLIC SCHOOL

INTERIOR RENOVATIONS

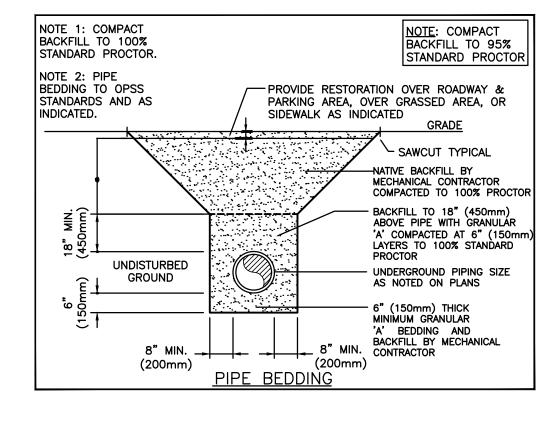


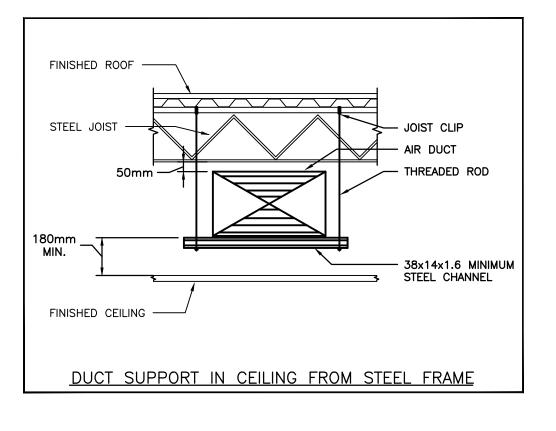


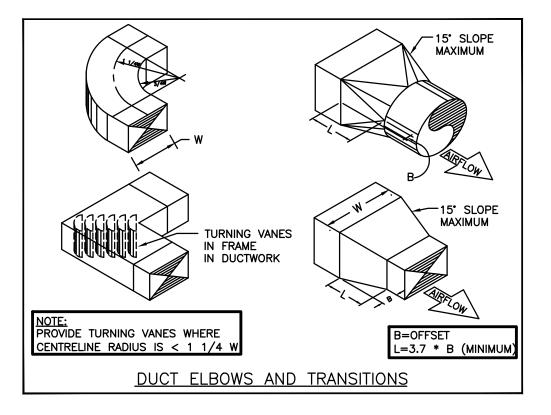


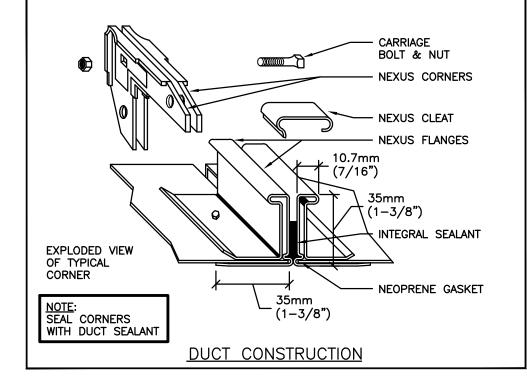





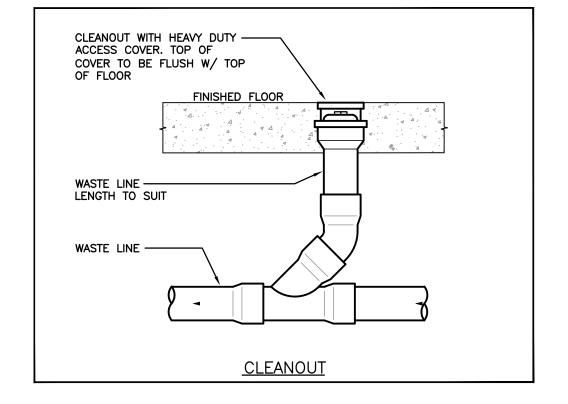


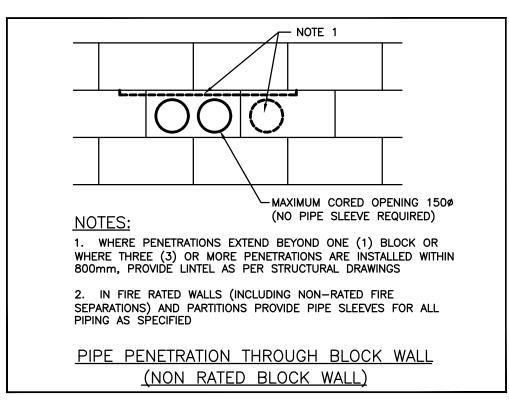


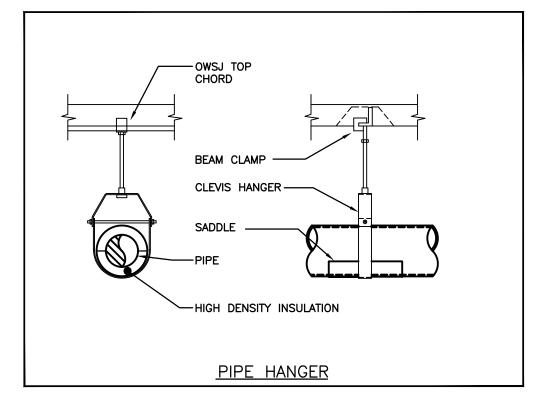


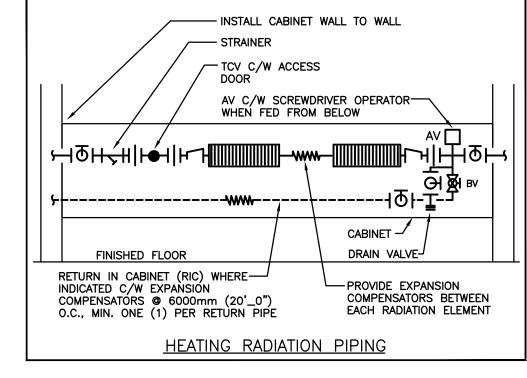


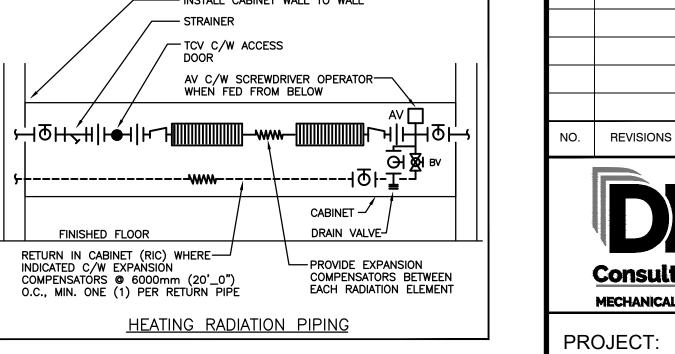


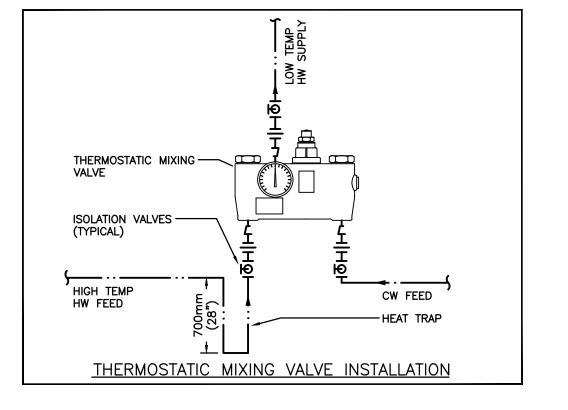


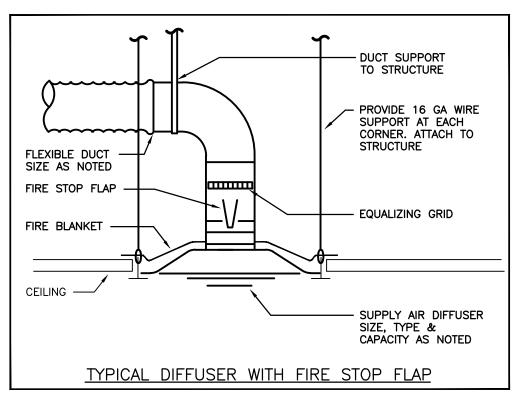

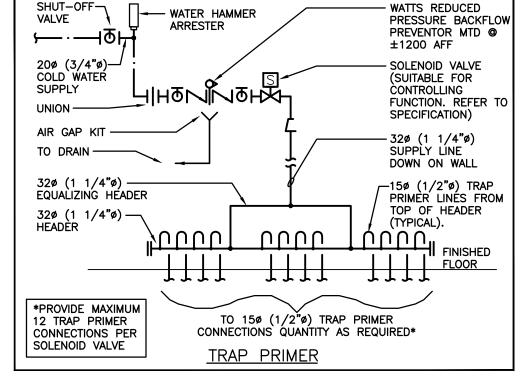

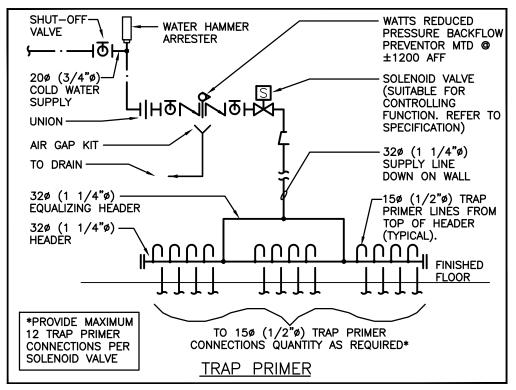

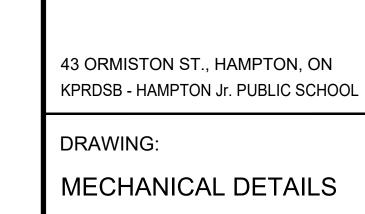

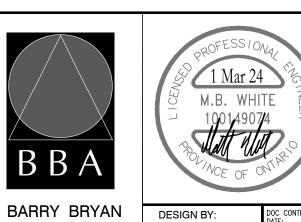



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BARRY BRYAN ASSOCIATES	DESIGN BY: DB	DOC CONTROL DATE:			
Architects Engineers	DRAWN BY: KB	% COMPLETE:			
Project Managers 250 Water Street	CHECKED BY: MW	INITIAL:			
Suite 201 Whitby, Ontario L1N 0G5	DATE: FEB 2024				
Tel: (905) 666-5252 Fax: (905) 666-5256	SCALE: AS NOTED				
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FILE:

PROJECT NO: DRAWING NO: M401 24004

e-mail: bba@bba-archeng.com



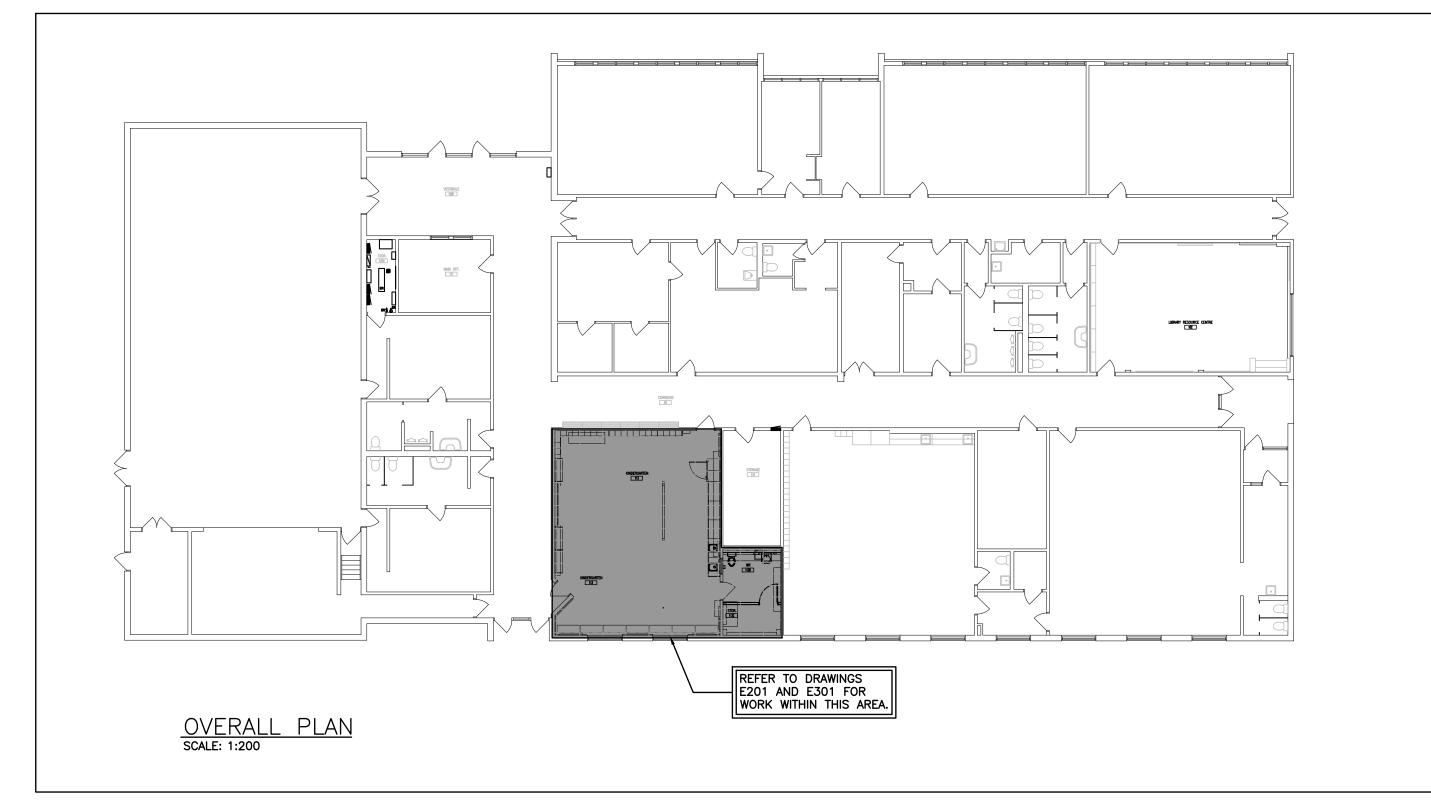


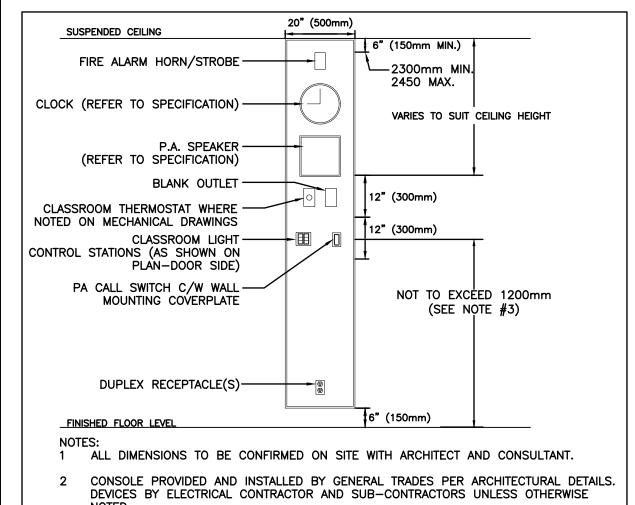MOUNTING HEIGHT OF CONTROL SWITCHES AND T-STAT IS NOT TO EXCEED 1200mm AS

A-MILLWORK CONSOLE DEVICE MOUNTING DETAIL

PER O.B.C. 3.8.1.5. ADJUST LAMINATE PANEL SIZE TO SUIT.

SCALE: NTS

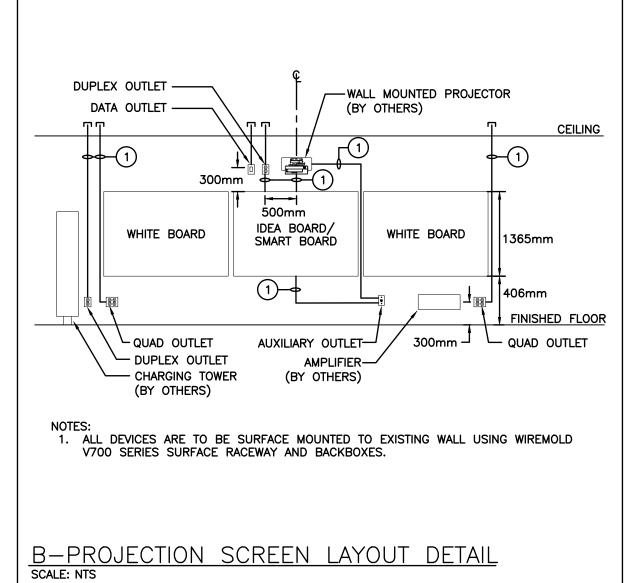



GHT FIXTURE SCHEDULE						
Manufacturer/Catalog Number	Voltage	Lamp	Mounting	CRI	Listings	Description
COOPER CAT. #24FPSL2SCT3 LITHONIA CAT. #CPX 2X4 ALO8 SWW7 M2 SIGNIFY CAT. #2SBP3550L8CS-4-UNV-DIM	120V	LED 6300 LUMENS 4000K 56.3W	RECESSED	80	DLC DAMP LOC.	2'X4' (610mmX1220mm) LED BACKLIT FLAT PANEL FIXTURE C/W FIELD SELECTABLE LUMENS AND COLOUR TEMPERATURE, WHITE FROSTED LENS, 10% 0-10V DIMMING DRIVER, AND WHITE FINISH. LIGHT FIXTURE SETTING IS TO BE SET AT "4000K" AND AT "MEDIUM"
AIMLITE #EBST12 SERIES: EM-1 #EBST12036-2SM4WLRWHT-ATD STANPRO CAT. #SLX12 SERIES EM-1 #SLA12036-2N4LJ/AT LUMACELL CAT. #RGS SERIES EM-1 #RG12S361LD7ATN	12V/120V	LED 2-4W MR16	SURFACE	N/A	N/A	LONG LIFE, SEALED RECHARGEABLE BATTERY PROVIDING MINIMUM EMERGENCY WATTAGE AS NOTED BY THE CATALOGUE NUMBER C/W MICRO SIZE 12V 4W (MINIMUM) LED HEADS AND AUTOTEST FEATURE.
	Manufacturer/Catalog Number COOPER CAT. #24FPSL2SCT3 LITHONIA CAT. #CPX 2X4 ALO8 SWW7 M2 SIGNIFY CAT. #2SBP3550L8CS-4-UNV-DIM AIMLITE #EBST12 SERIES: EM-1 #EBST12036-2SM4WLRWHT-ATD STANPRO CAT. #SLX12 SERIES EM-1 #SLA12036-2N4LJ/AT LUMACELL CAT. #RGS SERIES	Manufacturer/Catalog Number COOPER CAT. #24FPSL2SCT3 LITHONIA CAT. #CPX 2X4 ALO8 SWW7 M2 SIGNIFY CAT. #2SBP3550L8CS-4-UNV-DIM AIMLITE #EBST12 SERIES: EM-1 #EBST12036-2SM4WLRWHT-ATD STANPRO CAT. #SLX12 SERIES EM-1 #SLA12036-2N4LJ/AT LUMACELL CAT. #RGS SERIES	Manufacturer/Catalog Number COOPER CAT. #24FPSL2SCT3 LITHONIA CAT. #CPX 2X4 ALO8 SWW7 M2 SIGNIFY CAT. #25BP3550L8CS-4-UNV-DIM AIMLITE #EBST12 SERIES: EM-1 #EBST12036-2SM4WLRWHT-ATD STANPRO CAT. #SLX12 SERIES EM-1 #SLA12036-2N4LJ/AT LUMACELL CAT. #RGS SERIES	Manufacturer/Catalog Number COOPER CAT. #24FPSL2SCT3 LITHONIA CAT. #CPX 2X4 ALO8 SWW7 M2 SIGNIFY CAT. #2SBP3550L8CS-4-UNV-DIM AIMLITE #EBST12 SERIES: EM-1 #EBST12036-2SM4WLRWHT-ATD STANPRO CAT. #SLX12 SERIES EM-1 #SLA12036-2N4LJ/AT LUMACELL CAT. #RGS SERIES Voltage Lamp Mounting RECESSED 6300 LUMENS 4000K 56.3W 12V/120V LED 2-4W MR16	Manufacturer/Catalog Number Voltage Lamp Mounting CRI COOPER CAT. #24FPSL2SCT3 LITHONIA CAT. #CPX 2X4 ALO8 SWW7 M2 SIGNIFY CAT. #2SBP3550L8CS-4-UNV-DIM AIMLITE #EBST12 SERIES: EM-1 #EBST12036-2SM4WLRWHT-ATD STANPRO CAT. #SLX12 SERIES EM-1 #SLA12036-2N4LJ/AT LUMACELL CAT. #RGS SERIES	Manufacturer/Catalog Number Voltage Lamp Mounting CRI Listings COOPER CAT. #24FPSL2SCT3 LITHONIA CAT. #CPX 2X4 ALO8 SWW7 M2 SIGNIFY CAT. #2SBP3550L8CS-4-UNV-DIM AIMLITE #EBST12 SERIES: EM-1 #EBST12036-2SM4WLRWHT-ATD STANPRO CAT. #SLX12 SERIES EM-1 #SLA12036-2N4LJ/AT LUMACELL CAT. #RGS SERIES

- 1 LED LUMEN VALUES QUOTED FOR FIXTURES ARE TO BE CONSIDERED MINIMUM, AND AS ABSOLUTE OR DELIVERED LUMENS. LUMEN VALUES SHOULD NOT EXCEED MORE THAN 10% OF SPECIFIED OUTPUT.
- 2 EQUAL MANUFACTURERS/SUPPLIERS MUST CONFIRM THE PROPOSED FIXTURE BY EMAIL WITH CONSULTANTS OFFICE A MINIMUM OF 10 DAYS PRIOR TO TENDER CLOSE.
- (3) IF THERE ARE ANY DISCREPANCIES BETWEEN THE FIXTURE PART NUMBER AND DESCRIPTION, IT IS THE RESPONSIBILITY OF THIS CONTRACTOR TO BRING THESE TO THE ELECTRICAL CONSULTANT'S ATTENTION PRIOR TO TENDER CLOSE. NO EXTRAS WILL BE ENTERTAINED FOR FAILURE TO DO SO. FINAL FIXTURE CHARACTERISTICS AND DESCRIPTION WILL BE MARKED BY CONSULTANT AT TIME OF SHOP DRAWING REVIEW.

	GENERAL		LIGHTING	
ER	INDICATED EXISTING ITEM TO REMAIN	X	LIGHT FIXTURE TYPE AS INDICATED	
D	INDICATES EXISTING ITEM TO BE DELETED	199(1	CEILING MOUNTED EXIT LIGHT ARROWS DENOTE DIRECTION SHADING INDICATES FACE	
R	INDICATES EXISTING ITEM TO BE RELOCATED/IN RELOCATED POSITION	R.A	TWIN EMERGENCY LIGHTING FIXTURE	
GF	GROUND FAULT	EM-X DC-X X-X	BATTERY UNIT WITH INTEGRAL TWIN EMERGENCY FIXTURE (EM-X INDICATES BATTERY UNIT	
WP	WEATHERPROOF	1 1 1 1 1 1 1 1 1 1 1 1 1 1 1 1 1 1 1	TYPE, DC-X INDICATES DC CIRCUIT, AND X-X INDICATES AC SOURCE CIRCUIT	
TR	TAMPER RESISTANT	RECESSED REMOTE EMERGENCY FIXTURES		
CLG	CEILING MOUNTED	\$	SINGLE POLE SWITCH (3=3 WAY, 4=4 WAY, P=PILOT LIGHT, K=KEYED, DM=DIMMER, M=MOTOR RATED)	
X	NOTE INDICATOR	\$°s	OCCUPANCY SENSOR	
⊗	MECHANICAL ITEM NO.	\$ OCCUPANCY SENSOR (DM=DIMI		
		OS	DIGITAL CEILING MOUNTED MOTION SENSOR	
STA	NDARD CIRCUIT LABELING	PK	POWER PACK	
CIRCUIT	A-1-1 PANEL LABEL	XB	DIGITAL WALL STATION, 'X' DENOTES NUMBER OF CONTROL BUTTONS IN SINGLE GANG	
	POWER		COMMUNICATIONS	
	FOWER	T 7	WIRELESS ACCESS POINT. PROVIDE	
©	DIRECT CONNECTION	WAP	¾" (21mm) C TO CABLE MANAGEMENT SYSTEM	
—	PANEL AS INDICATED	구	CLOCK AS PER SPECIFICATIONS	
ď	FUSED DISCONNECT	\$cs	P.A. CALL SWITCH	
<u> </u>	UNFUSED DISCONNECT	8	WALL MOUNTED PA SPEAKER SINGLE COMPUTER OUTLET C/W ¾"	
	MANUAL STARTER	▽ #	(21mm) C TO CABLE MANAGEMENT SYSTEM. # INDICATES THE QUANTITY OF	
	MAGNETIC STARTER COMBINATION MAGNETIC STARTER		PORTS COMBINATION SINGLE VOICE/ SINGLE	
HD	HAND DRYER	VOICE DATA	COMPUTER OUTLET UNLESS OTHERWISE NOTED C/W 1" (27mm) C TO CABLE MANAGEMENT SYSTEM. # INDICATES TH QUANTITY OF ACTIVE PARTS. LEFT VALUE ALWAYS INDICATES VOICE.	
DVR	DUAL VOLTAGE RELAY	8	PA PROGRAM BELL	
•	PUSH-BUTTON STATION (QUANTITY OF BUTTONS AS PER PLANS)	8	CEILING MOUNTED SPEAKER	
Ф	WALL MOUNTED RECEPTACLE (15A-120V)	(A)	AUXILIARY ROUGH—IN FOR USE AS NOTED.	
	WALL MOUNTED T-SLOT RECEPTACLE	C HANGER SYSTEM (REFER TO DETA		
P	(20A-120V)			
P	T-SLOT RECEPTACLE MD. ABOVE COUNTER (20A-120V)		FIRE ALARM	
	T-SLOT RECEPTACLE MD. ABOVE		FIRE ALARM END-OF-LINE RESISTOR	
#	T-SLOT RECEPTACLE MD. ABOVE COUNTER (20A-120V) RECEPTACLE MD. ABOVE COUNTER	FSD		
#	T-SLOT RECEPTACLE MD. ABOVE COUNTER (20A-120V) RECEPTACLE MD. ABOVE COUNTER (15A-120V)	<u> </u>	END-OF-LINE RESISTOR	
#	T-SLOT RECEPTACLE MD. ABOVE COUNTER (20A-120V) RECEPTACLE MD. ABOVE COUNTER (15A-120V) SECURITY SECURITY DETECTOR (SURFACE	F50 Y	END-OF-LINE RESISTOR FIRE SMOKE DAMPER	
#	T-SLOT RECEPTACLE MD. ABOVE COUNTER (20A-120V) RECEPTACLE MD. ABOVE COUNTER (15A-120V) SECURITY SECURITY DETECTOR (SURFACE	FSD	END-OF-LINE RESISTOR FIRE SMOKE DAMPER COMBINATION HORN/STROBE HEAT DETECTOR (135 DEGREE FIXED	
#	T-SLOT RECEPTACLE MD. ABOVE COUNTER (20A-120V) RECEPTACLE MD. ABOVE COUNTER (15A-120V) SECURITY SECURITY DETECTOR (SURFACE	F50 Y	END-OF-LINE RESISTOR FIRE SMOKE DAMPER COMBINATION HORN/STROBE HEAT DETECTOR (135 DEGREE FIXED TEMPERATURE)	

ELECTRICAL SYMBOLS

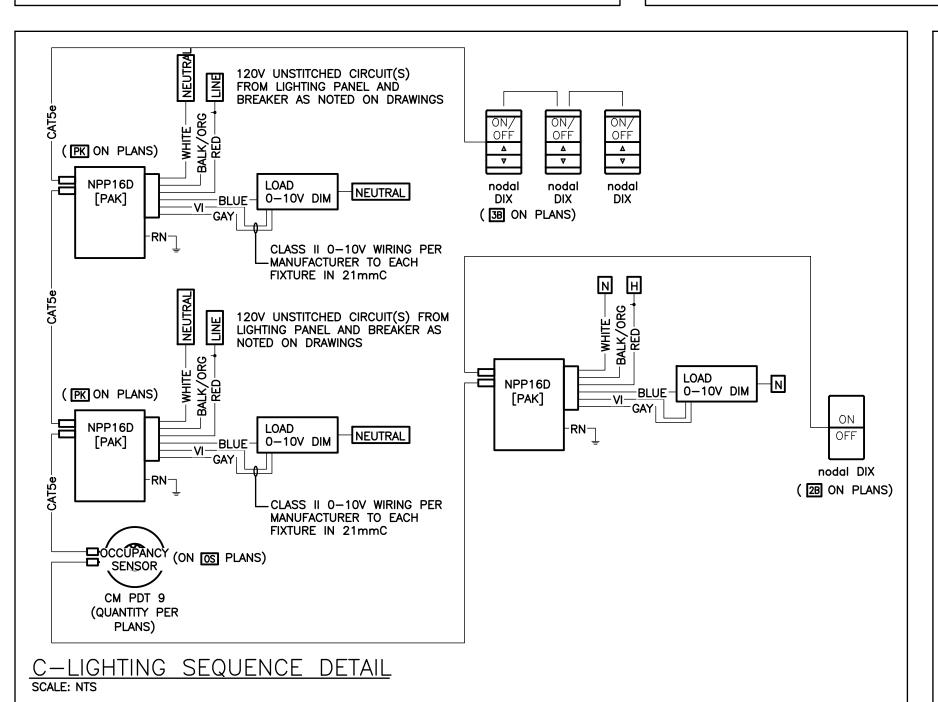

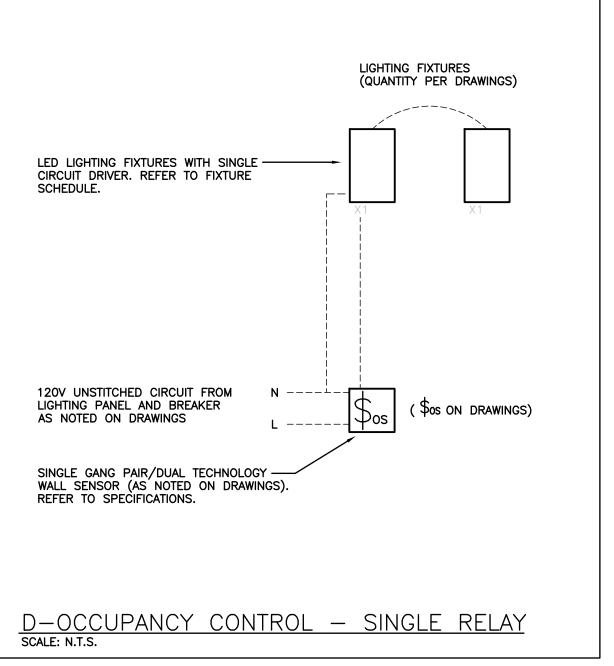

EQUIPMENT WIRING SCHEDULE												E=ELECTRICAL M=MECHANICAL O=OTHERS																				
	Description			Data				Sta	rter			Cont	rol D	evice			solatiı Devic					Re	mote	e Iter	ns					Inte	rlock	Remarks
Electrical Item	Description	Provided by	Voltage	Size hp/kW/Amps	Phase	Magnetic	Manual	Contactor	:	Combination Variable	≥َ اَ	Hana/ Uni/ Auto	rt/Sto	High/Low/Off	Pilot Light	Disconnect	WP Disconnect		Starter/Device Wired By	_	RA Thermostat	Interval Timer	ure Sw	Motor Rated Sw. c/w Pilot Light	Dual Voltage Relay	Control Panel	Wired by	Bldg Auto System	Wired by	Interlock To	Interlock By	Description
EF-101	EXHAUST FAN	М	120	FHF	1											Е		Е	Е						М		M/E	м	М			CONTROLLED THROUGH DVR/BAS
(EF-102)	EXHAUST FAN	М	120	FHF	1											Ε		Ε	E						М		M/E	М	М			CONTROLLED THROUGH DVR/BAS

ne contractor shall verify all dimensions and report all errors nd discrepancies to the Consultant before commencement of The drawings show general arrangement of services. Follow as closely as actual building construction will permit. Obtain approval for relocation of service from Consultant before commencement of the work.

The drawings do not indicate all offsets fitting and accessories which may be required. Provide the same to meet the required conditions. conditions.

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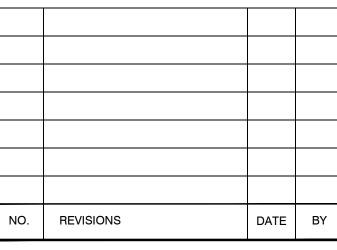
NOTE: ALL SYMBOLS MAY NOT BE USED



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NO.	ISSUES		DATE	ВҮ
1	ISSUED FOR COORDI	NATION	07.02.24	MEK
2	ISSUED FOR TENDER	REVIEW	23.02.24	MEK
3	ISSUED FOR TENDER	2	01.03.24	MEK
	·	·		



<u>Key Plan</u>





PROJECT:

HAMPTON Jr. PUBLIC SCHOOL **INTERIOR RENOVATIONS**

MECHANICAL | ELECTRICAL | AQUATIC

43 ORMISTON ST., HAMPTON, ON KPRDSB - HAMPTON Jr. PUBLIC SCHOOL

DRAWING:

KEYPLAN, SCHEDULES, AND DETAILS





% COMPLETE:

ASSOCIATES Architects Engineers Project Managers 250 Water Street Suite 201 Whitby, Ontario

L1N 0G5 Tel: (905) 666-5252 Fax: (905) 666-5256

FEB 2024 AS NOTED e-mail: bba@bba-archeng.com FILE:


DESIGN BY:

DRAWN BY:

CHECKED BY:

MEK

PROJECT NO: 24004 DRAWING NO: E101

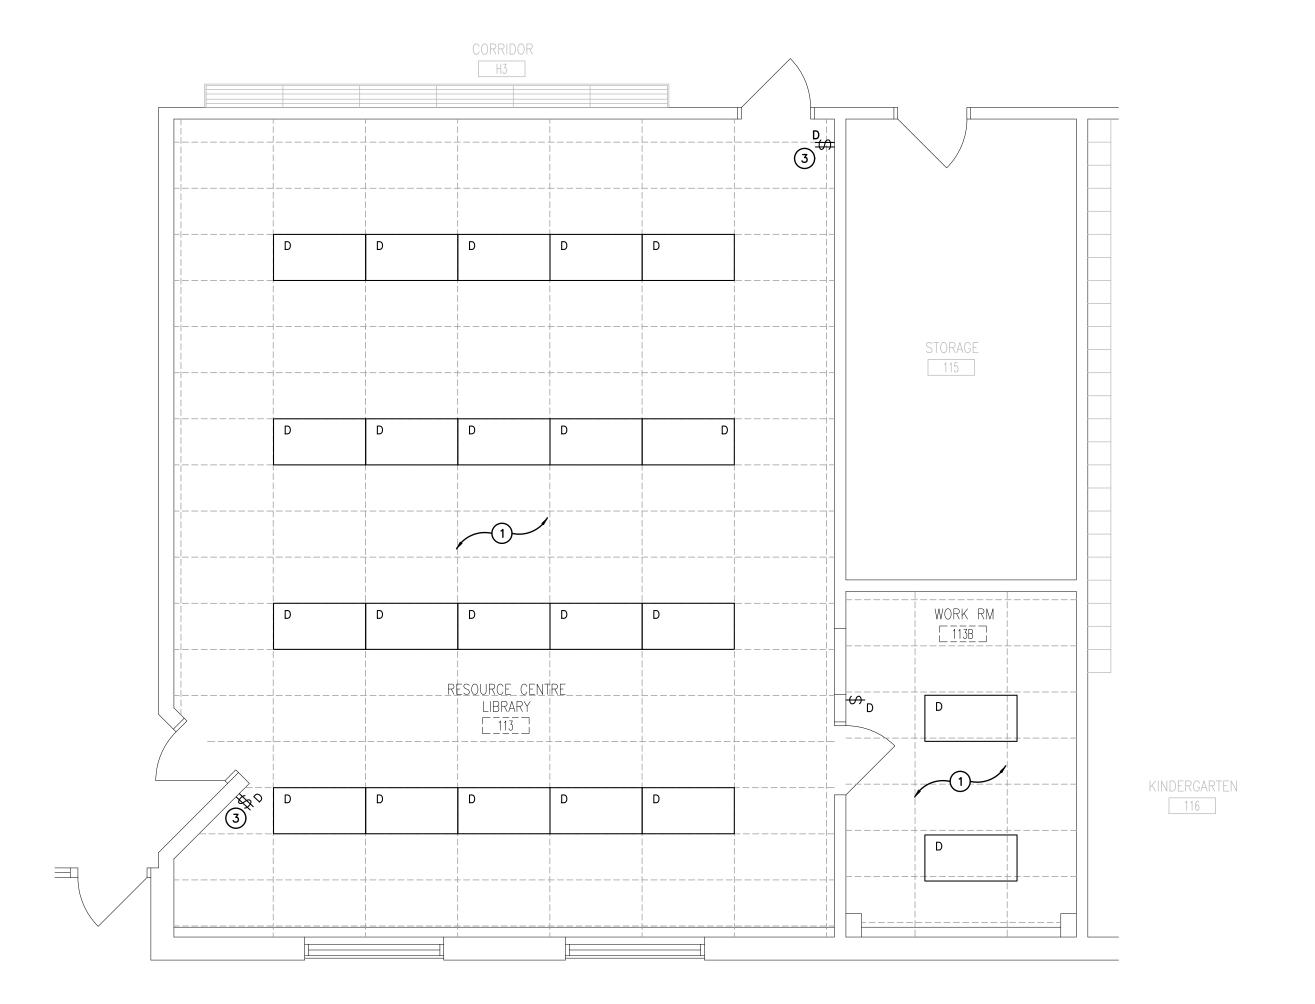

<u>LIBRARY RESOURCE AND WORK ROOM — LIGHTING DEMOLITION PLAN</u> SCALE: 1:50

- 'ER' DENOTES EXISTING ITEM TO REMAIN.
- EXISTING ELECTRICAL EQUIPMENT NOT SHOWN SHALL REMAIN UNLESS NOTED OTHERWISE.
- 'R' INDICATES EXISTING ITEM TO BE RELOCATED. REFER TO RENOVATION DRAWINGS AND RELOCATE DEVICE AND WIRING TO SUIT. UNLESS OTHERWISE NOTED.
- 'D' INDICATES EXISTING ITEM TO BE DELETED. UNLESS OTHERWISE NOTED DISCONNECT AND REMOVE NOTED DEVICE AND WIRING BACK TO SOURCE.
- ALL LIGHTING FIXTURES BEING RELOCATED SHALL BE CLEANED AND CHECKED PRIOR TO BEING REINSTALLED.

SPECIFIC DEMOLITION NOTES

EXISTING FIXTURES ARE TO BE DISCONNECTED AND REMOVED. REWORK EXISTING WIRING AND CIRCUIT FOR RECONNECTION TO NEW FIXTURES AS NOTED ON THE RENOVATION

- 2 NOT USED.
- INDICATED SWITCH SHALL BE REMOVED COMPLETE. REWORK NEW CONTROLS AS NOTED ON RENOVATION PLANS. PROVIDE BLANK STAINLESS STEEL COVERPLATE TO SUIT EXISTING BACKBOX. REMOVE CONDUIT IF/AND WHEN NECESSARY.

The contractor shall verify all dimensions and report all errors and discrepancies to the Consultant before commencement of the work.

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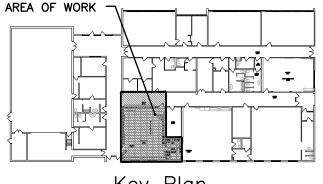
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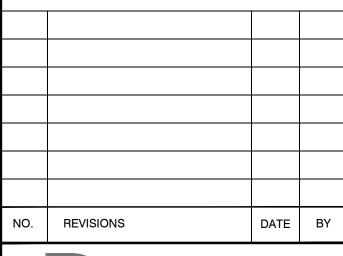




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NO.	ISSUES		DATE	BY
1	ISSUED FOR COORDI	NATION	07.02.24	MEK
2	ISSUED FOR TENDER	REVIEW	23.02.24	MEK
3	ISSUED FOR TENDER		01.03.24	MEK



<u>Key Plan</u>





Consulting Engineers n In MECHANICAL | ELECTRICAL | AQUATIC

PROJECT:


HAMPTON Jr. PUBLIC SCHOOL INTERIOR RENOVATIONS

43 ORMISTON ST., HAMPTON, ON KPRDSB - HAMPTON Jr. PUBLIC SCHOOL

DRAWING:

AREA OF WORK -LIGHTING DEMOLITION PLAN



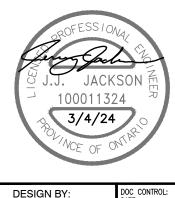

% COMPLETE:

BARRY BRYAN ASSOCIATES
Architects Engineers Project Managers
250 Water Street

Suite 201 Whitby, Ontario L1N 0G5

DATE: FEB 2024 Tel: (905) 666-5252 Fax: (905) 666-5256 e-mail: bba@bba-archeng.com


AS NOTED FILE:

24004

E201

DRAWN BY:

CHECKED BY:

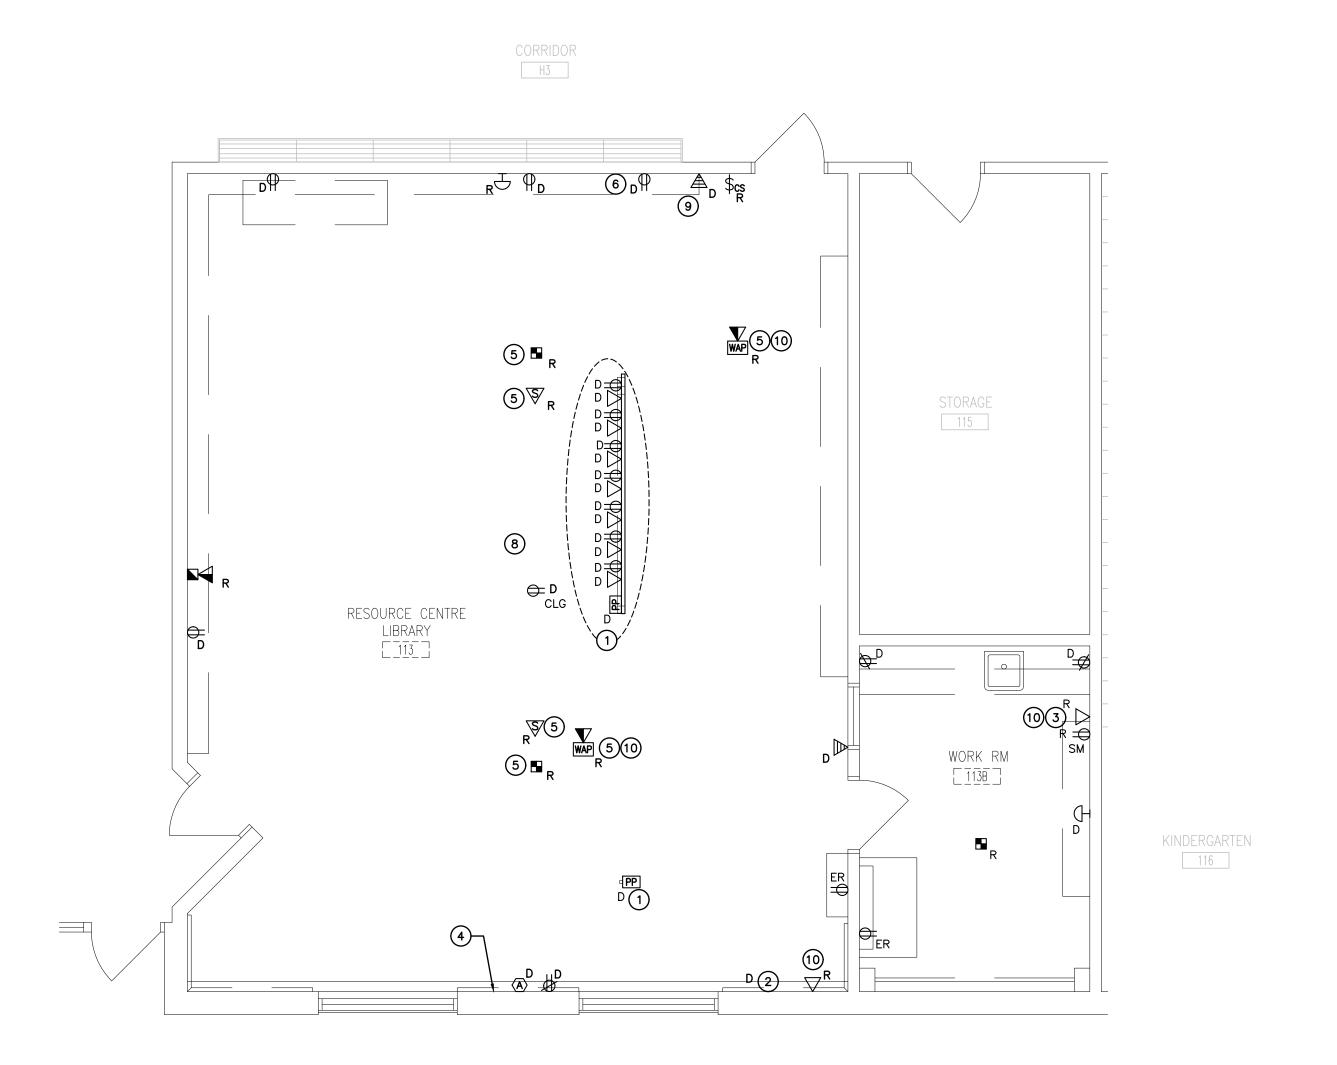

LIBRARY RESOURCE AND WORK ROOM — POWER AND SYSTEMS DEMOLITION PLAN SCALE: 1:50

- 'ER' DENOTES EXISTING ITEM TO REMAIN.
- EXISTING ELECTRICAL EQUIPMENT NOT SHOWN SHALL REMAIN UNLESS NOTED OTHERWISE.
 'R' INDICATES EXISTING ITEM TO BE RELOCATED. REFER TO RENOVATION DRAWINGS AND RELOCATE DEVICE AND WIRING TO SUIT. UNLESS OTHERWISE NOTED.
- 'D' INDICATES EXISTING ITEM TO BE DELETED. UNLESS OTHERWISE NOTED DISCONNECT AND REMOVE NOTED DEVICE AND WIRING BACK TO SOURCE.
- ALL MATERIALS REMOVED UNDER DEMOLITION. NOT TO BE RELOCATED OR DESIGNATED TO BE TURNED OVER TO THE OWNER, SHALL BECOME PROPERTY OF THE CONTRACTOR AND SHALL BE REMOVED COMPLETELY FROM THE SITE.

SPECIFIC DEMOLITION NOTES

- 1 INDICATES POWER POLE COMPLETE WITH RECEPTACLES AND DATA DROPS TO BE DISCONNECTED AND REMOVED COMPLETE.
- INDICATES HEARING ASSISTANCE AMPLIFIER COMPLETE WITH CABLING TO BE DISCONNECTED AND REMOVED.
- 3 INDICATES SURFACE MOUNTED DATA OUTLET. EXTEND TO NEW STORAGE ROOM. REFER TO RENOVATION DRAWING FOR CONTINUATION.
- INDICATES EXISTING SMART BOARD SHALL BE DISCONNECTED AND REMOVED COMPLETE.

MAINTAIN EXISTING CEILING MOUNTED DEVICES AND WIRING FOR RE-INSTALLATION ON NEW

- CEILING TILES AFTER CEILING TILE REPLACEMENT.

 6 INDICATES EXISTING RECEPTACLE TO BE DISCONNECTED AND REMOVED. CONTRACTOR SHALL
- RETAIN EXISTING CIRCUIT/WIRING AND REWORK/EXTEND FOR FUTURE RECONNECTION TO NEW DEVICES. REFER TO RENOVATION DRAWING FOR FURTHER DETAILS.
- NOT USED.8 INDICATES OVERHEAD PROJECTOR TO BE DISCONNECTED, REMOVED AND RETURNED TO
- 9 MAINTAIN EXISTING CIRCUIT WIRING OF DEMOLISHED DEVICE FOR EXTENSION AND CONNECTION TO NEW DEVICE AS SHOWN ON RENOVATION PLANS.
- 10 MAINTAIN EXISTING DATA CABLING COILED IN CEILING SPACE FOR RE—USE IN RENOVATION PLAN. COORDINATE WITH SCHOOL BOARD IT REPRESENTATIVE FOR RE—USE OF DATA CABLING. ANY SPARE DATA CABLE DROPS AT END OF RENOVATION WORK SHALL BE REMOVED COMPLETE BACK TO SOURCE PATCH PANEL.

The contractor shall verify all dimensions and report all errors and discrepancies to the Consultant before commencement of the work.


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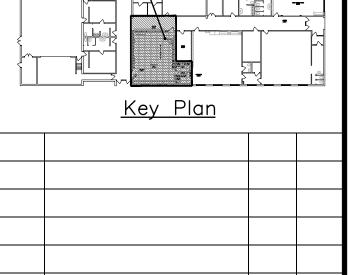
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NO. ISSUES



1	ISSUED FOR COORDINATION	07.02.24	MEK
2	ISSUED FOR TENDER REVIEW	23.02.24	MEK
3	ISSUED FOR TENDER	01.03.24	MEK
AREA	OF WORK		1



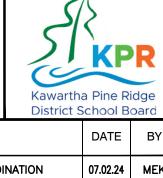

Consulting Engineers

PROJECT:


HAMPTON Jr. PUBLIC SCHOOL INTERIOR RENOVATIONS

43 ORMISTON ST., HAMPTON, ON KPRDSB - HAMPTON Jr. PUBLIC SCHOOL

DRAWING:

AREA OF WORK -POWER AND SYSTEMS DEMOLITION PLAN



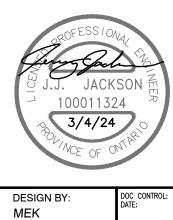

% COMPLETE:

ASSOCIATES

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Engineers
Project Managers
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L1N 0G5
Tel: (905) 666-5252
Fax: (905) 666-5256
e-mail: bba@bba-archeng.com


DATE:
FEB 2024
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FILE:

DRAWN BY:

CHECKED BY:

PROJECT NO: **24004**

E202

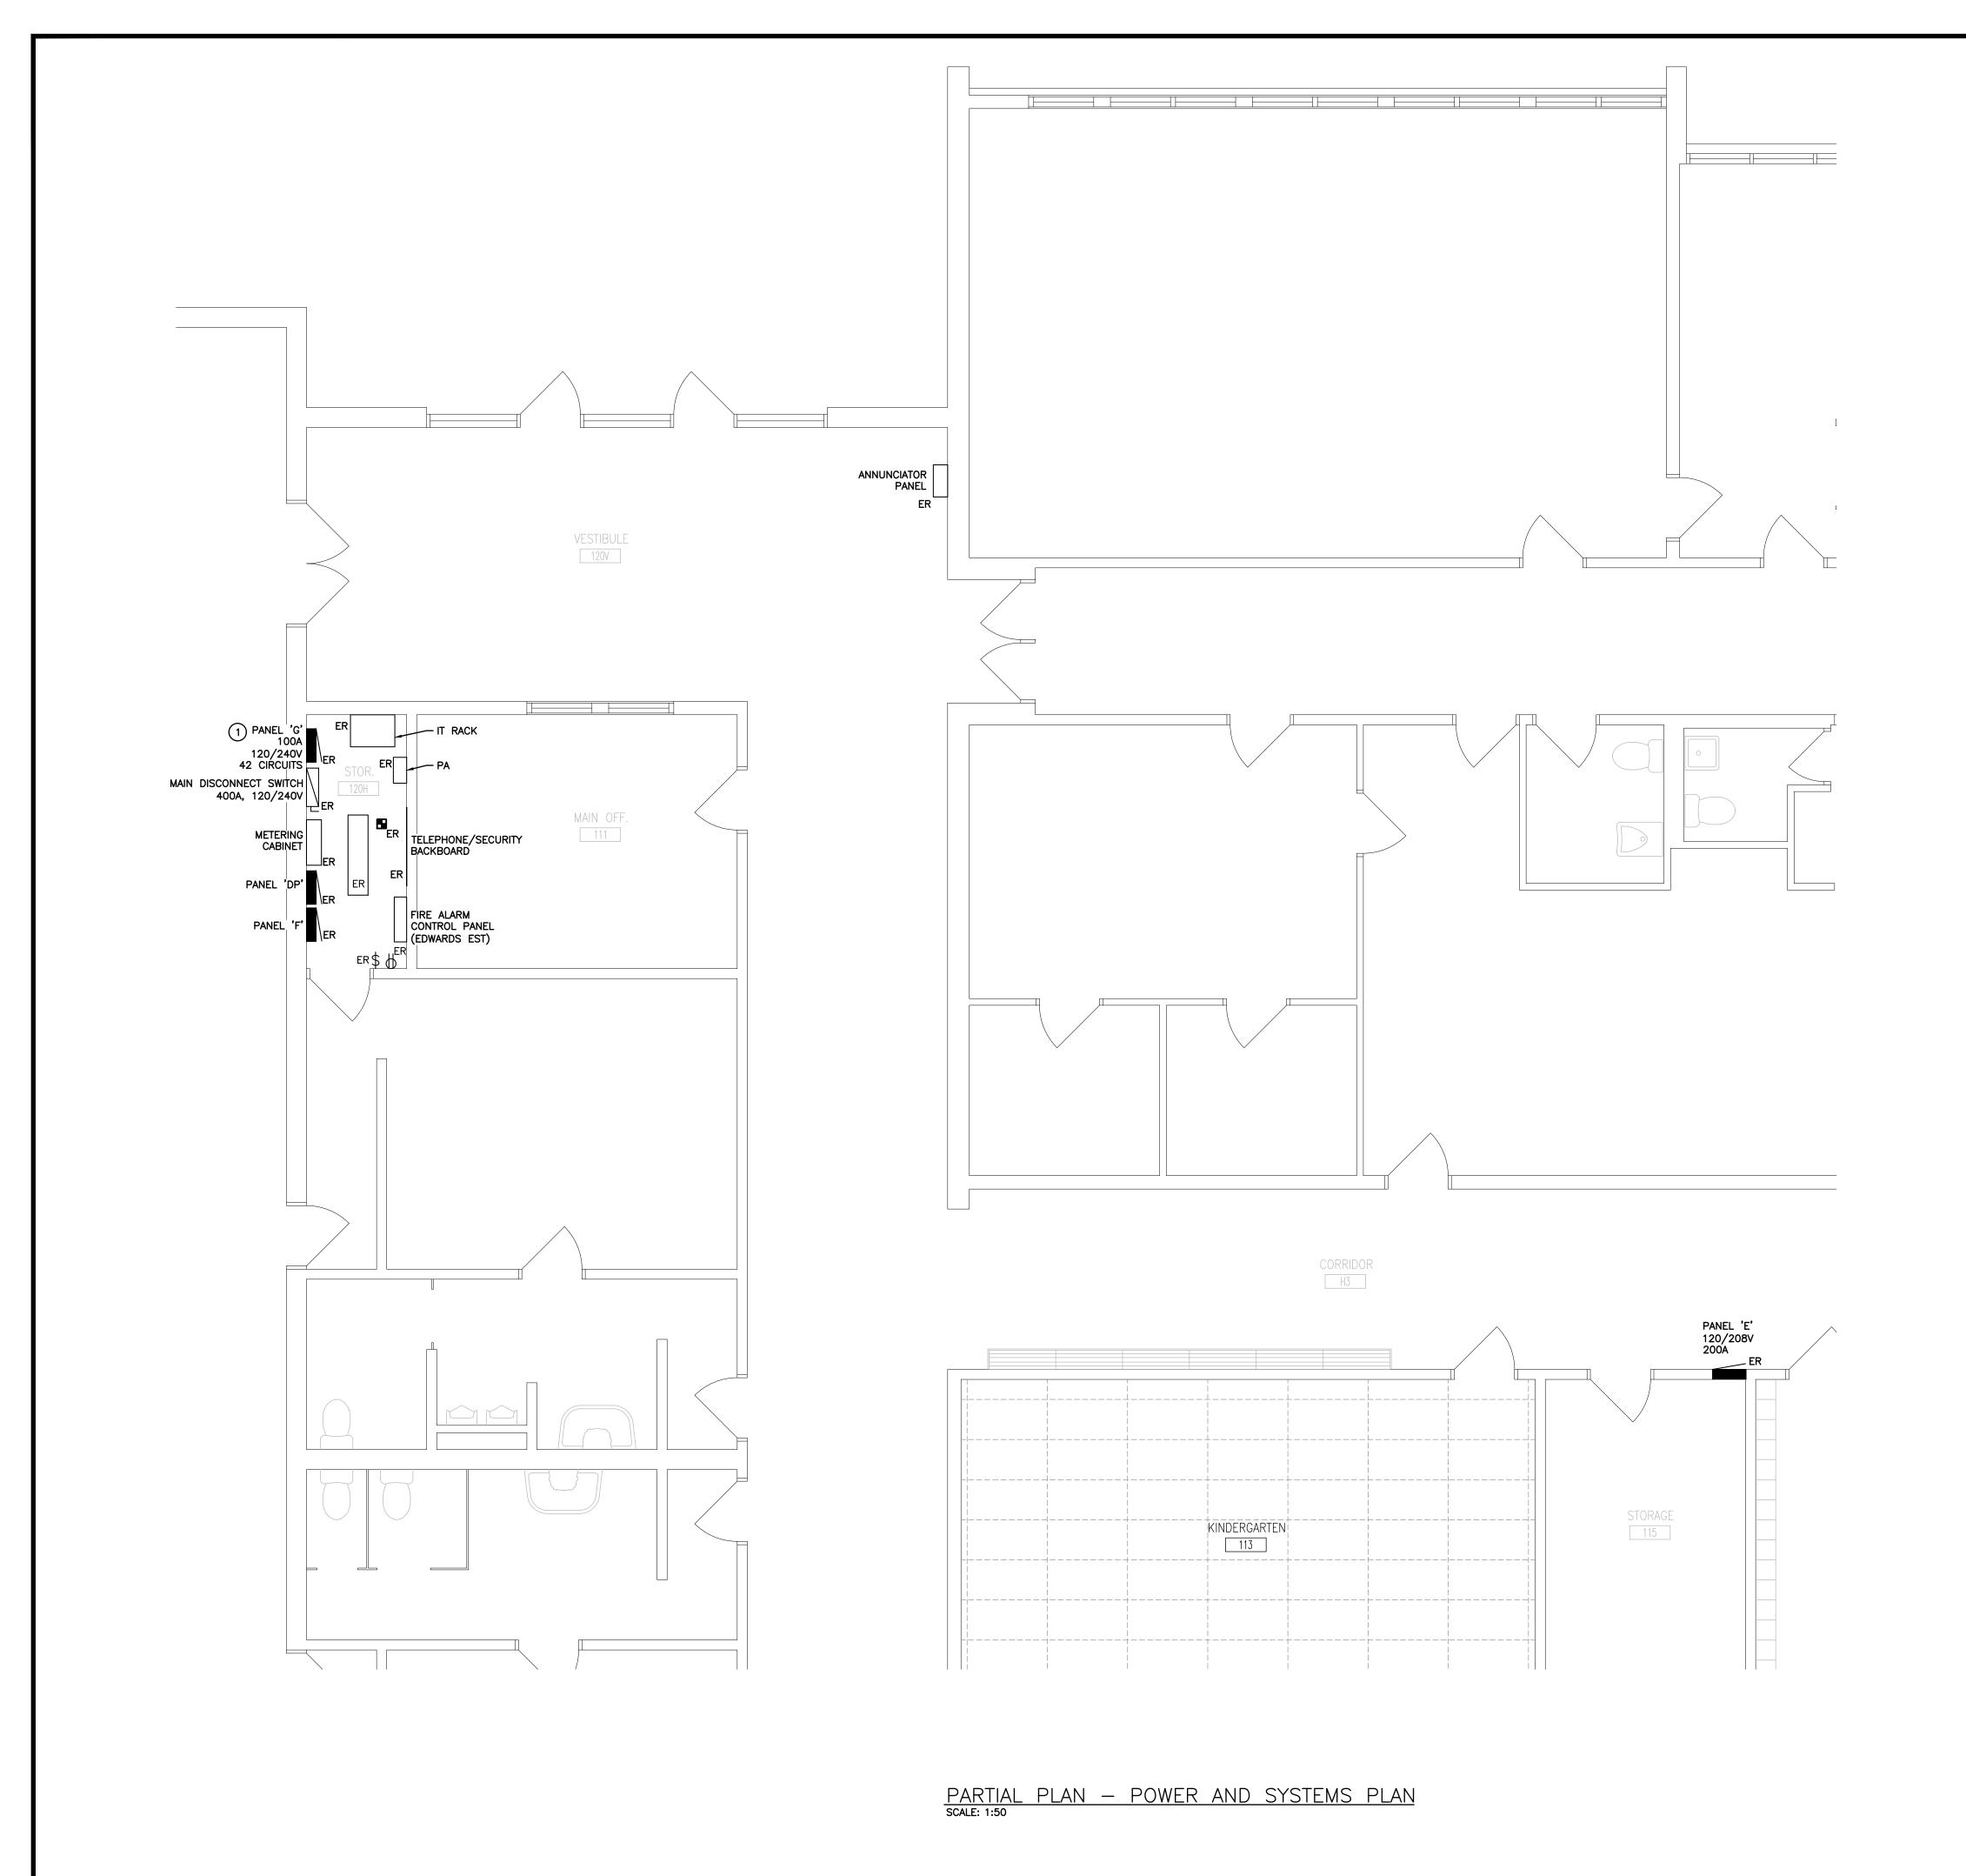

- 'ER' DENOTES EXISTING ITEM TO REMAIN.
- EXISTING ELECTRICAL EQUIPMENT NOT SHOWN SHALL REMAIN UNLESS NOTED OTHERWISE.

 'R' INDICATES EXISTING ITEM TO BE RELOCATED. REFER TO RENOVATION DRAWINGS AND
- 'R' INDICATES EXISTING ITEM TO BE RELOCATED. REFER TO RENOVATION DRAWINGS AND RELOCATE DEVICE AND WIRING TO SUIT. UNLESS OTHERWISE NOTED.
- 'D' INDICATES EXISTING ITEM TO BE DELETED. UNLESS OTHERWISE NOTED DISCONNECT AND REMOVE NOTED DEVICE AND WIRING BACK TO SOURCE.
- ALL MATERIALS REMOVED UNDER DEMOLITION. NOT TO BE RELOCATED OR DESIGNATED TO BE TURNED OVER TO THE OWNER, SHALL BECOME PROPERTY OF THE CONTRACTOR AND SHALL BE REMOVED COMPLETELY FROM THE SITE.

SPECIFIC DEMOLITION NOTES

1 CONTRACTOR SHALL PROVIDE NEW CIRCUITS/FEEDERS AS NOTED ON RENOVATION PLAN AND AS PER SPECIFICATIONS. THIS CONTRACTOR IS RESPONSIBLE TO PROVIDE CEILING TILE TO SUIT REQUIRED INSTALLATION, ANY DAMAGED OR FINGERPRINTED TILE MUST BE REPLACED.

The contractor shall verify all dimensions and report all errors and discrepancies to the Consultant before commencement of the work.

The drawings show general arrangement of services. Follow as closely as actual building construction will permit. Obtain approval for relocation of service from Consultant before commencement of the work.

The drawings do not indicate all offsets fitting and accessories which may be required. Provide the same to meet the required conditions.


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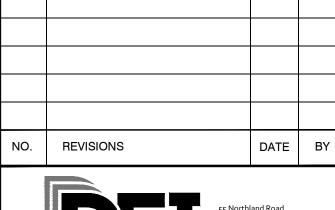
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NO.	ISSUES	DATE	BY
1	ISSUED FOR COORDINATION	07.02.24	MEK
2	ISSUED FOR TENDER REVIEW	23.02.24	MEK
3	ISSUED FOR TENDER	01.03.24	MEK







MECHANICAL | ELECTRICAL | AQUATIC

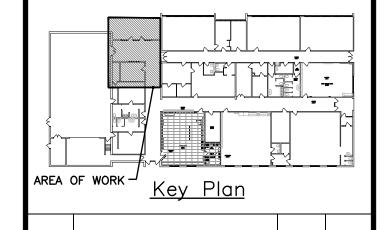PROJECT:

HAMPTON Jr. PUBLIC SCHOOL INTERIOR RENOVATIONS

43 ORMISTON ST., HAMPTON, ON KPRDSB - HAMPTON Jr. PUBLIC SCHOOL

DRAWING:

GENERAL
POWER AND SYSTEMS
PLAN





BARRY BRYAN ASSOCIATES	DESIGN BY:
ASSOCIATES	MEK
Architects	DRAWN BY:
Engineers	-
Project Managers	CHECKED BY:
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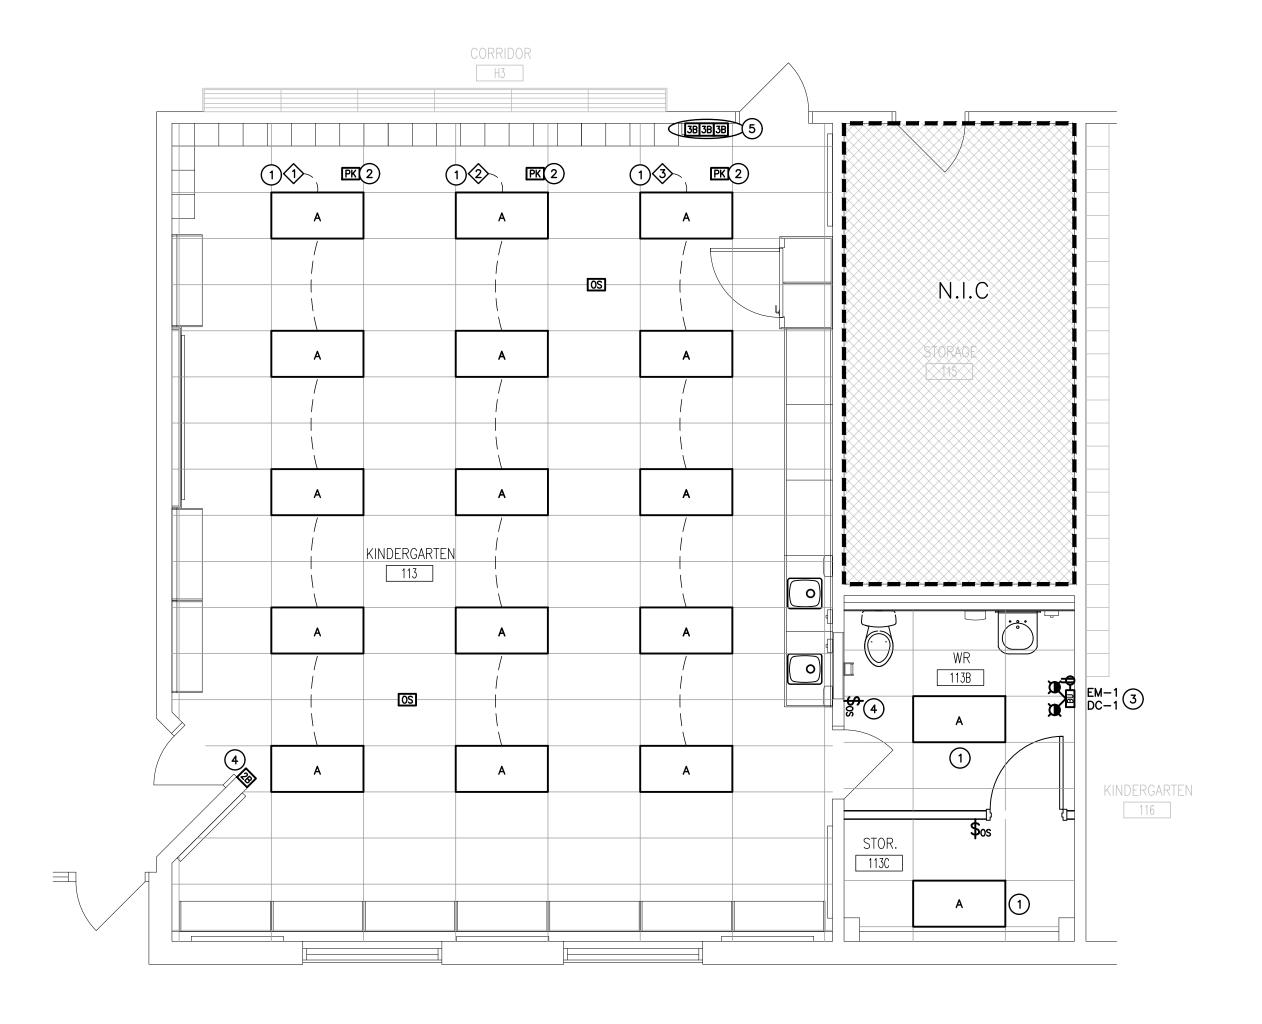
e-mail: bba@bba-archeng.com

SCALE: AS NOTED FILE:

24004

DRAWING NO:

E203



KINDERGARTEN, WASHROOM AND STORAGE — LIGHTING RENOVATION PLAN SCALE: 1:50

GENERAL RENOVATION NOTES

- 'ER' INDICATES EXISTING ITEM TO REMAIN.
- 'R' INDICATES EXISTING ITEM IN RELOCATED POSITION.
 ALL DEVICES SHOWN ARE NEW UNLESS OTHERWISE NOTED.
- EXISTING ELECTRICAL EQUIPMENT NOT SHOWN SHALL REMAIN UNLESS NOTED OTHERWISE.
- MAINTAIN SERVICE TO ALL EXISTING DEVICES TO REMAIN.

 REVISE PANEL DIRECTORIES TO SUIT CHANGES (TYPED).

SPECIFIC RENOVATION NOTES

- 1 REWORK EXISTING LIGHTING CIRCUIT MADE AVAILABLE DURING DEMOLITION TO SUIT NEW FIXTURES. CLASSROOMS HAVE TWO SEPARATE LIGHTING CIRCUITS LOCATED AT SWITCHES. REWORK ONE EXISTING CIRCUIT TO SUIT NEW CONTROLS.
- RE-WORK EXISTING LINE AND LOAD SIDE WIRING THROUGH POWER PACK TO SUIT.
 REFER TO C/E101. POWER PACK TO BE INSTALLED ABOVE ACCESSIBLE CEILING SPACE IN FINISHED AREAS.
- 3 REWORK EXISTING LIGHTING CIRCUIT MADE AVAILABLE DURING DEMOLITION AND CONNECT EMERGENCY BATTERY UNIT TO UNSWITCHED SIDE.
- FEED INDICATED DEVICE USING SURFACE METAL RACEWAY EQUAL TO WIREMOLD SERIES V700.
- 5 INDICATED DEVICES SHALL BE MOUNTED IN MILLWORK CONTROL PANEL. REFER TO DETAILS.

The contractor shall verify all dimensions and report all errors and discrepancies to the Consultant before commencement of the work.

The drawings show general arrangement of services. Follow as closely as actual building construction will permit. Obtain approval for relocation of service from Consultant before commencement of the work.


The drawings do not indicate all offsets fitting and accessories which may be required. Provide the same to meet the required conditions.

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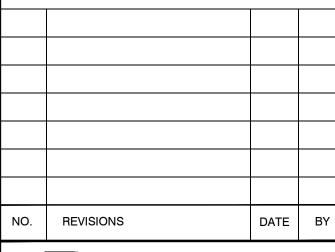




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1	ISSUED FOR COORDI	NATION	07.02.24	MEK
2	ISSUED FOR TENDER	REVIEW	23.02.24	MEK
3	ISSUED FOR TENDER		01.03.24	MEK

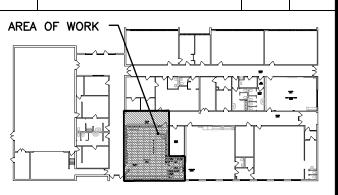

<u>Key Plan</u>





Consulting Engineers Properties


PROJECT:

HAMPTON Jr. PUBLIC SCHOOL INTERIOR RENOVATIONS

43 ORMISTON ST., HAMPTON, ON KPRDSB - HAMPTON Jr. PUBLIC SCHOOL

DRAWING:

PARTIAL GROUND FLOOR - RENOVATION PLANS

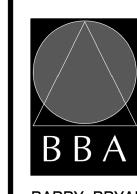



ASSOCIATES
Architects Engineers Project Managers
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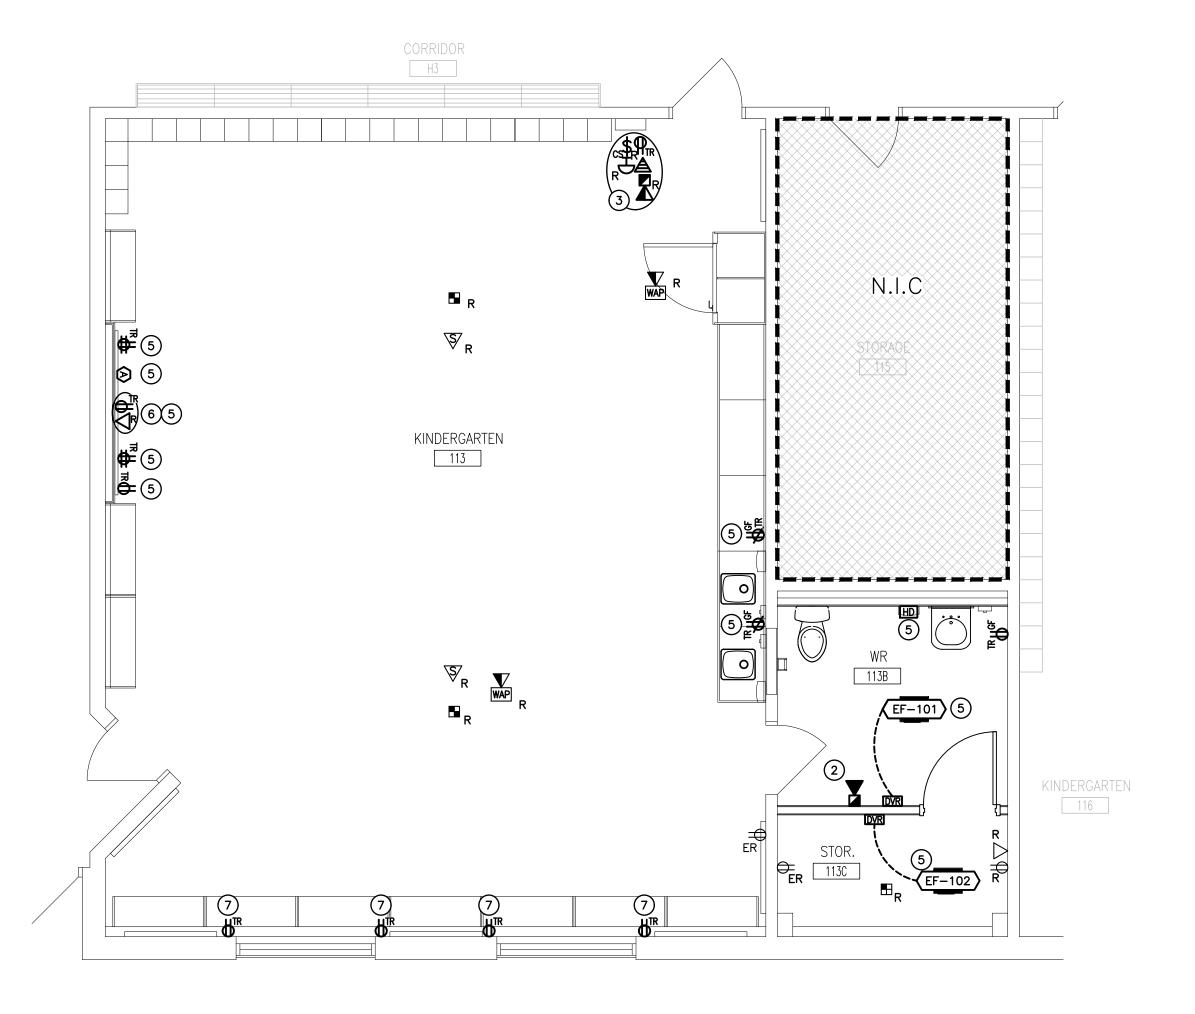
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FEB 2024
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DRAWN BY:

CHECKED BY:

PROJECT NO: **24004**

E301



KINDERGARTEN, WASHROOM AND STORAGE — POWER AND SYSTEMS RENOVATION PLAN SCALE: 1:50

GENERAL RENOVATION NOTES

- 'ER' INDICATES EXISTING ITEM TO REMAIN.
- 'R' INDICATES EXISTING ITEM IN RELOCATED POSITION.
- ALL DEVICES SHOWN ARE NEW UNLESS OTHERWISE NOTED.
- EXISTING ELECTRICAL EQUIPMENT NOT SHOWN SHALL REMAIN UNLESS OTHERWISE NOTED.
- MAINTAIN SERVICE TO ALL EXISTING DEVICES TO REMAIN.
- REVISE PANEL DIRECTORIES TO SUIT CHANGES (TYPED).

SPECIFIC RENOVATION NOTES

- NOT USED.
- 2 CONNECT NEW FIRE ALARM SIGNALING DEVICE TO EXISTING LOCAL SIGNALING CIRCUIT. RE-VERIFY PORTIONS OF ALARM SYSTEM TO CAN/ULC-S537. REFER TO SPECIFICATIONS FOR FURTHER DETAILS AND REQUIREMENTS.
- INDICATED DEVICES SHALL BE MOUNTED IN MILLWORK CONTROL PANEL. REFER TO DETAILS. CONNECT POWER CIRCUIT MADE AVAILABLE DURING DEMOLITION.
- 4 ALL DEVICES IN THE INDICATED ROOM SHALL REMAIN AS IS.
- 5 INDICATES NEW MECHANICAL EQUIPMENT AND ELECTRICAL DEVICES TO BE FED FROM EXISTING PANEL BOARD 'G' EATON POW-R-LINE 1a, 120/240V 1-PH, 3 WIRE, 42 CIRCUITS. PROVIDE NEW FEEDS, BREAKERS AND LABEL AS FOLLOWS:
 - 15A-1P EF-101 WR 113B 15A-1P - EF-102 STOR. 113C
 - 15A-1P EQUIPMENT RECEPTACLE 113
 - 15A-1P RECEPTACLE 113 15A-1P - RECEPTACLE 113
 - 20A-1P WR 113B HAND DRYER (*5mA GF STYLE)
- 6 INDICATES DEVICES TO BE INSTALLED AT HIGH LEVEL FOR PROJECTOR TO A MAXIMUM OF 3048mm AFF. CONFIRM EXACT LOCATION AND MOUNTING HEIGHT WITH SCHOOL BOARD REPRESENTATIVE PRIOR TO ROUGH—IN. REFER TO PROJECTION SCREEN LAYOUT DETAIL B./F102.
- 7 INDICATED RECEPTACLE IS TO BE MOUNTED HORIZONTALLY BELOW REPLACEMENT RADIATORS AND FED WITH WIREMOLD V700 SERIES SURFACE RACEWAY AND SURFACE BOXES.
 RECEPTACLES ARE TO BE CONNECTED TO EXISTING BRANCH RECEPTACLE CIRCUIT WITHIN CLASSROOM. COORDINATE MOUNTING WITH ARCHITECTURAL INTERIOR ELEVATIONS PRIOR TO ROUGH—IN.

The contractor shall verify all dimensions and report all errors and discrepancies to the Consultant before commencement of the work.

The drawings show general arrangement of services. Follow as closely as actual building construction will permit. Obtain approval for relocation of service from Consultant before commencement of the work.


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3	ISSUED FOR TENDER		01.03.24	MEK



<u>Key Plan</u>

NO. REVISIONS DATE BY

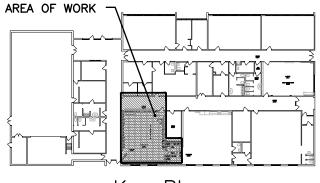

Consulting Engineers 1 To MECHANICAL | ELECTRICAL | AQUATIC

PROJECT:


HAMPTON Jr. PUBLIC SCHOOL INTERIOR RENOVATIONS

43 ORMISTON ST., HAMPTON, ON KPRDSB - HAMPTON Jr. PUBLIC SCHOOL

DRAWING:

PARTIAL GROUND FLOOR - RENOVATION PLANS



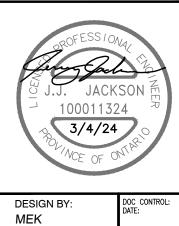

% COMPLETE:

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FEB 2024
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PROJECT NO: **24004**

E302