	MECHANICAL LEGEND		 MECH
HEATING VENTIL	ATION AND AIR CONDITIONING (HVAC)	HEATING VENTU	ATION AND AIR C
/ / / /	RIGID DUCTWORK	TILATINO, VENTIL	WALL FIN HEATE
	ACOUSTICALLY LINED DUCTWORK	CV-A 7000 0.15	7000 DENO DENO DENO DENO DENO DENO DENO DE NO DE
· · · · · · · · · · · · · · · · · · ·	FLEXIBLE ROUND DUCTWORK	550.4	FORCED FLOW H
	SUPPLY DUCTWORK RISER UP	FFH-A	REFER TO FORC
	EXHAUST/RETURN DUCTWORK RISER UP	1-101 4	VAV BOX
	SUPPLY DUCTWORK RISER DOWN	125 75	
BD	EXHAUST/RETURN DUCTWORK RISER DOWN	PLUMBING AND STM	
→ SD	BALANCING DAMPER  SPLITTER DAMPER	STM	ABOVE-GROUND
<u>→</u> U/C	DOOR UNDERCUT	SAN	ABOVE-GROUND
	DOOR GRILLE	SAN —	UNDERGROUND
CAP [	CAPPED DUCTWORK	PUMPED SAN	PUMPED SANITA
<b>D</b>	SPIN-ON FITTING WITH BALANCING DAMPER	<i>─</i> <b></b>	RUNNING TRAP
	SUPPLY AIR DIFFUSER	<b>€</b>	PLUMBING TRAP
	RETURN/EXHAUST AIR GRILLE	/ V	SANITARY VENT
	FLEXIBLE CONNECTION	/—IICO	SANITARY CLEAN
	SUPPLY AIR GRILLE — WALL—MOUNTED  RETURN AIR GRILLE — WALL—MOUNTED	co <b>a⊢</b> ∕	SANITARY CLEAN DOMESTIC COLD
	TETOTAL WALL WOOM ILD	//	DOMESTIC HOT
BD	FLEXIBLE DUCT CONNECTION TO RIGID DUCTWORK	<i></i>	DOMESTIC HOT
The state of the s	COLLABE ELDOW WITH ALB THRANKS MANES	BFP /	BACKFLOW PRE
	SQUARE ELBOW WITH AIR TURNING VANES	/W	WATER METER
p FD	FUSIBLE LINK FIRE DAMPER WITH ACCESS DOOR IN DUCT	<b>Т</b> нв	HOSE BIBB
<u> </u>	2 2 7.05255 500K IN 5001	<b>↓</b> NFHB	NON-FREEZE HO
<b>□</b> MD	MOTORIZED DAMPER	O VTR	VENT THROUGH
PDD		O RWL O FD	RAIN WATER LEA
BDD	BACK DRAFT DAMPER	Ø FFD	FUNNEL FLOOR
BD _		Ø RD	ROOF DRAIN
	BALANCING DAMPER	CONTROLS	
<u> </u>	BRANCH TAKE-OFF WITH ADJUSTABLE SPLITTER DAMPER IN	<b>─</b> (T)	BAS - TEMPERA
	SUPPLY DUCT	<b>-</b> □ c/s	BAS - CURREN
OED	OPEN ENDED DUCT WITH BALANCING DAMPER AND BELLMOUTH	<b>-</b> □ P/S	BAS - PRESSUF
		<b>─</b> □ F/S	BAS - FLOW SV
SL-AHU1-2	AIR HANDLING UNIT SILENCER AS PER SILENCER SCHEDULE	AO	BAS — ANALOG BAS — ANALOG
		DI	BAS - DIGITAL
A-84 25	DENOTES DIFFUSER TYPE — DENOTES AIRFLOW (IN L/S) — DENOTES NECK SIZE. DUCTWORK TO MATCH.	DO	BAS - DIGITAL
T	THERMOSTAT TIED TO AN EXISTING CONTROL SYSTEM	FIRE PROTECTION	<u>N</u>
Т	STANDALONE THERMOSTAT	FE	FIRE EXTINGUISH
	PUMP	FE	FIRE EXTINGUISH
/—HWS—/	HOT WATER SUPPLY — HEATING	FB	FIRE BLANKET
/HWR/ /HWRR/	HOT WATER RETURN — HEATING  HOT WATER REVERSE RETURN — HEATING	<u>ACRONYMS</u>	
/ RL	REFRIGERATION LINE — LIQUID		RIPTION
/— RG —/	REFRIGERATION LINE - GAS	AC AIR C	SS DOOR ONDITIONER ICING DAMPER
/— CD —/	CONDENSATE LINE	BDD BACKE	DRAFT DAMPER EXISTING SERVICE
/ G/	NATURAL GAS LINE	CTE CONNE	ENSATE ECT TO EXISTING
/GV→	NATURAL GAS VENT LINE		ING FOUNTAIN JST AIR
/ A/	COMPRESSED AIR LINE	EX EXISTI FD FIRE [	NG DAMPER
<u>∕</u>	ISOLATION VALVE. TYPE AS PER SPECIFICATION	FS FLOW	EXTINGUISHER SWITCH -HELD SHOWER
	BALANCING VALVE STRAINER	LV LAVAT	
	PRESSURE REDUCING VALVE	NC NORM	ALLY OPEN ALLY CLOSED
	AUTOMATIC 2-WAY CONTROL VALVE	PG PRESS	OOR AIR SURE GAUGE WATER LEADER
/—————————————————————————————————————	AUTOMATIC 3-WAY CONTROL VALVE	REM REMOV	VE KCE
	CHECK VALVE	SA SUPPL	RN AIR LY AIR RVISED VALVE
/——II——/	UNION	TYP TYPIC	
<del>/                                    </del>	MANUAL AIR VENT	WD WASHE	THROUGH ROOF ER-DRYER UNIT
/ × × × /	DENOTES EXISTING PIPING TO BE REMOVED	WC WATER	R CLOSET
	DENOTES EXISTING PIPING TO REMAIN		
/G/	DENOTES NEW PIPING  GAS METER		
/—(P)—/	PROPANE METER		
/ () / () / () / () / () / () / () / ()	ELECTRIC HEAT TRACING; DIVISION 15 UNLESS OTHERWISE NOTED		
PG	PRESSURE GAUGE		
TG	THERMOMETER		
UP 0	PIPE UP		
ND C	PIPE DOWN		

ABOVE—GROUND STORM  SAN ABOVE—GROUND SANITARY  DUNDERGROUND SANITARY  ABOVE—GROUND SANITARY  DUNDERGROUND SANITARY  PUMPED SAN  PUMPED SANITARY  PUMBING TRAP  PUMBING TRAP  V SANITARY VENT  PUMPED SANITARY CLEANOUT IN ACCESSIBLE CEILING SPACE  CO C	
WALL FIN FEATER CV-A 7000 DENOTES TYPE TOOD DENOTES HEAT OUTPUT IN WATTS 0.15 DENOTES FLOW RATE IN L/S FFH-A DENOTES TYPE REFER TO FORCED FLOW RATE IN L/S FFH-A DENOTES TYPE REFER TO FORCED FLOW RATE IN L/S PLOMBING AND DRAINAGE  STM ABOVE-GROUND STORM  STM ABOVE-GROUND STORM  SAN ABOVE-GROUND STORM  SAN ABOVE-GROUND STORM  SAN ABOVE-GROUND SANITARY  UNDERGROUND SANITARY  PUMPED SANITARY  RUNNING TRAP  PLUMBING TRAP  PLUMBING TRAP  PLUMBING TRAP  V SANITARY VERNOUT IN ACCESSIBLE CEILING SPACE CO CH SANITARY CLEANOUT IN SLAB  DOMESTIC COLD WATER  DOMESTIC HOT WATER RECIRCULATION  BITP BACKFLOW PREVENTER - SUITABLE FOR SERVICE INTI  W WATER METER  THB HOSE BIBB  I NFHB NON-FREEZE HOSE BIBB  OVIR VENT THROUGH ROOF  ORWL RAIM WATER LEADER  FD FLOOR DRAIN  ORD ROOF DRAIN  ORD BAS - ANALOG OUTPUT  OI BAS - DIGITAL INPUT  DO BAS - DIGITAL INPUT  DO BAS - DIGITAL INPUT  DO BAS - DIGITAL OUTPUT  FIRE EXTINGUISHER IN ENCLOSURE C/W MOUNTING BRACKET  THE CONTINUENCE CONTINUENCE C/W MOUNTING BRACKET  THE CONTINUENCE SERVICE  COD CONTINUENCE DENOTING  CONTINUENCE DENOTING  EX EXISTING  EX EXISTING  THE EXTINGUISHER IN ENCLOSURE C/W MOUNTING BRACKET  THE CONTINUENCE SERVICE  COD CONTINUENCE DENOTING  CONTINUENCE SERVICE  COD	
###   PROBLEM   PROPED FILE   PROPED FILE	
FFH-A  FORCE  FFH-A  FORCE  FFH-A  FFH-B  FF	
PLUMBING AND DRAINACE  STM ABOVE—GROUND STORM  SAN ABOVE—GROUND SANITARY  UNDERGROUND SANITARY  UNDERGROUND SANITARY  PUMPED SAN PUMPED SANITARY  PUMPED SAN PUMPED SANITARY  PUMPED SANITARY VENT  HICO SANITARY CLEANOUT IN ACCESSIBLE CEILING SPACE  CO CI SANITARY CLEANOUT IN SLAB  DOMESTIC COLD WATER  DOMESTIC HOT WATER  DOMESTIC HOT WATER RECIRCULATION  BFP ABACKFLOW PREVENTER — SUITABLE FOR SERVICE INTI  W WATER METER  I HB HOSE BIBB  I NFHB NON—FREEZE HOSE BIBB  OVTR VENT THROUGH ROOF  ORWL RAIN WATER LEADER  FFD FLOOR DRAIN  OFFD FLOOR DRAIN  OFFD FLOOR DRAIN  ORD ROOF DRAIN  ONTROLS  TO BAS — TEMPERATURE SENSOR — IN PIPING  CONTROLS  TO BAS — PRESSURE SWITCH  AD BAS — ANALOG OUTPUT  DO BAS — DIGITAL INPUT  DO BAS — DIGITAL DUTPUT  PIRE EXTINGUISHER IN ENCLOSURE C/W MOUNTING BRACKET  THE BLANKET  ACRONYMS  LABEL DESCRIPTION  AD ACCESS DOOR  AD ACC	AT OUTPUT
ABOVE—GROUND STORM  STM	
ABOVE-GROUND STORM  SAN ABOVE-GROUND SANITARY  PUMPED SAN PUMPED SANITARY  PUMPED SAN PUMPED SANITARY  PUMPE	
ABOVE-GROUND SANITARY  SAN UNDERGROUND SANITARY  PUMPED SAN PUMPED SANITARY  RUNNING TRAP  PLUMBING TRAP  DOMESTIC COLD WATER  DOMESTIC HOT WATER  DOMESTIC HOT WATER  DOMESTIC HOT WATER  PLUMBING PREVENTER - SUITABLE FOR SERVICE INTI  WHATER METER  JHB HOSE BIBB  JNFHB HOSE BIBB  JNFHB NON-FREEZE HOSE BIBB  OVTR VENT THROUGH ROOF  ORWL RAIN WATER LEADER  PFD FLOOR DRAIN  PFD FLOOR DRAIN  CONTROLS  DRAIN	
SAN	
PUMPED SAN PUMPED SANITARY  TUMPED SAN PUMPED SANITARY  PUMPED SANITARY  PUMPED SANITARY  PUMPED SANITARY  PUMPED SANITARY  PUMBING TRAP  SANITARY VENT  HICO SANITARY CLEANOUT IN ACCESSIBLE CEILING SPACE  CO QI-/ SANITARY CLEANOUT IN SLAB  DOMESTIC COLD WATER  DOMESTIC HOT WATER  DOMESTIC HOT WATER RECIRCULATION  BEFP BACKFLOW PREVENTER - SUITABLE FOR SERVICE INTI  WATER METER  I HB HOSE BIBB  I NFHB NON-FREEZE HOSE BIBB  OVTR VENT THROUGH ROOF  ORWL RAIN WATER LEADER  FD FLOOR DRAIN  FTD FUNNEL FLOOR DRAIN  ROF D FLOOR DRAIN  ROF D FLOOR DRAIN  ORD ROOF DRAIN  CONTROLS  BAS - TEMPERATURE SENSOR - IN PIPING  CO'S BAS - CURRENT SENSOR  P/S BAS - PRESSURE SWITCH  AI BAS - ANALOG INPUT  AO BAS - ANALOG OUTPUT  DO BAS - DIGITAL INPUT  DO BAS - DIGITAL OUTPUT  THE PROTECTION  FIRE EXTINGUISHER IN ENCLOSURE C/W MOUNTING BRACKET  FIRE EXTINGUISHER C/W MOUNTING BRACKET  FIRE EXTINGUISHER C/W MOUNTING BRACKET  FIRE EXTINGUISHER C/W MOUNTING BRACKET  COT TO PASSITION  AD ACCESS DOOR  AC AIR CONDITIONER  BOD BALANCING DAMPER  BOD BACKDRAFT DAMPER  CUT CONDENSATE  CUT CUT POINT  UT POINT  CUT CUT POINT  DO CONDENSATE  CUT CUT POINT  DO CONDENSATE  CUT CUT POINT  DO CONDENSATE  CUT CUT POINT  CUT CUT POINT  DO CONDENSATE  CUT CUT POINT  CUT CUT P	
RUNNING TRAP  PLUMBING TRAP  Y SANITARY VENT  HICO SANITARY CLEANOUT IN ACCESSIBLE CEILING SPACE  CO OH SANITARY CLEANOUT IN SLAB  DOMESTIC COLD WATER  DOMESTIC HOT WATER  DOMESTIC HOT WATER RECIRCULATION  BEP BACKFLOW PREVENTER - SUITABLE FOR SERVICE INTI  W WATER METER  I HB HOSE BIBB  I NFHB NON-FREEZE HOSE BIBB  OVTR VENT THROUGH ROOF  ORWL RAIN WATER LEADER  OFD FLOOR DRAIN  OFFD FUNNEL FLOOR DRAIN  ORD ROOF DRAIN  ONTROLS  BAS - TEMPERATURE SENSOR - IN PIPING  C/S BAS - CURRENT SENSOR  P/S BAS - PRESSURE SWITCH  AI BAS - ANALOG INPUT  AO BAS - ANALOG OUTPUT  DO BAS - DIGITAL INPUT  DO BAS - DIGITAL OUTPUT  THE PROTECTION  FIRE EXTINGUISHER IN ENCLOSURE C/W MOUNTING BE FIRE EXTINGUISHER (// WOUNTING BRACKET)  E FIRE EXTINGUISHER (// WOUNTING BRACKET)  ACCONYMS  LABEL DESCRIPTION  AD ACCESS DOOR  AC AIR CONDITIONER  BOD BALANOING DAMPER  BOD BALANOING	
PLUMBING TRAP  SANITARY VENT  ICO SANITARY CLEANOUT IN ACCESSIBLE CEILING SPACE  SANITARY CLEANOUT IN SLAB  DOMESTIC COLD WATER  DOMESTIC HOT WATER  DOMESTIC HOT WATER RECIRCULATION  BFP	
SANITARY VENT	
COCH SANITARY CLEANOUT IN ACCESSIBLE CEILING SPACE  COCH SANITARY CLEANOUT IN SLAB  DOMESTIC COLD WATER  DOMESTIC HOT WATER  DOMESTIC HOT WATER RECIRCULATION  BFP BACKFLOW PREVENTER - SUITABLE FOR SERVICE INTI  W WATER METER  I HB HOSE BIBB  I NFHB NON-FREEZE HOSE BIBB  O VTR VENT THROUGH ROOF  O RWL RAIN WATER LEADER  OFD FLOOR DRAIN  OFFD FUNNEL FLOOR DRAIN  ORD ROOF DRAIN  CONTROLS  DAS - TEMPERATURE SENSOR - IN PIPING  CONTROLS  DAS - PRESSURE SWITCH  AI BAS - ANALOG INPUT  AO BAS - ANALOG INPUT  DO BAS - DIGITAL INPUT  DO BAS - DIGITAL OUTPUT  TIER PROTECTION  FE FIRE EXTINGUISHER IN ENCLOSURE C/W MOUNTING BRACKET  DEST FB FIRE BLANKET  ACRONYMS  LABEL DESCRIPTION  AD ACCESS DOOR  AC AIR CONDITIONER  BDD BACKDRAFT DAMPER  BDD BACKDR	
CO QI— SANITARY CLEANOUT IN SLAB	
DOMESTIC COLD WATER  DOMESTIC HOT WATER  DOMESTIC HOT WATER RECIRCULATION  BPP BACKFLOW PREVENTER - SUITABLE FOR SERVICE INTI  W WATER METER  I HB HOSE BIBB  I NFHB NON-FREEZE HOSE BIBB  O VTR VENT THROUGH ROOF  O RWL RAIN WATER LEADER  OFD FLOOR DRAIN  OFFD FUNNEL FLOOR DRAIN  ORD ROOF DRAIN  CONTROLS  O BAS - TEMPERATURE SENSOR - IN PIPING  CONTROLS  O BAS - PRESSURE SWITCH  I BAS - ANALOG INPUT  AO BAS - ANALOG INPUT  AO BAS - DIGITAL INPUT  DO BAS - DIGITAL OUTPUT  THE PROTECTION  FIRE EXTINGUISHER IN ENCLOSURE C/W MOUNTING BRACKET  OFFI FIRE EXTINGUISHER IN ENCLOSURE C/W MOUNTING BRACKET  CONTROLS  ACCASS DOOR  AC AR CONDITIONER  BD BALANCING DAMPER  CAP EXISTING SERVICE  CUT CUT POINT DETAIL OUTPUT  DI BASHANGING DAMPER  CAP EXISTING SERVICE  CUT CUT POINT DETAIL OUTPUT  DO DEALANCING DAMPER  CAP CAP EXISTING SERVICE  CUT CUT POINT DETAIL OUTPUT  DO DEALANCING DAMPER  CAP CAP EXISTING SERVICE  CUT CUT POINT DETAIL OUTPUT  DO DEALANCING DAMPER  CAP CAP EXISTING SERVICE  CUT CUT POINT DETAILS  EX EXISTING  EX EXISTING  EX EXISTING  DETAIL OUTPUT  DETA	
DOMESTIC COLD WATER  DOMESTIC HOT WATER  DOMESTIC HOT WATER RECIRCULATION  BPP BACKFLOW PREVENTER - SUITABLE FOR SERVICE INTI  W WATER METER  I HB HOSE BIBB  I NFHB NON-FREEZE HOSE BIBB  O VTR VENT THROUGH ROOF  O RWL RAIN WATER LEADER  OFD FLOOR DRAIN  OFFD FUNNEL FLOOR DRAIN  ORD ROOF DRAIN  CONTROLS  O BAS - TEMPERATURE SENSOR - IN PIPING  CONTROLS  O BAS - PRESSURE SWITCH  I BAS - ANALOG INPUT  AO BAS - ANALOG INPUT  AO BAS - DIGITAL INPUT  DO BAS - DIGITAL OUTPUT  THE PROTECTION  FIRE EXTINGUISHER IN ENCLOSURE C/W MOUNTING BRACKET  OFFI FIRE EXTINGUISHER IN ENCLOSURE C/W MOUNTING BRACKET  CONTROLS  ACCASS DOOR  AC AR CONDITIONER  BD BALANCING DAMPER  CAP EXISTING SERVICE  CUT CUT POINT DETAIL OUTPUT  DI BASHANGING DAMPER  CAP EXISTING SERVICE  CUT CUT POINT DETAIL OUTPUT  DO DEALANCING DAMPER  CAP CAP EXISTING SERVICE  CUT CUT POINT DETAIL OUTPUT  DO DEALANCING DAMPER  CAP CAP EXISTING SERVICE  CUT CUT POINT DETAIL OUTPUT  DO DEALANCING DAMPER  CAP CAP EXISTING SERVICE  CUT CUT POINT DETAILS  EX EXISTING  EX EXISTING  EX EXISTING  DETAIL OUTPUT  DETA	
DOMESTIC HOT WATER  DOMESTIC HOT WATER RECIRCULATION  BFP	
DOMESTIC HOT WATER RECIRCULATION  BFP	
BACKFLOW PREVENTER — SUITABLE FOR SERVICE INTI  W	
WATER METER    HB	
I HB HOSE BIBB  I NFHB NON-FREEZE HOSE BIBB  O VTR VENT THROUGH ROOF  O RWL RAIN WATER LEADER  ○ FD FLOOR DRAIN  ○ FFD FUNNEL FLOOR DRAIN  ○ RD ROOF DRAIN  ○ CONTROLS  ───────────────────────────────────	
INFHB NON-FREEZE HOSE BIBB  O VTR VENT THROUGH ROOF  O RWL RAIN WATER LEADER  ○ FD FLOOR DRAIN  ○ FFD FUNNEL FLOOR DRAIN  ○ RD ROOF DRAIN  ○ ONTROLS  ──□ C/S BAS - TEMPERATURE SENSOR - IN PIPING  ──□ C/S BAS - PRESSURE SWITCH  ──□ F/S BAS - FLOW SWITCH  AI BAS - ANALOG INPUT  AO BAS - ANALOG OUTPUT  DI BAS - DIGITAL INPUT  DO BAS - DIGITAL OUTPUT  IRE PROTECTION  FEE FIRE EXTINGUISHER IN ENCLOSURE C/W MOUNTING BRACKET  ○ FIRE EXTINGUISHER C/W MOUNTING BRACKET  ■ FIRE BLANKET  ■ CRONYMS  LABEL DESCRIPTION  AD ACCESS DOOR  AC AIR CONDITIONER  BD BALANCING DAMPER  BD BALANCING SERVICE  CO CONDENSATE  CTE CONNECT TO EXISTING  CUT CUT POINT  DF DRINKING FOUNTAIN  EX EXISTING	
OVTR VENT THROUGH ROOF  ORWL RAIN WATER LEADER  ØFD FLOOR DRAIN  ØFFD FUNNEL FLOOR DRAIN  ØRD ROOF DRAIN  CONTROLS  ───────────────────────────────────	
ORWL RAIN WATER LEADER	
FIDE FLOOR DRAIN  FED FUNNEL FLOOR DRAIN  ROOF DRAIN  CONTROLS  BAS - TEMPERATURE SENSOR - IN PIPING  CS BAS - CURRENT SENSOR  P/S BAS - PRESSURE SWITCH  AI BAS - ANALOG INPUT  AO BAS - ANALOG OUTPUT  DI BAS - DIGITAL INPUT  DO BAS - DIGITAL OUTPUT  IRE PROTECTION  FE FIRE EXTINGUISHER IN ENCLOSURE C/W MOUNTING BRACKET  FIRE EXTINGUISHER C/W MOUNTING BRACKET  CCRONYMS  LABEL DESCRIPTION  AD ACCESS DOOR  AC AIR CONDITIONER  BD BALANCING DAMPER  BDD BACKDRAFT DAMPER  CAP CAP EXISTING SERVICE  CON CONDENSATE  CIT CONNECT TO EXISTING  CUT CUT POINT  DF DRINKING FOUNTAIN  EX EXISTING  EX EXISTING  EX EXISTING  FOR TOWN TO A CONDITIONER  BC DESCRIPTION  BC CONDENSATE  CIT CONNECT TO EXISTING  EX EXISTING  EX EXISTING	
FFD FUNNEL FLOOR DRAIN  RD ROOF DRAIN  CONTROLS	
RD ROOF DRAIN  CONTROLS  TO BAS - TEMPERATURE SENSOR - IN PIPING  C/S BAS - CURRENT SENSOR  P/S BAS - PRESSURE SWITCH  AI BAS - ANALOG INPUT  AO BAS - ANALOG OUTPUT  DI BAS - DIGITAL INPUT  DO BAS - DIGITAL OUTPUT  IRE PROTECTION  FE FIRE EXTINGUISHER IN ENCLOSURE C/W MOUNTING BRACKET  FIRE EXTINGUISHER C/W MOUNTING BRACKET  C/C FIRE BLANKET  ACRONYMS  LABEL DESCRIPTION  AD ACCESS DOOR  AC AIR CONDITIONER  BD BALANCING DAMPER  BCAP CAP EXISTING SERVICE  COD CONDENSATE  CTE CONNECT TO EXISTING  CUT CUT POINT  DF DRINKING FOUNTAIN  EA EXHAUST AIR  EX EXISTING  EXISTING  EX EXISTING	
BAS - TEMPERATURE SENSOR - IN PIPING  C/S BAS - CURRENT SENSOR  P/S BAS - PRESSURE SWITCH  AI BAS - ANALOG INPUT  AO BAS - ANALOG OUTPUT  DI BAS - DIGITAL INPUT  DO BAS - DIGITAL OUTPUT  IRE PROTECTION  FE FIRE EXTINGUISHER IN ENCLOSURE C/W MOUNTING BRACKET  FIRE EXTINGUISHER C/W MOUNTING BRACKET  FIRE EXTINGUISHER C/W MOUNTING BRACKET  CACRONYMS  LABEL DESCRIPTION  AD ACCESS DOOR  AC AIR CONDITIONER  BD BALANCING DAMPER  BDD BACKDRAFT DAMPER  CAP CAP EXISTING SERVICE  CD CONDENSATE  CTE CONNECT TO EXISTING  CUT CUT POINT  DF DRINKING FOUNTAIN  EA EXHAUST AIR  EX EXISTING  EX EXISTING	
BAS - TEMPERATURE SENSOR - IN PIPING  C/S BAS - CURRENT SENSOR  P/S BAS - PRESSURE SWITCH  AI BAS - ANALOG INPUT  AO BAS - ANALOG OUTPUT  DI BAS - DIGITAL INPUT  DO BAS - DIGITAL OUTPUT  TIRE PROTECTION  FE FIRE EXTINGUISHER IN ENCLOSURE C/W MOUNTING BROWN FIRE BLANKET  CE FIRE BLANKET  ACCONYMS  LABEL DESCRIPTION  AD ACCESS DOOR  AC AIR CONDITIONER  BD BALANCING DAMPER  BDD BACKDRAFT DAMPER  CAP CAP EXISTING SERVICE  CD CONDENSATE  CTE CONNECT TO EXISTING  CUT CUT POINT  DF DRINKING FOUNTAIN  EA EXHAUST AIR  EX EXISTING  EXISTING  BAS - CURRENT SENSOR  IN PIPING  WOUNTING  BAS - PRESSURE SWITCH  ANALOG OUTPUT  BAS - ANALOG OUTPUT  DE DRINKING FOUNTAIN  EA EXHAUST AIR  EX EXISTING	
BAS - CURRENT SENSOR	
BAS - PRESSURE SWITCH    F/S   BAS - FLOW SWITCH	
BAS - FLOW SWITCH  AI BAS - ANALOG INPUT  AO BAS - ANALOG OUTPUT  DI BAS - DIGITAL INPUT  DO BAS - DIGITAL OUTPUT  IRE PROTECTION  FE FIRE EXTINGUISHER IN ENCLOSURE C/W MOUNTING BR  FIRE EXTINGUISHER C/W MOUNTING BRACKET  FIRE BLANKET  CRONYMS  LABEL DESCRIPTION  AD ACCESS DOOR AC AIR CONDITIONER BD BALANCING DAMPER BDD BACKDRAFT DAMPER CAP CAP EXISTING SERVICE CO CONDENSATE CTE CONNECT TO EXISTING CUT CUT POINT DF DRINKING FOUNTAIN EX EXHAUST AIR EX EXISTING	
AI BAS - ANALOG INPUT  AO BAS - ANALOG OUTPUT  DI BAS - DIGITAL INPUT  DO BAS - DIGITAL OUTPUT  IRE PROTECTION  FE FIRE EXTINGUISHER IN ENCLOSURE C/W MOUNTING BR  FE FIRE EXTINGUISHER C/W MOUNTING BRACKET  FIRE BLANKET  ACRONYMS  LABEL DESCRIPTION  AD ACCESS DOOR  AC AIR CONDITIONER  BD BALANCING DAMPER  CAP CAP EXISTING SERVICE  CO CONDENSATE  CTE CONNECT TO EXISTING  CUT CUT POINT  DF DRINKING FOUNTAIN  EA EXHAUST AIR  EX EXISTING	
AO BAS - ANALOG OUTPUT  DI BAS - DIGITAL INPUT  DO BAS - DIGITAL OUTPUT  IRE PROTECTION  FE FIRE EXTINGUISHER IN ENCLOSURE C/W MOUNTING BR  FE FIRE EXTINGUISHER C/W MOUNTING BRACKET  FB FIRE BLANKET  CRONYMS  LABEL DESCRIPTION  AD ACCESS DOOR  AC AIR CONDITIONER  BD BALANCING DAMPER  BDD BACKDRAFT DAMPER  BDD BACKDRAFT DAMPER  CAP CAP EXISTING SERVICE  CD CONDENSATE  CTE CONNECT TO EXISTING  CUT CUT POINT  DF DRINKING FOUNTAIN  EA EXHAUST AIR  EX EXISTING	
DI BAS - DIGITAL INPUT  DO BAS - DIGITAL OUTPUT  IRE PROTECTION  FE FIRE EXTINGUISHER IN ENCLOSURE C/W MOUNTING BR  FE FIRE EXTINGUISHER C/W MOUNTING BRACKET  FIRE BLANKET  ACRONYMS  LABEL DESCRIPTION  AD ACCESS DOOR  AC AIR CONDITIONER  BD BALANCING DAMPER  BDD BACKDRAFT DAMPER  CAP CAP EXISTING SERVICE  CD CONDENSATE  CTE CONNECT TO EXISTING  CUT CUT POINT  DF DRINKING FOUNTAIN  EA EXHAUST AIR  EX EXISTING	
BAS - DIGITAL OUTPUT  FE FIRE EXTINGUISHER IN ENCLOSURE C/W MOUNTING BR FE FIRE EXTINGUISHER C/W MOUNTING BRACKET  FIRE BLANKET  ACRONYMS  LABEL DESCRIPTION  AD ACCESS DOOR AC AIR CONDITIONER BD BALANCING DAMPER BDD BACKDRAFT DAMPER CAP CAP EXISTING SERVICE CD CONDENSATE CTE CONNECT TO EXISTING CUT CUT POINT DF DRINKING FOUNTAIN EA EXHAUST AIR EX EXISTING	
FE FIRE EXTINGUISHER IN ENCLOSURE C/W MOUNTING BR FE FIRE EXTINGUISHER C/W MOUNTING BRACKET  FIRE BLANKET  ACRONYMS  LABEL DESCRIPTION  AD ACCESS DOOR AC AIR CONDITIONER BD BALANCING DAMPER BDD BACKDRAFT DAMPER CAP CAP EXISTING SERVICE CD CONDENSATE CTE CONNECT TO EXISTING CUT CUT POINT DF DRINKING FOUNTAIN EA EXHAUST AIR EX EXISTING	
FE FIRE EXTINGUISHER IN ENCLOSURE C/W MOUNTING BR  FIRE EXTINGUISHER C/W MOUNTING BRACKET  FIRE BLANKET  ACRONYMS  LABEL DESCRIPTION  AD ACCESS DOOR AC AIR CONDITIONER BD BALANCING DAMPER BDD BACKDRAFT DAMPER CAP CAP EXISTING SERVICE CD CONDENSATE CTE CONNECT TO EXISTING CUT CUT POINT DF DRINKING FOUNTAIN EA EXHAUST AIR EX EXISTING	
FIRE EXTINGUISHER C/W MOUNTING BRACKET  CRONYMS  LABEL DESCRIPTION  AD ACCESS DOOR AC AIR CONDITIONER BD BALANCING DAMPER BDD BACKDRAFT DAMPER CAP CAP EXISTING SERVICE CD CONDENSATE CTE CONNECT TO EXISTING CUT CUT POINT DF DRINKING FOUNTAIN EA EXHAUST AIR EX EXISTING	
FB FIRE BLANKET  ACRONYMS  LABEL DESCRIPTION  AD ACCESS DOOR AC AIR CONDITIONER BD BALANCING DAMPER BDD BACKDRAFT DAMPER CAP CAP EXISTING SERVICE CD CONDENSATE CTE CONNECT TO EXISTING CUT CUT POINT DF DRINKING FOUNTAIN EA EXHAUST AIR EX EXISTING	ACKET
ACRONYMS  LABEL DESCRIPTION  AD ACCESS DOOR AC AIR CONDITIONER BD BALANCING DAMPER BDD BACKDRAFT DAMPER CAP CAP EXISTING SERVICE CD CONDENSATE CTE CONNECT TO EXISTING CUT CUT POINT DF DRINKING FOUNTAIN EA EXHAUST AIR EX EXISTING	
LABEL DESCRIPTION  AD ACCESS DOOR AC AIR CONDITIONER BD BALANCING DAMPER BDD BACKDRAFT DAMPER CAP CAP EXISTING SERVICE CD CONDENSATE CTE CONNECT TO EXISTING CUT CUT POINT DF DRINKING FOUNTAIN EA EXHAUST AIR EX EXISTING	
AD ACCESS DOOR AC AIR CONDITIONER BD BALANCING DAMPER BDD BACKDRAFT DAMPER CAP CAP EXISTING SERVICE CD CONDENSATE CTE CONNECT TO EXISTING CUT CUT POINT DF DRINKING FOUNTAIN EA EXHAUST AIR EX EXISTING	
AC AIR CONDITIONER BD BALANCING DAMPER BDD BACKDRAFT DAMPER CAP CAP EXISTING SERVICE CD CONDENSATE CTE CONNECT TO EXISTING CUT CUT POINT DF DRINKING FOUNTAIN EA EXHAUST AIR EX EXISTING	
BD BALANCING DAMPER BDD BACKDRAFT DAMPER CAP CAP EXISTING SERVICE CD CONDENSATE CTE CONNECT TO EXISTING CUT CUT POINT DF DRINKING FOUNTAIN EA EXHAUST AIR EX EXISTING	
CD CONDENSATE CTE CONNECT TO EXISTING CUT CUT POINT DF DRINKING FOUNTAIN EA EXHAUST AIR EX EXISTING	
CUT CUT POINT DF DRINKING FOUNTAIN EA EXHAUST AIR EX EXISTING	
DF DRINKING FOUNTAIN EA EXHAUST AIR EX EXISTING	
FE FIRE EXTINGUISHER FS FLOW SWITCH	
HHS HAND—HELD SHOWER LV LAVATORY	
MD MOTORIZED DAMPER NO NORMALLY OPEN	
NC NORMALLY CLOSED OA OUTDOOR AIR	
PG PRESSURE GAUGE RWL RAIN WATER LEADER REM REMOVE	

#### GENERAL NOTES:

- 1. ALL DEMOLITION AND NEW WORK SHALL BE COORDINATED WITH ALL TRADES PRESENT ON SITE. CONSTRUCT NEW SERVICES AND LOCATE NEW EQUIPMENT IN SUCH A WAY THAT IT DOES NOT CONFLICT WITH WORK OF OTHER DIVISIONS AND/OR THE OPERATION/MAINTENANCE OF WORK/MATERIAL SUPPLIED BY OTHER DIVISIONS.
- 2. IT IS MANDATORY FOR THE MECHANICAL CONTRACTOR TO VISIT THE SITE PRIOR TO BIDDING AND REVIEW EXISTING CONDITIONS AND DEMOLITION SCOPE OF WORK TO SUIT EXISTING ARCHITECTURAL, ELECTRICAL, STRUCTURAL AND MECHANICAL SITE CONDITIONS, DRAWINGS, SPECIFICATIONS AND ALL CONTRACT DOCUMENTS. NO EXTRA WILL SUBSEQUENTLY BE ALLOWED TO COVER ANY SUCH ERROR, OMISSION AND/OR OVERSIGHT FOR NOT HAVING MADE A THOROUGH INSPECTION OF THE GROUNDS, EXISTING CONDITIONS, DRAWINGS, SPECIFICATION AND DESIGN INTENT. THE ELECTRICAL CONTRACTOR SHALL NOTE THAT THE EXISTING BUILDING WILL REMAIN IN OPERATION THROUGHOUT DEMOLITION/CONSTRUCTION. ALLOW FOR ANY WORK REQUIRED TO BE DONE WHICH MAY AFFECT POWER SUPPLY AND OPERATION OF THE BUILDING TO BE CARRIED OUT AFTER HOURS OR AT A TIME CONVENIENT TO THE BUILDING MANAGEMENT. PROVIDE TEMPORARY SERVICES AS REQUIRED TO ENSURE CONTINUED OPERATION AT ALL TIMES.
- 3. CAREFULLY EXAMINE OTHER EXISTING UTILITY LINES SUCH AS GAS, WATER ETC. PRIOR TO STARTING ANY WORK.
- 4. THESE DRAWINGS SHALL BE READ & PRICED IN CONJUNCTION WITH ALL DRAWINGS AND SPECIFICATIONS FORMING THE CONTRACT AS WELL AS ALL OTHER DOCUMENTS FORMING THIS BID. NO EXTRA COST WILL BE ACCEPTED IN FAILURE TO OBTAINING AND/OR REVIEW OF SUCH DOCUMENTS. REFER TO ARCHITECTURAL, ELECTRICAL, FIRE PROTECTION STRUCTURAL AND MECHANICAL LAYOUTS IN CONJUNCTION FOR EXACT LOCATION OF ALL EQUIPMENT. REPORT ANY DISCREPANCIES TO THE MECHANICAL ENGINEER PRIOR TO COMMENCING WORK. NO EXTRA WILL BE PROVIDED AS A RESULT OF A FAILURE TO DO SO.
- 5. IT IS MANDATORY THAT ALL WORK COMPLY WITH ALL APPLICABLE CODES AND, CITY OF TORONTO STANDARDS, AND THE STANDARDS SET BY ANY AND ALL LOCAL AUTHORITIES HAVING JURISDICTION.
- 6. ARRANGE FOR ALL INSPECTIONS REQUIRED BY AUTHORITIES HAVING JURISDICTION AS MANDATED BY CODES OR THE REQUIREMENTS OF THE AUTHORITIES. ATTEND ALL INSPECTIONS AND FURNISH ALL MATERIALS AND LABOUR REQUIRED TO COMPLETE THE INSPECTIONS TO THE SATISFACTION OF THE AUTHORITIES.
- 7. IN THE EVENT OF ANY DISCREPANCY BETWEEN THE MECHANICAL DRAWINGS AND SPECIFICATIONS, ALLOW FOR THE HIGHEST—PRICED OPTION IN THE
- 8. ALL EQUIPMENT AND SERVICES SHALL BE STARTED—UP BY THE CONTRACTOR AND BY THE APPROPRIATE AGENCIES REQUIRED FOR CONDUCTING SUCH START—UPS. PROVIDE A MINIMUM OF 10 BUSINESS DAYS NOTICE TO THE MECHANICAL ENGINEER OF NEW EQUIPMENT/SERVICES START—UPS.
- 9. FURNISH ALL MATERIAL AND EQUIPMENT AS SPECIFIED, EXCEPT WHERE SPECIFIC APPROVAL FOR SUBSTITUTION IS GIVEN IN WRITING BY THE
- 10. PROVIDE AS—BUILT DRAWINGS IN CAD AND PDF FORMAT AT THE CONCLUSION OF THE PROJECT TO THE OWNER, ARCHITECT AND ENGINEERS.

DRAWING LIST							
DRAWING NUMBER DESCRIPTION							
M1	MECHANICAL LEGEND AND NOTES						
M2	KEY PLAN						
М3	EXISTING MECHANICAL LAYOUT						
M4	NEW MECHANICAL LAYOUT						
M5	SCHEDULES & SCHEMATICS						

## NOTES ABOUT ABATEMENT


- 1. REFER TO THE PROJECT—SPECIFIC DESIGNATED SUBSTANCES SURVEY CONDUCTED FOR THIS PROJECT DURING PRICING AND THROUGHOUT CONSTRUCTION. IT IS INCLUDED IN THE TENDER PACKAGE.
- 2. THE GENERAL CONTRACTOR IS RESPONSIBLE FOR COMPLETING ALL NECESSARY ABATEMENT WORK WITHIN THE WORK AREA REQUIRED FOR THIS PROJECT AS PART OF THE BASE TENDER PRICE BASED ON THE PROJECT—SPECIFIC DSS.
- THE CONTRACTOR SHALL RETAIN ONLY LICENSED ABATEMENT/ENVIRONMENTAL CONTRACTORS TO COMPLETE ALL NECESSARY ABATEMENT WORK.
   COORDINATE ALL ABATEMENT ACTIVITIES WITH THE ENVIRONMENTAL CONSULTANT IN ADVANCE OF WORK EXECUTION. THE ENVIRONMENTAL CONSULTANT IS RETAINED DIRECTLY BY THE OWNER TO SUPERVISE ABATEMENT ACTIVITIES AS WELL AS CONDUCT POST—ABATEMENT INSPECTIONS.

## GENERAL NOTES:

CONTRACTORS SHALL VERIFY AND BE RESPONSIBLE FOR ALL DIMENSIONS AND CONDITIONS ON THE JOB AND THE ENGINEER SHALL BE INFORMED OF ANY VARIATIONS FROM THE DIMENSIONS AND CONDITIONS SHOWN ON THE DRAWINGS. DO NOT SCALE DRAWINGS. SHOP DRAWINGS SHALL BE SUBMITTED TO THE ENGINEER FOR APPROVAL BEFORE PROCEEDING WITH FABRICATION. THIS DRAWING IS THE PROPERTY OF SURI & ASSOCIATES LTD. AND SHALL NOT BE REPRODUCED WITHOUT THEIR PERMISSION AND UNLESS THE REPRODUCTION CARRIES THEIR NAME. ALL INFORMATION SHOWN ON THIS DRAWING IS FOR USE ON THE SPECIFIED PROJECT ONLY AND SHALL NOT BE USED OTHERWISE WITHOUT WRITTEN PERMISSION OF SURI & ASSOCIATES LTD.

2	ISSUED FOR TENDER	MAY 31/24
1	ISSUED FOR 100% DESIGN REVIEW	MAY 6/24
No.	REVISION	DATE

Contractors shall verify all dimensions at the job.

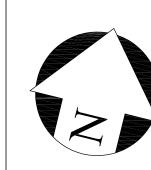



Mechanical & Electrical Consultant:

SURI & ASSOCIATES LTD. ENGINEERING CONSULTANTS

1018 ALBERTSON CRESCENT MISSISSAUGA, ONTARIO L5H 3C7 T (905)-290-7861

ELECTRICAL
MECHANICAL
LIGHTING
COMMUNICATION
SECURITY



Project

OAKRIDGE COMMUNITY
RECREATIONAL CENTRE
63 PHARMACY AVENUE,
TORONTO, ONTARIO. M1L 4S9


AIR HANDLING UNIT REPLACEMENT

Drawing Title

MECHANICAL LEGEND AND

NOTES

Checked:	Date:
RS	MAY 2024
Drawn:	Scale:
RS	AS NOTED
File Number:	Dwg Number:
	M 1

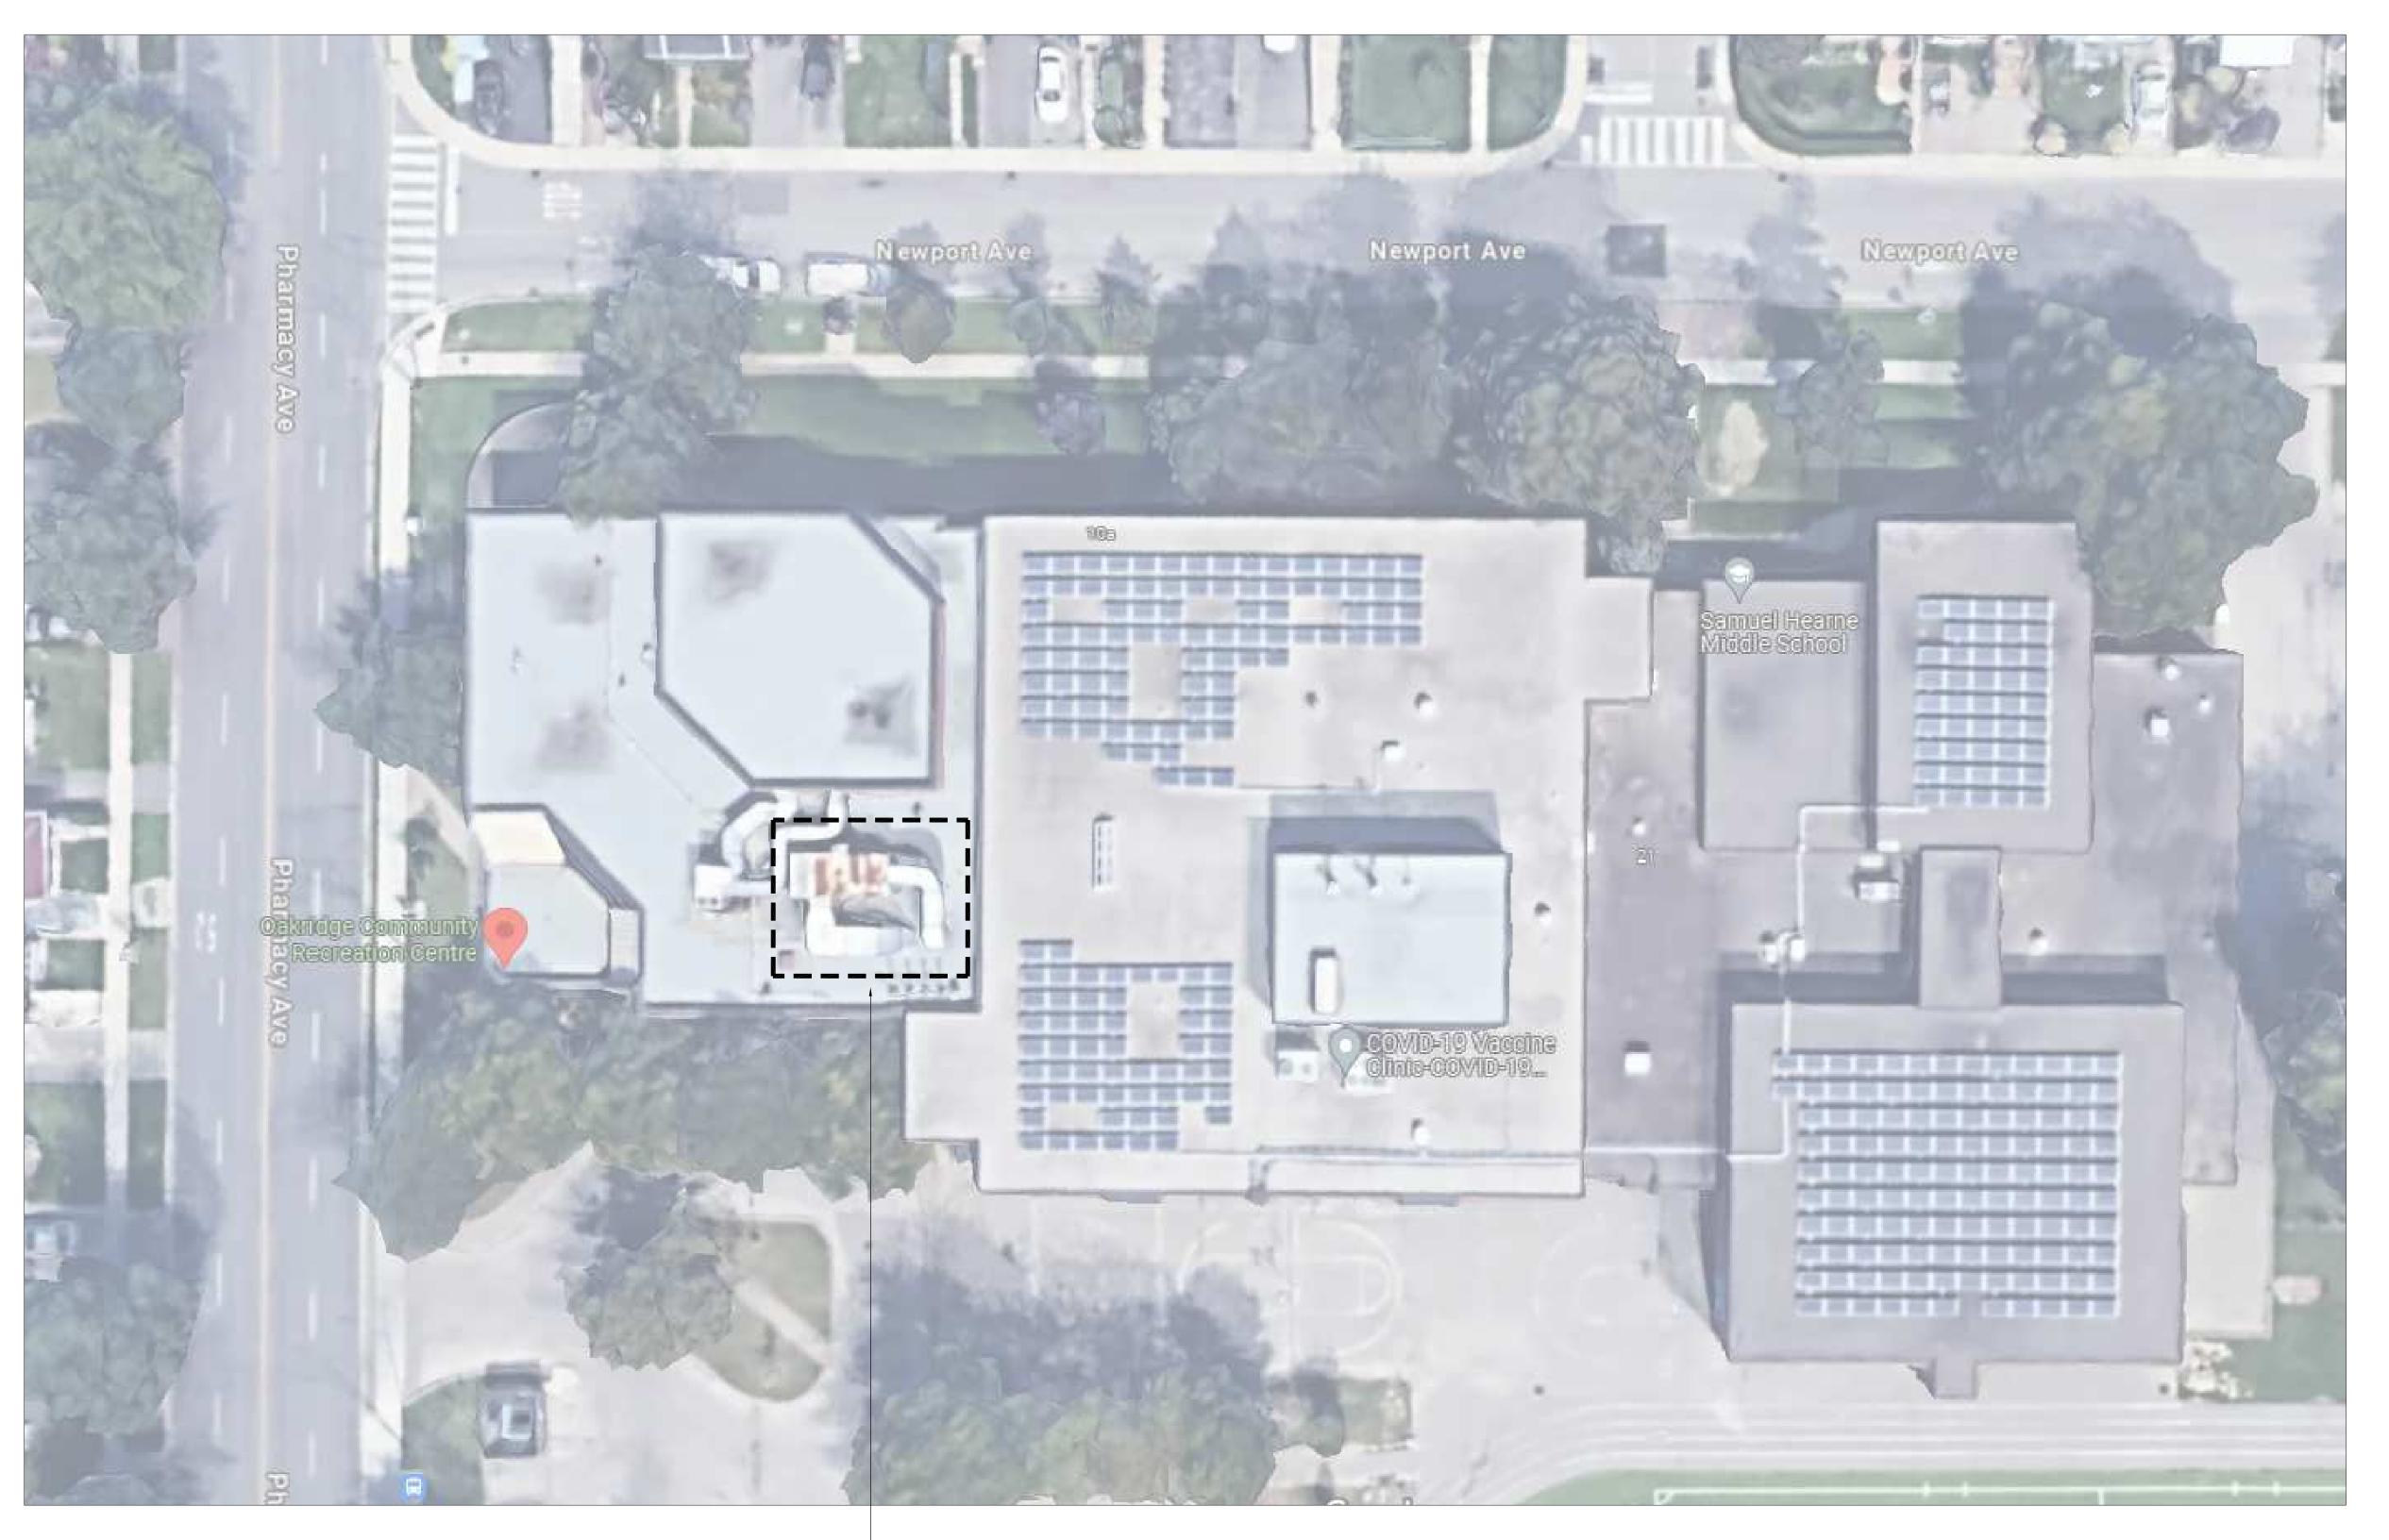

\_ <u>AREA OF WORK:</u>
EXISTING AIR HANDLING UNIT 'AHU-1' TO
BE REPLACED WITH NEW. SEE DRAWINGS
FOR FULL EXTENT OF WORK


1 KEY PLAN OF THE OAKRIDGE COMMUNITY RECREATIONAL CENTRE M2 SCALE: N.T.S.


# **GENERAL NOTES:**

CONTRACTORS SHALL VERIFY AND BE RESPONSIBLE FOR ALL DIMENSIONS AND CONDITIONS ON THE JOB AND THE ENGINEER SHALL BE INFORMED OF ANY VARIATIONS FROM THE DIMENSIONS AND CONDITIONS SHOWN ON THE DRAWINGS. DO NOT SCALE DRAWINGS. SHOP DRAWINGS SHALL BE SUBMITTED TO THE ENGINEER FOR APPROVAL BEFORE PROCEEDING WITH FABRICATION. THIS DRAWING IS THE PROPERTY OF SURI & ASSOCIATES LTD. AND SHALL NOT BE REPRODUCED WITHOUT DRAWING IS THE PROPERTY OF SURI & ASSOCIATES
LTD. AND SHALL NOT BE REPRODUCED WITHOUT
THEIR PERMISSION AND UNLESS THE REPRODUCTION
CARRIES THEIR NAME. ALL INFORMATION SHOWN ON
THIS DRAWING IS FOR USE ON THE SPECIFIED
PROJECT ONLY AND SHALL NOT BE USED
OTHERWISE WITHOUT WRITTEN PERMISSION OF SURI & ASSOCIATES LTD.

L			
	2	ISSUED FOR TENDER	MAY 31/24
	1	ISSUED FOR 100% DESIGN REVIEW	MAY 6/24
	No.	REVISION	DATE

Contractors shall verify all dimensions at the job.

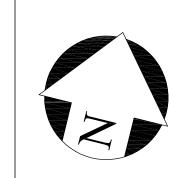

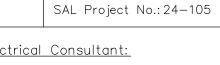

Mechanical & Electrical Consultant:

SURI & ASSOCIATES LTD. Engineering consultants

1018 ALBERTSON CRESCENT MISSISSAUGA, ONTARIO L5H 3C7 T (905)-290-7861

ELECTRICAL MECHANICAL LIGHTING COMMUNICATION SECURITY




Project

OAKRIDGE COMMUNITY RECREATIONAL CENTRE 63 PHARMACY AVENUE, TORONTO, ONTARIO. M1L 4S9

AIR HANDLING UNIT REPLACEMENT

Drawing Title KEY PLAN

Checked:	Date:
RS	MAY 2024
Drawn:	Scale:
RS	AS NOTED
File Number:	Dwg Number:
	M2
1	

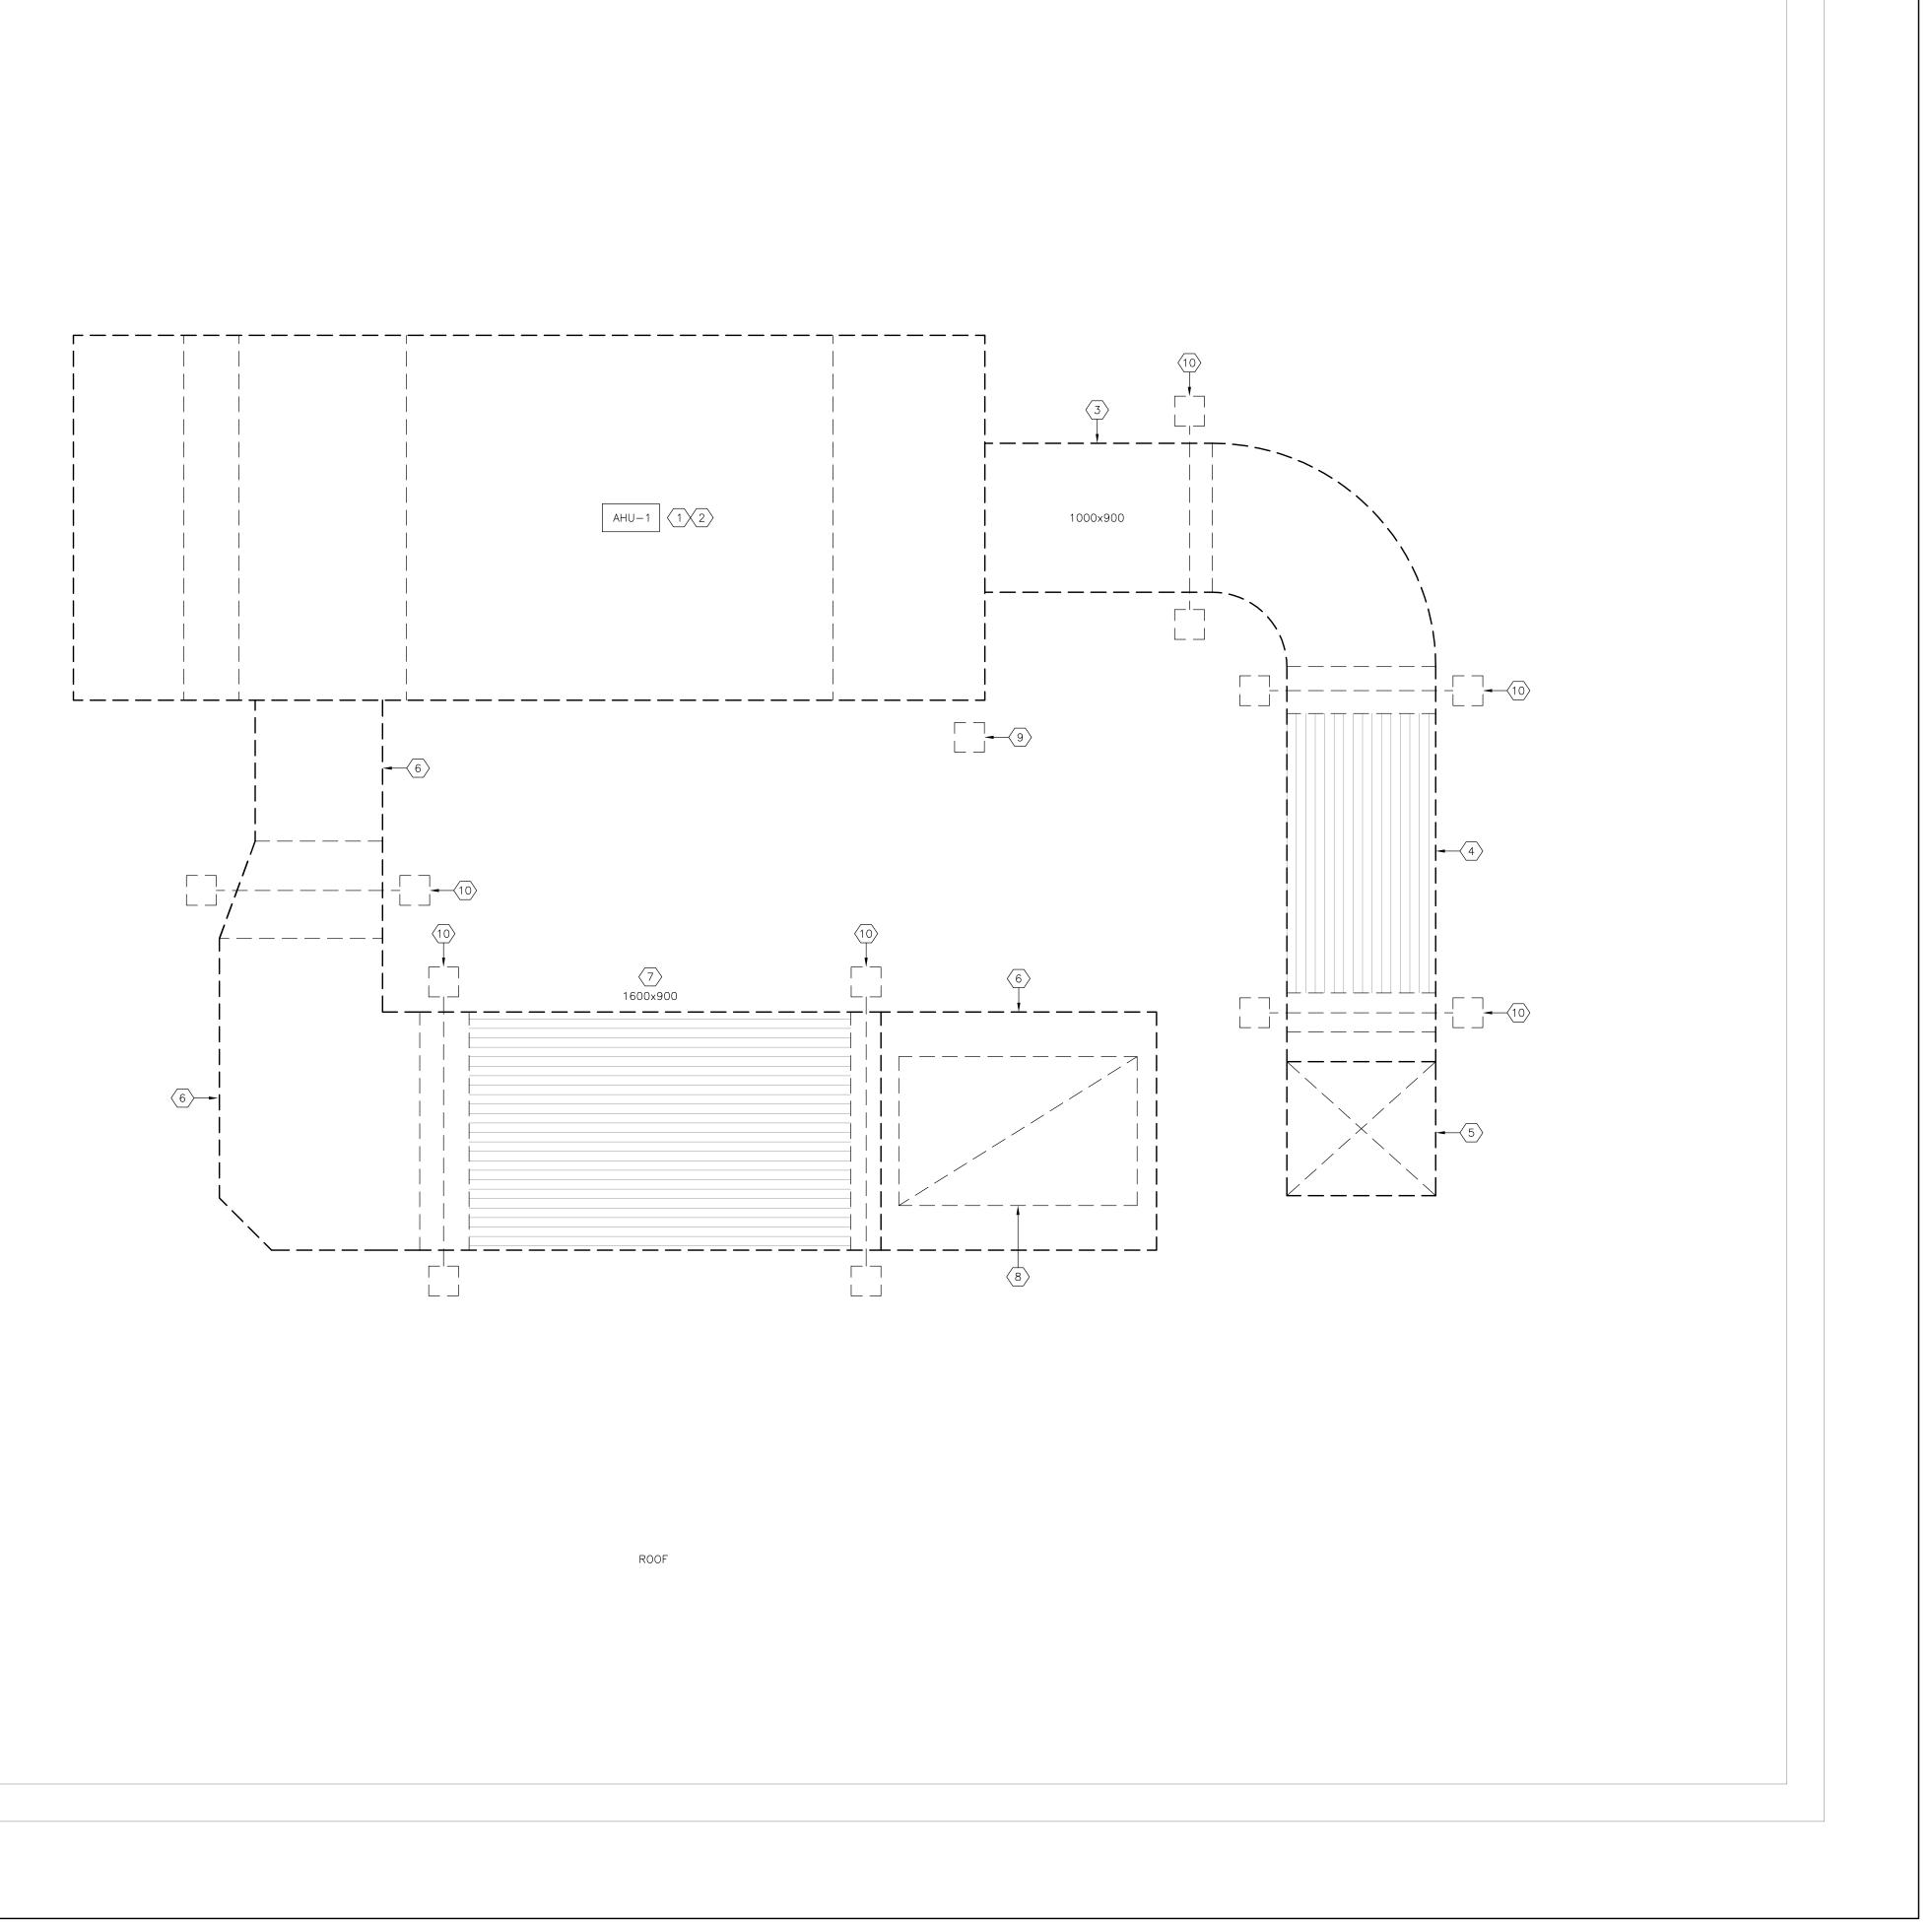

1 ROOF PART PLAN - EXISTING/DEMOLITION HVAC PLAN

M3 SCALE: 1:25

#### DRAWING NOTES:


- 1 REMOVE THE EXISTING AIR HANDLING UNIT 'AHU-1' IN ENTIRETY. DISPOSE OF OFF SITE.
- 2 EXISTING STEEL BEAM FRAME SUPPORTING THE EXISTING AIR HANDLING UNIT IS TO REMAIN AS
- 3 REMOVE ALL ROOFTOP SUPPLY AIR DUCTWORK IN ENTIRETY. DISPOSE OF OFF SITE.
- REMOVE THE EXISTING SUPPLY AIR SILENCER IN ENTIRETY. DISPOSE OF OFF SITE.
- (5) EXISTING 1000x900 SUPPLY AIR DUCT DN. THROUGH THE ROOF. CUT AND REMOVE ALL ROOFTOP DUCTWORK.
- 6 REMOVE ALL ROOFTOP RETURN AIR DUCTWORK IN ENTIRETY. DISPOSE OF OFF SITE.
- $\overline{\langle 7 \rangle}$  remove the existing return air silencer in entirety. Dispose of off site.
- 8 EXISTING 1600×1000 RETURN AIR DUCT DN. THROUGH THE ROOF. CUT AND REMOVE ALL ROOFTOP DUCTWORK.
- REMOVE THE EXISTING PITCH POCKET SERVING THE ELECTRICAL FEEDER. MAKE GOOD ROOF ASSEMBLY. THE MECHANICAL CONTRACTOR SHALL RETAIN THE SERVICES OF THE DESIGNATED ROOFING CONTRACTOR(S) TO REPAIR THE EXISTING ROOF OPENING WHERE THE EXISTING POWER FEED TO THE AIR HANDLING UNIT COMES THROUGH THE ROOF. SEAL, MAKE WATERTIGHT AND MATCH THE EXISTING ROOF CONSTRUCTION. ALL COSTS OF THE ROOFING CONTRACTOR SHALL BE INCLUDED FOR IN THE BASE TENDER PRICE.
- REMOVE THE EXISTING PENETRATING ROOFTOP DUCT SUPPORTS. MAKE GOOD ROOF ASSEMBLY. THE MECHANICAL CONTRACTOR SHALL RETAIN THE SERVICES OF THE DESIGNATED ROOFING CONTRACTOR(S) TO REPAIR THE EXISTING ROOF PENETRATIONS. SEAL, MAKE WATERTIGHT AND MATCH THE EXISTING ROOF CONSTRUCTION. ALL COSTS OF THE ROOFING CONTRACTOR SHALL BE INCLUDED FOR IN THE BASE TENDER PRICE.


## GENERAL NOTES:

CONTRACTORS SHALL VERIFY AND BE RESPONSIBLE FOR ALL DIMENSIONS AND CONDITIONS ON THE JOB AND THE ENGINEER SHALL BE INFORMED OF ANY VARIATIONS FROM THE DIMENSIONS AND CONDITIONS SHOWN ON THE DRAWINGS. DO NOT SCALE DRAWINGS. SHOP DRAWINGS SHALL BE SUBMITTED TO THE ENGINEER FOR APPROVAL BEFORE PROCEEDING WITH FABRICATION. THIS DRAWING IS THE PROPERTY OF SURI & ASSOCIATES LTD. AND SHALL NOT BE REPRODUCED WITHOUT THEIR PERMISSION AND UNLESS THE REPRODUCTION CARRIES THEIR NAME. ALL INFORMATION SHOWN ON THIS DRAWING IS FOR USE ON THE SPECIFIED PROJECT ONLY AND SHALL NOT BE USED OTHERWISE WITHOUT WRITTEN PERMISSION OF SURI & ASSOCIATES LTD.

2	ISSUED FOR TENDER	MAY 31/24
1	ISSUED FOR 100% DESIGN REVIEW	MAY 6/24
No.	REVISION	DATE

Contractors shall verify all dimensions at the job.

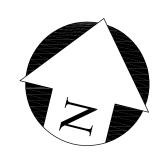

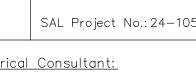

Mechanical & Electrical Consultant:

SURI & ASSOCIATES LTD. ENGINEERING CONSULTANTS

1018 ALBERTSON CRESCENT MISSISSAUGA, ONTARIO L5H 3C7 T (905)-290-7861

ELECTRICAL MECHANICAL LIGHTING COMMUNICATION SECURITY



Project


OAKRIDGE COMMUNITY
RECREATIONAL CENTRE
63 PHARMACY AVENUE,
TORONTO, ONTARIO. M1L 4S9

AIR HANDLING UNIT REPLACEMENT

Drawing Title

EXISTING MECHANICAL LAYOUT

Checked: RS	Date: MAY 2024
Drawn: RS	Scale: AS NOTED
File Number:	Dwg Number:

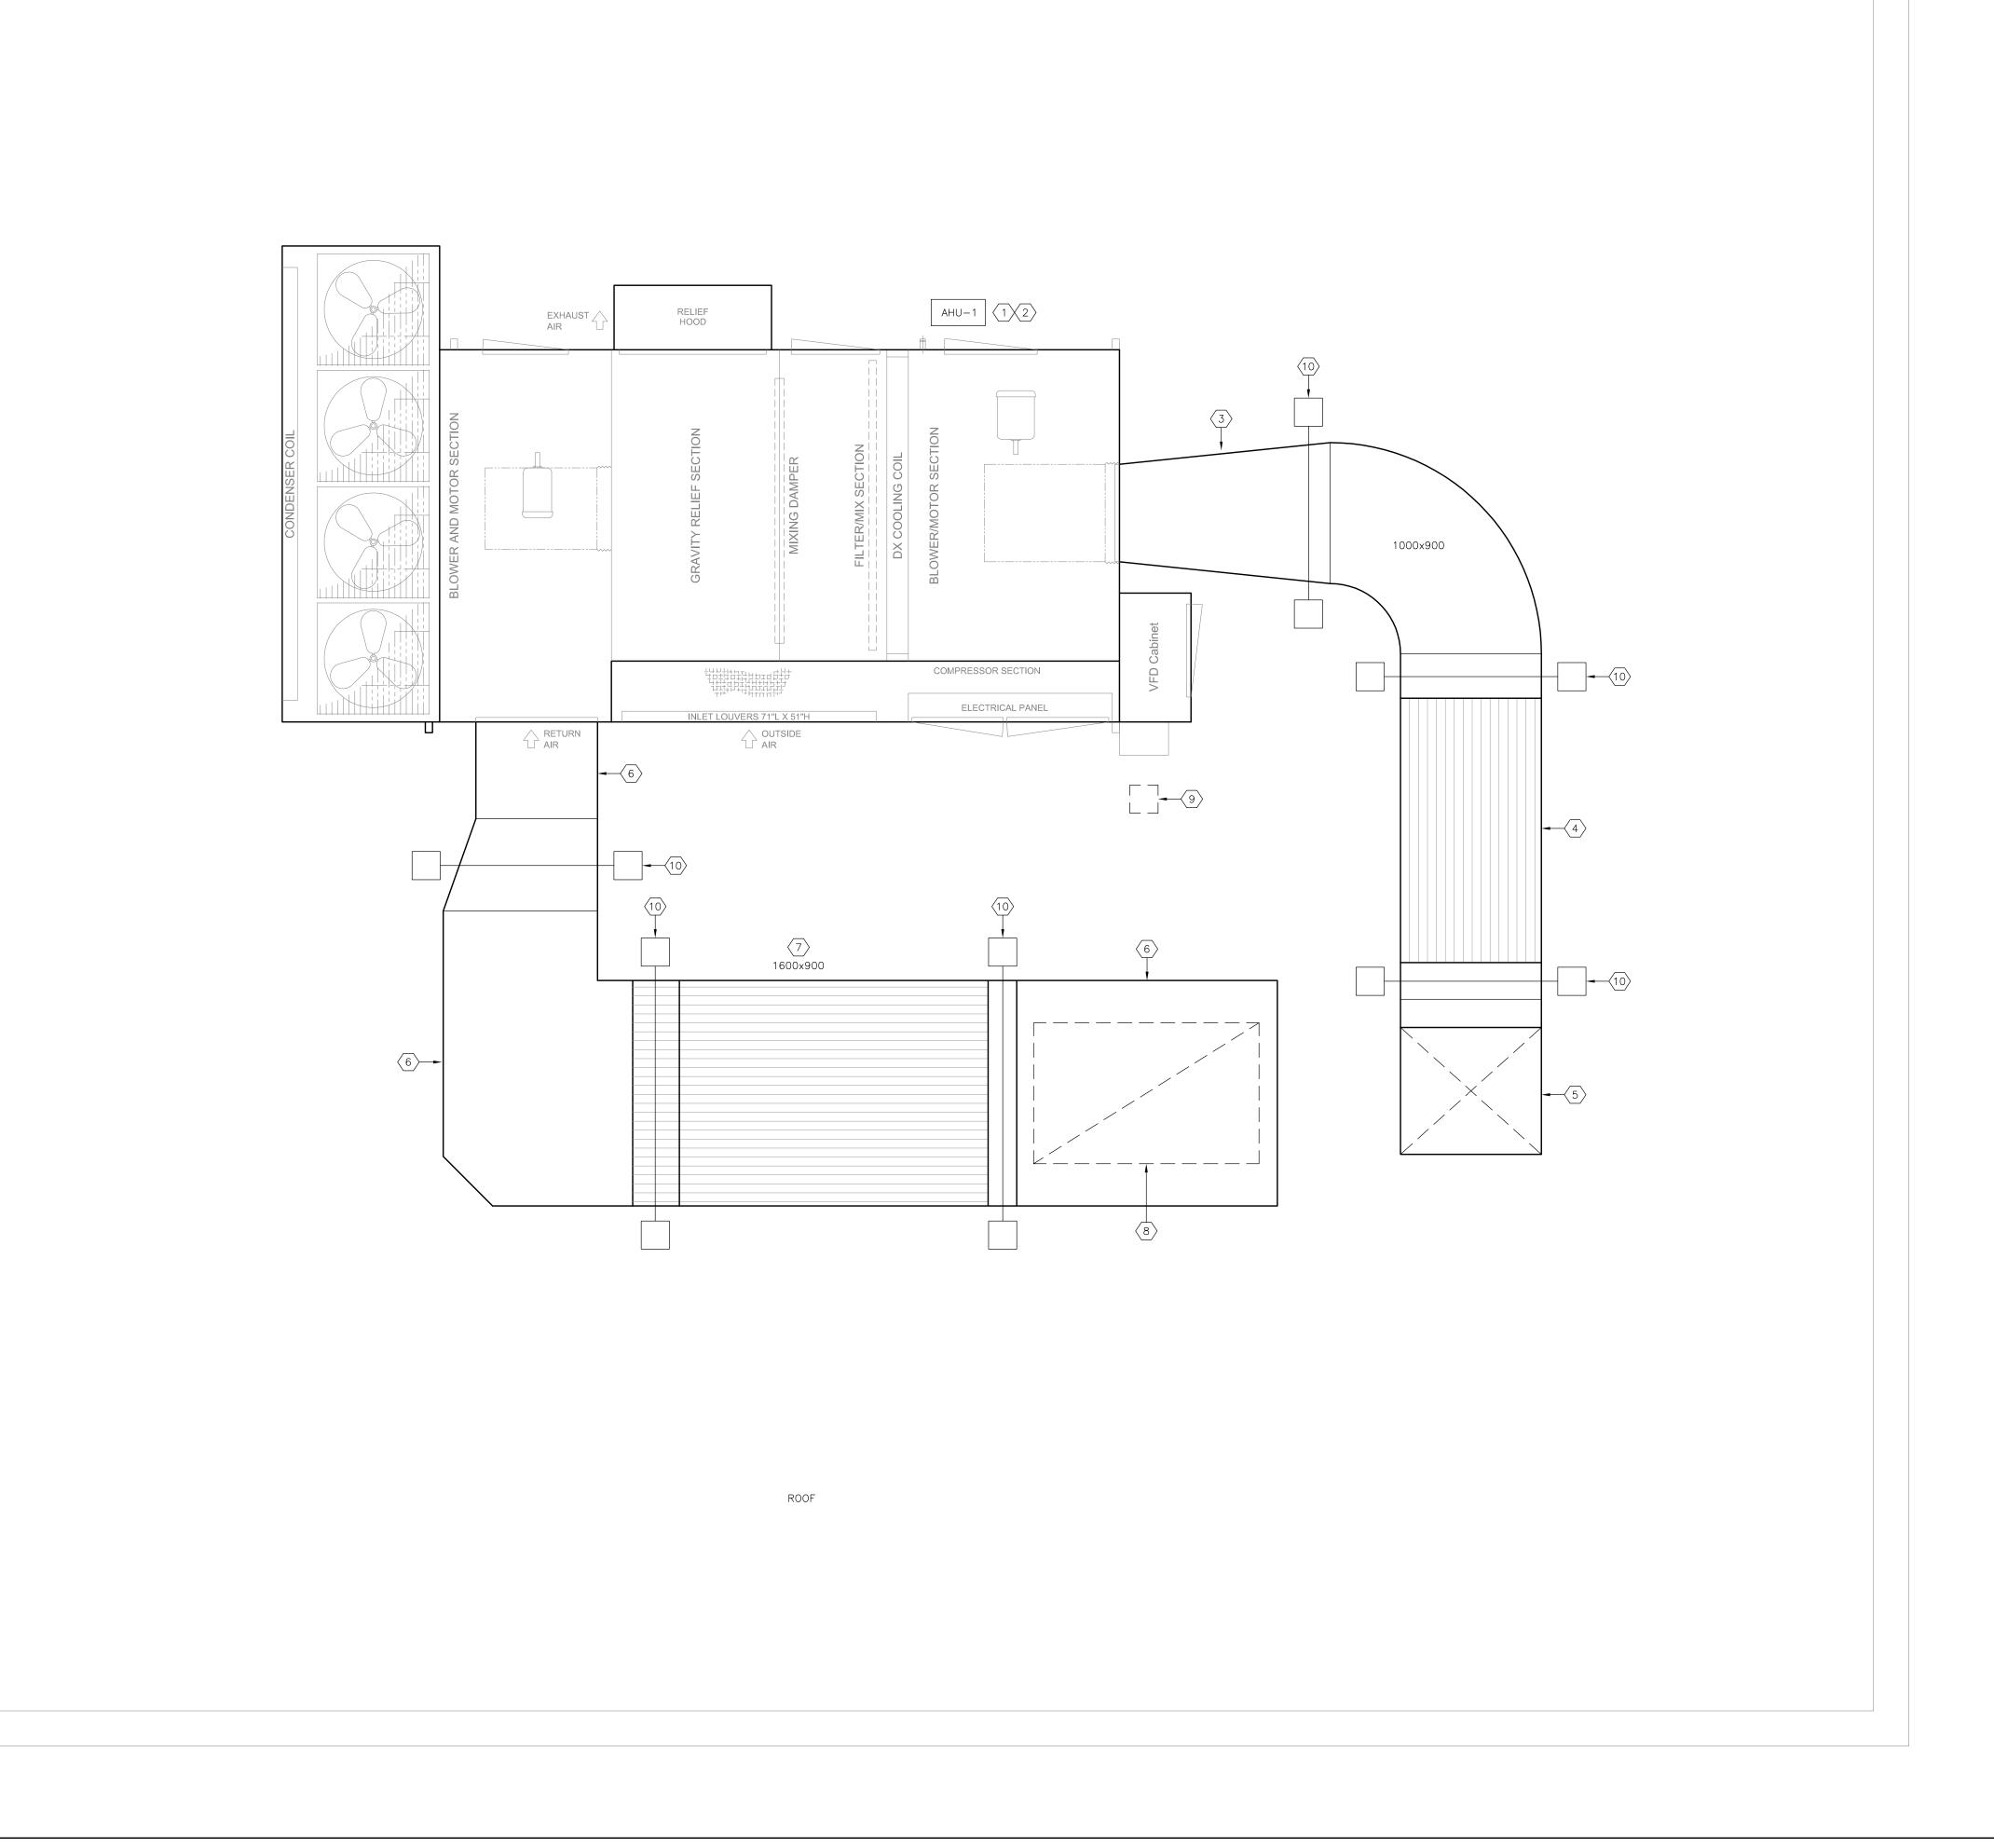

1 ROOF PART PLAN - NEW HVAC PLAN

M4 SCALE: 1:25

#### DRAWING NOTES:


- PROVIDE A NEW AIR HANDLING UNIT 'AHU-1' AS SCHEDULED ON THE EXISTING STEEL FRAME.
- 2 EXISTING STEEL BEAM FRAME SUPPORTING THE EXISTING AIR HANDLING UNIT IS TO REMAIN AS
- 3 PROVIDE NEW ROOFTOP SUPPLY AIR DUCTWORK AS SHOWN.
- $\overline{\langle}$  4 PROVIDE A NEW SUPPLY AIR SILENCER AS SHOWN.
- EXISTING 1000x900 SUPPLY AIR DUCT DN. THROUGH THE ROOF. PROVIDE NEW DUCTWORK UP TO WITHIN 6" OF THE ROOF PENETRATION AND DUCT ROOF CURB. DO NOT IMPACT THE EXISTING DUCT CURB WHATSOEVER. TRANSITION THE NEW DUCTWORK TO MATCH THE EXISTING DUCT SIZE PENETRATING THE ROOF.
- 6 PROVIDE NEW ROOFTOP RETURN AIR DUCTWORK AS SHOWN.
- $\overline{\langle 7 \rangle}$  provide a new return air silencer as shown.
- EXISTING 1600×1000 RETURN AIR DUCT DN. THROUGH THE ROOF. PROVIDE NEW DUCTWORK UP TO WITHIN 6" OF THE ROOF PENETRATION AND DUCT ROOF CURB. DO NOT IMPACT THE EXISTING DUCT CURB WHATSOEVER. TRANSITION THE NEW DUCTWORK TO MATCH THE EXISTING DUCT SIZE PENETRATING THE ROOF
- PROVIDE A NEW ROOFTOP DOGHOUSE AT THE AIR HANDLING UNIT LOCATION FOR ALL NEW ELECTRICAL AND CONTROLS CONDUITS. ALL ROOFING WORK SHALL BE COMPLETED BY THE ROOFING CONTRACTOR. THE MECHANICAL CONTRACTOR SHALL RETAIN THE SERVICES OF THE DESIGNATED ROOFING CONTRACTOR(S) FOR ALL ROOFING WORK. ALL COSTS OF THE ROOFING CONTRACTOR SHALL BE INCLUDED FOR IN THE BASE TENDER PRICE.
- PROVIDE NEW ROOFTOP NON-PENETRATING DUCT SUPPORTS. DUCT SUPPORTS SHALL BE CUSTOM FABRICATED TO SUIT THE NEW DUCTWORK DIMENSIONS AND ALL ELBOWS, OFFSETS, TRANSITIONS, ETC. EXTERNALLY INSULATE ALL DUCTWORK. SEE DRAWING M5 FOR DETAIL


## **GENERAL NOTES:**

CONTRACTORS SHALL VERIFY AND BE RESPONSIBLE FOR ALL DIMENSIONS AND CONDITIONS ON THE JOB AND THE ENGINEER SHALL BE INFORMED OF ANY VARIATIONS FROM THE DIMENSIONS AND CONDITIONS SHOWN ON THE DRAWINGS. DO NOT SCALE DRAWINGS. SHOP DRAWINGS SHALL BE SUBMITTED TO THE ENGINEER FOR APPROVAL BEFORE PROCEEDING WITH FABRICATION. THIS DRAWING IS THE PROPERTY OF SURI & ASSOCIATES LTD. AND SHALL NOT BE REPRODUCED WITHOUT THEIR PERMISSION AND UNLESS THE REPRODUCTION CARRIES THEIR NAME. ALL INFORMATION SHOWN ON THIS DRAWING IS FOR USE ON THE SPECIFIED PROJECT ONLY AND SHALL NOT BE USED OTHERWISE WITHOUT WRITTEN PERMISSION OF SURI & ASSOCIATES LTD.

2	ISSUED FOR TENDER	MAY 31/24
1	ISSUED FOR 100% DESIGN REVIEW	MAY 6/24
No.	REVISION	DATE

Contractors shall verify all dimensions at the job.

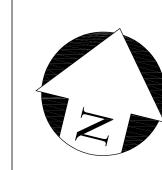

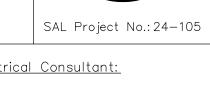

Mechanical & Electrical Consultant:

SURI & ASSOCIATES LTD. ENGINEERING CONSULTANTS

1018 ALBERTSON CRESCENT MISSISSAUGA, ONTARIO L5H 3C7 T (905)-290-7861 ELECTRICAL MECHANICAL LIGHTING COMMUNICATION SECURITY



Project


OAKRIDGE COMMUNITY
RECREATIONAL CENTRE
63 PHARMACY AVENUE,
TORONTO, ONTARIO. M1L 4S9


AIR HANDLING UNIT REPLACEMENT


Drawing Title


NEW MECHANICAL LAYOUT

Checked:	Date:
RS	MAY 2024
Drawn:	Scale:
RS	AS NOTED
File Number:	Dwg Number:
	M4

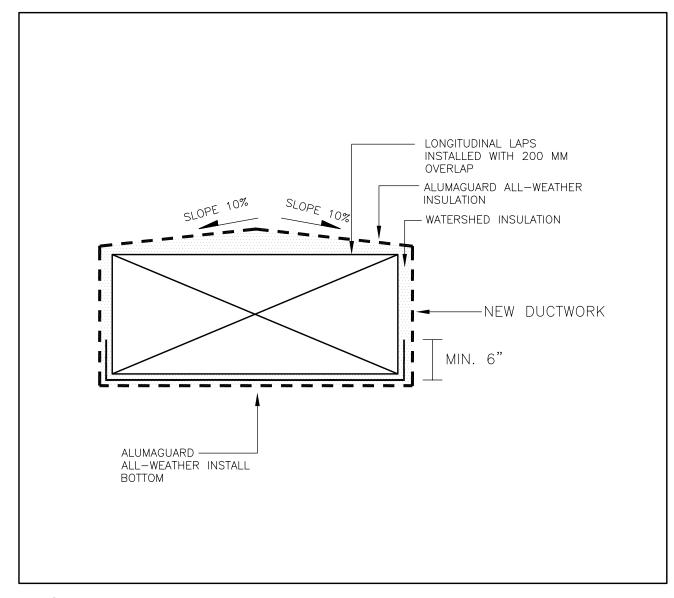

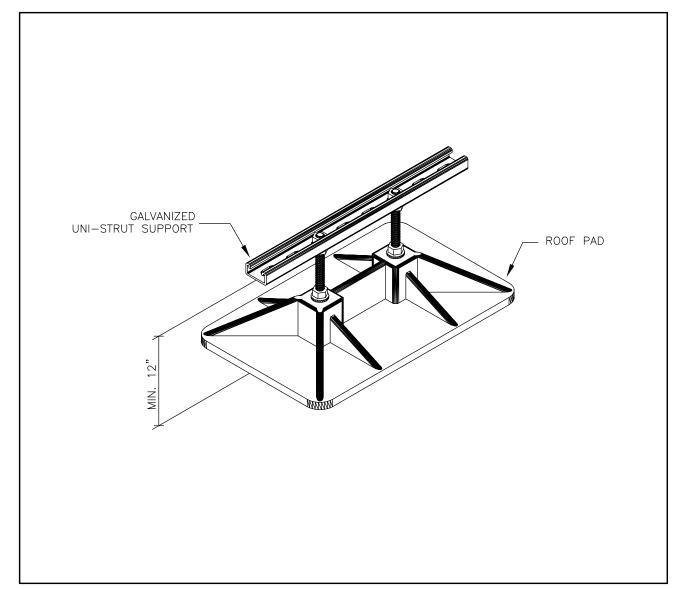

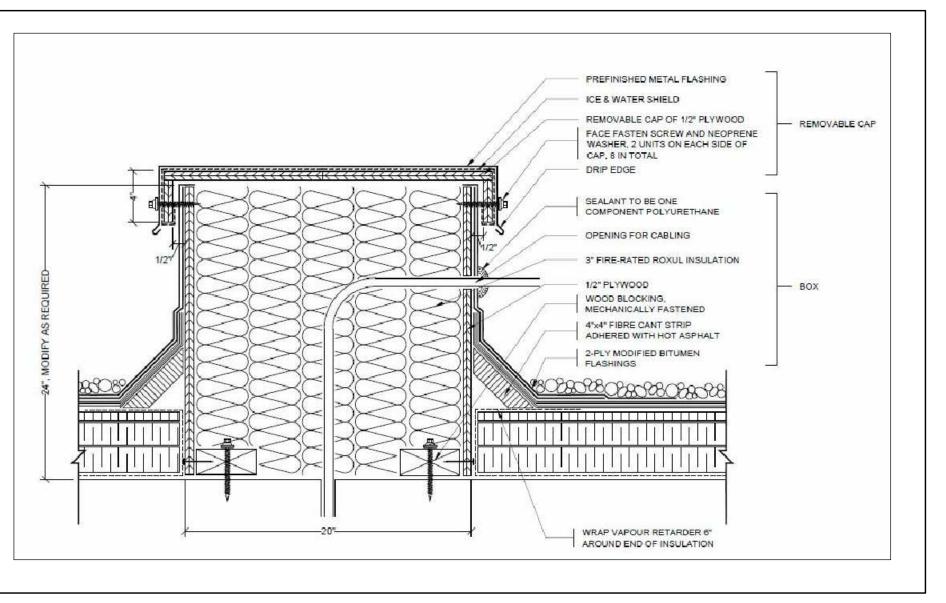

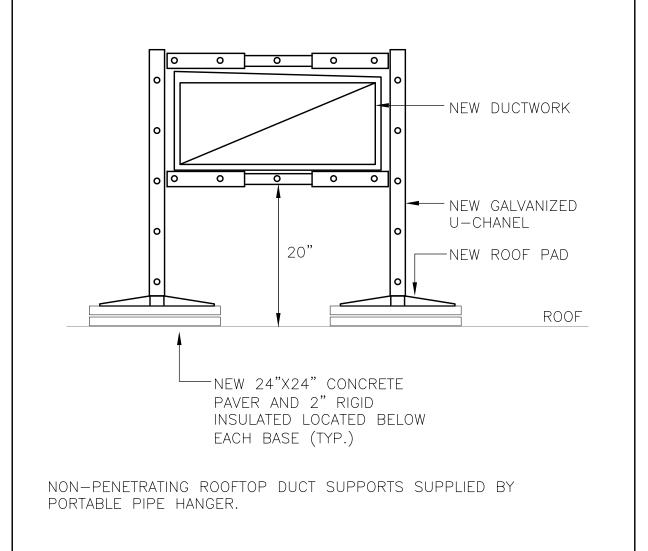

1 ROOFTOP DUCT INSTALL DETAIL
M5 SCALE: N.T.S.

ROOFTOP CONDUIT SUPPORT DETAIL

M5 SCALE: N.T.S.

ROOFTOP "DOGHOUSE" DETAIL FOR ROOF PENETRATIONS FOR CONDUITS M5 SCALE: N.T.S.

4 ROOFTOP DUCT SUPPORT DETAIL

CUSTOM AIR HANDLING UNIT SCHEDULE

EQUIPMENT	MANUEAGTURER	MODEL		SUPPLY	Y FAN		RETURN F	AN	MINIMUM		HEATING						COOLING			1404	MOOD WOLTAG	UNIT WEIGHT
EQUIPMENT DESIGNATION	MANUFACTURER	MODEL	CFM	E.S.P. (IN.WC) RP	M HP	VFD	CFM E.S.P. RPM	HP	VFD OUTDOOR AIR (CFM)	TYPE	INPUT (MBH)	OUTPUT (MBH)	TYPE	COOLING STAGES	TOTAL CAPACITY	SENSIBLE CAPACITY	EDBT/EWBT LDBT/LWBT	LEAVING COIL VELOCITY	COIL PRESSURE DROP	MCA	MOCP VOLTAGE	(LBS)
AHU-1	ENGINEERED AIR	FWE313/O/MV	11,500	1.00 -	10.0	YES	10,400 0.50 -	7.5	YES 2,300 (20.0%)	N/A	N/A	N/A	INTEGRAL DIRECT EXPANSION (DX)	3	388 MBH [113.7 KW]	283 MBH [82.9 KW]	80°F/67°F 57.2°F/ 56.4°F [26.7°C/ 19.4°C] 13.6°C/	537 FPM [2.73 M/S]	0.94 IN. W.C. [233.9 Pa]	183.6A	200A 208V/3ø/	7,900

#### NOTES:

1. RTU SHALL COME BASE CHANNEL TO SUIT THE EXISTING ROOFTOP STEEL STRUCTURE.

2. RTU SHALL COME C/W A 2" MERV 13 PRE-FILTER. NO POST-FILTER REQUIRED.
3. RTU SHALL BE CAPABLE OF FREE COOLING/ECONOMIZER MODE.

4. RTU SHALL COME C/W MOTORIZED MODULATING OUTDOOR AIR INTAKE, EXHAUST AIR AND MIXED AIR DAMPERS.

5. RTU SHALL COME C/W WEATHERPROOF, GFCI SERVICE RECEPTACLE, FACTORY INSTALLED, FIELD WIRED C/W WEATHERPROOF COVER.

6. RTU SHALL COME C/W UNFUSED, LOCAL DISCONNECT SWITCH MOUNTED ON THE UNIT.

7. RTIL SHALL COME C/W POWER OLITIET FOR THE GLOBAL PLASMA SOLUTION (GPS) IMOD MODULAR NEEDLEPOINT RIPOLAR IONIZATION AIR PURI

7. RTU SHALL COME C/W POWER OUTLET FOR THE GLOBAL PLASMA SOLUTION (GPS) IMOD MODULAR NEEDLEPOINT BIPOLAR IONIZATION AIR PURIFICATION SYSTEM.
8. RTU SHALL COME C/W THREE (3) DAMPER ACTUATORS.


6. RTO SHALL COME C/W THREE (3) DAMPER ACTUATORS.
9. THE MECHANICAL CONTRACTOR, AS A PART OF THE BASE TENDER PRICE, IS RESPONSIBLE SUPPLYING AND SITE INSTALLING THE GLOBAL PLASMA SOLUTION (GPS) IMOD MODULAR NEEDLEPOINT BIPOLAR IONIZATION AIR PURIFICATION SYSTEM (AS SUPPLIED BY APPLIED ENERGY SYSTEMS). INSTALL IN STRICT ACCORDANCE WITH THE MANUFACTURER'S INSTRUCTIONS.

CONTRACTORS SHALL VERIFY AND BE RESPONSIBLE FOR ALL DIMENSIONS AND CONDITIONS ON THE JOB AND THE ENGINEER SHALL BE INFORMED OF ANY VARIATIONS FROM THE DIMENSIONS AND CONDITIONS SHOWN ON THE DRAWINGS. DO NOT SCALE DRAWINGS. SHOP DRAWINGS SHALL BE SUBMITTED TO THE ENGINEER FOR APPROVAL BEFORE PROCEEDING WITH FABRICATION. THIS DRAWING IS THE PROPERTY OF SURI & ASSOCIATES LTD. AND SHALL NOT BE REPRODUCED WITHOUT THEIR PERMISSION AND UNLESS THE REPRODUCTION CARRIES THEIR NAME. ALL INFORMATION SHOWN ON THIS DRAWING IS FOR USE ON THE SPECIFIED PROJECT ONLY AND SHALL NOT BE USED OTHERWISE WITHOUT WRITTEN PERMISSION OF SURI & ASSOCIATES LTD.

**GENERAL NOTES:** 

2	ISSUED FOR TENDER	MAY 31/24
1	ISSUED FOR 100% DESIGN REVIEW	MAY 6/24
No.	REVISION	DATE

Contractors shall verify all dimensions at the job.

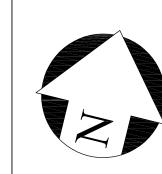



Mechanical & Electrical Consultant:

SURI & ASSOCIATES LTD. Engineering consultants

1018 ALBERTSON CRESCENT MISSISSAUGA, ONTARIO L5H 3C7

T (905)-290-7861

ELECTRICAL MECHANICAL LIGHTING COMMUNICATION SECURITY



Project

OAKRIDGE COMMUNITY
RECREATIONAL CENTRE
63 PHARMACY AVENUE,
TORONTO, ONTARIO. M1L 4S9

AIR HANDLING UNIT REPLACEMENT

Drawing Title

SCHEDULES & SCHEMATICS

Checked:	Date:
RS	MAY 2024
Drawn:	Scale:
RS	AS NOTED
File Number:	Dwg Number:

	LIGHTING LEGEND
A1	STANDARD TYPE 'A1' LIGHT FIXTURE AS SCHEDULED
//A1///	TYPE 'A1' LIGHT FIXTURE AS SCHEDULED, CONNECTED TO THE EMERGENCY POWER SOURCE (INVERTER OR GENERATOR)
□ B1	WALL-MOUNTED TYPE 'B1' LIGHT FIXTURE AS SCHEDULED
\$	LINE-VOLTAGE, TOGGLE LIGHT SWITCH.
\$D	LOW-VOLTAGE, TOGGLE & DIMMER LIGHT SWITCH, AS SPECIFIED.
\$K	LOW-VOLTAGE, KEY-SWITCH TYPE LIGHT SWITCH, AS SPECIFIED.
\$MS	LOW-VOLTAGE, KEY-SWITCH TYPE, MASTER LIGHT SWITCH, AS SPECIFIED. CONTROLS ALL CORRIDOR, WASHROOM AND VESTIBULE LIGHTING
\$os	LOW-VOLTAGE LIGHT SWITCH COMPLETE WITH INTEGRAL OCCUPANCY SENSOR, AS SPECIFIED.
OS	CORNER/WALL-MOUNTED, LOW-VOLTAGE OCCUPANCY SENSOR, AS SCHEDULED
OS	CEILING-MOUNTED, LOW-VOLTAGE OCCUPANCY SENSOR, AS SCHEDULED
ОН	EXTERIOR-GRADE, WALL-MOUNTED LIGHT FIXTURE
	EXTERIOR-GRADE, LIGHT STANDARD COMPLETE WITH CONCRETE BASE
<b>■</b> BU	EMERGENCY LIGHTING BATTERY UNIT C/W NO REMOTE HEADS
BU	EMERGENCY LIGHTING BATTERY UNIT C/W DUAL-HEAD REMOTE HEADS
•_•	EMERGENCY LIGHTING DUAL-HEAD REMOTE HEAD
$\overline{\square}$	EMERGENCY LIGHTING, WALL-MOUNTED EXIT SIGN
	EMERGENCY LIGHTING, CEILING-MOUNTED EXIT SIGN

	POWER DEVICES & EQUIPMENT LEGEND
Ф	SINGLE RECEPTACLE MOUNTED AT STANDARD HEIGHT; USE AND RATING FOR THE PURPOSE INTENDED
\$	SINGLE RECEPTACLE MOUNTED AT HIGH LEVEL; USE AND RATING FOR THE PURPOSE INTENDED
Ф	15A, 120V DUPLEX RECEPTACLE MOUNTED AT STANDARD HEIGHT. 'T' DENOTES 20A, T-SLOT TYPE RECEPTACLE
\$	15A, 120V DUPLEX RECEPTACLE MOUNTED AT HIGH LEVEL. 'T' DENOTES 20A, T-SLOT TYPE RECEPTACLE
<b>Ø</b>	15A, 120V, GFI DUPLEX RECEPTACLE MOUNTED AT HIGH LEVEL. 'T' DENOTES 20A, T—SLOT TYPE RECEPTACLE
	DIRECT POWER CONNECTION
	UNFUSED DISCONNECT SWITCH
	FUSED DISCONNECT SWITCH
	DIRECT POWER CONNECTION COMPLETE UNFUSED DISCONNECT SWITCH
	BLANK COVERPLATE COMPLETE WITH WIRING, CONDUIT, AND BACKBOX
J	ROUND JUNCTION BOX COMPLETE WITH COVERPLATE
J	SQUARE JUNCTION BOX COMPLETE WITH COVERPLATE
	RECESSED ELECTRICAL PANEL, AS SCHEDULED
	SURFACE-MOUNTED ELECTRICAL PANEL, AS SCHEDULED
CC-1	DEVICE/EQUIPMENT CONNECTED TO CIRCUIT #1 IN PANEL 'CC'

	COMMUNICATIONS (VOICE/DATA) LEGEND
$\nabla$	DATA OUTLET MOUNTED AT STANDARD HEIGHT ROUGH—IN
▼	TELEPHONE OUTLET MOUNTED AT STANDARD HEIGHT ROUGH-IN
$\forall$	DATA OUTLET MOUNTED AT HIGH LEVEL ROUGH—IN
₩	TELEPHONE OUTLET MOUNTED AT HIGH LEVEL ROUGH—IN
WAP	WIRELESS ACCESS POINT COMPLETE WITH CATEGORY 6, FT6 CABLING TO THE HUB RACK
<b>A</b>	TELEPHONE & DATA OUTLET

DRAWING LIST				
DRAWING NUMBER	DESCRIPTION			
E1	ELECTRICAL LEGEND AND NOTES			
E2	KEY PLAN			
E3	EXISTING ELECTRICAL LAYOUT			
E4	NEW ELECTRICAL LAYOUT			

	SYSTEMS DEVICE & EQUIPMENT LEGEND
	MODULAR CONTROL PANEL, SUPPLIED AND INSTALLED BY DIVISION 26
•	DOOR OPERATOR ACTUATOR BUTTON
KS	KEY SWITCH, TIED TO THE DOOR OPERATOR SYSTEM
HD	HAND DRYER, SUPPLIED AND INSTALLED BY DIVISION 26
PL	PUSH-TO-LOCK BUTTON TIED TO THE WASHROOM DOOR OPERATOR SYSTEM
()H	'OCCUPIED-WHEN-LIT' LED ANNUNCIATOR TIED TO THE WASHROOM DOOR OPERATOR SYSTEM
EH	VISUAL INDICATOR TIED TO THE CALL-FOR-ASSISTANCE SYSTEM
E	EMERGENCY PUSH-BUTTON TIED TO THE CALL-FOR-ASSISTANCE SYSTEM
X	AUDIBLE/VISUAL INDICATOR

	FIRE ALARM SYSTEM LEGEND
	RATE-OF-RISE HEAT DETECTOR
<b>&gt;</b>	FIXED TEMPERATURE HEAT DETECTOR
•	SMOKE DETECTOR
	PULL STATION C/W TAMPERPROOF, POLYCARBONATE COVER
	FIRE ALARM BELL
	FIRE ALARM HORN/STROBE
S	FIRE ALARM SPEAKER
TL	REMOTE TROUBLE INDICATOR
FS	SPRINKLER/STANDPIPE FLOW SWITCH
SV	SPRINKLER/STANDPIPE SUPERVISED VALVE
	FIRE ALARM ANNUNCIATOR
	FIRE ALARM CONTROL PANEL

	ACCESS CONTROL SYSTEM LEGEND
DB	DOOR BELL
ES	ELECTRIC STRIKE
MS	AIPHONE MASTER STATION
SMS	AIPHONE SUB-MASTER STATION
KP	ALARM KEYPAD
СН	DOOR BELL CHIME
)Ú	AUDIBLE/VISUAL ANNUNCIATOR TIED TO THE LOCAL DOOR ALARM SYSTEM

# GENERAL NOTES

- 1. IT IS MANDATORY FOR THE ELECTRICAL CONTRACTOR TO VISIT SITE AND REVIEW EXISTING CONDITIONS AND DEMOLITION SCOPE OF WORK TO SUIT EXISTING ARCHITECTURAL AND STRUCTURAL CONDITIONS AND MECHANICAL DRAWINGS. NO EXTRA WILL SUBSEQUENTLY BE ALLOWED TO COVER ANY SUCH ERROR, OMISSION AND/OR OVERSIGHT FOR NOT HAVING MADE A THOROUGH INSPECTION OF THE GROUNDS, EXISTING CONDITIONS, DRAWINGS, SPECIFICATION AND DESIGN INTENT. THE ELECTRICAL CONTRACTOR SHALL NOTE THAT THE EXISTING BUILDING WILL REMAIN IN OPERATION THROUGHOUT DEMOLITION/CONSTRUCTION. ALLOW FOR ANY WORK REQUIRED TO BE DONE WHICH MAY AFFECT POWER SUPPLY AND OPERATION OF THE BUILDING TO BE CARRIED OUT AFTER HOURS OR AT A TIME CONVENIENT TO THE BUILDING MANAGEMENT. PROVIDE TEMPORARY SERVICES AS REQUIRED TO ENSURE CONTINUED OPERATION AT ALL TIMES
- 2. CAREFULLY EXAMINE OTHER EXISTING UTILITY LINES SUCH AS GAS, WATER ETC. PRIOR TO START THE ELECTRICAL CONSTRUCTION WORKS AND COORDINATE WITH OTHER TRADES AND REPORT OF ANY DISCREPANCY PRIOR TO PROCEEDING.
- THESE DRAWINGS SHALL BE READ & PRICED IN CONJUNCTION WITH ARCHITECTURAL, MECHANICAL, AND AV DRAWINGS AND SPECIFICATIONS. INCLUDE FOR THE SUPPLY AND INSTALLATION OF POWER, SYSTEMS, AND LIGHTING AS PER THE COMPLETE CONSTRUCTION DOCUMENTS. NO EXTRA COST WILL BE ACCEPTED IN FAILURE TO OBTAINING AND/OR REVIEW OF SUCH DOCUMENTS. REFER TO ARCHITECTURAL, AV, ELECTRICAL, AND MECHANICAL LAYOUTS IN CONJUNCTION FOR EXACT LOCATION OF ALL EQUIPMENT. REPORT ANY DISCREPANCIES TO THE ELECTRICAL ENGINEER PRIOR TO COMMENCING WORK. NO EXTRA WILL BE PROVIDED AS A RESULT OF A FAILURE TO DO SO.
- H. IT IS MANDATORY THAT ELECTRICAL WORK CONFORM TO ALL APPLICABLE CODES (INCLUDING ONTARIO BUILDING, FIRE, AND ELECTRICAL SAFETY CODE), BASE BUILDING STANDARDS, AND THE STANDARDS SET BY ANY AND ALL LOCAL AUTHORITIES HAVING JURISDICTION.
- 5. LOCATIONS OF ALL NEW DISCONNECT SWITCHES AND STARTERS SHALL BE CONFIRMED WITH DIVISION 15 PRIOR TO INSTALLATION. STARTERS FOR EXHAUST FANS SHALL BE SUPPLIED AND INSTALLED BY DIV. 16.
- ALL ELECTRICAL WORK SHALL BE INSPECTED BY THE ELECTRICAL SAFETY AUTHORITY (ESA).

  CONTRACTOR IS RESPONSIBLE FOR HIRING A FIRE WATCH AS REQUIRED BY CODE, LOCAL AUTHORITIES HAVING JURISDICTION, OR AS MANDATED BY THE PROPERTY MANAGER DURING ANY ALTERATION OR DOWNTIME OF THE FIRE ALARM SYSTEM.
- 8. CONTRACTOR MUST REVIEW CITY OF TORONTO STANDARDS AND PRIOR TO PRICING. ALL CONSTRUCTION MUST ABIDE BY CITY OF TORONTO STANDARDS. INCLUDE FOR ANY SUCH ITEMS MANDATED BY THE CITY IN THE TENDER PRICING.

# MECHANICAL FOUIPMENT WIRING SCHEDULE

WEST MINOR E EQUIT WEITH WHITHOUT SOTTED SEE										
EQUIPMENT DESCRIPTION	STARTER LOCATION	STARTER TYPE	MCA/HP/KW	VOLTS/PH./ FREQUENCY	BREAKER SIZE OR FUSE SIZE	FEEDER SIZE	PANEL AND CCT. NOS.	REMARKS	FIRE ALARM FAN SHUTDOWN [AHU/EF ONLY]	TIED TO BAS SYSTEM?
AIR HANDLING UNIT 'AHU-1'	INTEGRAL	INTEGRAL	MCA: 183.6A	208V/3PH/60Hz	200A-3P	3-250MCM RW90+G IN 63mmC	MAIN DISTRIBUTION PANEL	ELECTRICAL DIVISION SHALL PROVIDE POWER CONNECTION TO THE AIR HANDLING UNIT. PROVIDE A LOCAL DISCONNECT SWITCH.	YES	NO

- 1. PROVIDE POWER CONNECTION TO ALL MECHANICAL EQUIPMENT LISTED IN THE SCHEDULE FOR A FULL OPERATIONAL SYSTEM. REFER TO MECHANICAL LAYOUTS AND SCHEDULES FOR EXACT LOCATION OF EQUIPMENT. PROVIDE SEPARATE BREAKER FOR INDIVIDUAL MECHANICAL EQUIPMENT. SIZE AS INDICATED IN THE SCHEDULE.
- 2. PROVIDE A LOCAL DISCONNECT SWITCH FOR ALL MECHANICAL EQUIPMENT IN THIS SCHEDULE, UNLESS IT IS NOTED THAT THE DISCONNECT SWITCH IS TO BE PROVIDED BY THE EQUIPMENT MANUFACTURER. DISCONNECT SWITCH SHALL BE SEPARATE FROM THE STARTER SERVING THE RESPECTIVE EQUIPMENT. NOTE THAT DISCONNECT SWITCHES ARE NOT ILLUSTRATED ON THE FLOOR PLAN (FOR CLARITY), HOWEVER MUST BE SUPPLIED AND INSTALLED BY DIVISION 26 FOR ALL MECHANICAL EQUIPMENT LISTED IN THE ABOVE SCHEDULE.
- 3. THE ELECTRICAL CONTRACTOR WILL BE RESPONSIBLE FOR REVIEWING ALL MECHANICAL SHOP DRAWINGS WITH RESPECT TO RELEVANT ELECTRICAL INFORMATION PRIOR TO THE SHOP DRAWINGS BEING SUBMITTED TO THE MECHANICAL AND ELECTRICAL ENGINEER FOR REVIEW. NO EQUIPMENT SHALL BE ORDERED PRIOR TO SUBMITTING SHOP DRAWINGS AND RECEIVING SHOP DRAWINGS BACK APPROVED BY BOTH THE MECHANICAL ENGINEER. THE ELECTRICAL CONTRACTOR IS RESPONSIBLE FOR WORKING WITH EACH MANUFACTURER OR MECHANICAL EQUIPMENT AND GATHERING THE 'MCA' AND 'MOP' OF ALL EQUIPMENT AND LISTING IT ON THE SHOP DRAWING FOR EACH MECHANICAL EQUIPMENT PRIOR TO SUBMITTING SHOP DRAWINGS FOR REVIEW.
- 4. WHERE NOTED THAT AN AIR HANDLING UNIT/EXHAUST FAN IS TO HAVE FIRE ALARM FAN SHUTDOWN, PROVIDE THE NECESSARY WIRING, CONDUIT AND RELAYS TO TIE THE EQUIPMENT TO THE FIRE ALARM SYSTEM FOR SHUTDOWN ON A GENERAL ALARM.
- 5. PROVIDE VFD RATED CABLES FROM THE VFD TO THE MOTOR

SECURITY SYSTEM LEGEND

CLOCK SYSTEM LEGEND

ANALOG CLOCK, BATTERY OPERATED - WALL-MOUNTED

AUDIO/VISUAL SYSTEM LEGEND

GENERAL

DENOTES DEVICE/EQUIPMENT EQUIPPED WITH A WIREGUARD

DENOTES DEVICE/EQUIPMENT TO BE RELOCATED

DENOTES DEVICE/EQUIPMENT TO REMOVED C/W ALL REDUNDANT

DENOTES RELOCATED POSITION OF AN EXISTING DEVICE/EQUIPMENT

DENOTES EXISTING DEVICE/EQUIPMENT TO BE REPLACED WITH NEW

ACRONYM LEGEND

DENOTES EXISTING DEVICE OR EQUIPMENT TO BE RELOCATED DENOTE EXISTING DEVICE OR EQUIPMENT TO REMAIN

DENOTES EXISTING DEVICE OR EQUIPMENT TO BE REMOVED

DENOTES EXISTING DEVICE OR EQUIPMENT TO BE REPLACED

DENOTES RELOCATED POSITION OF AN EXISTING DEVICE OR EQUIPMENT

DENOTE DEVICE OR EQUIPMENT WITH GFI PROTECTION DENOTES DEVICE OR EQUIPMENT AT HIGH LEVEL

DENOTES NEW DEVICE OR EQUIPMENT DENOTES NIGHT LIGHT FIXTURE

DENOTES ROOFTOP DEVICE OR EQUIPMENT

DENOTES TAMPERPROOF DEVICE OR EQUIPMENT
DENOTES DEVICE OR EQUIPMENT WITH A WIREGUARD
DENOTES WEATHERPROOF TYPE DEVICE OR EQUIPMENT

MASTER CLOCK SYSTEM CONTROLLER

WIRING/RACEWAYS

ABOVE FINISHED FLOOR CONNECT TO EXISTING

T-SLOT, 20A, DEVICE

ANALOG CLOCK, 120V PLUG-IN TYPE COMPLETE WITH SINGLE RECEPTACLE

ANALOG CLOCK, 120V PLUG-IN TYPE COMPLETE WITH SINGLE RECEPTACLE

ANALOG CLOCK TIED TO THE MASTER CLOCK SYSTEM - WALL-MOUNTED

DUAL-FACE ANALOG CLOCK TIED TO THE MASTER CLOCK SYSTEM -

DUAL-FACE ANALOG CLOCK, BATTERY OPERATED - WALL-MOUNTED

EMPTY BACKBOX COMPLETE WITH BLANK COVERPLATE AND 25mmC UP TO

DENOTES NEW DEVICE/EQUIPMENT C/W NEW WIRING AND NEW RACEWAYS

THE ACCESSIBLE CEILING SPACE PROVISION FOR FUTURE AV CABLING

MOTION DETECTOR

ELECTRIC STRIKE

CAMERA

**-**()-

**→** MC '

₿во

**-**⊕-B0

ER

<u>ACRONYM</u> <u>DESCRIPTION</u>


INTRUSION ALARM SYSTEM KEY PAD


#### GENERAL NOTES:

CONTRACTORS SHALL VERIFY AND BE RESPONSIBLE FOR ALL DIMENSIONS AND CONDITIONS ON THE JOB AND THE ENGINEER SHALL BE INFORMED OF ANY VARIATIONS FROM THE DIMENSIONS AND CONDITIONS SHOWN ON THE DRAWINGS. DO NOT SCALE DRAWINGS. SHOP DRAWINGS SHALL BE SUBMITTED TO THE ENGINEER FOR APPROVAL BEFORE PROCEEDING WITH FABRICATION. THIS DRAWING IS THE PROPERTY OF SURI & ASSOCIATES LTD. AND SHALL NOT BE REPRODUCED WITHOUT THEIR PERMISSION AND UNLESS THE REPRODUCTION CARRIES THEIR NAME. ALL INFORMATION SHOWN ON THIS DRAWING IS FOR USE ON THE SPECIFIED PROJECT ONLY AND SHALL NOT BE USED OTHERWISE WITHOUT WRITTEN PERMISSION OF SURI & ASSOCIATES LTD.

2	ISSUED FOR TENDER	MAY 31/24
1	ISSUED FOR 100% DESIGN REVIEW	MAY 6/24
No.	REVISION	DATE

Contractors shall verify all dimensions at the job.

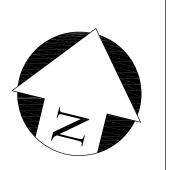

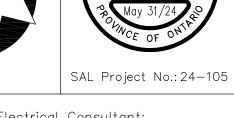

Mechanical & Electrical Consultant:

SURI & ASSOCIATES LTD.

ENGINEERING CONSULTANTS

1018 ALBERTSON CRESCENT MISSISSAUGA, ONTARIO L5H 3C7 T (905)-290-7861 ELECTRICAL MECHANICAL LIGHTING COMMUNICATION SECURITY



Project


OAKRIDGE COMMUNITY
RECREATIONAL CENTRE
63 PHARMACY AVENUE,
TORONTO, ONTARIO. M1L 4S9

AIR HANDLING UNIT REPLACEMENT

Drawing Title

ELECTRICAL LEGEND AND NOTES

Checked:	Date:
RS	MAY 2024
Drawn:	Scale:
RS	AS NOTED
File Number:	Dwg Number:
	E1

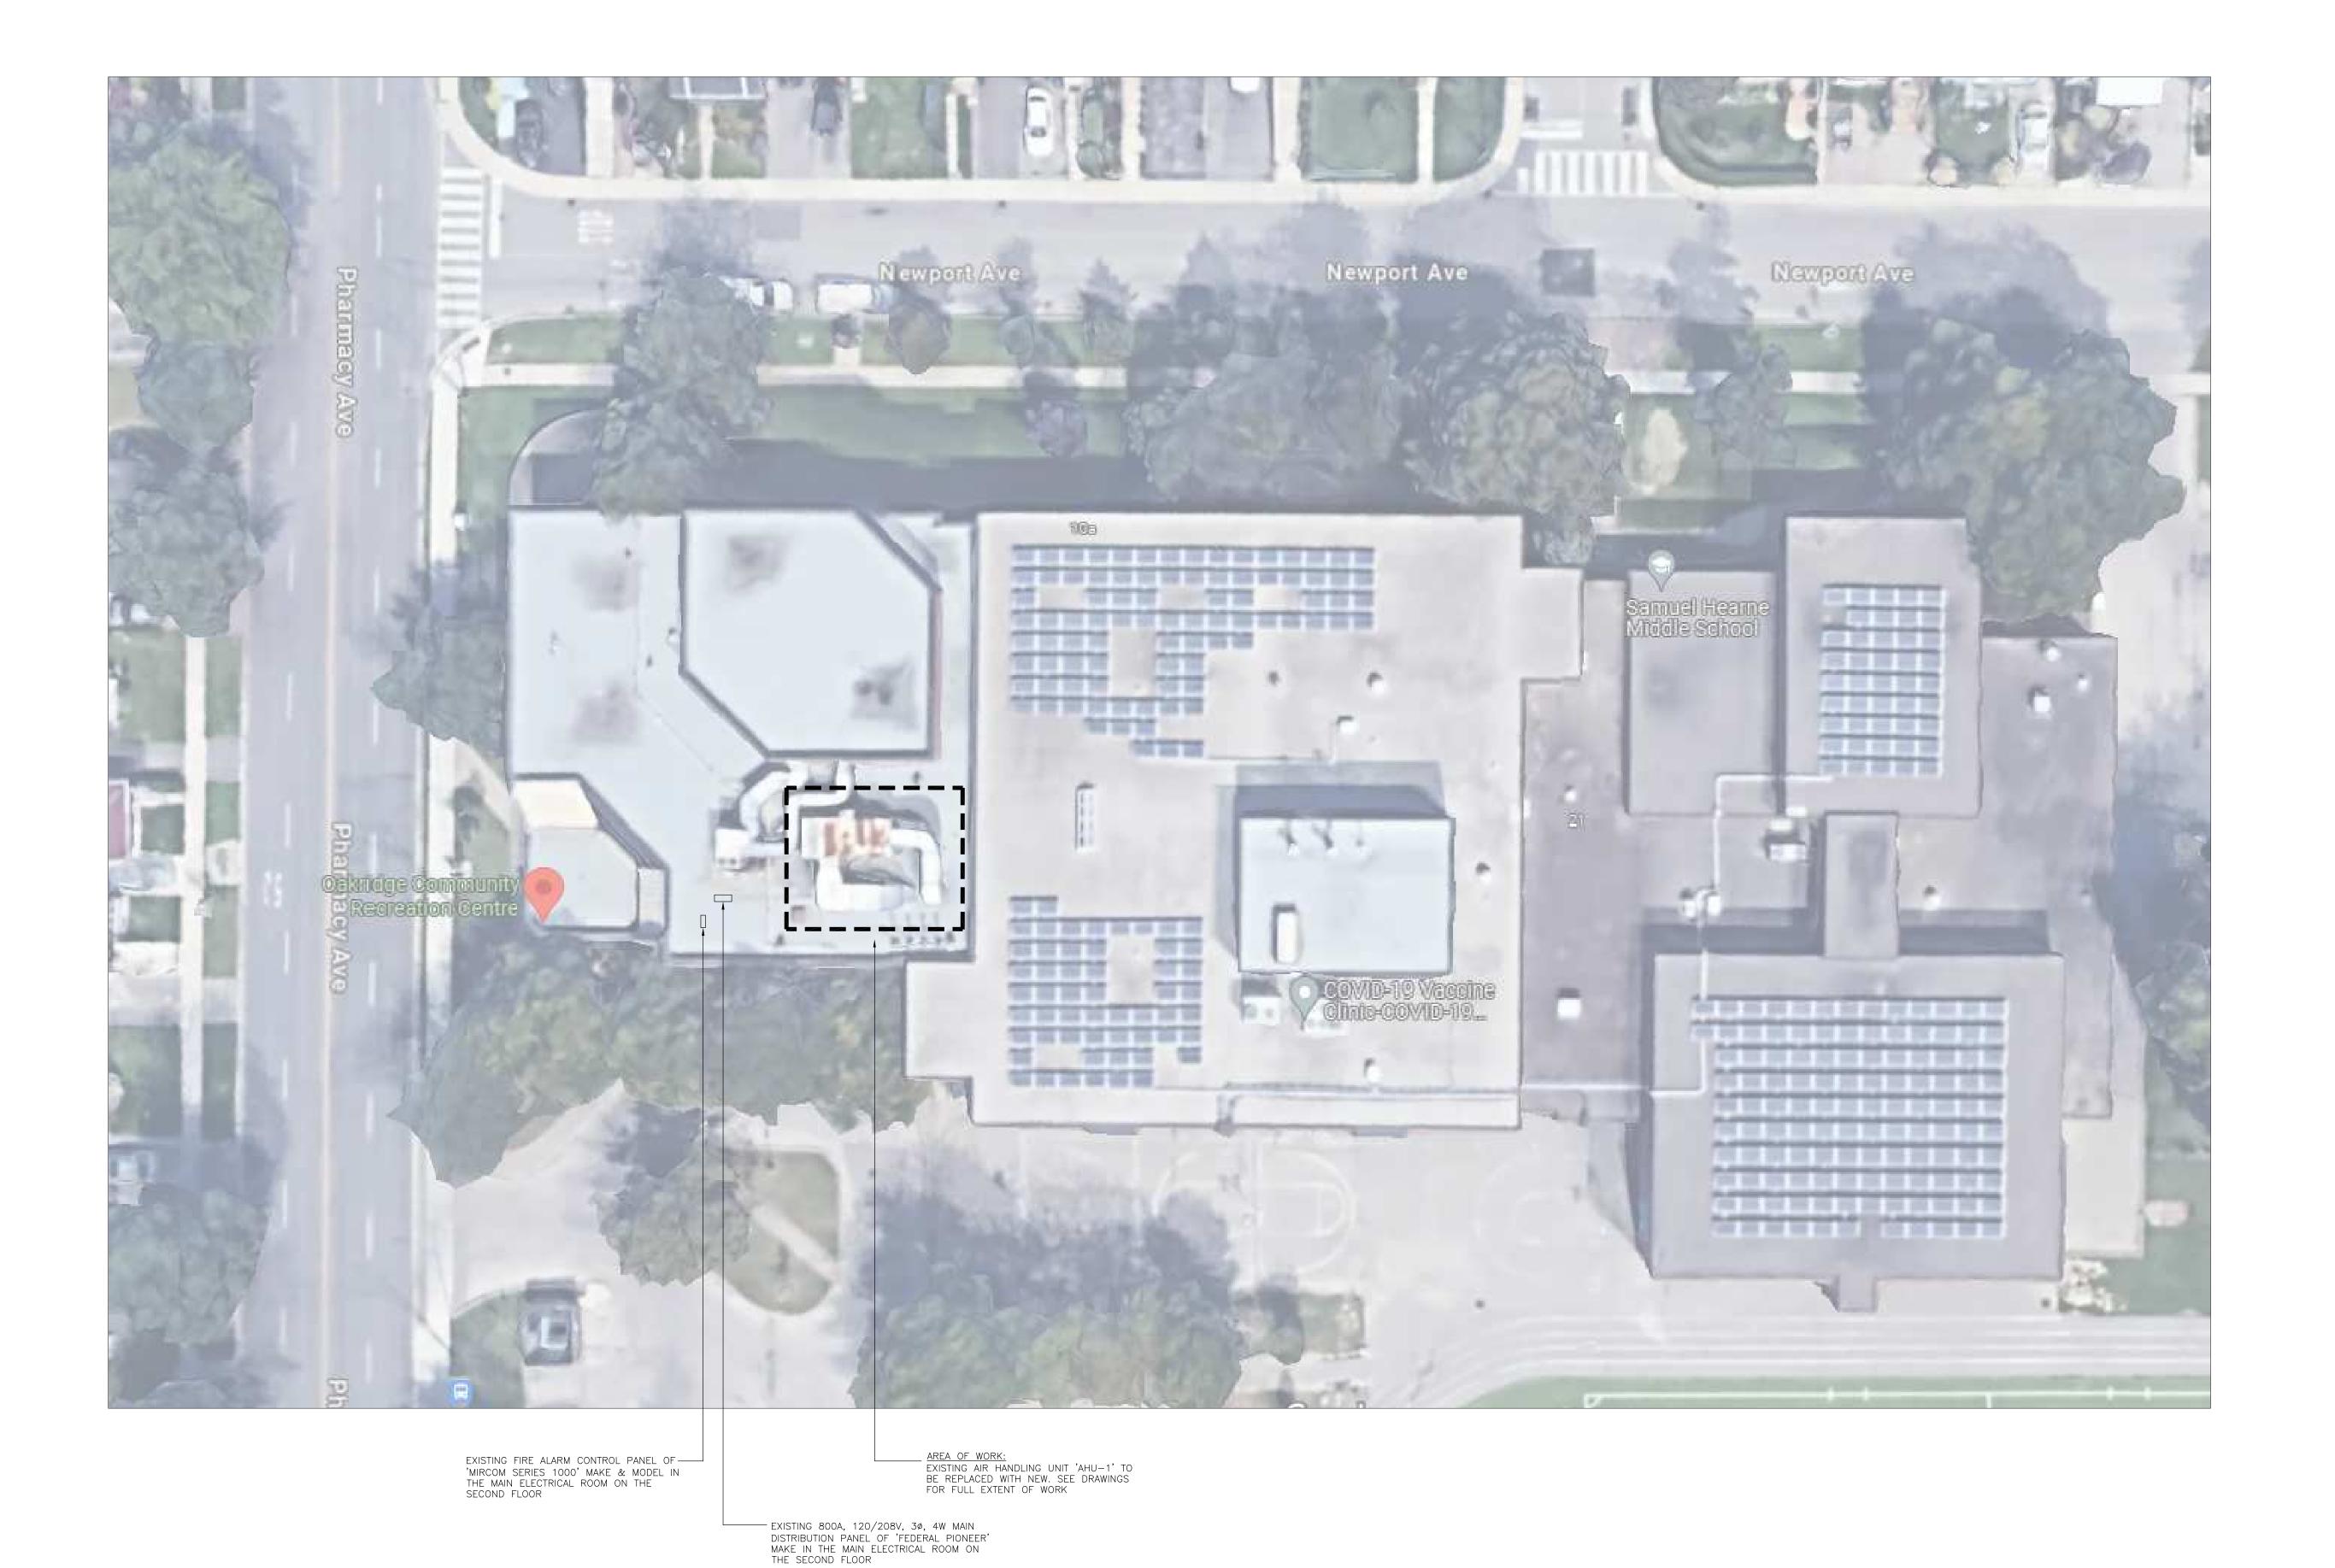

GENERAL NOTES:

CONTRACTORS SHALL VERIFY AND BE RESPONSIBLE FOR ALL DIMENSIONS AND CONDITIONS ON THE JOB AND THE ENGINEER SHALL BE INFORMED OF ANY VARIATIONS FROM THE DIMENSIONS AND CONDITIONS SHOWN ON THE DRAWINGS. DO NOT SCALE DRAWINGS. SHOP DRAWINGS SHALL BE SUBMITTED TO THE ENGINEER FOR APPROVAL BEFORE PROCEEDING WITH FABRICATION. THIS DRAWING IS THE PROPERTY OF SURI & ASSOCIATES LTD. AND SHALL NOT BE REPRODUCED WITHOUT THEIR PERMISSION AND UNLESS THE REPRODUCTION CARRIES THEIR NAME. ALL INFORMATION SHOWN ON THIS DRAWING IS FOR USE ON THE SPECIFIED PROJECT ONLY AND SHALL NOT BE USED OTHERWISE WITHOUT WRITTEN PERMISSION OF SURI & ASSOCIATES LTD.

2	ISSUED FOR TENDER	MAY 31/24
1	ISSUED FOR 100% DESIGN REVIEW	MAY 6/24
No.	REVISION	DATE





Mechanical & Electrical Consultant:

SURI & ASSOCIATES LTD.

ENGINEERING CONSULTANTS

1018 ALBERTSON CRESCENT MISSISSAUGA, ONTARIO L5H 3C7 T (905)-290-7861 ELECTRICAL MECHANICAL LIGHTING COMMUNICATION SECURITY




Project

OAKRIDGE COMMUNITY
RECREATIONAL CENTRE
63 PHARMACY AVENUE,
TORONTO, ONTARIO. M1L 4S9

AIR HANDLING UNIT REPLACEMENT

Drawing Title
KEY PLAN

Checked:	Date:
RS	MAY 2024
Drawn:	Scale:
RS	AS NOTED
File Number:	Dwg Number:
	E2

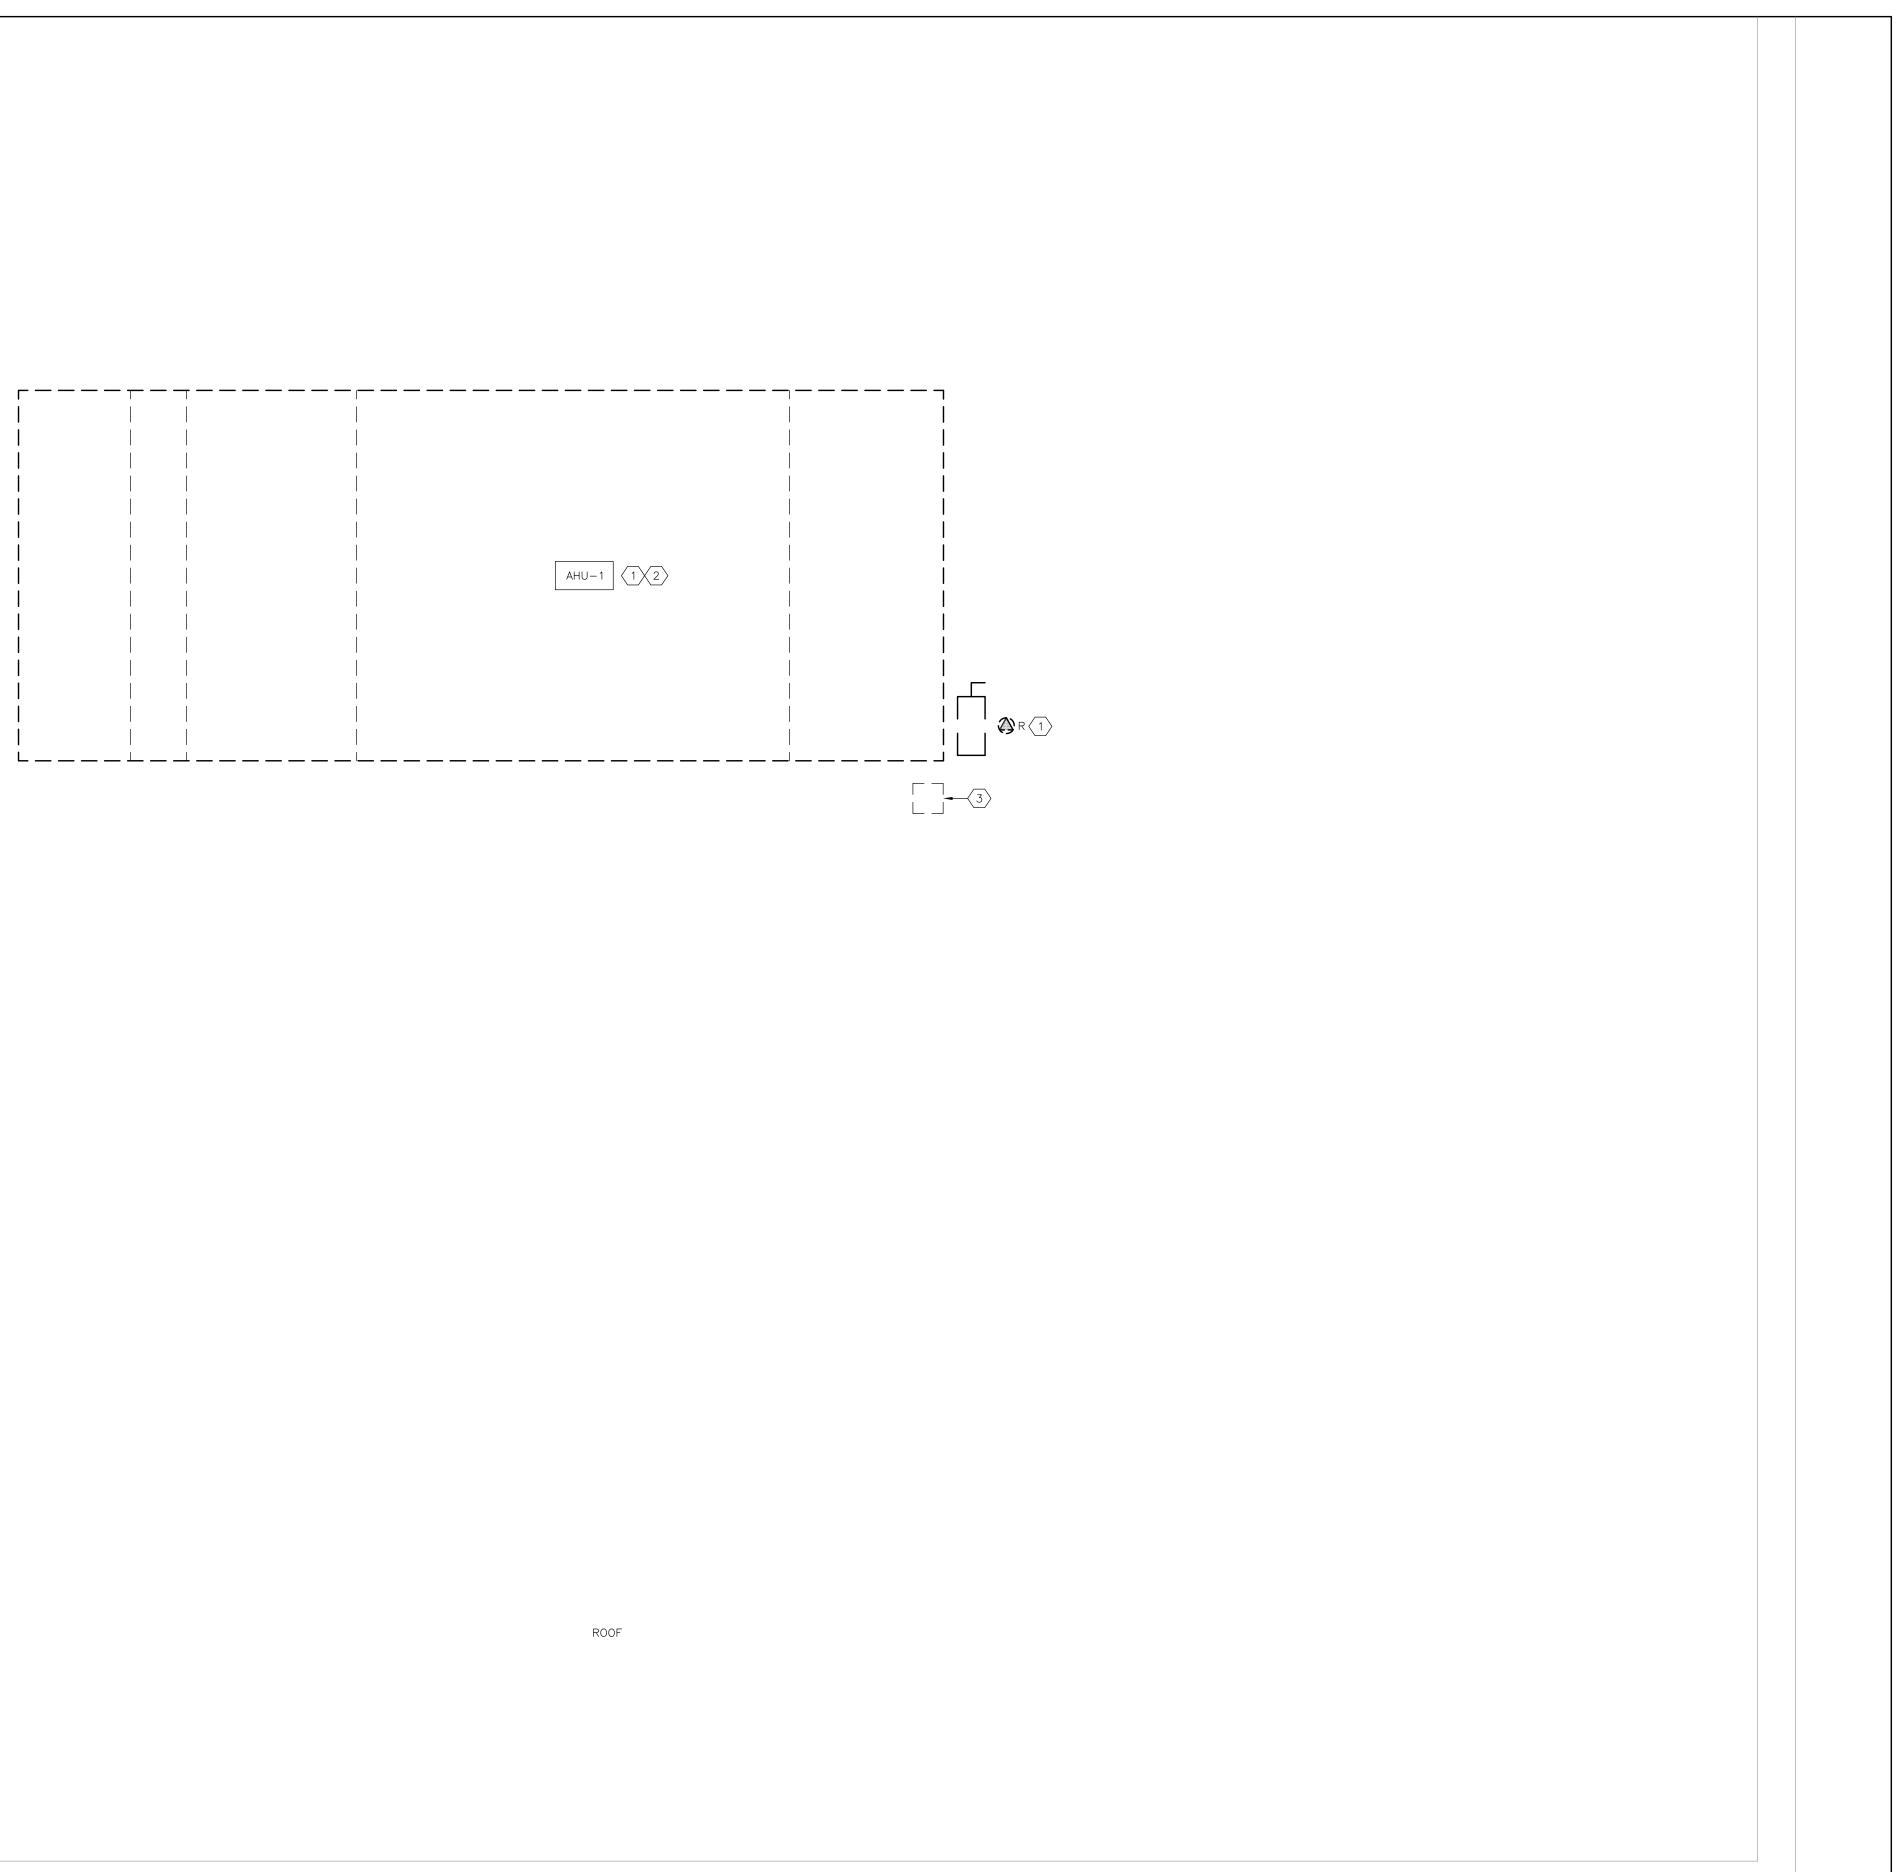

1 ROOF PART PLAN - EXISTING/DEMOLITION ELECTRICAL PLAN

E3 SCALE: 1:25

DRAWING NOTES:

- REMOVE POWER CONNECTION TO THE EXISTING AIR HANDLING UNIT. TRACE AND VERIFY THE EXISTING POWER SOURCE SERVING THE AIR HANDLING UNIT. REMOVE ALL ASSOCIATED REDUNDANT WIRING/RACEWAYS TO THE RESPECTIVE SOURCE. REMOVE AND DISPOSE OF THE EXISTING EQUIPMENT—MOUNTED LOCAL DISCONNECT SWITCH. REMOVE THE ASSOCIATED BREAKER/SWITCH IN THE EXISTING SOURCE PANEL AND PROVIDE BLANK BREAKER COVERS IN THE RESPECTIVE EXISTING PANEL. REDUNDANT ROOF OPENING/CONE SHALL BE REPAIRED BY THE ROOFING CONTRACTOR. PROVIDE A NEW PRINTED PANEL DIRECTORY.
- REMOVE ANY EXISTING FIRE ALARM SHUT-DOWN WIRING TO THE EXISTING AIR HANDLING UNIT IN ENTIRETY. REMOVE ALL REDUNDANT WIRING RACEWAYS.
- THE MECHANICAL CONTRACTOR SHALL RETAIN THE SERVICES OF THE DESIGNATED ROOFING CONTRACTOR(S) TO REPAIR THE EXISTING ROOF OPENING WHERE THE EXISTING POWER FEED TO THE AIR HANDLING UNIT COMES THROUGH THE ROOF. SEAL, MAKE WATERTIGHT AND MATCH THE EXISTING ROOF CONSTRUCTION. ALL COSTS OF THE ROOFING CONTRACTOR SHALL BE INCLUDED FOR IN THE BASE TENDER PRICE.

## GENERAL NOTES:

CONTRACTORS SHALL VERIFY AND BE RESPONSIBLE FOR ALL DIMENSIONS AND CONDITIONS ON THE JOB AND THE ENGINEER SHALL BE INFORMED OF ANY VARIATIONS FROM THE DIMENSIONS AND CONDITIONS SHOWN ON THE DRAWINGS. DO NOT SCALE DRAWINGS. SHOP DRAWINGS SHALL BE SUBMITTED TO THE ENGINEER FOR APPROVAL BEFORE PROCEEDING WITH FABRICATION. THIS DRAWING IS THE PROPERTY OF SURI & ASSOCIATES LTD. AND SHALL NOT BE REPRODUCED WITHOUT THEIR PERMISSION AND UNLESS THE REPRODUCTION CARRIES THEIR NAME. ALL INFORMATION SHOWN ON THIS DRAWING IS FOR USE ON THE SPECIFIED PROJECT ONLY AND SHALL NOT BE USED OTHERWISE WITHOUT WRITTEN PERMISSION OF SURI & ASSOCIATES LTD.

2	ISSUED FOR TENDER	MAY 31/24
1	ISSUED FOR 100% DESIGN REVIEW	MAY 6/24
No.	REVISION	DATE

Contractors shall verify all dimensions at the job.





Mechanical & Electrical Consultant:

SURI & ASSOCIATES LTD. ENGINEERING CONSULTANTS

1018 ALBERTSON CRESCENT MISSISSAUGA, ONTARIO L5H 3C7 T (905)-290-7861 ELECTRICAL MECHANICAL LIGHTING COMMUNICATION SECURITY



Project


OAKRIDGE COMMUNITY
RECREATIONAL CENTRE
63 PHARMACY AVENUE,
TORONTO, ONTARIO. M1L 4S9

AIR HANDLING UNIT REPLACEMENT

Drawing Title

EXISTING ELECTRICAL LAYOUT

Date:
MAY 2024
Scale:
AS NOTED
Dwg Number:
E3

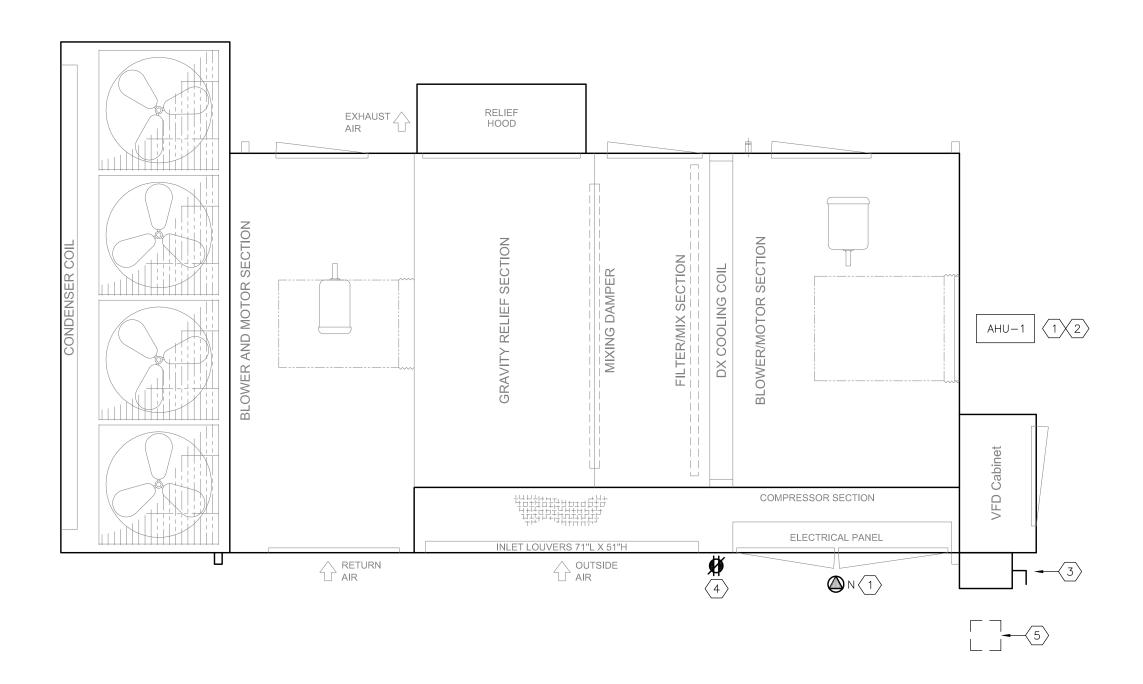

ROOF

1 ROOF PART PLAN - NEW HVAC PLAN

E4 SCALE: 1:25

DDAWING NOT


- PROVIDE POWER CONNECTION TO THE NEW AIR HANDLING UNIT UNIT AS SCHEDULED SEE DRAWING E1. PROVIDE A NEW FEEDER FROM THE MAIN DISTRIBUTION PANEL TO THE AIR HANDLING UNIT. THE UNIT SHALL BE FED FROM A DEDICATED CIRCUIT. ROUTE THE NEW FEEDER THROUGH THE EXISTING CEILING SPACES; FEEDER SHALL BE BROUGHT UP NEAR THE AIR HANDLING UNIT THROUGH A NEW ROOFTOP DOGHOUSE LOCATED IN CLOSE PROXIMITY TO THE NEW AIR HANDLING UNIT. COORDINATE FINAL CONNECTION WITH THE MECHANICAL CONTRACTOR. FINAL CONNECTION TO THE MECHANICAL EQUIPMENT SHALL BE WITH WEATHERTIGHT RACEWAYS. PROVIDE A NEW BREAKER IN THE EXISTING MAIN DISTRIBUTION PANEL FOR THE NEW AIR HANDLING UNIT.
- PROVIDE NEW FIRE ALARM SHUTDOWN SIGNAL TO THE AIR HANDLING UNIT. PROVIDE NEW WIRING/RACEWAYS FROM THE FIRE ALARM CONTROL PANEL TO THE ROOFTOP UNIT. FIRE ALARM FAN SHUTDOWN SHALL SHUTDOWN THE UNIT UPON A GENERAL ALARM. COMPLETE ALL WORK AS PER CAN/ULC-S524 AND VERIFY AS PER CAN/ULC-S537. PROVIDE NEW FAN SHUT DOWN RELAY IN THE EXISTING PANEL. RETAIN THE SERVICES OF MIRCOM FOR ALL FIRE ALARM MATERIAL SUPPLY, PROGRAMMING AND VERIFICATION COSTS. THE MANUFACTURER AND CONTRACTOR SHALL INCLUDE IN THE TENDER PRICE FOR ALL NECESSARY UPGRADES REQUIRED TO THE EXISTING PANEL TO ACCOMMODATE THE NEW FIRE ALARM FAN SHUTDOWN,
- NEW WEATHERPROOF, UNFUSED DISCONNECT SWITCH SUPPLIED BY THE EQUIPMENT MANUFACTURER. WIRE THE NEW ROOFTOP UNIT THROUGH THE UNFUSED DISCONNECT SWITCH.
- NEW 20A, T-SLOT, WEATHERPROOF (GFI) SERVICE RECEPTACLE SUPPLIED AND MOUNTED ON THE ROOFTOP UNIT ENCLOSURE BY THE EQUIPMENT MANUFACTURER. CONNECT THE RECEPTACLE TO THE DEDICATED CIRCUIT IN THE MAIN DISTRIBUTION PANEL SEE KEY PLAN FOR LOCATION. PROVIDE 1 X 15A-1P BREAKER SUITABLE FOR THE EXISTING 'FEDERAL PIONEER' PANEL. PROVIDE NEW WIRING AND CONDUIT FROM THE PANEL TO THE SERVICE RECEPTACLE. RUN CONDUIT THROUGH THE NEW DOGHOUSE (BY THE ROOFING CONTRACTOR).
- PROVIDE A NEW ROOFTOP DOGHOUSE AT THE AIR HANDLING UNIT LOCATION FOR ALL NEW ELECTRICAL AND CONTROLS CONDUITS. ALL ROOFING WORK SHALL BE COMPLETED BY THE ROOFING CONTRACTOR. THE MECHANICAL CONTRACTOR SHALL RETAIN THE SERVICES OF THE DESIGNATED ROOFING CONTRACTOR(S) FOR ALL ROOFING WORK. ALL COSTS OF THE ROOFING CONTRACTOR SHALL BE INCLUDED FOR IN THE BASE TENDER PRICE.


# GENERAL NOTES :

CONTRACTORS SHALL VERIFY AND BE RESPONSIBLE FOR ALL DIMENSIONS AND CONDITIONS ON THE JOB AND THE ENGINEER SHALL BE INFORMED OF ANY VARIATIONS FROM THE DIMENSIONS AND CONDITIONS SHOWN ON THE DRAWINGS. DO NOT SCALE DRAWINGS. SHOP DRAWINGS SHALL BE SUBMITTED TO THE ENGINEER FOR APPROVAL BEFORE PROCEEDING WITH FABRICATION. THIS DRAWING IS THE PROPERTY OF SURI & ASSOCIATES LTD. AND SHALL NOT BE REPRODUCED WITHOUT THEIR PERMISSION AND UNLESS THE REPRODUCTION CARRIES THEIR NAME. ALL INFORMATION SHOWN ON THIS DRAWING IS FOR USE ON THE SPECIFIED PROJECT ONLY AND SHALL NOT BE USED OTHERWISE WITHOUT WRITTEN PERMISSION OF SURI & ASSOCIATES LTD.

2	ISSUED FOR TENDER	MAY 31/24
1	ISSUED FOR 100% DESIGN REVIEW	MAY 6/24
No.	REVISION	DATE

Contractors shall verify all dimensions at the job.

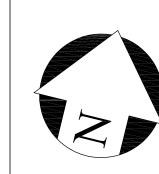

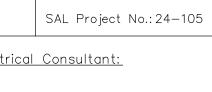

Mechanical & Electrical Consultant:

SURI & ASSOCIATES LTD. ENGINEERING CONSULTANTS

1018 ALBERTSON CRESCENT MISSISSAUGA, ONTARIO L5H 3C7 T (905)-290-7861 ELECTRICAL MECHANICAL LIGHTING COMMUNICATION SECURITY



Project

OAKRIDGE COMMUNITY
RECREATIONAL CENTRE
63 PHARMACY AVENUE,
TORONTO, ONTARIO. M1L 4S9

AIR HANDLING UNIT REPLACEMENT

Drawing Title

NEW ELECTRICAL LAYOUT

Checked:	Date:
RS	MAY 2024
Drawn:	Scale:
RS	AS NOTED
File Number:	Dwg Number:
	E4