	MECHANICAL LEGEND		MECHANICAL LEGEND
HEATING, VENTIL	ATION AND AIR CONDITIONING (HVAC)	HEATING, VENTIL	LATION AND AIR CONDITIONING (HVAC)
	RIGID DUCTWORK		WALL FIN HEATER CV-A DENOTES TYPE
	ACOUSTICALLY LINED DUCTWORK	CV-A 7000 0.15	7000 DENOTES HEAT OUTPUT IN WATTS 0.15 DENOTES FLOW RATE IN L/S
NWM.	FLEXIBLE ROUND DUCTWORK	FFH-A	FORCED FLOW HEATER FFH—A DENOTES TYPE
	SUPPLY DUCTWORK RISER UP		REFER TO FORCED FLOW HEATER SCHEDULE FOR HEAT OUTPUT AND FLOW RATE
	EXHAUST/RETURN DUCTWORK RISER UP	1-101 4 125 75	VAV BOX
	SUPPLY DUCTWORK RISER DOWN		
□ □ □ □ □ □ □ □ □ □ □ □ □ □ □ □ □ □ □	EXHAUST/RETURN DUCTWORK RISER DOWN	PLUMBING AND STM	T
•⊢SD →BD	BALANCING DAMPER  SPLITTER DAMPER	STM	ABOVE-GROUND STORM  UNDERGROUND STORM
<u>→</u> U/C	DOOR UNDERCUT	SAN	ABOVE-GROUND SANITARY
<b>→</b> D/G	DOOR GRILLE	SAN	UNDERGROUND SANITARY
CAP [	CAPPED DUCTWORK	PUMPED SAN	PUMPED SANITARY
<b>∏</b> bo	SPIN-ON FITTING WITH BALANCING DAMPER	<u></u>	RUNNING TRAP
X	SUPPLY AIR DIFFUSER	<b>%</b> ─	PLUMBING TRAP
	RETURN/EXHAUST AIR GRILLE	/ V	SANITARY VENT
	FLEXIBLE CONNECTION	<i>∕</i> ∥co	SANITARY CLEANOUT IN ACCESSIBLE CEILING SPACE
<del></del>	SUPPLY AIR GRILLE — WALL—MOUNTED	co <b>a⊢</b> /	SANITARY CLEANOUT IN SLAB
	RETURN AIR GRILLE — WALL—MOUNTED		DOMESTIC COLD WATER
BD	FLEXIBLE DUCT CONNECTION TO RIGID DUCTWORK		DOMESTIC HOT WATER  DOMESTIC HOT WATER RECIRCULATION
		BFP	BACKFLOW PREVENTER - SUITABLE FOR SERVICE INTENDED
REFERENCE OF THE PARTY OF THE P	SQUARE ELBOW WITH AIR TURNING VANES	/	WATER METER
FD		<b>↓</b> HB	HOSE BIBB
	FUSIBLE LINK FIRE DAMPER WITH ACCESS DOOR IN DUCT	<b>↓</b> NFHB	NON-FREEZE HOSE BIBB
<b>₽</b> MD	MOTORIZED DAMPER	<b>O</b> VTR	VENT THROUGH ROOF
	MOTORIZED DAMI ER	<b>O</b> RWL	RAIN WATER LEADER
BDD	BACK DRAFT DAMPER	<b>⊘</b> FD	FLOOR DRAIN
		Ø FFD	FUNNEL FLOOR DRAIN
BD	BALANCING DAMPER	© RD  CONTROLS	ROOF DRAIN
T*T		—(T)	BAS — TEMPERATURE SENSOR — IN PIPING
	BRANCH TAKE-OFF WITH ADJUSTABLE SPLITTER DAMPER IN SUPPLY DUCT	c/s	BAS — CURRENT SENSOR
OED OED	OPEN ENDED DUCT WITH BALANCING DAMPER AND BELLMOUTH	<b>-</b> □ P/S	BAS - PRESSURE SWITCH
	INLET	<b>-</b> □ F/S	BAS - FLOW SWITCH
	AIR HANDLING UNIT SILENCER	Al	BAS - ANALOG INPUT
SL-AHU1-2	AS PER SILENCER SCHEDULE	AO	BAS — ANALOG OUTPUT
A-84 — 25 —	DENOTES DIFFUSER TYPE — DENOTES AIRFLOW (IN L/S)  DENOTES NECK SIZE. DUCTWORK TO MATCH.	DI	BAS - DIGITAL INPUT
	THERMOSTAT TIED TO AN EXISTING CONTROL SYSTEM	DO FIRE PROTECTIO	BAS - DIGITAL OUTPUT
T	STANDALONE THERMOSTAT	FE	FIRE EXTINGUISHER IN ENCLOSURE C/W MOUNTING BRACKET
	PUMP	fE T	FIRE EXTINGUISHER C/W MOUNTING BRACKET
/HWS/	HOT WATER SUPPLY — HEATING	FB	FIRE BLANKET
∕HWR	HOT WATER RETURN — HEATING	<u>ACRONYMS</u>	
/HWRR/	HOT WATER REVERSE RETURN — HEATING	LABEL DESCR	<u>RIPTION</u>
/ RL /	REFRIGERATION LINE - LIQUID		SS DOOR CONDITIONER
/— RG —/	REFRIGERATION LINE — GAS	BD BALAN	NCING DAMPER DRAFT DAMPER
/— CD —/	CONDENSATE LINE  NATURAL GAS LINE	CAP CAP E CD CONDI	EXISTING SERVICE ENSATE
/GV	NATURAL GAS LINE  NATURAL GAS VENT LINE	CUT CUT F	ECT TO EXISTING POINT KING FOUNTAIN
/	COMPRESSED AIR LINE	EA EXHAU EX EXISTI	UST AIR ING
<b>├────</b>	ISOLATION VALVE. TYPE AS PER SPECIFICATION	FE FIRE (	DAMPER EXTINGUISHER SWITCH
/ <b>—</b>   <b>X</b>	BALANCING VALVE	HHS HAND LV LAVA	HELD SHOWER TORY
//	STRAINER	NO NORM	RIZED DAMPER ALLY OPEN
4	PRESSURE REDUCING VALVE	OA OUTDO	ALLY CLOSED OOR AIR SURE GAUGE
	AUTOMATIC 2-WAY CONTROL VALVE	RWL RAIN REM REMO'	WATER LEADER VE
	AUTOMATIC 3-WAY CONTROL VALVE		ACE RN AIR LY AIR
	UNION		RVISED VALVE
<u>*                                    </u>	MANUAL AIR VENT	UV UNIT VTR VENT	VENTILATOR THROUGH ROOF
/ X X X /	DENOTES EXISTING PIPING TO BE REMOVED		ER-DRYER UNIT R CLOSET
	DENOTES EXISTING PIPING TO REMAIN		
<i></i>	DENOTES NEW PIPING		
/G/	GAS METER		
/—P—/	PROPANE METER		
/ <b>()</b>	ELECTRIC HEAT TRACING; DIVISION 15 UNLESS OTHERWISE NOTED		
PG	PRESSURE GAUGE		
UP O	THERMOMETER PIPE UP		
—0 90 MD C—	PIPE DOWN		
		1	

#### **GENERAL NOTES:**

- ALL DEMOLITION AND NEW WORK SHALL BE COORDINATED WITH ALL TRADES PRESENT ON SITE. CONSTRUCT NEW SERVICES AND LOCATE NEW EQUIPMENT IN SUCH A WAY THAT IT DOES NOT CONFLICT WITH WORK OF OTHER DIVISIONS AND/OR THE OPERATION/MAINTENANCE OF WORK/MATERIAL SUPPLIED BY OTHER DIVISIONS.
- . IT IS MANDATORY FOR THE MECHANICAL CONTRACTOR TO VISIT THE SITE PRIOR TO BIDDING AND REVIEW EXISTING CONDITIONS AND DEMOLITION SCOPE OF WORK TO SUIT EXISTING ARCHITECTURAL, ELECTRICAL, STRUCTURAL AND MECHANICAL SITE CONDITIONS, DRAWINGS, SPECIFICATIONS AND ALL CONTRACT DOCUMENTS. NO EXTRA WILL SUBSEQUENTLY BE ALLOWED TO COVER ANY SUCH ERROR, OMISSION AND/OR OVERSIGHT FOR NOT HAVING MADE A THOROUGH INSPECTION OF THE GROUNDS, EXISTING CONDITIONS, DRAWINGS, SPECIFICATION AND DESIGN INTENT. THE ELECTRICAL CONTRACTOR SHALL NOTE THAT THE EXISTING BUILDING WILL REMAIN IN OPERATION THROUGHOUT DEMOLITION/CONSTRUCTION. ALLOW FOR ANY WORK REQUIRED TO BE DONE WHICH MAY AFFECT POWER SUPPLY AND OPERATION OF THE BUILDING TO BE CARRIED OUT AFTER HOURS OR AT A TIME CONVENIENT TO THE BUILDING MANAGEMENT. PROVIDE TEMPORARY SERVICES AS REQUIRED TO ENSURE CONTINUED OPERATION AT ALL TIMES.
- CAREFULLY EXAMINE OTHER EXISTING UTILITY LINES SUCH AS GAS, WATER ETC. PRIOR TO STARTING ANY WORK.
- THESE DRAWINGS SHALL BE READ & PRICED IN CONJUNCTION WITH ALL DRAWINGS AND SPECIFICATIONS FORMING THE CONTRACT AS WELL AS ALL OTHER DOCUMENTS FORMING THIS BID. NO EXTRA COST WILL BE ACCEPTED IN FAILURE TO OBTAINING AND/OR REVIEW OF SUCH DOCUMENTS. REFER TO ARCHITECTURAL, ELECTRICAL, FIRE PROTECTION STRUCTURAL AND MECHANICAL LAYOUTS IN CONJUNCTION FOR EXACT LOCATION OF ALL EQUIPMENT. REPORT ANY DISCREPANCIES TO THE MECHANICAL ENGINEER PRIOR TO COMMENCING WORK. NO EXTRA WILL BE PROVIDED AS A RESULT OF A FAILURE TO DO SO.
- . IT IS MANDATORY THAT ALL WORK COMPLY WITH ALL APPLICABLE CODES AND, CITY OF TORONTO STANDARDS, AND THE STANDARDS SET BY ANY AND ALL LOCAL AUTHORITIES HAVING JURISDICTION.
- ARRANGE FOR ALL INSPECTIONS REQUIRED BY AUTHORITIES HAVING JURISDICTION AS MANDATED BY CODES OR THE REQUIREMENTS OF THE AUTHORITIES. ATTEND ALL INSPECTIONS AND FURNISH ALL MATERIALS AND LABOUR REQUIRED TO COMPLETE THE INSPECTIONS TO THE SATISFACTION OF THE AUTHORITIES.
- IN THE EVENT OF ANY DISCREPANCY BETWEEN THE MECHANICAL DRAWINGS AND SPECIFICATIONS, ALLOW FOR THE HIGHEST-PRICED OPTION IN THE
- ALL EQUIPMENT AND SERVICES SHALL BE STARTED—UP BY THE CONTRACTOR AND BY THE APPROPRIATE AGENCIES REQUIRED FOR CONDUCTING SUCH START-UPS. PROVIDE A MINIMUM OF 10 BUSINESS DAYS NOTICE TO THE MECHANICAL ENGINEER OF NEW EQUIPMENT/ SERVICES START-UPS.
- FURNISH ALL MATERIAL AND EQUIPMENT AS SPECIFIED, EXCEPT WHERE SPECIFIC APPROVAL FOR SUBSTITUTION IS GIVEN IN WRITING BY THE
- 10. PROVIDE AS-BUILT DRAWINGS IN CAD AND PDF FORMAT AT THE CONCLUSION OF THE PROJECT TO THE OWNER, ARCHITECT AND ENGINEERS.

DRAWING LIST		
DRAWING NUMBER	DESCRIPTION	
M1	MECHANICAL LEGEND AND NOTES	
M2	BASEMENT LEVEL KEY PLAN	
М3	FIRST FLOOR KEY PLAN	
M4	FIRST FLOOR — EXISTING & NEW MECHANICAL LAYOUTS	
M5	BASEMENT — EXISTING & NEW MECHANICAL LAYOUTS	
M6	SCHEDULES & SCHEMATICS	
М7	SITE PHOTOS	
М8	SITE PHOTOS	

### NOTES ABOUT ABATEMENT


- REFER TO THE PROJECT-SPECIFIC DESIGNATED SUBSTANCES SURVEY CONDUCTED FOR THIS PROJECT DURING PRICING AND THROUGHOUT CONSTRUCTION. IT IS INCLUDED IN THE TENDER PACKAGE.
- . THE GENERAL CONTRACTOR IS RESPONSIBLE FOR COMPLETING ALL NECESSARY ABATEMENT WORK WITHIN THE WORK AREA REQUIRED FOR THIS PROJECT AS PART OF THE BASE TENDER PRICE BASED ON THE PROJECT-SPECIFIC DSS.
- 3. THE CONTRACTOR SHALL RETAIN ONLY LICENSED ABATEMENT/ENVIRONMENTAL CONTRACTORS TO COMPLETE ALL NECESSARY ABATEMENT WORK.
- 4. COORDINATE ALL ABATEMENT ACTIVITIES WITH THE ENVIRONMENTAL CONSULTANT IN ADVANCE OF WORK EXECUTION. THE ENVIRONMENTAL CONSULTANT IS RETAINED DIRECTLY BY THE OWNER TO SUPERVISE ABATEMENT ACTIVITIES AS WELL AS CONDUCT POST-ABATEMENT INSPECTIONS.

### **GENERAL NOTES:**

CONTRACTORS SHALL VERIFY AND BE RESPONSIBLE FOR ALL DIMENSIONS AND CONDITIONS ON THE JOB AND THE ENGINEER SHALL BE INFORMED OF ANY VARIATIONS FROM THE DIMENSIONS AND CONDITIONS SHOWN ON THE DRAWINGS. DO NOT SCALE DRAWINGS. SHOP DRAWINGS SHALL BE SUBMITTED TO THE ENGINEER FOR APPROVAL BEFORE PROCEEDING WITH FABRICATION. THIS DRAWING IS THE PROPERTY OF SURI & ASSOCIATES LTD. AND SHALL NOT BE REPRODUCED WITHOUT THEIR PERMISSION AND UNLESS THE REPRODUCTION CARRIES THEIR NAME. ALL INFORMATION SHOWN ON THIS DRAWING IS FOR USE ON THE SPECIFIED PROJECT ONLY AND SHALL NOT BE USED OTHERWISE WITHOUT WRITTEN PERMISSION OF SURI & ASSOCIATES LTD.

1	ISSUED FOR TENDER	JUN. 10/24
No.	REVISION	DATE

Contractors shall verify all dimensions at the job.

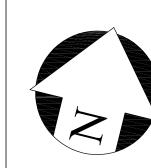



Mechanical & Electrical Consultant:

SURI & ASSOCIATES LTD. ENGINEERING CONSULTANTS

1018 ALBERTSON CRESCENT MISSISSAUGA, ONTARIO L5H 3C7 T (905)-290-7861

MECHANICAL LIGHTING COMMUNICATION




Project

BIRCHMOUNT COMMUNITY CENTRE 93 BIRCHMOUNT ROAD, TORONTO, ONTARIO. M1N 3J7

POOL HVAC IMPROVEMENTS

Drawing Title MECHANICAL LEGEND AND NOTES

Checked: RS	Date: MAY 2024
Drawn: RS	Scale: AS NOTED
File Number:	Dwg Number:

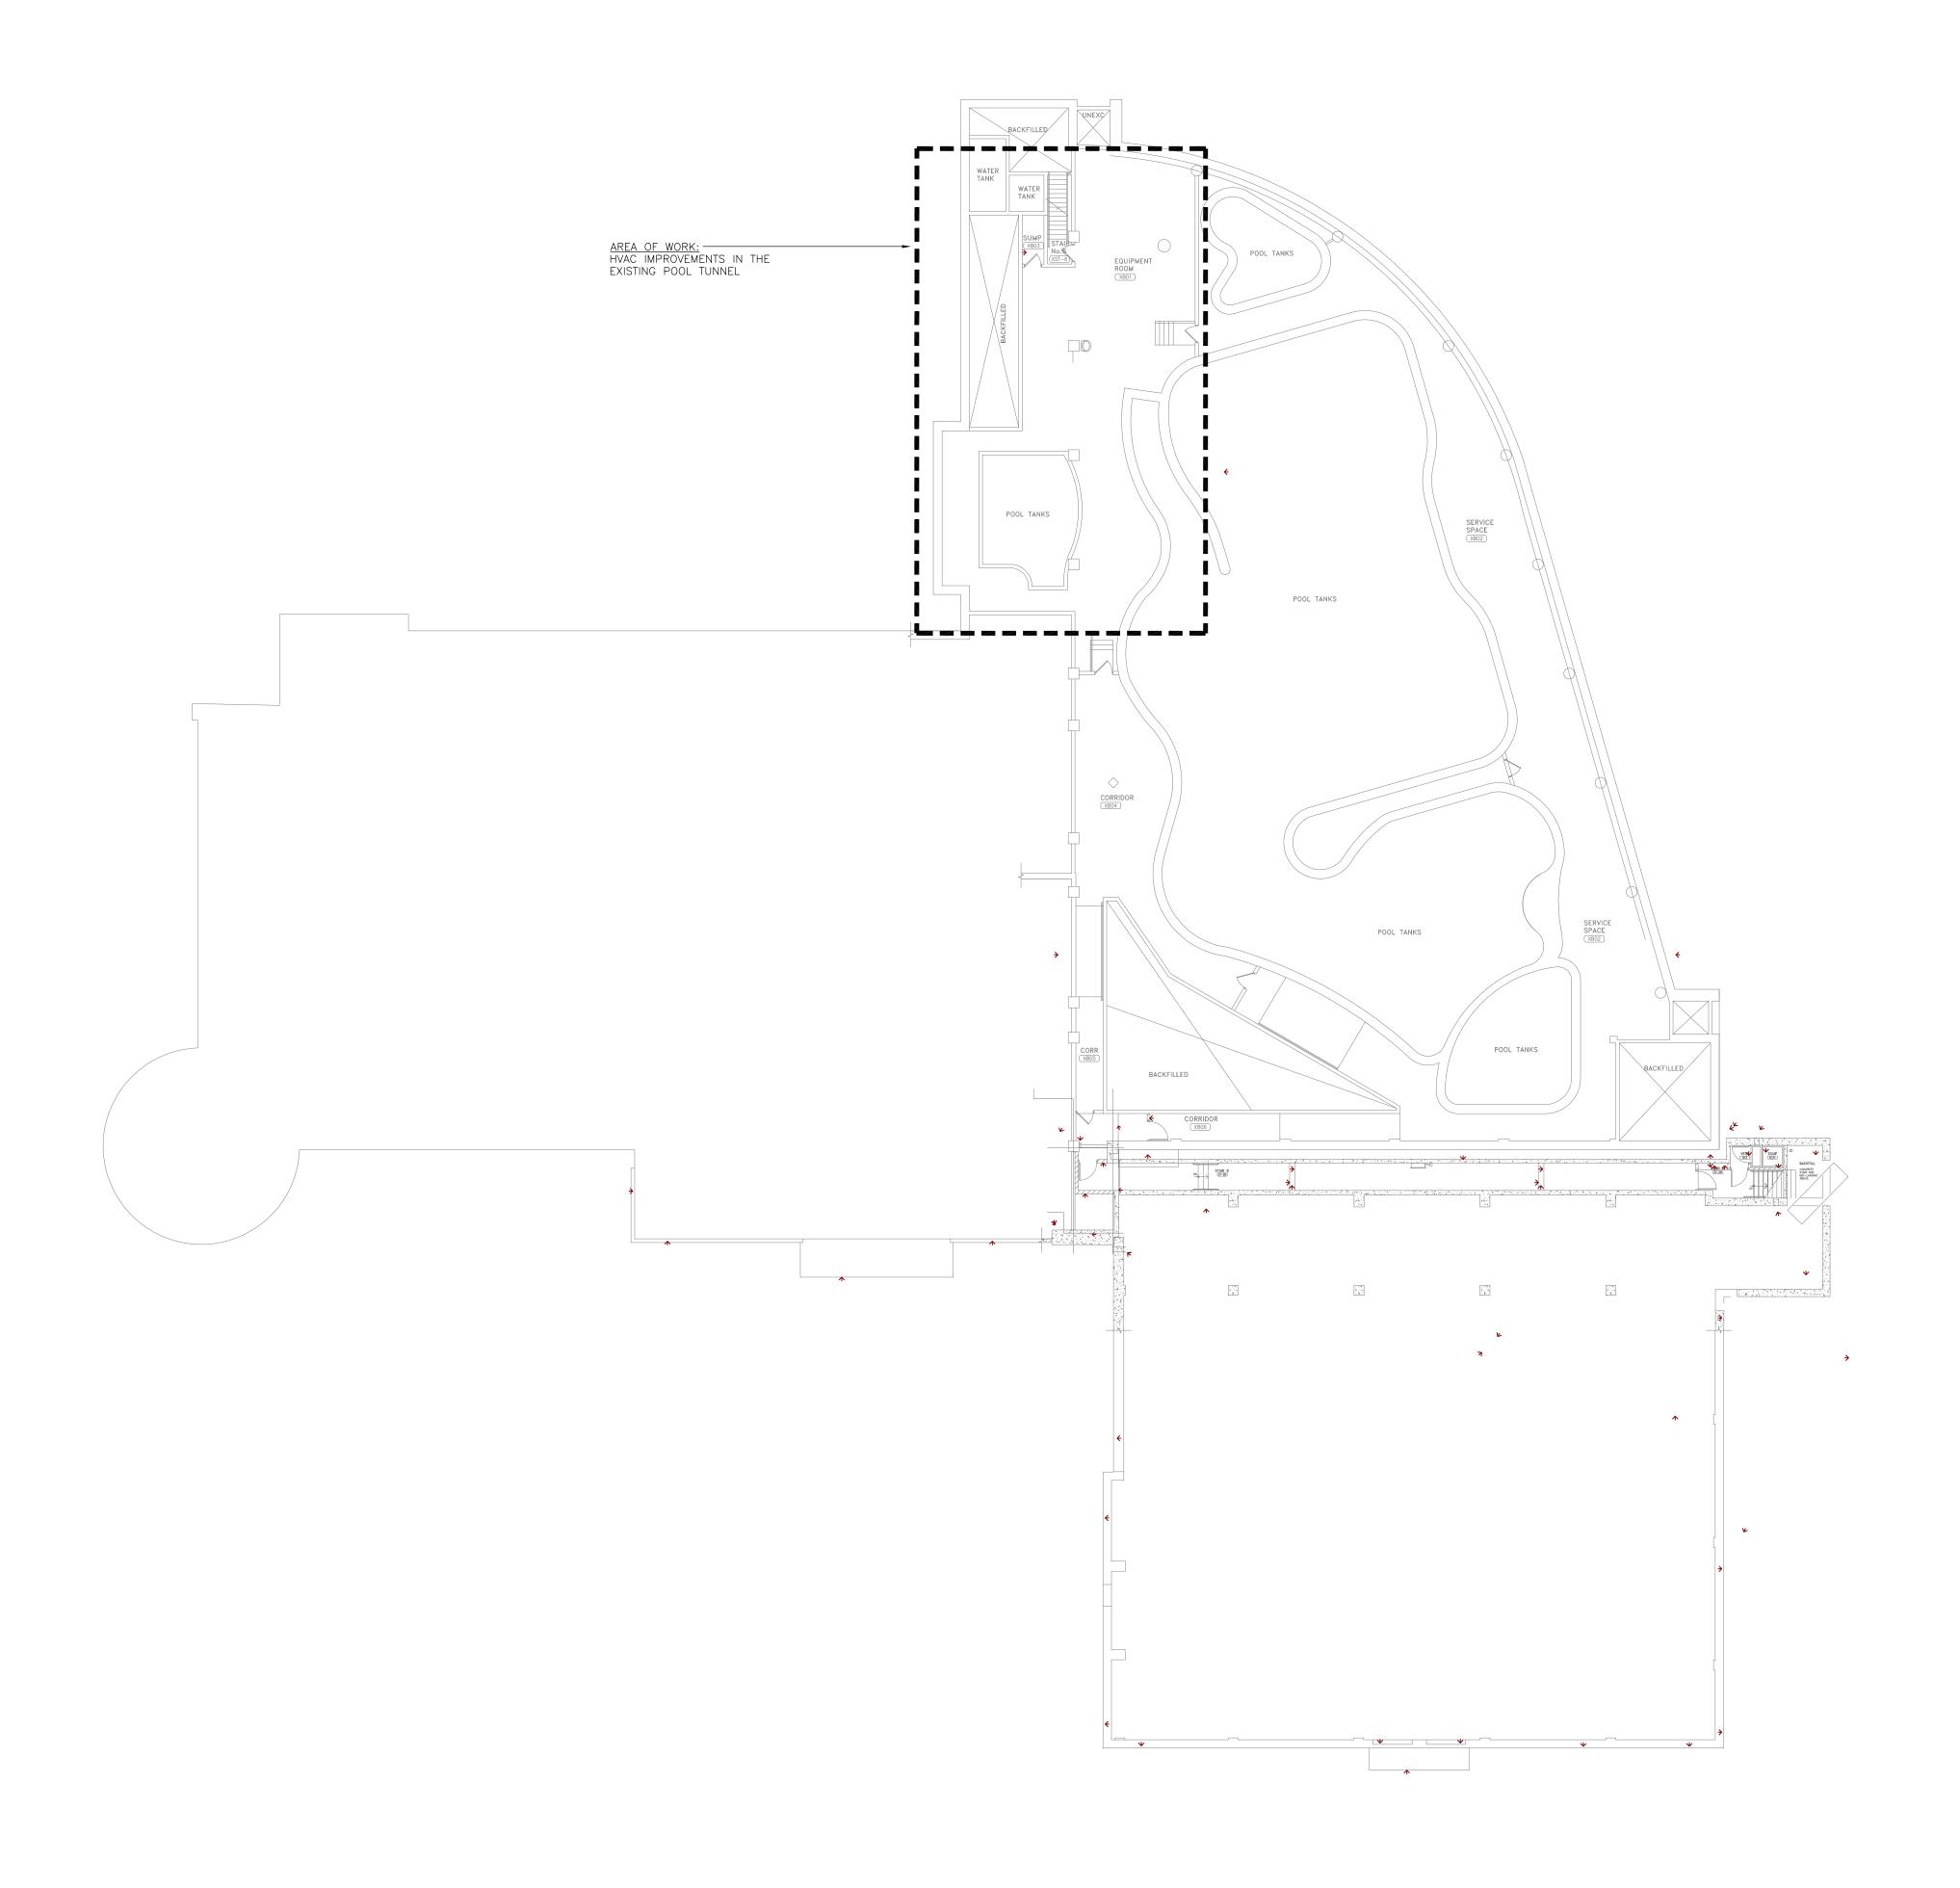


1 BASEMENT LEVEL KEY PLAN
M2 SCALE: 1:200

GENERAL NOTES:

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ENGINEERING CONSULTANTS

1018 ALBERTSON CRESCENT MISSISSAUGA, ONTARIO L5H 3C7 T (905)-290-7861 ELECTRICAL MECHANICAL LIGHTING COMMUNICATION SECURITY

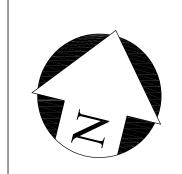

Project


BIRCHMOUNT COMMUNITY CENTRE 93 BIRCHMOUNT ROAD, TORONTO, ONTARIO. M1N 3J7

POOL HVAC IMPROVEMENTS

Drawing Title

BASEMENT LEVEL KEY PLAN

Checked:	Date:
RS	MAY 2024
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	M2

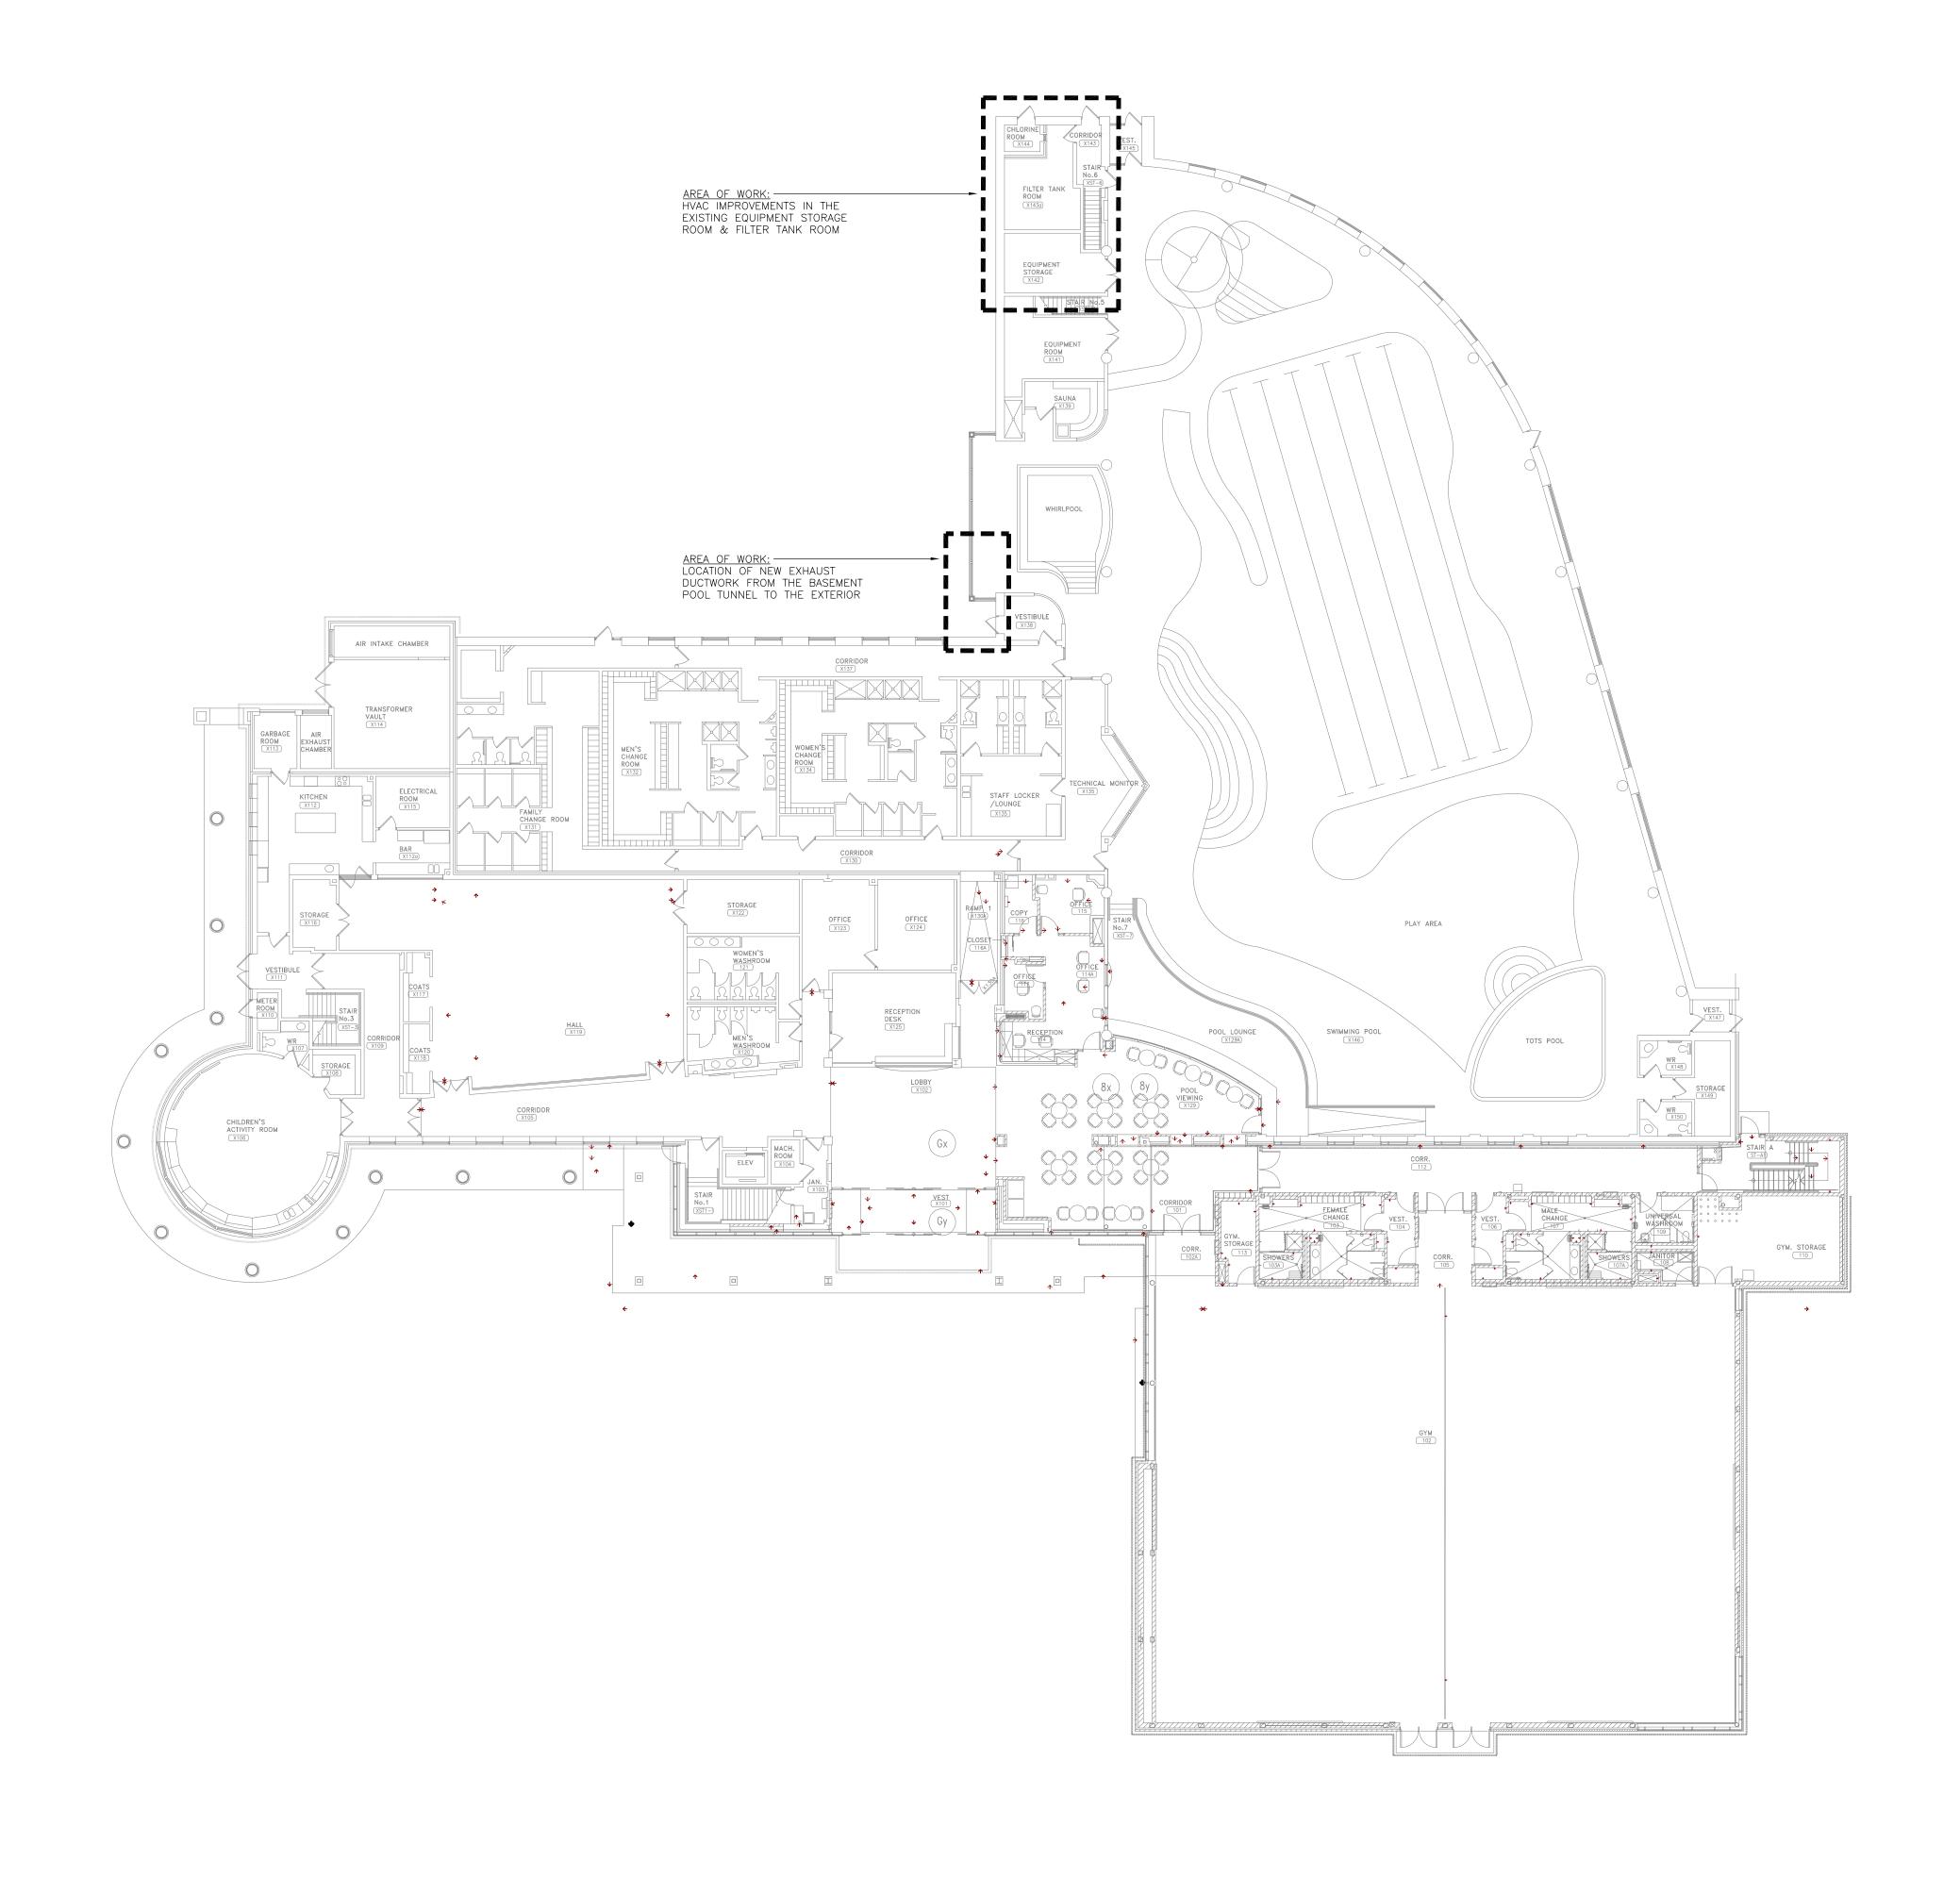


1 FIRST FLOOR KEY PLAN M3 SCALE: 1:200

# **GENERAL NOTES:**

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THEIR PERMISSION AND UNLESS THE REPRODUCTION
CARRIES THEIR NAME. ALL INFORMATION SHOWN ON
THIS DRAWING IS FOR USE ON THE SPECIFIED
PROJECT ONLY AND SHALL NOT BE USED
OTHERWISE WITHOUT WRITTEN PERMISSION OF SURI & ASSOCIATES LTD.

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ELECTRICAL MECHANICAL LIGHTING COMMUNICATION SECURITY

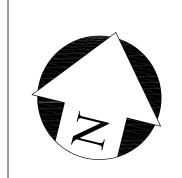

Project


BIRCHMOUNT COMMUNITY CENTRE 93 BIRCHMOUNT ROAD, TORONTO, ONTARIO. MÍN 3J7

POOL HVAC IMPROVEMENTS


Drawing Title

FIRST FLOOR KEY PLAN

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File Number:	Dwg Number:
	M3

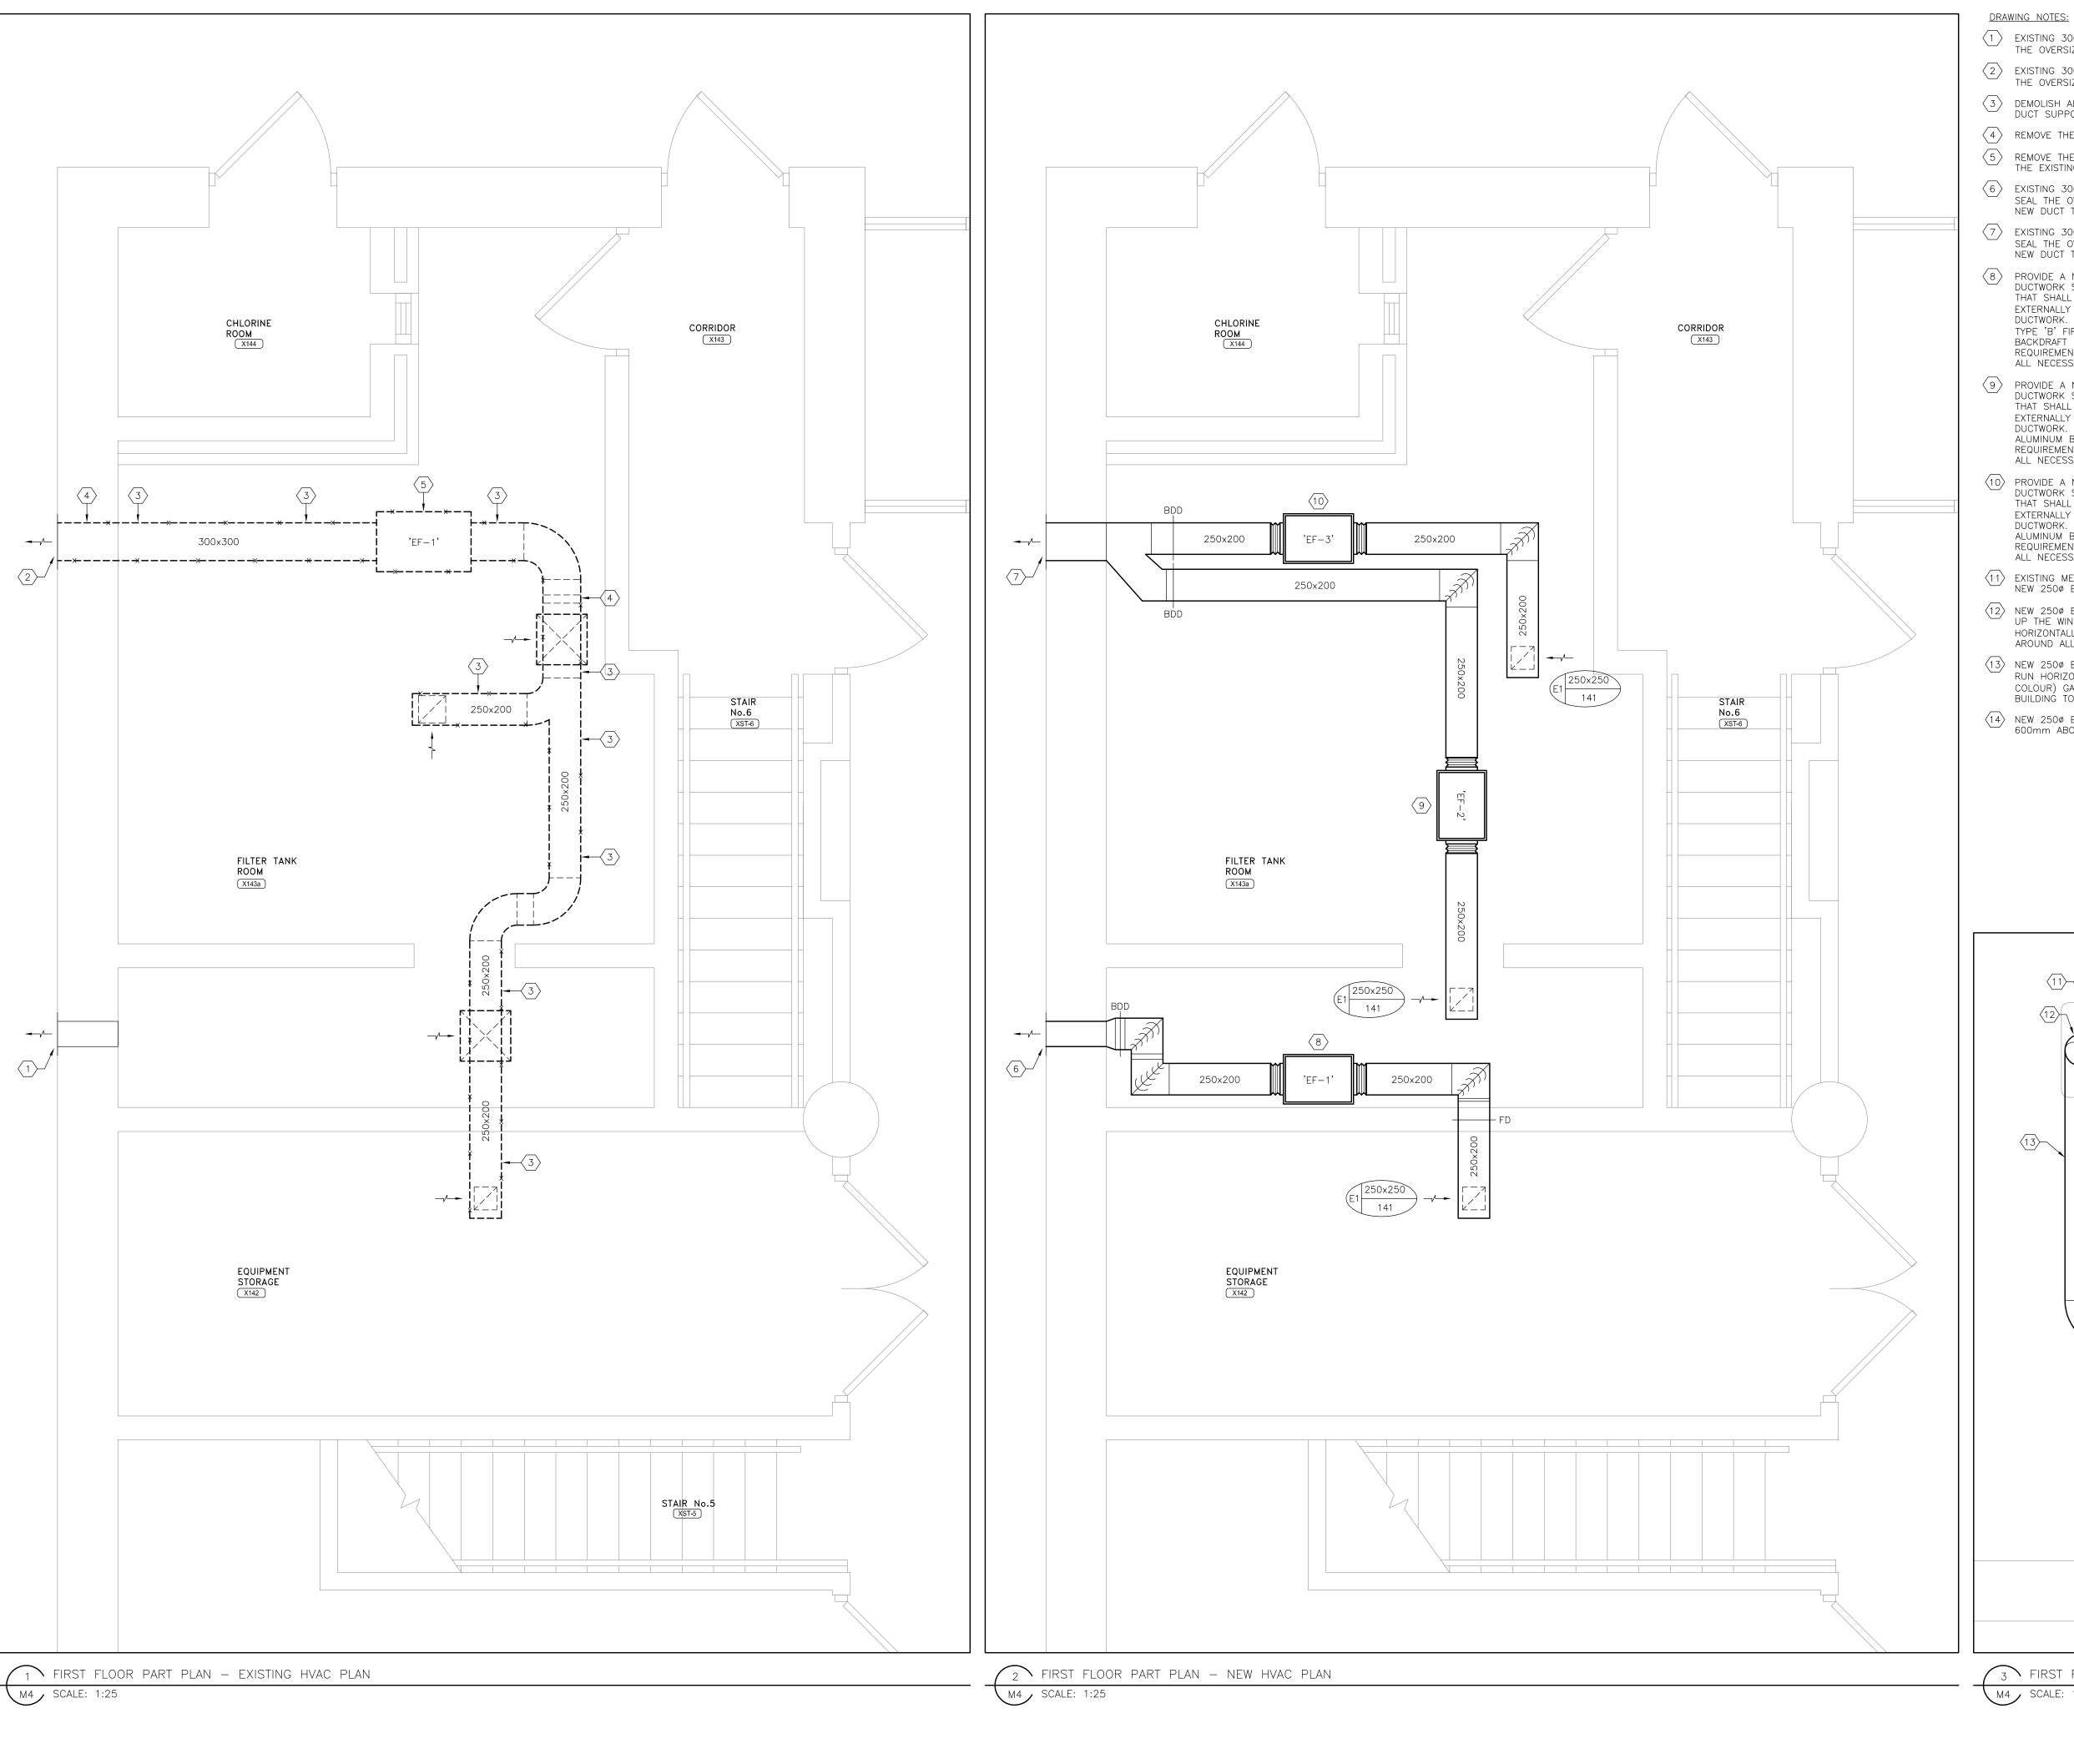

- 1) EXISTING 300x200 EXTERIOR LOUVER AND WALL OPENING TO REMAIN. INFILL AND SEAL THE OVERSIZED BLOCK (MASONRY) OPENING TO SUIT THE NEW DUCT.
- 2) EXISTING 300x300 EXTERIOR LOUVER AND WALL OPENING TO REMAIN. INFILL AND SEAL
- THE OVERSIZED BLOCK (MASONRY) OPENING TO SUIT THE NEW DUCT. DEMOLISH ALL EXISTING EXHAUST DUCTWORK PRESENT WITHIN THE AREAS. REMOVE ALL DUCT SUPPORTS. PATCH AND MAKE GOOD ALL SURFACES.
- 4 REMOVE THE EXISTING IN-DUCT FILTER BANK.
- 75 REMOVE THE EXISTING IN-LINE CEILING-HUNG EXHAUST FAN 'EF-1' IN ENTIRETY. REMOVE THE EXISTING FAN SUPPORTS. REMOVE ALL ELECTRICAL AND CONTROLS IN ENTIRETY.
- (6) EXISTING 300x200 EXTERIOR LOUVER AND WALL OPENING TO REMAIN. INFILL, PAINT AND SEAL THE OVERSIZED BLOCK (MASONRY) OPENING TO SUIT THE NEW DUCT. CONNECT THE NEW DUCT TO THE EXISTING LOUVER.
- $\overline{\langle 7 \rangle}$  Existing 300x300 exterior louver and wall opening to remain. Infill, paint and SEAL THE OVERSIZED BLOCK (MASONRY) OPENING TO SUIT THE NEW DUCT. CONNECT THE NEW DUCT TO THE EXISTING LOUVER.
- 8 PROVIDE A NEW IN-LINE CEILING-HUNG EXHAUST FAN 'EF-1' AS SCHEDULED. ALL DUCTWORK SHALL BE OF RIGID ALUMINUM TYPE, EXCEPT FOR CONNECTIONS TO THE FAN THAT SHALL BE OF FLEXIBLE CONNECTIONS. EXTERNALLY INSULATE ALL DUCTWORK. EXTERNALLY JACKET (WITH ALUMINUM JACKETING) THE FULL LENGTH OF EXHAUST DUCTWORK. CONNECT THE DUCTWORK TO THE EXISTING LOUVER AS SHOWN. PROVIDE A TYPE 'B' FIRE DAMPER (ALUMINUM CONSTRUCTION) WHERE SHOWN. PROVIDE AN ALUMINUM BACKDRAFT DAMPER WHERE SHOWN. SEE ELECTRICAL DRAWINGS FOR POWER REQUIREMENTS. RUN DUCTWORK AND INSTALL THE FAN AS HIGH AS POSSIBLE. PROVIDE ALL NECESSARY OFFSETS TO SUIT SITE CONDITIONS.
- PROVIDE A NEW IN-LINE CEILING-HUNG EXHAUST FAN 'EF-2' AS SCHEDULED. ALL DUCTWORK SHALL BE OF RIGID ALUMINUM TYPE, EXCEPT FOR CONNECTIONS TO THE FAN THAT SHALL BE OF FLEXIBLE CONNECTIONS. EXTERNALLY INSULATE ALL DUCTWORK. EXTERNALLY JACKET (WITH ALUMINUM JACKETING) THE FULL LENGTH OF EXHAUST DUCTWORK. CONNECT THE DUCTWORK TO THE EXISTING LOUVER AS SHOWN. PROVIDE AN ALUMINUM BACKDRAFT DAMPER WHERE SHOWN. SEE ELECTRICAL DRAWINGS FOR POWER REQUIREMENTS. RUN DUCTWORK AND INSTALL THE FAN AS HIGH AS POSSIBLE. PROVIDE ALL NECESSARY OFFSETS TO SUIT SITE CONDITIONS.
- PROVIDE A NEW IN-LINE CEILING-HUNG EXHAUST FAN 'EF-3' AS SCHEDULED. ALL DUCTWORK SHALL BE OF RIGID ALUMINUM TYPE, EXCEPT FOR CONNECTIONS TO THE FAN THAT SHALL BE OF FLEXIBLE CONNECTIONS. EXTERNALLY INSULATE ALL DUCTWORK. EXTERNALLY JACKET (WITH ALUMINUM JACKETING) THE FULL LENGTH OF EXHAUST DUCTWORK. CONNECT THE DUCTWORK TO THE EXISTING LOUVER AS SHOWN. PROVIDE AN ALUMINUM BACKDRAFT DAMPER WHERE SHOWN. SEE ELECTRICAL DRAWINGS FOR POWER REQUIREMENTS. RUN DUCTWORK AND INSTALL THE FAN AS HIGH AS POSSIBLE. PROVIDE ALL NECESSARY OFFSETS TO SUIT SITE CONDITIONS.
- EXISTING METAL GRATING COVER. CUT A HOLE THROUGH THE GRATING SUITABLE FOR THE NEW 2500 EXHAUST DUCT UP FROM THE BASEMENT THROUGH THE GRATING.
- (12) NEW 2500 EXHAUST DUCT THROUGH THE EXISTING LOUVER IN THE 'WINDOW WELL' AND UP THE WINDOW WELL. RUN DUCT UP TO 900mm ABOVE FINISHED GRADE AND RUN HORIZONTALLY. PROVIDE A PAINTED (TO MATCH THE WALL COLOUR) GALVANIZED COVER AROUND ALL DUCTWORK RUN ON THE EXTERIOR OF THE BUILDING TO CONCEAL IT.
- $\langle 13 
  angle$  NEW 2500 EXHAUST DUCT RUN AT AN ELEVATION OF 900mm ABOVE FINISHED GRADE AND RUN HORIZONTALLY AROUND THE BUILDING. PROVIDE A PAINTED (TO MATCH THE WALL COLOUR) GALVANIZED COVER AROUND ALL DUCTWORK RUN ON THE EXTERIOR OF THE BUILDING TO CONCEAL IT.
- (14) NEW 2500 EXHAUST DUCT UP THE WALL UP TO THE ROOF LEVEL. RUN THE DUCT TO 600mm ABOVE THE ROOF LEVEL AND TERMINATE AS A GOOSENECK WITH INSECT SCREEN.

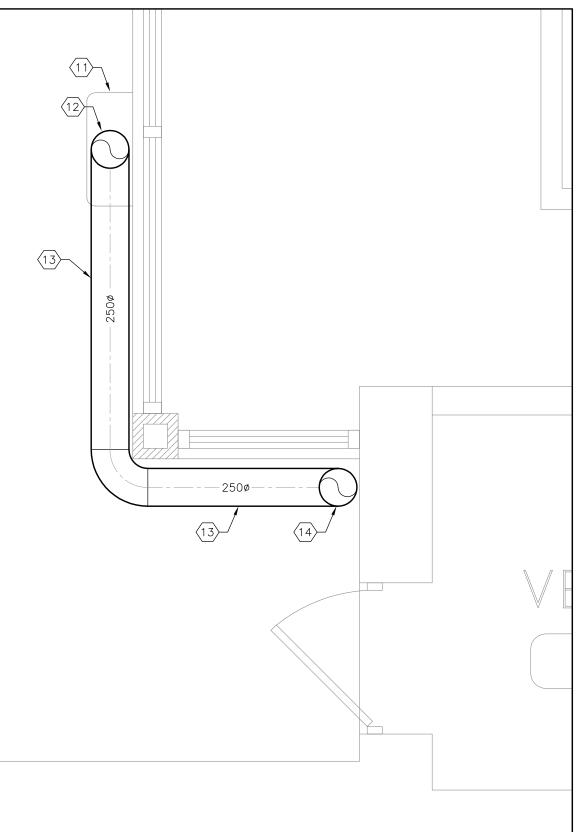


3 FIRST FLOOR PART PLAN - NEW EXHAUST DUCT PLAN M4 SCALE: 1:25

#### **GENERAL NOTES:**

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Mechanical & Electrical Consultant:

SURI & ASSOCIATES LTD. ENGINEERING CONSULTANTS

1018 ALBERTSON CRESCENT MISSISSAUGA, ONTARIO L5H 3C7 T (905)-290-7861

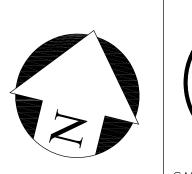ELECTRICAL MECHANICAL LIGHTING COMMUNICATION SECURITY



BIRCHMOUNT COMMUNITY CENTRE 93 BIRCHMOUNT ROAD,


POOL HVAC IMPROVEMENTS

TORONTO, ONTARIO. M1N 3J7

Drawing Title

FIRST FLOOR - EXISTING & NEW MECHANICAL LAYOUTS

Checked: RS	Date: MAY 2024
Drawn:	Scale: AS NOTED
File Number:	Dwg Number:

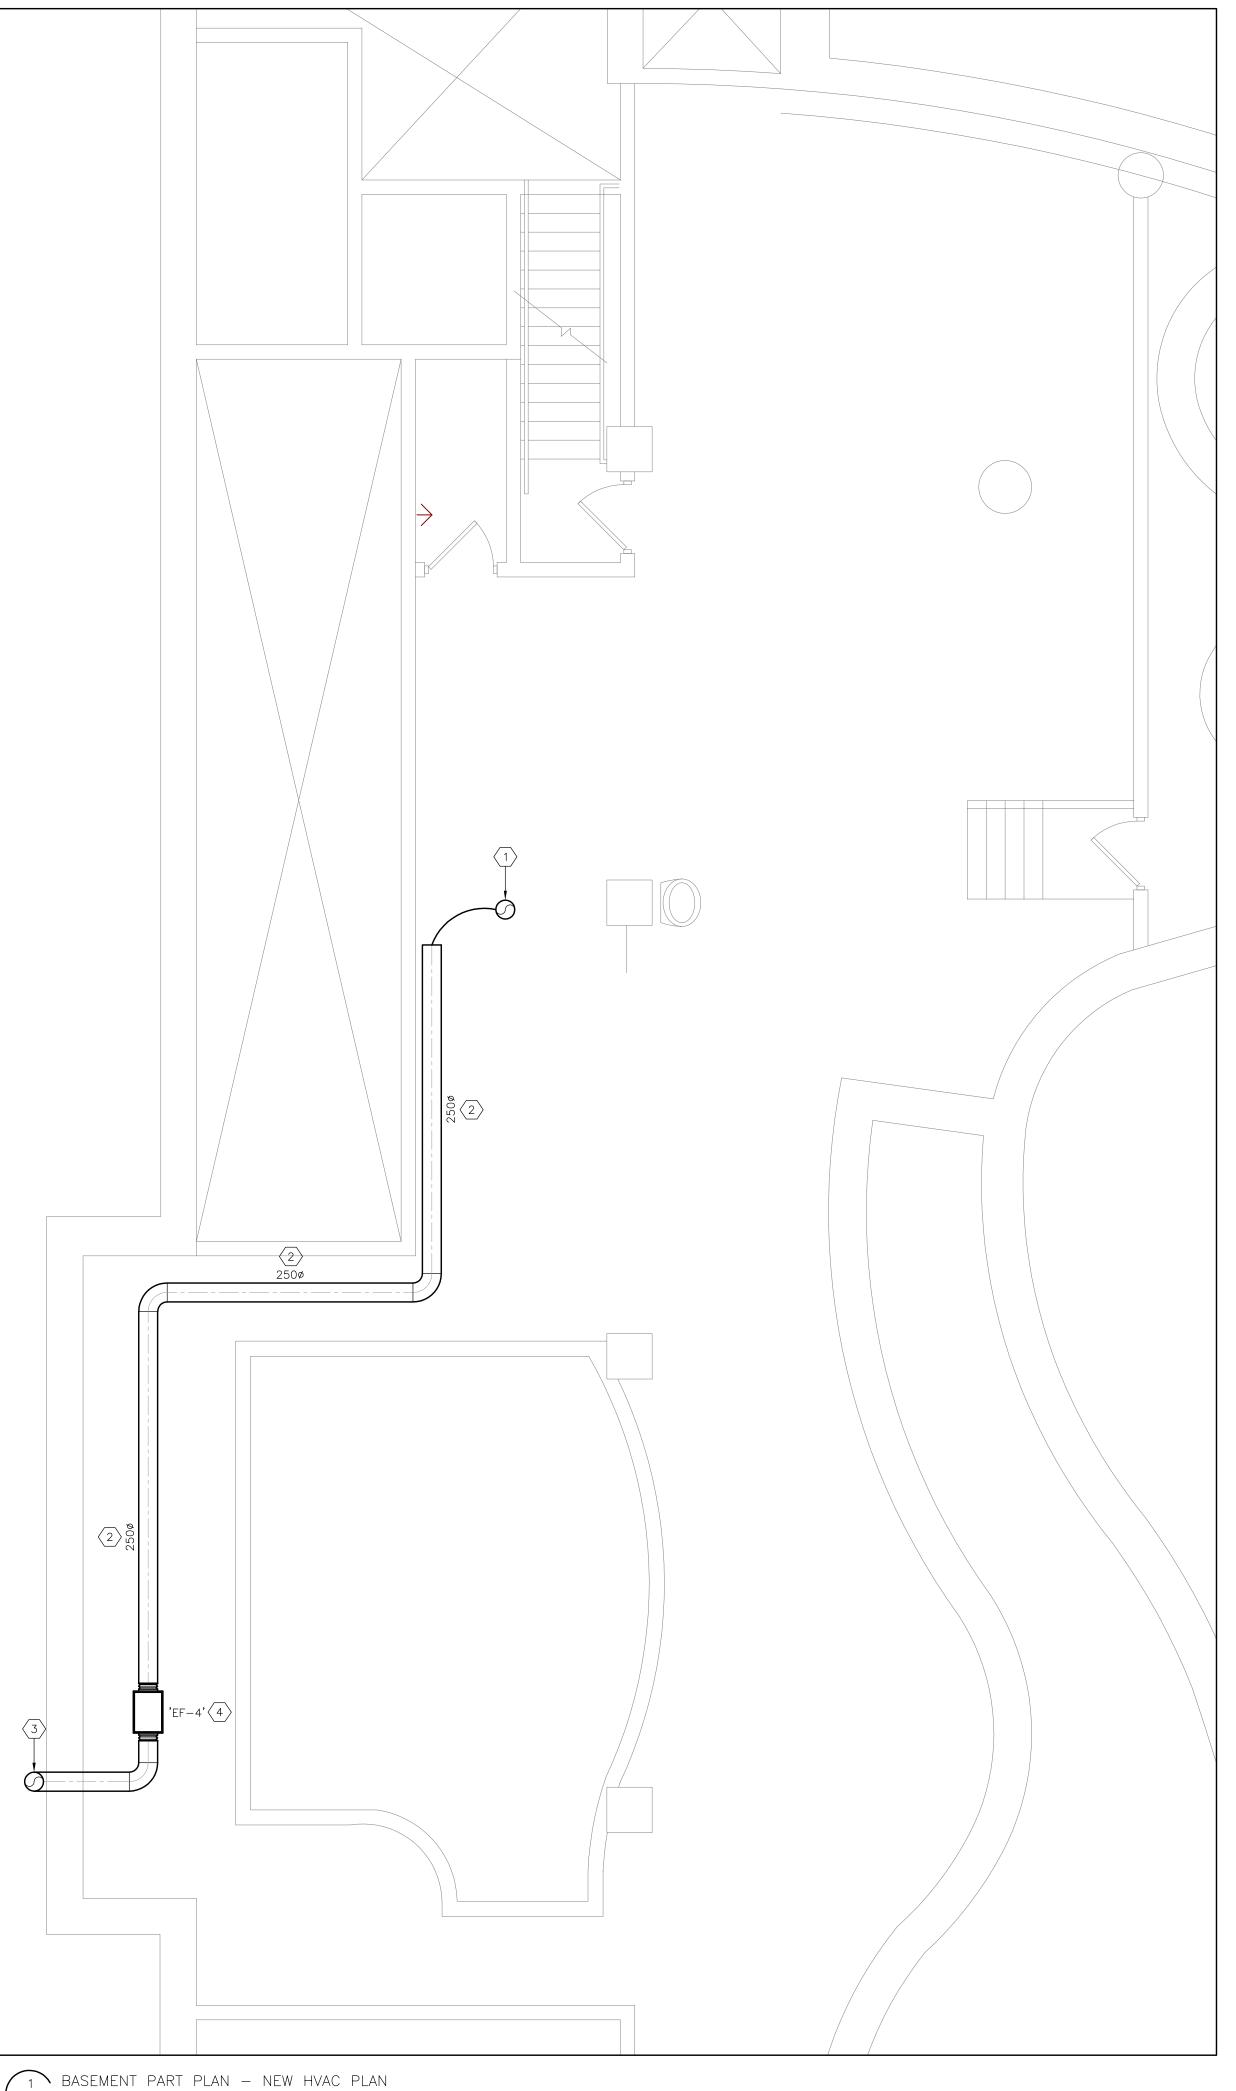

M5 SCALE: 1:50

- 1) PROVIDE NEW 10"Ø RIGID DUCT DN. FROM THE CEILING HEIGHT DOWN TO A HEIGHT OF 6' AFF. PROVIDE FLANGED CONNECTION FOR THE NEW EXTRACTION ARM. PROVIDE A NEW EXTRACTION ARM. EXTRACTION ARM SHALL BE NEDERMAN "EXTRACTION ARM ORIGINAL", 2.0 METERS IN LENGTH, MODEL: 10557835, WHITE COLOUR. EXTRACTION ARM SHALL COME C/W WALL BRACKET, HOOD TO HOSE ADAPTOR, SPARK FILTER AND ALUMINUM HOOD WITH DAMPER. PROVIDE A UNISTRUT ASSEMBLY (PAINTED) TO SUPPORT THE DUCTWORK AND EXTRACTION ARM. BALANCE EACH ARM TO 300 CFM. VERIFY EXACT LOCATIONS FOR EACH EXTRACTION ARM WITH THE USER GROUP PRIOR TO DUCTWORK FABRICATION AND INSTALLATION.
- 2) NEW EXTERNALLY INSULATED AND JACKETTED 2500 ALUMINUM EXHAUST DUCTWORK THROUGH THE POOL TUNNEL. PROVIDE ALL NECESSARY OFFSETS TO SUIT SITE CONDITIONS AND ROUTING AROUND EXISTING ELEMENTS. SUPPORT ALL DUCTWORK FROM
- NEW 2500 EXHAUST DUCT THROUGH THE EXISTING LOUVER IN THE 'WINDOW WELL' AND UP THE WINDOW WELL. RUN DUCT UP TO 900mm ABOVE FINISHED GRADE AND RUN
- PROVIDE A NEW IN-LINE CEILING-HUNG EXHAUST FAN 'EF-4' AS SCHEDULED. ALL DUCTWORK SHALL BE OF RIGID ALUMINUM TYPE, EXCEPT FOR CONNECTIONS TO THE FAN THAT SHALL BE OF FLEXIBLE CONNECTIONS. EXTERNALLY INSULATE ALL DUCTWORK. EXTERNALLY JACKET (WITH ALUMINUM JACKETING) THE FULL LENGTH OF EXHAUST DUCTWORK. SE ELECTRICAL DRAWINGS FOR POWER REQUIREMENTS. RUN DUCTWORK AND INSTALL THE FAN AS HIGH AS POSSIBLE. PROVIDE ALL NECESSARY OFFSETS TO SUIT SITE CONDITIONS.


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ELECTRICAL MECHANICAL LIGHTING COMMUNICATION SECURITY

1018 ALBERTSON CRESCENT MISSISSAUGA, ONTARIO L5H 3C7 T (905)-290-7861

Project

BIRCHMOUNT COMMUNITY CENTRE 93 BIRCHMOUNT ROAD,


POOL HVAC IMPROVEMENTS

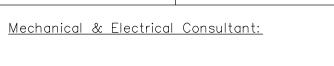
Drawing Title

BASEMENT - EXISTING & NEW MECHANICAL LAYOUTS

TORONTO, ONTARIO. M1N 3J7

Checked:	Date:
RS	MAY 2024
Drawn:	Scale:
RS	AS NOTED
File Number:	Dwg Number:
	M5

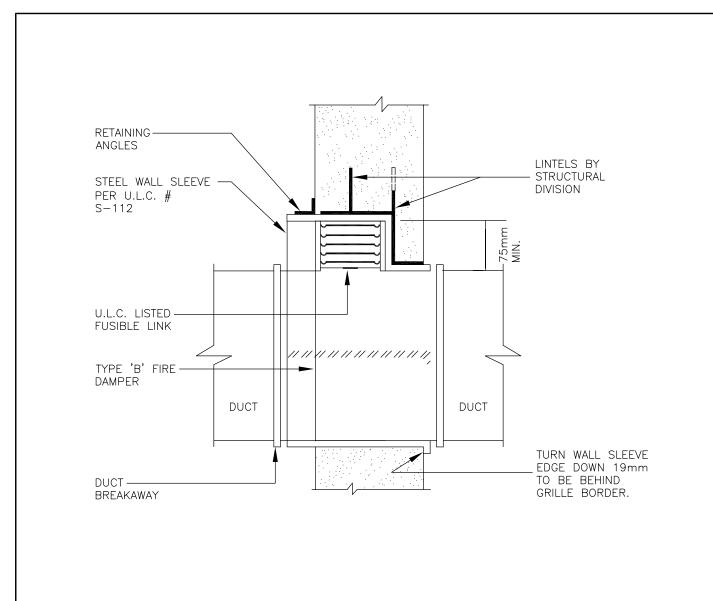

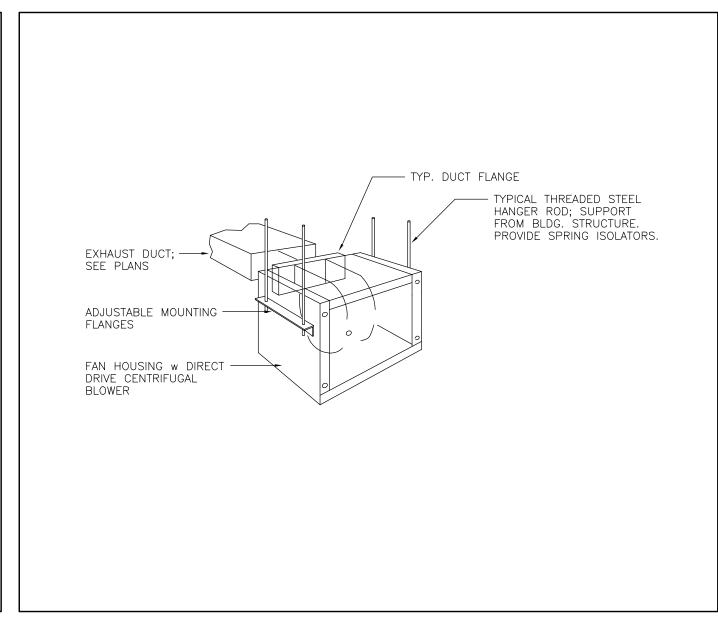

1 TYPE 'B' FIRE DAMPER INSTALLATION DETAIL M6 SCALE: N.T.S.

2 CEILING FAN INSTALLATION DETAIL M6 SCALE: N.T.S.

	EXHAUST FAN SCHEDULE										
EQUIPMENT DESIGNATION	MANUFACTURER	MODEL NO.	SERVICE	FAN TYPE	AIRFLOW (L/S)	ESP (Pa)	UNIT SIZE (WxLxH) mm	UNIT WEIGHT (KG)	CONTROLLED BY	VOLTAGE MOCP	NOTES
EF-1	COOK	GN-542	EQUIPMENT STORAGE ROOM [X142]	IN-LINE EXHAUST FAN	141	93.3	-	_	LOCAL CONTROL ONLY BY THE STARTER ONLY	120V/1ø/60 15A	C/W VIBRATION ISOLATION KIT AND SUSPENSION KIT; SUPPORT FROM THE BUILDING STRUCTURE C/W DUCT BLOWER FILTER C/W CORROSION RESISTANT CONSTRUCTION, SUITABLE FOR POOL ENVIRONMENT. C/W LOCAL DISCONNECT SWITCH
EF-2	COOK	GN-542	FILTER TANK ROOM [X143a]	IN-LINE EXHAUST FAN	141	93.3	-	_	LOCAL CONTROL ONLY BY THE STARTER ONLY	120V/1ø/60 15A	C/W VIBRATION ISOLATION KIT AND SUSPENSION KIT; SUPPORT FROM THE BUILDING STRUCTURE C/W DUCT BLOWER FILTER C/W CORROSION RESISTANT CONSTRUCTION, SUITABLE FOR POOL ENVIRONMENT. C/W LOCAL DISCONNECT SWITCH
EF-3	СООК	GN-542	FILTER TANK ROOM [X143a]	IN-LINE EXHAUST FAN	141	93.3	-	_	LOCAL CONTROL ONLY BY THE STARTER ONLY	120V/1ø/60 15A	C/W VIBRATION ISOLATION KIT AND SUSPENSION KIT; SUPPORT FROM THE BUILDING STRUCTURE C/W DUCT BLOWER FILTER C/W CORROSION RESISTANT CONSTRUCTION, SUITABLE FOR POOL ENVIRONMENT. C/W LOCAL DISCONNECT SWITCH
EF-4	COOK	GN-542	POOL TUNNEL	IN-LINE EXHAUST FAN	141	124.4	-	_	LOCAL CONTROL ONLY BY THE STARTER ONLY	120V/1ø/60 15A	C/W VIBRATION ISOLATION KIT AND SUSPENSION KIT; SUPPORT FROM THE BUILDING STRUCTURE C/W DUCT BLOWER FILTER C/W CORROSION RESISTANT CONSTRUCTION, SUITABLE FOR POOL ENVIRONMENT. C/W LOCAL DISCONNECT SWITCH

	DIFFUSER, GRILLES AND LOUVER SCHEDULE								
DESIGNATION	MANUFACTURER	MODEL NO.	TYPE	SIZE	NECK SIZE	COLOUR/FINISH	FIRE RATED	VOLUME CONTROL	NOTES
'S1'	EH PRICE	610-B12	SUPPLY AIR GRILLE	SEE DRAWING	-	WHITE (B12)	NO	YES	SEE NOTES 1, 2 BELOW; SUITABLE FOR DUCT MOUNTING; COMPLETE ALUMINUM CONSTRUCTION, INCLUDING FRAME
'E1'	EH PRICE	80-B12	EXHAUST AIR GRILLE	SEE DRAWING	-	WHITE (B12)	NO	YES	SEE NOTES 1, 2 BELOW; SUITABLE FOR DUCT MOUNTING; COMPLETE ALUMINUM CONSTRUCTION, INCLUDING FRAME


NOTES: 1. SUBMIT SHOP DRAWINGS FOR ALL DIFFUSERS, GRILLES AND LOUVERS PRIOR TO ORDERING. 2. PROVIDE A PHYSICAL COLOUR CHIP TO THE ARCHITECT DURING SHOP DRAWING SUBMISSION FOR APPROVAL PRIOR TO ORDERING.

# **GENERAL NOTES:**

CONTRACTORS SHALL VERIFY AND BE RESPONSIBLE FOR ALL DIMENSIONS AND CONDITIONS ON THE JOB AND THE ENGINEER SHALL BE INFORMED OF ANY VARIATIONS FROM THE DIMENSIONS AND CONDITIONS SHOWN ON THE DRAWINGS. DO NOT SCALE DRAWINGS. SHOP DRAWINGS SHALL BE SUBMITTED TO THE ENGINEER FOR APPROVAL BEFORE PROCEEDING WITH FABRICATION. THIS DRAWING IS THE PROPERTY OF SURI & ASSOCIATES LTD. AND SHALL NOT BE REPRODUCED WITHOUT THEIR PERMISSION AND UNLESS THE REPRODUCTION CARRIES THEIR NAME. ALL INFORMATION SHOWN ON THIS DRAWING IS FOR USE ON THE SPECIFIED PROJECT ONLY AND SHALL NOT BE USED OTHERWISE WITHOUT WRITTEN PERMISSION OF SURI & ASSOCIATES LTD.

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1018 ALBERTSON CRESCENT MISSISSAUGA, ONTARIO L5H 3C7 T (905)-290-7861 ELECTRICAL MECHANICAL LIGHTING COMMUNICATION SECURITY

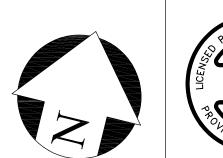


Project

BIRCHMOUNT COMMUNITY
CENTRE
93 BIRCHMOUNT ROAD,
TORONTO, ONTARIO. M1N 3J7


POOL HVAC IMPROVEMENTS

Drawing Title

SCHEDULES & SCHEMATICS

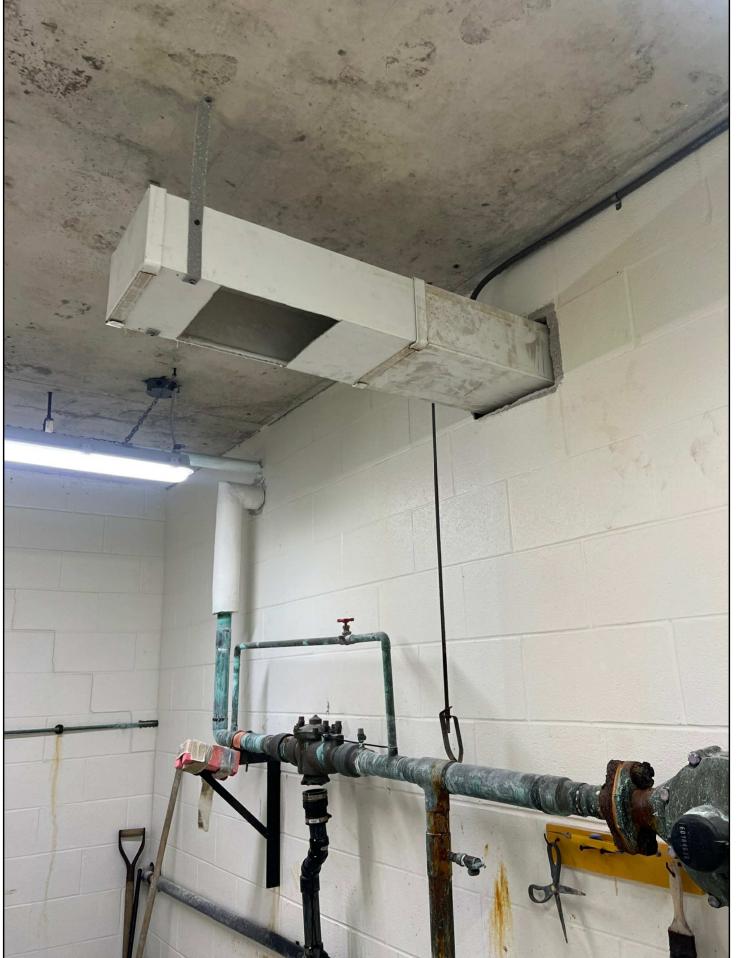


1 FIRST FLOOR SITE PHOTOS

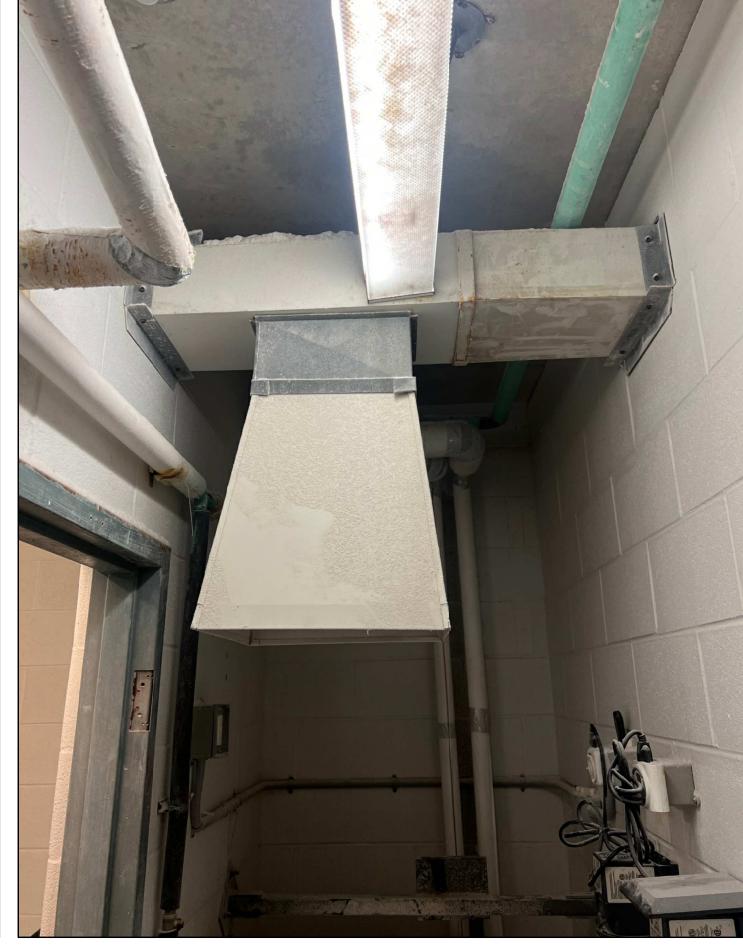


2 FIRST FLOOR SITE PHOTOS



3 FIRST FLOOR SITE PHOTOS

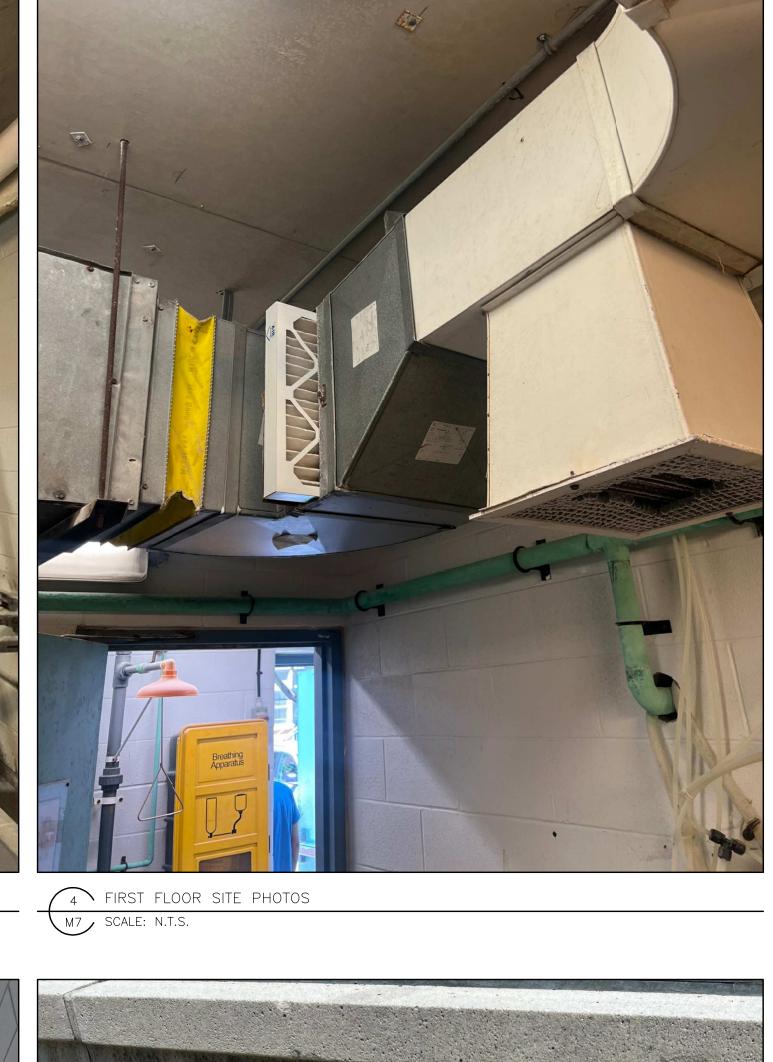

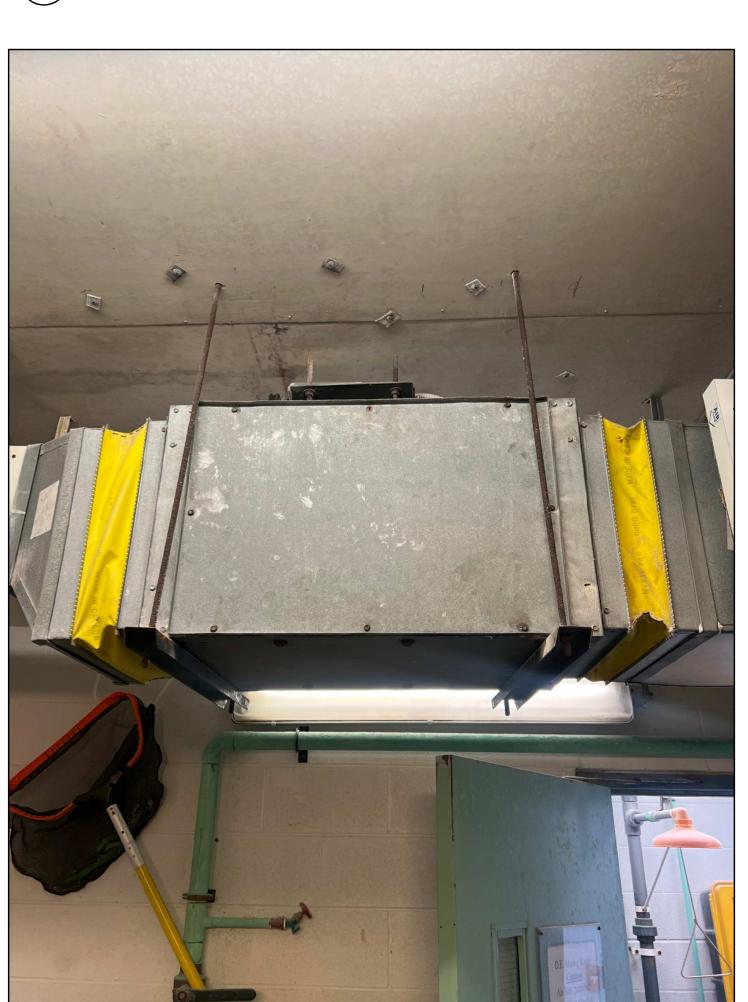


5 FIRST FLOOR SITE PHOTOS
M7 SCALE: N.T.S.



6 EXTERIOR SITE PHOTOS
M7 SCALE: N.T.S.



7 EXTERIOR SITE PHOTOS
M7 SCALE: N.T.S.

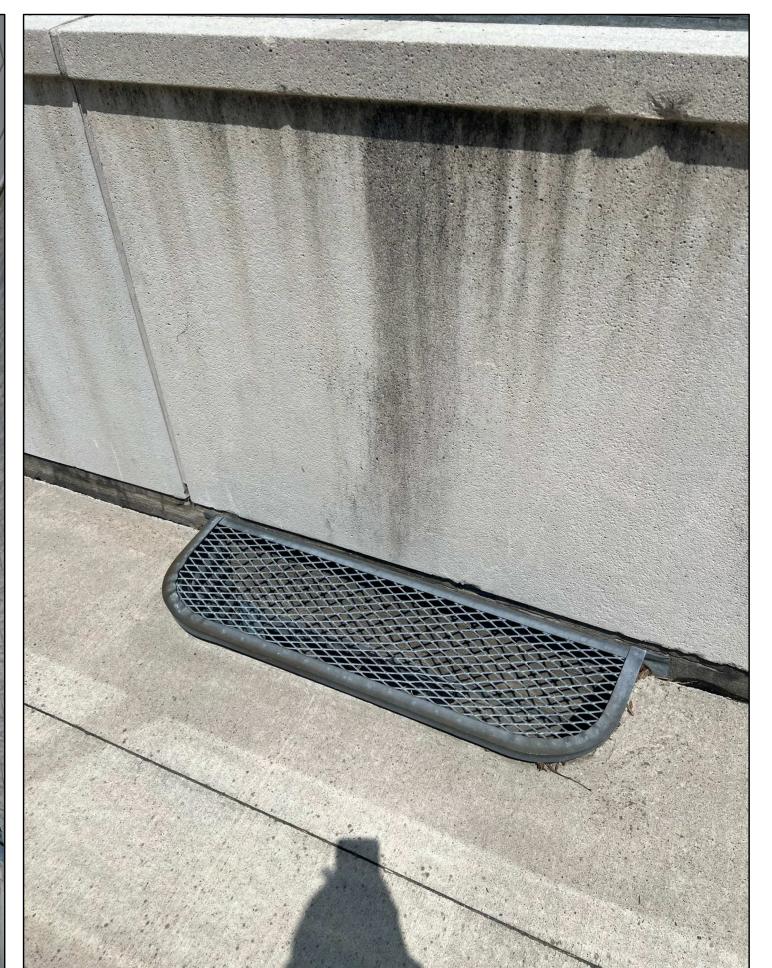


8 EXTERIOR SITE PHOTOS
M7 SCALE: N.T.S.

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ELECTRICAL MECHANICAL LIGHTING COMMUNICATION SECURITY




BIRCHMOUNT COMMUNITY CENTRE 93 BIRCHMOUNT ROAD, TORONTO, ONTARIO. M1N 3J7


POOL HVAC IMPROVEMENTS

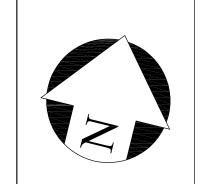Drawing Title SITE PHOTOS


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1 BASEMENT POOL TUNNEL SITE PHOTOS

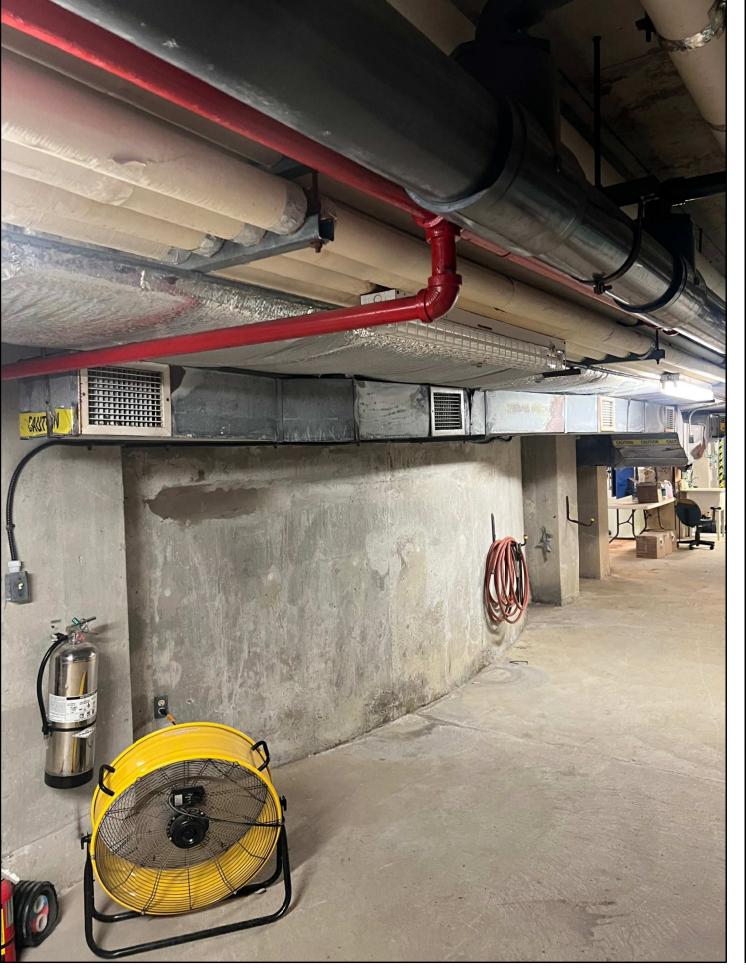


2 BASEMENT POOL TUNNEL SITE PHOTOS

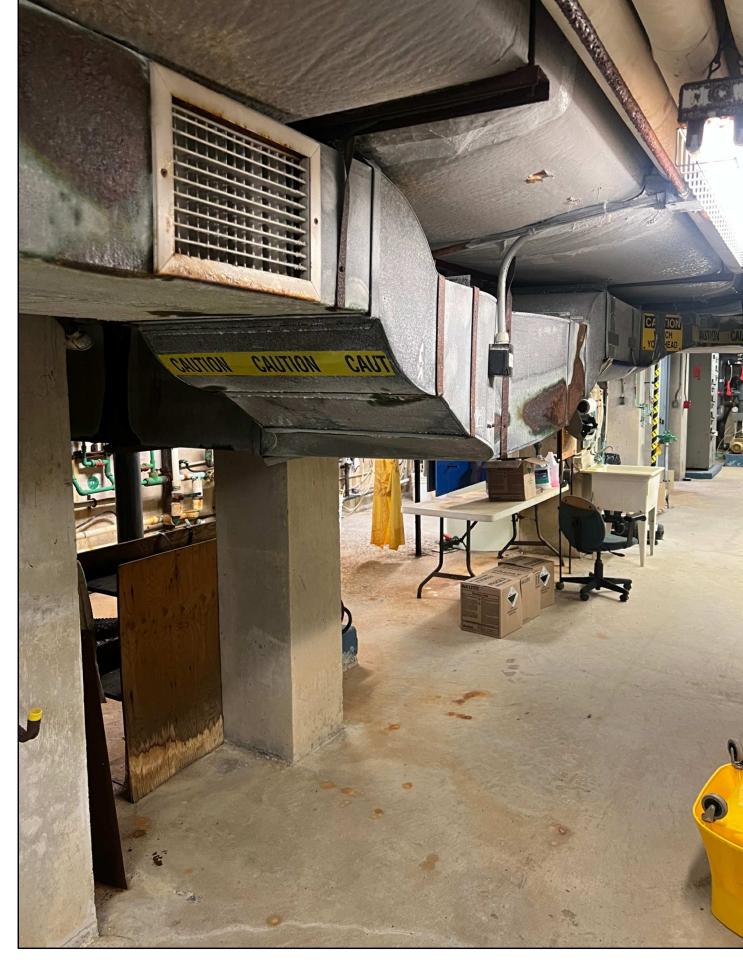

3 BASEMENT POOL TUNNEL SITE PHOTOS

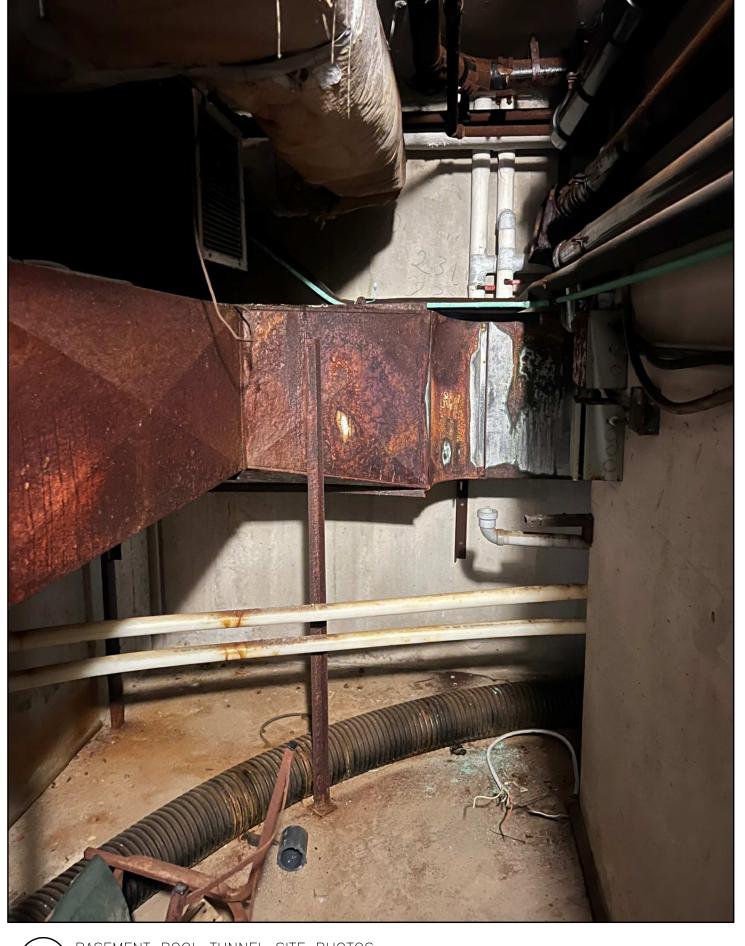

7 BASEMENT POOL TUNNEL SITE PHOTOS M8 SCALE: N.T.S.

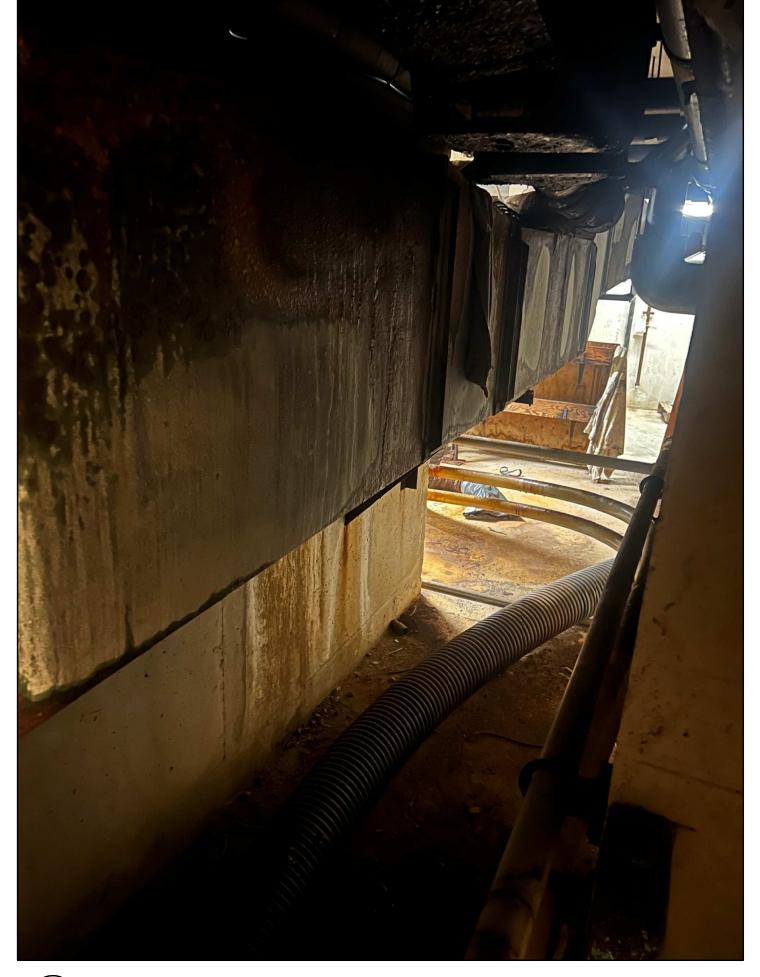

BASEMENT POOL TUNNEL SITE PHOTOS M8 SCALE: N.T.S.




8 BASEMENT POOL TUNNEL SITE PHOTOS M8 SCALE: N.T.S.

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SURI & ASSOCIATES LTD. ENGINEERING CONSULTANTS

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ELECTRICAL MECHANICAL LIGHTING COMMUNICATION SECURITY



Project

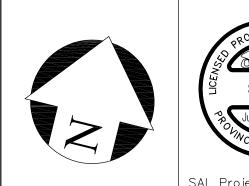BIRCHMOUNT COMMUNITY CENTRE 93 BIRCHMOUNT ROAD,

POOL HVAC IMPROVEMENTS

TORONTO, ONTARIO. MÍN 3J7

Drawing Title SITE PHOTOS

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File	Number:	Dwg Number:
		M8





	LIGHTING LEGEND
A1	STANDARD TYPE 'A1' LIGHT FIXTURE AS SCHEDULED
//A1//	TYPE 'A1' LIGHT FIXTURE AS SCHEDULED, CONNECTED TO THE EMERGENCY POWER SOURCE (INVERTER OR GENERATOR)
B1	WALL-MOUNTED TYPE 'B1' LIGHT FIXTURE AS SCHEDULED
\$	LINE-VOLTAGE, TOGGLE LIGHT SWITCH.
\$D	LOW-VOLTAGE, TOGGLE & DIMMER LIGHT SWITCH, AS SPECIFIED.
\$ĸ	LOW-VOLTAGE, KEY-SWITCH TYPE LIGHT SWITCH, AS SPECIFIED.
\$MS	LOW-VOLTAGE, KEY-SWITCH TYPE, MASTER LIGHT SWITCH, AS SPECIFIED. CONTROLS ALL CORRIDOR, WASHROOM AND VESTIBULE LIGHTING
\$os	LOW-VOLTAGE LIGHT SWITCH COMPLETE WITH INTEGRAL OCCUPANCY SENSOR, AS SPECIFIED.
OS	CORNER/WALL-MOUNTED, LOW-VOLTAGE OCCUPANCY SENSOR, AS SCHEDULED
OS	CEILING-MOUNTED, LOW-VOLTAGE OCCUPANCY SENSOR, AS SCHEDULED
ОН	EXTERIOR-GRADE, WALL-MOUNTED LIGHT FIXTURE
	EXTERIOR-GRADE, LIGHT STANDARD COMPLETE WITH CONCRETE BASE
<b>≥</b> BU	EMERGENCY LIGHTING BATTERY UNIT C/W NO REMOTE HEADS
<b>₽</b> BU	EMERGENCY LIGHTING BATTERY UNIT C/W DUAL-HEAD REMOTE HEADS
•_•	EMERGENCY LIGHTING DUAL-HEAD REMOTE HEAD
$\blacksquare$	EMERGENCY LIGHTING, WALL-MOUNTED EXIT SIGN
	EMERGENCY LIGHTING, CEILING-MOUNTED EXIT SIGN

	POWER DEVICES & EQUIPMENT LEGEND
ф	SINGLE RECEPTACLE MOUNTED AT STANDARD HEIGHT; USE AND RATING FOR THE PURPOSE INTENDED
Ø	SINGLE RECEPTACLE MOUNTED AT HIGH LEVEL; USE AND RATING FOR THE PURPOSE INTENDED
Ф	15A, 120V DUPLEX RECEPTACLE MOUNTED AT STANDARD HEIGHT. 'T' DENOTES 20A, T—SLOT TYPE RECEPTACLE
\$	15A, 120V DUPLEX RECEPTACLE MOUNTED AT HIGH LEVEL. 'T' DENOTES 20A, T—SLOT TYPE RECEPTACLE
***	15A, 120V, GFI DUPLEX RECEPTACLE MOUNTED AT HIGH LEVEL. 'T' DENOTES 20A, T—SLOT TYPE RECEPTACLE
	DIRECT POWER CONNECTION
	UNFUSED DISCONNECT SWITCH
	FUSED DISCONNECT SWITCH
	DIRECT POWER CONNECTION COMPLETE UNFUSED DISCONNECT SWITCH
	BLANK COVERPLATE COMPLETE WITH WIRING, CONDUIT, AND BACKBOX
J	ROUND JUNCTION BOX COMPLETE WITH COVERPLATE
J	SQUARE JUNCTION BOX COMPLETE WITH COVERPLATE
	RECESSED ELECTRICAL PANEL, AS SCHEDULED
	SURFACE-MOUNTED ELECTRICAL PANEL, AS SCHEDULED
CC-1	DEVICE/EQUIPMENT CONNECTED TO CIRCUIT #1 IN PANEL 'CC'

	COMMUNICATIONS (VOICE/DATA) LEGEND
$\overline{\nabla}$	DATA OUTLET MOUNTED AT STANDARD HEIGHT ROUGH-IN
▼	TELEPHONE OUTLET MOUNTED AT STANDARD HEIGHT ROUGH-IN
$\bigvee$	DATA OUTLET MOUNTED AT HIGH LEVEL ROUGH-IN
₩	TELEPHONE OUTLET MOUNTED AT HIGH LEVEL ROUGH—IN
WAP	WIRELESS ACCESS POINT COMPLETE WITH CATEGORY 6, FT6 CABLING TO THE HUB RACK
<b>V</b>	TELEPHONE & DATA OUTLET

	DRAWING LIST		
DRAWING NUMBER	DESCRIPTION		
E1	ELECTRICAL LEGEND, NOTES AND SCHEDULE		
E2	BASEMENT LEVEL KEY PLAN		
E3	FIRST FLOOR KEY PLAN		
E4	BASEMENT — NEW ELECTRICAL LAYOUT		
E5	FIRST FLOOR — EXISTING & NEW ELECTRICAL LAYOUTS		

	SYSTEMS DEVICE & EQUIPMENT LEGEND
	THE STORE OF THE S
	MODULAR CONTROL PANEL, SUPPLIED AND INSTALLED BY DIVISION 26
•	DOOR OPERATOR ACTUATOR BUTTON
KS	KEY SWITCH, TIED TO THE DOOR OPERATOR SYSTEM
HD	HAND DRYER, SUPPLIED AND INSTALLED BY DIVISION 26
PL	PUSH-TO-LOCK BUTTON TIED TO THE WASHROOM DOOR OPERATOR SYSTEM
$\bigcirc \vdash$	'OCCUPIED-WHEN-LIT' LED ANNUNCIATOR TIED TO THE WASHROOM DOOR OPERATOR SYSTEM
EH	VISUAL INDICATOR TIED TO THE CALL-FOR-ASSISTANCE SYSTEM
Е	EMERGENCY PUSH-BUTTON TIED TO THE CALL-FOR-ASSISTANCE SYSTEM
)Ót	AUDIBLE/VISUAL INDICATOR

SECURITY SYSTEM LEGEND

CLOCK SYSTEM LEGEND

ANALOG CLOCK, BATTERY OPERATED - WALL-MOUNTED

AUDIO/VISUAL SYSTEM LEGEND

GENERAL

DENOTES DEVICE/EQUIPMENT EQUIPPED WITH A WIREGUARD

DENOTES DEVICE/EQUIPMENT TO BE RELOCATED

DENOTES DEVICE/EQUIPMENT TO REMOVED C/W ALL REDUNDANT

DENOTES RELOCATED POSITION OF AN EXISTING DEVICE/EQUIPMENT

DENOTES EXISTING DEVICE/EQUIPMENT TO BE REPLACED WITH NEW

ACRONYM LEGEND

DENOTES EXISTING DEVICE OR EQUIPMENT TO BE RELOCATED DENOTE EXISTING DEVICE OR EQUIPMENT TO REMAIN

DENOTES EXISTING DEVICE OR EQUIPMENT TO BE REMOVED

DENOTES EXISTING DEVICE OR EQUIPMENT TO BE REPLACED

DENOTES RELOCATED POSITION OF AN EXISTING DEVICE OR EQUIPMENT

DENOTE DEVICE OR EQUIPMENT WITH GFI PROTECTION DENOTES DEVICE OR EQUIPMENT AT HIGH LEVEL

DENOTES NEW DEVICE OR EQUIPMENT DENOTES NIGHT LIGHT FIXTURE

DENOTES ROOFTOP DEVICE OR EQUIPMENT

DENOTES TAMPERPROOF DEVICE OR EQUIPMENT
DENOTES DEVICE OR EQUIPMENT WITH A WIREGUARD
DENOTES WEATHERPROOF TYPE DEVICE OR EQUIPMENT

MASTER CLOCK SYSTEM CONTROLLER

WIRING/RACEWAYS

ABOVE FINISHED FLOOR CONNECT TO EXISTING

T-SLOT, 20A, DEVICE

EQUIPMENT. SIZE AS INDICATED IN THE SCHEDULE.

<u>ACRONYM</u> <u>DESCRIPTION</u>

ANALOG CLOCK, 120V PLUG-IN TYPE COMPLETE WITH SINGLE RECEPTACLE

ANALOG CLOCK, 120V PLUG-IN TYPE COMPLETE WITH SINGLE RECEPTACLE

ANALOG CLOCK TIED TO THE MASTER CLOCK SYSTEM - WALL-MOUNTED

DUAL-FACE ANALOG CLOCK TIED TO THE MASTER CLOCK SYSTEM -

DUAL-FACE ANALOG CLOCK, BATTERY OPERATED - WALL-MOUNTED

EMPTY BACKBOX COMPLETE WITH BLANK COVERPLATE AND 25mmC UP TO

DENOTES NEW DEVICE/EQUIPMENT C/W NEW WIRING AND NEW RACEWAYS

THE ACCESSIBLE CEILING SPACE PROVISION FOR FUTURE AV CABLING

MOTION DETECTOR

ELECTRIC STRIKE

CAMERA

**→**(•)→

**→** MC '

₿во

**-**⊕-B0

INTRUSION ALARM SYSTEM KEY PAD

	FIRE ALARM SYSTEM LEGEND
	RATE-OF-RISE HEAT DETECTOR
	FIXED TEMPERATURE HEAT DETECTOR
•	SMOKE DETECTOR
	PULL STATION C/W TAMPERPROOF, POLYCARBONATE COVER
	FIRE ALARM BELL
	FIRE ALARM HORN/STROBE
S	FIRE ALARM SPEAKER
TL	REMOTE TROUBLE INDICATOR
FS	SPRINKLER/STANDPIPE FLOW SWITCH
SV	SPRINKLER/STANDPIPE SUPERVISED VALVE
	FIRE ALARM ANNUNCIATOR
	FIRE ALARM CONTROL PANEL

	ACCESS CONTROL SYSTEM LEGEND
DB	DOOR BELL
ES	ELECTRIC STRIKE
MS	AIPHONE MASTER STATION
SMS	AIPHONE SUB-MASTER STATION
KP	ALARM KEYPAD
СН	DOOR BELL CHIME
	AUDIBLE/VISUAL ANNUNCIATOR TIED TO THE LOCAL DOOR ALARM SYSTEM

### GENERAL NOTES

- 1. IT IS MANDATORY FOR THE ELECTRICAL CONTRACTOR TO VISIT SITE AND REVIEW EXISTING CONDITIONS AND DEMOLITION SCOPE OF WORK TO SUIT EXISTING ARCHITECTURAL AND STRUCTURAL CONDITIONS AND MECHANICAL DRAWINGS. NO EXTRA WILL SUBSEQUENTLY BE ALLOWED TO COVER ANY SUCH ERROR, OMISSION AND/OR OVERSIGHT FOR NOT HAVING MADE A THOROUGH INSPECTION OF THE GROUNDS, EXISTING CONDITIONS, DRAWINGS, SPECIFICATION AND DESIGN INTENT. THE ELECTRICAL CONTRACTOR SHALL NOTE THAT THE EXISTING BUILDING WILL REMAIN IN OPERATION THROUGHOUT DEMOLITION/CONSTRUCTION. ALLOW FOR ANY WORK REQUIRED TO BE DONE WHICH MAY AFFECT POWER SUPPLY AND OPERATION OF THE BUILDING TO BE CARRIED OUT AFTER HOURS OR AT A TIME CONVENIENT TO THE BUILDING MANAGEMENT. PROVIDE TEMPORARY SERVICES AS REQUIRED TO ENSURE CONTINUED OPERATION AT ALL TIMES
- 2. CAREFULLY EXAMINE OTHER EXISTING UTILITY LINES SUCH AS GAS, WATER ETC. PRIOR TO START THE ELECTRICAL CONSTRUCTION WORKS AND COORDINATE WITH OTHER TRADES AND REPORT OF ANY DISCREPANCY PRIOR TO PROCEEDING.
- THESE DRAWINGS SHALL BE READ & PRICED IN CONJUNCTION WITH ARCHITECTURAL, MECHANICAL, AND AV DRAWINGS AND SPECIFICATIONS. INCLUDE FOR THE SUPPLY AND INSTALLATION OF POWER, SYSTEMS, AND LIGHTING AS PER THE COMPLETE CONSTRUCTION DOCUMENTS. NO EXTRA COST WILL BE ACCEPTED IN FAILURE TO OBTAINING AND/OR REVIEW OF SUCH DOCUMENTS. REFER TO ARCHITECTURAL, AV, ELECTRICAL, AND MECHANICAL LAYOUTS IN CONJUNCTION FOR EXACT LOCATION OF ALL EQUIPMENT. REPORT ANY DISCREPANCIES TO THE ELECTRICAL ENGINEER PRIOR TO COMMENCING WORK. NO EXTRA WILL BE PROVIDED AS A RESULT OF A FAILURE TO DO SO.
- IT IS MANDATORY THAT ELECTRICAL WORK CONFORM TO ALL APPLICABLE CODES (INCLUDING ONTARIO BUILDING, FIRE, AND ELECTRICAL SAFETY CODE), BASE BUILDING STANDARDS, AND THE STANDARDS SET BY ANY AND ALL LOCAL AUTHORITIES HAVING JURISDICTION.
- 5. LOCATIONS OF ALL NEW DISCONNECT SWITCHES AND STARTERS SHALL BE CONFIRMED WITH DIVISION 15 PRIOR TO INSTALLATION. STARTERS FOR EXHAUST FANS SHALL BE SUPPLIED AND INSTALLED BY DIV. 16.
- 3. ALL ELECTRICAL WORK SHALL BE INSPECTED BY THE ELECTRICAL SAFETY AUTHORITY (ESA).

  7. CONTRACTOR IS RESPONSIBLE FOR HIRING A FIRE WATCH AS REQUIRED BY CODE, LOCAL AUTHORITIES HAVING JURISDICTION, OR AS MANDATED BY THE PROPERTY MANAGER DURING ANY ALTERATION OR DOWNTIME OF THE FIRE ALARM SYSTEM.
- 8. CONTRACTOR MUST REVIEW CITY OF TORONTO STANDARDS AND PRIOR TO PRICING. ALL CONSTRUCTION MUST ABIDE BY CITY OF TORONTO STANDARDS. INCLUDE FOR ANY SUCH ITEMS MANDATED BY THE CITY IN THE TENDER PRICING.

### MECHANICAL FOLLIPMENT WIRING SCHEDLILE

MECHANICAL EQUIPMENT WIRING SCHEDULE										
EQUIPMENT DESCRIPTION	STARTER LOCATION	STARTER TYPE	MCA/HP/KW	VOLTS/PH./ FREQUENCY	BREAKER SIZE OR FUSE SIZE	FEEDER SIZE	PANEL AND CCT. NOS.	REMARKS	FIRE ALARM FAN SHUTDOWN [AHU/EF ONLY]	TIED TO BAS SYSTEM?
EXHAUST FAN 'EF-1'	SEE PLAN	MAGNETIC	FRACTIONAL	120V/1PH/60Hz	15A-1P	2#12 RW90+G IN 21mmC	CIRCUIT J-37	ELECTRICAL DIVISION SHALL PROVIDE POWER CONNECTION TO THE AIR HANDLING UNIT. PROVIDE A LOCAL DISCONNECT SWITCH.	NO	NO
EXHAUST FAN 'EF-2'	SEE PLAN	MAGNETIC	FRACTIONAL	120V/1PH/60Hz	15A-1P	2#12 RW90+G IN 21mmC	CIRCUIT J-39	ELECTRICAL DIVISION SHALL PROVIDE POWER CONNECTION TO THE AIR HANDLING UNIT. PROVIDE A LOCAL DISCONNECT SWITCH.	NO	NO
EXHAUST FAN 'EF-3'	SEE PLAN	MAGNETIC	FRACTIONAL	120V/1PH/60Hz	15A-1P	2#12 RW90+G IN 21mmC	CIRCUIT J-41	ELECTRICAL DIVISION SHALL PROVIDE POWER CONNECTION TO THE AIR HANDLING UNIT. PROVIDE A LOCAL DISCONNECT SWITCH.	NO	NO
EXHAUST FAN 'EF-4'	SEE PLAN	MAGNETIC	FRACTIONAL	120V/1PH/60Hz	15A-1P	2#12 RW90+G IN 21mmC	CIRCUIT K-2	ELECTRICAL DIVISION SHALL PROVIDE POWER CONNECTION TO THE AIR HANDLING UNIT. PROVIDE A LOCAL DISCONNECT SWITCH.	NO	NO

- 1. PROVIDE POWER CONNECTION TO ALL MECHANICAL EQUIPMENT LISTED IN THE SCHEDULE FOR A FULL OPERATIONAL SYSTEM. REFER TO MECHANICAL LAYOUTS AND SCHEDULES FOR EXACT LOCATION OF EQUIPMENT. PROVIDE SEPARATE BREAKER FOR INDIVIDUAL MECHANICAL
- 2. ALL LOOSE STARTERS (MANUAL OR MAGNETIC TYPE AS STATED) SHALL BE SUPPLIED AND INSTALLED BY DIVISION 26. STARTER LOCATIONS SHALL BE VERIFIED AND CO-ORDINATED WITH DIVISION 23 AND CONSULTANT ON SITE. INTEGRAL STARTER WILL BE BUILT—IN THE MECHANICAL EQUIPMENT AND SUPPLIED & INSTALLED BY THE EQUIPMENT MANUFACTURER. ACCEPTABLE MANUFACTURER FOR LOOSE STARTERS SHALL BE CUTLER HAMMER, SIEMENS SQUARE D AND KLOCKNER MOELLER. ALL MAGNETIC STARTER SHALL BE C/W OVERLOAD PROTECTION, H/O/A SWITCH AND GREEN—RUN AND RED—STOP PILOT LAMPS. ALL MANUAL STARTERS SHALL BE C/W OVERLOAD PROTECTION AND GREEN—RUN AND RED—STOP PILOT LAMP.
- 3. PROVIDE A LOCAL DISCONNECT SWITCH FOR ALL MECHANICAL EQUIPMENT IN THIS SCHEDULE, UNLESS IT IS NOTED THAT THE DISCONNECT SWITCH IS TO BE PROVIDED BY THE EQUIPMENT MANUFACTURER. DISCONNECT SWITCH SHALL BE SEPARATE FROM THE STARTER SERVING THE RESPECTIVE EQUIPMENT. NOTE THAT DISCONNECT SWITCHES ARE NOT ILLUSTRATED ON THE FLOOR PLAN (FOR CLARITY), HOWEVER MUST BE SUPPLIED AND INSTALLED BY DIVISION 26 FOR ALL MECHANICAL EQUIPMENT LISTED IN THE ABOVE SCHEDULE.
- 4. THE ELECTRICAL CONTRACTOR WILL BE RESPONSIBLE FOR REVIEWING ALL MECHANICAL SHOP DRAWINGS WITH RESPECT TO RELEVANT ELECTRICAL INFORMATION PRIOR TO THE SHOP DRAWINGS BEING SUBMITTED TO THE MECHANICAL AND ELECTRICAL ENGINEER FOR REVIEW. NO EQUIPMENT SHALL BE ORDERED PRIOR TO SUBMITTING SHOP DRAWINGS BACK APPROVED BY BOTH THE MECHANICAL ENGINEER. THE ELECTRICAL CONTRACTOR IS RESPONSIBLE FOR WORKING WITH EACH MANUFACTURER OR MECHANICAL EQUIPMENT AND GATHERING THE 'MCA' AND 'MOP' OF ALL EQUIPMENT AND LISTING IT ON THE SHOP DRAWING FOR EACH MECHANICAL EQUIPMENT PRIOR TO SUBMITTING SHOP DRAWINGS FOR REVIEW.
- 5. THE STARTER LOCATION AND TYPE LISTED ABOVE IS FOR INFORMATIONAL PURPOSES ONLY. THE CONTRACTOR SHALL REFER TO MECHANICAL DRAWINGS FOR EXACT EQUIPMENT LOCATIONS AND MANUFACTURER CUT SHEETS AND EQUIPMENT DATA SHEETS FOR STARTER INFORMATION. NO EXTRA WILL BE PERMITTED AS A RESULT OF A FAILURE TO DO SO.


# GENERAL NOTES:

CONTRACTORS SHALL VERIFY AND BE RESPONSIBLE FOR ALL DIMENSIONS AND CONDITIONS ON THE JOB AND THE ENGINEER SHALL BE INFORMED OF ANY VARIATIONS FROM THE DIMENSIONS AND CONDITIONS SHOWN ON THE DRAWINGS. DO NOT SCALE DRAWINGS. SHOP DRAWINGS SHALL BE SUBMITTED TO THE ENGINEER FOR APPROVAL BEFORE PROCEEDING WITH FABRICATION. THIS DRAWING IS THE PROPERTY OF SURI & ASSOCIATES LTD. AND SHALL NOT BE REPRODUCED WITHOUT THEIR PERMISSION AND UNLESS THE REPRODUCTION CARRIES THEIR NAME. ALL INFORMATION SHOWN ON THIS DRAWING IS FOR USE ON THE SPECIFIED PROJECT ONLY AND SHALL NOT BE USED OTHERWISE WITHOUT WRITTEN PERMISSION OF SURI & ASSOCIATES LTD.

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Contractors shall verify all dimensions at the job.



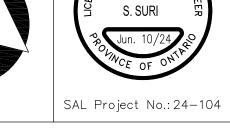

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ENGINEERING CONSULTANTS

1018 ALBERTSON CRESCENT MISSISSAUGA, ONTARIO L5H 3C7 T (905)-290-7861 ELECTRICAL MECHANICAL LIGHTING COMMUNICATION SECURITY



roject

BIRCHMOUNT COMMUNITY CENTRE
93 BIRCHMOUNT ROAD,


POOL HVAC IMPROVEMENTS

Drawing Title

ELECTRICAL LEGEND, NOTES AND SCHEDULE

TORONTO, ONTARIO. M1N 3J7

Checked:	Date:
RS	MAY 2024
Drawn:	Scale:
RS	AS NOTED
File Number:	Dwg Number:

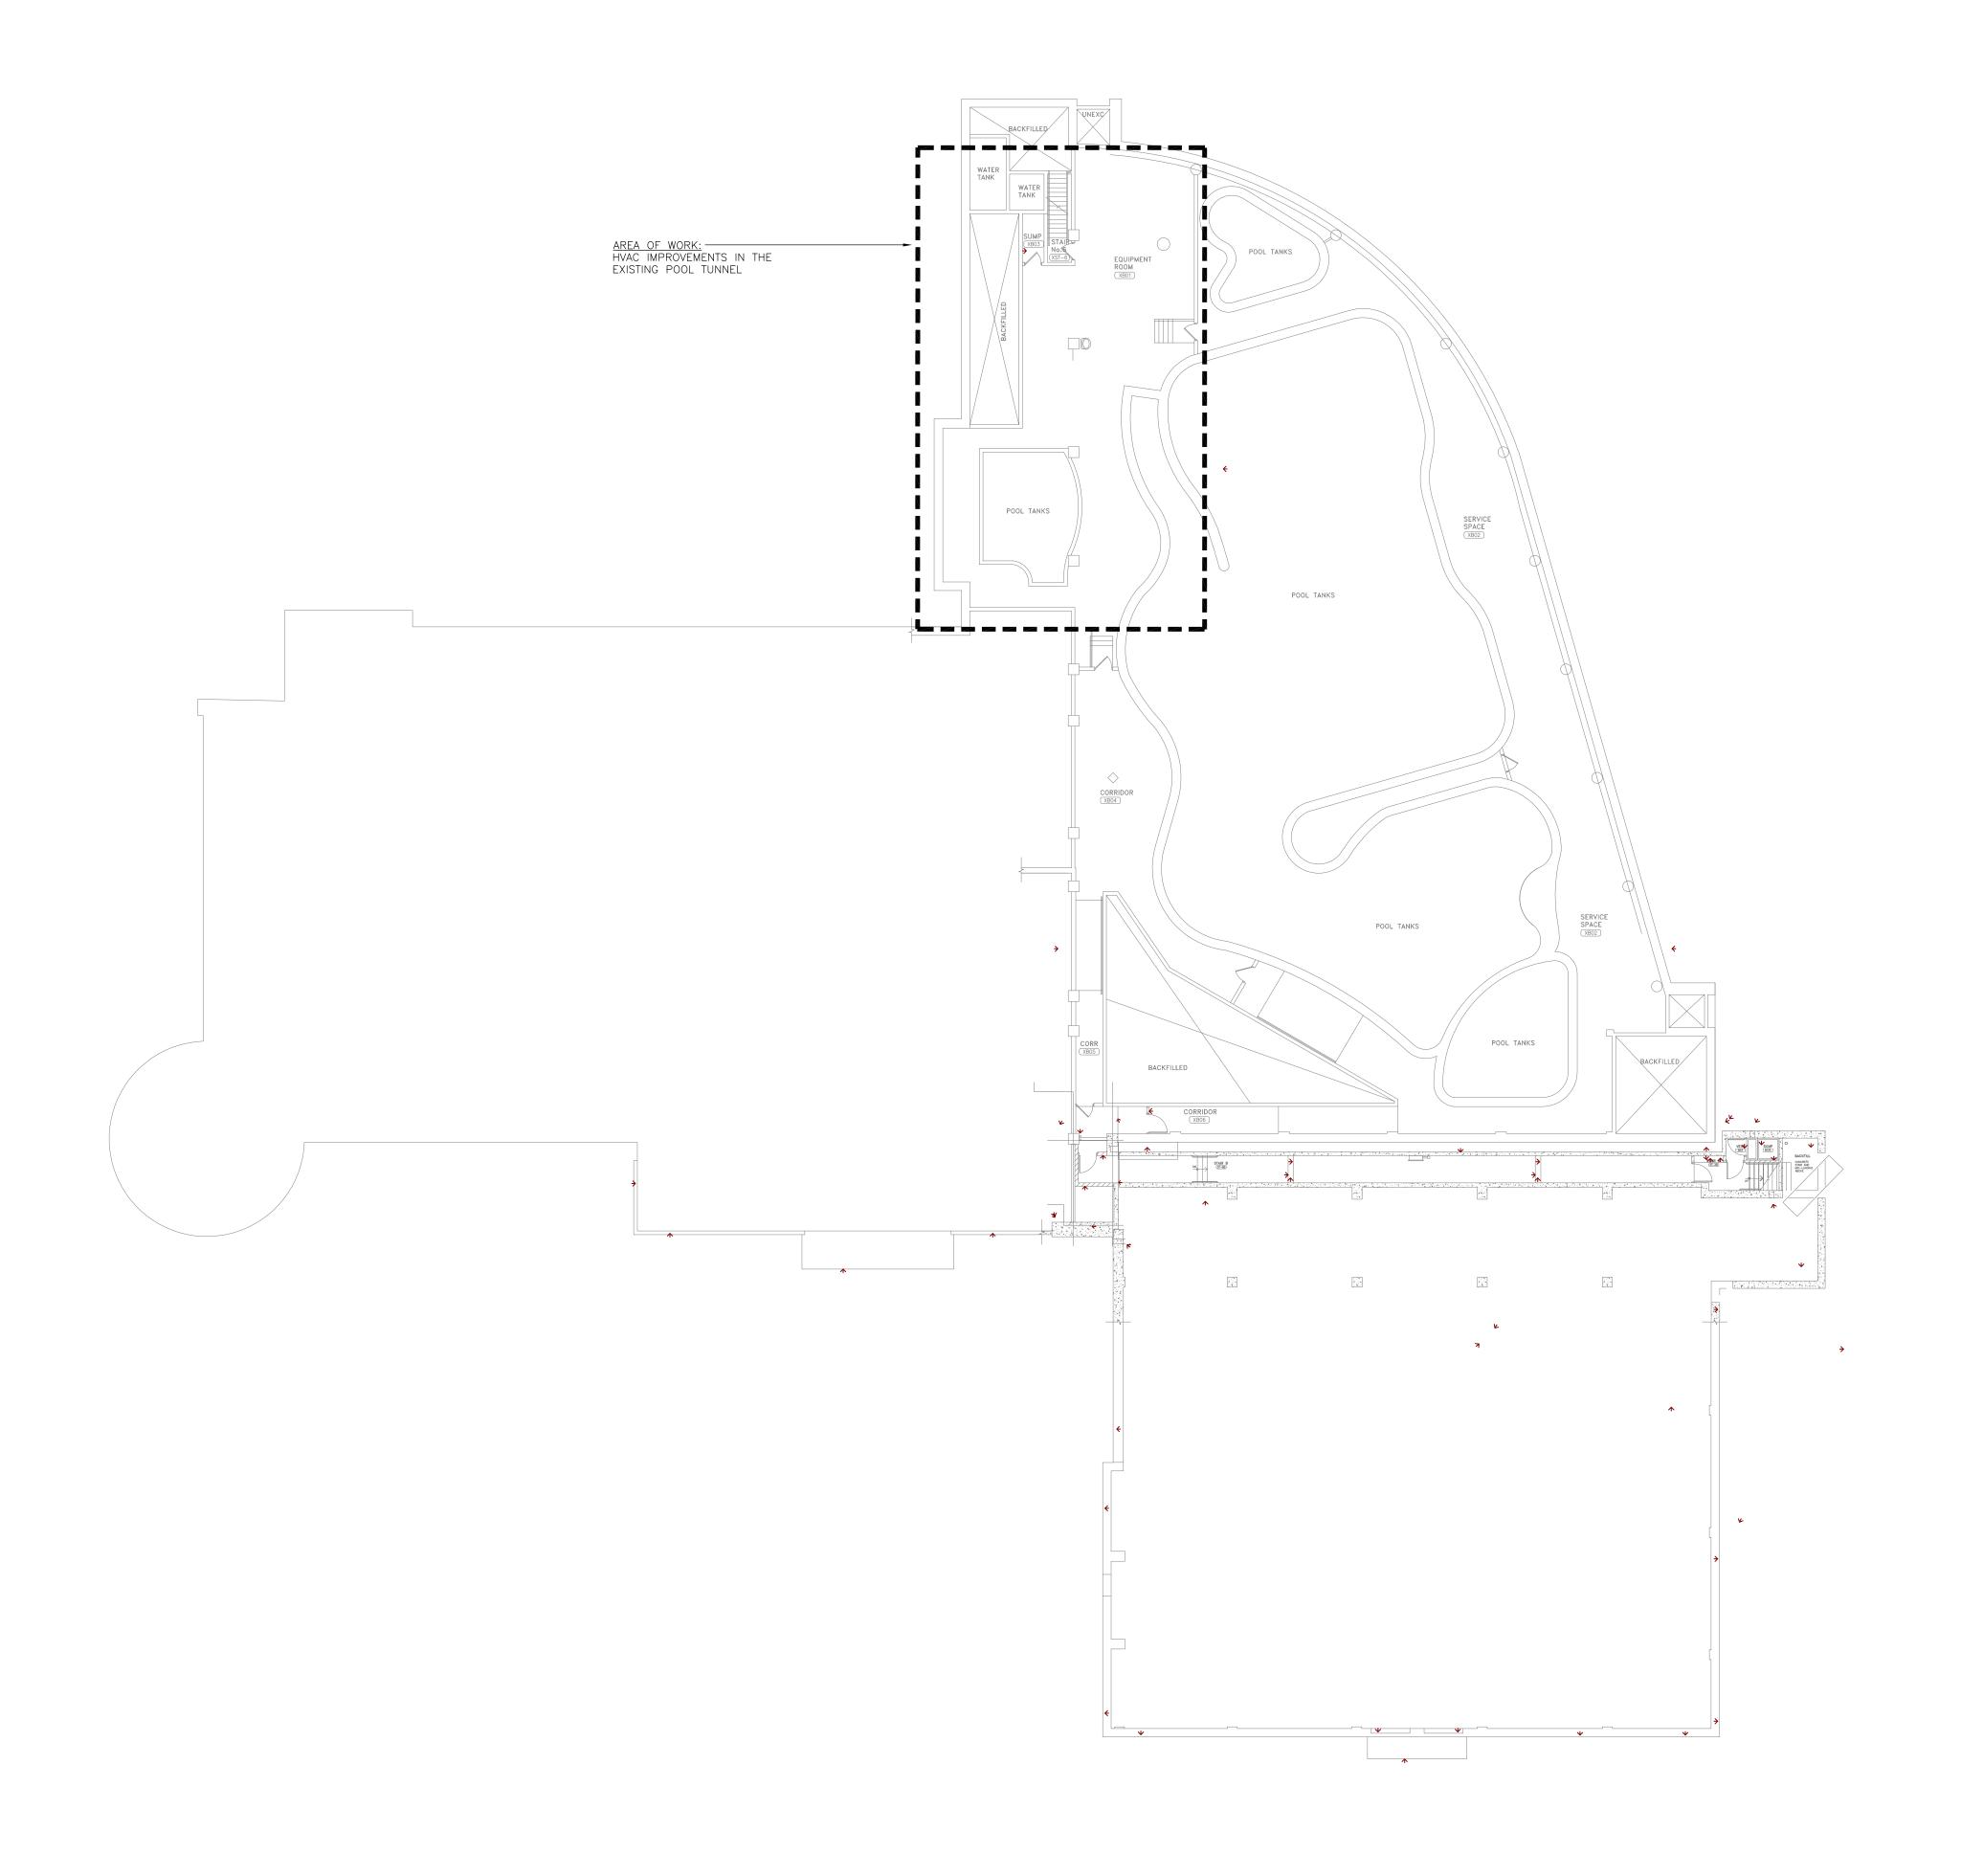

1 BASEMENT LEVEL KEY PLAN
E2 SCALE: 1:200

# GENERAL NOTES:

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Project


BIRCHMOUNT COMMUNITY
CENTRE
93 BIRCHMOUNT ROAD,
TORONTO, ONTARIO. M1N 3J7

POOL HVAC IMPROVEMENTS

Drawing Title

BASEMENT LEVEL KEY PLAN

Checked:	Date:
RS	MAY 2024
Drawn:	Scale:
RS	AS NOTED
File Number:	Dwg Number:
	E2

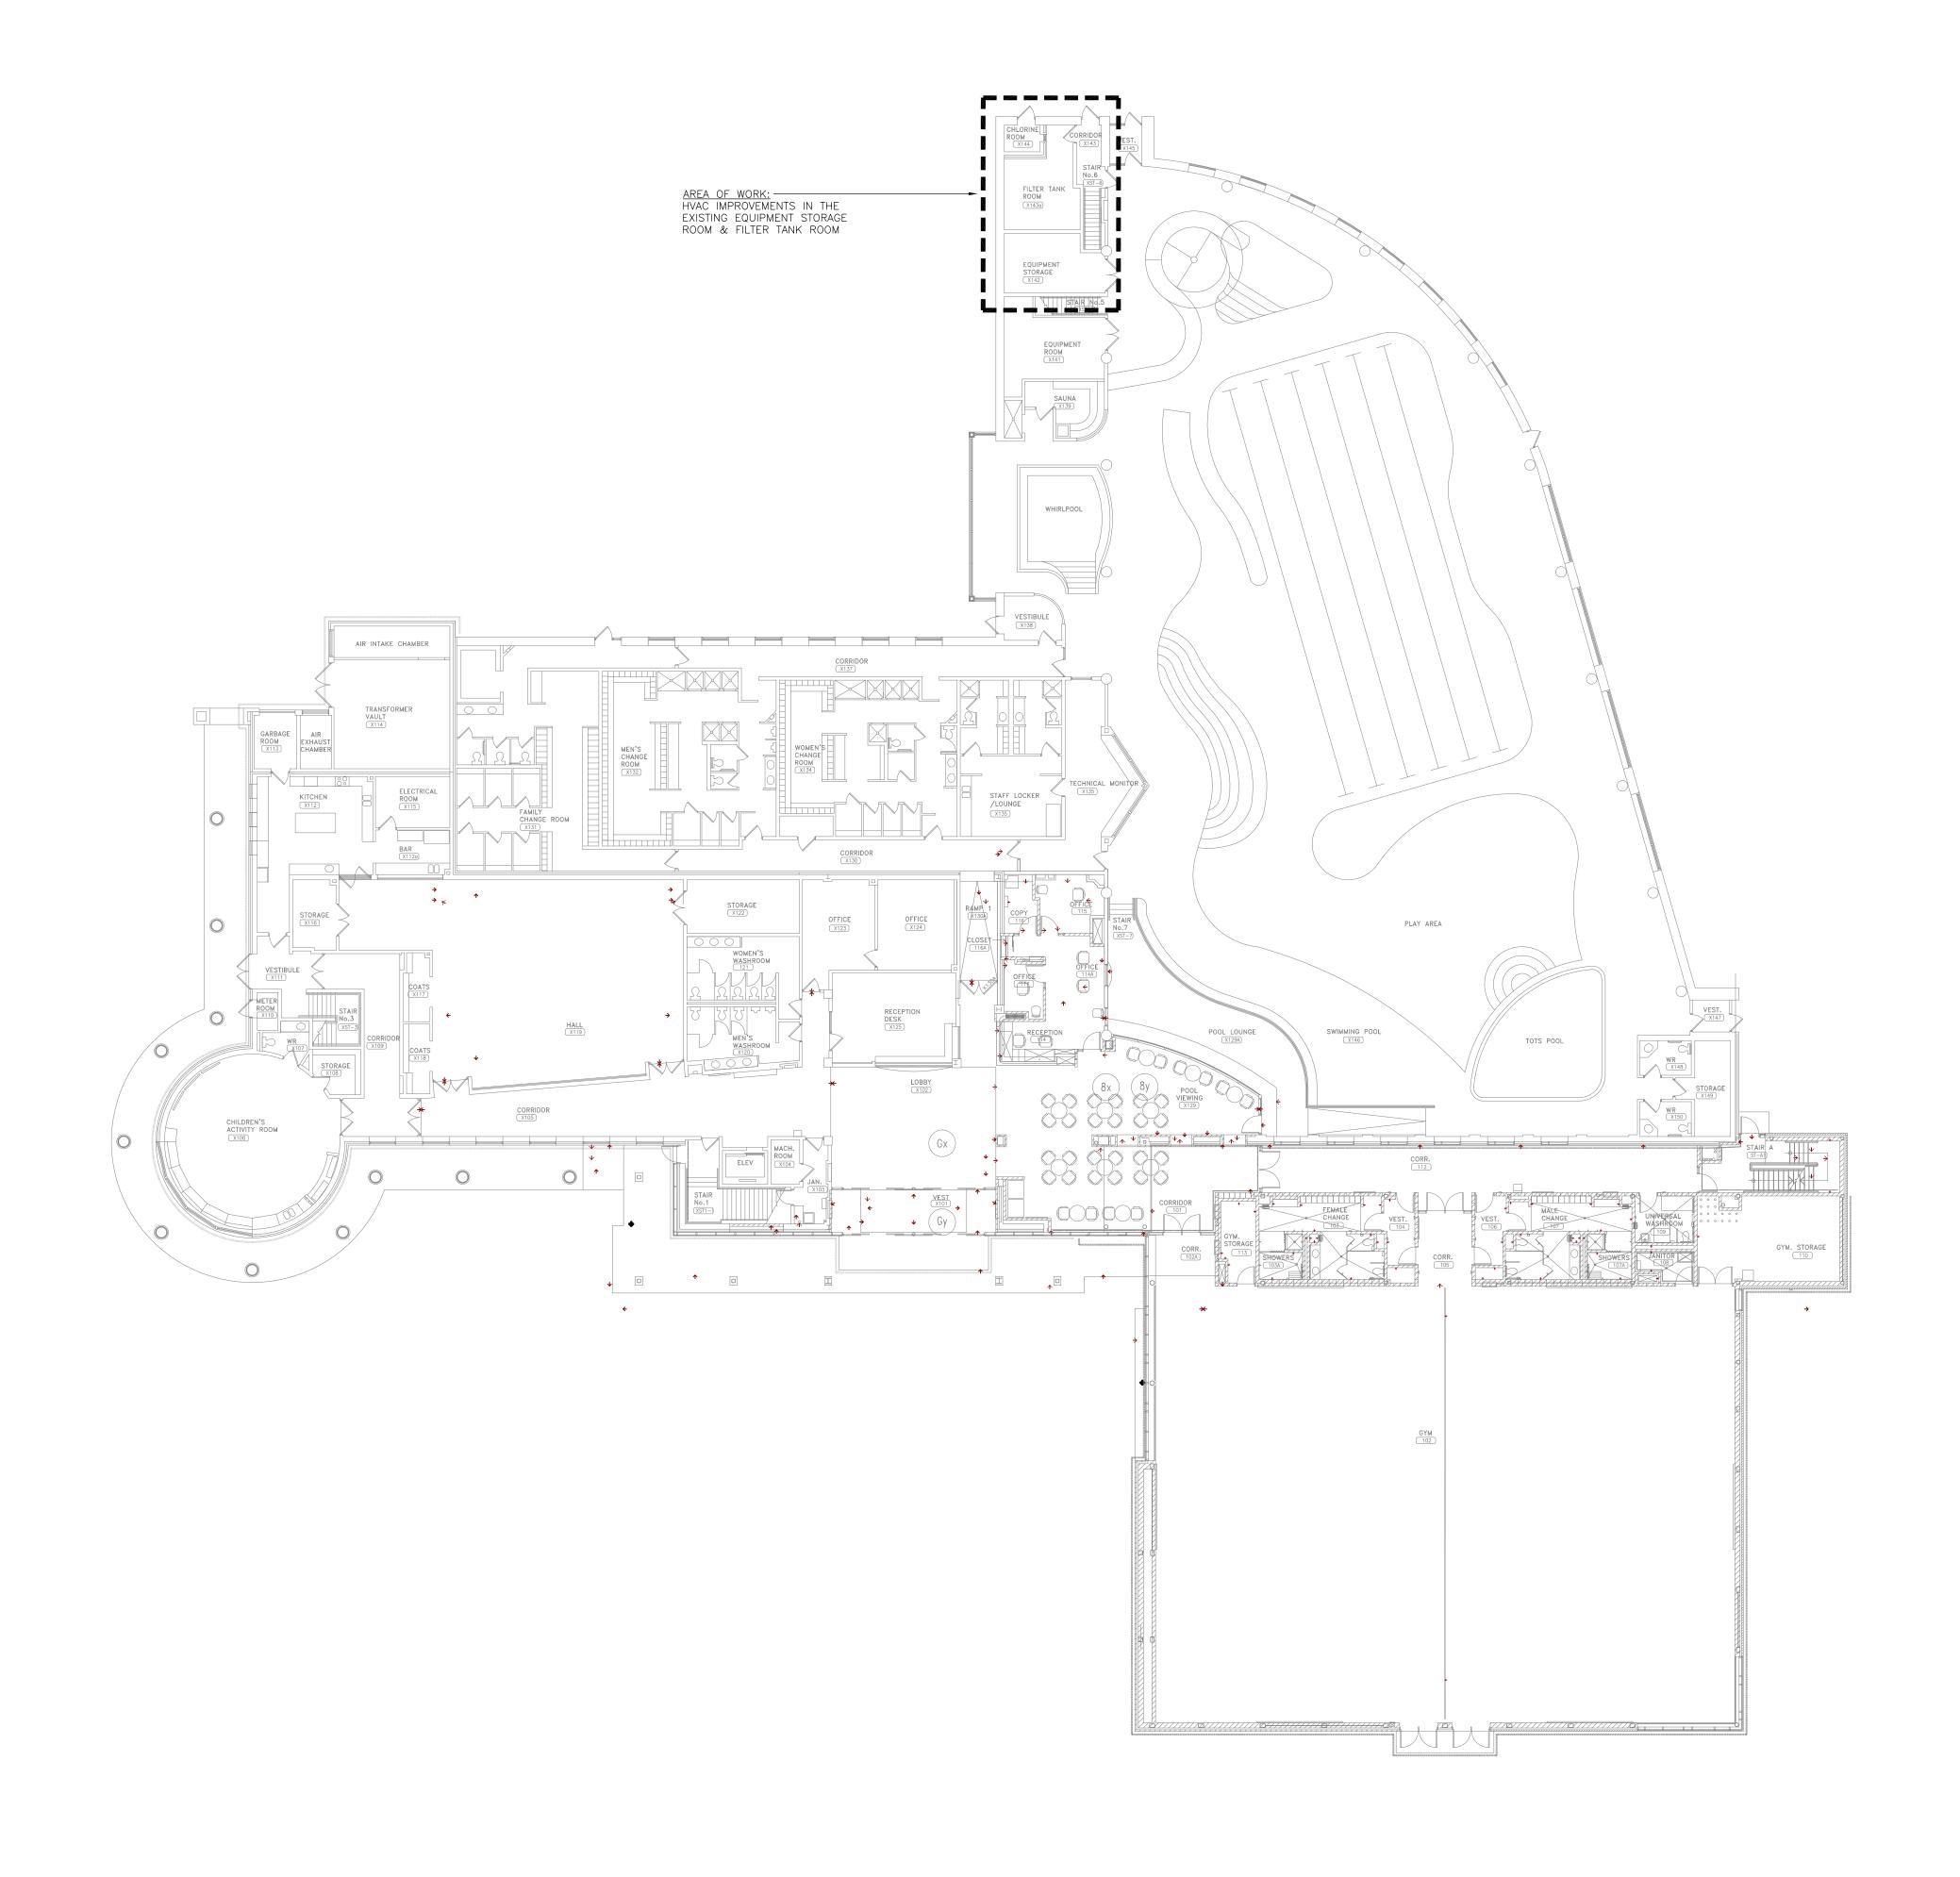

1 FIRST FLOOR KEY PLAN E3 SCALE: 1:200

# **GENERAL NOTES:**

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ELECTRICAL MECHANICAL LIGHTING COMMUNICATION SECURITY



Project


BIRCHMOUNT COMMUNITY CENTRE 93 BIRCHMOUNT ROAD, TORONTO, ONTARIO. M1N 3J7

POOL HVAC IMPROVEMENTS

Drawing Title

FIRST FLOOR KEY PLAN

Checked:	Date:
RS	MAY 2024
Drawn:	Scale:
RS	AS NOTED
File Number:	Dwg Number:
	E3

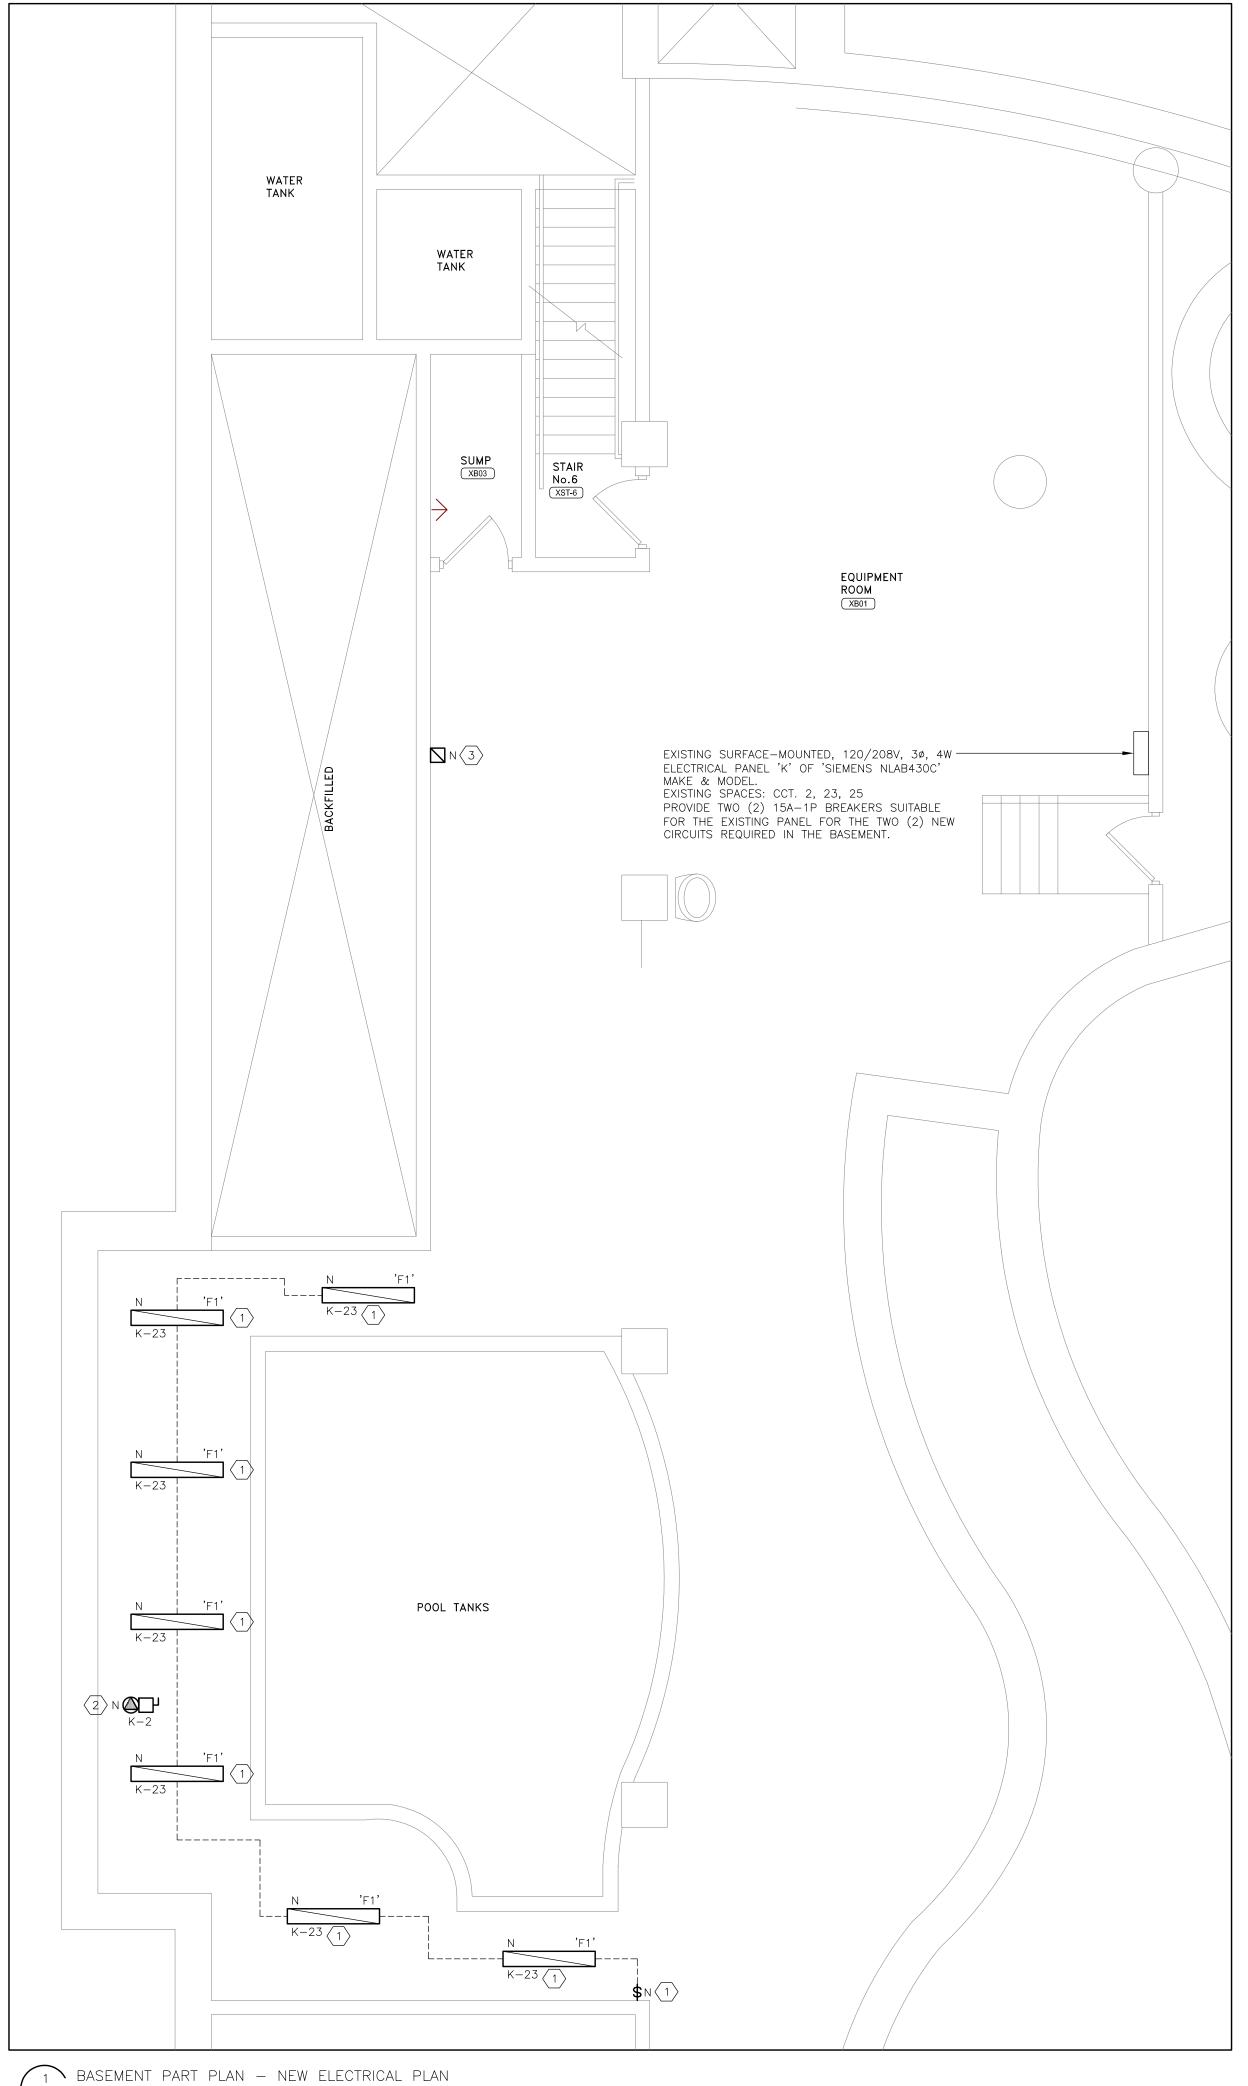

E4 SCALE: 1:50

PROVIDE NEW LIGHT FIXTURES THROUGHOUT THE POOL TUNNEL AS SHOWN. THE POOL TUNNEL IS CURRENTLY VERY POORLY LIT. CONNECT LIGHTING TO A NEW DEDICATED CIRCUIT IN PANEL 'K'; PROVIDE A NEW 15A-1P BREAKER SUITABLE FOR THE PANEL. PROVIDE A NEW LINE—VOLTAGE ON/OFF TOGGLE LIGHT SWITCH WHERE SHOWN. ALL CONDUIT SHALL BE OF ALUMIMUM CONSTRUCTION. ALL FIXTURES SHALL BE SUPPORTED USING ADJUSTABLE AIR CRAFT CABLE. INSTALL LIGHT FIXTURES BELOW AND TO CLEAR ALL EXISTING OBSTRUCTIONS. SITE VERIFY AND COORDNIATE EXACT POSITIONING AND MOUNTING HEIGHTS.

LIGHT FIXTURE TYPE 'F1' SHALL BE LITHONIA CLX-L48-4000LM-HEF-MVOLT-GZ10-40K-80CRI OR EQUAL FROM COOPER OR PEERLESS ELECTRIC

- PROVIDE 120V POWER CONNECTION COMPLETE WITH LOCAL DISCONNECT SWITCH TO THE NEW IN-LINE EXHAUST FAN 'EF-4'. CONNECT THE EXHAUST FAN TO A NEW DEDICATED CIRCUIT IN PANEL 'K'; PROVIDE A NEW 15A-1P BREAKER SUITABLE FOR THE PANEL. ALL CONDUIT SHALL BE OF ALUMIMUM CONSTRUCTION. ELECTRICAL CONTRACTOR TO PROVIDE BONDING OF THE NEW DUCTWORK ASSOCIATED WITH EXHAUST FAN 'EF-4' (SEE MECHANICAL DRAWINGS) TO THE EXISTING BUILDING GROUND IN ACCORDANCE WITH THE ONTARIO ELECTRICAL SAFETY CODE.
- $\sqrt{3}$  Location of New Starter for exhaust fan 'ef-4'.

**GENERAL NOTES:** 

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ELECTRICAL
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LIGHTING
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Project

BIRCHMOUNT COMMUNITY CENTRE 93 BIRCHMOUNT ROAD, TORONTO, ONTARIO. MÍN 3J7

POOL HVAC IMPROVEMENTS

Drawing Title

BASEMENT — NEW ELECTRICAL LAYOUT

Date:	
MAY 2024	
Scale:	
AS NOTED	
Dwg Number:	
E4	



#### DRAWING NOTES:

- DISCONNECT POWER CONNECTION TO THE EXISTING EXHAUST FAN 'EF-1' SERVING THE SERVICE ROOM EXHAUST. REMOVE ALL REDUNDANT WIRING/RACEWAYS TO THE EXISTING SOURCE.
- REMOVE THE EXISTING STARTER SERVING THE EXISTING EXHAUST FAN 'EF-1'. REMOVE ALL REDUNDANT WIRING/RACEWAYS TO THE EXISTING SOURCE.
- PROVIDE 120V POWER CONNECTION COMPLETE WITH LOCAL DISCONNECT SWITCH TO THE NEW IN-LINE EXHAUST FAN 'EF-1'. CONNECT THE EXHAUST FAN TO A NEW DEDICATED CIRCUIT IN PANEL 'J'; PROVIDE A NEW 15A-1P BREAKER SUITABLE FOR THE PANEL. ALL CONDUIT SHALL BE OF ALUMIMUM CONSTRUCTION. ELECTRICAL CONTRACTOR TO PROVIDE BONDING OF THE NEW DUCTWORK ASSOCIATED WITH EXHAUST FAN 'EF-1' (SEE MECHANICAL DRAWINGS) TO THE EXISTING BUILDING GROUND IN ACCORDANCE WITH THE ONTARIO ELECTRICAL SAFETY CODE.
- PROVIDE 120V POWER CONNECTION COMPLETE WITH LOCAL DISCONNECT SWITCH TO THE NEW IN-LINE EXHAUST FAN 'EF-2'. CONNECT THE EXHAUST FAN TO A NEW DEDICATED CIRCUIT IN PANEL 'J'; PROVIDE A NEW 15A-1P BREAKER SUITABLE FOR THE PANEL. ALL CONDUIT SHALL BE OF ALUMIMUM CONSTRUCTION. ELECTRICAL CONTRACTOR TO PROVIDE BONDING OF THE NEW DUCTWORK ASSOCIATED WITH EXHAUST FAN 'EF-2' (SEE MECHANICAL DRAWINGS) TO THE EXISTING BUILDING GROUND IN ACCORDANCE WITH THE ONTARIO ELECTRICAL SAFETY CODE.
- PROVIDE 120V POWER CONNECTION COMPLETE WITH LOCAL DISCONNECT SWITCH TO THE NEW IN-LINE EXHAUST FAN 'EF-3'. CONNECT THE EXHAUST FAN TO A NEW DEDICATED CIRCUIT IN PANEL 'J'; PROVIDE A NEW 15A-1P BREAKER SUITABLE FOR THE PANEL. ALL CONDUIT SHALL BE OF ALUMIMUM CONSTRUCTION. ELECTRICAL CONTRACTOR TO PROVIDE BONDING OF THE NEW DUCTWORK ASSOCIATED WITH EXHAUST FAN 'EF-3' (SEE MECHANICAL DRAWINGS) TO THE EXISTING BUILDING GROUND IN ACCORDANCE WITH THE ONTARIO ELECTRICAL SAFETY CODE.
- 6 Location of New Starter for exhaust fan 'ef-1'.
- $\overline{\langle 7 \rangle}$  Location of New Starter for exhaust fan 'ef-2'.
- $\langle 8 \rangle$  LOCATION OF NEW STARTER FOR EXHAUST FAN 'EF-3'.

### **GENERAL NOTES:**

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ELECTRICAL

MECHANICAL LIGHTING

SECURITY

COMMUNICATION



Project

BIRCHMOUNT COMMUNITY CENTRE 93 BIRCHMOUNT ROAD,

TORONTO, ONTARIO. M1N 3J7
POOL HVAC IMPROVEMENTS

Drawing Title

FIRST FLOOR — EXISTING & NEW ELECTRICAL LAYOUTS

Date:	
MAY 2024	
Scale:	
AS NOTED	
Dwg Number:	
E5	