

LOCATION PLAN

**KEY PLAN** 

AREA OF WORK: 187 m<sup>2</sup> (2,010 sq. ft. USEABLE)

AREA NOT IN CONTRACT

#### SCOPE OF WORK

#### A. INTERIOR ALTERATION TO GROUP D OCCUPANCY:

- INTERIOR RENOVATION DEMOLITION OF EXISTING PARTITIONS AND DOORS
- NEW PARTITIONS AND DOORS NEW PLUMBING FOR NEW SHOWERS

#### **DRAWING LIST**

INTERIOR DESIGN ID0 COVER PAGE

ID1 DEMOLITION AND PARTITION PLANS

ID2 POWER AND COMMUNICATIONS PLAN; REFLECTED CEILING PLAN

ID3 FINISHES PLAN AND DOOR SCHEDULE ID4 SHOWER DETAILS

F1 FURNITURE PLAN

MECHANICAL

REFER TO MECHANICAL DRAWINGS FOR COVER PAGE DRAWING LIST

REFER TO ELECTRICAL DRAWINGS FOR COVER PAGE DRAWING LIST

#### PROJECT CONTACT

INTERIOR DESIGN COMLEY VAN BRUSSEL DESIGN 2600 SKYMARK AVENUE, BUILDING 8, SUITE 101 MISSISSAUGA, ON L4W 5B2 CONTACT: DARCEL LeBLANC-YOUNG

LANDLORD PEEL REGIONAL POLICE 7150 MISSISSAUGA ROAD

dleblanc-young@comleyvanbrussel.com

MISSISSAUGA, ON L5N8M5 CONTACT: ANDREW COBER 3076C@peelpolice.ca

MECHANICAL & ELECTRICAL TANCO ENGINEERING LTD. 80 NASHDENE RD, 2ND FLR., STE 213 TORONTO, ON M1V 5E4

tanco@tancoengineering.ca NORRIS FIRE CONSULTING 1840 CLEMENTS RD., STE 202

CONTACT: MIKE CHONG

PICKERING, ON L1W 3Y2

CONTACT: MBJ NORRIS 905-669-5154

#### **GENERAL NOTES**

#### TENDERING, PERMITS AND INSPECTIONS, COMPLIANCE OF WORK:

- 1. NO DEMOLITION OR CONSTRUCTION IS TO START WITHOUT ISSUANCE OF A BUILDING PERMIT. 2. THE CONTRACTOR SHALL GIVE ALL REQUIRED NOTICES FOR INSPECTIONS AS REQUIRED BY THE BUILDING PERMIT AND ALL
- AUTHORITIES HAVING JURISDICTION.
- 3. UPON COMPLETION OF THE WORK, THE CONTRACTOR SHALL PAY FOR, AND OBTAIN, A SIGNED RELEASE FROM THE
- MUNICIPALITY HAVING JURISDICTION INDICATING THAT ALL WORK IS COMPLETED AND THE PERMIT IS SIGNED OFF. 4. ALL WORK IN THIS CONTRACT SHALL CONFORM TO THE REQUIREMENTS OF ALL EXISTING BY-LAWS, CODES, MUNICIPAL
- GOVERNMENTS AND JURISDICTIONS HAVING AUTHORITY OVER THIS PROJECT. 5. CONTRACTOR IS TO COMPLY WITH ALL BASE BUILDING WORK REGULATIONS AND PROCEDURES. REFER TO TENANT GUIDELINES
- AND/OR CO-ORDINATE WITH PROPERTY MANAGER.

#### SITE MEETINGS:

SCALE: 1/16"=1'-0"

- 1. THE GENERAL CONTRACTOR, DURING THE COURSE OF THE WORK, SHALL CO-ORDINATE REGULARLY SCHEDULED SITE
- 2. IT IS THE GENERAL CONTRACTORS RESPONSIBILITY TO CHAIR, RECORD AND DISTRIBUTE MEETING. MINUTES INCLUSIVE OF SCHEDULE UPDATES.

#### CO-ORDINATION OF THE WORK:

- 1. IT IS THE GENERAL CONTRACTORS RESPONSIBILITY TO ENSURE THAT THE CONTRACT DOCUMENTS ARE MADE AVAILABLE TO ALL TRADES IN ORDER TO ENSURE INCLUSION OF ALL ASPECTS OF THE WORK.
- 2. ALL DRAWINGS AND SPECIFICATIONS MUST BE REVIEWED IN CONJUNCTION WITH ALL OTHER DRAWINGS OF ALL CONSULTANTS INCLUDING BUT NOT LIMITED TO MECHANICAL AND ELECTRICAL ENGINEERING DRAWINGS AND SPECIFICATIONS. EXTRAS FOR MISSED WORK THAT WAS COVERED ON ANY OF THE DRAWINGS EVEN IF NOT COVERED IN ALL OF THE DRAWINGS WILL NOT BE
- 3. ANY CONFLICTS, DISCREPANCIES AND/OR OMISSIONS ARE TO BE REPORTED TO COMLEY VAN BRUSSEL DESIGN AND MANAGEMENT FOR CLARIFICATIONS PRIOR TO PROCEEDING WITH ANY WORK.


#### SITE MAINTENANCE, PROTECTION AND CLEANING:

- 1. THE GENERAL CONTRACTOR SHALL PROTECT ALL FINISHED AREAS DURING THE SCOPE OF THE PROJECT. ANY RESULTANT DAMAGE SHALL BE MADE GOOD BY THE GENERAL CONTRACTOR TO THE SATISFACTION OF THE DESIGNER.
- 2. CONTRACTOR IS TO PROVIDE PROTECTION TO ANY BASE BUILDING ELEMENTS DURING THE SCOPE OF THE PROJECT. 3. THE GENERAL CONTRACTOR IS RESPONSIBLE FOR THE REMOVAL, SAFE STORAGE AND RE-INSTALLATION OF CEILING TILES AS
- REQUIRED FOR THE SUB-TRADES TO COMPLETE THEIR WORK. 4. ALL DEBRIS SHALL BE REMOVED FROM SITE ON A DAILY BASIS. SITE TO BE LEFT BROOM CLEAN DAILY.
- 5. CONTRACTOR IS TO INCLUDE FOR ALL NECESSARY AND REQUIRED MEANS TO MAINTAIN A CLEAN WORK SITE AND FOR THE REMOVAL OF DEBRIS AND RUBBISH INCLUDING BUT NOT LIMITED TO GARBAGE CHUTES AND DISPOSAL BINS.


6. EXITS AND POINTS OF EGRESS SHALL BE CLEARLY IDENTIFIED AND MAINTAINED ACCESSIBLE DURING THE PROJECT.

#### DEMOLITION AND CONSTRUCTION:

- 1. DESIGNATED MATERIALS (E.G. ASBESTOS): IMMEDIATELY REPORT THE DISCOVERY OF DM'S AND STOP WORK IN THE AREA UNTIL THE BUILDING MANAGER OR OWNER AUTHORIZES OTHERWISE. ALL CLEAN UP, REMOVAL AND DISPOSAL OF DM'S SHALL
- CONFORM TO THE ONTARIO MINISTRY OF LABOUR CURRENT REGULATIONS. 2. FIREPROOFING: PATCH AND REPAIR ALL FIREPROOFING DAMAGED DURING THE CONSTRUCTION.

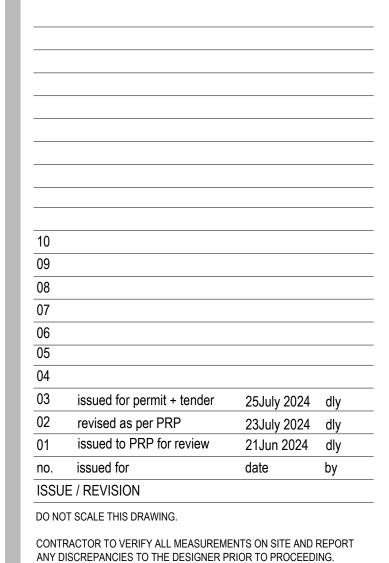

ALL DRAWINGS REMAIN THE PROPERTY OF COMLEY VAN BRUSSEL DESIGN. ALL PREVIOUS ISSUES OF THIS DRAWING ARE SUPERCEDED.

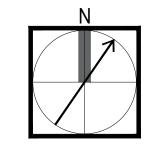





2600 skymark ave., bldg. 8, ste. 101 | mississauga, ON L4W 5B2 telephone: 416.621.7745 | email: design@comleyvanbrussel.com


project PEEL REGIONAL POLICE 3030 Erin Mills Parkway Mississauga, ON Basement

**COVER PAGE** 

drawn by project no 24-3538 sheet no.

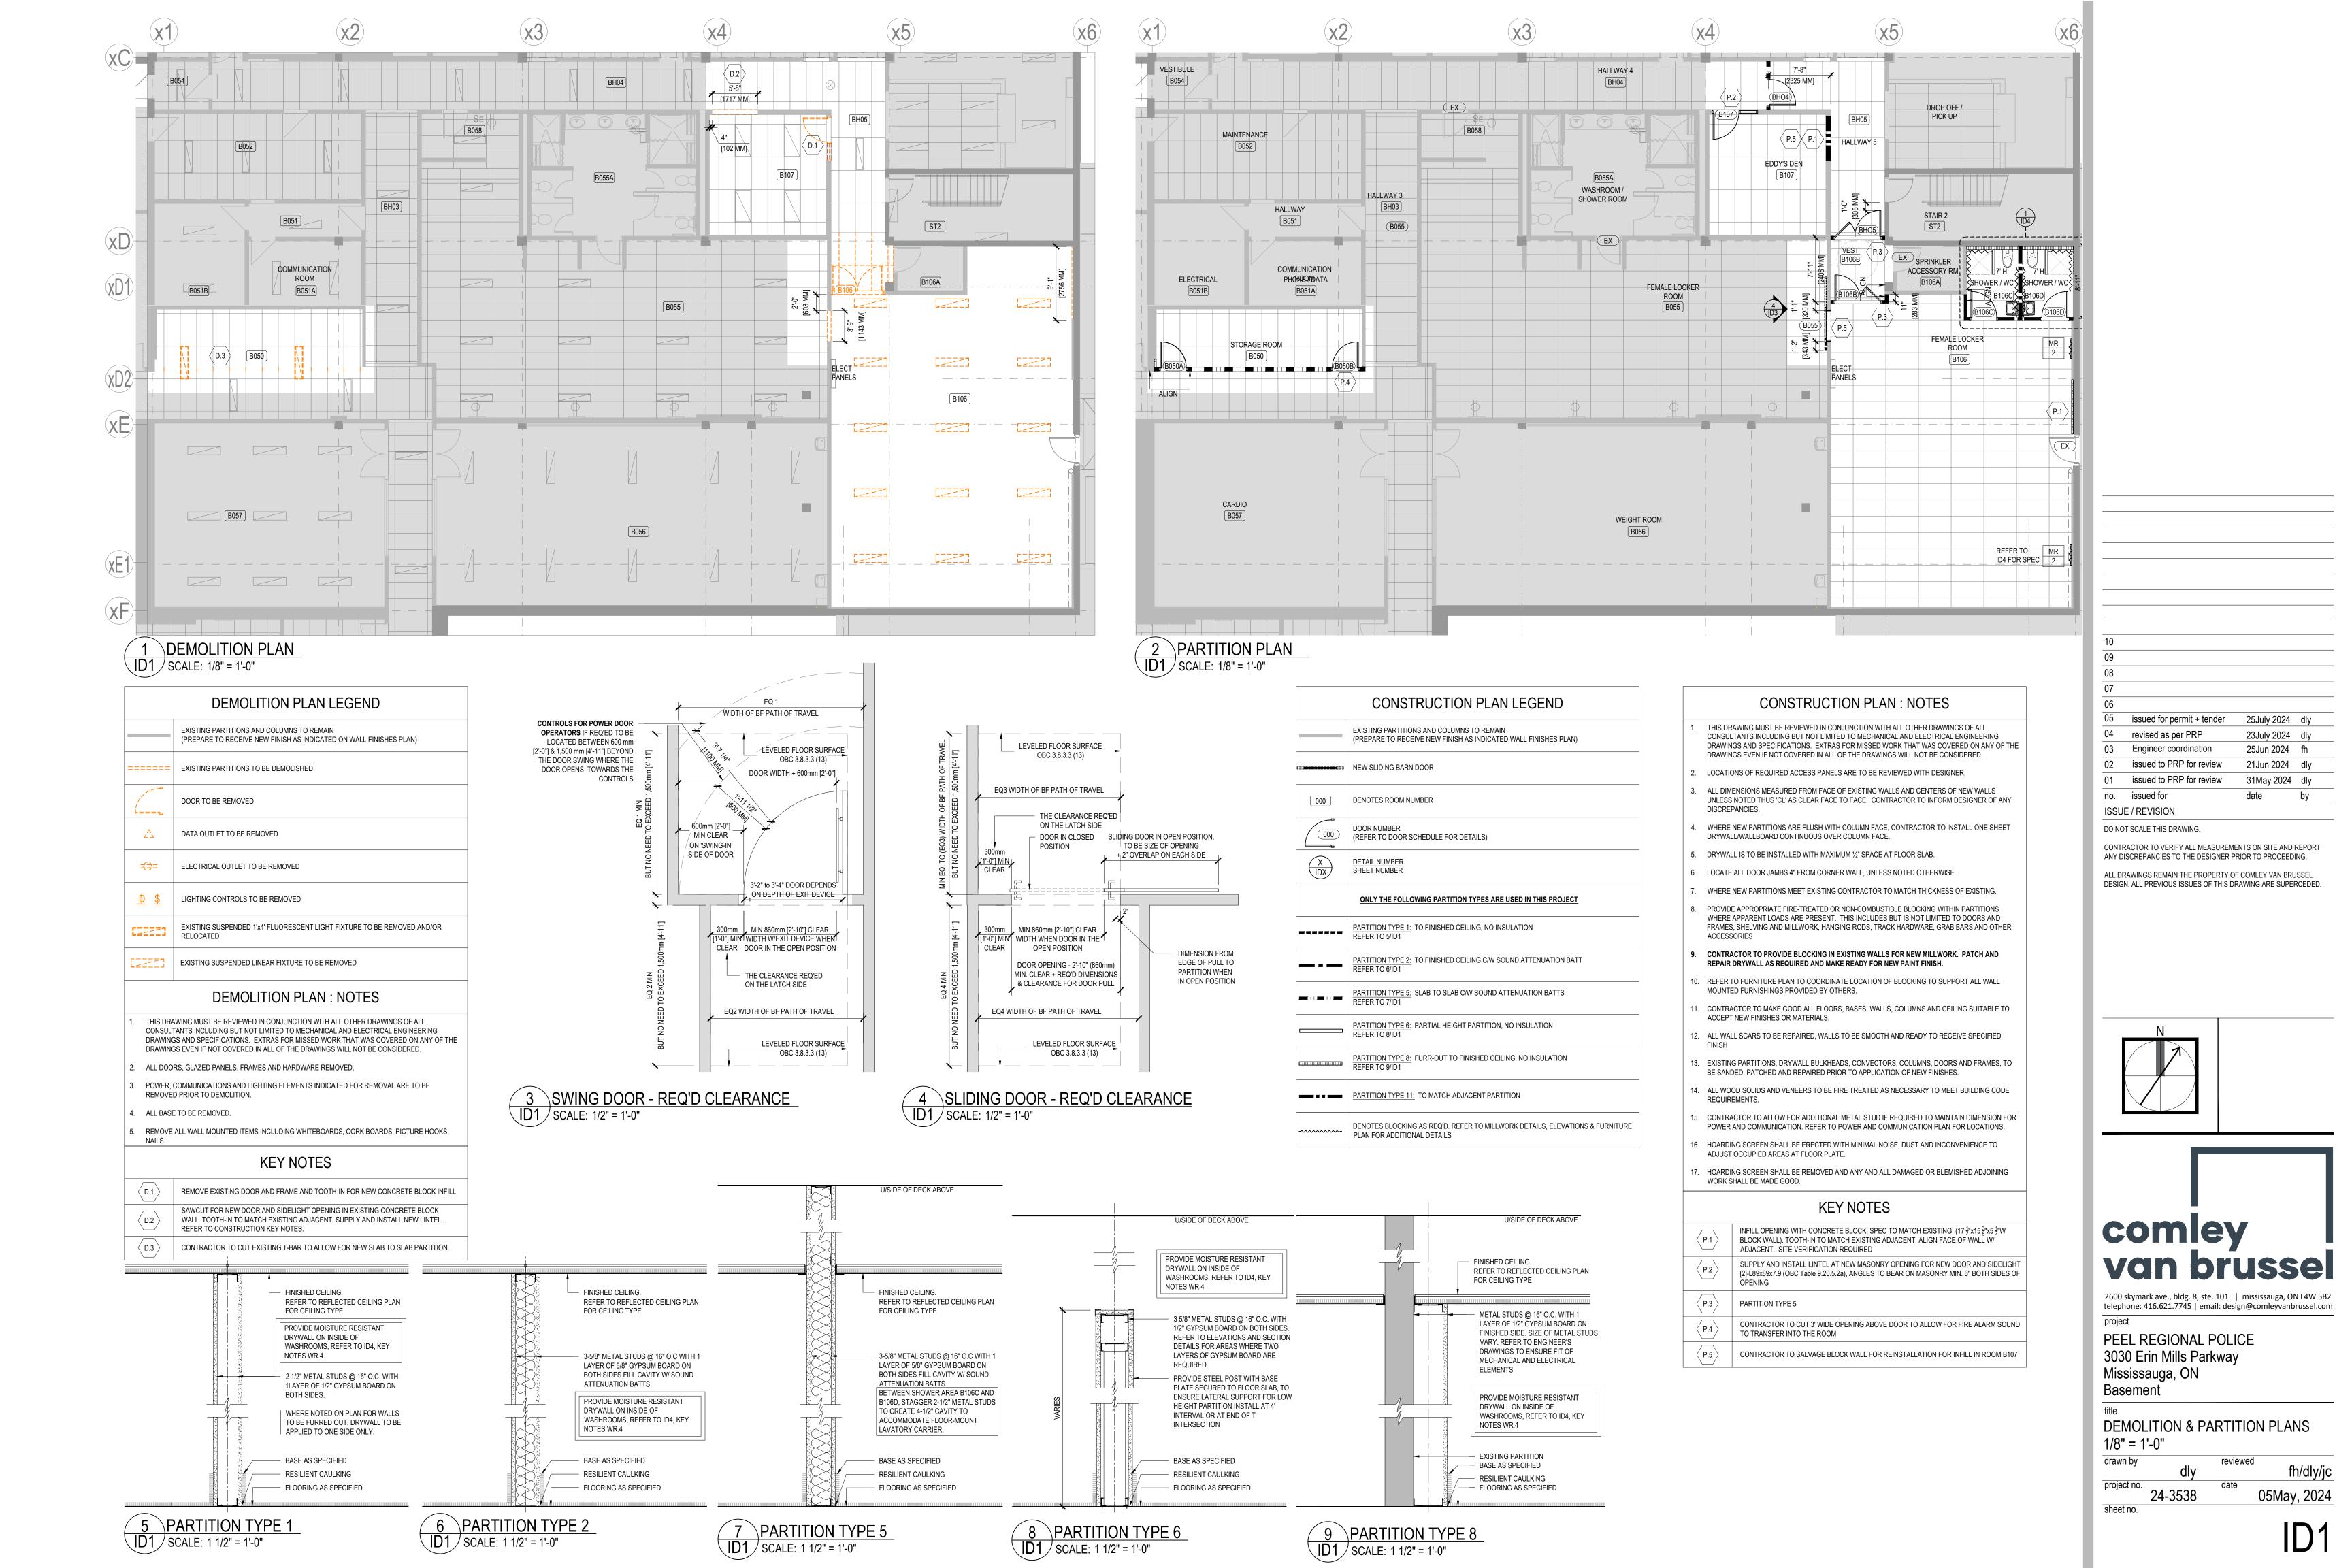

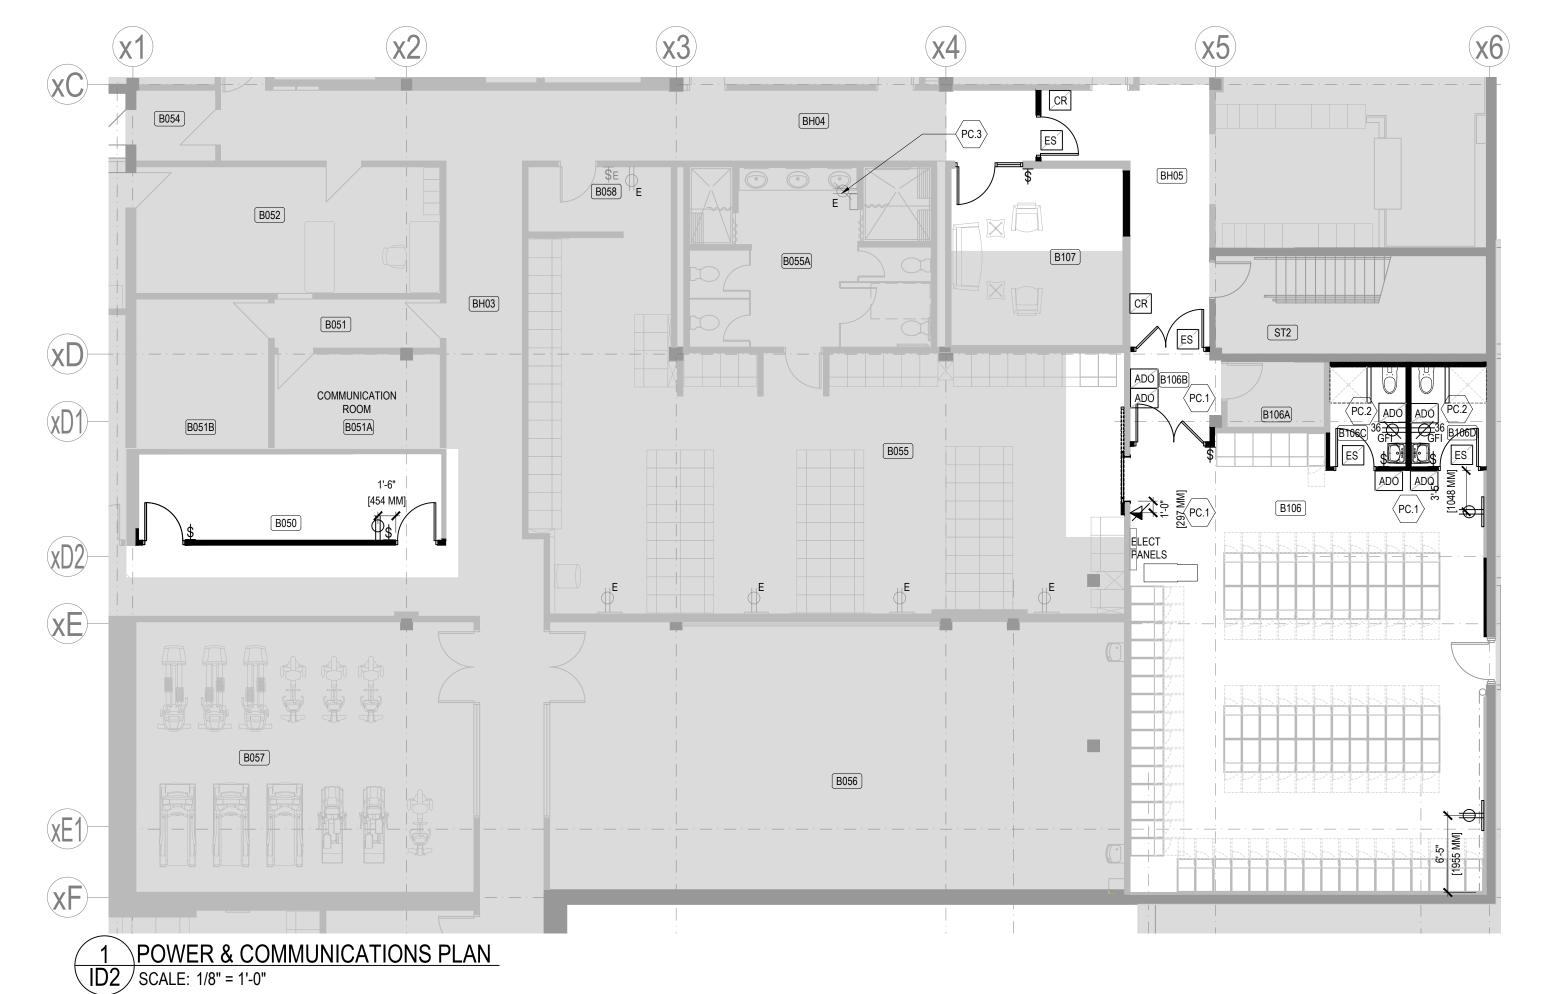

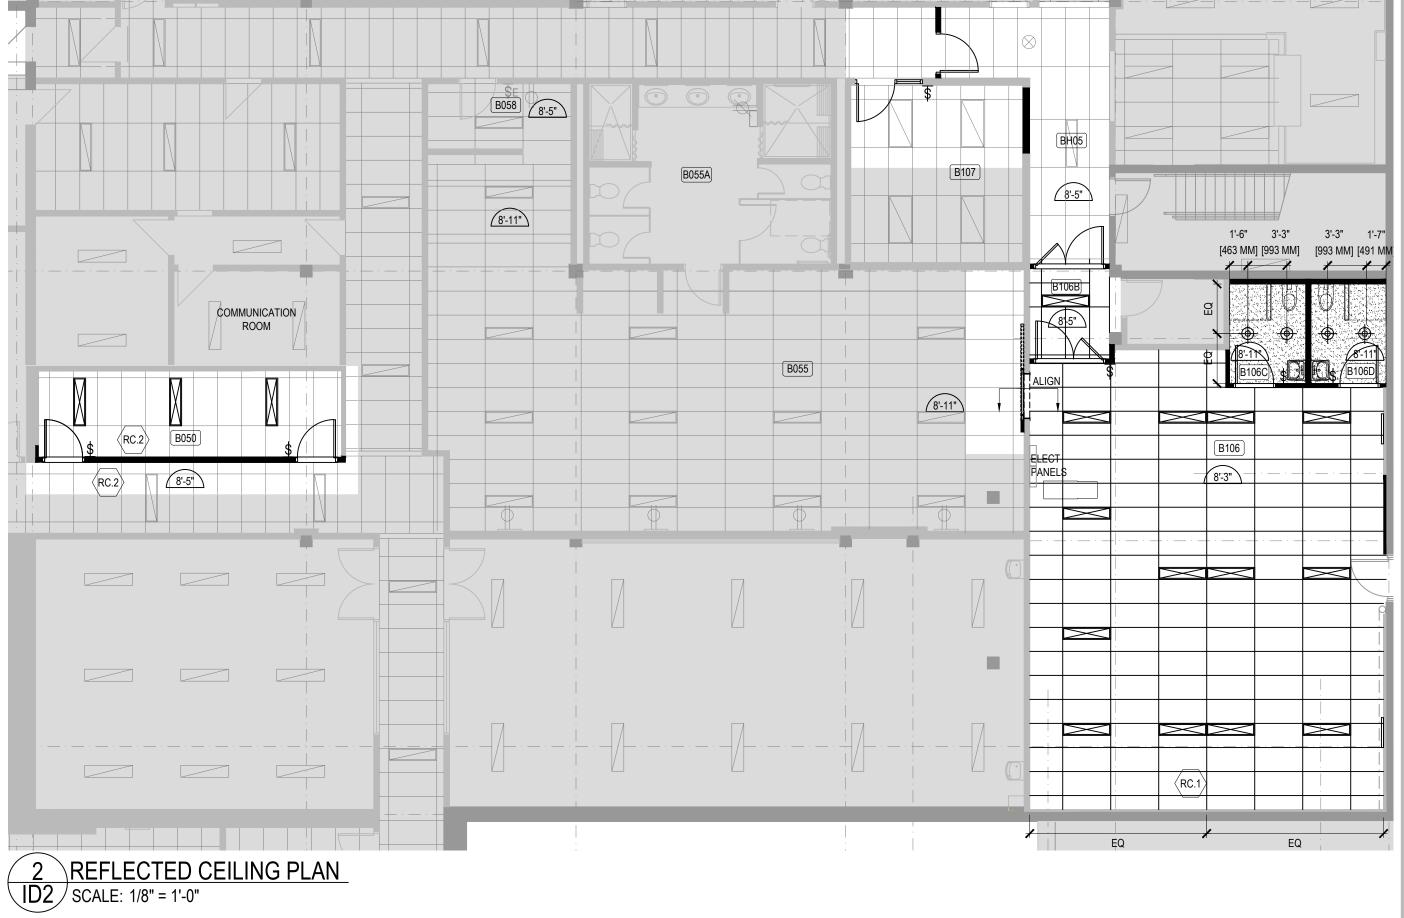

#### POWER & COMMUNICATIONS LEGEND

| 'R'       | DENOTES EXISTING TO BE REMOVED AND DISPOSED OF OR RELOCATED   |
|-----------|---|
| 'E'       | DENOTES EXISTING TO REMAIN  |
| 'C'       | DENOTES EXISTING TO BE CAPPED   |
| ф         | DENOTES STANDARD DUPLEX ELECTRICAL RECEPTACLE, WALL MOUNTED @ 12" A.F.F.  |
| #         | DENOTES DUPLEX ELECTRICAL, WALL MOUNTED @ SPECIFIED NON-STANDARD HEIGHT   |
| K         | DENOTES <u>VOICE/DATA</u> OUTLET, WALL MOUNTED @ 12" A.F.F. UNLESS NOTED OTHERWISE. STANDARD 1 VOICE AND 1 DATA UNLESS NOTED OTHERWISE, THUS #V/#D  |
| <u>\$</u> | SINGLE SWITCH TO BE WALL MOUNTED TO MATCH EXISTING HEIGHT, UNLESS NOTED OTHERWISE. 'M' DENOTES MASTER, '3' DENOTES 3-WAY, 'MS' DENOTES MOTORIZED SCREEN, 'MB' DENOTES MOTORIZED BLINDS          |
| ADO       | NEW AUTOMATIC DOOR OPERATORS TO BE SUPPLIED AND INSTALLED BY THIS CONTRACTOR. REFER TO ENGINEERS DRAWINGS FOR CONDUIT LOCATION. REFER TO DOOR SCHEDULE ID3 NOTE 8. REFER TO O.B.C 3.8.3.3. (17) |
|           | SECURITY LEGEND   |

DENOTES ELECTRIC STRIKE

DENOTES CARD READER

#### **POWER & COMMUNICATIONS: NOTES**

- THIS DRAWING MUST BE REVIEWED IN CONJUNCTION WITH ALL OTHER DRAWINGS OF ALL CONSULTANTS INCLUDING BUT NOT LIMITED TO MECHANICAL AND ELECTRICAL ENGINEERING DRAWINGS AND SPECIFICATIONS. EXTRAS FOR MISSED WORK THAT WAS COVERED ON ANY OF THE DRAWINGS EVEN IF NOT COVERED IN ALL OF THE DRAWINGS WILL NOT BE CONSIDERED.
- <u>THIS DRAWING SHALL TAKE PRECEDENCE FOR LOCATION,</u> ENGINEERING DRAWINGS TO TAKE PRECEDENT FOR CIRCUITRY AND LIFE SAFETY CONSIDERATIONS.
- ANY CORING, DRILLING OR CHASING OF SLABS IS TO BE DONE IN ACCORDANCE WITH THE LANDLORDS CRITERIA AND AUTHORIZATION.
- INACTIVE DEVICES: REMOVE ALL BLANK PLATED DEVICES C/W, BOXES/CONDUIT AND WIRING IN LOCATIONS NOT TO BE REACTIVATED. PATCH AND REPAIR RESULTANT DAMAGE AS REQUIRED TO
- ENSURE ALL 'EXISTING TO REMAIN' OUTLETS, WITHIN THE AREA OF WORK, ARE OPERATIONAL. CONFIRM CIRCUITRY AND REPAIR OR REPLACE AS REQUIRED.
- ALL 'EXISTING TO REMAIN' OUTLETS REQUIRE ALL EXISTING OUTLETS NOT SHOWN ARE TO REMAIN
- ALL DIMENSIONS ARE TO THE CENTER OF THE RECEPTACLE, OR CENTER OF GANGED RECEPTACLES. ADJACENT OUTLETS TO BE GANGED C/W COMMON COVER PLATE.
- WHERE OUTLETS OCCUR BACK TO BACK, STAGGER AND PACK WITH INSULATION TO PREVENT SOUND
- ADJACENT OUTLETS TO BE GANGED W/ COMMON COVER PLATE.
- 10. ALL NEW POWER AND COMMUNICATIONS DEVICES AND FACE PLATES TO BE: MATCH EXISTING
- 11. LOCATION MAY VARY 10'-0" ± IN ANY DIRECTION NOT AFFECTING CONTRACT PRICE.

#### COMMUNICATIONS:

- ALL DATA AND TELEPHONE REQUIREMENTS SHALL BE COORDINATED THROUGH THE CLIENT CONTACT: ANDREW COBER, 1-289-541-8829
- ELECTRICAL TRADE IS RESPONSIBLE FOR THE SUPPLY AND INSTALLATION OF ALL BOXES, CONDUITS AND PULL STRINGS FOR VOICE AND DATA.
- CABLING CONTRACTOR IS RESPONSIBLE FOR THE SUPPLY AND INSTALL OF CABLING, JACKS AND FACE PLATES.
- CABLING CONTRACTOR IS TO INCLUDE FOR THE TERMINATION OF ALL COMMUNICATIONS CABLING AT BOTH ENDS COMPLETE INCLUDING TESTING AND VERIFICATION. CAT 6 PLENUM RATED CABLING, 1 DROPS PER LOCATION UNLESS OTHERWISE NOTED
- PULL QTY. OF CABLES AS SHOWN ON PLAN LABEL ALL CABLES AND OUTLETS
- CABLES TO BE JACKED AT OUTLET, PUNCHED DOWN AT PANEL AND CERTIFIED
- RUN CABLE BUNDLES IN CEILING SUSPENDED ON J-HOOKS

#### FOR EQUIPMENT SPECIFICATIONS.

- ELECTRICAL TRADE IS TO INCLUDE ALL ROUGH-INS, CONDUIT, DEVICES BOXES AND LINE VOLTAGE WIRING AS REQUIRED FOR SECURITY SYSTEM.
- SECURITY VENDOR IS TO SUPPLY AND INSTALL ALL SECURITY DEVICES INCLUSIVE OF LOW-VOLTAGE WIRING AND REQUIRED PROGRAMMING AS NEEDED TO RENDER A COMPLETE AND OPERABLE

10. ALL COMMUNICATIONS CABLING TO TERMINATE IN ROOM B051A. REFER TO ENGINEER'S DRAWINGS

- CONTRACTOR TO INCLUDE CASH ALLOWANCE FOR COMMUNICATION (DATA/VOICE) AND SECURITY. ELECTRIC STRIKE ON NON-CARD ACCESS DOORS TO BE SUPPLIED AND INSTALLED BY GC (OVER AND ABOVE CASH ALLOWANCE FOR SECURITY) SUPPLY AND INSTALL AUTOMATIC FAUCET (HARDWIRED, ON GENERATOR). REFER TO ELECTRICAL DRAWINGS FOR FURTHER INFORMATION.
- RECIRCUIT EXISTING OUTLET. REFER TO ELECTRICAL DRAWINGS FOR FURTHER INFORMATION.

| T | DENOTES <b>NEW THERMOSTATS</b> SHALL BE MOUNTED WITH THEIR CENTRELINE 1,200 mm [3'-11"] ABOVE THE FINISHED FLOOR LEVEL AND SHALL BE LOCATED SO AS TO BE ADJACENT TO AND CENTRED ON EITHER THE LENGTH OR WIDTH OF A CLEAR FLOOR SPACE OF 810 mm by 1,370 mm [2'-8" x 4'-6"]. |
|---|---|
|   |   |

DENOTES NEW MANUAL PULL STATIONS FOR THE FIRE ALARM SYSTEM SHALL BE MOUNTED ON THE WALL NOT LESS THAN 410 mm [1'-4"] AND NOT MORE THAN 600 mm [1' 5/8"] FROM THE DOOR WITH THEIR CENTRELINE 1,200 mm [3'-11"] ABOVE THE FINISHED FLOOR LEVEL. NEW MANUAL PULL STATIONS SHALL BE LOCATED SO AS TO BE ADJACENT TO AND CENTRED ON THE WIDTH OF A CLEAR FLOOR SPACE OF 810 mm by 1,370 mm [2'-8" x 4'-6"] . THE SIGN TO BE INSTALLED ON THE DOOR AS PER **3.4.6.17.** (4) REQUIREMENTS.

**CONTROLS LEGEND** 

- DENOTES **NEW CONTROLS FOR POWER DOOR OPERATORS** SHALL BE MOUNTED WITH THEIR CENTRELINE NOT LESS THAN 900 mm [2'-11"] AND NOT MORE THAN 1,100 mm [3'-7"] ABOVE THE FINISHED FLOOR LEVEL AND BE LOCATED BETWEEN 600 mm [2'-0"] AND 1,500 mm [4'-11"] BEYOND THE DOOR SWING WHERE THE DOOR OPENS TOWARDS THE CONTROLS PER OBC 3.8.3.3.(18)
- ES DENOTES ELECTRIC STRIKE.
  - DENOTES **NEW CARD READER** SHALL BE MOUNTED NOT LESS THAN 900 mm [2'-11"] AND NOT MORE THAN 1,100 mm [3'-7"] ABOVE THE FINISHED FLOOR LEVEL.

#### **CONTROLS NOTES**

LESS THAN 900 mm [2'-11"] AND NOT MORE THAN 1,100 mm [3'-7"] ABOVE THE FINISHED FLOOR LEVEL. WHEN CONTROLS EXIST, NEW CONTROLS TO MATCH THE MOUNTING HEIGHT OF EXISTING CONTROLS WITHOUT COMPRISING OBC 3.8.1.5 REQUIREMENTS. CONTROLS FOR THE OPERATION OF BUILDING SERVICES AND/OR SAFETY DEVICES (INCL. ELECTRICAL SWITCHES, THERMOSTATS, INTERCOM SWITCHES) INTENDED TO BE

ALL NEW OTHER WALL MOUNTED CONTROLS NOT LISTED ABOVE SHALL BE MOUNTED NOT


A CLEAR FLOOR SPACE OF 810 mm by 1,370 mm [2'-8" x 4'-6"] . REFER TO ENGINEER'S DRAWINGS FOR LIFE SAFETY SYSTEMS AND LOCATIONS OF ALL NECESSARY DEVICES, AS WELL AS FOR ALL FIXTURE, SWITCH, AND COVER PLATE

OPERATED BY THE OCCUPANT SHALL BE LOCATED TO BE ADJACENT TO AND CENTERED ON

SPECIFICATIONS.

ANY DISCREPANCIES BETWEEN DESIGN AND ENGINEERING DRAWINGS TO BE REPORTED TO THE CONSULTANTS IMMEDIATELY.

FINISHED CEILING

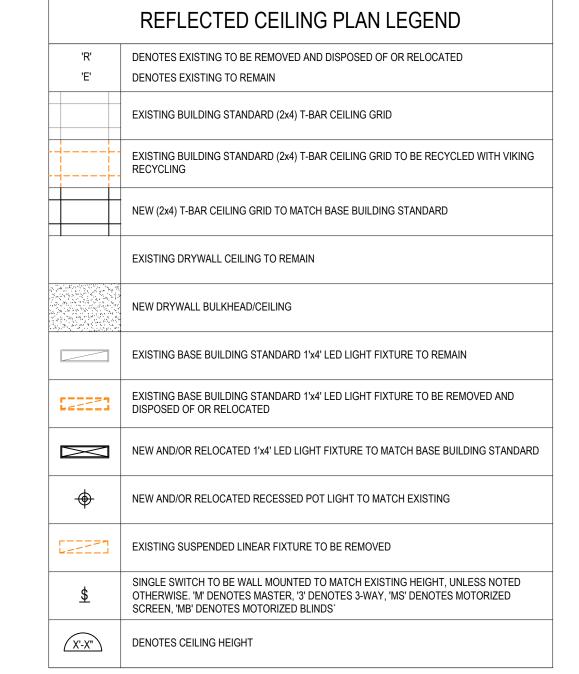

#### REFLECTED CEILING: NOTES

- THIS DRAWING MUST BE REVIEWED IN CONJUNCTION WITH ALL OTHER DRAWINGS OF ALL CONSULTANTS INCLUDING BUT NOT LIMITED TO MECHANICAL AND ELECTRICAL ENGINEERING DRAWINGS AND SPECIFICATIONS. EXTRAS FOR MISSED WORK THAT WAS COVERED ON ANY OF THE DRAWINGS EVEN IF NOT COVERED IN ALL OF THE DRAWINGS WILL NOT BE CONSIDERED.
- THIS DRAWING SHALL TAKE PRECEDENCE FOR LOCATION, ENGINEERING DRAWINGS TO TAKE

PRECEDENT FOR CIRCUITRY AND LIFE SAFETY CONSIDERATIONS.

- WHERE EXISTING PARTITIONS ARE REMOVED, PATCH AND REPAIR ALL ADJACENT CEILING GRIDS WITH FULL CROSS TEES -'FILL-IN' PIECES NOT ACCEPTED. MAIN TEES TO BE REPAIRED WITH MIN. 4'
- PROVIDE MODIFICATIONS TO CEILING GRID, INCLUDING THE PROVISION OF ADDITIONAL SUPPORTS,
- AS REQUIRED FOR THE INSTALLATION OF REQUIRED EQUIPMENT AND DEVICES. 5. TURN ALL INTERMEDIATE T'S AND CUTTING OF THE CEILING GRID AS REQUIRED FOR NEW LAYOUT.
- REMOVE AND RE-INSTALL CEILING TILES AS MAY BE REQUIRED TO ALLOW ACCESS FOR ALL TRADES.
- INCLUDE FOR CUTTING OF CEILING TILES.
- CUT EXISTING DRYWALL CEILINGS FOR TRADE ACCESS, PATCH AND REPAIR AS REQUIRED.
- PROVIDE ADEQUATE NON-COMBUSTIBLE HANGERS AND BLOCKING ABOVE THE CEILING TO SUPPORT ALL ITEMS FORMING PART OF THIS PROJECT SCOPE OF WORK.
- REPLACE ANY DAMAGED OR SOILED CEILING TILES INCLUDING TILES DAMAGED DUE TO PREVIOUS CONSTRUCTION WITH NEW TO MATCH EXISTING AT JOB COMPLETION.
- 10. GENERAL CONTRACTOR TO ALLOW FOR 20% OF CEILING TILES TO BE REPLACED.
- 11. EXISTING LIGHT FIXTURES TO BE CLEANED AND RE-LAMPED AS REQUIRED.

DIMENSIONED OTHERWISE.

BE PAINTED FLAT BLACK.

- RECESSED FIXTURES LOCATED IN CEILING TILE ARE TO BE CENTERED ON TILE UNLESS
- 13. LAYOUT ON THE FLOOR ALL DRYWALL BULKHEADS AND FEATURE ELEMENTS INCLUSIVE OF LIGHT FIXTURES, ACCESS PANELS, SPRINKLERS ETC., FOR THE APPROVAL OF THE DESIGNER, PRIOR TO THE CONSTRUCTION. PROVIDE 24 HOURS NOTICE TO DESIGNER.
- LAYOUT ON THE FLOOR ALL LOCATIONS OF RECESSED DOWNLIGHTS, TRACK LIGHTING AND PENDANTS FOR THE APPROVAL OF THE DESIGNER, PRIOR TO THE CONSTRUCTION. PROVIDE 24 HOURS NOTICE TO DESIGNER.
- ALL FRAMING IN CEILING PLENUM, VISIBLE THROUGH AIR SLOTS OR RETURN AIR GRILLES, ARE TO
- 16. LOCATION OF THERMOSTATS ARE TO REVIEWED BY DESIGNER PRIOR TO INSTALLATION.
- 17. THE HVAC SYSTEM IS TO BE BALANCED UPON COMPLETION OF CONSTRUCTION. 18. ALL SWITCHES ARE TO BE GANGED TOGETHER WHEREVER POSSIBLE.
- 19. REUSE EXISTING DIMMER AND LIGHT SWITCHES FROM DEMOLITION UNLESS OTHERWISE NOTED.
- 20. SWITCH HEIGHTS TO BE 39" TO CENTERLINE ABOVE FINISHED FLOOR UNLESS NOTED OTHERWISE.
- 21. ALL NEW SWITCH PLATES TO MATCH EXISTING.
- 22. CONTRACTOR TO ALLOW FOR PAINT GRADE METAL ACCESS PANELS IN DRYWALL CEILINGS AS REQUIRED. REVIEW ALL LOCATIONS WITH DESIGNER ON SITE PRIOR TO INSTALL.

| 3:-3"  S11" [100 mm] MIN | CONCEALED CONTACT |  |      |
|--------------------------|-------------------|--|------|
| 1'-4" [410 mm] MIN & T   |                   |  |      |
|                          |                   | 1'-4" [410 mm] MIN & 1'-11 5/8" [600 mm] MAX | PB F |

|      | KEY NOTES   |
|------|---|
| RC.1 | NEW CEILING GRID TO BE CENTRED IN ROOM  |
| RC.2 | CONTRACTOR TO CUT EXISTING T-BAR TO ACCEPT NEW SLAB TO SLAB PARTITION, REPAIR T-BAR AND PROVIDE NEW CEILING TILES |

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PEEL REGIONAL POLICE 3030 Erin Mills Parkway Mississauga, ON Basement

issued for permit + tender

revised as per PRP

no. issued for

ISSUE / REVISION

DO NOT SCALE THIS DRAWING.

Engineer coordination

issued to PRP for review

issued to PRP for review

CONTRACTOR TO VERIFY ALL MEASUREMENTS ON SITE AND REPORT

ANY DISCREPANCIES TO THE DESIGNER PRIOR TO PROCEEDING.

ALL DRAWINGS REMAIN THE PROPERTY OF COMLEY VAN BRUSSEL

DESIGN. ALL PREVIOUS ISSUES OF THIS DRAWING ARE SUPERCEDED.

25July 2024 dly

23July 2024 dly

25Jun 2024 fh


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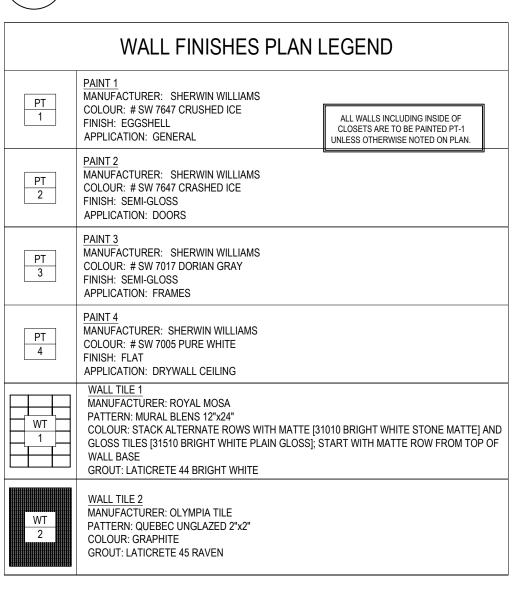
31May 2024 dly


P&C AND RCP PLANS 1/8" = 1'-0"


drawn by fh/dly/jc project no. 24-3538





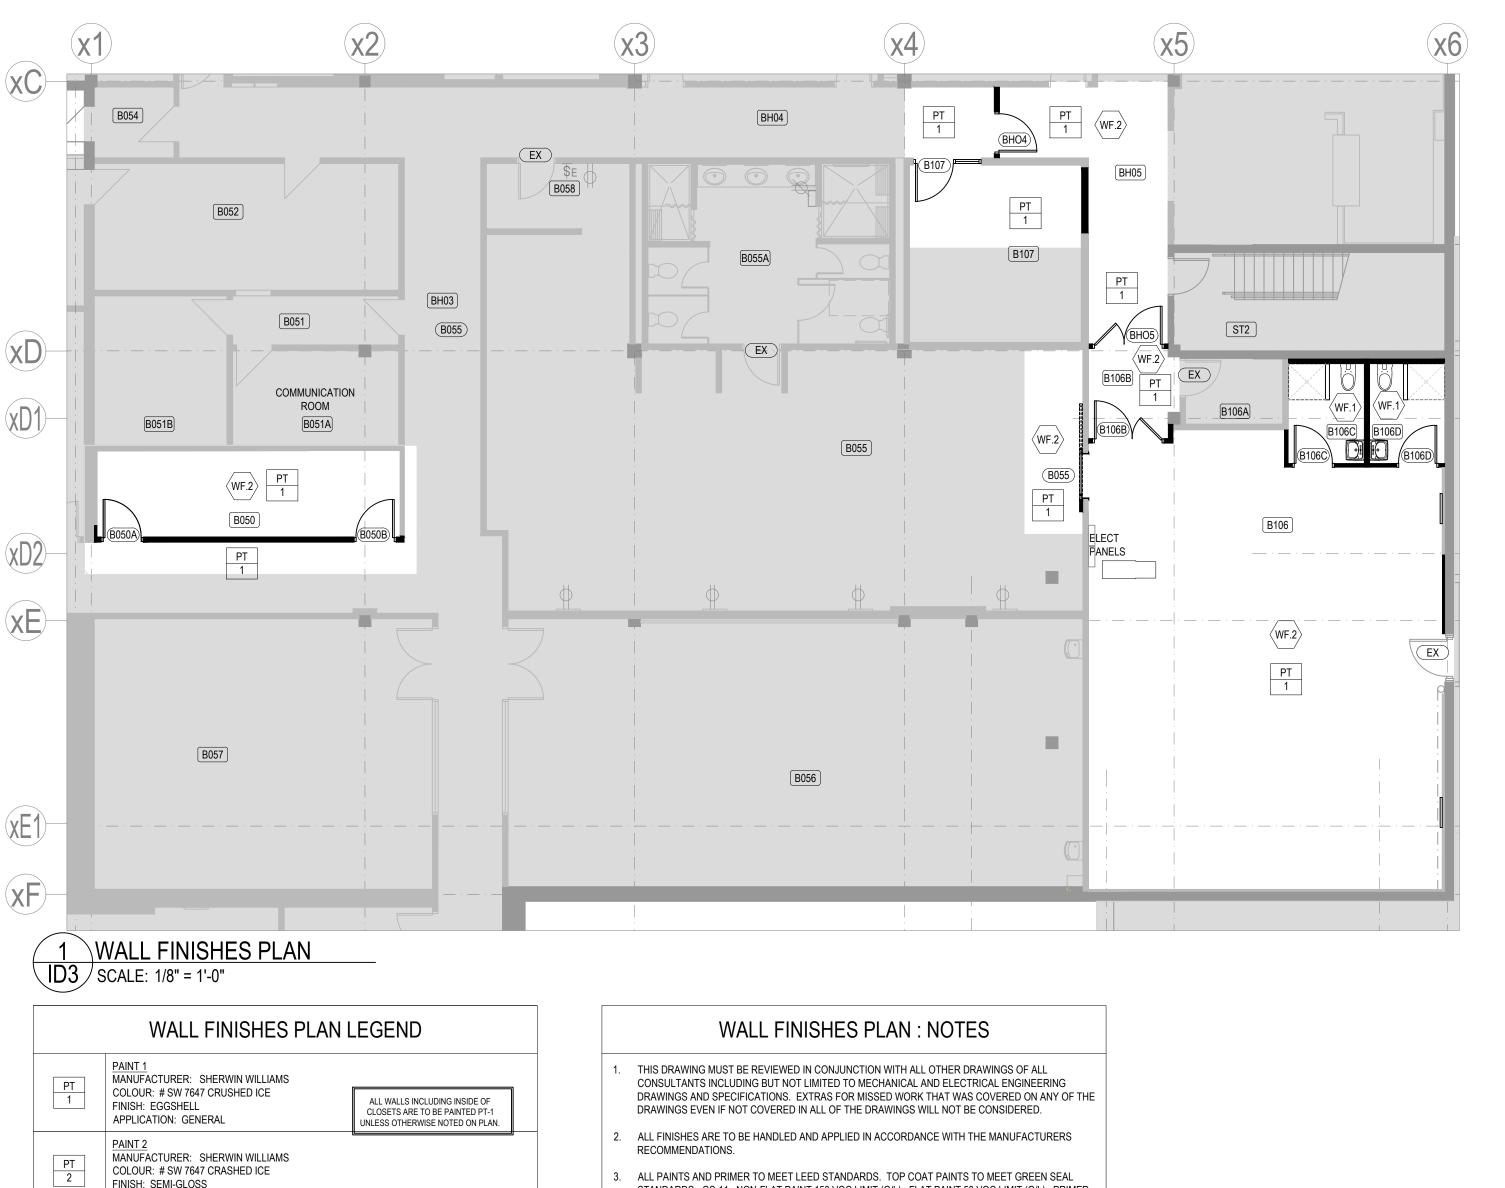

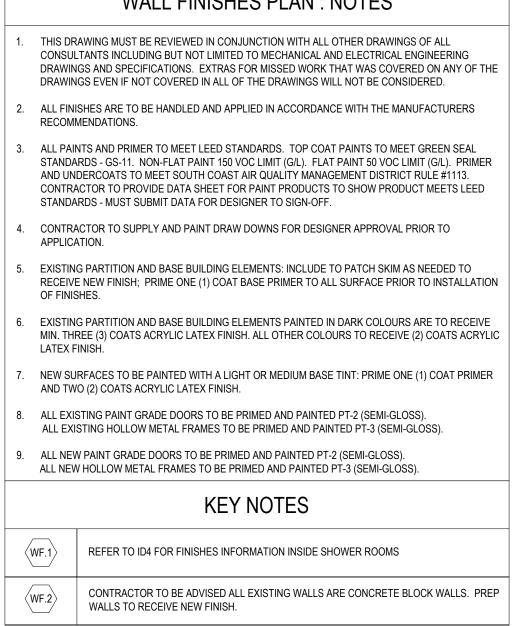

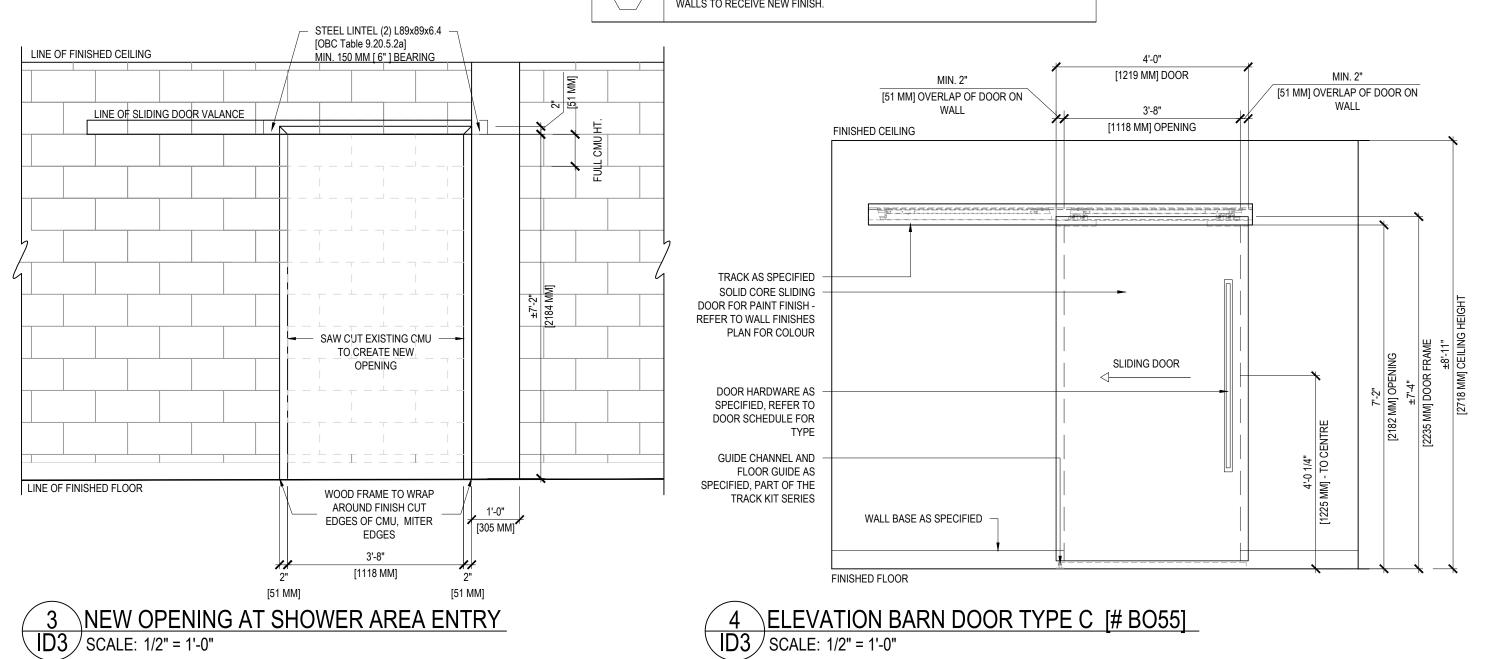

B058 COMMUNICATION ROOM 2 FLOOR FINISHES PLAN ID3 SCALE: 1/8" = 1'-0"

|                   | FLOOR FINISHES PLAN LEGEND  |
|-------------------|---|
| TL 1              | FLOOR TILE 1  MANUFACTURER: UNICOM STARKER  PATTERN: ICON COMPACT 12"x24"  COLOUR: GUN POWDER  GROUT: LATICRETE 78 STERLING SILVER  BASE: 4" TILE BASE C/W SCHLUTER TOP CAP  CONTROL JOINT: SCHLUTER DILEX BWS, 100G GREY |
| TL 2              | FLOOR TILE 2  MANUFACTURER: UNICOM STARKER PATTERN: ICON COMPACT 12"x24"  COLOUR: JET BLACK GROUT: LATICRETE 45 RAVEN BASE: 4" TILE BASE C/W SCHLUTER TOP CAP CONTROL JOINT: SCHLUTER DILEX BWS, 100G GREY                |
| TL<br>3           | FLOOR TILE 3  MANUFACTURER: OLYMPIA TILE PATTERN: QUEBEC UNGLAZED 2"x2" COLOUR: GRAPHITE GROUT: LATICRETE 45 RAVEN  |
| INSTALL DIRECTION | DENOTES DIRECTION OF FLOORING   |

DS DOOR SWEEP

WS WALL STOP

AS ASTRAGAL

OH OVERHEAD DOOR STOP

CLOSERS: TO BE SLIM LINE MODEL W/HOLD-OPEN

FLOOR FINISHES PLAN: NOTES THIS DRAWING MUST BE REVIEWED IN CONJUNCTION WITH ALL OTHER DRAWINGS OF ALL CONSULTANTS INCLUDING BUT NOT LIMITED TO MECHANICAL AND ELECTRICAL ENGINEERING DRAWINGS AND SPECIFICATIONS. EXTRAS FOR MISSED WORK THAT WAS COVERED ON ANY OF THE DRAWINGS EVEN IF NOT COVERED IN ALL OF THE DRAWINGS WILL NOT BE CONSIDERED. ALL FINISHES ARE TO BE HANDLED AND APPLIED IN ACCORDANCE WITH THE MANUFACTURERS RECOMMENDATIONS. ALL FLOORING TO BE CLEANED, SEALED AND PROPERLY FINISHED ACCORDING TO MANUFACTURERS SPECIFICATIONS PRIOR TO CLIENT MOVE IN. ALL FLOOR AND BASE ADHESIVE MUST NOT EXCEED THE FOLLOWING REQUIREMENTS: ADHESIVES, SEALANT AND SEALANT PRIMERS: SOUTH COAST AIR QUALITY MANAGEMENT DISTRICT (SCAQMD) RULE # 1168 REQUIREMENTS IN EFFECT JANUARY 1, 2003 AND RULE AMENDMENT DATED OCTOBER 3, 2003. AEROSOL ADHESIVES: GREEN SEAL STANDARD GS-36 REQUIREMENTS IN EFFECT OCTOBER 19, 2000. CONTRACTOR MUST SUBMIT PRODUCT DATA SHEETS VERIFYING ADHERENCE TO THESE STANDARDS FOR DESIGNER SIGN OFF. SUB-FLOOR TO BE FREE OF ALL DEBRIS AND GLUE PRIOR TO NEW FLOORING INSTALLATION. TRANSITIONS FROM ONE FLOORING MATERIAL TO THE NEXT TO BE MADE LEVEL. FEATHER FLOOR WITH APPROPRIATE FLOOR LEVELER AS REQUIRED TO MAKE ADJACENT FLOORING MATERIALS **KEY NOTES** EXISTING TILE FLOOR TO REMAIN, CONTRACTOR TO PROVIDE NEW TILE WALL BASE TO  $\langle FF.1 \rangle$ NEW PARTITIONS. WHERE DEMOLITION OCCURS, CONTRACTOR TO REMOVE WALL BASE AND REPLACE WITH

ONE CONTINUOUS WALL BASE. 4" PIECE INSTALLATION AT WALL SCAR IS NOT

| 000   | R SCHEDULE   |   |                    |---|--|---|--------------------|--------|--------|--------|--------|-----------------------|--|---|--|--|--------------------------------------|---|-------------------------|-----------------|------------------|---------------------------------|--|--|---------------------------------------|---|----------------------------|--|
| OCATIO  | NO   | DOOR  | S                  |        |        | FRAMES | 8      |                       | HARDW  | /ARE  |  |  |                                      |   |                         |                 |                  |                                 |  | SECURI   | TY                                    |   |                            | REMARKS                                  |
| 0.  | ROOM   | TYPE  | DESCRIPTION        | CONST. | FINISH | CONST. | FINISH | FIRE<br>RATED         | LATCH<br>SET   | LOCK<br>SET   | PRIVACY<br>SET   | PULL   | DOOR<br>STOP                         | DEAD<br>BOLTS                             | KICK<br>PLATES          | GRILL           | ADO<br>EL STRIKE | CLO<br>CONCEALED<br>(HOLD OPEN) |  |  | READER<br>MAG LOCK                    | TAMPER<br>PLATE   | DOOR<br>CONTACT<br>(ALARM) | T  |
| 8050A   | STORAGE ROOM   | А   | 38"W X 7'-0"       | НМ     | PT     | НМ     | PT     |                       |  | •   |  |  | WS                                   |   |                         |                 |                  |                                 | •  |  |                                       |   |                            | HOLD OPEN CLOSER                         |
| 050B  | STORAGE ROOM   | А   | 38"W X 7'-0"       | НМ     | PT     | НМ     | PT     |                       |  | •   |  |  | WS                                   |   |                         |                 |                  |                                 | •  |  |                                       |   |                            | HOLD OPEN CLOSER                         |
| 3055  | LOCKER ROOM  | С   | 48"W X 7'-0"       | НМ     | PT     | НМ     | PT     |                       |  |   |  | •  |                                      | •   |                         |                 |                  |                                 |  |  |                                       |   |                            | BARN DOOR HARDWARE                       |
| 3H04  | HALLWAY  | А   | 38"W X 7'-0"       | НМ     | PT     | НМ     | PT     |                       |  | •   |  |  | WS                                   |   |                         |                 |                  |                                 |  | •  |                                       |   | •                          |  |
| 3H05  | VESTIBULE  | AA  | 38" + 30"W X 7'-0" | НМ     | PT     | НМ     | PT     |                       |  | •   |  |  | WS                                   |   | •                       |                 | •                |                                 |  | •  |                                       |   | •                          |  |
| 3106B   | LOCKER ROOM  | AA  | 38" + 30"W X 7'-0" | НМ     | PT     | НМ     | PT     |                       | •  |   |  |  | WS                                   |   | •                       |                 | •                |                                 |  |  |                                       |   |                            |  |
| 3106C   | SHOWER ROOM  | А   | 38"W X 7'-0"       | НМ     | PT     | НМ     | PT     |                       |  |   | •  |  | WS                                   |   |                         | •               | •                |                                 |  |  |                                       |   |                            | REFER TO ENGINEER DRAWING FOR GRILL SIZE |
| 3106D   | SHOWER ROOM  | А   | 38"W X 7'-0"       | НМ     | PT     | НМ     | PT     |                       |  |   | •  |  | WS                                   |   |                         | •               | •                |                                 |  |  |                                       |   |                            | REFER TO ENGINEER DRAWING FOR GRILL SIZE |
| B107  | QUIET ROOM   | В   | 38"W X 7'-0"       | НМ     | PT     | НМ     | PT     |                       |  | •   |  |  | WS                                   |   |                         |                 |                  |                                 |  |  |                                       |   |                            |  |
| LEGI<br>DOORS<br>EX<br>HM<br>PT<br>ME<br>/N/ST<br>WD<br>HARDV | E AND FRAMES:  EXISTING  HOLLOW METAL  PAINT  METAL  WOOD VENEER/STAIN  WOOD | LEVER: MANUFACTURER: - SCHLAGE SERIES: ND SERIES (ND96 STOREROOM OR ND92 ENTRANCE FUNCTIONS) TO MATCH EXISTING  BARN DOOR: KN CROWDER CATCH 'N' CLOSE CCB-810 KIT SERIES [96" LONG]. INCLUDING CC-920 SNAP-ON FASCIA [96" L] AND END CAPS. WHITE FINISH CUSTOM FLUSH PULL 48" HIGH, BRUSHED STAINLESS STEEL |                    |        |        |        |        | 1. F 2. F 8 3. # 4. ( | NERAL REFER TO PROVIDE S BEFORE P ALL DOOR GLAZING (I ALL GLAZIN NOTED. 3.3.1.3.88 | PARTITION SHOP DW ROCEEDI S TO BE INCLUDES NGPANEL ALL GLAZ | ON PLAN F<br>GS OF DO<br>NG W/ WO<br>I 3/4" THK<br>S SIDELIG<br>S TO BE O<br>ZING TO B | OOR/FRAM<br>DRK.<br>UNLESS<br>HTS):<br>CLEAR, TE<br>E INSTAL | IE DETAIL: OTHERWI: MPERED LED IN AC | S FOR DE<br>SE NOTE<br>GLASS, L<br>CORDAN | D OR RECURING OF WITH ( | )'D<br>THERWISI | 8                | . <u>KEYI</u> ● F . <u>BAR</u>  | ING:<br>FINAL KEY<br>RIER FRE<br>AUTOMATI<br>DOOI<br>STAII<br>DOOI | E:<br>IC DOOR (<br>R BH05/B1<br>NLESS ST<br>RS B106C | WNER  OPERATO 106B- BEA TEEL TAND B10 | REMOVEABLE PINS) AS REQUIRED.  OR PUSH BUTTONS  A10PBDGP1 BEA DUAL VESTIBULE PUSH PLATE  OBD- TO MATCH EXISTING  DMATIC DOOR OPERATOR TO BE SUPPLIED AN |                            |  |

• REFER TO WALL FINISHES PLAN FOR PAINT SPECIFICATIONS.

FOR CARD ACCESS.

ALL PAINTED DOORS/FRAMES (INCL. SIDELIGHTS): TO BE SHOP FINISHED

GENERAL CONTRACTOR TO CARRY CASH ALLOWANCE FOR BASE BUILDING

ELECTRICIAN TO SUPPLY CONDUIT, BOXES & PULL STRINGS AS REQ'D;

PREPARE DOORS AND FRAMES AS REQUIRED FOR SECURITY DEVICES.

REFER TO CVBD POWER & COMMUNICATIONS DRAWING FOR LOCATIONS.

ELECTRIC STRIKE TO BE SPECIFIED BY SECURITY VENDOR. THIS DOES NOT


INCLUDE ELECTRIC STRIKE FOR AUTOMATIC DOOR OPERATOR THAT IS NOT

SECURITY CONTRACTOR. CONTACT EMAIL: corporatesecurity@peelpolice.ca

DOOR TYPE

'ÀA'


ACCEPTABLE.

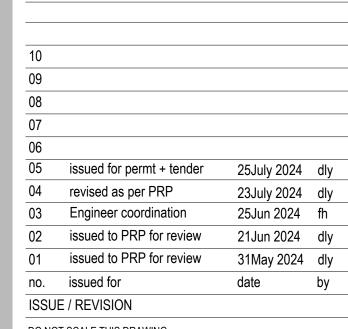

DO NOT SCALE THIS DRAWING.

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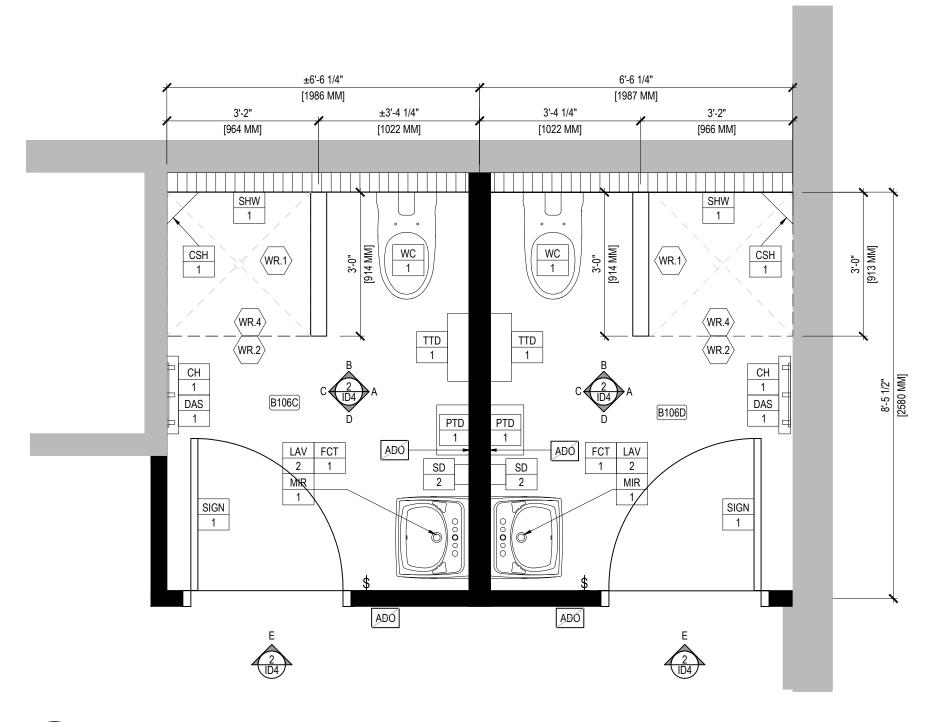
2600 skymark ave., bldg. 8, ste. 101 | mississauga, ON L4W 5B2 telephone: 416.621.7745 | email: design@comleyvanbrussel.com

PEEL REGIONAL POLICE 3030 Erin Mills Parkway

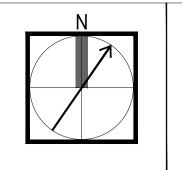
Mississauga, ON Basement


FINISHES PLAN & DOOR SCHEDULE 1/8" = 1'-0" drawn by


fh/dly/jc project no 24-3538 sheet no.




## 1 SHOWER AND CHANGE AREA OVERALL PLAN SCALE: 1/2" = 1'-0'

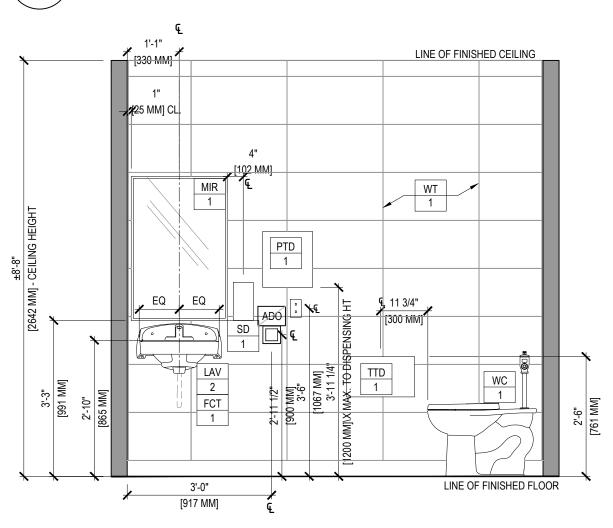

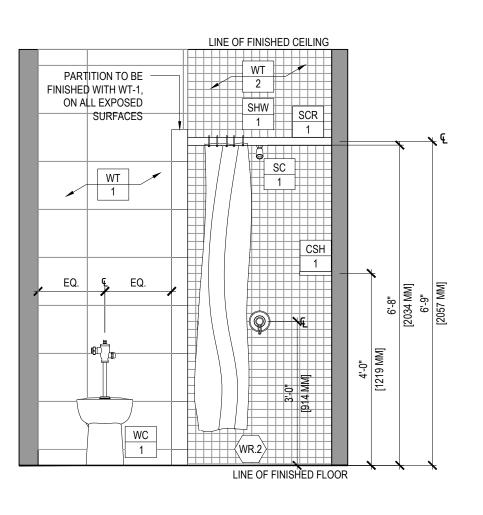


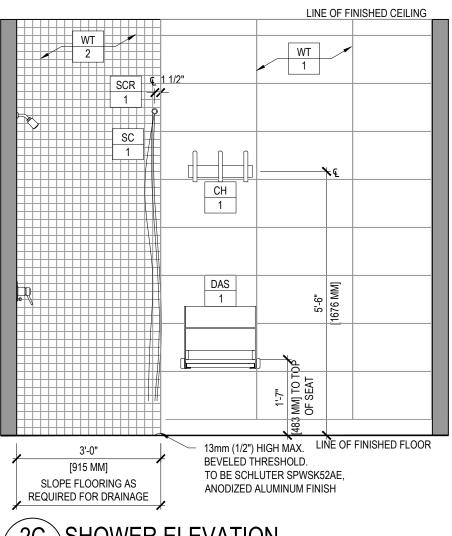



### 2A SHOWER ELEVATION ID4 SCALE: 1/2" = 1'-0'

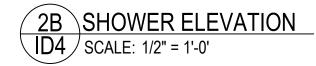



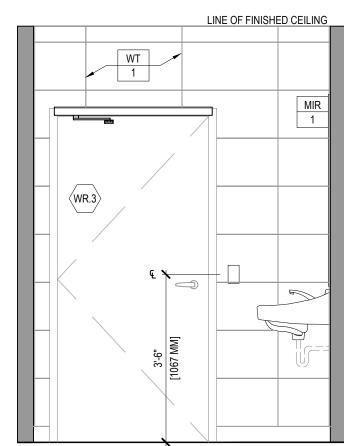

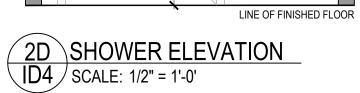

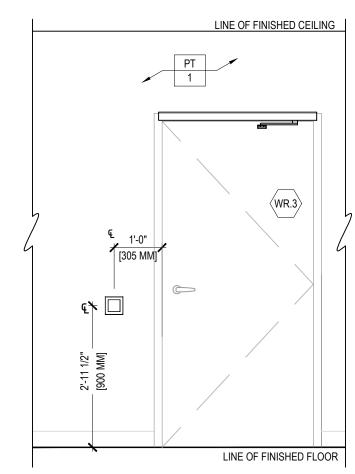

2E SHOWER ELEVATION ID4 SCALE: 1/2" = 1'-0'

| 1         | REFER TO FURNITURE PLAN LEGEND ON ID1 FOR SPECIFICATIONS   |
|-----------|--|
| CH<br>1   | COAT HOOK MANUFACTURER: FROST MODEL: 1147 COAT HOOK, THREE HOOK STRIP FINISH:STAINLESS STEEL NOTE: COAT HOOK TO BE MOUNTED @ 3'-11" [1200 mm] A.F.F. TO CENTER   |
| CSH<br>1  | CORNER SHELF MANUFACTURER: FROST MODEL: 950-8X8" FINISH: BRUSHED STAINLESS STEEL NOTE: TO BE MOUNTED @ 3'-11" [1200 mm] A.F.F. TO CENTER   |
| DAS 1     | DRESSING AREA FOLDING SEAT  MANUFACTURER: INVISIA  MODEL: SERENA SEAT PRO  MOUNTING HEIGHT: 19" TO THE TOP OF THE SEAT WHEN IN OPEN POSITION - PROVID  BLOCKING AS REQUIRED  |
| MIR<br>1  | MIRROR 1 (OVER SINK) MANUFACTURER: FROST MODEL: TEMPERED GLASS MIRROR 941-TG2436 SIZE: 24"W x 36"H NOTE: REFER TO ELEVATION FOR MOUNTING HEIGHT  |
| MIR 2     | MIRROR 2 (CHANGE ROOM) GLASS MIRROR WITH 1/2" STAINLESS STEEL FRAME SECURED TO WALL WITH ACID-FREE MIRROR ADHESIVE SIZE: 30" x 72"; TO BE MOUNTED 6" A.F.F. TO THE BOTTOM OF MIRROR  |
| PTD 1     | PAPER TOWEL DISPENSER 1 GEORGIA PACIFIC ENMOTION IMPULSE, SIZE: 8" 1-ROLL, BLACK FINISH SUPPLIED AND INSTALLED BY GC. NOTE: REFER TO ELEVATION FOR MOUNTING HEIGHT   |
| SC 1      | SHOWER CURTAIN C/W ROD AND HOOKS  MANUFACTURER: FROST  MODEL: 1145-S ROD [36" FOR NON BARRIER-FREE SHOWERS AND 60" FOR BARRIER-FREE SHOWER] / 1144-501L CURTAIN HOOKS / 1144-503 VINYL CURTAIN (70"W x 72"H)  NOTE: REFER TO ELEVATION FOR MOUNTING HEIGHT |
| SD 1      | SOAP DISPENSER 1 SC JOHNSON PROFESSIONAL, FOAM DISPENSER. ITEM# DEBTPW1LDSEA, MFR. MODEL# TPW1LDS, UNSPSC# 47131704 SUPPLIED AND INSTALLED BY GC. NOTE: REFER TO ELEVATION FOR MOUNTING HEIGHT   |
| SIGN<br>1 | WASHROOM SIGNAGE 1 (UNISEX SHOWER) BY CLIENT (N.I.C.)  |
| SIGN 2    | WASHROOM SIGNAGE 2 (UNISEX BARRIER-FREE SHOWER) BY CLIENT (N.I.C.)   |
| TTD<br>1  | TOILET TISSUE DISPENSER  CASCADES PRO TANDEM JUMBO ROOL BATH TISSUE DISPENSER, DOUBLE ROLL, DAF GREY #C380  SUPPLIED AND INSTALLED BY GC. NOTE: REFER TO ELEVATION FOR MOUNTING HEIG   |
| WB 1      | WASTE BIN ULINE, SUPPLIED BY CLIENT. NOTE: CONFIRM WITH CLIENT FOR PLACEMENT   |

| WASHROOM ACCESSORIES LEGEND  | WASHROOM FIXTURE LEGEND  |
|--|--|
| BENCH REFER TO FURNITURE PLAN LEGEND ON ID1 FOR SPECIFICATIONS   | FAUCET (SENSOR-OPERATED)  REFER TO ENGINEER'S DRAWINGS FOR SPECIFICATIONS.  NOTE: WATER SUPPLY TEMPERATURE TO BE LIMITED TO A MAXIMUM OF 43°C  |
| COAT HOOK MANUFACTURER: FROST MODEL: 1147 COAT HOOK, THREE HOOK STRIP FINISH:STAINLESS STEEL NOTE: COAT HOOK TO BE MOUNTED @ 3'-11" [1200 mm] A.F.F. TO CENTER | LAVATORY 1 MANUFACTURER: AMERICAN STANDARD MODEL: LUCERNE COLOUR - WHITE REFER TO ENGINEER'S DRAWINGS FOR SPECIFICATIONS   |
| CORNER SHELF MANUFACTURER: FROST MODEL: 950-8X8" FINISH: BRUSHED STAINLESS STEEL   | SHW 1 SHOWERHEAD 1 (NON-BARRIER-FREE SHOWERS) REFER TO ENGINEER'S DRAWINGS FOR SPECIFICATIONS  |
| NOTE: TO BE MOUNTED @ 3'-11" [1200 mm] A.F.F. TO CENTER  DRESSING AREA FOLDING SEAT  | WC WATER CLOSET REFER TO ENGINEER'S DRAWINGS FOR SPECIFICATIONS  |
| MANUFACTURER: INVISIA MODEL: SERENA SEAT PRO MOUNTING HEIGHT: 19" TO THE TOP OF THE SEAT WHEN IN OPEN POSITION - PROVIDE BLOCKING AS REQUIRED                  | WASHROOM GENERAL NOTES   |
| MIRROR 1 (OVER SINK) MANUFACTURER: FROST MODEL: TEMPERED GLASS MIRROR 941-TG2436 SIZE: 24"W x 36"H NOTE: REFER TO ELEVATION FOR MOUNTING HEIGHT                | <ol> <li>REFER TO PARTITION PLAN FOR CONSTRUCTION GENERAL NOTES AND LEGEND.</li> <li>CONTRACTOR TO SITE VERIFY ALL DIMENSIONS.</li> <li>CONTRACTOR TO PROVIDE ADEQUATE BLOCKING IN PARTITION AS REQUIRED FOR LOAD</li> </ol> |

|      | WASHROOM KEY NOTES   |
|------|--|
| WR.1 | SHOWER WATERPROOFING TO MEET TTMAC 319SR-2016-2017   |
| WR.2 | LINE OF 13mm (1/2") HIGH BEVELED THRESHOLD. FLOOR WITHIN SHOWER ENCLOSURE TO SLOPE TOWARDS THE SHOWER DRAIN.   |
| WR.3 | REFER TO WALL FINISHES PLAN FOR DOORS AND FRAMES PAINT FINISH SPECIFICATIONS   |
| WR.4 | SHOWER TO BE COMPLETE WITH SCHLUTER WATERPROOFING SYSTEM; KERDI MEMBRANE, KERDI-SEAL-PS/-MV FOR PIPE PROTRUSIONS, KERDI-BOARD, KERDI-BAND STRIP SEALS, KERDI-KERECK-F/-KERS-B WATERPROOFING CORNERS, KERDI-DS WATERPROOFING AND VAPOR-RETARDANT MEMBRANE, KERDI-FIX SINGLE-COMPONENT SEALING AND BONDING |

4. REFER TO ACCESSORIES MANUFACTURER'S INSTRUCTIONS FOR MOUNTING HEIGHTS AND

5. ALL BARRIER-FREE WASHROOM DESIGN SHALL CONFORM TO THE O.B.C. BARRIER FREE REQUIREMENTS (AS PER SECTION 3.8 OF THE ONT. BUILDING CODE - BARRIER FREE DESIGN). 6. ANY DISPENSING OR HAND-OPERATED WASHROOM ACCESSORIES SHALL BE MOUNTED SO THAT

. REFER TO ENGINEER'S DRAWINGS FOR LOCATION AND SPECIFICATIONS FOR LIGHTING

8. REFER TO ENG'S DWGS FOR LOCATION AND SPECS FOR LIGHTING AND FIRE ALARM SIGNALS

10. LAVATORY WATER SUPPLY TEMPERATURE TO BE LIMITED TO A MAXIMUM OF 43° CELSIUS. REFER


THE DISPENSING HEIGHT IS BETWEEN 2'-11" [900 mm] AND 3'-11" [1200 mm] A.F.F.

INSTALLATION DETAILS, <u>UNLESS NOTED OTHERWISE</u>.

9. ALL VISIBLE EXPOSED PLUMBING PIPES TO BE PAINTED PT-1.


TO ENGINEER'S DRAWINGS FOR SPECIFICATIONS.


CONTROLLED BY A MOTION SENSOR

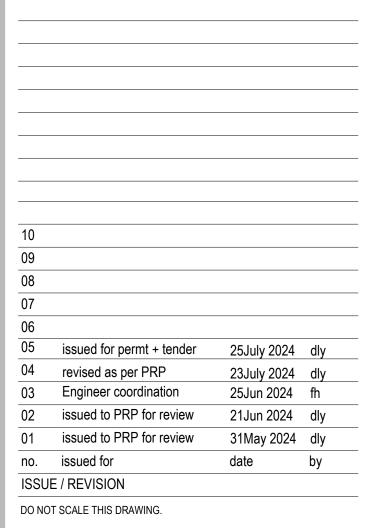

CONTRACTOR TO VERIFY ALL MEASUREMENTS ON SITE AND REPORT ANY DISCREPANCIES TO THE DESIGNER PRIOR TO PROCEEDING.

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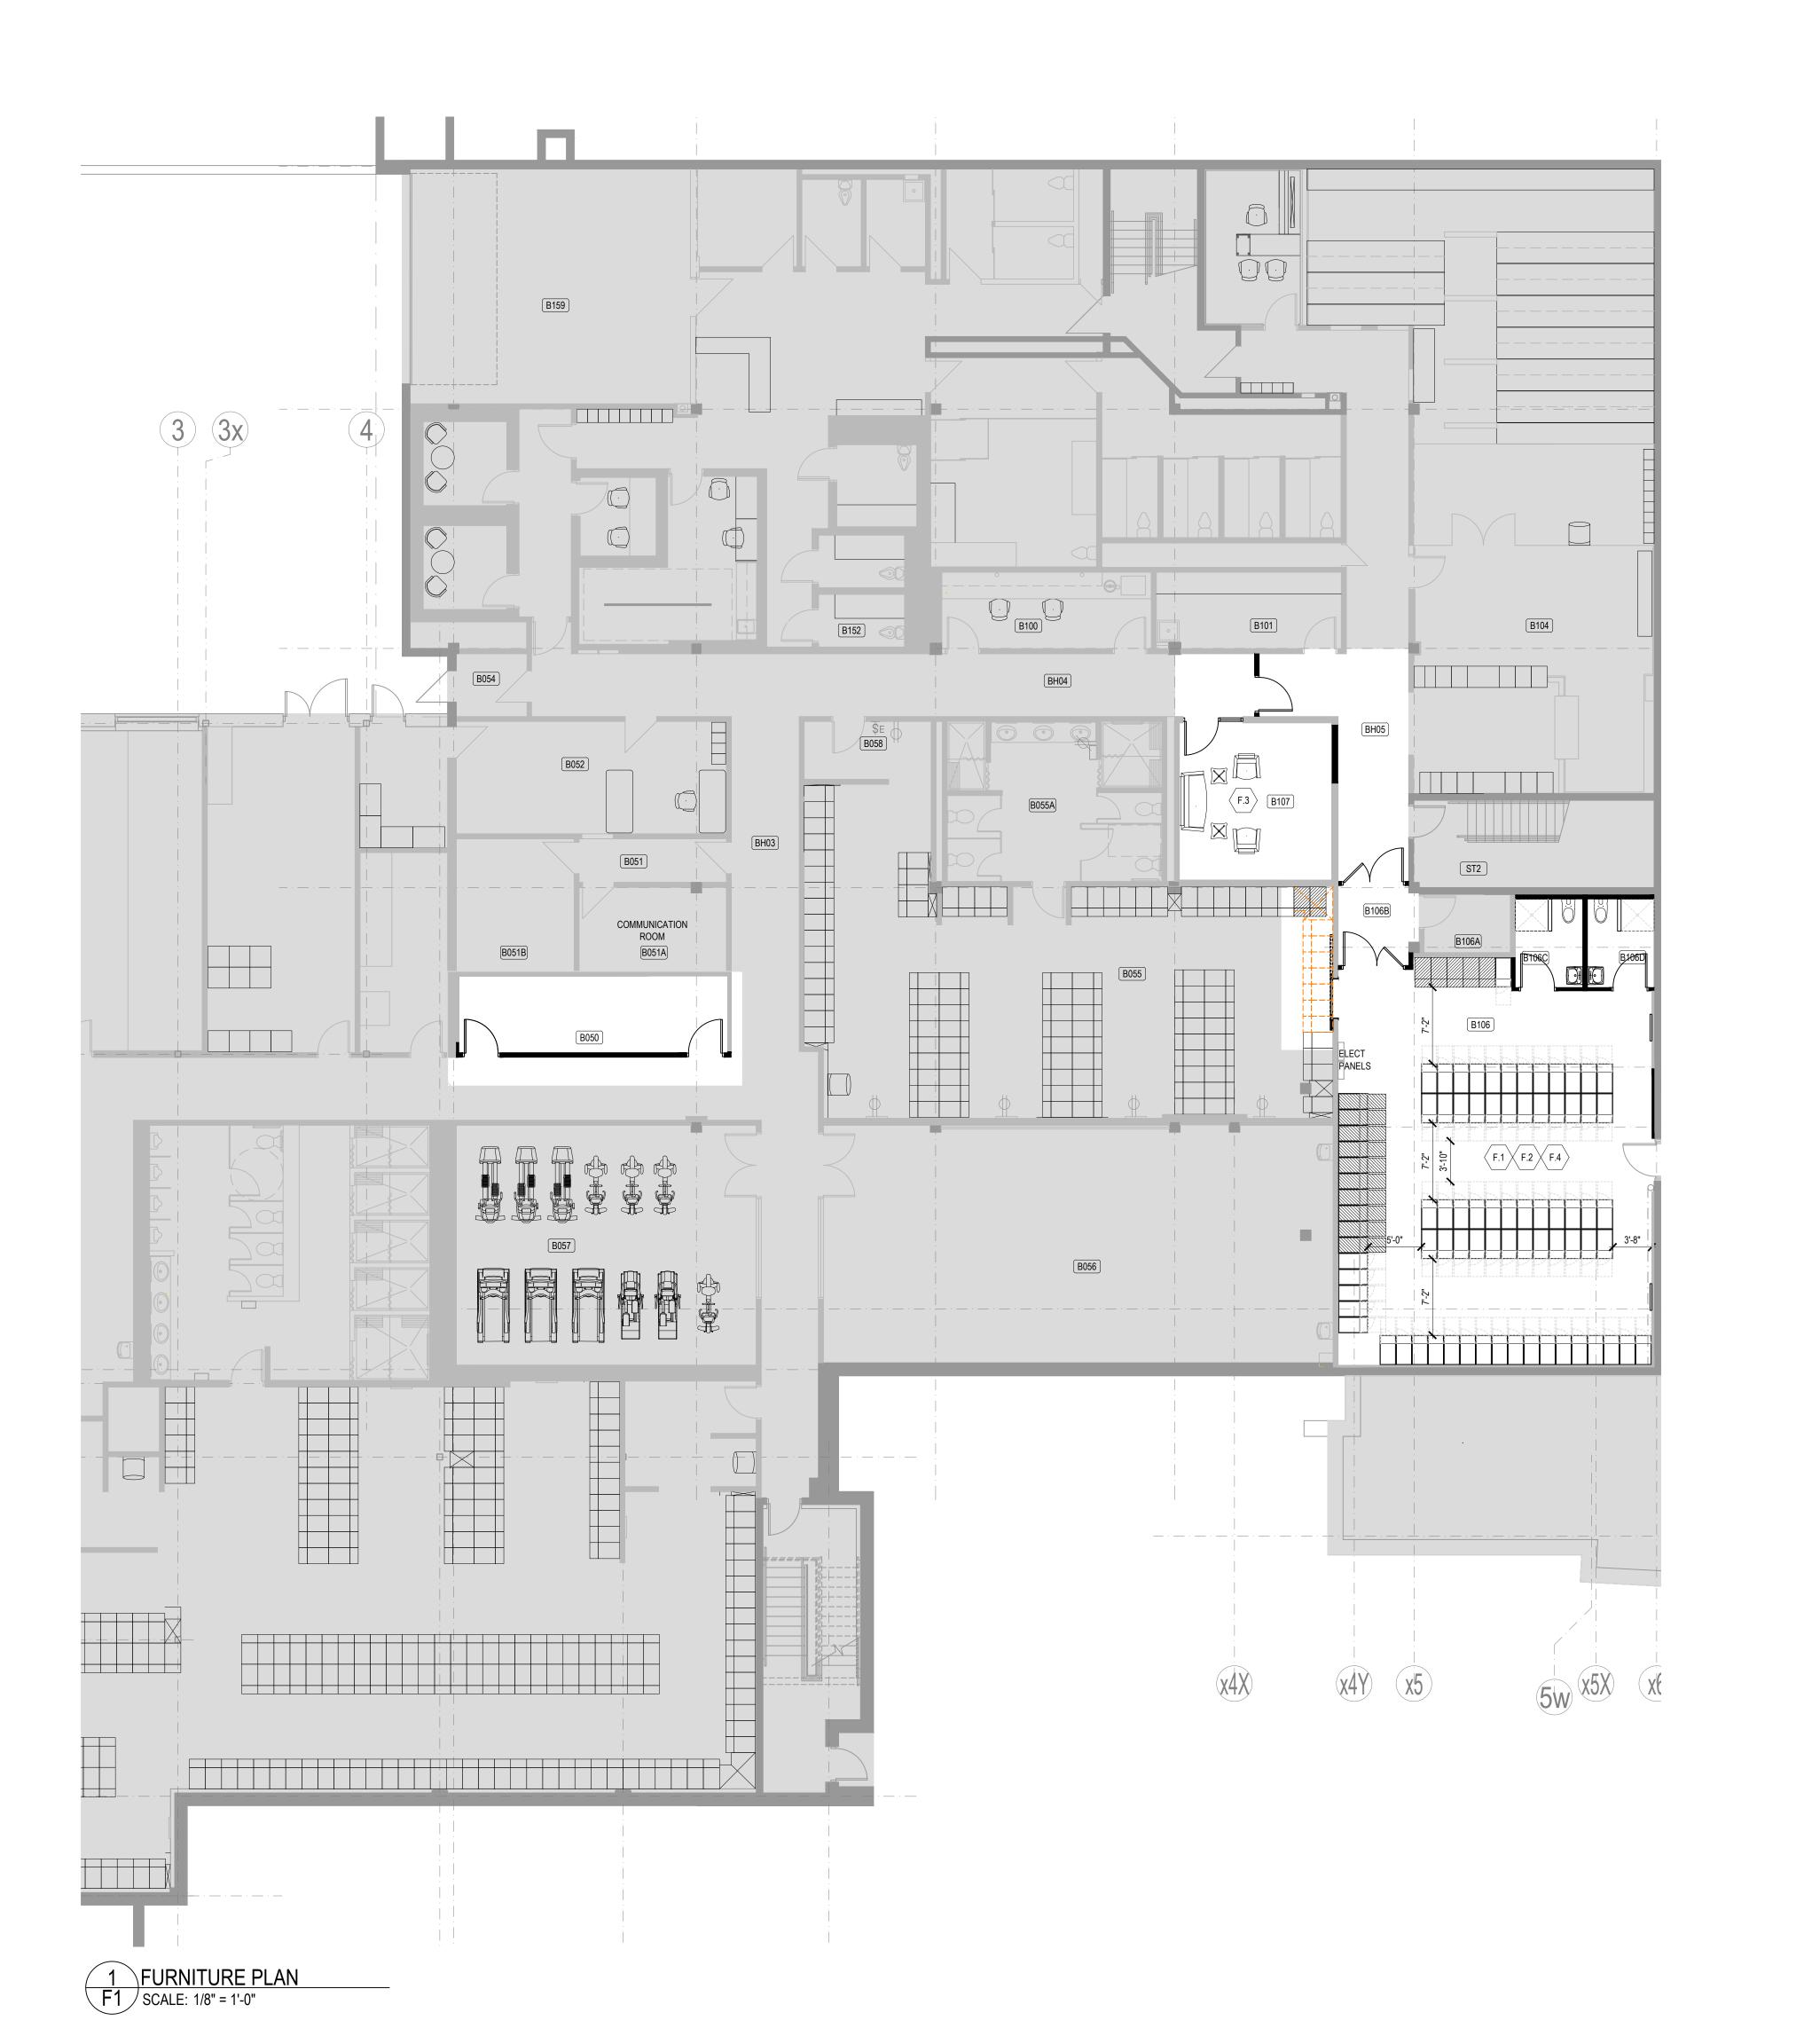
project PEEL REGIONAL POLICE 3030 Erin Mills Parkway Mississauga, ON

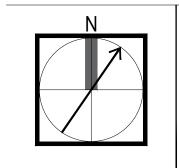
SHOWER DETAILS SCALE AS NOTED

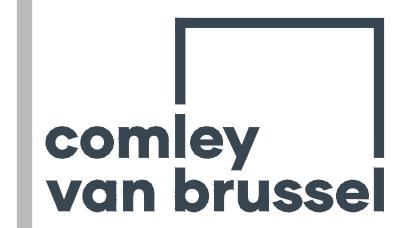Basement

sheet no.

drawn by fh/dly/jc project no. 24-3538



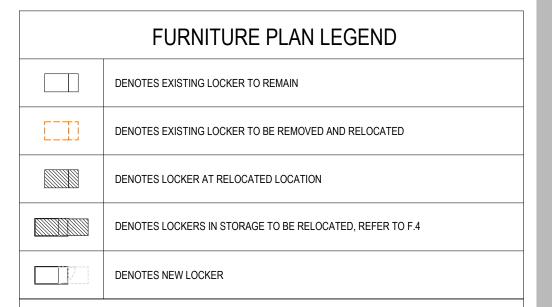

#### FURNITURE PLAN: NOTES

- I. ALL DELIVERIES/INSTALLATION OF FURNITURE TO COMPLY WITH BASE BUILDING REGULATIONS, INCLUDING DISPOSAL OF WASTE.
- 2. FURNITURE SUPPLIER TO COORDINATE WITH MECHANICAL AND ELECTRICAL DRAWINGS AND REPORT ANY SPECIAL CONDITIONS TO DESIGN CONSULTANT.
- 3. FURNITURE INSTALLER TO BE RESPONSIBLE FOR VERIFYING CRITICAL DIMENSIONS ON SITE.
- 4. ALL SYSTEMS FURNITURE MAIN PANEL SPINES TO BE CHALKED/TAPED BY FURNITURE INSTALLER TO BE REVIEWED ON SITE BY DESIGN CONSULTANT.
- 5. NO SUBSTITUTIONS OF PRODUCT WILL BE ACCEPTED WITHOUT PRIOR APPROVAL FROM DESIGN CONSULTANT.
- 6. FURNITURE SUPPLIER TO PROVIDE FULL COMPUTER GENERATED INSTALLATION DRAWINGS FOR REVIEW BY DESIGN CONSULTANT PRIOR TO INSTALLATION, AT NO COST TO THE OWNER.
- 7. AS-BUILTS (RECORD) DRAWINGS TO BE PROVIDED BY FURNITURE SUPPLIER.
- 8. FURNITURE INSTALLER TO ENSURE ALL SURFACES ARE WIPED CLEAN AND SITE IS FREE OF ALL WASTE MATERIAL UPON COMPLETION.
- 9. FURNITURE SUPPLIER TO PROVIDE 3 COPIES OF MAINTENANCE MANUAL, CUT SHEETS AND LIST
- OF FINISHES FOR ALL PRODUCTS TO OWNER.

  10. ALL DIMENSIONS FOR SYSTEMS FURNITURE ARE SHOWN TO CENTER OF PANELS UNLESS NOTED
- 11. KEYING OF LOCKABLE COMPONENTS SUCH AS PEDESTALS, FILE CABINETS, AND OVER HEAD STORAGE TO BE COORDINATED WITH OWNER.
- 12. FURNITURE SUPPLIER TO BE RESPONSIBLE FOR FULL WORKING DAY OF TRAINING SESSIONS ON NEW PRODUCT WITH OWNER/USERS.

#### **KEY NOTES**

| F.1 | GC TO RECONFIGURE EXISTING LOCKERS, SUPPLY AND INSTALL NEW LOCKERS: MANUFACTURER: ANTHONY STEEL STYLE: CONSTABLE LOCKER, 16GA DOORS, C/W HAT SHELF COAT ROD, 4 COAT HOOKS (HOOKS ON BACK OF DOOR) LOCKABLE LOWER DRAWER AND GUN STORAGE VENTILATED DOOR AND DRAWER FINISH: POWDER COATED SOFT WHITE A700, C/W CLEAR LACQUERED MAPLE BENCH SIZE: 18"W x 76"H + SLOPE TOP x 24"-33.5"D CONTACT: METRIC STORAGE SYSTEMS; ED BARRON, TEL. 647-221-6144, EMAIL: ed.barron@metricss.com |
|-----|---|
| F.2 | CLIENT TO REMOVE EXISTING SHELVING UNITS IN THIS AREA   |

| F.2 | CLIENT TO REMOVE EXISTING SHELVING UNITS IN THIS AREA |
|-----|---|
|-----|---|


| F.3 | CONFIRM WITH CLIENT FOR FURNITURE RECONFIGURATION IN THIS AREA |
|-----|--|
|     |  |

CONTRACTOR TO CONTACT CLIENT FOR LOCATION OF 10 NEW LOCKERS STORED ON SITE FOR RELOCATION INTO NEW LOCKER ROOM.

10
09
08
07
06
05
04 issued for permit + tender 25July 2024 dly
03 revised as per PRP 23July 2024 dly
02 Engineer coordination 25Jun 2024 fh
01 issued to PRP for review 21Jun 2024 dly
no. issued for date by
ISSUE / REVISION
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PEEL REGIONAL POLICE 3030 Erin Mills Parkway Mississauga, ON

title FURNITURE PLAN

1/8" = 1'-0"

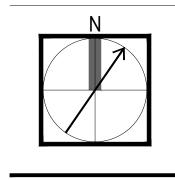drawn by

dly

Basement

sheet no.

dly fh/dly/jc project no. 24-3538 date 05May, 2024

F٬