

CITY OF TORONTO GENERATOR REPLACEMENT (51 DIVISION)

51 PARLIAMENT STREET, TORONTO - ONTARIO

DRAWING LIST:

210248-CVR

COVER PAGE

SITE DRAWINGS:

210248-P-200

SITE PLAN

MECHANICAL DRAWINGS:

210248-M-100

NATURAL GAS PIPING PLAN

ELECTRICAL DRAWINGS:

210248-E-100 EXISTING ELECTRICAL SITE PLAN & ELECTRICAL DEMO

210248-E-101 NEW ELECTRICAL SITE PLAN

210248-E-102 EXISTING ELECTRICAL SLD, NEW ELECTRICAL NOTES & DETAILS

210248-E-103 NEW ELECTRICAL SLD & GENERATOR CONTROLS.

STRUCTURAL DRAWINGS:


210248-S100 GENERATOR SLAB PLAN AND DETAILS


J + B ENGINEERING INC.

TORONTO
25 CENTURIAN DR.
SUITE 201
MARKHAM, ON L3R 5N8


CALGARY
638-11TH AVE. SW
SUITE 200
CALGARY AB T2R 0E2

416 229 2636

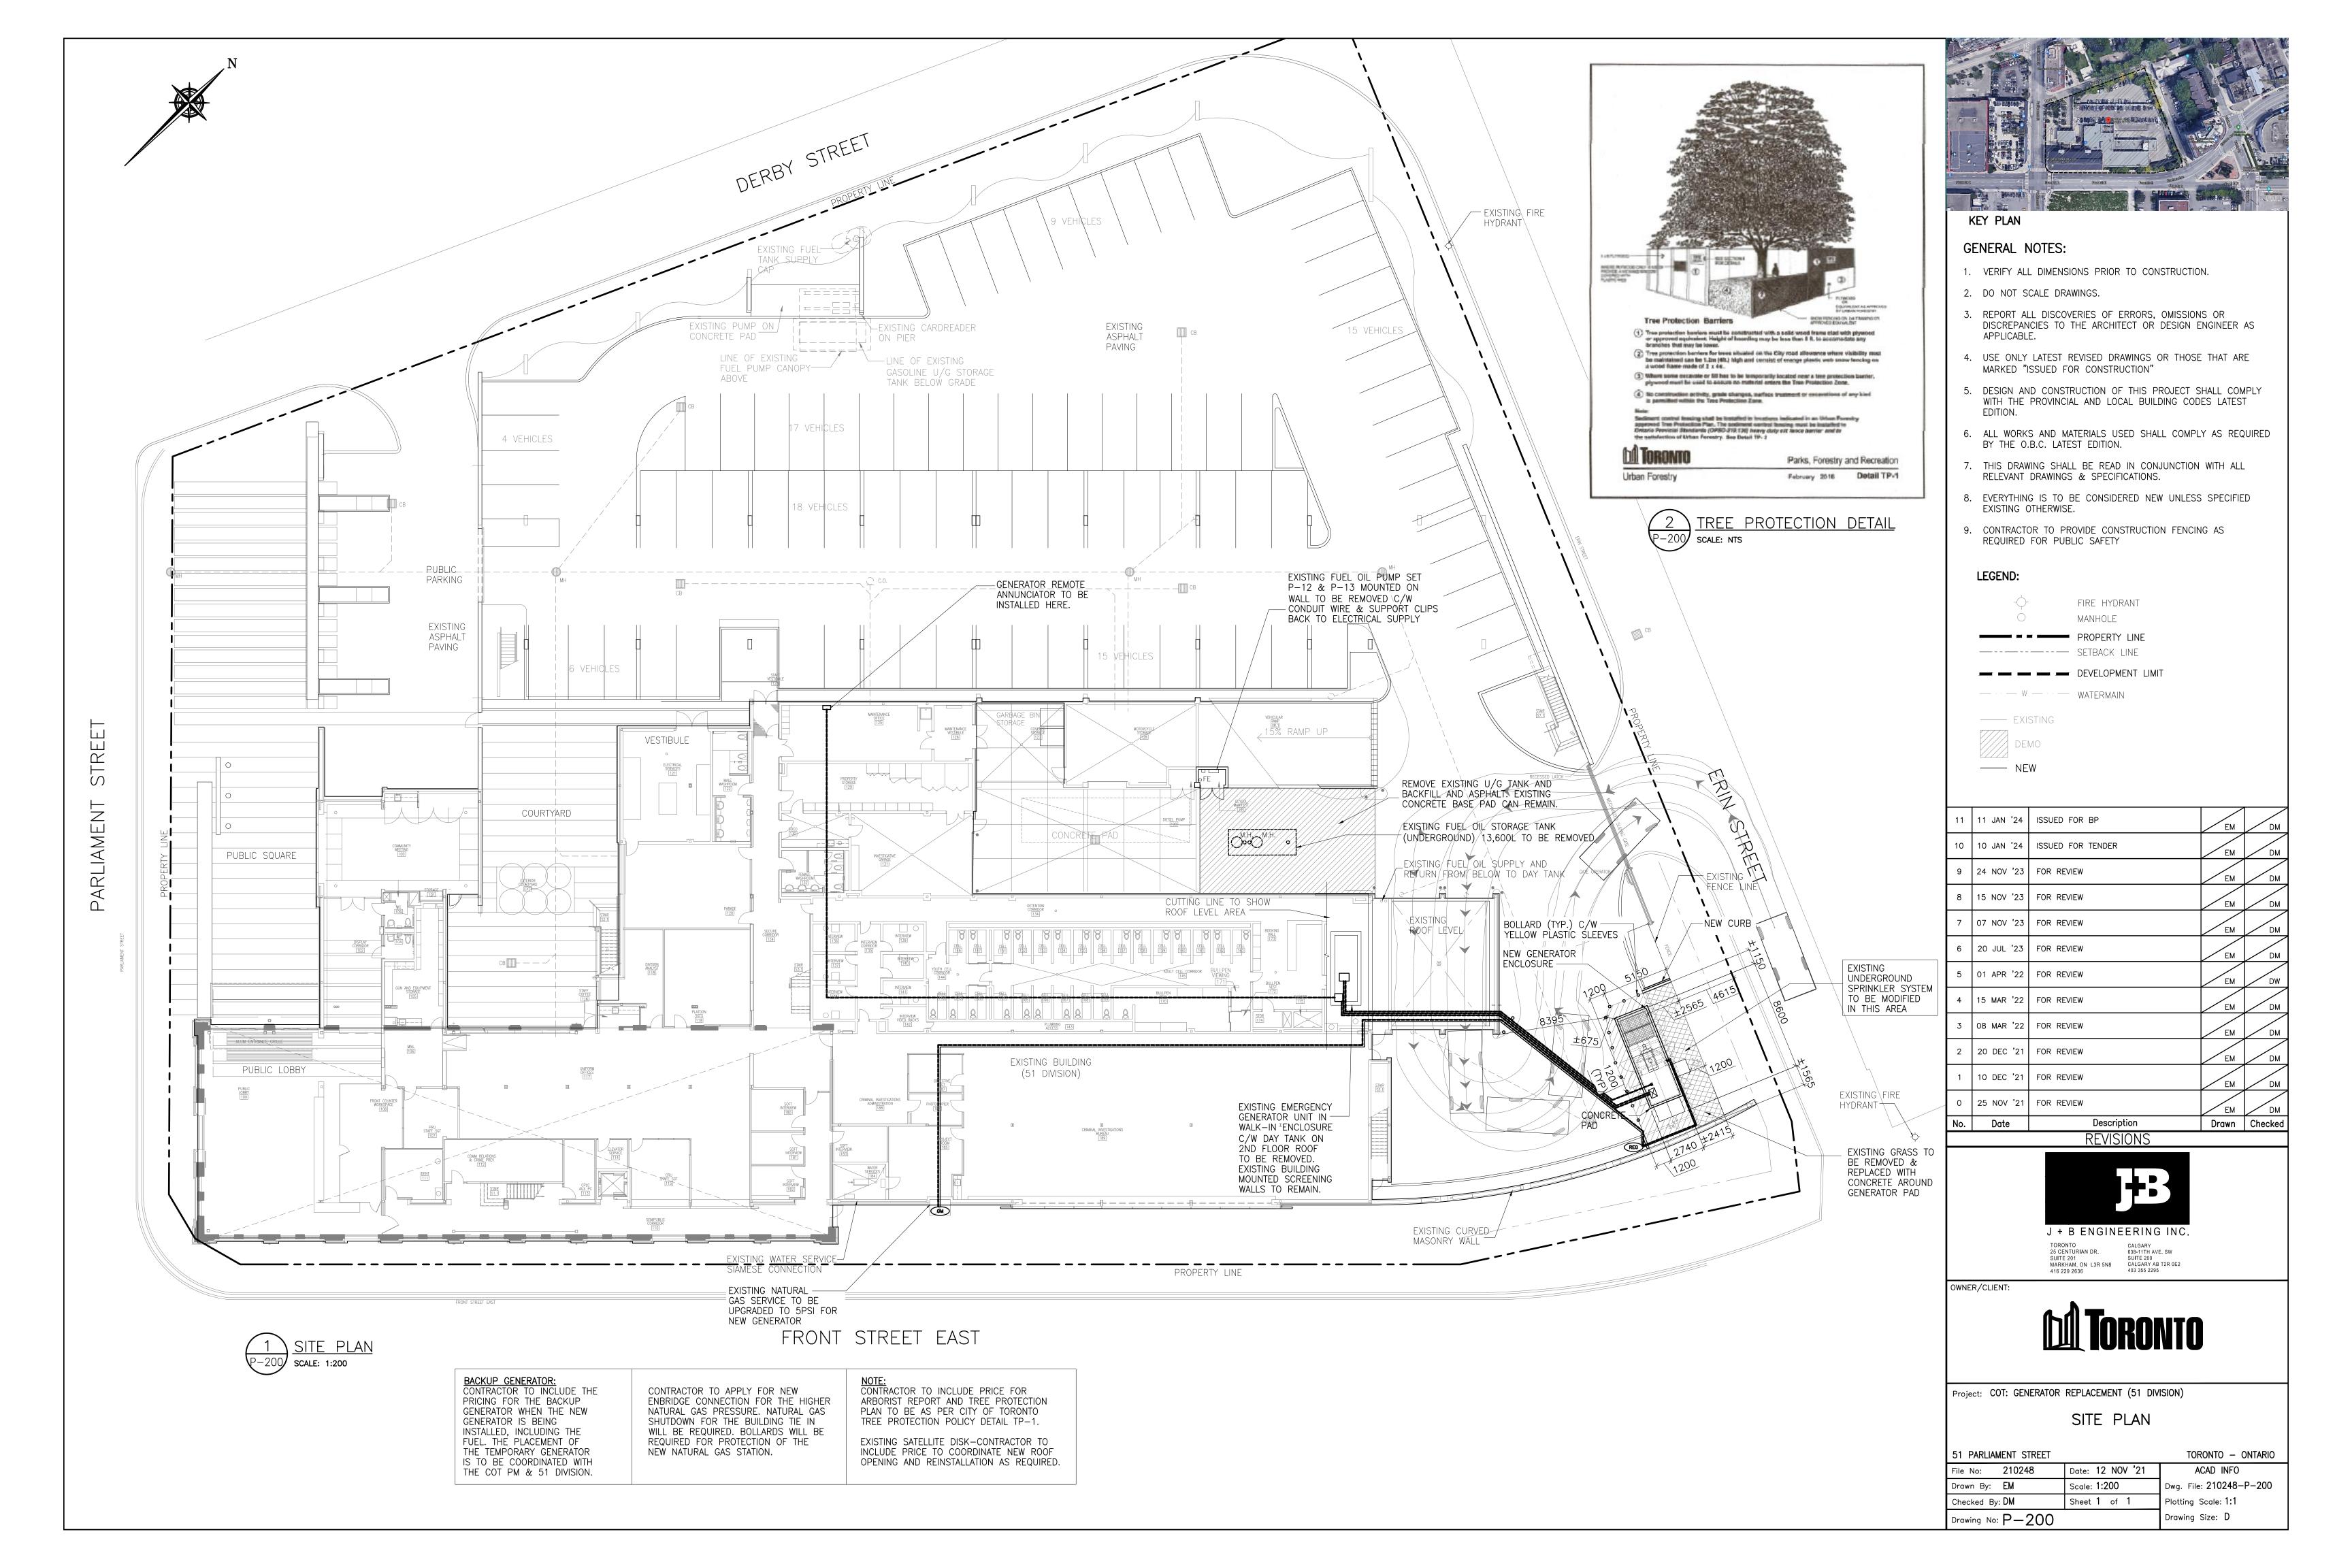

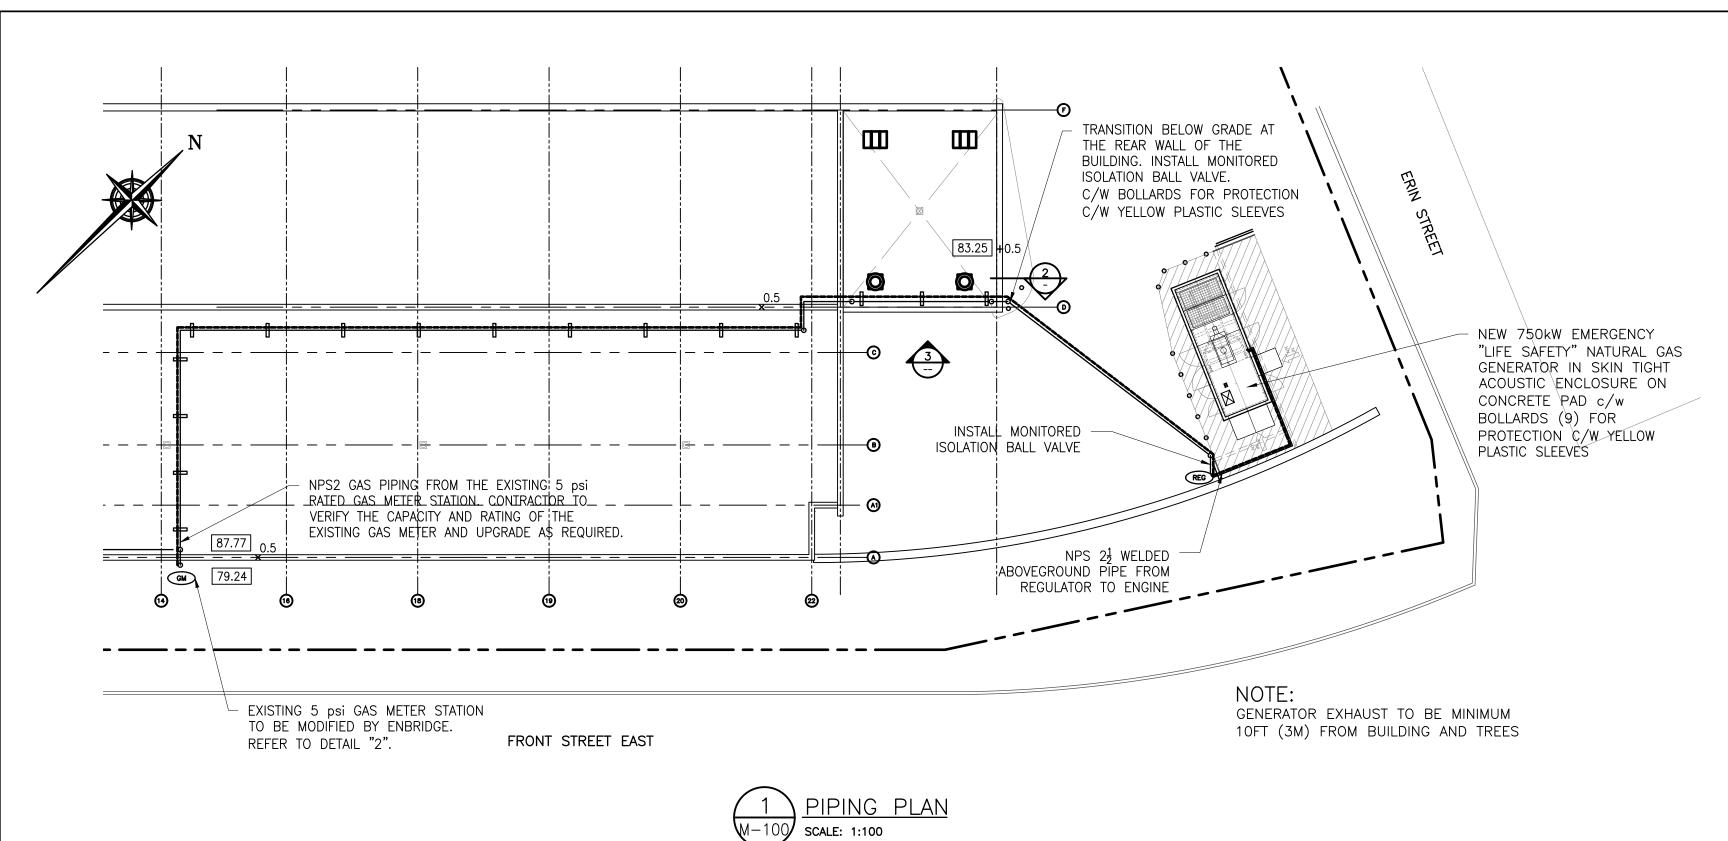





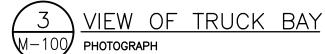


PHP MODEL SS8-R PIPE SUPPORT OR 9.5mm TK PLATE, PIPE CLAMP, ANVIL 75×100 9.5mm TK PLATE, FIG 295 OR EQUAL 50 WIDE, LENGTH CUT TO SUIT PIPE CLAMP, ANVIL BOLLARDS FOR -FIG 295 OR EQUAL PROTECTION C/W PLAN VIEW YELLOW PLASTIC SLEEVES MONITORED ISOLATION BALL VALVE SCALE: 1:30

NPS 2 PIPE

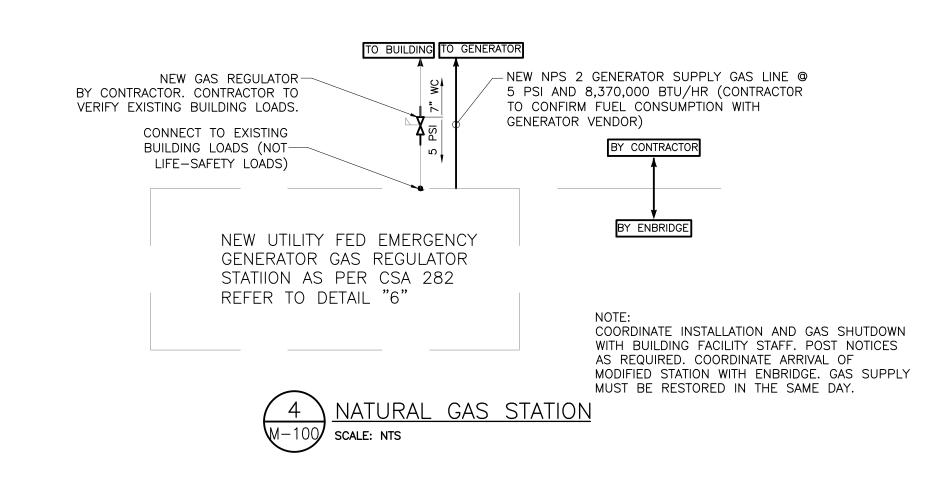

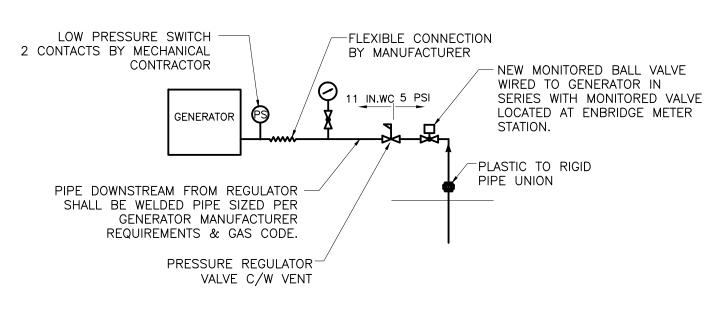



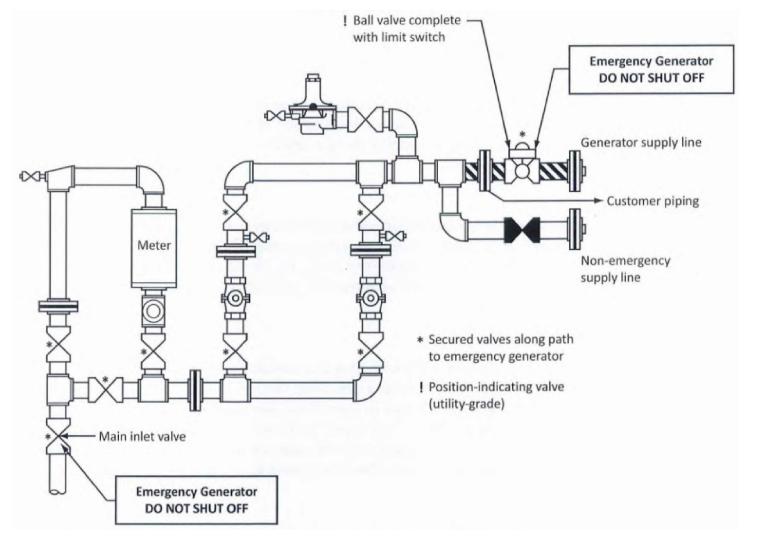

6 CSA C28 2FIG B.1 — UTILITY FED EMERGENCY GENERATOR GAS STATION SCALE: NTS

GAS PIPING NOTES:

- 1. CONTRACTOR TO PAY AND CO-ORDINATE WITH ENBRIDGE REPLACEMENT/UPGRADE OF THE EXISTING METER STATION WITH NEW 5PSI GAS METER STATION IN ACCORDANCE WITH CSA C282-REFER TO DETAILS IN THIS DRAWING. PROTECTIVE BOLLARDS TO BE INSTALLED AS REQUIRED TO PROTECT METER STATION FROM VEHICLE DAMAGE. REFER TO DWG S-100 FOR BOLLARDS DETAILS.
- 2. CONTRACTOR TO CO-ORDINATE WITH ENBRIDGE THE TERMINATION POINTS OF THE NEW GAS LINE AND EXISTING GAS LINE AT THE NEW/UPGRADED 5 PSI GAS METER STATION. CHECK WITH ENBRIDGE REGARDING CORROSION PROTECTION REQUIREMENTS. SUPPORT PIPE FROM BUILDING WALLS WITH SUITABLE RISER CLAMPS.
- INSTALL NEW GAS LINE FOR GENERATOR FROM ENBRIDGE UPGRADED GAS STATION AS SHOWN ON THE PLAN. THE GAS FUEL CONSUMPTION AT 100% LOAD IS SITE SPECIFIC. VERIFY THIS WITH SHOP DRAWINGS.
- 4. CO-ORDINATE WITH THE GENERATOR MANUFACTURER THE EXACT ENTRY POINT ON THE GENERATOR OF THE NATURAL GAS LINE.
- 5. THE FINAL ROUTE OF NEW GAS LINE FROM UPGRADED GAS METER TO THE NEW GENERATOR TO BE DETERMINED AND VERIFIED BY THE CONTRACTOR.
- CONTRACTOR TO COORDINATE WITH GENERAL CONTRACTOR FOR EXCAVATION, BACKFILLING AND COMPACTION FOR INSTALLATION OF BURIED GAS LINE. GENERAL CONTRACTOR IS RESPONSIBLE TO PERFORM EXCAVATION, BACKFILLING AND COMPACTION. GENERAL CONTRACTOR TO COORDINATE ANY TRENCHING AND INSTALLATION WITH CITY REPRESENTATIVE TO MINIMIZE DISRUPTION TO FACILITY OPERATION.
- 7. GAS SYSTEM SHALL COMPLY WITH THE LATEST EDITION OF CSA B149.1&2, THE ONTARIO GAS UTILIZATION CODE, THE ONTARIO ENERGY ACT AND LOCAL BY—LAWS AND AUTHORITIES HAVING JURISDICTION.
- 8. USE WELDERS QUALIFIED AND LICENSED BY PROVINCIAL AUTHORITIES. FURNISH WELDER'S QUALIFICATIONS UPON REQUEST.
- 9. ALL EQUIPMENT AND MATERIALS TO BE CGA OR CSA
- 10. GAS PIPING ABOVE GROUND SHALL BE SCHEDULE 40 STEEL PIPE, BURIED GAS PIPES SHALL BE PLASTIC PIPE.
- 11. FITTINGS SHALL BE 150 PSI BLACK MALLEABLE IRON. USE SCREWED FITTING FOR PIPE UP TO NPS 2" DIAMETER WHERE ACCEPTABLE AND STEEL WELDED FITTINGS FOR PIPE NPS $2\frac{1}{2}$ " AND OVER.
- 12. USE CSA AND CGA APPROVED BALL AND LUBRICATED PLUG VALVES WITH LEVER HANDLES.
- 13. TEST ALL GAS PIPING AS REQUIRED BY GAS CODE. SYSTEM SHALL RETAINED THE TEST PRESSURE FOR THE MIN. DURATION OF 1 HOUR WITHOUT LOSS OF PRESSURE.
- 14. JOINTS SHALL BE CHECKED WITH SOAP AND WATER SOLUTION DURING AIR TEST TO ASCERTAIN ANY LEAKS.
- 15. ALL BURIED PIPING SHALL BE TESTED BEFORE BACKFILLING.
- 16. ALL GAS PIPING, INCLUDING PIPING IN CONCEALED SPACES, SHALL BE PAINTED "YELLOW" EXCEPT THE VERTICAL PIPE ON EXTERIOR WALL FACING FRONT STREET WHICH SHALL BE PAINTED GRAY TO MATCH BRICK FACADE.
- 17. PIPE ALL INTERIOR RELIEF VALVES AND GAS VENTS TO THE EXTERIOR OF THE BUILDING.
- 18. MINIMUM GAS PIPE SIZES SHALL BE IN COMPLIANCE WITH GAS UTILIZATION CODE.




KEY PLAN

GENERAL NOTES:

- 1. VERIFY ALL DIMENSIONS PRIOR TO CONSTRUCTION.
- 2. DO NOT SCALE DRAWINGS.
- 3. REPORT ALL DISCOVERIES OF ERRORS, OMISSIONS OR DISCREPANCIES TO THE ARCHITECT OR DESIGN ENGINEER AS APPLICABLE.
- 4. USE ONLY LATEST REVISED DRAWINGS OR THOSE THAT ARE MARKED "ISSUED FOR CONSTRUCTION"
- 5. DESIGN AND CONSTRUCTION OF THIS PROJECT SHALL COMPLY WITH THE PROVINCIAL AND LOCAL BUILDING CODES LATEST FOITION
- 6. ALL WORKS AND MATERIALS USED SHALL COMPLY AS REQUIRED BY THE O.B.C. LATEST EDITION.
- 7. THIS DRAWING SHALL BE READ IN CONJUNCTION WITH ALL RELEVANT DRAWINGS & SPECIFICATIONS.
- 8. EVERYTHING IS TO BE CONSIDERED NEW UNLESS SPECIFIED EXISTING OTHERWISE.
- 9. CONTRACTOR TO PROVIDE CONSTRUCTION FENCING AS REQUIRED FOR PUBLIC SAFETY

REVISIONS					
No.	Date	Description	Drawn	Checked	
0	08 MAR '22	PRELIM FOR REVIEW	EM	DW	
1	15 MAR '22	FOR REVIEW	EM	DW	
2	01 APR '22	FOR REVIEW	EM	DW	
3	07 NOV '23	FOR REVIEW	EM	DW	
4	15 NOV '23	FOR REVIEW	EM	DW	
5	24 NOV '23	FOR REVIEW	EM	DW	
6	10 JAN '24	ISSUED FOR TENDER	EM	DW	
7	11 JAN '24	ISSUED FOR BP	EM	DW	
8	27 MAY '24	ADDED NATURAL GAS DETAIL	DW	DW	

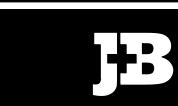

J + B ENGINEERING INC.

TORONTO
25 CENTURIAN DR.
SUITE 201
MARKHAM, ON L3R 5N8
416 229 2636

CALGARY
707-10TH AVE. SW
SUITE 150
CALGARY AB T2R 0B3
403 355 2295

OWNER/CLIENT:



Project: COT: GENERATOR REPLACEMENT (51 DIVISION)


NATURAL GAS PIPING PLAN

51 PARLIAMENT STREET			
File No: 210248	Date: 20 SEPT '23		
Drawn By: DW	Scale: AS SHOWN		
Checked By: DM	Sheet 1 of 1		
Drawing No: $M-100$			

Dwg. File: 210248—M—100
Plotting Scale: 1:1
Drawing Size: D

ACAD INFO

TORONTO - ONTARIO

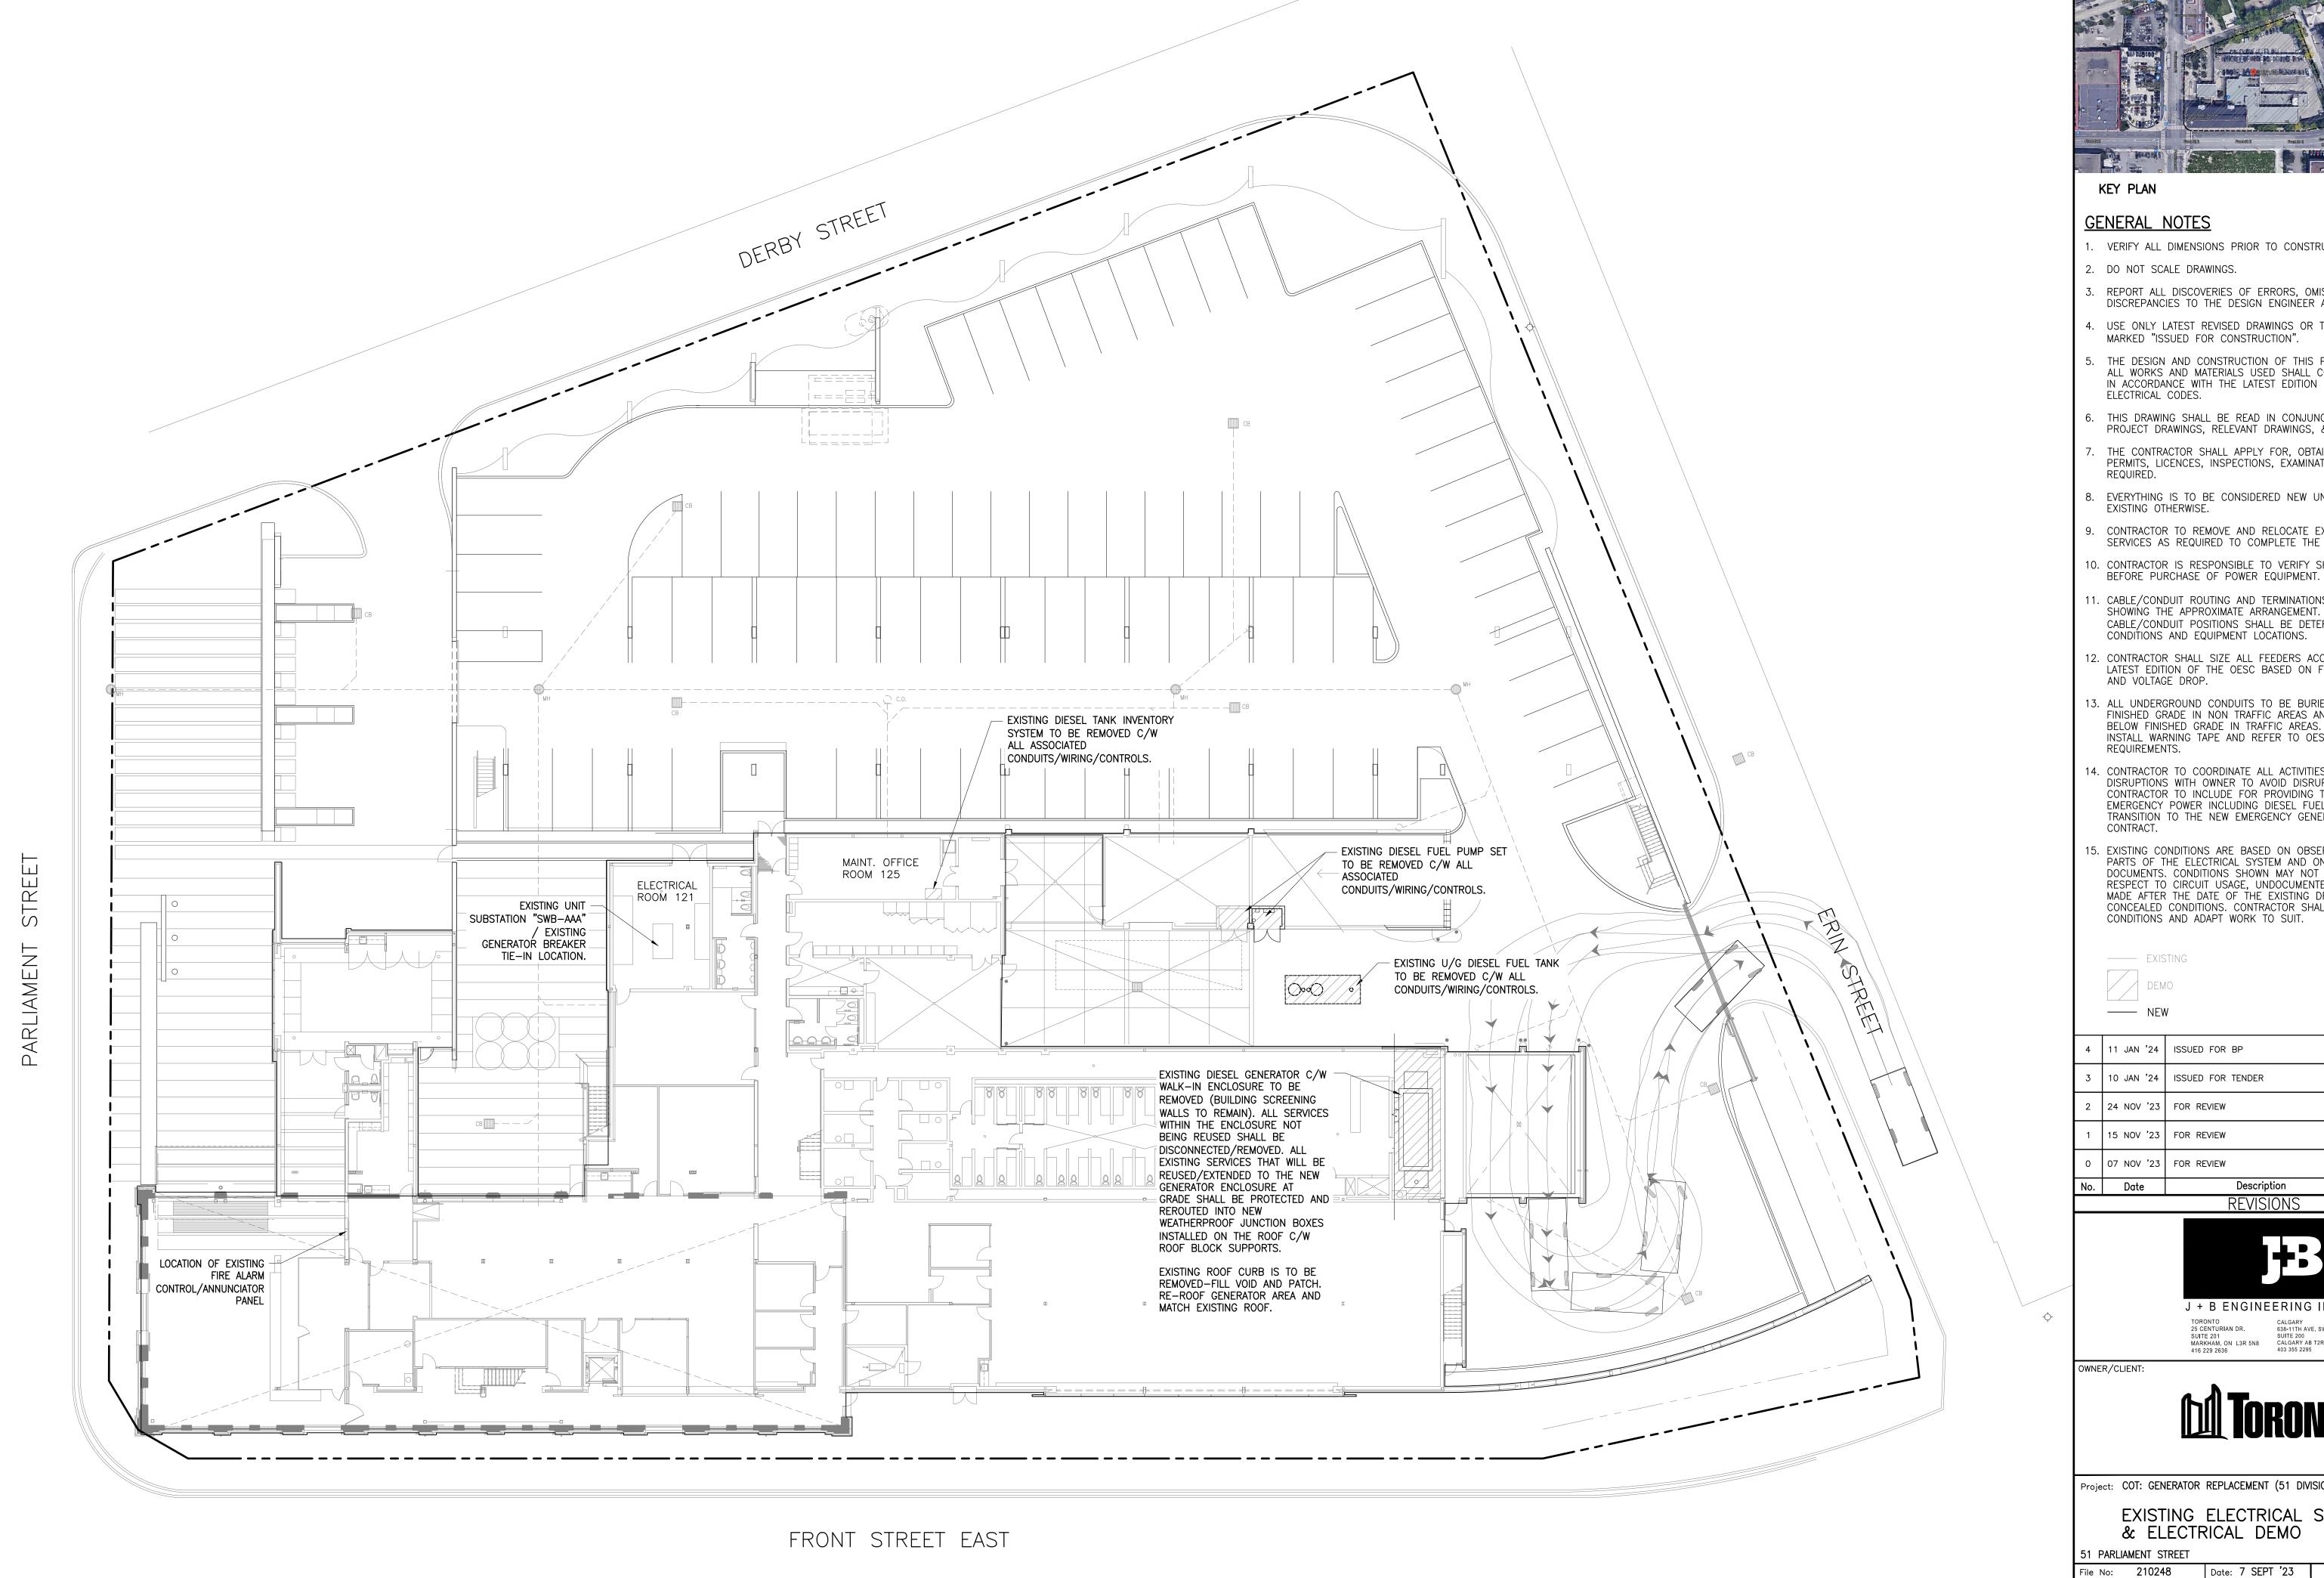



- 1. VERIFY ALL DIMENSIONS PRIOR TO CONSTRUCTION.
- 3. REPORT ALL DISCOVERIES OF ERRORS, OMISSIONS OR DISCREPANCIES TO THE DESIGN ENGINEER AS APPLICABLE.
- 4. USE ONLY LATEST REVISED DRAWINGS OR THOSE THAT ARE MARKED "ISSUED FOR CONSTRUCTION".
- 5. THE DESIGN AND CONSTRUCTION OF THIS PROJECT INCLUDING ALL WORKS AND MATERIALS USED SHALL COMPLY AS REQUIRED IN ACCORDANCE WITH THE LATEST EDITION OF THE BUILDING AND
- 6. THIS DRAWING SHALL BE READ IN CONJUNCTION WITH ALL PROJECT DRAWINGS, RELEVANT DRAWINGS, & SPECIFICATIONS.
- 7. THE CONTRACTOR SHALL APPLY FOR, OBTAIN AND PAY FOR ALL PERMITS, LICENCES, INSPECTIONS, EXAMINATIONS AND FEES
- B. EVERYTHING IS TO BE CONSIDERED NEW UNLESS SPECIFIED
- 9. CONTRACTOR TO REMOVE AND RELOCATE EXISTING ELECTRICAL SERVICES AS REQUIRED TO COMPLETE THE ELECTRICAL WORK.
- 10. CONTRACTOR IS RESPONSIBLE TO VERIFY SHORT CIRCUIT RATING
- 11. CABLE/CONDUIT ROUTING AND TERMINATIONS ARE DIAGRAMMATIC, SHOWING THE APPROXIMATE ARRANGEMENT. ACTUAL CABLE/CONDUIT POSITIONS SHALL BE DETERMINED TO SUIT FIELD
- 12. CONTRACTOR SHALL SIZE ALL FEEDERS ACCORDING TO THE LATEST EDITION OF THE OESC BASED ON FINAL FEEDER LENGTHS
- 13. ALL UNDERGROUND CONDUITS TO BE BURIED MIN. 600MM BELOW FINISHED GRADE IN NON TRAFFIC AREAS AND MIN. 900MM BELOW FINISHED GRADE IN TRAFFIC AREAS. CONTRACTOR TO INSTALL WARNING TAPE AND REFER TO OESC FOR ADDITIONAL
- 14. CONTRACTOR TO COORDINATE ALL ACTIVITIES AND POWER DISRUPTIONS WITH OWNER TO AVOID DISRUPTIONS TO TENANTS. CONTRACTOR TO INCLUDE FOR PROVIDING TEMPORARY EMERGENCY POWER INCLUDING DIESEL FUEL DURING THE TRANSITION TO THE NEW EMERGENCY GENERATOR UNDER THIS
- 15. EXISTING CONDITIONS ARE BASED ON OBSERVATIONS OF VISIBLE PARTS OF THE ELECTRICAL SYSTEM AND ON EXISTING DOCUMENTS. CONDITIONS SHOWN MAY NOT BE ACCURATE WITH RESPECT TO CIRCUIT USAGE, UNDOCUMENTED MODIFICATIONS MADE AFTER THE DATE OF THE EXISTING DRAWINGS OR CONCEALED CONDITIONS. CONTRACTOR SHALL VERIFY EXISTING CONDITIONS AND ADAPT WORK TO SUIT.

4	11 JAN '24	ISSUED FOR BP	AM	DM
3	10 JAN '24	ISSUED FOR TENDER	AM	DM
2	24 NOV '23	FOR REVIEW	AM	DM
1	15 NOV '23	FOR REVIEW	AM	DM
0	07 NOV '23	FOR REVIEW	AM	DM
No.	Date	Description	Drawn	Checked

REVISIONS



J + B ENGINEERING INC.

TORONTO CALGARY
25 CENTURIAN DR. 638-11TH AVE. SW
SUITE 201 SUITE 200
MARKHAM, ON L3R 5N8 CALGARY AB T2R 0E2
416 229 2636 403 355 2295



Project: COT: GENERATOR REPLACEMENT (51 DIVISION)

EXISTING ELECTRICAL SITE PLAN & ELECTRICAL DEMO

Scale: 1:200

Date: 7 SEPT '23


Drawn By: **EM**

ACAD INFO Dwg. File: 210248-E-100 Plotting Scale: 1:1

TORONTO - ONTARIO

Sheet 1 of 1 Checked By: AM Drawing No: E-100

Drawing Size: D

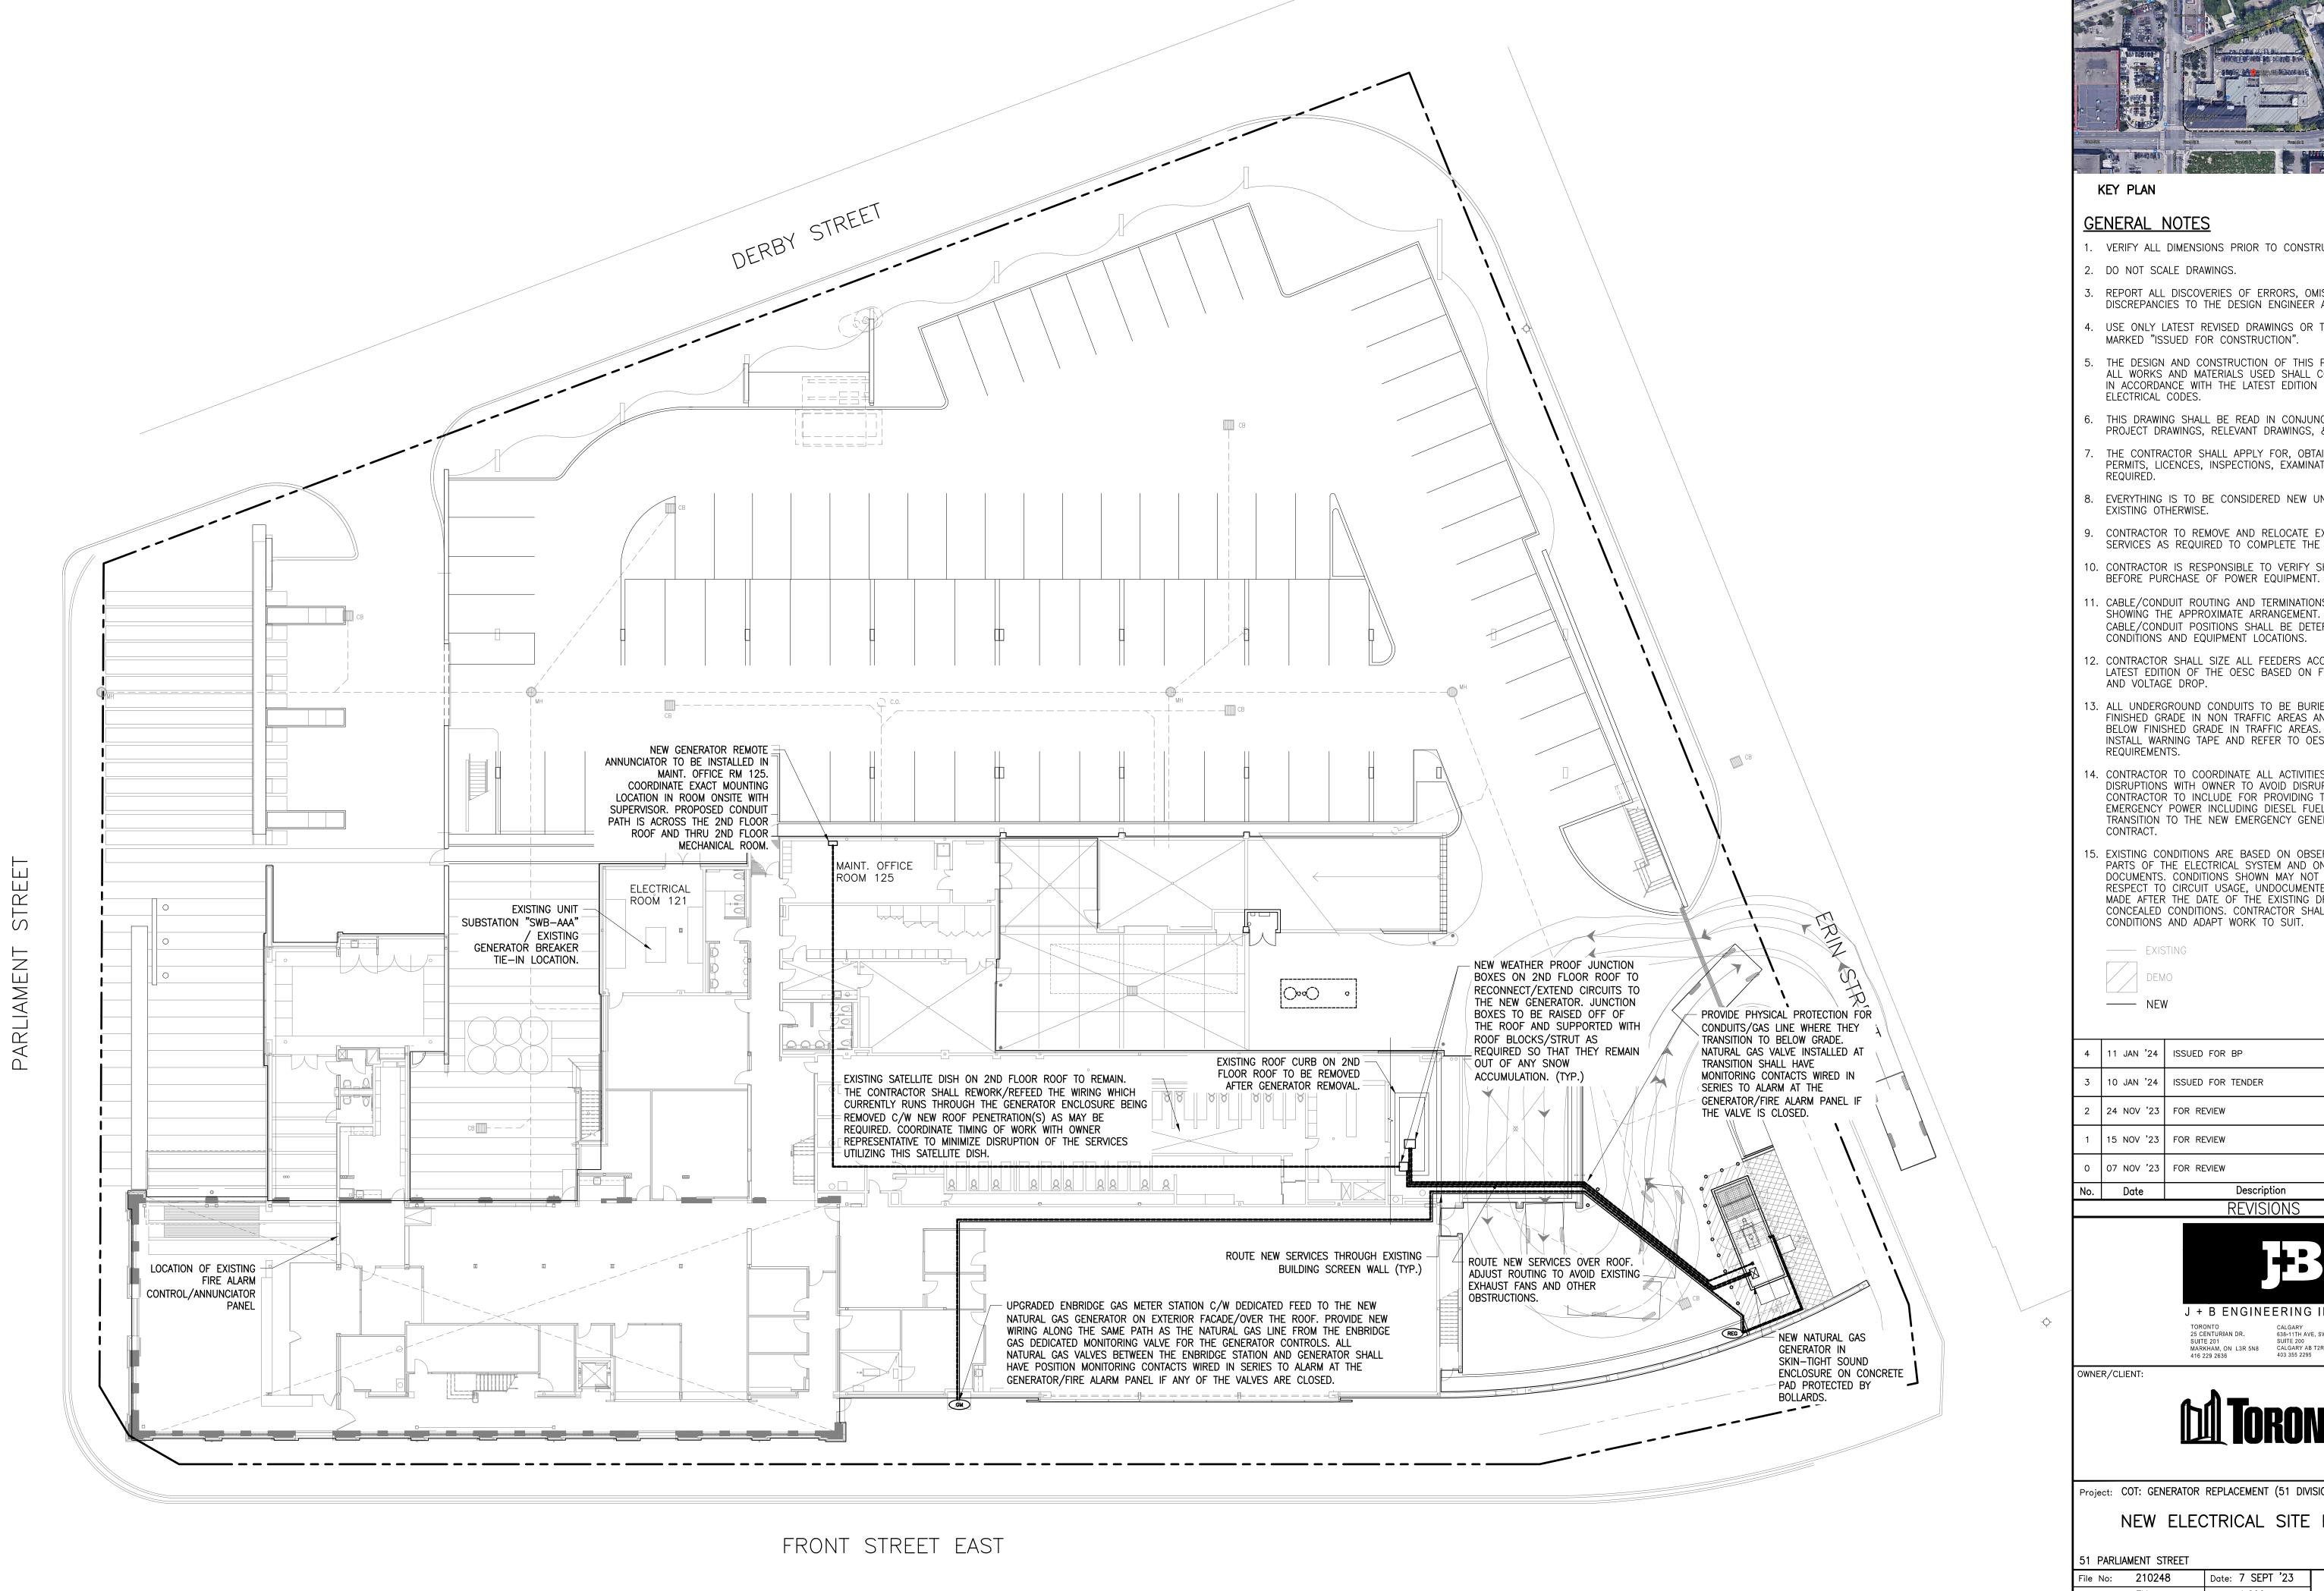

KEY PLAN

GENERAL NOTES

- 1. VERIFY ALL DIMENSIONS PRIOR TO CONSTRUCTION.
- 2. DO NOT SCALE DRAWINGS.
- 3. REPORT ALL DISCOVERIES OF ERRORS, OMISSIONS OR DISCREPANCIES TO THE DESIGN ENGINEER AS APPLICABLE.
- 4. USE ONLY LATEST REVISED DRAWINGS OR THOSE THAT ARE MARKED "ISSUED FOR CONSTRUCTION".
- 5. THE DESIGN AND CONSTRUCTION OF THIS PROJECT INCLUDING ALL WORKS AND MATERIALS USED SHALL COMPLY AS REQUIRED IN ACCORDANCE WITH THE LATEST EDITION OF THE BUILDING AND ELECTRICAL CODES.
- 6. THIS DRAWING SHALL BE READ IN CONJUNCTION WITH ALL PROJECT DRAWINGS, RELEVANT DRAWINGS, & SPECIFICATIONS.
- 7. THE CONTRACTOR SHALL APPLY FOR, OBTAIN AND PAY FOR ALL PERMITS, LICENCES, INSPECTIONS, EXAMINATIONS AND FEES
- B. EVERYTHING IS TO BE CONSIDERED NEW UNLESS SPECIFIED EXISTING OTHERWISE.
- 9. CONTRACTOR TO REMOVE AND RELOCATE EXISTING ELECTRICAL SERVICES AS REQUIRED TO COMPLETE THE ELECTRICAL WORK.
- 10. CONTRACTOR IS RESPONSIBLE TO VERIFY SHORT CIRCUIT RATING
- 11. CABLE/CONDUIT ROUTING AND TERMINATIONS ARE DIAGRAMMATIC, SHOWING THE APPROXIMATE ARRANGEMENT. ACTUAL
- CABLE/CONDUIT POSITIONS SHALL BE DETERMINED TO SUIT FIELD CONDITIONS AND EQUIPMENT LOCATIONS. 12. CONTRACTOR SHALL SIZE ALL FEEDERS ACCORDING TO THE
- LATEST EDITION OF THE OESC BASED ON FINAL FEEDER LENGTHS AND VOLTAGE DROP. 13. ALL UNDERGROUND CONDUITS TO BE BURIED MIN. 600MM BELOW FINISHED GRADE IN NON TRAFFIC AREAS AND MIN. 900MM

BELOW FINISHED GRADE IN TRAFFIC AREAS. CONTRACTOR TO

- INSTALL WARNING TAPE AND REFER TO OESC FOR ADDITIONAL REQUIREMENTS. 14. CONTRACTOR TO COORDINATE ALL ACTIVITIES AND POWER DISRUPTIONS WITH OWNER TO AVOID DISRUPTIONS TO TENANTS.
- CONTRACTOR TO INCLUDE FOR PROVIDING TEMPORARY EMERGENCY POWER INCLUDING DIESEL FUEL DURING THE TRANSITION TO THE NEW EMERGENCY GENERATOR UNDER THIS CONTRACT.
- 15. EXISTING CONDITIONS ARE BASED ON OBSERVATIONS OF VISIBLE PARTS OF THE ELECTRICAL SYSTEM AND ON EXISTING DOCUMENTS. CONDITIONS SHOWN MAY NOT BE ACCURATE WITH RESPECT TO CIRCUIT USAGE, UNDOCUMENTED MODIFICATIONS MADE AFTER THE DATE OF THE EXISTING DRAWINGS OR CONCEALED CONDITIONS. CONTRACTOR SHALL VERIFY EXISTING CONDITIONS AND ADAPT WORK TO SUIT.



---- NEW

4	11 JAN '24	ISSUED FOR BP	AM	DN
3	10 JAN '24	ISSUED FOR TENDER	AM	DM
2	24 NOV '23	FOR REVIEW	AM	DM
1	15 NOV '23	FOR REVIEW	AM	DM
0	07 NOV '23	FOR REVIEW	AM	DN
No.	Date	Description	Drawn	Checke

REVISIONS

J + B ENGINEERING INC.

TORONTO CALGARY
25 CENTURIAN DR. 638-11TH AVE. SW
SUITE 201 SUITE 200
MARKHAM, ON L3R 5N8 CALGARY AB T2R 0E2
416 229 2636 403 355 2295

OWNER/CLIENT:




Project: COT: GENERATOR REPLACEMENT (51 DIVISION)

NEW ELECTRICAL SITE PLAN

PARLIAMENT STREET	
e No: 210248	Date: 7 SEPT '23
awn By: EM	Scale: 1:200
acked By: AM	Sheet 1 of 1

Drawing No: E-101

TORONTO - ONTARIO ACAD INFO Dwg. File: 210248-E-101 Plotting Scale: 1:1 Drawing Size: **D**

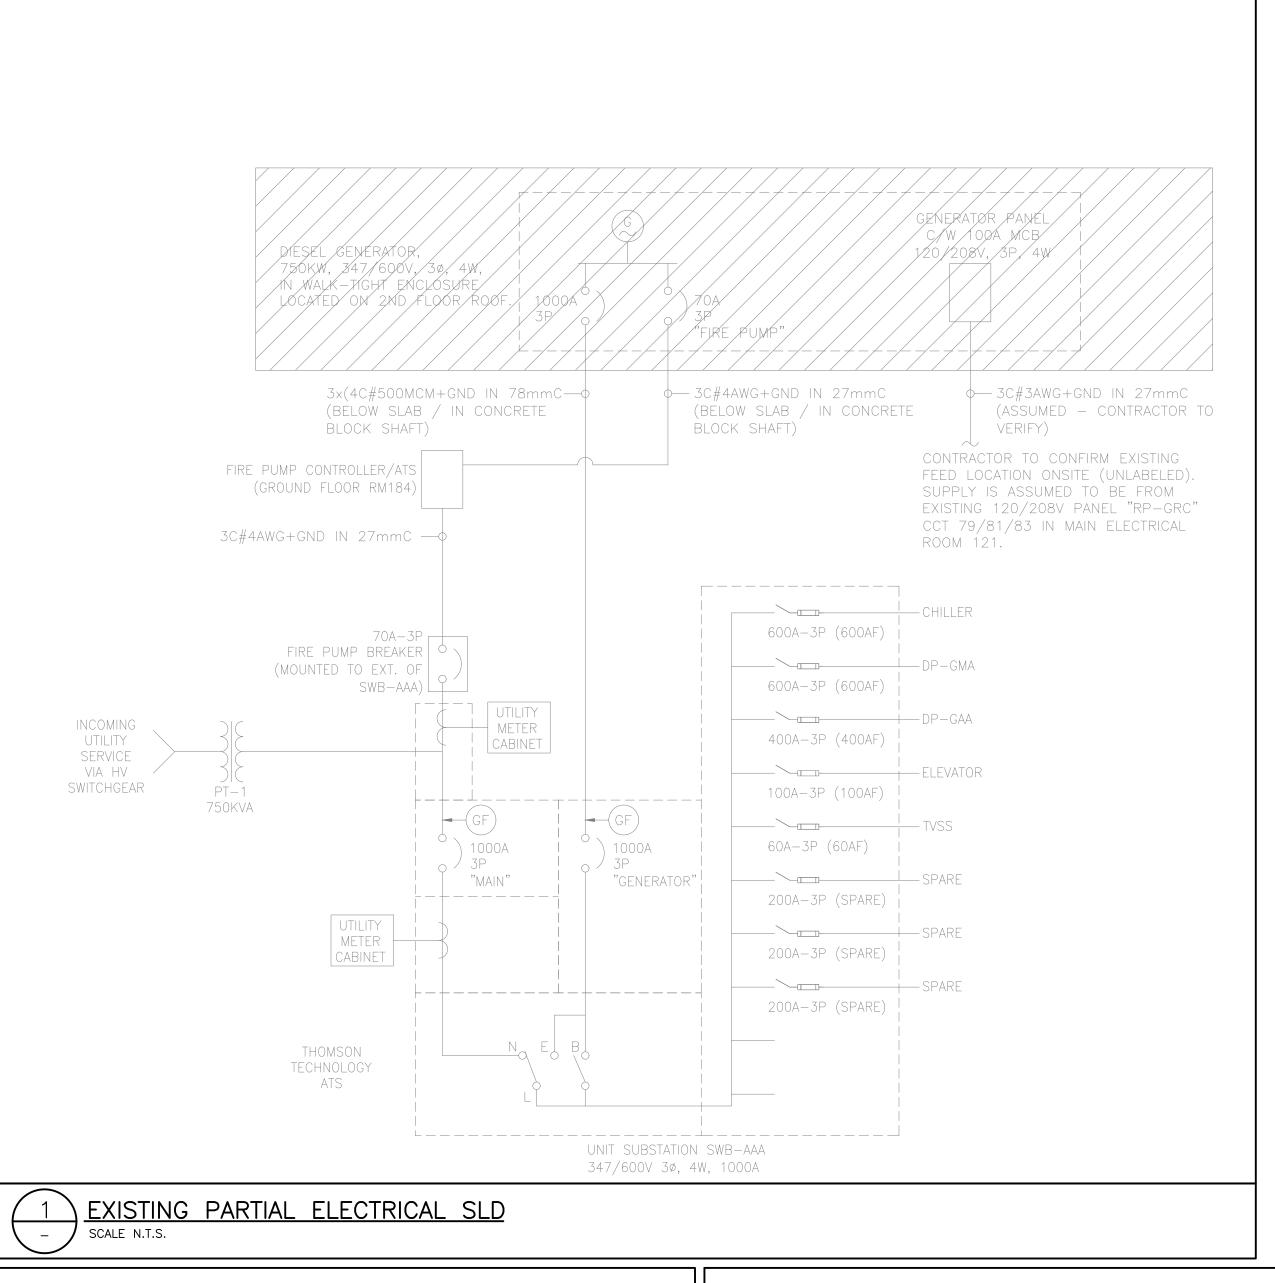

ELECTRICAL NOTES:

- IN GENERAL, THE WORK INCLUDES TO FURNISH AND INSTALL A NEW LIFE SAFETY GENERATOR INCLUDING NEW ELECTRICAL, MECHANICAL, CIVIL/STRUCTURAL AND DEMOLITION OF EXISTING SYSTEMS, AS MORE THOROUGHLY DEFINED IN DRAWINGS AND SPECIFICATIONS.
- 1. THIS PROJECT IS NOT A COMPLETE REPLACEMENT/UPGRADE OF THE ELECTRICAL LIFE SAFETY SYSTEMS WITHIN THE BUILDING. THE ELECTRICAL SCOPE OF WORK INCLUDES THE REPLACEMENT OF THE EMERGENCY GENERATOR, ASSOCIATED CONTROL EQUIPMENT, AND THE RECONNECTION OF THE EXISTING EMERGENCY LIFE SAFETY LOADS TO THE NEW GENERATOR AS SHOWN IN THE DRAWING PACKAGE. THE ELECTRICAL SCOPE OF WORK FOR THIS PROJECT DOES NOT EXTEND TO THE REPLACEMENT/UPGRADES OF THE INDIVIDUAL ELECTRICAL LIFE SAFETY DEVICES THROUGHOUT THE BUILDING.
- 2. THE DESIGN AND CONSTRUCTION OF THIS PROJECT INCLUDING ALL WORKS AND MATERIALS USED SHALL COMPLY AS REQUIRED IN ACCORDANCE WITH THE LATEST EDITION OF THE ONTARIO BUILDING CODE, ONTARIO ELECTRICAL SAFETY CODE, AND CSA STANDARD C282 "EMERGENCY ELECTRICAL POWER SUPPLY FOR BUILDINGS".
- 3. BUILDING TEMPORARY POWER IS NOT ANTICIPATED TO BE REQUIRED BY THE CONTRACTOR DURING THE TIME OF RECONNECTION TO THE NEW POWER DISTRIBUTION SYSTEM (CONNECTING NEW GENERATOR FEEDERS/CONTROLS AT NEW ROOF TOP JUNCTION BOXES) WITH THE UNDERSTANDING THAT THE OUTAGE TO THE GENERATOR SYSTEM WOULD BE LESS THAN A SINGLE 4H OUTAGE. CONTRACTOR MUST PROVIDE CITY PM 10 BUSINESS DAY ADVANCE NOTICE OF ANY POWER OUTAGES SO THAT POWER OUTAGES CAN BE RESCHEDULED OR TEMPORARY POWER CAN BE ARRANGED AT AN ADDITIONAL COST IF DEEMED NECESSARY BY THE OWNER/CLIENT.
- 4. ALL MATERIALS AND EQUIPMENT AS HEREINAFTER SPECIFIED AND/OR SHOWN ON THE DRAWINGS SHALL BE FURNISHED AND INSTALLED IN SUCH MANNER AS TO LEAVE EACH OF THE SYSTEMS OF THE VARIOUS TRADES COMPLETE AND IN SATISFACTORY OPERATING CONDITION.
- 5. THE CONTRACTOR SHALL INSTALL AND HAVE THE EQUIPMENT MANUFACTURER(S) COMMISSION THE SYSTEM A WHOLE TO PROVIDE A COMPLETE READY TO OPERATE EMERGENCY (LIFE—SAFETY) POWER SYSTEM CAPABLE OF OPERATING UNDER ALL APPLICABLE REGULATORY/CODE REQUIREMENTS (CSA 282, MOE, ESA, TSSA, BUILDING CODE, ETC.). MAJOR EQUIPMENT FAT RESULTS SHALL BE PROVIDED TO CONSULTANT AND OWNER FOR REVIEW/APPROVAL PRIOR TO EQUIPMENT DELIVERY ON SITE.
- 5. CONTRACTOR/EQUIPMENT SUPPLIER TO PROVIDE SHORT CIRCUIT AND COORDINATION STUDY FOR NEW EQUIPMENT AND ADJUST BREAKER SIZE/TRIP SETTINGS OR REPLACE FUSES AS REQUIRED TO ACHIEVE PROPER COORDINATION AND PROTECTION. THE CONTRACTOR IS RESPONSIBLE FOR ALL FIELD VERIFICATIONS REQUIRED TO COMPLETE THE STUDY. EXISTING SLD IS PROVIDED ONLY FOR REFERENCE.
- 6. ALL EXISTING CONDUITS/WIRING MAY ONLY BE REUSED IF APPROPRIATELY SIZED, IN SUITABLE CONDITION FOR REUSE, AND CONDUCTORS PASSED INSULATION TESTS (MEGGER) BY CONTRACTOR. FOR ALL EXISTING WIRING BEING REUSED/RECONNECTED THE CONTRACTOR SHALL COMPLETE INSULATION TESTS (MEGGER) TO ENSURE THAT THE EXISTING WIRING PASSES PRIOR TO RECONNECTING / PUTTING THE WIRING BACK IN SERVICE.
- 7. THE CONTRACTOR SHALL PROVIDE AND INSTALL ALL REQUIRED EQUIPMENT TO COMPLETE THE GENERATOR INSTALLATION AS FURTHER DEFINED IN THE PROJECT SPECIFICATIONS WHICH INCLUDES BUT IS NOT LIMITED TO THE FOLLOWING:
- a. NEW 750KW 347/600V 3PH 4W, FLOATING NEUTRAL, NATURAL GAS POWERED GENERATOR C/W WEATHERPROOF SOUND RATED ENCLOSURE EQUIPPED IN ACCORDANCE WITH CSA C282:
- b. NEW MONITORING AND PROTECTION SYSTEMS FOR GENERATOR OPERATION INCLUDING REMOTE GENERATOR ANNUNCIATOR IN THE MAINTENANCE OFFICE ROOM 125; c. CONNECTION OF THE NEW GENERATOR TO THE EXISTING FIRE ALARM PANEL (USE SPARE ZONES AS NEEDED) C/W ALL REQUIRED PROGRAMING AND UPDATING OF LABELS ON REMOTE ANNUNCIATOR(S) FOR
- THE NEW CONNECTIONS AS REQUIRED AND THE REMOVAL OF THE OLD GENERATOR ENCLOSURE FIRE ALARM ZONE/POINTS. d. CONTRACTOR TO RETAIN A MANUFACTURER AUTHORIZED SERVICE PROVIDER TO COMMISSION THE EXISTING THOMSON TECHNOLOGY ATS WITH ONCE CONNECTED TO THE NEW GENERATOR SYSTEM TO ENSURE
- PROPER OPERATION OF THE COMPLETE SYSTEM. e. NEW LED EMERGENCY LIGHTING UNITS IN THE NEW GENERATOR ENCLOSURE AND IN THE ELECTRICAL ROOM AROUND THE EXISTING TRANSFER SWITCH TO PROVIDE A MINIMUM LIGHTING LEVEL OF 50 LUX FOR 2
- HOURS AS PER CSA 282.
- f. RELOCATE ANY EXISTING EQUIPMENT/CONDUITS WHERE NOTED AND/OR REQUIRED TO ACCOMMODATE THE NEW INSTALLATION; a. VERIFY EXISTING ELECTRICAL EQUIPMENT INFORMATION SHOWN ON DRAWING WITH SITE CONDITION PRIOR TO START OF WORK:
- h. EXISTING DISTRIBUTION SYSTEM SHOWN IS DIAGRAMMATIC TO SHOW THE DESIGN INTENT. CONTRACTOR IS BE RESPONSIBLE TO CONFIRM/VERIFY IT PRIOR TO FABRICATION OR ROUGH—IN AND ENSURE ALL EXISTING LOADS ARE RE-CONNECTED AND BALANCED BY THE NEW ELECTRICAL DISTRIBUTION SYSTEM. CONTRACTOR TO PROVIDE ALL ASSOCIATED ACCESSORIES AS REQUIRED TO FACILITATE THE NEW INSTALLATION COMPLETELY.
- i. CONDUCTORS AND CONDUITS TO BE OVERSIZED TO SUIT VOLTAGE DROP AS PER OESC WHERE REQUIRED. j. ALL FEEDER AND CONTROL CABLES FORMING PART OF THE LIFE SAFETY EMERGENCY POWER SYSTEM INSTALLED OUTSIDE OF THE FIRE RATED ELECTRICAL ROOM SHALL BE ULC \$139 LISTED WITH A 2 HOUR
- FIRE RATING UNLESS THE CABLES ARE LOCATED OUTSIDE OF THE BUILDING ENVELOPE (ON THE ROOF / UNDERGROUND).
- 7. COMPLETE ALL FIRE ALARM RELATED WORK INCLUDING BUT NOT LIMITED TO:
- a. REMOVAL OF OLD FIRE ALARM WIRING/ZONES FOR THE OLD WALK-IN GENERATOR ENCLOSURE.
- b. NEW FIRE ALARM WIRING FOR GENERATOR AS PER ELECTRICAL SLD / DETAILS (GENERATOR COMMON TROUBLE, GENERATOR RUNNING, GENERATOR LOW FUEL). c. CONTRACTOR SHALL INCLUDE ADDING ANY ADDITIONAL ZONES / MODULES AS MAY BE REQUIRED TO THE MAIN FIRE ALARM PANEL TO ACCOMMODATE THE FIRE ALARM SYSTEM ADDITIONS UNDER THIS CONTRACT.
- d. NEW AND/OR RELOCATED FIRE ALARM SYSTEM/DEVICES TO BE INSTALLED PER CAN/ULC-S524-01 AND VERIFIED PER CAN/ULC-S537-04. CONTRACTOR SHALL COMPLETE INTEGRATED SYSTEMS TESTING OF THE FIRE PROTECTION AND LIFE SAFETY SYSTEMS IN ACCORDANCE WITH CAN/ULC-S1001. A COPY OF THE VERIFICATION CERTIFICATES MUST BE SUBMITTED TO THE CONSULTANTS PRIOR TO ISSUING FINAL ACCEPTANCE LETTER TO THE CITY AS PER O.B.C. REQUIREMENTS.
- 8. THE CONTRACTOR SHALL DISCONNECT, DEMOLISH, REMOVE AND/OR RECONNECT EXISTING EQUIPMENT WHERE NOTED AND/OR REQUIRED TO COMPLETE THE INSTALLATION. ALL EQUIPMENT/CONDUITS WHICH IS NOT BEING REUSED SHALL BE REMOVED. WHEN ELECTRICAL EQUIPMENT (LIGHTING, POWER AND SYSTEMS) IS SHOWN TO BE REMOVED OR RELOCATED, BLANK-OFF EXISTING JUNCTION BOX, CUT BACK EXISTING UNUSED CONDUIT AND WIRING, MAKE SAFE. SHOULD ANY CIRCUITS BE ABANDONED, THE CONDUCTORS TO THESE CIRCUITS MUST BE REMOVED OR PROPERLY TERMINATED AS DETAILED IN OESC RULE 2-130, RULE 12-144, RULE 12-3000, AND BULLETIN 12-25-*. REMOVED ALL UNUSED ELECTRICAL EQUIPMENT AND CONSULT WITH OWNER IF EQUIPMENT IS TO BE DISPOSED OF OR TURNED BACK TO THE OWNER.
- 9. CONTRACTOR SHALL COORDINATE CABLE TERMINATIONS WITH EQUIPMENT MANUFACTURES TO ENSURE THE EQUIPMENT LUGS WILL ACCOMMODATE THE FEEDERS.
- 10. CONTRACTOR SHALL SUPPLY AND INSTALL UPDATED LAMACOID LABELS AND PANEL SCHEDULES FOR ALL EXISTING/NEW ELECTRICAL EQUIPMENT MODIFIED/INSTALLED UNDER THIS CONTRACT. CONTRACTOR SHALL UPDATE AND SUPPLY LAMINATED AS-BUILT ELECTRICAL SLD AND MOUNT IN THE MAIN ELECTRICAL ROOM. CONTRACTOR SHALL UPDATE AND SUPPLY A NEW FIRE ALARM DIRECTORY AND FLOOR PLAN AT THE ANNUNCIATOR PANEL TO MATCH EXISTING THAT IS UPDATED TO REFLECT THE REMOVAL OF THE OLD GENERATOR ENCLOSURE ZONES/POINTS AND THE NEW GENERATOR MONITORING POINTS.
- 11. CONTRACTOR TO PROVIDE POWER AND CONTROLS AS REQUIRED BY MECHANICAL TRADE AND RELOCATE ANY EXISTING POWER / CONTROLS AS REQUIRED BY THE MECHANICAL TRADE.
- 12. CONTRACTOR SHALL PROVIDE PROJECT AS-BUILT DOCUMENTATION ACCORDING TO CITY REQUIREMENTS.

GROUNDING NOTES:

- 1. ALL GROUNDING AND BONDING SHALL BE IN ACCORDANCE WITH THE LATEST OESC EDITION AND ALL LOCAL ELECTRICAL INSPECTION AUTHORITY REQUIREMENTS.
- 2. ALL INSTALLED EQUIPMENT INCLUDING ANY INSTALLED BOLLARDS OR METAL FENCING AROUND THE GENERATOR SHALL BE GROUNDED/BONDED BY THE CONTRACTOR IN ACCORDANCE WITH OESC LATEST EDITION AS MAY BE REQUIRED. FOR FENCE GROUNDING/BONDING REFER TO OESC SECTION 10 AND OESC 26-300 THRU 26-324.
- 3. IF REQUIRED, THE CONTRACTOR SHALL UPGRADE THE EXISTING GROUNDING SYSTEM AND INSTALL ARTIFICIAL GROUNDING ELECTRODES AS REQUIRED TO MEET THE REQUIREMENTS OF THE OESC LATEST EDITION.

4. AS THE EXISTING TRANSFER SWITCHES ARE 3-POLE THE NEW NATURAL GAS GENERATOR SHALL HAVE A FLOATING NEUTRAL AS PER BULLETIN 10-10-*, RULE 2-100, RULE 10-210, RULE 20-212.

KEY PLAN

GENERAL NOTES

- . VERIFY ALL DIMENSIONS PRIOR TO CONSTRUCTION.
- 2. DO NOT SCALE DRAWINGS.
- REPORT ALL DISCOVERIES OF ERRORS, OMISSIONS OR DISCREPANCIES TO THE DESIGN ENGINEER AS APPLICABLE.
- 4. USE ONLY LATEST REVISED DRAWINGS OR THOSE THAT ARE MARKED "ISSUED FOR CONSTRUCTION".
- 5. THE DESIGN AND CONSTRUCTION OF THIS PROJECT INCLUDING ALL WORKS AND MATERIALS USED SHALL COMPLY AS REQUIRED IN ACCORDANCE WITH THE LATEST EDITION OF THE BUILDING AND ELECTRICAL CODES.
- 6. THIS DRAWING SHALL BE READ IN CONJUNCTION WITH ALL PROJECT DRAWINGS, RELEVANT DRAWINGS, & SPECIFICATIONS.
- THE CONTRACTOR SHALL APPLY FOR, OBTAIN AND PAY FOR ALL PERMITS, LICENCES, INSPECTIONS, EXAMINATIONS AND FEES REQUIRED.
- EVERYTHING IS TO BE CONSIDERED NEW UNLESS SPECIFIED EXISTING OTHERWISE.
- 9. CONTRACTOR TO REMOVE AND RELOCATE EXISTING ELECTRICAL SERVICES AS REQUIRED TO COMPLETE THE ELECTRICAL WORK.
- 10. CONTRACTOR IS RESPONSIBLE TO VERIFY SHORT CIRCUIT RATING BEFORE PURCHASE OF POWER EQUIPMENT.
- 11. CABLE/CONDUIT ROUTING AND TERMINATIONS ARE DIAGRAMMATIC, SHOWING THE APPROXIMATE ARRANGEMENT. ACTUAL CABLE/CONDUIT POSITIONS SHALL BE DETERMINED TO SUIT FIELD CONDITIONS AND EQUIPMENT LOCATIONS.
- 12. CONTRACTOR SHALL SIZE ALL FEEDERS ACCORDING TO THE LATEST EDITION OF THE OESC BASED ON FINAL FEEDER LENGTHS AND VOLTAGE DROP.
- 13. ALL UNDERGROUND CONDUITS TO BE BURIED MIN. 600MM BELOW FINISHED GRADE IN NON TRAFFIC AREAS AND MIN. 900MM BELOW FINISHED GRADE IN TRAFFIC AREAS. CONTRACTOR TO INSTALL WARNING TAPE AND REFER TO OESC FOR ADDITIONAL REQUIREMENTS.
- 14. CONTRACTOR TO COORDINATE ALL ACTIVITIES AND POWER DISRUPTIONS WITH OWNER TO AVOID DISRUPTIONS TO TENANTS. CONTRACTOR TO INCLUDE FOR PROVIDING TEMPORARY EMERGENCY POWER INCLUDING DIESEL FUEL DURING THE TRANSITION TO THE NEW EMERGENCY GENERATOR UNDER THIS CONTRACT.
- 5. EXISTING CONDITIONS ARE BASED ON OBSERVATIONS OF VISIBLE PARTS OF THE ELECTRICAL SYSTEM AND ON EXISTING DOCUMENTS. CONDITIONS SHOWN MAY NOT BE ACCURATE WITH RESPECT TO CIRCUIT USAGE, UNDOCUMENTED MODIFICATIONS MADE AFTER THE DATE OF THE EXISTING DRAWINGS OR CONCEALED CONDITIONS. CONTRACTOR SHALL VERIFY EXISTING CONDITIONS AND ADAPT WORK TO SUIT.

---- EXISTING



---- NEW

No.	Date	Description	Drawn	Checked
0	07 NOV '23	FOR REVIEW	AM	DM
1	15 NOV '23	FOR REVIEW	AM	DM
2	24 NOV '23	FOR REVIEW	AM	DM
3	10 JAN '24	ISSUED FOR TENDER	AM	DM
4	11 JAN '24	ISSUED FOR BP	AM	DM

REVISIONS



J + B ENGINEERING INC

25 CENTURIAN DR. 638-11TH AVE. SW 25 CENTURIAN UK.
SUITE 201
MARKHAM, ON L3R 5N8
CALGARY AB T2R 0E2
403 355 2295

OWNER/CLIENT:

Drawing No: E-102



Project: COT: GENERATOR REPLACEMENT (51 DIVISION)

EXISTING ELECTRICAL SLD, NEW ELECTRICAL NOTES & DETAILS

ACAD INFO

Drawing Size: D

51 PARLIAMENT STREET TORONTO - ONTARIO

File No: 210248 Date: 7 SEPT '23 Dwg. File: 210248-E-102 Drawn By: **EM** Scale: 1:200 Plotting Scale: 1:1 Sheet 1 of 1 Checked By: AM

CLEAN FILL WITH NO ROCKS (SAND) ELECTRICAL CONDUIT OR DIRECT BURRY TECK CONTROL CABLE FOR MONITORED NATURAL GAS VALVES. 1. DIRECT BURIED CONDUCTORS, CABLES, OR RACEWAYS SHALL BE INSTALLED TO MEET THE MINIMUM COVER REQUIREMENTS OF TABLE 53 FROM THE LATEST EDITION OF OESC. PROVIDE ADDITIONAL PROTECTION WHERE REQUIRED FOR REDUCED COVER PER OESC 12-012. 2. DIRECT BURIED CONDUCTORS, CABLES OR RACEWAYS SHALL BE INSTALLED SO THAT THEY RUN ADJACENT TO EACH OTHER SPACED A MINIMUM OF 1 DIAMETER APART AND DO NOT CROSS OVER EACH OTHER. NATURAL GAS PIPING SHALL MAINTAIN A MINIMUM HORIZONTAL SEPARATION OF 300MM FROM ALL CONDUITS AND MAINTAIN A MINIMUM 300MM VERTICAL CLEARANCE AT ANY CROSSINGS. DEPTH OF ELECTRICAL CONDUCTORS/CABLES/RACEWAYS SHALL BE INCREASED IF REQUIRED TO ACCOMMODATE THE REQUIRED GAS LINE CLEARANCES AT CROSSINGS. REFER TO OESC BULLETIN 12-2-20 AND CSA 22.3 NO.7 FOR ADDITIONAL REQUIREMENTS. 4. DEPTH OF NATURAL GAS PIPE TO BE IN ACCORDANCE WITH CSA B149.1 (MINIMUM 400MM IN NON VEHICULAR AREAS AND MINIMUM 610MM IN VEHICULAR AREAS). REFER TO MECHANICAL DRAWINGS FOR ADDITIONAL REQUIREMENTS. 5. PROVIDE MINIMUM 50MM OF CLEAN BEDDING WITHOUT ROCKS (SAND) ALL AROUND U/G SERVICES WHEN BACKFILLING.

TYP. U/G GAS & CONTROL SECTION (TRAFFIC)

FINISHED GRADE

(VEHICULAR AREA)

RESTORE TO MATCH -

MARKING TAPE -

NATIVE BACKFILL

NATURAL GAS LINE-

EXISTING SURFACE FINISH

MARKING TAPE NATIVE BACKFILL GAS LINE -CLEAN FILL WITH -NO ROCKS (SAND) CABLE/CONDUIT SEE NOTE #2

FINISH GRADE

1. DIRECT BURIED CONDUCTORS, CABLES, OR RACEWAYS SHALL BE INSTALLED TO MEET THE MINIMUM COVER REQUIREMENTS OF TABLE 53 FROM THE LATEST EDITION OF OESC. PROVIDE ADDITIONAL PROTECTION WHERE REQUIRED FOR REDUCED COVER PER OESC 12-012.


2. DIRECT BURIED CONDUCTORS, CABLES OR RACEWAYS SHALL BE INSTALLED SO THAT THEY RUN ADJACENT TO EACH OTHER SPACED A MINIMUM OF 1 DIAMETER APART AND DO NOT CROSS OVER EACH OTHER. 3. NATURAL GAS PIPING SHALL MAINTAIN A MINIMUM HORIZONTAL SEPARATION OF 300MM FROM ALL CONDUITS AND

MAINTAIN A MINIMUM 300MM VERTICAL CLEARANCE AT ANY CROSSINGS. DEPTH OF ELECTRICAL CONDUCTORS/CABLES/RACEWAYS SHALL BE INCREASED IF REQUIRED TO ACCOMMODATE THE REQUIRED GAS LINE CLEARANCES AT CROSSINGS. REFER TO OESC BULLETIN 12-2-20 AND CSA 22.3 NO.7 FOR ADDITIONAL REQUIREMENTS. 4. DEPTH OF NATURAL GAS PIPE TO BE IN ACCORDANCE WITH CSA B149.1 (MINIMUM 400MM IN NON VEHICULAR AREAS

AND MINIMUM 610MM IN VEHICULAR AREAS). REFER TO MECHANICAL DRAWINGS FOR ADDITIONAL REQUIREMENTS. 5. PROVIDE MINIMUM 50MM OF CLEAN BEDDING WITHOUT ROCKS (SAND) ALL AROUND U/G SERVICES WHEN BACKFILLING.

TYPICAL U/G CONDUIT SECTION

SCALE NTS

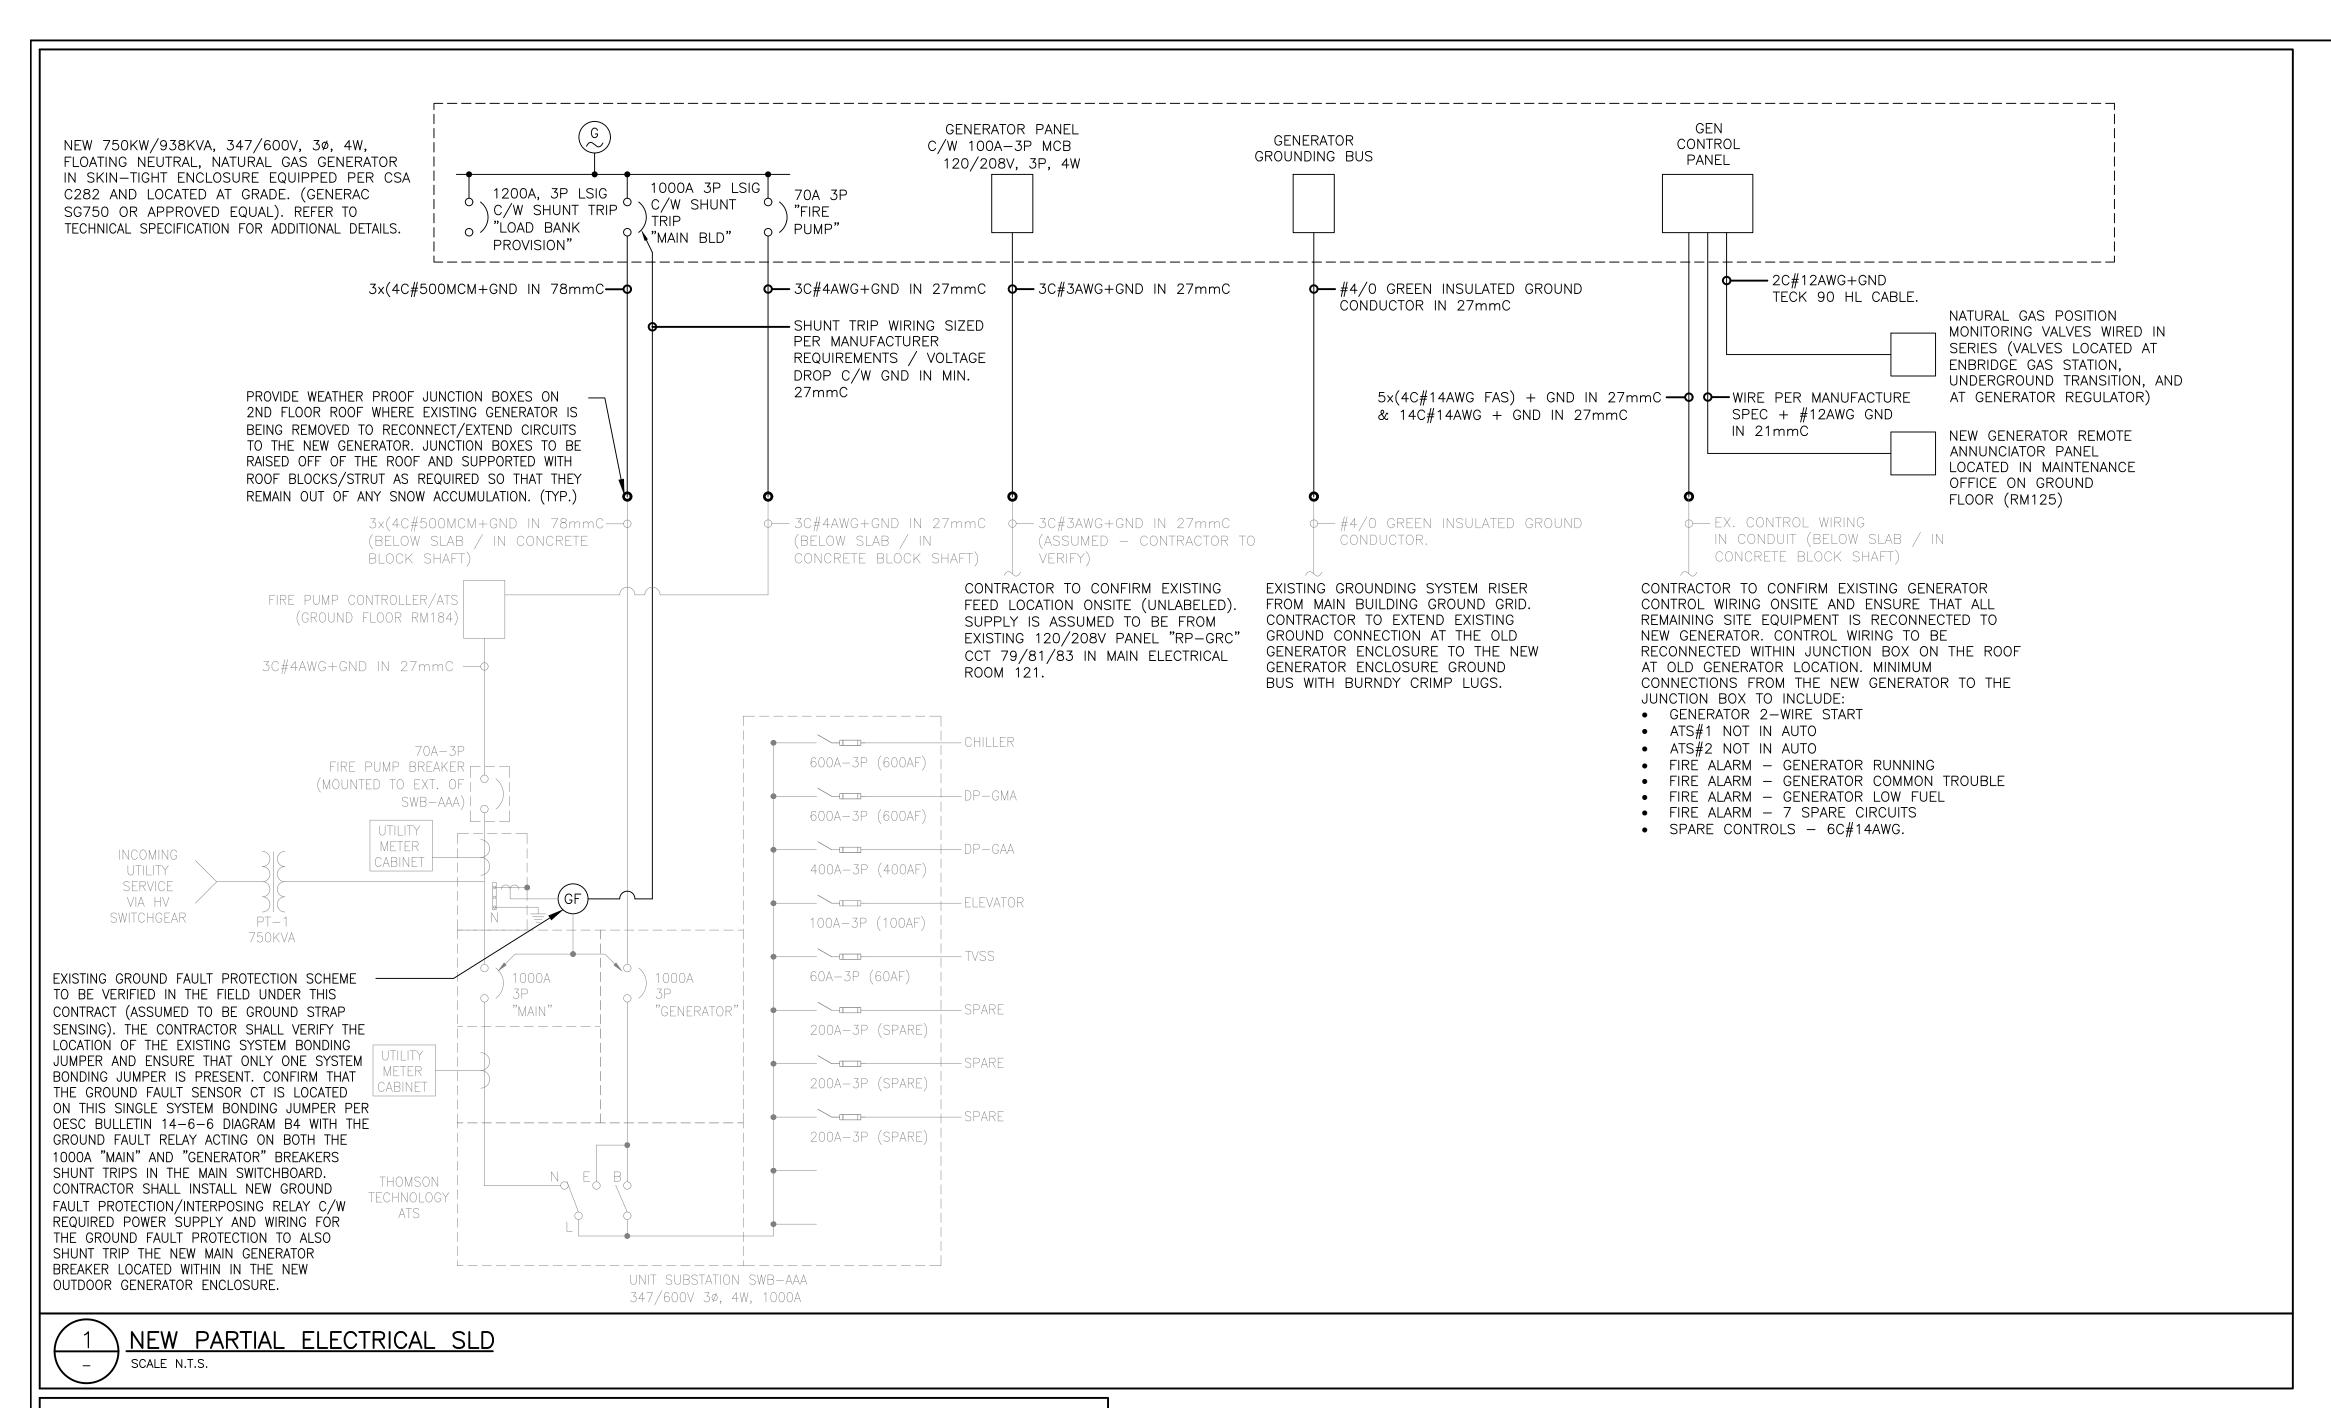

GEN. GAS GEN. GAS VALVE POSITION GEN. GAS NEW NATURAL GAS VALVE POSITION UNDERGROUND VALVE POSITION GENERATOR TRANSITION @ ENBRIDGE STN. @ GEN. REGULATOR + - - - -╼┈ \Box GEN. AUX INPUT GAS STN. VALVE POSITION NEW JUNCTION BOXES LOCATED ON 2ND FLOOR ATS#1 ROOF IN PLACE OF OLD "BUILDING LOADS" DIESEL GENERATOR. ATS#1 GEN. AUX INPUT NOT" IN AUTO ATS#1 NOT IN AUTO GEN. START ATS#1 GEN. START ATS#2 "FIRE PUMP" ATS#2 GEN. START ATS#2 GEN. AUX INPUT NOT IN AUTO ATS#2 NOT IN AUTO FIRE ALARM PANEL GEN. AUX. OUTPUT GEN. RUNNING. GEN. RUNNING GEN. AUX. OUTPUT GEN. COMMON GEN. COMMON TROUBLE TROUBLE GEN. AUX. OUTPUT GEN. LOW FUEL LOW FUEL / GAS VALVE CLOŚED NEW GENERATOR PARTIAL CONTROL SCHEMATIC SCALE N.T.S.

// DEMO ---- NEW



KEY PLAN

GENERAL NOTES

- 1. VERIFY ALL DIMENSIONS PRIOR TO CONSTRUCTION.
- 2. DO NOT SCALE DRAWINGS.
- 3. REPORT ALL DISCOVERIES OF ERRORS, OMISSIONS OR DISCREPANCIES TO THE DESIGN ENGINEER AS APPLICABLE.
- 4. USE ONLY LATEST REVISED DRAWINGS OR THOSE THAT ARE MARKED "ISSUED FOR CONSTRUCTION".
- 5. THE DESIGN AND CONSTRUCTION OF THIS PROJECT INCLUDING ALL WORKS AND MATERIALS USED SHALL COMPLY AS REQUIRED IN ACCORDANCE WITH THE LATEST EDITION OF THE BUILDING AND ELECTRICAL CODES.
- 6. THIS DRAWING SHALL BE READ IN CONJUNCTION WITH ALL PROJECT DRAWINGS, RELEVANT DRAWINGS, & SPECIFICATIONS.
- 7. THE CONTRACTOR SHALL APPLY FOR, OBTAIN AND PAY FOR ALL PERMITS, LICENCES, INSPECTIONS, EXAMINATIONS AND FEES
- . EVERYTHING IS TO BE CONSIDERED NEW UNLESS SPECIFIED EXISTING OTHERWISE.
- 9. CONTRACTOR TO REMOVE AND RELOCATE EXISTING ELECTRICAL SERVICES AS REQUIRED TO COMPLETE THE ELECTRICAL WORK.
- 10. CONTRACTOR IS RESPONSIBLE TO VERIFY SHORT CIRCUIT RATING

BEFORE PURCHASE OF POWER EQUIPMENT.

- 11. CABLE/CONDUIT ROUTING AND TERMINATIONS ARE DIAGRAMMATIC, SHOWING THE APPROXIMATE ARRANGEMENT. ACTUAL CABLE/CONDUIT POSITIONS SHALL BE DETERMINED TO SUIT FIELD CONDITIONS AND EQUIPMENT LOCATIONS.
- 12. CONTRACTOR SHALL SIZE ALL FEEDERS ACCORDING TO THE LATEST EDITION OF THE OESC BASED ON FINAL FEEDER LENGTHS AND VOLTAGE DROP.
- 13. ALL UNDERGROUND CONDUITS TO BE BURIED MIN. 600MM BELOW FINISHED GRADE IN NON TRAFFIC AREAS AND MIN. 900MM BELOW FINISHED GRADE IN TRAFFIC AREAS. CONTRACTOR TO INSTALL WARNING TAPE AND REFER TO OESC FOR ADDITIONAL REQUIREMENTS.
- 14. CONTRACTOR TO COORDINATE ALL ACTIVITIES AND POWER DISRUPTIONS WITH OWNER TO AVOID DISRUPTIONS TO TENANTS. CONTRACTOR TO INCLUDE FOR PROVIDING TEMPORARY EMERGENCY POWER INCLUDING DIESEL FUEL DURING THE TRANSITION TO THE NEW EMERGENCY GENERATOR UNDER THIS CONTRACT.
- 15. EXISTING CONDITIONS ARE BASED ON OBSERVATIONS OF VISIBLE PARTS OF THE ELECTRICAL SYSTEM AND ON EXISTING DOCUMENTS, CONDITIONS SHOWN MAY NOT BE ACCURATE WITH RESPECT TO CIRCUIT USAGE, UNDOCUMENTED MODIFICATIONS MADE AFTER THE DATE OF THE EXISTING DRAWINGS OR CONCEALED CONDITIONS. CONTRACTOR SHALL VERIFY EXISTING CONDITIONS AND ADAPT WORK TO SUIT.

NO.	Date	Describuon	Drawn	Checked
No.	Data	Description	Drawn	Chaakad
0	07 NOV '23	FOR REVIEW	AM	DM
1	15 NOV '23	FOR REVIEW	AM	DW
2	24 NOV '23	FOR REVIEW	AM	DM
3	10 JAN '24	ISSUED FOR TENDER	AM	DM
4	11 JAN '24	ISSUED FOR BP	AM	DM
5	19 MAR '24	ADDED CLARIFICATION ON EXISTING GROUND FAULT PROTECTION PER ESA	AM	DM
6	26 MAR '24	GENERATOR BREAKER GFI SHUNT TRIP ADDED PER ESA PLAN REVIEW	AM	DM

REVISIONS



J + B ENGINEERING INC.

638-11TH AVE. SW 25 CENTURIAN DR. SUITE 201 SUITE 200
MARKHAM, ON L3R 5N8 CALGARY AB T2R 0E2
416 229 2636 403 355 2295

OWNER/CLIENT:



Project: COT: GENERATOR REPLACEMENT (51 DIVISION)

NEW ELECTRICAL SLD & GENERATOR CONTROLS

51 PARLIAMENT STREET

TORONTO - ONTARIO ACAD INFO Dwg. File: 210248-E-103

Sheet 1 of 1 Plotting Scale: 1:1 Checked By: AM Drawing Size: **D**


Date: 7 SEPT '23


Scale: 1:200


Drawing No: E-103


File No: 210248

Drawn By: **EM**

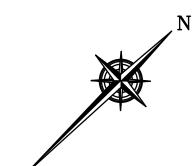


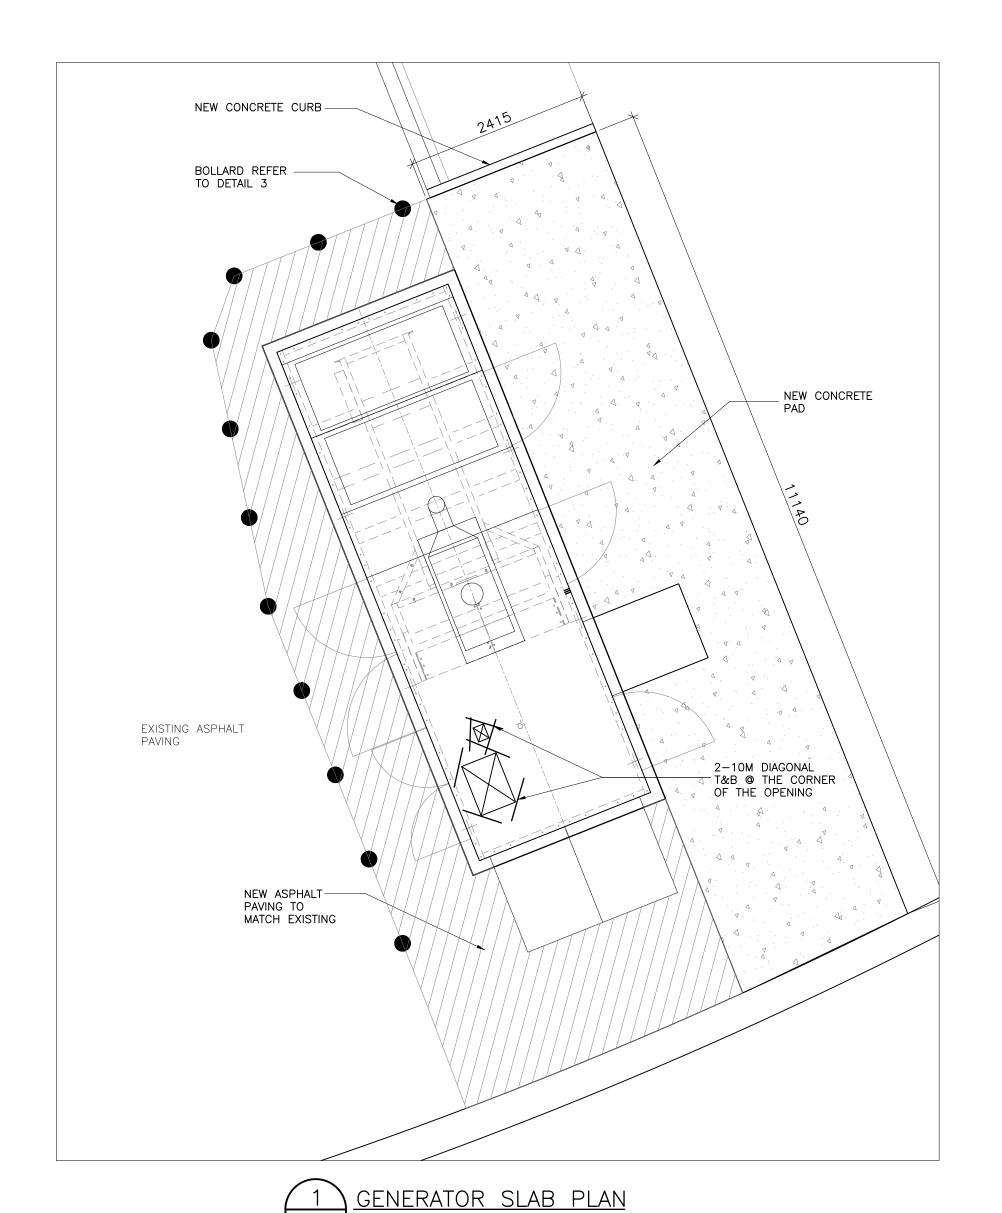

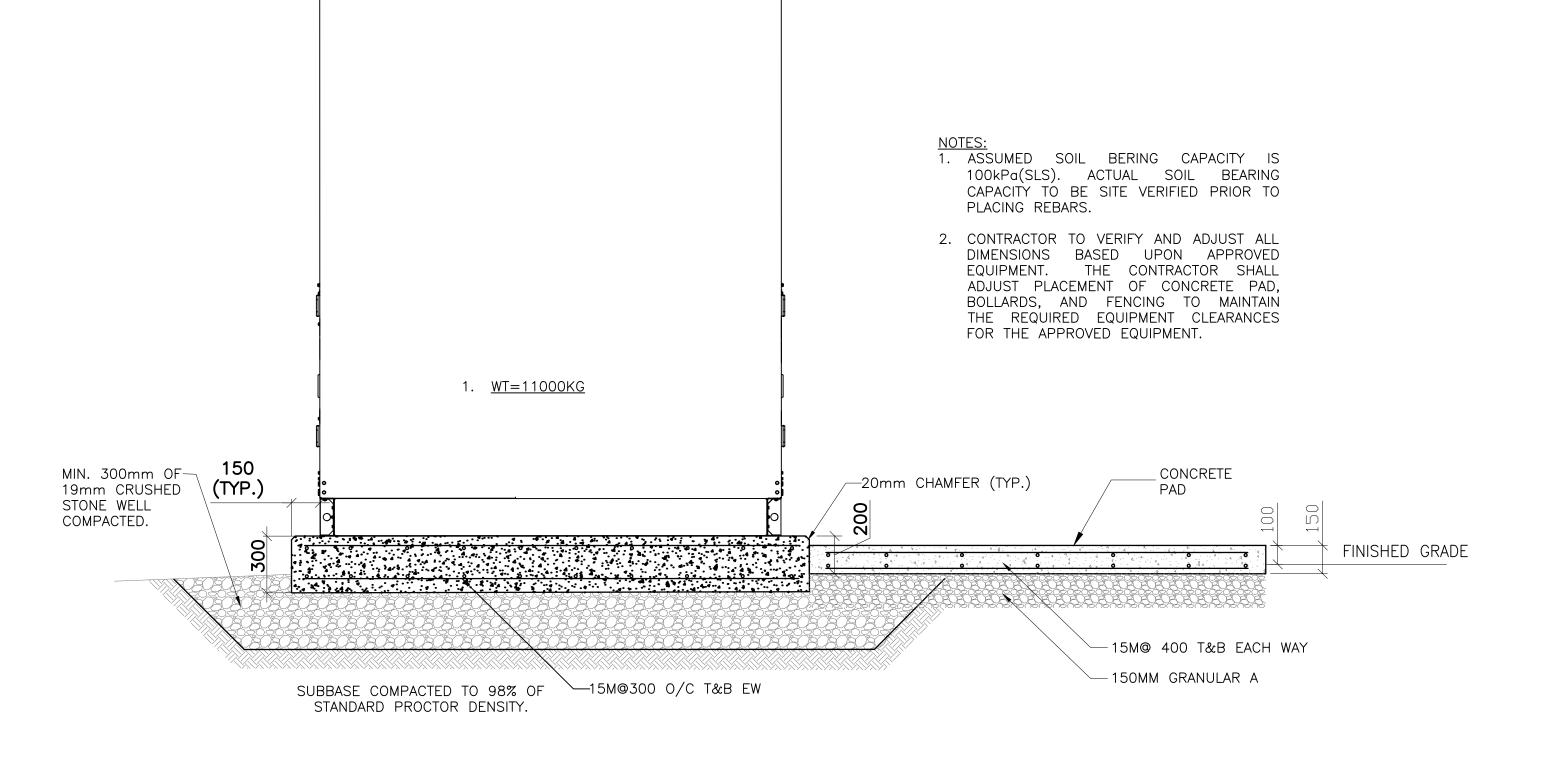

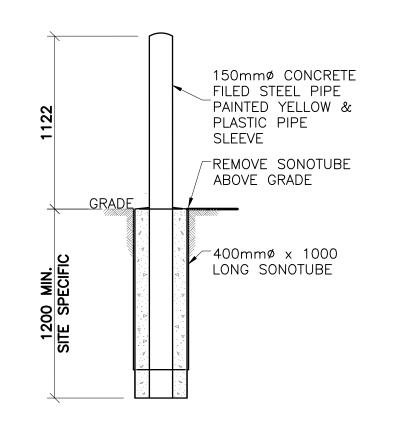

S-100 SCALE: 1:50

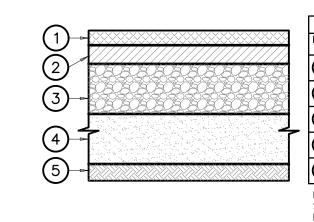


ITEM NO.	MATERIAL DESCRIPTION	PAVEMENT THICKNESS	COMPACTION REQUIREMENTS
①	ASPHALT HL-3 (WEARING COURSE)	40mm	> 97% (MBD)
2	ASPHALT HL-8 (BINDING COURSE)	50mm	> 97% (MBD)
3	GRANULAR 'A' (BASE)	150mm	> 100% (SPMDD)
4	GRANULAR 'B' (SUB-BASE)	200mm	> 100% (SPMDD)
⑤	SUBGRADE (TO BE RESHAPED)	VARIES	> 95% (SPMDD)

SCALE: 1:30

GENERATOR SLAB SECTION



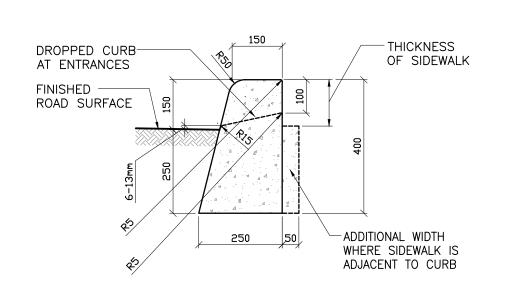





KEY PLAN GENERAL NOTES:

- VERIFY ALL DIMENSIONS PRIOR TO CONSTRUCTION. DO NOT SCALE DRAWINGS.
- 2. REPORT ALL DISCOVERIES OF ERRORS, OMISSIONS OR DISCREPANCIES TO OWNER OR DESIGN ENGINEER AS APPLICABLE.
- 3. USE ONLY LATEST REVISED DRAWINGS OR THOSE THAT ARE MARKED "ISSUED FOR CONSTRUCTION".
- 4. DESIGN AND CONSTRUCTION OF THIS PROJECT SHALL COMPLY WITH THE PROVINCIAL AND LOCAL BUILDING CODES LATEST EDITION.
- 5. ALL WORKS AND MATERIALS USED SHALL COMPLY AS REQUIRED BY THE NATIONAL AND APPLICABLE PROVINCIAL BUILDING CODE. LATEST EDITION.
- . THIS DRAWING SHALL BE READ IN CONJUNCTION WITH ALL RELEVANT DRAWINGS & SPECIFICATIONS.
- 7. EVERYTHING IS TO BE CONSIDERED NEW UNLESS SPECIFIED OTHERWISE.

. EXCAVATION AND FILL REQUIREMENTS

- 1. EXCAVATE TO THE REQUIRED LINES, LEVELS, AND GRADES. DO NOT OVER EXCAVATE OR DISTURB BEYOND THE REQUIRED LINES, LEVELS, AND GRADES UNLESS OTHERWISE REQUESTED BY THE ENGINEER.
- 2. IF THE REQUIRED LINES, LEVELS, AND GRADES ARE NOT DEFINED, EXCAVATE AS NECESSARY FOR THE ITEMS THAT ARE TO BE PLACED INTO THE
- 5. DO NOT PLACE FILL UNTIL SUBGRADE HAS BEEN COMPACTED TO NO LESS THAN 95% OF STANDARD PROCTOR MAXIMUM DRY DENSITY (SPMDD).
- 4. DO NOT COVER OR WORK ON ANY SUBGRADE UNTIL AUTHORIZED BY THE ENGINEER, OTHERWISE PLACE THE FILL AS SOON AS POSSIBLE.
- 5. REMOVE ALL DISTURBED OR UNSUITABLE MATERIAL AS RECOMMENDED BY THE GEOTECHNICAL CONSULTANT, AND ALL MATERIAL THAT HAVE BECAME UNSUITABLE DUE TO INADEQUATE PROTECTION. REPLACE SUCH MATERIAL WITH APPROVED GRANULAR MATERIAL, AND COMPACT IN LAYERS AS PER GEOTECHNICAL CONSULTANT RECOMMANDATIONS.
- 6. 150mm OF GRANULAR "A" MATERIAL SHALL BE PLACED IN ONE LIFT UNDER ALL SLAB-ON-GRADE, AND COMPACTED TO NO LESS THAN 100% OF STANDARD PROCTOR MAXIMUM DRY DENSITY (SPMDD).

B. <u>CONCRETE</u>

- 1. ALL MIXING AND PLACING OF CONCRETE MIXES SHALL CONFORM TO CSA STANDARD CAN3-A23.1-M94 (LATEST EDITION) WITH A MINIMUM CONCRETE STRENGTH AT 28 DAYS OF 32MPa FOR GENERATOR SLAB.
- 2. CEMENT SHALL BE TYPE 10, NORMAL (UNLESS NOTED OTHERWISE).
- SLUMP SHALL BE IN ACCORDANCE WITH CAN3-A23.1-M (CLAUSE 14) AND MAXIMUM WATER/CEMENT RATIO SHALL BE 0.55 & 0.50 RESPECTIVELY.
- 4. AIR ENTRAINMENT SHALL BE IN ACCORDANCE WITH CAN3-A23.1-M94 (CLAUSE 14, TABLES 7 & 8) TO MEET THE FOLLOWING EXPOSURE CONDITIONS:
 CLASS C1 FOR ALL EXPOSED AND UNHEATED AREAS.
- 5. CONCRETE COVER FOR REINFORCING STEEL SHALL CONFORM TO CAN3-A23.1-M94. MINIMUM CONCRETE COVER TO STEEL:
- CAN3—A23.1—M94. MINIMUM CONCRETE COVER TO STEEL:

 50mm, UNLESS NOTED OTHERWISE.
- 6. REINFORCING STEEL SHALL CONFORM TO CSA STANDARD G30.18-M (LATEST EDITION), GRADE 400MPa. WWF SHALL CONFORM TO CSA G30.5, GRADE 400MPa.
- 7. THE CONCRETE PAD REINFORCING TO BE VERIFIED BY DESIGN ENGINEER OR HIS REPRESENTIVE PRIOR TO POURING CONCRETE.

C. GENERATOR PAD:

1. THE CONCRETE PAD SHALL BE FOUNDED ON UNDISTURBED SOIL (OTHERWISE ON ENGINEERED FILL) AS RECOMMENDED BY SOIL'S CONSULTANT TO ACHIEVE A MINIMUM ALLOWABLE BEARING CAPACITY OF 100KPa(SLS). THE ACTUAL MINIMUM SOIL CAPACITY TO BE CONFIRMED BY A QUALIFIED GEOTECHNICAL ENGINEER IN THE FIELD.

6	11 JAN '24	ISSUED FOR BP	EM	DW
5	10 JAN '24	ISSUED FOR TENDER	EM	DW
4	24 NOV '23	FOR REVIEW	EM	DW
3	15 NOV '23	FOR REVIEW	EM	DW
2	06 NOV '23	FOR REVIEW	EM	DW
1	01 APR '22	FOR REVIEW	EM	DW
0	25 MAR '22	FOR REVIEW	EM	DW
No.	Date	Description	Drawn	Checked
		DEVICIONO		

REVISIONS

J + B ENGINEERING INC.

TORONTO CALGARY
25 CENTURIAN DR. 707-10TH AVE. SW
SUITE 201 SUITE 150
MARKHAM, ON L3R 5N8 CALGARY AB T2R 0B3
416 229 2636 403 355 2295

OWNER/CLIENT:



Project: COT: GENERATOR REPLACEMENT (51 DIVISION)

GENERATOR SLAB PLAN AND DETAILS

51 PARLIAMENT STREET	
File No: 210248	Date: 04 MAR '22
Drawn By: EM	Scale: AS SHOWN
Checked By: DM	Sheet 1 of 1

Drawing No: S-100

Dwg. File: 210248-S-100
Plotting Scale: 1:1
Drawing Size: D

ACAD INFO

TORONTO - ONTARIO