

Lower Hillside Washroom Building Improvements

1873 BLOOR ST W TORONTO, ON M6R 2Z3 TENDER AUGUST 7, 2024

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STRUCTURAL ENGINEERING

ENGINEERING LINK INC. 375 University Ave Suite 901, Toronto, ON M5G 2J5

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MECHANICAL ENGINEERING

SMITH + ANDERSEN 100 Sheppard Ave East North York, ON M2N 6N5

TM-0.0 MECHANICAL DRAWING LIST AND LEGENDS
TM-0.1 MECHANICAL STANDARD DETAILS
TM-1.1 GROUND FLOOR PLUMBING & DRAINAGE DEMOLITION LAYOUT
TM-1.2 GROUND FLOOR HVAC DEMOLITION LAYOUT
TM-2.1 GROUND FLOOR PLUMBING & DRAINAGE LAYOUT
TM-3.1 GROUND FLOOR HVAC LAYOUT

ELECTRICAL ENGINEERING

SMITH + ANDERSEN 100 Sheppard Ave East North York, ON M2N 6N5

TE-0.1 DRAWING LIST AND LEGENDS
TE-0.2 ELECTRICAL DETAILS
TE-0.3 ELECTRICAL DETAILS
TE-1.1 GROUND FLOOR ELECTRICAL LAYOUT
TE-1.2 GROUND FLOOR ELECTRICAL DEMOLITION LAYOUT

		1137a QUEEN STREET EAST	
		TORONTO, ONTARIO M4M 1K9 (437) 916-9272	
	OF PROJECT: TION:	LOWER HILLSIDE WASHROOM BUILDIN GIMPROVEMENTS HIGH PARK, 1873 BLOOR STREET WEST	
DATE	:	JUNE 12, 2024	
		Ontario Building Code Data Matrix Part 11 - Renovation of Existing Building	OBC Reference
1.00	Building Code Version:	O. Reg. 332/12 Last Amendment: 390/23	
1.01	Project Type:	☐ Addition ☐ Renovation ☐ Addition and Renovation ☐ Change of use	[A] 1.1.2.
1.02	Major Occupancy	Description Washroom building expansion and winterization. Occupancy Use	3.1.2.1.(1)
	Classification:	Group A Div. 2 Washroom facility	
1.03	Superimposed Major Occupancies:	☐ Yes	3.2.2.7
1.04	Building Area (m ²)	Description Existing New Total LEVEL 1 30m ² 46m ² 76m ²	[A] 1.4.1.2.
1.05	Building Height	1 Storeys above grade 4.13m Above Grade 0 Storey below grade	[A] 1.4.1.2 & 3.2.1.1
1.06	Number of streets/ fire fighter access:	1 street(s)	3.2.2.10 & 3.2.5
1.07	Building Size:	⊠ Small	T.11.2.1.1.C.
1.08	Existing Building Classification:	Change in Major Occupancy: Yes Not Applicable (no change of major occupancy) Construction Index: Hazard Index: Importance Category: Dumplication Not Applicable (no change of major occupancy)	11.2.1 T11.2.1.1A T11.2.1.1B to N, 4.2.1(3) & 5.2.2.1.(2)
1.09	Renovation Type:	☐ High ☐ Post-disaster ☐ Basic Renovation ☐ Extensive Renovation	11.3.3.1 & 11.3.3.2
1.10	Occupant Load:	Floor Level/ Area Occupancy Type Based On Occupant Load Ground Floor Assembly 3.1.17.1. N/A	3.1.17
1.11	Plumbing Fixture	Ratio: Male/Female = 50:50 Except as noted otherwise	3.7.4 / 9.31
	Requipments:	Floor Level/ Area Occupant Load Based On Fixtures Req. Fixtures Provided Ground Floor N/A N/A N/A 6 All washrooms are gender neutral. Washrooms are servicing a park, no defined interior or exterior occupant load.	
1.12	Barrier-free Design:	⊠Yes	11.3.3.2.(2)
1.13	Reduction in Performance Level:	Structural By Increase in occupant load: By change of major occupancy: Plumbing No Yes No Yes No Yes No Yes No Yes Pumbing No Yes Sewage - system: No Yes	11.4.2.1 11.4.2.2 11.4.2.3 11.4.2.4 11.4.2.5
1.14	Compensating Construction:	☐ Yes ☒ No Structural ☒ No ☐ Yes By Increase in occupant load: ☒ No ☐ Yes By change of major occupancy: ☒ No ☐ Yes Plumbing ☒ No ☐ Yes Sewage - system: ☒ No ☒ Yes Extension of Combustible ☒ No ☐ Yes Construction: ☐ Yes	11.4.2.1 11.4.2.2 11.4.2.3 11.4.2.4 11.4.2.5 11.4.2.6 11.4.2.7
1.15	Compliance Alternatives Proposed:	⊠ No ☐ Yes	11.5.1.
1.16	Notes:	BUILDING CLASSIFICATION: 3.2.2.28 COMBUSTIBLE CONSTRUCTION PERMITTED	

SOCA STUDIO OF CONTEMPORARY ARCHITECTURE

LAPTISTE ARCHITECTURE INC.

1137A Queen St. East Toronto, ON M4M 1K9 (437) 916-9272

Lower Hillside Washroom Building Improvements

City of Toronto 1873 BLOOR ST W TORONTO, ON M6R 2Z3

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No. Date Descripti
1 2024-02-09 Issued for Permit/Tender
2 2024-09-12 Issued for Permit/Tender

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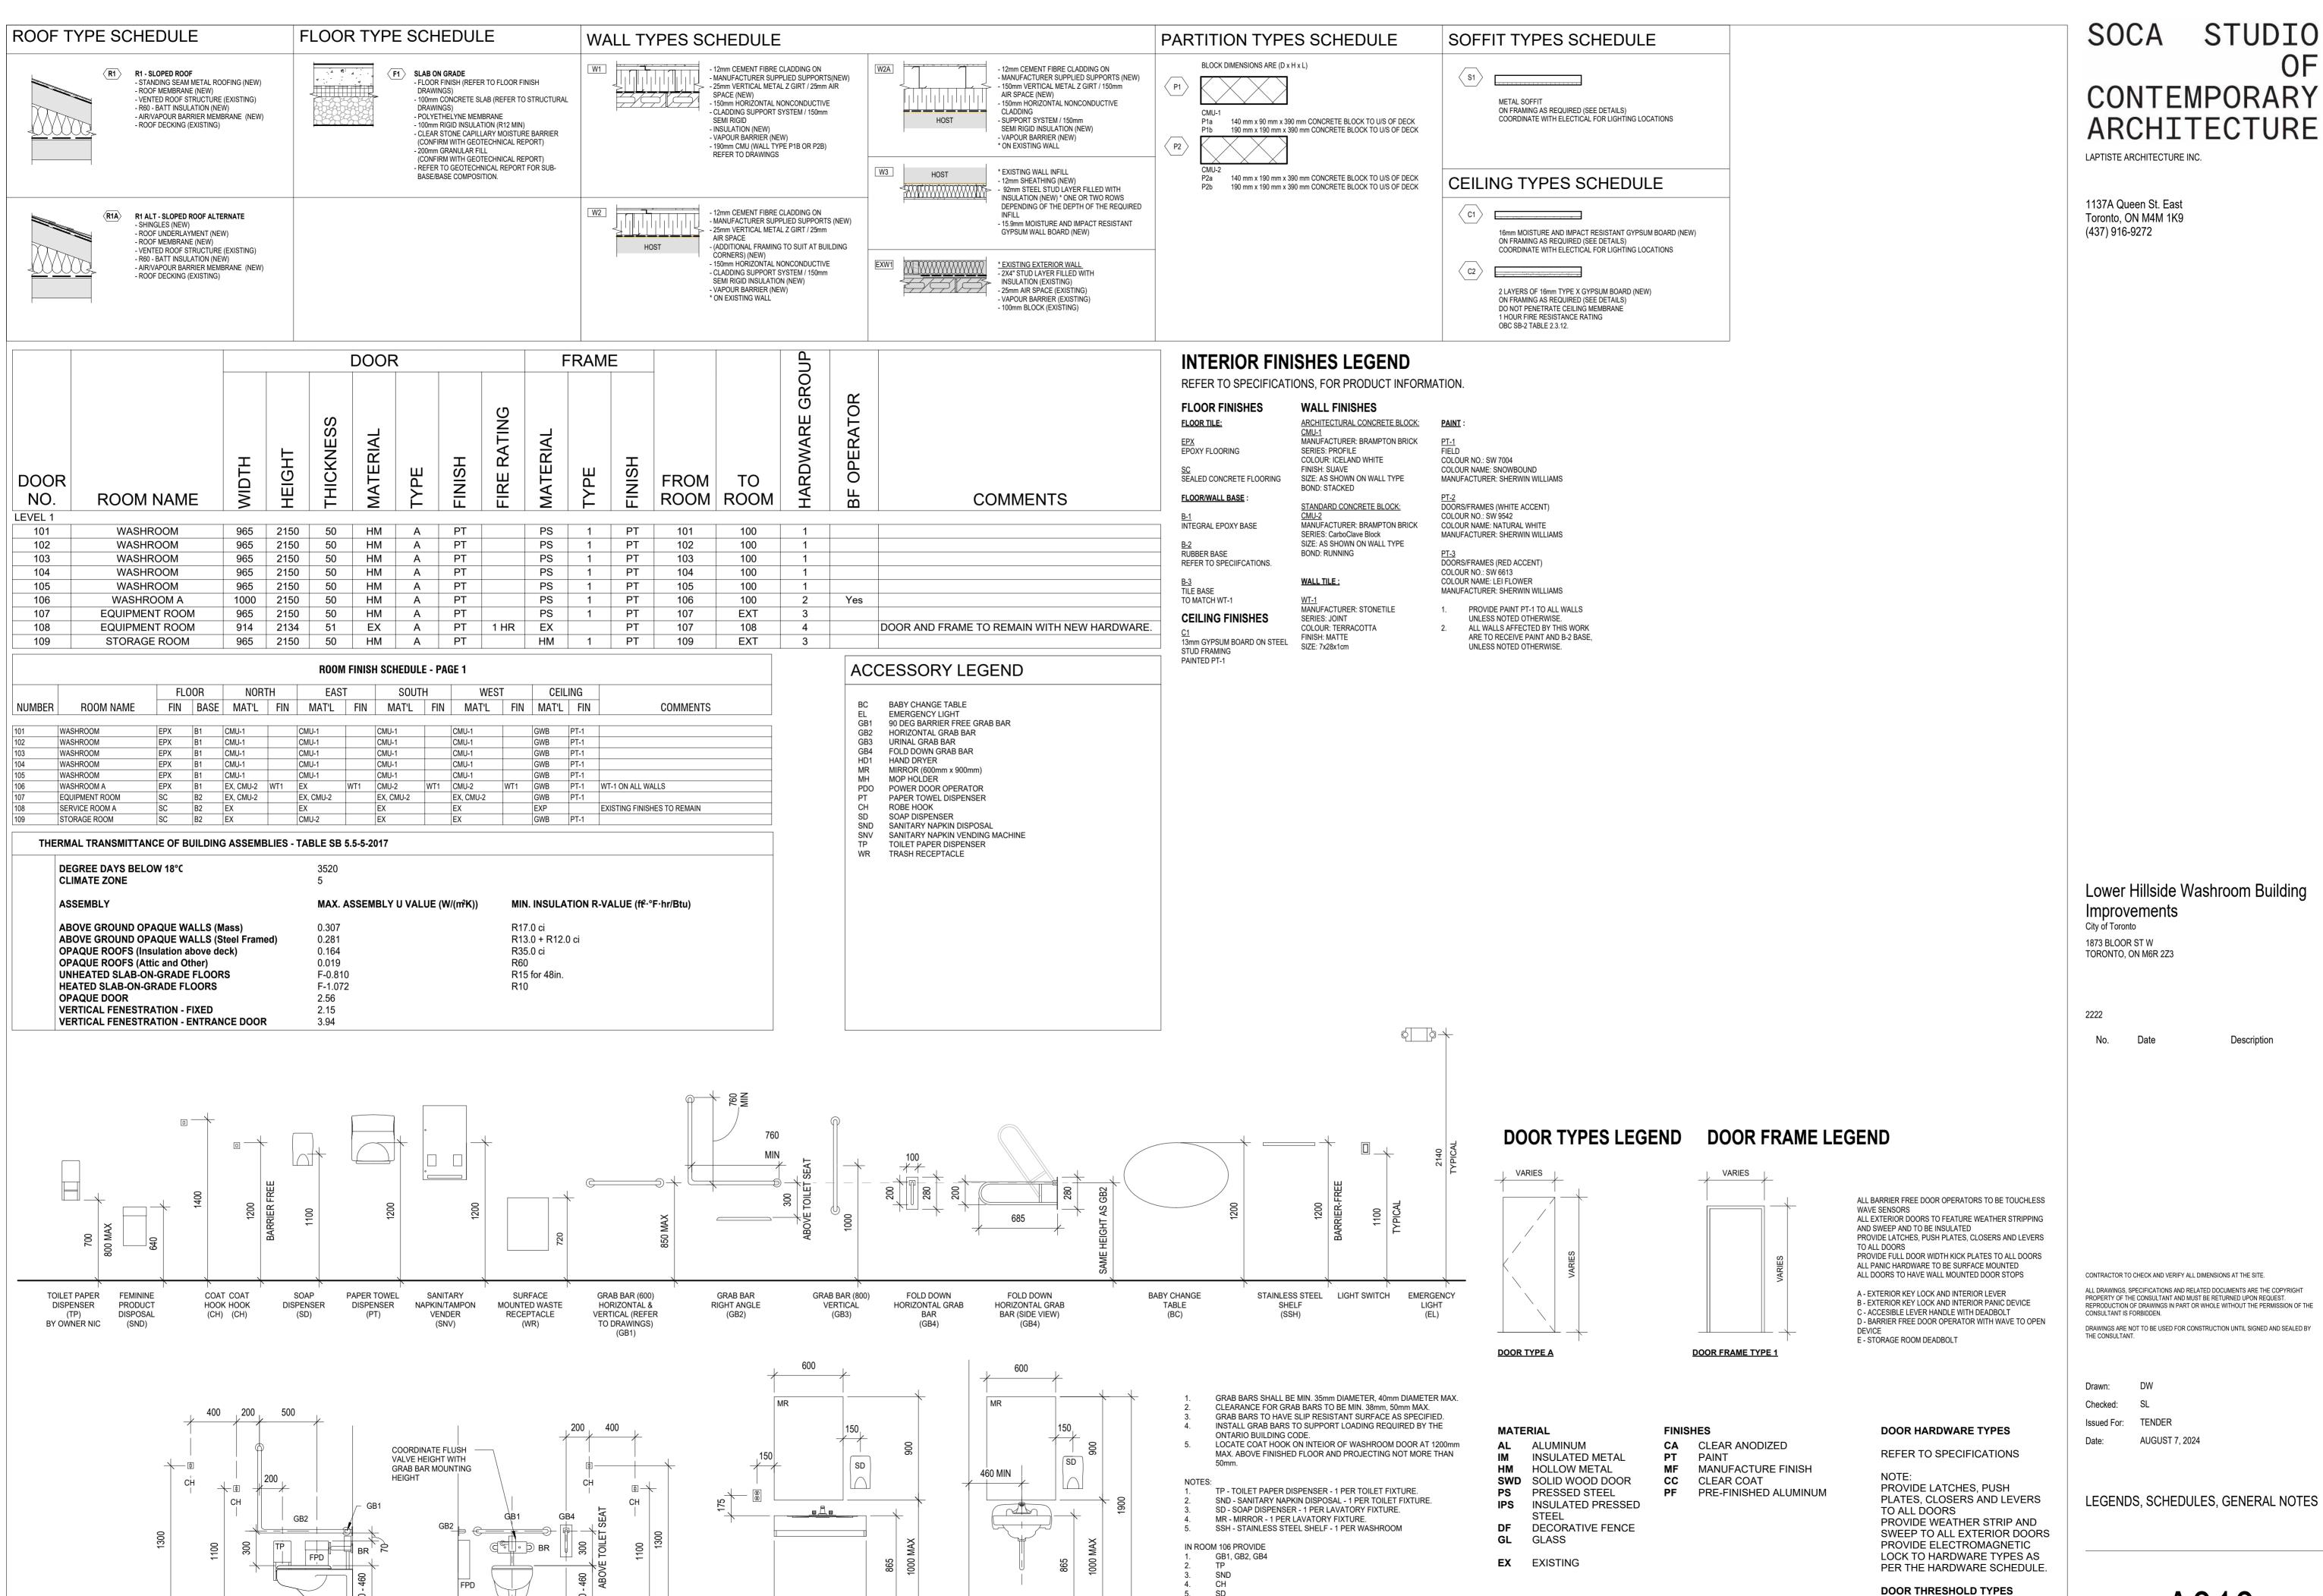
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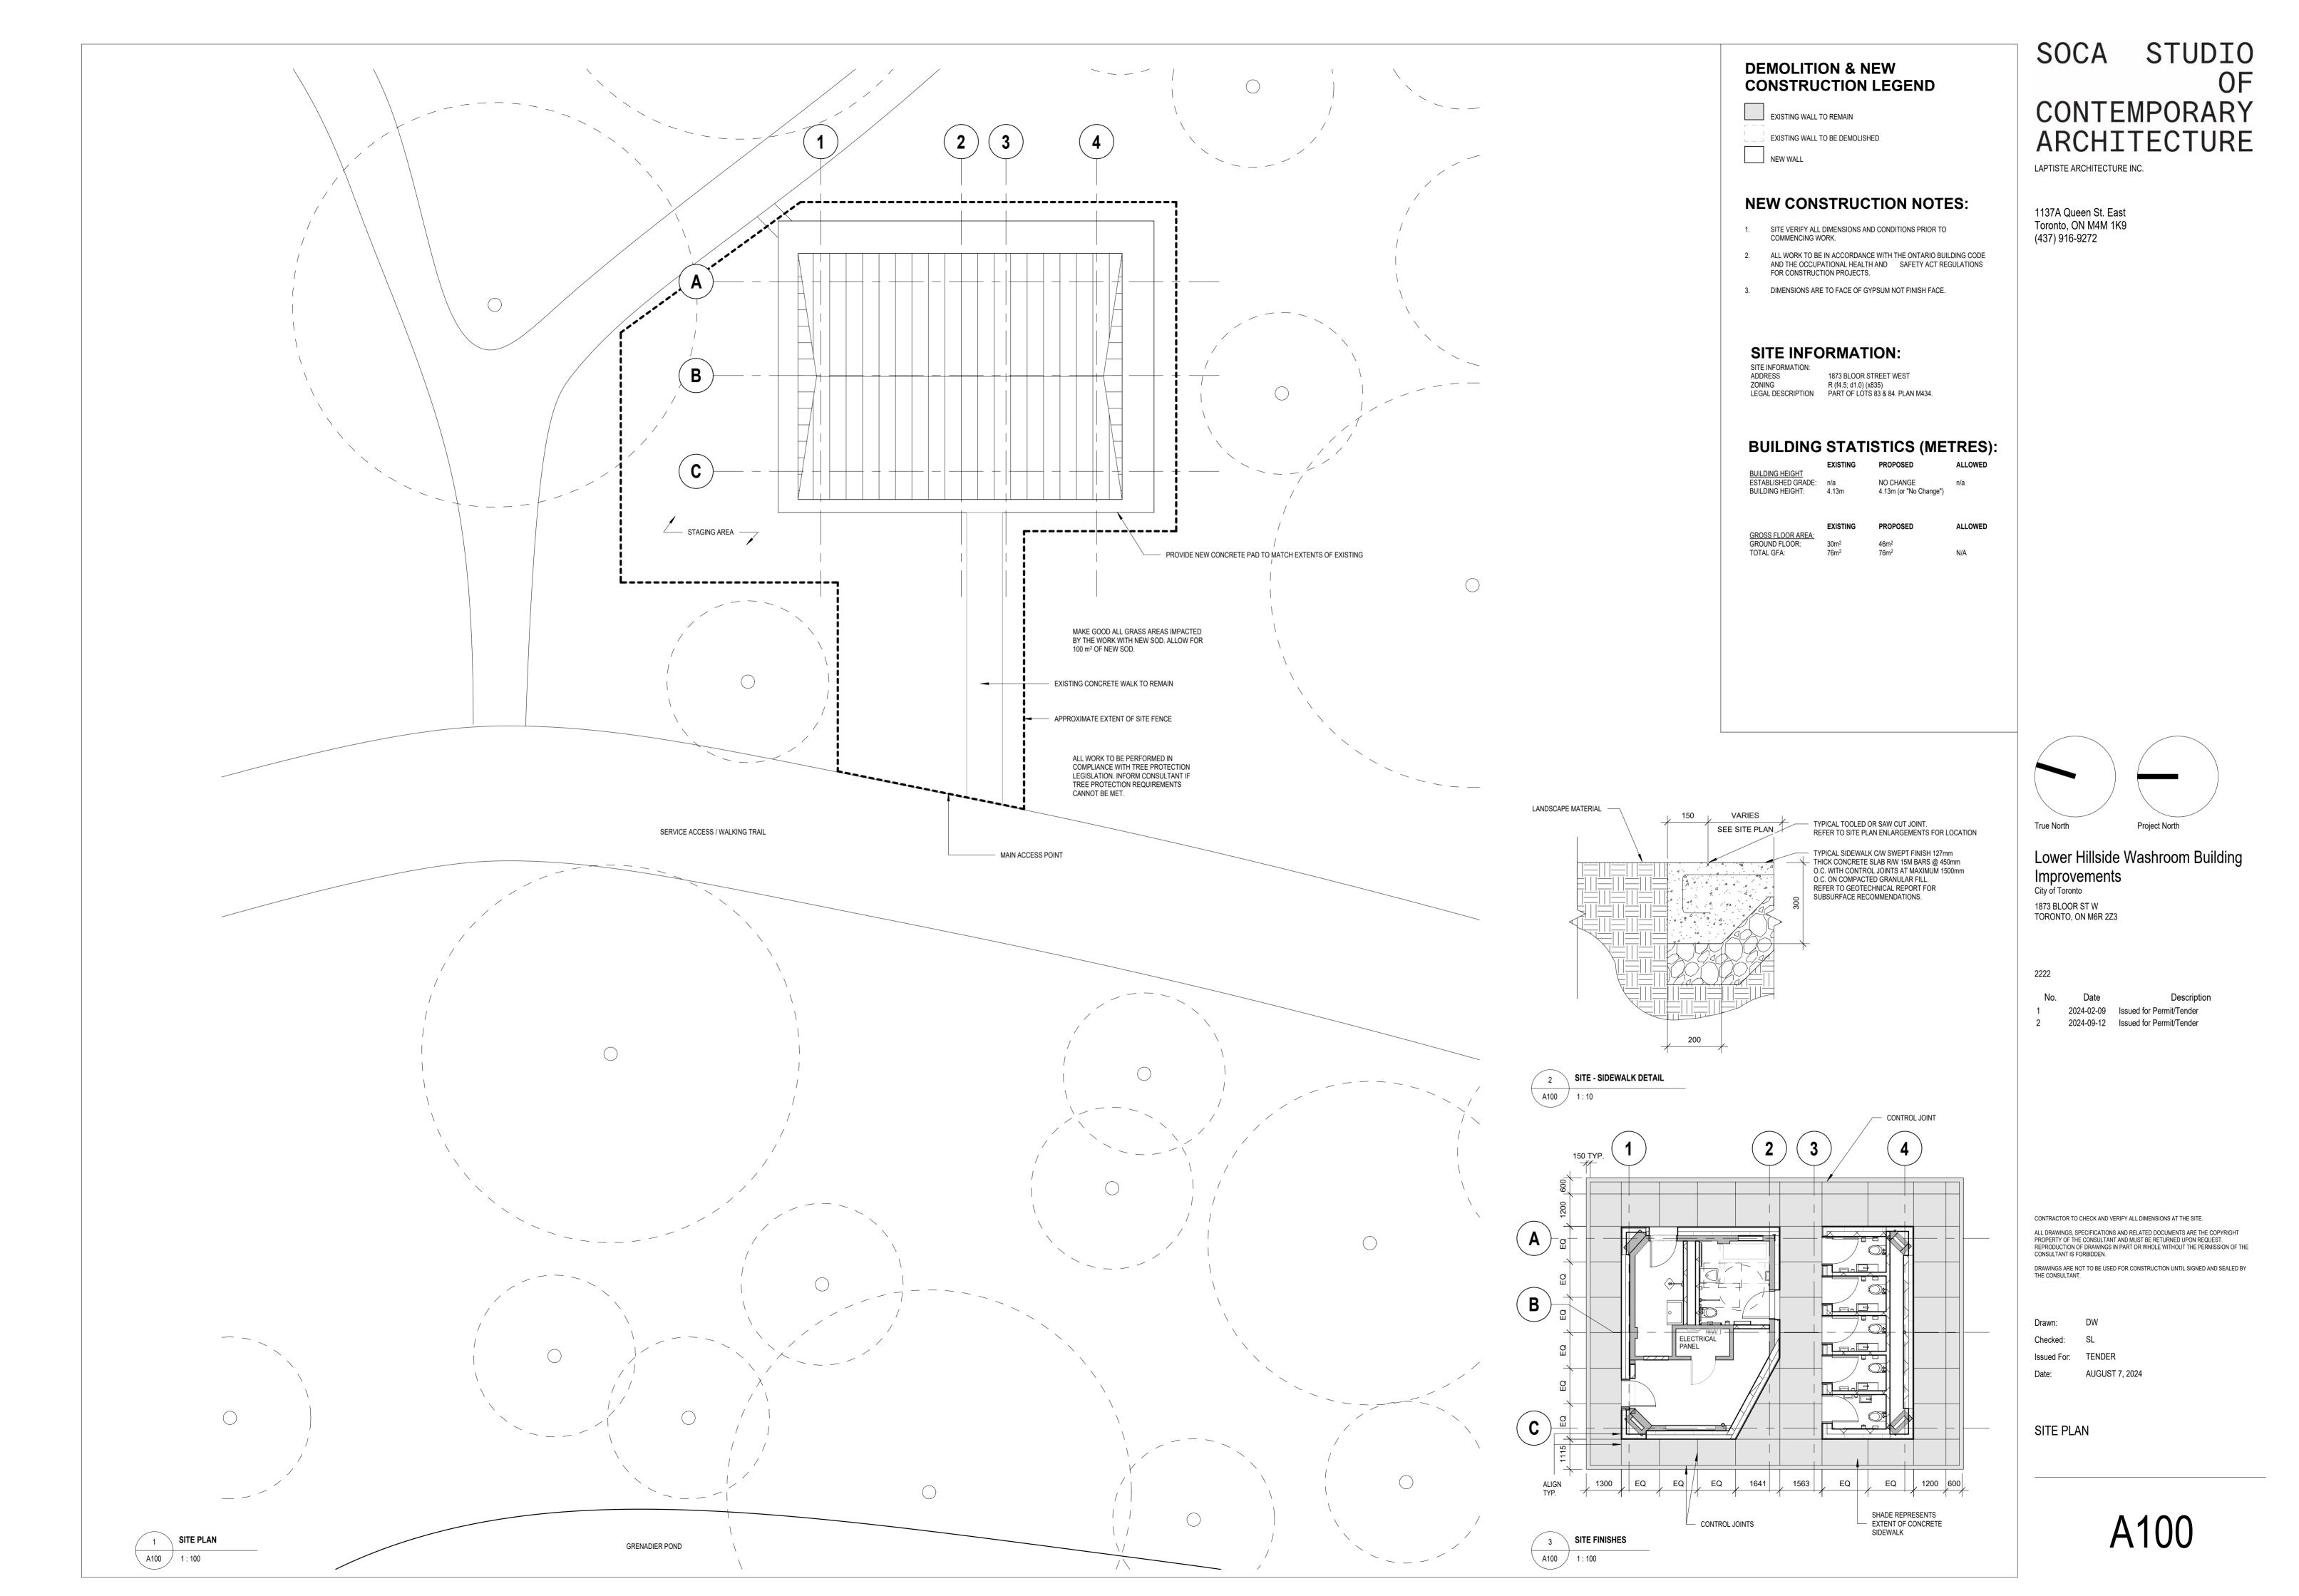
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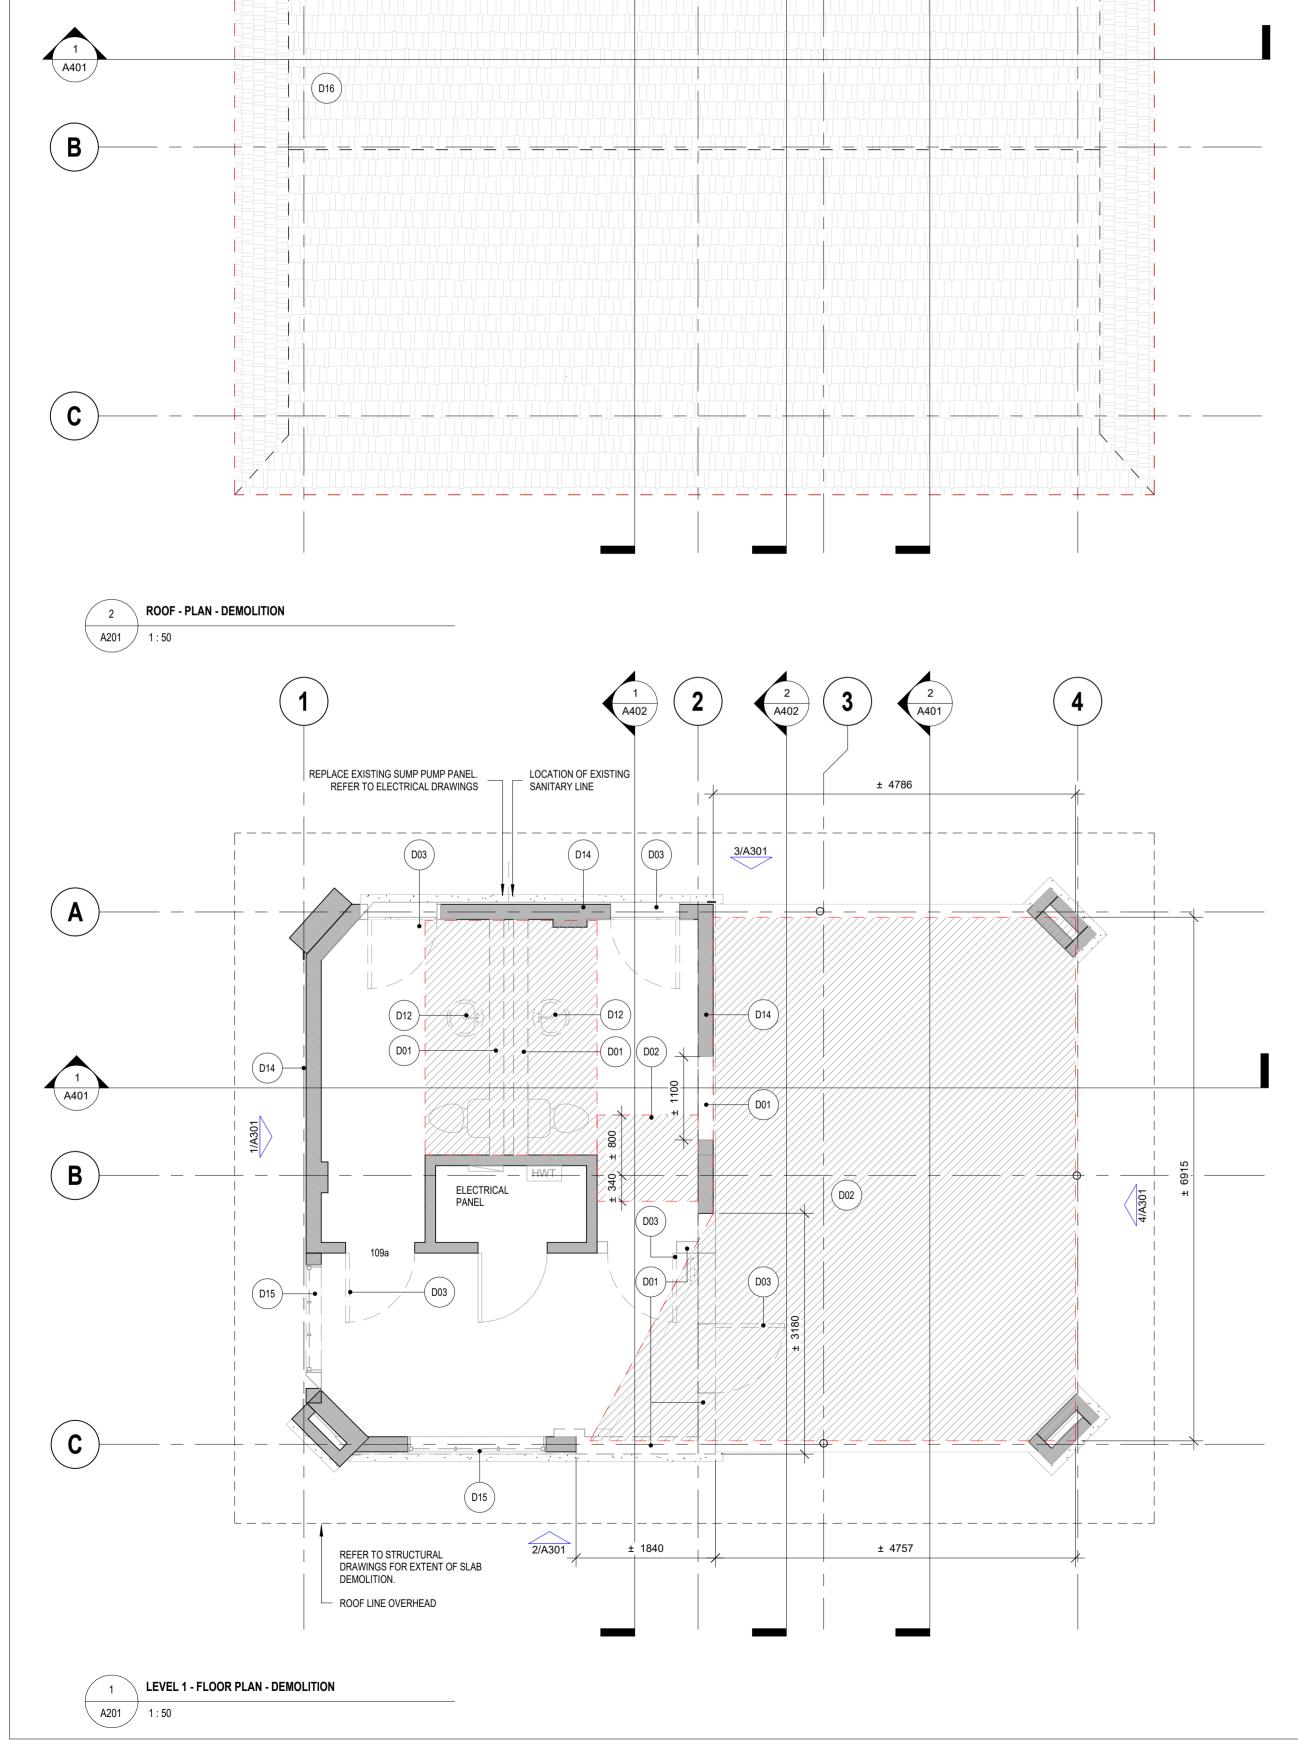
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EXTERIOR LIGHT FIXTURES TO BE REMOVED. REFER TO ELECTRICAL DRAWINGS. STEEL COLUMNS TO REMAIN. MAKE GOOD FOR NEW PAINT. PUMP EQUIPMENT TO BE RELOCATED TO BUILDING INTERIOR. REFER TO MECHANICAL AND ELECTRICAL DRAWINGS.



EXISTING SLAB TO BE DEMOLISHED

- CODE AND THE OCCUPATIONAL HEALTH AND SAFETY ACT REGULATIONS FOR CONSTRUCTION PROJECTS.
- PROVIDE PROTECTION IN LOCATIONS APPROVED BY THE OWNER AND
- ARCHITECTURAL, MECHANICAL AND ELECTRICAL DEMOLITION NOTIFY CONSULTANT OF LOAD BEARING MEMBERS OR ASSEMBLIES IDENTIFIED OR DISCOVERED DURING WORK AND NOT INDICATED ON

DRAWINGS. DO NOT PROCEED WITH REMOVALS WITHOUT PRIOR

- CHASES AS REQUIRED FOR SAFE REMOVAL. EXISTING AND CAUSE OTHERS TO FALL.
- REMOVAL OF BASE AND ALL MORTAR AND ADHESIVES AND
- 10. DEMOLITION INCLUDES ALL ASSOCIATED MECHANICAL AND BRACKETS, TRIM AND ACCESSORIES AS REQUIRED TO COMPLETE
- MAINTAIN EXISTING FIRE SUPPRESSION SYSTEMS AND EQUIPMENT MAINTAIN FIRE SEPRATIONS AND FIRE RATINGS. MAKE GOOD ANY
- DAMAGE TO CEILING CEMENTITIOUS FIRE SPRAY.
- EXISTING STRUCTURE OR FINISHES SHOWN TO REMAIN AND REPAIR
- PROVIDE OPENING FOR NEW 750mm X 750mm ACCESS PANEL IN EXISTING GYPSUM BOARD CEILING OF JANITOR ROOM (ROOM 124).

INSTALLATION OF NEW FLOOR FINISHES. REMOVE EXISTING DOOR AND FRAME.

GOOD EXISTING SHEATHING. TYPICAL.

REMOVE EXISTING GLASS BLOCK.

REFER TO DETAIL DRAWINGS.

DEMOLISH CONCRETE SLAB TO EXTENTS SHOWN BY HATCH. PATCH. REPAIR AND MAKE GOOD EXISTING FLOOR SLAB FOR

REMOVE EXISTING TOILETS, URINALS AND SINKS. TYPICAL.

REMOVE EXISTING ROOFING AND PREPARE FOR NEW.

DEMOLISH PORTION OF EAVE TO EXTENT INDICATED ON

DRAWINGS. MAKE GOOD EAVE TO PREPARE FOR NEW SOFFT

REMOVE EXISTING CLADDING TO FACE OF SHEATHING. MAKE

Key Value

DEMOLITION LEGEND

EXISTING WALL TO BE DEMOLISHED

EXISTING WALL TO REMAIN



DEMOLITION NOTES

- SITE VERIFY ALL DIMENSIONS AND CONDITIONS.
 ALL WORK TO BE IN ACCORDANCE WITH THE ONTARIO BUILDING
- CONSULTANT SO AS NOT TO DAMAGE EXISTING STRUCTURE OR PART THEREOF. CONTRACTOR SHALL BE RESPONSIBLE FOR ANY DAMAGE TO THE EXISTING STRUCTURE OR FINISHES SHOWN TO REMAIN AND IS TO REPAIR / REPLACE SAME TO THE SATISFACTION OF THE OWNER
- COMPLETE ALL DEMOLITION WORK NECESSARY TO COMPLETE THE RENOVATIONS AS SHOWN AND AS REQUIRED. DEMOLITION OF BUILDING ELEMENTS INCLUDES COMPLETE REMOVAL OF ALL ASSOCIATED FIXTURES, FITTINGS, HARDWARE, FASTENERS,
- EQUIPMENT AND ACCESSORIES UNLESS NOTED OTHERWISE. DRAWINGS ARE COMPLEMENTARY AND SHALL BE READ TOGETHER.
- REVIEW BY THE CONSULTANT. PROVIDE TEMPORARY SUPPORT OF PIPES, DUCTS AND ELECTRICAL PROPOSED SUPPORTS ARE TO BE REVIEWED BY THE CONSULTANT PRIOR TO THE REMOVAL OF ANY COMPONENTS WHICH MAY FALL. OR
- MAINTAIN WORK AREAS AND STORAGE AREAS CLEAN AND ORDERLY AT ALL TIMES. REMOVAL OF EXISTING FLOOR FINISHES IS TO INCLUDE COMPLETE
- PREPARATION OF EXISTING SUBSTRATES TO RECEIVE NEW FLOORING, SATISFACTORY TO THE MANUFACTURER OF NEW FLOOR FINISHES. ALLOW FOR EXCESSIVE LEVELING OF SLABS.
- ELECTRICAL SERVICES, EQUIPMENT, FITTINGS, FIXTURES, HANGERS,
- REMOVAL OF DOORS AND FRAMES IS TO INCLUDE REMOVAL OF ALL
- DISCONNECT AND CAP OFF ALL SERVICES PRIOR TO DEMOLITION. CONTRACTOR TO BE RESPONSIBLE FOR ANY DAMAGE TO THE
- SAME TO THE SATISFACTION OF THE OWNER AND CONSULTANT.
- COORDINATE LOCATION WITH ELECTRICAL DRAWINGS.
 CONTRACTOR TO VACUUM EXISTING RANGE HOOD DUCTWORK PRIOR

	Demolition Keynote		
	Keynote Text		,
	DEMOLISH EXISTING WALL TO EXTENTS SHOWN. MAKE GOOD INTERFACE WITH REMAINING WALLS.		
_			

True North

Project North

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CONTEMPORARY

ARCHITECTURE

LAPTISTE ARCHITECTURE INC.

1137A Queen St. East Toronto, ON M4M 1K9

(437) 916-9272

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City of Toronto 1873 BLOOR ST W TORONTO, ON M6R 2Z3

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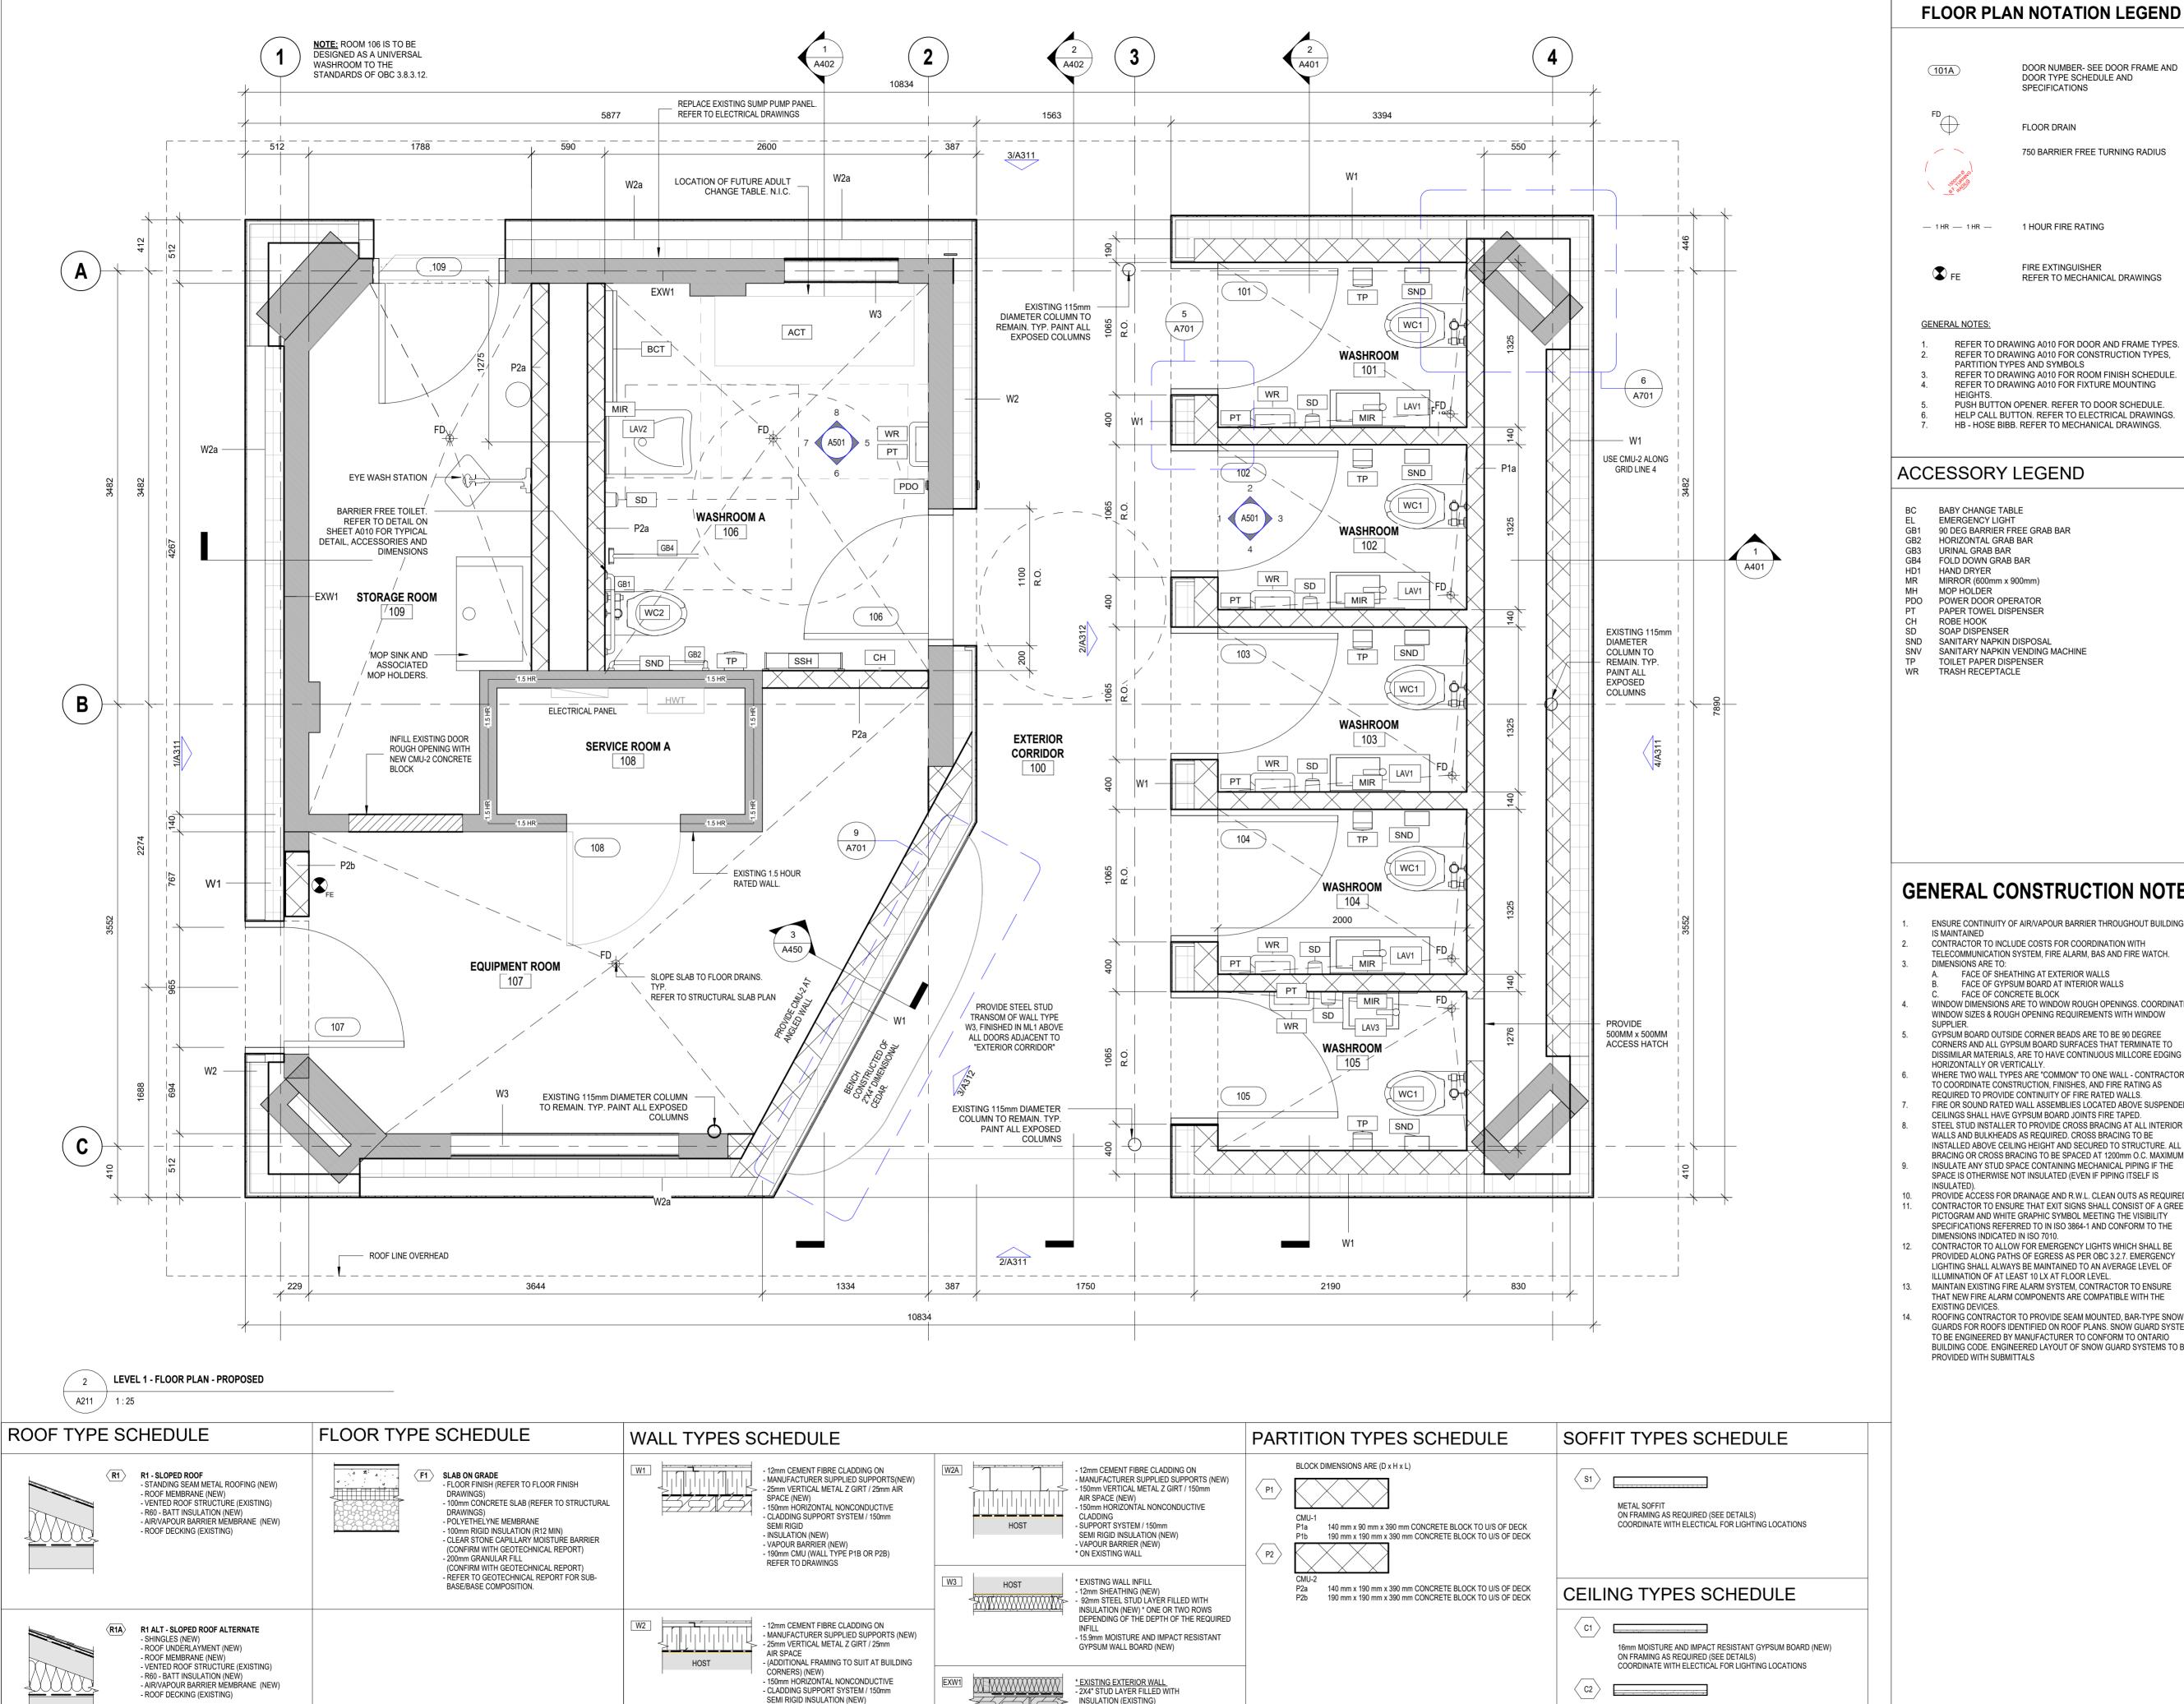
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LEVEL 1 - DEMOLITION PLAN

BRICK AND CONCRETE COLUMNS TO REMAIN.

EXISTING EXTERIOR VIEW



- VAPOUR BARRIER (NEW)

* ON EXISTING WALL

- 25mm AIR SPACE (EXISTING)

- VAPOUR BARRIER (EXISTING - 100mm BLOCK (EXISTING)

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DOOR NUMBER- SEE DOOR FRAME AND DOOR TYPE SCHEDULE AND

750 BARRIER FREE TURNING RADIUS

REFER TO MECHANICAL DRAWINGS

SPECIFICATIONS

1 HOUR FIRE RATING

FIRE EXTINGUISHER

REFER TO DRAWING A010 FOR DOOR AND FRAME TYPES.

REFER TO DRAWING A010 FOR CONSTRUCTION TYPES,

REFER TO DRAWING A010 FOR ROOM FINISH SCHEDULE. REFER TO DRAWING A010 FOR FIXTURE MOUNTING

PUSH BUTTON OPENER. REFER TO DOOR SCHEDULE. HELP CALL BUTTON. REFER TO ELECTRICAL DRAWINGS. HB - HOSE BIBB. REFER TO MECHANICAL DRAWINGS.

PARTITION TYPES AND SYMBOLS

FLOOR DRAIN

BC BABY CHANGE TABLE EMERGENCY LIGHT GB1 90 DEG BARRIER FREE GRAB BAR GB2 HORIZONTAL GRAB BAR

GB3 URINAL GRAB BAR GB4 FOLD DOWN GRAB BAR HD1 MR HAND DRYER MIRROR (600mm x 900mm) MOP HOLDER

PDO POWER DOOR OPERATOR PAPER TOWEL DISPENSER **ROBE HOOK**

SOAP DISPENSER SND SANITARY NAPKIN DISPOSAL SNV SANITARY NAPKIN VENDING MACHINE TOILET PAPER DISPENSER

GENERAL CONSTRUCTION NOTES

- ENSURE CONTINUITY OF AIR/VAPOUR BARRIER THROUGHOUT BUILDING IS MAINTAINED
- CONTRACTOR TO INCLUDE COSTS FOR COORDINATION WITH TELECOMMUNICATION SYSTEM, FIRE ALARM, BAS AND FIRE WATCH. DIMENSIONS ARE TO:
- FACE OF SHEATHING AT EXTERIOR WALLS FACE OF GYPSUM BOARD AT INTERIOR WALLS FACE OF CONCRETE BLOCK
- WINDOW DIMENSIONS ARE TO WINDOW ROUGH OPENINGS. COORDINATE WINDOW SIZES & ROUGH OPENING REQUIREMENTS WITH WINDOW
- GYPSUM BOARD OUTSIDE CORNER BEADS ARE TO BE 90 DEGREE CORNERS AND ALL GYPSUM BOARD SURFACES THAT TERMINATE TO DISSIMILAR MATERIALS, ARE TO HAVE CONTINUOUS MILLCORE EDGING
- HORIZONTALLY OR VERTICALLY. WHERE TWO WALL TYPES ARE "COMMON" TO ONE WALL - CONTRACTOR
- TO COORDINATE CONSTRUCTION, FINISHES, AND FIRE RATING AS REQUIRED TO PROVIDE CONTINUITY OF FIRE RATED WALLS.
- FIRE OR SOUND RATED WALL ASSEMBLIES LOCATED ABOVE SUSPENDED CEILINGS SHALL HAVE GYPSUM BOARD JOINTS FIRE TAPED. STEEL STUD INSTALLER TO PROVIDE CROSS BRACING AT ALL INTERIOR WALLS AND BULKHEADS AS REQUIRED. CROSS BRACING TO BE
- INSTALLED ABOVE CEILING HEIGHT AND SECURED TO STRUCTURE, ALL BRACING OR CROSS BRACING TO BE SPACED AT 1200mm O.C. MAXIMUM. INSULATE ANY STUD SPACE CONTAINING MECHANICAL PIPING IF THE
- PROVIDE ACCESS FOR DRAINAGE AND R.W.L. CLEAN OUTS AS REQUIRED CONTRACTOR TO ENSURE THAT EXIT SIGNS SHALL CONSIST OF A GREEN
- PICTOGRAM AND WHITE GRAPHIC SYMBOL MEETING THE VISIBILITY SPECIFICATIONS REFERRED TO IN ISO 3864-1 AND CONFORM TO THE DIMENSIONS INDICATED IN ISO 7010.
- CONTRACTOR TO ALLOW FOR EMERGENCY LIGHTS WHICH SHALL BE PROVIDED ALONG PATHS OF EGRESS AS PER OBC 3.2.7. EMERGENCY LIGHTING SHALL ALWAYS BE MAINTAINED TO AN AVERAGE LEVEL OF ILLUMINATION OF AT LEAST 10 LX AT FLOOR LEVEL.
- MAINTAIN EXISTING FIRE ALARM SYSTEM, CONTRACTOR TO ENSURE THAT NEW FIRE ALARM COMPONENTS ARE COMPATIBLE WITH THE


2 LAYERS OF 16mm TYPE X GYPSUM BOARD (NEW)

ON FRAMING AS REQUIRED (SEE DETAILS)

DO NOT PENETRATE CEILING MEMBRANE 1 HOUR FIRE RESISTANCE RATING

OBC SB-2 TABLE 2.3.12.

EXISTING DEVICES. ROOFING CONTRACTOR TO PROVIDE SEAM MOUNTED. BAR-TYPE SNOW GUARDS FOR ROOFS IDENTIFIED ON ROOF PLANS. SNOW GUARD SYSTEM TO BE ENGINEERED BY MANUFACTURER TO CONFORM TO ONTARIO BUILDING CODE. ENGINEERED LAYOUT OF SNOW GUARD SYSTEMS TO BE PROVIDED WITH SUBMITTALS

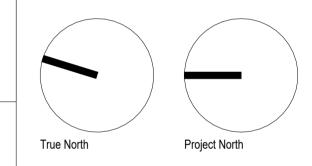

Lower Hillside Washroom Building **Improvements**

City of Toronto 1873 BLOOR ST W

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LEVEL 1 - PROPOSED PLAN

A212 / 1:50

GENERAL CONSTRUCTION NOTES

- 1. ENSURE CONTINUITY OF AIR/VAPOUR BARRIER THROUGHOUT BUILDING
- IS MAINTAINED
 CONTRACTOR TO INCLUDE COSTS FOR COORDINATION WITH
 TELECOMMUNICATION SYSTEM, FIRE ALARM, BAS AND FIRE WATCH.
- DIMENSIONS ARE TO: FACE OF SHEATHING AT EXTERIOR WALLS FACE OF GYPSUM BOARD AT INTERIOR WALLS
- FACE OF CONCRETE BLOCK 4. WINDOW DIMENSIONS ARE TO WINDOW ROUGH OPENINGS. COORDINATE WINDOW SIZES & ROUGH OPENING REQUIREMENTS WITH WINDOW
- 5. GYPSUM BOARD OUTSIDE CORNER BEADS ARE TO BE 90 DEGREE CORNERS AND ALL GYPSUM BOARD SURFACES THAT TERMINATE TO DISSIMILAR MATERIALS, ARE TO HAVE CONTINUOUS MILLCORE EDGING HORIZONTALLY OR VERTICALLY.
- WHERE TWO WALL TYPES ARE "COMMON" TO ONE WALL CONTRACTOR
 TO COORDINATE CONSTRUCTION, FINISHES, AND FIRE RATING AS
- REQUIRED TO PROVIDE CONTINUITY OF FIRE RATED WALLS.
 FIRE OR SOUND RATED WALL ASSEMBLIES LOCATED ABOVE SUSPENDED CEILINGS SHALL HAVE GYPSUM BOARD JOINTS FIRE TAPED.
- STEEL STUD INSTALLER TO PROVIDE CROSS BRACING AT ALL INTERIOR WALLS AND BULKHEADS AS REQUIRED. CROSS BRACING TO BE INSTALLED ABOVE CEILING HEIGHT AND SECURED TO STRUCTURE. ALL
- BRACING OR CROSS BRACING TO BE SPACED AT 1200mm O.C. MAXIMUM. INSULATE ANY STUD SPACE CONTAINING MECHANICAL PIPING IF THE SPACE IS OTHERWISE NOT INSULATED (EVEN IF PIPING ITSELF IS
- 10. PROVIDE ACCESS FOR DRAINAGE AND R.W.L. CLEAN OUTS AS REQUIRED CONTRACTOR TO ENSURE THAT EXIT SIGNS SHALL CONSIST OF A GREEN PICTOGRAM AND WHITE GRAPHIC SYMBOL MEETING THE VISIBILITY SPECIFICATIONS REFERRED TO IN ISO 3864-1 AND CONFORM TO THE DIMENSIONS INDICATED IN ISO 7010.


 12. CONTRACTOR TO ALLOW FOR EMERGENCY LIGHTS WHICH SHALL BE PROVIDED ALONG PATHS OF EGRESS AS PER OBC 3.2.7. EMERGENCY
- LIGHTING SHALL ALWAYS BE MAINTAINED TO AN AVERAGE LEVEL OF ILLUMINATION OF AT LEAST 10 LX AT FLOOR LEVEL. 13. MAINTAIN EXISTING FIRE ALARM SYSTEM, CONTRACTOR TO ENSURE
- 14. ROOFING CONTRACTOR TO PROVIDE SEAM MOUNTED, BAR-TYPE SNOW GUARDS FOR ROOFS IDENTIFIED ON ROOF PLANS. SNOW GUARD SYSTEM TO BE ENGINEERED BY MANUFACTURER TO CONFORM TO ONTARIO BUILDING CODE. ENGINEERED LAYOUT OF SNOW GUARD SYSTEMS TO BE PROVIDED WITH SUBMITTALS

THAT NEW FIRE ALARM COMPONENTS ARE COMPATIBLE WITH THE

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A212 1:50


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ROOF - PROPOSED PLAN

AUGUST 7, 2024

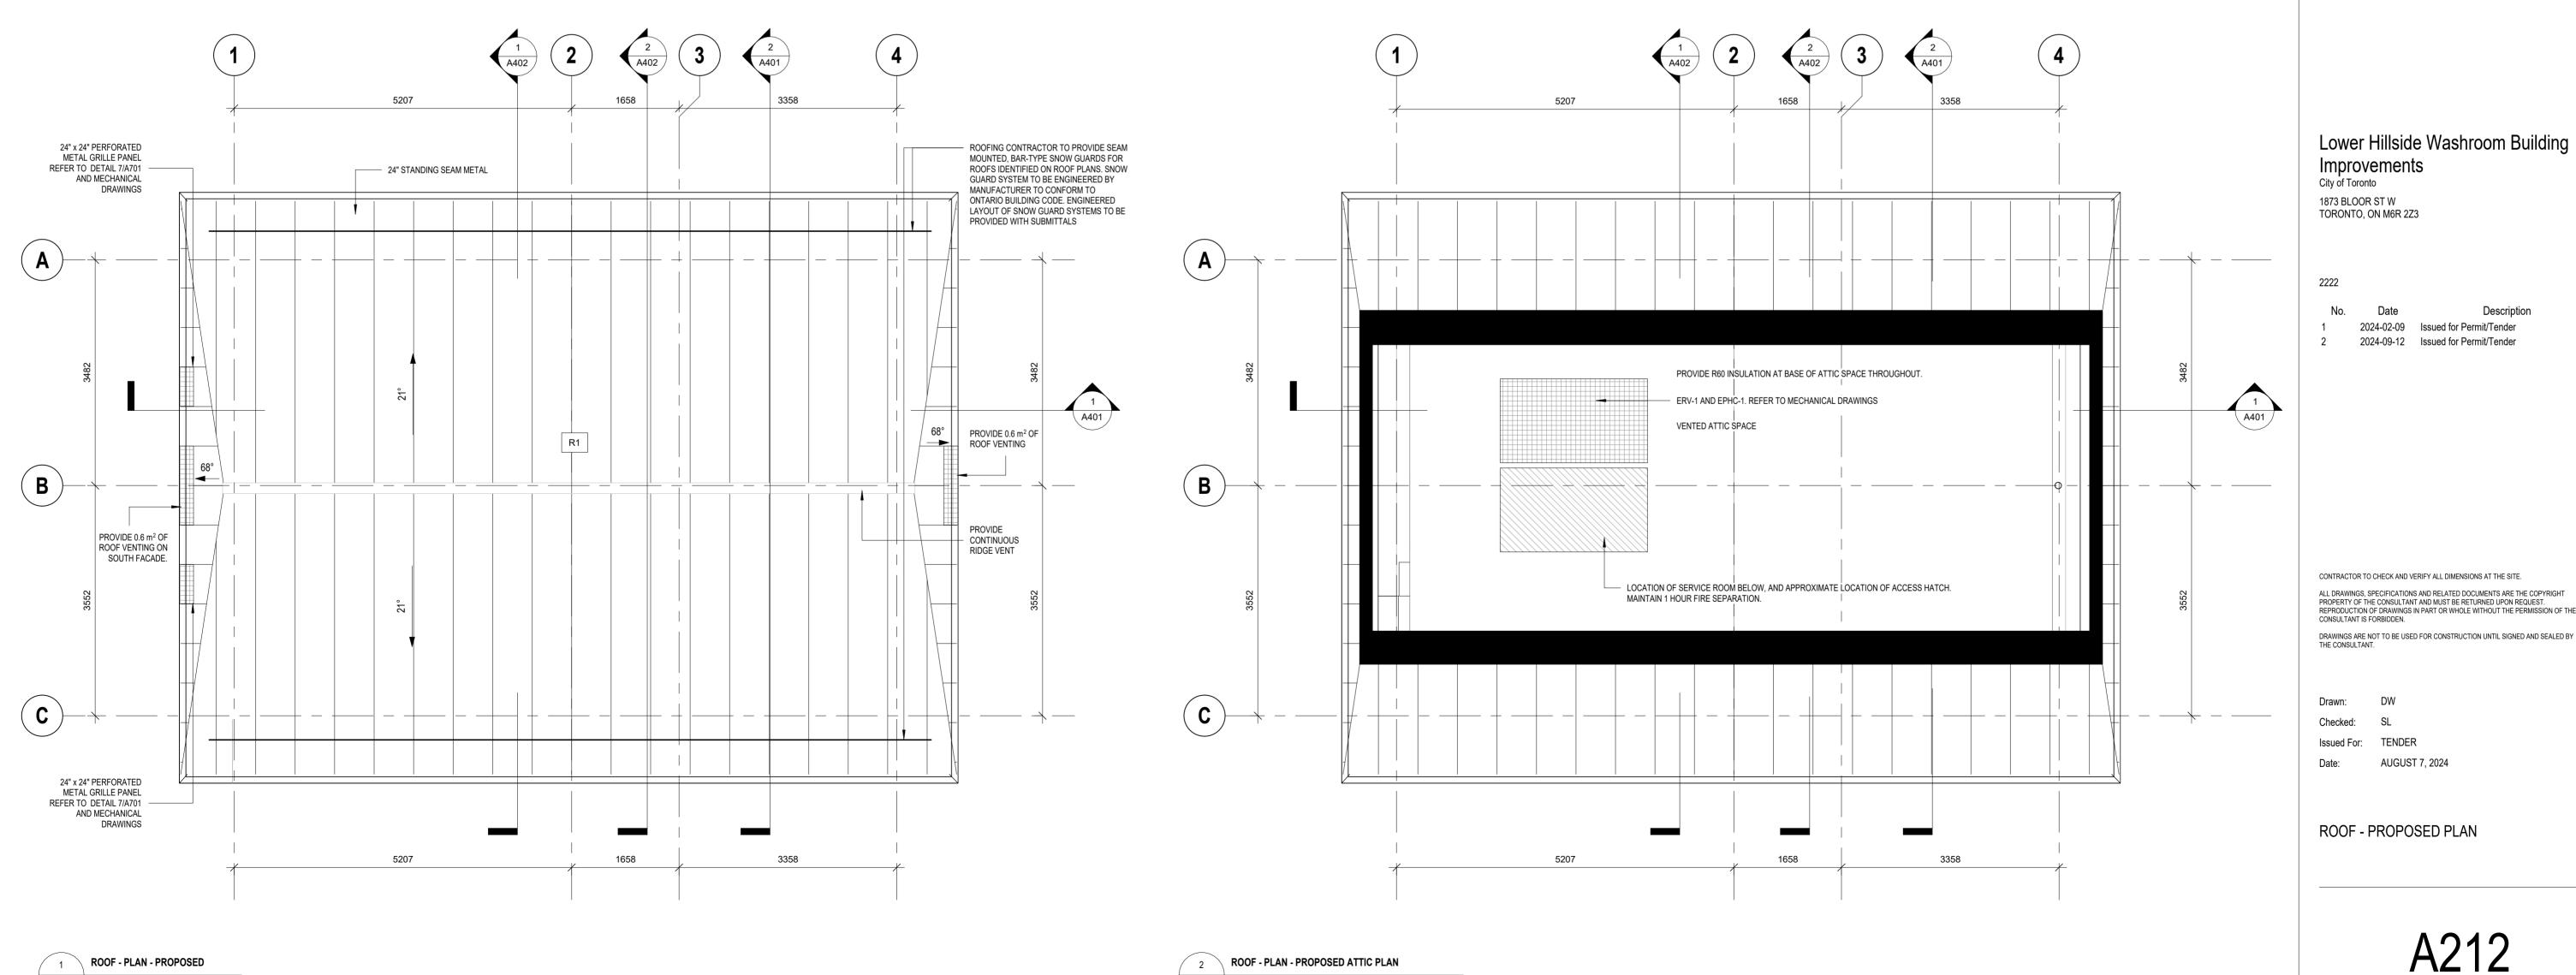A221 / 1:50

CEILING LEGEND

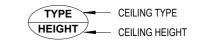

CEILING NOTES

- CEILING HEIGHTS FOR EXPOSED STRUCTURE NOTED AS UNDERSIDE OF DECK. REFER TO WALL SECTIONS.
- REFLECTED CEILING PLAN TO BE READ IN CONJUNCTION WITH
- MECHANICAL AND ELECTRICAL CONSULTANT DRAWINGS. REFER TO MECHANICAL AND ELECTRICAL DRAWINGS FOR FURTHER DUCTING AND LIGHTING INFORMATION.
- ALL CEILING TYPES SHOWN ARE TO BE READ IN CONJUNCTION WITH THE REFLECTED CEILING PLAN FOR HEIGHTS AND INSTALLATION LOCATIONS.


 5. CEILING IN ROOM 108 IS 1 HOUR RATED.

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SOFFIT TYPES		
TYPE	DESCRIPTION	
C1	GWB CEILING	
C2	GWB CEILING - 1HR RATED	
S1	METAL SOFFIT	



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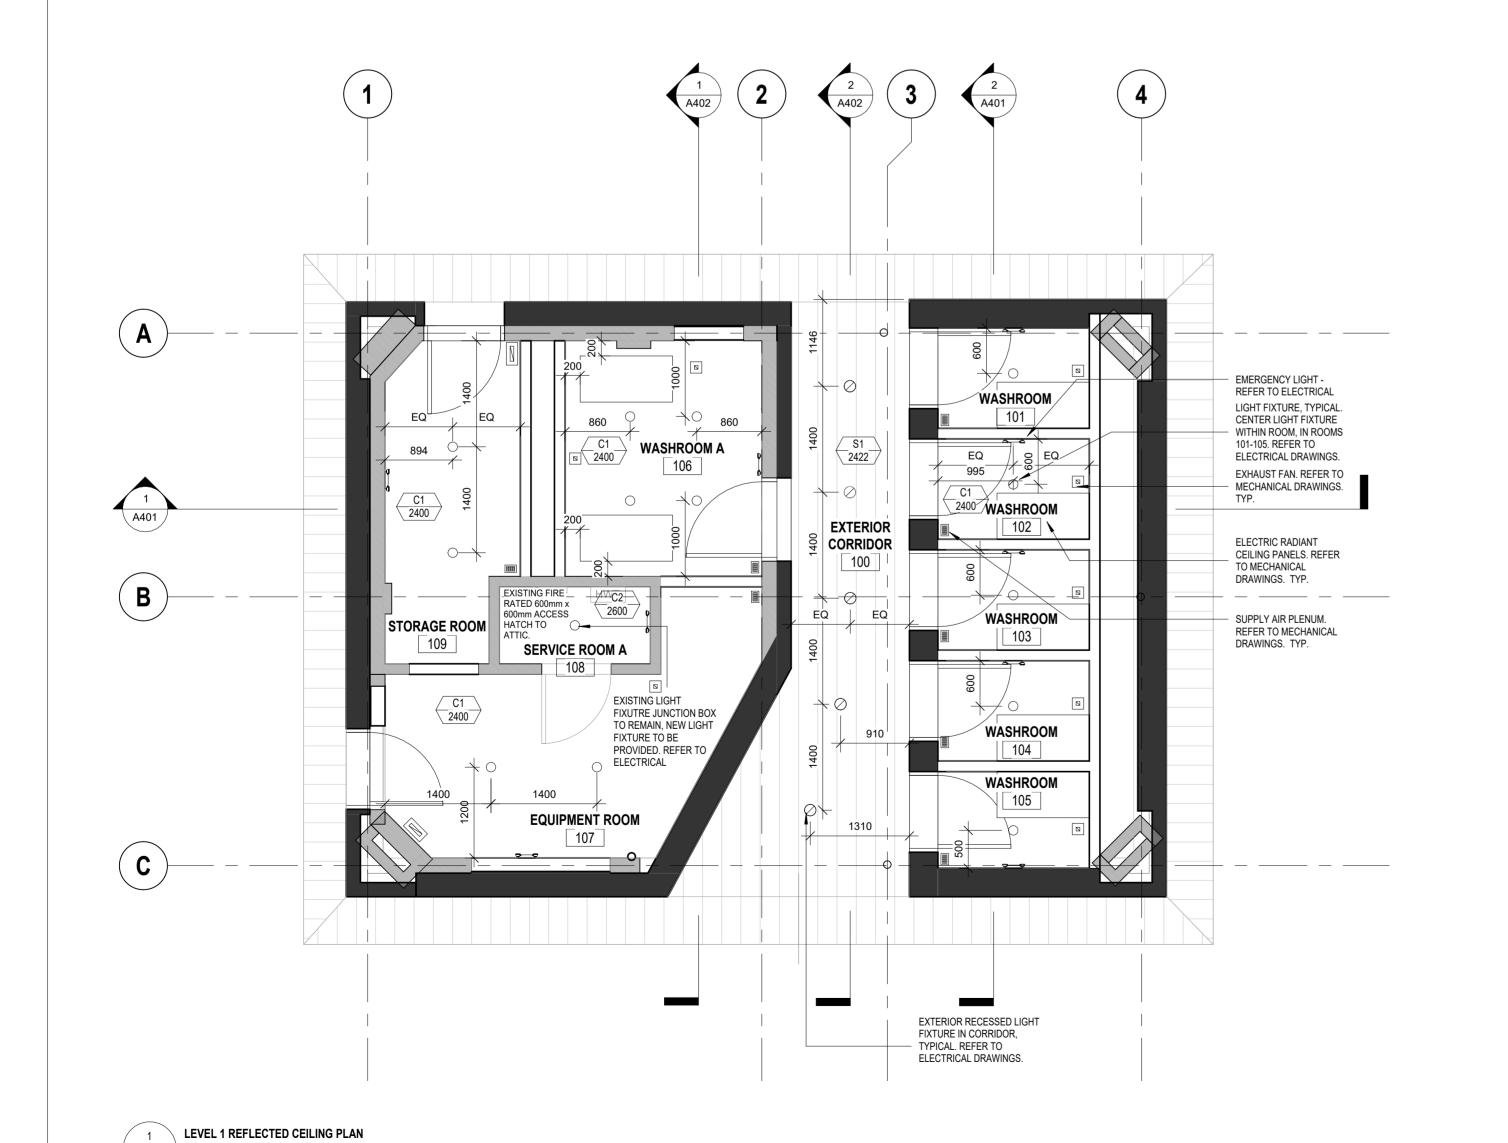
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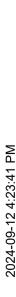
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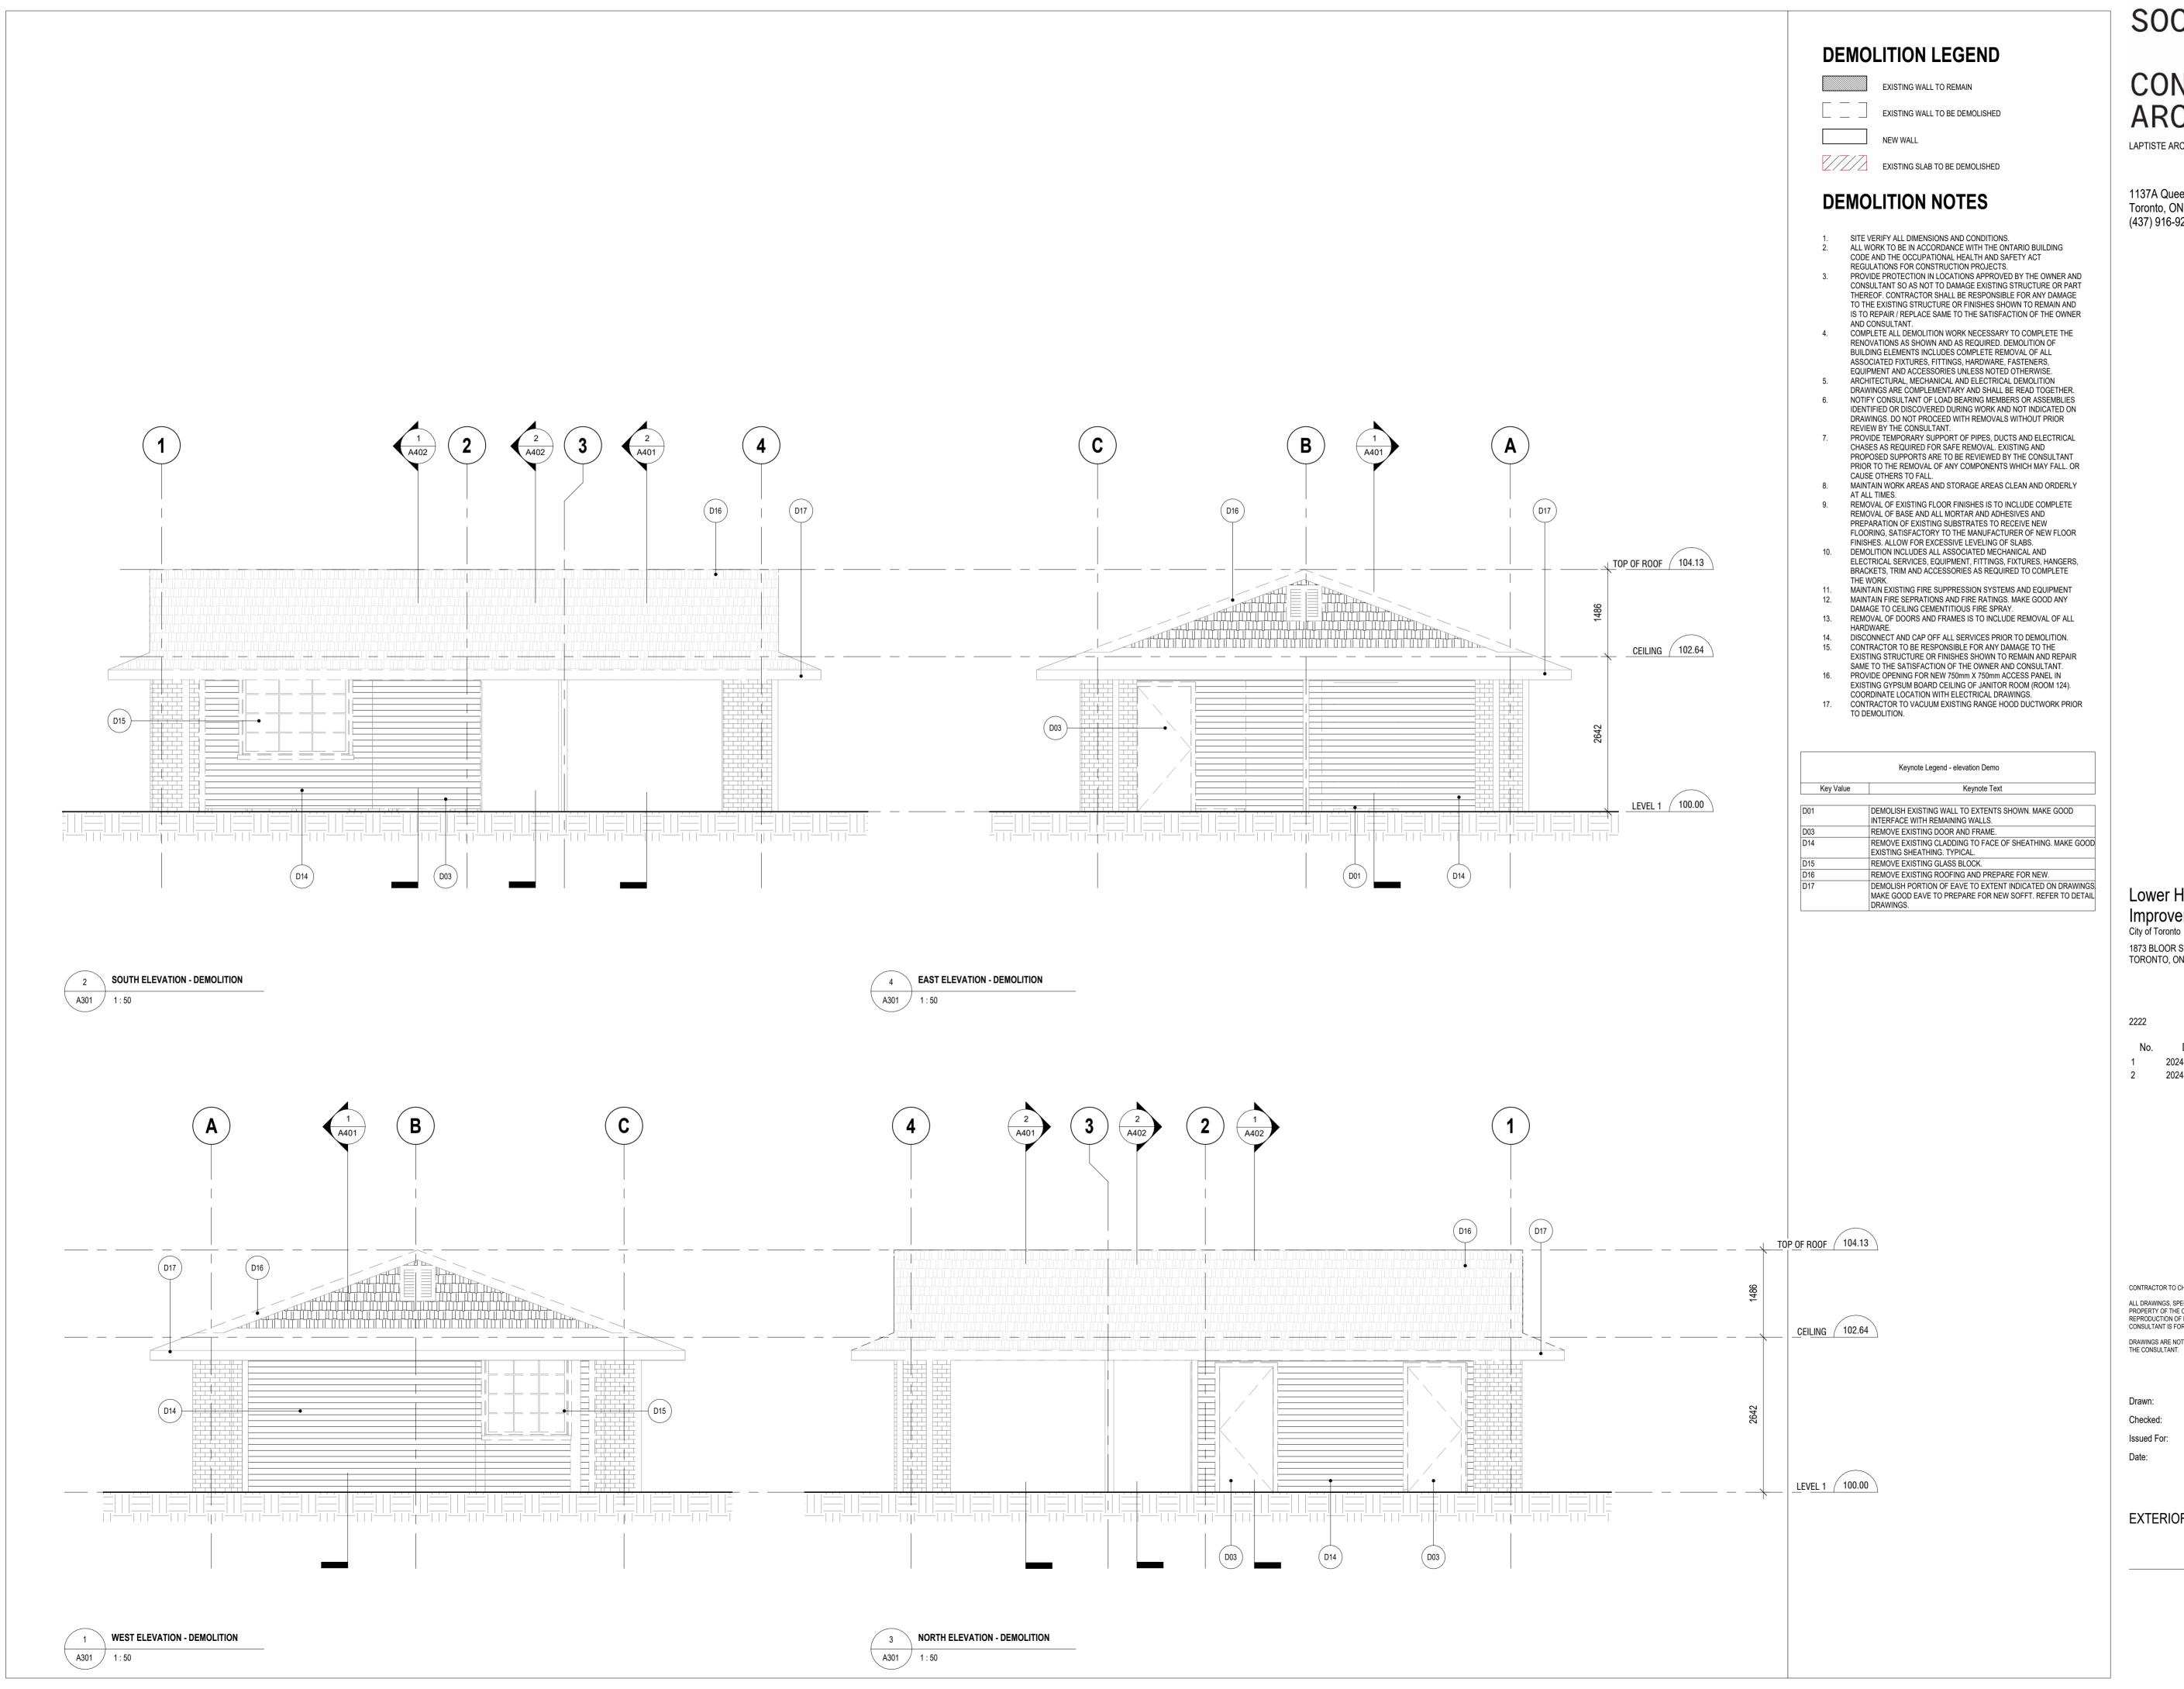
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LEVEL 1 - REFLECTED CEILING PLAN PROPOSED



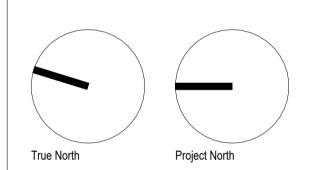



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EXTERIOR ELEVATIONS - DEMOLITION

Material Keynote Legend

FIBER CEMENT PATTERN 2, REFER TO SPECIFICATIONS. ALUMINUM METAL TRANSOM FINISH, REFER TO SEPCIFICATIONS.

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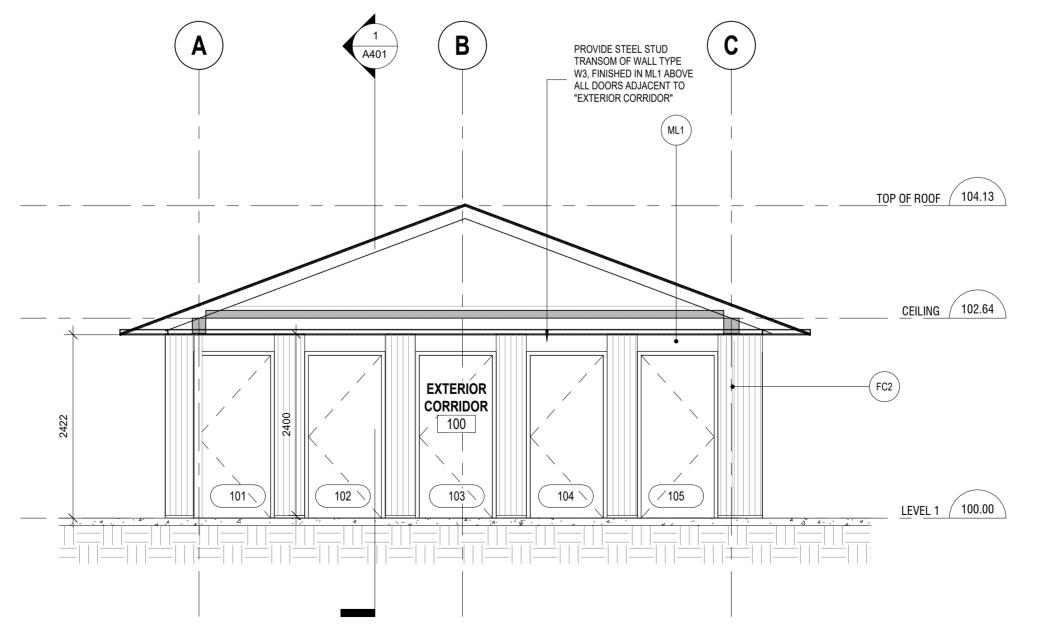
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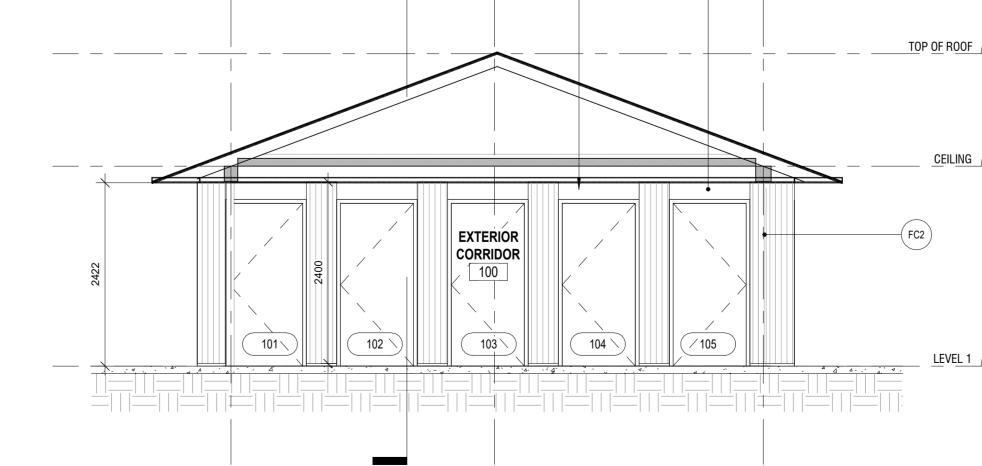
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AUGUST 7, 2024

EXTERIOR ELEVATIONS - PROPOSED

A312







BENCH

TOP OF ROOF 104.13

CEILING 102.64


LEVEL 1 (100.00)

A701

REFER TO 2/A702

EXTERIOR




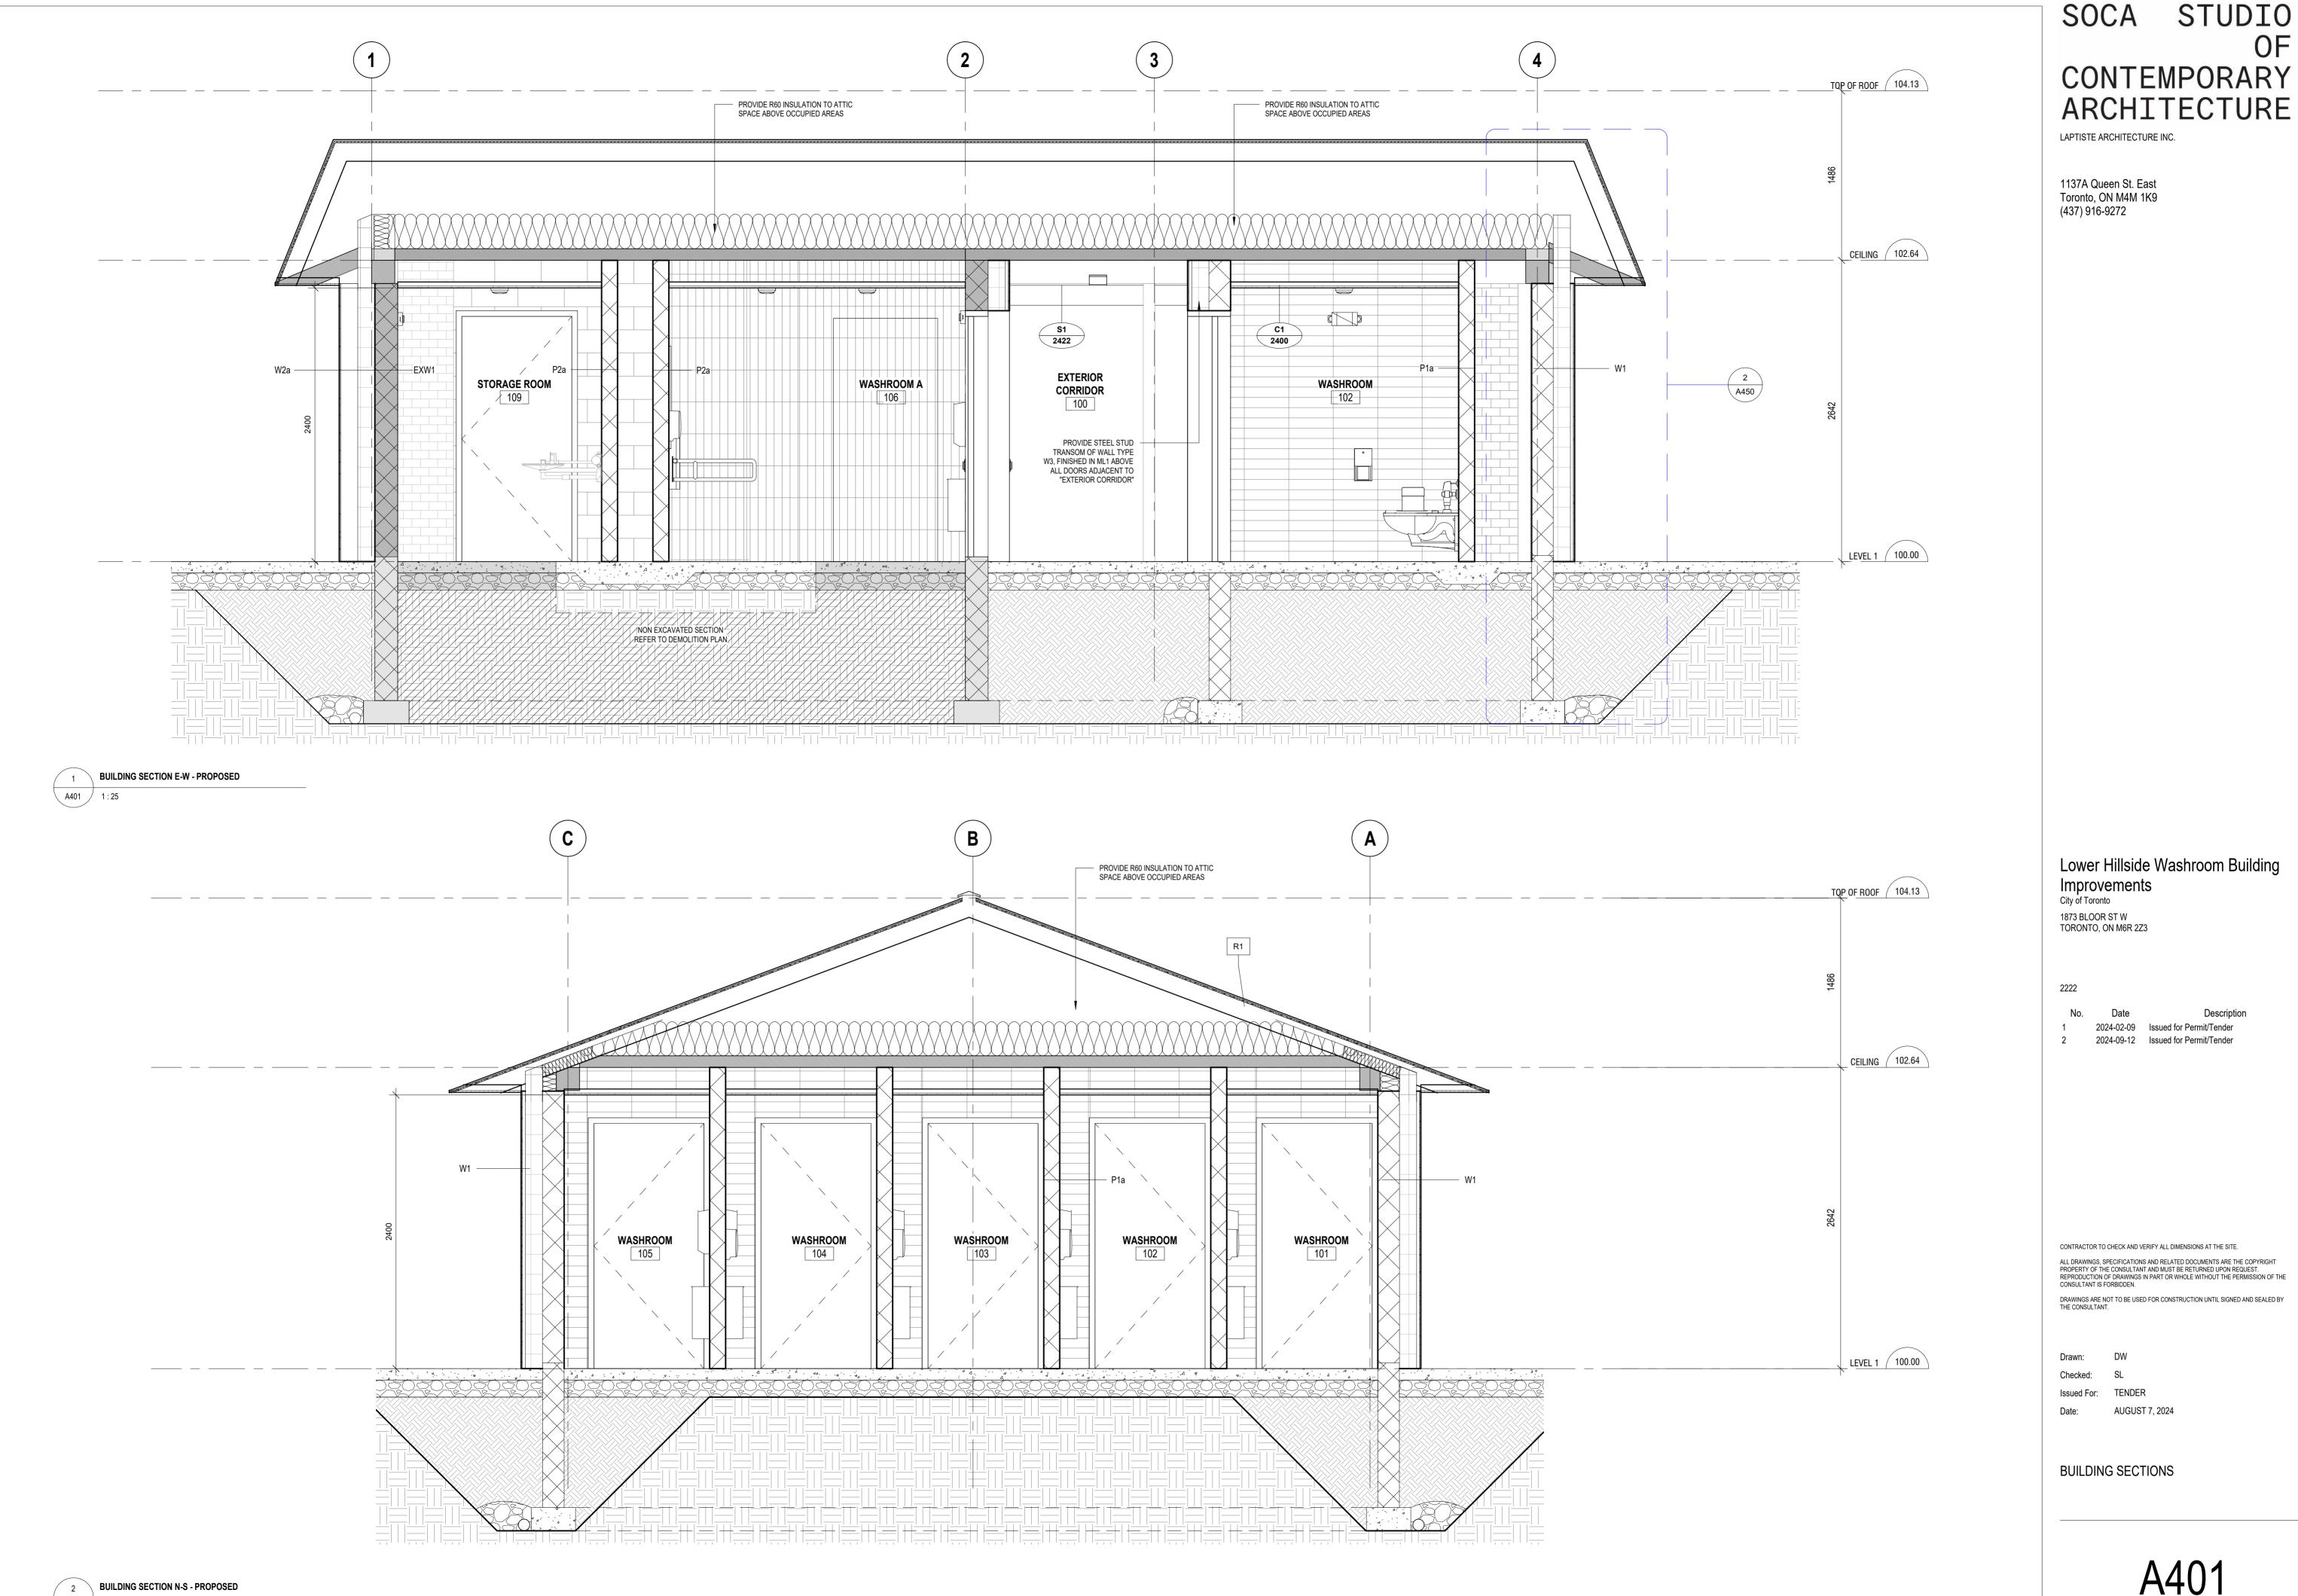

CONTEMPORARY ARCHITECTURE

Lower Hillside Washroom Building

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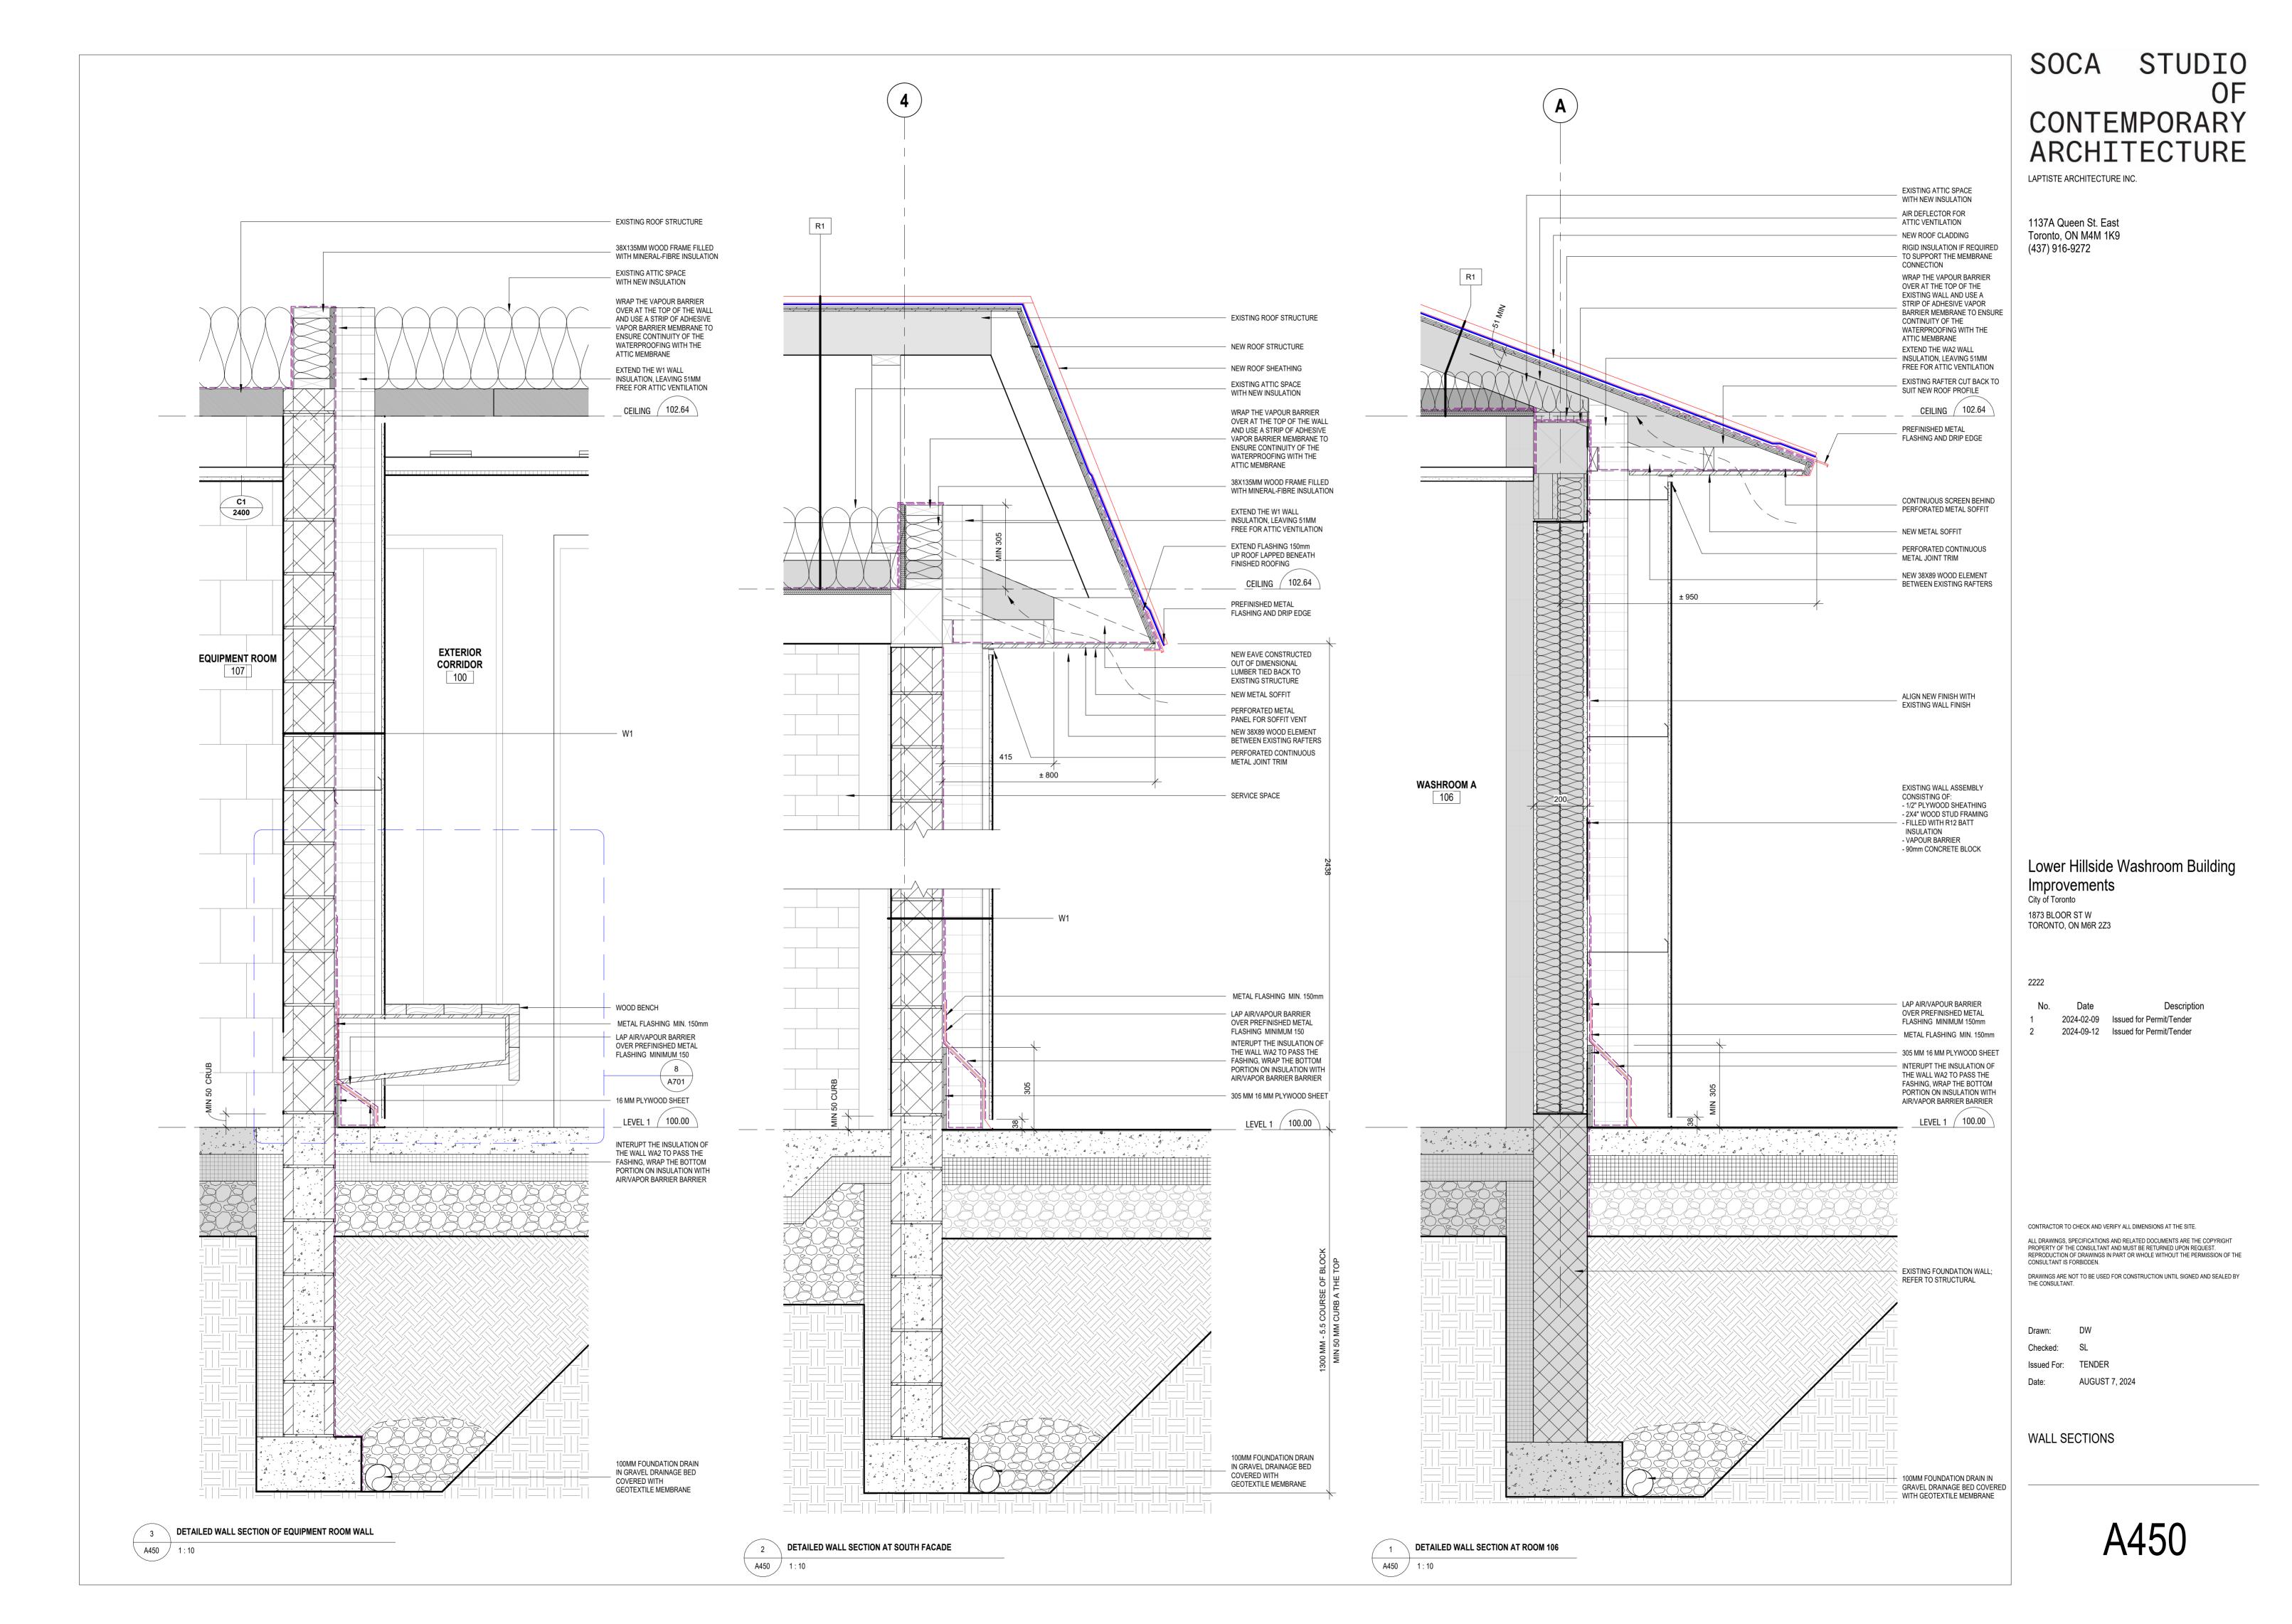
CONTEMPORARY ARCHITECTURE

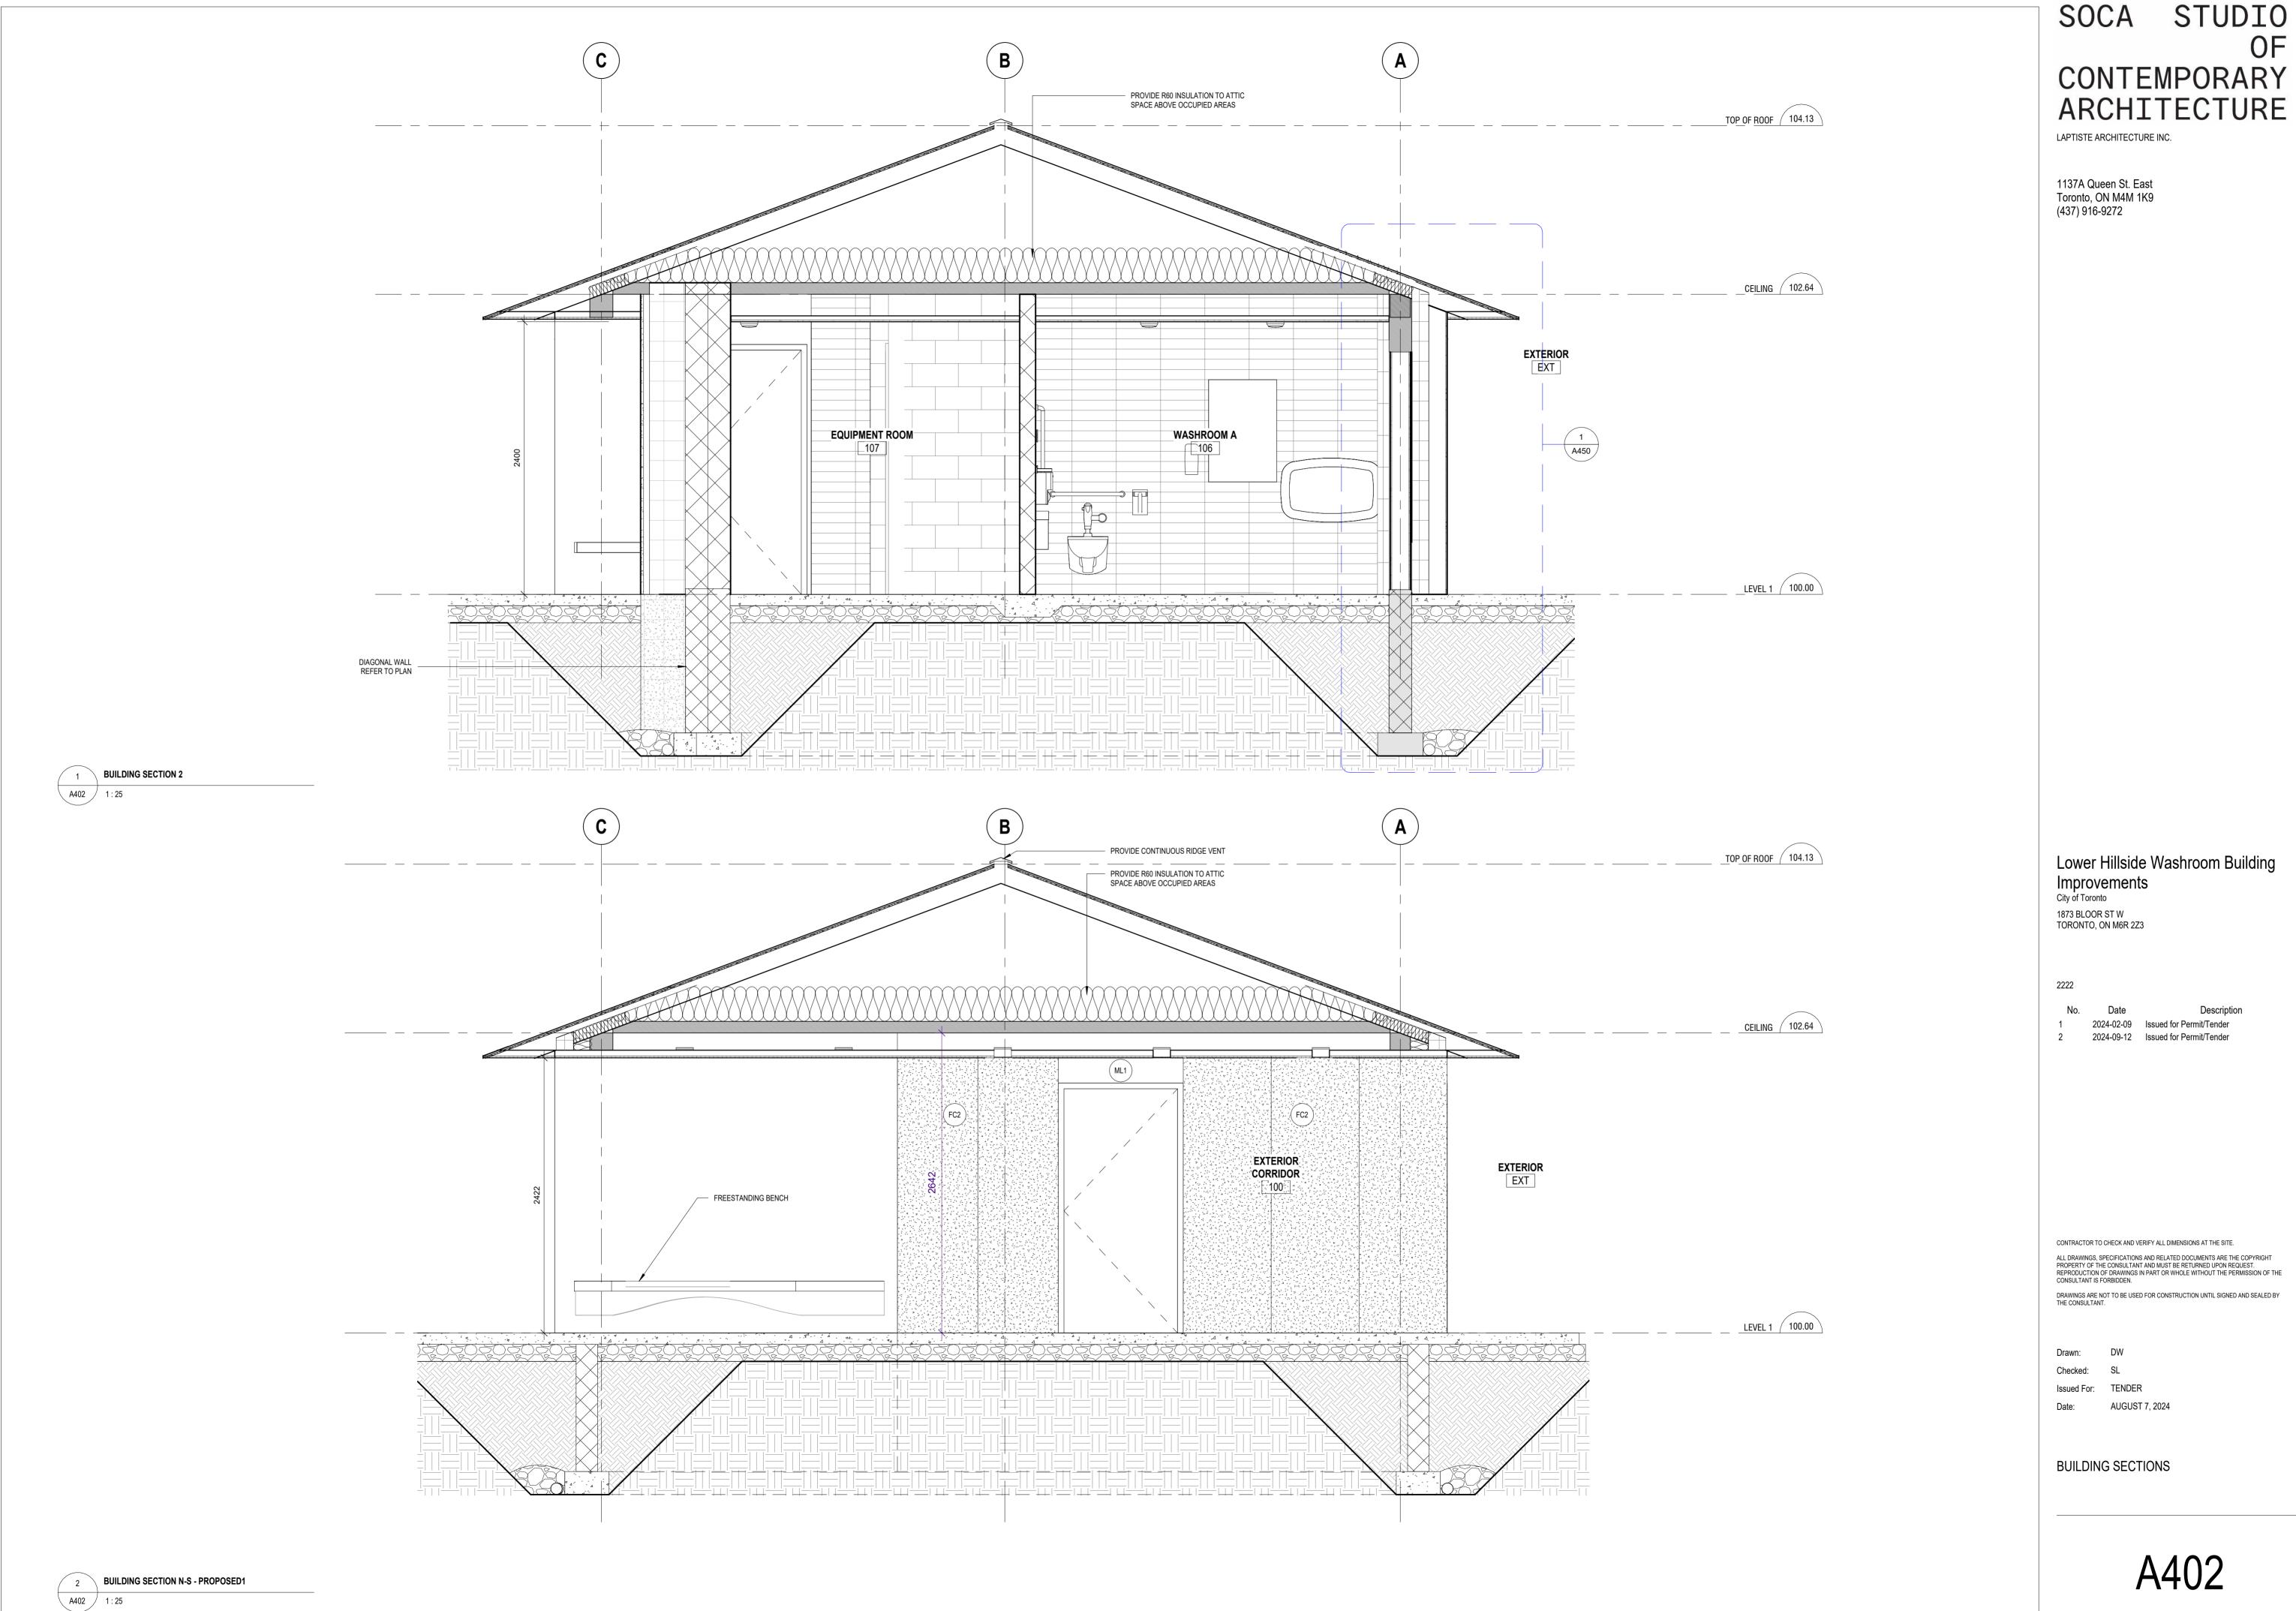
Lower Hillside Washroom Building

2024-02-09 Issued for Permit/Tender 2024-09-12 Issued for Permit/Tender

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SOCA STUDIO OF CONTEMPORARY ARCHITECTURE

LAPTISTE ARCHITECTURE INC.

1137A Queen St. East Toronto, ON M4M 1K9 (437) 916-9272

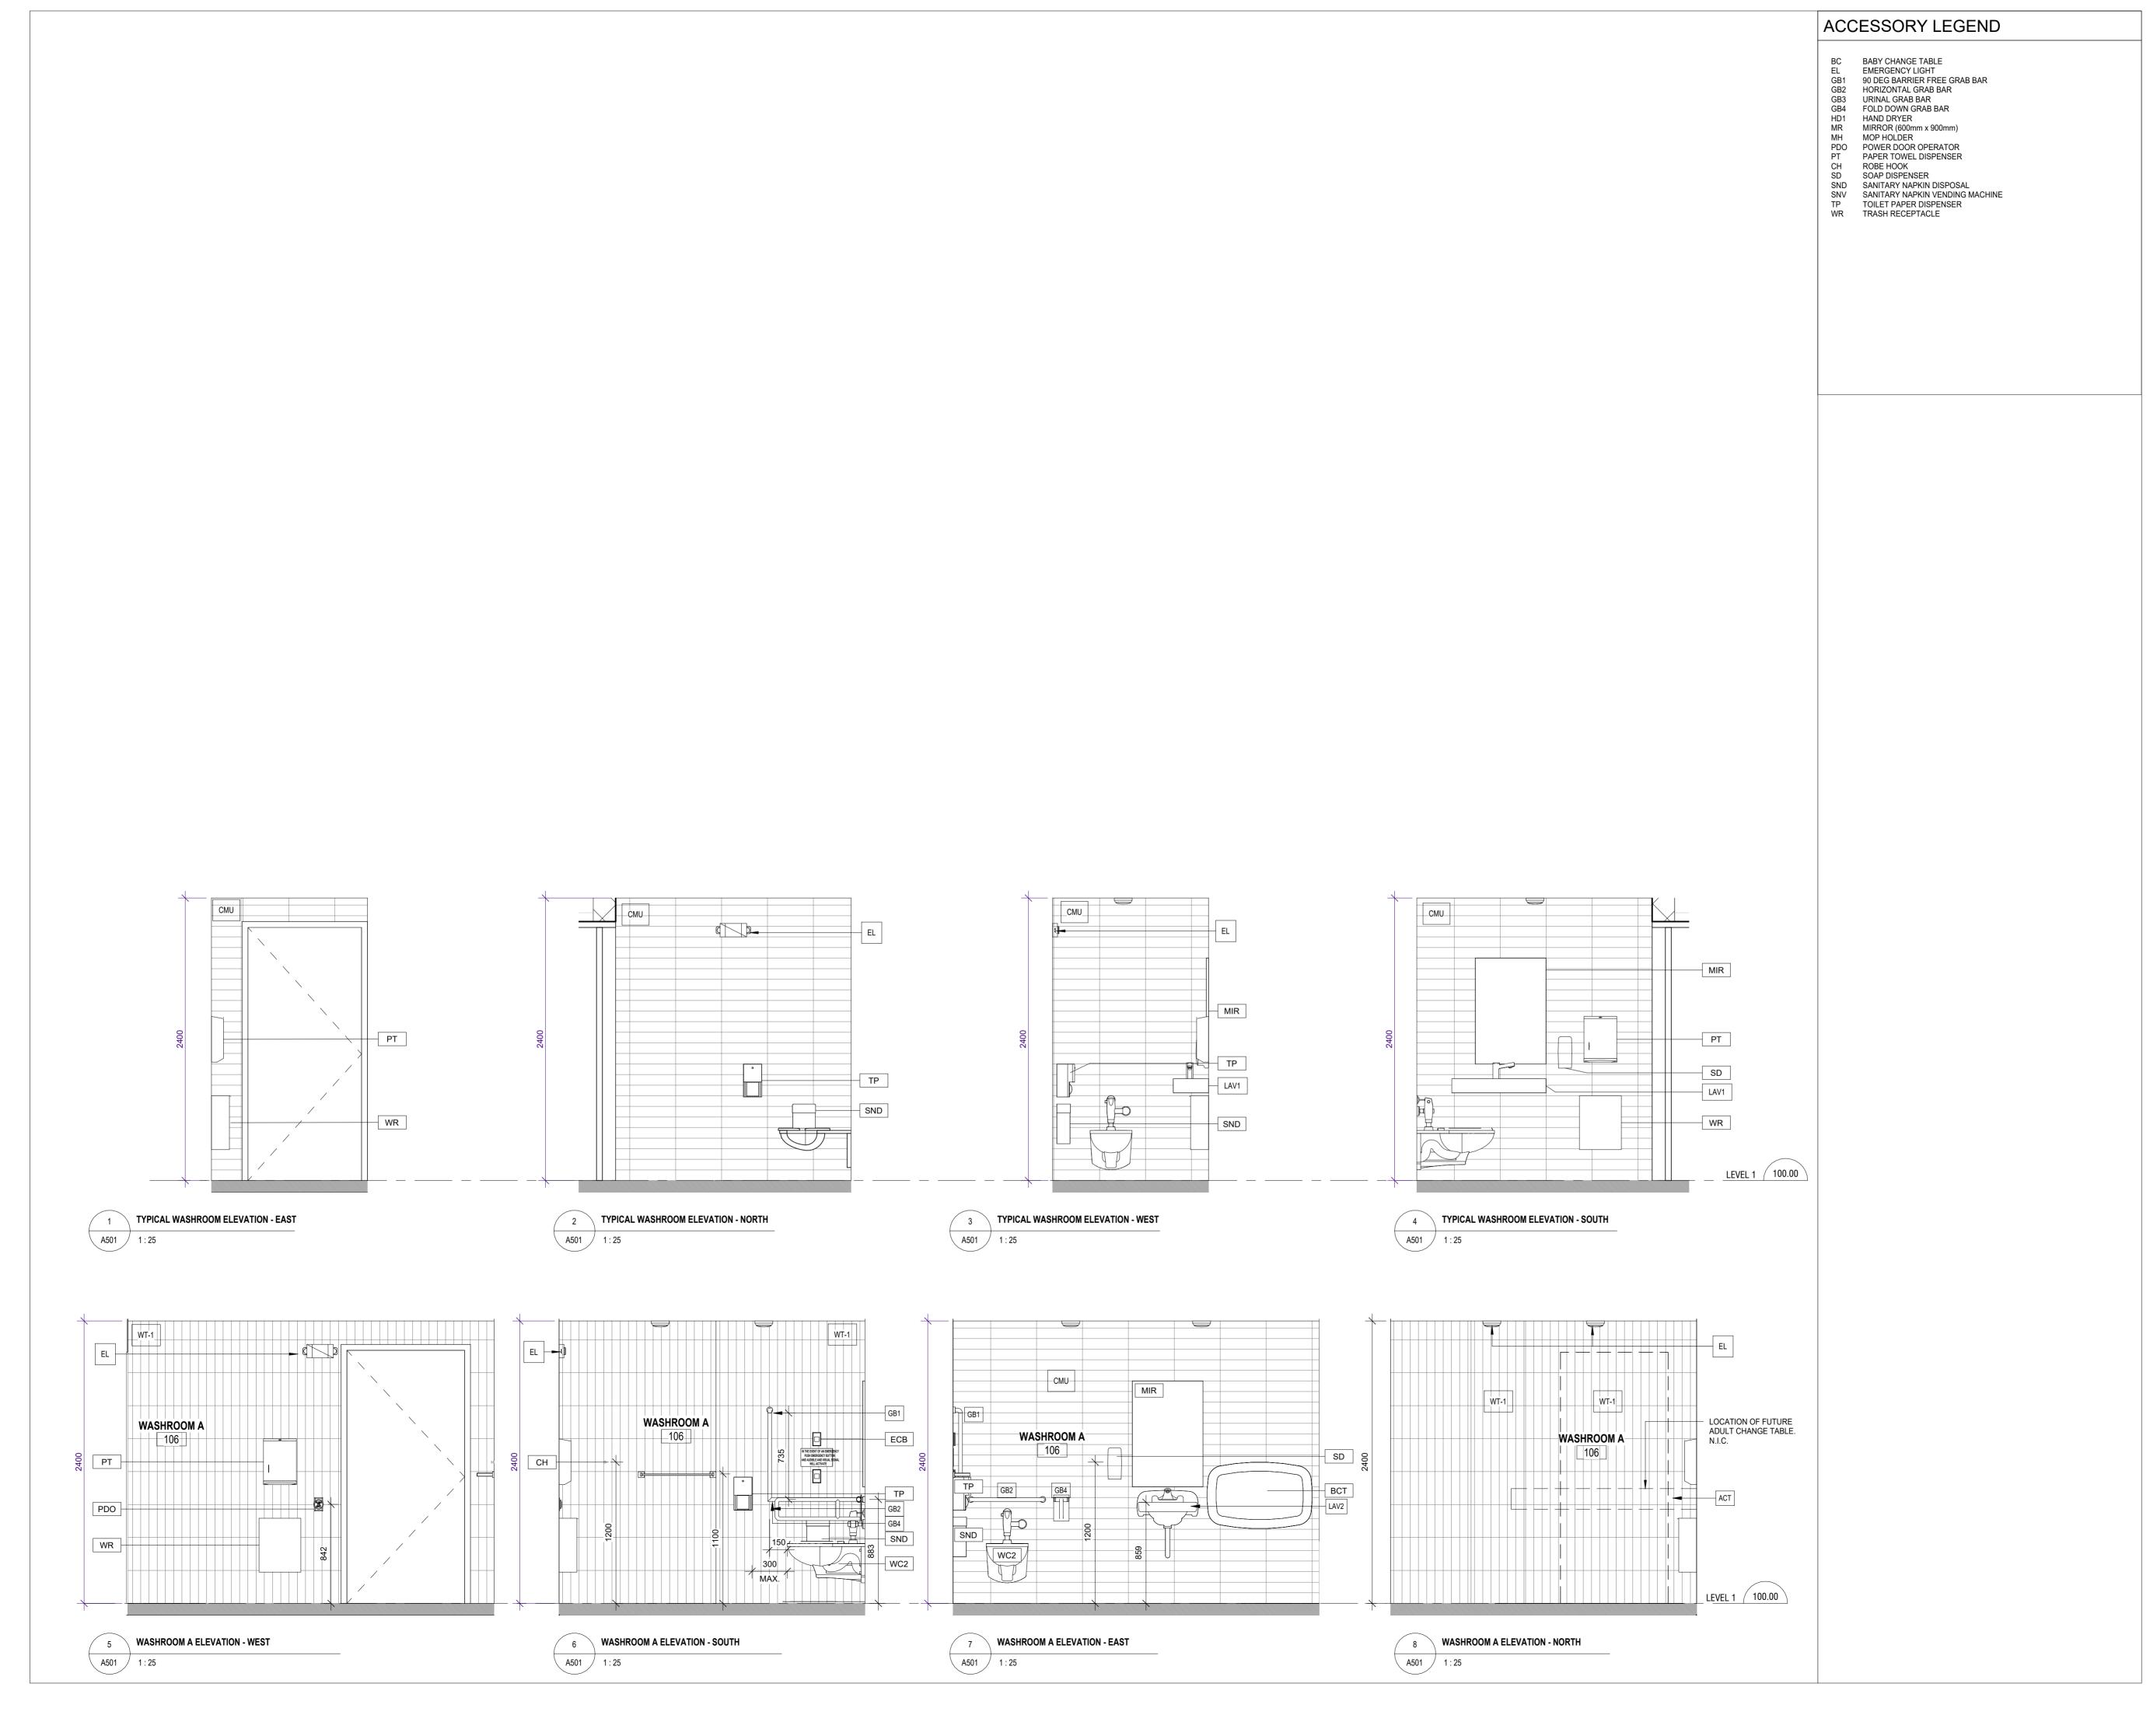Lower Hillside Washroom Building Improvements

City of Toronto 1873 BLOOR ST W TORONTO, ON M6R 2Z3

2222

No. Date Description

2024-02-09 Issued for Permit/Tender

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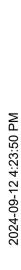
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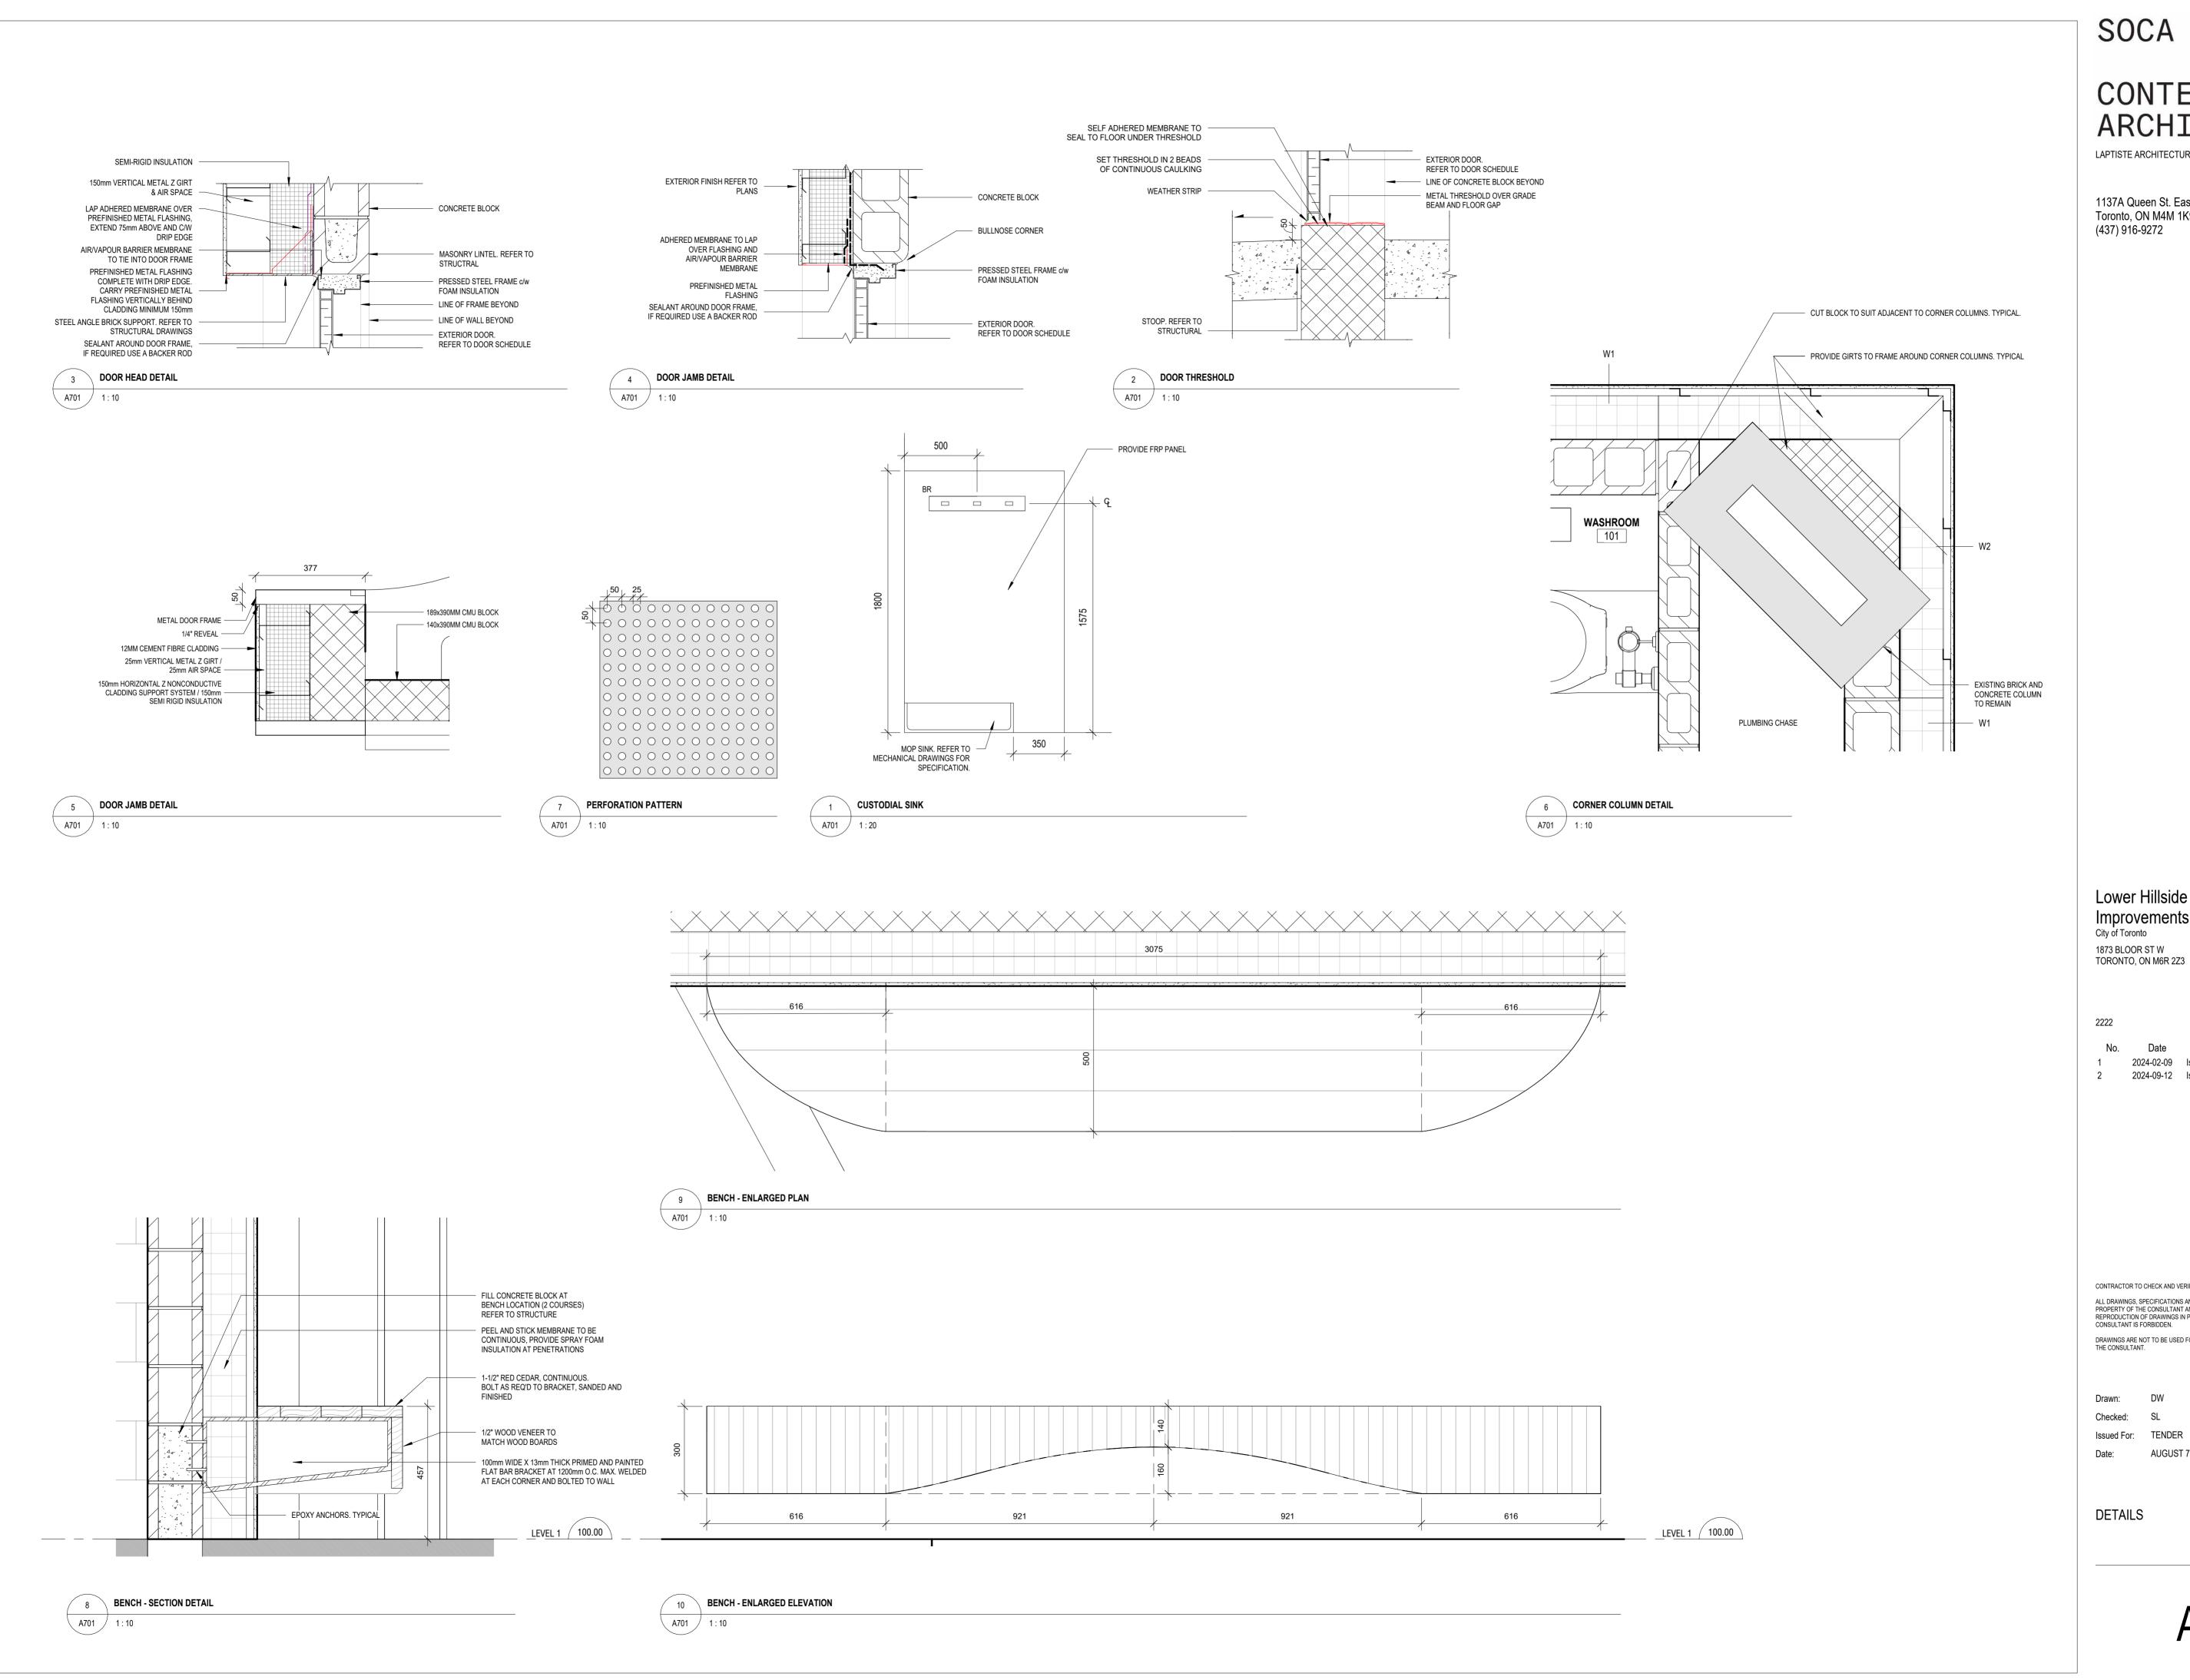
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INTERIOR ELEVATIONS

A50′





SOCA STUDIO CONTEMPORARY ARCHITECTURE

LAPTISTE ARCHITECTURE INC.

1137A Queen St. East Toronto, ON M4M 1K9

Lower Hillside Washroom Building Improvements

1873 BLOOR ST W

2024-02-09 Issued for Permit/Tender 2024-09-12 Issued for Permit/Tender

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Issued For: TENDER AUGUST 7, 2024

A701

1 PANEL LEGEND

A702 1 : 20

GENERAL NOTES

A. GENERAL INFORMATION

- 1. READ STRUCTURAL DOCUMENTS IN CONJUNCTION WITH CONTRACT DOCUMENTS, WHICH INCLUDE, BUT ARE NOT LIMITED TO, ARCHITECTURAL, MECHANICAL, AND ELECTRICAL DOCUMENTS.
- 2. CONTRACTOR TO BE RESPONSIBLE FOR CHECKING SITE CONDITIONS AGAINST DOCUMENTS, BEFORE PROCEEDING WITH THE WORK, AND REPORT DISCREPANCIES TO THE CONSULTANT.
- 3. CONTRACTOR TO PROVIDE LABOUR, MATERIALS, AND EQUIPMENT TO COMPLETE ALL STRUCTURAL WORK INDICATED.
- CARRY OUT CONSTRUCTION OPERATIONS, INCLUDING THE INSTALLATION OF TEMPORARY GUYING AND SHORING REQUIRED, ENSURING THAT THE EXISTING STRUCTURE OR MEMBERS ALREADY ERECTED ARE NOT LOADED IN EXCESS OF THEIR SAFE LOAD CARRYING CAPACITY.
- STRUCTURAL DOCUMENTS DO NOT NECESSARILY SHOW ALL OPENINGS AND SLAB VARIATIONS REQUIRED. THE CONTRACTOR SHALL REFER TO ARCHITECTURAL, MECHANICAL, AND ELECTRICAL DRAWINGS FOR THE EXACT LOCATION, NUMBER, AND SIZE OF OPENINGS, TRENCHES, PITS, SUMPS, SLEEVES, AND DEPRESSIONS. PROVIDE STRUCTURAL FRAMING AT THESE LOCATIONS IN ACCORDANCE WITH THE APPLICABLE TYPICAL DETAIL.

REFERENCE STANDARDS / CODES AND ACTS

CONFORM WITH THE 2012 BUILDING CODE (ONTARIO REGULATION 332/12, AMENDED BY ONTARIO REGULATION 867/21), AND ANY APPLICABLE ACTS OF ANY AUTHORITY HAVING JURISDICTION, AND THE FOLLOWING:

REF	CODE	TITLE
a)	CAN/CSA A23.1	CONCRETE MATERIALS AND METHODS OF CONCRETE CONSTRUCTION
b)	CAN/CSA A23.2	METHODS OF TEST FOR CONCRETE
c)	CAN/CSA A23.3	DESIGN OF CONCRETE STRUCTURES
d)	CAN/CSA-S16	LIMIT STATES DESIGN OF STEEL STRUCTURES
e)	CAN/CSA G40.20/G40.21	STRUCTURAL QUALITY STEEL
f)	RSIC	REINFORCING STEEL INSTITUTE OF CANADA (RSIC), MANUAL OF STANDARD PRACTICE
g)	O86	ENGINEERING DESIGN IN WOOD (LIMIT STATES DESIGN)
h)	CAN/CSA-A370	CONNECTORS FOR MASONRY
i)	CSA-A371	MASONRY CONSTRUCTION FOR BUILDINGS
j)	S304.1	DESIGN OF MASONRY STRUCTURES
k)	CSA G30.18	CARBON STEEL BARS FOR CONCRETE REINFORCING

- 2. ALL STANDARDS AND PUBLICATIONS REFERENCED BY THE STANDARDS NOTED ABOVE ARE TO APPLY.
- . WHERE THERE ARE DIFFERENCES BETWEEN THE DOCUMENTS AND THE STANDARDS, CODES AND ACTS, THE MOST STRINGENT SHALL GOVERN.

C. <u>SUBMITTALS</u>

1. SUBMIT FOR REVIEW BY THE VARIOUS CONSULTANTS, DETAILED INFORMATION FOR ALL TEMPORARY AND PERMANENT STRUCTURAL WORK. THIS INCLUDES. BUT IS NOT LIMITED TO:

ITEM	SUBMISSION REQUIRED	SUBMISSION TO BE SEALED BY PROFESSIONAL ENGINEER	COMMENTS
CONCRETE MIX DESIGNS	YES	NO	INCLUDE A BRIEF DESCRIPTION OF WHERE EACH MIX WILL BE USED

- 2. CONTRACTOR SHALL ALLOW FOR A TURN AROUND TIME OF FIVE WORKING DAYS FOR THE REVIEW OF THESE SUBMISSIONS.
- OUR REVIEW OF THE SHOP DRAWINGS IS ONLY FOR GENERAL CONFORMITY WITH STRUCTURAL CONTRACT DOCUMENTS AND SPECIFICATIONS. COMMENTS MADE ON THE SHOP DRAWINGS DURING THIS REVIEW DO NOT RELIEVE THE CONTRACTOR FROM COMPLIANCE WITH THE REQUIREMENTS OF THE STRUCTURAL CONTRACT DOCUMENTS AND SPECIFICATIONS, NOR DO THEY AUTHORIZE ANY CHANGES TO THE CONTRACT. REVIEW OF A SPECIFIC ITEM SHALL NOT INCLUDE REVIEW OF AN ASSEMBLY OF WHICH THE ITEM IS A COMPONENT. THE CONTRACTOR'S RESPONSIBILITIES INCLUDE ALL QUANTITIES, DETAIL DIMENSIONS, FIELD MEASUREMENTS, FABRICATION PROCESS, MEANS, METHODS, SEQUENCES, AND PROCEDURES OF CONSTRUCTION, COORDINATION OF WORK WITH ALL TRADES AND PERFORMING ALL WORK IN A SAFE AND SATISFACTORY MANNER. THE REVIEW OF SHOP DRAWINGS DOES NOT IMPLY ANY CHANGE IN ANY OTHER CONSULTANTS' OR PROFESSIONALS' RESPONSIBILITY RELATED TO DESIGN OF SPECIFIC ITEMS AS OUTLINED BY THE SPECIFICATIONS (SUCH AS STRUCTURAL STEEL CONNECTIONS, STEEL JOISTS, PRECAST ELEMENTS, ETC.). AFTER REVIEW, THE DRAWINGS WILL BE STAMPED AND RETURNED TO SHOW ONE OF THE FOLLOWING:

NOT REVIEWED SHOWS WORK WHICH IS NOT WITHIN THE SCOPE OF STRUCTURAL CONSULTING SERVICES.

REVIEWED NO DEVIATIONS FROM THE CONTRACT DOCUMENTS NOTED.

NOTED WE HAVE MADE COMMENTS, TO BE REVIEWED/INCORPORATED. SUBMIT RECORD PRINT.

RESUBMIT REVISE AND RESUBMIT FOR REVIEW.

. MATERIALS

PROVIDE ONLY NEW STRUCTURAL MATERIALS IN ACCORDANCE WITH THE REFERENCE STANDARDS AND THE FOLLOWING, UNLESS OTHERWISE NOTED.

1.1. CONCRETE:

STRUCTURAL ELEMENT AND EXPOSURE	EXPOSURE CLASS PER CSA A23.1	CONCRETE STRENGTH f'c (MPa)	SLUMP (mm)	MAX W/C RATIO	AIR CONTENT
FOOTING AND CAPS		25	80		
SLABS-ON-GRADE EXPOSED TO CHLORIDES AND FREEZING	C-2	32	60*	0.45	5% - 8%

TOLERANCE FOR SLUMP SHALL BE \pm 20 mm FOR SPECIFIED SLUMP LESS THAN 80 mm, AND \pm 30 mm FOR SPECIFIED SLUMP BETWEEN 80 mm AND 170 mm.

* SPECIAL CONCRETE HANDLING AND PLACING METHODS, OR THE USE OF A SUPER PLASTICIZER, WILL BE REQUIRED TO PLACE THIS CONCRETE. FINAL PLASTICIZED SLUMP SHALL BE ± 125 mm.

- 1.2. REINFORCING STEEL: CONFORM TO CSA G30 SERIES, GRADE 400.
- 1.3. WELDED WIRE FABRIC: CONFORM TO CSA G30 SERIES, GRADE 386, IN FLAT SHEETS.
- 1.4. STRUCTURAL STEEL:
 - 1.4.1. STRUCTURAL WIDE FLANGE AND WELDED WIDE FLANGE SHAPES (W, WWF) TO CONFORM TO CAN/CSA G40.20/G40.21 GRADE 350W.
 - 1.4.2. ANGLES (L), CHANNELS (C), AND PLATES TO CONFORM TO CAN/CSA-G40.20/G40.21 GRADE 300W.
 - 1.4.3. HOLLOW STRUCTURAL SECTIONS (HSS) TO CONFORM TO ASTM A500 GRADE C.
- 1.5. PRIME PAINT: CONFORM TO CISC/CPMA STANDARD 2-75.
- 1.6. STRUCTURAL BOLTS, NUTS, AND WASHERS: CONFORM TO ASTM A325M.
- 1.7. NON-SHRINK GROUT = COMPRESSIVE STRENGTH OF 35 MPa AT 24 HOURS.
- 1.8. BLOCK: CONFORM TO CAN3-A165 SERIES, MINIMUM COMPRESSIVE STRENGTH = 15.0 MPa (MIN) BASED ON NET AREA.
- 1.9. MORTAR: CONFORM TO CSA A179 TYPE S FOR LOADBEARING WALLS UNLESS NOTED.
- 1.10. MASONRY GROUT: CONFORM TO CSA A179, 15 MPa MINIMUM COMPRESSIVE STRENGTH AT 28 DAYS, 250 mm (10") SLUMP, MAXIMUM AGGREGATE SIZE 10 mm (3/8").
- 1.11. SAWN LUMBER: SPRUCE-PINE-FIR (SPF), No. 2 GRADE OR BETTER UNLESS NOTED ON DRAWINGS. CONFORM TO CSA 0141.
- 1.12. POST-INSTALLED ANCHORS: PROVIDED BY HILTI (CANADA) CORPORATION. CONTACT HILTI AT (800) 363-4458 FOR PRODUCT RELATED QUESTIONS.

E. EXECUTION

1. FOUNDATIONS

- 1.1. FOUND ALL FOOTINGS (AND UNDERPINNING) ON SOIL CAPABLE OF SUSTAINING A MINIMUM ULTIMATE LIMIT STATES / SERVICE LIMIT STATES BEARING STRESS (ULS / SLS) OF 100 kPa (2,100 psf) / 225 kPa (4,700 psf).
- 1.2. FOUND ALL FOOTINGS WHICH WILL BE EXPOSED TO FROST ACTION IN THE COMPLETED BUILDING A MINIMUM OF 1200 mm (4'-0") BELOW FINISHED GRADE.
- 1.3. DO NOT EXCEED A RISE OF 7 IN A RUN OF 10 IN THE LINE OF SLOPE BETWEEN ADJACENT FOOTING EXCAVATIONS OR ALONG STEPPED FOOTINGS. FOR STEPPED FOOTINGS, USE STEPS NOT EXCEEDING 600 mm (2'-0") IN HEIGHT AND 1200 mm (4'-0") (MIN) IN LENGTH.
- 1.4. SOIL BEARING CAPACITY SPECIFIED MUST BE VERIFIED BY THE SOIL ENGINEER PRIOR TO THE PLACING OF FOOTINGS AND ANY NON-CONFORMANCE WITH THE SPECIFIED MINIMUM CAPACITIES MUST BE IMMEDIATELY REPORTED TO THE STRUCTURAL ENGINEERS.

2. SLAB ON GRADE

- 2.1. PLACE SLAB-ON-GRADE ON SUB-GRADE MATERIAL CAPABLE OF SUSTAINING A MINIMUM BEARING CAPACITY OF 25 kPa (500 psf) WITHOUT SETTLEMENT RELATIVE TO THE BUILDING FOOTINGS.
- 2.2. UNLESS OTHERWISE NOTED, PROVIDE IMMEDIATELY UNDER SLABS-ON-GRADE A MINIMUM OF 200 mm (8") OF COMPACTED (MTC) GRANULAR 'B' MATERIAL. COMPACTION TO ACHIEVE A MINIMUM OF 98% STANDARD PROCTOR MAXIMUM DRY DENSITY.

3. CONCRETE

3.1. WHEN ATMOSPHERIC TEMPERATURE IS AT OR BELOW 5°C, OR WHEN THERE IS A POSSIBILITY OF IT FALLING TO THAT LIMIT, PLACE CONCRETE IN ACCORDANCE WITH THE REQUIREMENTS OF CAN/CSA A23.1 "COLD WEATHER CONCRETING" AND ACI 306 "RECOMMENDED PRACTICE FOR COLD WEATHER CONCRETING". WHEN ATMOSPHERIC TEMPERATURE IS AT OR ABOVE 27° C, PLACE CONCRETE IN ACCORDANCE WITH CAN/CSA A23.1 "HOT WEATHER CONCRETING" AND ACI 305 "RECOMMENDED PRACTICES FOR HOT WEATHER CONCRETING".

4. STRUCTURAL STEEL

- 4.1. PAINT ALL STRUCTURAL STEEL TO REQUIREMENTS OF CISC/CPMA 2-75. TOUCH UP ALL FIELD WELDS.
- 4.2. ALL STRUCTURAL STEEL EXPOSED TO WEATHER SHALL BE GALVANIZED IN ACCORDANCE WITH CSA G164.
- 4.3. ALL WELDS SHALL CONFORM TO CSA STANDARD W59.
- 4.4. ALL WELDS EXPOSED TO VIEW SHALL BE GROUND SMOOTH.
- 4.5. ANY ORGANIZATION UNDERTAKING TO WELD UNDER THIS CONTRACT SHALL BE CERTIFIED BY THE CANADIAN WELDING BUREAU UNDER REQUIREMENTS OF DIVISION 1 OR DIVISION 2.1 OF W47.1.
- 4.6. DO NOT SPLICE STRUCTURAL STEEL SECTIONS WITHOUT PRIOR APPROVAL OF THE CONSULTANT. ALL SPLICES SHALL DEVELOP THE FULL CAPACITY OF THE SECTION AND ARE TO BE TESTED BY NON DESTRUCTIVE METHODS, BY AN INDEPENDENT INSPECTION AND TESTING COMPANY, AT THE CONTRACTOR'S EXPENSE.
- 4.7. SEE ARCHITECTURAL DRAWINGS FOR FIREPROOFING REQUIREMENTS. CONFIRM COMPATIBILITY OF FIREPROOFING MATERIAL WITH STEEL PAINT.

MASONRY

- 5.1. PROVIDE A MINIMUM LENGTH OF 200 mm (8") OF 100% SOLID MASONRY UNITS FOR BEARING OF STEEL, CONCRETE OR REINFORCED MASONRY LINTELS.
- 5.2. SUPPLY AND PLACE REINFORCEMENT AND CONCRETE FOR REINFORCED MASONRY LINTELS IN ACCORDANCE WITH TYPICAL DETAILS SHOWN.
- 5.3. FOR THE PURPOSE OF DETERMINING THE REQUIRED REINFORCING FOR LOAD-BEARING AND NON-LOAD-BEARING MASONRY WALLS THE SEISMIC HAZARD INDEX IEFASA(0.2) = XXXXXX. REFER TO TYPICAL DETAILS FOR REINFORCING REQUIREMENTS.

6. POST-INSTALLED ANCHORS

- 6.1. INSTALL ANCHORS PER THE MANUFACTURER INSTRUCTIONS, AS INCLUDED IN THE ANCHOR PACKAGING.
- 6.2. THE CONTRACTOR SHALL ARRANGE AN ANCHOR MANUFACTURER'S REPRESENTATIVE TO PROVIDE ONSITE INSTALLATION TRAINING FOR ALL OF THEIR ANCHORING PRODUCTS SPECIFIED. THE STRUCTURAL ENGINEER OF RECORD MUST RECEIVE DOCUMENTED CONFIRMATION THAT ALL OF THE CONTRACTOR'S PERSONNEL WHO INSTALL ANCHORS ARE TRAINED PRIOR TO THE COMMENCEMENT OF INSTALLING ANCHORS.
- 7. ALTERATIONS AND/OR CONNECTIONS TO EXISTING STRUCTURE
 - 7.1. INSPECT THE EXISTING BUILDING AND BECOME THOROUGHLY FAMILIAR WITH THE EXISTING CONDITIONS.
 - 7.2. MAKE GOOD THE EXISTING WORK.

QUALITY CONTROL

1. GENERAL

- 1.1. IMPLEMENT A SYSTEM OF QUALITY CONTROL TO ENSURE THAT THE MINIMUM STANDARDS SPECIFIED HEREIN ARE ATTAINED.
- 1.2. BRING TO THE ATTENTION OF THE CONSULTANT ANY DEFECTS IN THE WORK OR DEPARTURES FROM THE CONTRACT DOCUMENTS, WHICH MAY OCCUR DURING CONSTRUCTION. THE CONSULTANT WILL DECIDE UPON CORRECTIVE ACTION AND GIVE RECOMMENDATIONS IN WRITING.
- 1.3. THE CONSULTANT'S GENERAL REVIEW DURING CONSTRUCTION AND INSPECTION AND TESTING BY INDEPENDENT INSPECTION AND TESTING AGENCIES REPORTING TO THE CONSULTANT ARE BOTH UNDERTAKEN TO INFORM THE OWNER / CLIENT OF THE CONTRACTOR'S PERFORMANCE AND SHALL IN NO WAY AUGMENT THE CONTRACTOR'S QUALITY CONTROL OR RELIEVE THE CONTRACTOR OF CONTRACTUAL RESPONSIBILITY.

2. NOTIFICATION

PRIOR TO COMMENCING SIGNIFICANT SEGMENTS OF THE WORK, GIVE THE CONSULTANT AND INDEPENDENT INSPECTION AND TESTING COMPANIES APPROPRIATE NOTIFICATION (MINIMUM 24 HOURS) SO AS TO AFFORD THEM REASONABLE OPPORTUNITY TO REVIEW THE WORK. FAILURE TO MEET THIS REQUIREMENT MAY BE CAUSE FOR THE CONSULTANT TO CLASSIFY THE WORK AS DEFECTIVE.

3. INSPECTION AND TESTING

- 3.1. AN INDEPENDENT INSPECTION AND TESTING COMPANY SHALL MAKE INSPECTIONS OR PERFORM TESTS AS THE CONSULTANT DIRECTS. THE INDEPENDENT INSPECTION AND TESTING COMPANIES SHALL BE RESPONSIBLE ONLY TO THE CONSULTANT AND SHALL MAKE ONLY SUCH INSPECTIONS OR TESTS AS THE CONSULTANT MAY DIRECT.
- 3.2. THE FOLLOWING ITEMS REQUIRE TESTING AND/OR INSPECTION BY A CERTIFIED, INDEPENDENT INSPECTION AND TESTING COMPANY UNLESS OTHERWISE NOTED. THE TESTING FIRM SHALL SUBMIT COPIES OF ALL STRUCTURAL TESTING AND INSPECTION REPORTS TO THE CONSULTANT FOR REVIEW:

ITEM	REQUIRED	COMMENTS
SOIL BEARING CAPACITY	YES	BY GEOTECHNICAL CONSULTANT

4. DEFECTIVE MATERIALS AND WORK

- 4.1. WHERE EVIDENCE EXISTS THAT DEFECTIVE WORK HAS OCCURRED OR THAT WORK HAS BEEN CARRIED OUT INCORPORATING DEFECTIVE MATERIALS, THE CONSULTANT MAY HAVE TESTS, INSPECTIONS OR SURVEYS PERFORMED, ANALYTICAL CALCULATIONS OF STRUCTURAL STRENGTH MADE, AND THE LIKE, IN ORDER TO HELP DETERMINE WHETHER THE WORK MUST BE CORRECTED OR REPLACED. TESTS, INSPECTIONS OR SURVEYS OR CALCULATIONS CARRIED OUT UNDER THESE CIRCUMSTANCES WILL BE MADE AT THE CONTRACTOR'S EXPENSE, REGARDLESS OF THEIR RESULTS, WHICH MAY BE SUCH THAT, IN THE CONSULTANT'S OPINION, THE WORK MAY BE ACCEPTABLE.
- 4.2. ALL TESTING SHALL BE CONDUCTED IN ACCORDANCE WITH THE REQUIREMENTS OF THE 2012 BUILDING CODE (ONTARIO REGULATION 332/12), EXCEPT WHERE THIS WOULD, IN THE CONSULTANT'S OPINION, CAUSE UNDUE DELAY OR GIVE RESULTS NOT REPRESENTATIVE OF THE REJECTED MATERIAL IN PLACE. IN THIS CASE, THE TESTS SHALL BE CONDUCTED IN ACCORDANCE WITH THE STANDARDS GIVEN BY THE CONSULTANT.
- 4.3. MATERIALS OR WORK, WHICH FAIL TO MEET SPECIFIED REQUIREMENTS, MAY BE REJECTED BY THE CONSULTANT WHENEVER FOUND AT ANY TIME PRIOR TO FINAL ACCEPTANCE OF THE WORK REGARDLESS OF PREVIOUS INSPECTION. IF REJECTED, DEFECTIVE MATERIALS OR WORK SHALL BE PROMPTLY REMOVED AND REPLACED OR REPAIRED TO THE SATISFACTION OF THE CONSULTANT, AT NO EXPENSE TO THE OWNER.



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Project No. 24-2107

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Professional Seal



No.	Revision Description	YYYY-MM-DD
1	ISSUED FOR PERMIT	2024 - 02 - 08
2	ISSUED FOR TENDER	2024 - 08 - 07

Project Title:

PARK WASHROOM RENOVATION

LIST OF STRUCTURAL DRAWINGS

SHEET No.	SHEET TITLE
S1.1	GENERAL NOTES
S1.2	TYPICAL DETAILS
S1.3	TYPICAL DETAILS
S1.4	TYPICAL DETAILS
S2.1	FOUNDATION PLAN
S2.2	ROOF FRAMING PLAN
S4.1	SECTIONS AND DETAILS

1873 BLOOR STREET WEST, TORONTO, ON

Designed by:

STB

Scale:

N/A

Drawn by:

AQV

Date:

MAY 29, 2024


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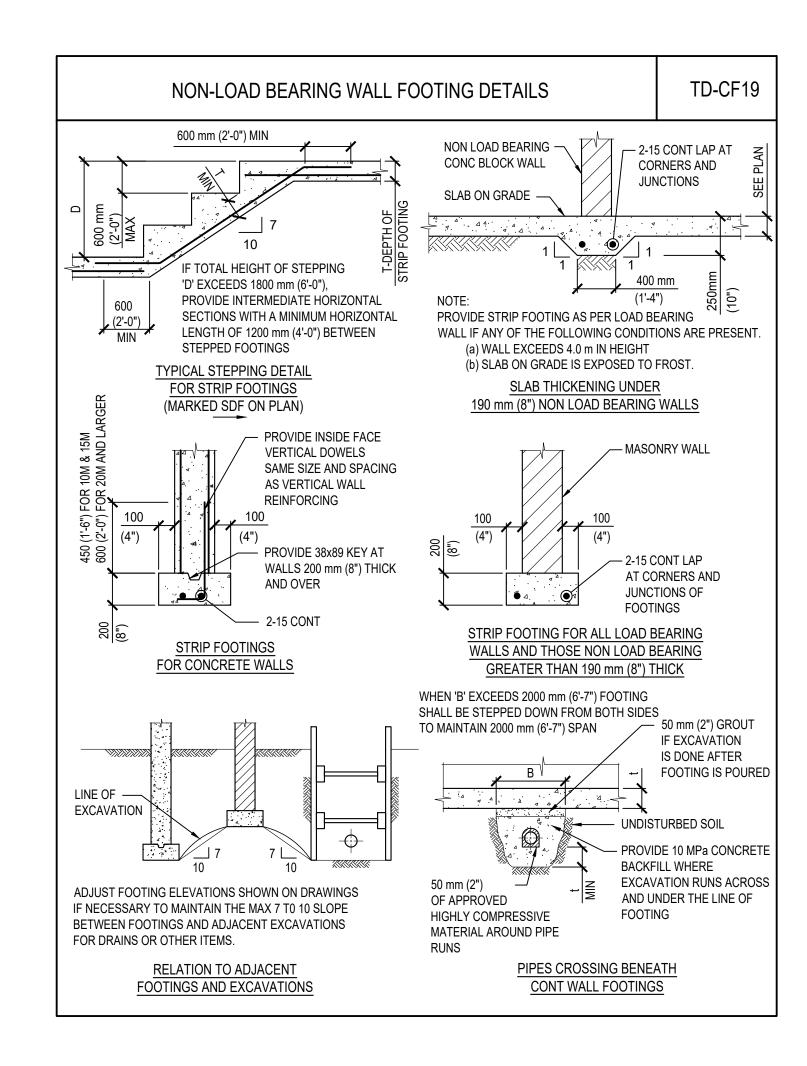
GENERAL NOTES

Sheet Number


S1.1


	STRUC	TURAL A	ABBREVIATIONS			TD-G01
A BOLT	ANCHOR BOLT	fc	28 DAYS CONCRETE	OF	OUTSIDE FA	CE
ADJ	ADJUSTABLE		COMPRESSIVE STRENGTH	OPEN	OPENING	
AFF	ABOVE FINISHED FLOOR	FDN	FOUNDATION	OWSJ	OPEN WEB S	
AIFB	ASPHALT IMPREGNATED	FF	FAR FACE	Pf		E (FACTORED)
A1 T	FIBREBOARD	FIN FL	FINISHED	PC	PRECAST	
ALT ARCH	ALTERNATE ARCHITECTURAL	ft	FLOOR FOOT, FEET	PL PLF	PLATE	R LINEAR FOOT
ASL	ADDITIONAL ACCUMULATED	ιι FTG	FOOTING	PROJ	PROJECTION	
AOL	SNOW LOAD	Fig	YIELD STRENGTH	psf		N R SQUARE FOOT
@	AT	GA	GAUGE	PT	PRESSURE 1	
B, BOTT	ВОТТОМ	GALV	GALVANIZED	RD	ROOF DRAIN	
B/B	BACK TO BACK	GEN	GENERAL	Rf	REACTION (F	
BEW	BOTTOM EACH WAY	HEF	HORIZONTAL EACH FACE	RAD	RADIUS `	,
BH	BOREHOLE	Hf	HORIZONTAL FORCE (FACTORED)	REINF	REINFORCED	, REINFORCEMENT
BLL	BOTTOM LOWER LAYER	HH	HOOK EACH END	REF	REFERENCE	
BLDG	BUILDING	HIF	HORIZONTAL INSIDE FACE	RE	RIGHT END	
BM	BEAM	HOF	HORIZONTAL OUTSIDE FACE	REQ'D	REQUIRED	
BPL	BEARING/BASE PLATE	H, HORZ	HORIZONTAL	REV	REVISION, R	
BRDG	BRIDGING	HSC	HORIZONTALLY SLOTTED CONNECTION	R/W	REINFORCE	
BUL	BOTTOM UPPER LAYER	HSS	HOLLOW STEEL SECTION	SAD		ECTURAL DRAWINGS
c C	CAMBER	IF IN	INSIDE FACE	SDF	STEP DOWN SECTION	FOOTING
c/c, o/c	EPOXY COATED CENTRE TO CENTRE	INT	INCH(ES) INTERIOR	SECT SIM	SIMILAR	
C/C, 0/C	COLUMN ABOVE	JT	JOINT	SL	SLAB	
CB	COLUMN BELOW	K	KIP, 1000 LBS	SOG	SLAB ON GR	ADE
CANT	CANTILEVER	K-ft	KIP FEET	SPDD		OCTOR DRY DENSITY
Cf	COMPRESSIVE FORCE (FACTORED)	kg	KILOGRAM(S)	ST	STRAIGHT	OOTON BILLION
CJ	CONTROL JOINT	KLF	KIPS PER LINEAR FOOT	STIFF	STIFFENER	
Q.	CENTRELINE	kN	KILONEWTON	STIR	STIRRUP	
COL	COLUMN	kN-m	KILONEWTON METRE	STRUCT	STRUCTURA	.L
COMP	COMPOSITE	kN/m	KILONEWTON PER METRE	STD	STANDARD	
CONC	CONCRETE	kPa	KILOPASCAL	SQ	SQUARE	
CONT	CONTINUOUS	KSF	KIPS PER SQUARED FOOT	T	TOP	
C/W	COMPLETE WITH	KSI	KIPS PER SQUARED INCH	Tf		RCE (FACTORED)
DEMO	DEMOLITION	L 	SINGLE ANGLE	TEMP		, TEMPERATURE
DET	DETAIL	LE	LEFT END	TEW	TOP EACH W	VAY
DIA, Ø DIAG	DIAMETER DIAGONAL	LG LL	LONG LIVE LOAD, LOWER LAYER	TJ TLL	TIE JOIST TOP LOWER	LAVED
DIAG	DIMENSION	LLH	LONG LEG HORIZONTAL	TMf		OMENT (FACTORED)
DL	DEAD LOAD	LLV	LONG LEG VERTICAL	TOD	TOP OF DEC	,
DP	DEEP	m	METRE	TOS	TOP OF STE	
DWG(S)	DRAWING(S)	MC >	MOMENT CONNECTION	TRANS	TRANSVERS	
DWL(S)	DOWEL(S)	•	(FULL MOMENT UNLESS NOTED)	TUL	TOP UPPER	
DN `´	DOWN	MECH	MECHANICAL	TYP	TYPICAL	
EA	EACH	Mf	MOMENT (FACTORED)	UL	UPPER LAYE	ER .
EE	EACH END	ML	MIDDLE LAYER	U/N		TED OTHERWISE
EF	EACH FACE	mm	MILLIMETRE	U/S	UNDERSIDE	
ELEC	ELECTRICAL	MPa	MEGAPASCAL	V, VERT	VERTICAL	
ELEV	ELEVATION	Mxf	BENDING MOMENT	Vf		AR FORCE (FACTORED)
ELEV	ELEVATOR	N As of	ABOUT x-x AXIS (FACTORED)	VBF		RACED FRAME
EMBED	EMBEDMENT	Myf	BENDING MOMENT	VEF	VERTICAL E	
EQ ES	EQUAL EACH SIDE	NF	ABOUT y-y AXIS (FACTORED) NEAR FACE	VIF VOF	VERTICAL IN	
EX, EXIST	EXISTING	NF NIC	NOT IN CONTRACT	VOF VSC		UTSIDE FACE SLOTTED CONNECTION
EJ, EXP JT	EXPANSION JOINT	N-S	NORTH-SOUTH	W	WIDE FLANG	
E-W	EAST WEST	NTS	NOT TO SCALE	WT		RUCTURAL TEE
EW	EACH WAY			WWF		BRIC OR WELDED WIDE FLANGE
EXT	EXTERIOR			W.P.	WORKING POI	



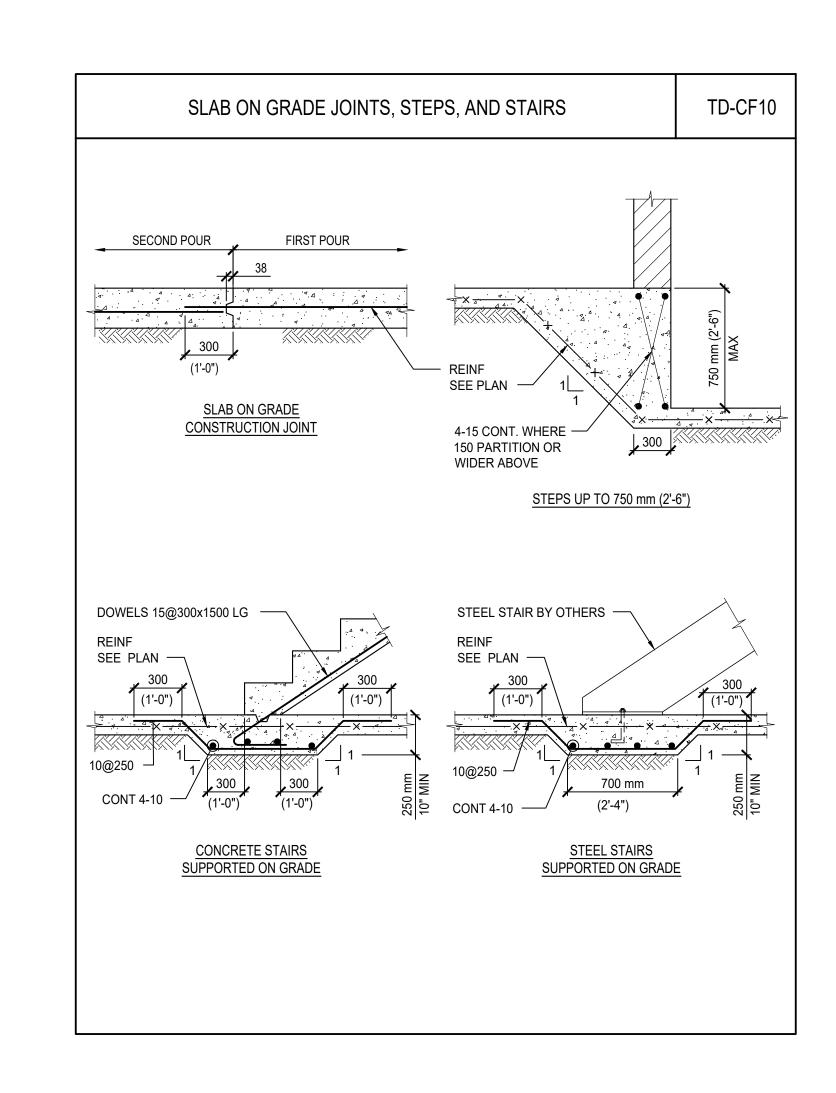

SLAB ON GRADE TRENCH INF	LL AT NEW UND	DERSLAB SERVICES	TD-CF2
NEW SLAB ON GRADE, MATCH EXISTING SLAB THICKNESS 100 mm (4") EMBED PROVIDE DOWELS 250 mm (10") LG @ 600 mm (2'-0") c/c (STAGGERED). DRILL AND EPOXY INTO EXISTING SLAB EDGE.		IF WIDTH OF TRENCH G 600 mm (2'-0") PROVIDE 152x152 MW 18.7x18.7 F MESH 2" FROM TOP OF CONCRETE BRICK SUP REQUIRED TO SUPPOR EXISTING 100 mm (4") SLAB ON GRADE NEW MECHANICAL SERVICE BACKFILL TRENCH V COMPACTED GRAN MATERIAL	1 - LAYER WWF REINF. LOCATE SLAB. PROVIDE PORT AS T MESH.
FOR LOCATION A 2. PRIOR TO CUTTIN	ND EXTENT OF NEW UND	HE CONTRACTOR SHALL SCAN	

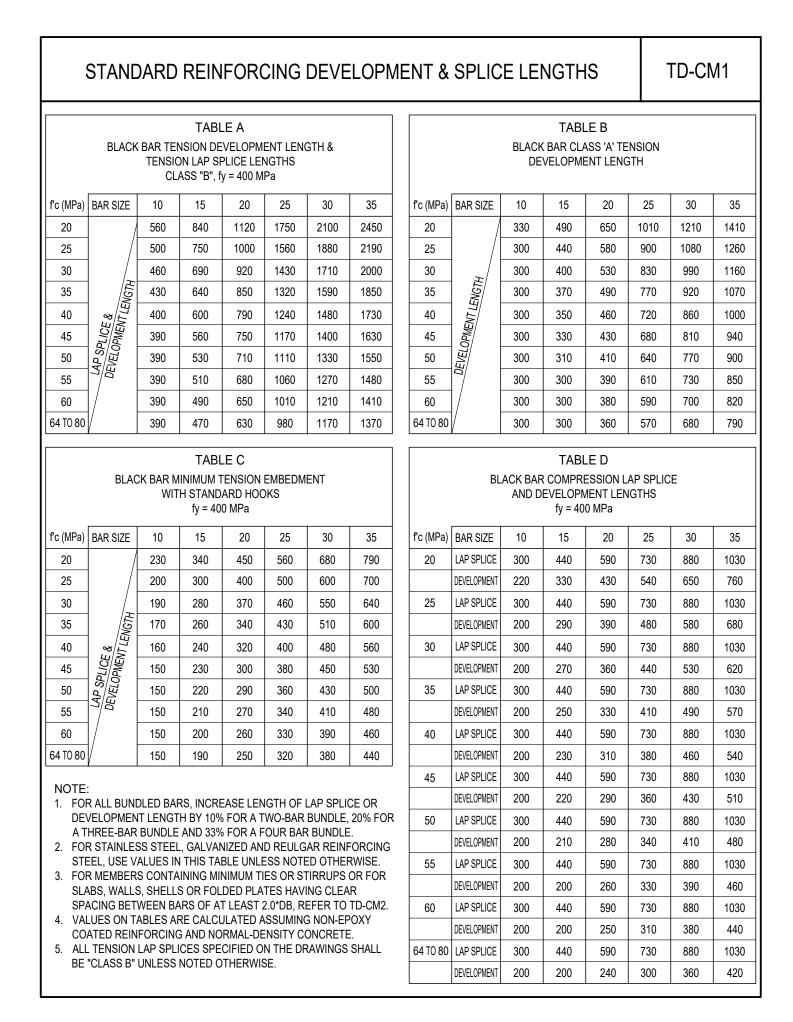

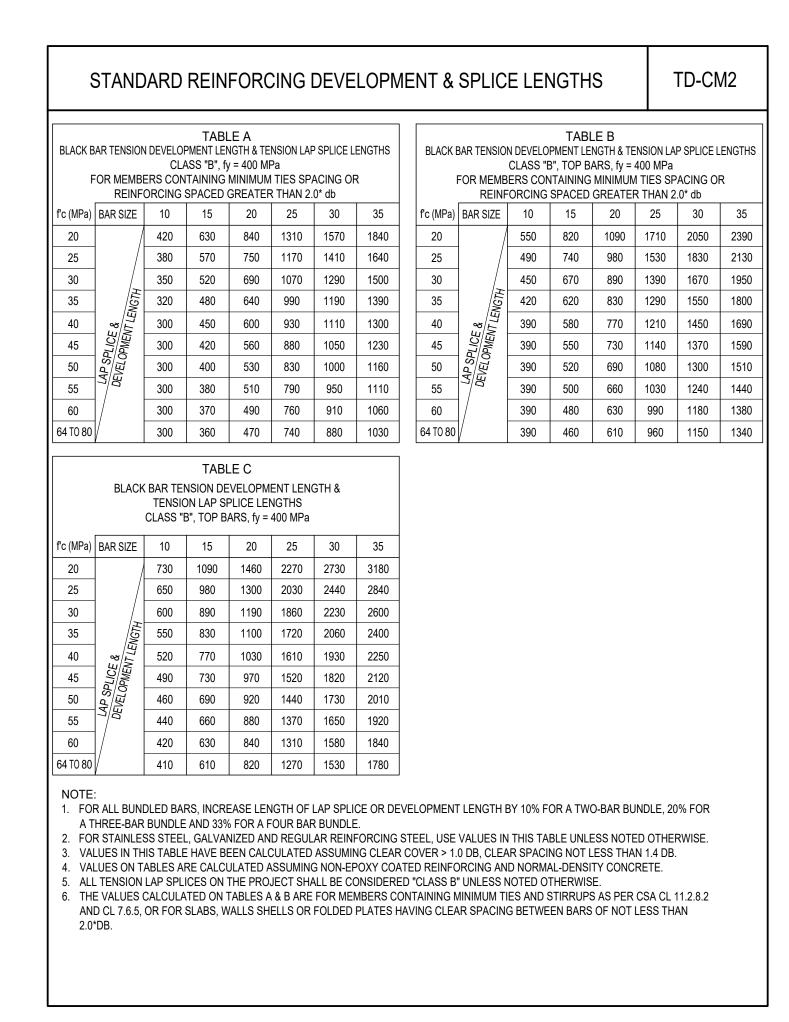




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1	ISSUED FOR PERMIT	2024 - 02 - 08
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North

Project Title:

PARK WASHROOM RENOVATION


1873 BLOOR STREET WEST, TORONTO, ON

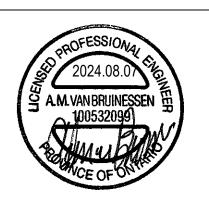
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Drawn by:	AQV	Date:	MAY 29, 2024
Sheet Title			


TYPICAL DETAILS


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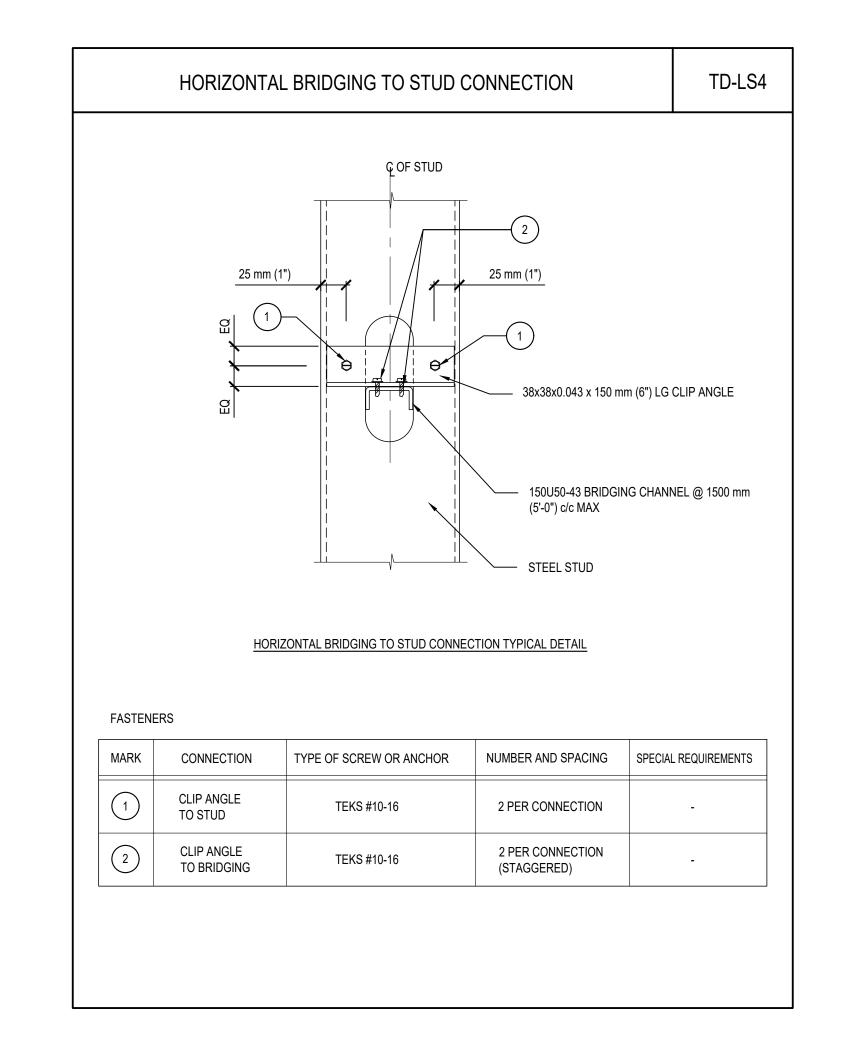
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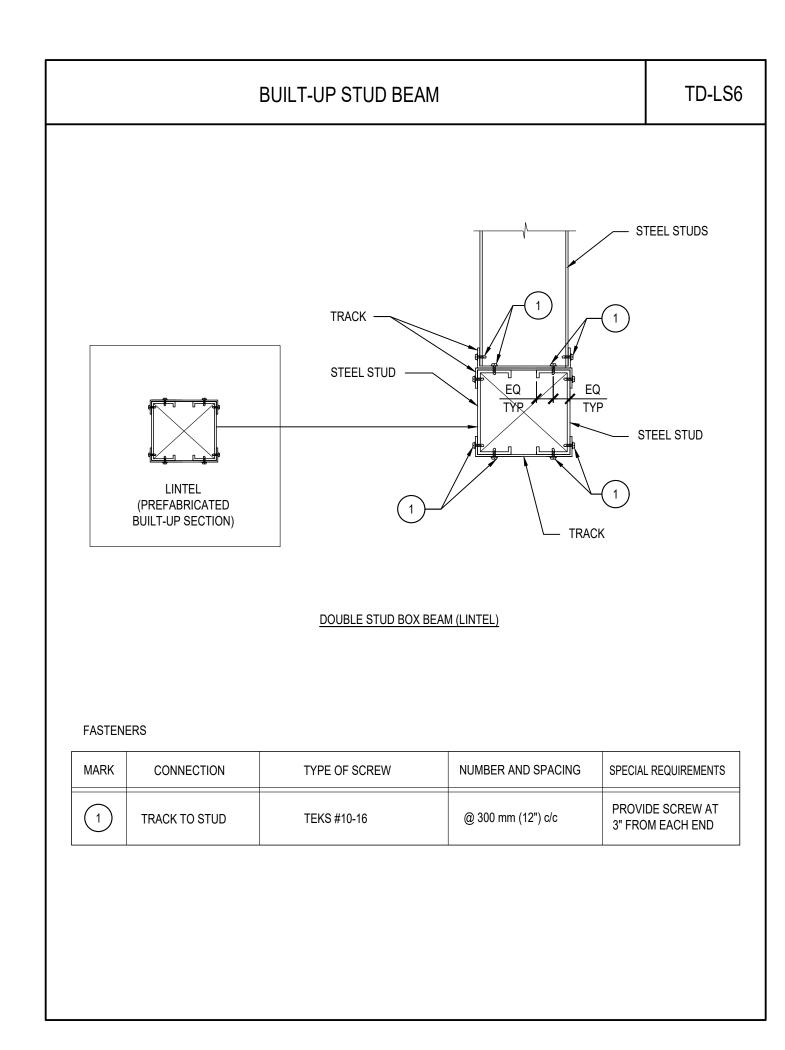




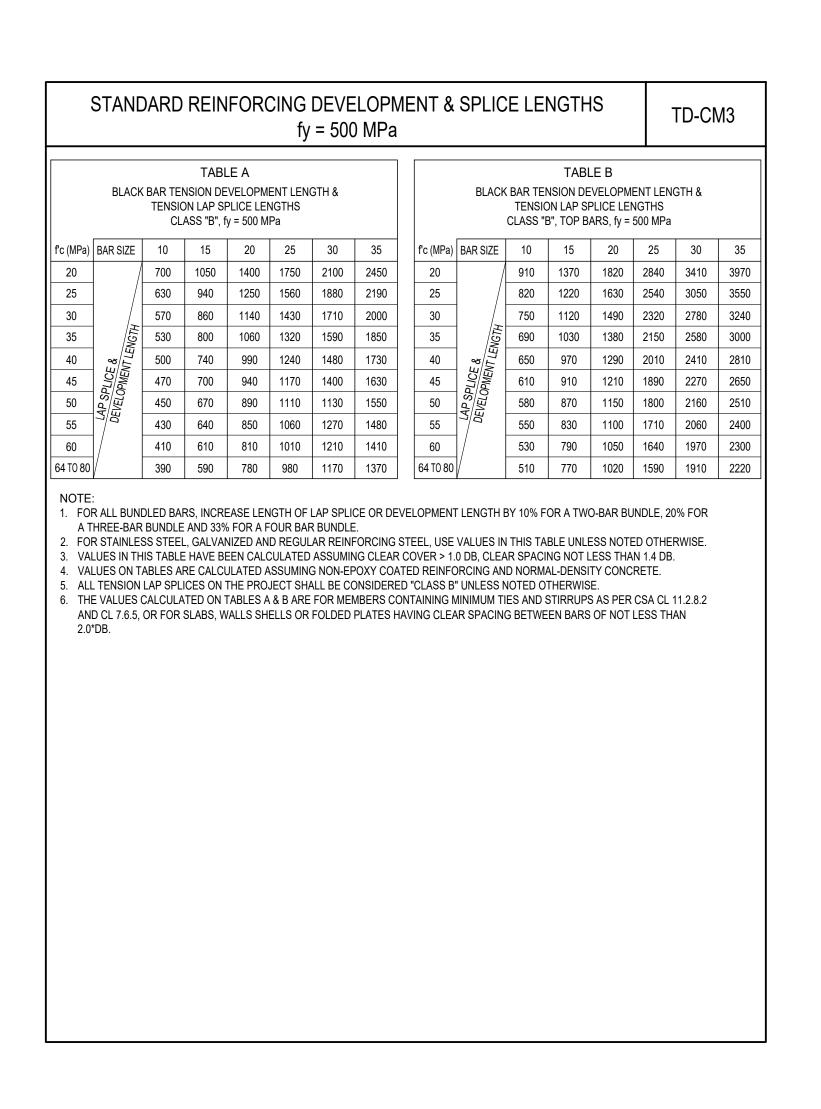

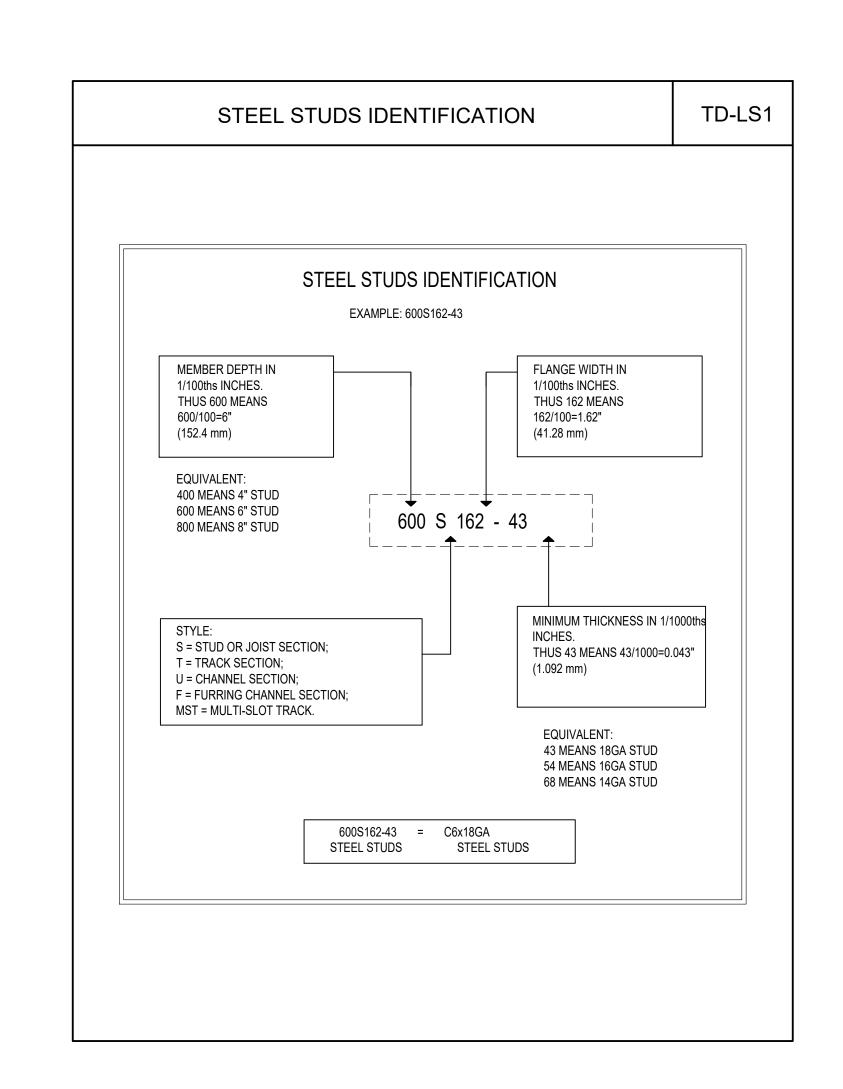

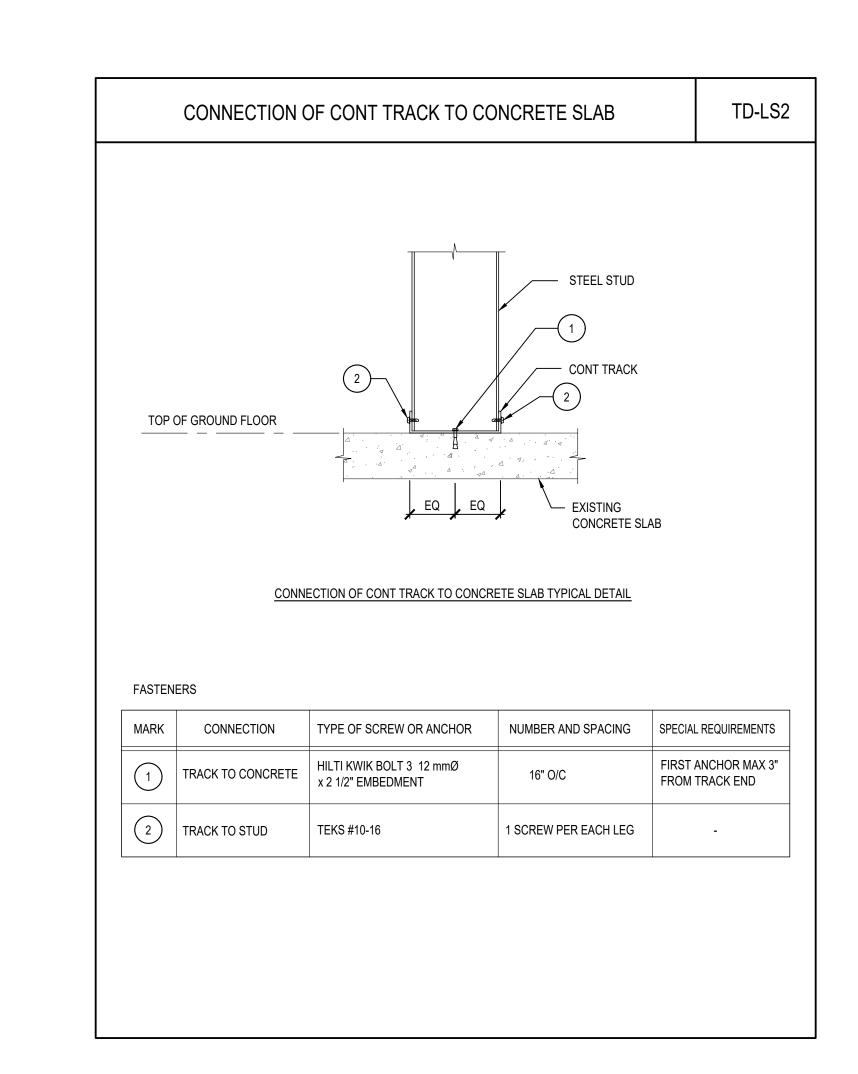

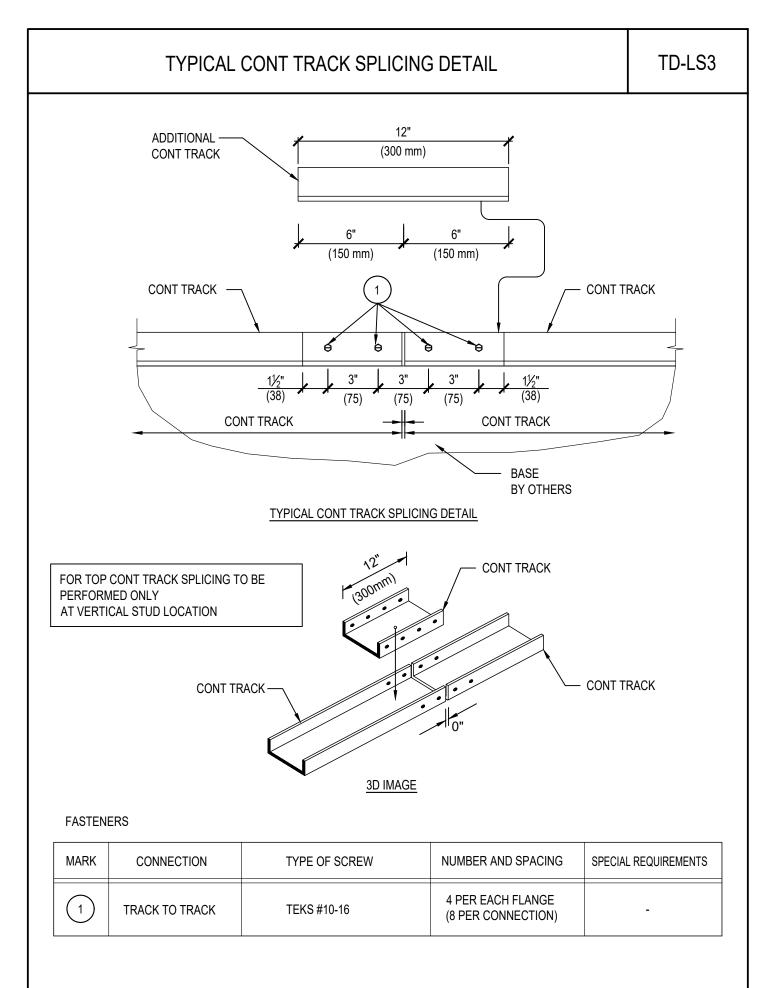



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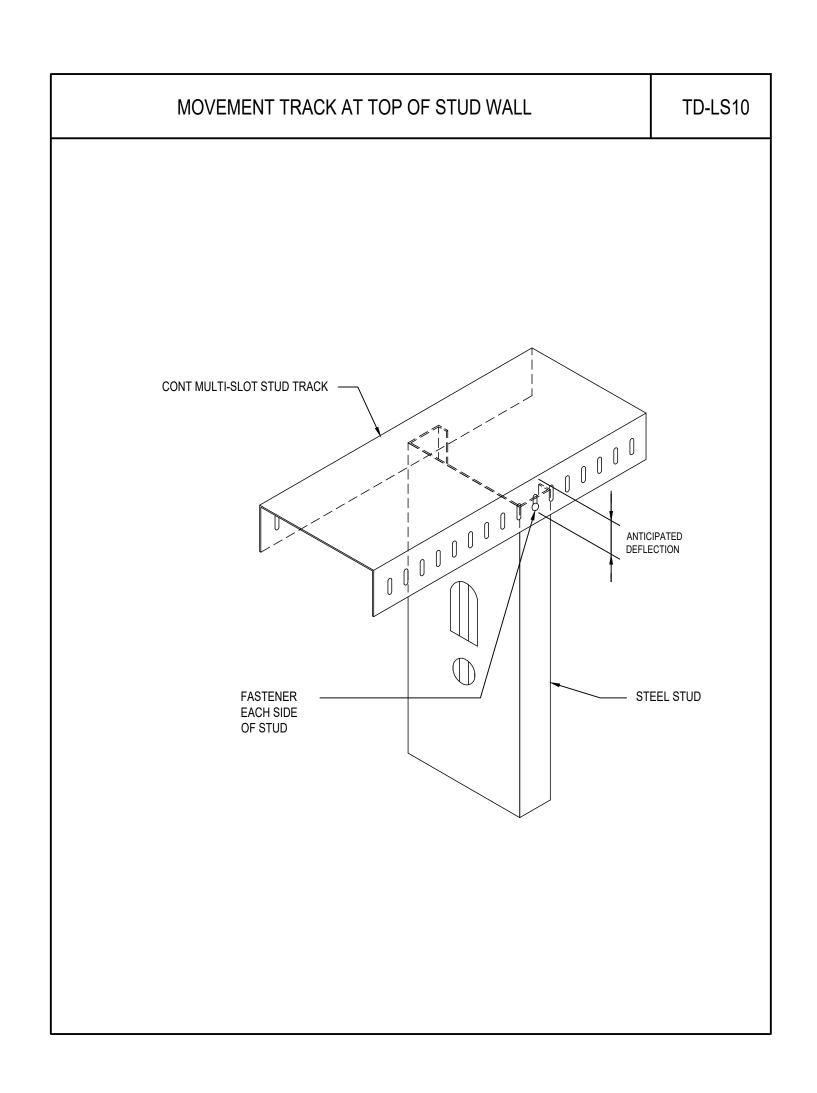
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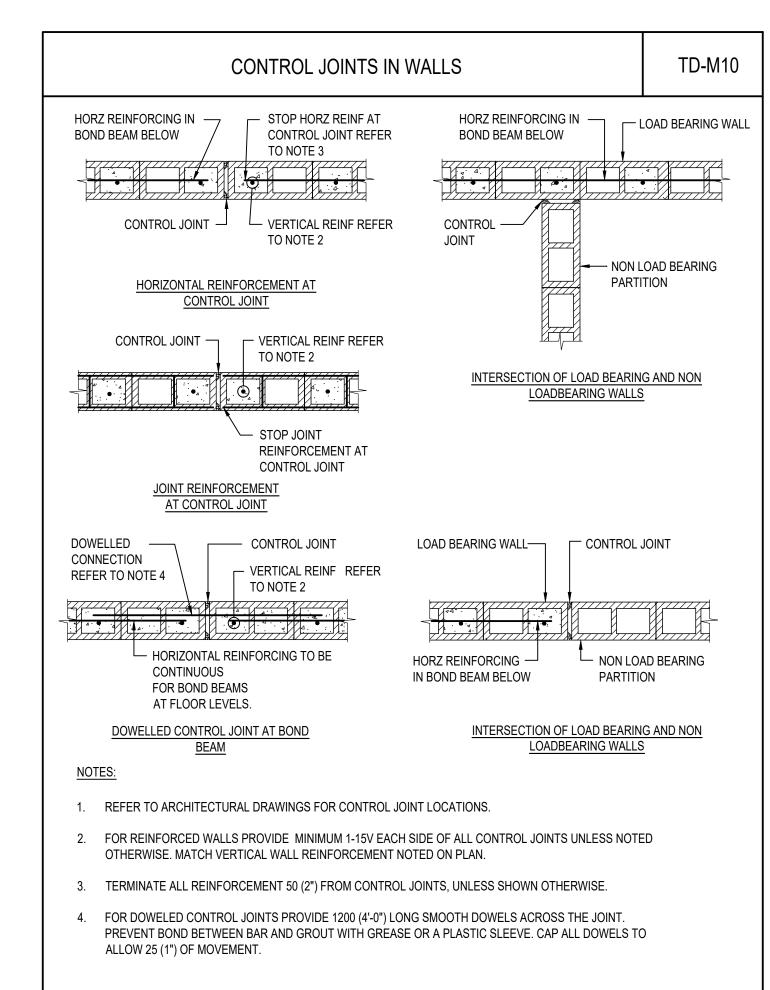
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Drawn by:	AQV	Date:	MAY 29, 2024
Sheet Title		•	


TYPICAL DETAILS


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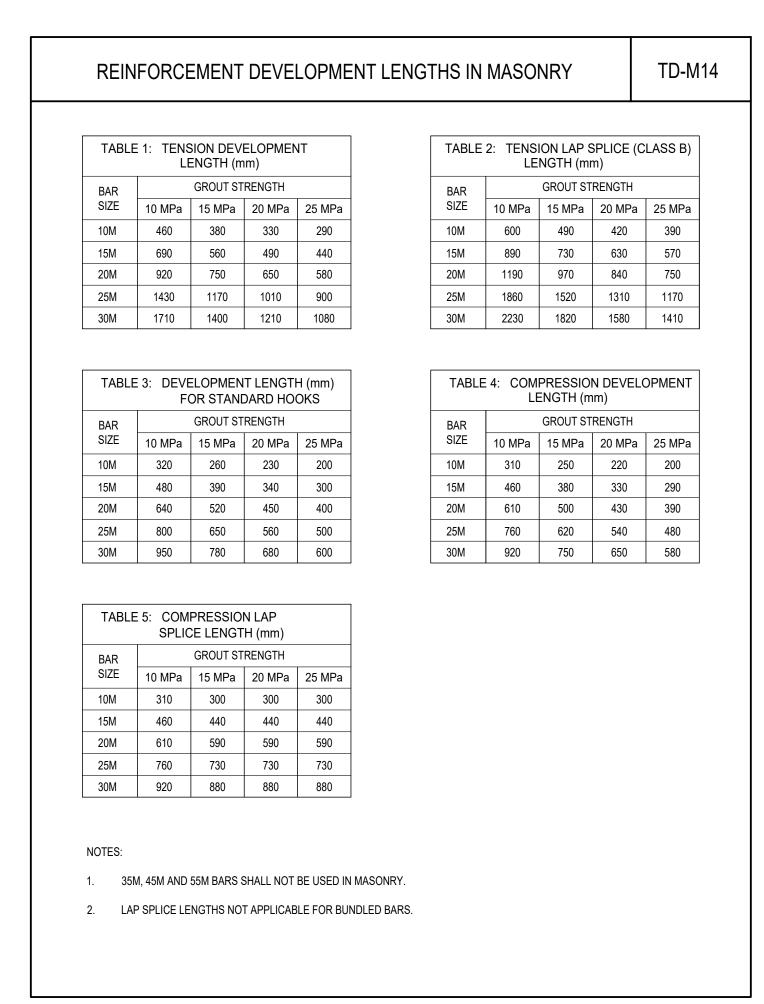
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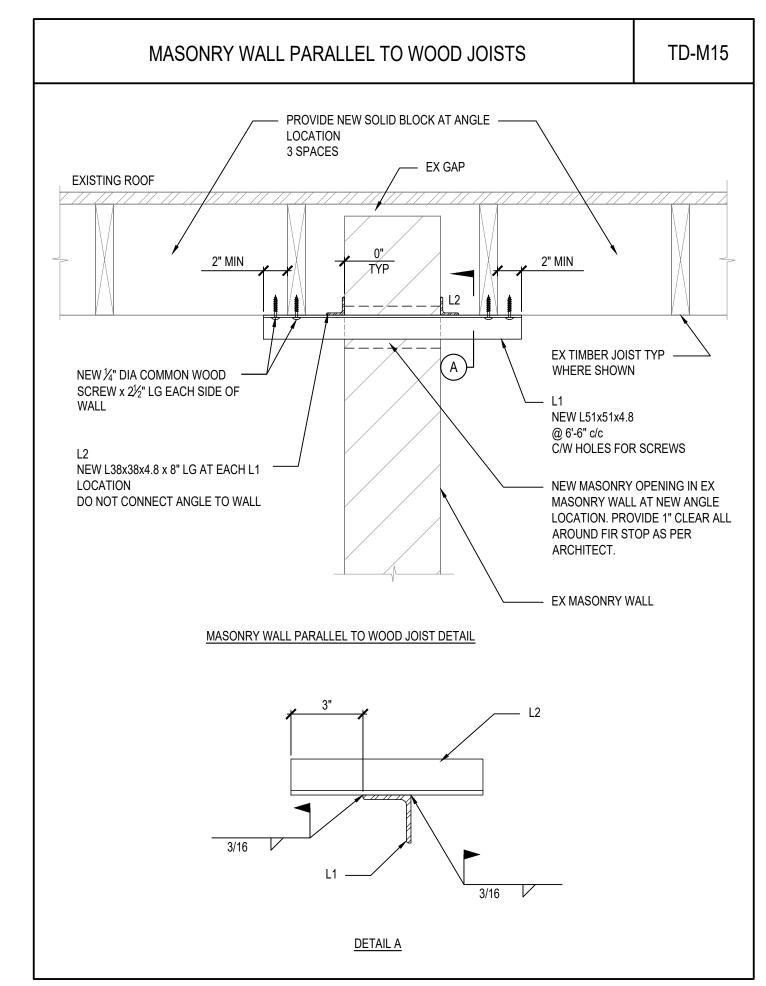









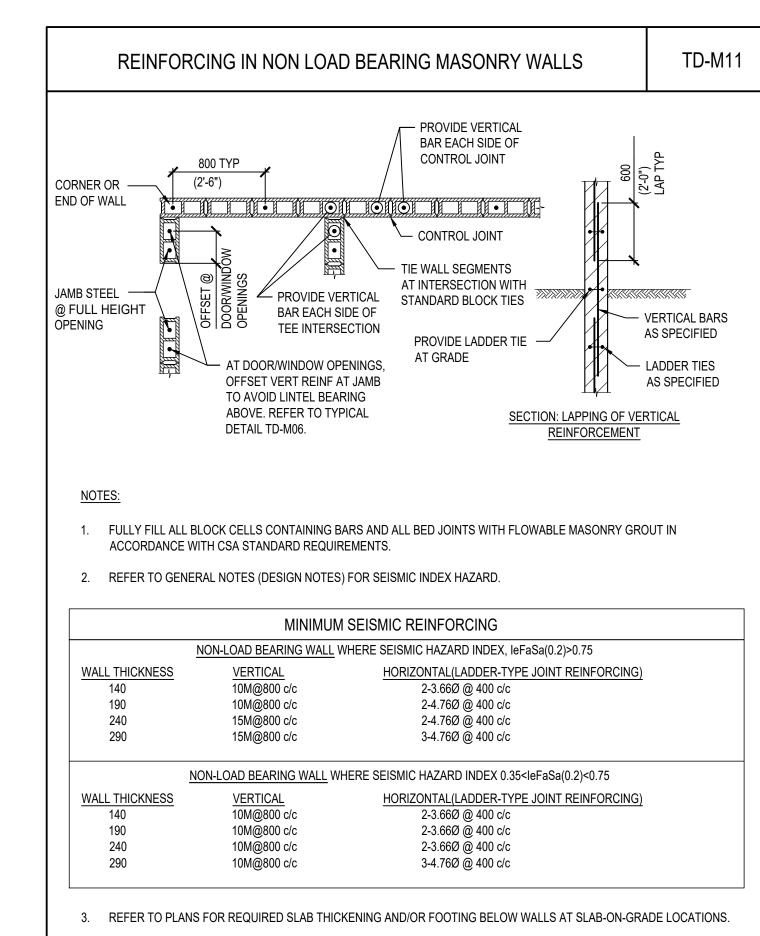

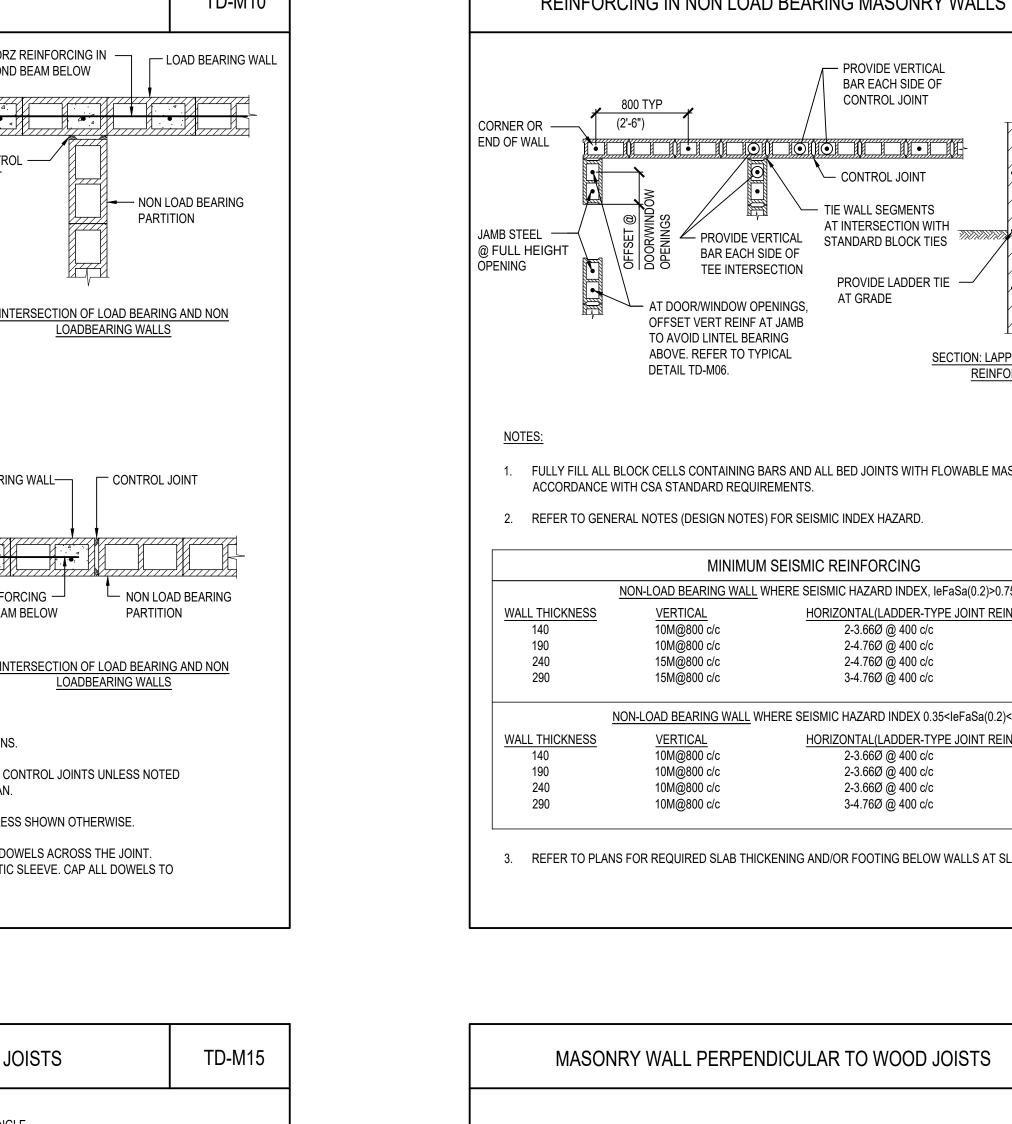

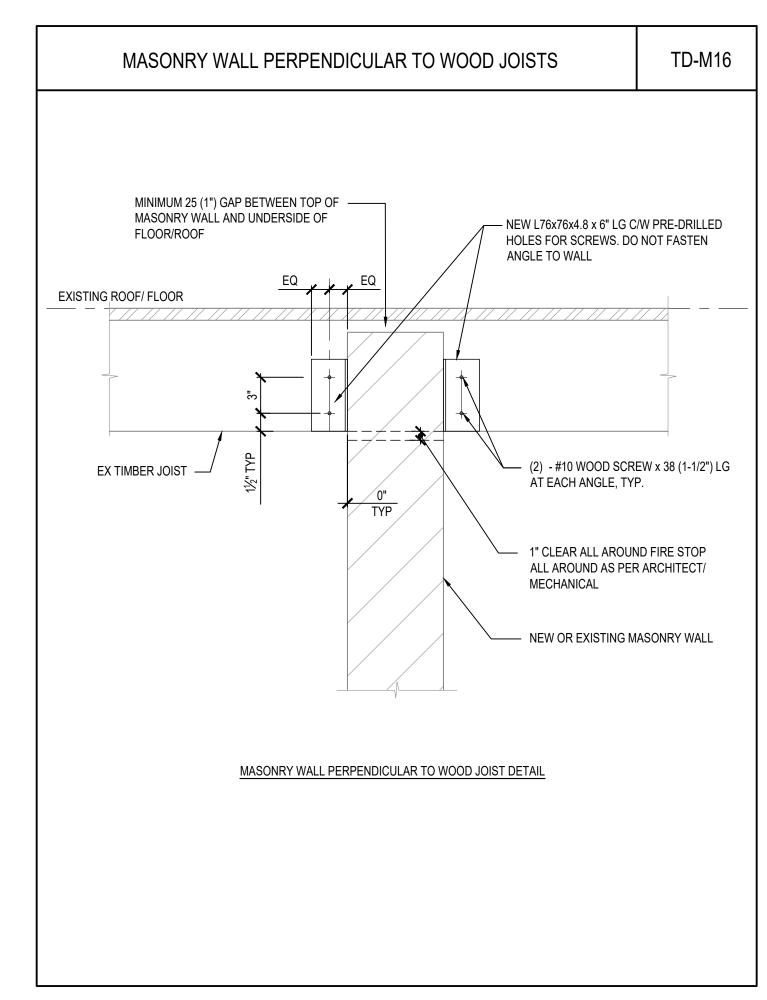




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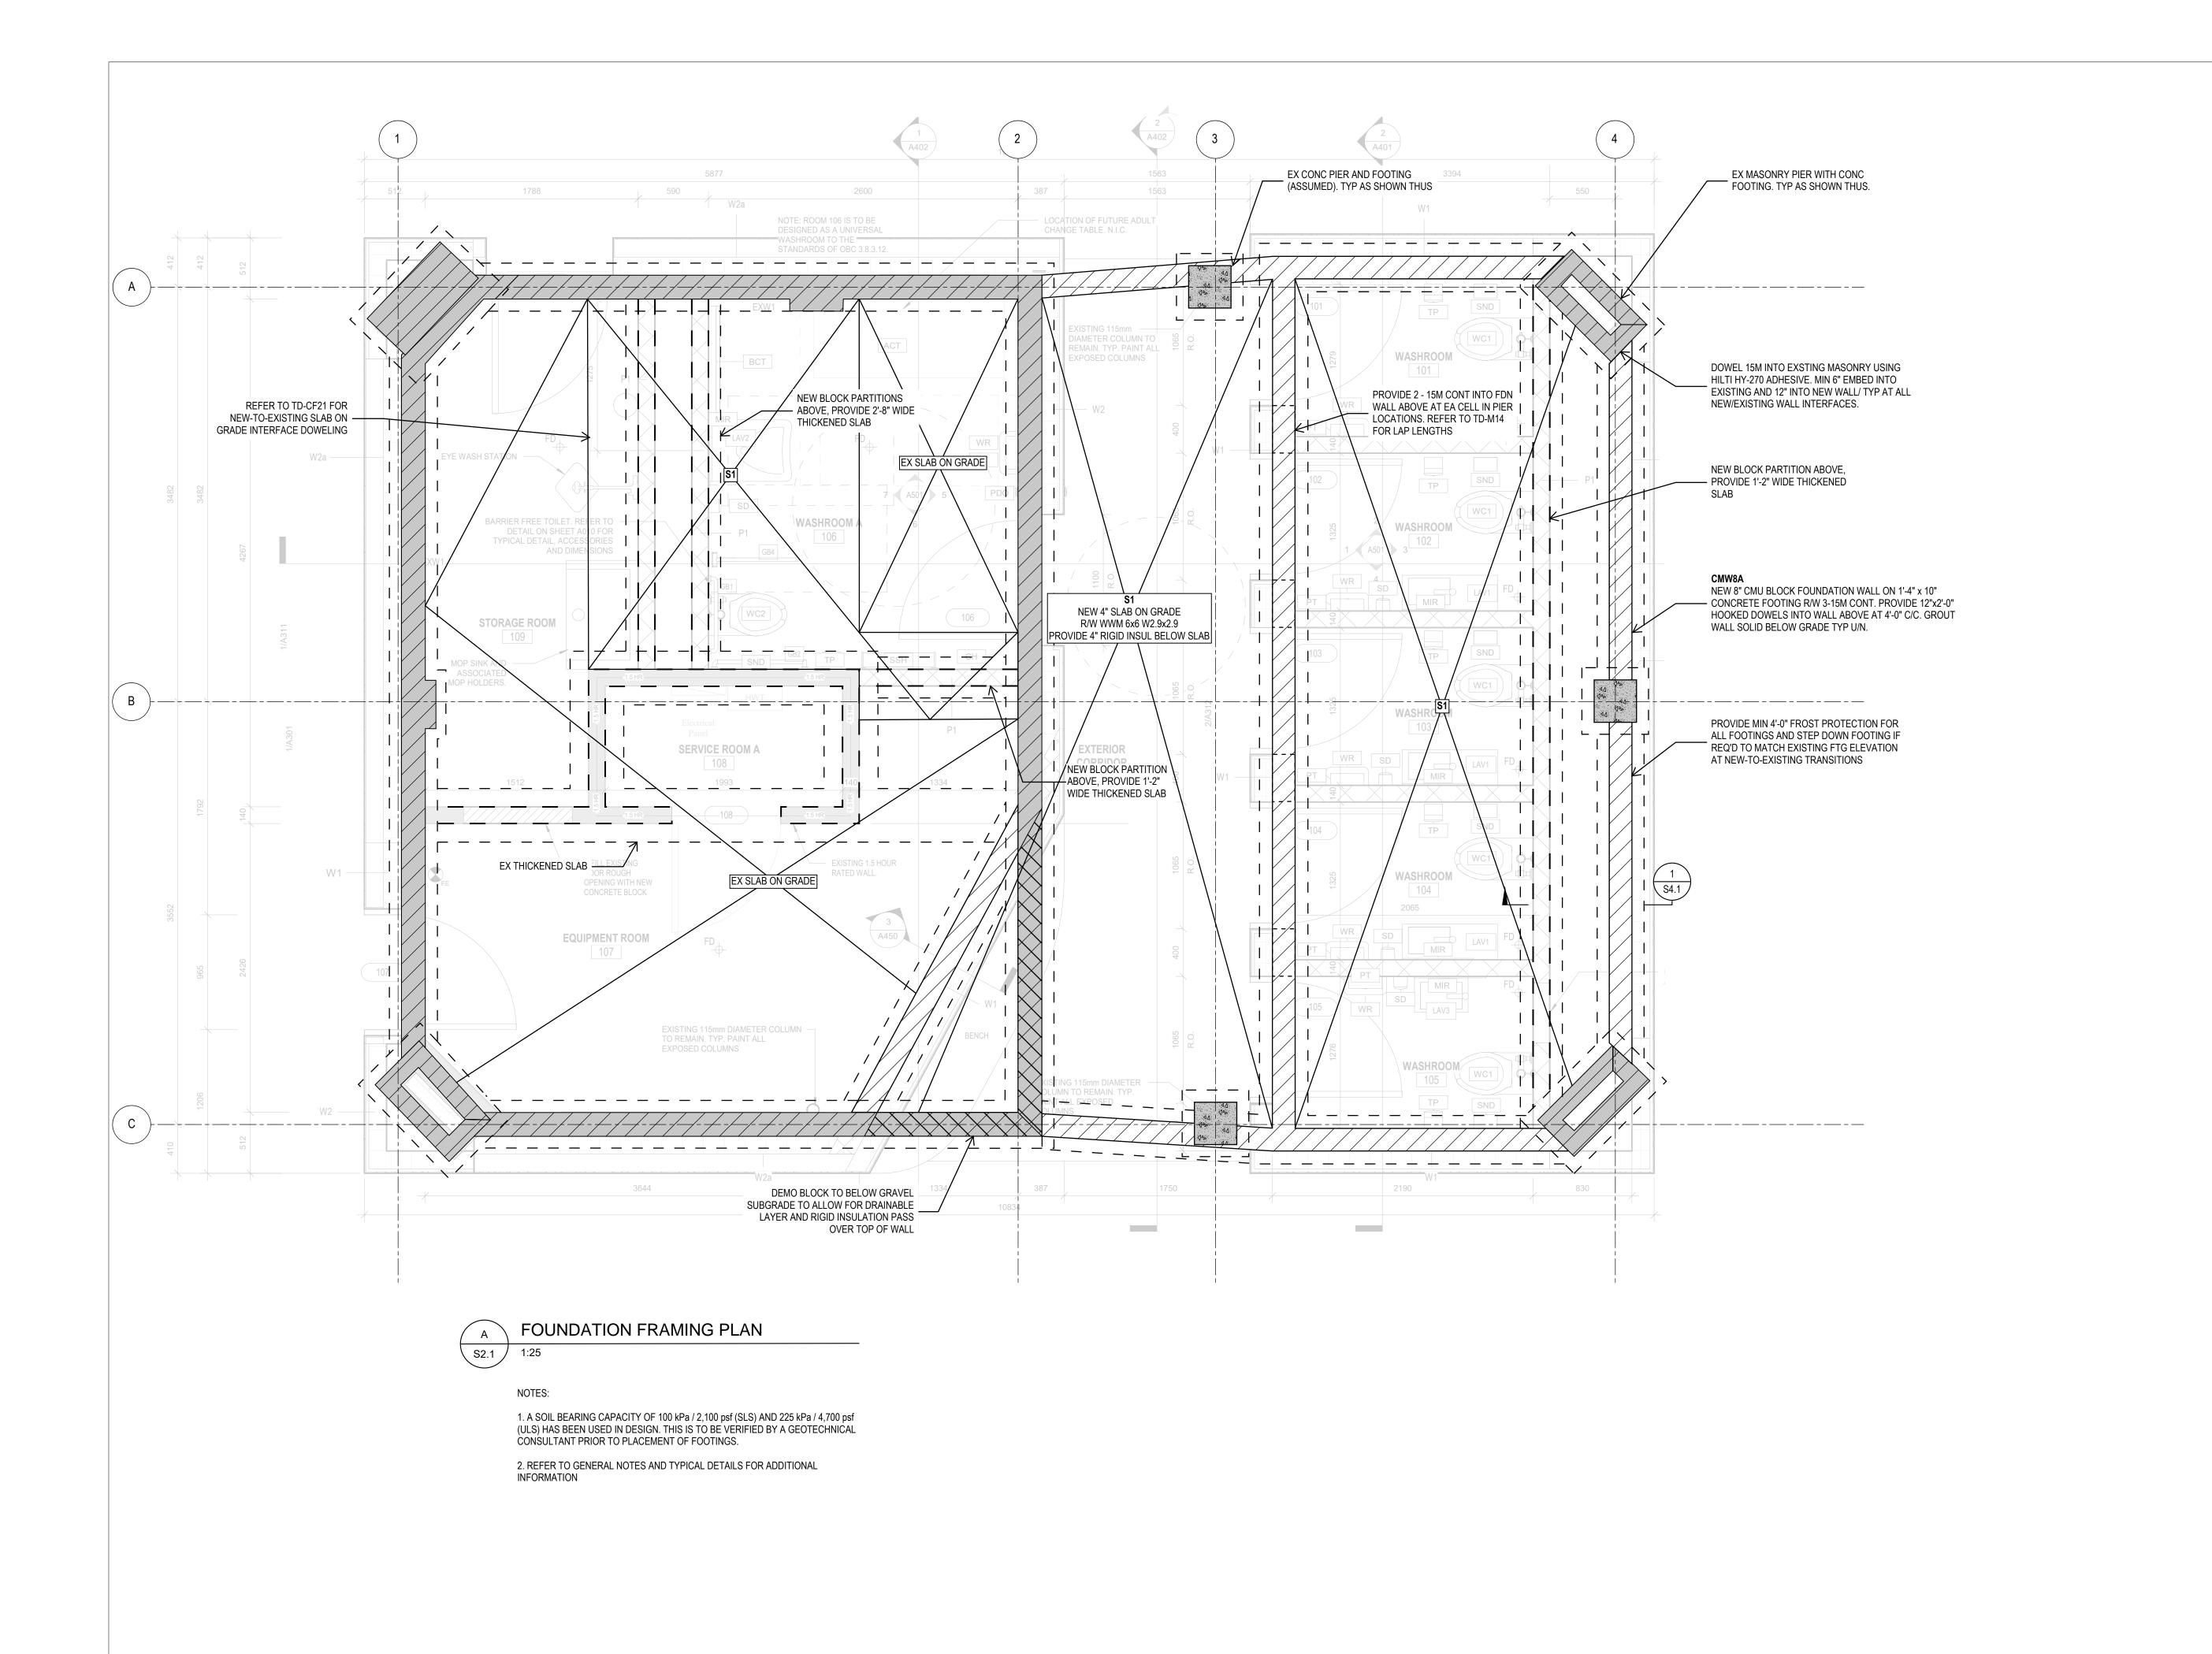
PARK WASHROOM RENOVATION

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TYPICAL DETAILS

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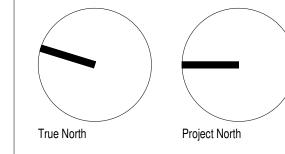
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Lower Hillside Washroom Building Improvements City of Toronto

1873 BLOOR ST W TORONTO, ON M6R 2Z3
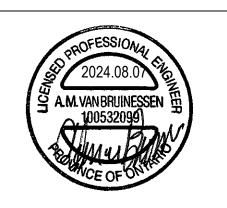
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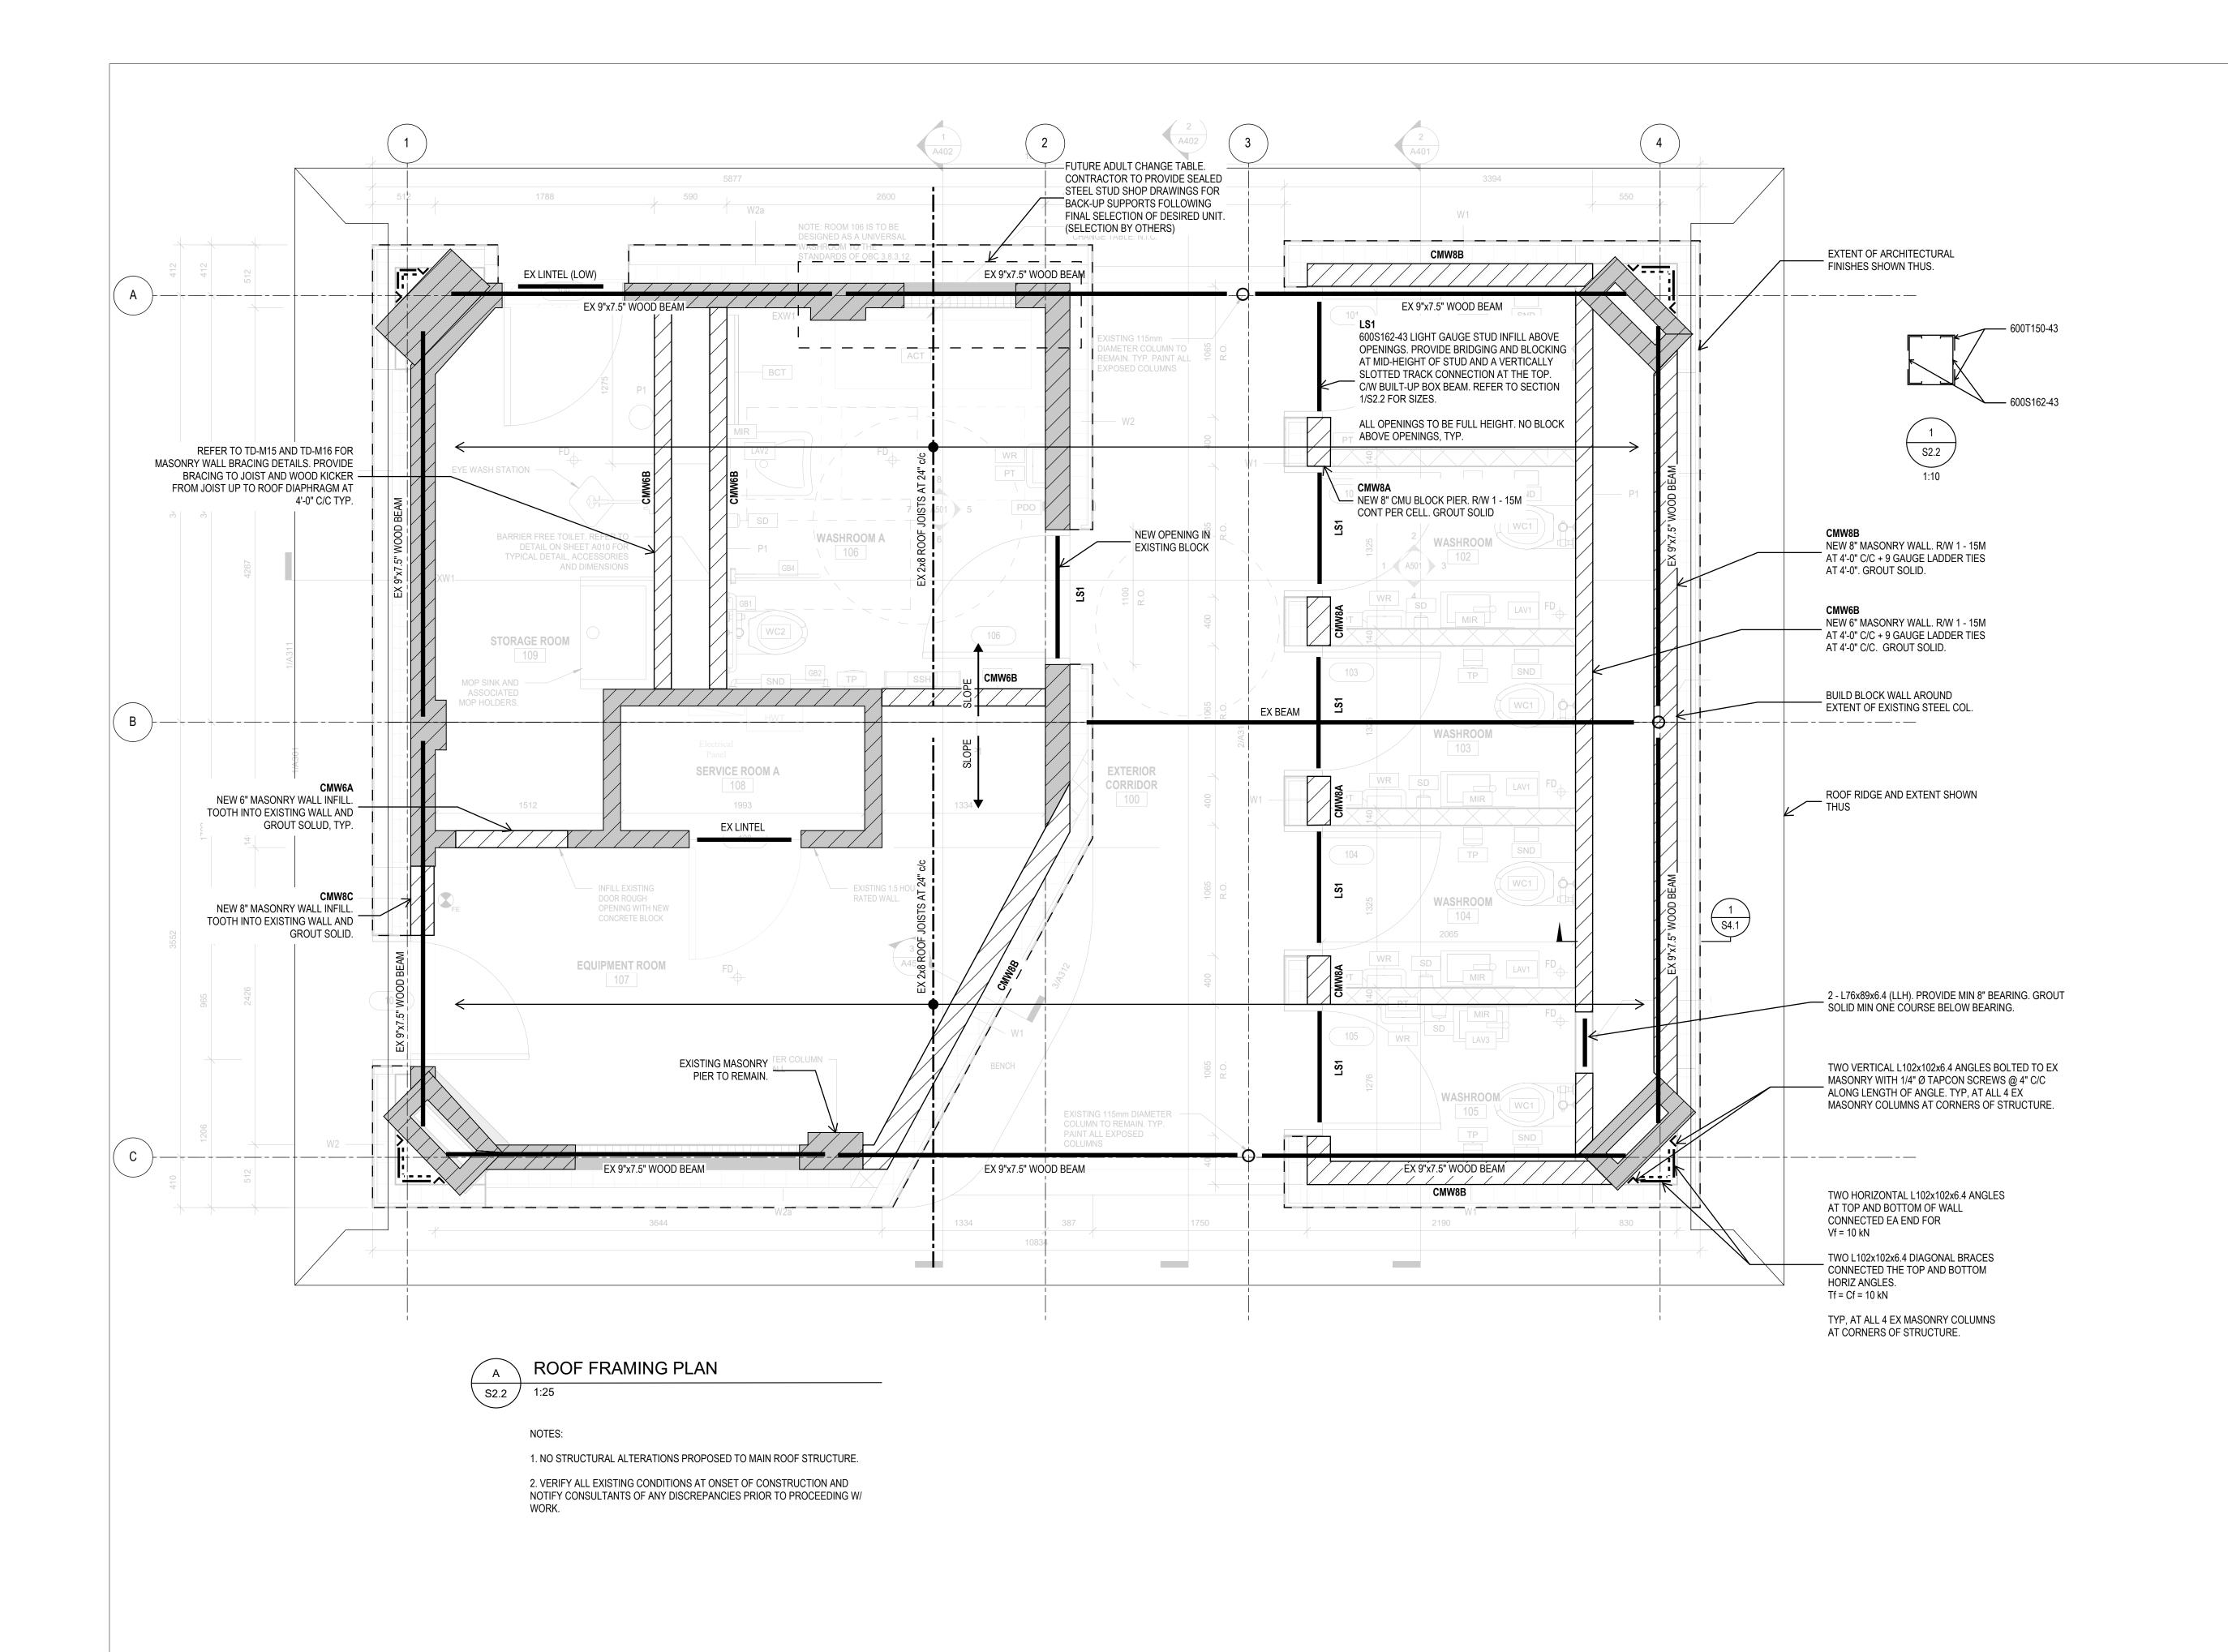
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FOUNDATION PLAN




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Lower Hillside Washroom Building Improvements

City of Toronto 1873 BLOOR ST W TORONTO, ON M6R 2Z3

2222 No.

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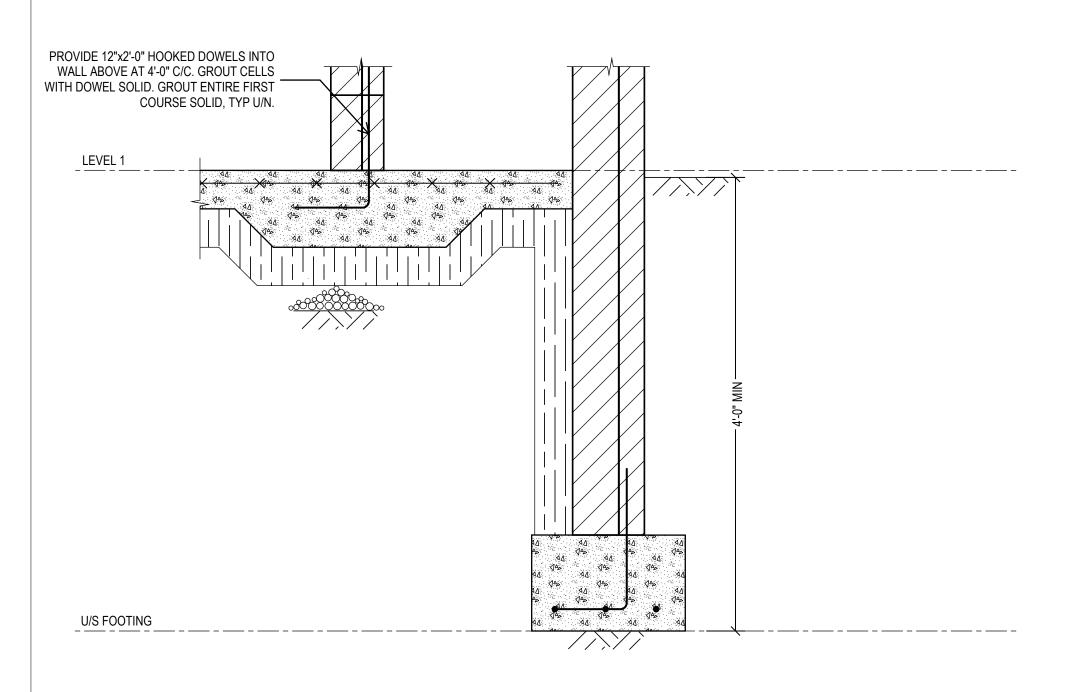
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ROOF FRAMING PLAN

PROVIDE SOLID BLOCKING AT 4'-0" C/C. L64x64x6.4 FASTENED TO CMU WALL AND WOOD BEAM AT 4'-0" C/C ALONG WALL. MAX SHIM OFFSET OF 1/2". ALTERNATE WHICH SIDE THE ANGLE IS INSTALLED. CEILING REFER TO TYPICAL DETAIL (2) - 1/4" Ø x 3" LAG SCREW. PRE-DRILL A PILOT HOLE. TD-M15 AND TD-M16 FOR 6" CMU -WALL BRACING DETAILS EXTENT OF EXISTING SHOWN DASHED FOR CONTEXT SHIMS PROVIDED TO ALIGN BEAM AND WALL AND ENSURE ANGLES REMAIN VERTICAL. 1/2" Ø THREADED ROD WITH HILTI HY270 ADHESIVE THROUGH VERTICALLY SLOTTED CONNECTION IN ANGLE. GROUT COURSE SOLID PRIOR TO ANCHORING.

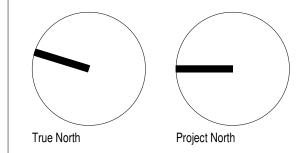




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DETAILS AND SECTIONS

SYMBOL	DESCRIPTION	SYMBOL	DESCRIPTION
⇔ F.D.	FLOOR DRAIN SIZE AS NOTED REFER TO SPECIFICATION FOR TYPES		DOMESTIC COLD WATER (DOM. COLD WATER)
∯ F.F.D.	FUNNEL FLOOR DRAIN SIZE AS NOTED REFER TO SPECIFICATION FOR TYPES		DOMESTIC HOT WATER (DOM. HOT WATER)
OC.O.	UPTURNED CLEANOUT		DOMESTIC HOT WATER RECIRCULATION (DOM. HOT WATER RECIRC.)
———II ^{C.O.}	HORIZONTAL CLEANOUT	— т —	TEMPERED DOMESTIC HOT WATER
 \$\displaystyle{\Phi_{\phi}}\displaystyle{\phi_{\phi}}}\displaystyle{\phi_{\phi}}\displaystyle{\phi_{\phi}}\displaystyle{\phi_{\phi}}\displaystyle{\phi_{\phi}}\displaystyle{\phi_{\phi}}}\displaystyle{\phi_{\phi}}\displaystyle{\phi_{\phi}}\displaystyle{\phi_{\phi}}\displaystyle{\phi_{\phi}}\displaystyle{\phi_{\phi}}\displaystyle{\phi_{\phi}}\displaystyle{\phi_{\phi}}\displ	FLOOR DRAIN FROM ABOVE WITH TRAP	—— G ——	NATURAL GAS
 \$\\\\\\\\\\\\\\\\\\\\\\\\\\\\\\\\\	FUNNEL FLOOR DRAIN FROM ABOVE WITH TRAP	— — GV — —	NATURAL GAS VENT
€ € ₩ -	WATER CLOSET AS NOTED REFER TO SPECIFICATION FOR TYPES		VENT
CS- CS-	SINGLE COMPARTMENT KITCHEN SINK	——SAN ——	SANITARY ABOVE GRADE OR FLOOR
MS- MS-	MOP SINK	——SAN(B)——	SANITARY BELOW GRADE OR FLOOR
cs- cs-	DOUBLE COMPARTMENT SINK	── ⋈──	GATE OR ISOLATION VALVE (REFER TO SPECIFICATION)
<mark>८ छि ८ छि</mark> DF− DF−	DRINKING FOUNTAIN	×	GLOBE VALVE
□ □ □ □ □ □ □ □	URINAL	——ф——	BALL VALVE
₽ ₽ L−	WALL HUNG LAVATORY	•	PENDANT SPRINKLER HEAD
SP	WET SPRINKLER	● DP	DRY PENDANT SPRINKLER HEAD
—— DSP ——	DRY SPRINKLER	0	UPRIGHT SPRINKLER HEAD
F.H.Cx	FIRE HOSE CABINET AND TYPE	•	CONCEALED SPRINKLER HEAD
S.V.Cx	SPRINKLER SHUT-OFF VALVE CABINET AND TYPE	O ^{NF}	NON-FREEZE SPRINKLER HEAD
F.E.−x ⊗	FIRE EXTINGUISHER AND TYPE	O ^{HT}	HIGH TEMPERATURE SPRINKLER HEAD
F.E.C.—× ^	FIRE EXTINGUISHER CABINET AND TYPE	O*	CHEMICAL SPRINKLER HEAD
F.R. [FIRE REEL	4	SIDEWALL SPRINKLER HEAD
WM	WATER METER	∢ ^w	WINDOW SPRINKLER HEAD
BFP	BACK FLOW PREVENTOR		L SYMBOLS APPLY, REFER NS AND DRAWINGS

GENERAL SYMBOLS AND ABBREVIATIONS (MSD-012.13)

SYMBOL	DESCRIPTION	SYMBOL	DESCRIPTION
\bowtie	GATE OR ISOLATION VALVE (REFER TO SPECIFICATION)		PIPE GUIDE
	GLOBE VALVE		PIPE SLEEVE
ιΦι	BALL VALVE	×	ANCHOR
\boxtimes	LOCKSHIELD VALVE	- , -	STRAINER
F.B.V.	FLOW BALANCING VALVE		UNION
P.I.F.B.V.	PRESSURE INDEPENDENT FLOW BALANCING VALVE		FLANGE FITTING
\Diamond	PLUG VALVE		ECCENTRIC FITTING
P.R.V. SS——SS	PRESSURE REDUCING VALVE		CONCENTRIC FITTING
$\overrightarrow{\mathbb{N}}$	CHECK VALVE	─ ⋈-∅	PRESSURE GAUGE
	SOLENOID VALVE		THERMOMETER
≾ h S.R.V.	SAFETY RELIEF VALVE	Н ФН⊘	PRESSURE GAUGE COCK ASSEMBLY
FMS	FLOW METERING STATION	T.W.	THERMOMETER WELL
□ B.P.	BACKFLOW PREVENTOR	E.J.	EXPANSION JOINT
×	ANGLE VALVE	M.V.	MANUAL AIR VENT
10	BUTTERFLY VALVE		AUTOMATIC AIR VENT
∑	2-WAY BUTTERFLY VALVE	SA.S	AIR SEPARATOR
-··- - X	TEMPEDED MIVING VALVE	S.G.	SIGHT GLASS
	TEMPERED MIXING VALVE	-5555-	PUMP
M	FLEXIBLE JOINT	-×-X-×-	P.R.V. C/W SHUT-OFF VALVE
VB	VACUUM BREAKER	-M	P.R.V. STATION
B.W.V.	BACK WATER VALVE	WHA	WATER HAMMER ARRESTOR

VALVES AND APPURTENANCES (MSD-012.05)

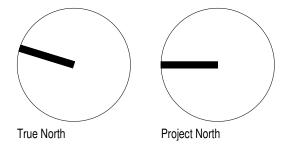SYMBOL	DESCRIPTION	SYMBOL	DESCRIPTION				
F/D	FIRE DAMPER	SM/D	SMOKE DAMPER				
M.O.D.	MOTOR OPERATED DAMPER	P.S.D.	POSITIVE SEAL DAMPER				
M.D.	MANUAL DAMPER	B.D.D.	GRAVITY OR BACKDRAFT DAMPER				
B.D.	BALANCING DAMPER	SP/D	SPLITTER DAMPER				
C.S.F/D	COMBINATION SMOKE AND FIRE DAMPER	SP/U 1					
	VOLUME EXTRACTOR	_					
<u>V.A.V. Al</u>	ND F.P.V.A.V. TAG						
MIN. PRIM	WERED V.A.V. FE 120/1000 SECONDAR	\ / /	IMPERIAL: CFM,[INS.] METRIC: L/s,[mm]				
	V.A.V. BOX (VARIABLE AIR VOLUME)	COIL CAPACITY	FAN POWERED BOX C/W RETURN AIR SILENCER OR ACOUSTICALLY LINED				
	V.A.V. BOX WITH ATTENTUATOR		RETURN AIR INDUCTION V.A.V. BOX				
	V.A.V. BOX WITH REHEAT COIL		PNEUMATIC AIR VALVE (LAB)				
	V.A.V. BOX WITH REHEAT COIL AND ATTENTUATOR						
HFATING	HEATING ELEMENT TAG						
A 1200	OW — HEATING CAPACITY						
	ENCLOSURE TYPE						
	REHEAT COIL IN DUCT (RHC) WATER		REHEAT COIL IN DUCT (ERHC) ELECTRIC				
[HORIZONTAL UNIT HEATER	R-X	RADIATION HEATING RISER NUMBERS (S=SUPPLY AND R=RETURN)				
	DOWN BLAST UNIT HEATER		WALL FIN ELEMENT IN CONTINUOUS ENCLOSURE				
	RADIANT HEATING PANEL						
NOTE: NOT AL	LL SYMBOLS APPLY, REFER TO FLOOR PL	I ANS AND DRAW	INCC				
3 AIR	HANDLING SYMBOLS D-012.08)						
SYMBOL	DESCRIPTION	SYMBOL	DESCRIPTION				
	SUPPLY DUCT UP OR FROM ABOVE		ACOUSTICALLY LINED TRANSFER AIR DUCT				
	SUPPLY DUCT DOWN OR FROM BELOW		SILENCER				
	RETURN OR EXHAUST DUCT UP OR FROM ABOVE	CTS	CROSSTALK SILENCER				
	RETURN OR EXHAUST DUCT DOWN OR FROM BELOW		DUCT WITH MINIMUM CLEARANCE FIRE RATED ENCLOSURE				
	ROUND DUCT UP OR FROM ABOVE	F/D	DUCT WITH SLEEVE, INSULATION AND DAMPER				

SYMBOL	DESCRIPTION	SYMBOL	DESCRIPTION
	SUPPLY DUCT UP OR FROM ABOVE		ACOUSTICALLY LINED TRANSFER AIR DUCT
	SUPPLY DUCT DOWN OR FROM BELOW		SILENCER
	RETURN OR EXHAUST DUCT UP OR FROM ABOVE	CTS	CROSSTALK SILENCER
	RETURN OR EXHAUST DUCT DOWN OR FROM BELOW		DUCT WITH MINIMUM CLEARANCE FIRE RATED ENCLOSURE
	ROUND DUCT UP OR FROM ABOVE	F/D	DUCT WITH SLEEVE, INSULATION AND DAMPER
	ROUND DUCT DOWN OR FROM BELOW	САР	CAPPED CONNECTION
	ACOUSTIC LINED DUCT	RISE UP-	RISE IN DUCT
#	FLEXIBLE CONNECTION	SLOPE DN	DROP IN DUCT
(CC)	SQUARE ELBOW DUCT WITH TURNING VANE	S.B.	SOUND BAFFLE
	RADIUS ELBOW WITH TURNING VANES		PROPELLER FAN
	AXIAL FAN/INLINE FAN MIXED FLOW OR CENTRIFUG		
	CENTRIFUGAL FAN		
DIFFUSER GRILLE OR REGISTER TYF IMPERIAL: CFM,[IN METRIC: L/s,[mm	NS.] P4 300 AIR FLOW (L/S)	LINEAR SLOT DIFFUSER — AIR FLOW (L/S) —	IMPERIAL: CFM,[INS.] (S4 1500X1200mm METRIC: L/s,[mm] NECK SIZE AND LINEAR DIFFUSER LENGTH (MM)
(O) →	ROUND SUPPLY DIFFUSER		SUPPLY AIR DIFFUSER C/W FLEXIBLE DUCT
<u> </u>	DUCTED RETURN OR EXHAUST REGISTER OR GRILLE		LIGHT TROFFER DIFFUSER TOP INLET C/W FLEXIBLE DUCT
	SQUARE OR RECTANGULAR DIFFUSER		LIGHT TROFFER DIFFUSER SIDE INLET C/W FLEXIBLE DUCT
-• →	NON DUCTED RETURN OR EXHAUST GRILLE		DUCT MOUNTED SUPPLY OR RETURN GRILLE
	NON DUCTED ROUND RETURN OR EXHAUST GRILLE		LINEAR SUPPLY OR RETURN GRILLE
<u> </u>	SQUARE PLAQUE DIFFUSER		SPIN-IN CONNECTION C/W BALANCING DAMPER AND FLEX DUCT
	DIFFUSERS WITH BLANK-OFF PORTION (QTY SHOWN)		SPIN-IN CONNECTION C/W BALANCING DAMPER AND RIGID DUCT
NOTE: NOT AL	L SYMBOLS APPLY, REFER TO FLOOR PI	ANS AND DRAW	INGS

	AIR	HANDLING	SYMBOLS
TM-0.0	(MS	D-012.09	

MECHANI	CAL DRAWING LIST								
	Der Sheet Title								
GENERAL	SHOOT HEIG								
TM-0.0		MECHANICAL DRAWING LIST AND LEGENDS							
TM-0.1	MECHANICAL STANDARD DE	TAILS							
EMOLITION FM-1.1	GROUND FLOOR PLUMBING	AND DRAINA	GE DEMOLITION LAYOUT						
ΓM-1.2	GROUND FLOOR H.V.A.C. DE	EMOLITION LA	YOUT						
PLUMBING TM-2.1	GROUND FLOOR PLUMBING	AND DRAINA	GE LAYOUT						
H.V.A.C.		NACHT.							
ГМ — 3.1	GROUND FLOOR H.V.A.C. LA	4 100 1							
_									
	AWING LIST								
	AWING LIST								
M-0.0	AWING LIST DESCRIPTION	SYMBOL	DESCRIPTION						
M-0.0 SYMBOL	DESCRIPTION	<u> </u>							
M-0.0	DESCRIPTION DETAIL NUMBER	SYMBOL 12 M-01	SECTION NUMBER						
SYMBOL	DESCRIPTION DESCRIPTION DETAIL NUMBER DRAWING NUMBER	12	SECTION NUMBER DRAWING NUMBER						
SYMBOL	DESCRIPTION DETAIL NUMBER	12	SECTION NUMBER						
SYMBOL	DESCRIPTION DESCRIPTION DETAIL NUMBER DRAWING NUMBER	12	SECTION NUMBER DRAWING NUMBER						
SYMBOL	DESCRIPTION DESCRIPTION DETAIL NUMBER DRAWING NUMBER	12	SECTION NUMBER DRAWING NUMBER						
SYMBOL 6 M-01 4	DESCRIPTION DETAIL NUMBER DRAWING NUMBER REVISION NUMBER ELBOWS TEE	12	SECTION NUMBER DRAWING NUMBER REVISION BUBBLE PIPING SERVICE CONTINUES						
SYMBOL 6 M-01 4	DESCRIPTION DETAIL NUMBER DRAWING NUMBER REVISION NUMBER ELBOWS	12 M-01	SECTION NUMBER DRAWING NUMBER REVISION BUBBLE PIPING SERVICE CONTINUES REFER TO STANDARD DETAIL DRAWINGS FOR ADDITIONAL REQUIREMENTS OF						
SYMBOL 6 M-01 4	DESCRIPTION DESCRIPTION DETAIL NUMBER DRAWING NUMBER REVISION NUMBER ELBOWS TEE BRANCH OFF	12 M-01 ————————————————————————————————————	SECTION NUMBER DRAWING NUMBER REVISION BUBBLE PIPING SERVICE CONTINUES REFER TO STANDARD DETAIL DRAWINGS FOR ADDITIONAL REQUIREMENTS OF EQUIPMENT NOTED						
SYMBOL 6 M-01 4	DESCRIPTION DESCRIPTION DETAIL NUMBER DRAWING NUMBER REVISION NUMBER ELBOWS TEE BRANCH OFF BOTTOM OF MAIN	12 M-01 ————————————————————————————————————	SECTION NUMBER DRAWING NUMBER REVISION BUBBLE PIPING SERVICE CONTINUES REFER TO STANDARD DETAIL DRAWINGS FOR ADDITIONAL REQUIREMENTS OF EQUIPMENT NOTED						
SYMBOL 6 M-01 4 1 1 1 1 1 1 1 1 1 1 1 1 1 1 1 1 1	DESCRIPTION DETAIL NUMBER DRAWING NUMBER REVISION NUMBER ELBOWS TEE BRANCH OFF BOTTOM OF MAIN BRANCH OFF TOP OF MAIN DIRECTION OF FLOW	12 M-01 M-01 S CFM	SECTION NUMBER DRAWING NUMBER REVISION BUBBLE PIPING SERVICE CONTINUES REFER TO STANDARD DETAIL DRAWINGS FOR ADDITIONAL REQUIREMENTS OF EQUIPMENT NOTED AIR QUANTITY C.F.M. (L/s)						
M-0.0 SYMBOL 6 M-01 4 1 1 1 1 1 1 1 1 1 1 1 1	DESCRIPTION DESCRIPTION DETAIL NUMBER DRAWING NUMBER REVISION NUMBER ELBOWS TEE BRANCH OFF BOTTOM OF MAIN BRANCH OFF TOP OF MAIN	12 M-01 M-01 S CFM	SECTION NUMBER DRAWING NUMBER REVISION BUBBLE PIPING SERVICE CONTINUES REFER TO STANDARD DETAIL DRAWINGS FOR ADDITIONAL REQUIREMENTS OF EQUIPMENT NOTED AIR QUANTITY C.F.M. (L/s)						
SYMBOL 6 M-01 4 1 1 1 1 1 1 1 1 1 1 1 1	DESCRIPTION DETAIL NUMBER DRAWING NUMBER REVISION NUMBER ELBOWS TEE BRANCH OFF BOTTOM OF MAIN BRANCH OFF TOP OF MAIN DIRECTION OF FLOW EXISTING EQUIPMENT, PIPING, VALVES, DUCTOME EXISTING DUCT, FLEX. DUCT AND	MORK SHOWN LIGH	SECTION NUMBER DRAWING NUMBER REVISION BUBBLE PIPING SERVICE CONTINUES REFER TO STANDARD DETAIL DRAWINGS FOR ADDITIONAL REQUIREMENTS OF EQUIPMENT NOTED AIR QUANTITY C.F.M. (L/s) HT TO REMAIN EXISTING CONCEALED SPRINKLER						
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SOCA STUDIO CONTEMPORARY ARCHITECTURE LAPTISTE ARCHITECTURE INC.

1137A Queen St. East Toronto, ON M4M 1K9 (437) 916-9272

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Lower Hillside Washroom Building Improvements

City of Toronto 1873 BLOOR ST W TORONTO, ON M6R 2Z3

Issue / Revision

No. Date Description 1. 23/11/06 Issued for 50% Tender Review 2. 24/02/08 Issued for Permit / Tender 3. 24/08/07 Issued for Tender

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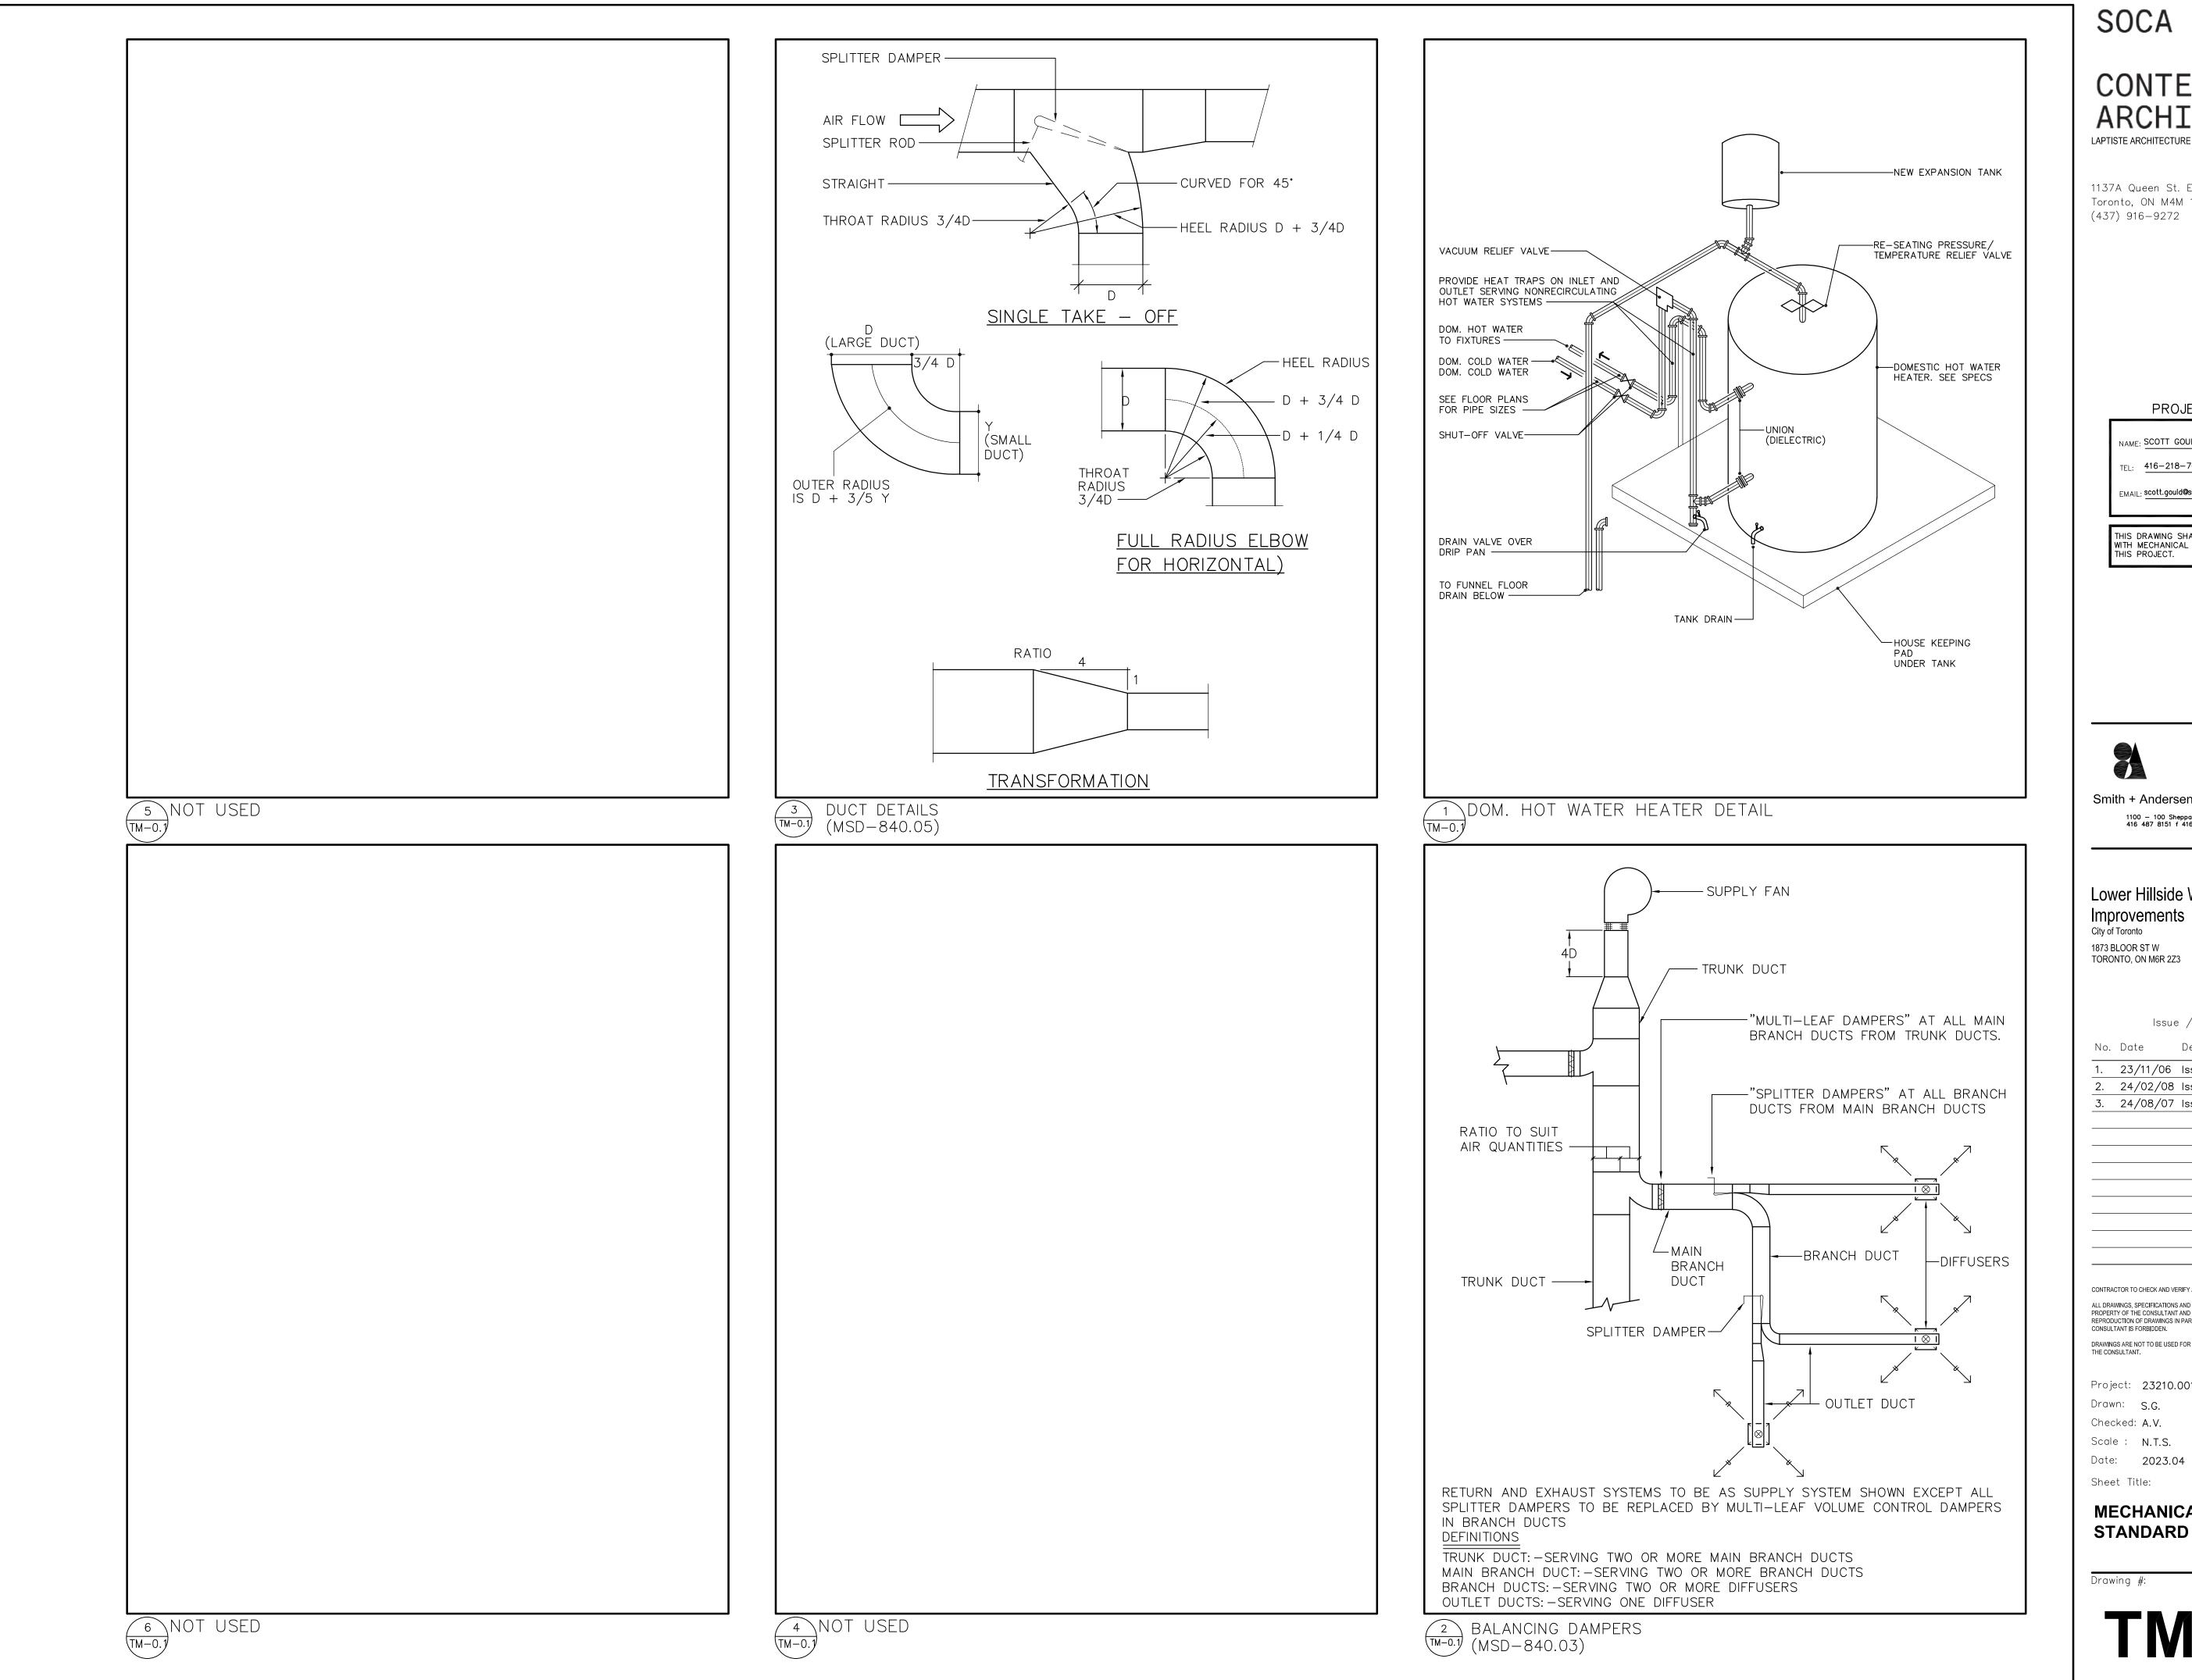
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NOTE: NOT ALL SYMBOLS APPLY, REFER TO FLOOR PLANS AND DRAWINGS

GENERAL SYMBOLS AND ABBREVIATIONS (MSD-012.12)


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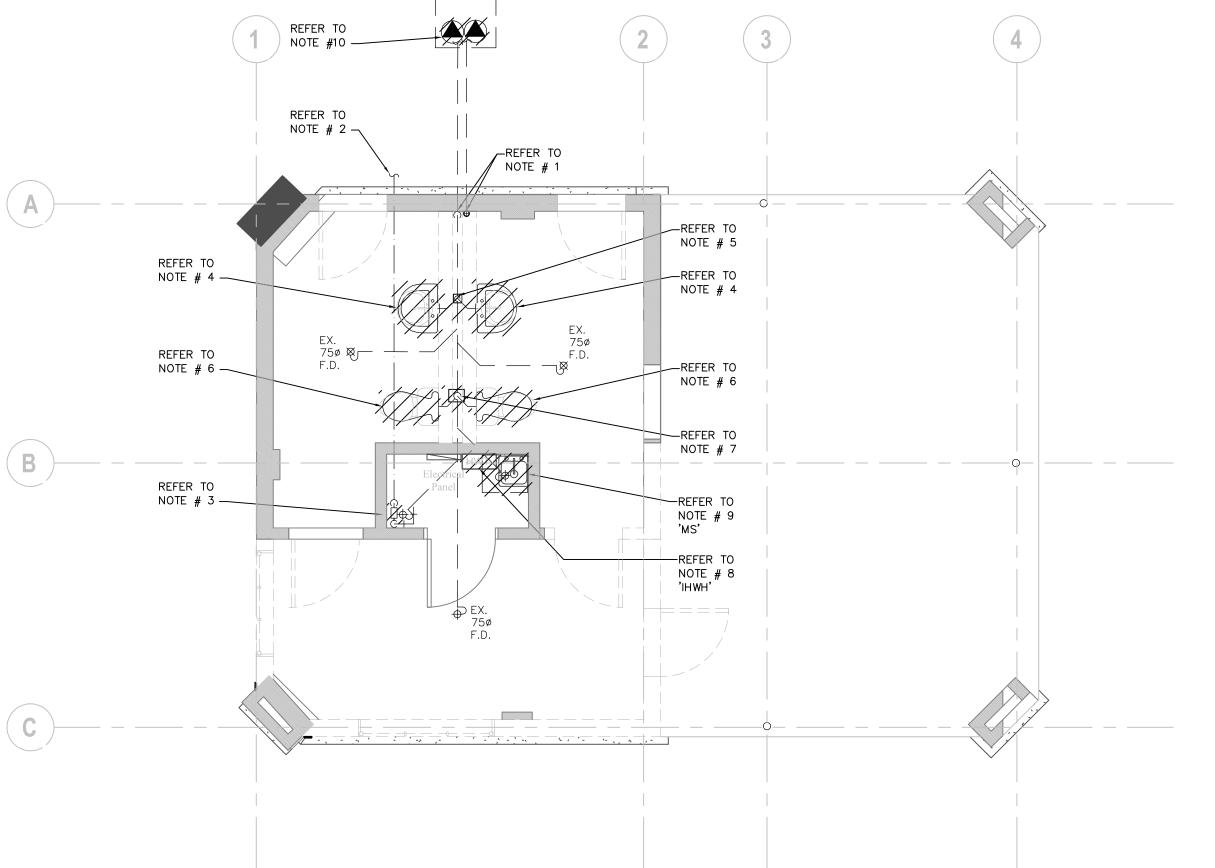
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MECHANICAL STANDARD DETAILS.

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DRAWING NOTES:

- EXISTING 100Ø BURIED SANITARY TO EXISTING PUMPING STATION BEYOND. EXISTING 50Ø VENT PIPE UP FROM EXISTING PUMPING STATION.
- EXISTING BURIED INCOMING 500 DOMESTIC COLD WATER LINE TO REMAIN.
- 3. EXISTING 400 WATER METER TO BE REMOVED. CAP EXISTING SERVICES TO ALLOW FOR INSTALLATION OF NEW 500 METER.
- REMOVE EXISTING LAVATORY(S) AND ALL ASSOCIATED DOMESTIC HOT AND COLD WATER PIPES, VENT PIPE AND SANITARY DRAIN. (TYPICAL).
- 5. CONTRACTOR TO CAP EXISTING LAVATORY DRAIN BELOW FLOOR SLAB AND PATCH FLOOR SLAB.
- REMOVE EXISTING WATER CLOSET(S) AND ALL ASSOCIATED DOMESTIC COLD WATER PIPES, VENT PIPE AND SANITARY DRAIN. (TYPICAL).
- CONTRACTOR TO CAP EXISTING WATER CLOSET DRAIN BELOW FLOOR SLAB AND PATCH FLOOR SLAB.
- 8. REMOVE EXISTING ELECTRIC INSTANT HOT WATER HEATER, TEMPORARILY CAP EXISTING SERVICES TO ALLOW FOR NEW HEATER INSTALLATION. ELECTRIC DISCONNECTION BY ELECTRICAL DIVISION.
- 9. REMOVE EXISTING MOP SINK AND ALL ASSOCIATED HOT AND COLD WATER PIPES, VENT PIPE AND SANITARY DRAIN. REMOVE BURIED P TRAP AND CAP SANITARTY DRAIN BELOW FLOOR..
- 10. REMOVE EXISTING GRINDER DUPLEX PUMP SET. ELECTRICAL DISCONNECTION BY ELECTRICAL DIVISION.

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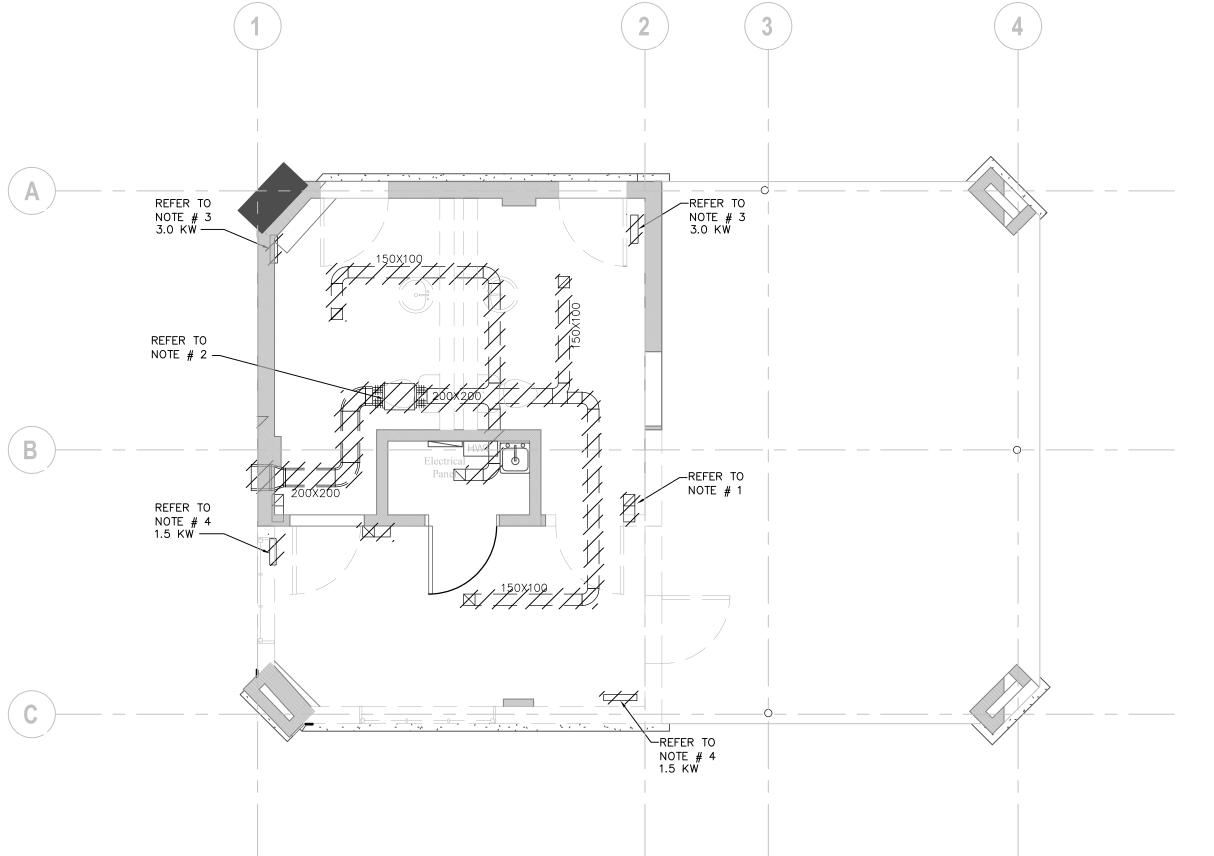
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GROUND FLOOR
PLUMBING & DRAINAGE
DEMOLITION LAYOUT

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- REFER TO STANDARD DETAILS AND DETAIL SHEETS FOR ADDITIONAL INFORMATION.

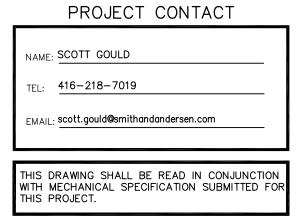DRAWING NOTES:

- EXISTING 150X150 TRANSFER GRILLE AND ACOUSTICALLY LINED DUCT TO BE REMOVED. (TYPICAL).
- REMOVE EXISTING SANITARY EXHAUST FAN AND ALL ASSOCIATED SANITARY EXHAUST DUCTWORK.
- 3. REMOVE AND RELOCATE EXISTING 3.0 KW FORCE FLOW HEATERS. CONTRACTOR TO SUBMIT A REPORT ON CONDITION OF EXISTING ELECTRIC FORCE FLOW HEATER AND PROVIDE COSTS ASSOCIATED WITH RECOMMENDED REPAIR, MAINTENANCE OR REPLACEMENT. ELECTRICAL DISCONNECTION AND RECONNECTION BY THE ELECTRICAL DIVISION.
- 4. REMOVE AND DISPOSE OF EXISTING ELECTRIC FORCE FLOW HEATERS. ELECTRICAL DISCONNECTION BY THE ELECTRICAL DIVISION.

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Lower Hillside Washroom Building

Improvements
City of Toronto
1873 BLOOR ST W

TORONTO, ON M6R 2Z3

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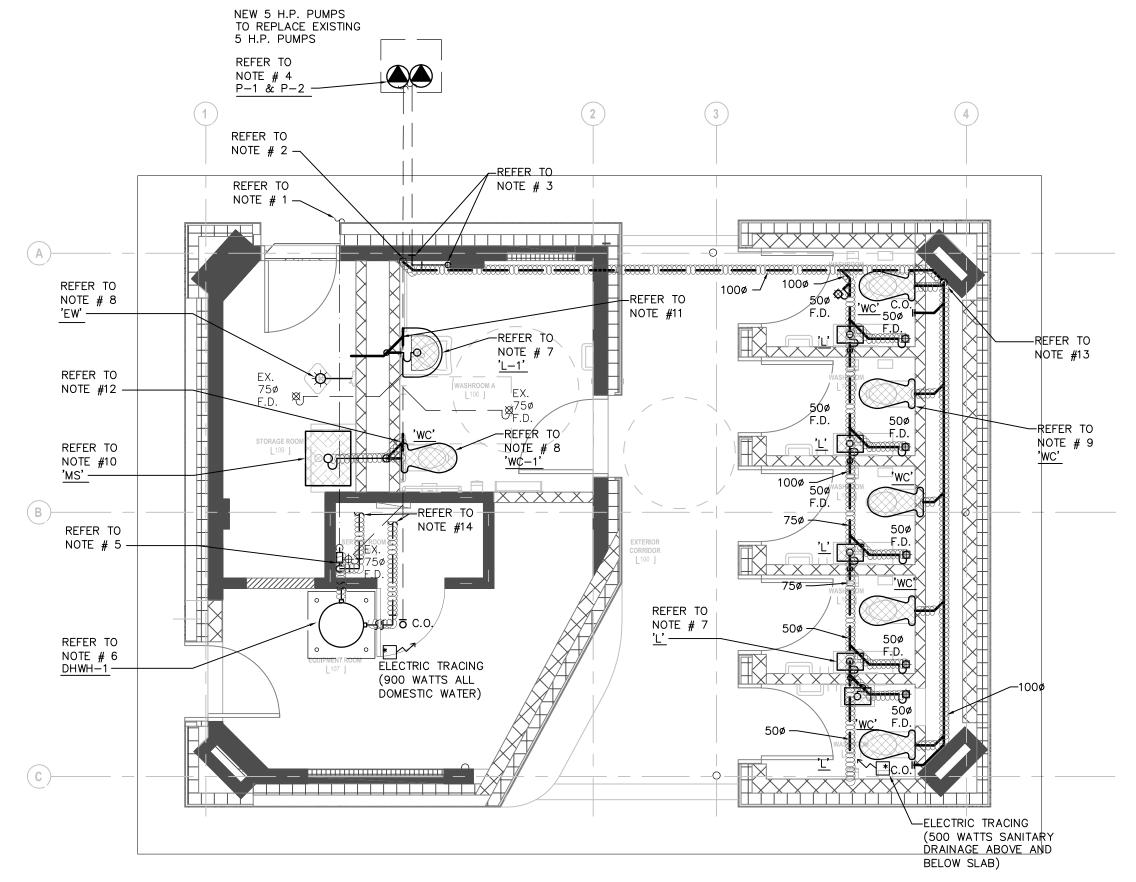
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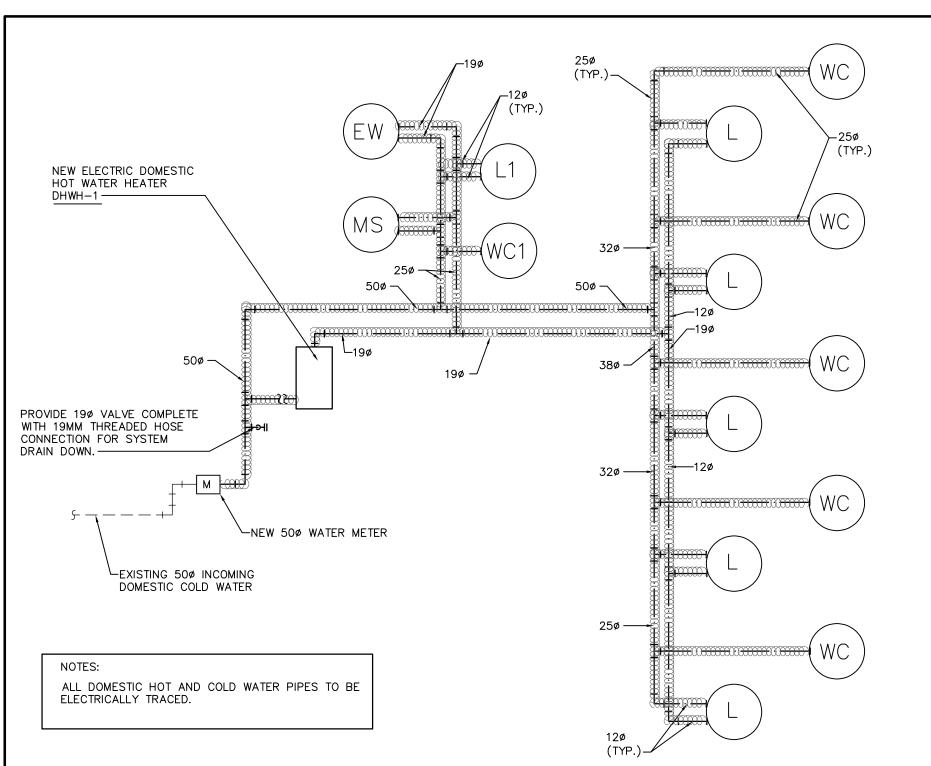
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GROUND FLOOR H.V.A.C. DEMOLITION LAYOUT

Drawing #:

TM-1.3





DOMESTIC WATER PIPING SCHEMATIC

EQUIPMENT	LIST	ELECTRIC DO	OMESTIC HOT	WATER HEA	ATER				
TAG	SERVICE	LOCATION	# ELEMENTS	kW/MBH	RECOVERY L/S-GPM	STORAGE	VOLTAGE	WEIGHT	REMARKS
DHWH-1	LAVATORIES/MOP SINK EYEWASH	EQUIP. RM 107	1	3.0/9.2	85.0/23.0	20 GAL.	208/1/60	276 LBS	A.O. SMITH DEL—20 SIDE CONNECTIONS REQUIRED

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- READ FLOOR PLANS IN CONJUNCTION WITH SCHEMATICS. ASSUME INFORMATION SHOWN ON FLOOR PLANS TO BE APPLICABLE TO THE RELATED SYSTEM SCHEMATIC AND VICE-VERSA TO PROVIDE
- VERIFY STRUCTURAL INTEGRITY OF ALL TEMPORARY AND PERMANENT OPENINGS. PROVIDE ADDITIONAL FRAMING TO ENSURE STRUCTURAL INTEGRITY AS REQUIRED. REFER TO DETAIL SHEETS AND STANDARD DETAILS FOR ADDITIONAL INFORMATION.

- 1. EXISTING INCOMING BURIED 500 DOMESTIC COLD WATER SERVICE TO
- 3. CONNECT NEW BURIED 500 VENT PIPE TO EXISTING INCOMING
- 5. PROVIDE AND INSTALL NEW 500 DOMESTIC COLD WATER METER, MODIFY PIPING AS REQUIRED, PROVIDE NEW PIPING AS INDICATED ON THE PIPING SCHEMATIC LOCATED ON THIS DRAWING.
- DOWN TO 500 BURIED SANITARY DRAIN BELOW SLAB.
- 8. 19¢ DOMESTIC HOT AND COLD WATER PIPES DOWN TO EYEWASH STATION, 38¢ VENT LINE UP FROM EYEWASH STATION AND 50¢ SANITARY DRAIN DOWN FROM EYEWASH STATION DOWN AND RUN BELOW FLOOR SLAB.
- 9. 25¢ DOMESTIC COLD WATER PIPE DOWN TO WATERCLOSET, 50¢ VENT LINE UP FROM WATERCLOSET, AND 750 SANITARY DRAIN FROM WATERCLOSET RUN IN WALL PRIOR TO DROPPING DOWN TO BELOW FLOOR SLAB. (TYPICAL)
- 380 VENT PIPE UP AND 500 SANITARY DRAIN FROM MOP SINK RUN BELOW FLOOR SLAB.
- 11. CONNECT NEW 500 SANITARY DRAIN TO EXISTING 1000 BURIED SANITARY PIPE.
- 12. CONNECT NEW 750 SANITARY DRAIN TO EXISTING 1000 BURIED SANITARY PIPE.
- 13. NEW 1000 SANITARY DRAIN PIPE DOWN TO BELOW FLOOR SLAB AND RUN BURIED AS INDICATED.
- 14. REFER TO DOMESTIC WATER PIPING SCHEMATIC THIS DRAWING FOR PIPE SIZES. ALL DOMESTIC WATER PIPING TO BE ELECTRICALLY TRACED AND INSULATED.
- 15. ALL NEW SANITARY DRAINAGE PIPING LOCATED ABOVE SLAB TO BE
- 16. PROVIDE NEW FLOOR DRAINS COMPLETE WITH TRAPS AND TRAP
- 17. ALL NEW SANITARY DRAINAGE ABOVE AND BELOW GRADE TO BE ELECTRICALLY TRACED, INCLUDING LAVATORY P TRAPS AND FLOOR

- DETERMINED THE EXACT LOCATIONS NECESSARY TO SECURE CONDITIONS. REVIEW ALL REVISIONS WITH THE CONSULTANT.
- A COMPLETE AND OPERATIONAL SYSTEM.

DRAWING NOTES:

- 2. CONNECT NEW 1000 BURIED SANITARY DRAIN DOWN AND CONNECT TO EXISTING 1000 BURIED SANITARY DRAIN.
- BURIED VENT AND EXTEND NEW 500 VENT PIPE UP THOUGH ROOF. 4. PROVIDE AND INSTALL NEW GRINDER DUPLEX PUMP SET COMPLETE WITH RAILS, FLOATS, CONTROLS ETC, ELECTRICAL CONNECTION BY ELECTRICAL DIVISION.
- 6. PROVIDE AND INSTALL NEW ELECTRIC DOMESTIC HOT WATER HEATER DHWH-1 COMPLETE WITH WALL SUPPORTS, HANGERS, BRACKETS, CONTROLS ETC. T&P RELIEF AND 250 DRAIN DOWN AND TERMINATE OVER FLOOR DRAIN IN SERVICE ROOM A 108. ELECTRICAL CONNECTION BY ELECTRICAL DIVISION.
- 7. 12¢ DOMESTIC HOT AND COLD WATER PIPES DOWN TO LAVATORY, 320 VENT LINE UP FROM LAVATORY, AND 320 SANITARY DRAIN

- 10. 120 DOMESTIC HOT AND COLD WATER PIPES DOWN TO MOP SINK,

- ELECTRICALLY TRACED AND INSULATED.
- DRAIN P TRAPS.

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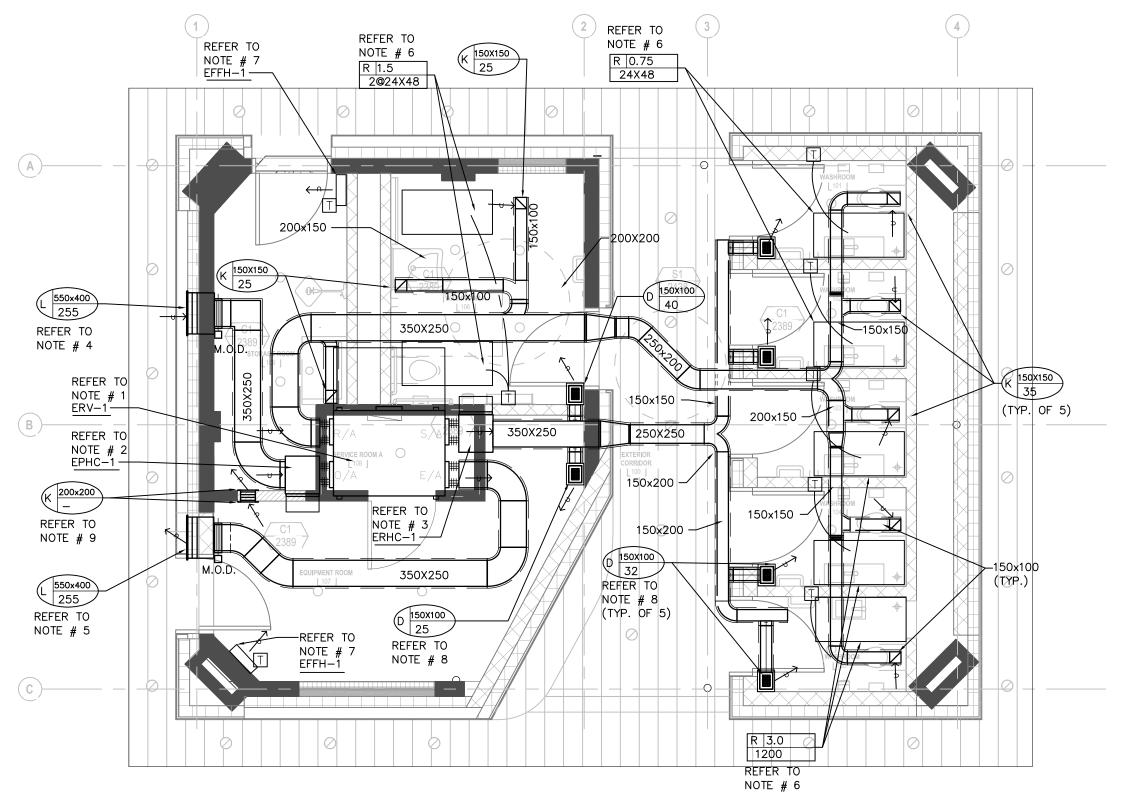
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GROUND FLOOR PLUMBING & DRAINAGE LAYOUT

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- REFER TO STANDARD DETAILS AND DETAIL SHEETS FOR ADDITIONAL INFORMATION.

DRAWING NOTES:

- 1. PROVIDE AND INSTALL ENERGY RECOVERY OUTSIDE AIR UNIT ERV-1 IN ATTIC SPACE, COMPLETE WITH ALL ASSOCIATED HANGERS, SUPPORTS, FLEXIBLE CONNECTIONS, THERMALLY LINED DUCTWORK, GRILLE, DIFFUSERS, CONDUIT, CONTROLS ETC. TO PROVIDE A COMPLETE AND FUNCTIONAL INSTALLATION. ELECTRICAL CONNECTION BY ELECTRICAL DIVISION.
- 2. PROVIDE AND INSTALL NEW ELECTRIC PRE—HEAT COIL EPHC—1 FOR INCOMING OUTSIDE AIR TO ENERGY RECOVERY UNIT COMPLETE WITH ALL ASSOCIATED HANGERS, SUPPORTS, CONDUIT, CONTROLS ETC. TO PROVIDE A COMPLETE AND FUNCTIONAL INSTALLATION. ELECTRICAL CONNECTION BY ELECTRICAL DIVISION.
- 3. PROVIDE AND INSTALL NEW ELECTRIC HEATING COIL EHC-1 FOR DISCHARGE AIR FROM ENERGY RECOVERY UNIT COMPLETE WITH ALL ASSOCIATED HANGERS, SUPPORTS, CONDUIT, CONTROLS ETC. TO PROVIDE A COMPLETE AND FUNCTIONAL INSTALLATION. ELECTRICAL CONNECTION BY ELECTRICAL DIVISION.
- 4. PROVIDE NEW 550X400 OUTSIDE AIR LOUVRE COMPLETE WITH THERMALLY INSULATED 550X400X400 INTAKE PLENUM. CONNECT NEW 350X250 OUTSIDE AIR DUCT TO PLENUM COMPLETE WITH MOTOR OPERATED DAMPED (M.O.D.). SEAL PLENUM WATER TIGHT AND SLOPE BOTTOM OF PLENUM TO OUTSIDE.
- 5. PROVIDE NEW 550X400 EXHAUST AIR LOUVRE COMPLETE WITH THERMALLY INSULATED 550X400X400 EXHAUST PLENUM. CONNECT NEW 350X250 EXHAUST AIR DUCT TO PLENUM COMPLETE WITH MOTOR OPERATED DAMPED (M.O.D.). SEAL PLENUM WATER TIGHT AND SLOPE BOTTOM OF PLENUM TO OUTSIDE.
- 6. PROVIDE AND INSTALL NEW ELECTRIC RADIANT CEILING PANELS COMPLETE WITH HANGERS CONDUIT AND CONTROLS. REFER TO DRAWING FOR LENGTH AND OUTPUT. ELECTRICAL CONNECTION BY ELECTRICAL DIVISION.
- RELOCATED EXISTING 3.0 KW FORCE FLOW HEATERS. PROVIDE ALL CONDUIT AND CONTROLS AS REQUIRED. ELECTRICAL CONNECTION BY ELECTRICAL DIVISION.
- 8. ACOUSTICALLY LINED 150X150X250 HIGH SUPPLY AIR PLENUM OVER TYPE 'D' CEILING REGISTER. CONNECT NEW 150X100 THERMALLY INSULATED DUCT TO SUPPLY AIR PLENUM. (TYPICAL).
- 9. PROVIDE TRANSFER AIR GRILLE DUCT TROUGH WALL AT HIGH LEVEL COMPLETE WITH WALL GRILLES ON BOTH SIDES.
- 10. ALL DUCTWORK IN ATTIC SPACE TOP BE 50mm THERMALLY INSULATED DUCTWORK.

EQUIPMENT	Γ LIST				100% OU	TSIDE AIR ERV										
						DESIGN OUTDOOR			DESIGN INDOOR		SUPPLY CONDITIONS					
NAME	SUPPLY	EXHAUST	EXT.SP (IN WC)	POWER	MROPD	EXH.SUM/WIN DBT (F°)	OA/SUM/WIN WBT (F°)	SUM/WIN R.H.	SUM/WIN DBT (F°)	R.H.	SUM/WIN DBT (F°)	SUM/WIN WBT (F°)	SUM/WIN RH %	SUM/WIN DEW POINT	SUM/WIN ENTHALPY BTU/LB	REMARKS
ERV-1	255 L/S	255 L/S	3.9"	208/1/60	15 AMP	75.0/-70.0	75.0/-4.0	50.0/35.0 %	75.0/72.0	50.0/35.0 %	81.6/47.0	69.1/37.2	52.6/12.9	54.0/36.0	31.1/13.9	OXYGEN8 A16IN

EQUIPMEN	T LIST			ELECTR	IC DUCT COILS
TAG	AIR FLOW	POWER	KILOWATTS	MOCP	REMARKS
EPHC-1	255 L/S	208/1/60	2.0	15 AMP	OXYGEN 8 PRE-HEAT COIL NOVA A16IDU INTEGRATED TO ERV CONTROLS
EHC-1	255 L/S	208/1/60	6.0	40 AMP	OXYGEN 8 PRE-HEAT COIL NOVA A16IDU INTEGRATED TO ERV CONTROLS
ELECTRIC	RADIANT P	I ANELS			
R		120/1/60	0.75	15 AMP	OUELLET 'AS2448-750-120' COMPLETE WITH LINE VOLTAGE RECESSED TEMPERATURE SENSOR WITH VANDAL PROOF SCREWS

SOCA STUDIO OF CONTEMPORARY ARCHITECTURE LAPTISTE ARCHITECTURE.

1137A Queen St. East Toronto, ON M4M 1K9 (437) 916-9272

PROJECT	CONTACT

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THIS DRAWING SHALL BE READ IN CONJUNCTION WITH MECHANICAL SPECIFICATION SUBMITTED FOR THIS PROJECT.



Smith + Andersen

1100 — 100 Sheppard Ave. East, Toronto On, M2N 6N5 416 487 8151 f 416 487 9104 smithandandersen.com

Lower Hillside Washroom Building Improvements

City of Toronto 1873 BLOOR ST W TORONTO, ON M6R 2Z3

Issue / Revision

No. Date Description

l .	110.	Date							
	1.	23/11/06	Issued	for	50% Tender Revie				
	2.	24/02/08	Issued	for	Permit / Tender				
	3.	24/08/07	Issued	for	Tender				

CONTRACTOR TO CHECK AND VERIFY ALL DIMENSIONS AT THE SITE.

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Project: 23210.001.ME

Drawn: S.G.

Checked: A.V.

Scale: 1:50

Date: 2023.04

GROUND FLOOR H.V.A.C. LAYOUT

Drawing #:

Sheet Title:

TM-3.1

SYMBOL	DESCRIPTION	SYMBOL	DESCRIPTION
	CEILING MOUNTED LINEAR LUMINAIRE. DIMENSIONS AS SHOWN. REFER TO SCHEDULE FOR TYPE.	÷	CEILING MOUNTED WALL WASHER LUMINAIRE. ILLUMINATION DIRECTION DENOTED BY HATCHED SIDE.
<i>'</i> ////////////////////////////////////	DENOTES FIXTURE ON EMERGENCY/NIGHT LIGHT CIRCUIT.	$\nabla \nabla \nabla$	CEILING MOUNTED TRACK LIGHTING C/W NUMBER OF FIXTURES.
Ş	WALL MOUNTED LINEAR LUMINAIRE. DIMENSIONS AS SHOWN. REFER TO SCHEDULE FOR TYPE.	ф	WALL MOUNTED LUMINAIRE
	CEILING MTD. LUMINAIRE OR BASKET LUMINAIRE. LAMP ORIENTATION AS SHOWN. REFER TO SCHEDULE FOR TYPE.	•	PENDANT FIXTURE
	EXISTING LUMINAIRE TO BE REMOVED	¢	CEILING MOUNTED LUMINAIRE
	EXISTING LUMINAIRE TO REMAIN	lacktriangle	FLOOR MOUNTED LUMINAIRE
	POLE MOUNTED LUMINAIRE. NUMBER OF HEADS SHOWN. REFER TO SCHEDULE FOR FIXTURE AND POLE TYPE.	 	TRACK LIGHT WITH PENDANT LUMINAIRE AS INDICATED
00000	CEILING MOUNTED LUMINAIRE WITH GIMBALLED HEADS. REFER TO SCHEDULE FOR TYPE AND NUMBER OF HEADS.	•	BOLLARD LUMINAIRE
모	VERTICAL WALL MOUNTED FLUORESCENT LUMINAIRE		
	CONTINUOUS STRIP LIGHT. REFER TO SCHEDULE FOR FIXTURE TYPE.		
	STAGGERED COVE LIGHT. DIMENSIONS AND NUMBER OF FIXTURES SHOWN. REFER TO SCHEDULE FOR FIXTURE TYPE.		
•	RECESSED CEILING MOUNTED REMOTE ADJUSTABLE LUMINAIRE CONNECTED TO EMERGENCY LIGHTING BATTERY UNIT.	B	EMERGENCY LIGHTING BATTERY UNIT C/W NUMBER OF HEADS SHOWN
Î	WALL MOUNTED EMERGENCY SINGLE REMOTE HEAD	B(P	EMERGENCY LIGHTING BATTERY UNIT
5.7	WALL MOUNTED EMERGENCY DOUBLE REMOTE HEAD	₹ <mark>X</mark>	EMERGENCY LIGHTING BATTERY + EXIT LIGHT COMBINATION UNIT C/W NUMBER OF HEADS SHOWN
↑	CEILING MOUNTED EMERGENCY SINGLE REMOTE HEAD	<u> </u>	EXIT LIGHT CEILING MOUNTED C/W FACES AND ARROWS AS INDICATED
<>	CEILING MOUNTED EMERGENCY DOUBLE REMOTE HEAD	₩	EXIT LIGHT WALL MOUNTED C/W FACES AND ARROWS AS INDICATED

NOTE: NOT ALL SYMBOLS APPLY, REFER TO FLOOR PLANS AND DRAWINGS

5 LIGHTING LEGEND 1 OF 2

SYMBOL	DESCRIPTION	SYMBOL	DESCRIPTION
\$	SINGLE POLE LINE VOLTAGE LIGHT SWITCH		
\$	2 GANG - LINE VOLTAGE LIGHT SWITCH		
#	3 GANG - LINE VOLTAGE LIGHT SWITCH		
\$ 3	3 WAY - LINE VOLTAGE LIGHT SWITCH		
\$ ⁴	4 WAY - LINE VOLTAGE LIGHT SWITCH		
\$ ^{LV}	LOW VOLTAGE LIGHT SWITCH		
 \$ ^K	KEY OPERATED LINE VOLTAGE SWITCH		
\$ ^{MS}	MASTER SWITCH		
\$ ^{AO}	ALL-OFF SWITCH		
\$	SINGLE POLE 347V SWITCH		
Φ	DIMMER TYPE TO SUIT LOAD		
PC	CEILING MOUNTED PHOTO CELL SWITCH		
PC	WALL MOUNTED PHOTO CELL SWITCH		
(DL)	DAY LIGHT PHOTO SENSOR		
K	TIME SWITCH		
(OS)'X'	CEILING MOUNTED OCCUPANCY SENSOR. TYPE DENOTED BY 'X'. REFER TO OCCUPANCY SENSOR SCHEDULE.		
OS 'X'	WALL MOUNTED OCCUPANCY SENSOR. TYPE DENOTED BY 'X'. REFER TO OCCUPANCY SENSOR SCHEDULE.		
LC	LIGHTING CONTROL MODULE		
DIM	MULTI-ZONE LIGHTING CONTROL PANEL		
RS	REMOTE STATION WITH PRESET SCENE SELECTION BUTTON		
IR	PARTITION POSITION INFRARED SENSOR FOR LIGHTING CONTROL		

6 LIGHTING LEGEND 2 OF 2

NOTE: NOT ALL SYMBOLS APPLY, REFER TO FLOOR PLANS AND DRAWINGS

SYMBOL	DESCRIPTION	SYMBOL	DESCRIPTION
φ	WALL MOUNTED DUPLEX RECEPTACLE 120 VOLT, 15 AMP, CSA 5-15R	₩.	WALL MOUNTED COMBINATION COMMS./ QUADPLEX RECEPTACLE 120 VOLT, 15 AMP, CSA 5-15R. REFER TO DETAIL.
Ø	WALL MOUNTED ABOVE COUNTER DUPLEX RECEPTACLE 120 VOLT, 15 AMP, CSA 5-15R		FLOOR OR CEILING MOUNTED (AS SHOWN) COMBINATION COMMUNICATION /
 	WALL MOUNTED DUPLEX RECEPTACLE 120 VOLT, 20 AMP, CSA 5-20R (T-SLOT)	₩7	QUADPLEX RECEPTACLE 120 VOLT, 15 AMP, CSA 5-15R. REFER TO CORRESPONDING DETAIL.
#	WALL MOUNTED ABOVE COUNTER DUPLEX RECEPTACLE 120 VOLT, 20 AMP, CSA 5-20R (T-SLOT)		FLOOR POKE THROUGH COMBINATION COMMUNICATION / QUADPLEX RECEPTACLE 120 VOLT, 15 AMP, CSA
P	WALL MOUNTED DUPLEX RECEPTACLE 120 VOLT, 15 AMP, CSA 5-15R, DEDICATED CIRCUIT		5-15R. REFER TO CORRESPONDING DETAIL.
•	WALL MOUNTED DUPLEX RECEPTACLE 120 VOLT, 20 AMP, CSA 5-20R, DEDICATED CIRCUIT		FLOOR POKE THROUGH AS ABOVE WITH AUDIO/VISUAL REQUIREMENT. REFER TO DETAIL.
Φ	WALL MOUNTED, SPLIT SWITCH CONTROLLED DUPLEX RECEPTACLE 120 VOLT, 15 AMP, CSA 5-15R	Φ ⊅	WALL MOUNTED COMBINATION COMMS./ DUPLEX RECEPTACLE 120 VOLT, 15 AMP, CSA 5-15R. REFER TO DETAIL.
₩	WALL MOUNTED DUPLEX GROUND FAULT RECEPTACLE 120 VOLT, 15 AMP, CSA 5-15R		FLOOR OR CEILING MOUNTED (AS SHOWN) COMBINATION COMMUNICATION / DUPLEX RECEPTACLE 120 VOLT, 15 AMP,
#	WALL MOUNTED ABOVE COUNTER DUPLEX GROUND FAULT RECEPTACLE 120 VOLT, 15 AMP, CSA 5-15R	₽	CSA 5-15R. REFER TO CORRESPONDING DETAIL.
₩	WALL MOUNTED DUPLEX GROUND FAULT RECEPTACLE 120 VOLT, 20 AMP CSA 5-20R		FLOOR POKE THROUGH COMBINATION COMMUNICATION / DUPLEX RECEPTACLE 120 VOLT, 15 AMP, CSA 5-15R. REFER
#	WALL MOUNTED ABOVE COUNTER DUPLEX GROUND FAULT RECEPTACLE 120 VOLT, 20 AMP CSA 5-20R		TO CORRESPONDING DETAIL. FLOOR POKE THROUGH AS ABOVE WITH
#	WALL MOUNTED QUADPLEX RECEPTACLE 120 VOLT, 15 AMP, CSA 5-15R		AUDIO/VISUAL REQUIREMENT. REFER TO DETAIL.
•	WALL MOUNTED DUPLEX RECEPTACLE 120 VOLT, 15 AMP, 2 POLE, SPLIT CIRCUIT		SYSTEMS FURNITURE FEED POINT FOR POWER & COMMS. CABLING. LETTER
P	WALL MOUNTED ABOVE COUNTER DUPLEX RECEPTACLE 120 VOLT, 15 AMP, 2 POLE, SPLIT CIRCUIT		DENOTES FEED LOCATION: W= WALL, F= FLOOR, P= PAC POLE, WM = WIREMOLD
Ψ	WALL MOUNTED SIMPLEX RECEPTACLE 250 VOLT, 15 AMP, 3Ø CSA 15-15R	ф	CEILING MOUNTED DUPLEX RECEPTACLE 120 VOLT, 15 AMP, CSA 5-15R
φ	SPECIAL RECEPTACLE. TYPE AND DETAILS AS NOTED ON DRAWING.	Ф	CEILING MOUNTED SIMPLEX RECEPTACLE 120 VOLT, 15 AMP, CSA 5-15R
Ø	WALL MOUNTED ABOVE COUNTER SIMPLEX RECEPTACLE 120 VOLT, 15 AMP, CSA 5-15R	\$	CEILING MOUNTED QUADPLEX RECEPTACLE 120 VOLT, 15 AMP, CSA 5-15R
*	WALL MOUNTED SIMPLEX RECEPTACLE 120 VOLT, 20 AMP, CSA 5-20R		FLOOR MOUNTED DUPLEX RECEPTACLE 120 VOLT, 15 AMP, CSA 5-15R
•	WALL MOUNTED SIMPLEX RECEPTACLE 250 VOLT, 30 AMP, CSA 14-30R		FLOOR MOUNTED QUADPLEX RECEPTACLE 120 VOLT, 15 AMP, CSA 5-15R
φ	WALL MOUNTED SIMPLEX RECEPTACLE 120 VOLT, 30 AMP, CSA 5-30R	<u> </u>	RACEWAY RECEPTACLE, TYPE AS SPECIFIED C/W QUANTITY OF DEVICES INDICATED
•	WALL MOUNTED SIMPLEX RECEPTACLE 250 VOLT, 50 AMP, CSA 14-50R	0■0	SERVICE POLE, TYPE AS SPECIFIED C/W QUANTITY OF DEVICES INDICATED

NOTE: NOT ALL SYMBOLS APPLY, REFER TO FLOOR PLANS AND DRAWINGS

3 TE-0.1 POWER LEGEND 1 OF 2

POWER LEGEND 2 OF 2

SYMBOL	DESCRIPTION	SYMBOL	DESCRIPTION
	FLUSH MOUNTED SINGLE TUB PANEL. RATING AS NOTED ON SINGLE LINE/PANEL SCHEDULE.	©	CONTACTOR
	FLUSH MOUNTED DOUBLE TUB PANEL RATING AS NOTED ON SINGLE LINE/PANEL SCHEDULE.	P	GROUND ROD WITH INSPECTION PIT
	SURFACE MOUNTED SINGLE TUB PANEL. RATING AS NOTED ON SINGLE LINE/PANEL SCHEDULE.	T	THERMOSTAT-16mm (1/2") CONDUIT TO ACCESSIBLE CEILING SPACE
	SURFACE MOUNTED DOUBLE TUB PANEL. RATING AS NOTED ON SINGLE LINE/PANEL SCHEDULE.	JB	JUNCTION BOX (SIZE SPECIFIED ON DRAWING)
\boxtimes	TRANSFORMER (SIZE NOTED ON SINGLE LINE DIAGRAM)		ELECTRIC UNIT HEATER
ㅁ	DISCONNECT	X	ELECTRIC BASEBOARD HEATER. 'X' DENOTES TYPE. REFER TO BASEBOARD HEATER SCHEDULE.
ď	COMBINATION MANUAL STARTER WITH INTEGRAL DISCONNECT	▽ ▽	GROUND BAR
Z Y	COMBINATION STARTER WITH INTEGRAL DISCONNECT	HD	HAND DRYER HARD WIRED CONNECTION
(A)	DIRECT CONNECTION	М	METER
	DIRECT CONNECTION C/W DISCONNECT	R	RELAY
	MOTOR AND DISCONNECT	РВ	PULL BOX
	MOTOR AND RELAY DISCONNECT DISCONNECT	•———• •———•	GROUND BUS
	MOTOR AND COMBINATION STARTER WITH INTEGRAL DISCONNECT		DENOTES RECEPTACLE TYPE. REFER TO RECEPTACLE SCHEDULE.
	VARIABLE FREQUENCY DRIVE AND VFD CABLE CONNECTION TO MOTOR. LINE AND		UTILITY METERING CABINET
	LOAD SIDE WIRING OF HARMONIC FILTER AND VFD BY ELECTRICAL CONTRACTOR. MOTOR, VFD AND HARMONIC FILTER	\Box	DOOR BELL/CHIME
	SUPPLIED BY MECHANICAL DIVISION.	Φ	CLOCK WALL MOUNTED
	VARIABLE FREQUENCY DRIVE. LINE AND	(CLOCK CEILING MOUNTED
VFD	LOAD SIDE WIRING OF HARMONIC FILTER AND VFD BY ELECTRICAL CONTRACTOR, LOAD SIDE WIRING OF VFD TO BE VFD	·	PUSH BUTTON
	CABLE. VFD AND HARMONIC FILTER SUPPLIED BY MECHANICAL DIVISION.	NÒ	MOTOR
HF	HARMONIC FILTER (SUPPLIED BY MECH. CONTRACTOR UNLESS NOTED		
ПГ	OTHERWISE.) LINE AND LOAD SIDE WIRING OF HARMONIC FILTER BY ELECTRICAL CONTRACTOR.		

DRAWING No. DRAWING NAME

TE-0.1 DRAWING LIST AND LEGENDS

TE-0.2 ELECTRICAL DETAILS

TE-0.3 ELECTRICAL DETAILS

TE-1.1 GROUND FLOOR ELECTRICAL LAYOUT

TE-1.2 GROUND FLOOR ELECTRICAL DEMOLITION LAYOUT

CLOSEOUT DOCUMENT CHECKLIST

ELECTRICAL CONTRACTOR SHALL PROVIDE THE FOLLOWING DOCUMENTS TWO (2) DAYS PRIOR TO OCCUPANCY:

- ESA CERTIFICATE
 (NOTING ALL NEW DEVICE TYPES AND QUANTITIES TESTED)
- NOTING ALL NEW DEVICE TYPES AND QUANTITIES TESTE
- EMERGENCY LIGHTING LETTER

 (LETTER SHALL STATE EMERGENCY LIGHTING HAS BEEN INSTALLED IN ACCORDANCE WITH CONTRACT DOCUMENTS AND LATEST EDITION OF THE ONTARIO BUILDING CODE SECTIONS [3.2.7.3 AND 3.2.7.4].)
- CHAIN HUNG LIGHTING LETTER

 (WRITTEN CONFIRMATION ALL NEW AND RELOCATED CEILING LIGHTING FIXTURES HAVE BEEN SUPPORTED FROM THE STRUCTURE INDEPENDENT FROM SUSPENDED CEILING)

1 GENERAL AND SYMBOLS AND ABBREVIATIONS

SYMBOL	DESCRIPTION	SYMBOL	DESCRIPTION			
6	DETAIL NUMBER	12	SECTION NUMBER			
E-01	DRAWING NUMBER	E-01	DRAWING NUMBER			
	REVISION NUMBER		REVISION BUBBLE			
A	AMPS	MO	MOTOR OPERATED			
AD	ACCESS DOOR	MOD	MOTOR OPERATED DAMPER			
AFCI	ARC FAULT CIRCUIT INTERRUPTER	MW	MICROWAVE			
AFF	ABOVE FINISHED FLOOR BASEBOARD HEATER	N NC	NEW NORMALLY CLOSED			
BBH BU	BATTERY UNIT	NC NIC	NORMALLY CLOSED NOT IN CONTRACT			
С	CONDUIT	NL NL	NIGHT LIGHT			
CD	CANDELA	NO	NORMALLY OPEN			
CL	CEILING MOUNTED	OC	OVER COUNTER			
CS	CHARGING STATION	OL	OBSTRUCTION LIGHT			
CV	CONVENTIONAL STYLE DEVICE	P	PARABOLIC LOUVRE			
D	DEDICATED	PL	PATIENT LIFT			
DG	DEDICATED GROUND	R	RELOCATE			
DHWT	DOMESTIC HOT WATER TANK	RA	RANGE			
DNC	DEDICATED NEUTRAL + BOND	RC	REVISE EXISTING CIRCUIT			
DR	LAUNDRY DRYER	RH	RANGE HOOD			
DW	DISHWASHER	RIC	ROUGH IN AND CONNECT			
E	EXISTING	RO	ROUGH IN ONLY			
EF	EXHAUST FAN	RR	REMOVE AND REINSTALL			
EM	EMERGENCY CIRCUIT	SC	SEPARATE CIRCUIT			
EP	ELECTRICAL SUITE PANEL	SF	SYSTEM FURNITURE			
ER	EXISTING TO BE REMOVED	SP	SUITE ALARM PANEL			
F	REFRIGERATOR	SSP	SLAVE SUITE ALARM PANEL			
FF	FLOOR FEED	TYP	TYPICAL			
FFH	FORCE FLOW HEATER	UC	UNDER CABINET MOUNTED			
FL	FLOOR MOUNTED	U	UPS CIRCUIT			
GFCI	GROUND FAULT CIRCUIT INTERRUPTER	UH	UNIT HEATER			
GFI	GROUND FAULT INTERRUPTER	UPS	UNINTERRUPTIBLE POWER SUPPLY			
GND	GROUND	V	VOLTS			
HK	HOUSE KEEPING	W	WATTS			
HMT	HARMONIC MITIGATING TRANSFORMER	WG	WIRE GUARD			
IG	ISOLATED GROUND	WAP	WALL FEED			
JB	JUNCTION BOX	WP	WEATHERPROOF			
KW	KILOWATTS	X	EXPLOSION PROOF DEVICE + BACK BOX			
LV	LOW VOLTAGE	ZSCT	ZERO SEQUENCE CURRENT TRANSFORMER			
NOTE: NOT AL	L SYMBOLS APPLY, REFER TO FLOOR PLANS AND DRA	WINGS				

SOCA STUDIO OF CONTEMPORARY ARCHITECTURE LAPTISTE ARCHITECTURE

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THIS DRAWING SHALL BE READ IN CONJUNCTION WITH ELECTRICAL SPECIFICATION SUBMITTED FOR THIS PROJECT.



Smith + Andersen

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Lower Hillside Washroom Building Improvements
City of Toronto

1873 BLOOR ST W TORONTO, ON M6R 2Z3

Issue / Revision

04	0000 44 00	IOOUED FOR FOW DEVIEW
01	2023-11-03	ISSUED FOR 50% REVIEW
02	2024-02-08	ISSUED FOR PERMIT/TENDER
03	2024-08-07	ISSUED FOR TENDER

CONTRACTOR TO CHECK AND VERIFY ALL DIMENSIONS AT THE SITE.

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Project: 23210.001.ME

Drawn: J.B.

Checked: W.Y.C./N.C.

Scale: N.T.S.


Date: 2023.04

DRAWING LIST AND LEGENDS

Drawing #:

Sheet Title:

TE-0.1

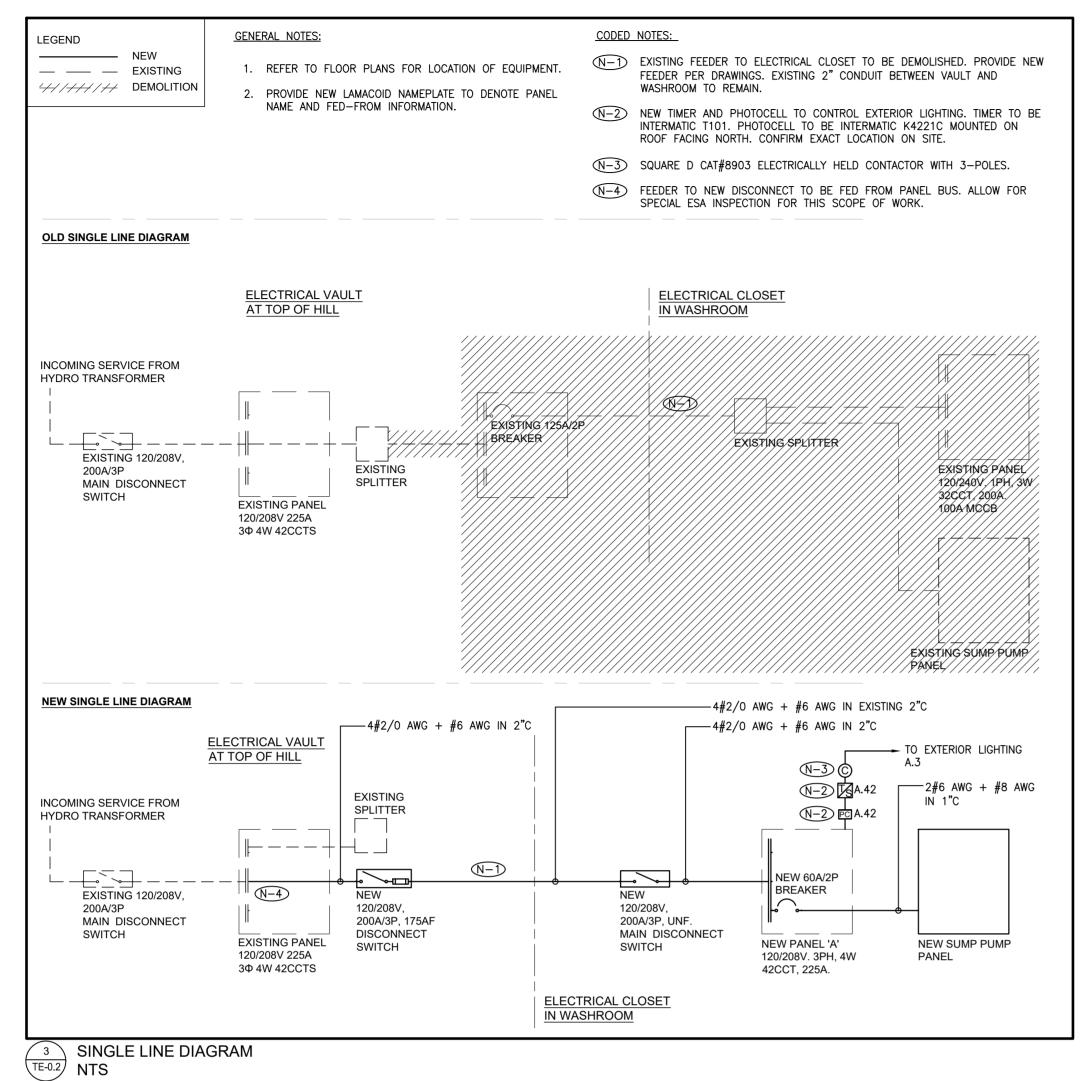

APPROXIMATE LOCATION - OF UNDERGROUND VAULT AT TOP OF HILL

LOCATION OF EXISTING

WASHROOM

4 PARTIAL KEYPLAN NTS

BARRIER FREE/UNIVERSAL WASHROOM SCHEMATIC AND FLOOR PLAN

INSIDE

DRY CONTACT ALARM

ANNUNCIATION TO

SECURITY.

PUSH TO LOCK

DOOR OPERATOR

WASHROOM

ELECTRIC LOCK

- SIGNAGE

N-7

BUTTON, AUDIBLE,

AND VISUAL SIGNAL DEVICE

COMBINED EMERGENCY PUSH | N-8 OUTSIDE

WASHROOM

AUTOMATIC DOOR

OPERATOR

PUSH TO —

LOCK

ADO

N-5

ASSISTANCE

REQUIRED

بغ

SIGN

N-4 1 ZD


ARS (N-5)


 \mathbb{Q} \mathbb{N}^{-4}

PIEZO

CHIME

DOOR OPERATOR

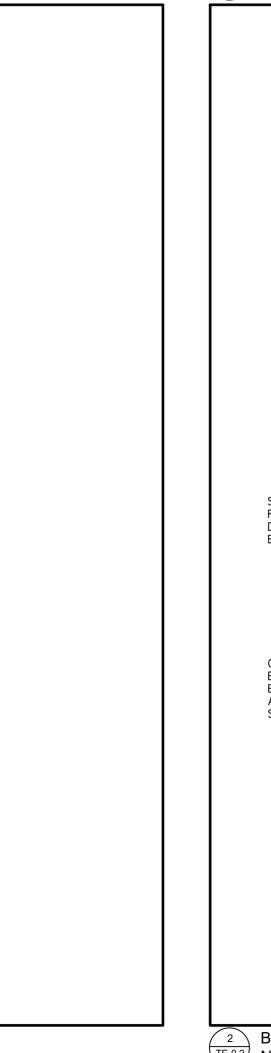

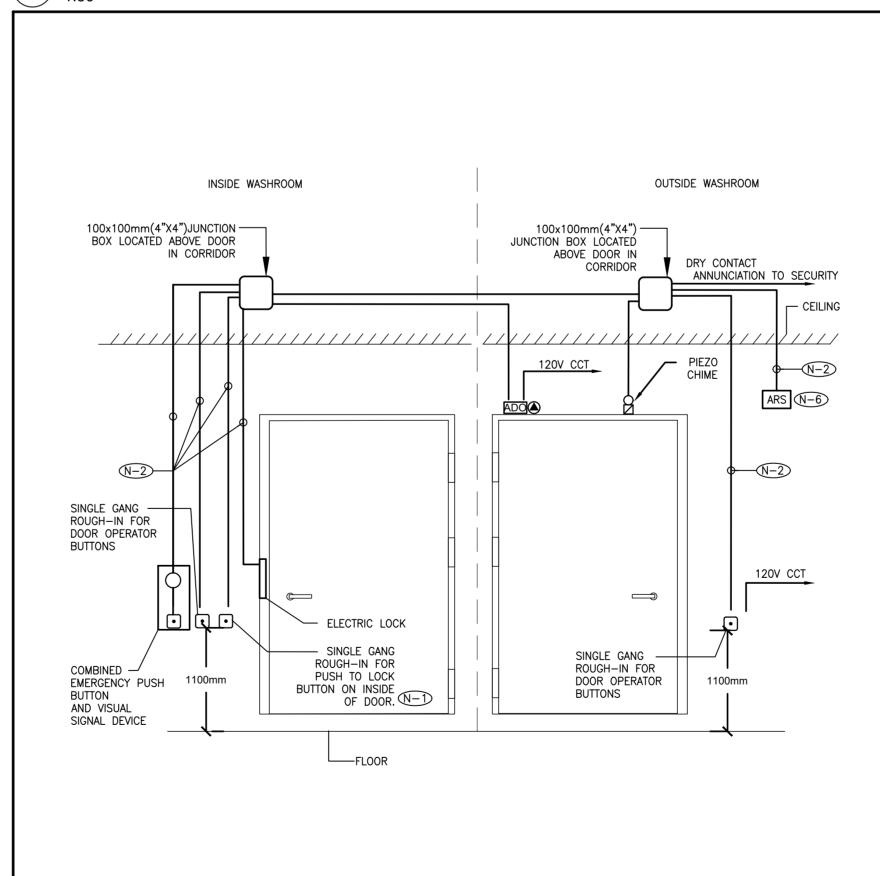

N-1 PROVIDE ROUGH-IN FOR PUSH PADDLES, DOOR OPENER, ELECTRIC STRIKE, AND JUNCTION BOX COMPLETE WITH EMT AND BLANK COVERPLATES. EQUIPMENT TO BE SUPPLIED AND INSTALLED

N-2 3/4" CONDUIT

N-3 REFER TO ARCHITECTURAL DRAWINGS FOR EXACT LOCATIONS OF PUSH BUTTONS.

N-7 REFER TO ARCHITECTURAL DRAWING FOR FINAL DEVICE LOCATION.

N-4) ALL DEVICES ARE BY OTHERS.

N-5 WIRING FOR ALL DEVICES SUPPLIED BY OTHERS, INSTALLED BY THIS CONTRACTOR.

N-6 ASSISTANCE REQUIRED SIGN.

BARRIER FREE/UNIVERSAL WASHROOM DOOR DETAIL

TE-0.2 N.T.S.

<u>NOTES</u>

- MINIMUM SIZE CONDUITS SHALL BE 21mmC (3/4") UNLESS OTHERWISE NOTED.
- N-2 ALL PUSH BUTTONS ARE TO BE MOUNTED AT 1050mm ABOVE FINISHED FLOOR AND ARE TO BE OPERABLE USING A CLOSED FIST.
- N-3 ELECTRICAL CONTRACTOR TO PROVIDE AND INSTALL COMBINATION EMERGENCY PUSH BUTTON AND VISUAL SIGNAL DEVICE INSIDE OF WASHROOM, INTEGRAL VISUAL DEVICE TO ACTUATE WHEN EMERGENCY BUTTON IS PRESSED. EMERGENCY BUTTON TO BE MUSHROOM STYLE AND LATCHING TYPE, SUCH THAT VISUAL INDICATION WILL REMAIN ACTIVATED ONCE PRESSED, MUSHROOM STYLE BUTTON TO BE TWIST-TO-RELEASE TYPE TO ALLOW EASE OF TURNING OFF VISUAL INDICATION AFTER WASHROOM OCCUPANT HAS BEEN ASSISTED. PUSH BUTTON TO ALSO ILLUMINATE SPECIAL WORDING SIGNAGE AND ACTIVATE PIEZO CHIME, BUILT AND LOCATED OUTSIDE OF THE WASHROOM. PUSH BUTTON & VISUAL ALARM COMPONENTS TO BE MOUNTED ON STAINLESS STEEL FACEPLATE.

MOUNT COMBINATION DEVICE SUCH THAT THE CENTRE OF THE PUSHBUTTON IS LOCATED AT 1050mm ABOVE FINISHED FLOOR. INTEGRAL VISUAL DEVICE TO BE LIT BY AN LED SOURCE. COMBINATION DEVICE TO BE 24 VOLT DC STYLE FOR EASY INTEGRATION WITH WASHROOM DOOR ELECTRIC STRIKE. WASHROOM DOOR ELECTRIC STRIKE TO BE RELEASED WHEN EMERGENCY BUTTON IS PRESSED TO ALLOW MANUAL ACCESS TO WASHROOM TO PROVIDE ASSISTANCE. DOOR OPERATOR IS NOT TO OPEN DOOR WHEN EMERGENCY BUTTON IS PRESSED.

SUBMIT SHOP DRAWINGS FOR ARCHITECT AND CONSULTANT REVIEW PRIOR TO MANUFACTURING/RELEASE.

- N-4 ELECTRICAL CONTRACTOR TO PROVIDE AND INSTALL PIEZO CHIME OUTSIDE OUTSIDE OF THE WASHROOM, WHEN THE EMERGENCY BUTTON IS PRESSED. THE PIEZO CHIME IS TO SOUND. CHIME OUTSIDE OF WASHROOM TO HAVE SOUND PRESSURE LEVEL OF 82 DBA AT 3 METERS. CHIME TO BE 24 VOLT DC TYPE. SUBMIT SHOP DRAWINGS OF PIEZO CHIME FOR ARCHITECT AND CONSULTANT REVIEW PRIOR TO MANUFACTURING/RELEASE.
- N-5) ELECTRICAL CONTRACTOR TO PROVIDE AND INSTALL 'ASSISTANCE REQUIRED' COMPLETE WITH WHEELCHAIR GRAPHIC SPECIAL WORDING SIGNAGE OUTSIDE OF THE WASHROOM. WHEN THE EMERGENCY BUTTON IS PRESSED, THE SIGN IS TO ILLUMINATE. SIGN TO BE 24 VOLT DC TYPE. SUBMIT SHOP DRAWINGS FOR ARCHITECT AND ELECTRICAL CONSULTANT REVIEW PRIOR TO MANUFACTURING/RELEASE. ILLUMINATED SIGN TO BE EMERGI-LITE OR APPROVED EQUAL.
- N-6 ELECTRICAL CONTRACTOR TO PROVIDE ALL CONDUIT, WIRING, POWER SUPPLIES, AND CONNECTIONS DETAILED ABOVE FOR ALL UNIVERSAL WASHROOMS. ALL WIRING TO BE INSTALLED IN CONDUIT.
- N-7) ELECTRICAL CONTRACTOR TO PROVIDE AND INSTALL A LAMACOID SIGN ABOVE THE EMERGENCY BUTTON THAT READS "IN THE EVENT OF AN EMERGENCY PUSH EMERGENCY BUTTON AND AUDIBLE AND VISUAL SIGNAL WILL ACTIVATE". LETTERS ON LAMACOID MUST BE AT LEAST 25mm HIGH WITH A 5mm STROKE. SUBMIT SHOP DRAWING FOR ARCHITECT AND CONSULTANT REVIEW PRIOR TO MANUFACTURING AND RELEASE.
- (N-8) ELECTRICAL CONTRACTOR TO PROVIDE AND INSTALL 24 VOLT DC POWER SUPPLY IN A SEPARATE JUNCTION BOX WITH SUFFICIENT CAPACITY TO POWER ALL EMERGENCY CALL SYSTEM COMPONENTS INCLUDING ALL AUDIBLE AND VISUAL INDICATORS AS WELL AS DOOR ELECTRIC STRIKE RELEASE. ADDITIONALLY, POWER SUPPLY TO HAVE 50% SPARE CAPACITY FOR FUTURE USE. POWER SUPPLY INPUT TO BE 120V.
- N-9 NOT USED.
- NEW 20A, GFI RECEPTACLE FOR ADULT CHANGE TABLE, PROVIDE CIRCUIT FROM NEAREST AVAILABLE BASE-BUILDING PANEL.
- (N-11) REFER TO ARCHITECTURAL DRAWINGS FOR EXACT DEVICE LOCATIONS.

STUDIO SOCA CONTEMPORARY ARCHITECTURE LAPTISTE ARCHITECTURE INC.

1137A Queen St. East Toronto, ON M4M 1K9 (437) 916-9272

PROJECT CONTACT

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HIS DRAWING SHALL BE READ IN CONJUNCTION WITH ELECTRICAL SPECIFICATION SUBMITTED FOR



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1100 - 100 Sheppard Ave. East, Toronto On, M2N 6N5

Lower Hillside Washroom Building Improvements City of Toronto

1873 BLOOR ST W TORONTO, ON M6R 2Z3

Issue / Revision

2024-08-07

No. Date Description 2023-11-03 ISSUED FOR 50% REVIEW ISSUED FOR PERMIT/TENDER

ISSUED FOR TENDER

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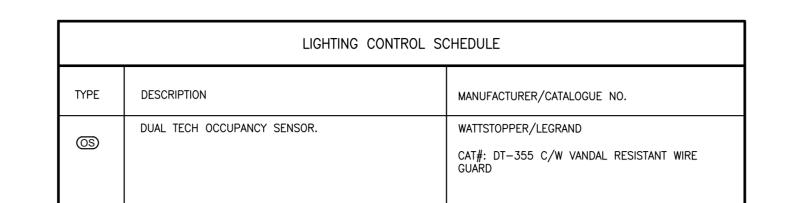
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ELECTRICAL DETAILS

Drawing #:

TE-0.2



	EMERGENCY LIGHTING SCHEDULE								
TYPE	DESCRIPTION	MANUFACTURER/CATALOGUE NO.							
B B B	EMERGENCY BATTERY UNIT	LUMACELL CAT#: RG12S-200							
R1	VANDAL RESISTANT EMERGENCY REMOTE HEAD	LUMACELL CAT#: MQMP2NX-LD10-X-SM							

	LUMINAIRE SCHEDULE								
TYPE	LAMP	VOLTAGE	DESCRIPTION	MANUFACTURER/CATALOGUE NO.					
	TYPE								
1 A	LED	120V	EXTERIOR VANDAL RESISTANT DOWNLIGHT	BEGA					
-ф^				24 136					
	LED	120V	INTERIOR VANDAL RESISTANT DOWNLIGHT	BEGA					
ტ₿			DOMNEIST.	24 330					

NOTES:

N-1 THE CONTRACTOR SHALL COORDINATE WITH THE ARCHITECT FOR ALL MOUNTING HEIGHTS, COLOR TEMPERATURES, AND FINISHED COLOURS PRIOR TO PROCUREMENT.

3 LUMINAIRE/LIGHTING CONTROL SCHEDULE 1 PANEL

LOCATION: SERVICE ROOM A ROJECT NAME: HIGH PARK HILLSIDE WASHROOM RENO Smith + Andersen ROJECT #: 23210.001.E.001 FED FROM: ELECTRICAL VAULT
 D.F
 CONN.
 DEMAND
 BKR
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 DESCRIPTION 100 480 480 15 1 A 2 15 100 200 50 STORAGE GFI | 100 | 560 | 560 | 15 | 3 | B | 4 | 20 | 50 | 100 | 50 | SERVICE ROOM OUTLET |
100	900	900	15	5	C	6	15	150	300	50	AUTOMATIC DOOR OPENER/EM CALL SYS
100	500	500	15	7	A	8	20	50	500	10	WASHROOM ADULT CHANGE TABLE
111	C	12	20	750	1500	50					
120	750	750	750	750	750	750	750				
131	A	14	2P	750	1500	50					
141	C	18	2P	750	1500	50					
150	750	750	750	750	750	750	750				
150	750	750	750	750	750	750	750				
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 20
 35
 C
 36
 15
 275
 550
 50
 ERV-1

 50
 1500
 750
 20
 37
 A
 38
 2P
 275
 550
 50

 50
 4056
 2028
 60
 39
 B
 40
 15
 100
 100
 100
 BAS
 RADIANT PANEL (101, 102) RADIANT PANEL (106) SUMP PUMP 50 4056 2028 2P **41 C 42** 15 100 100 100 CONTACTOR/TIMER PANEL OPTIONS: LOAD A [KW]: 5.63 PHASE VOLTAGE [V]: LINE VOLTAGE [V]: LOAD B [KW]: 6.99 2 ·CSA FNCLOSURE RATING FLUSH FEED THROUGH SURFACE LOAD C [KW]: 6.35 BOLT-ON BREAKER TOTAL [KW]: SUB-FEED MAIN BREAKER MAINS [A]: 200% RATED NEUTRAL BUS URRENT A [A]: 47 MAIN BREAKER [A]: ISOLATED GROUND BUS CURRENT B [A]: 58 CURRENT C [A]:

BAS-Building Automation System

R.C-Relay Controlled

LTS-Lighting

GFCI-Ground Fault Circuit Interrupter

M-Motor

HID-High Intensity Discharge
Lighting Breaker

D.F-Demand Factor

SPD - Surge Protection Device

REC-Receptacle

D.C-Direct Connection

NOTES:

1. Surge Protection Device (SPD) to be in a separate barriered enclosure with separate cover.

Lighting Breaker

D.C-Direct Connection

PANEL A SCHEDULE

BATTERY UNIT LOAD SCHEDULE

PROJECT NAME: LOWER HILLSIDE WASHROOM BUILDING IMPROVEMENTS

PROJECT #: 23210.001.E.001

Smith + Andersen
Suite 1100 - 100 Sheppard Ave. E.
Toronto, ON M2N 6N5

							TOTOTILO, ON IVEN	CVIOI	
									LENGTH OF
UNIT	LOCATION				TOTAL		TOTAL	MAXIMUM	RUNTIME
DESIGNATION	OF BATTERY UNIT	TYPE	QUANTITIES	WATTAGE	LOAD	VOLTAGE	CAPACITY	CAPACITY (W)	REQUIRED (hr
BU-1	SERVICE	R1	10	12 W	120 W	12 V	120 \//	200 W/	0.5
BO-1	ROOM A 108						120 W	200 W	0.5

NOTES:

1. Provide all mounting shelves for installation of battery units. Size to suit.

2. Provide breaker lock-on devices for all circuit(s) feeding battery units.

3. The electrical contractor is to measure the illumination of the floor at night with emergency lighting on only, and send a drawing showing the maximum and minimum level of illumination, to the consulting engineer, for review. Provide written confirmation that emergency lighting has been installed in accordance with contract documents and latest edition of the Ontario Building Code sections [3.2.7.3 and 3.2.7.4]. Letter to be included as part of close-out document submittal package.

4. Refer to drawings for exact Quantities and locations.

BATTERY UNIT LOAD SCHEDULE

SOCA STUDIO
OF
CONTEMPORARY
ARCHITECTURE
LAPTISTE ARCHITECTURE INC.

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Lower Hillside Washroom Building Improvements
City of Toronto

1873 BLOOR ST W TORONTO, ON M6R 2Z3

Issue / Revision

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Drawn: J.B.

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Scale: N.T.S.


Date: 2023.04


ELECTRICAL DETAILS

Drawing #:

Sheet Title:

TE-0.3

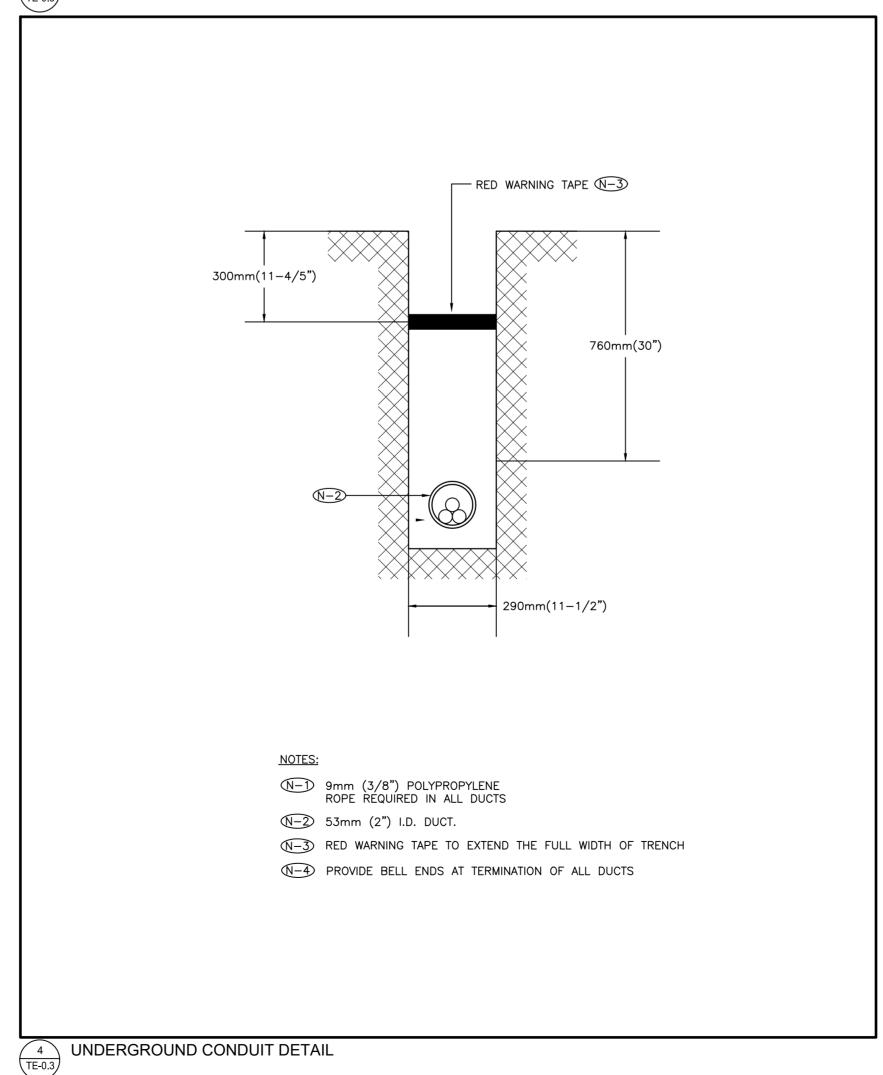

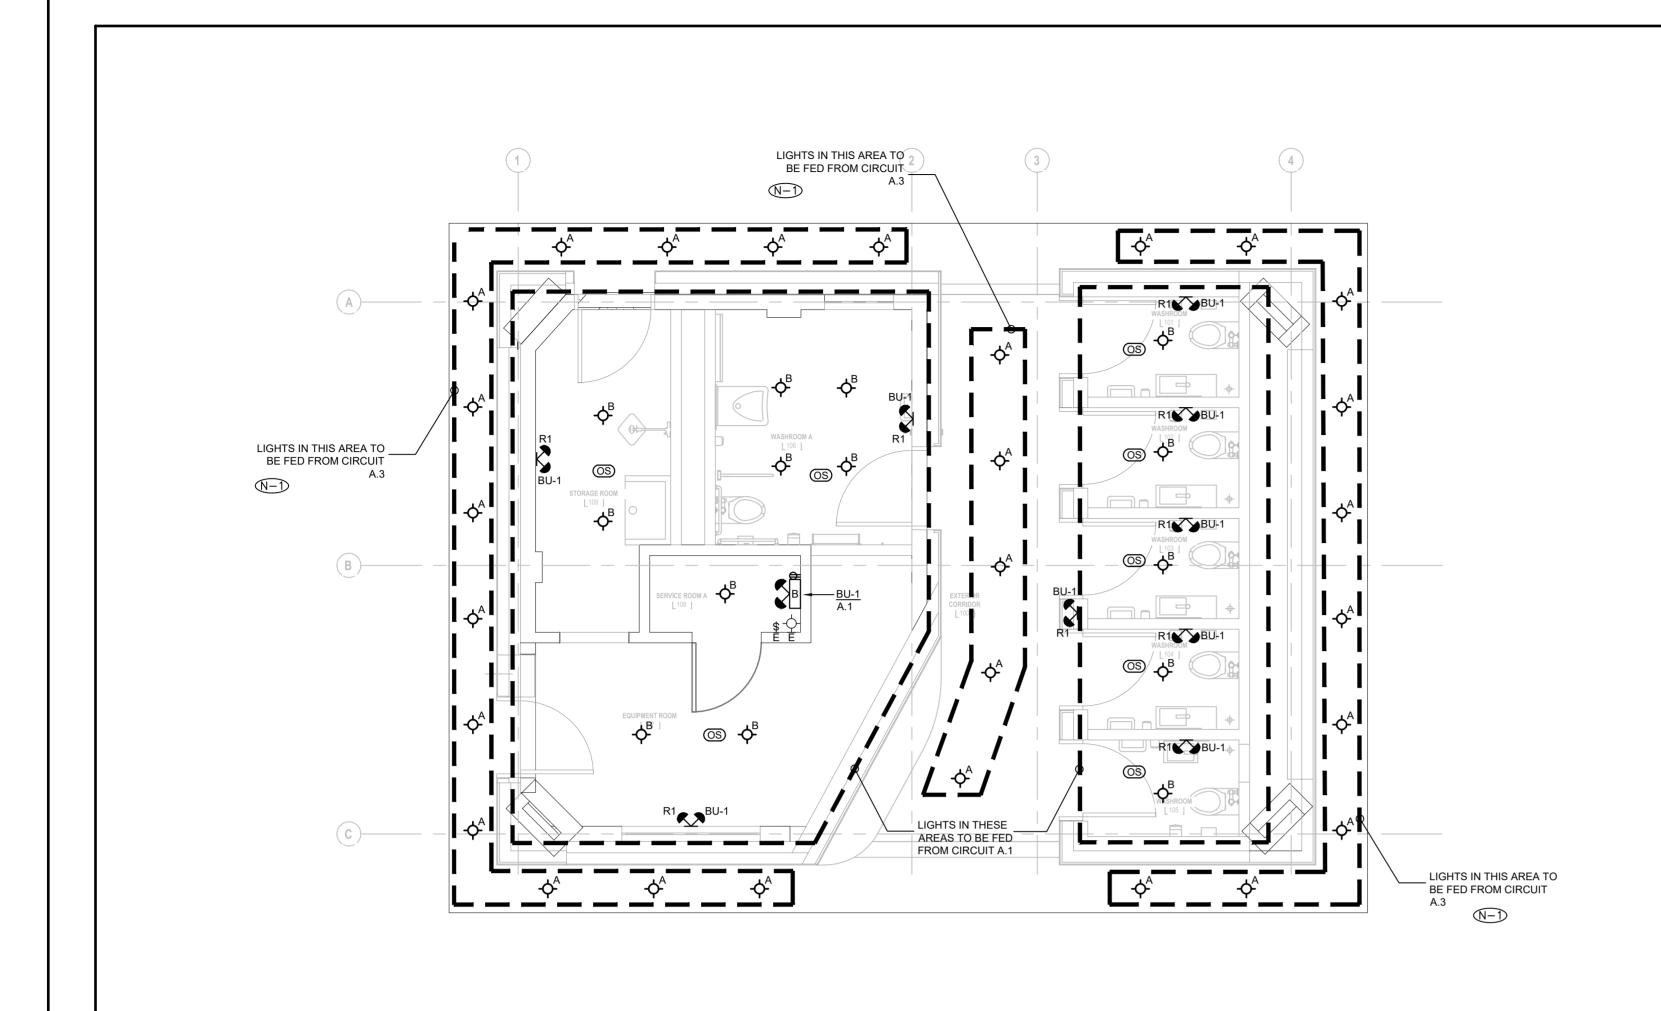

GENERAL NOTES:

- 1. THESE DRAWINGS SHALL BE READ IN CONJUNCTION WITH INTERIOR DESIGNER'S/ARCHITECT'S DRAWINGS FOR DIMENSIONS, HEIGHTS, CONSTRUCTION DETAILING, FINISHES AND COLOURS.
- 2. CIRCUITING IN PART IS DIAGRAMMATIC INTENDED TO SHOW GENERAL CIRCUIT ARRANGEMENT AND PANEL DESIGNATION.
- 3. PROVIDE EMT CONDUIT IN AREAS WITH EXPOSED CEILINGS .BX CABLING IS NOT ACCEPTABLE UNLESS OTHERWISE NOTED. BX CABLES MAY BE USED FOR FINAL CONNECTIONS TO LIGHTING FIXTURES OR EQUIPMENT WITH A MAXIMUM HORIZONTAL RUN LENGTH OF 3 FEET / 1 METER. PAINT CONDUITS TO MATCH ARCHITECTURAL BACKGROUNDS. MOUNT EXIT SIGNS, OCCUPANCY SENSORS, EXIT SIGNS, CAMERAS, WAPS AND ALL OTHER CEILING MOUNTED DEVICES WITH STEMS SUCH THAT THEY ARE ON THE SAME PLANE AS SUSPENDED LIGHTING FIXTURES. COORDINATE CEILINGS AND WALL HEIGHTS WITH INTERIOR DESIGNER DRAWINGS.
- 4. ALL NEWLUMINAIRES SHALL BE CHAIN HUNG AND SUPPORTED FROM THE SLAB ABOVE. PROVIDE LETTER
- 5. MEASURE THE ILLUMINATION OF THE FLOOR AT NIGHT WITH EMERGENCY LIGHTING ON ONLY, AND SEND A DRAWING SHOWING THE MAXIMUM AND MINIMUM LEVEL OF ILLUMINATION, TO THE CONSULTING ENGINEER, FOR REVIEW. PROVIDE WRITTEN CONFIRMATION THAT EMERGENCY LIGHTING HAS BEEN INSTALLED IN ACCORDANCE WITH CONTRACT DOCUMENTS AND LATEST EDITION OF THE ONTARIO BUILDING CODE SECTIONS 3.2.7.3 AND 3.2.7.4. LETTER TO BE INCLUDED AS PART OF CLOSE-OUT DOCUMENT SUBMITTAL PACKAGE.
- 6. ENSURE THAT ALL LIGHTING FIXTURES ARE CLEAN AND ILLUMINATED BY END OF PROJECT.
- COORDINATE INSTALLATION OF FIXTURES WITH MECHANICAL EQUIPMENT, ELECTRICAL EQUIPMENT, SPRINKLERS AND DUCT WORK WITH OTHER TRADES PRIOR TO WORK COMMENCING.
- 8. ALL CEILING MOUNTED OCCUPANCY SENSORS PROVIDED AS PART OF THIS SCOPE OF WORK MUST BE LOCATED AT LEAST 6'0" AWAY FROM ANY SUPPLY AIR DIFFUSER AND RETURN AIR GRILLE AS PER MANUFACTURER'S RECOMMENDATION. COORDINATE INSTALLATION ON SITE WITH MECHANICAL CONTRACTOR PRIOR TO COMMENCING WORK.

DRAWING NOTES:

N-D EXTERIOR LIGHTS TO BE CONTROLLED BY PHOTOCELL/TIMER. REFER TO DETAIL 3/TE-0.2.

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Lower Hillside Washroom Building Improvements

City of Toronto 1873 BLOOR ST W TORONTO, ON M6R 2Z3

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Drawn: J.B.

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Scale: AS SHOWN

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Date: 2023.04

Sheet Title:

GROUND FLOOR ELECTRICAL LAYOUT

Drawing #:

TE-1.1

SEPARATE PRICE:

PROVIDE SEPARATE PRICE TO DEMOLISH EXISTING CONDUIT FROM SUMP PUMP CONTROLLER TO SUMP PIT AND TO PROVIDE NEW 2" UNDERGROUND PVC CONDUIT.

GENERAL NOTES:

1. THESE DRAWINGS SHALL BE READ IN CONJUNCTION WITH INTERIOR DESIGNER'S/ARCHITECT'S DRAWINGS FOR DIMENSIONS, HEIGHTS, CONSTRUCTION DETAILING, FINISHES AND COLOURS.

2. CIRCUITING IN PART IS DIAGRAMMATIC INTENDED TO SHOW GENERAL CIRCUIT ARRANGEMENT AND PANEL DESIGNATION.

3. PROVIDE EMT CONDUIT IN AREAS WITH EXPOSED CEILINGS. BX CABLING IS NOT ACCEPTABLE UNLESS OTHERWISE NOTED. BX CABLES MAY BE USED FOR FINAL CONNECTIONS TO LIGHTING FIXTURES OR EQUIPMENT WITH A MAXIMUM HORIZONTAL RUN LENGTH OF 3 FEET / 1 METER. PAINT CONDUITS TO MATCH ARCHITECTURAL BACKGROUNDS. MOUNT EXIT SIGNS, OCCUPANCY SENSORS, EXIT SIGNS, CAMERAS, WAPS AND ALL OTHER CEILING MOUNTED DEVICES WITH STEMS SUCH THAT THEY ARE ON THE SAME PLANE AS SUSPENDED LIGHTING FIXTURES. COORDINATE CEILINGS AND WALL HEIGHTS WITH INTERIOR DESIGNER DRAWINGS.

4. VERIFY EXACT POWER REQUIREMENTS AND RECEPTACLE TYPES FOR SPECIAL EQUIPMENT WITH MANUFACTURER PRIOR TO INSTALLATION. PROVIDE HARDWIRE CONNECTIONS FOR DISHWASHERS AND COPIERS ETC. IN LIEU OF RECEPTACLES OR VICE VERSA, AS REQUIRED.

5. REFER TO INTERIOR DESIGN/ARCHITECT DRAWINGS FOR THE COLOUR OF COVERPLATES AND

6. PROVIDE SUITABLE LABELS ON ALL RECEPTACLES. LABELS TO INCLUDE BOTH PANEL AND CIRCUIT DESIGNATION. REVIEW LABEL SIZE AND TYPE WITH CONSULTANT PRIOR TO INSTALLATION.

WITH MECHANICAL DRAWINGS AND CONTRACTOR PRIOR TO ROUGH-INS.

8. ROUTE ALL CONDUIT SYSTEMS AROUND DUCT WORK, BEAMS AND PIPING AS REQUIRED TO

7. CONFIRM ELECTRICAL REQUIREMENTS AND EXACT LOCATION OF ALL MECHANICAL EQUIPMENT

 ROUTE ALL CONDUIT SYSTEMS AROUND DUCT WORK, BEAMS AND PIPING AS REQUIRED TO ACCOMMODATE LAYOUT SHOWN. REFER TO MECHANICAL DRAWINGS AND ARCHITECTURAL DRAWINGS FOR ADDITIONAL DETAILS.

9. REFER TO THE INTERIOR DESIGNER'S/ARCHITECT'S DRAWINGS TO DETERMINE COMPLETE EXTENT OF DEMOLITION AND ALLOW FOR ALL COSTS. COMPLETE EXTENT OF DEMOLITION IS NOT SHOWN.

10. AS PART OF THE DEMOLITION CONTRACT, THE ELECTRICAL CONTRACTOR SHALL REMOVE ALL FLOOR, COLUMN, CEILING, AND WALL MOUNTED POWER, TELEPHONE/DATA OUTLETS, CABLING AND CONDUIT NOT REQUIRED, TO SUIT NEW LAYOUT AND MAKE SAFE. VISIT THE SITE TO DETERMINE THE EXACT REQUIREMENTS AND REFER TO THE DEMOLITION DRAWINGS.

DRAWING NOTES:

N-1) REFER TO DETAIL 1/TE-0.2 FOR UNIVERSAL WASHROOM SCHEMATIC AND FLOOR PLAN.


N-2 EXHAUST FAN TO BE CONTROLLED BY OCCUPANCY SENSOR.

N-3 POWER CONNECTION FOR AUTO FAUCET/FLUSH. COORDINATE WITH MECHANICAL FOR EXACT REQUIREMENTS AND LOCATION ON SITE.

N-4 PROVIDE POWER TO RADIANT CEILING PANEL. PANEL TO BE CONTROLLED BY LINE-VOLTAGE THERMOSTAT. THERMOSTAT SUPPLIED MY MECHANICAL, INSTALLED BY ELECTRICAL. COORDINATE LOCATION WITH MECHANICAL ON SITE.


N-5 POWER TO SUMP PUMP MOTORS FED VIA PUMP CONTROL CONTROL PANEL. FEED POWER TO PUMPS VIA EXISTING CONDUIT. CONFIRM EXACT LOCATION AND ROUTING ON SITE.

N-6 POWER FOR HEAT TRACING. COORDINATE LOCATION WITH MECHANICAL.

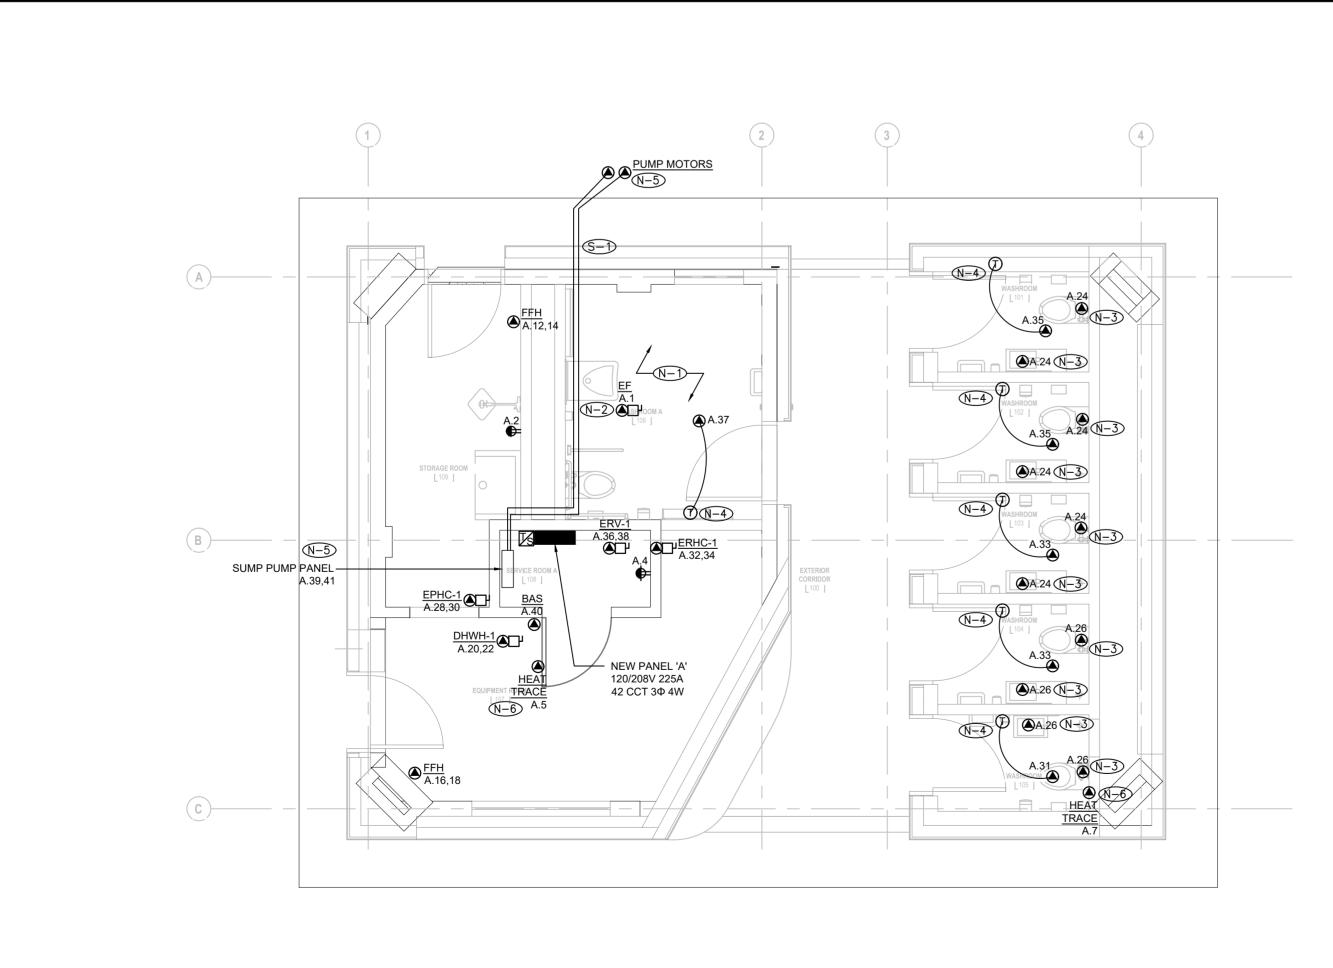

1 TE-1.1 LIGHTING LAYOUT 1:50

2 POWER AND SYSTEMS LAYOUT

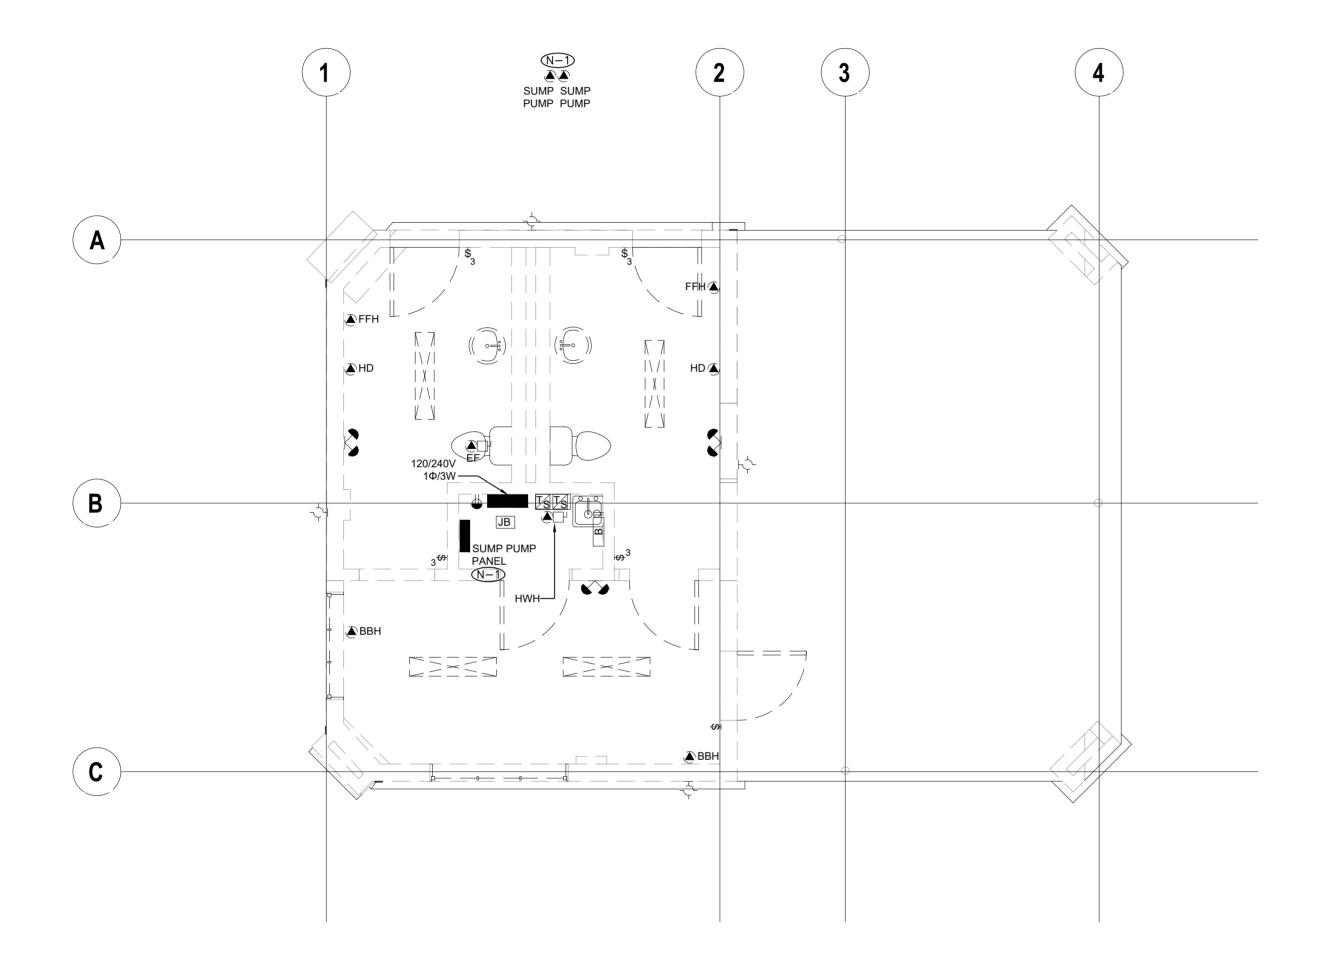

GENERAL NOTES:

- REFER TO THE ARCHITECT'S DRAWINGS TO DETERMINE COMPLETE EXTENT OF DEMOLITION AND ALLOW FOR ALL COSTS. COMPLETE EXTENT OF DEMOLITION IS NOT SHOWN.
- REMOVE ALL FLOOR, COLUMN, CEILING, AND WALL MOUNTED POWER, TELEPHONE/DATA OUTLETS, CABLING AND CONDUIT NOT REQUIRED, TO SUIT NEW LAYOUT AND MAKE SAFE. VISIT SITE TO DETERMINE EXACT REQUIREMENTS AND REFER TO DEMOLITION DRAWINGS.
- MAKE GOOD ALL CORE HOLES FROM ELECTRICAL EQUIPMENT AND DEVICES DISCONNECTED, RELOCATED AND OR REMOVED IN THIS PROJECT.
- 4. REMOVE FLOOR MONUMENT(S) AND ALL ASSOCIATED CONDUIT(S) AND WIRE BACK TO SOURCE. MAKE GOOD ALL FLOOR PENETRATIONS TO COMPLY WITH CURRENT LOCAL APPLICABLE CODES.
- 5. ENSURE THAT ALL EXISTING ELECTRICAL DEVICES, EQUIPMENT AND LIGHTING WITHIN BASE BUILDING ROOMS, STAIRWELLS AND AREAS DEEMED NOT IN SCOPE, REMAIN LIVE OPERATIONAL, ISOLATED AND PROTECTED DURING CONSTRUCTION.
- 6. NO ADDITIONAL COST WILL BE APPROVED FOR ANY REVISIONS/MODIFICATIONS REQUIRED BY ANY TRADE OR CONTRACTOR DUE TO THE LACK OF COORDINATION BETWEEN TRADES AND
- 7. COORDINATE WITH GENERAL CONTRACTOR AND LANDLORD FOR DISPOSAL OF ALL MATERIALS FROM SITE.

DRAWING NOTES:

N-D EXISTING FEEDERS FOR SUMP PUMP EQUIPMENT TO BE REMOVED BACK TO SOURCE AND MADE SAFE.

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Project: 23210.001.ME

Drawn: J.B.

Checked: W.Y.C./N.C.

Scale: 1:50

Date: 2023.04

Sheet Title:

GROUND FLOOR ELECTRICAL DEMOLITION LAYOUT

Drawing #:

TE-1.2