CITY OF MISSISSAUGA

REVISION

CODES AND REQUIREMENTS OF AUTHORITIES HAVING

MISSISSAUGA

MAVIS S. MECH. & ROOF RENEWAL

CITY OF MISSISSAUGA

Paul Didur Architect Inc. BCDN No. 2033

OBC MATRIX


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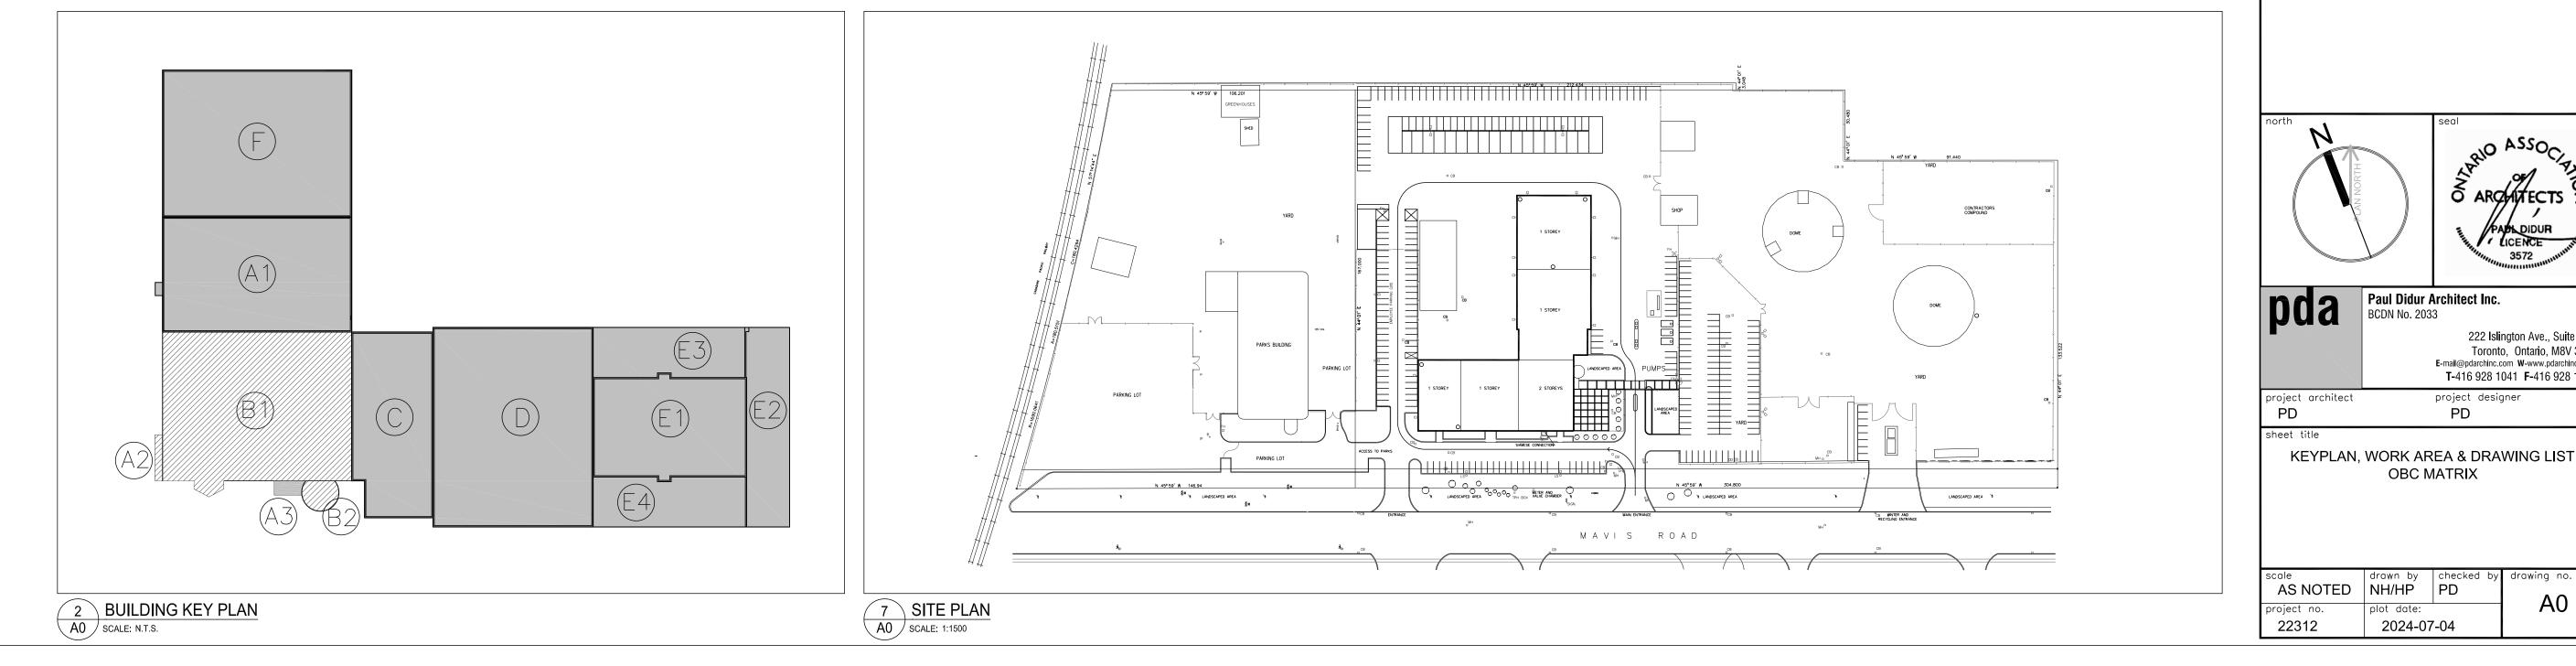
2024-07-04

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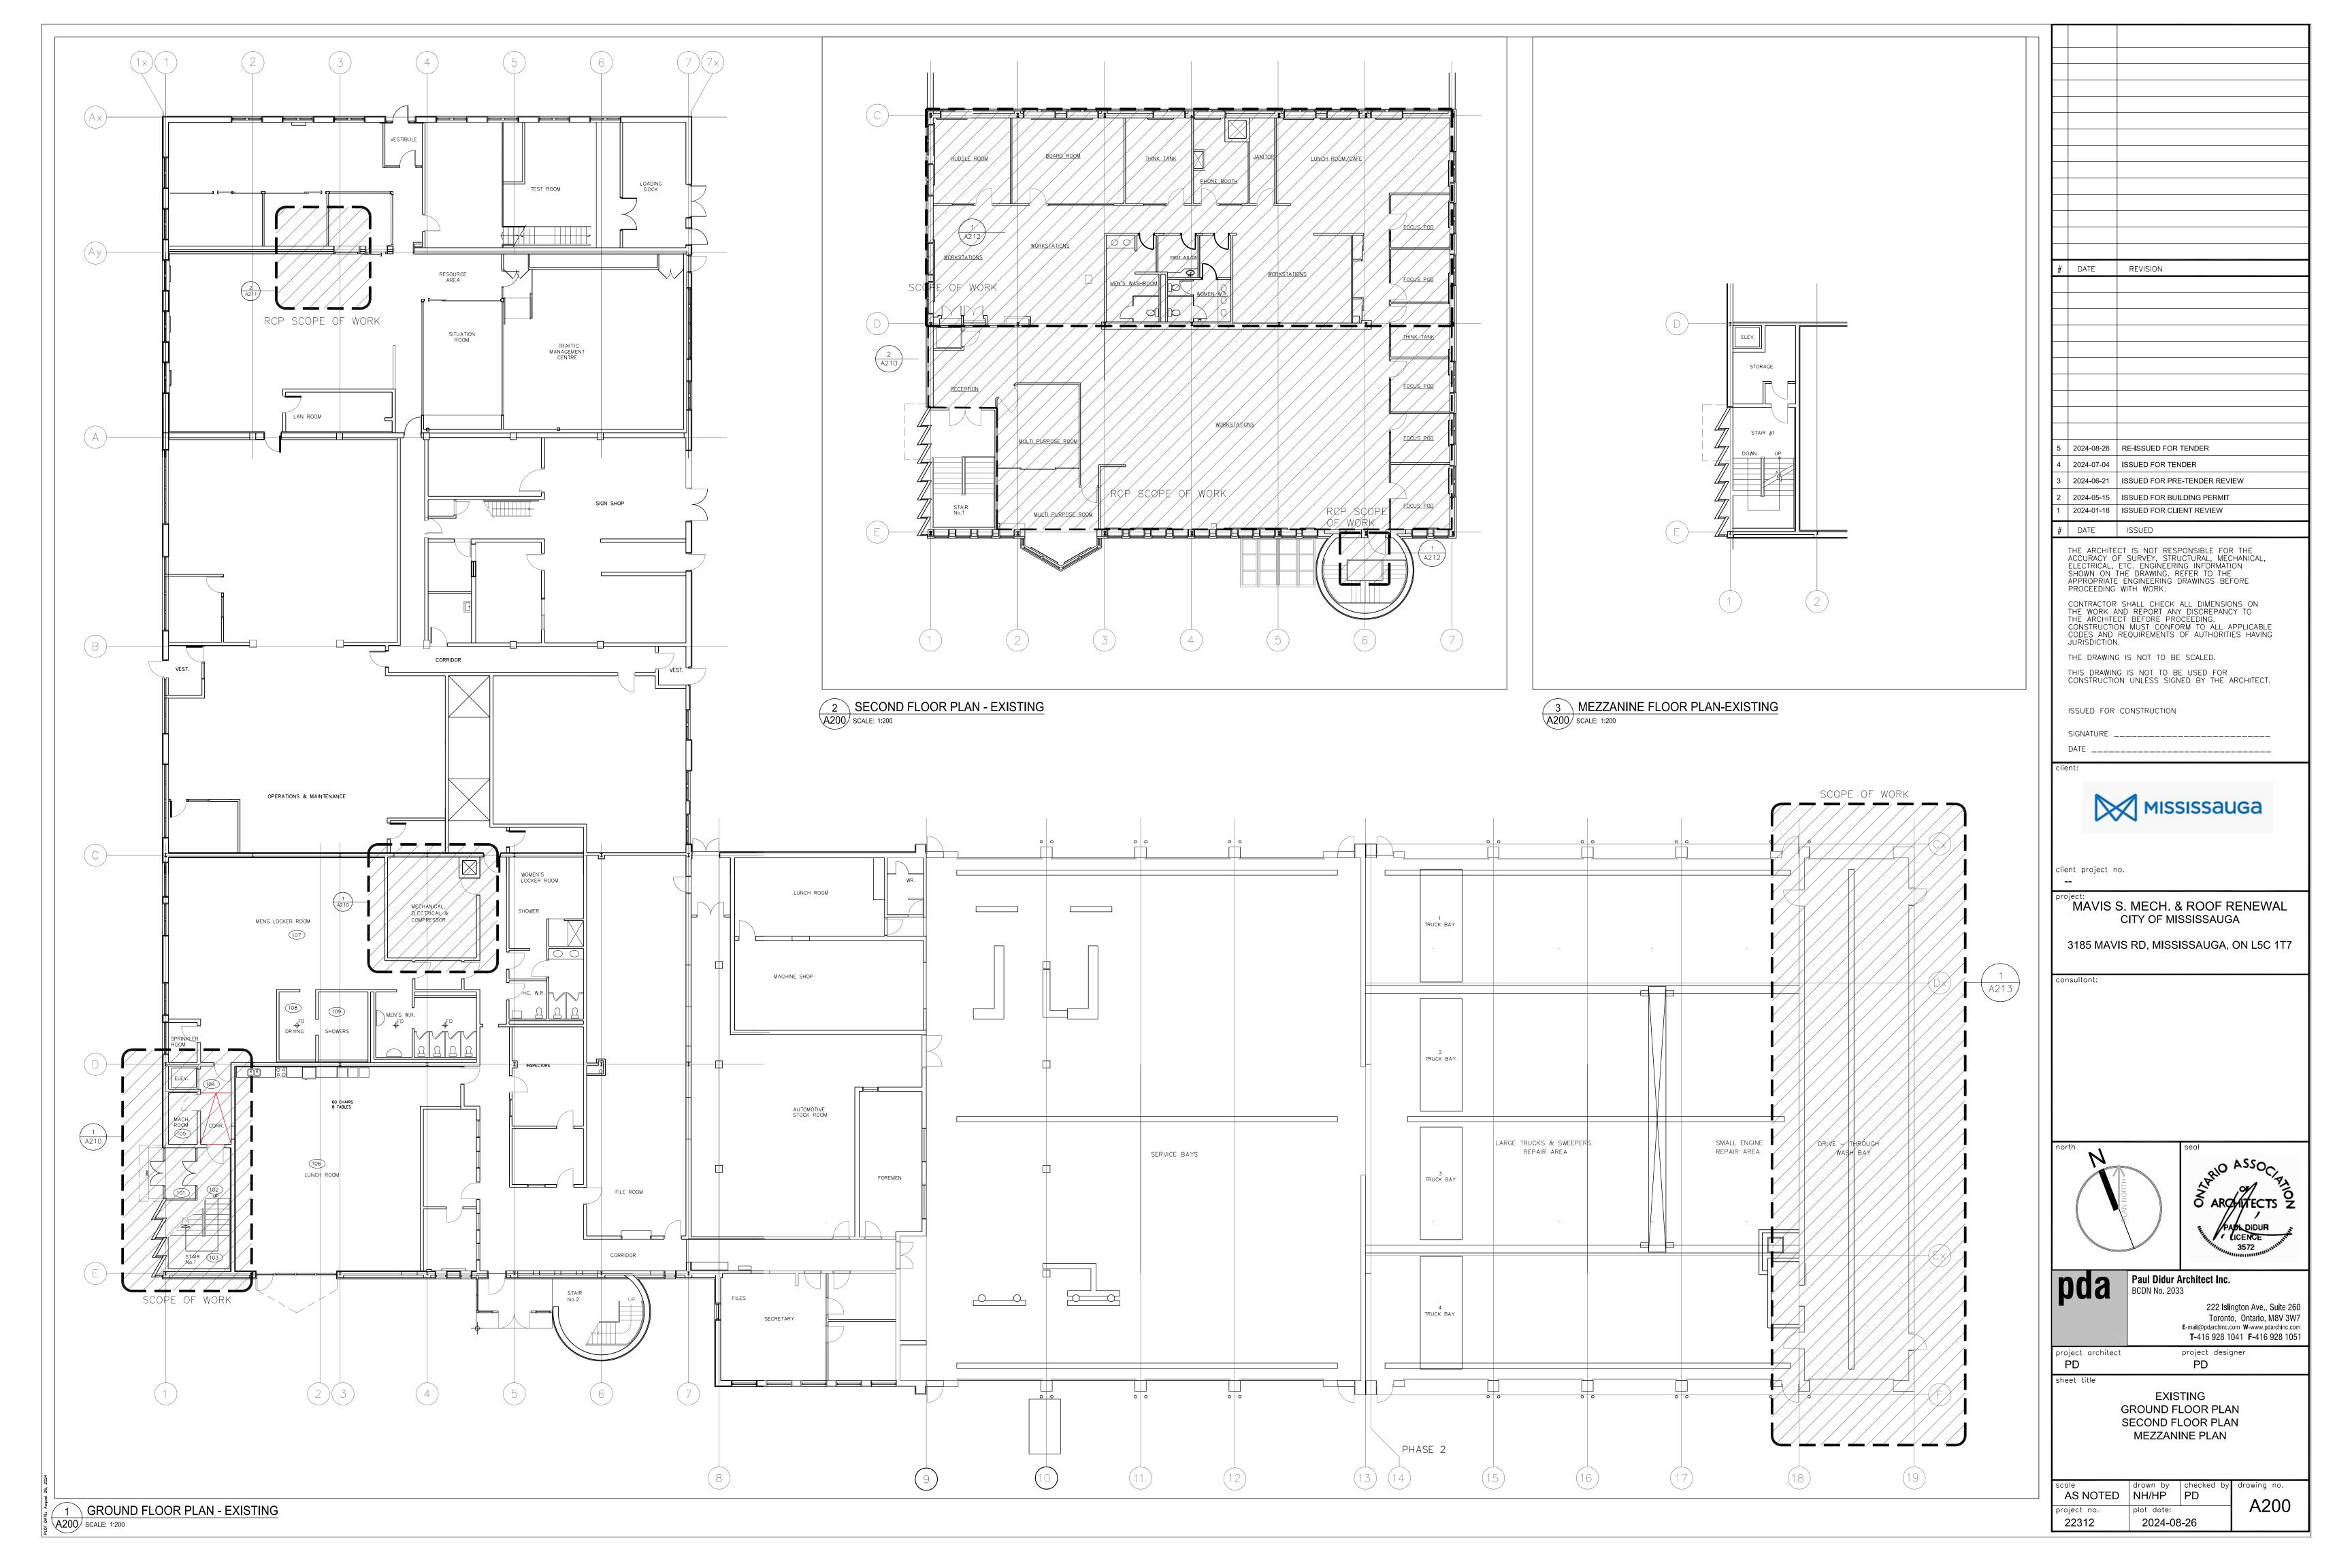
222 Islington Ave., Suite 260 Toronto, Ontario, M8V 3W7 E-mail@pdarchinc.com W-www.pdarchinc.com **T-**416 928 1041 **F-**416 928 1051


MAVIS S. MECHANICAL & ROOF RENEWAL 3185 MAVIS RD - MISSISSAUGA, ONTARIO - L5C 1T7




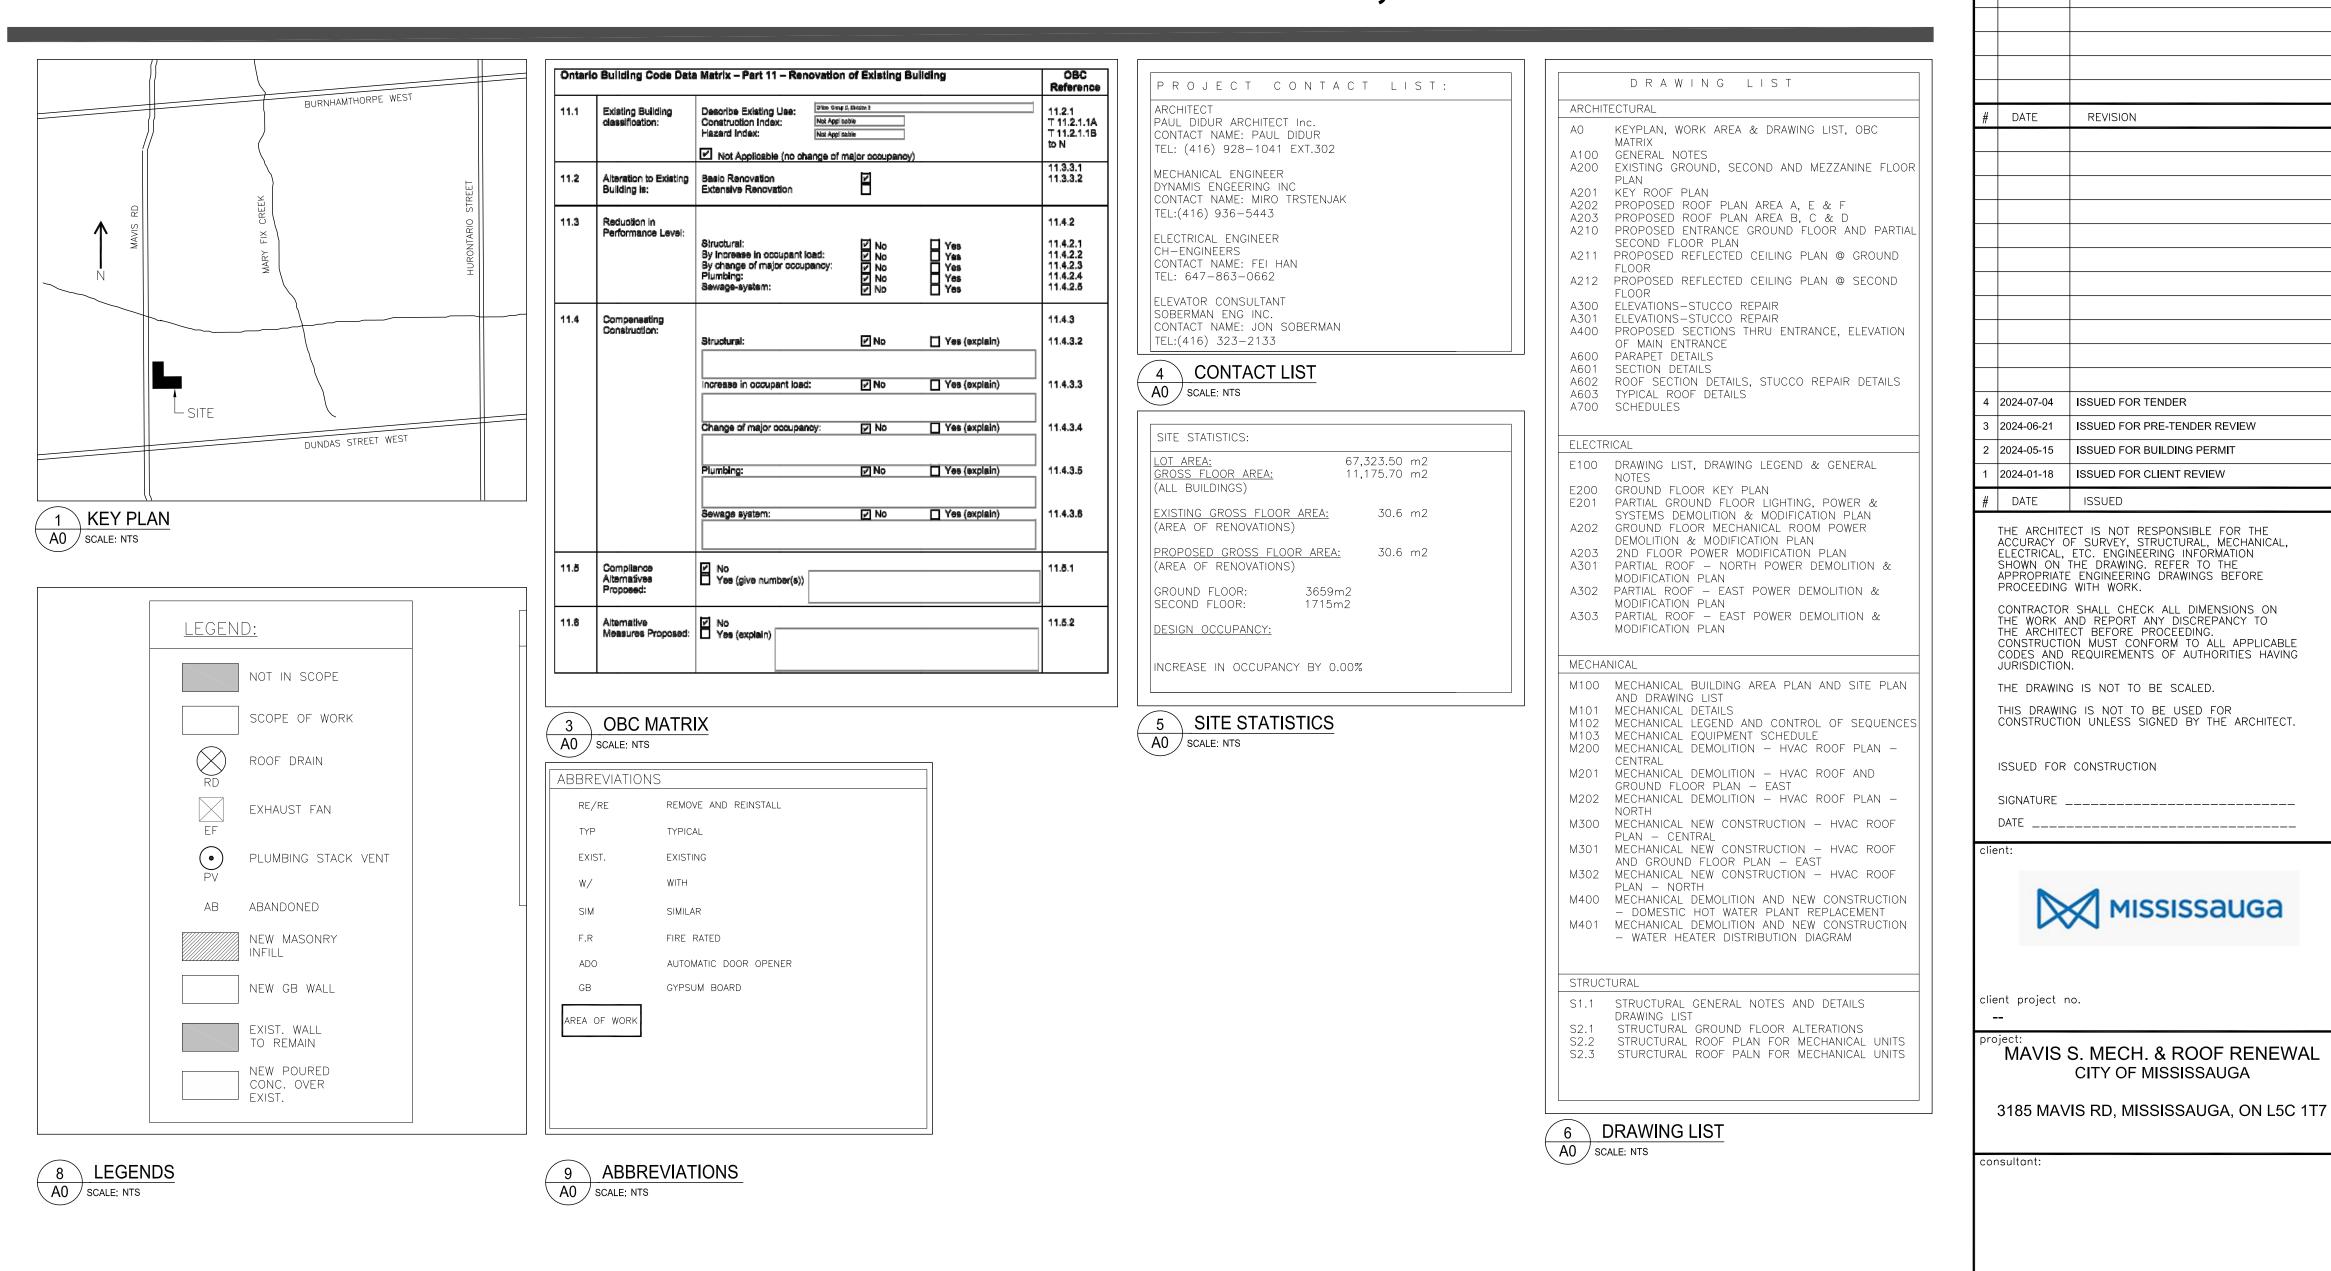



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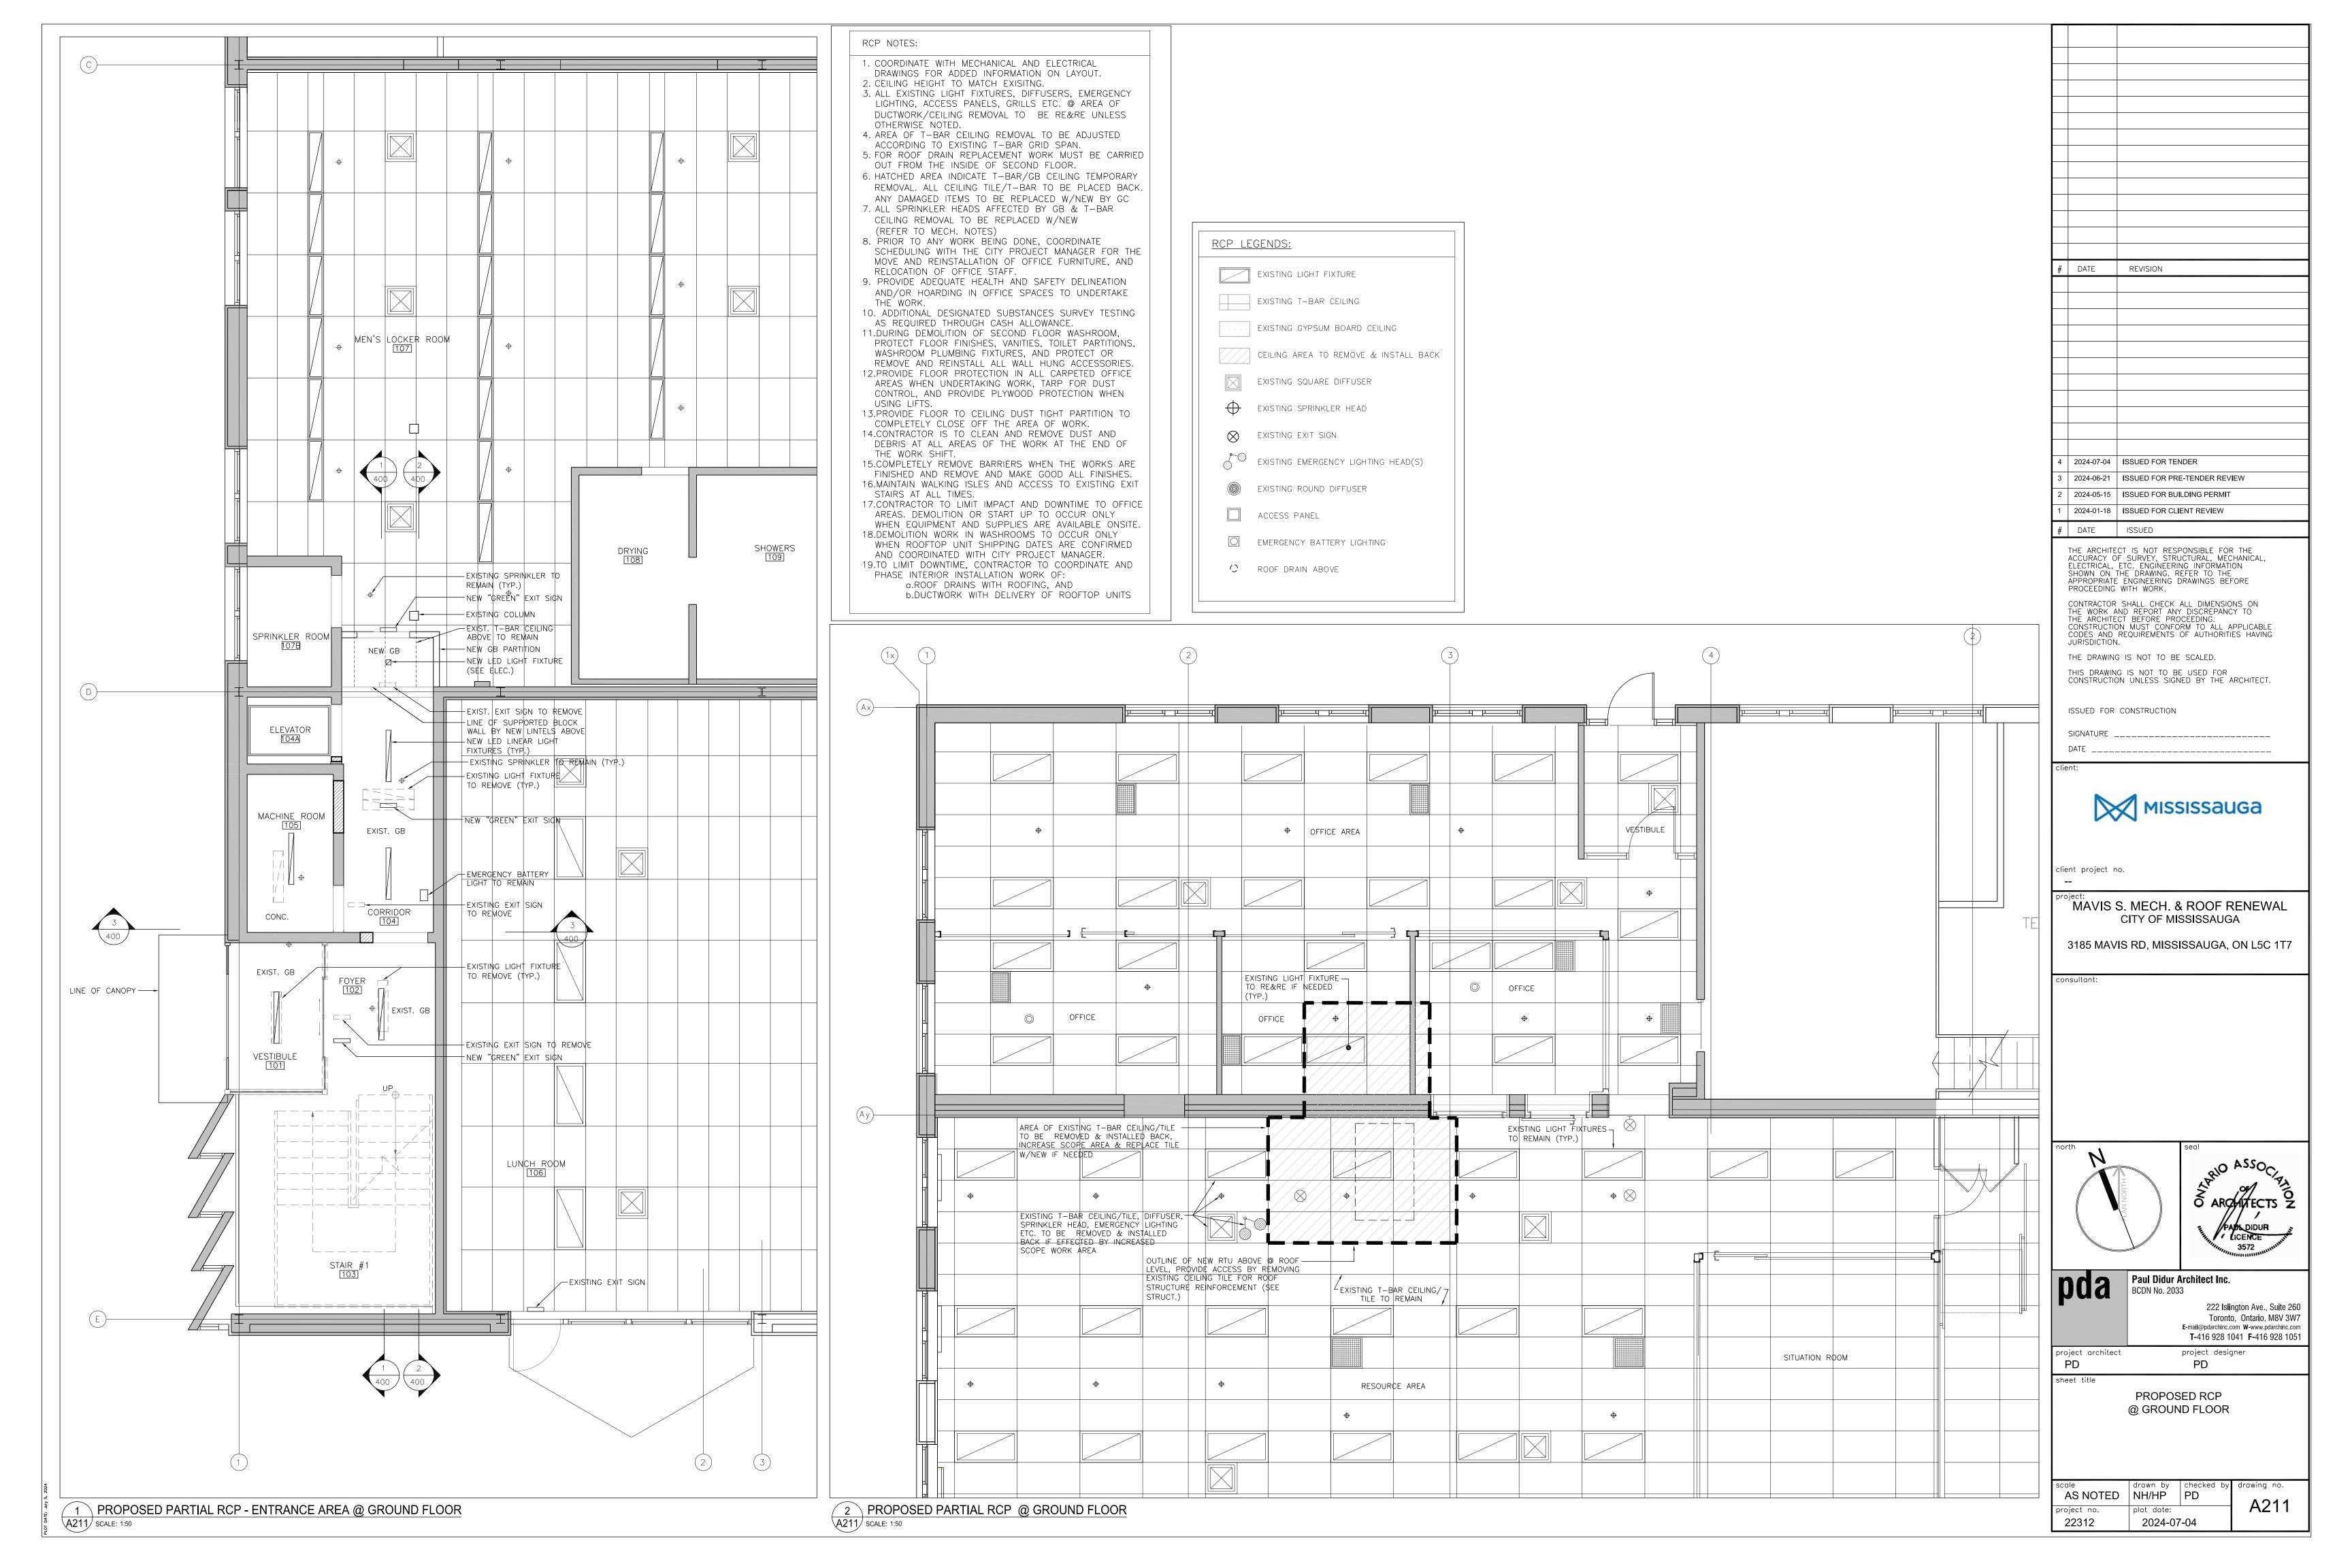





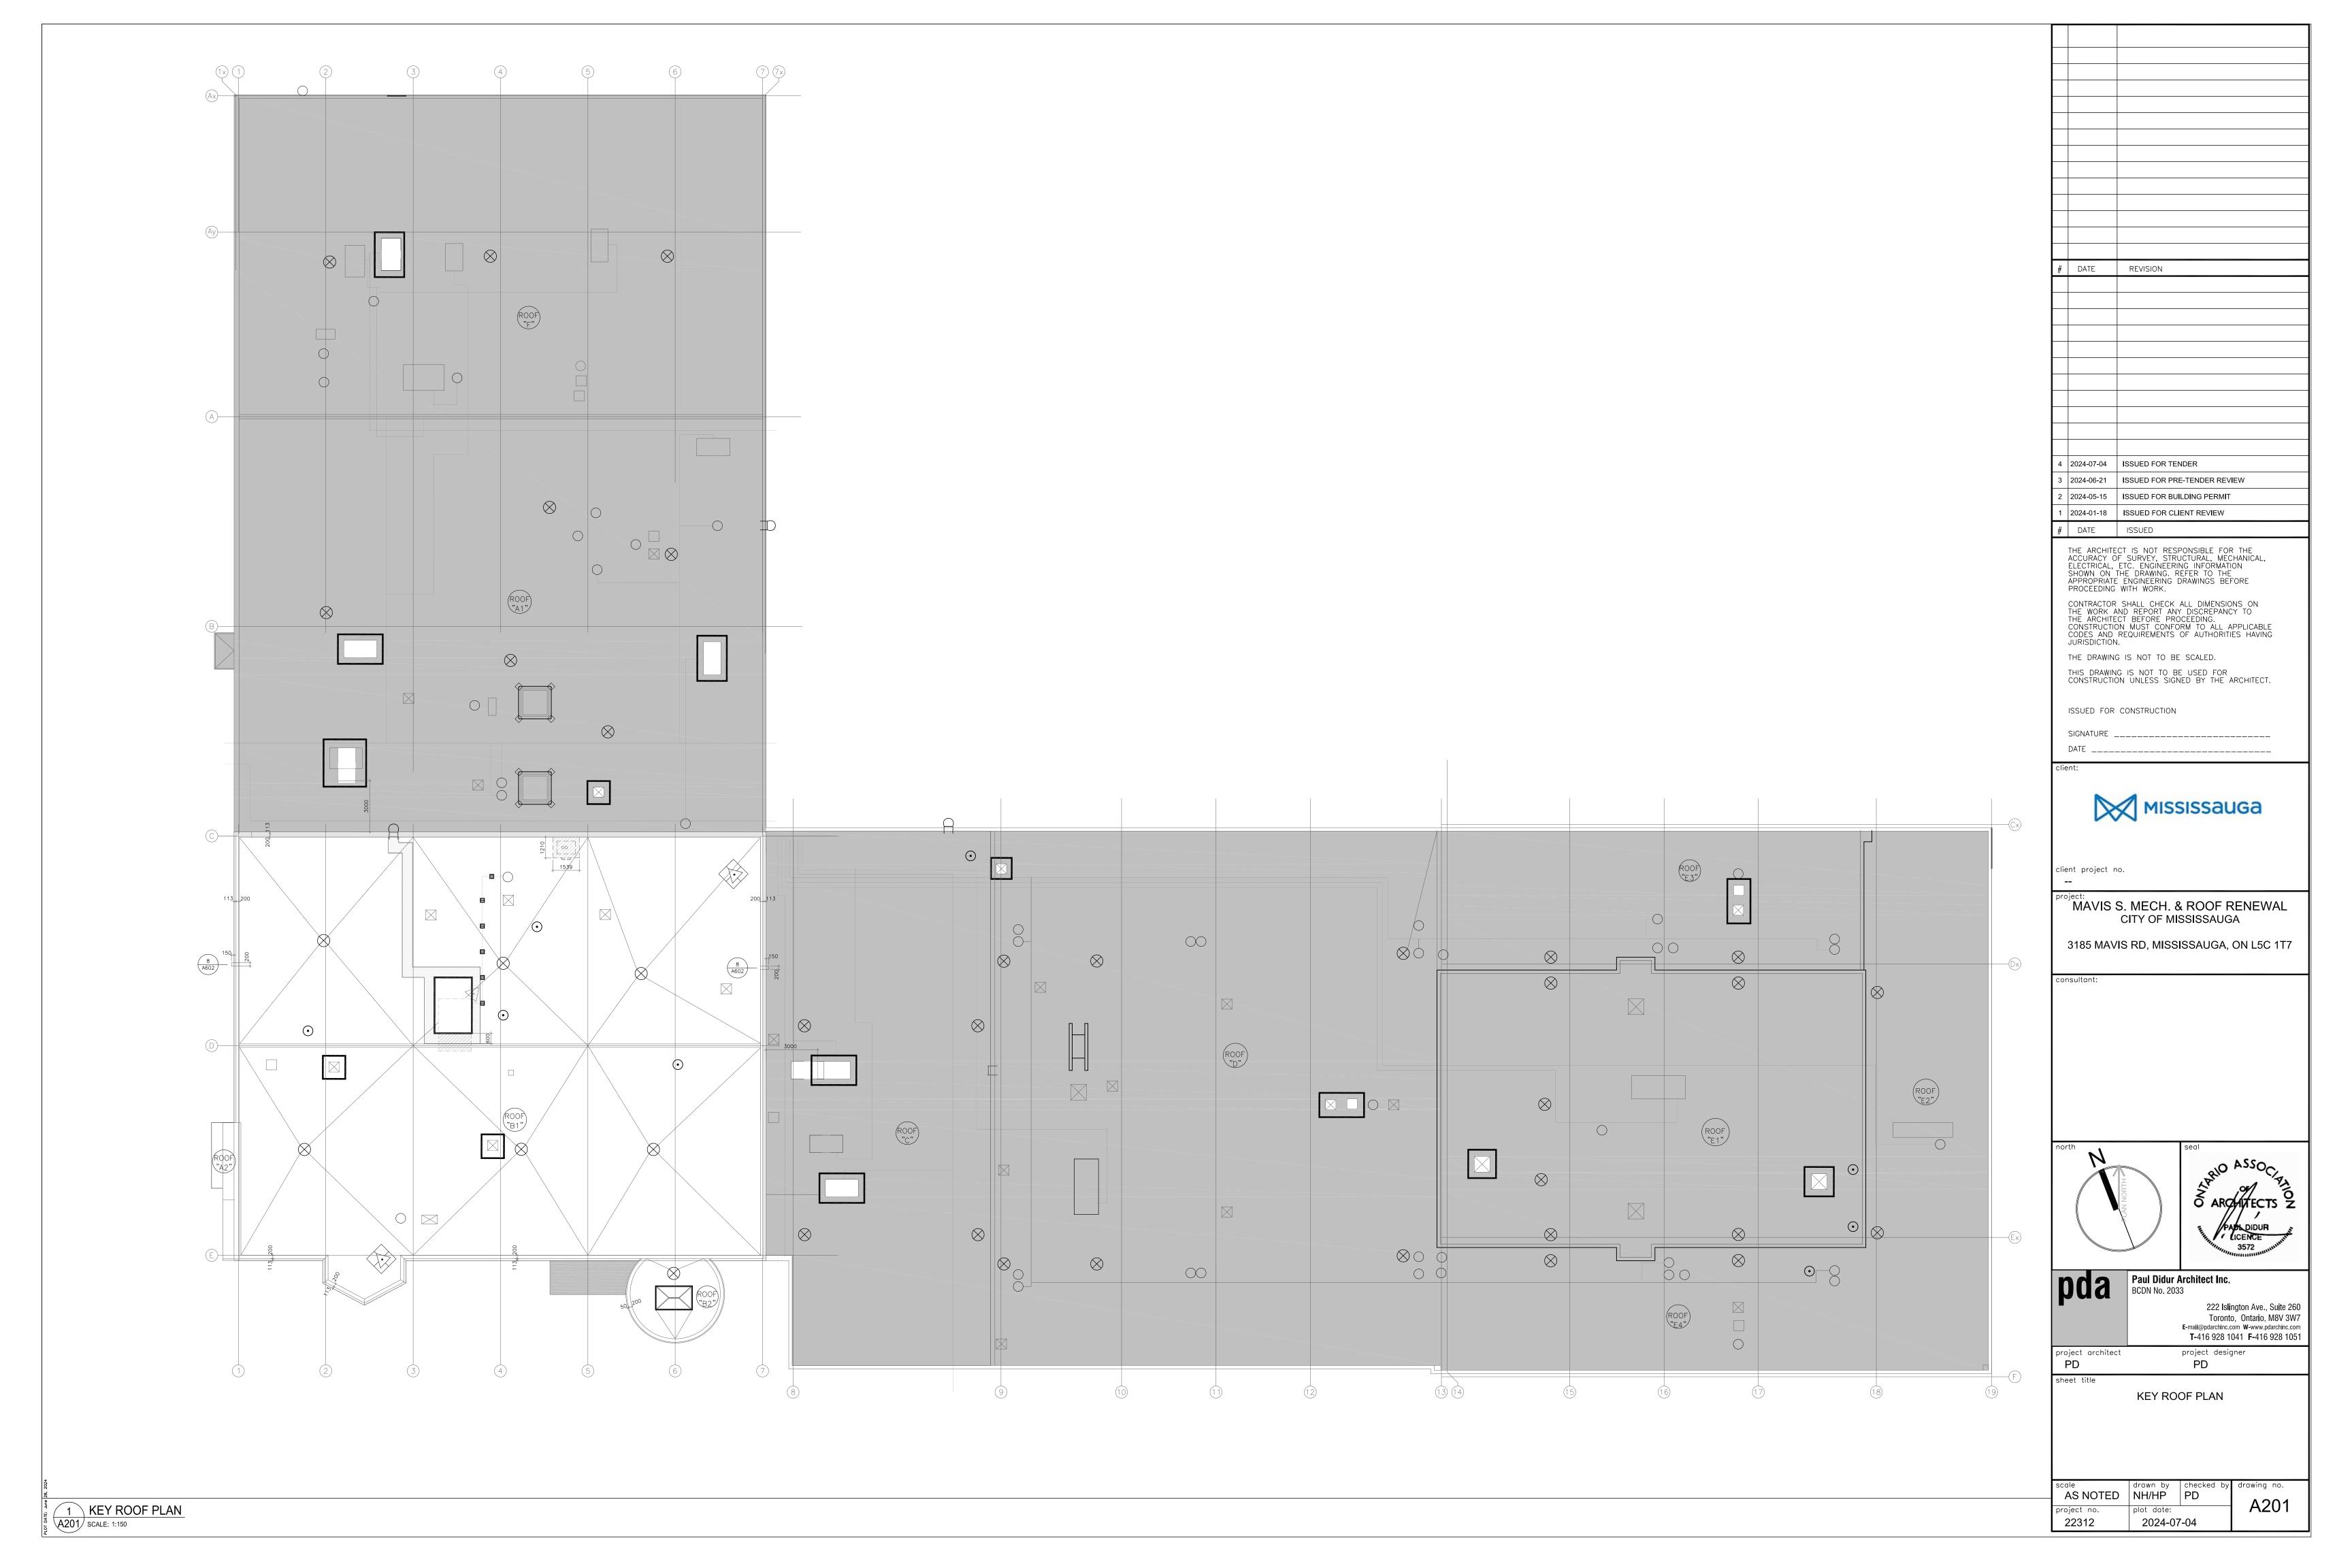


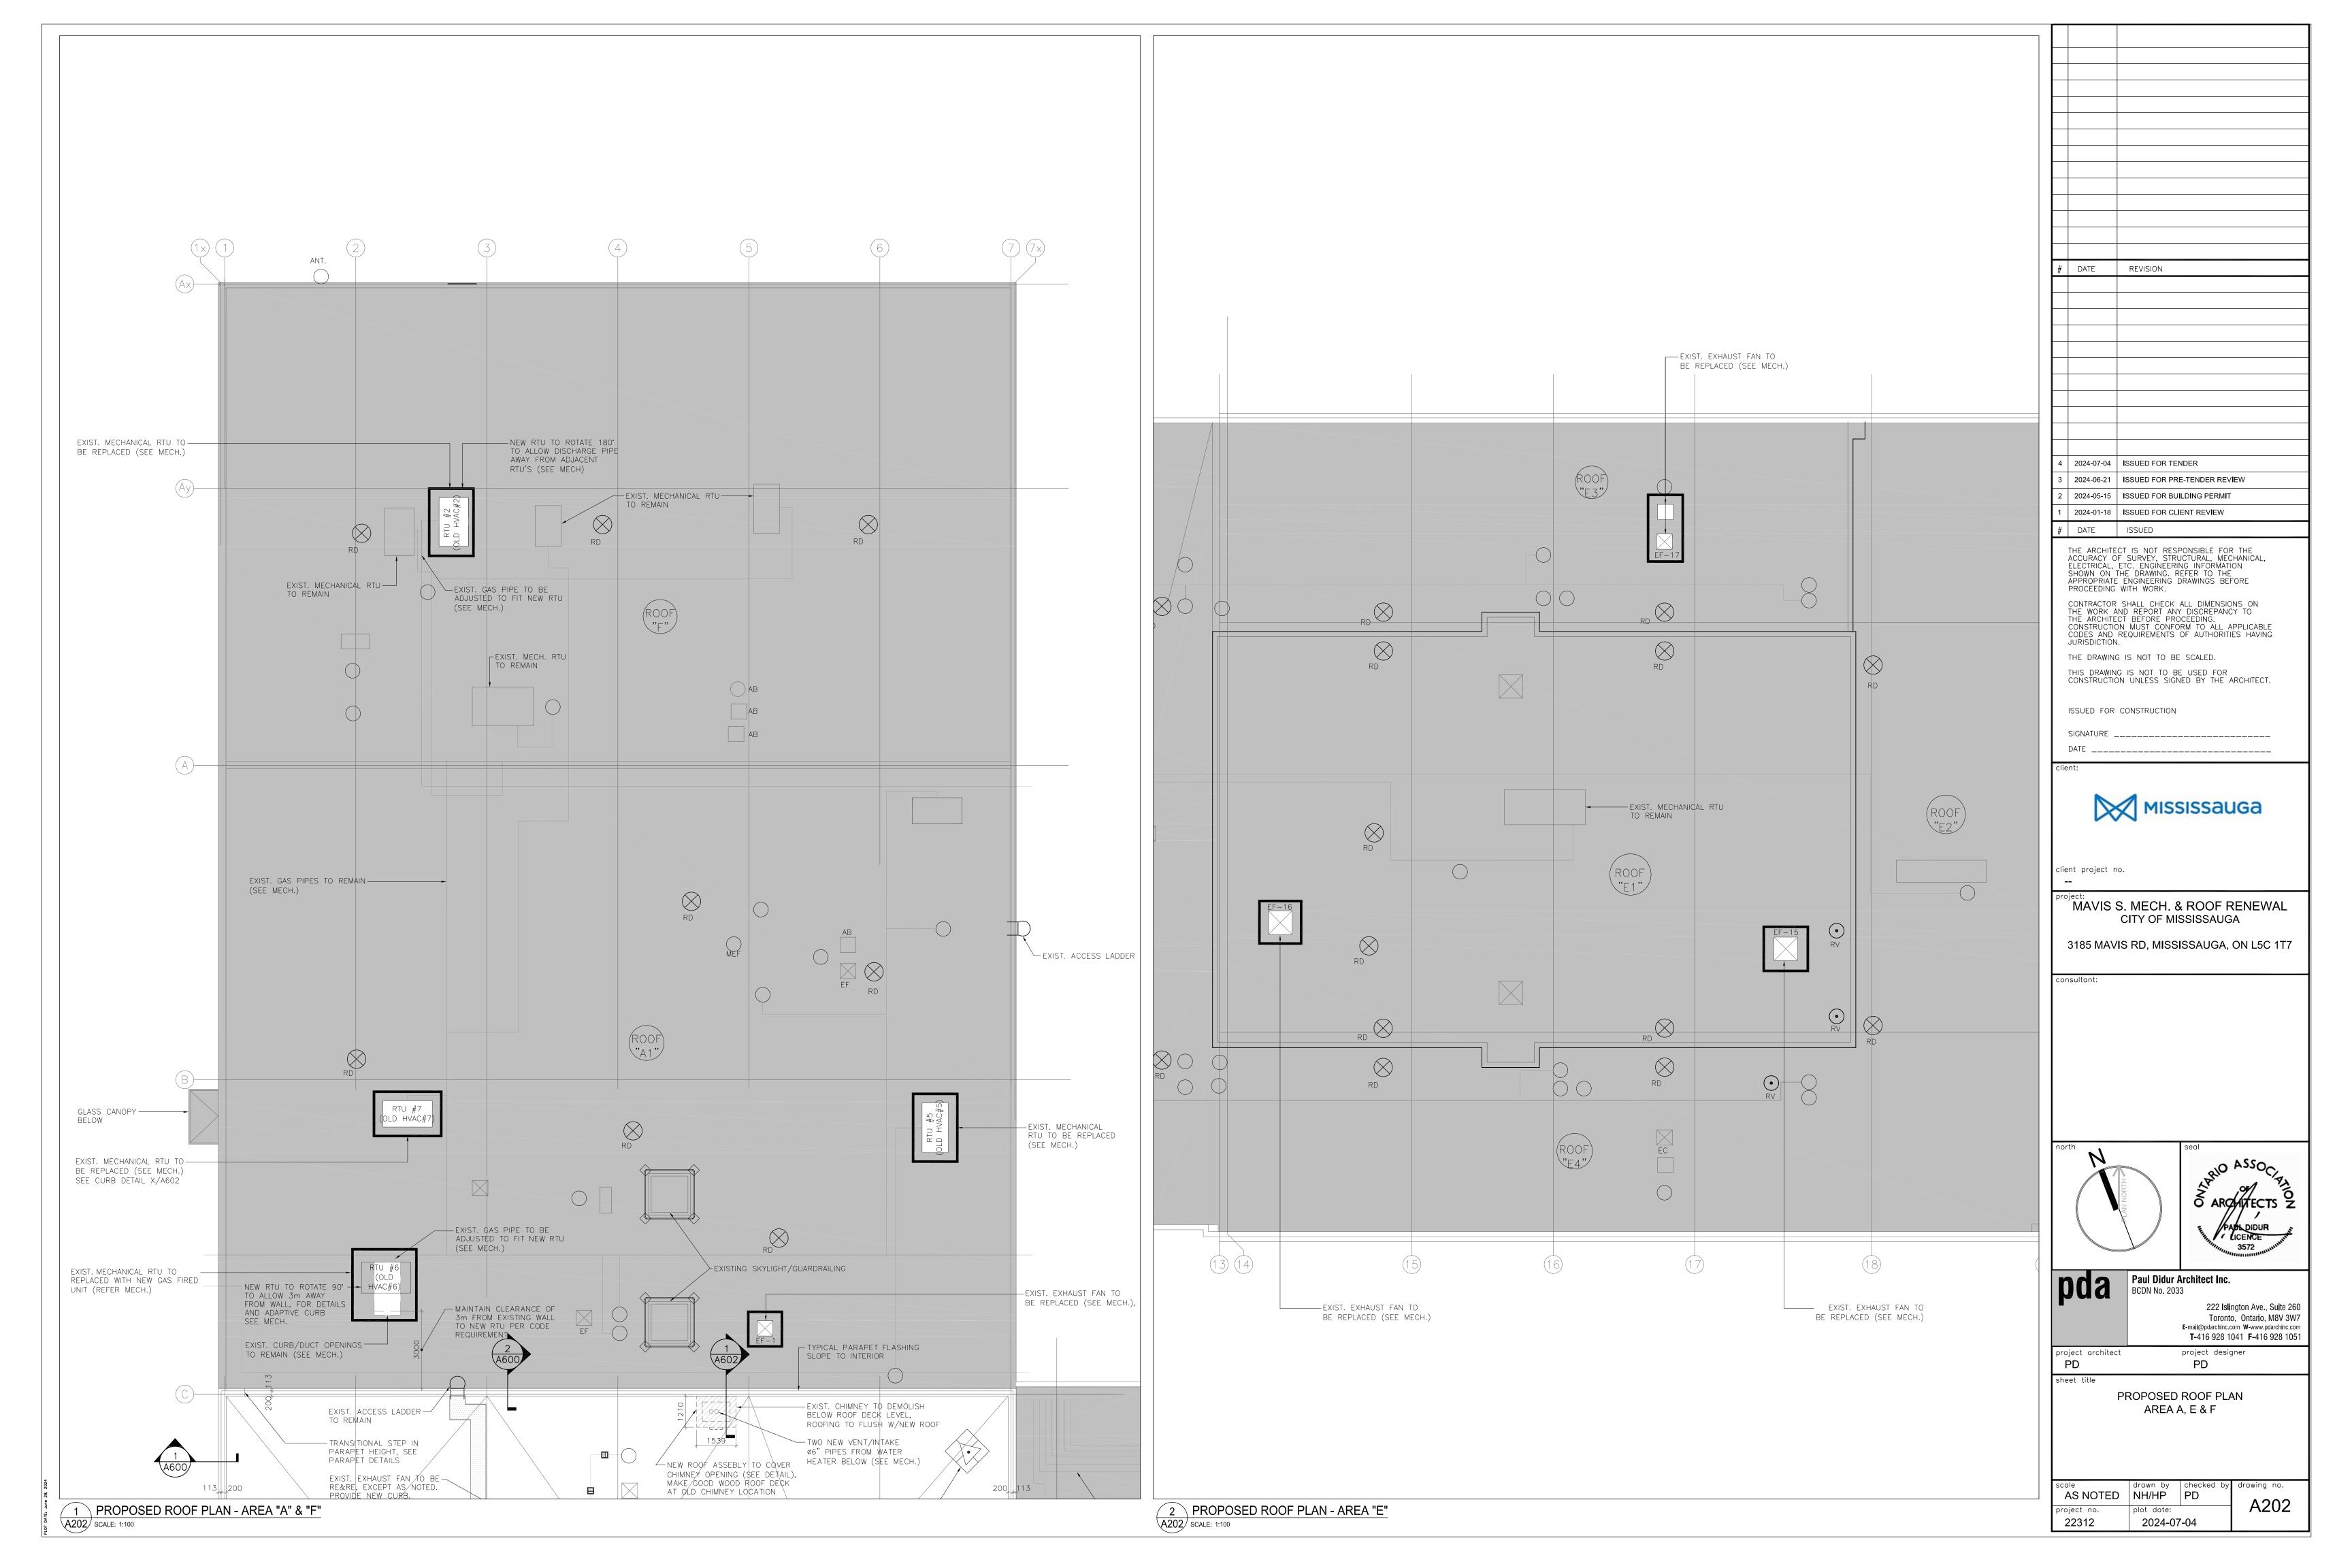

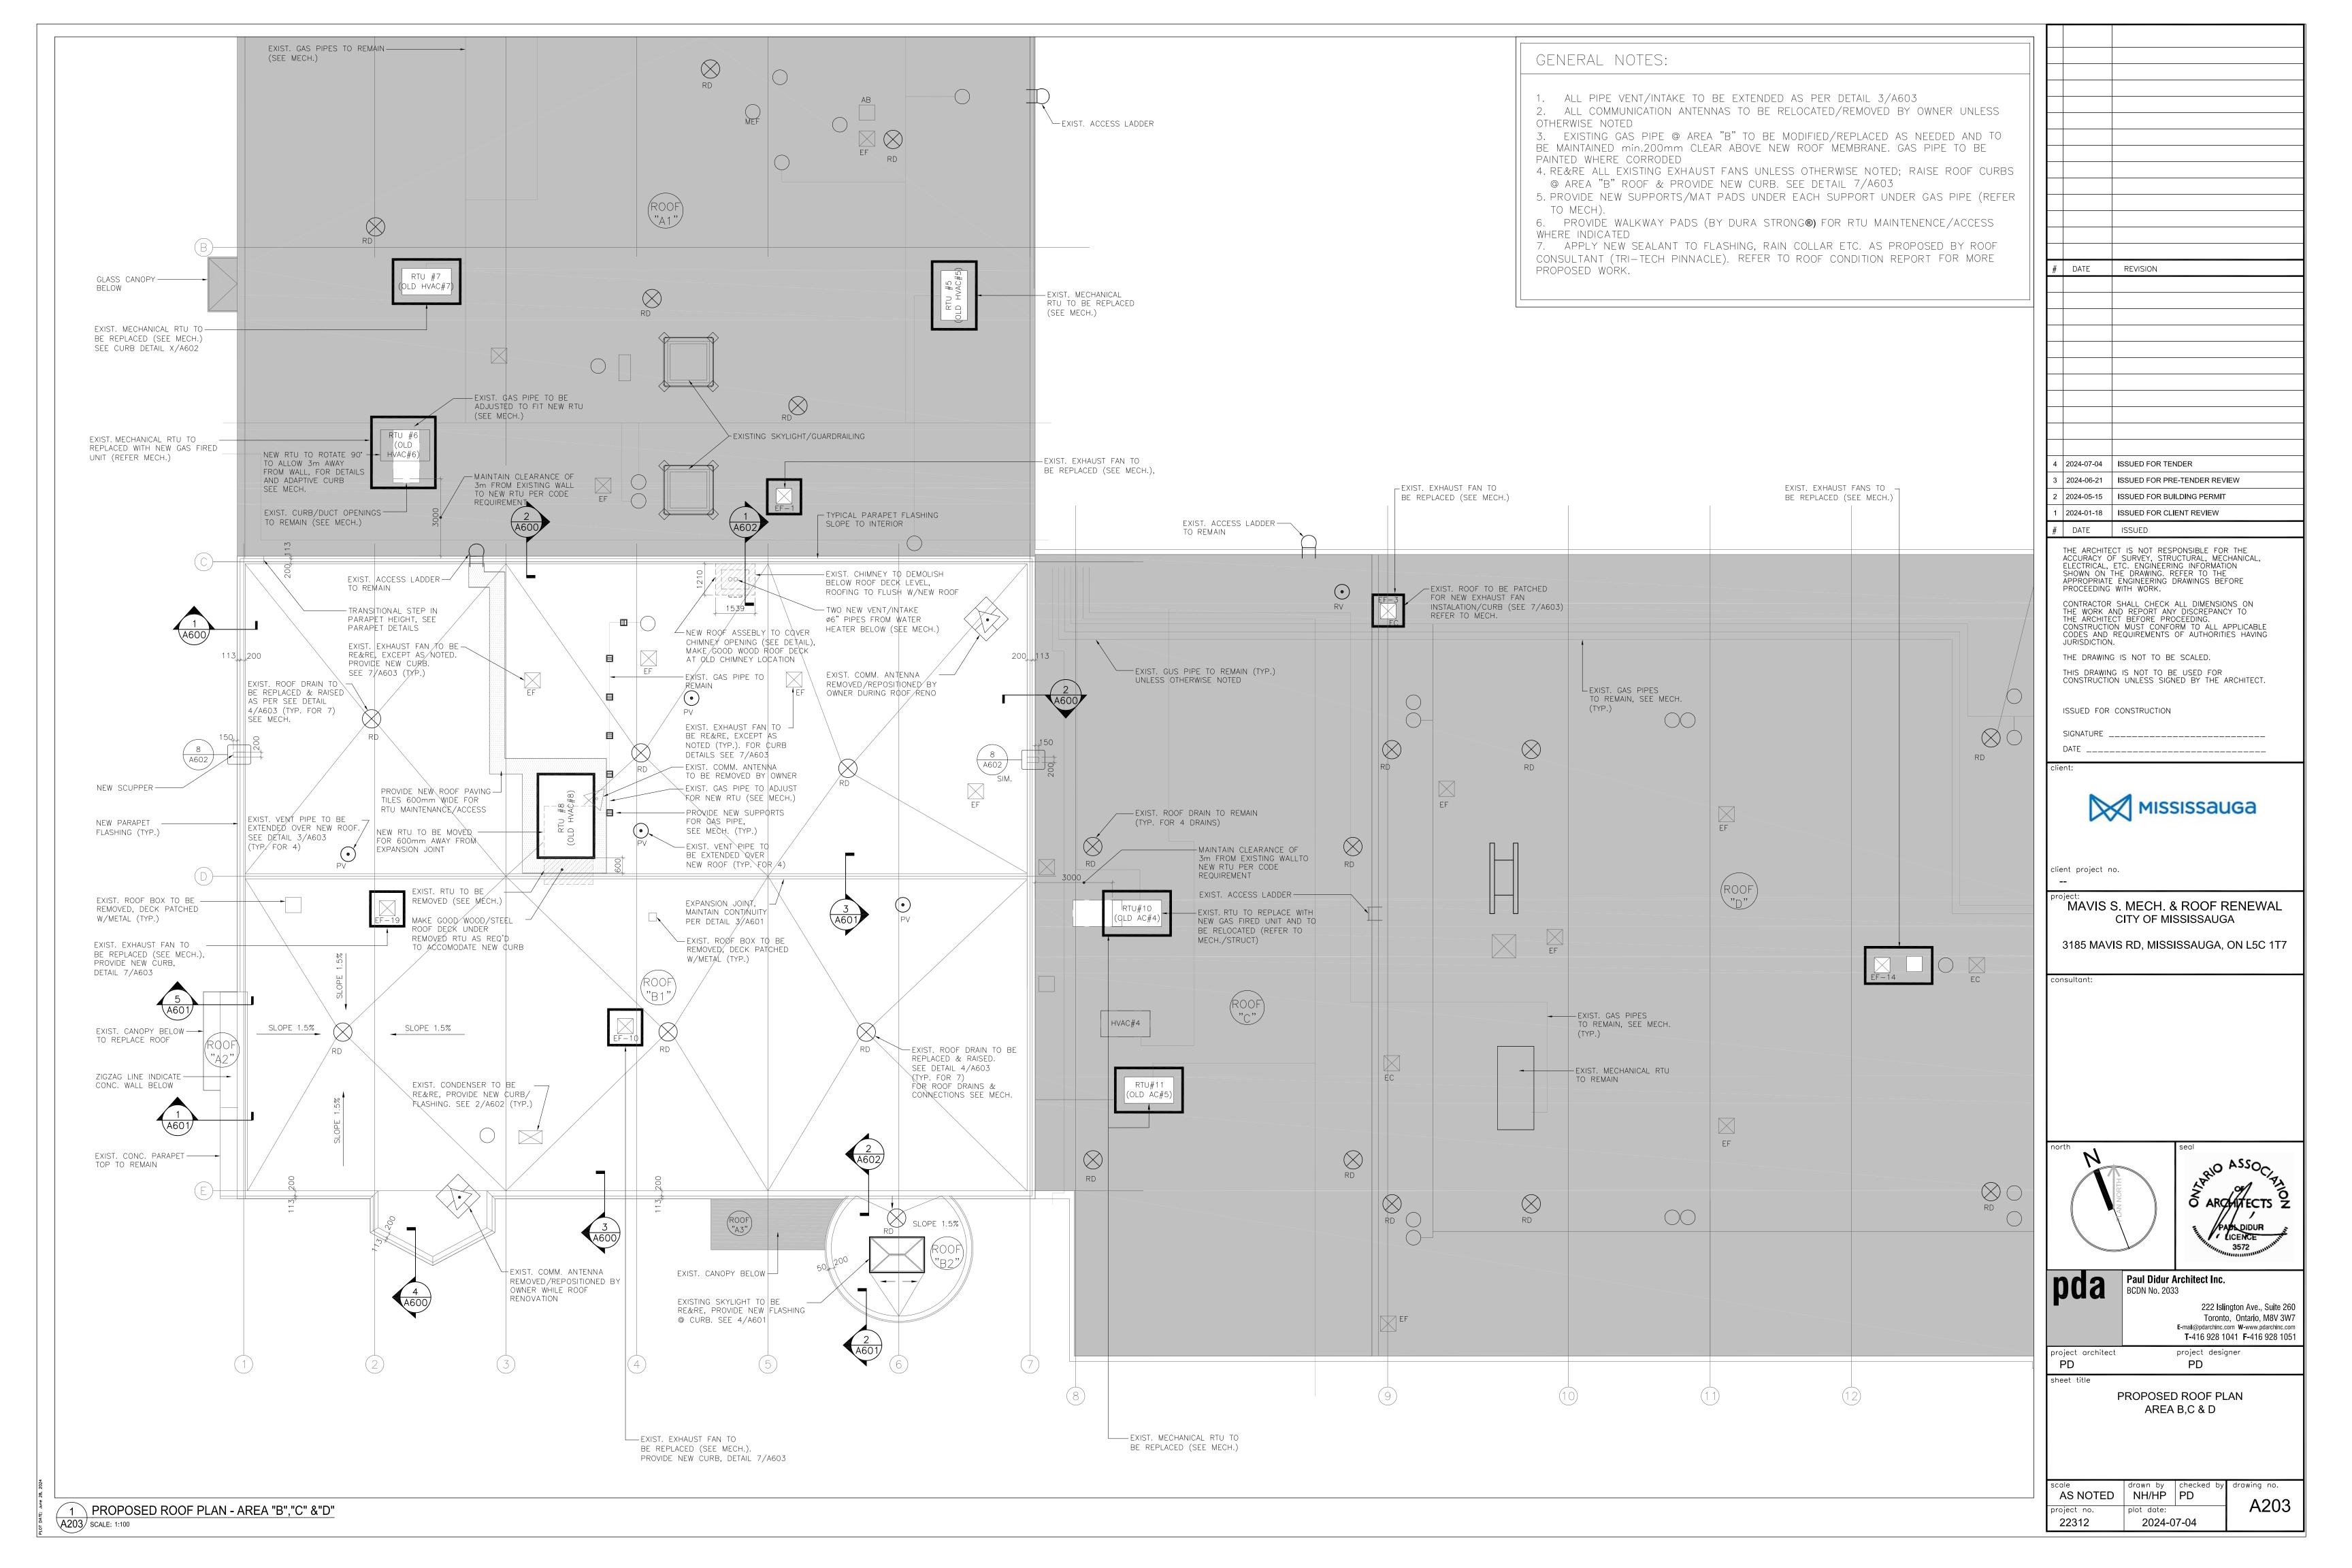


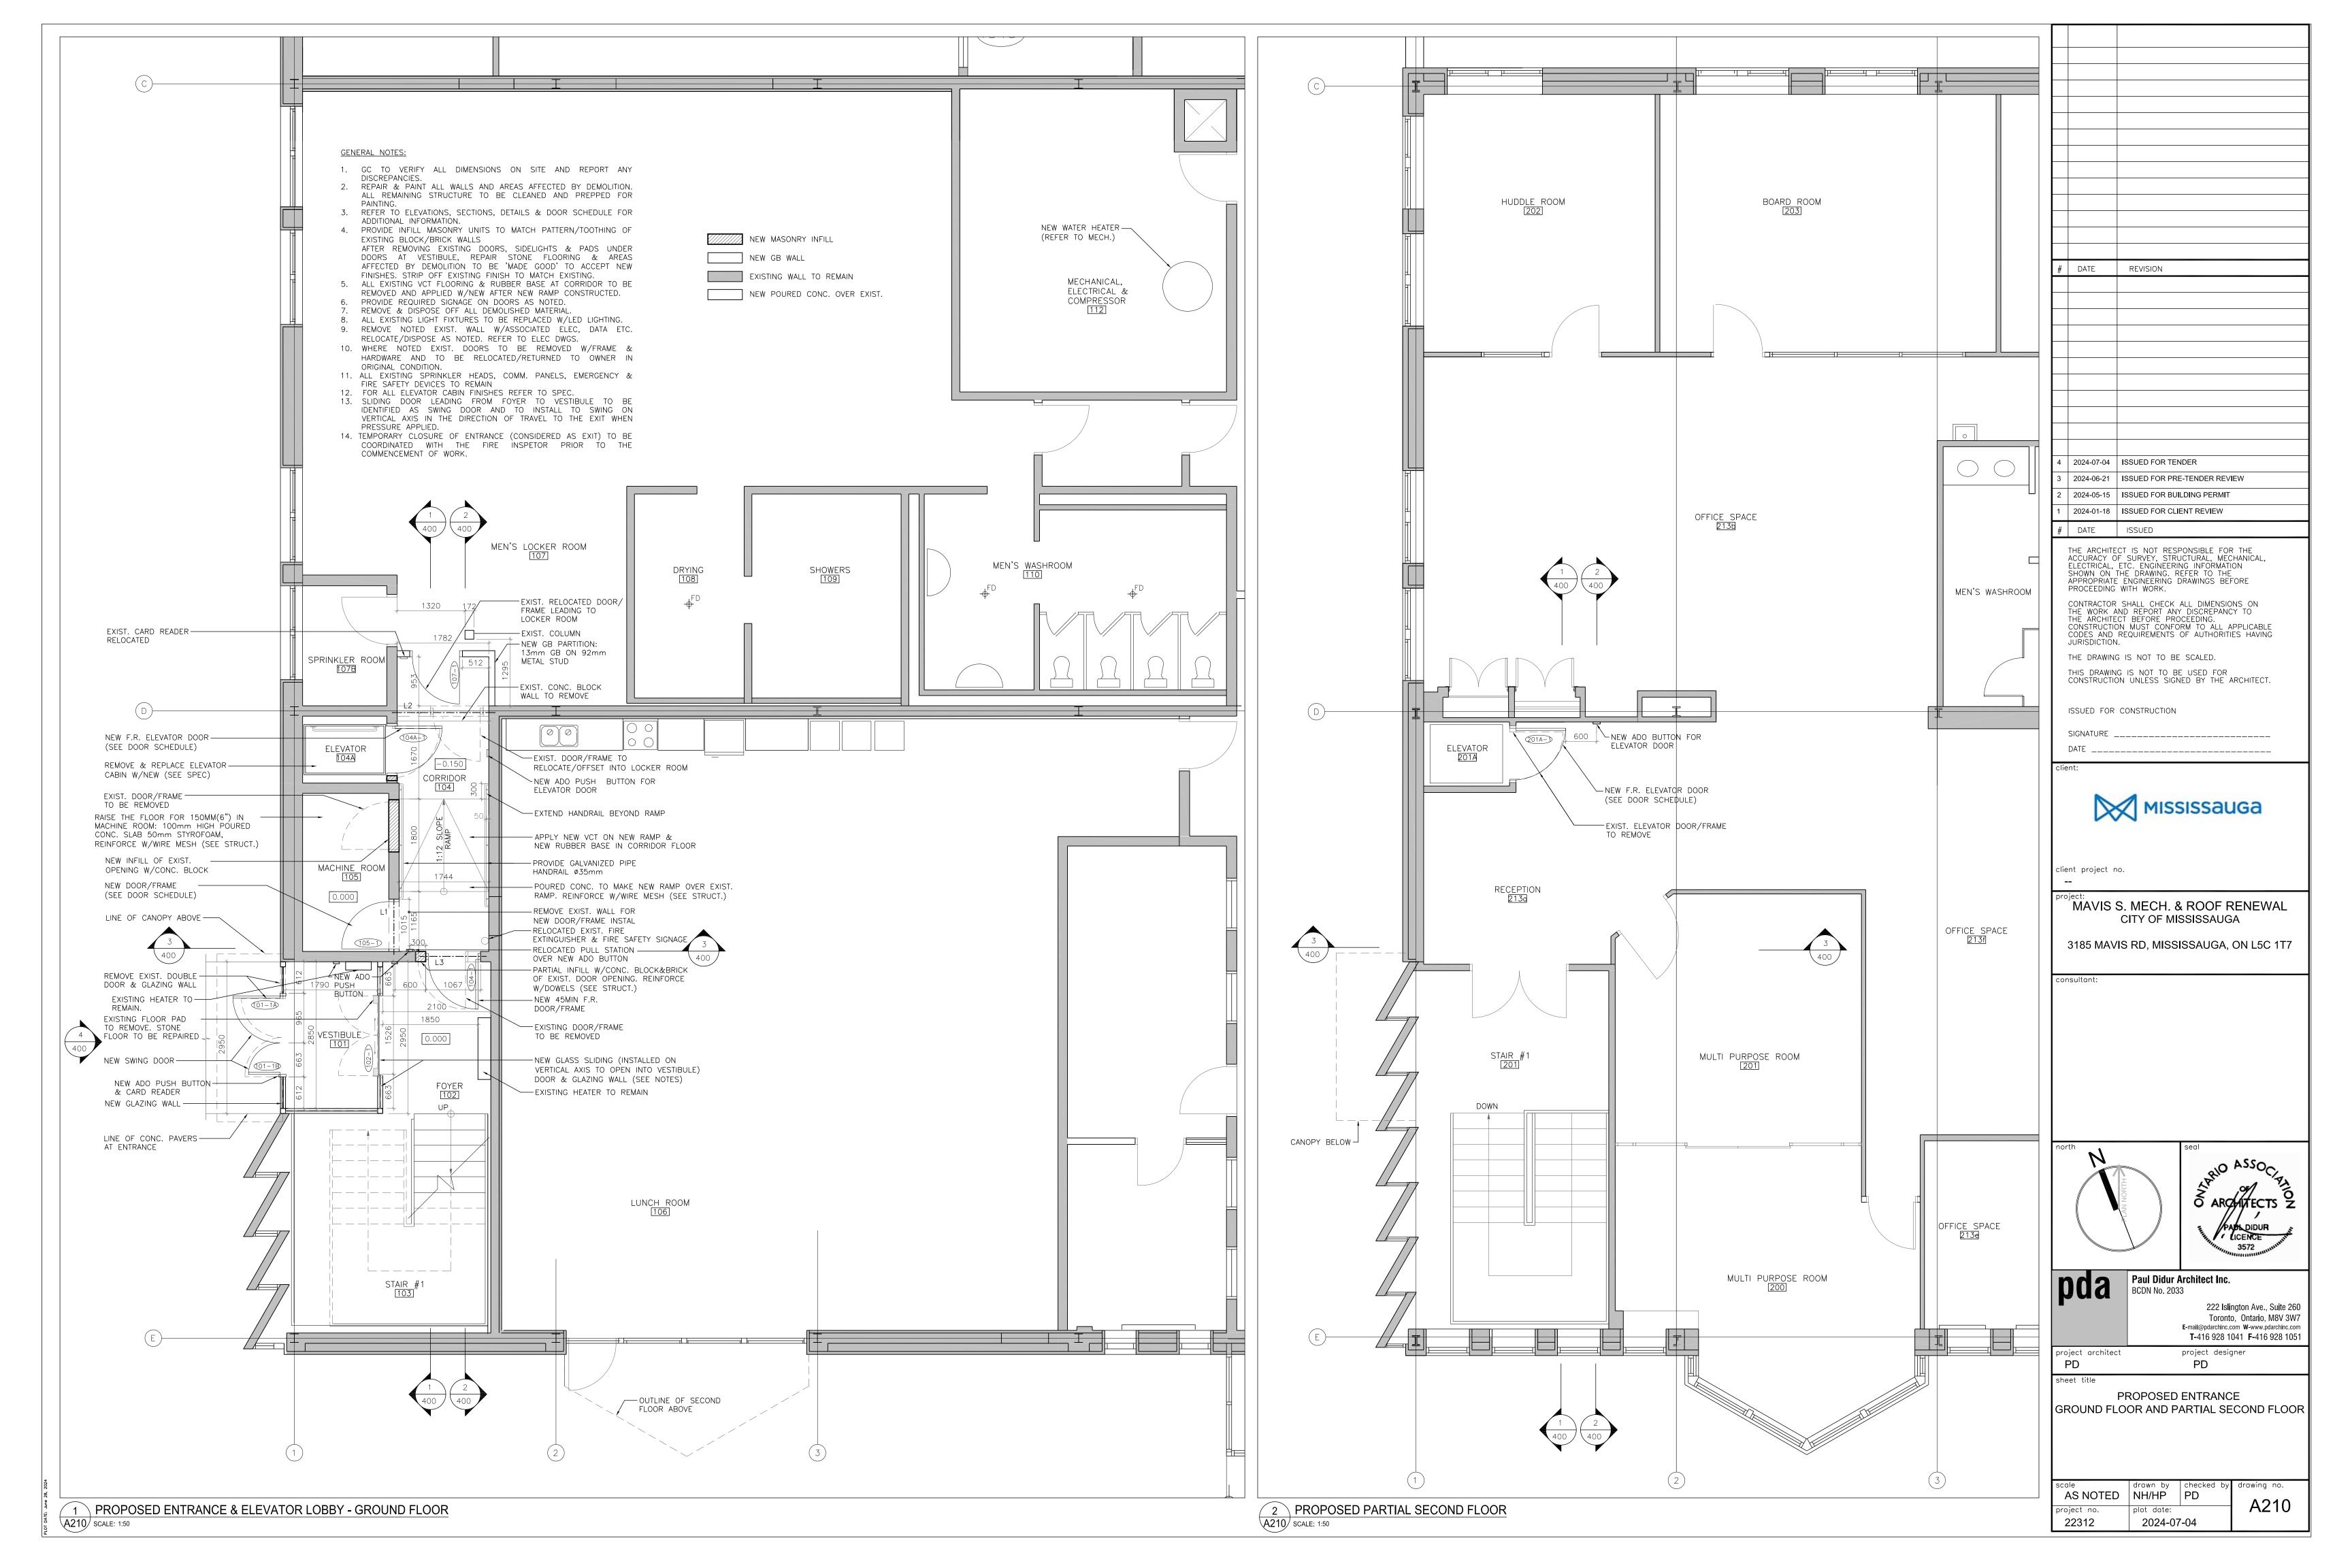

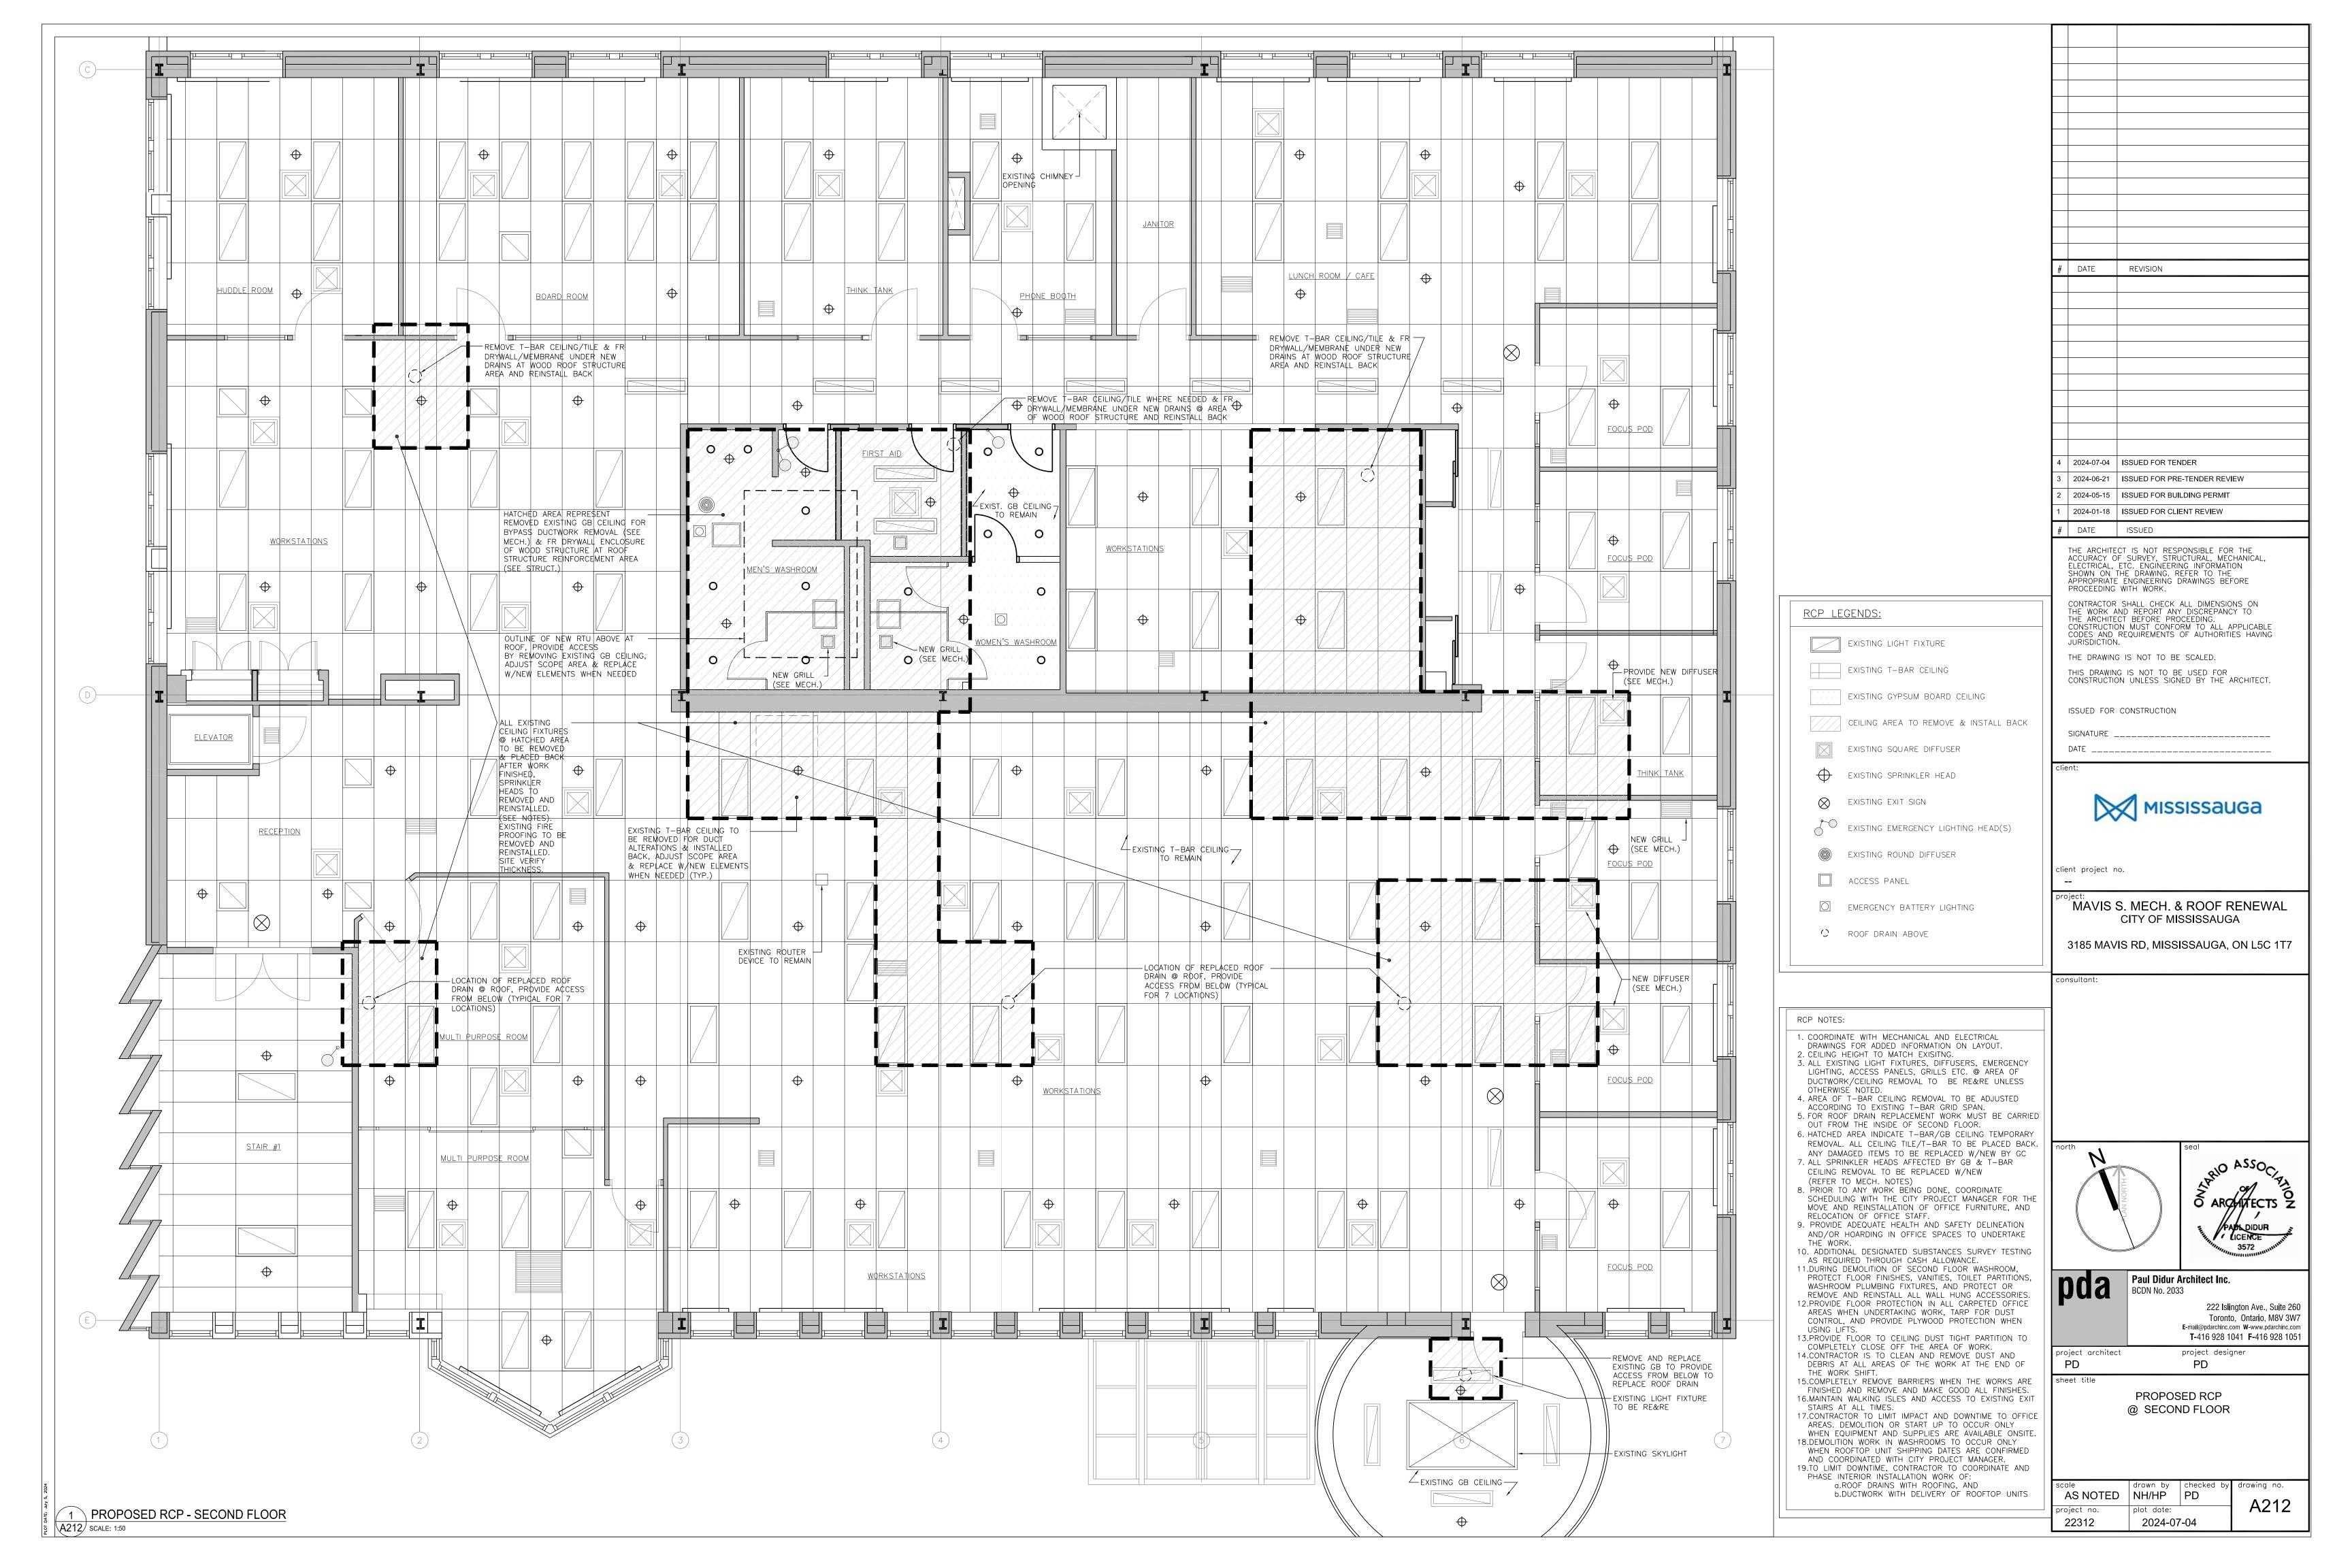

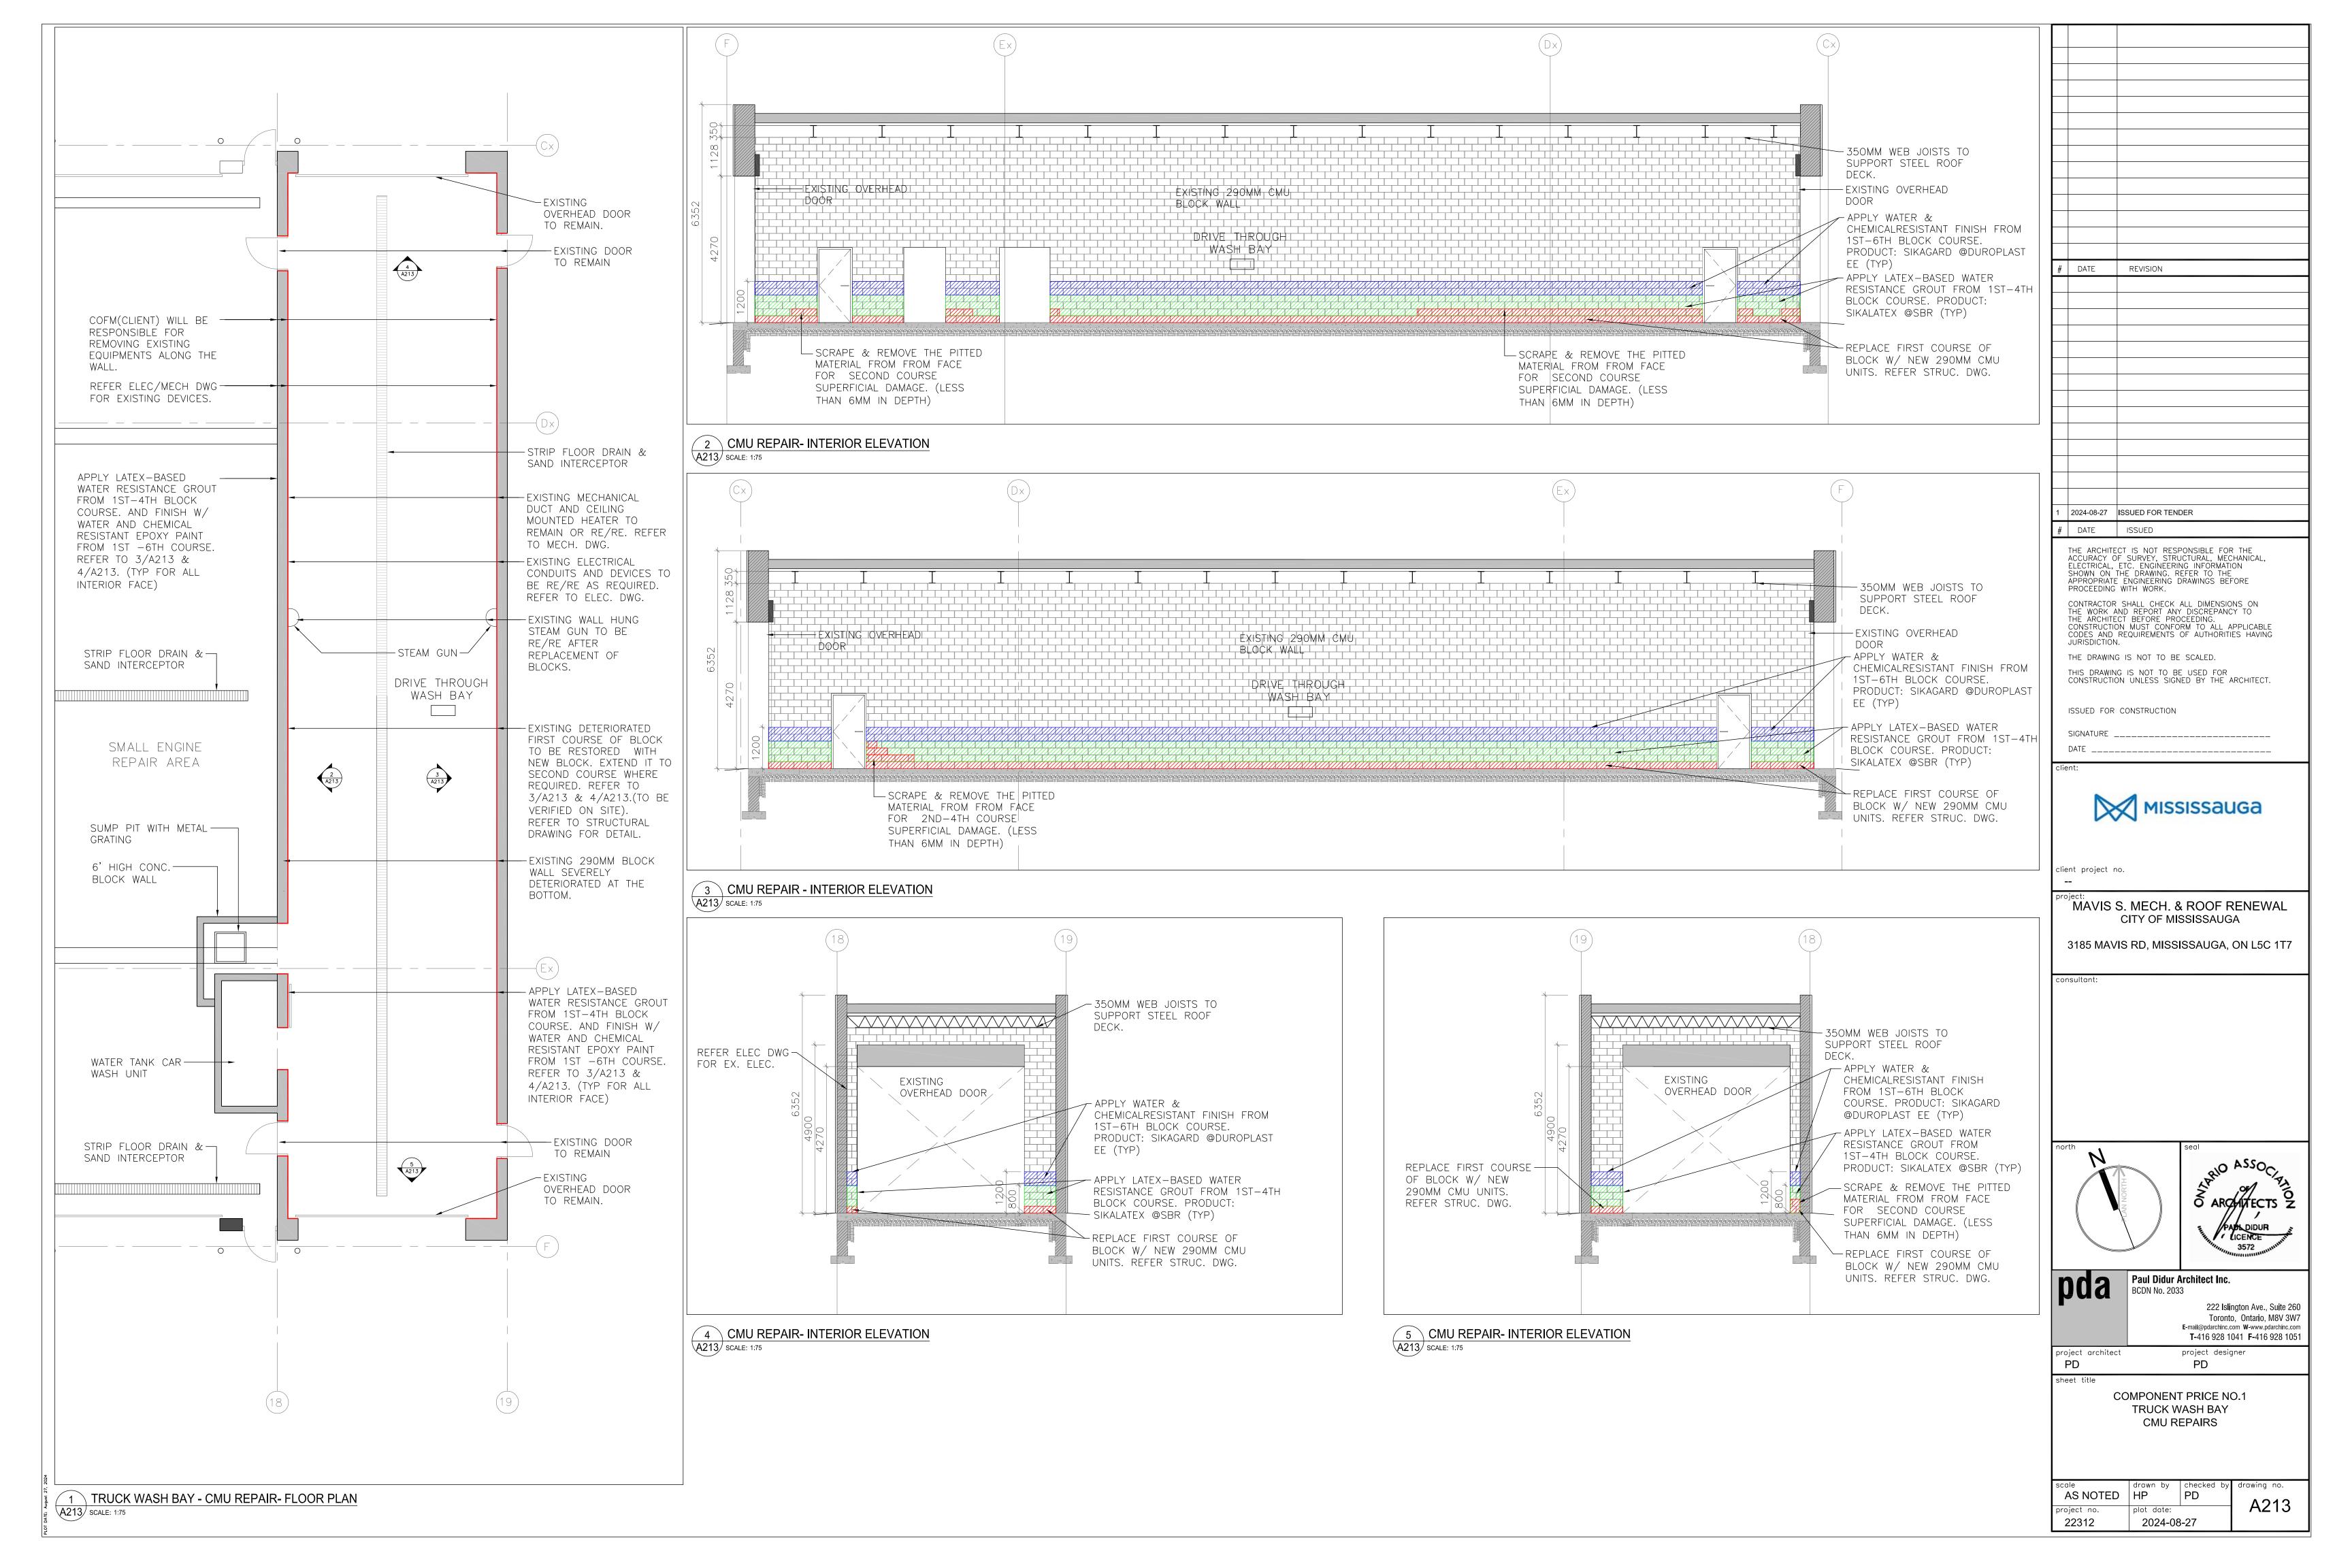




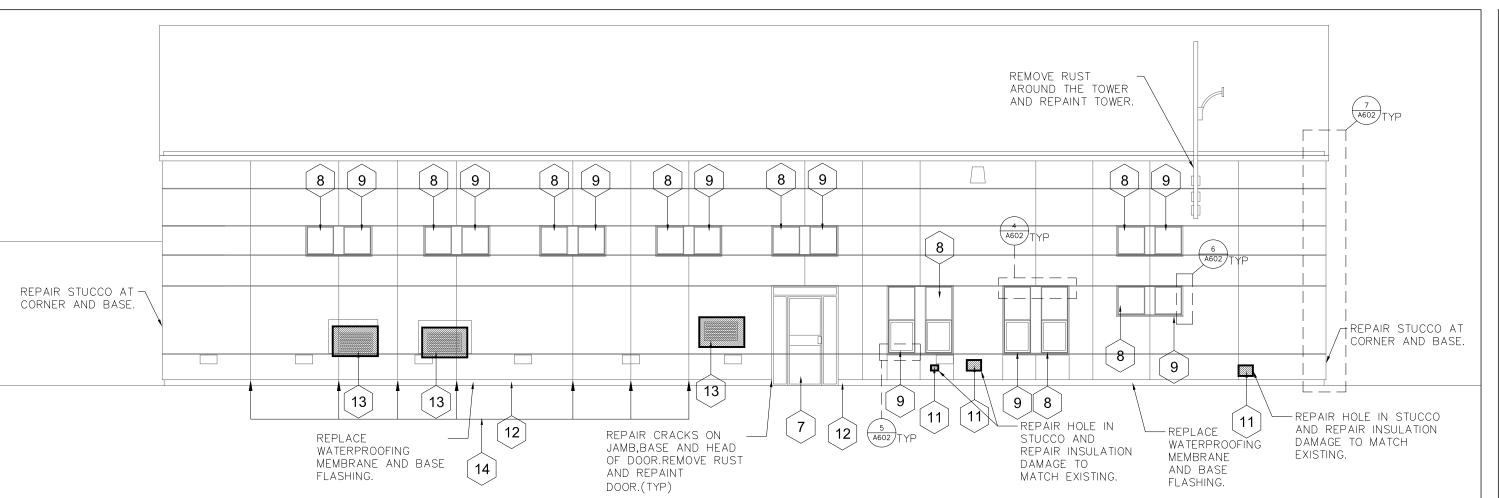

\ ELEVATION - NORTH


A300 SCALE: 1:100

A300 SCALE: 1:100

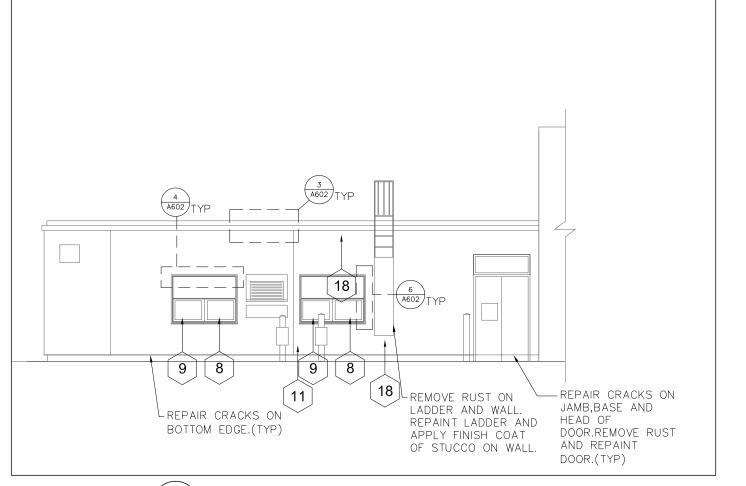

A300 SCALE: 1:100



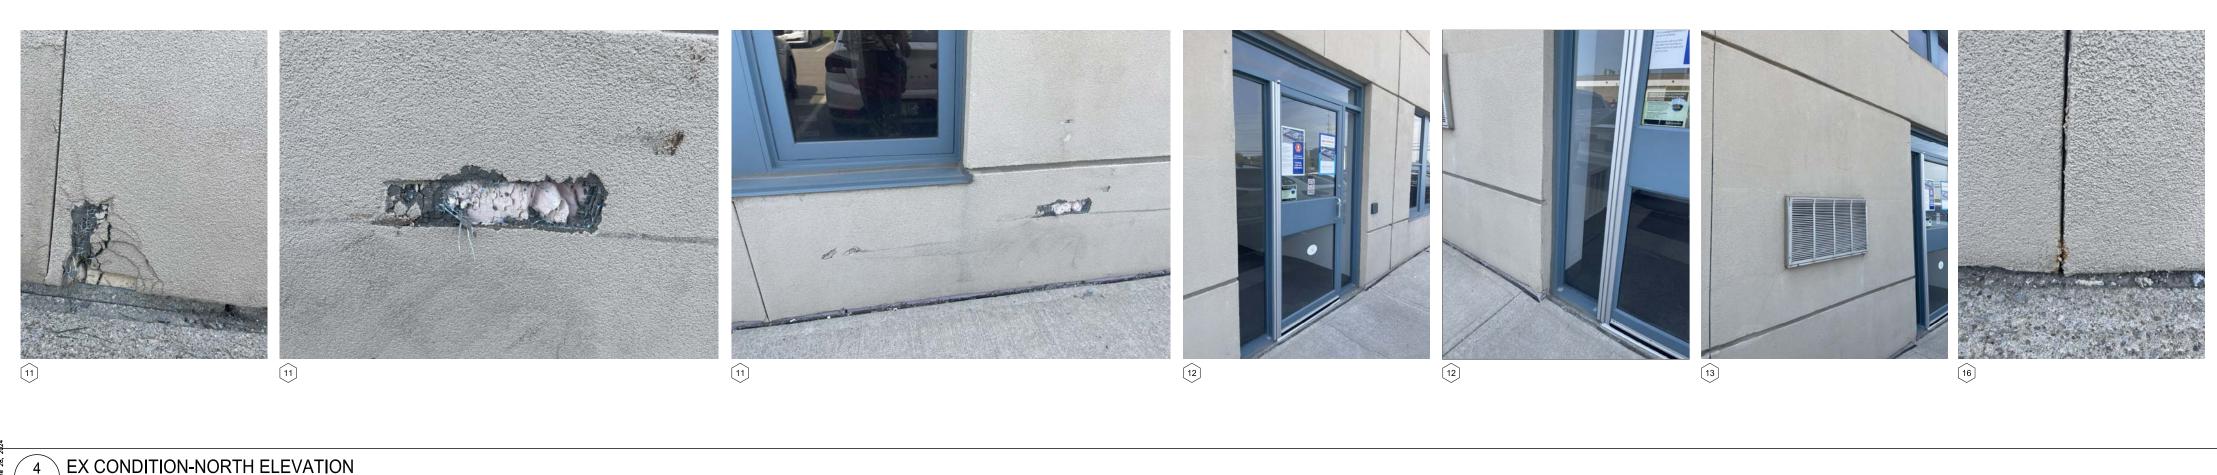

4 FILL GAP BETWEEN CONCRETE PAD AND STUCCO WALL. PROVIDE CAULKING AS

⑤ 3-5 SQ.MT REPAIR STUCCO, PATCH

HOLES AND WORN OUT ON EXISTING STUCCO, MAKE GOOD TO RECEIVE FINAL

(6) REPAIR STUCCO AT BASE AND REPAIR/REPLACE FLASHING.

(7) REPAIR STUCCO CRACKS AND REMOVE RUST ON DOOR FRAMES AND REPAINT

DOOR AND CANOPY.

® REPAIR CRACKS (IF ANY) AT WINDOW SILL, JAMB & HEAD BY MAINTAINING TYPICAL WINDOW TREATMENT. (TYP FOR ALL WINDOWS)

② REMOVE EXISTING GLASS CAULKING AND APPLY NEW CAULKING. CLEAN GLASS PANELS AFTER COMPLETION OF WORK. (TYP FOR ALL WINDOWS)

FOR NEW STUCCO. (3) REMOVE RUST FROM GRILL, REPAIR CRACKS AROUND THE GRILL AND REPLACE CAULKING.

> 14 REMOVE CAULKING AT JOINTS AND RE-CAULK AS NEEDED AND REPAIR JOINTS / STUCCO REVEALS AND MAKE GOOD TO RECEIVE FINAL COAT.

(5) REMOVE RUST AROUND THE PIPE, REPAIR CRACKS ON WALL AND MAKE GOOD TO RECEIVE NEW STUCCO.

(6) REMOVE RUST, REPAIR CRACKS AND STUCCO WORN AND INSULATION AND

MAKE GOOD.

(7) REMOVE RUST FROM METAL FRAME AND REPAINT THE DOOR. ® REMOVE RUST FROM REINFORCEMENT BARS AND CLEAN THE WALL TO APPLY

(9) REPAIR CRACKS AND HOLES AROUND THE WINDOWS AND DOORS. (TYP)



client project no.

MAVIS S. MECH. & ROOF RENEWAL CITY OF MISSISSAUGA

3185 MAVIS RD, MISSISSAUGA, ON L5C 1T7

consultant:

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project designer

PD


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ELEVATIONS STUCCO REPAIR

drawing no. A300 roject no. plot date: 22312 2024-07-04



6 EX CONDITION-PARTIAL NORTH ELEVATION A300 SCALE: 1:100

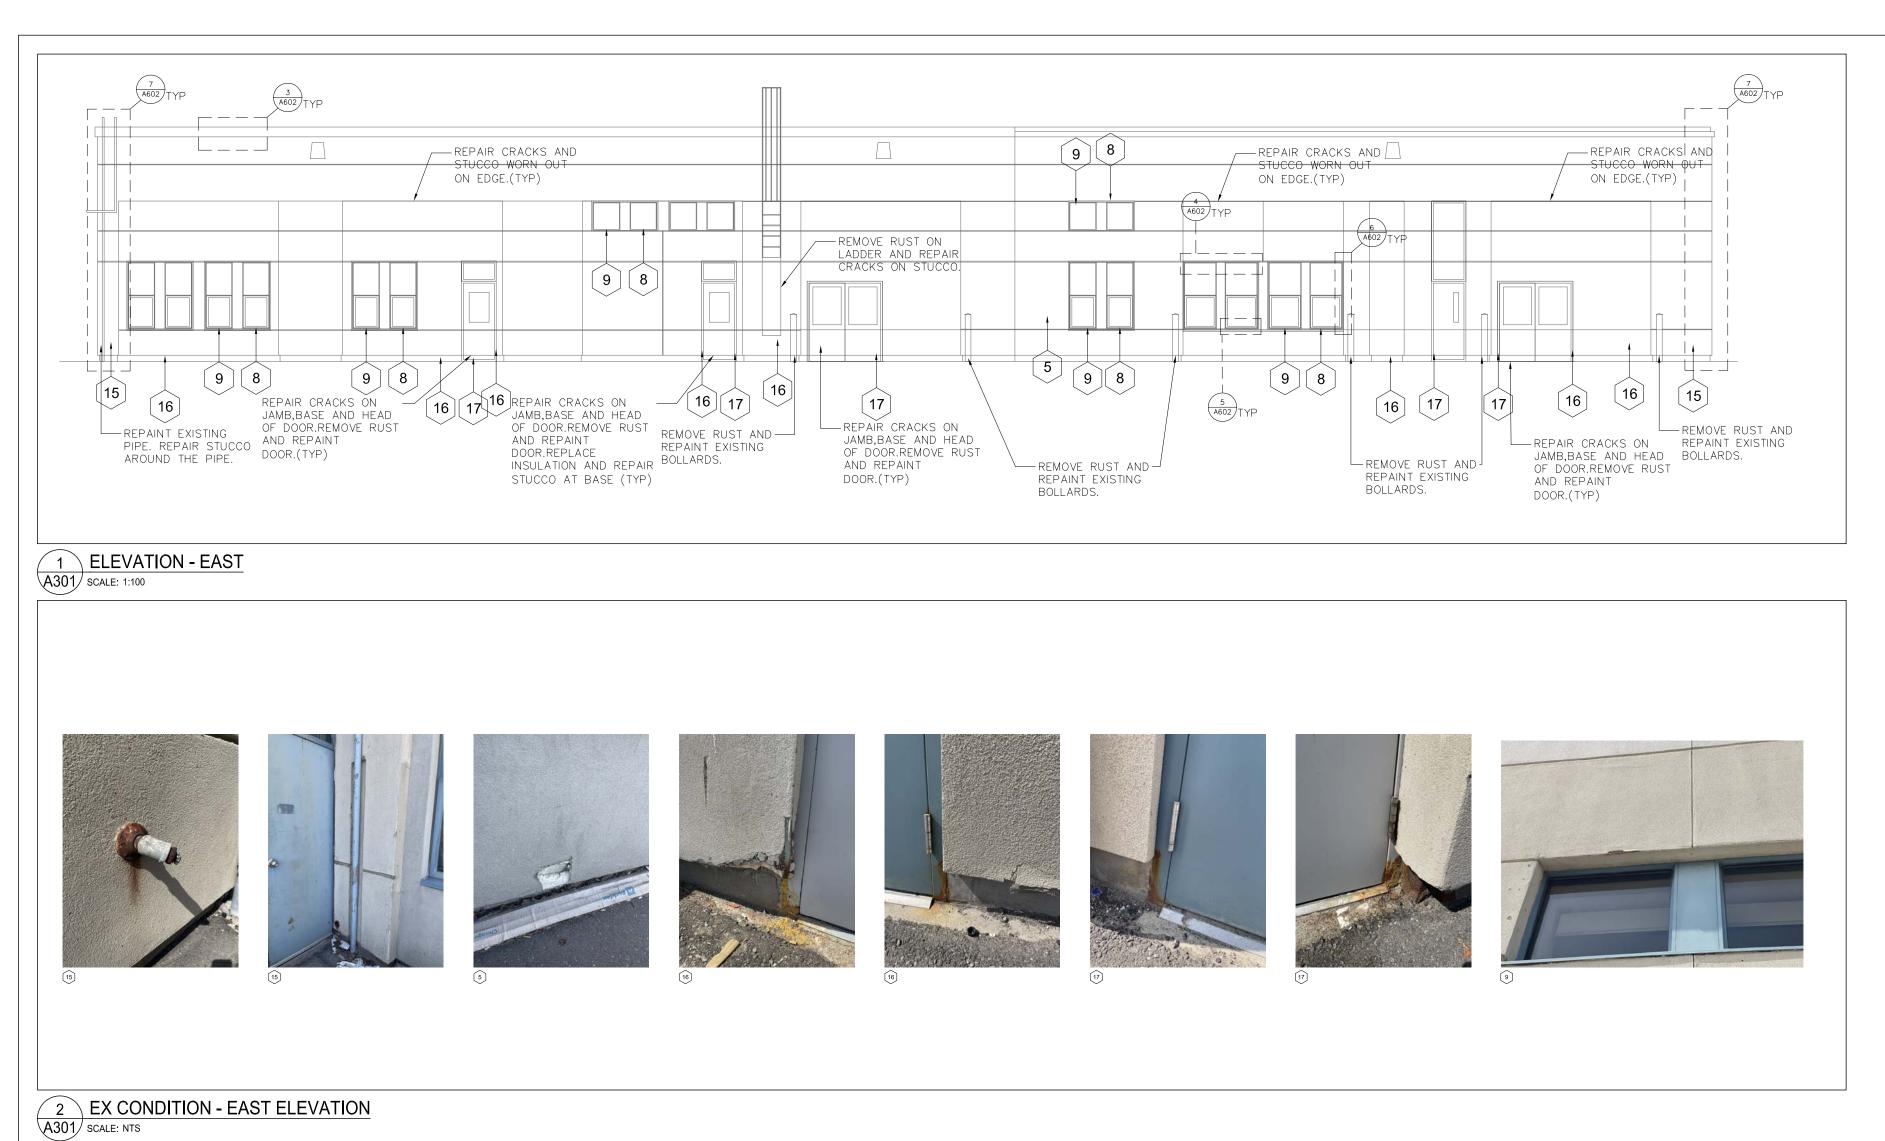

9 REPAIR HOLES
AND RUST ON
WALL MAKE [19] 18 -REPAIR CRACKS ON 19 REPAIR HOLES — AND RUST ON WALL. MAKE GOOD FOR FINISH REPAIR HOLE IN -JAMB, BASE AND HEAD OF DOOR, SIDELITE AND CANOPY. REMOVE RUST AND 11 5 A602 TYP STUCCO AND WALL. MAKE REPAIR INSULATION DAMAGE TO MATCH EXISTING. GOOD FOR FINISH REPAINT DOOR, SIDELITE COAT.(TYP) COAT.(TYP) AND CANOPY.(TYP)

3 ELEVATION - SOUTH SCALE: 1:100














- NOTE: REFER TO STUCCO REPAIR TYPICAL DETAILS ON A602.
- ① FRONT ENTRANCE. REPAINT EXISTING CANOPY.
- 2 REPLACE DAMAGED DOOR W/ NEW DOOR AS SPECIFIED.
- ③ REPAIR STUCCO CRACKS AT CORNERS AND WALL EDGE.
- 4 FILL GAP BETWEEN CONCRETE PAD AND STUCCO WALL. PROVIDE CAULKING AS REQUIRED.
- (5) 3-5 SQ.MT REPAIR STUCCO, PATCH HOLES AND WORN OUT ON EXISTING STUCCO, MAKE GOOD TO RECEIVE FINAL COAT.
- ® REPAIR STUCCO AT BASE AND REPAIR/REPLACE FLASHING.
- (7) REPAIR STUCCO CRACKS AND REMOVE RUST ON DOOR FRAMES AND REPAINT DOOR AND CANOPY.
- ® REPAIR CRACKS (IF ANY) AT WINDOW SILL, JAMB & HEAD BY MAINTAINING TYPICAL WINDOWS)
- ALL WINDOWS)

 REMOVE EXISTING GLASS CAULKING AND APPLY NEW CAULKING. CLEAN GLASS PANELS AFTER COMPLETION OF WORK.

(TYP FOR ALL WINDOWS)

- (1) REPAIR STUCCO CRACKS AT CORNER. REFER DETAIL(TYP)
- (1) REPAIR STUCCO DAMAGE AND REPLACE DAMAGED INSULATION LAYER IF NEEDED.
- REPLACE STUCCO DAMAGE AT BOTTOM EDGE OF WALL AND REPLACE DAMAGED INSULATION IF REQUIRED. MAKE GOOD FOR NEW STUCCO.
- REMOVE RUST FROM GRILL, REPAIR CRACKS AROUND THE GRILL AND REPLACE CAULKING.
- REMOVE CAULKING AT JOINTS AND RE-CAULK AS NEEDED AND REPAIR JOINTS / STUCCO REVEALS AND MAKE GOOD TO RECEIVE FINAL COAT.
- REMOVE RUST AROUND THE PIPE, REPAIR CRACKS ON WALL AND MAKE GOOD TO RECEIVE NEW STUCCO.
- REMOVE RUST, REPAIR CRACKS AND STUCCO WORN AND INSULATION AND MAKE GOOD.
- (1) REMOVE RUST FROM METAL FRAME AND REPAINT THE DOOR.
- REMOVE RUST FROM REINFORCEMENT BARS AND CLEAN THE WALL TO APPLY FINAL COAT.
- (9) REPAIR CRACKS AND HOLES AROUND THE WINDOWS AND DOORS. (TYP)

5 GENERAL NOTES
A301 SCALE: NTS

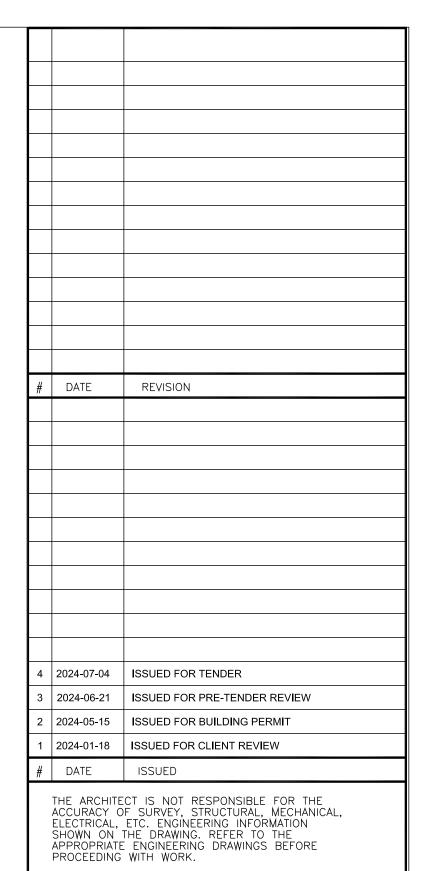

CONTRACTOR SHALL CHECK ALL DIMENSIONS ON THE WORK AND REPORT ANY DISCREPANCY TO THE ARCHITECT BEFORE PROCEEDING. CONSTRUCTION MUST CONFORM TO ALL APPLICABLE CODES AND REQUIREMENTS OF AUTHORITIES HAVING JURISDICTION.

THE DRAWING IS NOT TO BE SCALED.

THIS DRAWING IS NOT TO BE USED FOR CONSTRUCTION UNLESS SIGNED BY THE ARCHITECT.

ISSUED FOR CONSTRUCTION

SIGNATURE _____

client:



client project no.

MAVIS S. MECH. & ROOF RENEWAL
CITY OF MISSISSAUGA

3185 MAVIS RD, MISSISSAUGA, ON L5C 1T7

consultant:

O ARCHITECTS Z

Paul Didur Architect Inc.

Paul Didur Architect Inc. BCDN No. 2033

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project designer


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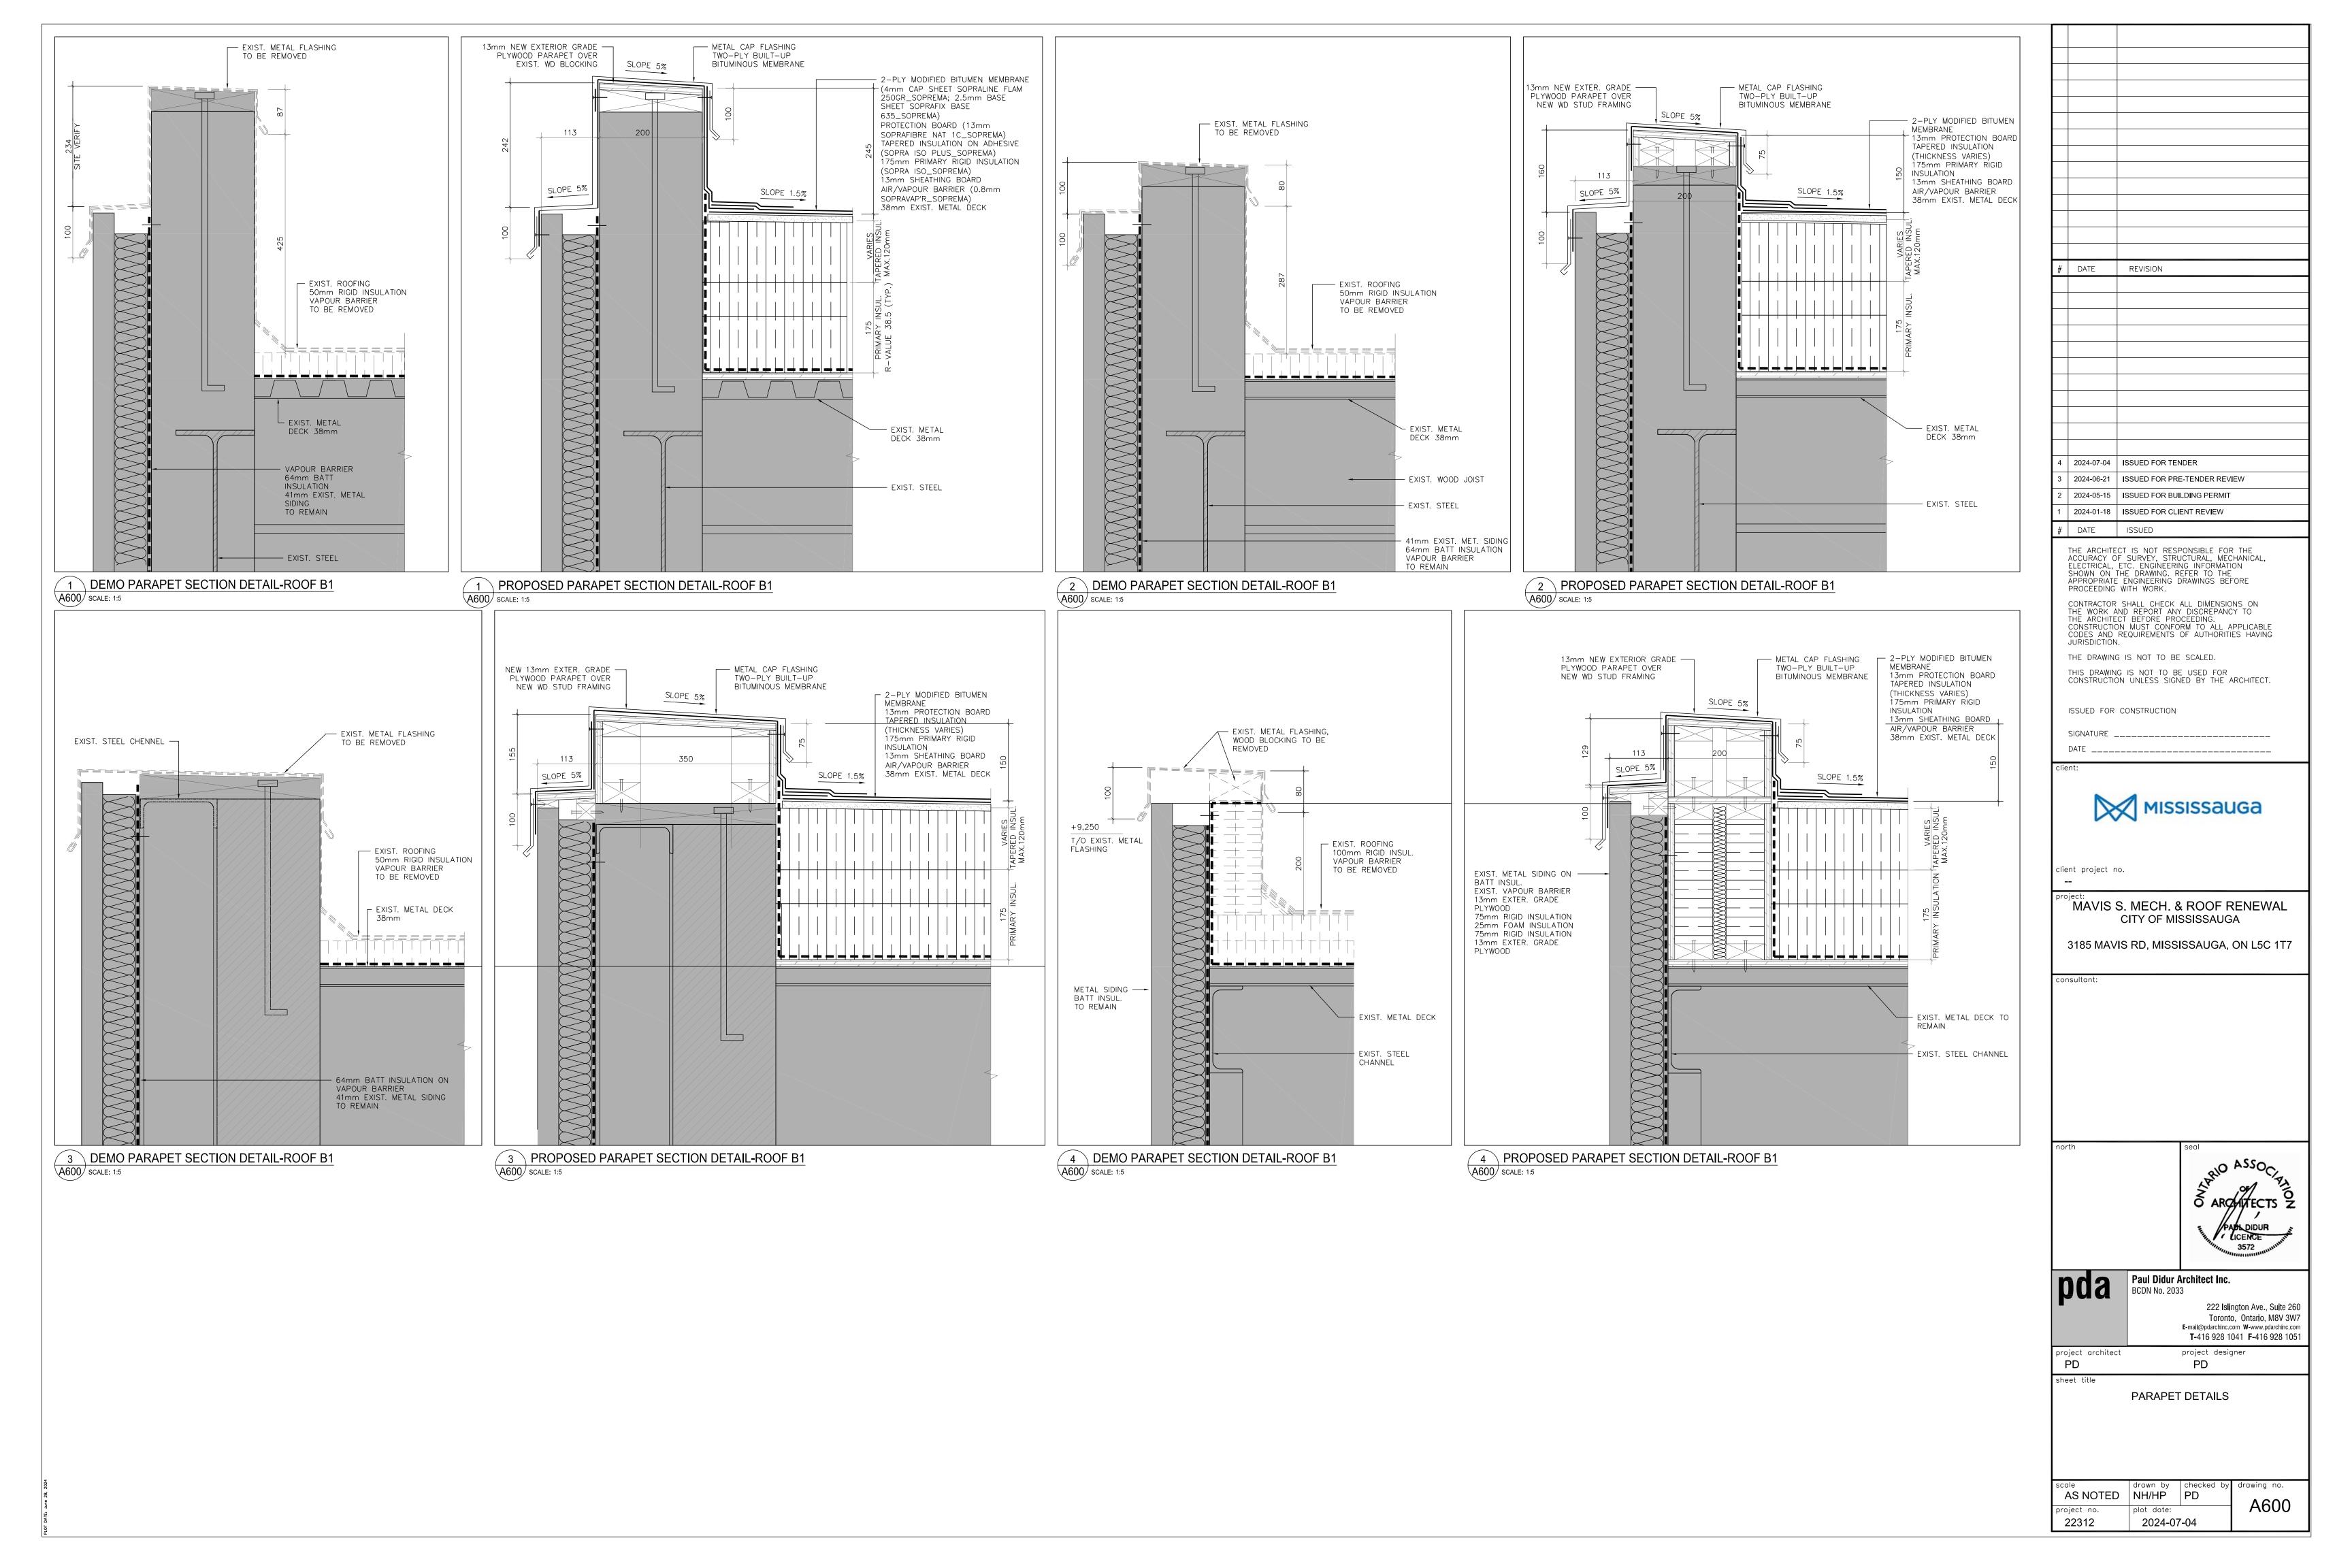
project architect


ELEVATIONS STUCCO REPAIR


scale
AS NOTED NH/HP PD drawing no.


project no. plot date: A301
22312 2024-07-04



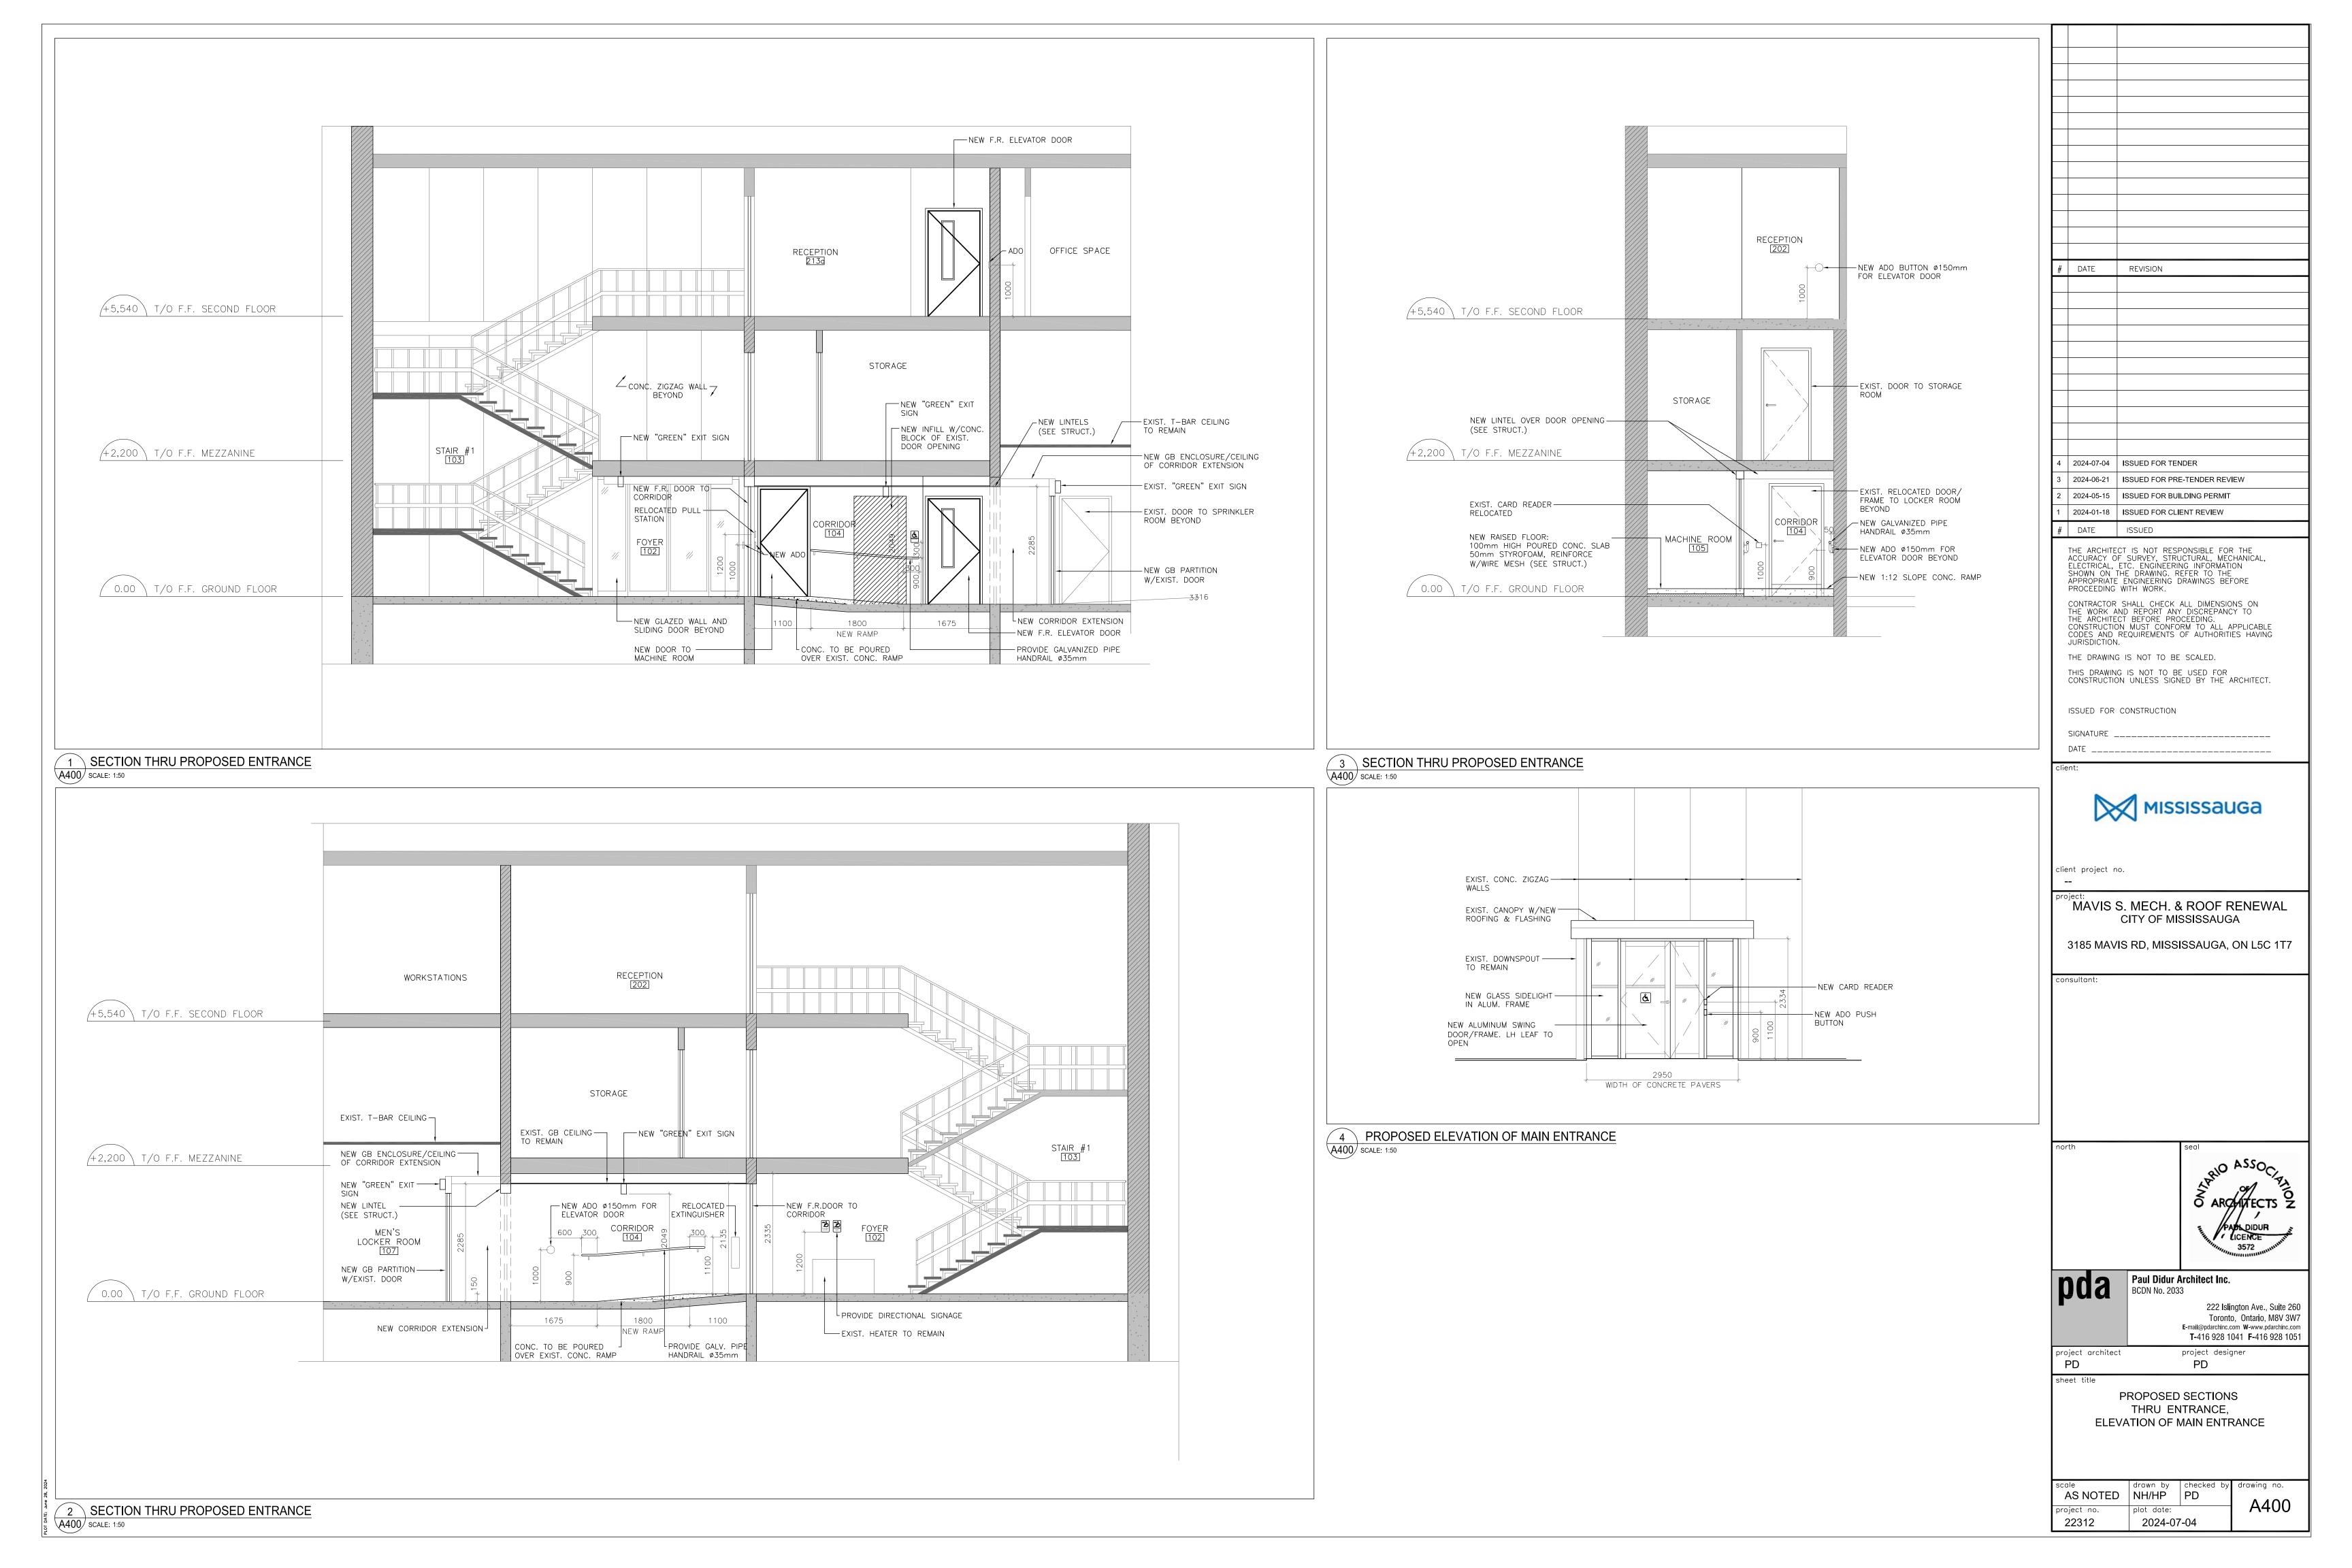

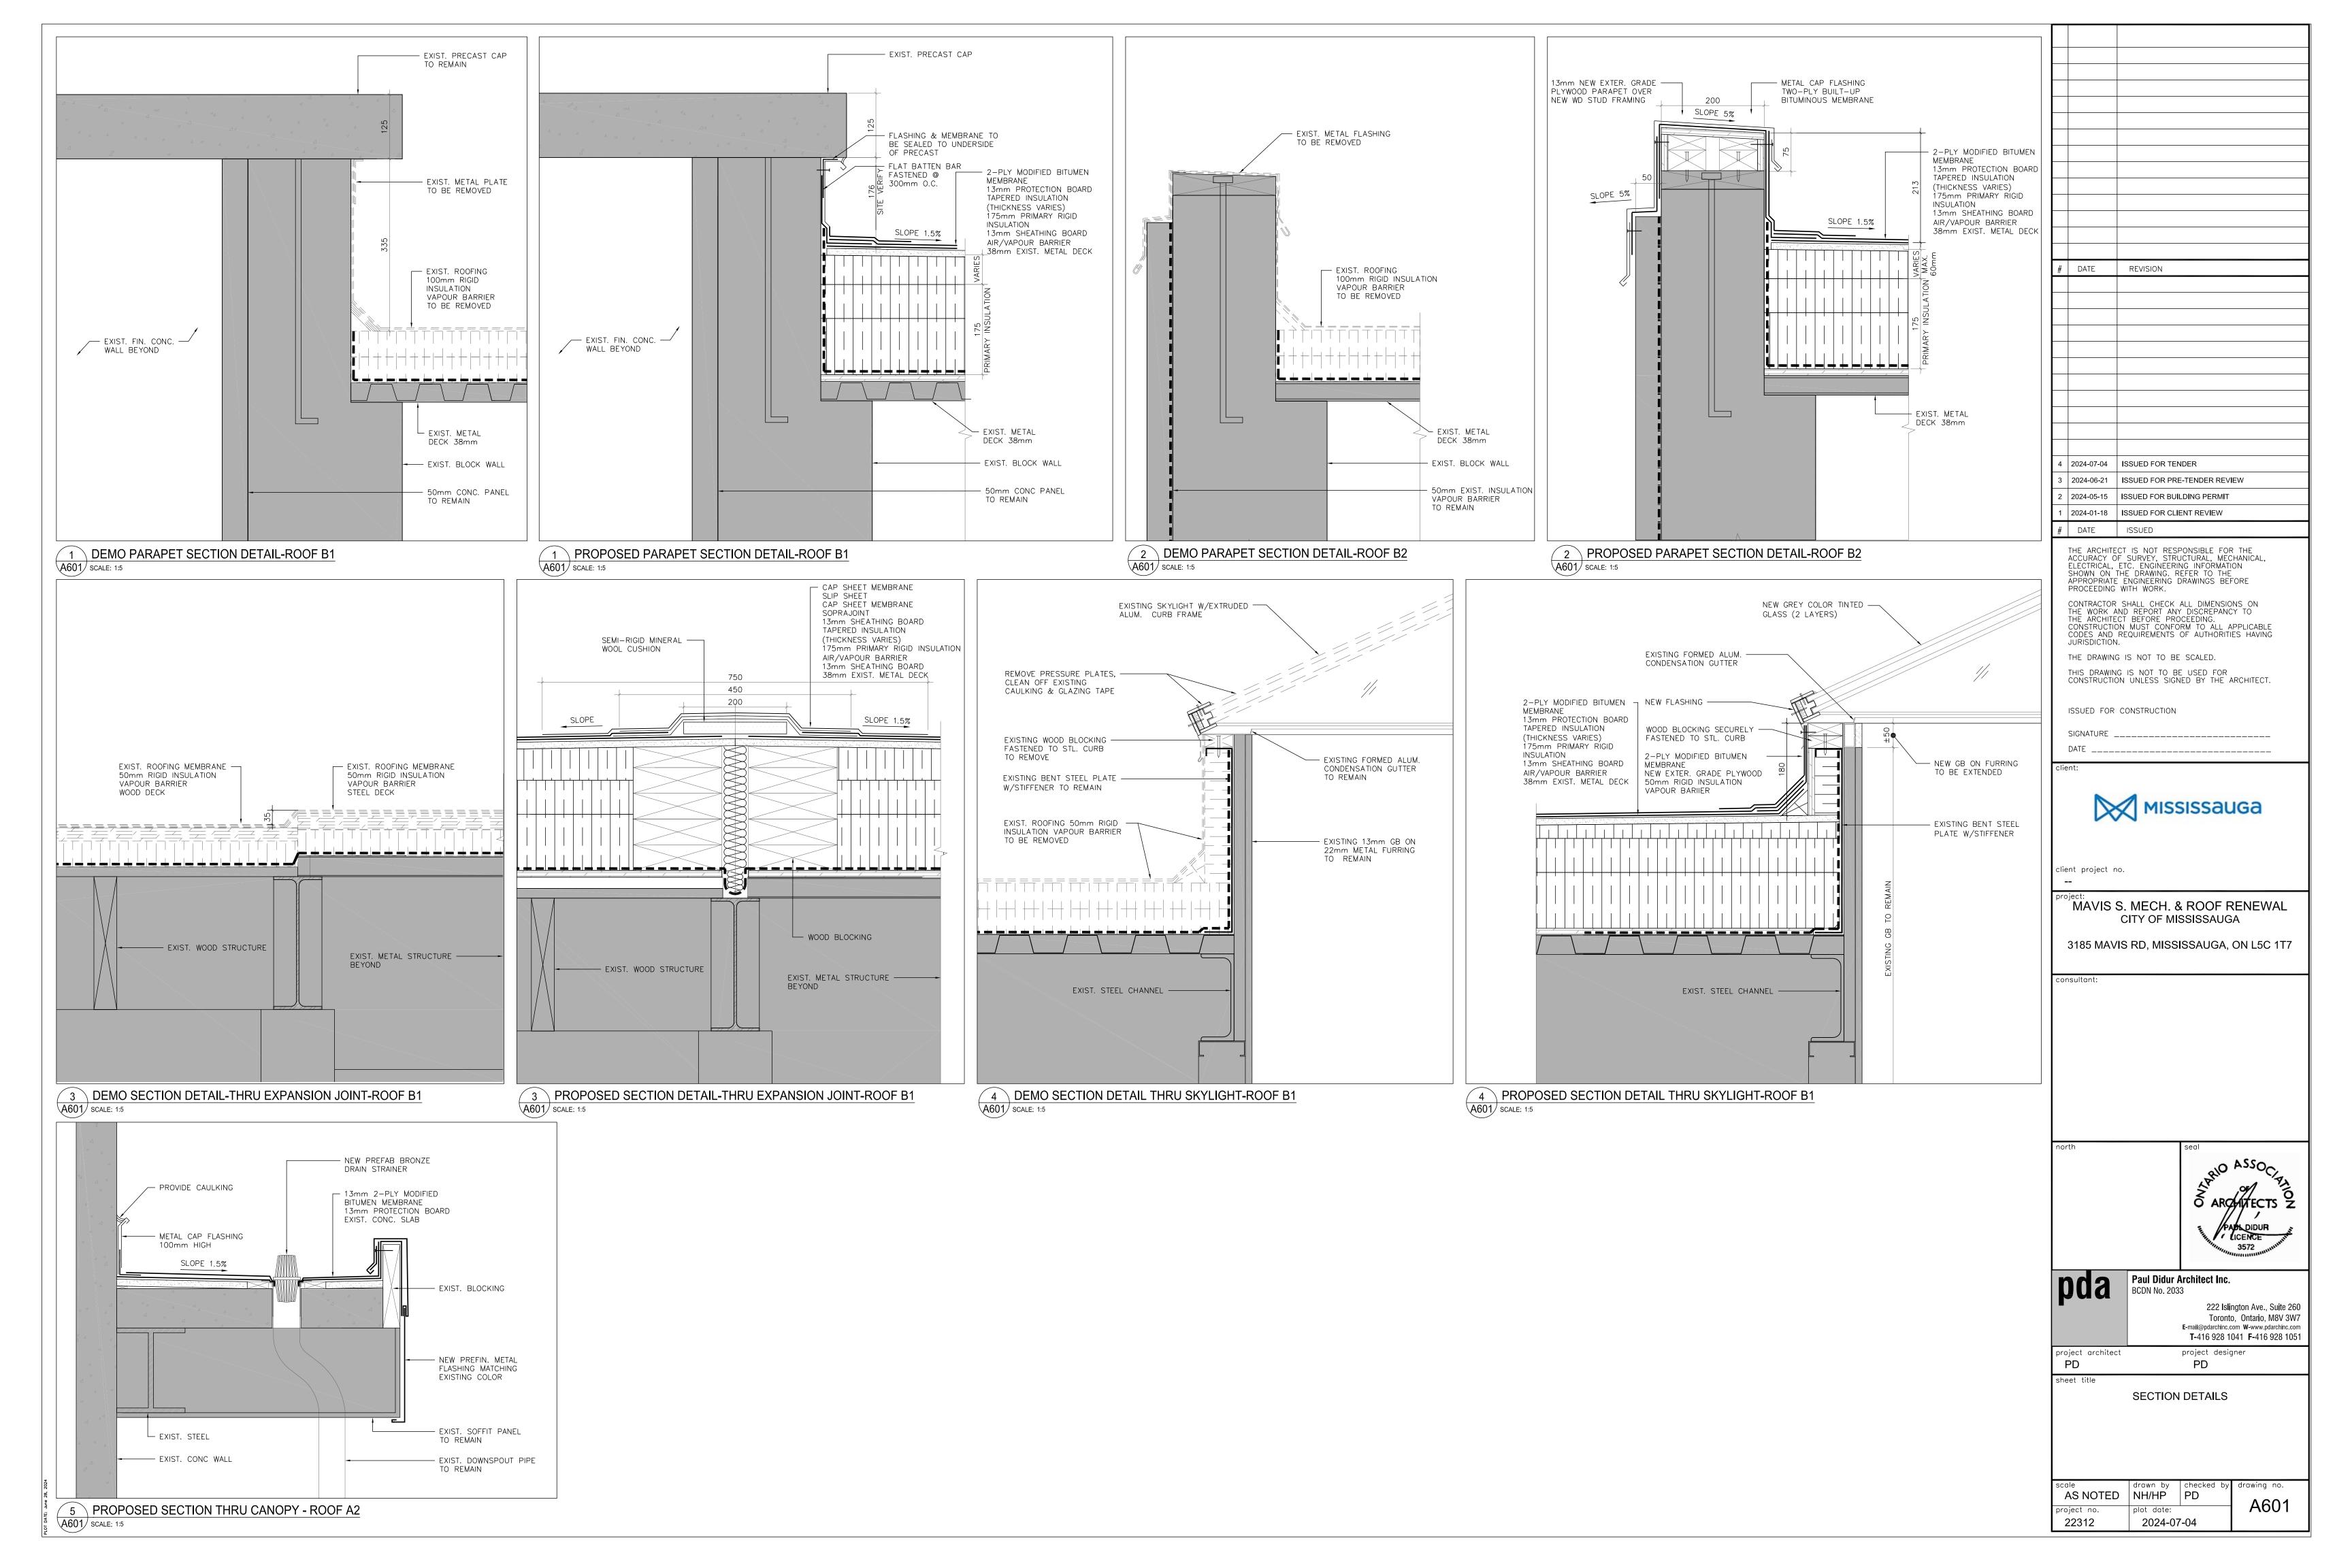

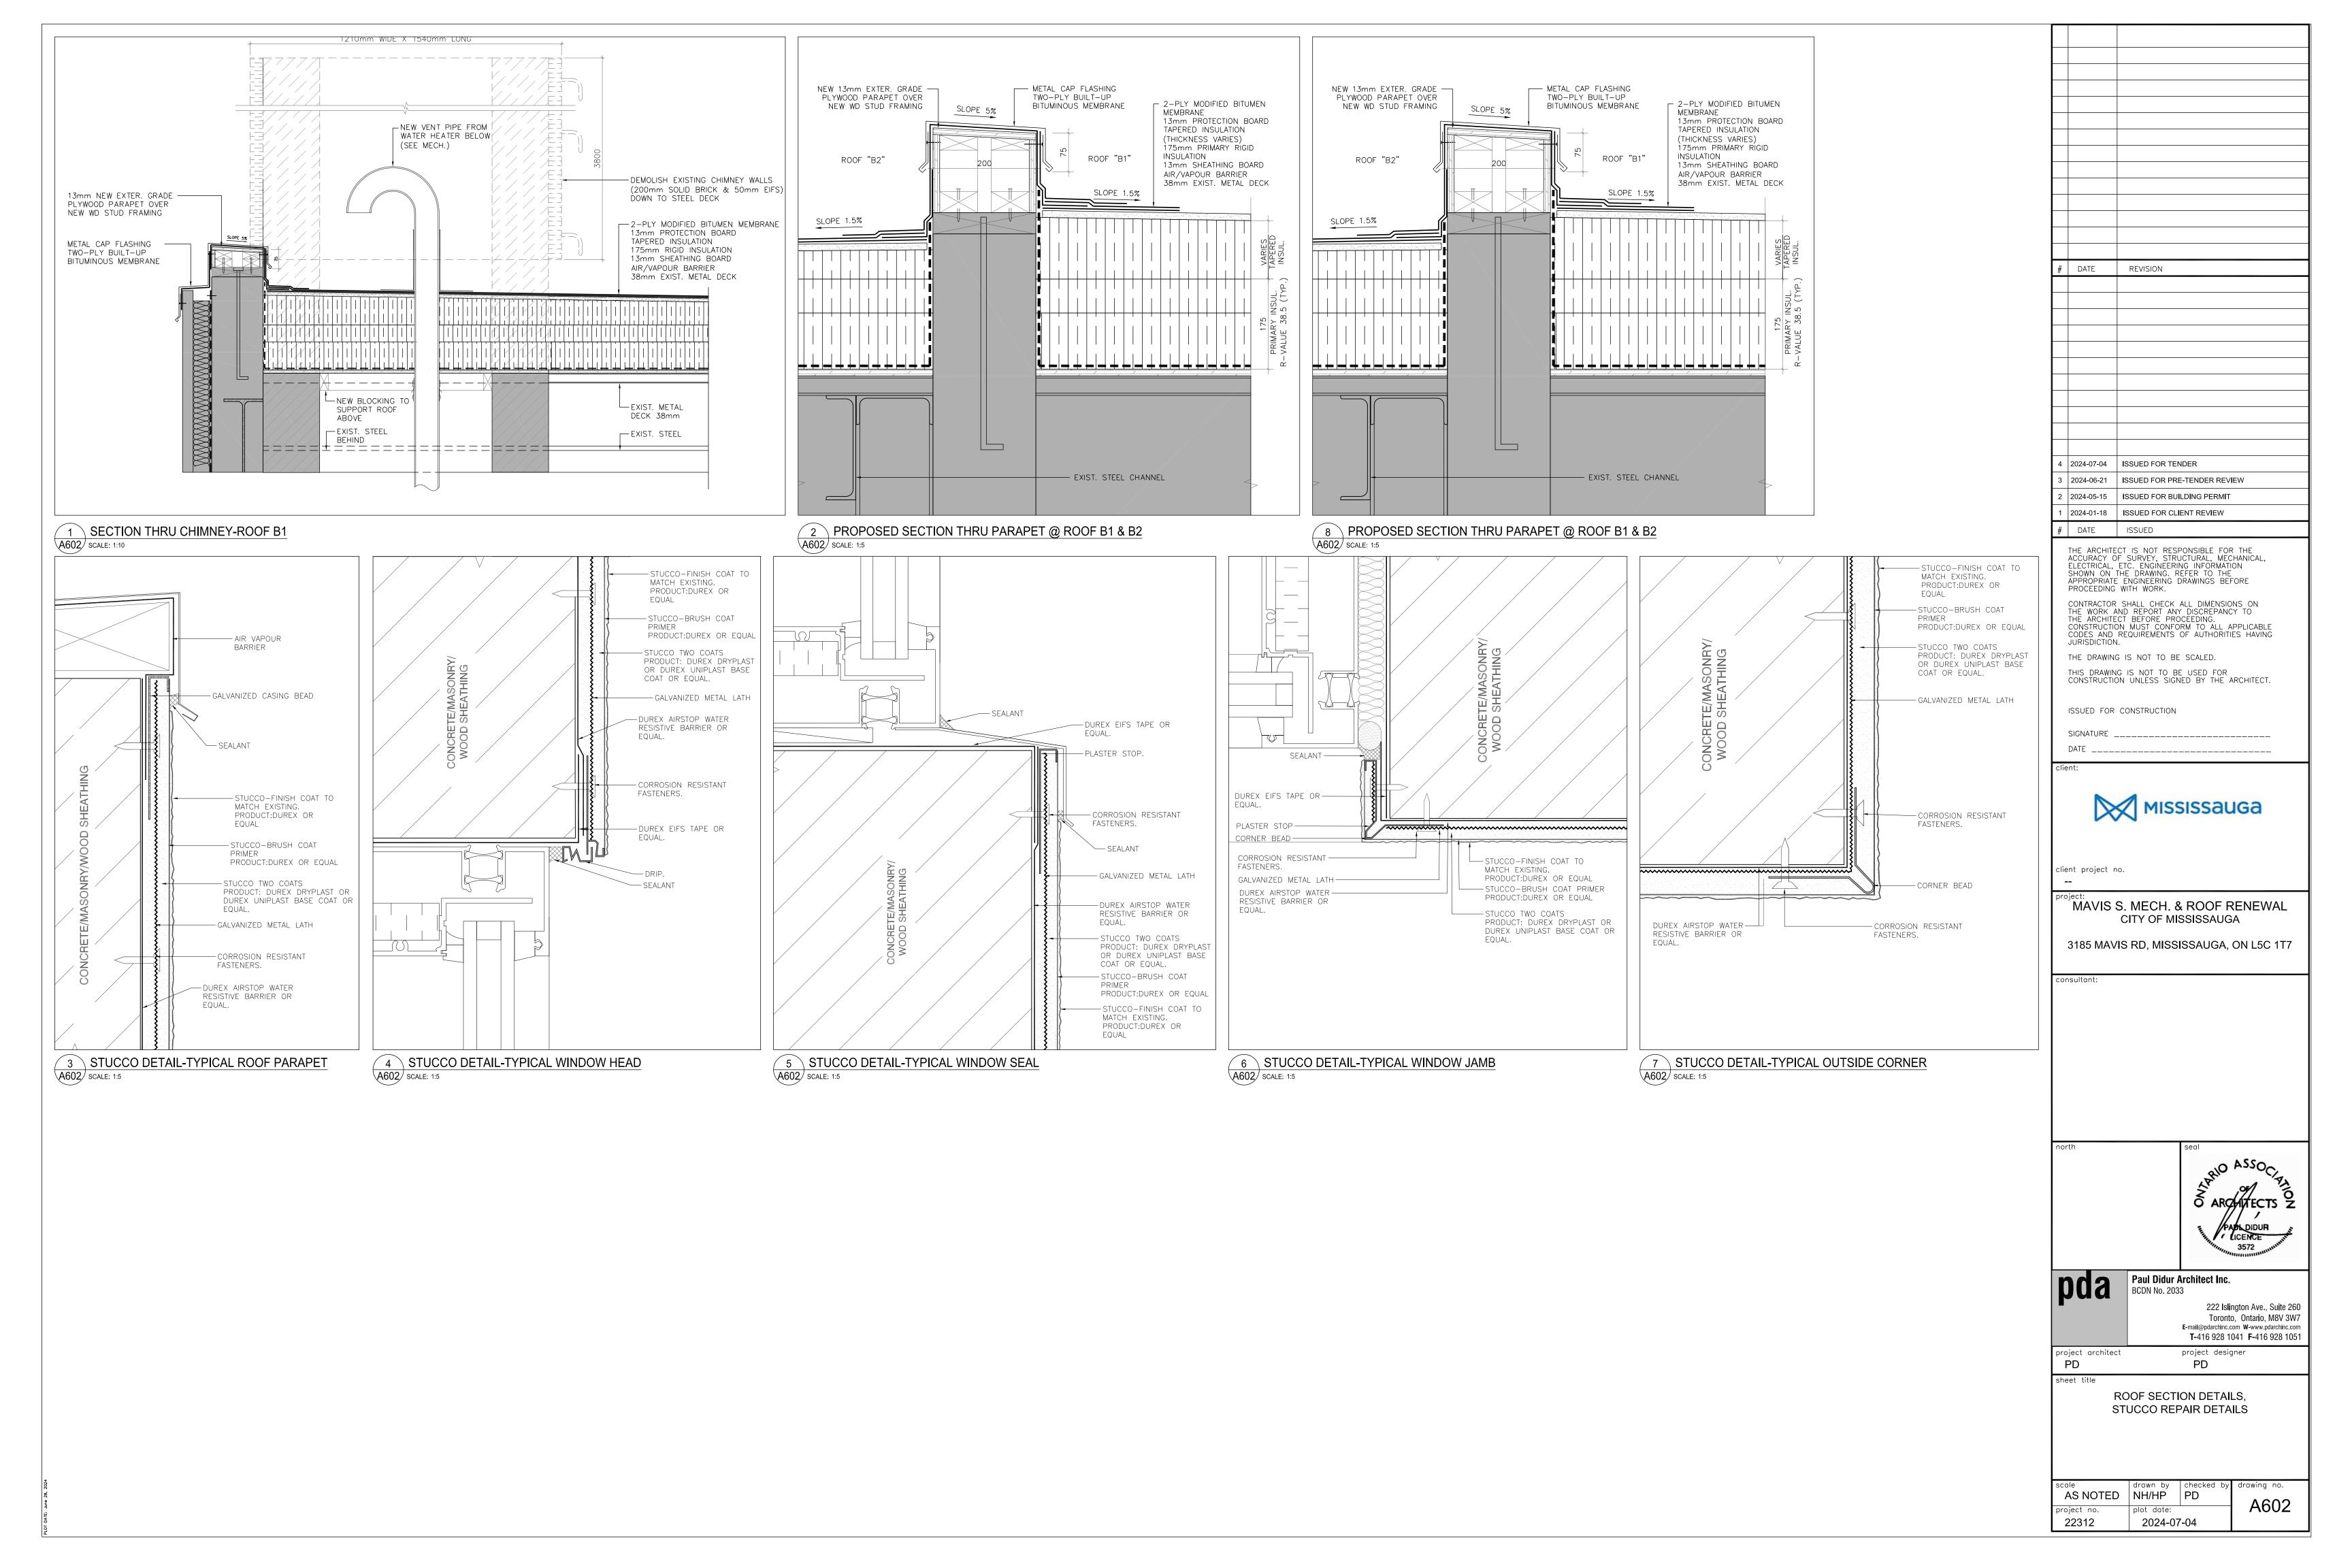

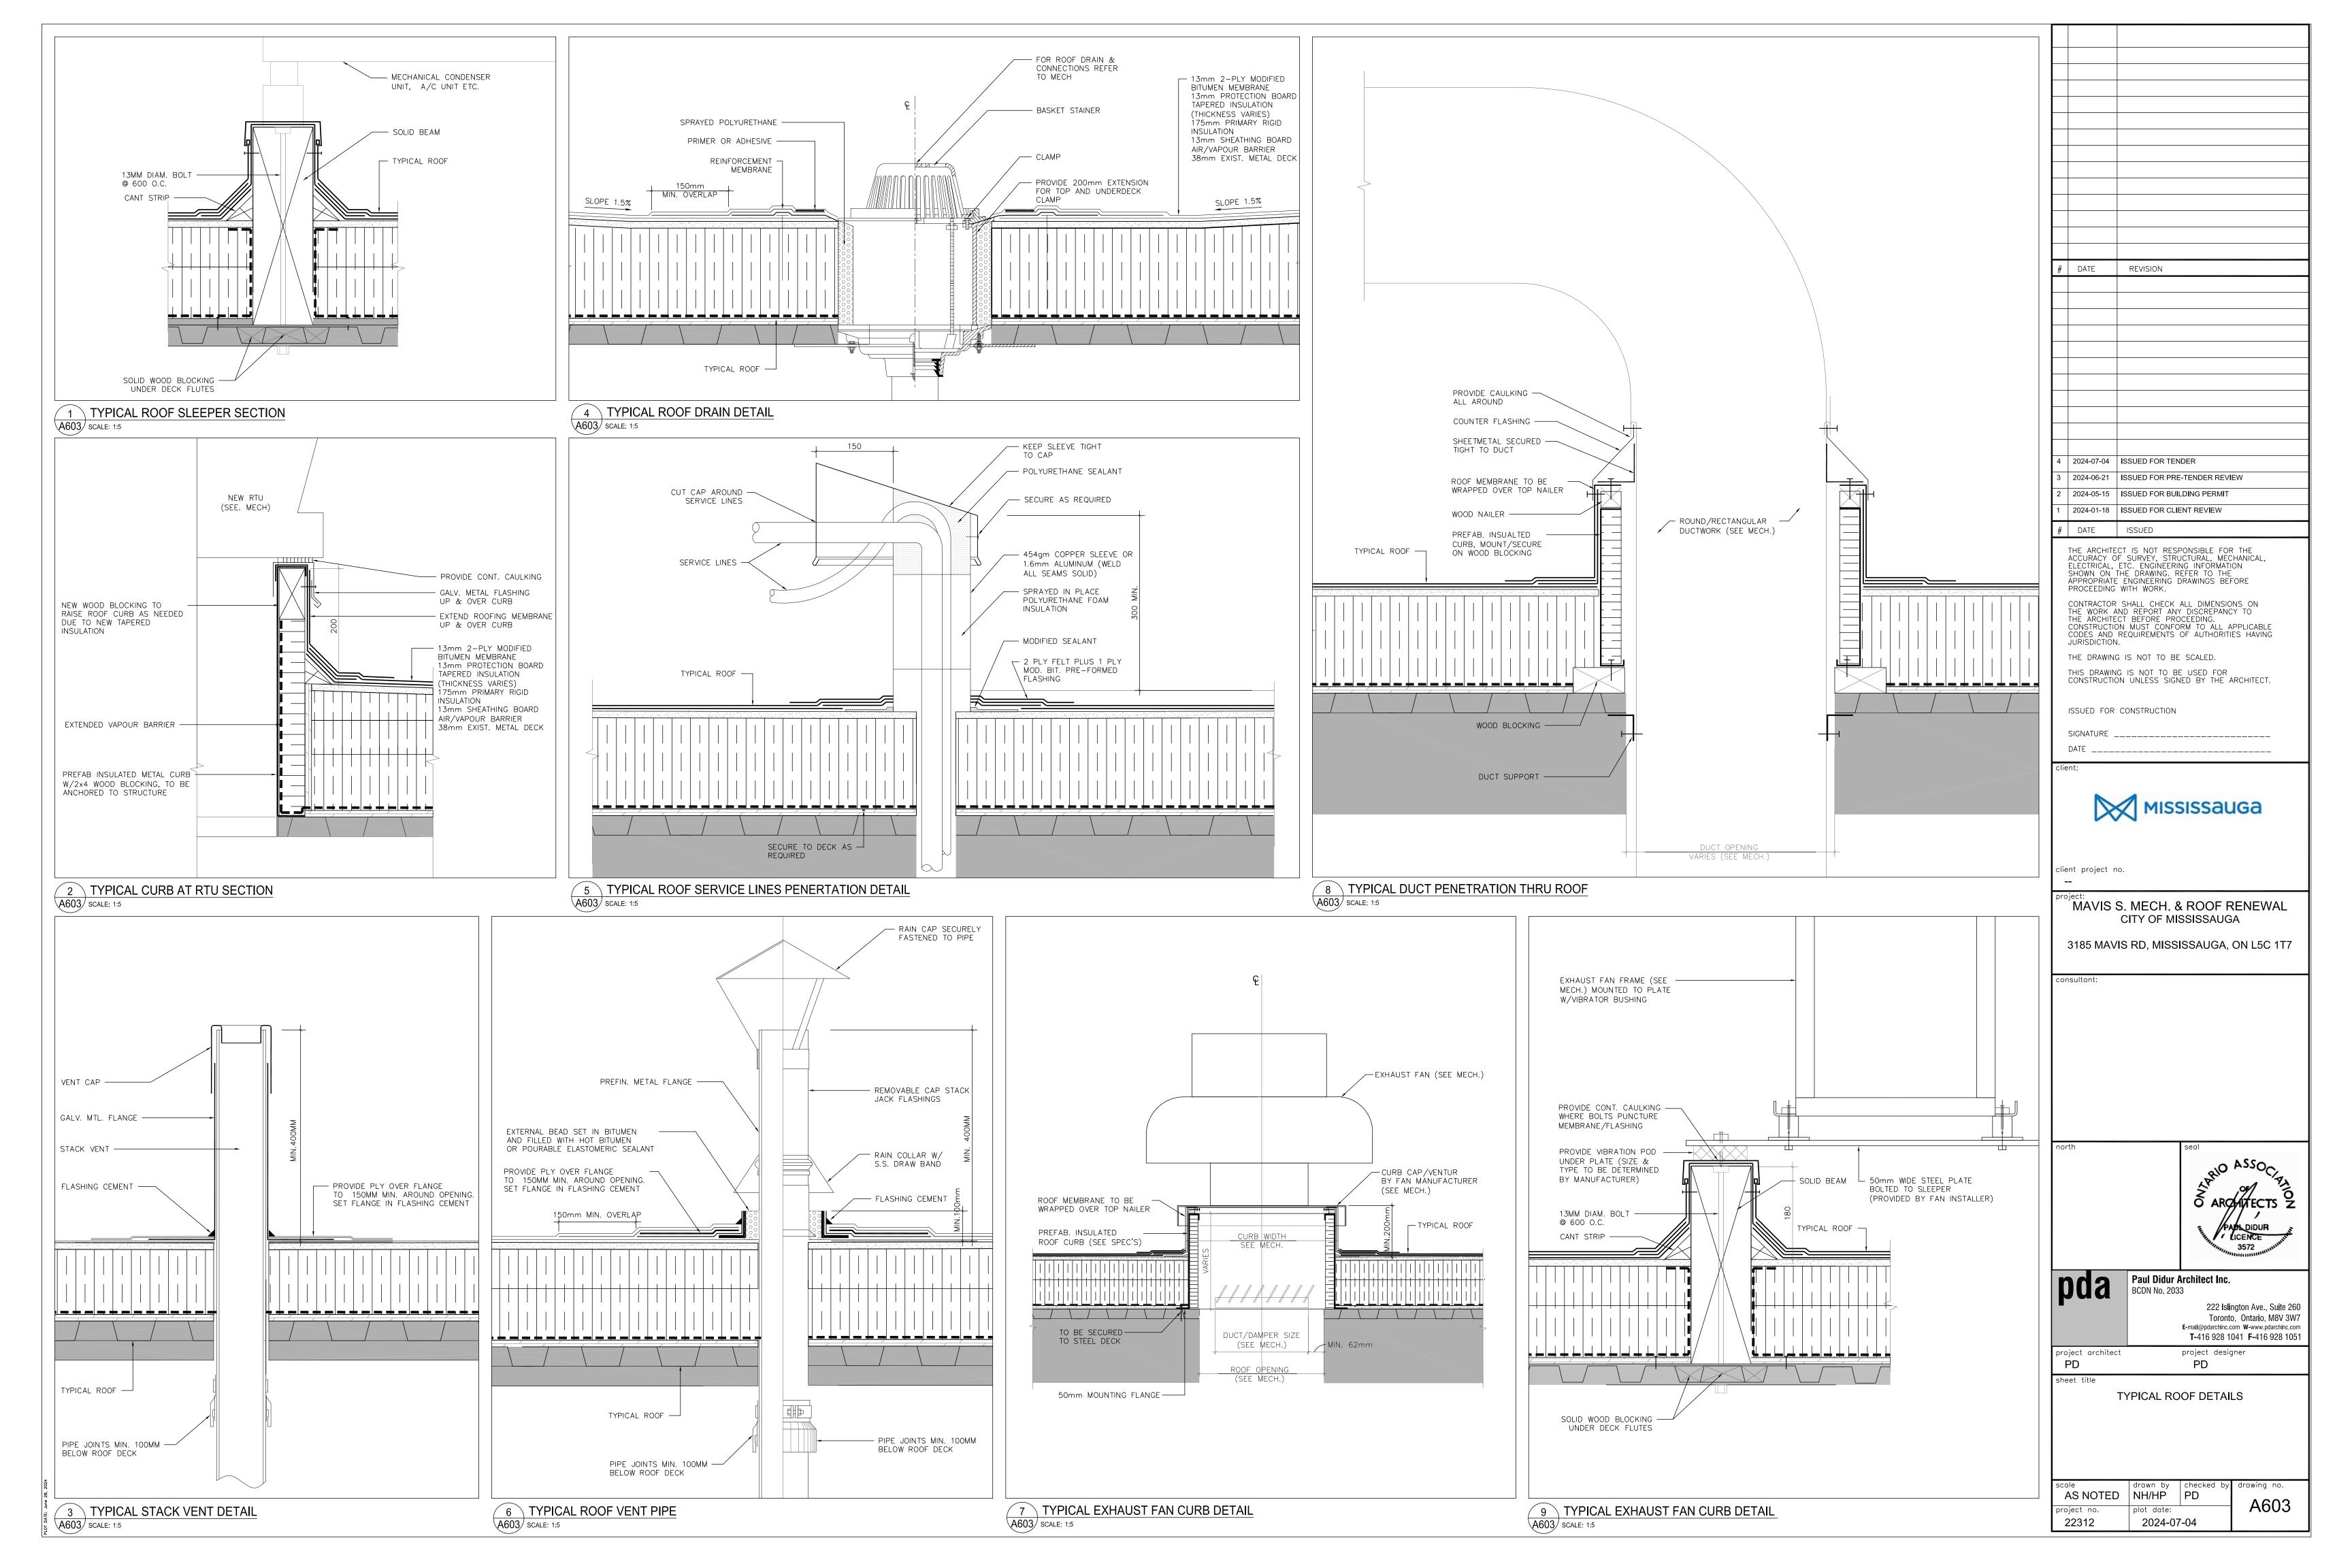


| DOOR | R SCHEDULE - 22XXX | DOOR | | | | FRAMES | RATING | TING HARDWARE | | | | | | | | | | | | | | REMARKS | | |
|---------|---------------------|-----------------|------------|----------|--------------------------|------------|-------------------|---------------|--|-----------------------------|------------------------------------|------------------------------|--|--------------------------|-------|--------------|-------------------------|-------------------------|------------------------|-------------------|-----------|--|------------------------|--|
| | | SIZE (mm) W x H | TYPE MAT'L | FINISH | MA | T'L FINISH | | | | | | | | | | ē | | | | | | | | |
| NUMB | ROOM NUMBER | | | ≤ | VENEER FACTORY FINISH | ZED / | FIRE RATING (MIN) | HINGE | STOREROOM LOCK CLASSROOM LOCK PASSAGE LOCK | OFFICE LOCK PRIVACY LOCK | CYLINDER LOCK PUSH PLATE DOOR PULL | KICK PLATE SURFACE CLOSER | OH STOP ELECTRIC STRIKE MAG LOCK | CARD READER DOOR CONTACT | | TONS LOCK | DOOR SEQUENCER INTERCOM | WALL STOP FLOOR STOP | DOOR SWEEP DOOR GASKET | WEATHER STRIPPING | MOKE SEAL | PANIC EXIT HARDWARE EMERGENCY CALL KIT | FLUSH BOLT SILENCER | |
| 1-1A 10 | 01 VESTIBULE | 965 x 2334 | A AL/GL | | ХА | L X X | | X X | | | X | X | XX | XX | X X | X X | | | X | X | Х | | | Provide door paddle from inside, D-handle pull from outside |
| 1-1B 10 | 01 VESTIBULE | 665 x 2334 | A AL/GL | | X A | L X X | | X | X | | X | | | X | | | | | X | X | X | | X | Provide top and bottom flush bolt |
| 2-1 10 | D2 FOYER | 1525 x 2334 | B AL/GL | | X A | L X X | | | | | | | | | | | | | X | X | | | | Design and install to swing on vertical axis to exit direction |
| l-1 10 | 04 CORRIDOR | 915 x 2135 | C HM/GL | | ХН | VI X | (45 | XX | X | | X | X | | | X X | x x | | X | X | | | | | |
| la-1 10 | 04a ELEVATOR | 915 x 2030 | C HM/GL | | ХН | VI X | 45 | XX | X | | | X | | X | X X | X X | | | X | | | | | Kick plate to be from inside |
| -1 10 | D5 MACHINE ROOM | 915 x 2135 | D HM | | ХН | M X | 45 | XX | X | | X | X | | | | | | Х | X | | | | | |
| a-1 20 | 01a ELEVATOR | 915 x 2030 | C HM/GL | | ХН | M X | 45 | XX | X | | | X | | X | X X | x x | | | X | | | | | Kick plate to be from inside |
| -1 10 | O7 MEN'S LOCKER ROC | M 915 x 2235 | D HM | | ХН | M > | | XX | X | | X | XX | X | XX | | | | Х | | | | | | |

LEGEND:

GL - Glass EX - Existing
AL - Aluminum HM - Hollow Metal

1 DOOR SCHEDULE A700 SCALE: N.T.S

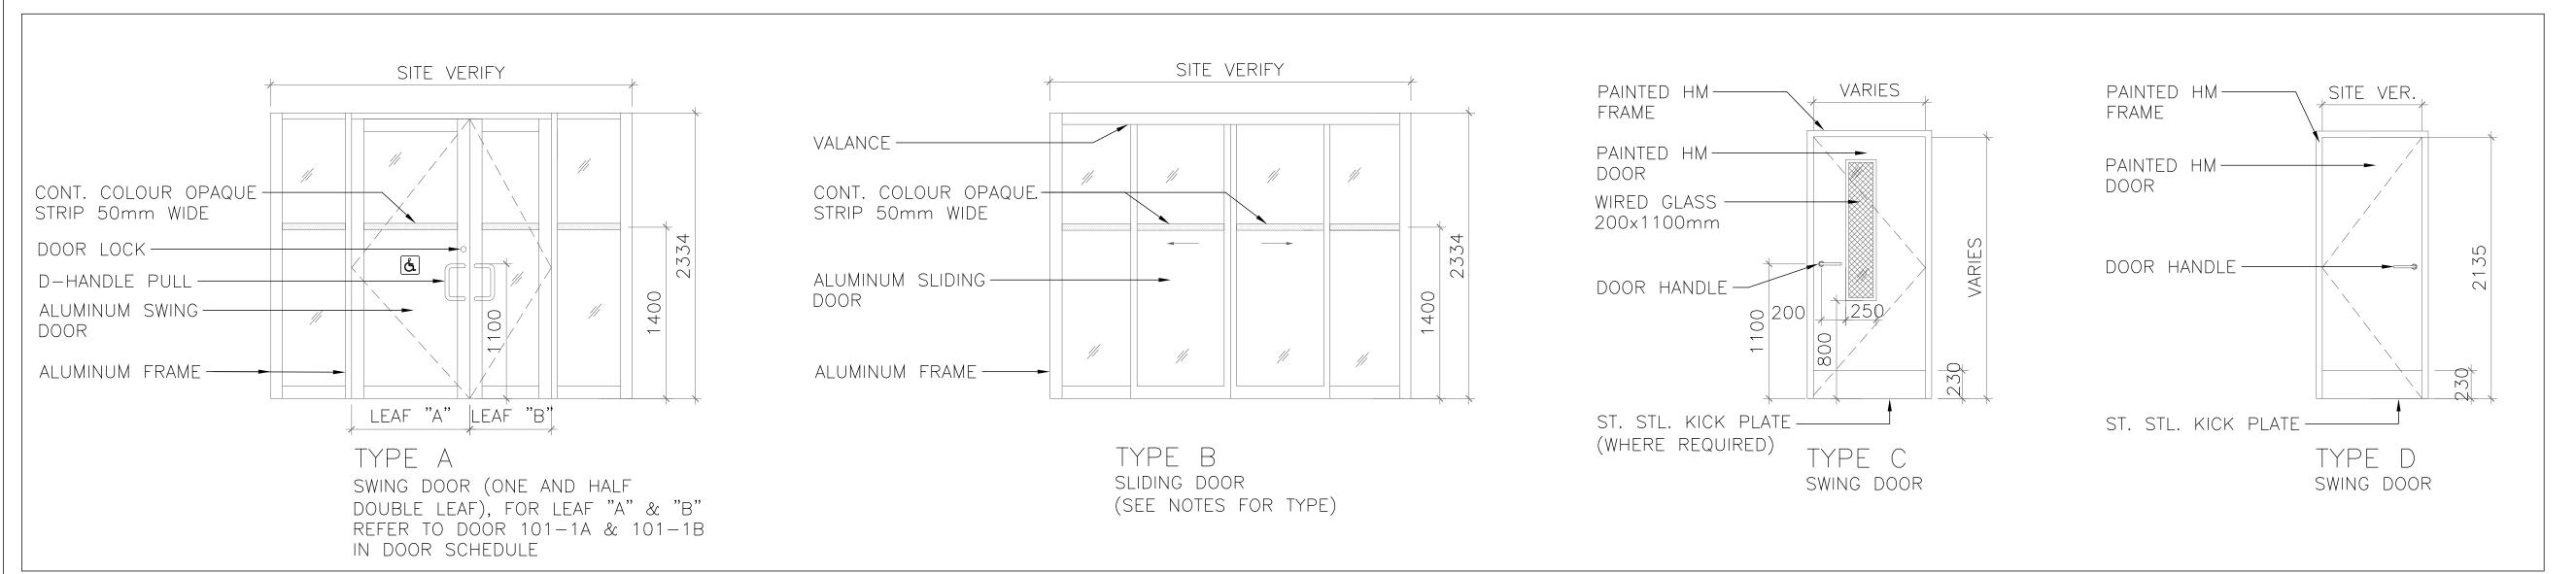

2 DOOR TYPES A700 SCALE: N.T.S # DATE REVISION 2024-07-04 ISSUED FOR TENDER 2024-06-21 ISSUED FOR PRE-TENDER REVIEW 2024-05-15 ISSUED FOR BUILDING PERMIT 2024-01-18 | ISSUED FOR CLIENT REVIEW # DATE ISSUED THE ARCHITECT IS NOT RESPONSIBLE FOR THE ACCURACY OF SURVEY, STRUCTURAL, MECHANICAL, ELECTRICAL, ETC. ENGINEERING INFORMATION SHOWN ON THE DRAWING. REFER TO THE APPROPRIATE ENGINEERING DRAWINGS BEFORE PROCEEDING WITH WORK. CONTRACTOR SHALL CHECK ALL DIMENSIONS ON THE WORK AND REPORT ANY DISCREPANCY TO THE ARCHITECT BEFORE PROCEEDING.
CONSTRUCTION MUST CONFORM TO ALL APPLICABLE CODES AND REQUIREMENTS OF AUTHORITIES HAVING JURISDICTION. THE DRAWING IS NOT TO BE SCALED. THIS DRAWING IS NOT TO BE USED FOR CONSTRUCTION UNLESS SIGNED BY THE ARCHITECT. ISSUED FOR CONSTRUCTION DATE _____ MISSISSAUGA client project no. MAVIS S. MECH. & ROOF RENEWAL CITY OF MISSISSAUGA 3185 MAVIS RD, MISSISSAUGA, ON L5C 1T7 consultant:

north



Paul Didu BCDN No. 2

Paul Didur Architect Inc. BCDN No. 2033

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project designer

project architect PD

SCHEDULES

scale
AS NOTED
NH/HP
PD
A700

project no. plot date: 22312 2024-07-04