# T M U CED MULTI-MEDIA LAB INTERIOR RENOVATION

### **DRAWING LIST**

#### **ARCHITECTURAL:**

A000 COVER SHEET WITH OBC MATRIX

A001 GENERAL NOTES

A002 THIRD FLOOR PLAN

A053 PARTIAL 3RD FLOOR DEMO PLAN

A 103 PARTIAL 3RD FLOOR PLAN

A203 PARTIAL 3RD FLOOR RCP A401 PARTIAL 3RD FLOOR SECTIONS

A402 PARTIAL 3RD FLOOR SECTIONS

A403 PARTIAL 3RD FLOOR SECTIONS

A404 PARTIAL 3RD FLOOR SECTIONS A 1001 ROOM FINISHES SCHEDULE AND

**LEGEND** 

A 1002 EQUIPMENT AND

ALTERNATE PRICE SCHEDULE

A1003 DOOR SCHEDULE

A 1004 HARDWARE SCHEDULE

**ARCHITECT** MARY ELLEN LYNCH, OAA / JENNIFER ANDERSON, OAA LYNCH + COMISSO:

**ARCHITECTURE + LIGHT 570 ANNETTE ST.** 

TORONTO, ON M6S 2C2

416 762 2778

905 417 6881

**ELECTRICAL CONSULTANT** 

JERRY MOBILIO / **BENNY VALERIO** E-LUMEN INTERNATIONAL INC. 595 CITYVIEW BLVD. SUITE 204/205 VAUGHAN, ON L4H 3M7

### **MECHANCIAL:**

M-000 COVER

M-001 NOTES, LEGEND AND SITE PLAN

M-002 SPECIFICATIONS

M-003 SCHEDULES

M-100 EXISTING / DEMOLITION -

**HVAC PLAN** M-101 NEW WORK - HVAC PLAN

#### **ELECTRICAL:**

E-IA ELECTRICAL DRAWING LIST AND **NOTES** 

E-IB ELECTRICAL NOTES

E-2A ELECTRICAL SPECIFICATION

E-2B ELECTRICAL SPECIFICATION

E-2C ELECTRICAL SPECIFICATION

ELECTRICAL DEMOLITION PLAN

ELECTRICAL PROPOSED LIGHTING **PLAN** 

E-5 ELECTRICAL PROPOSED POWER AND SYSTEMS PLAN

**ELECTRICAL LUMINARIES SCHEDULE** 

**ELECTRICAL DETAILS** 

**ELECTRICAL PANEL SCHEDULE** 

MECHANICAL CONSULTANT GIL GALANG, P. ENG /

IAN SIMPSON

GALANG CONSULTING SERVICES. 2275 LAKE SHORE BLVD WEST SUITE 315

TORONTO, ON M8V 2Y2

647 909 9899

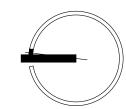
DATA MATRIX PARTS 3 AND 9					References are to Division B unless noted							
1. PROJECT DESCRIPTION: INTERIOR ALTERATIONS - New PART 11						Division A o	or [C] for Divi	ision C				
1.			RIOR	ALTERATIONS	-	☐ New	<u> </u>	PART 11	□ PART 3		☐ PART 9	
	TMU CED ME	EDIA LAB				☐ Addition		to 11.4	1.1.2. [A]		1.1.2. [A] &	9.10.1.3.
					<u> </u>	Alteration						
	MAJOR OCCUP			GROUP A [	NV. 2 – S	CHOOLS & COL	LEGES, NO	N RESIDENTIA	AL 3.1.2.1.(1)		9.10.2.	
3.	BUILDING AREA	(m²) Ex	sting:	573	New	: NONE	Total:	NO CHANGE	1.4.1.2. [A]		1.4.1.2. [A]	
4.	GROSS AREA	Ex	sting:		New	: NONE	Total:	NO CHANGE	1.4.1.2. [A]		1.4.1.2. [A]	
5.	NUMBER OF S	TOREYS	Abov	ve grade: 7	Ве	low grade: 1			1.4.1.2. [A] & 3	3.2.1.1.	1.4.1.2. [A]	& 9.10.4
6.	NUMBER OF S	TREETS/FIRE I	IGHTE	R ACCESS	1				3.2.2.10. & 3.2	.5.	9.10.20.	
7.	BUILDING CLAS	SIFICATION		NO CHANGE					3.2.2.2083		9.10.2.	
8.	SPRINKLER SY	STEM PROPOS	ED		entire buil	ding			3.2.2.2083		9.10.8.2.	
						compartments			3.2.1.5.			
					selected f	loor areas			3.2.2.17.			
					basement	□in	lieu of ro	of ratina	INDEX		INDEX	
					not requir			· · · · · · · · · · · · · · · · ·				
9	STANDPIPE RE	OUIRED			Yes 🗆 I				3.2.9.		N/A	
	FIRE ALARM R				Yes 🗆 I				3.2.4.		9.10.18.	
	WATER SERVICE		ADEO!		Yes 🗆 I				3.2.5.7.		9.10.16. N/A	
	HIGH BUILDING	•	~DEQU						3.2.6.		<b>-</b> '	
					Yes ⊠ I						N/A	
13.	PERMITTED CO			ombustible			□ Both		3.2.2.2083		9.10.6.	
	ACTUAL CONST		⊔ Co	ombustible			☐ Both					
	MEZZANINE(S)				Mezzanine				3.2.1.1.(3)-(8)		9.10.4.1.	
15.	OCCUPANT LO			m <sup>2</sup> /person	☐ des	ign of building			3.1.17.		9.9.1.3.	
	BASEMENT:	OCCUPAN	Y _N	IO CHANGE		LOAD	PERS	ONS				
	1ST FLOOR	OCCUPAN	Y N	IO CHANGE		LOAD _	PERS	ONS				
	2ND FLOOR	OCCUPAN	CY N	IO CHANGE		LOAD -	PERS	ONS				
	3RD FLOOR	OCCUPAN	Y N	IO CHANGE		LOAD -	PERS	ONS				
	(Additional floo	or areas conti	nued	on last page	e)							
16.	BARRIER-FREE	DESIGN		×	Yes □ I	No (explain)			3.8.		9.5.2.	
	_											
17.	HAZARDOUS S	UBSTANCES			Yes ⊠ I	No			3.3.1.2. & 3.3.1	.19.	9.10.1.3.(4)	
18.	REQUIRED	HORIZ	ONTAL	ASSEMBLIES		LISTE	DESIGN N	0.	3.2.2.2083 &		9.10.8.	
	FIRE		RR (I	HOURS)		OR DESC	CRIPTION (S	G-2)	3.2.1.4.		9.10.9.	
	RESISTANCE RATING	Floor	3:	- Hours		_						
	(FRR)	Roo		- Hours		_			-			
		Mezzanin		- Hours		_						
		mozzam.		OF		LISTE	DESIGN N	n				
		SUPF		G MEMBERS			CRIPTION (S					
		Floor	,.	- Hours		_						
		Roo		- Hours		_			_			
						_			_			
10	CDATIAL CEDAL	Mezzanin		- Hours	EDIOD WAI	-			7.0.7		0.10.14	
19.	SPATIAL SEPAR	- i	- 1		1				3.2.3.	00115	9.10.14.	NON COUR
	WALL AREA			L/H OR	PERMITTI MAX. %		FRR (HOURS	3	LISTED DESIGN OR	COMB. CONST.	COMB. CONSTR.	NON-COMB. CONSTR.
	EBF (	'''	'	H/L	OPENING	SS OPENINGS	\ \(\text{\text{Induk}}\)		DESCRIPTION	33,137.	NONC.	
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	SOUTH -	_		_	-	_	_		_	-	-	_
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	WEST -	=	_ ヿ	-	-	-	_		_	-	-	-
20.	PLUMBING FIX	TURE REQUIRE	MENTS			•	•	•			,	
	MALE/FEMALE	COUNT @ -	%/	- %,								
	EXCEPT AS NO				CCUPANT	OBC TABLE	FIXTURES	FIXTURES	O.B.C. F	EEEDE	NCE	
				١	LOAD		REQUIRED	PROVIDED		VEL EIVE		
				L		ļ			☐ PART 3		☐ PART 9	
		OCCUPANCY -			-	-	_	-	_		-	
	BASEMENT: (				_	-		_	_		-	
		OCCUPANCY -			-	-	_	-	_		-	
					_	_	_	-	_		-	
	1ST FLOOR: 0						_	_	_		_	
	1ST FLOOR: 0	OCCUPANCY -			_	_						
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2	PERMIT REVISION	9 OCT 202
Τ	PERMIT	6 SEPT 202

CLIENT:	
TORONTO M	1ETROPOLITAN
UNIVERSITY	
PROJECT NAME:	
CED MULTI-N	1EDIA LAB

٠.	LOCATION
	297 VICTORIA STREET TORONTO, ON M5B IWI
	DATE:
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DRAWN BY: CHECKED BY: MEL

### **COVER OBC MATRIX**

#### **GENERAL NOTES:**

- ALL NOTES HEREIN REFERRING TO 'CONTRACTOR' ARE TO MEAN THE GENERAL CONTRACTOR & SUB-CONTRACTORS.
- DRAWINGS ARE NOT TO BE SCALED. CONTRACTOR TO REFERENCE DIMENSIONS GIVEN ON DRAWINGS.
- ALL THE WORK SHALL BE CARRIED OUT IN ACCORDANCE WITH THE LATEST EDITION OF THE ONTARIO BUILDING CODE, THE OCCUPATIONAL HEALTH & SAFETY ACT & REGULATIONS FOR CONSTRUCTION PROJECTS, CONSTRUCTION SAFETY ACT, REGULATIONS OF THE ONTARIO DEPARTMENT 11. OF LABOUR & THE CANADIAN CONSTRUCTION SAFETY CODE, INCLUDING ALL CURRENT REVISIONS NEW UNLESS NOTED OTHERWISE. & WITH GOOD CONSTRUCTION PRACTICES.
- THE CONTRACTOR IS RESPONSIBLE TO FIELD VERIFY ALL DIMENSIONS & SITE CONDITIONS, COMPARE THEM WITH THOSE INDICATED ON THE DRAWINGS & ADVISE THE ARCHITECT OF ANY DISCREPANCIES. COMMENCEMENT OF WORK SHALL OCCUR. BE DEEMED AS ACCEPTANCE OF SITE CONDITIONS BY THE CONTRACTOR.
- DISCREPANCIES ITEMIZED AFTER COMMENCEMENT OF THE WORK SHALL BE RECTIFIED AT THE EXPENSE OF THE CONTRACTOR & TO THE SATISFACTION OF THE ARCHITECT AND OWNER.
- DRAWINGS ARE IN PART SCHEMATIC & ARE INTENDED TO CONVEY THE SCOPE OF WORK & TO INDICATE THE GENERAL & APPROXIMATE LOCATION & ARRANGEMENT OF THE WORK. CONTRACTOR TO OBTAIN ACCURATE INFORMATION ABOUT LOCATION ARRANGEMENT & SIZES BY COORDINATING DRAWINGS WITH THE SITE CONDITIONS.
- CONTRACTOR SHALL PROTECT FROM DAMAGE ALL EXISTING STRUCTURES, FINISHES, EQUIPMENT & PROPERTIES ADJACENT THE AREAS OF WORK. ALL DISTURBED AREAS, DAMAGED PROPERTIES AND/OR STRUCTURES SHALL BE 'MADE GOOD' /RESTORED TO ORIGINAL CONDITION AT THE EXPENSE OF THE CONTRACTOR & TO THE SATISFACTION OF THE ARCHITECT AND OWNER.
- & REINSTALLATION OF ANY ITEMS THAT IMPEDE IN ALL TIMES TO THE APPROVAL OF THE THE DEMOLITION, INSTALLATION AND/OR CONSTRUCTION OF THE WORK.

- ALL SERVICES ARE TO BE ACCURATELY LOCATED PRIOR TO CONSTRUCTION & ADEQUATE PROTECTION PROVIDED AT ALL TIMES. ANY INTERFERENCE TO EXISTING SERVICES OR UTILITIES CODES & REGULATIONS. WITH THE PROPOSED CONSTRUCTION OPERATIONS IS TO BE REPORTED TO THE DESIGNER PRIOR TO 19. THE CONTINUATION OF CONSTRUCTION.
- CONTRACTOR SHALL NOT CUT ADDITIONAL HOLES, OTHER THAN THOSE SHOWN ON DRAWINGS THROUGH WALLS, BEAMS, AND/OR OTHER ELEMENTS WITHOUT THE PRIOR APPROVAL OF THE ARCHITECT.
- ALL MATERIALS INDICATED ON THE DRAWINGS ARE
- THE CONSTRUCTION SCOPE OF WORK SHOWN ON THESE DRAWINGS HAS BEEN DESIGNED IN ACCORDANCE WITH ALL REQUIRED CURRENT BUILDING CODES & REGULATIONS IN THE MUNICIPALITY IN WHICH THE CONSTRUCTION IS TO
- CONTRACTOR SHALL PROVIDE TEMPORARY SUPPORTS WHERE REQUIRED.
- CONTRACTOR TO MAINTAIN ALL FIRE RESISTANCE RATINGS THROUGHOUT BUILDING UNLESS OTHERWISE NOTED.
- CONTRACTOR TO FOLLOW ALL MANUFACTURER'S INSTRUCTIONS & SPECIFICATIONS FOR MATERIALS USED TO CARRY OUT THE WORK.
- MAKE GOOD = ALL REPAIR WORK REQUIRED BY THE CONTRACTOR DUE TO THE WORK PERFORMED SHALL BE TO MATCH THE ORIGINAL CONDITION. ADJACENT MATERIALS/FINISH OR BETTER. WHERE NEW WORK CONNECTS WITH EXISTING & WHERE EXISTING WORK IS ALTERED, ALL NECESSARY CUTTING & FITTING REQUIRED TO MAKE SATISFACTORY CONNECTIONS WITH THE EXISTING WORK SHALL BE PERFORMED BY THE CONTRACTOR.
- THROUGHOUT THE ENTIRE CONSTRUCTION PERIOD PROPER & SAFE MEANS OF EGRESS SHALL BE CONTRACTOR IS RESPONSIBLE FOR THE REMOVAL PROVIDED FROM ALL ZONES OF THE BUILDING AT AUTHORITIES HAVING JURISDICTION.

18.

- ALL MATERIALS & DEBRIS TO BE DISPOSED OF SHALL BE REMOVED FROM THE SITE DAILY & DISPOSED OF LEGALLY IN ACCORDANCE TO ALL APPLICABLE FEDERAL, PROVINCIAL & LOCAL
- ELEMENTS OF THE BASE BUILDING, SUCH AS (BUT NOT LIMITED TO) DOOR HARDWARE. LIGHT FIXTURES, ETC. REMAIN THE PROPERTY OF THE LANDLORD/OWNER & SHALL BE TURNED OVER TO THE LANDLORD/OWNER & STORED WHERE DIRECTED BY THE LANDLORD/OWNER UNLESS SCHEDULED FOR REUSE AND/OR SHOWN TO BE REMOVED & RELOCATED UNDER THIS CONTRACT.
- CONTRACTOR TO PROTECT EXISTING AREAS TO PREVENT DUST, DEBRIS & OTHER REFUSE FROM ENTERING OTHER AREAS DURING DEMOLITION. PROVIDE DUST BARRIER AROUND ALL AREAS UNDER CONSTRUCTION.
- CONTRACTOR TO CONTACT ARCHITECT TO REVIEW SITE DURING DEMOLITION TO VERIFY EXISTING CONDITIONS. CONTRACTOR TO PROVIDE MINIMUM 24 HOURS NOTICE FOR INSPECTION.
- CONTRACTOR IS RESPONSIBLE FOR CONTACTING ESA INSPECTOR TO REVIEW THE WORK IN **PROGRESS**
- SEAL & FIRESTOP ALL WALL, FLOOR, CEILING & ROOF PENETRATIONS THROUGH FIRE RATED ASSEMBLIES WITH THE APPROPRIATE U.L.C. OR BUILDING CODE APPROVED MATERIALS TO MAINTAIN THE APPROPRIATE FIRE RESISTANCE RATING.
- PLANS OF EXISTING CONDITIONS ARE PROVIDED FOR INFORMATION ONLY & MUST BE VERIFIED BY FOR THE "AS-BUILT" DRAWING TO LATER BE THE CONTRACTOR.
- CONTRACTOR SHALL SUBMIT FOR APPROVAL, PROPOSED METHOD OF ACCESS TO SITE & BUILDING, STORAGE OF MATERIALS & LOCATION OF GARBAGE BINS. BEFORE STARTING SCOPE OF WORK.
- CONTRACTOR TO MAINTAIN A LIST OF ALL HAZARDOUS MATERIALS PROPOSED FOR USE ON SITE OR WORKPLACE.
- SMOKING ON SITE IS NOT PERMITTED.

- CONTRACTOR SHALL ARRANGE WITH THE OWNER FOR USE OF EXISTING ELECTRICAL SERVICE, TO THE EXTENT THAT THERE IS SUFFICIENT CAPACITY, TO AVOID OVERLOADING OF CIRCUITS. TO PROVIDE TEMPORARY ELECTRICAL SERVICE.
- CONTRACTOR SHALL PROVIDE & MAINTAIN SANITARY PORTABLE TOILETS FOR THE DURATION OF CONSTRUCTION FOR THE USE OF THE CONSTRUCTION PERSONNEL (UNLESS OTHERWISE PROVIDED BY THE OWNER) TOILETS SHALL BE LOCKED DURING NON-WORKING HOURS
- CLEANING OF THE INTERIOR & EXTERIOR CONSTRUCTION AREAS SHALL INCLUDE BUT NOT BE LIMITED TO:
- -THE REMOVAL OF RUBBISH AND/OR OTHER UNSIGHTLY MATERIAL OR DEBRIS.
- -THE REMOVAL OF DUST AND/OR OTHER DEBRIS BY BRUSHING, SWEEPING AND/OR OTHER SUITABLE METHODS.
- FINAL CLEANING OF ALL AREAS AFFECTED BY THE CONSTRUCTION SHALL INCLUDE BUT NOT BE LIMITED TO VACUUMING, WASHING & POLISHING OF FLOORS, CLEANING OF GLASS SURFACES & OTHER MEASURES DEEMED NECESSARY BY THE OWNER.
- A LIST OF ALL CONTRACTOR & SUB-CONTRACTOR PERSONNEL ON SITE MUST BE FORWARDED TO THE OWNER PRIOR TO THE COMMENCEMENT OF WORK.
- CONTRACTOR TO KEEP AN ACCURATE ACCOUNT OF SITE CHANGES NOTED IN RED INK ON THE SITE CONSTRUCTION DRAWINGS TO FORM THE BASIS SUBMITTED TO THE DESIGNER FOR "RECORD DRAWING" ISSUANCE.
- CONTRACTOR TO KEEP A COPY OF ALL LITERATURE, DELIVERY WAYBILLS, & WARRANTIES FOR ALL NEW PRODUCTS USED AS PART OF THE SCOPE OF WORK.
- WHEN ONE WALL FINISH IS INDICATED WITHIN AN ENCLOSED AREA, THIS FINISH MUST BE APPLIED TO ALL WALLS, INCLUDING VERTICAL BULKHEADS. PERIMETER WALLS & COLUMNS, UNLESS OTHERWISE NOTED.

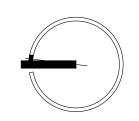
- ALL FINISHES TO BE PURCHASED BY CONTRACTOR. PROVIDE ALL LABOUR, MATERIALS, PRODUCTS, EQUIPMENT & SERVICES REQUIRED TO INSTALL THE FINISHES AS INDICATED ON THE DRAWINGS & WHERE CAPACITY IS INSUFFICIENT, CONTRACTOR IS FINISH SCHEDULE IN STRICT ACCORDANCE WITH THE MANUFACTURER'S INSTRUCTIONS.
  - CONTRACTOR IS RESPONSIBLE FOR ALL FRAMING, BLOCKING, AND MATERIALS REQUIRED TO MAKE GOOD EXISTING WALLS, FLOORS AND CEILINGS ALTERED BY THE CONSTRUCTION.
  - CONTRACTOR TO PROVIDE NECESSARY FURRING TO MAKE NEW WALLS, FLOORS AND CEILINGS ALIGN WITH EXISTING OLDER FULL-SIZE LUMBER.
  - WHERE NEW OR EXPANDED OPENINGS ARE PROPOSED, CONTRACTOR TO ACCOUNT FOR PACKING OUT OF EXISTING JOISTS AS NEEDED TO ACHIEVE FINISHED OPENING.
  - THE CONTRACTOR SHALL SUBMIT THE FOLLOWING FOR REVIEW & APPROVAL PRIOR TO THE COMMENCEMENT OF WORK: -CERTIFICATES OF INSURANCE
  - -DETAILED BAR GRAPH FORMAT WORK SCHEDULE. NOTE FINISH, LIGHTING & FFE LEAD TIMES
  - -SAMPLES OF ALL SPECIFIED MATERIALS -SHOP DRAWINGS & PRODUCT DATA
  - -COLOUR SAMPLES -STATUTORY DECLARATION
  - -WORKERS COMPENSATION CERTIFICATE OF CLEARANCE
  - GENERAL CONTRACTOR TO ENSURE ALL SUB CONTRACTORS REVIEW ALL DRAWINGS TO CAPTURE ALL ELEMENTS PERTAINING TO THEIR DISCIPLINES FOR PRICING.



570 Annette Street Toronto, Ontario M6S 2C2 Canada

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	2 TENDER	17 OCT 2024
	I PERMIT	6 SEPT 2024

TORONTO METROPOLITAN UNIVERSITY

PROJECT NAME: CED MULTI-MEDIA LAB

LOCATION 297 VICTORIA STREET TORONTO, ON M5B IWI

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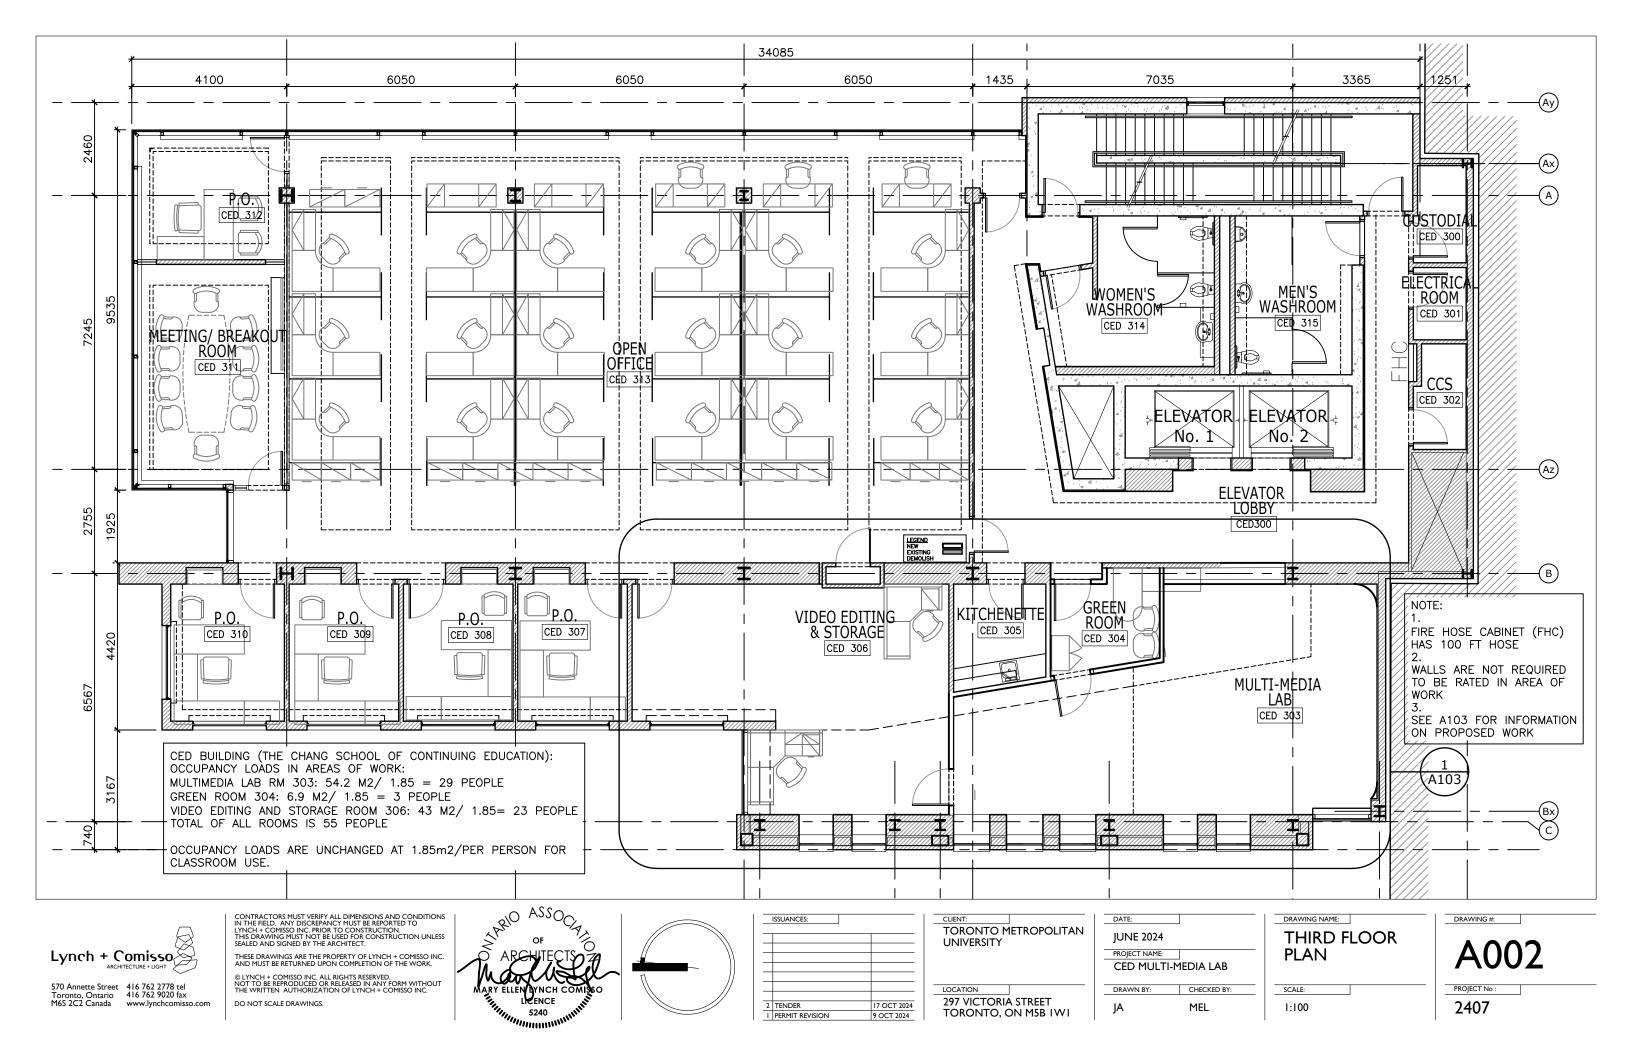
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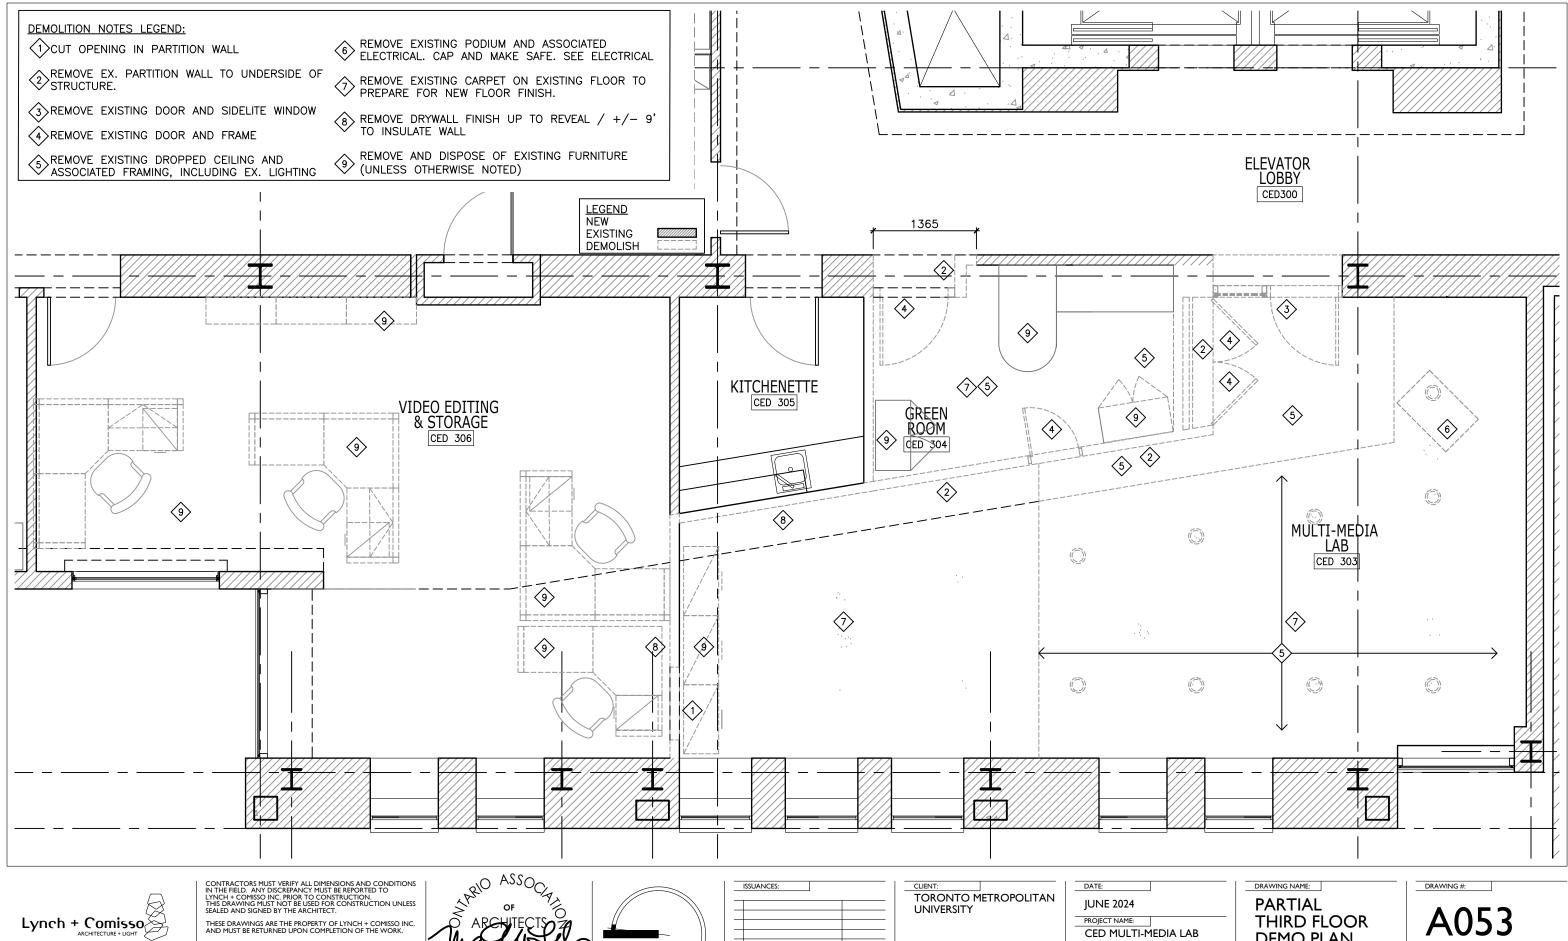
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I SCHEMATIC DESIGN

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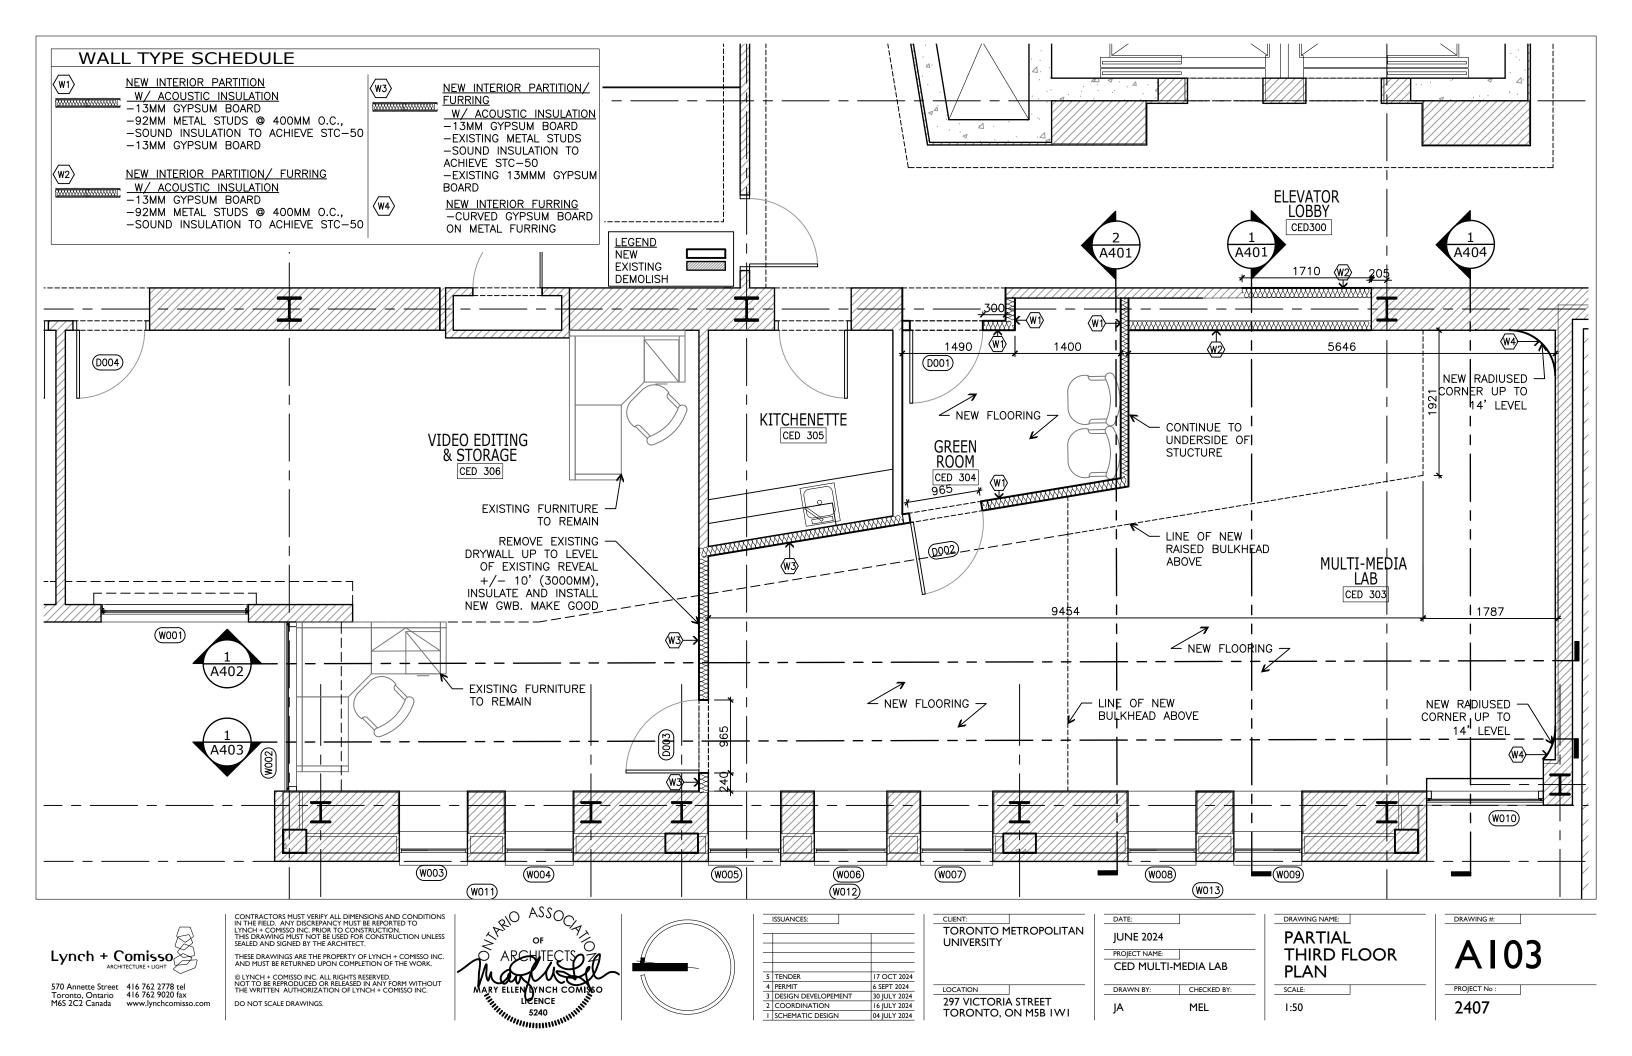
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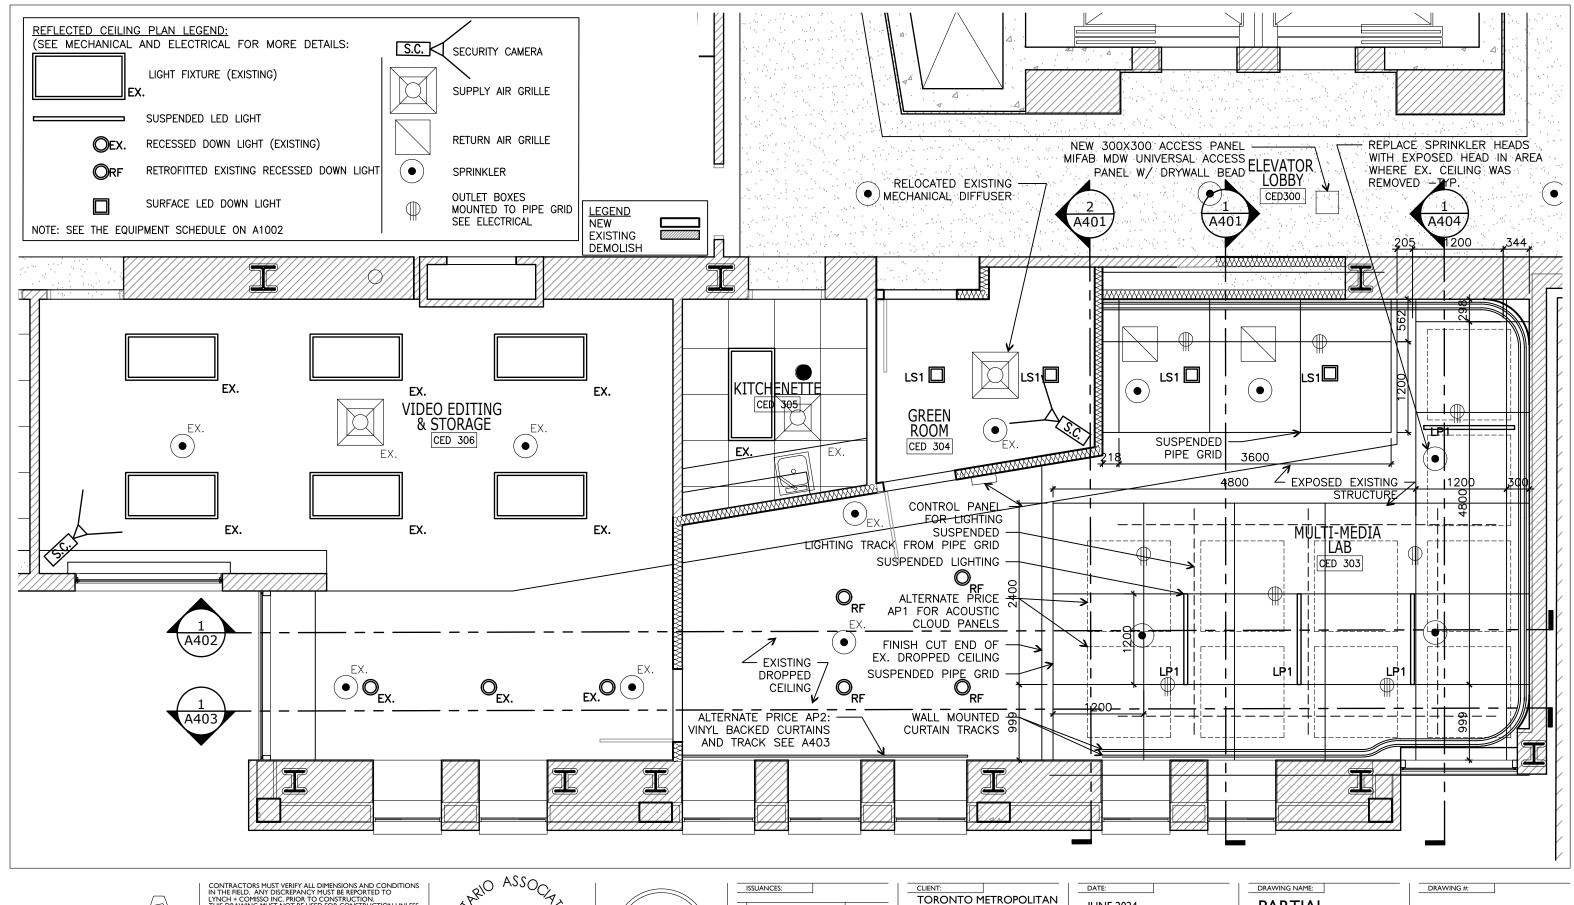
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DESIGN DEVELOPEMENT	30 JULY 2024	
COORDINATION	16 JULY 2024	297 VICTORIA STREET
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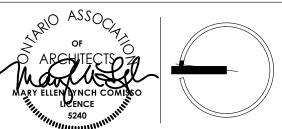


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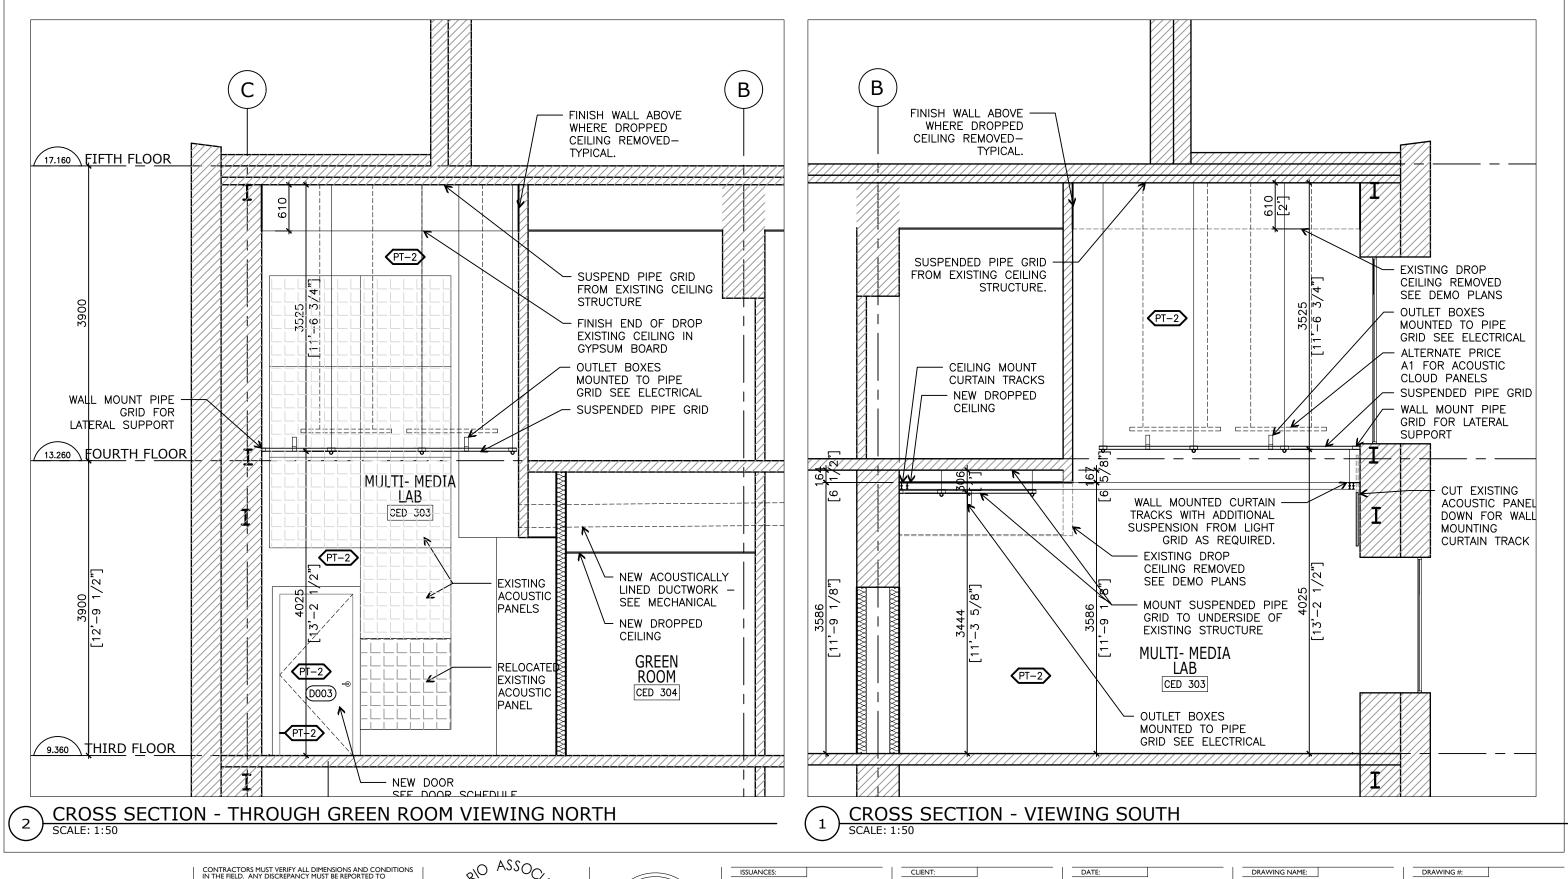


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Lynch + Comisso

ARCHITECTURE + LIGHT

570 Annette Street
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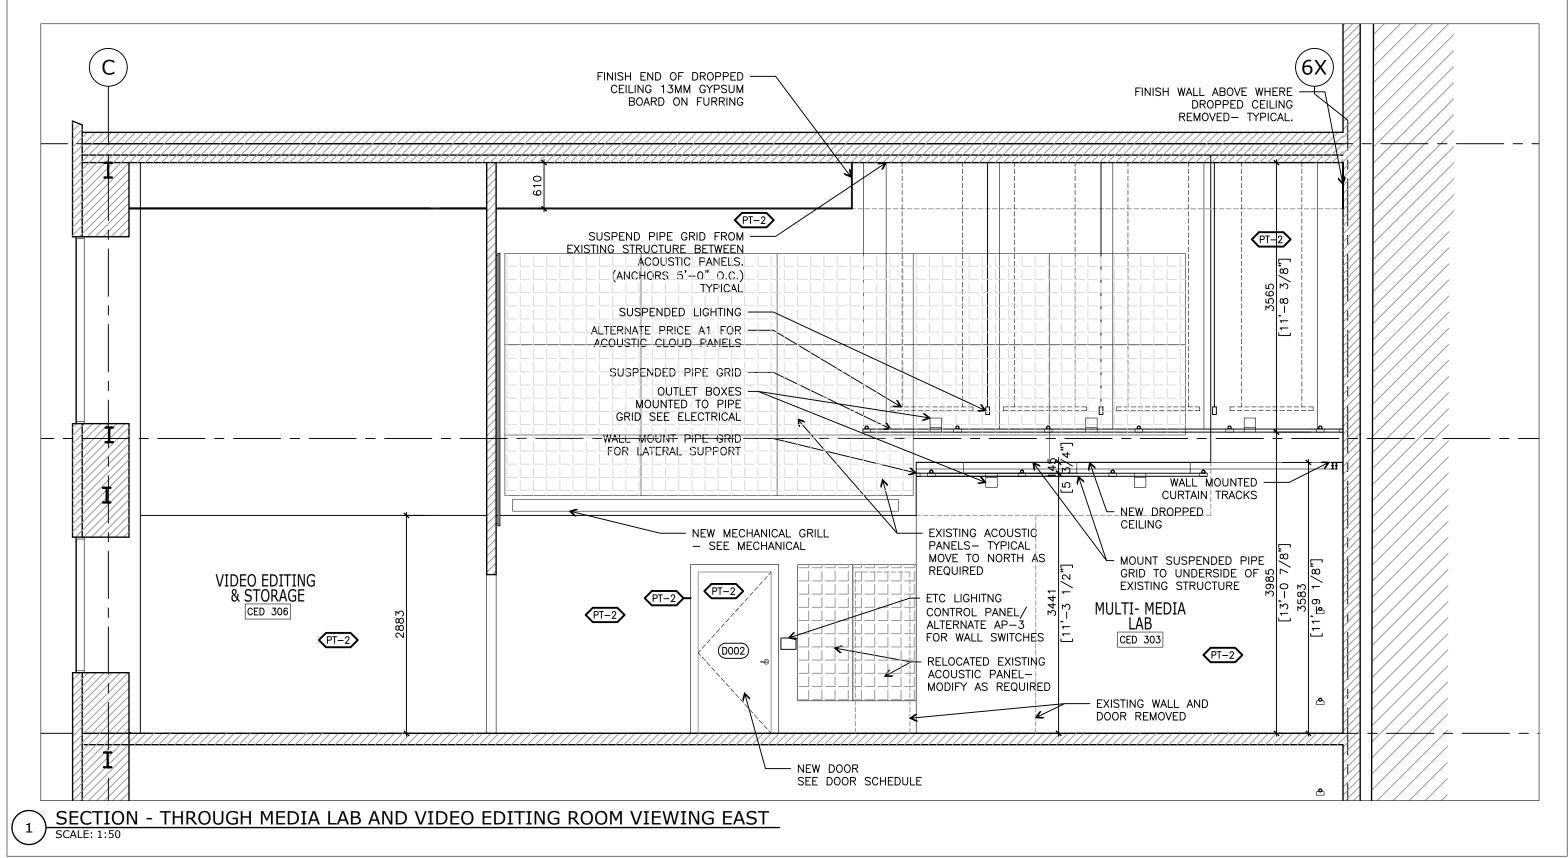
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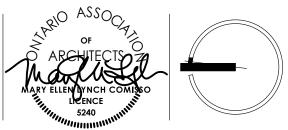
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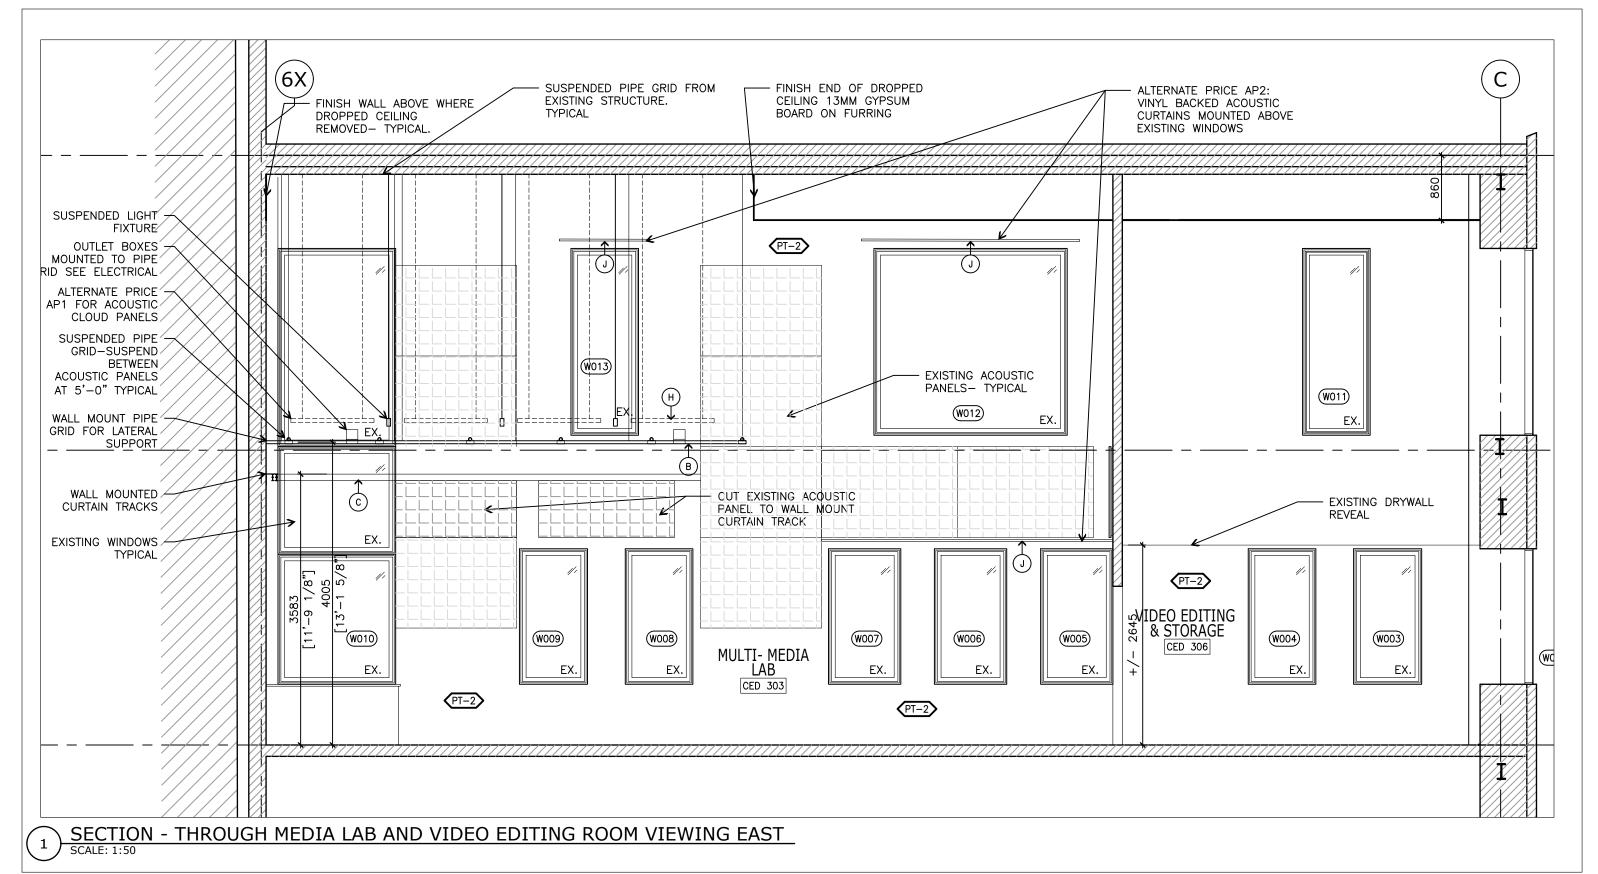
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TENDER	17 OCT 2024	
PERMIT	6 SEPT 2024	LOCATION
DESIGN DEVELOPEMENT	30 JULY 2024	
COORDINATION	16 JULY 2024	297 VICTORIA STREET
SCHEMATIC DESIGN	04 11 11 × 2024	TORONTO, ON M5B IWI

JUNE 2024		PARTIAL
CED MULTI-N	J MEDIA LAB	THIRD FLO SECTIONS
DRAWN BY:	CHECKED BY:	SCALE:
JA	MEL	1:50





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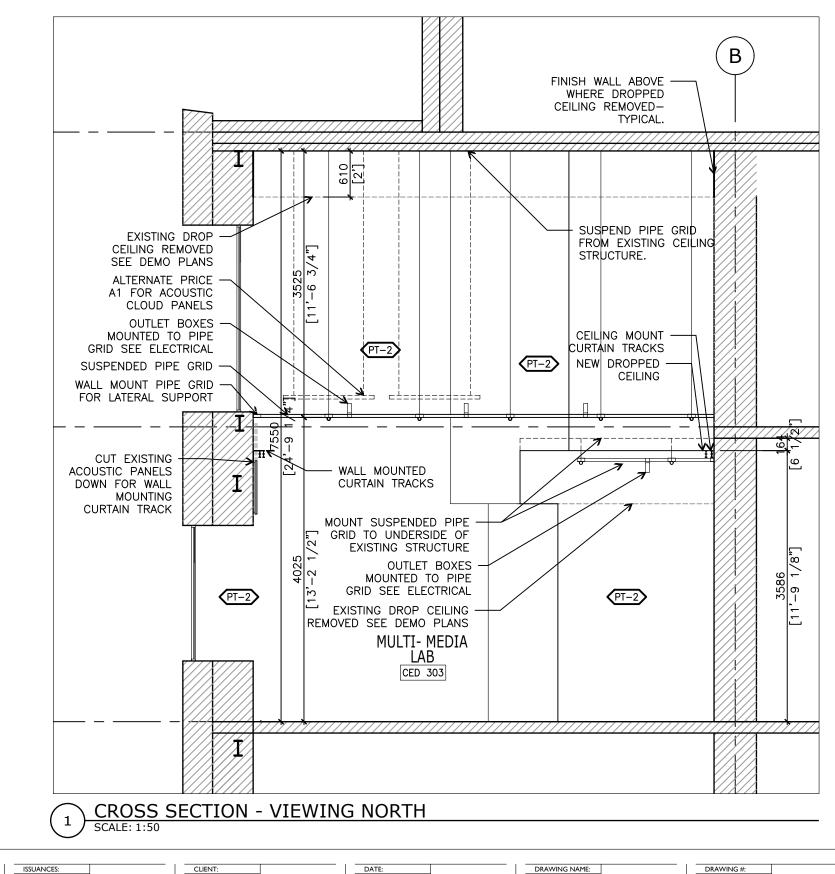
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ISS	SUANCES:		TORONTO METROPOLITAN UNIVERSITY
4 TI	ENDER	17 OCT 2024	LOCATION
3 PE	ERMIT	6 SEPT 2024	
2 D	ESIGN DEVELOPEMENT	30 JULY 2024	297 VICTORIA STREET
I C	OORDINATION	16 JULY 2024	TORONTO, ON M5B IWI

JUNE 2024  PROJECT NAME:  CED MULT	I-MEDIA LAB	PARTIAL THIRD FLO SECTIONS
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PROJECT No:
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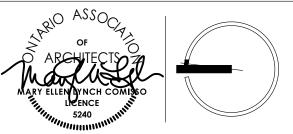
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3	TENDER	17 OCT 2024	
2	PERMIT	6 SEPT 2024	29
Т	DESIGN DEVELOPEMENT	30 IULY 2024	TC

CLIENT: TORONTO METROPOLITAN UNIVERSITY	
LOCATION	
297 VICTORIA STREET TORONTO, ON M5B IWI	

DATE:		DRAWING NAME: PARTIAL
PROJECT NAME:	-MEDIA LAB	THIRD FLO
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PROJECT No:
2407

#### **ROOM FINISH SCHEDULE** ROOM **FLOOR** TRIM **NORTH WALL EAST WALL SOUTH WALL WEST WALL CEILING** NUMBER NAME MAT'L **FINISH BASE** CASING/TRIM MAT'L **FINISH** MAT'L **FINISH** MAT'L FINISH MAT'L **FINISH** MAT'L FINISH 3RD FLOOR EX. GWB GWB/ EX. GWB PT-2 **GWB** PT-2 **GWB** PT-I CED 304 GREEN ROOM EX. CONC CF-1<sup>4</sup> WB-I PT-3 PT-2 **GWB** PT-2 CF-I<sup>4</sup> CED 305 MULI-MEDIA LAB EX. CONC WB-2 PT-2 PT-2 PT-2 EX. GWB<sup>2</sup> $PT-1^2$ EX. GWB<sup>2</sup> GWB/ EX. GWB<sup>2</sup> EX. GWB<sup>2</sup> PT-2 GWB/ EX. GWB<sup>2</sup> CED 306 VIDEO EDITING & STORAGE EX. CONC. EX. CPT. EX. WB PT-3 EX. GWB EX. GWB PT-2<sup>3</sup> GWB/ EX. GWB<sup>3</sup> PT-23 EX. GWB PT-23 EX. GWB EX. PT/ PT-13 CED 300 | ELEVATOR LOBBY EX. CONC. EX. CPT. EX. WB / WB-I EX. PT/ PT-35 EX. GWB EX. EX. GWB PT-3 EX. EX. GWB EX. GWB/ EX. GWB<sup>5</sup> GWB/ EX. GWB<sup>5</sup> EX. PT/ PT-3<sup>5</sup>

PAINT EXPOSED WALL AROUND EXISTING ACOUSTIC PANELS. PROTECT PANELS AND MODIFY PANELS AS SHOWN ON INTERIOR ELEVATIONS

<sup>5</sup> MAKE GOOD AND PAINT EXISTING WALL WHERE INFILLED. PAINT WALLS AND CEILING OF WIDENED NICHE FOR NEW DOOR TO GREEN ROOM

#### NOTE:

- I. ALL EXISTING FINISHES TO REMAIN ARE TO BE PATCHED AND MADE GOOD AND FINISHED AS NOTED. SEE INTERIOR ELEVATIONS.
- 2. MAKE GOOD EXISTING WALLS WHERE EXISTING WALLS AND CEILING ARE TO BE REMOVED. REFER TO DEMO DRAWINGS.
- 3. REFER TO INTERIOR ELEVATIONS FOR LOCATIONS AND EXTENTS OF FINISHES.
- 4. INSTALL BARREIR FREE TRANSITION FROM EXISTING CARPET TO CORK FLOORING

## DEFINITIONS ACT= ACOUSTIC CEILING TILE, ACWP= ACOUSTIC WALL PANEL, BRK= BRICK, CB

ACT= ACOUSTIC CEILING TILE, ACWP= ACOUSTIC WALL PANEL, BRK= BRICK, CB= CONCRETE BLOCK, CF- CORK FLOORING, CG= CASING/ TRIM, CONC= CONCRETE, CPT= CARPET,

CT= CERAMIC AND PORCELAIN TILE, EX= EXISTING, EP= EPOXY, GL= GLAZING, GWB= GYPSUM WALL BOARD, HW= HARDWOOD, LAM= LAMINATE FLOORING,

LINO= LINOLEUM SHEET FLOORING, MG= MAKE GOOD, MM= MELAMINE, PL= PLASTIC LAMINATE, PLYW= PLYWOOD, PT= PAINT, SM= SHOE MOULD, SS= SOLID SURFACE,

OR= QUARTER ROUND, WB= WALL BASE, WD= WOOD, WP= WOOD PANEL, WPP= WALLPAPER WALL COVERING, WV= WOOD VENEER, VF= VINYL FLOORING

#### **ROOM FINISH LEGEND**

#### **CORK FLOORING:**

CF-I AMORIM WOOD INSPIRE 48"X7" X 7.3MM / CONSTRUCTION IS CORK CORE WITH IMPRINTED WOOD LOOK WITH MATT FINISH / PRODUCT COLOUR ROYAL OAK INSPIRE 80003529, DISTRIBUTED BY THE FLOOR SHOP CONTACT LARRY WILLMOTT. TEL 416-234-0599 . EMAIL LARRY@THEFLOORSHOP.COM

### WALLBASE:

- WB-I RUBBER BASE TO MATCH EXISTING 4" RUBBER BASE DC JOHNSONSITE / TARKETT COMERICAL- COLOUR TBD
- WB-2 RUBBER BASE TO MATCH FLOORING 4" RUBBER BASE DC JOHNSONSITE / TARKETT COMERICAL- COLOUR WHITE

#### PAINT COLOUR SCHEDULE:

- PT-1 BENJAMIN MOORE CEILING WHITE FLAT SHEEN
- PT-2 BENJAMIN MOORE OC-130 CLOUD WHITE (WALLS EGGSHELL, TRIM SEMI-GLOSS)
- PT-3 BENJAMIN MOORE DARK GREY SHADE TO MATCH EXISTING (WALLS EGGSHELL, TRIM SEMI-GLOSS)

#### FINISHES NOTES:

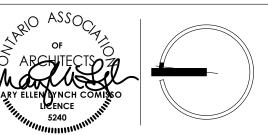
- 1. ALL MATERIALS INDICATED ON THE DRAWINGS ARE NEW UNLESS NOTED OTHERWISE.
- 2. REFER TO INTERIOR ELEVATIONS FOR LOCATIONS AND EXTENT OF FINISHES.
- 3. PATCH EXISTING FINISHES TO REMAIN ARE TO BE PATCHED AND MADE GOOD AND FINISHED AS NOTED
- 4. ALL SURFACES TO BE CLEAN AND FREE OF DIRT AND OIL PRIOR TO INSTALLATION OF NEW FINISHES. FILL AND PREPARE ALL SUBSTRATE SURFACES AND PRIME PER FINISH MANUFACTURER'S INSTRUCTIONS. CONCRETE SLAB SHALL BE LEVEL AND SMOOTH.
- 5. WHEN ONE WALL FINISH IS INDICATED WITHIN ENCLOSED AREA, THIS FINISH MUST BE APPLIED TO ALL WALLS, INCLUDING VERTICAL BULKHEADS, PERIMETER WALLS AND COLUMNS, UNLESS NOTED OTHERWISE.
- 6. ALL FINISHES TO BE PURCHASED BY CONTRACTOR. PROVIDE ALL LABOUR, MATERIALS, PRODUCTS, EQUIPMENT AND SERVICES REQUIRED TO INSTALL THE FINISHES AS INDICATED ON THE DRAWINGS AND FINISHES SCHEDULE IN STRICT ACCORDANCE WITH THE MANUFACTURER'S INSTRUCTIONS.
- 7. PATCH AND REPAIR ALL DAMAGED FINISHES WITHIN THE AREA OF WORK AS REQUIRED TO COMPLETE THE SCOPE OF WORK.
- B. PROVIDE ALL TRANSITION AND REDUCER STRIPS REQUIRED TO ELIMINATE TRIPPING HAZARDS, AND TO MEET OBC AND AODA
- REQUIREMENTS. CONTRACTOR TO SKIM FLOOR AND/OR FEATHER UP CONCRETE SLAB IF REQUIRED TO MINIMIZE TRANSITION HEIGHT. REVIEW WITH CONSULTANT PRIOR TO INSTALL.
- 9. FINISHED FLOOR SHALL BE LEVEL AND EVEN WITH NO TRIPPING EDGES.
- 10. CONTRACTOR SHALL SUBMIT SHOP DRAWINGS, MSDS, AND COLOUR/FINISH SAMPLES TO CONSULTANT FOR EACH NEW FIXTURE.
- 11. PRODUCT AND FINISH SPECIFIED, FOR REVIEW & APPROVAL PRIOR TO INSTALLING. G.C. IS RESPONSIBLE FOR SCHEDULING THE SUBMITTALS ALLOWING TIME FOR REVIEW & COMMENT.



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	ISSUANCES:	
2	TENDER	17 OCT 2024
T	PERMIT	6 SEPT 2024



297 VICTORIA STREET

TORONTO, ON M5B IWI

V	JUNE 2024	
	PROJECT NAME:	
	CED MULTI	-MEDIA LAB
_	DRAWN BY:	CHECKED BY:
	14	MEI

FINSIHES
SCHEDULE
AND LEGEND
SCALE:



<sup>&</sup>lt;sup>2</sup> MAKE GOOD WALL AND CEILING WHERE EXISTING DROP CEILING WAS REMOVED. PAINT EXPOSED STRUCTURE AND GWB

<sup>3</sup> REPLACE GWB WHERE SHOWN & PAINT WALLS UP TO EXISTING REVEAL (+/-10'-0") / UNDERSIDEOF CEILING. MAKE GOOD WALLS AND REVEAL. EXISTING WALL ABOVE REVEAL AND HEIGH CEILING TO REMAIN AS IS. PAINT LOW CEILING.

 $<sup>^4</sup>$ remove existing finishes where new finishes are proposed. Prepare existing substrate as per manufacturers requirements.

### TMU MULTI-MEDIA LAB EQUIPMENT LIST (IN ROOM CED 303) AND ALTERNATE PRICE LIST

ITEM 7	ITEM	ITEM DETAILS	QUANTITY	SUPPLIED BY	INSTALLED BY	LOCATION	COMMENTS
A	SMALL PIPE GRID*	4'X4' SPACING, OVER / UNDER SCHEDULE 40 ALUMINUM PIPE GRID, POWDER COATED BLACK BY ONTARIO STAGING LIMITED	1	GC	GC	UNDERSIDE OF 4TH FLOOR OVERHANG	
В	LARGE PIPE GRID*	4'X4' SPACING, OVER / UNDER SCHEDULE 40 ALUMINUM PIPE GRID, POWDER COATED BLACK BY ONTARIO STAGING LIMITED	1	GC	GC	SUSPENDED FROM 5TH FLOOR	
С	CURTAIN TRACK*	STANDARD DUTY CURVED TRACK WALKALONG IN BLACK FINISH. CURTAIN TRACK TO BE COMPLETE WITH END STOP, WALL HANGERS AND CEILING HANGERS WHERE REQUIRED. TRACK BY ONTARIO STAGING LIMITED	2	GC	GC	FLOOR OVERHANG CEILING WITH	TRACK SO GREEN SCREEN
D	GREEN SCREEN*	12'H X 30' W 100% IFR POLYESTER RB CLOTH - CHROMAKEY GREEN; C/W BLACK POLYPROPYLENE WEBBING & SILVER #4 GROMMETS ON ALL SIDES AND WEIGHTED BOTTOM BY ONTARIO STAGING LIMITED	1	GC	GC		SITE VERIFY SIZE TO ENSURE IT HANGS FLAT
F	BLACK CURTAIN*	12'H X 50' W BLACK FLAT 21 OZ FLAME RETARDENT VELOUR FABRIC C/W BLACK POLYPROPYLENE WEBBING & SILVER #4 GROMMETS ON ALL SIDES AND WEIGHTED BOTTOM BY ONTARIO STAGING LIMITED	1	GC	GC		SITE VERIFY SIZE TO ENSURE IT HANGS FLAT
G	MANFROTTO SKYTRACK AND MOUNTING BRACKETS AND PANTOGRAPH SPRING	MANFROTTO SKYTRACK TOP SYTSTEM 54 (FF3054) INCLUDES 2 FIXED RAILS, THREE MOBILE RAILS AND 4 PANTOGRAPHS. TRACK TO BE MOUTEND TO THE PIPE GRID USING MANRFROTTO SCAFFOLD MOUNTING BRACKETS (FF3214). PANTOGRAPHS TO BE INSTALLED WITH MANFROTTO SPRING FOR COUNTER BALANCING PANTOGRAPHS- TYPE 4, RED (FF3531)	1 TRACK- + 4- SPRINGS+ BRACKET S		GC		GC TO CONFIRM HOW MANY BRACKETS ARE REQUIRED FOR MOUNTING
Н	ALTERNATE PRICE AP1: ACOUSTIC CLOUD PANELS	SUPPLY AND INSTALL ACOUSTIC CLOUD - RECTANGULAR - 1200mmx1100mm w/ 50mm EDGE, PET THICKNESS :12MM ,COLOUR: OYSTER BY HUSH ACOUSTICS - CONTACT HUGO BURROWS CEL 647-792.4120 HUGO.BURROWES@HUSHACOUTICS.CA	10	GC	GC	SUSPENDED FROM HIGH CEILING ABOVE LARGE PIPE GRID - SEE DRAWINGS	
J	ALTERNATE PRICE AP2: SOUND BLOCKING ACOUSTIC CURTAINS WITH TRACKS	PROVIDE COMBINATION SOUND BLOCKING / SOUND ABSORBING CURTAINS. CURTAINS TO HAVE THREE LAYERS. MIDDLE LAYER TO BE SOUND BLOCKING VINYL STC-13. FRONT LAYER TO BE CRESCENT VELOUR IN BLACK COLOUR. CURTAINS TO HAVE WHITE DRAPERY LINER ON BACK AND ARE TO HAVE 100% FULLNESS. CURTAIN TO BE COMPLETE WITH HEAVY DUTY CURTAIN TRACKS BY SAME MANUFACTURER. ACCEPTABLE MANUFACTURER IS QUIET CURTAINS OR APPROVED EQUIVALENT. CONTACT DAVID ROST QUIET CURTAINS CELL: 510.708.5429 EMAIL DROST@QUIETCURTAINS.COM		GC	GC	SEE A403 FOR LOCATION	
K	ALTERNATE PRICE AP3: LIGHTING CONTROLS	DELETE ETC LIGHTING CONTROL SYSTEM FOR PIPE GRID EQUIPMENT AND PROVIDE WALL SWITCHES TO CONTOL OUTLET BOXES MOUNTED TO PIPE GRID. SEE ELECTRICAL FOR MORE INFORMATION.		GC	GC	SEE A402 FOR LOCATION	SEE ELECTRICAL

\*ITEMS TO BE SUPPLIED BY ONTARIO STAGING LIMITED OR APPROVED EQUIVALENT. CONTACT MARIA SICILIANO EMAIL MARIA@ONTARIOSTAGING.COM NOTE:

- 1 CONTACTOR TO INCLUDE, IN BASE BID, ALL ITEMS NOTED TO BE SUPPLED AND INSTALLED BY GC
- 2 CONTACTOR TO INCUDE INSTALLATION OF OWNER SUPPLED ITEMS AS NOTED IN THE CHART ABOVE
- 3 REFER TO REFLECTED CEILING PLAN AND SECTIONS FOR LOCATIONS
- 4 ALL ITEMS ARE TO BE BROUGHT TO THE WORK AREA BY THE EXISTING ELEVATOR. EXISTING ELEVATOR CABS ARE 7'-5" HIGH X 4'-9.5" WIDE X 6'-0" LONG

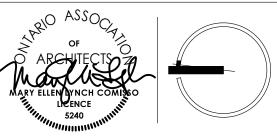


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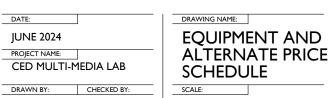
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2	TENDER PERMIT	17 OCT 2024 6 SEPT 2024	-	297 VICTORIA TORONTO, O					



MEL



#### WINDOW COVERING SCHEDULE

WINDOW	OW LOCATION			OPENING S	IZE*		
#	RM #	ROOM NAME	WIDTH	HEIGHT	SILL HEIGHT	TYPE	NOTES
W001	306	VIDEO EDITING					EXSTING WINDOW COVERING TO REMAIN
W002	306	VIDEO EDITING	2200	1800	800	WC-1	
W003	306	VIDEO EDITING	900	1800	800	WC-1	
W004	306	VIDEO EDITING	900	1800	800	WC-1	
W005	303	MULTI-MEDIA LAB	900	1800	800	WC-2	EXSITING TO REMAIN AND SEE ALTERNATE
W006	303	MULTI-MEDIA LAB	900	1800	800	WC-2	PRICE AP-1 FOR ADDITIONAL ACOUSTIC
W007	303	MULTI-MEDIA LAB	900	1800	800	WC-2	CURTAIN OVER THE THREE WINDOWS
W008	303	MULTI-MEDIA LAB	900	1800	800	WC-2	EXISTING TO REMAIN
W009	303	MULTI-MEDIA LAB	900	1800	800	WC-2	EXISTING TO REMAIN
W010	303	MULTI-MEDIA LAB	1600	5800	800		EXISTING TO REMAIN
W011	306	VIDEO EDITING	900	2500	4100		NO COVERINGS
W012	303	MULTI-MEDIA LAB	2600	2500	4100		SEE ALTERNATE PRICE AP-1
W013	303	MULTI-MEDIA LAB	900	2500	4100		SEE ALTERNATE PRICE AP-1
*DIMENSIONS ARE APPROXIMATE - VERIFY WINDOW SIZES ON SITE							

#### WINDOW COVERING TYPE:

MANUAL DOUBLE ROLLER BLIND WITH PRIVACY AND BLACK OUT FABRIC **ACCEPTABLE PRODUCTS:** 

1 SOLARFECTIVE: T-8 TELESHADE SYSTEM SNAP IN MOUTING DETAIL

SHADE TO BE INSET IN WINDOW NICHE

SHADES TO BE COMPLETE WITH FASCIA AND SIDE CHANEL FOR BLACKOUT BLINDS

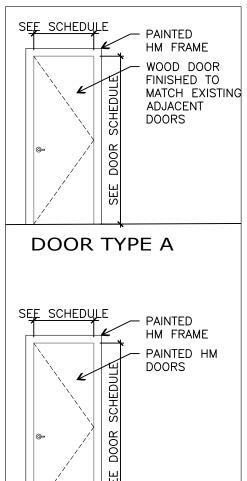
FABRIC 1: BLACKOUT BASIC 5B-08 BLACK/ WHITE (WHITE ON EXTERIOR WINDOW SIDE)

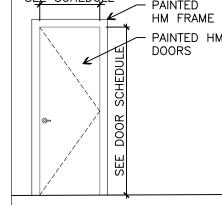
FABRIC 2: 1A03 - 3% OPEN COLOUR U59 ECO/ALABASTER

2 APPROVED EQUIVALENT

WC-2 ADD ALUMINUM SIDE CHANELS FOR EXISTING BLINDS

WINDOW COVERING LEGEND





DOOR TYPE B

DOOR TYPE LEGEND SCALE: 1:50

#### WINDOW COVERING SCHEDULE 3 SCALE:

DOOR SCHEDULE													
Door #	Room#	Room Name	Type	DR	FR	CAT.	Size	(inch)		Finish	Fire Rating Under Cut	Lock	Notes
				Mat.	Mat.		Width	Height	Thick.				
D001	CED 304	GREEN ROOM	N	SC	HM	N	38"	96"	1 3/4"	ST/ PT-3*		Y	WOOD DOOR TO MATCH EXISTING. PAINT FRAME*
D002	CED 303	MULTI-MEDIA LAB	N	HM	HM	N	38"	96"	1 3/4"	PT-3		Υ	PAINT DOOR AND FRAME**
D003	CED 303	MULTI-MEDIA LAB	N	HM	HM	N	38"	96"	1 3/4"	PT-3		Y	PAINT DOOR AND FRAME**
D004	CED 306	VIDEO EDITING & STORAGE	E							PT-3		Υ	PAINT FRAME - WOOD DOOR TO REMAIN AS IS

\*Wood door finish to match adjacent wood doors. Paint hollow metal frame to match existing (PT-3)

\*\* Daint door and frame DT 2

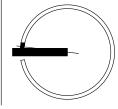
** Paint door and	d frame PT-2		
LEGEND;		GEN	IERAL NOTES FOR DOOR SCHEDULE:
	CATEGORY:	1.	VERIFY ALL DIMENSIONS ON SITE.
	E= EXISTING DOOR AND FRAME TO REMAIN	2.	NEW CORRIDOR DOORS TO MATCH EXISTING DOOR HEIGHTS IN CORRIDOR. VERIFY DOOR HEIGHTS
	N= NEW DOOR AND FRAME IN NEW OPENING		ON SITE PRIOR TO ORDERING.
	NE= NEW DOOR AND FRAME IN EXISTING OPENING⁴	3.	DOOR OPENINGS ARE TO BE LOCATED MINIMUM OF 4" FROM ADJACENT WALLS UNLESS
			OTHERWISE NOTED.
	AL= ALUMINUM	4.	REFER TO HARDWARE SCHEDULE ON A1004
	G= GLASS	5.	DOORS TO HAVE RECESSED / MORTISED AUTOMATIC DROP SEAL AT BASE AND FULL PERIMETER
	HM= HOLLOW METAL		ACOUSTIC SEALS AROUND FRAME. DOOR FRAME DIMENSIONS TO ACCOUNT FOR SOUND SEALS.
	SC= SOLID CORE WOOD DOOR		SEE HARDAWRE SCHEDULE.
	PT= PAINT FINISH	6.	FILL DOOR AND FRAMES SOLID WITH INSULATION FOR INCREASED SOUND TRANSMISSION RATING
	ST= STAIN FINISH		



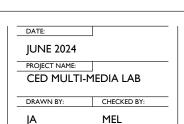
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-		<del></del>	LOCATION
2	TELIDED	17.0CT 2024	297 VICTORIA STREET
2	TENDER	17 OCT 2024	
I	PERMIT	6 SEPT 2024	TORONTO, ON M5B IWI



DRAWING NAME: DRAWING #: DOOR WINDOW COVERING **SCHEDULES** SCALE: PROJECT No

Lynch + Comisso 570 Annette Street Toronto, Ontario M6S 2C2 Canada 416 762 2778 tel 416 762 9020 fax www.lynchcomisso

### **Openings Schedule**

Opening Number(s)	Qty	Туре	Door Catalog	Location 1	To/ From	Location 2	Nominal Width	Nomina Height	l Door Thickne	ssHand	Label	Degree of Openi	e ng Hardware Group	Heading Num.	Remarks
001	1	Single	<wood></wood>	CORR	ТО	GREEN RM	38"	96"	1 3/4"	RH	 	90°	STORE RM SOUND	1	
0002	1	Single	     	GREEN RM	TO	MULTI MEDIA	38"	96"	1 3/4"	H		+ 100°	STORE RM SOUND CLOH	2	     
D003	1	Single	       	MULTI MEDIA	TO	VIDEO EDIT	38"	96"	1 3/4"	H		90°	STORE RM SOUND CLOH	   2 	       
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CDH

COMMERCIAL DOORS & HARDWARE LTD. 2150 WINSTON PARK DR UNIT 16 OAKVILLE , ON., ross@cdh.ca

T.M.U. MEDIA LAB 297 VICTORIA ST, TORONTO

Submittal Date: SEPT 4/24

Page 3 of 15

### **Hardware Schedule**

Heading #1 (Group: STORE RM SOUND)

Item #1 1 Single door D001, CORR TO GREEN RM 90° RH

38" x 96" x 1 3/4" - WD DR x HM FR

4	Standard Hinge	Ives 5BB1HW 4.5 " x 4 .5 " 652	652
1	Lockset	Sargent 10XG04 LL US26D RH CONFIRM KEYING PRIOR TO ORDER	US26D
1	Wall Door Stop	lves WS401/402CCV US26D	US26D
1	Threshold	K.N. Crowder CT-65F-CA x 38"	CA
1	Weatherstripping	K.N. Crowder W-42-BA x 38"x96" Opening	BA
1	Gasketing	K.N. Crowder CT-53 x 38"	

Heading #2 (Group: STORE RM SOUND CL OH)

Item #21 Single door D002, GREEN RM TO MULTI MEDIA100° RHItem #31 Single door D003, MULTI MEDIA TO VIDEO EDIT90° LH

38" x 96" x 1 3/4" - HM DR x HM FR

8	Standard Hinge	lves 5BB1HW 4.5 " x 4 .5 " 652	652
1	Lockset	Sargent 10XG04 LL US26D LH CONFIRM KEYING PRIOR TO ORDER	US26D
1	Lockset	Sargent 10XG04 LL US26D RH CONFIRM KEYING PRIOR TO ORDER	US26D
2	Surface Closer	LCN 1461 689 - REG MTD 1 3/4"	689
2	Kick Plate	CBH CBH 903 200 X 50MM LDW C32D	US32D
2	Overhead Door Stop	Glynn-Johnson 104S US32D	US32D
2	Threshold	K.N. Crowder CT-65F-CA x 38"	CA
2	Weatherstripping	K.N. Crowder W-42-BA x 38"x96" Opening	BA
2	Gasketing	K.N. Crowder CT-53 x 38"	

CDH

COMMERCIAL DOORS & HARDWARE LTD. 2150 WINSTON PARK DR UNIT 16 OAKVILLE, ON., ross@cdh.ca

T.M.U. MEDIA LAB 297 VICTORIA ST, TORONTO

Submittal Date: SEPT 4/24

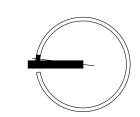
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Lynch + Comisso

570 Annette Street Toronto, Ontario M6S 2C2 Canada

416 762 2778 tel 416 762 9020 fax www.lynchcomisso.co





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TORONTO METROPOLITAN UNIVERSITY

CED MULTI-MEDIA LAB

297 VICTORIA STREET TORONTO, ON M5B I WI

DRAWN BY: CHECKED BY:

DRAWING NAME:

HARDWARE SCHEDULE

SCALE:

DRAWING #:

A 1004

PROJECT No :