


THREE-WAY WIRING DIAGRAM:
LIGHTS WILL TURN OFF AUTOMATICALLY WHEN SENSOR THAT DETECTED MOTION LAST, TIMES OUT.

1 UNIVERSAL WASHROOM EXHAUST FAN & LIGHTING CONTROL WIRING
SCALE: N.T.S.

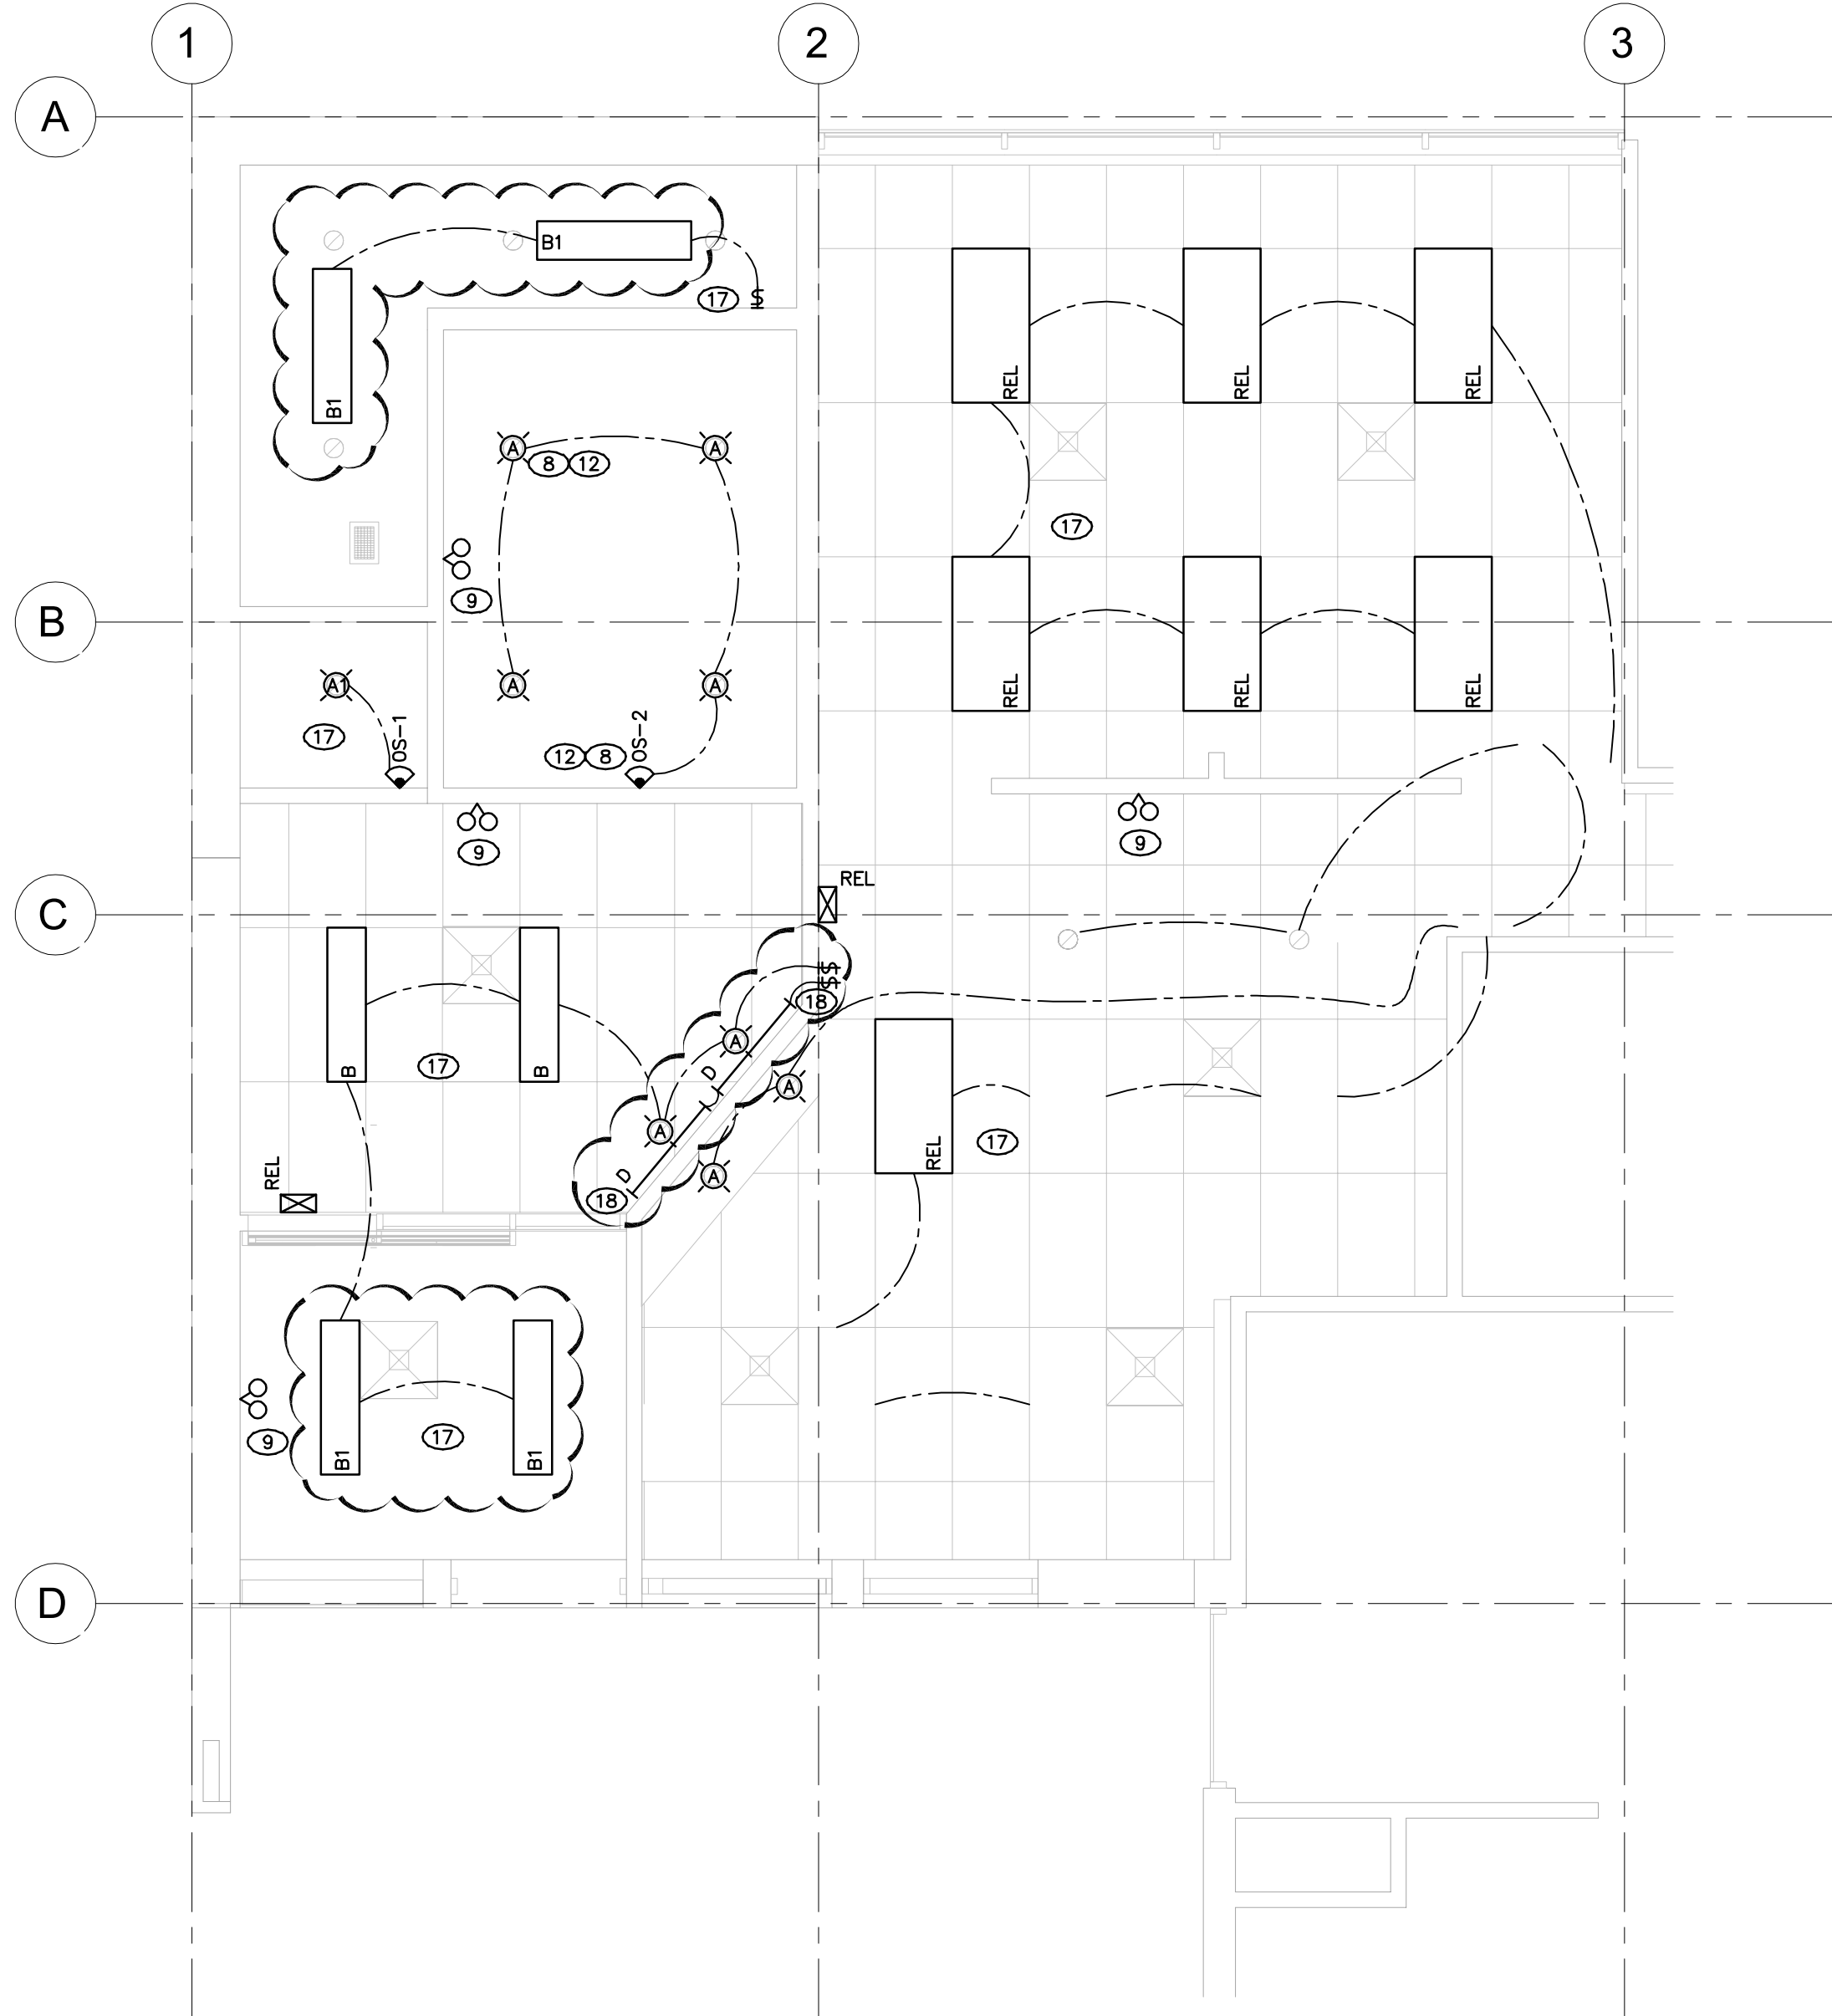

2 PART PLAN - PROPOSED - LIGHTING
SCALE: 1:50

GENERAL NOTES:

- THE FACILITY IS TO REMAIN IN OPERATION DURING THE COURSE OF CONSTRUCTION. THE CONTRACTOR SHALL INCLUDE FOR MAKING TEMPORARY CONNECTIONS AND EXTENDING CONDUIT AND WIRE AS REQUIRED TO FACILITATE RELOCATING AND REMOVING DEVICES. ALL SERVICES ARE TO REMAIN OPERATIONAL. COORDINATE ANY OUTAGES REQUIRED WITH THE OWNER IN WRITING A WEEK IN ADVANCE OF THE WORK.
- THE EXISTING IT CLOSET IS WITHIN THE DEMOLITION SCOPE. PRIOR TO ANY DEMOLITION THE CONTRACTOR SHALL WORK WITH THE OWNER AND INSTALL TEMPORARY HOARDING TO SECTION OFF THE RACK AND KEEP IT FREE OF DUST AND DEBRIS. PROVIDE ZIPPERED ENCLOSURES AND SEAL AIR TIGHT. ACCESS TO THE RACK IS TO BE AVAILABLE AT ALL TIMES SHOULD THE OWNER NEED ACCESS TO IT. THE CONTRACTOR SHALL COORDINATE THIS WORK WITH THE OWNERS IT REPRESENTATIVE.
- EXISTING LIGHTING AND POWER CIRCUITS ARE TO BE REUSED IN THE NEW LAYOUT.

DRAWING NOTES (CONT'D):

- PANIC BUTTON**
ELECTRICAL CONTRACTOR SHALL ENGAGE DUPONT SECURITY TO SUPPLY AND INSTALL WIRELESS PANIC BUTTON AT NEW WORK STATION AS SHOWN. C/W WIRELESS TRANSMITTER AND AUDIBLE AND VISUAL NOTIFICATION DEVICE, LOCATE IN SECURITY OFFICE (OR AS DIRECTED BY CLIENT). CONTRACTOR SHALL CARRY A CASH ALLOWANCE TO COMPLETE THIS WORK. COORDINATE DEVICE LOCATIONS WITH ELECTRICAL CONTRACTOR ELECTRICAL ROUGH-INS SECURITY VENDOR AND ARCHITECTURAL MILL WORK DRAWINGS FOR PUSHBUTTON LOCATION.
- SLIDING DOOR POWER SUPPLY:**
SUPPLY AND INSTALL ONE (1) 15A, 120V CIRCUIT COMPLETE WITH WIRING AND CONDUIT (2C#12+GRD IN 21mm EMT) AT THIS LOCATION FOR SLIDING DOOR OPERATOR. INCLUDING ONE (1) SINGLE POLE 15A BRANCH BREAKER IN EXISTING ELECTRICAL PANEL BOARD "DP-L" BRANCH POSITION #20 LOCATED IN ELECTRICAL ROOM. DOOR OPERATOR AND ALL WIRING TERMINATIONS AND CONTROLS SUPPLIED AND INSTALLED AND WIRED BY DOOR VENDOR/INSTALLER.

DRAWING NOTES (CONT'D):


- DOOR OPERATOR POWER SUPPLY:**
SUPPLY AND INSTALL TWO (2) 15A, 120V CIRCUITS COMPLETE WITH WIRING AND CONDUIT (2C#12+GRD IN 21mm EMT) ONE EACH AT THESE TWO LOCATIONS AND INCLUDING TWO (2) SINGLE POLE 15A BRANCH BREAKERS IN EXISTING ELECTRICAL PANEL BOARD "DP-L" LOCATED IN ELECTRICAL ROOM.
- UNIVERSAL WASHROOM LIGHTING AND POWER:**
SUPPLY AND INSTALL ONE (1) 15A, 120V CIRCUIT COMPLETE WITH WIRING AND CONDUIT (2C#12+GRD IN 21mm EMT) AT THIS LOCATION INCLUDING ONE (1) SINGLE POLE 15A BRANCH BREAKER IN EXISTING ELECTRICAL PANEL BOARD "DP-L" LOCATED IN ELECTRICAL ROOM. WIRE TO NEW COMBINATION LIGHT SWITCH FAN SWITCH.
- UNIVERSAL WASHROOM HAND DRYER:**
SUPPLY AND INSTALL ONE (1) 20A, 120V CIRCUIT COMPLETE WITH WIRING AND CONDUIT (2C#12+GRD IN 21mm EMT) AT THIS LOCATION INCLUDING ONE (1) SINGLE POLE 20A BRANCH BREAKER IN EXISTING ELECTRICAL PANEL BOARD "DP-L" LOCATED IN ELECTRICAL ROOM. WIRE TO NEW HAND DRYER.
- PHOTOCOPIER:**
SUPPLY AND INSTALL ONE (1) 20A, 120V CIRCUIT COMPLETE WITH WIRING AND CONDUIT (2C#12+GRD IN 21mm EMT) AND ONE NEW RJ45 DATA DROP AT THIS LOCATION FOR RELOCATED PHOTOCOPIER INCLUDING ONE (1) SINGLE POLE 20A BRANCH BREAKER IN EXISTING ELECTRICAL. RUN CAT6A DATA CABLE FROM DATA DROP TO SERVER ROOM TO SERVER ROOM
- NEW DATA OUTLET**
SUPPLY AND INSTALL ONE NEW COMPUTER/DATA OUTLET AT THIS LOCATION C/W BACK BOX, RJ45 JACK, COVER PLATE AND CAT6A DATA CABLE. RUN CAT6A DATA CABLE FROM DATA DROP TO SERVER ROOM DATA RACK AND TERMINATE TO PATCH PANEL.
- EXISTING WALL MOUNTED PHONE NEW LOCATION, RE-USE EXISTING MOUNTING WALL BRACKET IF PRACTICAL OTHERWISE PROVIDE NEW WALL BRACKET. CONTRACTOR TO SUPPLY AND INSTALL NEW BACK BOX C/W RJ11 PHONE JACK AND WIRING TO THIS LOCATION, RUN WIRING TO IT SERVER ROOM, TELEPHONE PUNCH DOWN BOARD OR IF VOIP TO DATA RACK. TERMINATE BOTH ENDS TO RESTORE PHONE TO GOOD WORKING ORDER.
- CONTRACTOR SHALL RECORD AND RE-USE ANY/ALL CIRCUITS MADE AVAILABLE IN DEMOLITION PHASE AND RE-PURPOSE THESE CIRCUITS TO ACCOMMODATE NEW RECEPTACLES, LIGHTING CIRCUITS, OR POWER SUPPLIES TO NEW EQUIPMENT. CONTRACTOR SHALL REVISE AND UPDATE PANEL BOARD SCHEDULES TO REFLECT THERE CORRESPONDING BRANCH BREAKERS ACCORDINGLY.

- SUPPLY AND INSTALL TWO 36" LONG TYPE "D" LED STRIP LIGHTING FIXTURES SURFACE MOUNTED UNDER SIDE OF MILLWORK (REFER TO DESK DETAIL #6 ON ARCHITECTURAL DRAWING A2.3) WIRE TO EXISTING LIGHT CIRCUIT IN LOBBY C/W SEPARATE WALL CONTROL ROCKER SWITCH FOR INDEPENDANT LIGHT CONTROL.

DRAWING NOTES:

- THE EXISTING IT CLOSET IS WITHIN THE DEMOLITION SCOPE. THE CONTRACTOR SHALL WORK WITH THE OWNER AND INSTALL TEMPORARY HOARDING TO SECTION OFF THE RACK AND KEEP IT FREE OF DUST AND DEBRIS. PROVIDE ZIPPERED ENCLOSURES AND SEAL AIR TIGHT. ACCESS TO THE RACK IS TO BE AVAILABLE AT ALL TIMES SHOULD THE OWNER NEED ACCESS TO IT. THE CONTRACTOR SHALL COORDINATE THIS WORK WITH THE OWNERS IT REPRESENTATIVE.
- EXISTING SECURITY CAMERA TO BE REINSTALLED. COORDINATE LOCATION ON SITE WITH OWNER AND ADJUST VIEWING ANGLE TO SUIT OWNERS PREFERENCE.
- EXISTING SECURITY DOOR DEVICES TO BE RELOCATED AND REINSTALLED AT THIS NEW LOCATION. REWORK WIRING AS REQUIRED AND EXTEND CONDUIT TO SUIT NEW LOCATIONS. COORDINATE WORK WITH THE OWNERS ACCESS CONTROL VENDOR FOR TERMINATING IN EXISTING SECURITY HEAD END EQUIPMENT. SEE DETAIL DWG
- REINSTALL FIRE ALARM DEVICES. DEVICES ARE TO BE RECESSED INTO THE WALL. THE CONTRACTOR IS TO INCLUDE FOR TESTING AND VERIFICATION OF EVERY DEVICE ON ANY LOOP THAT IS MODIFIED AS PART OF THIS PROJECT. PROVIDE A TESTING REPORT AS PART OF THE MANUALS AT PROJECT CLOSEOUT.
- EXISTING PUSHBUTTONS TO BE RELOCATED TO NEW WALL. EXTEND EXISTING CONDUIT AND WIRE AS REQUIRED TO NEW LOCATION. COORDINATE EXACT LOCATION ON SITE WITH THE OWNER AND WORK STATION LAYOUT AT TIME OF ROUGH-IN.
- PROVIDE NEW SURFACE MOUNTED BACK BOX AND RUN CONDUIT CONCEALED IN INTERIOR WALLS AND CEILINGS, AND ROUTE CONDUIT THROUGH BUILDING TO CONNECT TO THE NEW DOOR OPERATOR. DRILL THROUGH EXTERIOR MASONRY WALL TO PROVIDE CONDUIT NIPPLE OR RACEWAY FOR DOOR OPERATOR WIRING. COORDINATE WITH DOOR HARDWARE INSTALLER PRIOR TO ROUGH-IN.
- EXISTING PHONE TO REMAIN. PROTECT FROM POSSIBLE DAMAGE. REWORK CONDUIT AND WIRE AS REQUIRE TO FACILITATE WORK BY OTHERS IN THE AREA.
- NEW EXHAUST FAN TO BE CONNECTED WITH THE LIGHTING IN THE BATHROOM WITH A NEW DUEL RELAY OCCUPANCY SENSOR. UTILIZE THE SECOND RELAY OF THE OCCUPANCY SENSOR FOR THE FAN CONTROL. RELAY 1 SHALL BE FOR THE LIGHTING CONTROL. COORDINATE FAN AND LIGHTING TIMEOUT SETTINGS WITH THE OWNER AND ADJUST TO SUIT. REFER TO WIRING DETAIL-1 (THIS DRAWING).
- PROVIDE NEW LED HEADS FOR EMERGENCY LIGHTING. CONNECT LIGHTING TO EXISTING BATTERY PACK IN THE ELECTRICAL ROOM. EXTEND EXISTING DC WIRES AS REQUIRED. TEST SYSTEM AT COMPLETION AND PROVIDE REPORT WITH RUN TIME AND REMAINING WATTAGE AVAILABLE ON THE BATTERY.
- SUPPLY AND INSTALL ONE NEW CEILING MOUNT FIRE ALARM SMOKE DETECTOR IN RENOVATED IT ROOM. COMPATIBLE WITH EXISTING MRCOM FIRE ALARM SYSTEM. CONTRACTOR TO INCLUDE FOR TESTING AND VERIFICATION OF NEW DEVICE ON ANY LOOP THAT IS MODIFIED AS PART OF THIS PROJECT. PROVIDE A TESTING REPORT AS PART OF THE MANUALS AT PROJECT CLOSEOUT.

PROVIDE TEMPORARY HOARDING.
REFER TO GENERAL NOTES.

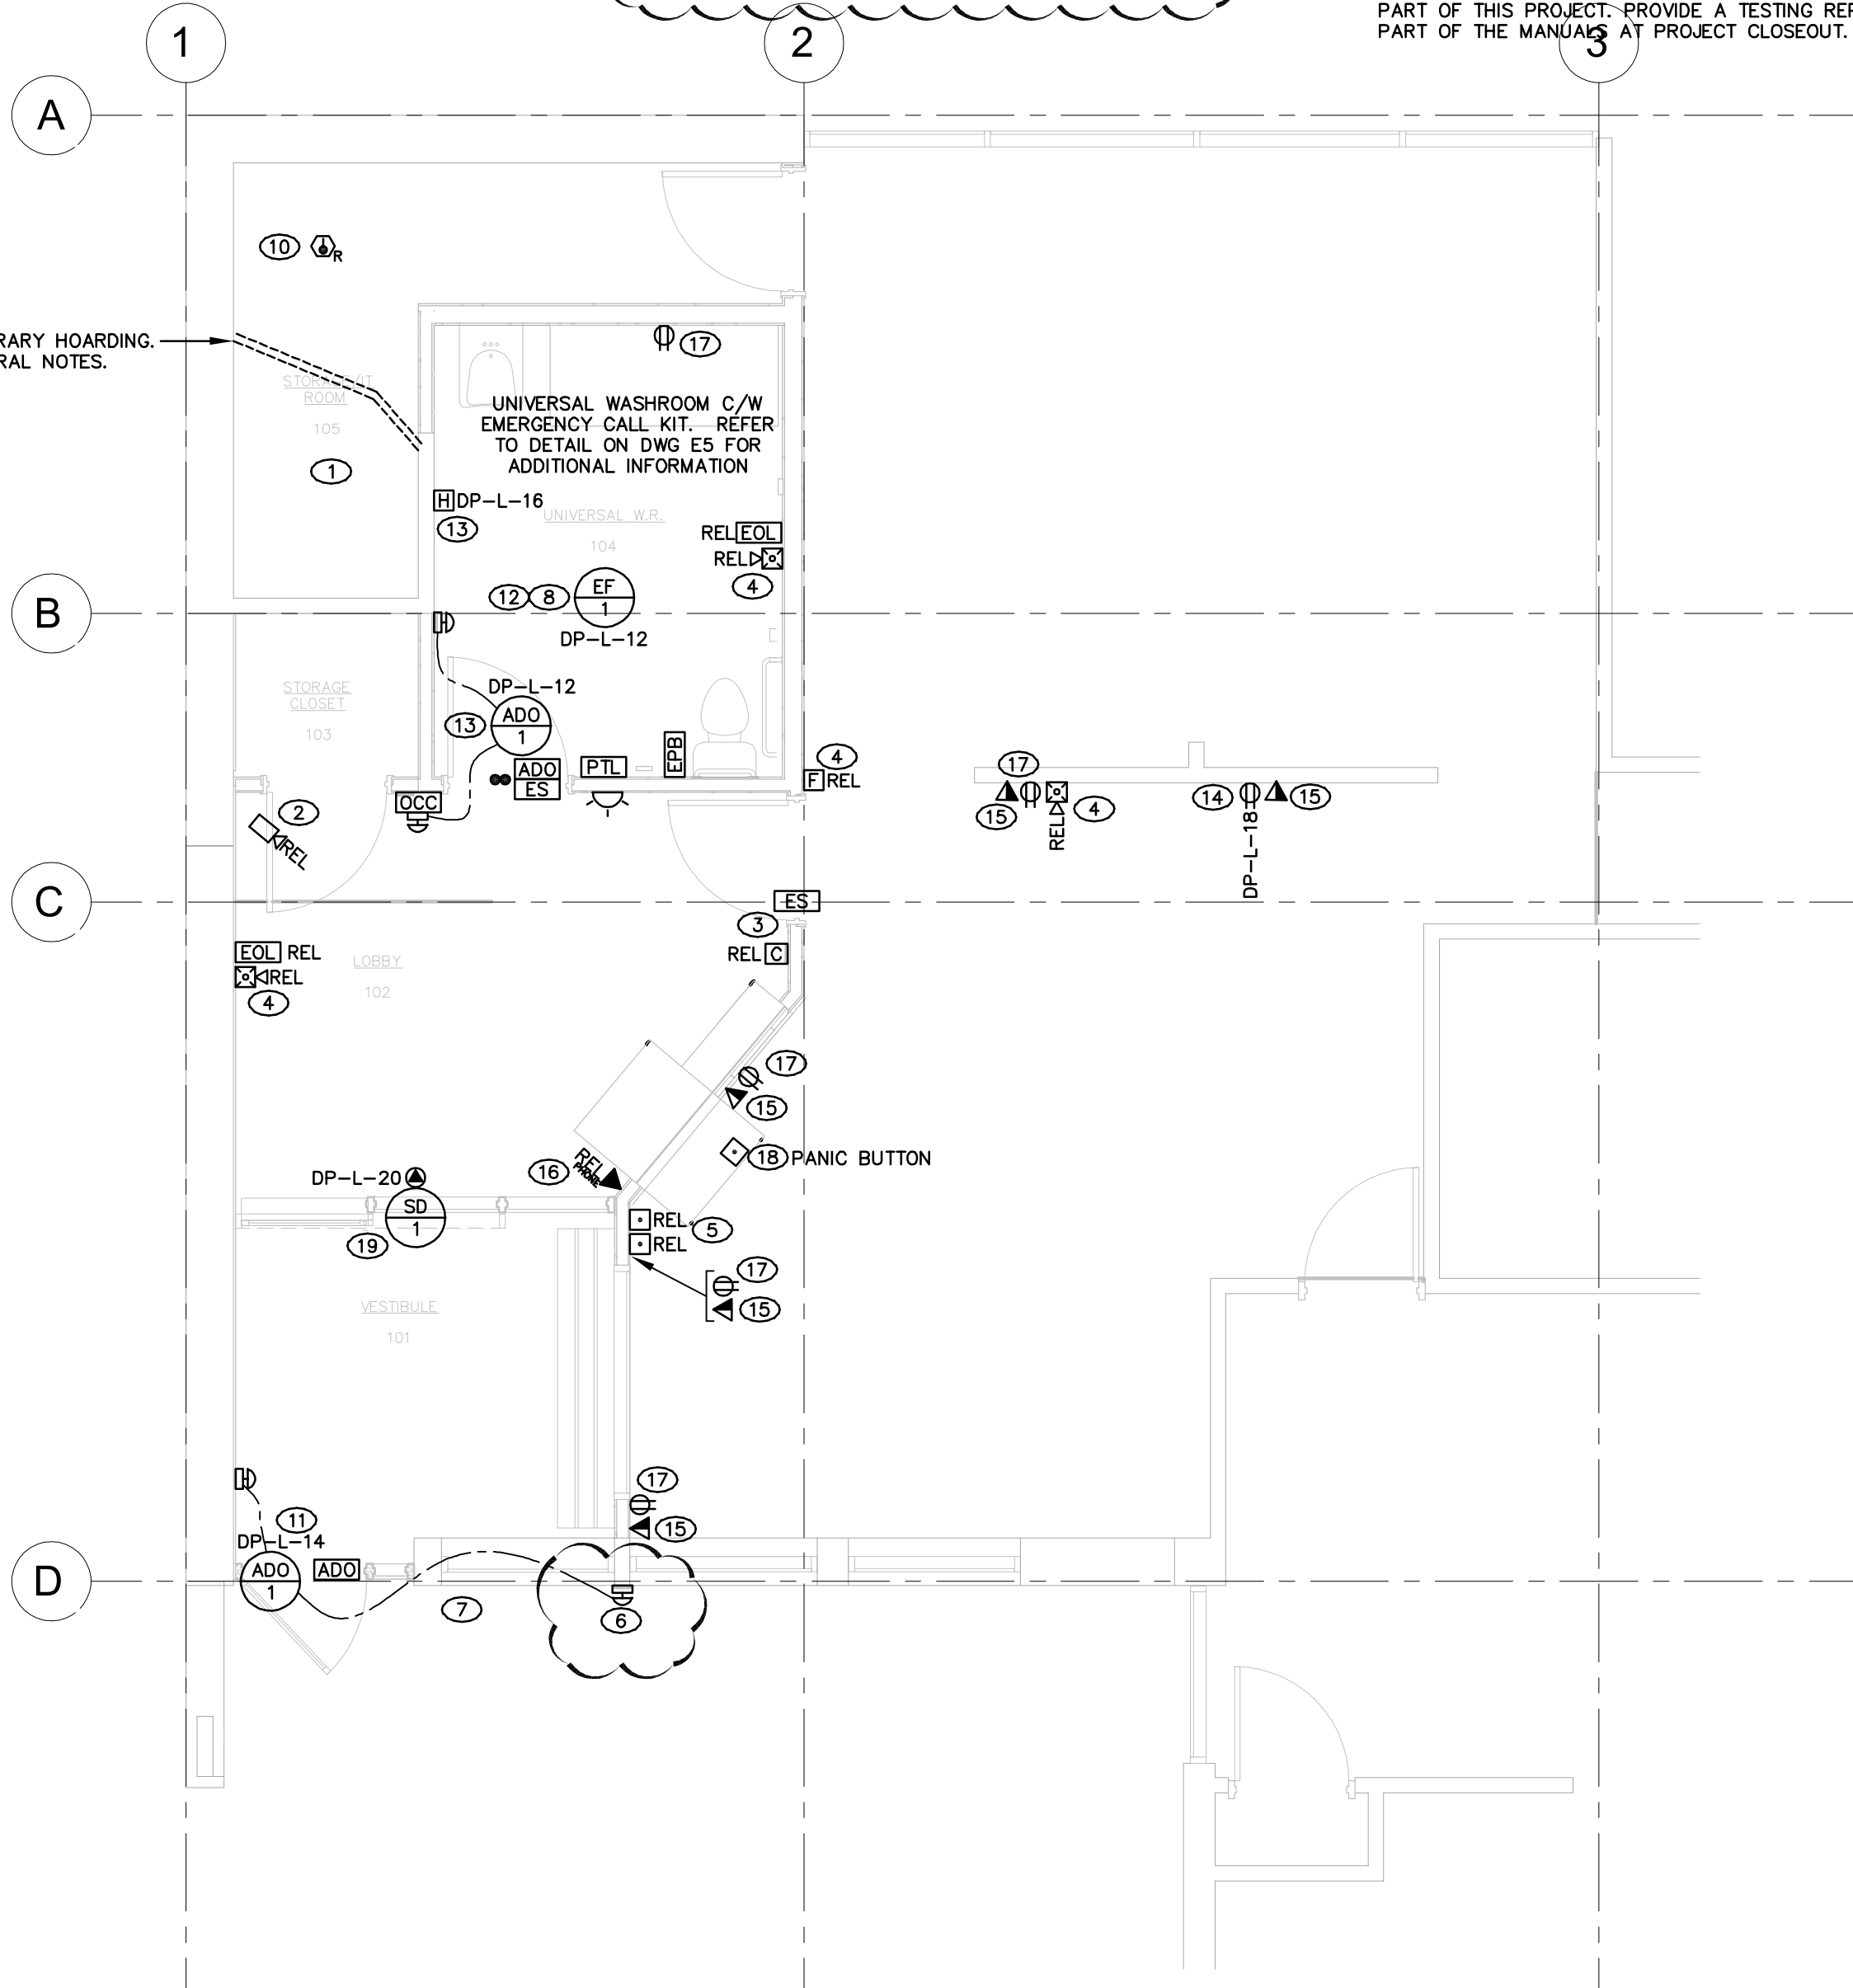

1 PART PLAN - PROPOSED - POWER AND SYSTEMS
SCALE: 1:50

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Notes:

No.	Revision	Date	By
1	ISSUED FOR ELECTRICAL ADDENDUM No.1	2024.09.27	DP
0	ISSUED FOR PERMIT AND TENDER	2024.09.10	DP
A	ISSUED FOR COMMENTS AND REVIEW	2024.08.01	DP

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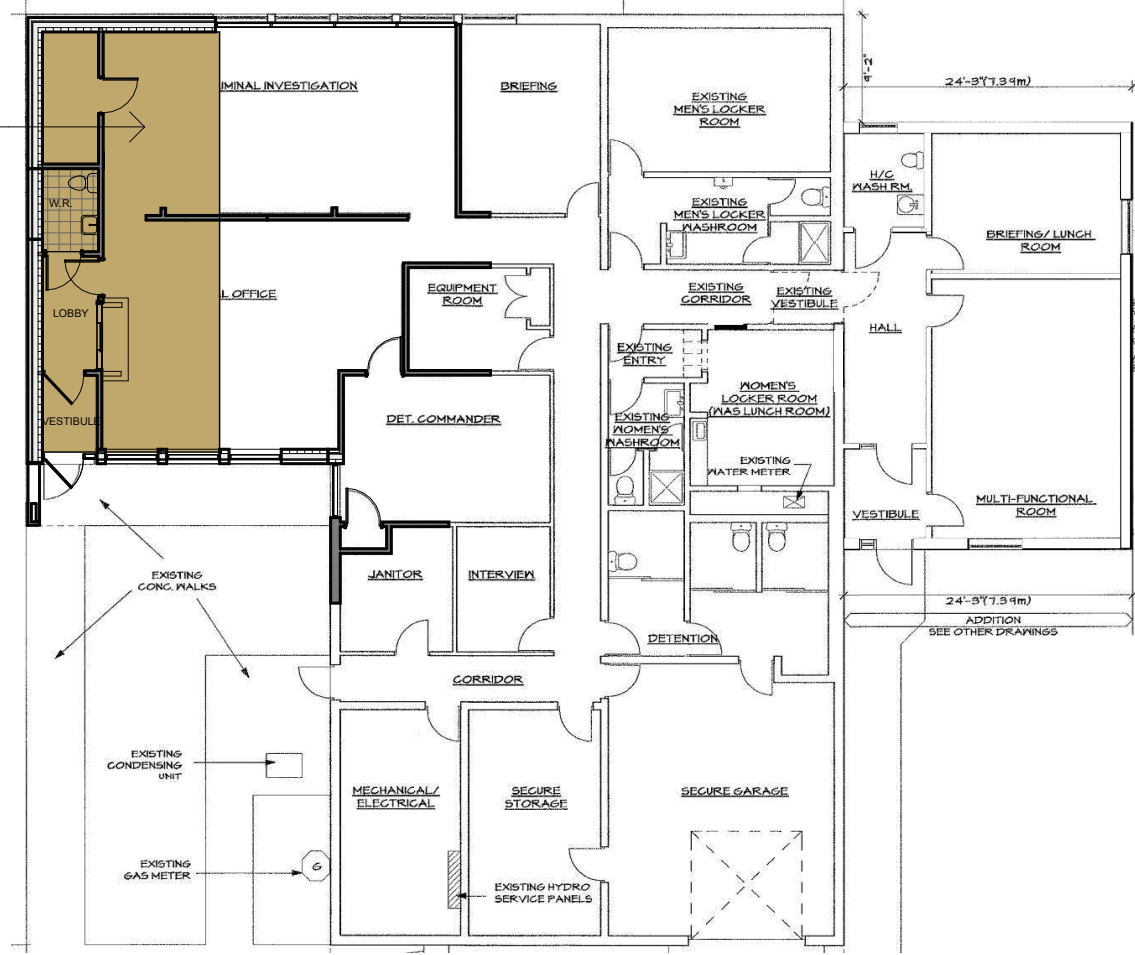
Title
PART PLAN - PROPOSED
POWER, SYSTEMS AND LIGHTING

Drawn By: DN	Designed By: DP	Approved By: DP	Date: JULY, 2024
Project No. 24-103	Scale 1:50	Sheet 5 of 6	Revision 1

ORIGINAL SHEET - ARCH D

File: X:\Projects\2024\24-103 Port Colborne Police Accessibility ARC\E\24-103 E4 NEW.dwg
September 27, 2024 - 11:24am Plotted by: Dominic

AREA OF
WORK
SHOWN
SHADED



KEY PLAN
1 : 200

DEMOLITION NOTES	
Note Number	REMOVE THE FOLLOWING:
1	INTERIOR G.W.B. PARTITION
2	PLUMBING FIXTURES
3	WOOD DOOR & FRAME AND RELATED
4	COUNTER TOP H.M. FRAME AND GLAZING
5	COUNTER AND SUPPORTING G.W.B. WALL CONST.
6	WALL TILE AND G.W.B.
7	SUSP. A.P. CEILING
8	CERAMIC TILE FLOORING
9	CARPET TILE FLOORING
10	CARD READER - HOLD TO SALVAGE
11	ALUM. DOOR AND FRAME AND RELATED
12	FABRIC WALL FINISH
13	WHITEBOARD / TACKBOARD - HOLD TO SALVAGE
14	WALL MOUNTED MONITOR - HOLD TO SALVAGE

GENERAL DEMOLITION NOTES

- ITEMS TO BE REMOVED SHOWN WITH DOTTED LINES.
- REFER ALSO TO DEMOLITION NOTES.
- DEMOLITION CONTRACTOR TO REVIEW THIS DRAWING IN CONJUNCTION WITH ALL OTHER CONTRACT DOCUMENTS TO DETERMINE EXTENT OF DEMOLITION.
- REPORT DISCOVERY OF HAZARDOUS SUBSTANCES TO OWNER IMMEDIATELY UPON DISCOVERY.
- OWNER IS TO PROPERLY REMOVE AND DISPOSE ALL DESIGNATED SUBSTANCES.
- SITE VERIFY EXIST'G CONSTRUCTION.
- OWNER TO REMOVE ALL LOOSE FURNITURE, EQUIPMENT, WALL MOUNTED DISPLAYS / INSTRUCTION / NOTICES AND THE LIKE TO BE SALVAGED.
- VERIFY PARTITIONS INDICATED TO BE REMOVED ARE NOT LOAD BEARING.
- THE CONTRACTOR IS RESPONSIBLE FOR BOARDING THE RENOVATION AREA TO PROTECT THE REMAINDER OF THE BUILDING FROM CONSTRUCTION DUST AND DEBRIS FOR THE DURATION OF THE PROJECT.

GENERAL NOTES


- INSTALL NEW PARTITIONS TO U/S OF EXISTING STRUCTURE ABOVE SUSPENDED G.W.B. OR A.P. CEILING AS APPLICABLE.
- MAKE GOOD EXISTING SURFACES AT ITEMS REMOVED, MODIFIED OR DISTURBED.
- NEW DIMENSIONS ARE TO NEW STUD FRAMING AND EXISTING SURFACE.
- REMOVE EXISTING CARD READER AT EXT WALL. BEING REMOVED AND HOLD TO SALVAGE
- REMOVE EXISTING WINDOW INTERCOM AT EXT WALL. HOLD TO BE SALVAGE
- FIRE SAFETY EQUIPMENT ON CEILING AND WALL TO REMOVE AND RETURN TO OWNER
- SECURITY EQUIPMENT ON CEILING AND WALL TO BE REMOVED AND RETURN TO OWNER
- LOCK SETS AND DOOR HANDLES EXCLUDING HINGES TO BE BY OTHERS
- REFER TO MANUFACTURE STANDARD METAL HARDWARE FOR MODEL NUMBER K10A FOR KICK PLATE TYPE.
- REFER TO MANUFACTURE ASSA ABLOY MODEL NUMBER HES 1006CLB FOR ELECTRICAL STRIKE TYPE.
- REFER TO MANUFACTURE IVES MODEL NUMBER 5BB1 FOR DOOR HINGE TYPE.
- REFER TO MANUFACTURE STANDARD METAL HARDWARE FOR MODEL NUMBER 3015-2 FOR DOOR PULL TYPE.
- REFER TO MANUFACTURE STANDARD METAL HARDWARE FOR MODEL NUMBER 8034-2 FOR DOOR PUSH BAR TYPE.
- REFER TO MANUFACTURE LCN FOR MODEL NUMBER 4040XP FOR DOOR CLOSER TYPE.
- PDO BUTTON TO BE LOCATED MIN 2' FROM ACTIVATED DOOR

GENERAL NOTES TO DOOR AND FRAME SCHEDULE

- READ THESE NOTES IN CONJUNCTION WITH THE DRAWINGS AND THE DOOR AND FRAME SCHEDULE.
- DOOR OPENINGS NUMBERED ON PLANS ARE THOSE WHERE PHYSICAL WORK (OTHER THAN PAINTING) IS BEING DONE. THIS PHYSICAL WORK MAY CONSIST OF REPAIR, REPLACEMENT, ALTERATIONS, REMOVAL, OR FITTING OF NEW HARDWARE TO EITHER THE DOOR, OR TO THE FRAME.
- ALL GLASS IN DOORS AND SIDELIGHTS AND SCREENS IS TRANSPARENT, TEMPERED AND UNWIRED UNLESS OTHERWISE INDICATED.
- ALL DOORS 1 1/2" UNLESS OTHERWISE INDICATED.
- ALL DOORS TO BE SOLID CORE UNLESS OTHERWISE NOTED.
- 101XA DOOR NUMBERS IN RECTANGLES ARE EXTERIOR DOORS.
- INSTALL NEW DOORS AND FRAMES AT EXISTING OR MODIFIED OPENINGS TO SUIT OPENING

GENERAL NOTES TO ROOM FINISH SCHEDULE


- READ THESE NOTES IN CONJUNCTION WITH THE DRAWINGS AND THE ROOM FINISH SCHEDULE.
- THE FOLLOWING NOTES EXCLUDE MECHANICAL AND ELECTRICAL: SEE MECHANICAL AND ELECTRICAL DRAWINGS FOR INFORMATION ON THOSE TRADES.
- A NUMBER IS ASSIGNED TO ALL ROOMS IN WHICH ARCHITECTURAL WORK IS TO TAKE PLACE.
- NUMBERED ROOMS ON PLANS ARE THOSE WHERE ALTERATIONS, NEW WORK, MAKING GOOD, OR ALL THREE ARE PORPOSED. SEE ROOM SCHEDULE FOR DETAILS.
- NUMBERED ROOMS APPEARING ON THE ROOM FINISH SCHEDULE WILL RECEIVE SIGNIFICANT WORK.
- NUMBERED ROOMS NOT APPEARING ON THE ROOM SCHEDULE SHALL GENERALLY RECEIVE MINOR PATCHING OF EXISTING SURFACES, MAKING GOOD AT OPENINGS FILLED, OR CREATED.
- ALL PAINTABLE SURFACES, INCLUDING - BUT NOT LIMITED TO: EXPOSED DUCTS, CONDUIT, GRILLS, LOUVRES AND THE LIKE, IN ALL ROOMS INDICATED IN THIS SCHEDULE TO RECEIVE A FINISH. PAINT, PLASTIC COATING, WALL VINYL, OR WALLPAPER, WHERE SPECIFICALLY INDICATED UNLESS OTHERWISE NOTED.
- APPLY SCHEDULED FINISHES TO ALL APPLICABLE SURFACES IN THE ROOM IN WHICH THEY ARE INDICATED. WALL SURFACES NOT SHOWN IN ELEVATION ARE TO RECEIVE SCHEDULED FINISHES.
- WHERE ROOM FINISH SCHEDULE CALLS FOR BOTH EXISTING AND NEW MATERIALS, DRAWINGS INDICATE THE EXTENT OF THE NEW MATERIALS. INDICATION OF A ROOM FINISH ON THIS SCHEDULE AS "EXISTING" DOES NOT PRECLUDE FILLING, PATCHING, OR "MAKING GOOD" OF THIS SURFACE. EVERY ATTEMPT HAS BEEN MADE TO INDICATE LARGE PATCHED AND FILLED AREAS ON DRAWINGS.
- ALL WALL BASE 4" HIGH, UNLESS OTHERWISE INDICATED.
- ALL NEW PARTITIONS IN FALSE-CEILINGED SPACES TO BE CARRIED UP TO THE UNDERSIDE OF FIRM STRUCTURE ABOVE. EXTEND G.W.B. TO 8" ABOVE CEILINGS. DRYWALL ABOVE CEILING LINE TO HAVE JOINTS TAPED. NO FILLING, SANDING, OR PAINTING REQUIRED.
- STUD BRACE STRUCTURE OF NON-RATED WALLS AND PARTITIONS UP TO THE STRUCTURE OVER, EXCEPT WHERE SPECIFICALLY INDICATED, AT RATED OR SOUND-SENSITIVE AREAS. CARRY GWB USE SHADOW MOLD TRIM DETAIL AT ALL NEW CEILING-WALL AND CEILING-BULKHEAD INTERSECTIONS UNLESS OTHERWISE NOTED.
- ALL STUD PARTITIONS: CARRY UP TO UNDERSIDE OF FIRM STRUCTURE OVER, FACE TWO SIDES WITH G.W.B., INSTALL SOUND INSULATION IN STUD SPACE.
- ALL GLASS CLEAR, LAMINATED AND TEMPERED UNLESS OTHERWISE NOTED.

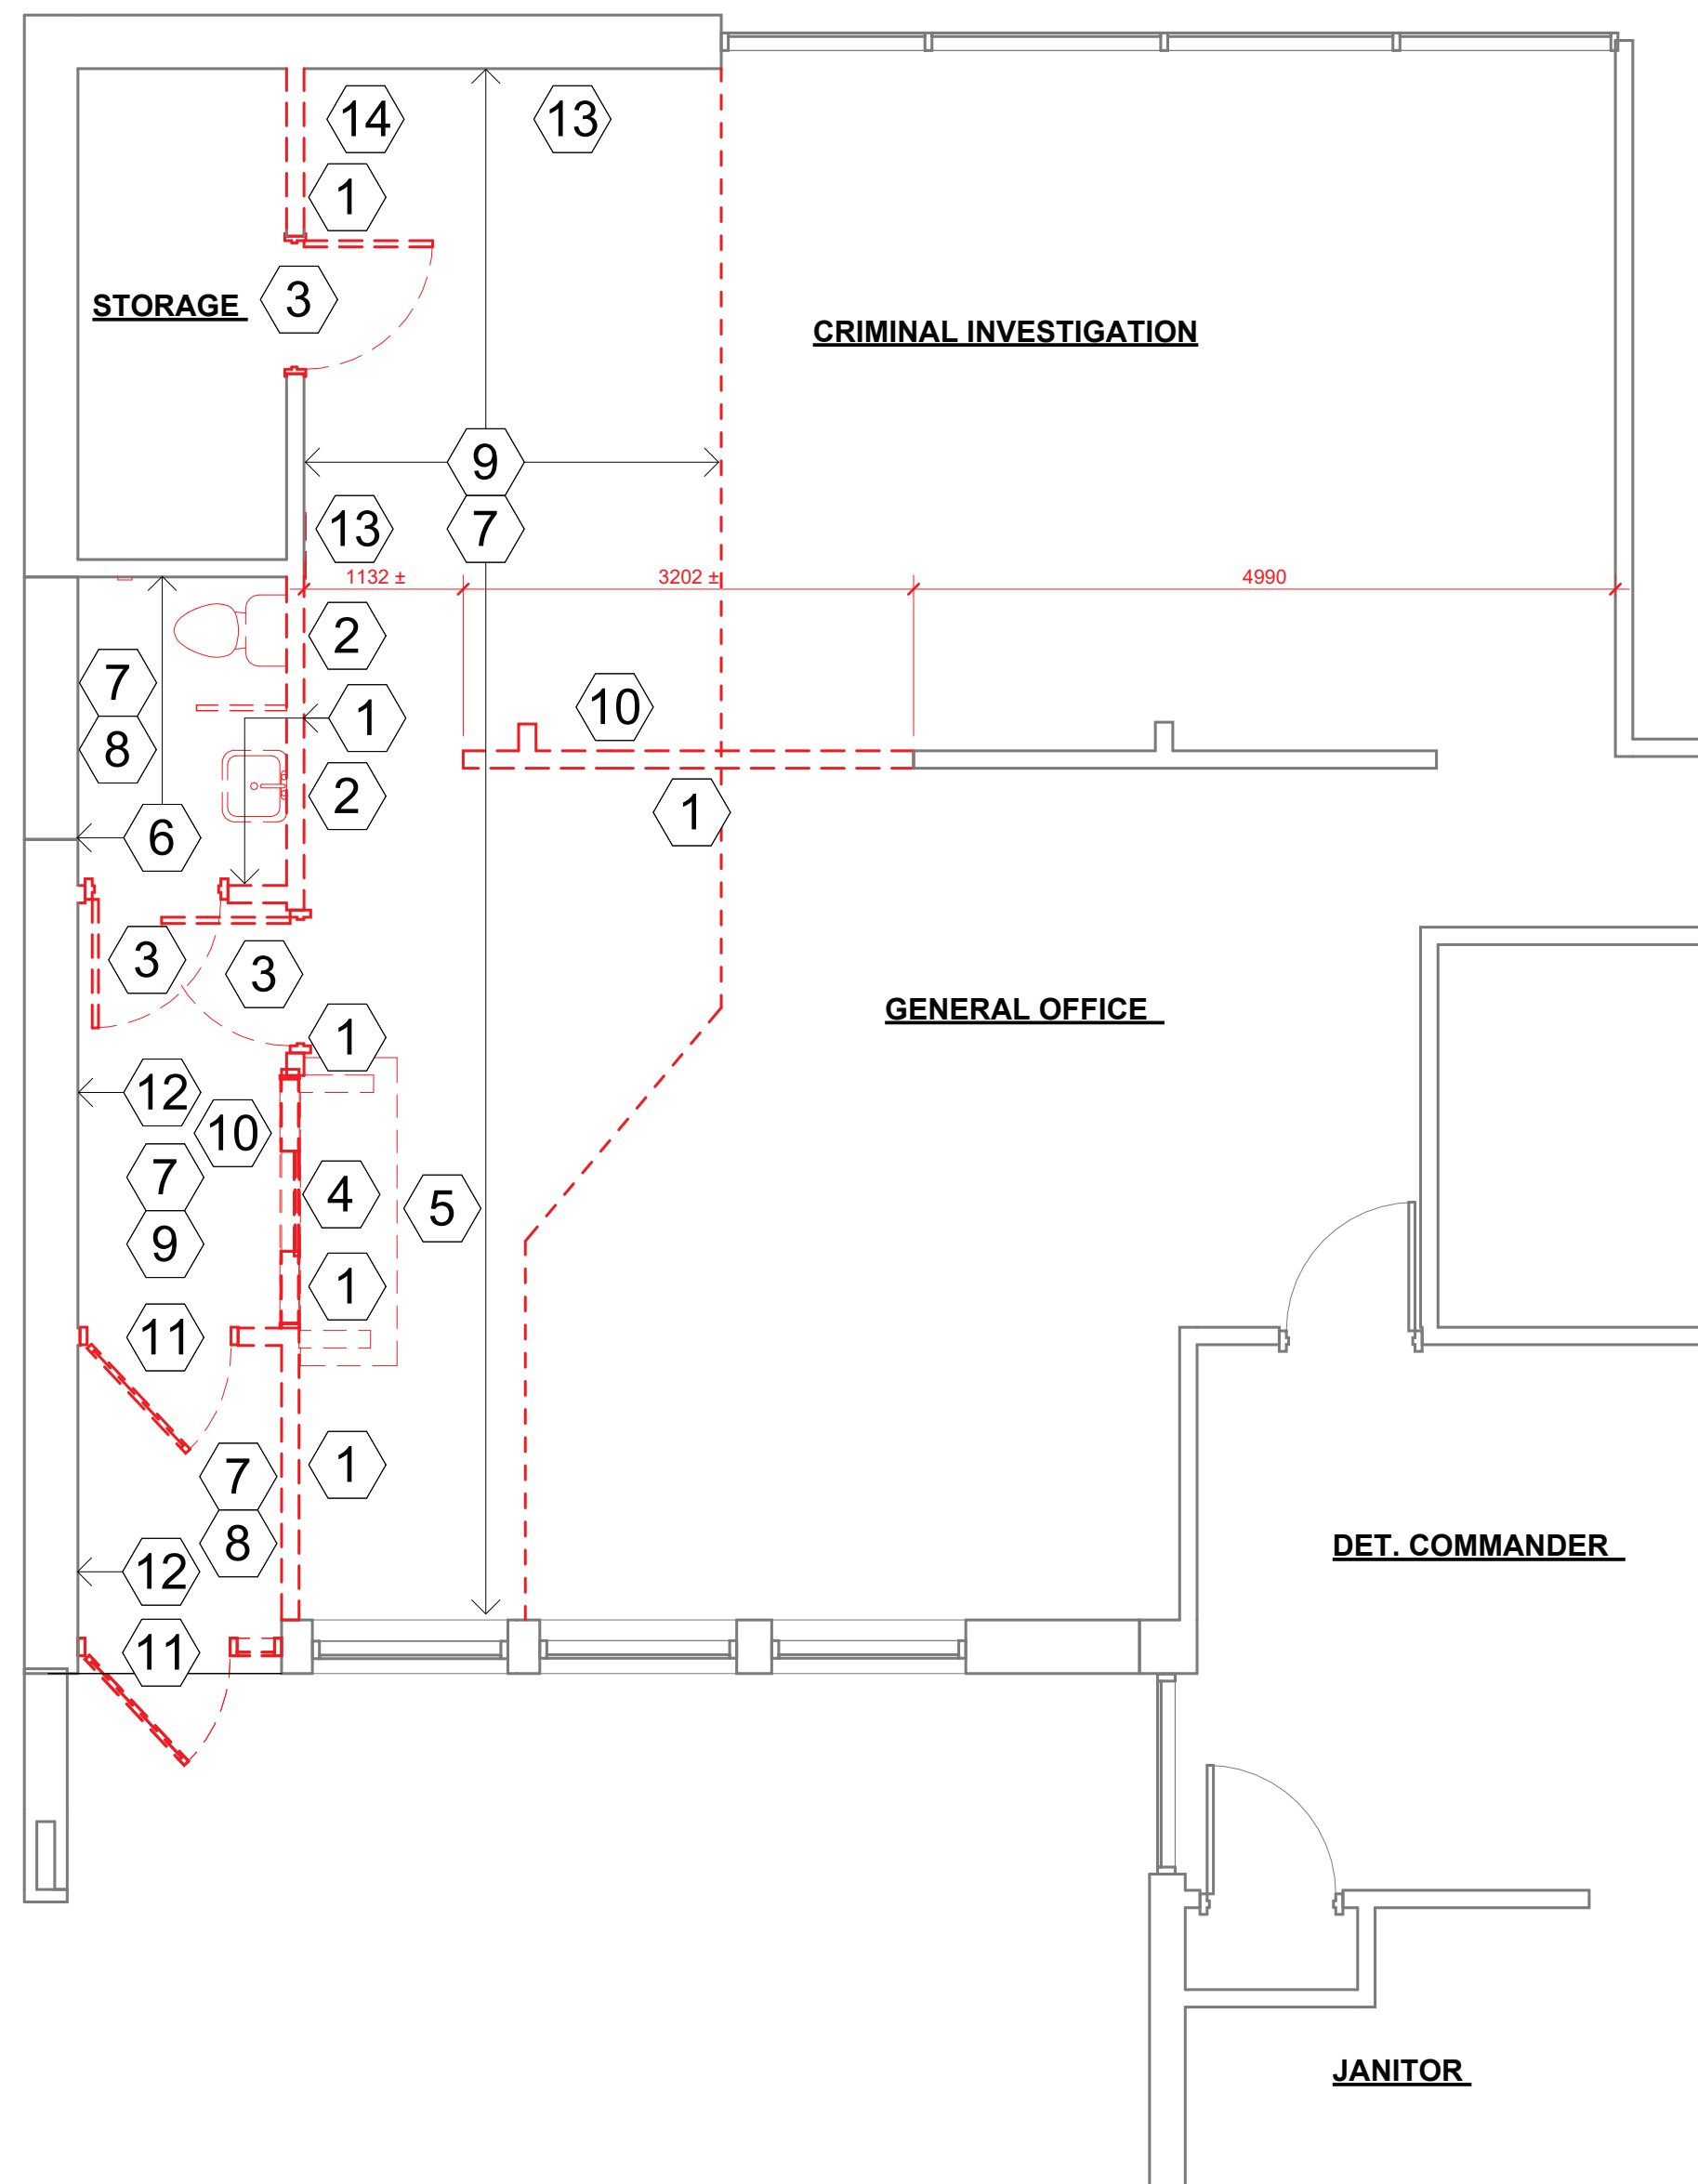

ENLARGE DEMO FLOOR PLAN
1 : 50



WALL LEGEND	
	NEW
	EXISTING
	DEMOLISH

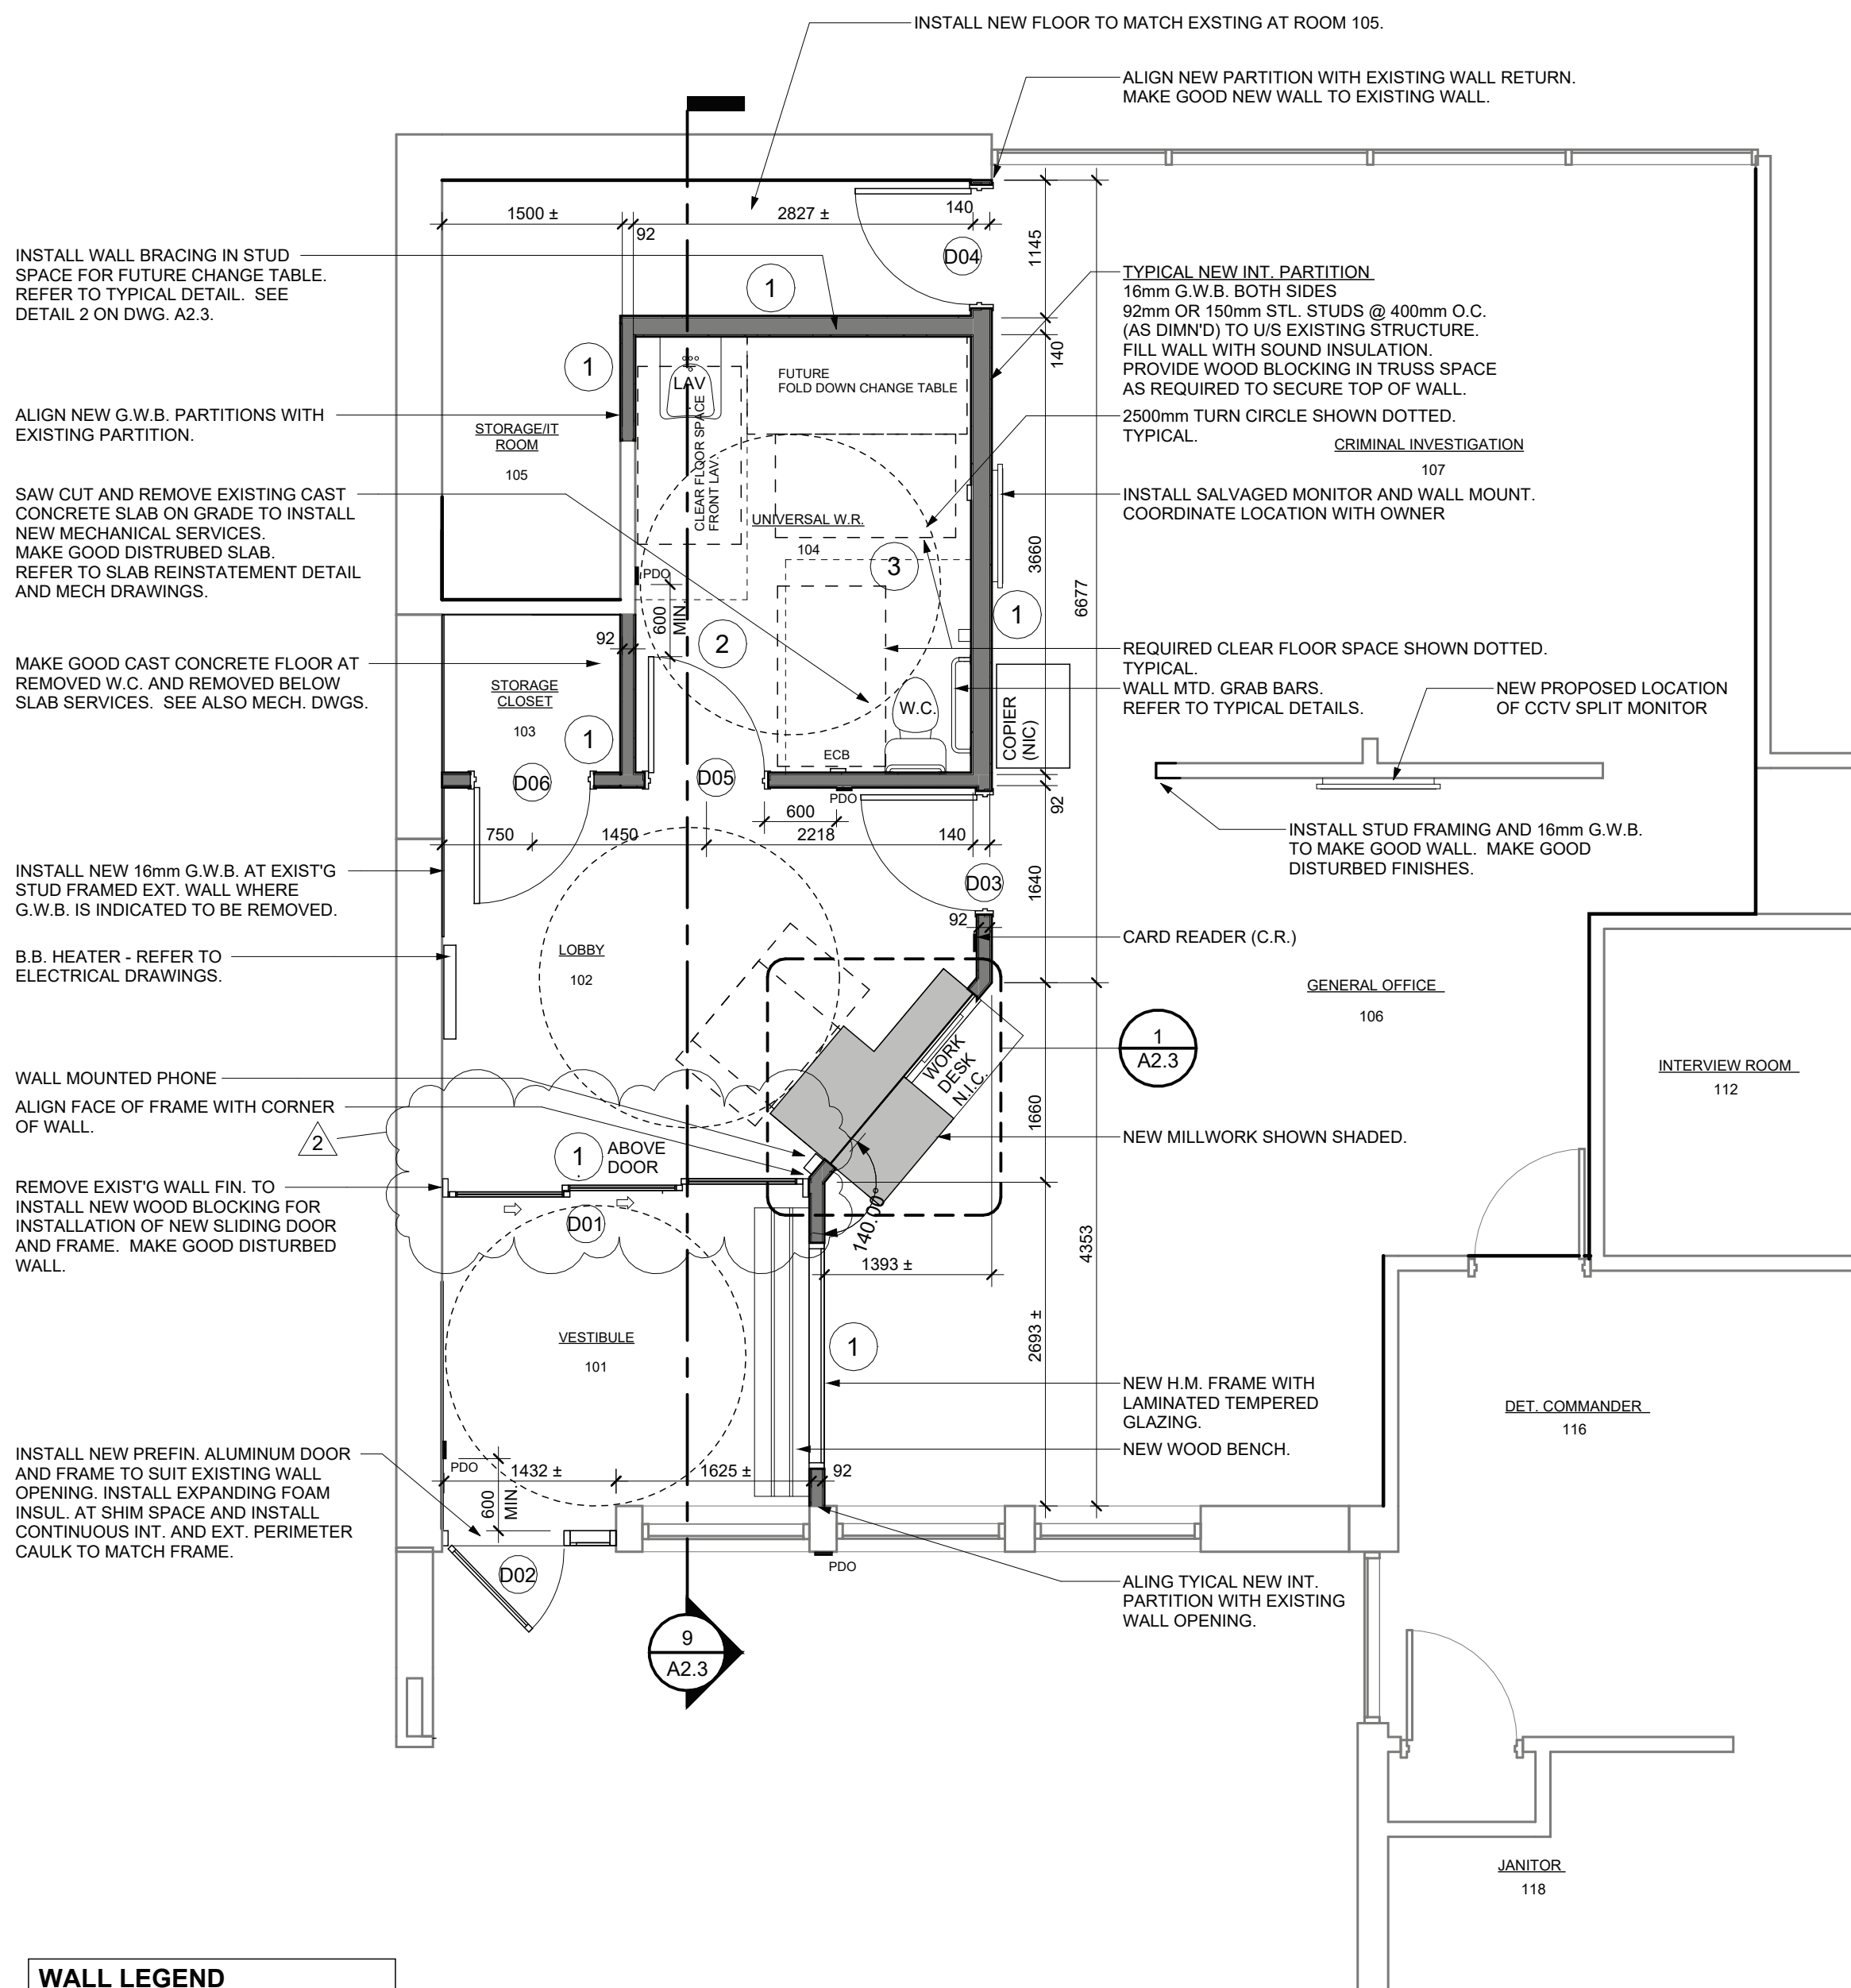

ENLARGE FLOOR PLAN
1 : 50



Entrance-WR's and Customer Service
Accessibility Upgrades
The Regional Municipality of Niagara - NRPS D6
501 Fielden Ave, Port Colborne, ON L3K 4T9
DEMO & PROPOSED PLANS

File No:	24-12
Scale:	As indicated
Drawn By:	MZE
Plot Date:	10/18/2024 10:04:13 AM
Issue Date:	09/07/2024
Revisions:	No.
ADDENDUM No. 1	2
TENDER/PERMIT SET	1

10/18/2024

09/25/2024

Date:




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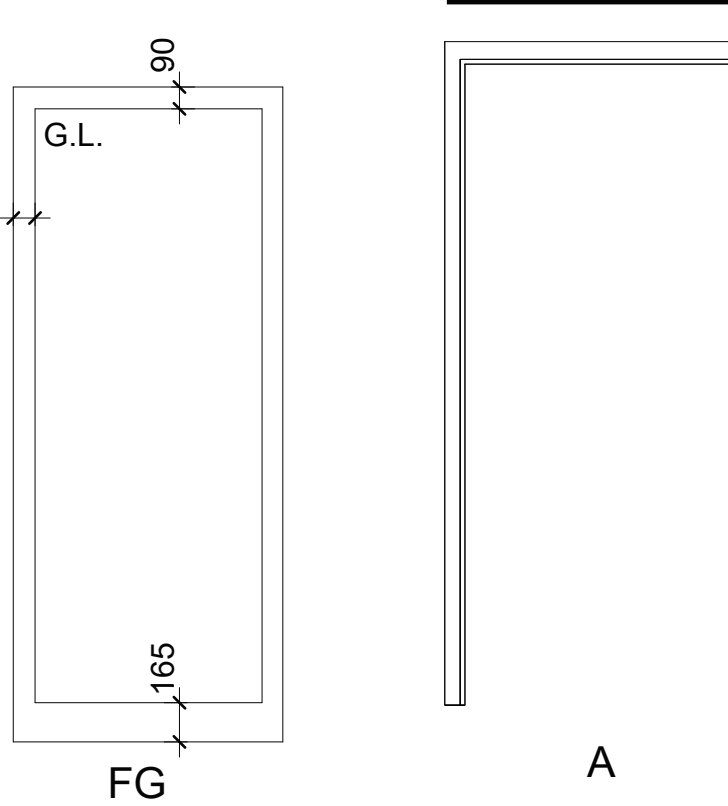
A2.1

DOOR AND FRAME SCHEDULE														
Number	Size	Height	Door Details				Frame Details		Hinge	Kick Plate	Electrical Strike	Door Pull/Push	Door closer	Power Door Operator
			Material	Type	Thickness	Fire Label	Frame Type	Frame Material						
D01	3041 mm X 2134 mm	2134 mm	NEW ALUM.	2G1	N/A		SEE ELEV.	NEW ALUM.	N/A	N/A	N/A	N/A	N/A	N/A
D02	965 mm X 2261 mm	2261 mm	NEW ALUM.	FG	44 mm		SEE ELEV.	NEW ALUM.	YES	N/A	YES	YES	YES	Yes
D03	965 mm X 2134 mm	2134 mm	NEW H.M.	M	44 mm		A	NEW H.M.	YES	YES	YES	NO	YES	Yes
D04	965 mm X 2134 mm	2134 mm	NEW H.M.	M	44 mm		A	NEW H.M.	YES	YES	N/A	NO	YES	No
D05	965 mm X 2134 mm	2134 mm	NEW H.M.	M	44 mm		A	NEW H.M.	YES	YES	YES	NO	YES	Yes
D06	965 mm X 2134 mm	2134 mm	NEW H.M.	M	44 mm		A	NEW H.M.	YES	YES	N/A	NO	YES	No


DOOR TYPE



FRAME TYPE

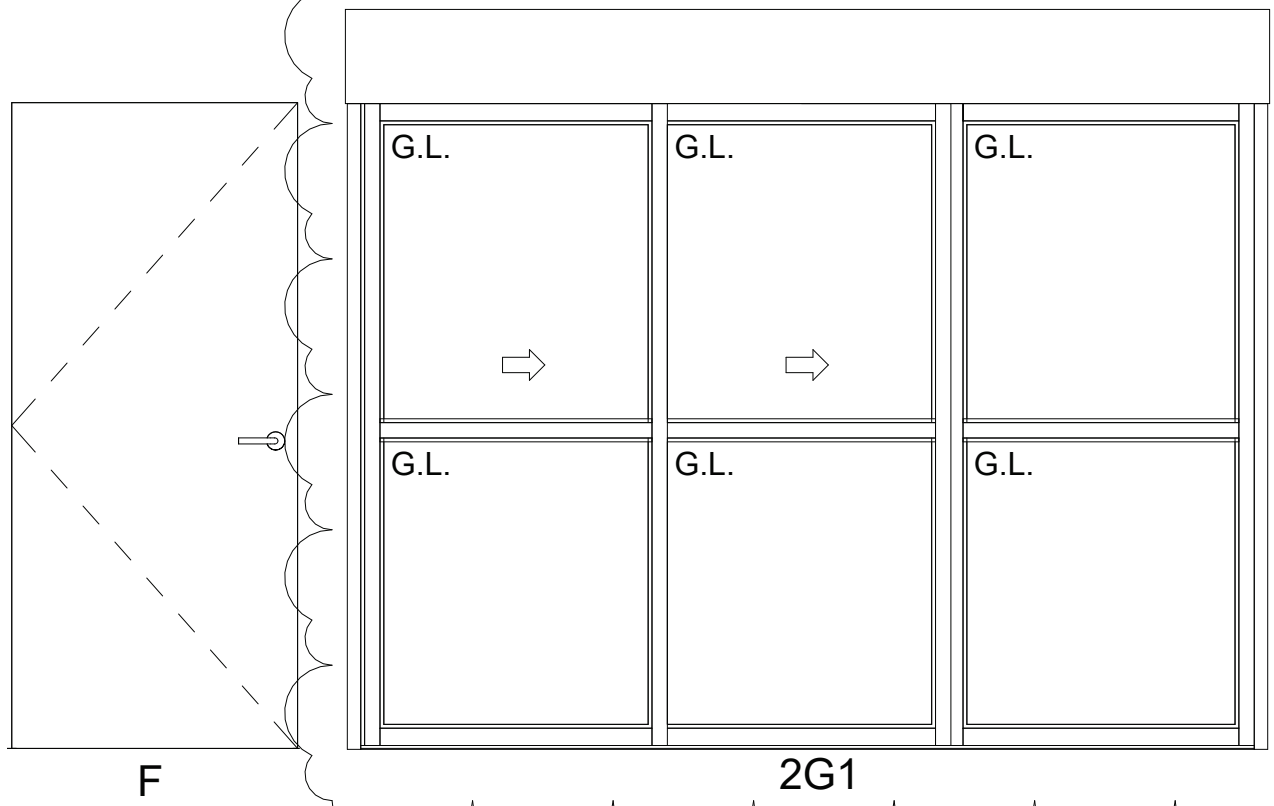

CEILING LEGEND

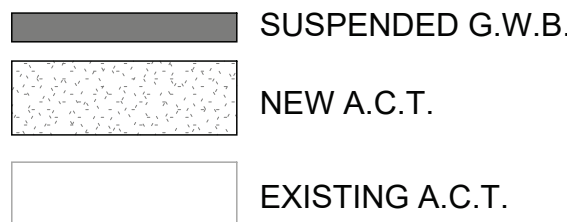

MAKE GOOD NEW G.W.B. TO EXIST'G G.W.B. CEILING.
REFER TO ELEC'TL DWGS. FOR LIGHT FIXTURES. TYPICAL.


MAKE GOOD EXISTING SUSP. A.P. CEILING TO NEW PARTITIONS - TYP.

INSTALL SALVAGED CAMERA. REFER TO ELECTRICAL DRAWINGS.


ALIGN FACE OF BULKHEAD WITH WALL.

16mm G.W.B. BULK HEAD ON 64mm STEEL STUD FRAMING @ 600mm O.C..

1 REFLECTED CEILING PLAN
1 : 50

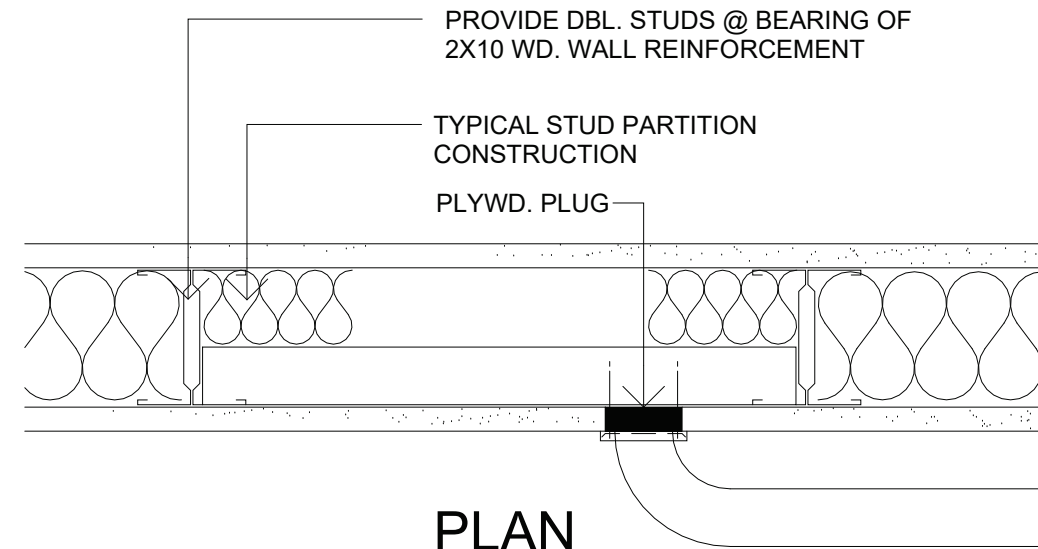

PLAN

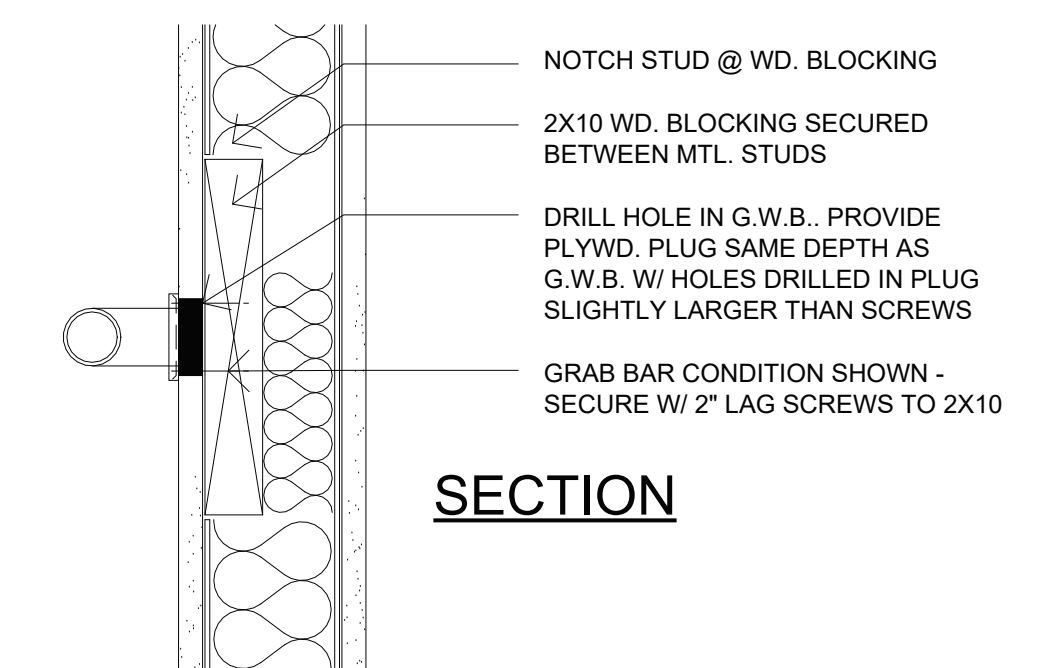


SECTION

STUD WALL REINFORCEMENT - TYPE 2


- FOR THE FOLLOWING ITEMS MOUNTED ON STUD WALLS:
- GRAB BARS
 - ADULT SIZE FOLD-UP CHANGE TABLES
 - WALL MOUNT CONTINUOUS COAT RACKS
 - ANY HIGH-WEIGHT, POINT LOAD WALL HUNG ITEM

12 TYPICAL GRAB BAR REINFORCEMENT DETAIL
1 : 5


NEW ALUMINUM AUTOMATIC SLIDING DOOR TO MATCH COLOUR OF EXIST'G ALUMINUM FRAMES. SEE ALSO ELEC'L DRAWING

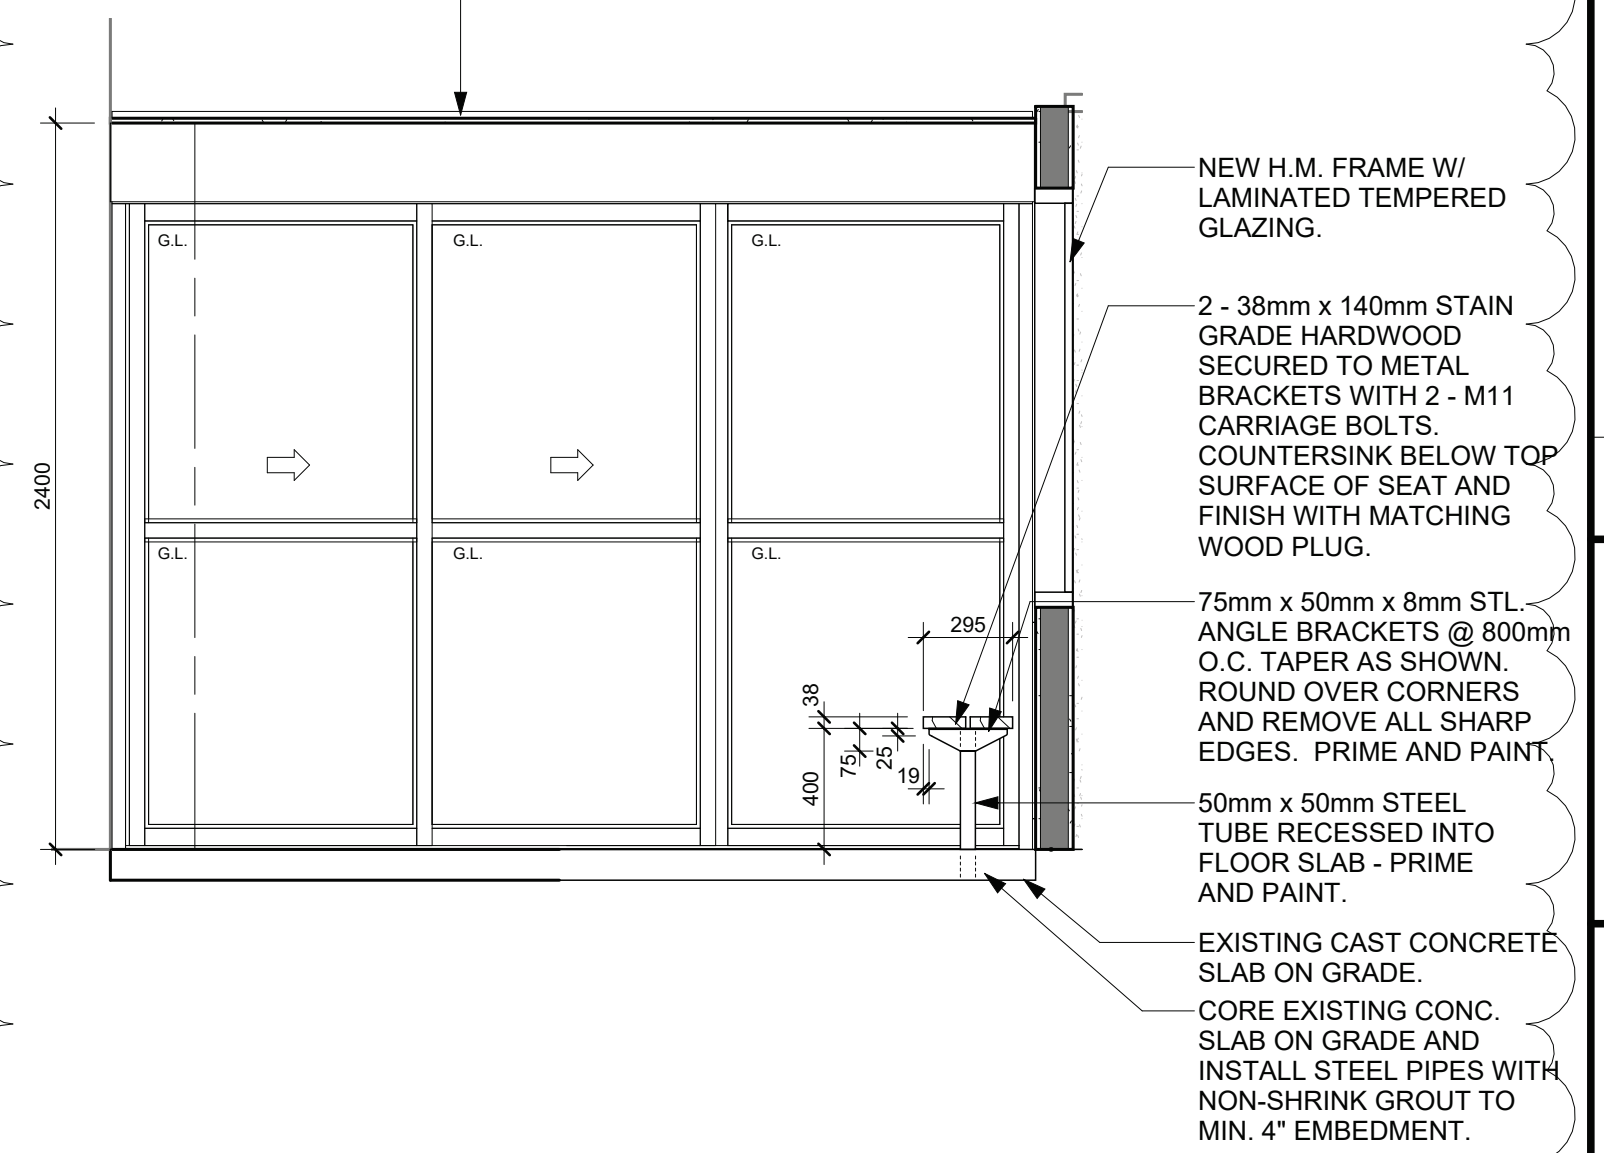


8 NORTH WALL VESTIBULE 101
1 : 25

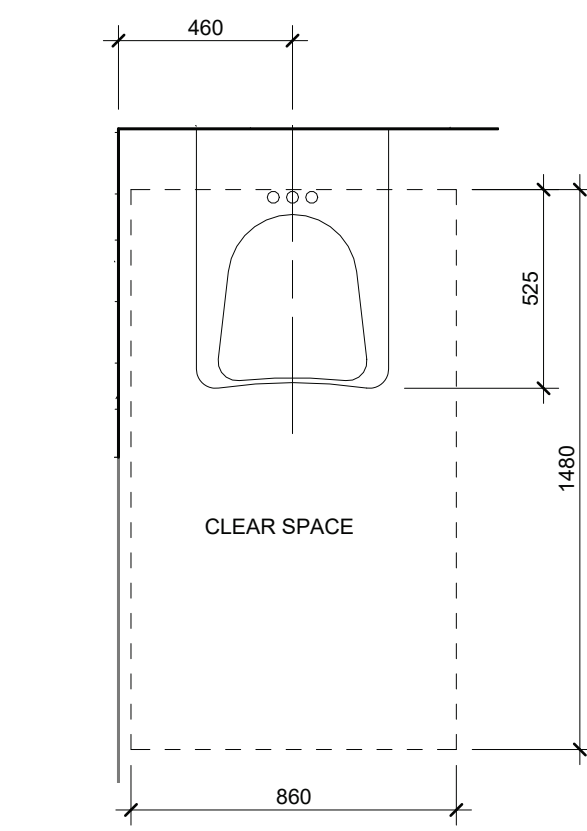


PLAN

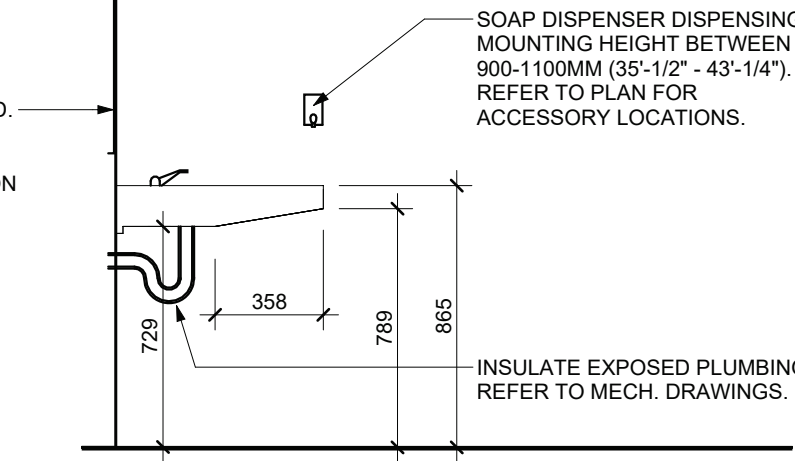


6 ACCESS LAV. MOUNTING HEIGHTS AND CLEARANCE
1 : 25

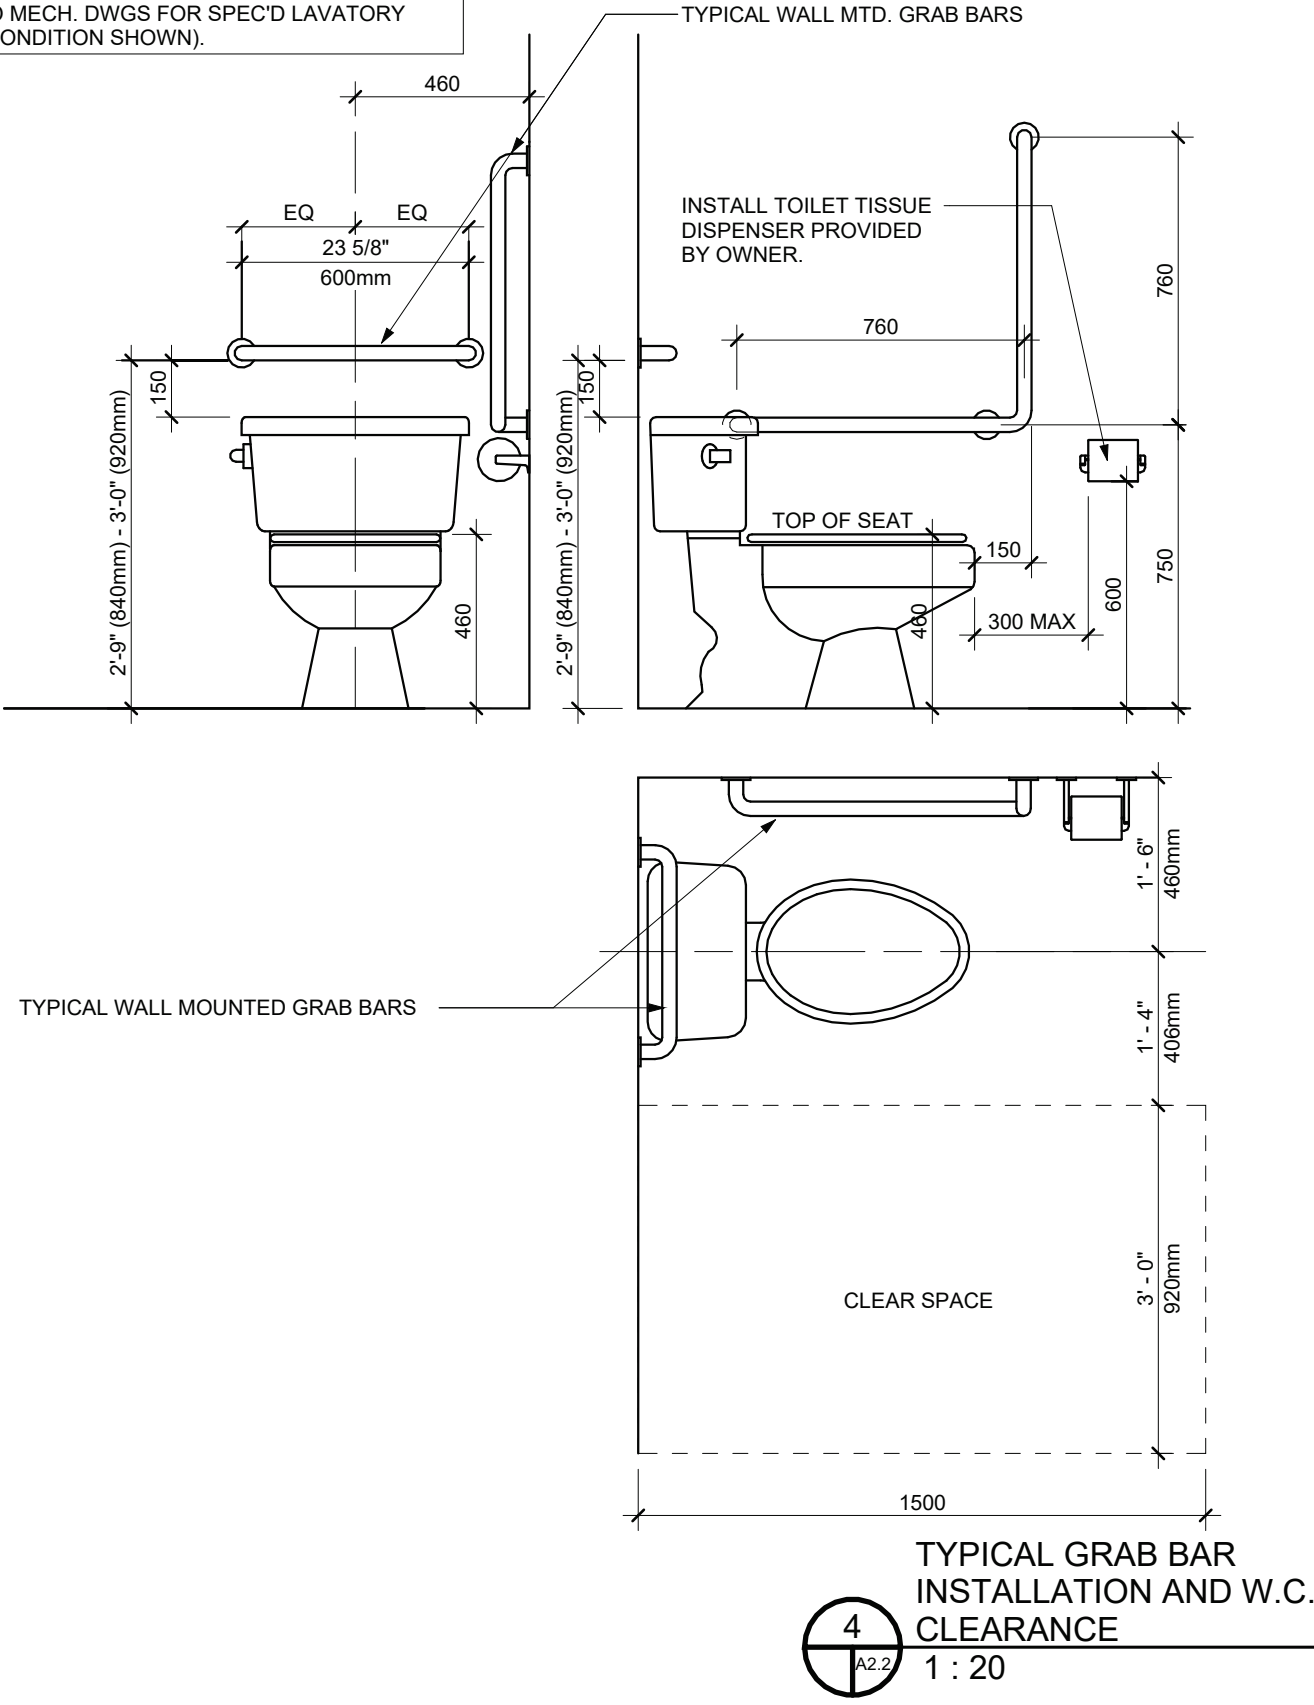


4 TYPICAL GRAB BAR INSTALLATION AND W.C. CLEARANCE
1 : 20

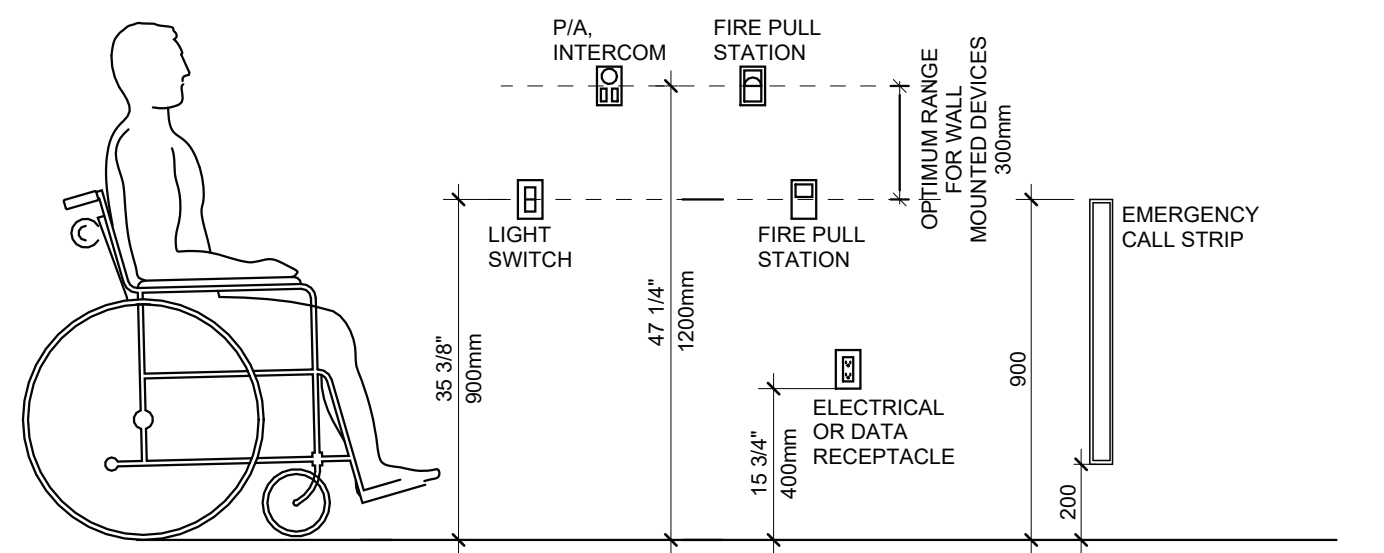

3 WALL MOUNTED DEVICE ACCESSIBLE HEIGHTS
1 : 20

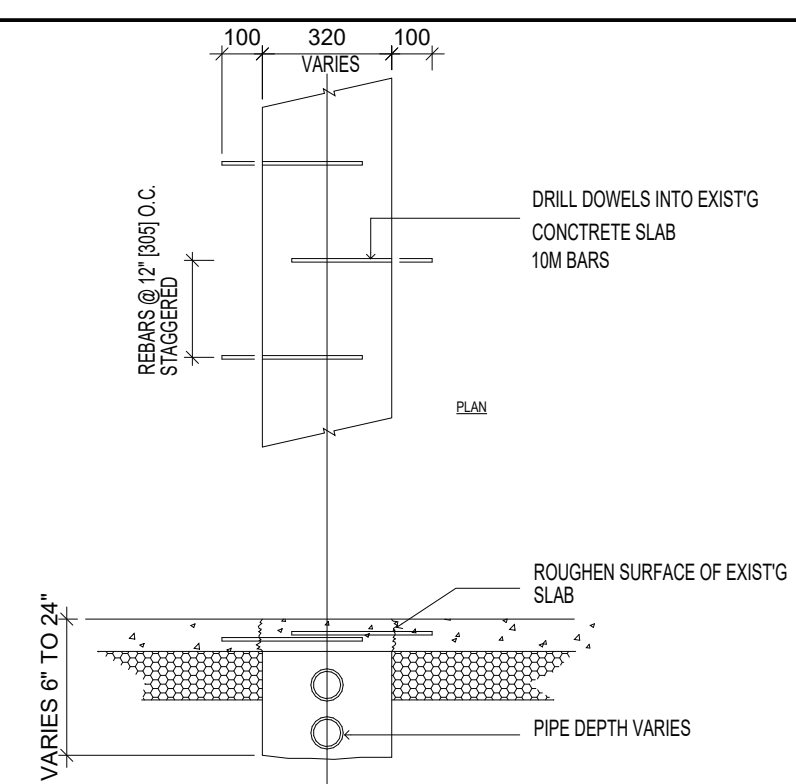

REINSTATEMENT DETAIL
Scale = NTS

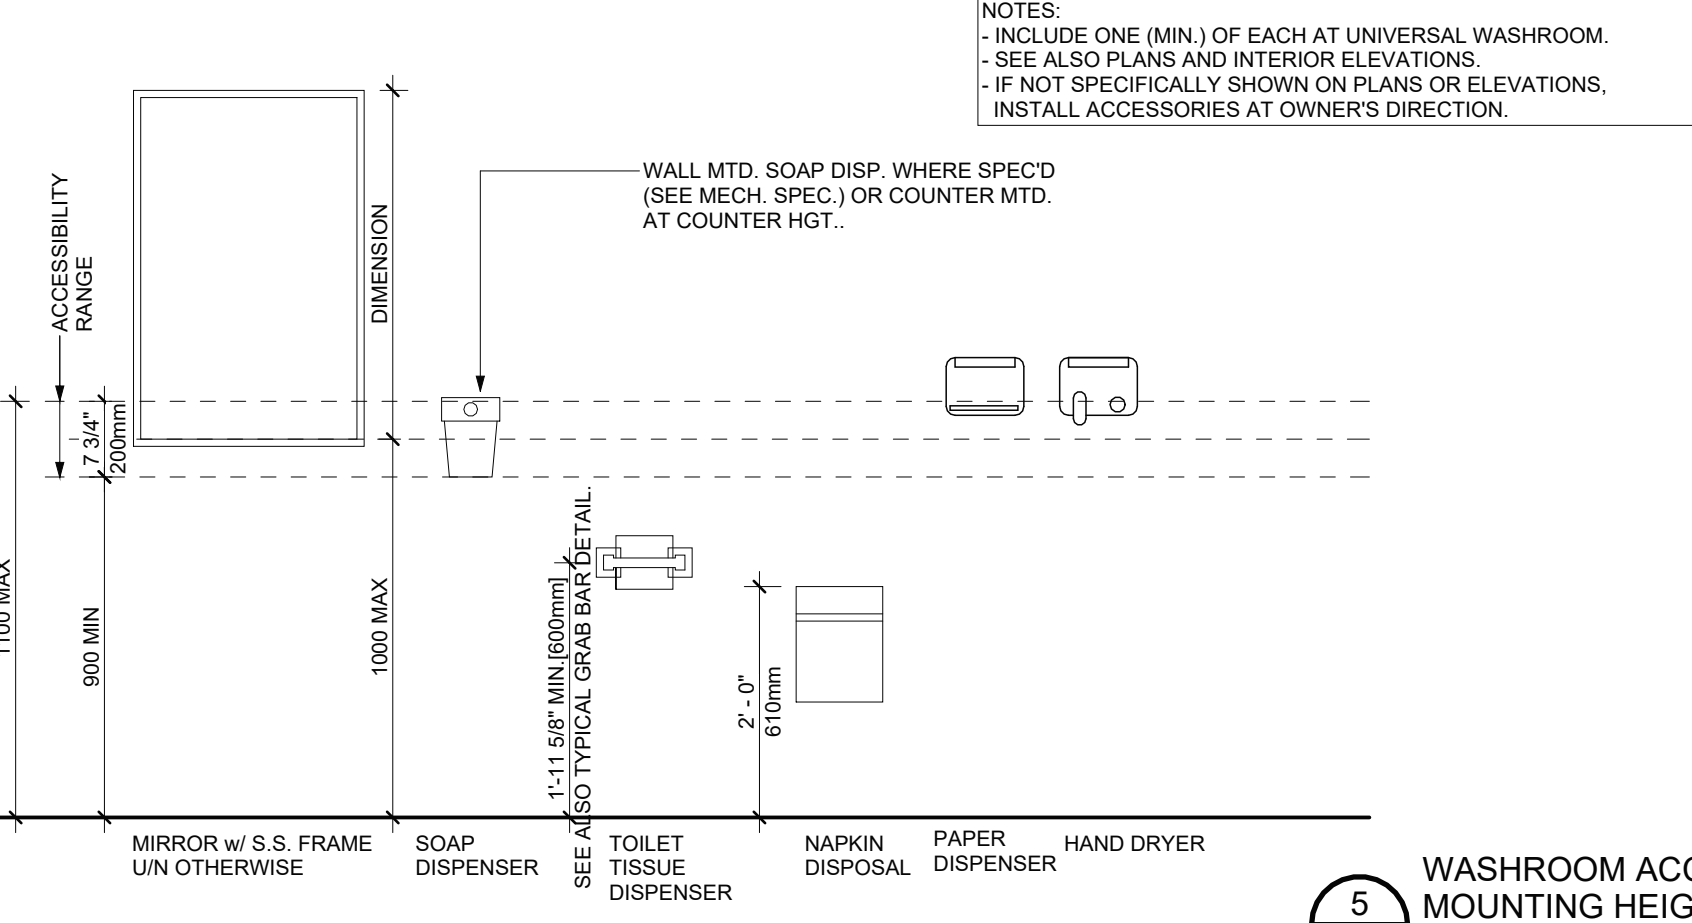

5 WASHROOM ACCESSORY MOUNTING HEIGHTS
1 : 20



9 PARTIAL FRONT ENTRANCE ELEVATION
1 : 25

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1
No
Revisions:

File No: 24-12
Scale: As indicated
Drawn By: Author
Plot Date: 10/18/2024 10:04:14 AM
Issue Date: 09/07/2024

Entrance-WR's and Customer Service Accessibility Upgrades
The Regional Municipality of Niagara - NRPS D6
501 Fielden Ave., Port Colborne, ON L3K 4T9
REFLECTED CEILING, DOORS, W.R. ACCESSORY PLAN

A2.2

