BEAVERTON ARENA BANQUET KITCHEN AREA RENOVATIONS

176 MAIN STREET BEAVERTON, ONTARIO


LIST OF DRAWINGS


LIST OF DRAWINGS, SITE LOCATION AND DETAILS

ARCHITECTURAL

SECOND FLOOR PLAN, DEMOLITION, AND RCP

SCHEDULES & MILLWORK A901 A902 SPECIFICATIONS

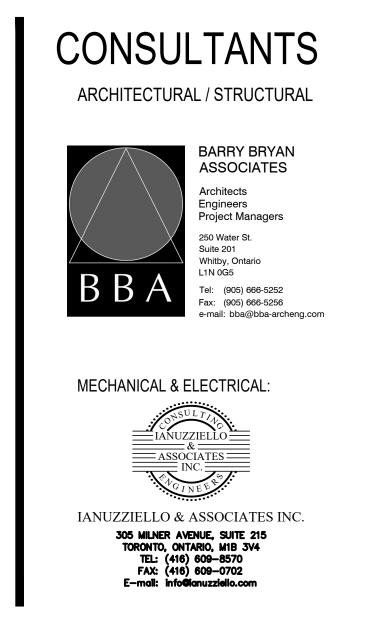

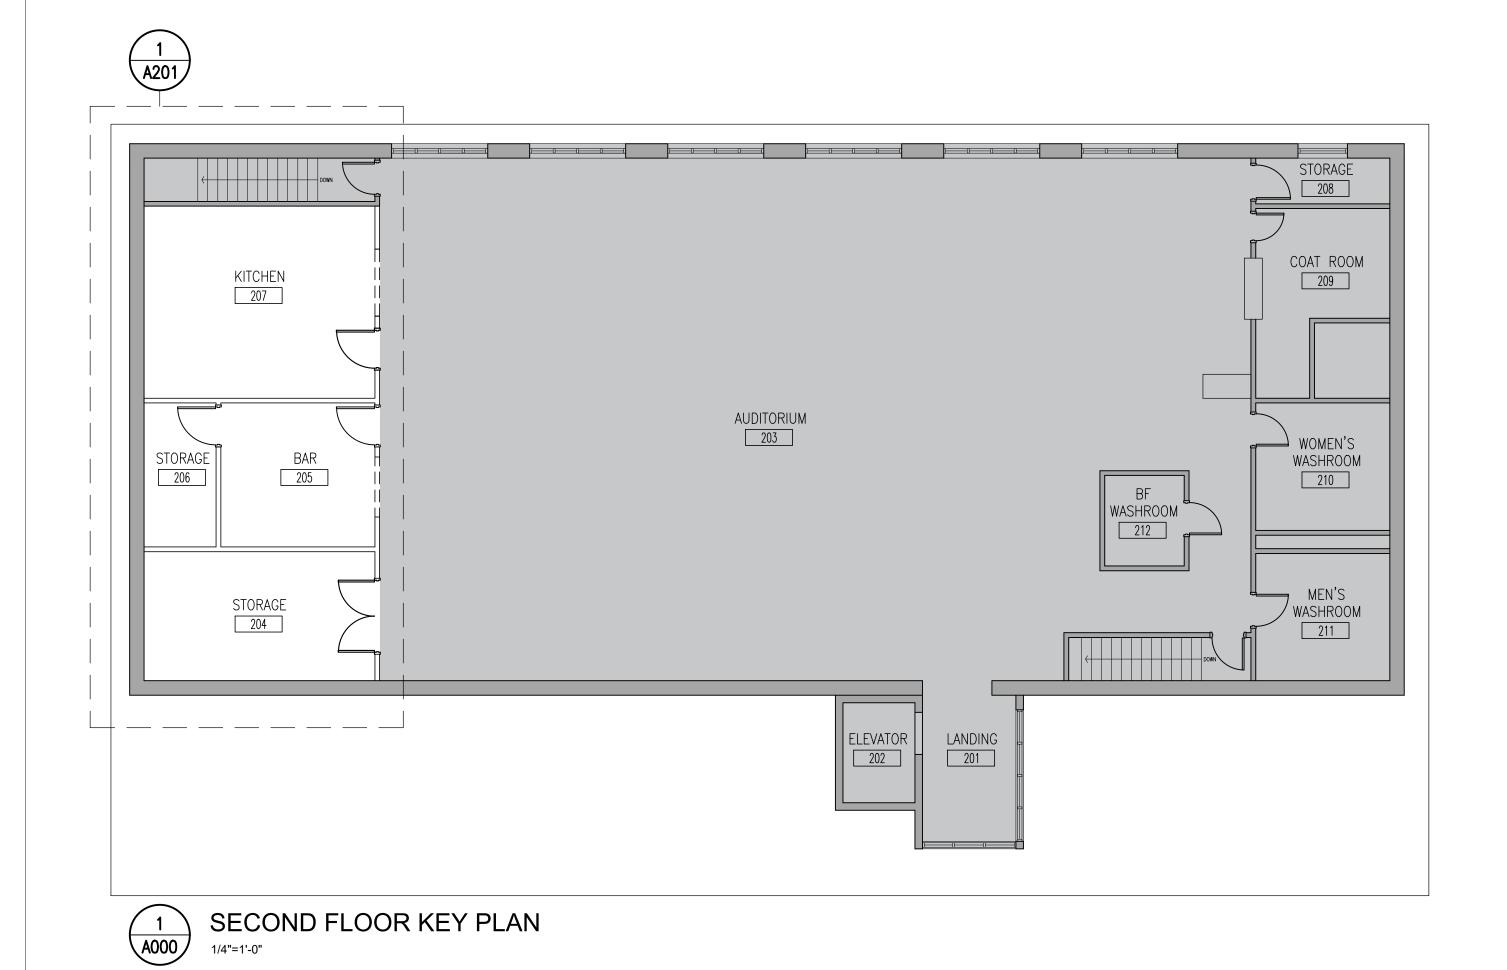

Description <u>New</u> <u>NO C</u>HANGE 11.04 Building Area (m²) [A] 1.4.1.2., 11.2, 8 SECOND FLOOR <u>NO C</u>HANGE NO CHANGE [A] 1.4.1.2 & 3.2.1.1 & 11.3. 11.05 Building Height* Storeys above grade Storeys below grade NO CHANGE 11.06 | Number of streets/ 3.2.2.10, 3.2.5 & fire fighter access: 11.07 | Building Size: ☐ Medium
■ Large T.11.2.1.1.B.-N. 11.08 | Existing Building Change in Major Occupancy: ☐ Yes Not Applicable 11.2.1 Classification: (no change of T11.2.1.1A major occupancy) T11.2.1.1B Construction Index: NO. REVISIONS 4.2.1(3) Hazard Index: ☐ Post-disaster ☐ High 11.09 Renovation Type: ■ Basic Renovation ☐ Extensive Renovation 11.3.3.1 & 11.3.3.2 11.10 | Occupant Load: 3.1.17, 11.4.2.2. Floor Level/ Area NO CHANGE 11.11a Plumbing Fixture Ratio: Male/Female = 50:50 Except as noted otherwise Occupant Provided Reference **NO CHANGE** 11.11b Plumbing Fixture B.F. Fixture B.F. Fixture Uni. Fixture Uni_Fixtures Requirements: 3.8.2.3.A Provided Required NO CHANGE 3.8.2.3.B 11.12 Barrier-free Design: Explanation AT AREA OF DESIGN ONLY ■ Yes □ No 11.3.3.2.(2) Barrier-Free Entrances: ____ Explanation 11.13 Reduction in 11.4.2.1 Performance Level: 11.4.2.2 By Increase in occupant load: By change of major occupancy: ■ No ☐ Yes 11.4.2.3 11.4.2.4 11.4.2.5 Sewage - system: 11.4.2.6 11.14 | Compensating 11.4.2.1 Construction: 11.4.2.2 Structural By Increase in occupant load: 11.4.2.3 By change of major occupancy: 11.4.2.4 Plumbing ■ No □ Yes 11.4.2.5 11.4.2.6 Sewage - system: 11.4.2.7 Extension of Combustible Construction: 11.15 Compliance Alternatives Proposed: 11.16 Notes: The project involves on interior renovation to the Banquet Hall Bar and Kitchen Space. Suite 201 The interior renovation is approximately 776 ft². L1N 0G5 The space will not accommodate cooking with grease and based on this the NFPA hood is not being installed

776ft² RENOVATION

Last Amendment: O. Reg. 158/24

Renovation

ARENA BANQUET HALL

INTERIOR RENOVATION

☐ Addition and Renovation

NAME OF CONSULTANT : BARRY BRYAN ASSOCIATES

CERTIFICATE OF PRACTICE NUMBER: 5192

BEAVERTON ARENA BANQUET KITCHEN AREA

176 MAIN STREET, BEAVERTON, ONTARIO, TOWNSHIP OF BROCK

☐ Addition

Description

☐ Change of use

Occupancy Group A, Div. 3

250 WATER STREET, SUITE 201 WHITBY, ONTARIO, CANADA. LIN 0G5

TEL: (905) - 666 - 5252

(Toronto) (905) - 427 - 4495 FAX: (905) - 666 - 5256

LOCATION OF PROJECT :

Ontario Building Code

Part 11 - Renovation of

11.00 Building Code Version: O. Reg. 332/12

NAME OF PROJECT :

RENOVATIONS

OCT 2024

11.01 | Project Type:

Occupancy Classification:

11.03 | Superimposed

Major Occupancies:

11.02 | Major

CHECK AND VERIFY ALL DIMENSIONS AT THE SITE. ALL DRAWINGS, SPECIFICATIONS AND RELATED DOCUMENTS ARE THE COPYRIGHT PROPERTY OF THE CONSULTANT AND MUST BE RETURNED UPON REQUEST. REPRODUCTION OF DRAWINGS IN PART OR WHOLE WITHOUT THE PERMISSION OF THE CONSULTANT IS FORBIDDEN. DRAWINGS ARE NOT TO BE USED FOR CONSTRUCTION UNTIL SIGNED AND SEALED BY THE CONSULTANT.

NO.	ISSUES	DATE	BY
1	ISSUED FOR 90% REVIEW	OCT 01 2024	AM
2	ISSUED FOR P&T	NOV 01 2024	AM



PROJECT:

OBC Reference

3.1.2.1.(1) & 11.2.

11.2 & 3.2.2.5. -

3.2.2.8.


[A] 1.1.2.

BEAVERTON ARENA BANQUET KITCHEN AREA RENOVATIONS

176 MAIN STREET BEAVERTON, ONTARIO TOWNSHIP OF BROCK

DRAWING:

TITLE SHEET / MATRIX

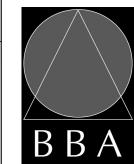




DATE BY


ASSOCIATES Architects Engineers Project Managers 250 Water Street Whitby, Ontario Tel: (905) 666-5252 Fax: (905) 666-5256 e-mail: bba@bba-archeng.com


BBA DRAWN BY: CHECKED BY: DM NOV 2024 AS NOTED

23116

DRAWING NO: A000

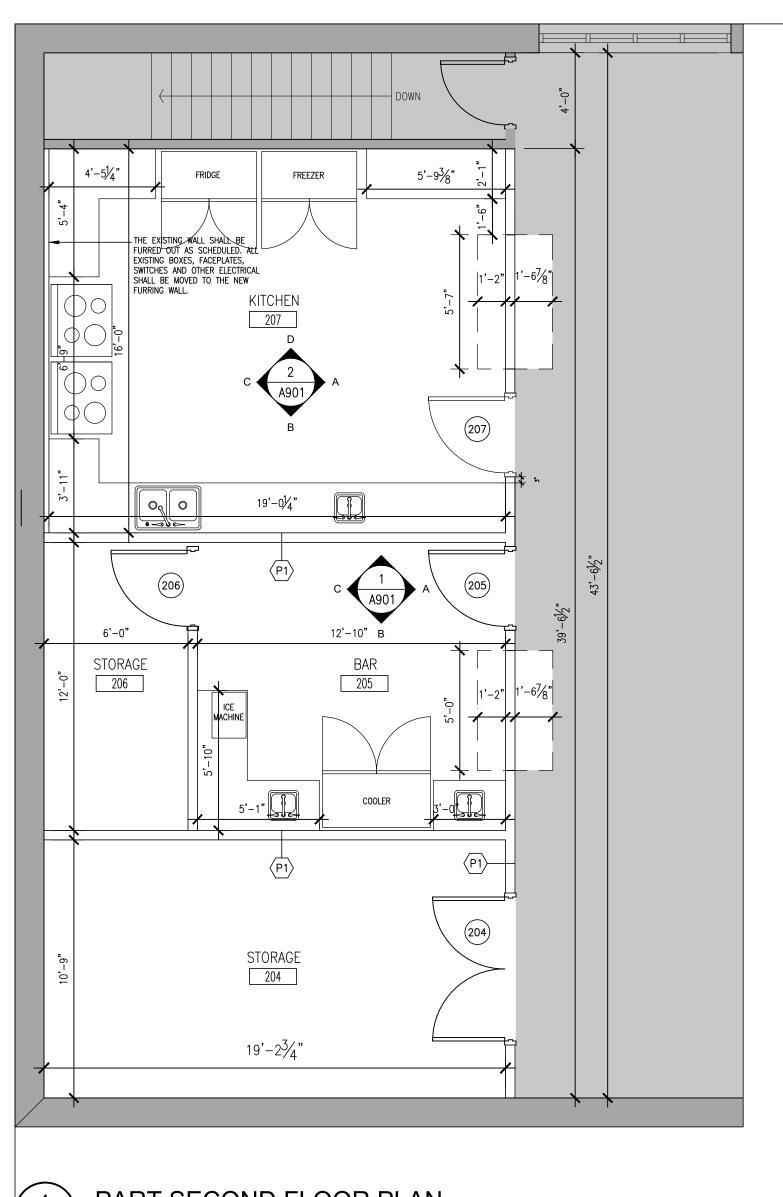

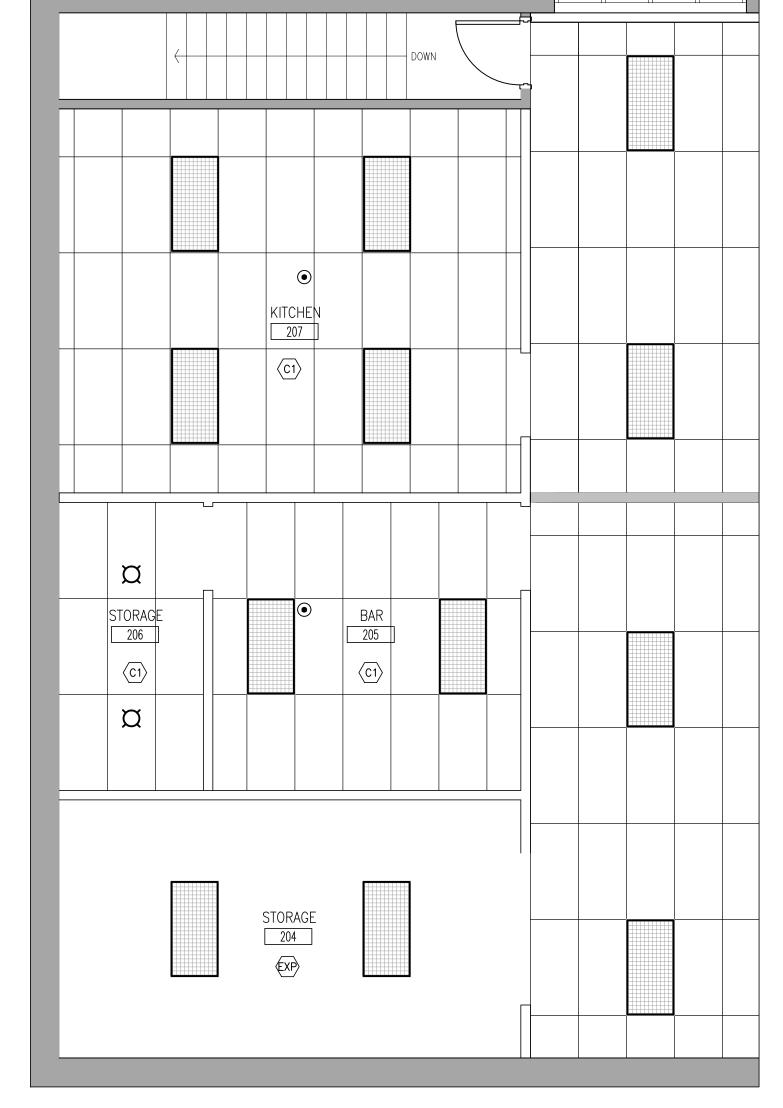

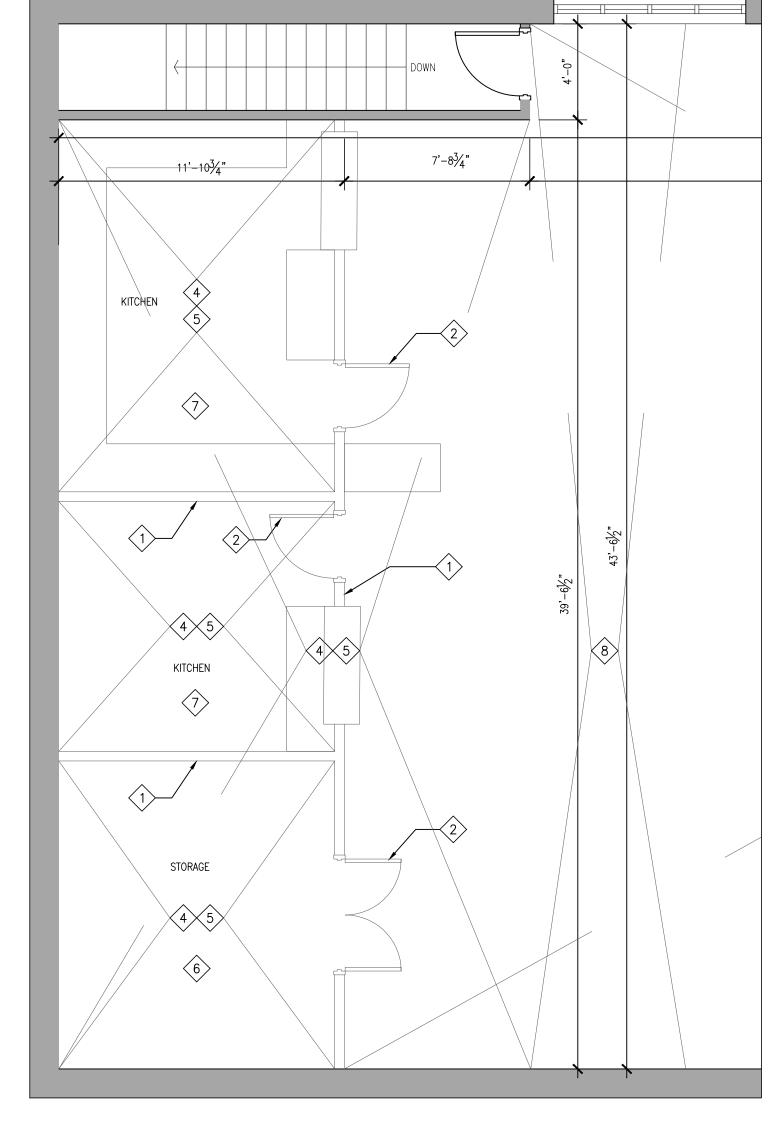


PART SECOND FLOOR PLAN A201 1/4"=1'-0"

2 A201

PART SECOND FLOOR REFLECTED CEILING PLAN

PART SECOND FLOOR DEMOLITION PLAN A201 1/4"=1'-0"



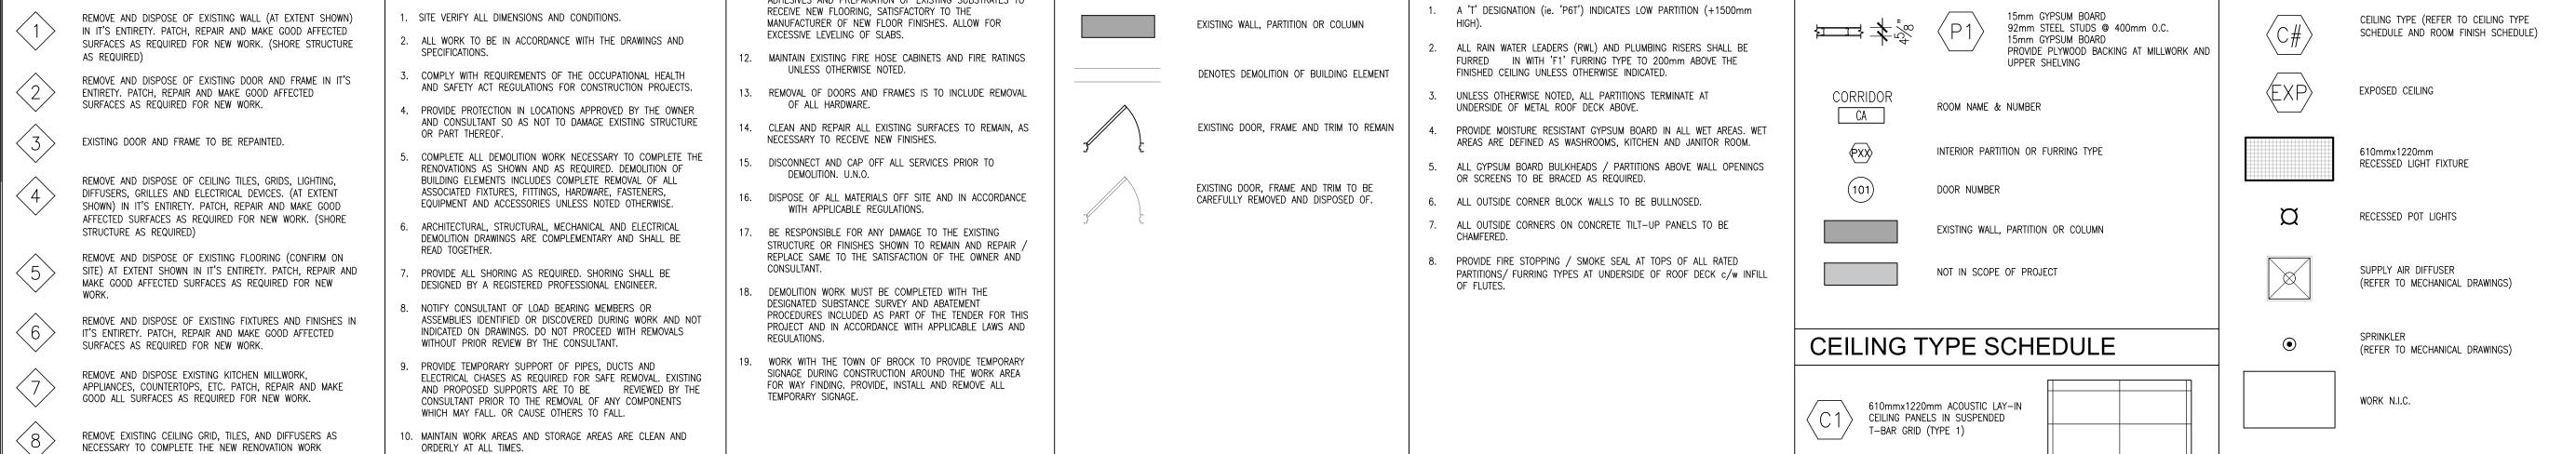

CHECK AND VERIFY ALL DIMENSIONS AT THE SITE. ALL DRAWINGS, SPECIFICATIONS AND RELATED DOCUMENTS ARE THE COPYRIGHT PROPERTY OF THE CONSULTANT AND MUST BE RETURNED UPON REQUEST. REPRODUCTION OF DRAWINGS IN PART OR WHOLE WITHOUT THE PERMISSION OF THE CONSULTANT IS FORBIDDEN. DRAWINGS ARE NOT TO BE USED FOR CONSTRUCTION UNTIL SIGNED AND SEALED BY THE CONSULTANT.

NO. ISSUES DATE BY 1 ISSUED FOR 90% REVIEW 2 ISSUED FOR P&T



DATE BY NO. REVISIONS

PROJECT:


BEAVERTON ARENA BANQUET KITCHEN AREA RENOVATIONS

176 MAIN STREET BEAVERTON, ONTARIO TOWNSHIP OF BROCK

DRAWING:

SECOND FLOOR PLAN, DEMOLITON PLAN, AND REFLECTED CEILING PLAN



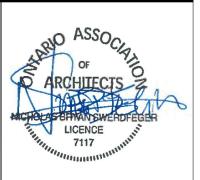

% COMPLETE:

BARRY BRYAN ASSOCIATES Architects Engineers Project Managers 250 Water Street Suite 201 Whitby, Ontario L1N 0G5 Tel: (905) 666-5252

BBA DRAWN BY: Fax: (905) 666-5256

CHECKED BY: DM e-mail: bba@bba-archeng.com

NOV 2024 1/4"=1'-0" FILE:

DESIGN BY:

23116


PROJECT NO: DRAWING NO: **A201**





- REMOVAL OF EXISTING FLOOR FINISHES IS TO INCLUDE COMPLETE REMOVAL OF BASE AND ALL MORTAR AND ADHESIVES AND PREPARATION OF EXISTING SUBSTRATES TO

DEMOLITION LEGEND

PARTITION & FURRING NOTES | FLOOR PLAN NOTATION LEGEND | CEILING NOTATION LEGEND

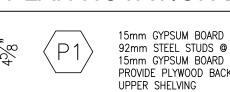

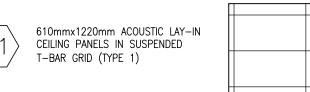

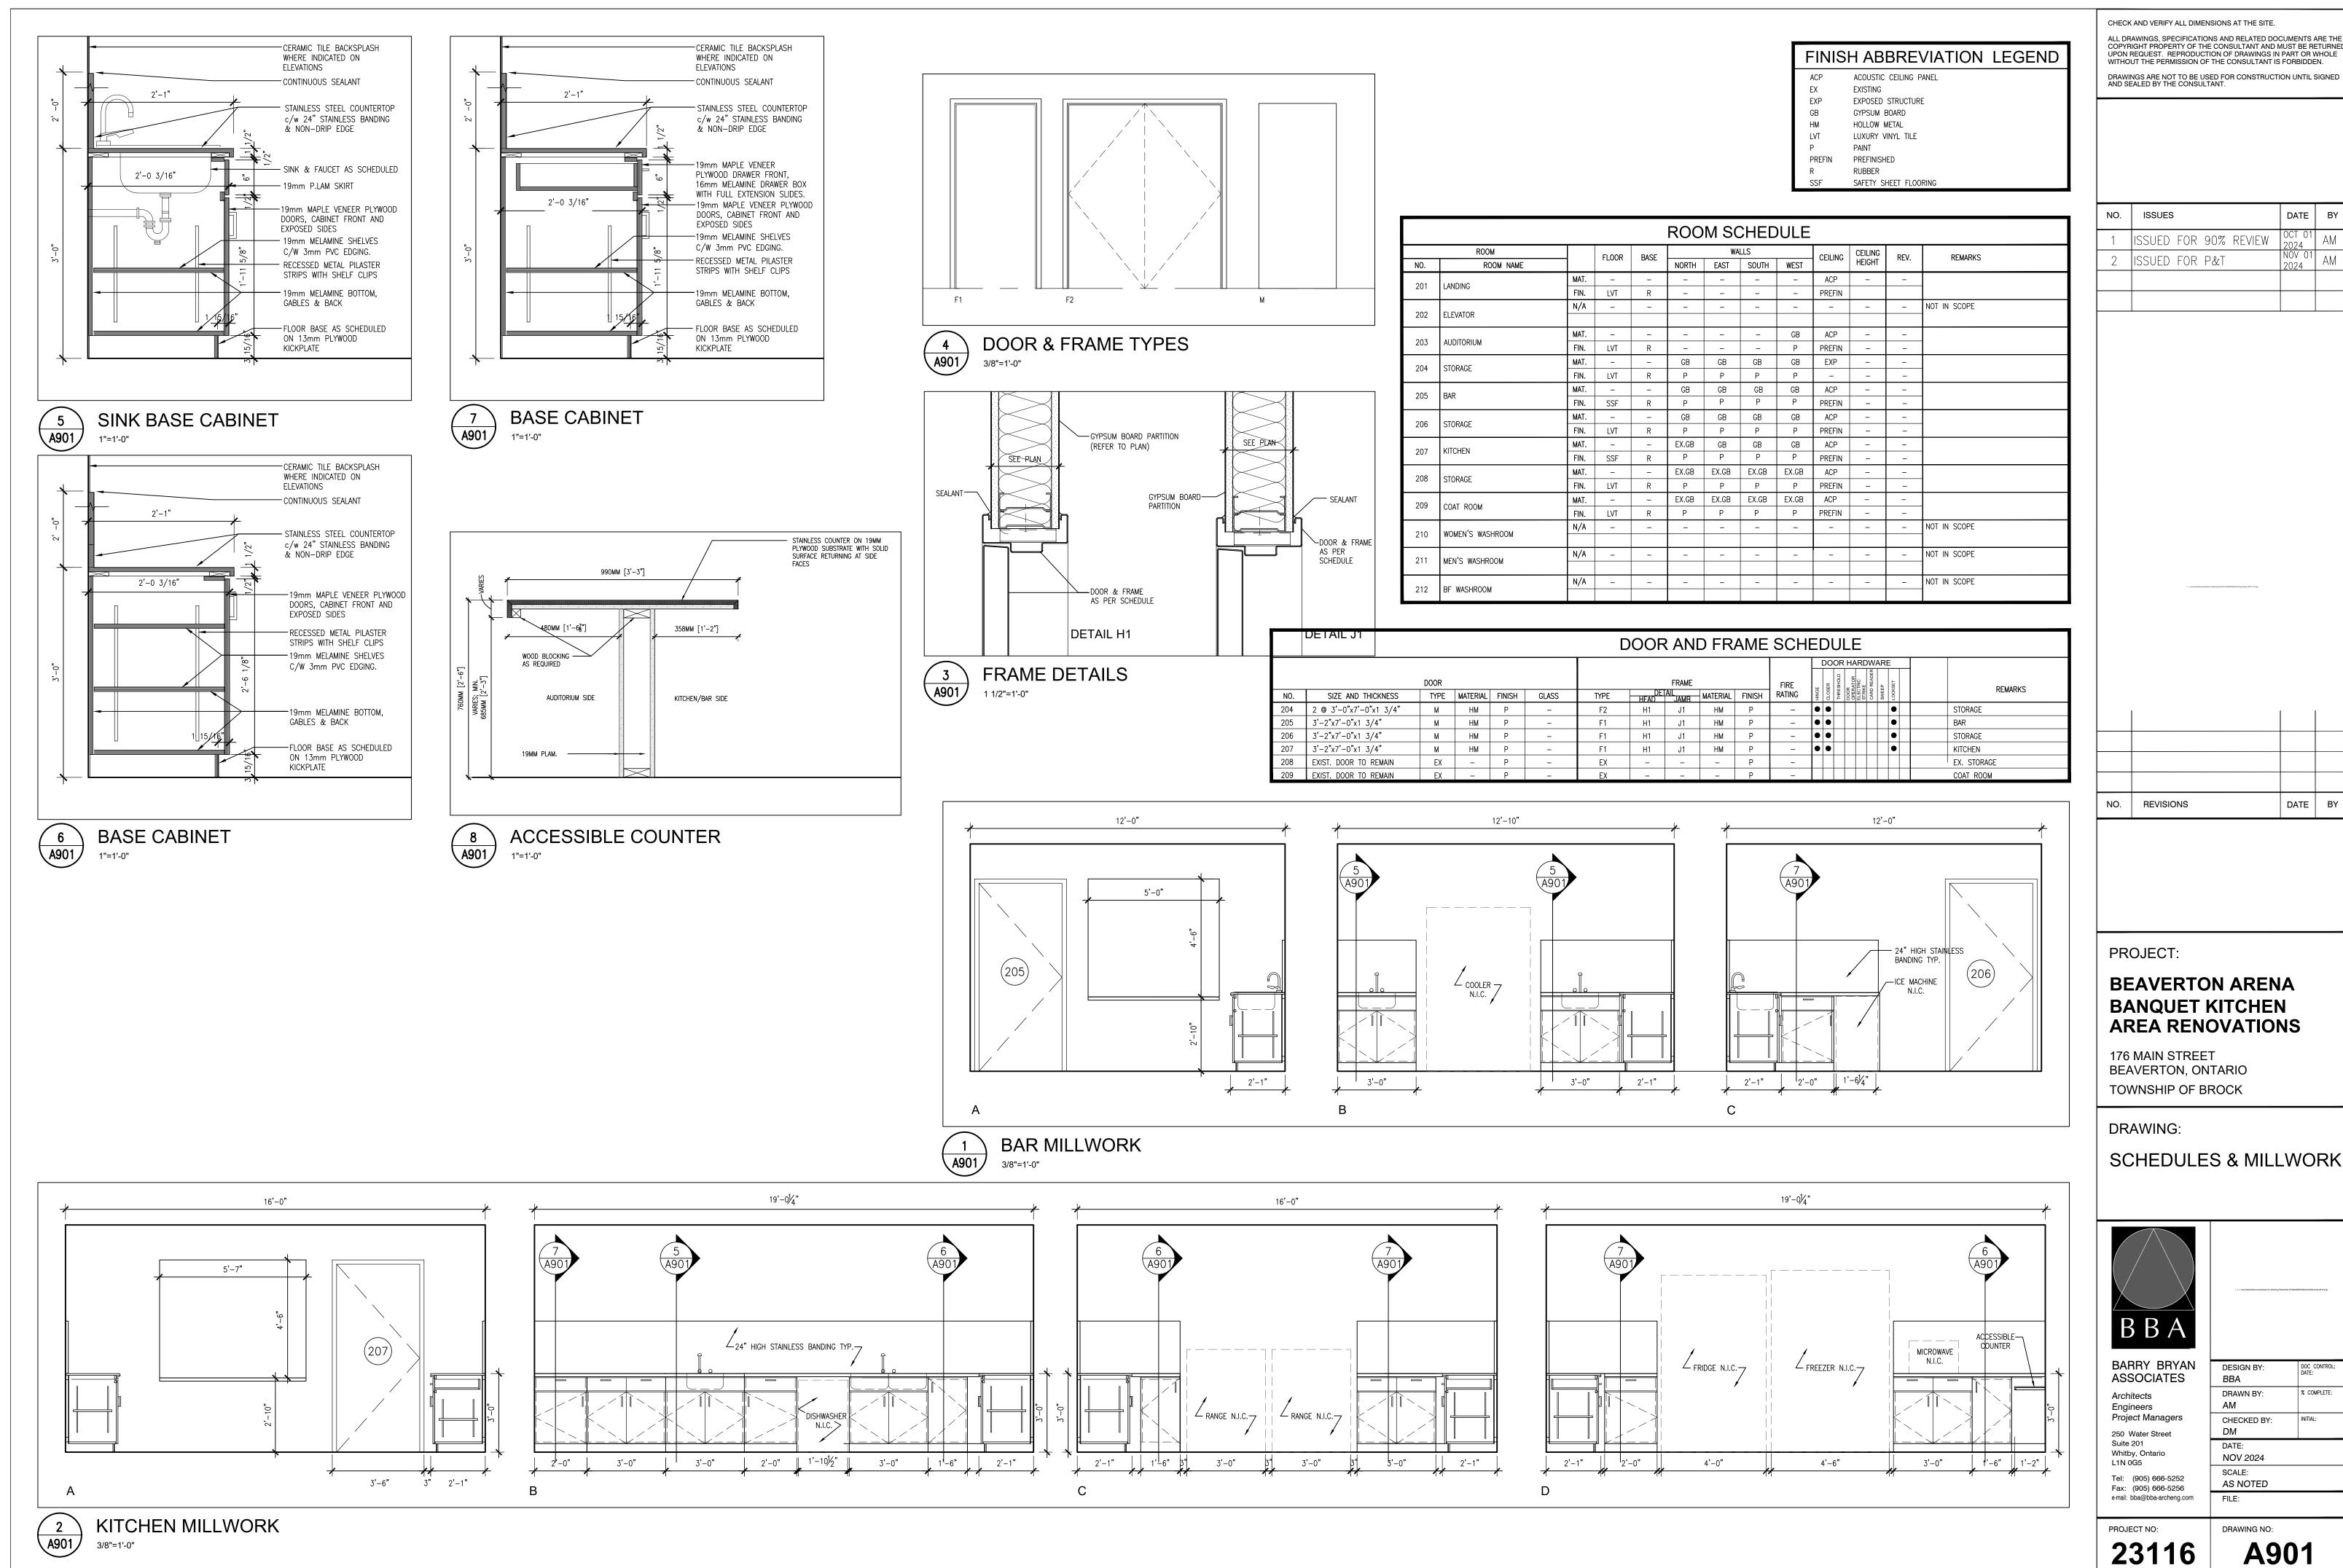

ALL DRAWINGS, SPECIFICATIONS AND RELATED DOCUMENTS ARE THE COPYRIGHT PROPERTY OF THE CONSULTANT AND MUST BE RETURNED UPON REQUEST. REPRODUCTION OF DRAWINGS IN PART OR WHOLE WITHOUT THE PERMISSION OF THE CONSULTANT IS FORBIDDEN.

DATE BY

A901

GENERAL NOTES

SAFETY ACT AND THESE DOCUMENTS/SPECIFICATIONS.

- ALL MATERIALS AND WORKMANSHIP SHALL CONFORM TO THE REQUIREMENTS OF THE ONTARIO BUILDING CODE, LATEST EDITION.
- COMPLY WITH THE OCCUPATIONAL HEALTH AND SAFETY ACT/REGULATIONS FOR CONSTRUCTION PROJECTS.
- INSTALL HOARDING, DUST CONTROL/PROTECTION, COVERED WALKWAYS AND FENCING IN ACCORDANCE WITH ONTARIO BUILDING CODE, CANADIAN CONSTRUCTION SAFETY REQUIREMENTS, ALL MUNICIPAL BY-LAWS, STANDARDS, OCCUPATIONAL HEALTH AND
- SITE VERIFY ALL DIMENSIONS, LEVELS AND EXISTING CONDITIONS AND IMMEDIATELY NOTIFY THE CONSULTANT OF ANY DISCREPANCIES.
- KEEP THE SITE THROUGHOUT THE WORK AREA IN A CLEAN AND ORDERLY CONDITION AT ALL TIMES TO THE SATISFACTION OF THE OWNER.
- INSTALL ALL MANUFACTURED ITEMS IN STRICT ACCORDANCE WITH THE MANUFACTURERS PRINTED INSTRUCTIONS AND THE REVIEWED SHOP DRAWINGS.
- ALL INTERIOR FINISHES SHALL MEET FLAME SPREAD AND SMOKE DEVELOPED CLASSIFICATIONS AS REQUIRED BY THE ONTARIO BUILDING CODE.
- THE LATEST EDITION OF ALL CODES AND STANDARDS SHALL BE USED.
- OBEY ALL FEDERAL, PROVINCIAL AND MUNICIPAL LAWS, ACTS, STATUTES, REGULATIONS, ORDINANCES AND BY-LAWS WHICH COULD, IN ANY WAY, PERTAIN TO THE WORK OUTLINED IN THE CONTRACT, OR TO ANY EMPLOYEE OF THE CONTRACTOR SATISFY ALL STATUTORY REQUIREMENTS IMPOSED BY THE OCCUPATIONAL HEALTH AND SAFETY ACT AND REGULATIONS MADE THEREUNDER, ON A CONTRACTOR, AND CONTRACTOR AND/OR EMPLOYER WITH RESPECT TO OR ARISING OUT OF THE PERFORMANCE OF THE CONTRACTORS OBLIGATIONS UNDER THIS CONTRACT.
- 10. NOTIFY THE OWNER SHOULD ANY HAZARDOUS CONDITION BECOME APPARENT.
- PROVIDE SAFEGUARD AND PROTECTION AGAINST FIRE IN ACCORDANCE WITH THE CURRENT FIRE CODES AND REGULATIONS.
- 12. COMPLY WITH FEDERAL, PROVINCIAL AND MUNICIPAL REGULATIONS PERTAINING TO WORK TIME RESTRICTIONS, WASTE, AIR, SOLID WASTE, CHEMICAL WASTE, SANITARY WASTE, SEDIMENT AND NOISE POLLUTION.
- 13. TAKE SPECIAL CARE TO PREVENT ACCUMULATION OF MOISTURE ON MATERIALS AND WITHIN PACKAGING DURING DELIVERY. STORAGE AND HANDLING TO PREVENT DEVELOPMENT OF MOLD AND MILDEW ON PACKAGING AND PRODUCTS.
- 14. NO SMOKING IS PERMITTED ON THE PROJECT SITE.

SHOP DRAWINGS & SUBMITTALS

- THE CONTRACTOR SHALL PREPARE AND SUBMIT TO THE CONSULTANT FOR REVIEW DIGITAL COPIES OF SHOP DRAWINGS, INCLUDING PLANS, FINISHES, ELEVATIONS, HARDWARE, AND INSTALLATION FOR DOORS, MISC. METALS, STEEL MEMBERS, CONNECTIONS. DOOR HARDWARE SCHEDULE, PAINT DRAW DOWNS, FINISHED MATERIAL SAMPLES, EQUIPMENT, AND ALL OTHER PRODUCTS REQUIRED.
- REFER TO GENERAL CONDITIONS OF THE CONTRACT.
- PROVIDE MAINTENANCE MANUALS.
- PROVIDE 1 YEAR GENERAL CONTRACTOR WARRANTY FOR THE PROJECT.

CONSTRUCTION **FACILITIES**

PROVIDE CONSTRUCTION FACILITIES IN ORDER TO EXECUTE THE WORK EXPEDITIOUSLY. REMOVE, RESTORE SITE AND SURFACES AFTER USE.

- PROVIDE AND MAINTAIN REQUIRED ACCESS TO PROJECT SITE AND ADJACENT AREAS
- HEIGHT, WIDTH AND WEIGHT RESTRICTIONS MUST BE VERIFIED PRIOR TO BRINGING EQUIPMENT INTO THE WORK AREA.
- PROVIDE NECESSARY SCREENS, COVERS AND HOARDINGS.
- OBEY AND ENFORCE ALL PARKING AND VEHICLE RESTRICTIONS AND SPEED LIMITS.
- 6. BE RESPONSIBLE FOR SECURITY OF SITE, EQUIPMENT, TOOLS AND MATERIALS.
- MAINTAIN THE BUILDING IN A SECURE AND WEATHERPROOF CONDITION AT ALL TIMES
- DURING CONSTRUCTION.

DEMOLITION/REMOVALS

KEEP THE SPREAD OF DUST TO OTHER AREAS AND ADJACENT PROPERTIES AND EQUIPMENT TO A MINIMUM BY USE OF WATER SAWS AND INSTALLING AND MAINTAINING DUST TARPAULINS AS DIRECTED AND APPROVED BY THE OWNER.

FINISH CARPENTRY

- ALL MILLWORK SHALL BE IN ACCORDANCE WITH AWMAC STANDARD DETAILS AND
- SOFTWOOD LUMBER: CAN/CSA 0141. UNLESS SPECIFIED OTHERWISE, S4S, MOISTURE CONTENT 19% OR LESS. NLGA STANDARD GRADING RULES FOR CANADIAN LUMBER. AWMAC CUSTOM PREMIUM GRADE, MOISTURE CONTENT AS SPECIFIED.
- MEDIUM DENSITY FIBREBOARD (MDF): TO ANSI A208.2-02, DENSITY 640-800 KG/M3. FORESTRY STEWARDSHIP COUNCIL (FSC) CERTIFIED. UREA-FORMALDEHYDE FREE.
- ROUGH HARDWARE: BOLTS, LAG SCREWS, ANCHORS, NAILS AND EXPANSION SHIELDS REQUIRED TO SECURE THIS PORTION OF WORK. ROUGH HARDWARE HOT DIP GALVANIZED CONFORMING TO LATEST EDITION OF CAN/CSA-G164. ALL FASTENERS USED IN DAMP OR WET AREAS TO BE SUITABLE FOR USE IN CORROSIVE ENVIRONMENT. USE HOT DIPPED GALVANIZED OR OTHER MATERIAL APPROVED BY THE
- NAILS AND STAPLES: TO CSA B111, GALVANIZED TO CAN/CSA G164.
- WOOD SCREWS: TO CSA B 35.4 PLAIN TYPE AND SIZE TO SUIT APPLICATION.
- STAINLESS STEEL HARDWARE: TYPE 316 STAINLESS STEEL FOR EXPOSED OR WET LOCATIONS, TAMPER PROOF.
- 8. SPLINES: WOOD OR METAL TO SUIT APPLICATION.
- ADHESIVE: RECOMMENDED BY MANUFACTURER, WATERPROOF TYPE, MAXIMUM VOC LIMIT 30 G/L SCAQMD RULE 1168 - ADHESIVES AND SEALANTS APPLICATIONS.
- 10. REFER TO CLIENT SUPPLIED DRAWINGS FOR MILLWORK DETAILS

INSULATION

- GLASS FIBRE ACOUSTIC BLANKET INSULATION: TO CAN/ULC-S702, TYPE 1, PRE-FORMED UNFACED GLASS FIBRE BATT ACOUSTIC INSULATION. THICKNESS AS REQUIRED FOR WALL TYPE TO CREATE THE HIGHEST STC. VALUE POSSIBLE.
- BASIS OF DESIGN: SELECT SOUND BOARD INSULATION, 25MM THICK, AS MANUFACTURED BY OWENS CORNING.

HOLLOW METAL DOORS AND FRAMES

- 1. DOORS: 18 GAUGE, WIPE COAT GALVANIZED STEEL.
- FRAMES: EXISTING WOOD FRAME.
- FRAME ANCHORS: EXISTING.
- 4. PRIMER: TO CGSB 1-GP-181

5. WELDING: N/A

- 6. STEEL FIRE RATED DOORS AND FRAMES: LABELLED AND LISTED BY AN ORGANIZATION ACCREDITED BY STANDARDS COUNCIL OF CANADA IN CONFORMANCE WITH CAN4-S104 NFPA 252 FOR RATINGS SPECIFIED OR INDICATED.
- 7. PROVIDE FIRE LABELED FRAMES FOR OPENINGS REQUIRING FIRE PROTECTION RATINGS. TEST PRODUCTS IN CONFORMANCE WITH CAN4-S104, ASTM E152 OR NFPA 252 AND LISTED BY NATIONALLY RECOGNIZED AGENCY HAVING FACTORY INSPECTION SERVICES.

FINISH HARDWARE

- 1. SUBMIT HARDWARE LIST FOR APPROVAL IN ACCORDANCE WITH THE GENERAL
- 2. SUBMIT TEMPLATES TO DOOR AND FRAME SUPPLIER
- 3. LOCKS TO BE MASTER KEYED TO SUIT OWNER'S REQUIREMENTS
- 4. ALL FASTENERS SHALL BE CONCEALED OR TAMPERPROOF HARDWARE GROUP NO. 1:

1 1/2 PAIR BUTTS	SSBB1199x114x101xNRPx619	HAGE
1 CLOSER	4114H-CUSHx689	LC
1 DOOR PULL w/ PULL PLATE	33J-4x16-US26D	HAGE
1 PUSH PLATE	HA9502Ax101x406x630	HAGE
1 KICK PLATE	HA9502Ax305x870x630	HAGE

5. FINISH HARDWARE SHALL BE SUPPLIED AND INSTALLED RIVETT HARDWARE OR

GYPSUM BOARD

- 1. COMPLY WITH REQUIREMENTS OF CSA A82.30 AND CSA A82.31
- 2. PLAIN GYPSUM BOARD; CSA A82.27 STANDARD, FOR NON-RATED APPLICATIONS. 1219mm WIDE X MAXIMUM PRACTICAL LENGTH, TAPERED EDGES, THICKNESS AS
- 3. LIGHTWEIGHT STEEL FRAMING FOR EXTERIOR WALLS TO ASTM A446.
- 4. NON-LOAD-BEARING CHANNEL STUD FRAMING TO ASTM C645, ROLL FORMED GALVANIZED SHEET STEEL.
- 5. SCREWS: CASE HARDENED SELF DRILLING NO. 6 GAUGE DRYWALL SCREWS TO CSA
- 6. JOINT TAPE: 50mm WIDE PERFORATED PAPER.
- 7. JOINT FILLER AND TOPPING: CASEIN, VINYL OR ACRYLIC BASE.
- 8. CASING BEADS; 20 GAUGE SHEET STEEL G20 FINISH, ASTM A525, PERFORATED,

ACOUSTICAL CEILING

- 1. ACOUSTIC UNITS FOR SUSPENDED CEILING SYSTEM: TO CAN/CGSB-92.1-M89 AND ASTM E 1264-14
- 2. ACOUSTIC PANELS: GLASS OR MINERAL FIBRE WITH FLAME SPREAD RATING OF 25 OR LESS AND NRC RAGE OF 0.65 TO 0.75 RANDOM FISSURED, WHITE, 610 X 1220 X
- 3. SUBMIT DUPLICATE 300 X 300mm SAMPLES OF EACH TYPE OF ACOUSTICAL UNITS.
- 4. SUSPENSION SYSTEM: TO ASTM A641. DONN DX, 15/16 WIDE, BAKED WHITE ENAMEL INTERLOCKING TEE GRID.
- 5. COMPONENTS: ALL MAIN BEAMS AND CROSS TEES SHALL BE COMMERCIAL QUALITY HOT-DIPPED GALVANIZED STEEL AS PER ASTM C635/C635M-07. MAIN BEAMS AND CROSS TEES SHALL BE DOUBLE-WEB STEEL CONSTRUCTION WITH TYPE EXPOSED FLANGE DESIGN. EXPOSED SURFACES CHEMICALLY CLEANSED, CAPPING PRE-FINISHED GALVANIZED STEEL IN BAKED POLYESTER PAINT. MAIN BEAMS AND CROSS TEES SHALL HAVE ROTARY STITCHING.
- 6. STRUCTURAL CLASSIFICATION: INTERMEDIATE DUTY SYSTEM, ASTM C635/C635M-07.
- 7. ATTACHMENT DEVICES: SIZE FOR FIVE TIMES DESIGN LOAD INDICATED IN ASTM C635. TABLE 1, DIRECT HUNG UNLESS OTHERWISE INDICATED.
- 8. WIRE FOR HANGERS AND TIES: ASTM A641, CLASS 1 ZINC COATING, SOFT ANNEALED. WITH A YIELD STRESS LOAD OF AT LEAST TIME THREE DESIGN LOAD, BUT NOT LESS
- 9. SOUND BLANKETS: 65mm SOUND ATTENUATION BATTS FIBREGLAS CANADA
- 10. CO-ORDINATE CEILING WORK TO ACCOMMODATE COMPONENTS OF OTHER SECTIONS TO BE BUILT INTO ACOUSTICAL CEILING INCLUDING MECHANICAL AND ELECTRICAL WORK.

METAL STUD FRAMING

- 1. ALL MATERIALS AND WORKMANSHIP TO CSA A82.31
- 2. NON BEARING STEEL STUD FRAMING: ASTM C645, ROLL FORMED GALVANIZED SHEET STEEL, MINIMUM 0.036" THICKNESS.
- 3. TRACKS: ASTM C645
- 4. HARDWARE: SELF TAPPING SHEET METAL SCREWS.

SEALANTS

- 1. ALL SEALANT MATERIAL SHALL BE ASBESTOS FREE.
- 2. SUBMIT WHMIS DATA SHEETS FOR REVIEW AND APPROVAL.
- 3. SEAL ALL JOINTS BETWEEN DISIMILAR MATERIALS AND SURFACES.
- 4. SEALANT SHALL BE TREMCO MONO OR EQUIVALENT.
- 5. PRIMERS AS RECOMMENDED BY SEALANT MANUFACTURER.
- 6. SEALANTS SHALL COMPY WITH THE FOLLOWING STANDARDS; 6.1. ASTM C834-14 STANDARD SPECIFICATION FOR LATEX SEALANTS 6.2. ASTM C920-14A STANDARD SPECIFICATION FOR ELASTOMERIC JOINT SEALANTS 6.3. ASTM C1184-14 STANDARD SPECIFICATION FOR STRUCTURAL SILICONE
- 6.4. ASTM C1193-13 STANDARD GUIDE FOR USE OF JOINT SEALANTS 6.5. ASTM C1311-14 STANDARD SPECIFICATION FOR SOLVENT RELEASE SEALANTS

GLASS AND GLAZING

- TEMPERED SAFETY GLASS: TO CAN/CGSB-12.1-M, TRANSPARENT, 10 MM THICK UNLESS INDICATED OTHERWISE. TYPE 2-TEMPERED. 1.1. CLASS B-FLOAT.
 - 1.2. CATEGORY 1 11. 1.3. EDGE TREATMENT: GROUND, BEVEL EDGE
- 2. FIRE RATED GLASS: 2.1. MATERIAL: FIRE PROTECTIVE SAFETY LAMINATED GLASS CERAMIC WITH HOSE
- STREAM, FIRE RATING AS INDICATED. 2.2. CONFORMING TO ULC 104 & ULC 106
- 2.3. PRODUCT AND MANUFACTURER:

2.3.1. PYRAN PLATINUM L AS MANUFACTURED BY SCHOTT TECHNICAL GLASS

- SOI UTIONS 2.3.2. KERALITE SELECT L AS MANUFACTURED BY VETROTECH SAINT-GOBAIN
- 2.3.3. FIRELITE PLUS PREMIUM AS MANUFACTURED BY NIPPON GLASS.
- 2.4. DESIGN REQUIREMENTS: 2.4.1. THICKNESS: 8 MM THICK.

2.6. ACCESSORIES

- 2.4.2. WEIGHT: 19.5 KG/M2 SOUND TRANSMISSION RATING: 36 STC. APPEARANCE: NEUTRAL COLOURATION FREE OF AMBER TINTS. FIRE RATING: FIRE RATED FROM 20-180 MINUTES WITH HOSE STREAM.
- IMPACT SAFETY RATING: MEET CPSC 16 CFR 1201 CATEGORY I & II. CRADLE TO CRADLE CERTIFICATION: MUST BE C2C SILVER CERTIFIED.
- 2.4.8. POLISHED FINISH. 2.4.9. ANZI Z97 IMPACT SAFETY FILMED AND LAMINATED 2.4.10. ENVIRONMENTAL IMPACT: MANUFACTURING PROCESS AND FINAL
- COMPOSITION FREE FROM TOXINS OR HAZARDOUS HEAVY METALS. 2.5. EACH PIECE OF FIRE-RATED GLAZING MATERIAL SHALL BE LABELED WITH A
- PERMANENT LOGO INCLUDING NAME OF PRODUCT, MANUFACTURER, TESTING LABORATORY AND FIRE RATING.
- 2.6.1. GLAZING ACCESSORIES: MANUFACTURER RECOMMENDED FIRE RATED GLAZING ACCESSORIES AS FOLLOWS: GLAZING TAPE: CLOSED CELL POLYVINYL CHLORIDE (PVC) FOAM. PEMKO MANUFACTURING COMPANY, FG3000S90 OR UNIFAX CORPORATION
- FIBERFRAX ALUMINO-SILICATE FIBER GLAZING TAPE. SETTING BLOCKS: CALCIUM SILICATE OR HARDWOOD. CLEANERS, PRIMERS, SEALERS: TYPE RECOMMENDED BY MANUFACTURER

RESILIENT FLOORING AND BASE

- RESILIENT BASE: 100mm HIGH THERMOPLASTIC RUBBER, NOT LESS THAN 3.0mm GAUGE WITH PREFORMED INTERNAL AND EXTERNAL CORNERS. BASE AT RESILIENT TILE SHALL HAVE STANDARD TOE.
- JOHNSONITE DURACOVE DC RUBBER WALL BASE OR APPROVE EQUAL. UP TO 2 COLOURS SHALL BE SELECTED BY CONSULTANT FROM

MANUFACTURERS FULL RANGE OF COLOURS.

- PRIMERS, ADHESIVES AND CAULKING: NON-FLAMMABLE, SOLVENT FREE. WATERPROOF, RECOMMENDED BY FLOORING MANUFACTURER FOR SPECIFIC MATERIAL ON APPLICABLE SUBSTRATE, ABOVE GRADE.
- PRIOR TO INSTALLATION OF THIS SECTION, CAREFULLY INSPECT THE INSTALLED WORK OF ALL OTHER TRADES AND VERIFY THAT ALL SUCH WORK IS COMPLETE TO THE POINT WHERE THIS INSTALLATION MAY PROPERLY COMMENCE.
- LUXURY VINYL TILES: SURFACE STYLE # 0515V LVT AS SUPPLIED BY SHAW CONTRACT FLOORING INC. OR APPROVED EQUAL.
- 4.2. COLOUR: UP TO 2 COLOURS FROM MANUFACTURER'S FULL RANGE.
- 4.3. OVERALL THICKNESS: 2.5mm 4.4. WEAR LAYER THICKNESS: 0.51mm
- 4.5. EDGE PROFILE: SQUARE EDGE 4.6. INSTALLATION: DIRECT GLUE TO SUB-STRATE.
- 4.7. INSTALLATION PATTERN: BRICK. ADHESIVE: AS RECOMMENDED BY MANUFACTURER.
- PROVIDE HIGH VENTILATION RATE, WITH MAXIMUM OUTSIDE AIR, DURING INSTALLATION, AND FOR 48 HOURS AFTER INSTALLATION, WHENEVER POSSIBLE VENTILATE DIRECTLY TO THE OUTSIDE. DO NOT ALLOW CONTAMINATED AIR TO

5. REMOVE ALL SUBSTANCE AND MATERIALS AFFECTING ADHESIVE BOND. VACUUM

- RECIRCULATE THROUGH THE BUILDING VENTILATION SYSTEM. INSTALL RESILIENT BASE WITH MINIMUM NUMBER OF JOINTS.
- REMOVE EXCESS ADHESIVE FROM RESILIENT FLOOR COVERINGS. BASE AND

ADJACENT FINISHED SURFACES AS THE WORK PROGRESSES.

PAINT

- 1. ALL PAINTING SHALL BE IN ACCORDANCE WITH THE ONTARIO PAINTING CONTRACTORS
- ASSOCIATION ARCHITECTURAL SPECIFICATION MANUAL. 2. ALL PAINT SHALL BE GLIDDEN, BEHR, OR EQUAL AS APPROVED BY THE OWNER. STORE ALL PAINT MATERIALS IN ACCORDANCE WITH THE REQUIREMENTS OF THE
- 3. CLEAN AND PREPARE ALL SURFACES PRIOR TO PAINTING IN ACCORDANCE WITH PAIN MANUFACTURERS INSTRUCTIONS.
- 4. TEST ALL SURFACES FOR MOISTURE. DO NOT PAINT WHEN MOISTURE CONTENT
- 5. PAINT ALL NEW MATERIALS AND SURFACES
- 6. PAINT SCHEDULE: COLOUR WILL BE SELECTED BY THE ARCHITECT FROM FULL RANGE OF MANUFACTURERS COLOUR CHARTS.
- 7. DELIVER TO EXTRA MATERIALS FROM SAME PRODUCTION RUN AS PRODUCTS INSTALLED. PACKAGE PRODUCTS WITH PROTECTIVE COVERING AND IDENTIFY WITH DESCRIPTIVE LABELS. 7.1. QUANTITY: PROVIDE ONE FOUR LITRE CAN OF EACH TYPE AND COLOUR OF
- TO ESTABLISHED COLOUR SCHEDULE AND FINISH SYSTEM.
- 8. <u>INTERIOR PAINTING SYSTEMS</u> 8.1. GYPSUM BOARD WALLS : INT 9.2A LATEX G3 EGGSHELL FINISH OVER LATEX
- 8.2. GYPSUM BOARD: CEILINGS AND BULKHEADS: INT 9.2A LATEX G2 VELVET FINISH OVER LATEX SEALER.

PRIMER STAIN FINISH COATING. IDENTIFY COLOUR AND PAINT TYPE IN RELATION

- 9. ALL OTHER SURFACES NOT NOTED ABOVE: HIGH PERFORMANCE FINISH SUITABLE FOR COMMERCIAL AND INSTITUTIONAL ENVIRONMENT AND IN ACCORDANCE WITH MPI
- 10. COORDINATE PAINT COLOUR WITH OWNER

CHECK AND VERIFY ALL DIMENSIONS AT THE SITE ALL DRAWINGS, SPECIFICATIONS AND RELATED DOCUMENTS ARE THE COPYRIGHT PROPERTY OF THE CONSULTANT AND MUST BE RETURNED UPON REQUEST. REPRODUCTION OF DRAWINGS IN PART OR WHOLE WITHOUT THE PERMISSION OF THE CONSULTANT IS FORBIDDEN. DRAWINGS ARE NOT TO BE USED FOR CONSTRUCTION UNTIL SIGNED AND SEALED BY THE CONSULTANT.

NO.	ISSUES	DATE	BY
		OCT 01	
1	ISSUED FOR 90% REVIEW	2024	AM
2	ISSUED FOR P&T	NOV 01 2024	AM



NO.	REVISIONS	DATE	BY


PROJECT:


BEAVERTON ARENA **BANQUET KITCHEN** AREA RENOVATIONS

176 MAIN STREET BEAVERTON, ONTARIO TOWNSHIP OF BROCK

SPECIFICATIONS

DRAWING:

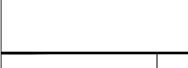

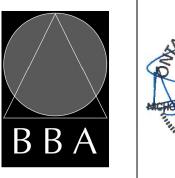

BARRY BRYAN DESIGN BY: ASSOCIATES BBA DRAWN BY:

FILE:

Architects Engineers Project Managers 250 Water Street Suite 201 Whitby, Ontario L1N 0G5 Tel: (905) 666-5252 Fax: (905) 666-5256

% COMPLETE: CHECKED BY: SEPT 2024 AS NOTED

PROJECT NO:

e-mail: bba@bba-archeng.com

DRAWING NO: A902

ALL LOUD WORK IS TO BE COMPLETED AFTER HOURS 10PM - 7AM

WORKING HOURS NOTE: