Pre-Engineered Building: PEB - Proposed Signage

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FACILITIES MANAGEMENT & PLANNING Maanjiwe nendamowinan 2nd Floor Suite 2220

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Issue No.	Description	Date	Drawn	Check
Revisio	ns and issues record			

NORTH MARK

SEAL

PROJECT TITLE

Pre-Engineered Building -Proposed Signage

DRAWING SHEET TITLE

Cover Sheet and Drawing List

SCALE NTS DATE

DRAWING NUMBER

SN-0

June 25, 2024 UTM PROJECT NUMBER P300-23-105



UTM Standards: Renovation & New Construction Section (00 00 01) : Interior Signage **General Notes**

Â. <u>~</u> UNIVERSITY OF **1** TORONTO MISSISSAUGA

UTM Standards: Renovation & New Construction

GENERAL NOTES (Con't):

- 4.4. The SM shall provide dimensions shop drawings for all signs clearly showing materials, typographic layouts. Letter spacing, fabrication methods, external finishes, anchorage electrical connections, etc.)..
- 4.5. Prior to any sing fabrication, SM shall provided samples and materials for each type, showing finishes, typography, colors and surface texture as per sign typr drawing. The SM shall provide manufacturer's tychnical data and installation instuction, as required.
- 4.6. SM shall be responsible for all construction installation and internal support for safe and permanent installation of all signs.
- 4.7. SM is responsible for providing stamped engineering drawings where required (i.e. concrete bases / footings, etc.)
- 4.8. The SM shall provide certificate / letters indicating warranties for labor and materials of all provided signage. For 3D printing, a Lifetime Replacement Warranty is to be provided (except for obvious signs of vandalism)

5. Field Measurements:

5.1. The SM shall be responsible for field measurements as required to verify or supplement dimensions indicated in the contract and shall be responsible for accurate fit of signs upon installation.

6. Quality Assurance:

- 6.1. In the event of a discrepancy, error, ot incompatibility and / or applicales codes. The SM should notify the UTM FMP Project Manager in writing for direction on how to proceed.
- 6.2. The UTM Project Manager must be notified of any variation of conditions as shown on the drawings indicated above. It shall be the SM's responsibility to obtain the utilize the most current and up-to-date plans and specifications for all construction and installation work.

GENERAL NOTES:

1. Definitions:

1.1. UTM University of Toronto Mississauga 1.2. FMP Facilities Management and Planning 1.3 SC/SM Sign Consultant &/ or Manufacturer 1.4. Universal Washroom Accessible, Single User, All Gender Washroom 1.5. AED Automated External Defibrillator 1.6. OC On Centre 1.7. AFF Above Finished Floor 1.8. ID Identification

2. Overview:

- 2.1. Full shop drawings shall be provided by the SM review and approval by Architectural Consultant. Additional inquires or questions by the Architectural Consultant to directed to the UTM FMP Project Manager.
- 2.2. Proposed altenative signage to be submitted in writing to the UTM FMP Project Manaher prior to fabrication, supply or installation or signage.

3. Compliance Criteria:

- 3.1. Full compliance is mandatory on projects involving new construction and renovations.
- 3.2. Compliance is required to the extent practical and feasible for all projects involving major renovations and rework of existing signage. If older version(s) of signage is required in order to match existing signage in a particular area / suite, UTM FMP Project Manager shall provide written insstructions on how to proceed.

4. Work Included:

- 4.1. SM shall furnish all labor, materials, equipment, tools, supplies and services necessary and incidental to complete fabrication, installation, storage and delivery of signs(s) as specified.
- 4.2. SM shall be responsible for a complete and thorough job. Materials not specifically described but required for a complete and proper installation shall be identified and provided for the SC.
- 4.3. Full shop drawings to include all proposed text for any Room Names, Room Number / Number ranges and Braille messaging. Approval and confirmation of wayfinding department names to be done by UTM FMP Project Manager, prior to fabrication of signage



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Revisio	ons and issues record				
NORTH	HMARK	SEAL			

PROJECT TITLE

Pre-Engineered Building -Proposed Signage

DRAWING SHEET TITLE

General Notes

SCALE NTS

DRAWING NUMBE

SN-1

DATE June 25, 2024

UTM PROJECT NUMBER

P300-23-105

Section (00 00 02) : Interior Signage **General Notes**



UTM Standards: Renovation & New Construction Section (00 00 03) : Interior Signage **General Notes**



UTM Standards: Renovation & New Construction

GENERAL NOTES (Con't):

- 7.5. Directional signage and similar ones shall be mounted to the wall via screws and environmentally friendly silicon adhesive as required. The SM to verify site conditions and select appropriate type / size or anchors prior to installation. Affixing the directional signs to columns shall be carried out by means other than screws whenever possible. SM must verify with the UTM Project Manager prior any installation of directional signs or columns.
- 7.6. Care must be taken with the handling of signage panels and components to prevent staining caused by oils and other agents. They Signage Panels must be protected by appropriate covering during fabrication, delivery and on site handling storage.
- 7.7. The SM shall not use any hazardous substance in the manufacture of the signs, nor bring in any hazardous substances, regulated under any environmental laws, without the express written consent of the UTM Project Manager.
- 7.8. Upon completion of the project the SM shall provide the Owner with a manual and / or instructions on the care and maintenance of the signs and replacement of component parts, as applicable.

8. Typography:

- 8.1. All typographic layouts shall use typeface specified in each sign type drawing.
- 8.2. Letter forms and symbols shall be photographically or digitally rendered in precise, crisp, clean forms.
- 8.3 All letter form shall be free of ticks, discontinuous curves, line waves, cut or ragged edges, edge buildup, bleeding, surface pinholes and other imperfections. Letter form shall conform to proportions of the typographic font(s) as specified.
- 8.4. Helvetica Regular font to be used for interior signage unless otherwise specified.
- 8.5. Copy text including Braille shall be 3D digital print in all identification signs and in some other applications. It is the reponsibility of the SC/SM to verify these applications and ensure that is the necessary clearance around the signs (i.e., directory/modular signs) are maintained. If any other installations infringe upon this clearance, the SC/SM should notify the UTM Project Manager to guarantee the signs remain accessible and maintained beyond construction.

9. Shop Drawings & Submittals:

9.1. Signage Manufacturer to submit Shop Drawings and all finishes including any paint samples to me UTM FMP Designate for Review and written Approval to proceed prior to manufacturing any signs. All finishes on signs to be "factory finished" including paint.

GENERAL NOTES (Con't):

- 6.3. The SM shall use only personnel thoroughly experienced and skilled with the product and methods of fabrication and installation of sign specified. SM must be able to demonstrate five years of more of fabrication and installation experience in the architectural graphics industry.
- 6.4. Work done and material furnished shall meet as specifications. Signs and sign panels shall be flat, plumb, and without oil - canning. All edges and surfaces to be smooth and free from burrs or sharp edges.
- 6.5. The UTM Project Manager shall reserve the right to reject any shop drawings, samples, or submittals, as well as any finished product or installation that does not meet or exactly equal to the established quality of standard with no extra cost to the university. Any decision will be considered final and not subject to recourse.
- 6.6. Where applicable, all electrical and components shall display required manufacturer's safety and / or electrical labels (i.e. ULC) or approved equal standards as acceptable by the UTM Project Manager. Such labels and equipment shall not be displayed or positioned so as to detract from the aesthetic quality of each sign.
- 6.7. The SM must guarantee that only new materials are being used for the work included
- 6.8. Products must be made accessible for quality control inspection at any time.
- 6.9. Any claims for work carried out on instructions by others (not authorized by Architectural Consultant or UTM FMP Project Manager) will not be accepted or honoured.
- 6.10. Where applicable, high quality acrylic polyurethane paint shall be used, pending approval from the UTM Project Manager, to ensure high quality with desired color paint finish (typically to match adjacent metal laminate finish on sign panel).

7. General Conditions:

- 7.1. The SM is responsible for visiting the site and being familiar with its conditions prior to submitting a bid
- 7.2. The SM is to protect supplied goods from damage during installation with appropriate insurance against fire, theft, or any other damage.
- 7.3. The SM shall protect from damage the property of the Owner, which may be adjacent, or with which the SM may come in contact, and shall make good any such damage occurring through his fault.
- 7.4. The SM shall be responsible for using the proper procedures and installation methods needed to ensure appropriate fixation of the different sign type.



UNIVERSITY OF TORONTO MISSISSAUGA

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Issue No.	Description		Date	Drawn	Check
Revisio	ons and issues record				
NORTI	H MARK	SEAL			

PROJECT TITLE

Pre-Engineered Building -**Proposed Signage**

DRAWING SHEET TITLE

General Notes

SCALE NTS

DRAWING NUMBER

SN-2

Section (00 00 04) : Interior Signage **General Notes**

DATE June 25, 2024

UTM PROJECT NUMBER P300-23-105



UTM Standards: Renovation & New Construction Section (00 00 05) : Interior Signage General Notes

GENERAL NOTES (Con't):

9.2. Signage Contractor to submit "mock up" of EACH Signage Type to be manufactured for Project / Signage Order to UTM FMP Designate for Review and Written Approval to proceed prior to manufacturing any signage to be installed on site. All "mock ups' must have written Approval prior to manufacturing the FINAL version of the signs to be installed for each Signage Order / Projects.


10. Accessibility:

Where custom signs are introduced, the SC/SM must take the following into consideration:

- 10.1. In applications where braille is required, it shall be Grade 1, 3D digital print 1/32" (1mm) minimum above the surface to meet the Tri-Campus The Facility Accessibility Design Standard;
- 10.2. In application where tactile is required, the copy text shall be 3D digital print, raised 1/32" (1mm) minimum above the surface. Fonts types and sizes must meet the Tri-Campus Facility Accessibility Design Standard.
- 10.3. Characters, symbols and backgrounds on signs should have a matte or satin (non-glare) finish.
- 10.4. Custom signage placed on glass shall observe accessibility requirements while matching the building/department design scheme concept.
- 10.5. Installations of signs with brushed aluminum finish shall be avoided on concrere like finish due to contrast; SM to notify UTM FMP Project Manager in writing if new brushed aluminum signage is schedule to be installed these types of surface.
- 10.6. The minimum level of illumination over directional or informational signage shall satisfy accessibility and codes requirements.

11. Codes and References:

- 11.1. University of Toronto Branding / Visual Identity guidelines. Most current version. (Copyright 2024 or later when available)
- 11.2. University of Toronto Facility Accessibility Design Standard, June 9, 2023

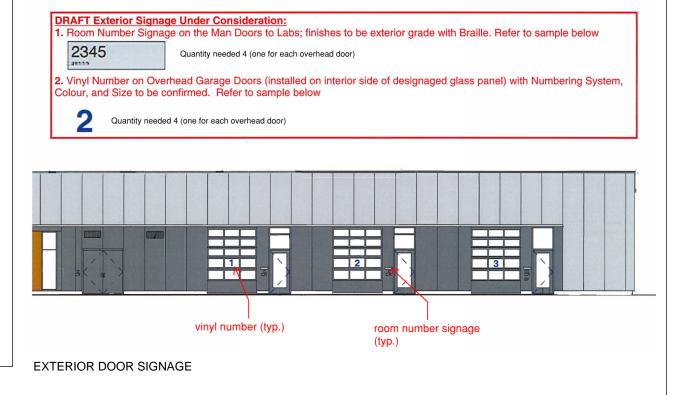





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SEAL

PROJECT TITLE

Pre-Engineered Building -Proposed Signage

DRAWING SHEET TITLE

General Notes


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UTM PROJECT NUMBER	
P300-23-105	

Font Type: Helvetical Regular (Typical for Interior Signage)

ABCDEFGHIJKLMNOPQRSTUVWXYZ abcdefghijklmnopqrstuvwxyz 1234567890

Note: All text and Braille to be 3D printed, not applied to sign panels / backgrounds.

Materials and Colors:

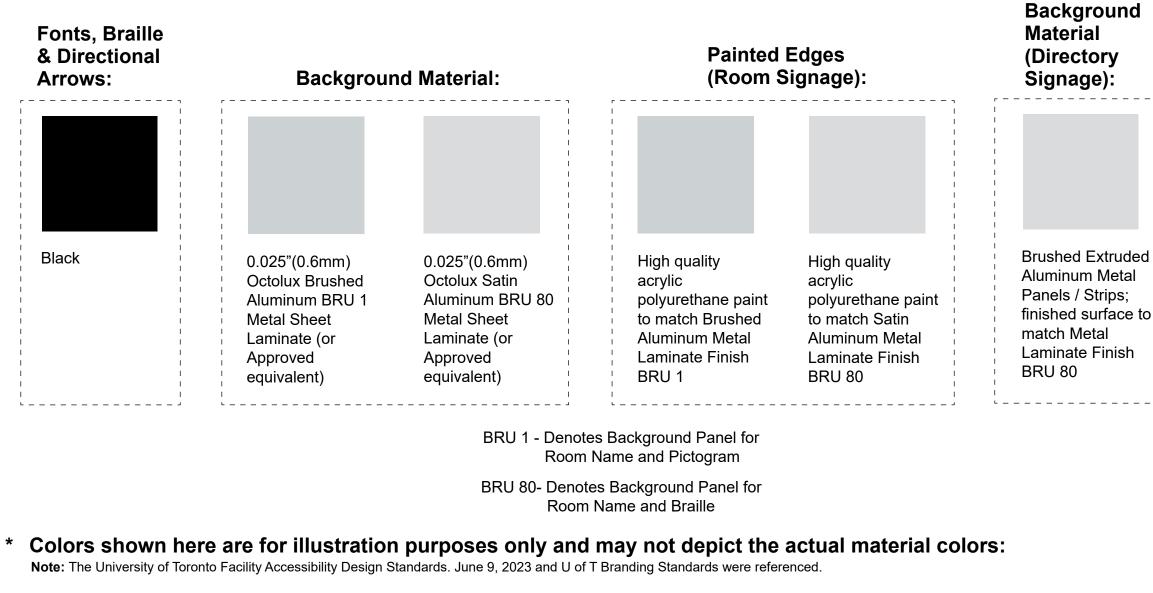





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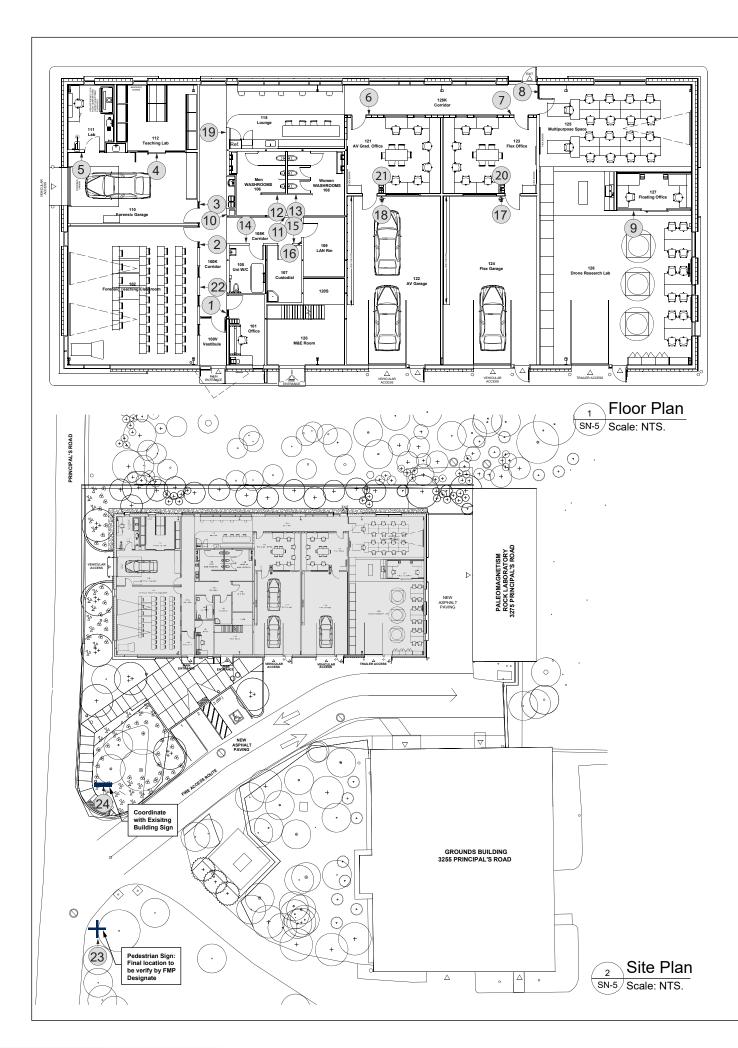
Fonts, Materials & Colors Interior Signs

SCALE NTS DATE

DRAWING NUMBER

SN-4

June 25, 2024 UTM PROJECT NUMBER P300-23-105



Note:

Room Numbers and Room Names may be subject to change.

Architectural Consultant to confirm Room Numbers and Room Names with the UTM FMP Project Manager prior to manufacturing signage.

Legend	Room Number Planning Name	Туре
Sign #1	101	ID-2INS white vin backer
Sign #2	102	ID-2INS white vir backer
Sign #3	110-112	ID-2INS white vir backer
Sign #4	112	ID-2INS
Sign #5	111	ID-2INS
Sign #6	121-122	ID-2INS
Sign #7	123-124	ID-2INS
Sign #8	125-127	ID-2INS white vir backer
Sign #9	127	ID-2INS white vin backer
Sign #10	100K Projecting Sign	ID-PRJ-AAGWR
Sign #11	105K Projecting Sign	ID-PRJ-AGWR
Sign #12	106 Men's Washroom	ID-MWR
Sign #13	108 Women's Washroom	ID-WWR
Sign #14	105 Universal Assisted Washroom	ID-UWR-AST
Sign #15	107 Custodial Closet	ID-FXD
Sign #16	109	ID-NINS
Sign #17	123	ID-2INS
Sign #18	121	ID-2INS
Sign #19	115	ID-NINS
Sign #20	124	ID-NINS
Sign #21	122	ID-NINS
Sign #22	100K Sub Directory	ID-SUB2-WMT
Sign #23	Exterior Pedestrian Sign	
Sign #24	Exterior Building Sign	

LEGEND:

- "5" Denotes Reference Number for new Room Sign. Arrow denotes approximate location of new wall mounted sign for that Reference Number. (#
- "109" Denotes Room Number "OFFICE" Denotes Room Name 109 OFFICE



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PROJECT TITLE

Pre-Engineered Building -Proposed Signage

DRAWING SHEET TITLE

Floor Plans, Site Plan and Legend

SCALE NTS DATE June 25, 2024

UTM PROJECT NUMBER P300-23-105

DRAWING NUMBER

SN-5



Sign Name	Sign Code	Sign Appearance & Area Use	Diagram / Photo	Signage Installation Details
Room Identificati	on Signage			
Fixed Room Number + Braille Language + Two (2) Different Sized Paper Inserts	ID-2INS	Sign Appearance Fixed Room + Braille Language + Two (2) Different Sized Paper inserts. Area Use: * Room Function is easily Changed * Room use Movable Furniture and Equipment * Posting of information is Required (i.e., schedules) Area use Examples (but not limited to): * Classroom * Laboratory (Teaching and Research) * Study / Meeting / Conference Room * Office * Student Residence Bedroom +TIP: Use when Posting of Information is Required and FMP Designate is to Confirm Consultant's selection during UTM Review Phase	Paper Insert 2345 IIIIII Paper Insert	 Location: Latch Side of Door * Wall Mounted - Double sided ta non-VOV silicon to be approved designate. * Side light Mount - White film loc and sign installed on top with do Provide white film on top of the to be install on top of the film. F same size of the sign.
Fixed Room Number + Braille Language + One (1) Sized Paper Inserts	ID-NINS	Sign Appearance Fixed Room + Braille Language + One (1) Sized Paper insert. Area Use: * Room Function is easily Changed * Room use Movable Furniture and Equipment * Posting of information is Required (i.e., schedules) Area use Examples (but not limited to): * Lounge * Laboratory (Teaching and Research) * Meeting / Conference Room +TIP: Use when Posting of Information is Required and FMP Designate is to Confirm Consultant's selection during UTM Review Phase	Paper Insert 2345	 Location: Latch Side of Door * Wall Mounted - Double sided ta non-VOV silicon to be approve designate. * Side light Mount - White film lo and sign installed on top with o Provide white film on top of the to be install on top of the film. F same size of the sign.
Fixed Room Number + Fixed Room Name + Braille Language	ID-FXD	Sign Appearance Fixed Room + Braille Language Area Use: * Room Function is NOT Easily Change Area use Examples (but not limited to): * Custodial Closets * Shipping and Receiving Areas +TIP: Limited Back-of-House areas. FMP Designate is to Confirm Consultant's selection during UTM Review Phase	Name line 1 Name line 2 Name line 3 2345	<u>Location:</u> Latch Side of Door * Wall Mounted - Double sided ta non-VOV silicon to be approve designate. * Or mounted on door if insufficie

Room Identification Signage Chart - Interior Signs



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PROJECT TITLE

Pre-Engineered Building -Proposed Signage

DRAWING SHEET TITLE

Room Identification Signage Chart Interior Signs

SCALE NTS DATE June 25, 2024 UTM PROJECT NUMBER P300-23-105

DRAWING NUMBER

SN-6

l tape and if required ved by FMP Operations

located on first surface double side tape. ne glass and new sign . Film should be the

d tape and if required oved by FMP Operations

located on first surface h double side tape. he glass and new sign h. Film should be the

l tape and if required ved by FMP Operations

cient adjacent wall space.

Sign Name	Sign Code	Sign Appearance & Area Use	Diagram / Photo	Signage Installation Details
Room Identificat	tion Signage			
Fixed Room Assisted + + Braille Language + Pictogram (Universal Assisted Washroom	ID-UWR-AST	<u>Sign Appearance</u> Fixed Room Name "All Gender" + Braille Language + Pictograms (s). <u>Area Use:</u> * Universal Assisted Washrooms	Assisted	<u>Location</u> : Latch Side of Door * Wall Mounted - Double sided ta non-VOV silicon to be approved designate. * Or mounted on door if insufficie
Projected Signs	ID-PJR-AAGWR	Sign Appearance Fixed Room Name "Accessible All Gender Washroom" + Pictograms (s). Area Use Examples (but not limited to): * All Washrooms * All Showers Rooms * All Ablution Rooms * Elevators (passenger and freight) * Exit Staircase Entrance (Interior Side)		 Location: Wall Mounted - Double sided tap and stainless-steel screws as per indicator (i.e., 4 or 6 screws per + Installed at a height most often a Projected with bracket for Optim Projected Unit is to be equip with 'interchanging" sign without affect Installation details will be provided Appendix
Projected Signs	ID-AGWR	<u>Sign Appearance</u> Fixed Room Name "All Gender Washroom" + Pictograms (s). <u>Area Use Examples (but not limited to):</u> * All Washrooms * All Showers Rooms * All Showers Rooms * All Ablution Rooms * Elevators (passenger and freight) * Exit Staircase Entrance (Interior Side)	Ť	 Location: Wall Mounted - Double sided tag and stainless-steel screws as per indicator (i.e., 4 or 6 screws per Installed at a height most often a Projected with bracket for Optim Projected Unit is to be equip with 'interchanging" sign without affect Installation details will be provided Appendix
Fixed Room + Braille Language + Pictogram (Women Washroom)	ID-WWR	Sign Appearance Fixed Room Name "Women Washroom" + Braille Language Pictograms (s). Area Use Examples (but not limited to): * All Washrooms * All Showers Rooms * All Ablution Rooms * Elevators (passenger and freight) * Exit Staircase Entrance (Interior Side)	Короловичиния Короловичиния Кананананананананананананананананананан	<u>Location</u> : + Wall Mounted - Double sided tag Installed at a height 1200 mm ble + Installation details will be provide Appendix
Fixed Room + Braille Language + Pictogram (Women Washroom)	ID-MWR	<u>Sign Appearance</u> Fixed Room Name "Men Washroom" + Braille Language Pictograms (s). <u>Area Use Examples (but not limited to):</u> * All Washrooms * All Showers Rooms * All Showers Rooms * All Ablution Rooms * Elevators (passenger and freight) * Exit Staircase Entrance (Interior Side)		<u>Location</u> : + Wall Mounted - Double sided tag Installed at a height 1200 mm bl + Installation details will be provide Appendix

Room Identification Signage Chart - Interior Signs



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1	Issued for Internal Discussion and Comments	06/25/2024	GF	MC
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3	Revised as per Comments	09/06/2024	GF	
4	Revised as per Comments	09/16/2024	GF	TF
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7	Revised as per Comments	11/15/2024	GF	M
8	Issued to Manju T. for Tender	11/19/2024	GF	TF
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PROJECT TITLE

Pre-Engineered Building -Proposed Signage

DRAWING SHEET TITLE

Room Identification Signage Chart Interior Signs

SCALE NTS DATE June 25, 2024 UTM PROJECT NUMBER P300-23-105

DRAWING NUMBER

SN-7

tape and if required ved by FMP Operations

ient adjacent wall space.

tape with screw anchors per the available sign' er sign) en above door height timum Visibility' with capability for ffecting mounting bracket vided in Manufacturing

tape with screw anchors per the available sign' er sign) en sign) en above door height otimum Visibility' with capability for affecting mounting bracket wided in Manufacturing

tape and silicon blow the sign vided in Manufacturing

tape and silicon blow the sign vided in Manufacturing

Appendix B - Informational / Code Compliant / Legislative Signage Chart

Sign Name	Sign Code	Sign Appearance & Area Use	Diagram / Photo	Signage Installation Details
Appendix B - Infe	ormational / Code	Compliant / Legislated Signage		
Mazimum Occupancy Sign	n/a	Sign Appearance Black text Graphics Applied on Second Surface of Acrylic Panel (1/4" Thick): all edges painted 'white' to match background 'white' Area Use Example (but not limited to): * Classroom * Lecture Theatre * Meeting Room * Conference Room * Laboratory * Gathering Areas *Note: Information to reflect design and approved occupancy details.	Maximum Occupancy 00 Persons	 <u>Location</u>: Walls * Wall Mounted - Double sided to non-VOV silicon to be approve designate. * Size of space to determine quantum
Automatic Door Operator (Sticker)	n/a	<u>Sign Appearance</u> Sticker to Represent Automatic Door Opener (ADO) (i,e,, Low Energy) <u>Area Use Examples (but not limited to):</u> * All Doors with ADO Hardware & Both Sides of Door	AUTOMATIC CAUTION DOOR ACTIVATE SWITCH TO OPERATE	<i>Location:</i> On Doors
Fire Pull Station	n/a	<u>Sign Appearance</u> "Material is toe be Rigid rather than Sticker Application <u>Area Use Example (but not limited to):</u> * As is Required by Code *Note: Locations and Final Quantity are specific to UTM Project and to be approved by UTM FMP Fire Prevention Officer	<section-header><section-header><section-header><section-header><section-header><section-header><section-header><section-header><section-header><section-header><section-header><text><text><text><text><text><text><text><text></text></text></text></text></text></text></text></text></section-header></section-header></section-header></section-header></section-header></section-header></section-header></section-header></section-header></section-header></section-header>	<u>Location:</u> + Wall Mounted - Double sided ta Installed at a height 1200 mm b + Installation details will be provid Appendix
'No Smoking / No Vaping Sign (Type 'A' and "E" Sticker or Metal) Quantity (To Be Determine by Consultantl)	n/a	Sign Appearance: (Ontario Ministry Sign) Sticker of Metal Area Use Examples (but not limited to): * One (1) sign per Double Building Doors, both Sides * All Exit Staircase Metal Doors, both Sides * These signs need to comply with: https://www.ontario.ca/page/no-smoking-no-vaping-signs-businesses * Or with the UTM FMP Designate, which ever is more stringent	Type A-Sticker	 <u>Location</u>: On Doors (both sides) Stickers sign on Interior installation Metal sign on Exterior Installation



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6	Received Email and Comments		/06/2024	GF	NIC
° 7	Revised as per Comments		/15/2024	GF	M
8	Issued to Manju T. for Tender		/19/2024	GF	TF

PROJECT TITLE

Pre-Engineered Building -Proposed Signage

DRAWING SHEET TITLE

Appendix B - Informational / Code Compliant / Legislative Signage Chart

SCALE NTS June 25, 2024 UTM PROJECT NUMBER P300-23-105

DRAWING NUMBER

SN-8

d tape and if required oved by FMP Operations

quantity of signs required.

t tape and silicon n blow the sign wided in Manufacturing

allation ation

DATE

Appendix B - Informational / Code Compliant / Legislated Signage

Sign Name	Sign Code	Sign Appearance & Area Use	Diagram / Photo	Signage Installation Details
Appendix B - Int	formational / Code	Compliant / Legislated Signage		
Health and Safety Sign (Sticker)	n/a	Sign Appearance Stiker Application (approximately 3" x 8") Area Use Examples (but not limited to): * Classrooms * Event Areas * Student Study Rooms * Student Common Areas *Note: Installation Location and Purchasing Cost per Unit to be Provided by UTM Environmental Health & Safety (EHS) Designate	EVENTSE MARKED IN CASE OF INJURY AND INCIDENT Control on many information Control on many info	Location: Wall Area Above Light St Area Entrance * Stickers to be self Adhesive
Siamese Connection	n/a	<u>Sign Appearance</u> Materials is to be Rigid rather than Sticker Application <u>Area Use Examples (but not limited to):</u> * As is required by Code *Note: Location and Final Quanttity are specific to UTM Project and to be approved by UTM FMP Fire Prevention Officer	FIRE DEPARTMENT CONNECTION	<u>Location</u> : (x2 Optionals) * Exterior Building Wall * Independent Post
Fire Route	n/a	Sign Appearance Factory Painted Metal Panels Area Use Examples (but not limited to): * As per City of Mississauga Requirements, Quantity and Locations * UTM FMP Designates are to be Conulted ir Required for assistance * New Signs to be Located on Existing or Bew Post as is determined by the City of Missisauga * New Post Sign specification and Locations are to be Approved by UTM Property Management	TIRE ROUTE VEHICLES WILL BE TOWED ON DRIVEWAY	<u>Location</u> : (x3 Options) * Exterior building Wall * Independent Post * Exisitng Post as per Distancing
UTM Campus Safety 'In Case of Emergency' Sign (Custom) Quantity (To Be Determined by Consultant)	n/a	Sign Appearance Factory Painted Metal Panels Text is White and Reflective with UTM blue background Size is 30" wide x 16" high (to match existing signs) Area Use Examples (but not limited to): * Test is to be Verified by UTM Campus Safety * New Signs to be Located on Existing or New Post as is determined by both UTM Campus Safety and UTM Property Management * Signs are Located along Pedestrian Pathways and Sidewalk Intersection *Note: UTM FMP Designate to Approve Location of New Building Panel Locations: Six (6) new Signs have been estimated, However final count is to be confirmed and are to included in this Project by both UTM Campus Safety and UTM Property Managemen	IN CASE OF EMERGENCY UTM Campus Safety 905-569-433 or call 9-1-1	<u>Location</u> : (x2 Options) * Installed on Existing Post(s) * Supply and Install new Post(s)



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1	Issued for Internal Discussion and Co	omments	06/25/2024	GF	MC
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PROJECT TITLE

Pre-Engineered Building -Proposed Signage

DRAWING SHEET TITLE

Appendix B - Informational / Code Compliant / Legislative Signage Chart

SCALE NTS DATE June 25, 2024 UTM PROJECT NUMBER P300-23-105

DRAWING NUMBER

SN-9

Switches at Room or

ng Required

Sign Name	Sign Code	Sign Appearance & Area Use	Diagram / Photo	Signage Installation Details
UTM Campus Ce	ntric Operational	Signage	-	
Fire Annuciator Panel (Municipal Address mounted above this Panel)	n/a	<u>Sign Appearance</u> 3-D Printing on Similar Materials as Room Identification Signs. <u>Area Use Examples:</u> * Primary Annunciator Panel * Secondary Annunciator Panel(s)	1599 Outer Circle	<u>Location</u> : Above building Fire Annuation * Double sided tape and if require to be approved by FMP Design
Automated External Defibrillator (AED) Sign (Projecting)	n/a	<u>Sign Appearance</u> Projecting Sign for Maximum Visibility. <u>Area Use Examples (but not limited to):</u> * As is Required by Code *Note: Locations and Final Quantity are specific to UTM Project and to be approved bu UTM Fire Prevention Officer	• escrestarian AED • AED	<u>Location</u> : Wall mounted Above AED * Double sided tape eith dvrew a Stainless Steel screws as per t indicator (i.e., 4 of 6 per sccrew
Fire Extinguisher (Sticker) Quantity (To Be Determine by Consultant)	n/a	Sign Appearance Sticker Application Area Use Examples (but not limited to): * At Each Individual Fire Extinguisher Location *Note: Locations and Final Quantity are specific to UTM Project and to be approved bu UTM FMP Fire Prevention Officer	FRUXT-ZGD-SIL	<u>Location</u> : Wall mounted Above Fin Stickers to be Self Adhesive
'Toilets are Flushed with Reclaimed Water	n/a	Sign Appearance Black Text Graphics Applied on Second Surface to Acrylic Pane (1/4" thick): All edges painted 'White to match background 'White' with Visual Graphics. Area Use Examples (but not limited to): * All Washroom Entries * All Washroom Interior Stall or Partition Doors *Note: This is only required if portable toiler water is affected	Toilets are flushed with Toilets are flushed with reclaimed water (*NOTE: Wording Does Not Reflect Finished Text, to be Approved by FMP Sustainability Designate)	<u>Location</u> : Partition and Stall Walls Double sided tape and to approv
Product Disposal Bin Sign (Sticker)	n/a	<u>Sign Appearance</u> Sticker Application ("Approximately 3' x 14". <u>Area Use Examples (but not limited to):</u> * All Washroom Interior Stall or Partition doors *Note:Artwork can be Provided by FMP Designate for Reproduction, or can be ordered from UTM Print Shop	<section-header><section-header><text><list-item><list-item><list-item><list-item><list-item><list-item></list-item></list-item></list-item></list-item></list-item></list-item></text></section-header></section-header>	<u>Location</u> : Individual Partition or Stall Stickers to be Self Adhesive



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PROJECT TITLE

Pre-Engineered Building -Proposed Signage

DRAWING SHEET TITLE

UTM Campus Centric Operational Signage Chart

SCALE NTS

DATE June 25, 2024 UTM PROJECT NUMBER P300-23-105 DRAWING NUMBER

SN-10

nuciator Panel(s)

ired non-VOC silicon ignate.

ED Unit

v anchors and er the available sign rews per sign)

Fire Extinguisher Unit

proved by FMP Designate

all Doors

Appendix C - Exterior Signage Chart

Sign Name	Sign Code	Sign Appearance & Area Use	Diagram / Photo	Signage Installation Details
Appendix C- Exte	erior Signage			
Accessible / Barrier Free Permit Parking	n/a	Sign Appearance Factory Painted Metal Panels Area Use Examples (but not limited to): * UTM FMP Designates are to be Consulted if Required for Assistance * New Signs to be located at the side walk as per site plan . * Confirm which parking spaces are 'Van Accessible' and the 'Maximum Fine' amount * New Post Sign specification and locations are to be approved by UTM Property Management * Accessible sign to be painted on the pavement 5'-0"h x 5'-0"w square * with light blue color and white.		 Location: New Post with Precast Concre Required metal signage secure weather resistance metal scre Supply and Install new Footing required; Professional Engined New Footings to suite condition Note: Sign Installation location and to be Approved by UTM FMF
Building ID (With Municipal Address Version) Quantity + 1	n/a	Sign Appearance Factory Painted Metal Panels Both Sides with University of Toronto Logo and Mississauga Campus Identifier if to be Visible from Multiple Directions Text is White and Reflective with International Symbol of Access (ASI) Area Use Examples (but not Limited to): * Required at the Building Entrance Closet to the Building Fire Annunciator Panel NOTE: 1. Sign Installation Location to be Approved by UTM FMP Designate 2. Building name and number to be finalized on a later date	UNIVERSITY OF DECONTO MISSISSAUCA BUILDING E E E	Location: Mounted on Posts with C & Footing * Signage Vendor to have a Profe stamp Shop Drawings for Footi assembly of precast concrete b hardware. Footings to suit site conditions.
Vehicular Directional (Wayfinding Indicator)	n/a	Sign Appearance Factory Painted Metal Panels Both Sides with University of Toronto Logo and Mississiauga Campus Identifier if to be Visible from Multiple Directions Text is White and Reflective Area Use Examples (but not limited to): * Supplement Existing Signs with new Building Identifier Panels on Both Sides * Building names and arrow to be finalized on a later date	↑ Instructional Centre ↑ Library ↑ Health Sciences Complex ↑ Parking Lots PB/P9/CCT ← Lislehurst	<u>Location</u> : Supplement Existing Cam * Signage Vendor to have Profess stamp Shop Drawings for Additi (i.e., fasterners and installation Note: Sign Installation Location and to be Approved by UTM FMP Design





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Issue No.	Description	Date	Drawn	Check

PROJECT TITLE

Pre-Engineered Building -Proposed Signage

DRAWING SHEET TITLE

Appendix C - Exterior Signage Chart

SCALE NTS

DRAWING NUMBER

SN-11

rete Base and Footing ured with appropriate crews and/ or hardware ings/ concrete bases if neer to stamp drawings tions

nd text on sign panels MP Designate

Concrete Base

ofessional Engineer otings, including e base, posts and

mpus Vehicular Signs


ssional Engineer litional Panel Installation n process at a minimum)


nd Text on Sign Panels ignate

DATE

June 25, 2024 UTM PROJECT NUMBER P300-23-105

Appendix C - Exterior Signage Chart

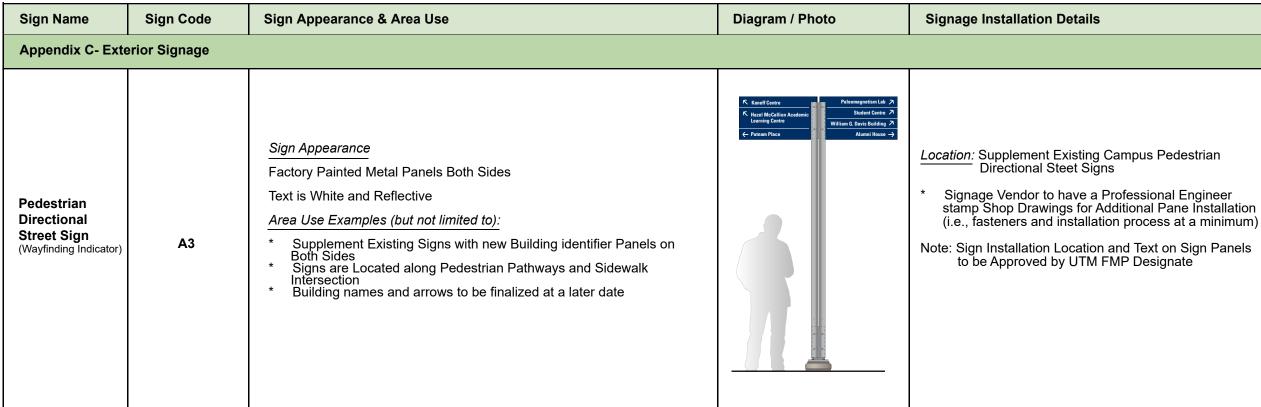

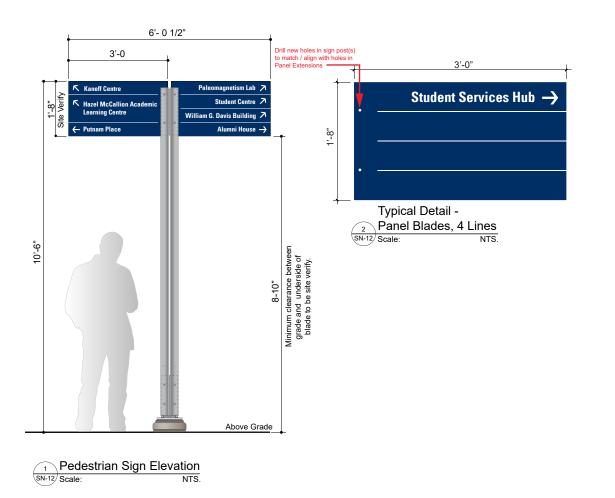

NOTE:

- 1. Maximum lines on each side not to exceed eight (8).
- 2. Minimum clearance between grade and underside of signage panel is 8'-10".
- 3. Orientation of arrows on each blade to be confirmed during site visit.
- 4. Submit shop drawings, sample of finishes and mock up of blade to UTM FMP Designate for written approval prior to manufacturing new blades.
- 5. Building names and arrows to be confirmed with UTM FMP Designate





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	d to Manju T. for Tender	11/19/2024	GF	TF
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2 Revis	ed as per Discussion and Comments	08/13/2024	GF	
1 Issue	d for Internal Discussion and Comments	06/25/2024	GF	MC
Issue	Description	Date	Drawn	Check
No.				

NORTH MARK

SEAL

PROJECT TITLE Pre-Engineered Building -Proposed Signage

DRAWING SHEET TITLE

Appendix C - Exterior Signage Chart

SCALE NTS

DRAWING NUMBER

SN-12

DATE June 25, 2024

UTM PROJECT NUMBER P300-23-105

Specification Legend for Room Identification / Catalogue Signage - Interior Signs:

- A 3M VPH tape or approved equivalent
- **B** 1/8"(3.2mm) thick 30/30 Green Edge face acrylic with notch for paper insert.
- **C** 1/32"(1 mm) raised thickness x 1"(25mm cab. Height, title case, Black direct 3D printed tactile copy. Font Helvetica Regular.
- **D** 0.025"(0.6mm) Octolux Brushed Aluminum BRU 1 aligned and laminated to the 1/8"(3.2mm) 30/30 Green Edge face acrylic. Room Number shall be verified with UTM FM&P Designate.
- E Braille, Grade 1, raised 1/32" (1 mm) minimum above the surface, color to match black font.
- F 1/4"(6mm) thick 30/30 Green Edge acrylic backer with opaque White vinyl on 2nd surface. Mounted on wall with double sided tape & silicone.
- **G** 0.025"(0.6mm) Octolux Brushed Aluminum BRU 1 aligned and laminated to the 1/8"(3.2mm) thick 30/30 Green Edge face acrylic
- H 0.025"(0.6 Mm) Octolux Satin Aluminum BRU 80 laminated to 1/4"(6mm) thick acrylic backer panel. Painted on the side to match Satin Aluminum. Mounted on wall with double sided tape & silicone. Room Name shall be verified with the UTM FM&P Designate.
- I 0.025"(0.6mm) Octolux Brushed Aluminum BRU 1 laminated to the 1/4"(6mm) thick acrylic backer panel. Painted on the side to match Brushed Aluminum. Mounted on wall with double sided tape & Silicone. Room Number shall be verified with the UTM FM&P Designate.

- J 1/32"(1mm) raised thickness x 1"(25mm) height. Black direct 3D printed tactile copy. Font: Helvetica regular. on 0.025"(0.6mm) Octolux Brushed Aluminum BRU 1 laminated to the 1/8"(3.2mm) thick 30/30 Green Edge face acrylic. Mounted on wall with double tape & silicone. Room Number shall be verified with the UTM FM&P Designate.
- K 0.025"(0.6mm) thick octolux satin Aluminum BRU 80 Single-sided Laminated to 1/4"(6mm) thick acrylic backer panel, Painted on the side to match Satin Aluminum, Mounted on wall with double tape & silicone.
- L Black direct 3d printing Pictograms Raised 1/32"(1mm) minimum above the surface
- M Braille, Grade 1, raised 1/32" (1mm) minimum above the surface (to meet City of Mississauga 2015 Facility Accessibility Design Standards); color to match black font. Braille should read "Women Washroom"
- **N** Braille, Grade 1, raised 1/32" (1mm) minimum above the surface (to meet City of Mississauga 2015 Facility Accessibility Design Standards); color to match black font. Braille should read "Men Washroom"
- **O** 0.020" thick Octolux Satin Aluminum **BRU 80 Double-Sided Sign Laminated** to 1/4" thick Aluminum backer panel.
- **P** Black 3D printing Pictograms Raised 1/32" minimum above the surface
- **Q** 1/4" thick Aluminum backer panel painted to match Satin Aluminum.
- **R** Countersunk Stainless Steel fasteners to suit wall conditions.
- **S** 1" x 1" x 1/4" Brushed Aluminum Angle Brackets

- **T** Braille, Grade 1, raised 1/32" (1 mm) minimum above the surface color to match black font. Braille to be read "Universal Assisted Washroom with Ceiling Lift and Adult Changing Table"
- U 1/32" thick x 1-1/4" high Black direct 3D printed tactile copy Font: Helvetica Regular on Brushed Aluminum Mate Finish.
- W End Cap to be Brushed Aluminum Mate Finish.
- X All text to be Black 3D printed tactile copy to the first surface. Modular Sign System: to Brushed Aluminum Mate Finish
- Y Directory mounted to wall via screw and silicone adhesive as required. Sign Manufacture to verify site conditions and, select appropriate type/size of anchors prior to installation. Sign Manufacturer to report any found discrepancies.
- **Z** Empty Horizontal panel for future use.





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NORTH MARK

Pre-Engineered Building -Proposed Signage

DRAWING SHEET TITLE


Specification Legend for Room Identification / Catalogue Signage -Interior Signs

SCALE NTS DATE


June 25, 2024 UTM PROJECT NUMBER P300-23-105

RAWING NUMBER

SN-13

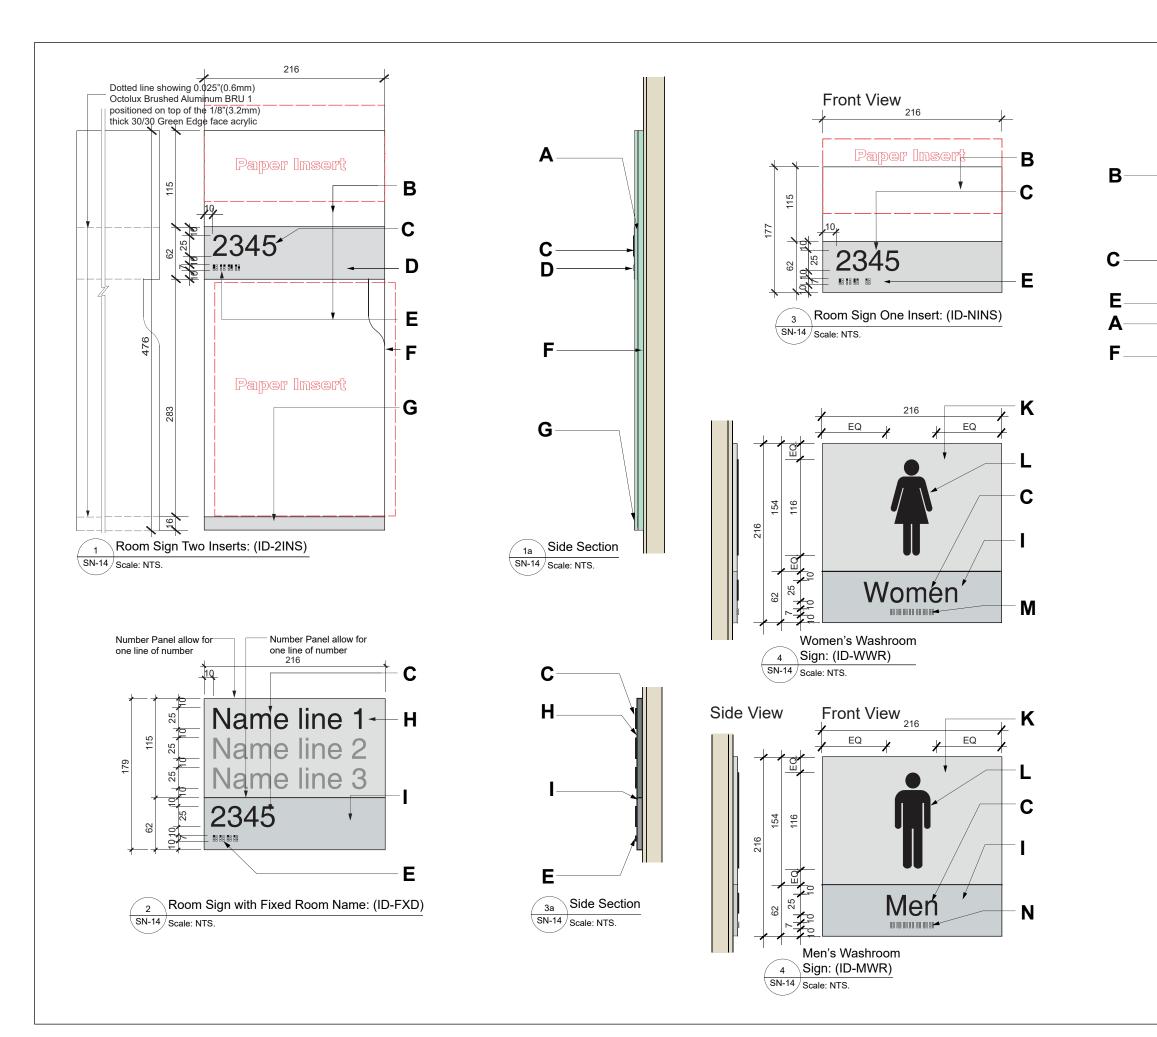

Side View

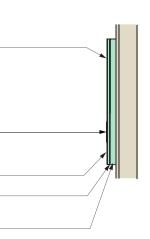



FACILITIES MANAGEMENT & PLANNING Maanjiwe nendamowinan 2nd Floor Suite 2220 3359 Mississauga Road, Mississauga, ON L5L 1C6

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8	Issued to Manju T. for Tender	11/19/2024	GF	TF
7	Revised as per Comments	11/15/2024	GF	MC
6	Received Email and Comments	11/06/2024	GF	
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2	Revised as per Discussion and Comments	08/13/2024	GF	
1	Issued for Internal Discussion and Comments	06/25/2024	GF	MC
Issue	Description	Date	Drawn	Check
No.	Revisions and issues record			

NORTH MARK

SEAL

PROJECT TITLE Pre-Engineered Building -Proposed Signage

DRAWING SHEET TITLE


Room Identification / Catalogue Signage - Interior Signs

SCALE NTS DATE

DRAWING NUMBER


SN-14

June 25, 2024 UTM PROJECT NUMBER P300-23-105

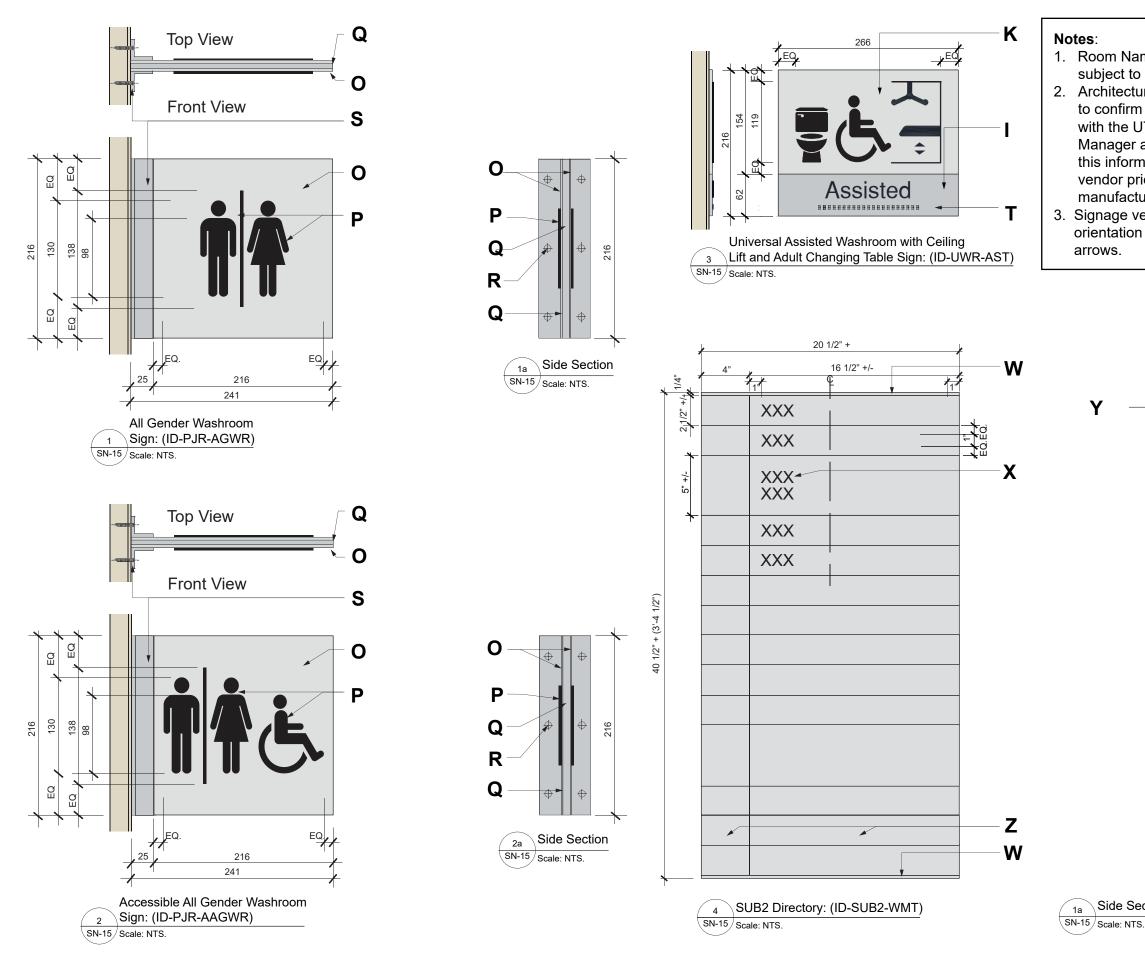

1. Room Names may be subject to change. 2. Architectural Consultant to confirm Room Names with the UTM FMP Project Manager and forward this information to signage vendor prior to manufacturing signage. 3. Signage vendor to confirm

orientation of signage

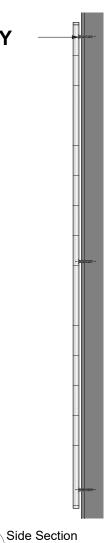



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NORTH MARK

SEAL

PROJECT TITLE

Pre-Engineered Building -Proposed Signage

DRAWING SHEET TITLE

Room Identification / Catalogue Signage - Interior Signs

SCALE NTS

DRAWING NUMBER

DATE June 25, 2024

UTM PROJECT NUMBER P300-23-105

SN-15



UTM Standards: Renovation & New Construction Section (10 14 25) : Exterior Panel Signage



UTM Standards: Renovation & New Construction Section (10 14 25) : Exterior Panel Signage

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1. GENERAL NOTES:

- 1.1. The design standards layouts and details are for design intent purposes only. Full stop drawings shall be provided by the Sign Consultant and or Manufacturer (SM) to be used as the final construction documents, and shall include complete construction, engineering and installation detail required for implementing described herein.
- 1.2. The designs specified in these standards and all the new signs to be specified and implemented in any of UTM buildings are / will be the property of the University of Toronto Mississauga (UTM)
- 1.3. Upon award of the contract, typical design templates, custom artwork and graphic layout shall be provided via electronic format for the production of sign layouts and lettering as provided by the UTM.
- 1.4. As anticipated / proposed signage types that are not included in these standards shall be submitted for a written approval by UTM / FMP designate prior to fabrication and installation.

2. WORK INCLUDED:

- 2.1. Sign Consultant / Contractor (SM) shall furnish all labor, materials, equipment, tools, supplies and services necessary and incidental to complete fabrication, installation and delivery of signs(s) as specified.
- 2.2. SC shall provided all material, equipment, services, labor tools, and supplies to fulfill completion of the contract. SM shall be responsible for a complete and through job. Materials not specifically described but required for a complete and proper installation shall be identified and provided by the SM.
- 2.3. SC shall be responsible for the quality of all materials and workmanship of any firms or individuals who act as his subcontractors. SM shall be responsible for providing subcontractors with complete and up-to-date drawings, specifications, sign schedule and other information issued for the project.
- 2.5. SC shall provide complete and comprehensive fabrication / installation liaison with all other trades. Where the SM is providing graphics only, it shall be the SM's responsibility to schedule his work to coincide with other trades fabrication, finishing and installation schedules.



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NORTH MARK

SEAL

PROJECT TITLE

Pre-Engineered Building -Proposed Signage

DRAWING SHEET TITLE

Exterior Panel Signage -Table of Contents and General Notes

SCALE NTS DATE

DRAWING NUMBER

SN-16

UTM PROJECT NUMBER P300-23-105

June 25, 2024

GENERAL NOTES (Con't):



UTM Standards: Renovation & New Construction Section (10 14 25) : Exterior Panel Signage



UTM Standards: Renovation & New Construction

- 2.6. The SM shall provide dimensioned shop drawing for all signs clearly showing materials, typographic layouts, fabrication methods, external finishes, anchorage, electrical connections and other details of construction as well as details related to engineering and other construction responsibilities.
- 2.7. SM is responsible for all construction installation and internal supports for a sage and permanent installation of signs. SM shall provide location detail drawings for signs supported or anchored to other construction.
- 2.8. SM is responsible for providing stamped engineering drawings where required.
- 2.9. Prior to any sign fabrication. SM shall provide sample for each sign product and material samples showing finishes, typography, letter spacing, colors and surface texture as requested by UTM and as indicated on sign type drawings.
- 2.10. The SM shall provide manufacturer's technical data and installation instruction for each type of sign required.

3. FIELD MEASUREMENTS:

3.1. The SM shall be responsible for field measurements as required to verify or supplement dimensions indicated in the contract documents and shall be responsible for accurate fit of signs upon installation.

4. MIN. REQUIRED TESTING:

- 4.1. Paint type automotive quality
- 4.2 Concrete 32 MPA C2: to 7% Air entrainment: Round stone / aggregate: concrete to be vibrated. (All requests to be submitted to UTM Facilities Management & Planning for approval)

5. REFERENCES

- 5.1. AODA guidelines
- 5.2 UofT branding / Visual Identity guidelines

6. WARRANTY:

6.1. 2 years

7. QUALITY ASSURANCE:

- 7.1. The intent of the drawings and contract documents package is to provide all information necessary for a complete the contract. In the event of a discrepancy, an error, neither one rules over the other, or incompatibility with regulations and / or required codes, the SM should notify UTM/Project Manager for direction or how to proceed.
- 7.2. The UTM/Project Manager must be notified of any violations of conditions as shown on these drawings. It shall be the SM's responsibility to obtain and utilize the most current and up-to-date plans and specifications for all construction and installation work.
- 7.3. The SM shall use only personnel thoroughly experience and skilled with the product methods of fabrication and installation of sign specified. SM must be able to demonstrate five years or more fabrication experience in the architectural graphics industry.
- 7.4. Work done and materials furnished shall be superior quality in every respect. Signs and sign panels shall be flat, plumb and without oil - canning. All edges and surface to be smooth and free from burrs.
- 7.5 The UTM/Project Manager shall reverse the right to reject any shop drawings, samples



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NORTH MARK

SEAL

PROJECT TITLE

Pre-Engineered Building -Proposed Signage

DRAWING SHEET TITLE

Exterior Panel Signage -General Notes

SCALE NTS DATE

DRAWING NUMBER

SN-17

Section (10 14 25) : Exterior Panel Signage

June 25, 2024 UTM PROJECT NUMBER

P300-23-105

GENERAL NOTES (Con't):



UTM Standards: Renovation & New Construction Section (10 14 25) : Exterior Panel Signage



Section (10 14 25) : Exterior Panel Signage

or other submittal s, as well as any finished product or installation that does meet or exactly equal the standard of quality established. Any such decision will be considered final and not subject to recourse.

- 8.6. All electrical components shall display required manufacturer's safety and / or electrical labels (UL/Hydro) or approved equal standards as acceptable by UTM/Project Manager. Such labels and equipment shall not be displayed so as to detract from the aesthetic guality of each sign.
- 8.7. The SM must guarantee that only new materials are being used for the work included.
- 8.8. Products must be made accessible for quality control inspection at any time.
- 8.9. Any claims for work carried out on instructions by others will not be accepted or honored.
- 8.10. All materials to be painted with high quality acrylic polyurethane, subject to approval from UTM/Project Manager, for high quality finish.

9. SUBSTITUTIONS:

9.1. Bidders shall submit (with bids), written notification of all proposed substitutions from specifications. Substitutions of any shall be approved to any sign fabrication or installation. No substitution will be considered without samples.

10. GENERAL CONDITIONS:

- 10.1. The SM is responsible for visiting the site and familiarizing himself with its conditions prior to submitting a bid.
- 10.2. The SC must familiarize himself with subsoil conditions which may affect engineering of footings / sign supports.
- 10.3. All necessary sign permits are to be obtain and paid for the SM.
- 10.4. SM is responsible for 'locates" (i.e. gas, phone, power lines etc.) Which may affect sign support / footings and locations.

- 10.5. SM is responsible for electrical and communications hookup and all internal wiring and supply of appropriate components (e.g. outdoor ballasts. etc.) for all signs. Unless otherwise specified, assume that 120V primary power will be made available by the UTM/Project Manager, to a point at the location of any illuminated signs. Final hookup will be the responsibility of the SM.
- 10.6. The SC is to protect goods supplied by him from damage during installation with appropriate insurance against fire, theft, or any damage. He shall protect from injury the property of the Owner, which may be adjacent, or with which he may come contact, and he shall make good any such damage occurring through his fault.
- 10.7. Care must be taken with the handling of signage panels and components to prevent staining caused by oils and other agents. They must be protected by appropriate covering during fabrication, delivery and on site storage.
- 10.8. The SM shall not use any hazardous substances in the manufacture of signs. nor bring on site any hazardous substances, regulated under any environmental laws, without the express written consent of the UTM.
- 10.9. Upon completion of the project the SM shall provide the Owner with a manual and / or instructions on the care and maintenance of the signs and replacement of component parts.

11. TYPOGRAPHY:

- 11.1. All typographic layout shall utilize typeface specified each sign type drawing. A digital version of the typeface shall be provided by he UTM/Project Manager. (Please refer to the CAD layouts PG 1-25 for more details).
- 11.2. Letterforms and symbols shall be photographically or digitally rendered in precise, crisp. clean forms. All letterforms shall be free of ticks, discontinuous curves, line waves, cut or ragged edges, edge buildup, surface pinholes, and other imperfections. Letterforms shall conform to proportion of the typographic font(s) as specified.

12. ACCESSIBILITY & SIGNS LOCATING CONSIDERATIONS:

12.1. A1.1 Building ID signs should be located adjacent to main entrance of the building per City of Mississauga by-law.



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PROJECT TITLE

Pre-Engineered Building -Proposed Signage

DRAWING SHEET TITLE

Exterior Panel Signage -**General Notes**

SCALE NTS

RAWING NUMBER


SN-18

UTM Standards: Renovation & New Construction

DATE June 25, 2024

UTM PROJECT NUMBER P300-23-105

GENERAL NOTES (Con't):

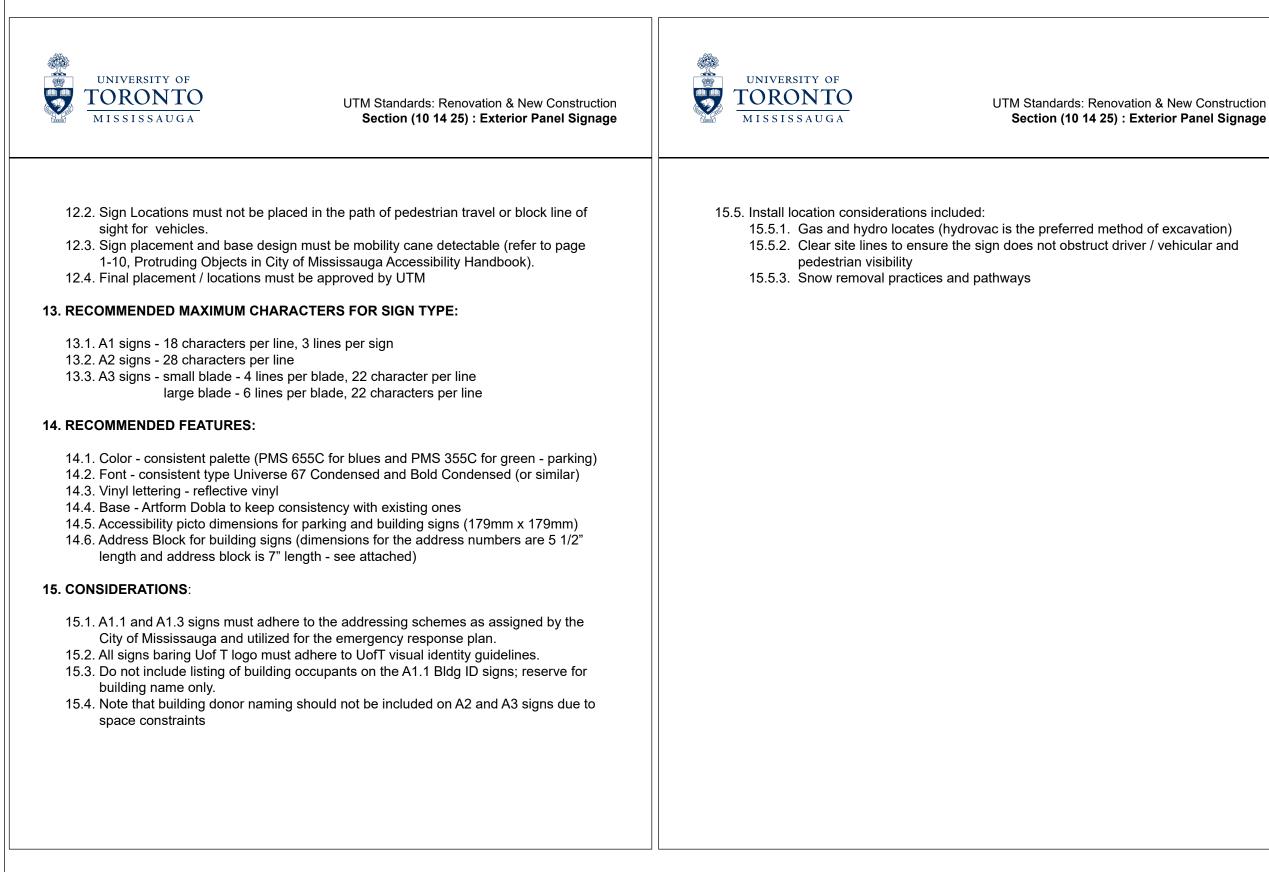



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PROJECT TITLE

Pre-Engineered Building -Proposed Signage

DRAWING SHEET TITLE

Exterior Panel Signage -**General Notes**

SCALE NTS

RAWING NUMBER

SN-19

Section (10 14 25) : Exterior Panel Signage


DATE June 25, 2024 UTM PROJECT NUMBER

P300-23-105

Font Types: Universe 67 Bold Condensed (Typical for Exterior Signage)

ABCDEFGHIJKLMNOPORSTUVWXYZ abcdefghijklmnopqrstuvwxyz 1234567890

Colors:

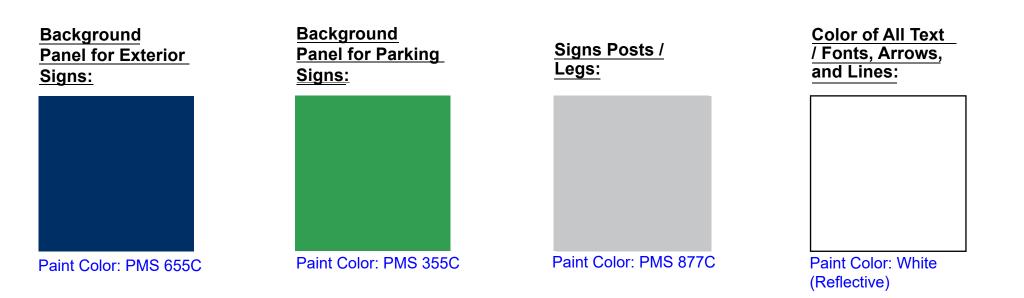

*Color blocks as shown on this page are for illustration purposes only and may not depict the actual material colors (Use Paint Color Codes). Note: The University of Toronto Facility Accessibility Design Standards. June 9, 2023 and U of T Branding Standards were referenced



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Pre-Engineered Building -Proposed Signage

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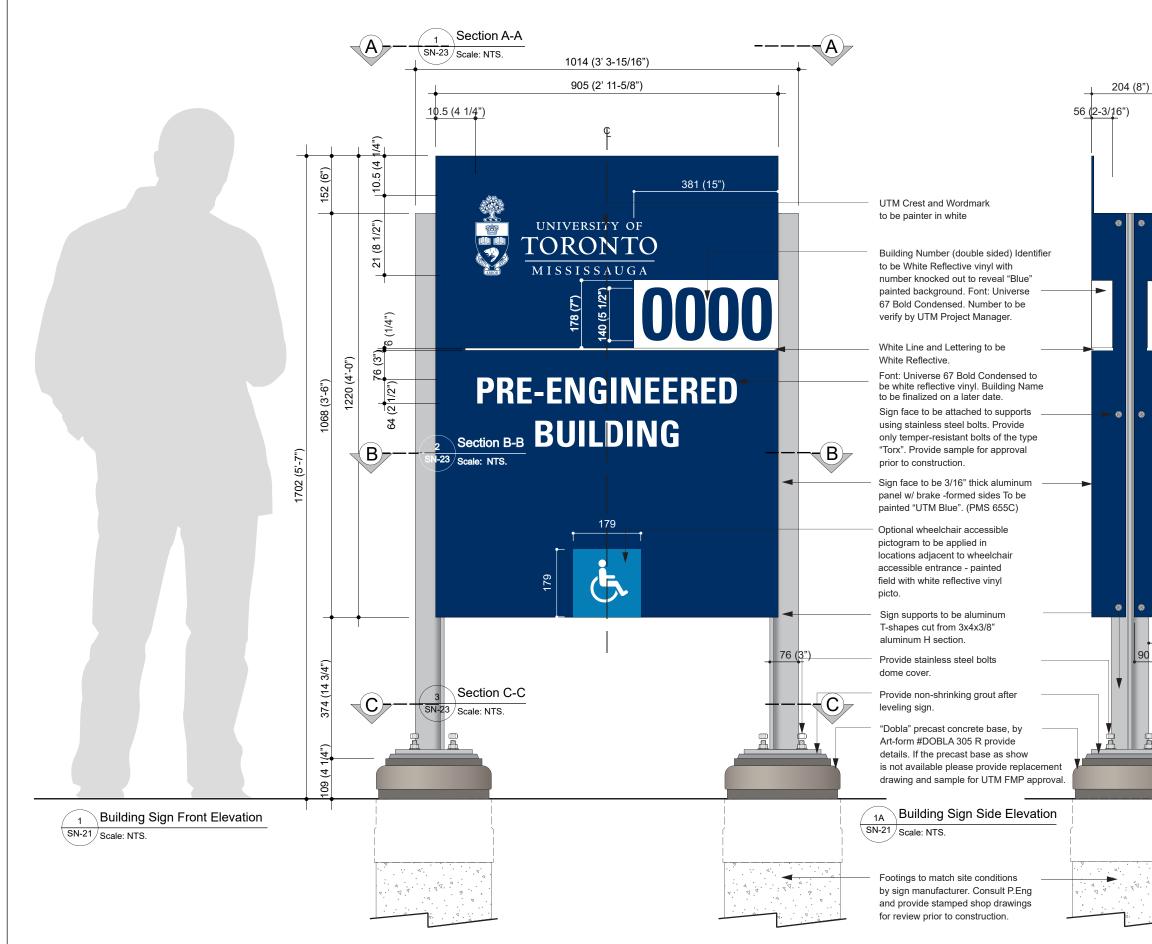
June 25, 2024 UTM PROJECT NUMBER P300-23-105

Fonts, Materials and Colors Exterior Sign

SCALE NTS DATE

DRAWING NUMBER

SN-20







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Pre-Engineered Building -Proposed Signage

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June 25, 2024 UTM PROJECT NUMBER P300-23-105


Building Sign Exterior -Front and Side Elevations

SCALE NTS DATE

DRAWING NUMBER

SN-21

56 (2 3/16) 90 (3 9/16")

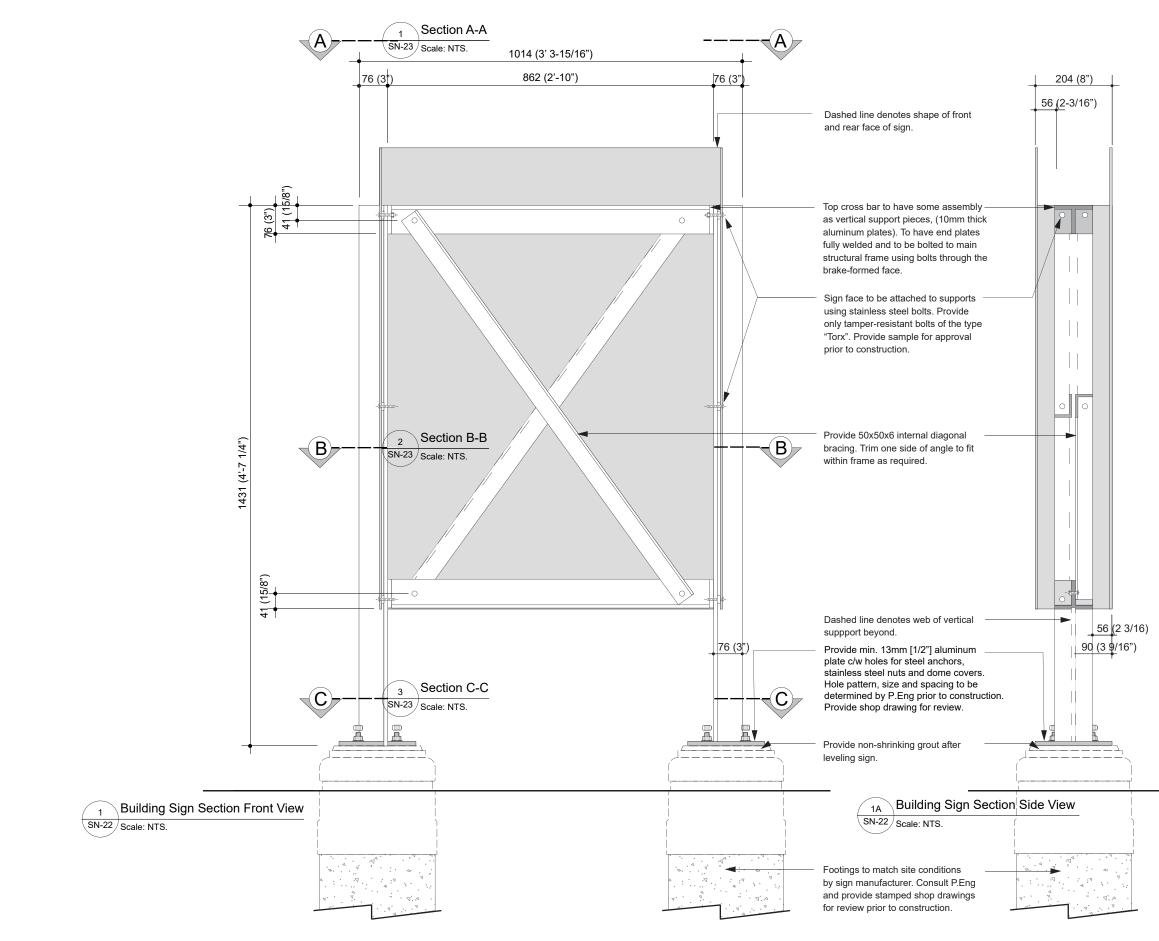





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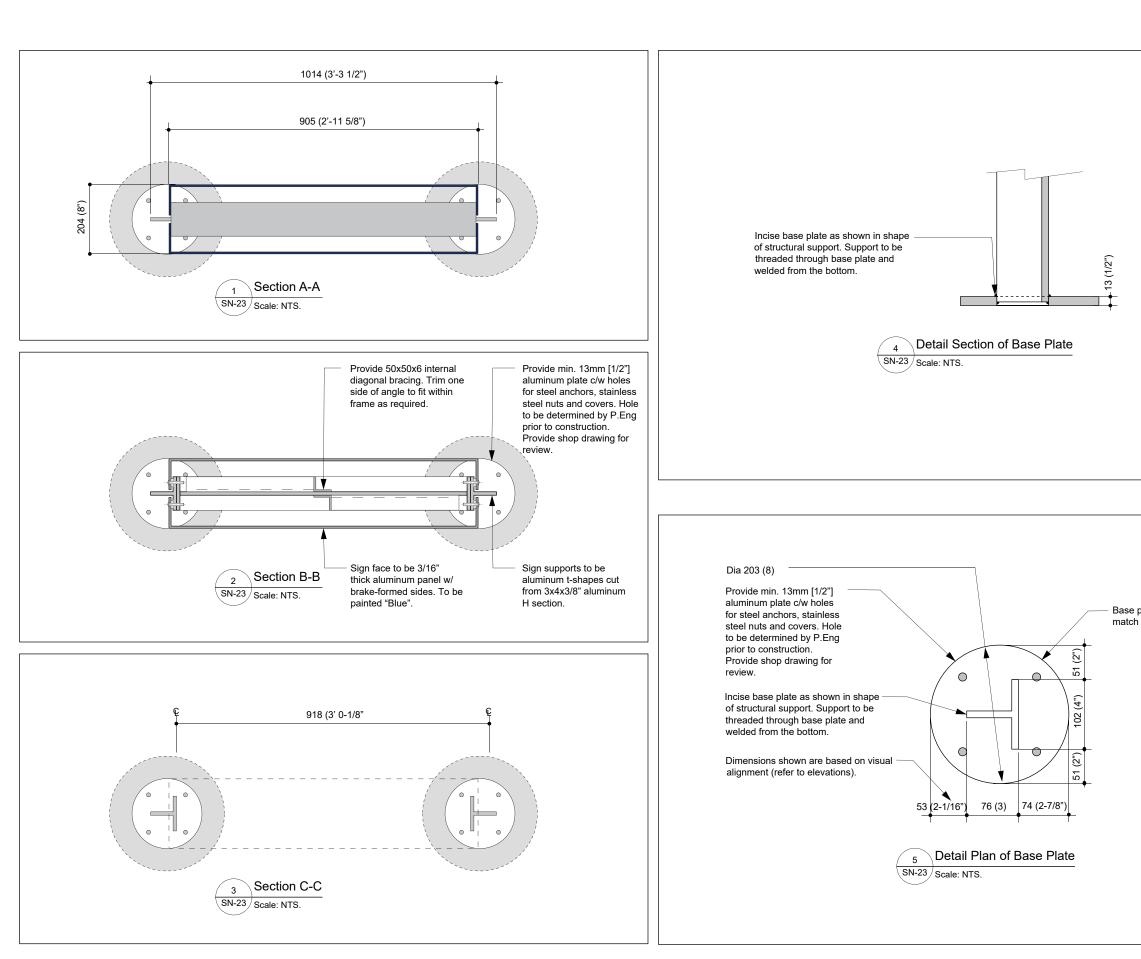
June 25, 2024 UTM PROJECT NUMBER P300-23-105

Building Sign Exterior Sections

SCALE NTS DATE

DRAWING NUMBER

SN-22





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NORTH MARK

SEAL

PROJECT TITLE

Pre-Engineered Building -Proposed Signage

DRAWING SHEET TITLE

Building Sign Exterior Sections and Details

SCALE NTS

DRAWING NUMBER

DATE June 25, 2024

SN-23

P300-23-105

UTM PROJECT NUMBER

Base plate to be painted to match "Silver" finish.