

GRILLES, REGISTERS AND DIFFUSERS SCHEDULE						
TAG	MANUFACTURER	MODEL	TYPE	SIZE	FINISH	REMARKS
A	E.H. PRICE	SCD	SQUARE CONE DIFFUSER	REFER TO FLOOR PLAN FOR NECK CONNECTION	BY ARCHITECT	1
B	E.H. PRICE	80	EGG GRATE RETURN	REFER TO FLOOR PLAN	BY ARCHITECT	1
C	E.H. PRICE	S10	LOUVERED GRILLE	REFER TO FLOOR PLAN	BY ARCHITECT	1, 2

NOTES:  
1. REFER TO SPECIFICATIONS FOR ADDITIONAL REQUIREMENTS.  
2. DEFLECTION

ELECTRICAL BASEBOARD HEATER SCHEDULE									
TAG	MANUFACTURER	MODEL	SERVICE	WIDTH (MM)	LENGTH (MM)	HEIGHT (MM)	HEAT OUTPUT (WATTS (W))	ELECTRICAL	REMARKS
BBH-01	QUELLET	QFM1008	ROOM 21	62	1069	150	1500 (S 12)	208/1/60	
BBH-02	QUELLET	QFM1008	ROOM 22	62	1206	150	1000 (S 41)	208/1/60	

- GENERAL NOTES**
- THE MECHANICAL CONTRACTOR SHALL VISIT THE SITE TO VERIFY EXISTING CONDITIONS PRIOR TO SUBMITTING BID. THIS SHALL BE DONE IN ORDER TO CORRELATE THE EQUIPMENT AND SERVICES TO BE INSTALLED AS SHOWN ON DRAWINGS AND THAT ADDITIONAL COSTS ARE INCLUDED IN BID TO ADDRESS ANY UNUSUAL CONDITIONS. THE CONTRACTOR SHALL BE RESPONSIBLE TO VERIFY THE DIMENSIONS OF ANY DISCREPANCIES, OMISSIONS, AND INTERFERENCES. CONTRACTOR SHALL NOTIFY ARCHITECT IMMEDIATELY TO CORRECT FOR ANY DISCREPANCIES.
  - ENSURE THAT ALL NEW AND EXISTING MECHANICAL EQUIPMENT REQUIRING MAINTENANCE IS ACCESSIBLE AND THAT ACCESS REQUIREMENTS ARE NOT OBSTRUCTED BY NEW OR EXISTING SERVICES AND STRUCTURE. COORDINATE WITH PROJECT MANAGER AND ALL OTHER TRADES. RETAIL MECHANICAL EQUIPMENT IN SUCH A WAY AS TO PROVIDE ALL ACCESS REQUIREMENTS. REFER TO SHOP DRAWINGS AND/OR MANUFACTURER'S RECOMMENDATIONS FOR ACCESS REQUIREMENTS. REPORT ANY OBSTRUCTIONS TO THE PROJECT MANAGER AND MECHANICAL ENGINEER PROVIDE ACCESS DISCREPANCIES TO BE AS SPECIFIED.
  - PROVIDE ALL REQUIRED CUTTING AND FINISHING OF EXISTING CEILINGS AND WALLS TO FACILITATE DEMOLITION AND THE INSTALLATION OF THE MECHANICAL SERVICES OUTLINES FOR THIS SCOPE OF WORK.
  - WORKING TO BE PERFORMED WITH STRICTEST ENVIRONMENTAL CONDITIONS FOR SMOKE AND FUME EVACUATION.
  - THE MECHANICAL DRAWINGS ARE PERFORMANCE DRIVEN. DIMENSIONS AND SHOW APPROXIMATE LOCATIONS OF EQUIPMENT AND CONNECTING SERVICES. ANY INFORMATION REQUIRING ACCURATE MEASUREMENT OF THE BUILDING ARE TO BE TAKEN AT THE SITE. DO NOT SCALE THE DRAWINGS, AND DO NOT USE THE DRAWINGS FOR PREPARATION WORK.
  - FOR CLARITY, NOT ALL EXISTING EQUIPMENT, DUCTWORK, PIPING, ETC. HAS BEEN SHOWN ON THE DRAWINGS. THE EXISTING EQUIPMENT, PIPES, DUCTS AND SERVICES ARE SHOWN FOR REFERENCE ONLY. EXACT LOCATIONS, SIZES AND DIMENSIONS SHALL BE DETERMINED ON SITE. WHERE INTERFERENCES EXIST, CONTRACTOR SHALL REMOVE THE NEW WORK TO SUIT THE EXISTING PIPING.
  - NOT ALL CONNECTIONS TO EQUIPMENT ARE SHOWN. REFER TO THE MANUFACTURER'S LITERATURE FOR ALL PIPING CONNECTIONS.
  - CONTRACTOR IS TO BE RESPONSIBLE FOR THE REMOVAL AND DISPOSAL OF ALL DUCTWORK AND EQUIPMENT AS SHOWN ON THE DEMOLITION PLAN.
  - COORDINATE ALL TEMPORARY SHUT DOWNING WITH THE OWNER.
  - SURVEY ALL AFFILIATED WORK AREAS AND REPORT ABNORMALITIES AND DISCREPANCIES TO COMBAT TAVAT.
  - WHERE EXISTING WORK SHALL BE REWORKED OR REMOVED, THE CONTRACTOR SHALL BE RESPONSIBLE FOR THE PROTECTION OF ALL EXISTING WORK. WHERE NECESSARY, THE CONTRACTOR SHALL BE RESPONSIBLE FOR THE PROTECTION OF ALL EXISTING WORK. WHERE NECESSARY, THE CONTRACTOR SHALL BE RESPONSIBLE FOR THE PROTECTION OF ALL EXISTING WORK.
  - IF ABSTRACTS CONTAINING MATERIAL IS SUSPECTED OR IDENTIFIED IN THE WORK AREA AND REQUIRED TO BE HANDLED AS PART OF THE DEMOLITION, THE CONTRACTOR SHALL BE RESPONSIBLE FOR THE PROTECTION OF SUCH MATERIAL WITHOUT A FORMAL ORDER FROM THE PROJECT MANAGER. REMOVAL OF SUCH MATERIALS TO ACCOMMODATE THE WORK DESCRIBED AND OUTLINED IN THESE DRAWINGS SHALL BE APPROVED THROUGH THE OWNER.
  - ALL ABANDONED OR OBSOLETE MECHANICAL SERVICES SUCH AS VALVES, PIPING, EQUIPMENT, INSTRUMENTATION, ETC. SHALL BE REMOVED WITHIN THE WORK AREA TO FACILITATE ALL NEW MECHANICAL WORK.
  - INSULATE ALL NEW DUCTWORK AND ANY EXISTING DUCTWORK WHERE INSULATION HAS BEEN REMOVED OR DAMAGED BY THIS WORK. REFER TO SPECIFICATIONS FOR ADDITIONAL REQUIREMENTS.
  - ANY FLOOR OR CEILING THAT HAS BEEN TOOK DOWN DUE TO INSTALLATION OF NEW EQUIPMENT OR INSTALLATION OF NEW PIPING OR DUE TO REMOVAL OF EXISTING PIPING MUST BE TILED AND PAINTED TO MATCH EXISTING.
  - ARRANGE FOR ANY AND ALL NECESSARY TIE-IN CONNECTIONS AND DETAIL CO-ORDINATE WHERE APPLICABLE. APPLY FOR DETAIL AND PAY FOR ALL TIE-IN FEES AND SERVICE CONNECTIONS FOR THE WORK AND THE INFORMATION REQUIRED BY AUTHORITIES (WATER, GAS, ELECTRICITY, ETC.) IN THE AREA WHERE THE WORK IS TO TAKE PLACE. INCLUDES TIE-IN COSTS WHERE APPLICABLE. ADVISE THE WORK HOP TO AND OBTAIN FROM THE PROJECT MANAGER AND PRESERVE VESSELS (V.O.), OR (EXISTING ENGINEERS REG.) AND (FS & PUL SAFETY REG.) BRANCHES OF T.S.A. AT THE END OF THE WORK. THE NEW PLANT SHALL BE FULLY TESTED.

Sheet List Table	
Sheet Number	Sheet Title
M-001	MECHANICAL LEGEND, EQUIPMENT SCHEDULES & DRAWING LIST
M-100	MECHANICAL KEY PLAN
M-200	SOUTH BUILDING - HVAC - TIE-IN & NEW WORK
M-300	MECHANICAL DETAILS & CONTROL SEQUENCES

CONTROLS	
SYMBOL	DESCRIPTION
	SUPPLY FAN
	RETURN FAN
	EXHAUST FAN
	HEATING COIL
	COOLING COIL
	FIRE-HEAT COIL
	FILTERS
	SUPPLY AIR
	EXHAUST AIR
	OUTDOOR AIR
	RETURN AIR
	MOTORIZED DAMPER
	MOTOR STARTER PANEL
	MOTOR CONTROL CENTER
	HUMIDIFIER
	NORMALLY OPEN POSITION
	NORMALLY CLOSED POSITION
	VARIABLE FREQUENCY DRIVE
	NORMALLY CLOSED CONTACT
	NORMALLY OPEN CONTACT
	FLOW SWITCH
	LEVEL SWITCH
	PRESSURE SWITCH
	ACTUATOR NORMALLY CLOSED POSITION (DE-ENERGIZED STATE)
	ACTUATOR NORMALLY OPEN POSITION (DE-ENERGIZED STATE)
	ACTUATOR FAIL OPEN POSITION
	ACTUATOR FAIL CLOSED POSITION
	ACTUATOR FAIL LAST POSITION
	TWO-POSITION ACTUATOR
	MODULATING ACTUATOR
	PRESSURE SENSOR
	DIFFERENTIAL PRESSURE SENSOR
	VELOCITY SENSOR
	HUMIDITY SENSOR
	TEMPERATURE SENSOR
	OCCUPANCY SENSOR
	CARBON MONOXIDE SENSOR
	NOX SENSOR
	OXYGEN SENSOR
	GAS DETECTION SYSTEM CONTROL PANEL
	VISUAL INDICATOR ALARM
	AUDIBLE INDICATOR ALARM
	BUILDING AUTOMATION SYSTEM
	ANALOG INPUT
	ANALOG OUTPUT
	DIGITAL INPUT
	DIGITAL OUTPUT
	BAS ADJUSTABLE SET POINT
	BACHET VARIABLE
	HAND-OFF-AUTO
	CONTROL WIRING

GENERAL	
SYMBOL	DESCRIPTION
	EXISTING TO REMAIN
	EXISTING TO BE DEMOLISHED
	EXISTING TO BE REMOVED FOR RELOCATION
	EXISTING RELOCATED IN NEW WORK
	NEW WORK
	CONNECT TO EXISTING
	AIRFLOW / PIPE FLOW DIRECTION
	PIPE TURNING DOWN
	PIPE TURNING UP
	PRESSURE REDUCING VALVE
	ROOM THERMOSTAT
	ROOM HUMIDISTAT
	PUMP
	CONTROL VALVE - TWO WAY
	CONTROL VALVE - THREE WAY
	ISOLATION VALVE
	BALANCING VALVE
	CHECK VALVE
	STRAINER - OVER 20MM WITH VALVED FLUSHING DRAIN
	PIPE BRANCH OFF TOP
	PIPE BRANCH OFF BOTTOM
	RELIEF VALVE
	PRESSURE GAUGE
	TEMPERATURE GAUGE
	CAP
	SOLENOID VALVE
	FUSIBLE LINK VALVE
	ELECTRIC HEAT TRACING

HEATING & COOLING PIPING	
SYMBOL	DESCRIPTION
	HEATING WATER RETURN
	HEATING WATER SUPPLY
	HEATING GLYCOL RETURN
	HEATING GLYCOL SUPPLY
	HIGH TEMPERATURE HEATING WATER RETURN
	HIGH TEMPERATURE HEATING WATER SUPPLY
	HIGH TEMPERATURE HEATING GLYCOL RETURN
	HIGH TEMPERATURE HEATING GLYCOL SUPPLY
	CONDENSER WATER RETURN
	CONDENSER WATER SUPPLY
	CHILLED WATER RETURN
	CHILLED WATER SUPPLY
	CHILLED GLYCOL RETURN
	CHILLED GLYCOL SUPPLY
	CONDENSATE DRAIN
	PUMPED CONDENSATE
	REFRIGERANT GAS
	REFRIGERANT LIQUID
	LOW PRESSURE STEAM
	LOW PRESSURE CONDENSATE
	HIGH PRESSURE STEAM
	HIGH PRESSURE CONDENSATE
	VENT
	STEAM VENT
	GEO-EXCHANGE SUPPLY
	GEO-EXCHANGE RETURN
	FUEL OIL SUPPLY
	FUEL OIL RETURN
	FUEL OIL VENT
	FUEL OIL OVERFLOW
	UNION
	MANUAL AIR VENT
	AUTOMATIC AIR VENT
	EXPANSION COMPENSATOR
	EXPANSION LOOP
	PIPE ANCHOR
	PIPE GUIDE
	PIPE SLEEVE
	FLOAT & THERMOSTATIC TRAP
	INVERTED BUCKET TRAP
	BASEBOARD HEATER
	RADIANT PANEL TYPE - HEAT OUTPUT
	CABINET UNIT HEATER
	UNIT HEATER

VENTILATION	
SYMBOL	DESCRIPTION
	FUSIBLE LINK FIRE DAMPER (DOUBLE LINE)
	FUSIBLE LINK FIRE DAMPER (SINGLE LINE)
	SMOKE DAMPER (DOUBLE LINE)
	SMOKE DAMPER (SINGLE LINE)
	COMBINATION SMOKE/FIRE DAMPER (DOUBLE LINE)
	COMBINATION SMOKE/FIRE DAMPER (SINGLE LINE)
	BACK DRAFT DAMPER (DOUBLE LINE)
	BACK DRAFT DAMPER (SINGLE LINE)
	BALANCING DAMPER (DOUBLE LINE)
	BALANCING DAMPER (SINGLE LINE)
	MOTORIZED DAMPER (DOUBLE LINE)
	MOTORIZED DAMPER (SINGLE LINE)
	RECTANGULAR DUCTWORK - DIMENSION AS SHOWN
	ROUND DUCTWORK - DIMENSION AS SHOWN
	DUCTWORK (SINGLE LINE) - DIMENSION AS SHOWN
	RECTANGULAR SUPPLY/OUTDOOR AIR DUCT UP
	RECTANGULAR EXHAUST/RETURN AIR DUCT UP
	CIRCULAR SUPPLY/OUTDOOR AIR DUCT UP
	CIRCULAR EXHAUST/RETURN AIR DUCT UP
	RECTANGULAR SUPPLY/OUTDOOR AIR DUCT DOWN
	RECTANGULAR EXHAUST/RETURN AIR DUCT DOWN
	CIRCULAR SUPPLY/OUTDOOR AIR DUCT DOWN
	CIRCULAR EXHAUST/RETURN AIR DUCT DOWN
	MITRED ELBOW WITH TURNING VANES
	DUCT RISE (DOUBLE LINE)
	DUCT RISE (SINGLE LINE)
	SUPPLY GRILLE - DIMENSIONS AS SHOWN ON SCHEDULE
	EXHAUST/RETURN GRILLE - DIMENSIONS AS SHOWN ON SCHEDULE
	CEILING SUPPLY AIR DIFFUSER - DIMENSIONS AS SHOWN ON SCHEDULE
	LINEAR SLOT DIFFUSER - DIMENSIONS AS SHOWN ON SCHEDULE
	CEILING EXHAUST/RETURN GRILLE - DIMENSIONS AS SHOWN ON SCHEDULE
	SUPPLY AIR ROUND DIFFUSER
	BRANCH TAKE-OFF WITH ADJUSTABLE SPLITTER DAMPER IN SUPPLY DUCT (DOUBLE LINE)
	BRANCH TAKE-OFF WITH ADJUSTABLE SPLITTER DAMPER IN SUPPLY DUCT (SINGLE LINE)
	OPEN ENDED DUCT WITH BALANCING DAMPER AND BELLMOUTH DIRECTION AS SHOWN (DOUBLE LINE)
	OPEN ENDED DUCT WITH BALANCING DAMPER AND BELLMOUTH DIRECTION AS SHOWN (SINGLE LINE)
	FLEXIBLE DUCT CONNECTION
	ACOUSTICALLY LINED DUCTWORK (DOUBLE LINE)
	ACOUSTICALLY LINED DUCTWORK (SINGLE LINE)
	DUCT SILENCER
	FLEXIBLE DUCT (DOUBLE LINE)
	FLEXIBLE DUCT (SINGLE LINE)
	FLEXIBLE DUCT CONNECTION WITH BALANCING DAMPER ON TAKE-OFF
	DUCT MOUNTED HEATING COIL (DOUBLE LINE)
	DUCT MOUNTED HEATING COIL (SINGLE LINE)
	SUPPLY AIR TERMINAL BOX CW REHEAT COIL AND ATTENUATOR
	SUPPLY AIR TERMINAL BOX CW ATTENUATOR
	RETURN / EXHAUST AIR TERMINAL BOX ATTENUATOR
	FIRE RATED DUCTWORK (DOUBLE LINE)
	DUCT TRANSITION FROM RECTANGULAR TO ROUND
	RECTANGULAR DUCT BREAK
	ROUND DUCT BREAK
	SINGLE LINE DUCT BREAK
	TRANSFER AIR DUCT
	SUPPLY AIR LIGHT TRIPPER
	75mm (3/4") DOOR UNDERCUT



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NO.	ISSUE/REVISION	DATE
3	ISSUED FOR IFIT	2024-12-03
2	ISSUED FOR BP	2024-05-03
1	ISSUED FOR COORDINATION	2024-05-01
	ISSUE/REVISION	DATE

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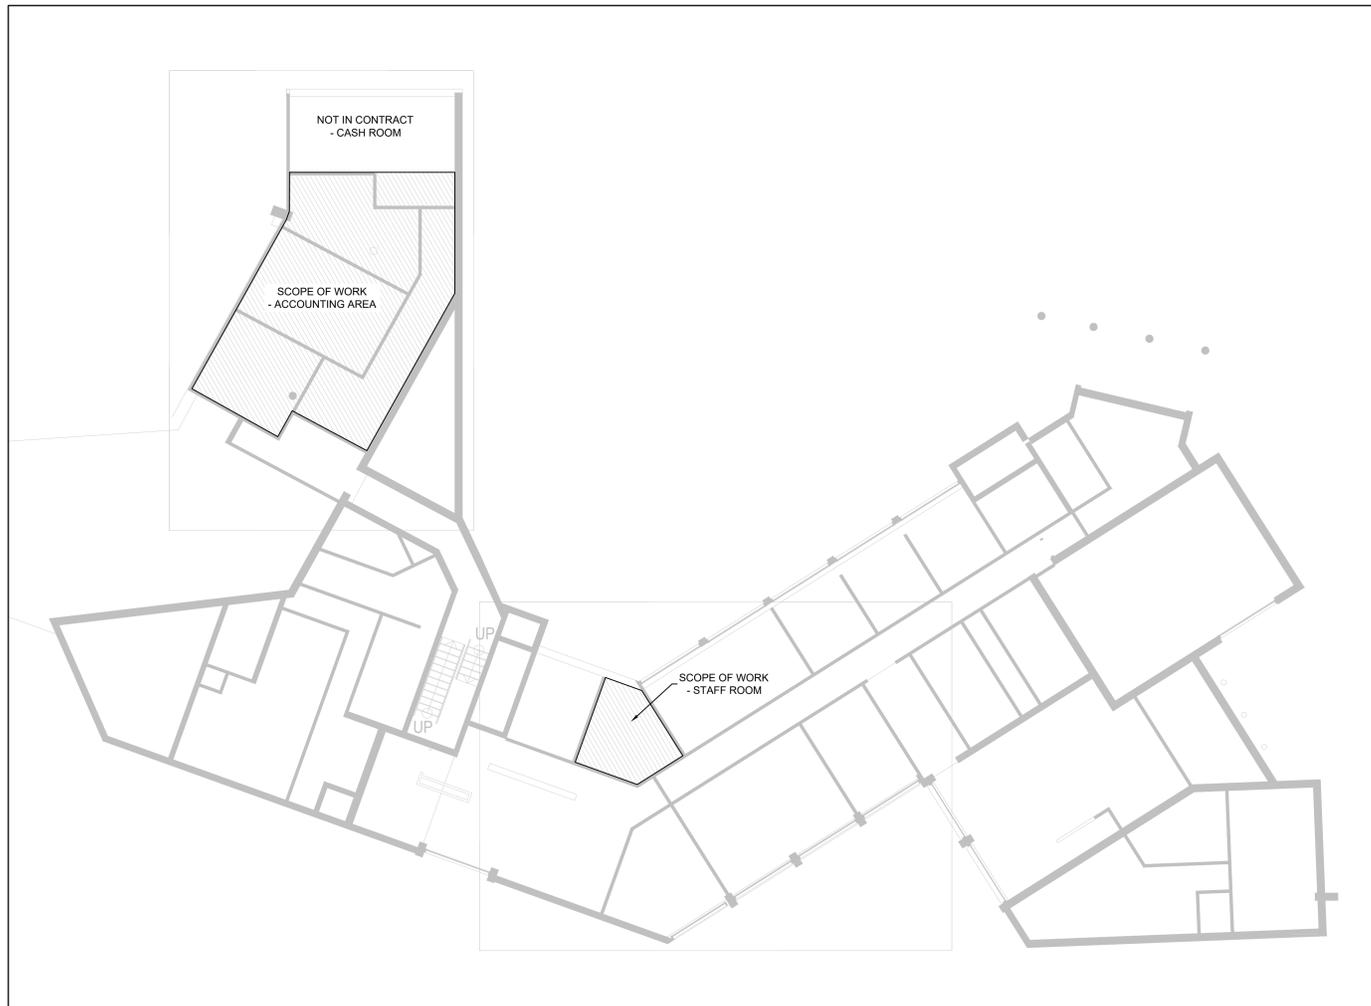
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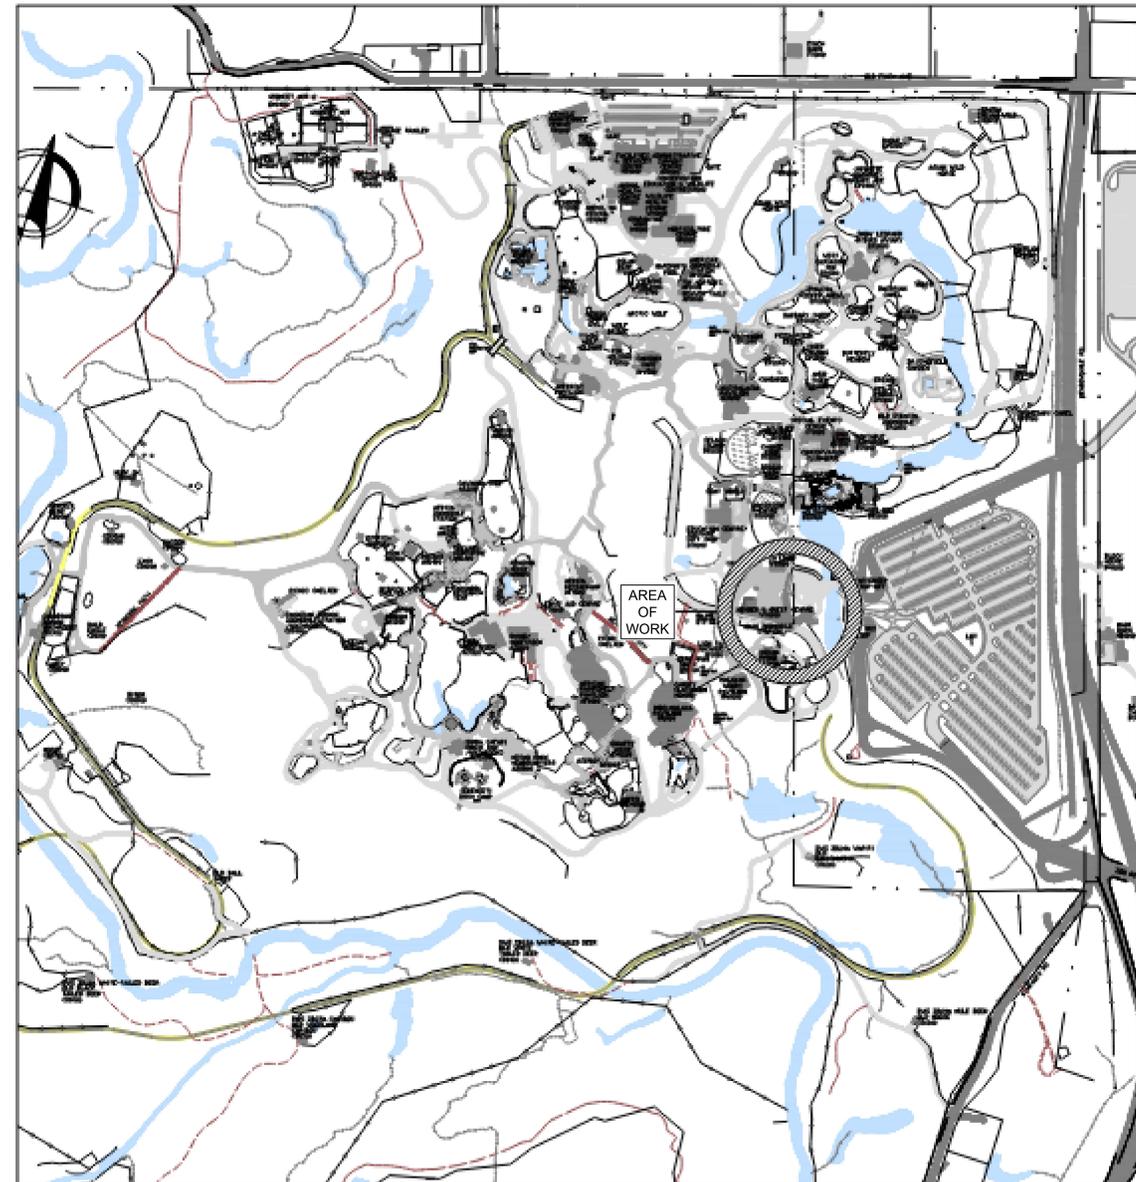
N.T.S.

PROJECT NO.

CM-23-257



**2 MECHANICAL KEY PLAN**  
SCALE: N.T.S.



**1 TORONTO ZOO - SITE PLAN**  
SCALE: N.T.S.

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3	ISSUED FOR IFT	2024-12-03
2	ISSUED FOR IFT	2024-09-03
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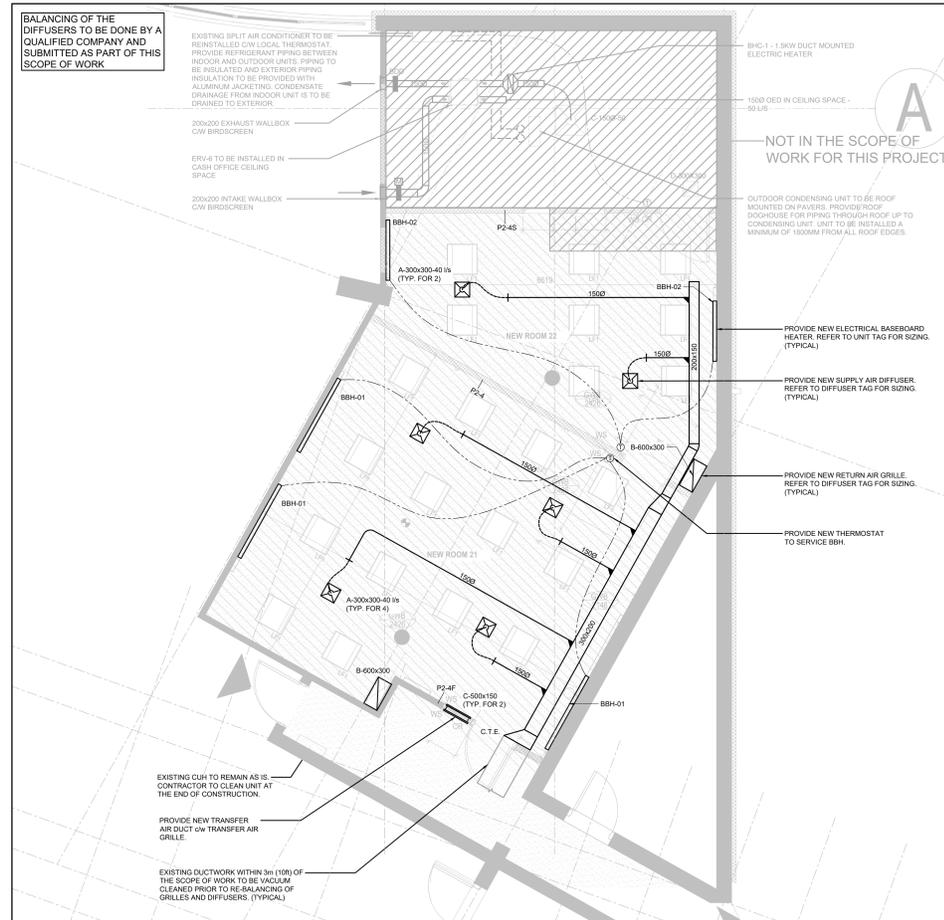
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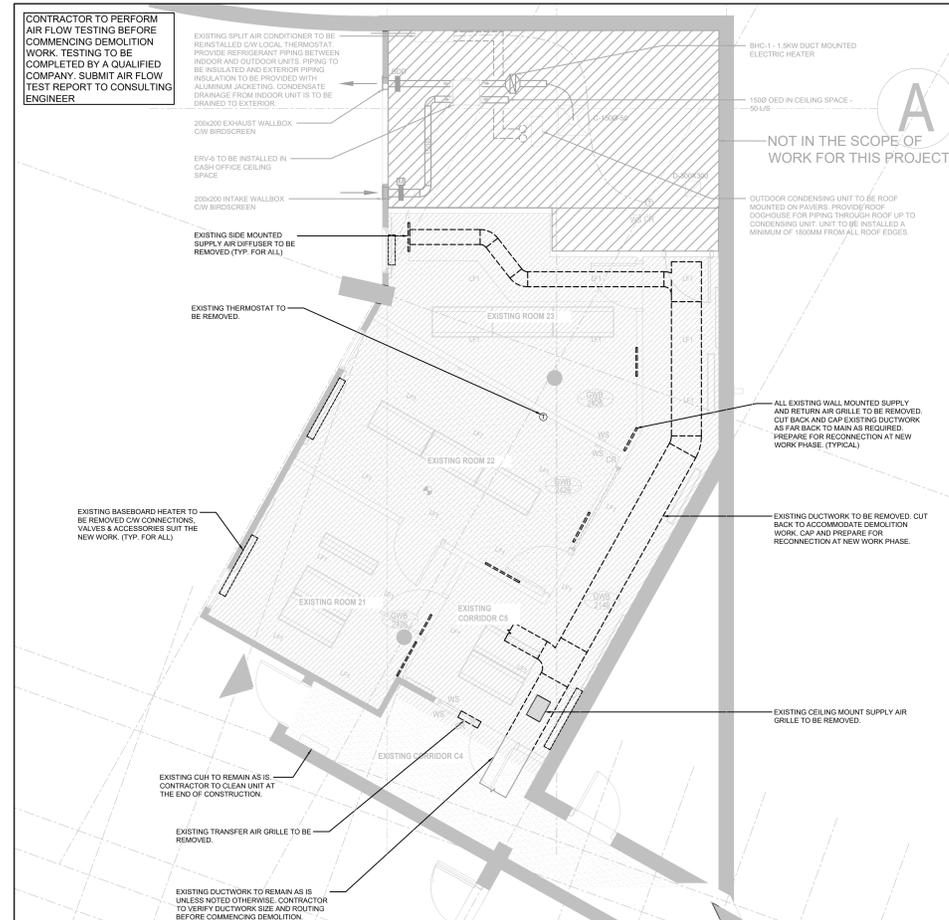
TITLE \_\_\_\_\_

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CHECKED: M.H.  
DATE: 2024-04-23  
SCALE: AS SHOWN


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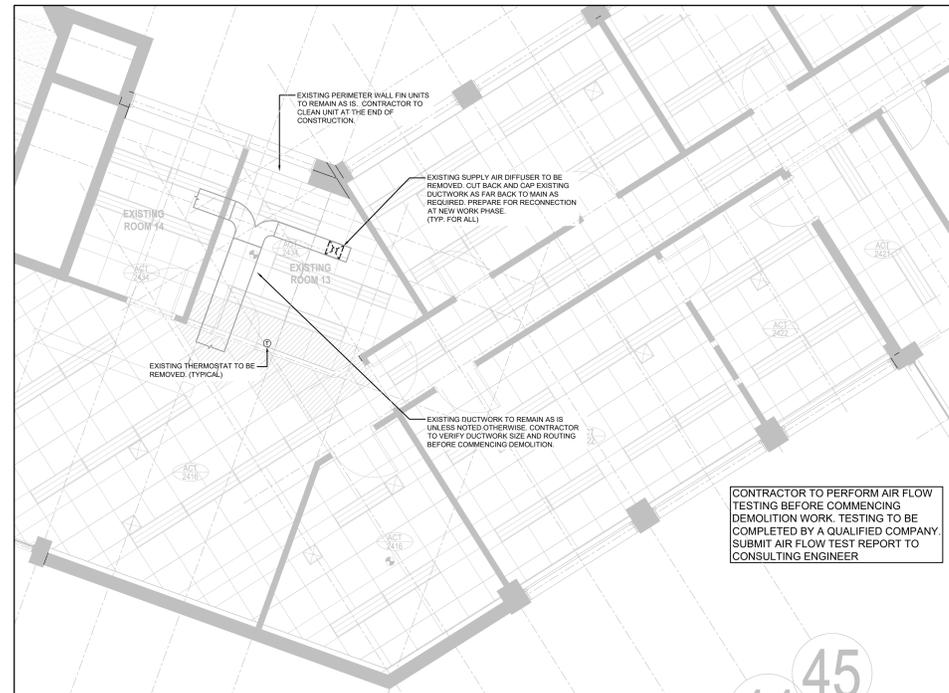
4 ACCOUNTING AREA - VENTILATION - NEW WORK  
SCALE: 1:50



2 ACCOUNTING AREA - VENTILATION - DEMOLITION  
SCALE: 1:50



3 STAFF ROOM 13 - VENTILATION - NEW WORK  
SCALE: 1:50

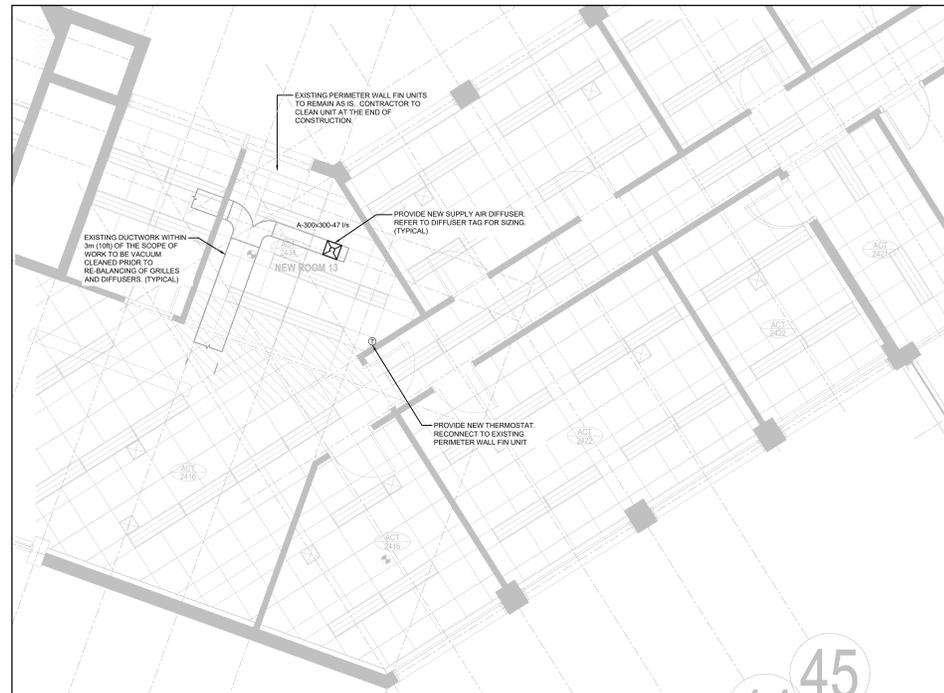

1 STAFF ROOM 13 - VENTILATION - DEMOLITION  
SCALE: 1:50

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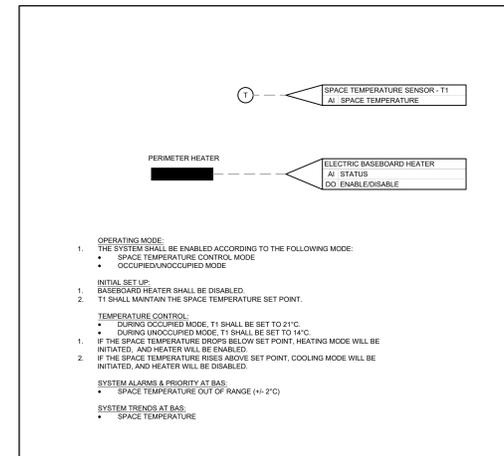
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DATE 2024-04-23


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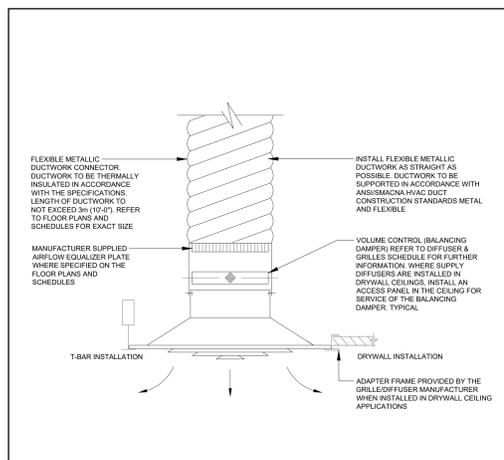
M-200 SOUTH BUILDING - HVAC - DEMO & NEW WORK




BASEBOARD HEATER CONTROL SEQUENCE  
NOT TO SCALE




23 30 42.02 CEILING MOUNTED GRILLE  
NOT TO SCALE

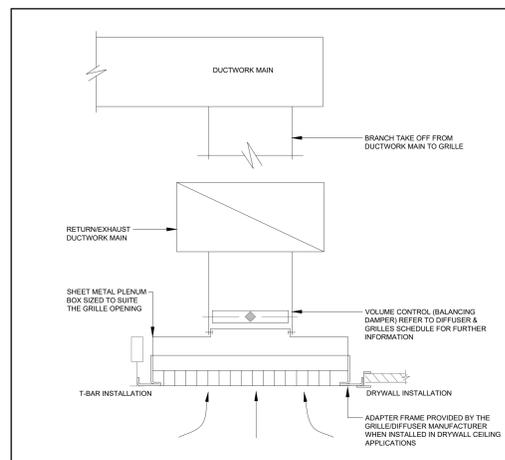


23 30 42.01 CEILING MOUNTED DIFFUSER  
NOT TO SCALE

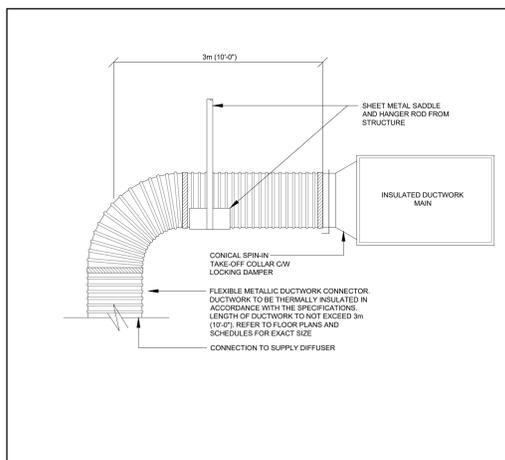


23 30 09.01 FLEXIBLE METALLIC DUCTWORK  
NOT TO SCALE

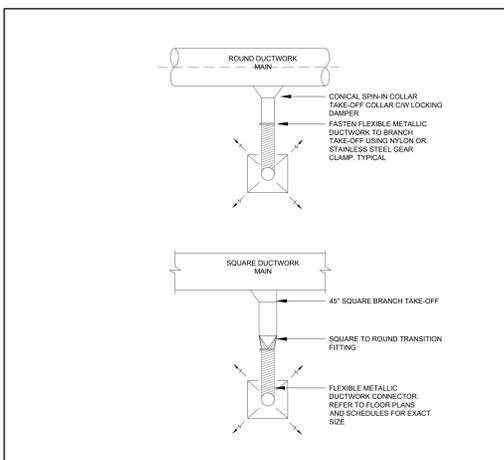


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NOT TO SCALE

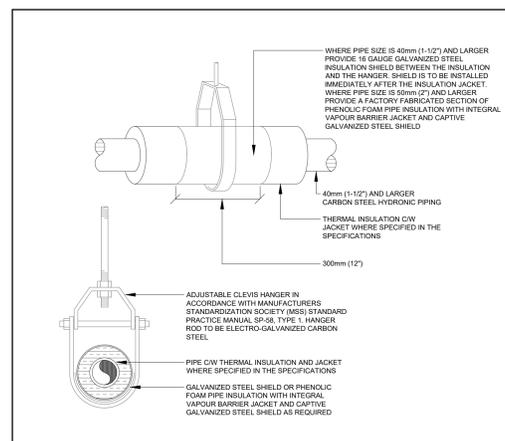


20 05 00.04 PIPING HANGERS AND SUPPORTS  
NOT TO SCALE

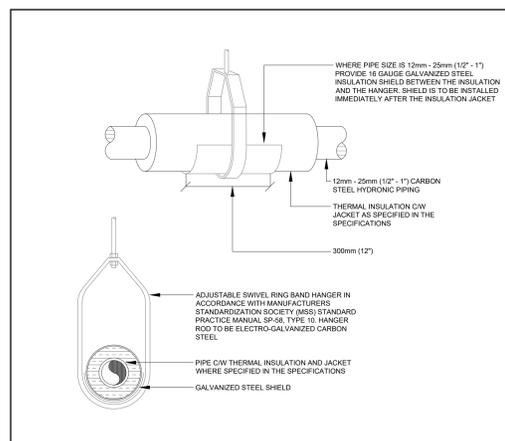


20 05 00.03 PIPING HANGERS AND SUPPORTS  
NOT TO SCALE

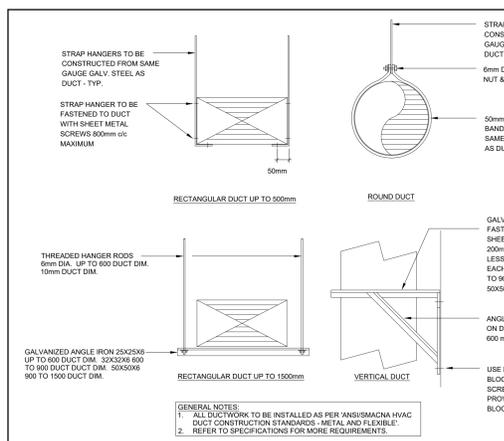

23 30 00.01 DUCTWORK FITTINGS & TAKE-OFF'S  
NOT TO SCALE

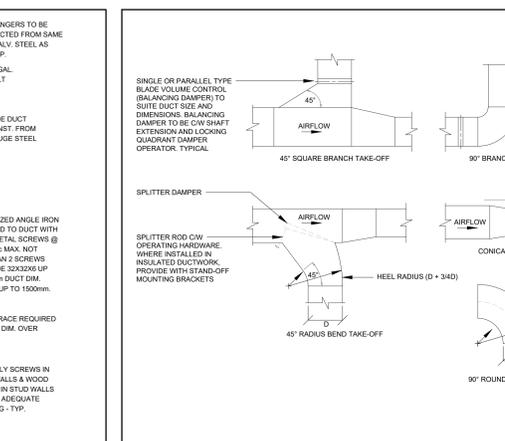

23 30 00.01 DUCTWORK FITTINGS & TAKE-OFF'S  
NOT TO SCALE

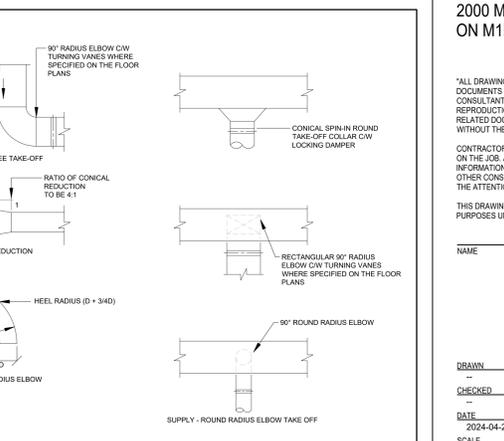

23 30 00.01 DUCTWORK FITTINGS & TAKE-OFF'S  
NOT TO SCALE

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3	ISSUED FOR IFT	2024-12-03
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