
GENERAL NOTES:


- ALL WORK TO COMPLY WITH ALL APPLICABLE BUILDING CODES AND BY-LAWS,
- THE CONTRACTOR SHALL VERIFY ALL DIMENSIONS ON SITE, AND BRING ANY DISCREPANCIES FORWARD BEFORE TENDER OR SUBMITTING A QUOTE,
- THE CONTRACTOR SHALL BE RESPONSIBLE FOR REFINISHING ALL DAMAGED SURFACES OF ADJACENT AREAS AND NEW AREAS,
- THESE DRAWINGS SHALL NOT BE SCALED UNLESS OTHERWISE AND SPECIFICALLY NOTED. ACCURACY OF ANY SCALES PROVIDED ARE NOT GUARANTEED
- INSTALL ALL PRODUCTS IN CONFORMANCE WITH MANUFACTURER'S SPECIFICATIONS.
- REMOVE ALL REDUNDANT EQUIPMENT AND MATERIALS FROM SITE AND DISPOSE OF IN AN APPROVED MANNER. REDUNDANT EQUIPMENT AND MATERIALS SHALL NOT BE ABANDONED IN PLACE,
- THE CONTRACTOR SHALL PRICE, SUPPLY, & INSTALL ALL PRODUCTS NOTED THROUGHOUT THIS DRAWING SET UNLESS OTHERWISE STATED AS: "SUPPLIED BY" AND/OR "INSTALLED BY," THE "OWNER," "DDSB", AND/OR "OTHERS"
- ITEMS TO BE TURNED OVER TO OWNER (DDSB) ARE TO BE DELIVERED TO THE MAINTENANCE SHOP (710 BAYLY STREET, AJAX) IF TURN OVER AT THE EDUCATION CENTRE IS NOT ACCEPTABLE OR APPROPRIATE,
- AT NO TIME SHALL MASONRY DRY CUTTING TAKE PLACE, ALL MASONRY TO BE WET-CUT ONLY,
- 10. UNLESS OTHERWISE PROVIDED BY THE MANUFACTURER, A MINIMUM OF 1 YEAR WARRANTY SHALL BE PROVIDED FOR ALL NEW INSTALLATIONS.
- 11. THE CONTRACTOR SHALL BE RESPONSIBLE FOR THE TEMPORARY REMOVAL OF DOOR COMPONENTS IN ANY UNFORESEEN SITUATION(S) WHICH ARISE FROM MATERIAL / PRODUCT SIZE BEING INCOMPATIBLE WITH THE EXISTING, UNALTERED OPENING(S)
- 12. THE CONTRACTOR SHALL CARRY A CASH ALLOWANCE OF THREE-THOUSAND FIVE-HUNDRED DOLLARS (\$3,500) TO COVER WORK INVOLVING P.A.

COMMUNICATIONS & SECURITY.

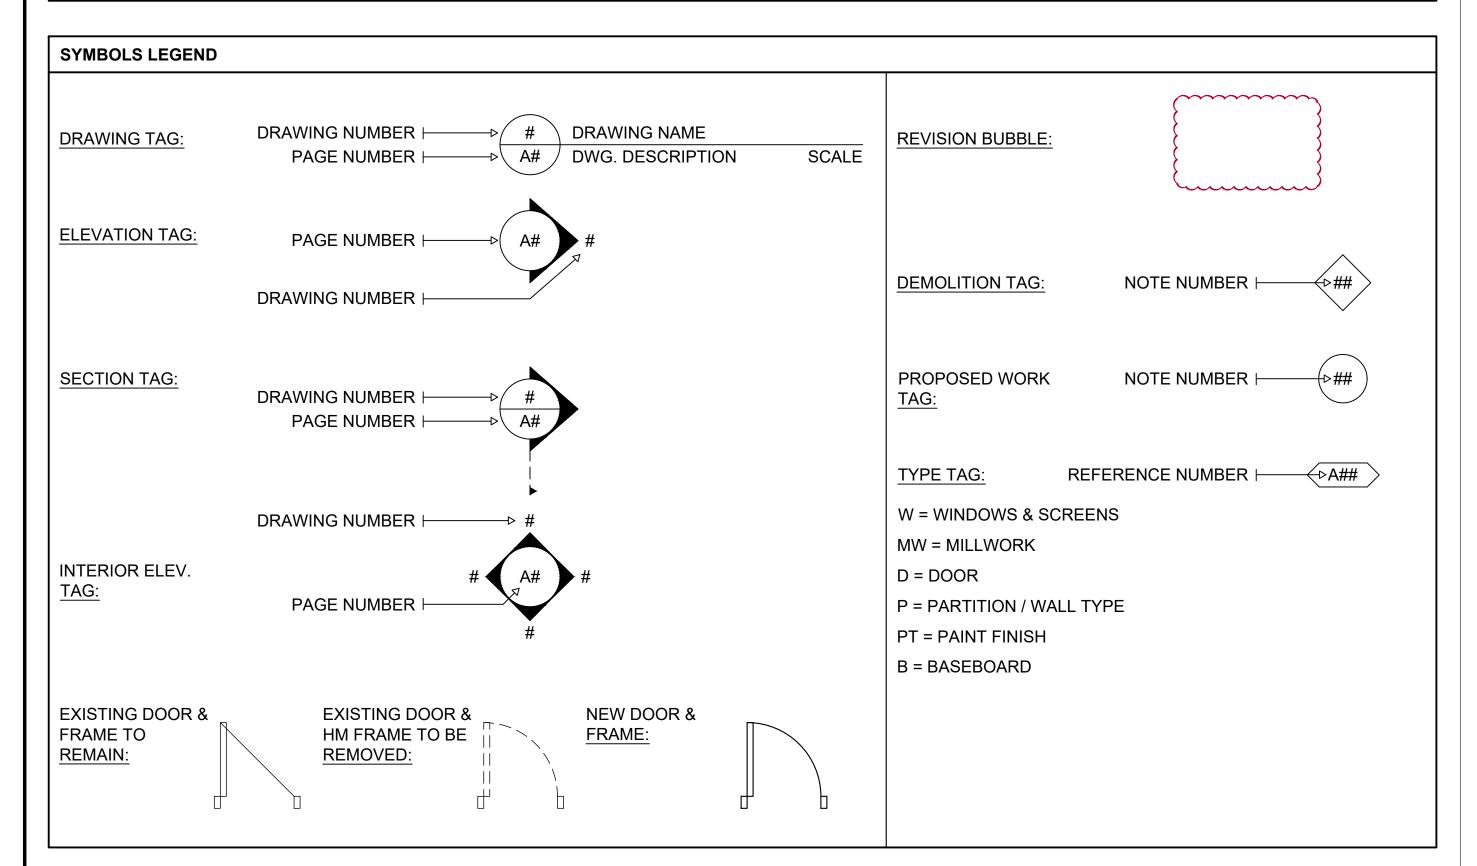


WALL 1	YPES		
LABEL		DESCRIPTION	NOTES
P-1	NEW INTERIOR FURRING: • EXISTING CMU WALL • 3\frac{5}{8}" METAL STUD LAYER • \frac{1}{2}" PLYWOOD • \frac{1}{2}" GYPSUM BOARD	35%" - 1/2" -	 STUDS: SUB-FLOOR TO UNDERSIDE OF DECK. PLYWOOD & GYPSUM: FINISH FLOOR TO 6" ABOVE CEILING GRID. TAPE, MUD, & SAND GYPSUM PRIOR TO APPLYING PRIMER / PAINT. TAKE NOTICE OF PARTITIONS TO BE INSTALLED AWAY FROM EXISTING WALLS TO PROVIDE CHASE.
P-2	GYPSUM ON EXIST. CMU WALL: • EXISTING CMU WALL • ½" GYPSUM BOARD	EXIST.	 FINISH FLOOR TO 6" ABOVE CEILING GRID. TAPE, MUD, & SAND GYPSUM PRIOR TO APPLYING PRIMER / PAINT.

ABBREVIATIONS / ACRONYMS:		REVIATIONS / ACRONYMS: E.Q.		RM	ROOM	
		EX.	EXISTING	T.B.D.	TO BE DETERMINED	
ACSTIC.	ACOUSTIC	EXIST.	EXISTING		/DISCUSSED	
ACT	ACOUSTIC CEILING TILE	FIN.	FINISH	VP	VISION PANEL	
AKA	ALSO KNOWN AS	F.R.R.	FIRE RESISTANCE RATING	\overline{w}	WITH	
AP	ACCESS POINT	FT ²	SQUARE FEET			
APPROX.	APPROXIMATELY	НМ	HOLLOW METAL			
BTTM.	BOTTOM	INSUL.	INSULATION			
CJ	CONTROL JOINT	LIN. FT.	LINEAR FEET			
CP	CONTROL PANEL	LVT	LUXURY VINYL TILE			
DDSB	DURHAM DISTRICT	NA	NOT APPLICABLE			
	SCHOOL BOARD	PROP.	PROPOSED			
DIM(S)	DIMENSION(S)	PT	PAINT			
DWG.	DRAWING	RCP	REFLECTED CEILING PLAN			

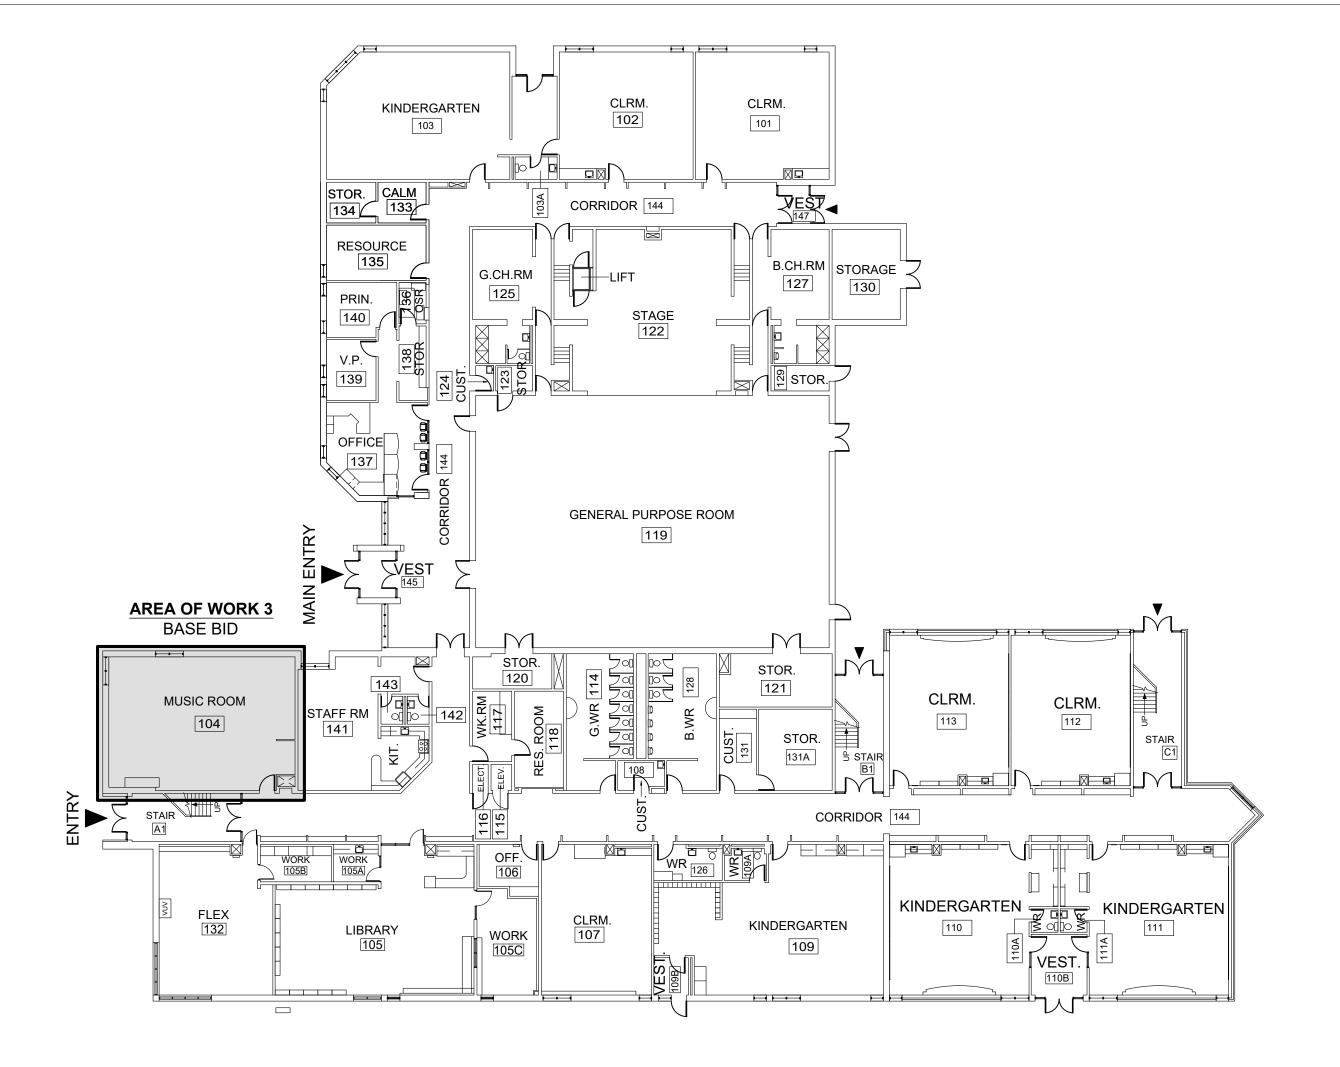


FIRST FLOOR

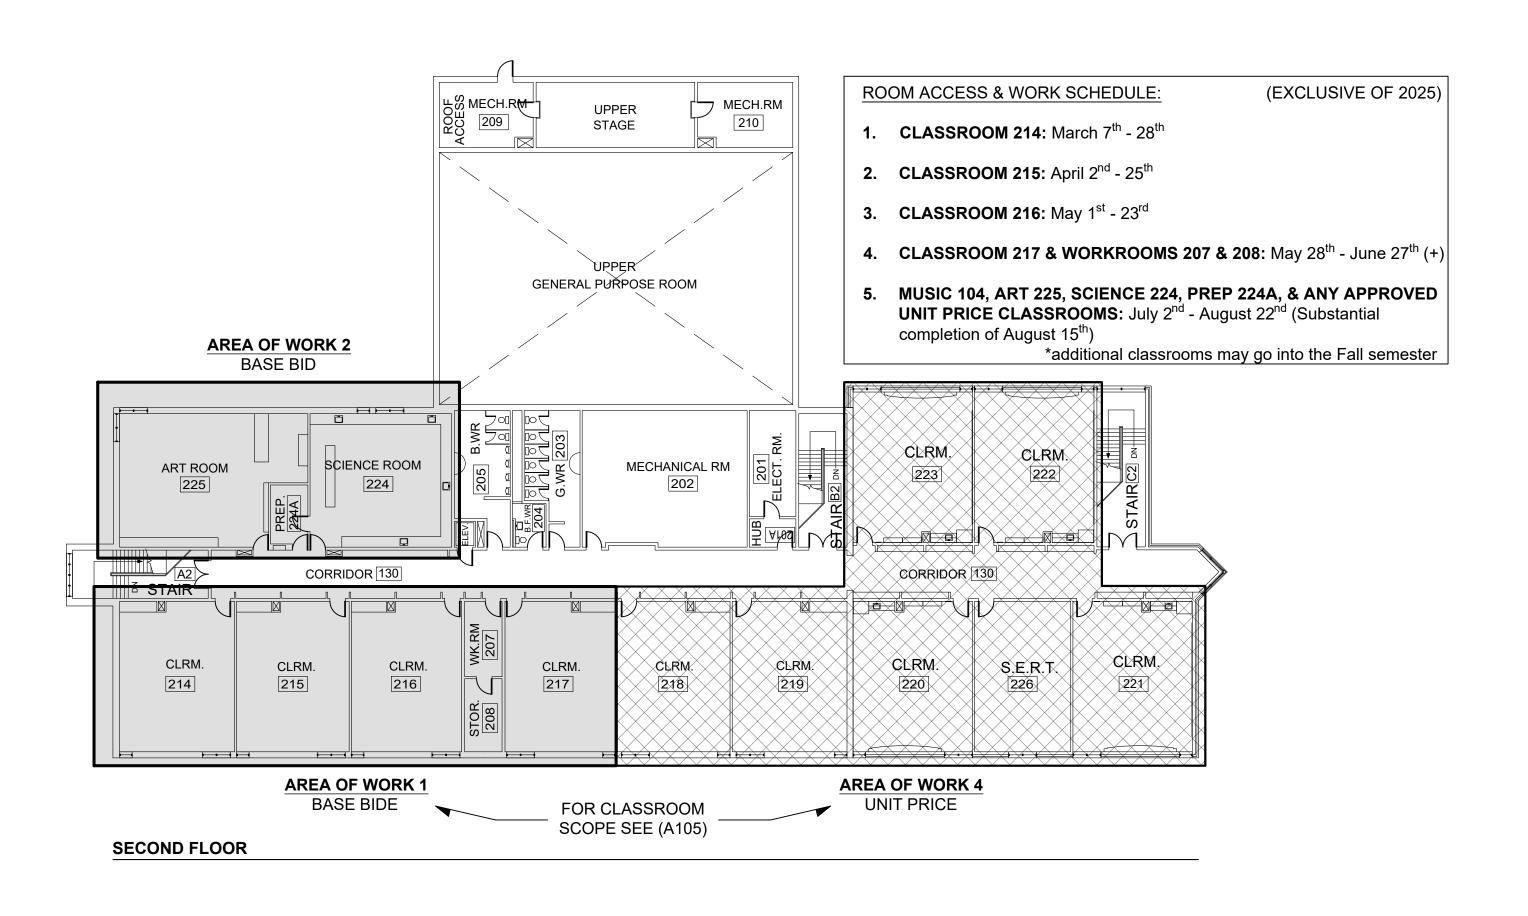


INDICATES 1800mm DIA. BARRIER FREE TURNING RADIUS (2130mm IN BARRIER FREE WASHROOMS) REQUIRED

> DENOTES 118mm FURRING \overline{W} : 92mm METAL STUD, 13mm PLYWOOD, 13mm GYPSUM.

DENOTES 13mm GYPSUM ON **EXISTING CMU: EXISTING CMU WALL** 13mm GYPSUM.

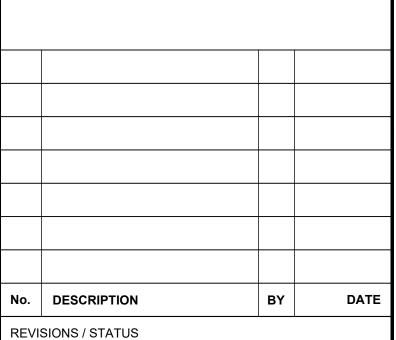

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WILLIAM DUNBAR ART, SCIENCE, MUSIC, & **CLASSROOM ALTERATIONS**

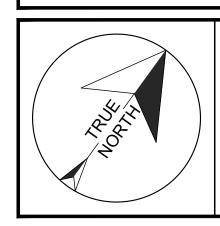AS NOTED Scale: Drawn by:

Chris Thaler Checked by: 1030 Glenanna Rd, Pickering, ON L1V 5E5

TITLE:


GENERAL NOTES & KEY PLANS




1 \ KEY PLANS \A001/ WILLIAM DUNBAR PS - FIRST FLOOR & SECOND FLOOR

DEMOLITION NOTES:

- 1. REMOVE AND DISPOSE OF ALL MILLWORK THROUGHOUT.
- 2. REMOVE & DISPOSE OF ALL FLOORING THROUGHOUT. TO INCLUDE RUBBER BASE ALONG PERIMETER AS WELL.
- 3. EXISTING DOORS & FRAMES SHALL BE MAINTAINED.
- 4. REMOVE AND DISPOSE OF ALL EXISTING SINKS. REFER TO MECHANICAL DRAWINGS FOR MORE INFORMATION, THE GENERAL CONTRACTOR SHALL PATCH ALL WALLS AND/OR FLOORS FOLLOWING PLUMBING DEMOLITION.
- 5. UNINSTALL EXISTING WHITEBOARDS AND TACK BOARDS THROUGHOUT.
- 6. TEMPORARILY UNINSTALL PROJECTOR SCREEN, TO BE REINSTALLED AS PART OF PROPOSED WORK.
- 7. PROTECT EXISTING ACOUSTICAL PANELS AROUND MUSIC ROOM 104. REFER TO PROPOSED SCOPE OF WORK FOR PAINTING.
- 8. MAINTAIN EXISTING KILN AND EQUIPMENT / SERVICES. PROTECT THROUGHOUT CONSTRUCTION.
- 9. REMOVE & DISPOSE OF EXISTING ACCORDION WALL IN ITS ENTIRETY.

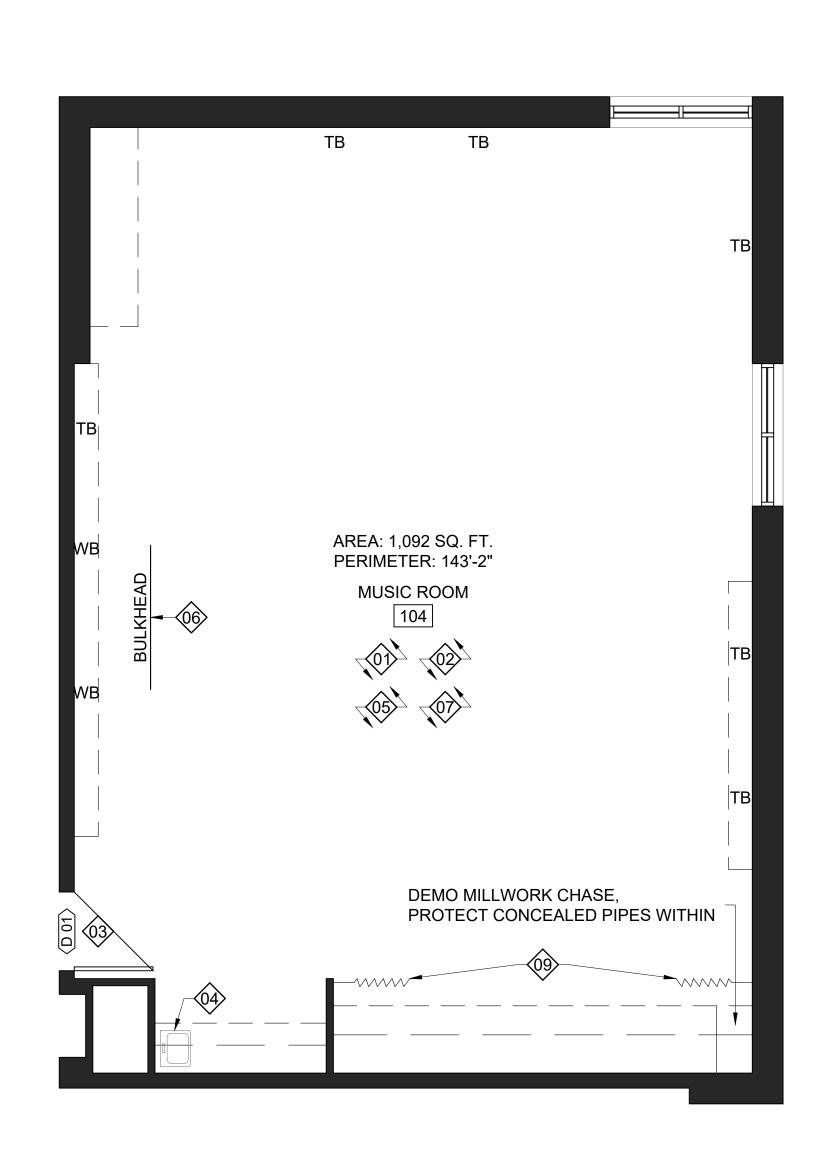

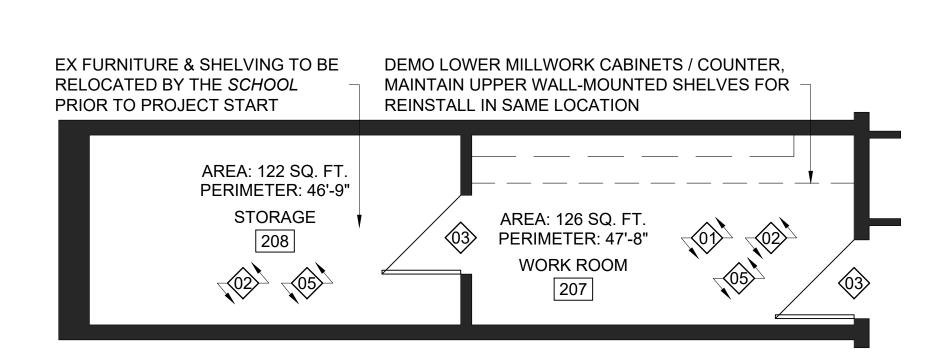



1/4" = 1'-0"

3 \ DEMOLITION PLAN (A101) WILLIAM DUNBAR PS - SECOND FLOOR - WORKROOMS 217 & 218

1/4" = 1'-0"


FREE WASHROOMS) REQUIRED DENOTES 118mm FURRING \overline{W} :

92mm METAL STUD, 13mm PLYWOOD, 13mm GYPSUM.


INDICATES 1800mm DIA.


BARRIER FREE TURNING RADIUS (2130mm IN BARRIER

DENOTES 13mm GYPSUM ON **EXISTING CMU:** EXISTING CMU WALL, 13mm GYPSUM.

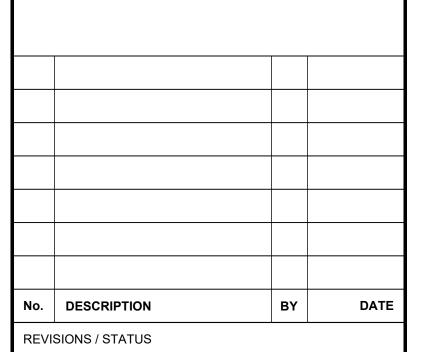

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AS NOTED Scale:

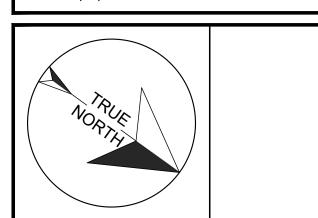Drawn by: lain Meldrum Checked by: Chris Thaler

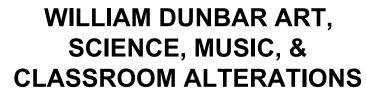1030 Glenanna Rd, Pickering, ON L1V 5E5 Address: TITLE:

DEMOLITION PLANS





WB

AREA: 1,012 SQ. FT. PERIMETER: 136'-2"

> ART ROOM 225

PERIMETER: 40'-8'

WORK ROOM 224A

RR, FIRE EXTINGUISHER

RR, FIRE BLANKET

WB

UNINSTALL GOGGLE STORAGE CABINET,

FOR REINSTALL IN SAME LOCATION

STORE & PROTECT ON SITE

AREA: 845 SQ. FT. PERIMETER: 116'-4"

SCIENCE ROOM 224


DEMO LOWER MILLWORK SHELVES / COUNTER, MAINTAIN UPPER WALL-MOUNTED SHELVES FOR


REINSTALL IN SAME LOCATION

- RL, FIRE EXTINGUISHER

PROPOSED NOTES:

- 1. PROVIDE AND INSTALL MATERIALS TO CONSTRUCT NEW INTERIOR PARTITIONS AS PER WALL TYPE: [P1].
- 2. PROVIDE & INSTALL MATERIALS TO LAMINATE EXISTING CMU WALLS AS PER WALL TYPE: [P2].
- 3. MAKE GOOD ON EXISTING CONCRETE SUB-FLOOR AS REQUIRED. ENSURE SURFACE IS LEVEL AND SMOOTH FOR FLOORING INSTALLATION.
- 4. PROVIDE AND INSTALL NEW FLOORING THROUGHOUT. REFER TO (1/A601) FOR PRODUCT AND LOCATIONS.
- 5. PROVIDE & INSTALL NEW [B-1] 4" RUBBER BASE ALONG PERIMETER OF ROOM. INCLUDE ALONG BOTTOM OF MILLWORK WHERE NOTED.
- 6. PROVIDE AND INSTALL NEW MILLWORK AS SHOWN. SITE VERIFY DIMENSIONS AND PROVIDE SHOP DRAWINGS FOR APPROVAL BY DDSB PROJECT SUPERVISOR PRIOR TO MANUFACTURING.
- EXISTING DOOR & FRAME. PROTECT AND PAINT ALL FACES, LESS CORRIDOR SIDE.
- 8. PROVIDE AND INSTALL NEW **SK-1** COUNTER-MOUNT SINK, FAUCET & EQUIPMENT. REFER TO (M001) FOR MORE INFORMATION, SPECS, AND PRODUCTS.
- 9. PROVIDE & INSTALL NEW **SK-2** COUNTER-MOUNT SINK, FAUCET & EQUIPMENT. REFER TO (M001) FOR MORE INFORMATION, SPECS, AND PRODUCTS.
- 10. PROVIDE AND INSTALL NEW **SK-3** FLOOR-MOUNT SINK, FAUCET & EQUIPMENT. REFER TO (M001) FOR MORE INFORMATION, SPECS, AND PRODUCTS.
- 11. PROVIDE AND INSTALL NEW **SK-4** BARRIER FREE COUNTER-MOUNT SINK, FAUCET & EQUIPMENT. REFER TO (M001) FOR MORE INFORMATION, SPECS, AND PRODUCTS.
- 12. PATCH, PRIME, AND PAINT ALL WALLS, DOORS, DOOR FRAMES (LESS CORRIDOR SIDE), WALL GRILLES & ACCESS PANELS, DRYWALL BULKHEADS AND CEILINGS, P.A. SPEAKERS, AND ACOUSTICAL PANELS (EXCLUSIVE TO MUSIC ROOM 104) THROUGHOUT. FINISHES TO BE GOVERNED BY FINISH SCHEDULE (A601).
- 13. PROVIDE AND INSTALL NEW WHITEBOARDS AND TACK BOARDS. SIZING AS SHOWN, COORDINATE MOUNTING LOCATION AND HEIGHTS WITH DDSB PROJECT SUPERVISOR PRIOR TO INSTALL.
- 14. PROVIDE AND INSTALL NEW TILE BACK-SPLASH BEHIND SINKS. SHALL BE FROM TOP OF 4" TRIM TO UNDERSIDE OF UPPER CABINETS. AND FROM FLOOR TO TOP OF UPPER CABINETS BEHIND MUSIC ROOM SINK. REFER TO (A601) FOR MORE INFORMATION & PRODUCTS. REFER TO APPROPRIATE ELEVATIONS FOR LOCATIONS AND HEIGHTS.
- 15. REINSTALL EXISTING PULL-DOWN PROJECTOR SCREEN.
- 16. CORE HOLES THROUGH SECOND FLOOR CONCRETE SLAB AS REQUIRED TO ACCOMMODATE NEW HOT & COLD WATER SUPPLY LINES AND SANITARY DRAINS. SIZE AND QUANTITY SHALL BE CONFIRMED BETWEEN THE PLUMBING CONTRACTOR AND GENERAL CONTRACTOR. SCAN FLOOR PRIOR TO ANY FLOOR CUTTING.
- 17. ALLOW FOR INSTALLATION OF NEW SOAP AND PAPER TOWEL DISPENSERS (PROVIDED BY DDSB). ART ROOM: 2 SOAP, 2 PAPER TOWEL. SCIENCE ROOM: 3 SOAP, 3 PAPER TOWEL. MUSIC ROOM: 1 SOAP, 1 PAPER TOWEL. PREP ROOM: 1 SOAP, 1 PAPER TOWEL.
- 18. EXISTING KILN SHALL REMAIN. PROTECT THROUGHOUT CONSTRUCTION AND SEAL ALL PENETRATIONS ABOVE CEILING.

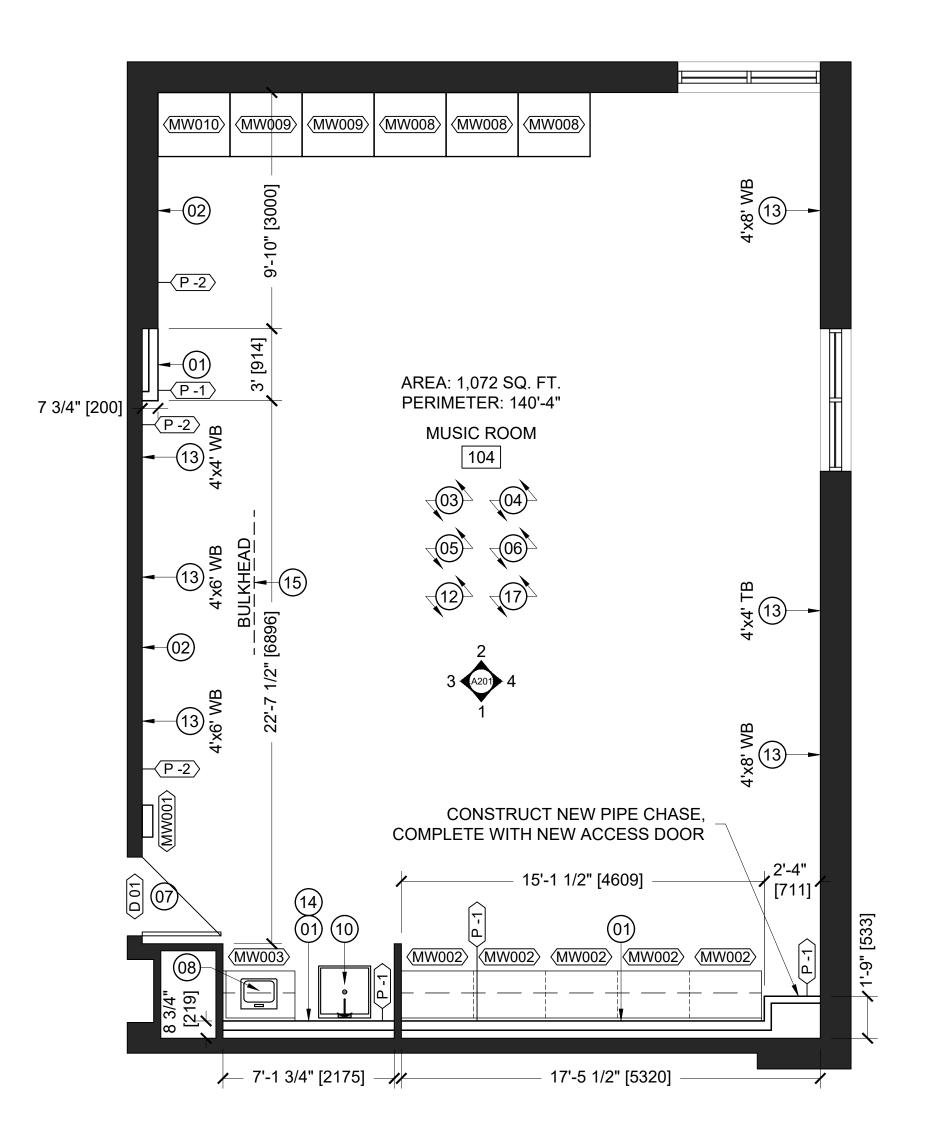

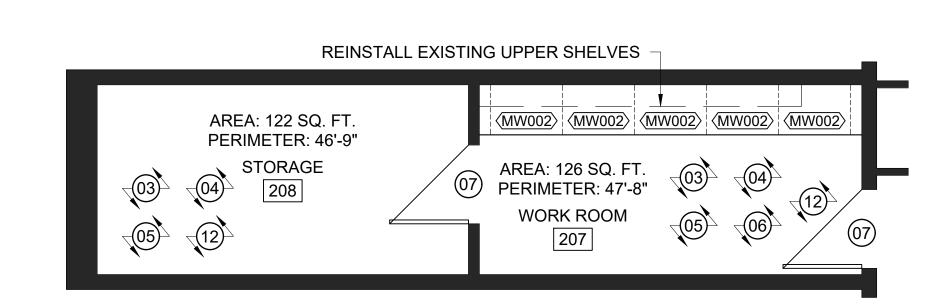

3 \ PROPOSED PLAN


BARRIER FREE TURNING RADIUS (2130mm IN BARRIER FREE WASHROOMS) REQUIRED

DENOTES 118mm FURRING \overline{W} : 92mm METAL STUD, 13mm PLYWOOD,


> 13mm GYPSUM. DENOTES 13mm GYPSUM ON

INDICATES 1800mm DIA.

EXISTING CMU: EXISTING CMU WALL, 13mm GYPSUM.

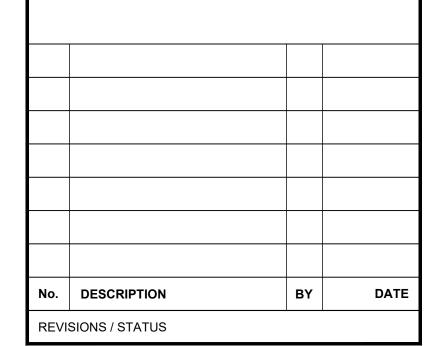

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WILLIAM DUNBAR ART

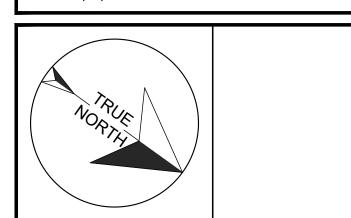SCIENCE, MUSIC, & **CLASSROOM ALTERATIONS**

AS NOTED Scale: Drawn by: Chris Thaler Checked by: Address: 1030 Glenanna Rd, Pickering, ON L1V 5E5 TITLE:

PROPOSED PLANS





13

4'x8' WB

(MW011) (MW011) (MW011) \(\frac{1}{1}\)

WORK ROOM

AREA: 98 SQ. FT.

PERIMETER: 40'-8"

REINSTALL EXISTING

GOGGLE STORAGE CABINET

8'-3" [2514]

WORK ROOM

(03)

(05)

22'-3 3/4" [6800]

13 (15)

4'x6' WB

AREA: 981 SQ. FT. PERIMETER: 136'-2"

ART ROOM

225

REINSTALL EXISTING WALL-MOUNTED UPPER SHELVES ABOVE NEW COUNTER

> 9'-8" [2946] REINSTALL EX

> > 4'x8' WB

20' [6096]

FIRE EXTINGUISHER

8 3/4" [219]

13) (15) 4'x6' WB

AREA: 808 SQ. FT.

PERIMETER: 114'-11"

SCIENCE ROOM

(04)

(06)


224

(05)

12

28'-3" [8610]

≥ 5 13 -

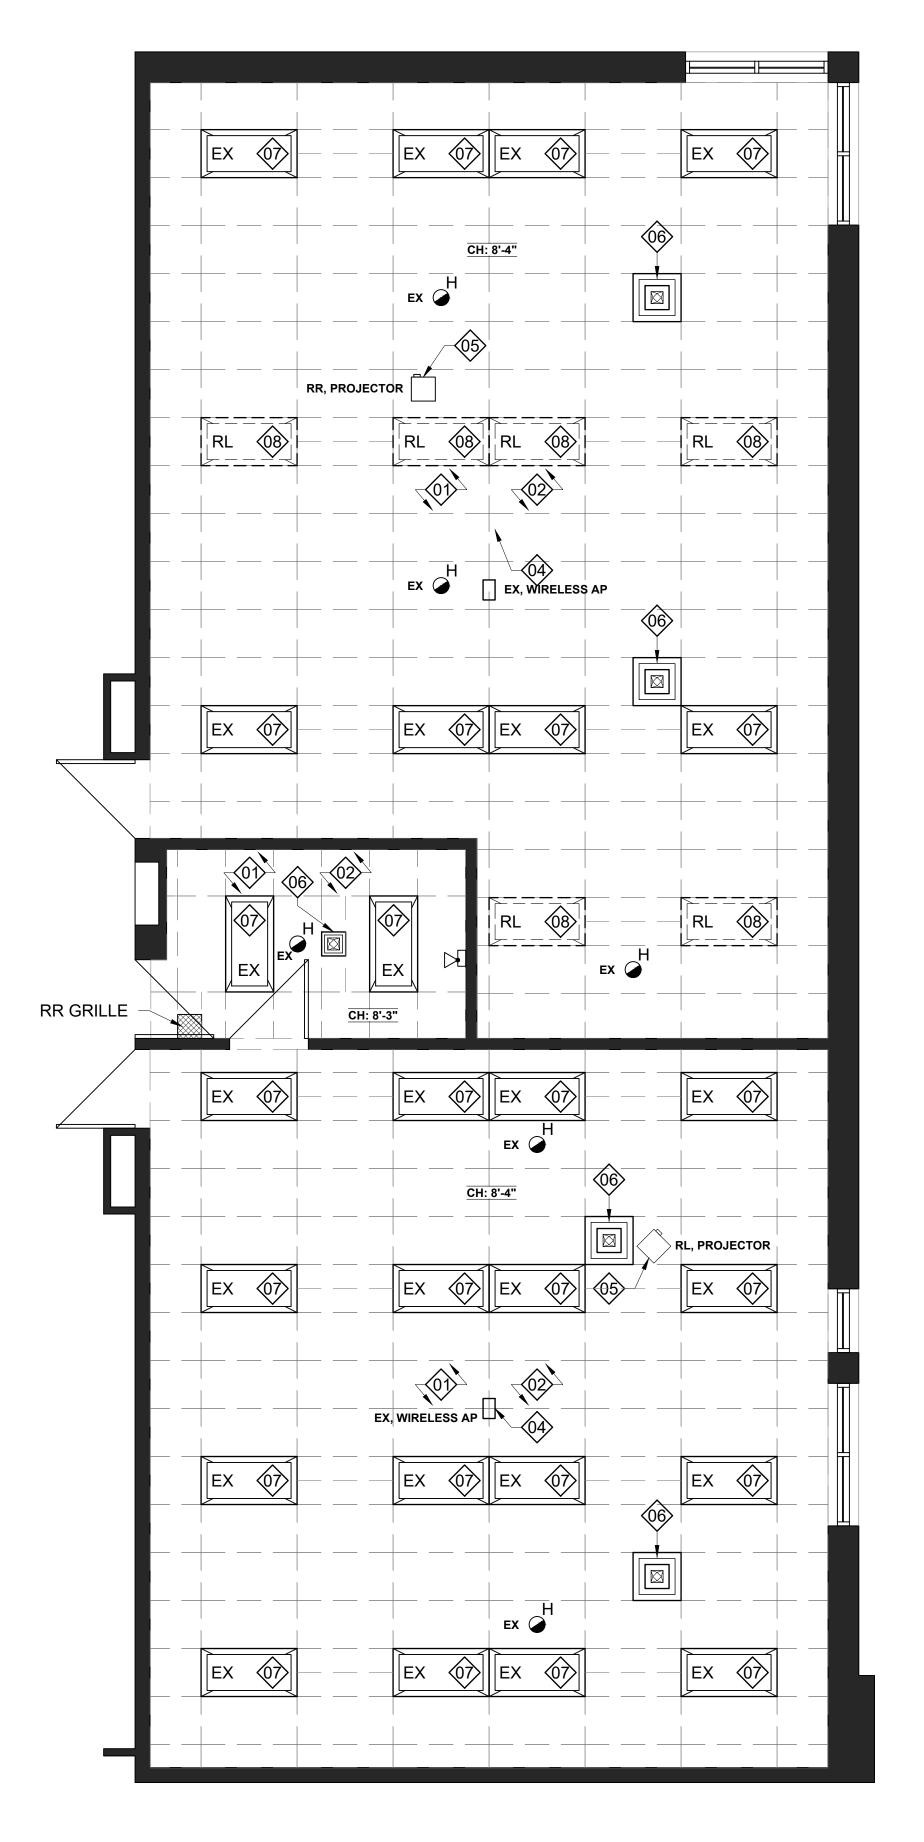

REFLECTED CEILING PLAN DEMOLITION

(A103) WILLIAM DUNBAR PS - SECOND FLOOR - ART / SCIENCE ROOMS

DEMOLITION RCP NOTES:


- REMOVE AND DISPOSE OF CEILING TILES AND GRID THROUGHOUT.
- 2. CONTRACTOR TO PROTECT AND SECURE ALL DEVICES THROUGHOUT CONSTRUCTION.
- MAINTAIN EXISTING GYPSUM BULKHEADS AND CEILINGS. BULKHEADS SHALL BE PAINTED AS PART OF PROPOSED WORK, SEE FINISH SCHEDULE (A601) FOR COLOURS.
- 4. WIRELESS ACCESS POINT TO BE REMOVED BY DDSB IT DEPARTMENT STAFF PRIOR TO CONSTRUCTION START.
- 5. PROJECTOR AND ASSOCIATED POWER TO BE RELOCATED. REFER TO *ELECTRICAL DRAWINGS* FOR MORE INFORMATION.
- 6. REMOVE AND DISPOSE OF EXISTING 2x2 AIR DIFFUSER. MAINTAIN DUCT WORK FOR REINSTALL IN SAME OR SIMILAR LOCATION.
- 7. EXISTING LIGHT FIXTURE TO REMAIN. REFER TO *ELECTRICAL & LIGHTING DRAWINGS* FOR MORE INFORMATION.
- 8. UNINSTALL EXISTING LIGHT FIXTURE. RELOCATE OR TURNOVER REDUNDANT EQUIPMENT TO SCHOOL. REFER TO ELECTRICAL & LIGHTING DRAWINGS FOR MORE INFO.




INDICATES 1800mm DIA. BARRIER FREE TURNING RADIUS (2130mm IN BARRIER FREE WASHROOMS) REQUIRED

DENOTES 118mm FURRING $\overline{\mathrm{W}}$: 92mm METAL STUD, 13mm PLYWOOD, 13mm GYPSUM.

DENOTES 13mm GYPSUM ON **EXISTING CMU:** EXISTING CMU WALL, 13mm GYPSUM.

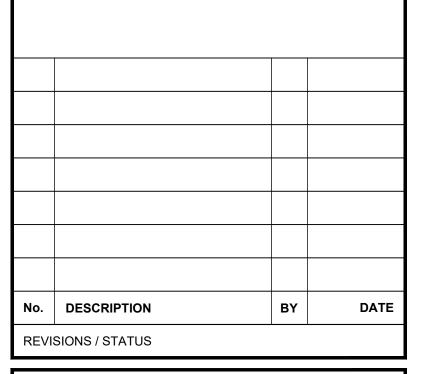

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WILLIAM DUNBAR ART, SCIENCE, MUSIC, & **CLASSROOM ALTERATIONS**

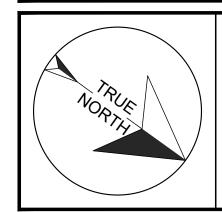
AS NOTED Scale: Drawn by:

Checked by: Chris Thaler 1030 Glenanna Rd, Pickering, ON L1V 5E5

Address: TITLE:

DEMOLITION RCP



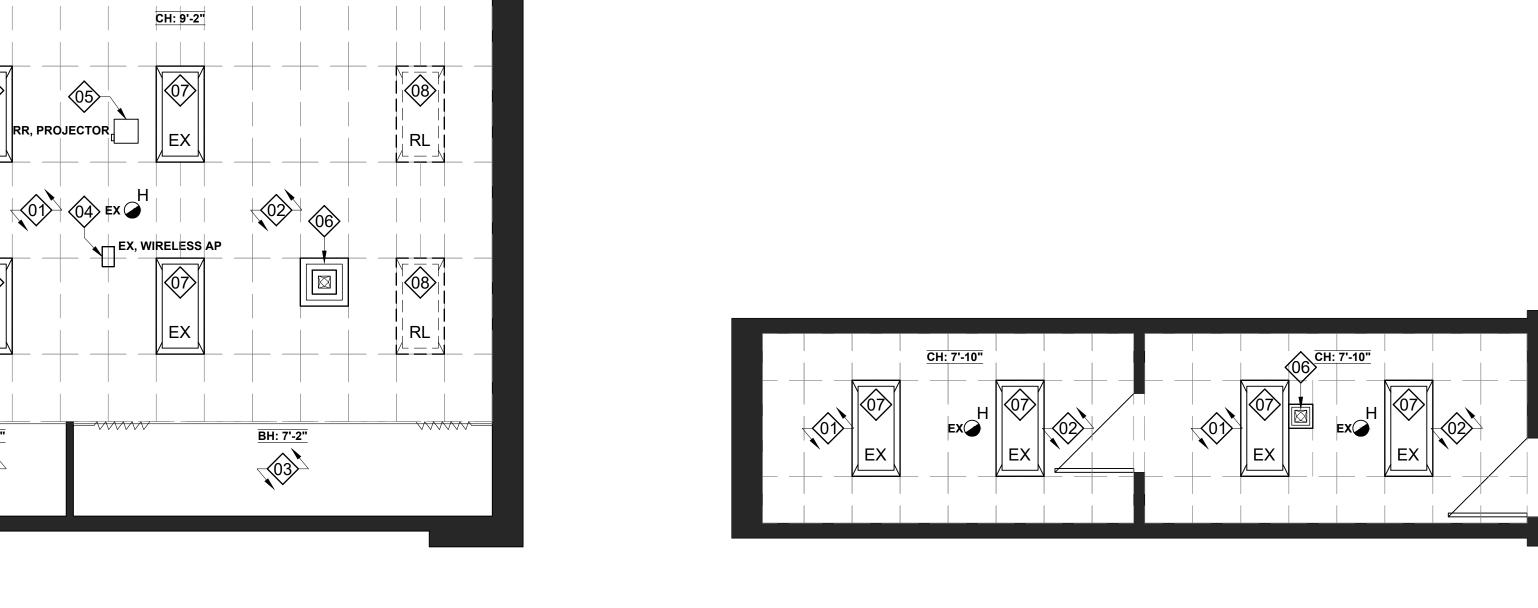

(03)

SLOPED 'POPCORN' DRYWALL CEILING

EX

RR, PROJECTOR

N 06

CH: 8'-4"

-03

N 06 N 06

(01)

PROPOSED RCP NOTES:


- 1. PROVIDE AND INSTALL NEW T-BAR GRID AND ACOUSTIC CEILING TILES THROUGHOUT. MATCH EXISTING LAYOUT AND HEIGHT AS BEST POSSIBLE. REFER TO FINISH SCHEDULE (A601) FOR PRODUCTS.
- 2. WIRELESS ACCESS POINTS TO BE RE-INSTALLED BY DDSB IT DEPARTMENT STAFF IN TAIL END OF PROJECT OR POST COMPLETION.
- 3. REINSTALL CEILING-MOUNTED PROJECTOR TO ACCOMMODATE NEW LOCATION OF PROJECTOR SCREEN. A/V CONNECTIONS AS PER ELECTRICAL DRAWINGS.
- 4. PAINT BULKHEADS AND GYPSUM CEILINGS, "POPCORN" CEILINGS SHALL BE PAINTED WITH A FLAT OIL PAINT. REFER TO FINISH SCHEDULE (A601) FOR MORE INFO.
- 5. PROVIDE AND INSTALL NEW AIR DIFFUSER. PRODUCT SHALL BE **SCD 31 33**, WHITE IN COLOUR, BY PRICE INDUSTRIES. TYPICAL 24"x24", SIZE 12"x12" AS NEEDED.
- 6. NEW LIGHT FIXTURE. REFER TO *ELECTRICAL & LIGHTING DRAWINGS* FOR MORE INFORMATION.




INDICATES 1800mm DIA. BARRIER FREE TURNING RADIUS (2130mm IN BARRIER FREE WASHROOMS) REQUIRED

DENOTES 118mm FURRING \overline{W} : 92mm METAL STUD, 13mm PLYWOOD, 13mm GYPSUM.

DENOTES 13mm GYPSUM ON **EXISTING CMU:** EXISTING CMU WALL, 13mm GYPSUM.

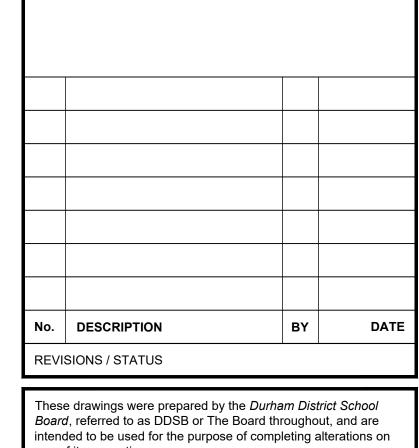

one of its properties.

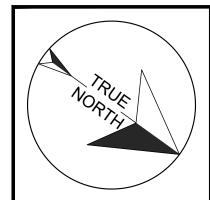

WILLIAM DUNBAR ART, SCIENCE, MUSIC, & **CLASSROOM ALTERATIONS**


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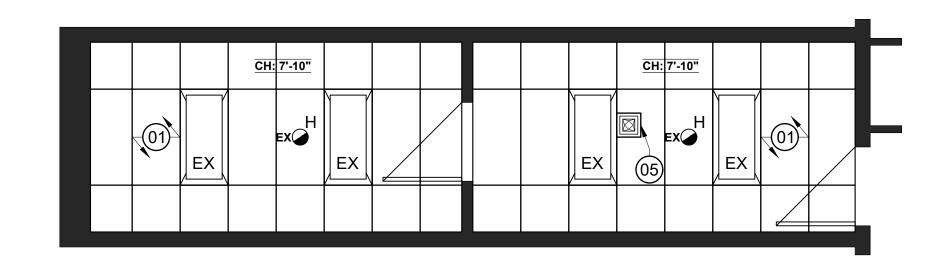
Checked by: Chris Thaler 1030 Glenanna Rd, Pickering, ON L1V 5E5

Address: TITLE:

PROPOSED RCP





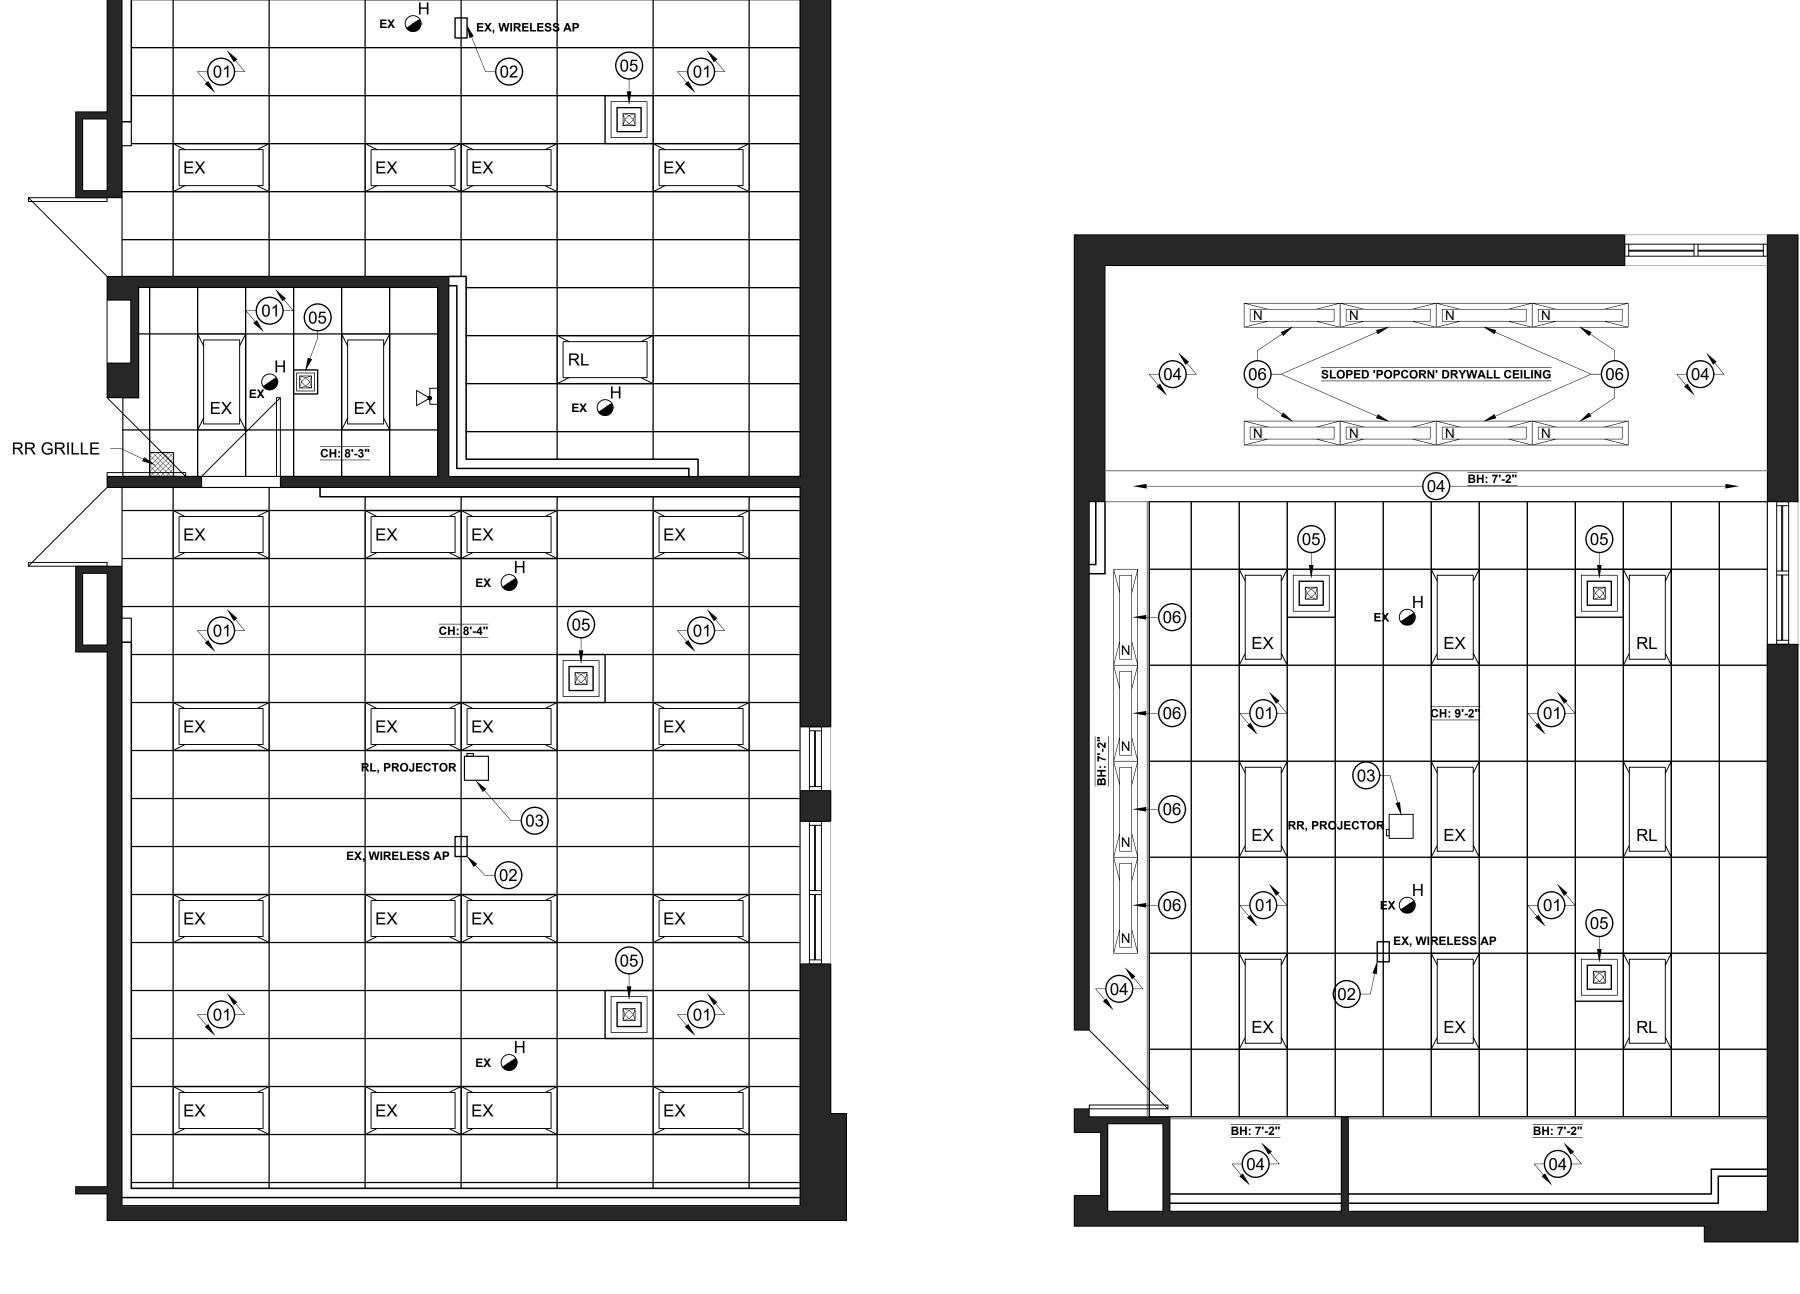





1/4" = 1'-0"

\A104/ WILLIAM DUNBAR PS - SECOND FLOOR - WORKROOMS 217 & 218

DEMOLITION NOTES:


- REMOVE AND DISPOSE OF EXISTING MILLWORK THROUGHOUT.
- REMOVE & DISPOSE OF EXISTING SINK. MAINTAIN SERVICES FOR NEW SINK IN SAME LOCATION.
- REMOVE AND DISPOSE OF FLOORING THROUGHOUT. SHALL INCLUDE RUBBER BASE ALONG PERIMETER OF ROOM ON WALLS AND/OR BOTTOM OF MILLWORK. UNINSTALL EXISTING WHITEBOARDS (WB) AND TACK BOARDS (TB) THROUGHOUT. WHITEBOARDS SHALL BE TURNED OVER TO THE SCHOOL, TACK BOARDS SHALL BE DISPOSED OF.
- 5. TEMPORARILY UNINSTALL PROJECTOR SCREEN, SHALL BE REINSTALLED AS PART OF PROPOSED WORK IN SAME LOCATION.
- EXISTING ROLLER BLINDS SHALL BE PROTECTED AND MAINTAINED.


PROPOSED NOTES:

- PROVIDE AND INSTALL NEW FLOORING THROUGHOUT. REFER TO *FINISH SCHEDULE* (A601) FOR PRODUCT AND LOCATIONS
- PROVIDE & INSTALL NEW [B-1] 4" RUBBER BASE ALONG PERIMETER OF ROOM. SHALL INCLUDE ALONG BOTTOM OF MILLWORK WHERE NOTED.
- PROVIDE AND INSTALL NEW MILLWORK AS SHOWN. SITE VERIFY DIMENSIONS AND PROVIDE SHOP DRAWINGS FOR APPROVAL BY DDSB PROJECT SUPERVISOR PRIOR TO MANUFACTURING.
- 10. PROVIDE & INSTALL NEW **SK-1** COUNTER-MOUNT SINK, FAUCET & EQUIPMENT. REFER TO (M001) FOR MORE INFORMATION, SPECS, AND PRODUCTS.
- 11. PATCH, PRIME, AND PAINT ALL WALLS, DOOR FRAMES (BOTH SIDES), DRYWALL BULKHEADS, & DRYWALL CEILINGS. FINISHES TO BE GOVERNED BY (A/601). 12. PROVIDE AND INSTALL NEW WHITEBOARDS & TACK BOARDS. SIZING AS SHOWN, COORDINATE MOUNTING LOCATION AND HEIGHTS WITH DDSB PROJECT
- SUPERVISOR PRIOR TO INSTALL
- 13. REINSTALL EXISTING PULL-DOWN PROJECTOR SCREEN IN ALIGNMENT WITH PROJECTOR. REFER TO (E001) FOR MORE INFORMATION.
- 14. ALLOW FOR INSTALLATION OF NEW SOAP AND PAPER TOWEL DISPENSERS, PROVIDED BY DDSB. ONE SOAP, AND 1 PAPER TOWEL PER CLASSROOM.

PRICING & CLASSROOM BREAKDOWN:

- SCOPE OF WORK SHALL BE CONSISTENT BETWEEN BOTH PRICES (BASEBID and UNIT PRICE)
- 2. THE BASEBID IS INCLUSIVE OF THE FOLLOWING ROOMS: (*see rest of drawing set for full scope of work)
- 2.1. 104*. 2.2. 207*
- 2.3. 208*,
- 2.4. 214. 215, 2.5.
- 216, 2.6.
- 2.7. 217,
- 2.8. 224*,
- 2.9. 224A*, & 225* 2.10.
- 3. THE UNIT PRICE SHALL COVER (BUT NOT GUARANTEE) THE FOLLOWING CLASSROOMS:
- 3.1.
- 3.2. 219,
- 3.3. 220, 221,
- 3.4. 3.5. 222,
- 3.6. 223, &
- 3.7.
- 4. UNIT PRICE CLASSROOM QUANTITY AND SELECTION SHALL BE AT DISCRETION OF OWNER & DDSB PROJECTOR SUPERVISOR AS BUDGET ALLOWS.

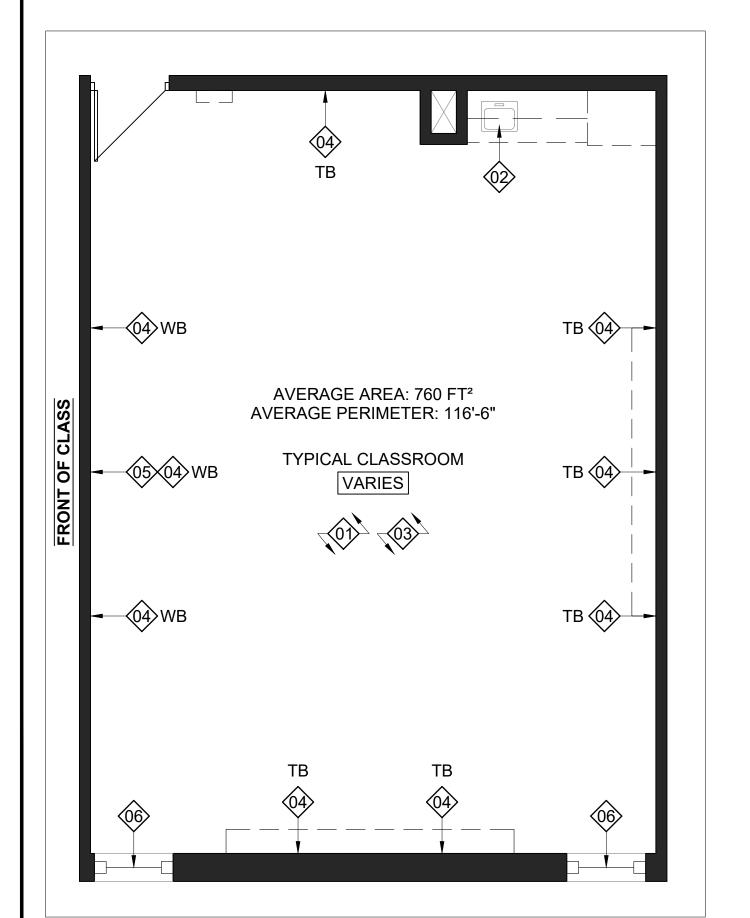

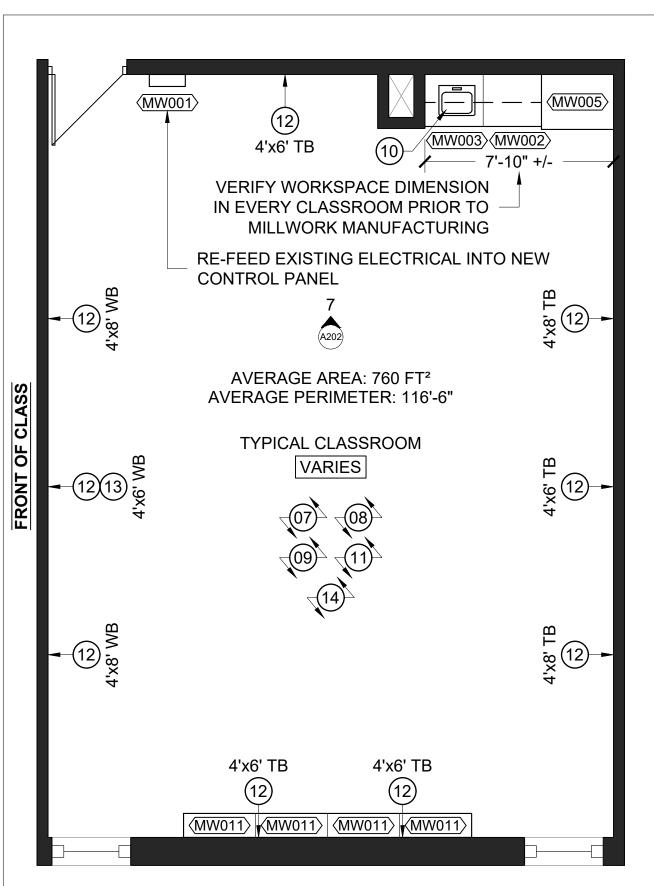


PROPOSED PLAN - CLASSROOM REFRESH TYPICAL CLASSROOM

RCP DEMOLITION NOTES:

- REMOVE AND DISPOSE OF EXISTING CEILING TILES AND GRID THROUGHOUT. NEW CEILING TO MATCH EXISTING CEILING HEIGHT & GRID LAYOUT.
- WIRELESS ACCESS POINTS TO BE REMOVED BY DDSB IT DEPARTMENT STAFF PRIOR TO CONSTRUCTION START. EXISTING LIGHT FIXTURES TO REMAIN. TEMPORARILY UNINSTALL AS REQUIRED FOR CEILING REMOVAL. TO BE INSTALLED IN SAME LOCATION. SWITCHING TO
- REMAIN AS PER EXISTING.
- REMOVE AND DISPOSE OF EXISTING 2x2 AIR DIFFUSERS. EXISTING DUCT WORK SHALL BE REUSED


(##) PROPOSED RCP NOTES:

- PROVIDE AND INSTALL NEW T-BAR GRID & ACOUSTIC CEILING TILES THROUGHOUT. MATCH EXISTING CEILING HEIGHT AND LAYOUT. SEE (A601) FOR PRODUCTS.
- WIRELESS ACCESS POINTS SHALL BE RE-INSTALLED BY DDSB IT DEPARTMENT STAFF IN TAIL END OF PROJECT OR POST COMPLETION.
- PROVIDE AND INSTALL NEW 2x2 DIFFUSERS IN SIMILAR LOCATION. PRODUCT SHALL BE SCD 31 33, WHITE IN COLOUR, BY PRICE INDUSTRIES. REINSTALL EXISTING LIGHT FIXTURE. RE-LAMP FIXTURE AS REQUIRED TO ENSURE EACH FIXTURE CONTAINS THREE (x3) FUNCTIONING LAMPS. CONNECT
- SWITCHING ACCORDINGLY, TWO (x2) SWITCHES PER CLASSROOM, OUTSIDE LAMPS ON ONE SWITCH, INSIDE LAMP ON OTHER SWITCH

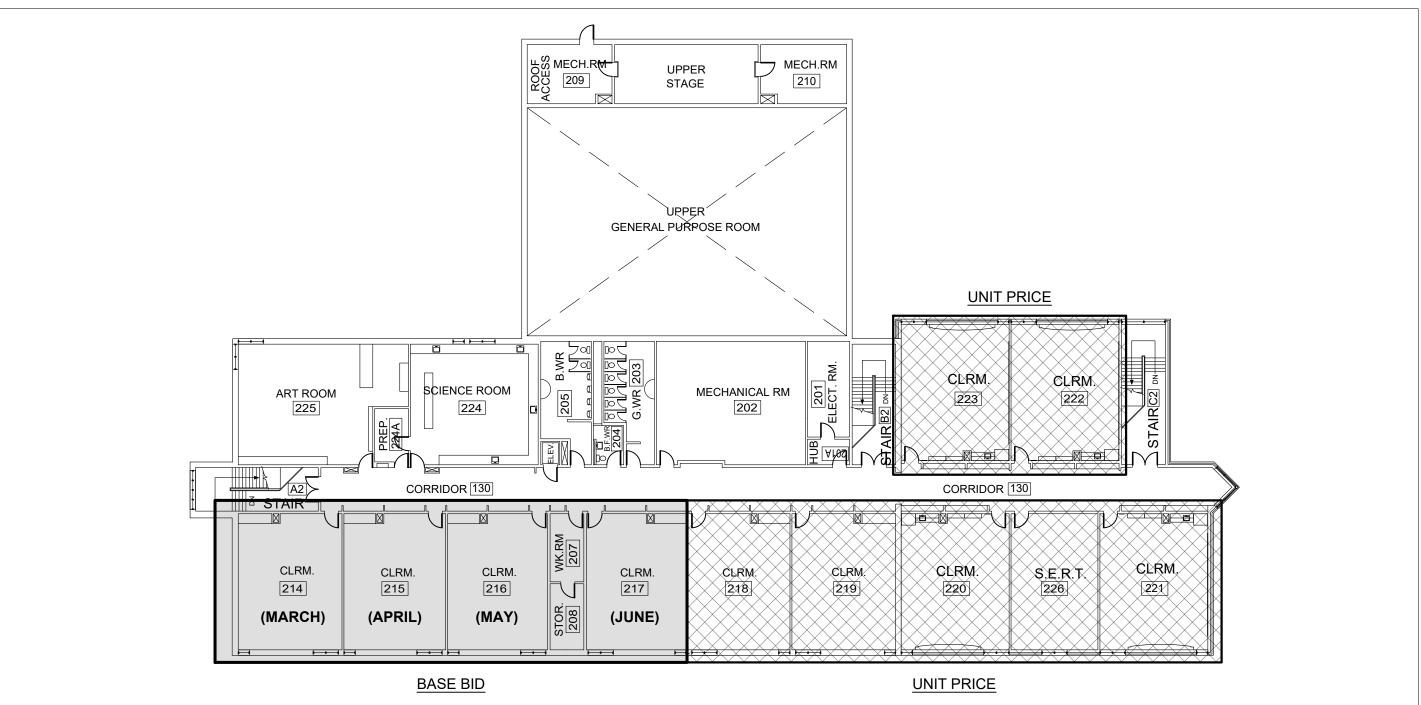

CLASSROOM REFRESH KEY PLAN

(A105) WILLIAM DUNBAR PS - SECOND FLOOR

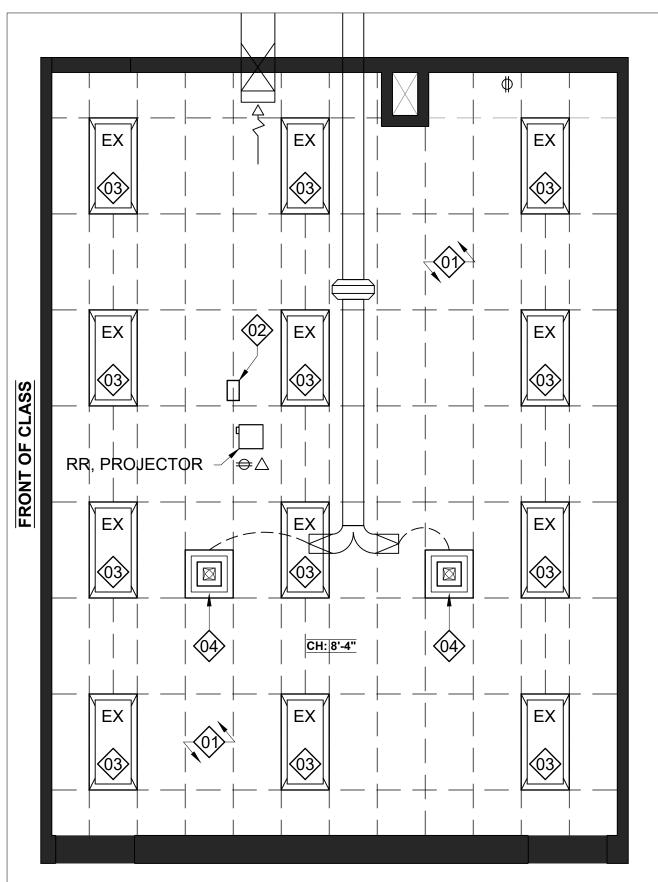

RCP DEMOLITION - CLASSROOM REFRESH (A105) TYPICAL CLASSROOM

EX 05 EX 、RR, PROJECTOR EX EX


PROPOSED RCP - CLASSROOM REFRESH TYPICAL CLASSROOM

INDICATES 1800mm DIA. BARRIER FREE TURNING RADIUS (2130mm IN BARRIER FREE WASHROOMS) REQUIRED


> DENOTES 118mm FURRING W: 92mm METAL STUD. 13mm PLYWOOD, 13mm GYPSUM.

DENOTES 13mm GYPSUM ON **EXISTING CMU: EXISTING CMU WALL**

13mm GYPSUM.

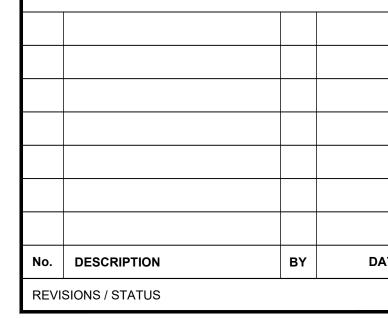

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WILLIAM DUNBAR ART

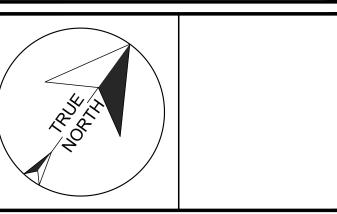SCIENCE, MUSIC, & **CLASSROOM ALTERATIONS** Project No: T25-01

AS NOTED Drawn by: Checked by: Chris Thaler


1030 Glenanna Rd, Pickering, ON L1V 5E5 Address: TITLE:

CLASSROOM REFRESH DEMOLITION & PROPOSED + RCP SCOPE OF WORK



1/4" = 1'-0"



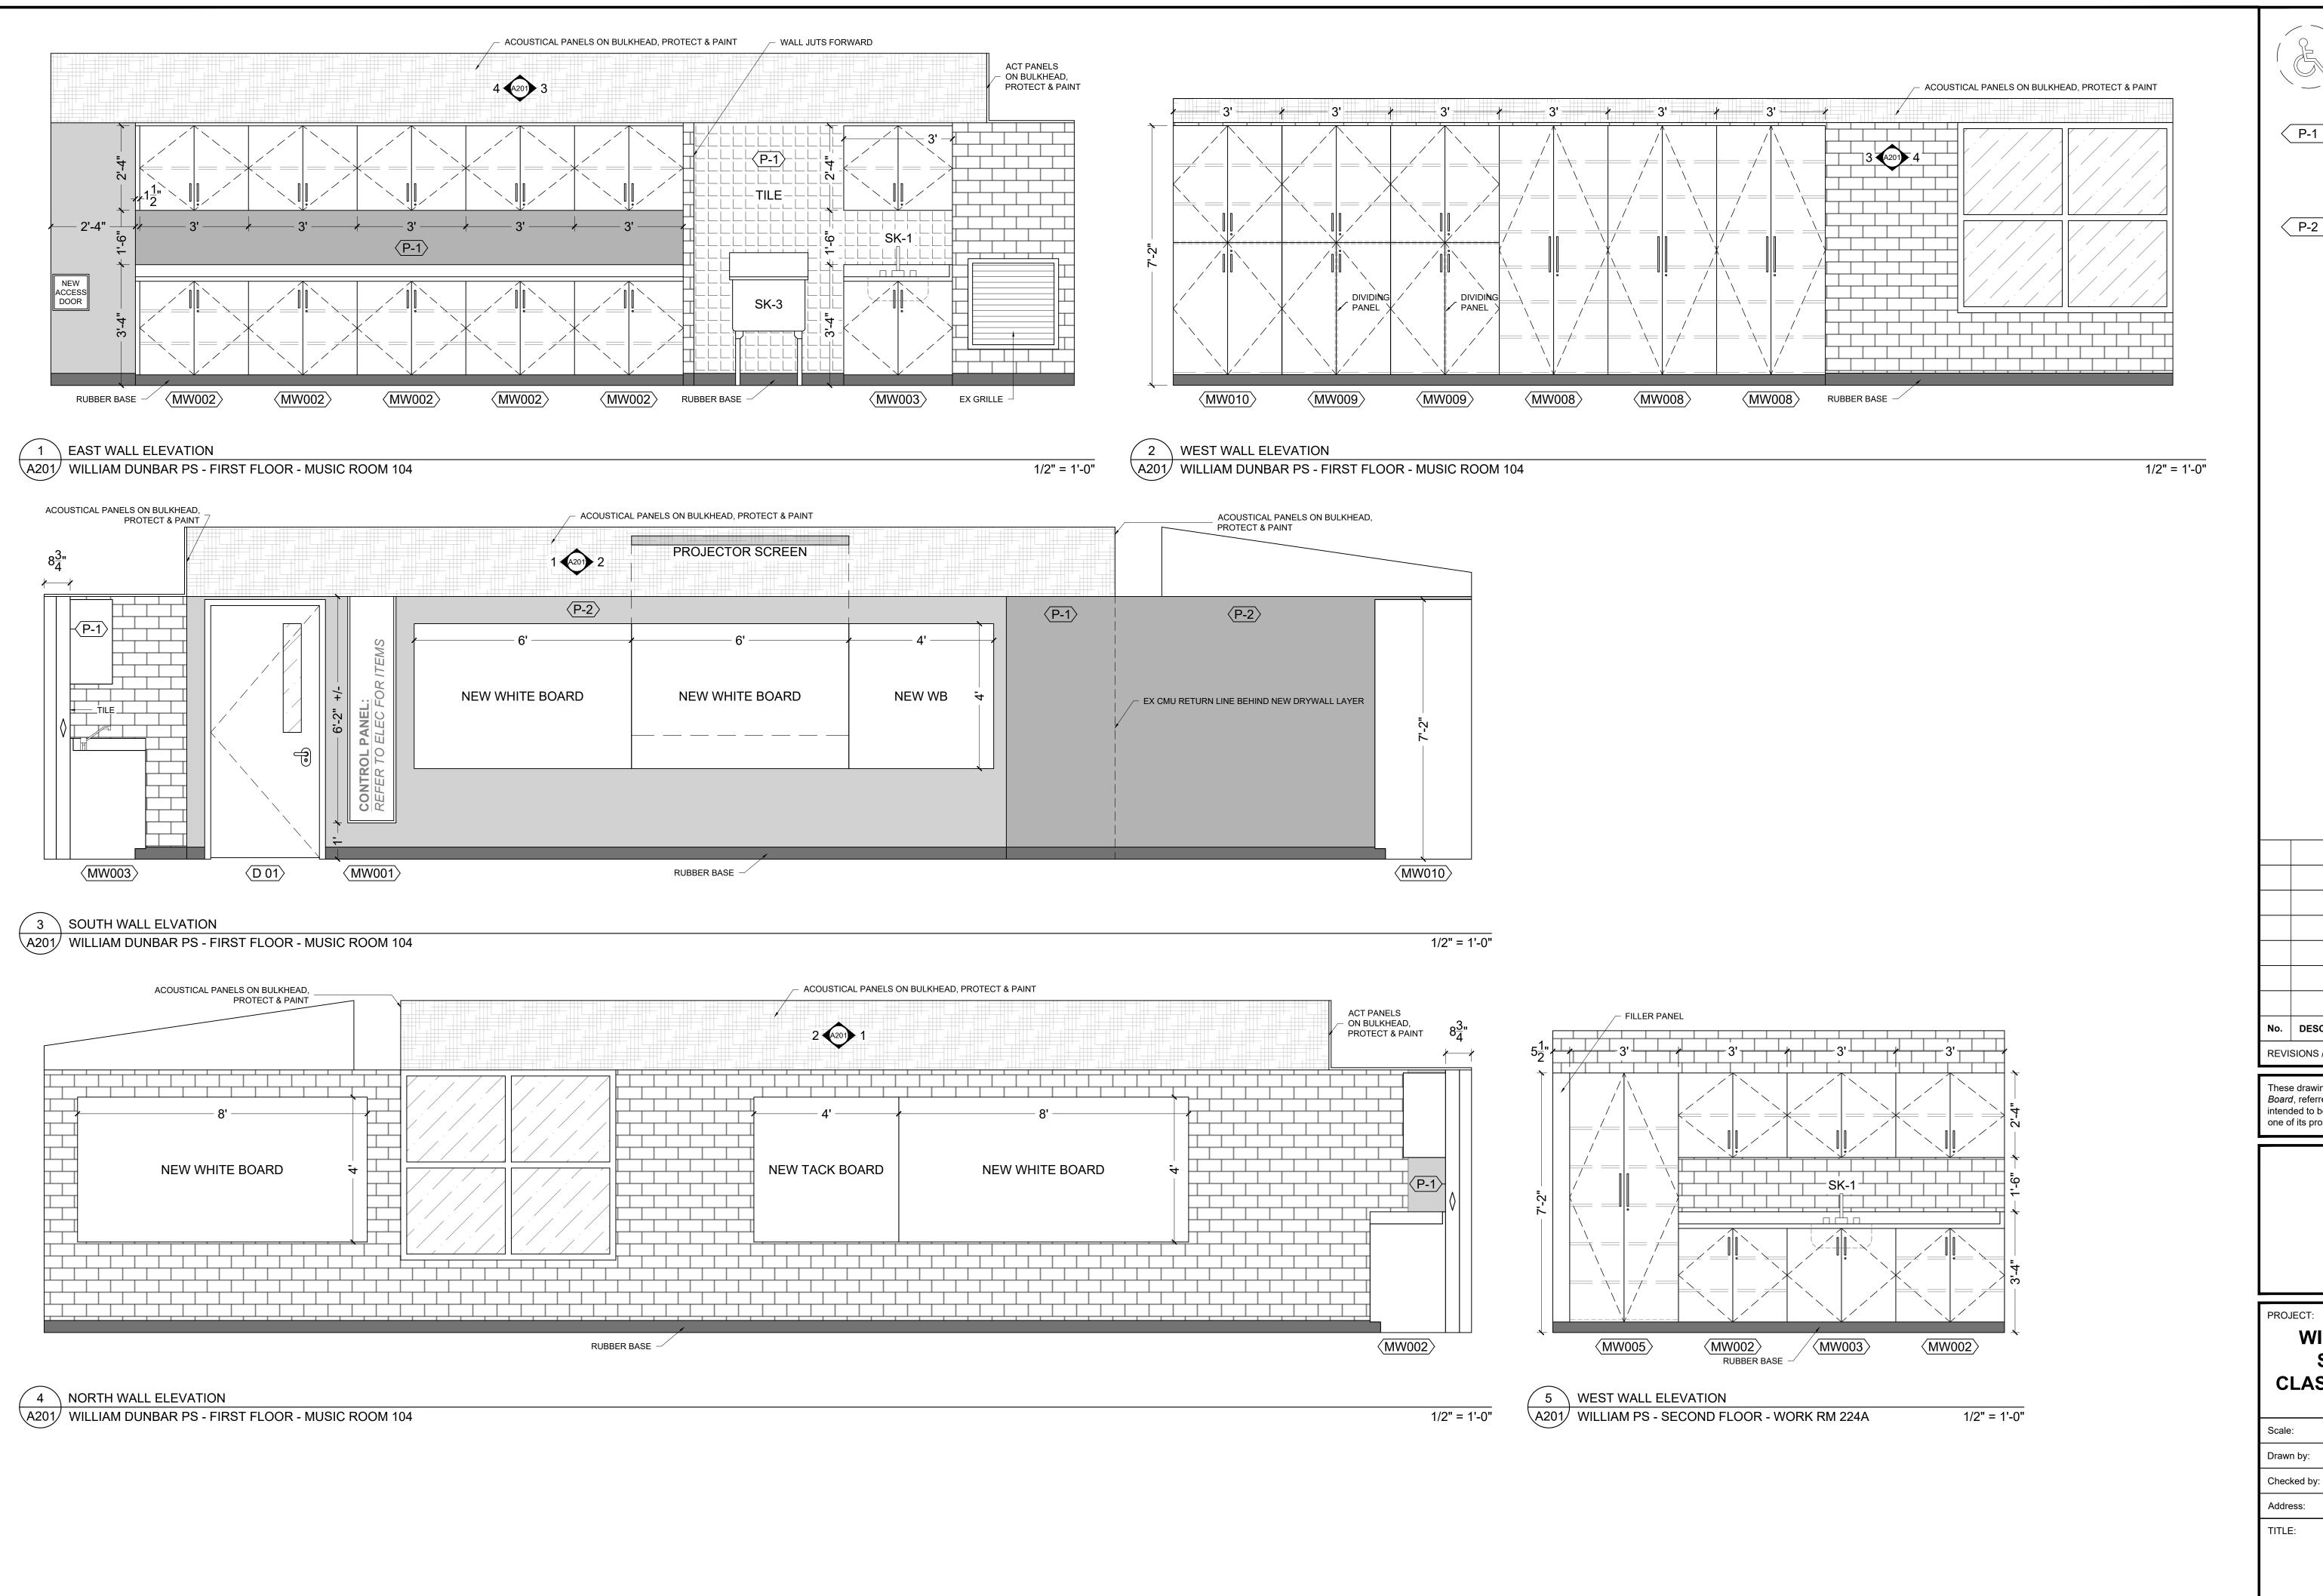

INDICATES 1800mm DIA.
BARRIER FREE TURNING
RADIUS (2130mm IN BARRIER
FREE WASHROOMS) REQUIRED

P-1 DENOTES 118mm FURRING W: 92mm METAL STUD,

92mm METAL STUD, 13mm PLYWOOD, 13mm GYPSUM.

P-2 DENG

DENOTES 13mm GYPSUM ON EXISTING CMU: EXISTING CMU WALL, 13mm GYPSUM.

No. DESCRIPTION BY DATE

REVISIONS / STATUS

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WILLIAM DUNBAR ART, SCIENCE, MUSIC, & CLASSROOM ALTERATIONS

Project No: T25-01

Scale: AS NOTED

Drawn by: lain Meldrum


Checked by: Chris Thaler


Address: 1030 Glenanna Rd, Pickering, ON L1V 5E5


ELEVATIONS (1)






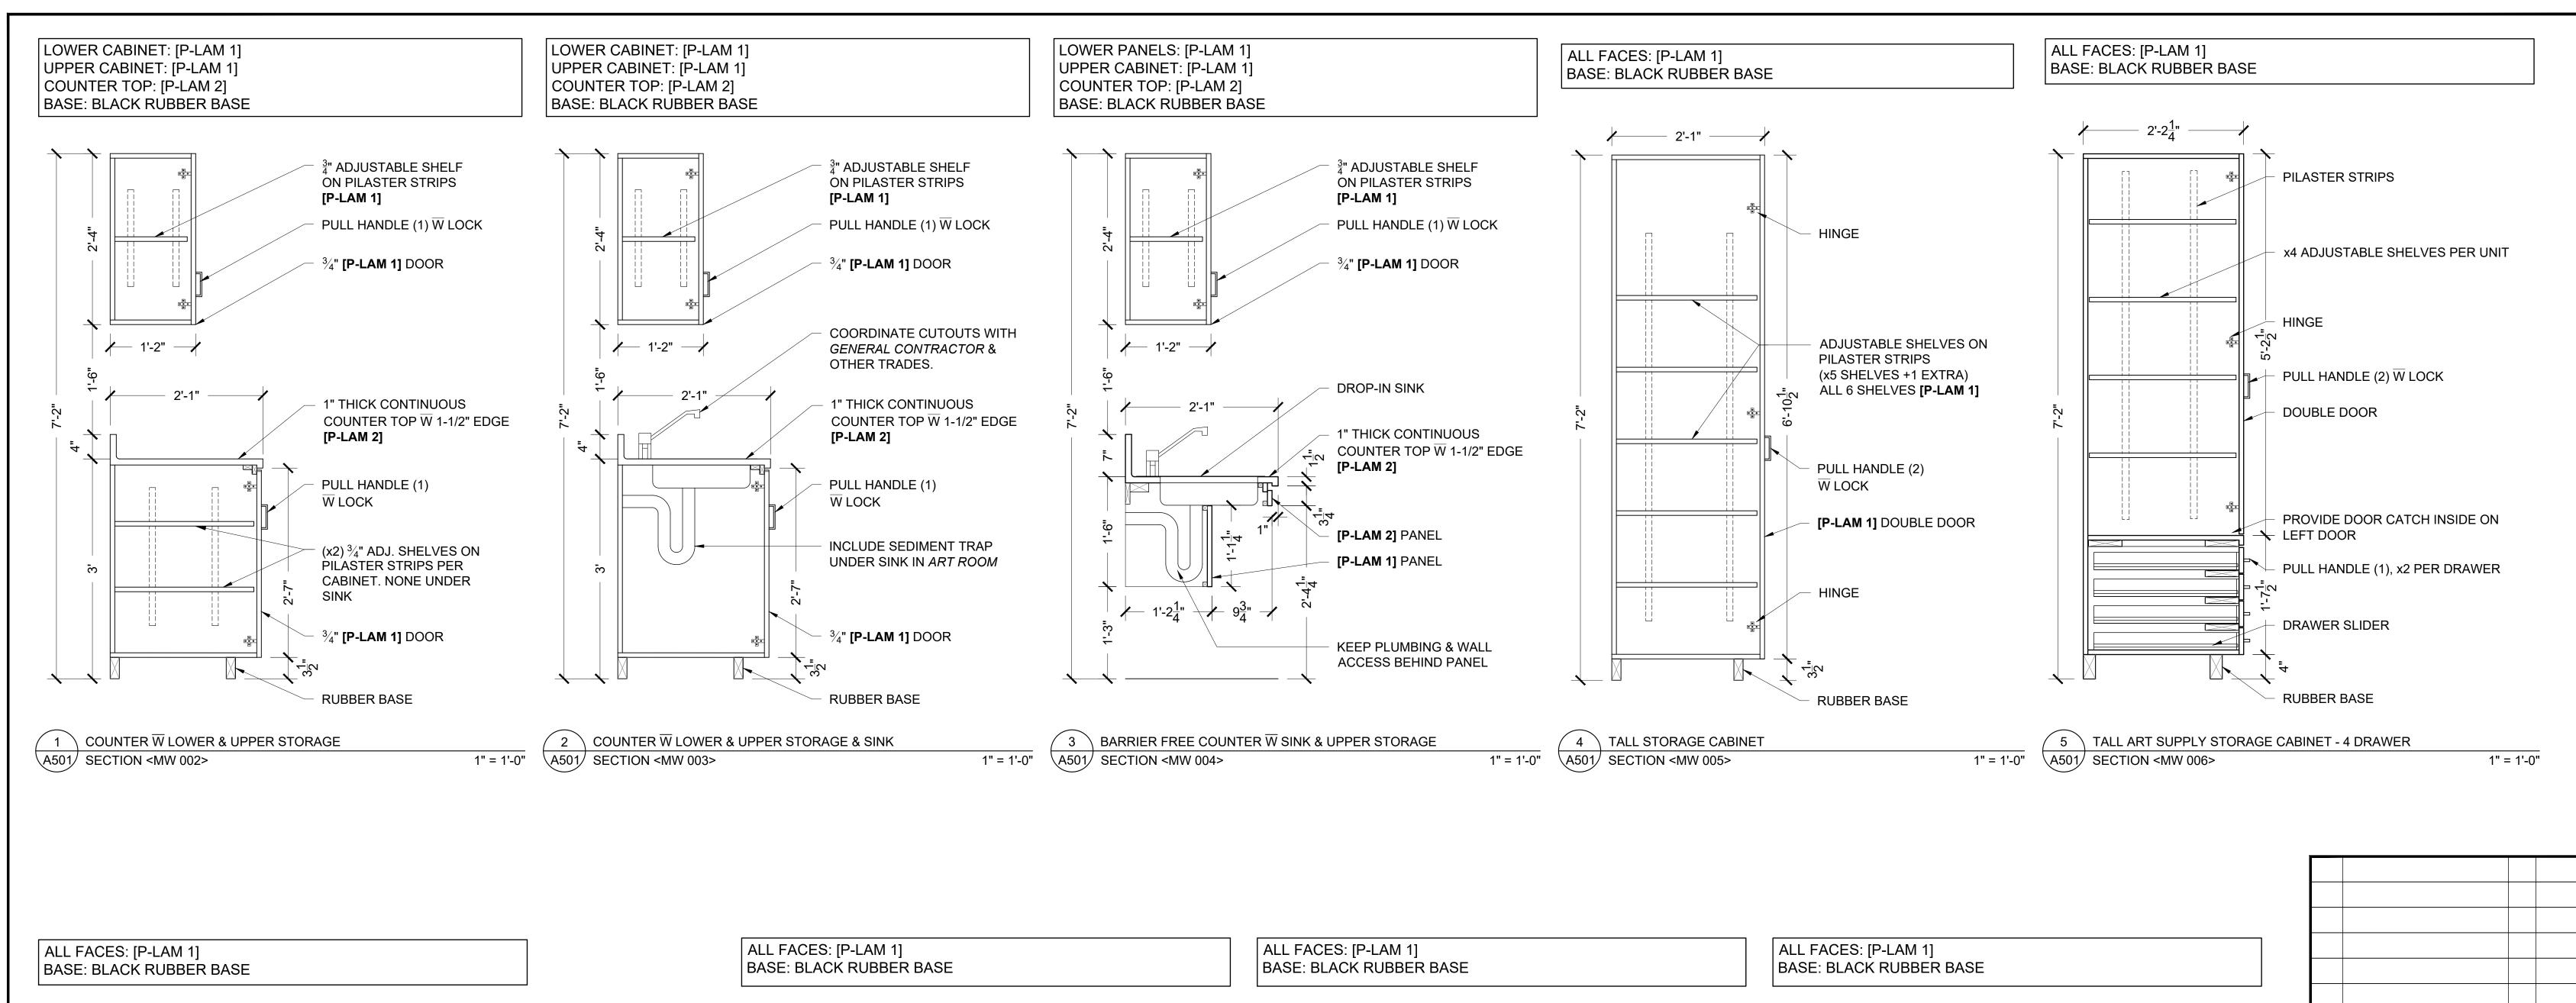

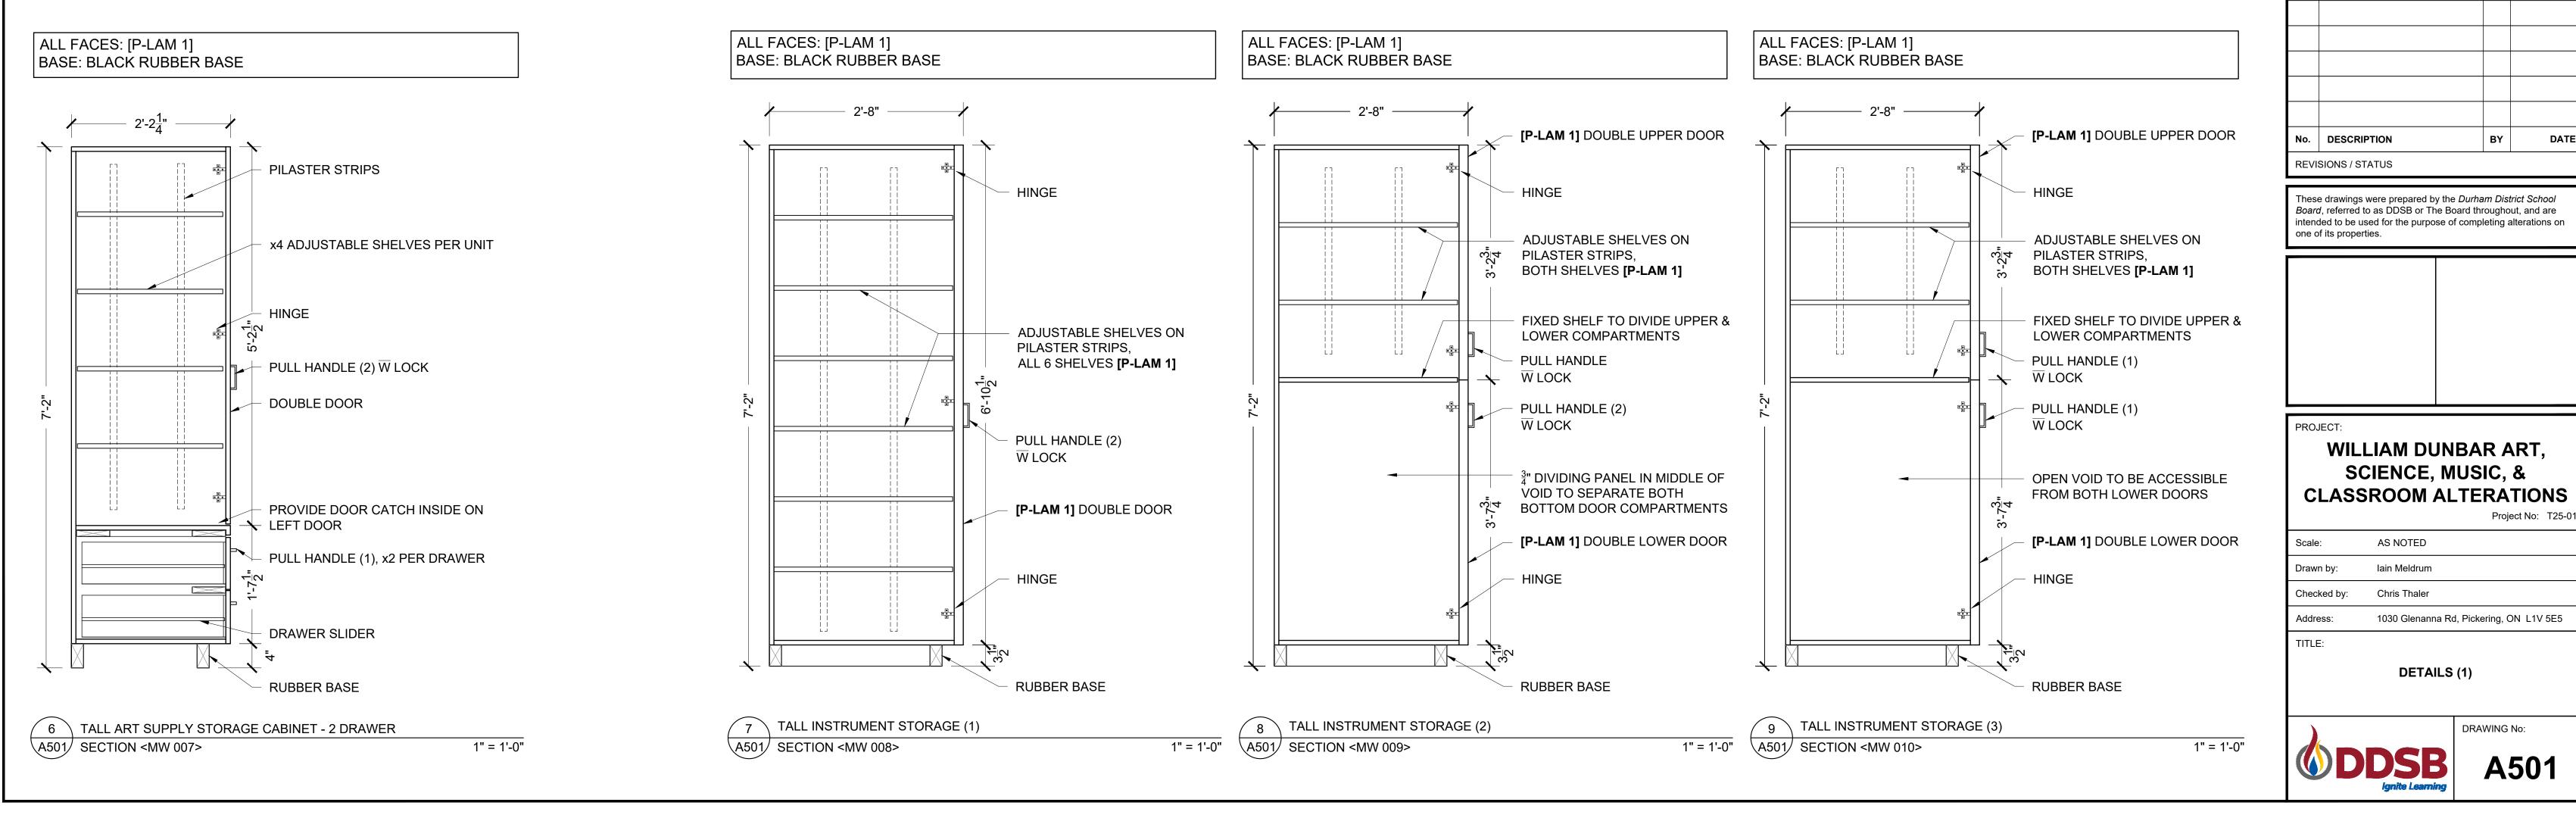

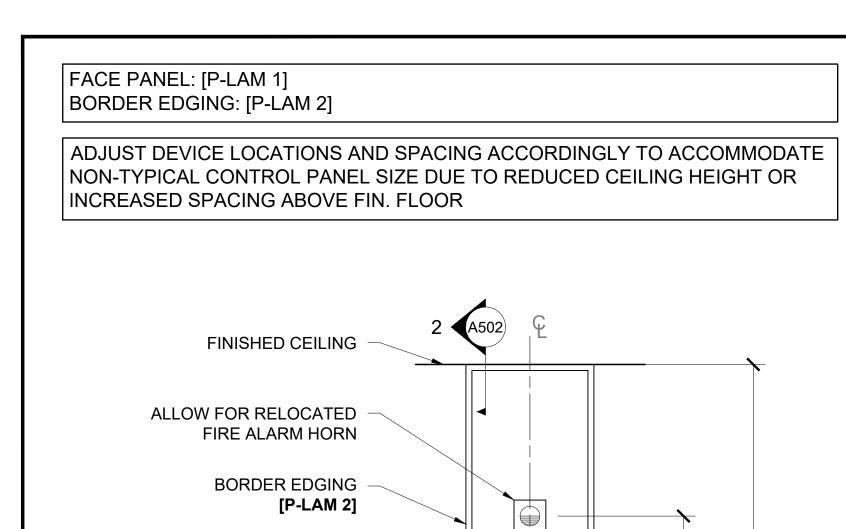

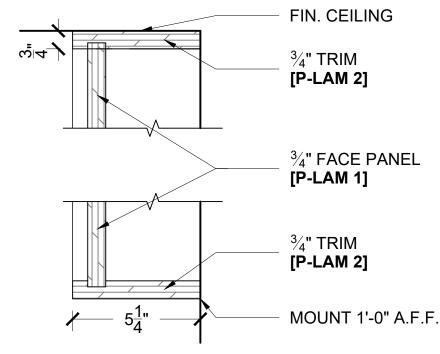

2 CONTROL PANEL A502 SECTION <MW 001>

1 \ CONTROL PANEL A502 ELEVATION <MW 001>

ALLOW FOR EXIST. ANALOG CLOCK

ALLOW FOR THERMOSTAT

ALLOW FOR CALL SWITCH CUTOUT: VALCOM V2791 W INTEGRAL VOLUME CONTROL

LIGHT SWITCHES, x2 PER

PLASTIC LAMINATE FACE

3/4" PLYWOOD PANEL

TYPICAL DUPLEX

TYP. RUBBER BASE

FINISHED FLOOR

[P-LAM 1]


2 (A502)

CONTROL PANEL


CONTROL PANEL

3" = 1'-0"

ALL FACES OF CABINET: [P-LAM 1] CONTINUOUS TOP SURFACE: [P-LAM 2] BASE: BLACK RUBBER BASE

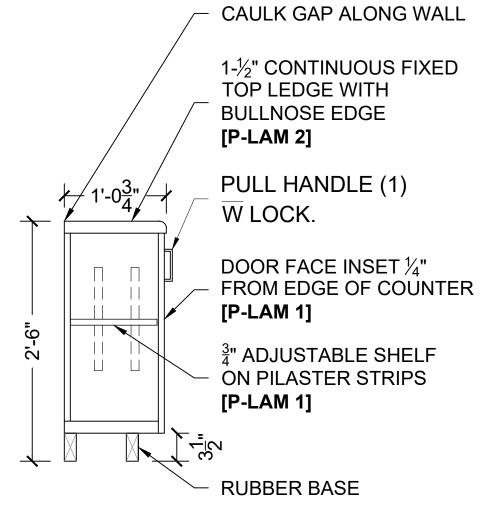

4 LOW COUNTER \overline{W} DOORS A502 SECTION <MW 011> 1" = 1'-0" ALL FACES OF CABINET: [P-LAM 1] CONTINUOUS TOP SURFACE: [P-LAM 2] BASE: P-LAM. RUBBER BASE ALONG WALL, BEHIND

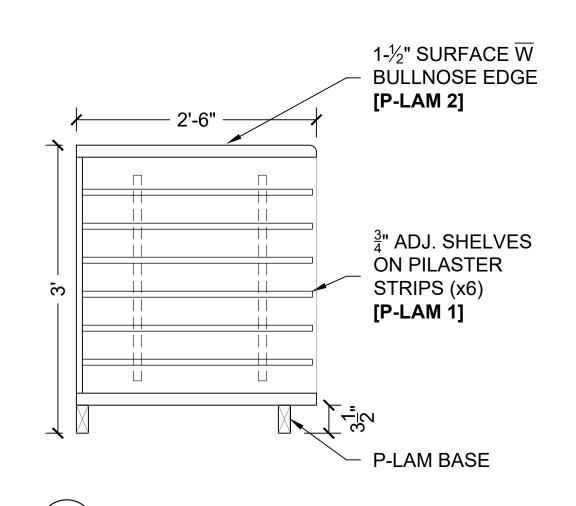

ART PAPER STORAGE COUNTER A502 SECTION < MW 012> 1" = 1'-0"

13mm GYPSUM. DENOTES 13mm GYPSUM ON **EXISTING CMU:** EXISTING CMU WALL, 13mm GYPSUM.

INDICATES 1800mm DIA.


BARRIER FREE TURNING

RADIUS (2130mm IN BARRIER


FREE WASHROOMS) REQUIRED

DENOTES 118mm FURRING $\overline{\mathrm{W}}$:

92mm METAL STUD, 13mm PLYWOOD,

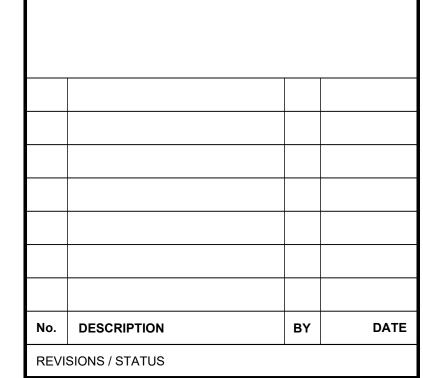

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WILLIAM DUNBAR ART, SCIENCE, MUSIC, & **CLASSROOM ALTERATIONS**

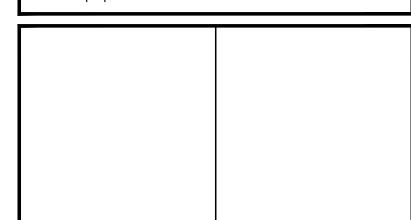Project No: T25-01

AS NOTED Scale:

Drawn by: lain Meldrum Chris Thaler Checked by:


1030 Glenanna Rd, Pickering, ON L1V 5E5 Address:

TITLE:

DETAILS (2)





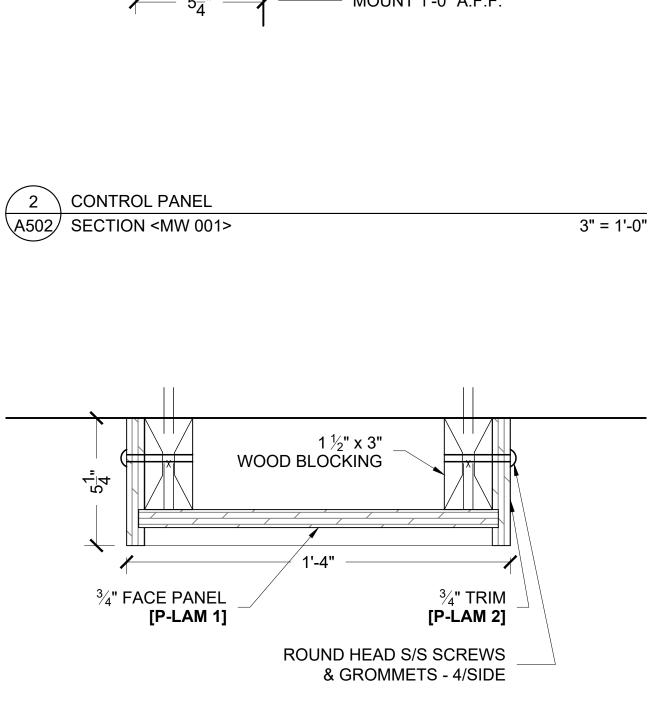





	PAINT FINISHES								
PT 1	UNIVERSAL GREY [00NN 62/000] FROM DULUX*								
PT 2	ASPHALT [CC-548] FROM BENJAMIN MOORE*								
CEILING	CEILING WHITE [615D0115] FROM DULUX* (TO INCLUDE BULKHEAD	DS)							
MUSIC RM PANELS	UNIVERSAL GREY [00NN 62/000] FROM DULUX*								
FRAME	ASPHALT [CC-548] FROM BENJAMIN MOORE* (TO INCLUDE DOOF	RS)							
	*OR APPROVED ALTERNATE								

	BASEBOARD FINISHES							
B - 1	B - 1 BLACK [40] 4" RUBBER BY JOHNSONITE*							
	*OR APPROVED ALTERNATE							

	WALL TILE							
TILE	TILE (COOL GREY) BEAUBRIDGE TILES BY CENTURA* 12"x24"							
GROUT	GROUT (RAIN) BY MAPEI*							
*OR APPROVED ALTERNATE								

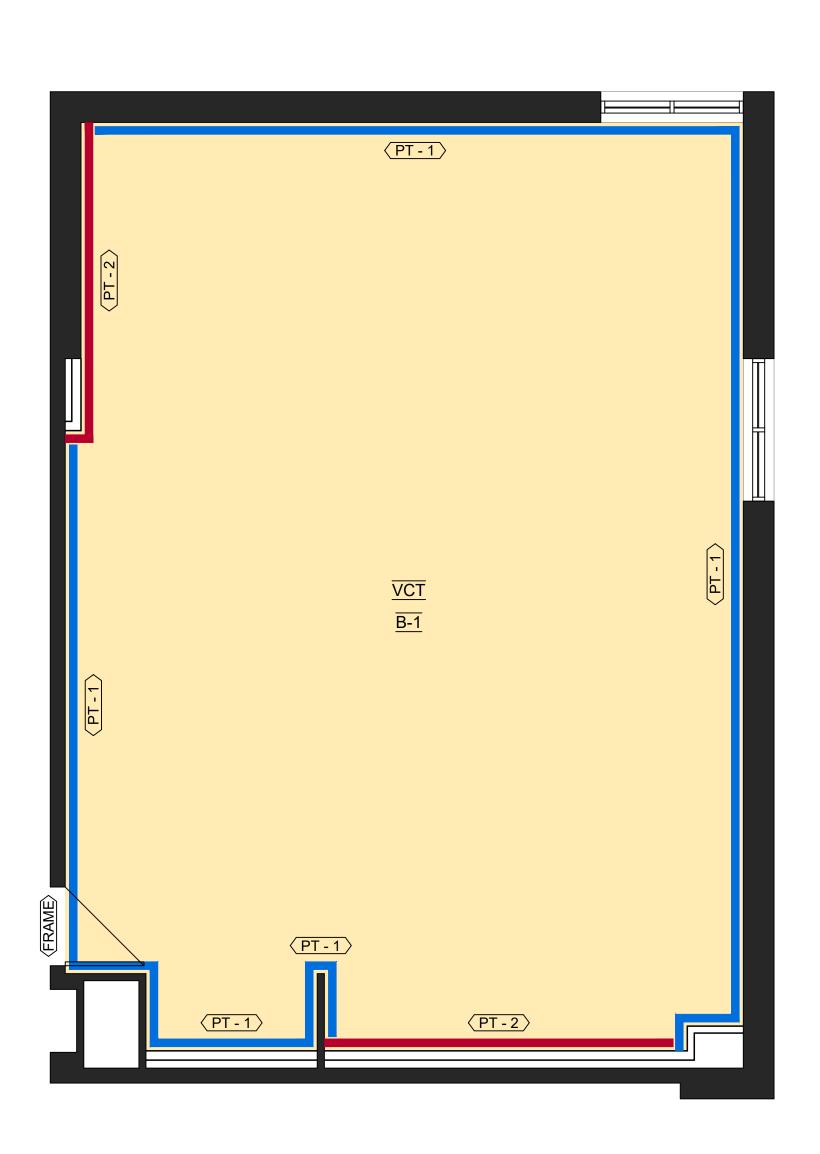

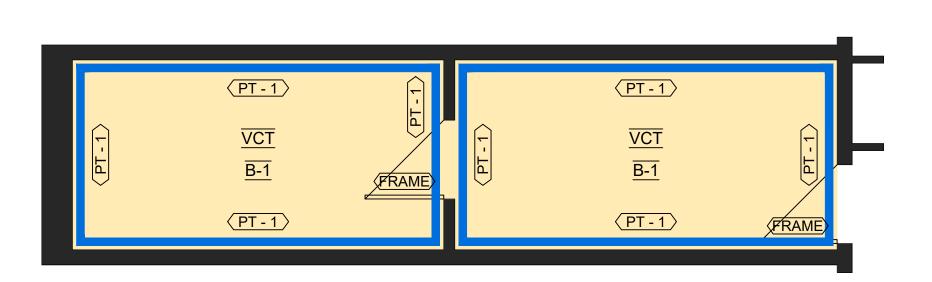

PRELUDE XL EXPOSED TEE SYSTEM* *OR APPROVED ALTERNATE

CEILING FINISHES ACOUSTIC PANELS: NON FIRE RATED CEILINGS TO CAN/CGSB-92.1 TYPE: MINERAL COMPOSITION & SAG RESISTANT. **PATTERN:** NON-DIRECTIONAL FISSURES. FLAME SPREAD RATING OF 25 OF LESS. SMOKE DEVELOPMENT CLASS OF 50 OR LESS. NOISE REDUCTION COEFFICIENT (NRC) DESIGNATION OF .55 MINIMUM. **EDGE TYPE:** SQUARE. COLOUR: WHITE. ACT SIZE: 16mm MINIMUM THICKNESS, 610mm X 1220mm. SHAPE: FLAT. ACCEPTABLE PRODUCTS*: 1. ARMSTRONG WORLD INDUSTRIES CANADA LTD.: FINE FISSURED 1729. 2. CERTAINTEED CEILINGS: VANTAGE 10, VAN-197. 3. CGC INTERIORS: RADAR CLIMAPLUS 2410. TYPE 1 (T-BAR - 1) TWO DIRECTIONAL EXPOSED TEE-BAR GRID, DOUBLE WEB. ARMSTRONG WORLD INDUSTRIES CANADA LTD:


NDICATES 1800mm DIA. BARRIER FREE TURNING RADIUS (2130mm IN BARRIER FREE WASHROOMS) REQUIRED

DENOTES 118mm FURRING \overline{W} : 92mm METAL STUD, 13mm PLYWOOD, 13mm GYPSUM.

DENOTES 13mm GYPSUM ON **EXISTING CMU:** EXISTING CMU WALL, 13mm GYPSUM.

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WILLIAM DUNBAR ART, SCIENCE, MUSIC, & **CLASSROOM ALTERATIONS**

AS NOTED

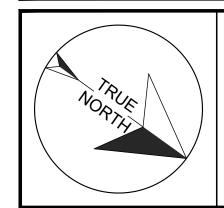Drawn by: Chris Thaler Checked by:

Address: TITLE:

FINISH SCHEDULE

1030 Glenanna Rd, Pickering, ON L1V 5E5

A601





(PT - 1)



	DOOR SCHEDULE															
TAG NUMBER	STATUS				DOOR FI	RAME				DOOR					MISCELLAN	EOUS
TAG NUMBER	LEFT HAND	RIGHT HANG	ORIGIN	DESTINATION	WIDTH	HEIGHT	MATERIAL	SIDELITE	PAINT	WIDTH	HEIGHT	MATERIAL	HARDWARE	GLASS	DWG#	NOTES
D 01		•	MUSIC ROOM 104	UNCHANGED	EXIST.	EXIST.	НМ	NO	YES	EXIST.	EXIST.	НМ	EXISTING	EXISTING	NA	EXISTING DOOR & FRAME SHALL REMAIN, PROTECT SURFACES THROUGHOUT CONSTRUCTION AND PAINT ALL FACES, LESS THE CORRIDOR SIDE.
D 02	•		SCIENCE 224	UNCHANGED	EXIST.	EXIST.	НМ	NO	YES	EXIST.	EXIST.	НМ	EXISTING	EXISTING	NA	EXISTING DOOR & FRAME SHALL REMAIN, PROTECT SURFACES THROUGHOUT CONSTRUCTION AND PAINT ALL FACES, LESS THE CORRIDOR SIDE.
D 03		•	ART 225	UNCHANGED	EXIST.	EXIST.	НМ	NO	YES	EXIST.	EXIST.	НМ	EXISTING	EXISTING	NA	EXISTING DOOR & FRAME SHALL REMAIN, PROTECT SURFACES THROUGHOUT CONSTRUCTION AND PAINT ALL FACES, LESS THE CORRIDOR SIDE.
D 04		•	WORK RM 224A	UNCHANGED	EXIST.	EXIST.	НМ	NO	YES	EXIST.	EXIST.	НМ	EXISTING	EXISTING	NA	EXISTING DOOR & FRAME SHALL REMAIN, PROTECT SURFACES THROUGHOUT CONSTRUCTION AND PAINT ALL FACES, LESS THE CORRIDOR SIDE.
D 05		•	WORK RM 224A	UNCHANGED	EXIST.	EXIST.	НМ	NO	YES	EXIST.	EXIST.	НМ	EXISTING	EXISTING	NA	EXISTING DOOR & FRAME SHALL REMAIN, PROTECT SURFACES THROUGHOUT CONSTRUCTION AND PAINT ALL FACES.

MILLWORK GENERAL NOTES:

- 1. MILLWORK TO BE ¾" (UNLESS OTHERWISE NOTED) PLYWOOD WITH PLASTIC LAMINATE FINISH ON ALL EXPOSED FACES AND EDGES {INSIDE **AND** OUTSIDE}.
 2. THE "GRAIN" OR "PATTERN" SHALL RUN THE SAME DIRECTION TO SIMILAR, ADJACENT UNITS, PREFERING TO RUN LENGTH WISE.
- 3. NO SHARP EDGES SHALL BE ALLOWED, AND LAMINATE FINISH SHALL BE FREE OF CHIPS AND BREAKAGE.
- 4. ALL SURFACES TO BE CLEAN AND FREE OF MARKINGS.

	MILLWORK SCHEDULE							
TAG#	DWG#	SHEET	QUANTITY	DESCRIPTION				
MW001	1 - 3	A502	x7+	[P-LAM 1] CUSTOM CONTROL PANEL FACE. TRIM / EDGING TO BE [P-LAM 2]. COORDINATE WITH ELECTRICAL FOR CUTOUTS.				
MW002	1	A501	x25+	[P-LAM 1] UPPER & [P-LAM 1] LOWER STORAGE \overline{W} [P-LAM 2] COUNTER TOP. x2 DOUBLE DOORS @ 1'-6" /EA. UPPER AND LOWER DOORS TO ALIGN. PROVIDE x2 ADJUSTABLE SHELVES IN LOWER CABINET AND x1 ADJUSTABLE SHELF IN UPPER CABINET PER UNIT.				
MW003	2	A501	x10+	[P-LAM 1] UPPER & [P-LAM 1] LOWER STORAGE W [P-LAM 2] COUNTER TOP AND DROP-IN SINK, CENTERED. x2 DOUBLE DOORS @ 1'-6" /EA. UPPER AND LOWER DOORS TO ALIGN. PROVIDE x1 ADJUSTABLE SHELF IN UPPER CABINET PER UNIT.				
MW004	3	A501	x2	[P-LAM 1] UPPER STORAGE W [P-LAM 2] BARRIER FREE COUNTER TOP AND DROP-IN SINK. 1'-6" /EA DOORS ON UPPERS. PROVIDE x1 ADJUSTABLE SHELF IN EACH UPPER CABINET. COORDINATE CUT-OUT FOR SINK. LOWER PANELS [P-LAM 1]				
MW005	4	A501	х9+	[P-LAM 1] (2'-0" W x 3'-0" L x 7'-2" H) STORAGE CABINET. INCLUDE x6 ADJUSTABLE SHELVES ON PILASTER STRIPS PER UNIT.				
MW006	5	A501	x1	[P-LAM 1] (2'-2 1/4" W x 3'-0" L x 7'-2" H) ART SUPPLY STORAGE CABINET. INCLUDE x4 ADJUSTABLE SHELVES ON PILASTER STRIPS PER UNIT & x4 DRAWERS.				
MW007	6	A501	x2	[P-LAM 1] (2'-2 1/4" W x 3'-0" L x 7'-2" H) ART SUPPLY STORAGE CABINET. INCLUDE x4 ADJUSTABLE SHELVES ON PILASTER STRIPS PER UNIT & x2 DRAWERS.				
MW008	7	A501	х3	[P-LAM 1] (2'-8" W x 3'-0" L x 7'-2" H) INSTRUMENT SUPPLY STORAGE CABINET. INCLUDE x6 ADJUSTABLE SHELVES ON PILASTER STRIPS PER UNIT.				
MW009	8	A501	x2	[P-LAM 1] (2'-8" W x 3'-0" L x 7'-2" H) INSTRUMENT SUPPLY STORAGE CABINET \overline{W} UPPER & LOWER DOORS. INCLUDE x2 ADJUSTABLE SHELVES ON PILASTER STRIPS PER UNIT IN UPPER PORTION AND CENTER DIVIDING PANEL IN LOWER PORTION.				
MW010	9	A501	x1	[P-LAM 1] (2'-8" W x 3'-0" L x 7'-2" H) INSTRUMENT SUPPLY STORAGE CABINET WUPPER & LOWER DOORS. INCLUDE x2 ADJUSTABLE SHELVES ON PILASTER STRIPS PER UNIT IN UPPER PORTION AND LARGE VOID IN LOWER PORTION.				
MW011	4	A502	x20+	[P-LAM 1] (1'- $\frac{3}{4}$ " W x 3'-0" L x 2'-6" H) LOW COUNTER WITH DOORS. [P-LAM 2] CONTINUOUS COUNTER TOP ACROSS ADJACENT UNITS. INCLUDE x1 ADJUSTABLE SHELF PER UNIT.				
MW012	5	A502	x1	[P-LAM 1] (30" W x 41" L x 3'-0" H) OPEN UNIT WITH SIX (x6) ADJUSTABLE SHELVES AND [P-LAM 2] COUNTER TOP.				

	MILLWORK HARDWARE & SPECIFICATIONS						
HANDLES (1)	HANDLES (1) MODERN METAL PULL - BP9256160140 (CHROME) FROM RICHELIEU. CENTER TO CENTER: 160mm, OVERALL LENGTH: 182mm						
HANDLES (2) MODERN METAL PULL - BP9256320140 (CHROME) FROM RICHELIEU. CENTER TO CENTER: 320mm, OVERALL LENGTH: 342mm							
HINGES BLUM 125 DEGREE SELF CLOSING							
DRAWER SLIDERS	ACCURIDE - FULL EXTENSION						
PILASTER STRIPS & CLIPS	U-SHAPED STEEL PILASTER - 2552G96 (ZINC), PILASTER SHELF CLIP - 25622G (STEEL, ZINC FINISH) - ALL BY KNAPE & VOGT, FROM RICHELIEU						

		MILLWORK FINISHES
P-LAM 1	HARD ROCK MAPLE [86992 - 58] BY FORMICA	(MATTE FINISH)
P-LAM 2	COSMIC STRANDZ [4941K - 60] BY WILSONART	(MATTE FINISH)

No.	DESCRIPTION	BY	DATE			
REVI	REVISIONS / STATUS					

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PROJECT:

WILLIAM DUNBAR ART, SCIENCE, MUSIC, & **CLASSROOM ALTERATIONS**

Scale: AS NOTED

Drawn by: lain Meldrum

Checked by: Chris Thaler 1030 Glenanna Rd, Pickering, ON L1V 5E5 Address:


TITLE:

MILLWORK & DOOR SCHEDULES



DRAWING No:

Project No: T25-01

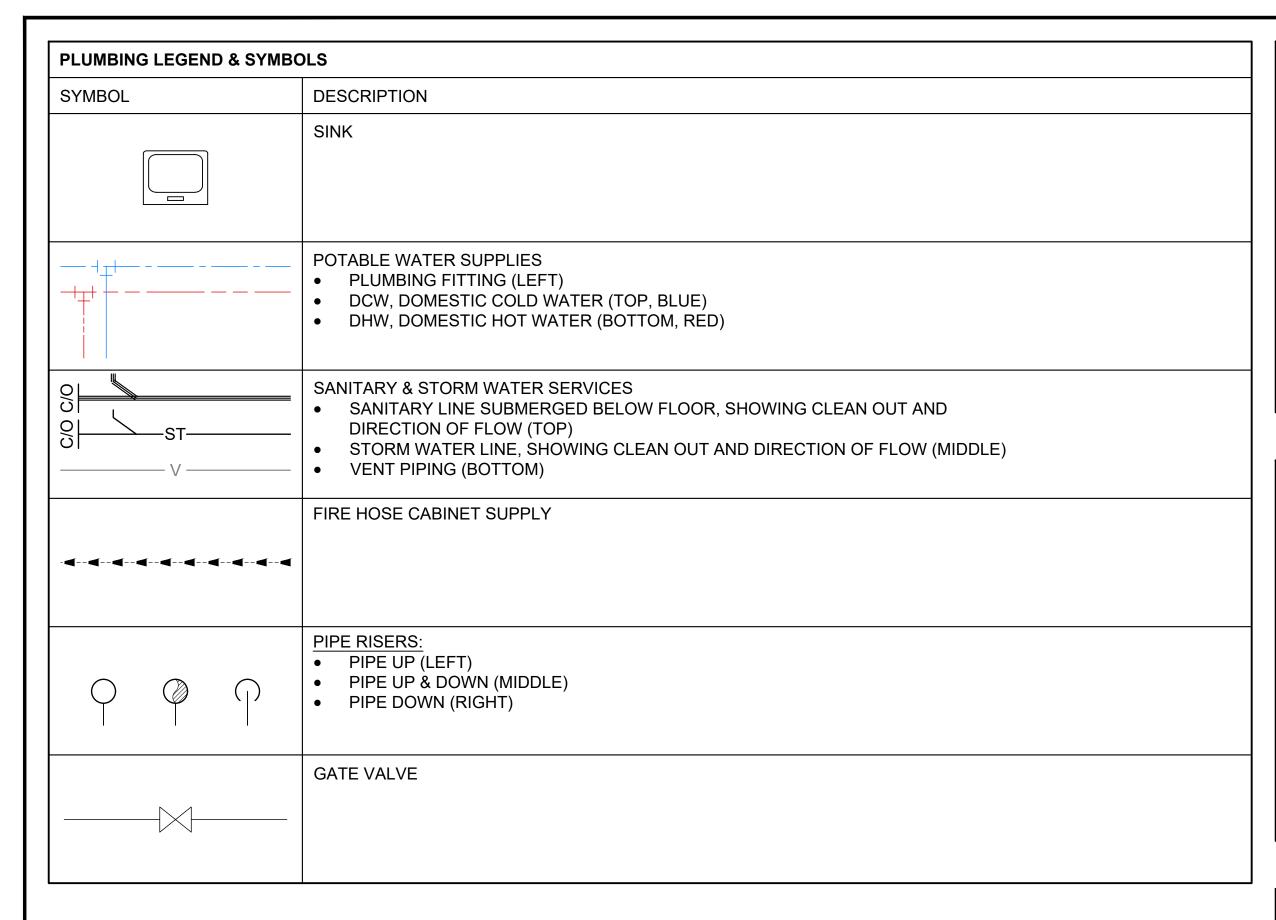

MECHANICAL ABBREVIA	ATIONS
AFF	ABOVE FINISHED FLOOR
BFC	BELOW FINISHED CEILING
C/O	CLEAN OUT
CTE	CONNECT TO EXISTING
C/W	COMPLETE WITH
D	EXISTING EQUIPMENT TO BE REMOVED. WIRING BACK TO SOURCE
DN	DOWN
DCW	DOMESTIC COLD WATER
DHW	DOMESTIC HOT WATER
DHWR	DOMESTIC HOT WATER RECIRC.
EX	EXISTING EQUIPMENT, TO REMAIN
FD	FLOOR DRAIN
F.E.A.	FUME HOOD EXHAUST AIR
FH	FIRE HYDRANT
FHC	FIRE HOSE CABINET
FPB	FAN-POWERED BOX
RET	RETURN
RL	EXISTING EQUIPMENT TO BE RELOCATED. EXTEND FEED AS REQUIRED
RTU	ROOF TOP UNIT
SAN.	SANITARY
SUP	SUPPLY
V	VENT
VAV	VARIABLE AIR VOLUME BOX
VAVR	VARIABLE AIR VOLUME BOX WITH REHEAT
x #	QUANTITY OF DEVICES

SK - 1 COUNTERTOP MOUNT ART & MUSIC ROOM SINK - TWO HANDLE FAUCET:

FRANKE COMMERCIAL #LBS681OP-1/3 SINGLE BOWL COUNTERTOP MOUNT SINK, 3 HOLES, 8" (203mm) CENTER, 20 $\frac{1}{8}$ " (511mm) WIDE x 20 $\frac{9}{16}$ " (522mm) LONG x 10" (254mm) HIGH, COUNTER MOUNTED, BACKLEDGE, GRADE 18-10 18 GA. (1.2mm) TYPE 304 STAINLESS STEEL, SELF-RIMMING, SATIN FINISH RIM AND BOWLS, MOUNTING KIT PROVIDED, FULLY UNDERCOATED TO REDUCE CONDENSATION AND RESONANCE, FACTORY APPLIED RIM SEAL, 3 $\frac{1}{2}$ " (89mm) CRUMB CUP WASTE ASSEMBLY WITH 1 $\frac{1}{2}$ " (38mm) TAILPIECE.

MOEN COMMERCIAL #8287 TWO HANDLE KITCHEN FAUCET, DECK MOUNT, BRASS CONSTRUCTION WITH CHROME PLATED FINISH, VANDAL RESISTANT TORX HEAD SCREWS, LEVER STYLE HANDLES WITH HOT AND COLD WATER COLOUR INDICATORS, 1.5 GPM MAX (5.7L/min) @ 60 PSI, 8" (203mm) CENTER.

McGUIRE #LFH170BV FAUCET SUPPLIES, CHROME PLATED FINISH POLISHED BRASS, COMMERCIAL DUTY 1/4 TURN BALL VALVE ANGLE STOPS, 1 (13mm) I.D. INLET x 5" (127mm) HORIZONTAL EXTENSION TUBES, COMBINATION V.P. LOOSE KEY HANDLES, ESCUTCHEON AND FLEXIBLE COPPER RISERS.

McGUIRE #8912CB P-TRAP, HEAVY CAST BRASS ADJUSTABLE BODY, WITH SLIP NUT, $1\frac{1}{2}$ " (38mm) SIZE, BOX FLANGE AND SEAMLESS TUBULAR WALL BEND.

SK - 2 COUNTERTOP MOUNT SCIENCE ROOM SINK - TWO HANDLE FAUCET:

FRANKE COMMERCIAL #LBS4607 / 316-1 / 3 SINGLE BOWL COUNTERTOP MOUNT SINK, 3 HOLES, $18\frac{1}{8}$ " (460mm) WIDE x $18\frac{13}{16}$ " (478mm) LONG x 7" (178mm) HIGH, COUNTER MOUNTED, BACKLEDGE, GRADE 18-8 20 GA. (0.9mm) TYPE 316 STAINLESS STEEL, SELF-RIMMING, SATIN FINISH RIM AND BOWLS, MOUNTING KIT PROVIDED, FULLY UNDERCOATED TO REDUCE CONDENSATION AND RESONANCE, FACTORY APPLIED RIM SEAL, $3\frac{1}{9}$ " (89mm) CRUMB CUP WASTE ASSEMBLY WITH $1\frac{1}{9}$ " (38mm) TAILPIECE.

MOEN COMMERCIAL #8280 TWO HANDLE BASE, COMPLETE WITH VACUUM BREAKERS, DECK MOUNT, BRASS CONSTRUCTION WITH CHROME PLATED FINISH, VANDAL RESISTANT TORX HEAD SCREWS, LEVER STYLE HANDLES WITH HOT AND COLD WATER COLOUR INDICATORS, 1.5 GPM MAX (5.7L/min) @ 60 PSI, 8" (203mm) CENTER. BASE ONLY, NO SPOUT.

MOEN COMMERCIAL #SV003, M-DURE COMMERCIAL SPOUT, BRASS CONSTRUCTION WITH CHOME PLATED FINISH, SWING SPOUT. NO BASE, SPOUT ONLY.

McGUIRE #LFH170BV FAUCET SUPPLIES, CHROME PLATED FINISH POLISHED BRASS, COMMERCIAL DUTY 1/4 TURN BALL VALVE ANGLE STOPS, $\frac{1}{2}$ " (13mm) I.D. INLET x 5" (127mm) HORIZONTAL EXTENSION TUBES, COMBINATION V.P. LOOSE KEY HANDLES, ESCUTCHEON AND FLEXIBLE COPPER RISERS. PROVIDE P-TRAP, ACID RESISTANT, 1 $\frac{1}{2}$ " (38mm) SIZE.

SK - 3 FLOOR MOUNT MUSIC ROOM SINK - TWO HANDLE MANUAL FAUCET:

FRANKE COMMERCIAL #SL2424-1/2 SINGLE BOWL SCULLERY SINK, 2 HOLE, 8" (203mm) CENTER, 27 $\frac{3}{8}$ " (695mm) WIDE x 27 $\frac{3}{16}$ " (691mm) LONG x 35" (889mm) DEEP, FLOOR MOUNTED, FAUCET ON BACKSPLASH, GRADE 18-10 16 GA. (1.5mm) TYPE 304 STAINLESS STEEL, RIM AND BOWL POLISHED SATIN FINISH, 9" (229mm) HIGH BACKSPLASH, RADIUS COVERED CORNERS ON FRONT AND BACK ONLY, ROLLED RIM, STAINLESS STEEL TUBULAR LEGS WITH ADJUSTABLE FEET, 3 $\frac{1}{2}$ " (89mm) CRUMB CUP WASTE ASSEMBLY WITH 1 $\frac{1}{2}$ " (38mm) TAILPIECE.

MOEN COMMERCIAL #8126 WALL MOUNT UTILITY SINK TWO HANDLE MANUAL FACUET, ADJUSTABLE 8" (203mm) CENTERSET, LEAD FREE CHROME PLATED SOLID BRASS BODY, VANDAL RESISTANT 8.3LPM (2.2 GPM) AERATOR OUTLET, CERAMIC 1/4 TURN CARTRIGES, 8" (204mm) SWING SPOUT, 4" (102mm) WRIST BLADE HANDLES WITH HOT AND COLD WATER COLOUR INDICATORS AND VANDAL RESISTANT SCREWS.

McGUIRE #8912CB P-TRAP, HEAVY CAST BRASS ADJSUTABLE BODY, WITH SLIP NUT, $1\frac{1}{2}$ " (38mm) SIZE, BOX FLANGE AND SEAMLESS TUBULAR WALL BEND.

SK - 4 BARRIER FREE COUNTER MOUNT SINK - ART & SCIENCE ROOMS - TWO HANDLE FAUCET:

FRANKE COMMERCIAL #LBS4607 / 316-1 / 3 SINGLE BOWL COUNTERTOP MOUNT SINK, 3 HOLES, $18\frac{1}{8}$ " (460mm) WIDE x $18\frac{13}{16}$ " (478mm) LONG x 7" (178mm) HIGH, COUNTER MOUNTED, BACKLEDGE, GRADE 18-8 20 GA. (0.9mm) TYPE 316 STAINLESS STEEL, SELF-RIMMING, SATIN FINISH RIM AND BOWLS, MOUNTING KIT PROVIDED, FULLY UNDERCOATED TO REDUCE CONDENSATION AND RESONANCE, FACTORY APPLIED RIM SEAL, $3\frac{1}{2}$ " (89mm) CRUMB CUP WASTE ASSEMBLY WITH $1\frac{1}{2}$ " (38mm) TAILPIECE.

McGUIRE #LFH170BV FAUCET SUPPLIES, CHROME PLATED FINISH POLISHED BRASS, COMMERCIAL DUTY 1/4 TURN BALL VALVE ANGLE STOPS, $\frac{1}{2}$ " (13mm) I.D. INLET x 5" (127mm) HORIZONTAL EXTENSION TUBES, COMBINATION V.P. LOOSE KEY HANDLES, ESCUTCHEON AND FLEXIBLE COPPER RISERS. PROVIDE P-TRAP, ACID RESISTANT, 1 $\frac{1}{2}$ " (38mm) SIZE.

<u>WITHIN ART ROOM:</u>

MOEN COMMERCIAL #8287 TWO HANDLE KITCHEN FAUCET, DECK MOUNT, BRASS CONSTRUCTION WITH CHROME PLATED FINISH, VANDAL RESISTANT TORX HEAD SCREWS, LEVER STYLE HANDLES WITH HOT AND COLD WATER COLOUR INDICATORS, 1.5 GPM MAX (5.7L/min) @ 60 PSI, 8" (203mm) CENTER.

WITHIN SCIENCE ROOM

MOEN COMMERCIAL #8280 TWO HANDLE BASE, COMPLETE WITH VACUUM BREAKERS, DECK MOUNT, BRASS CONSTRUCTION WITH CHROME PLATED FINISH, VANDAL RESISTANT TORX HEAD SCREWS, LEVER STYLE HANDLES WITH HOT AND COLD WATER COLOUR INDICATORS, 1.5 GPM MAX (5.7L/min) @ 60 PSI, 8" (203mm) CENTER. BASE ONLY, NO SPOUT.

MOEN COMMERCIAL #SV003, M-DURE COMMERCIAL SPOUT, BRASS CONSTRUCTION WITH CHOME PLATED FINISH, SWING SPOUT. NO BASE, SPOUT ONLY.

INSULATION:

- . EXTERNAL PIPE INSULATION SHALL BE RIGID, SECTIONAL FIBERGLASS TYPE AND BE COMPLETE WITH FACTORY APPLIED ALL PURPOSE VAPOUR BARRIER, PRE-FORMED INSULATION SHALL BE USED AT PIPE FITTINGS, VALVES, ETC. PROVIDE NON-CRUSHING INSULATION AT ALL PIPE HANGERS AND PROVIDE SADDLES.
- 2. INSULATE DCW, DHW, AND DTW PIPING, 1" THICK.

PLUMBING SYSTEMS:

- DOMESTIC HOT AND COLD WATER PIPING (DHW & DCW) TYPE "L" COPPER WITH COPPER FITTINGS USE 95 / 5 TIN / ANTIMONY SOLDER. PROVIDE TYPE "K" SOFT COPPER PIPING WITHOUT JOINTS BELOW GROUND.
- 2. VENT ALL SANITARY PLUMBING FIXTURES IN ACCORDANCE WITH OBC SECTION 7. ALL PLUMBING TRAPS ARE TO BE PRIMED AND VENTED.



INDICATES 1800mm DIA.

BARRIER FREE TURNING
RADIUS (2130mm IN BARRIER
FREE WASHROOMS) REQUIRED




DENOTES 118mm FURRING W:
92mm METAL STUD,
13mm PLYWOOD,
13mm GYPSUM.



DENOTES 13mm GYPSUM ON EXISTING CMU:

EXISTING CMU WALL,

13mm GYPSUM.

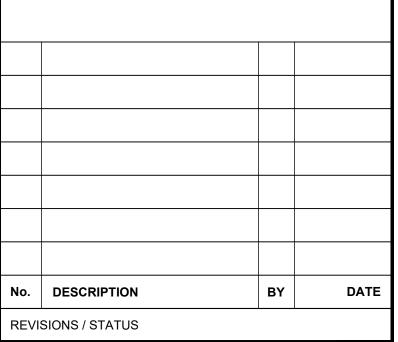

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PROJECT

WILLIAM DUNBAR ART, SCIENCE, MUSIC, & CLASSROOM ALTERATIONS

Project No: T25-01

Drawn by: Iain Meldrum

Checked by: Chris Thaler

Address: 1030 Glenanna Rd, Pickering, ON L1V 5E5

AS NOTED

TITLE:

Scale:

MECHANICAL LEGEND & SYMBOLS



PLUMBING DEMOLITION NOTES:

- 1. DISCONNECT SINK & EQUIPMENT TO BE REMOVED. CAP OR TERMINATE SERVICES AS REQUIRED.
- 2. REMOVE AND DISPOSE OF PIPING AND DRAIN AS REQUIRED. CAP WITHIN WALL OR BACK TO SOURCE AS REQUIRED.
- 3. MAINTAIN SERVICES TO BE RE-USED FOR NEW FIXTURES IN SIMILAR LOCATION.
- 4. DISCONNECT ALL SERVICES RAN WITHIN MILLWORK SET TO BE DEMOLISHED.
- 5. UNINSTALL EXISTING SEDIMENT TRAP SYSTEMS FROM ART ROOM ISLAND SINKS. MAINTAIN AND REUSE WITH NEW SINKS.




INDICATES 1800mm DIA. BARRIER FREE TURNING RADIUS (2130mm IN BARRIER FREE WASHROOMS) REQUIRED




DENOTES 118mm FURRING \overline{W} : 92mm METAL STUD, 13mm PLYWOOD, 13mm GYPSUM.

DENOTES 13mm GYPSUM ON **EXISTING CMU:** EXISTING CMU WALL, 13mm GYPSUM.

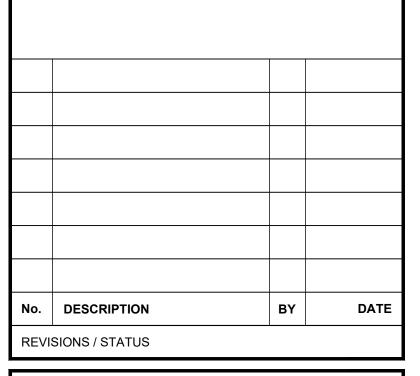

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WILLIAM DUNBAR ART, SCIENCE, MUSIC, & **CLASSROOM ALTERATIONS**

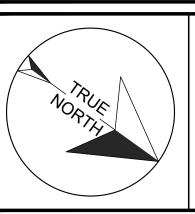
AS NOTED Scale:

Iain Meldrum Drawn by: Chris Thaler Checked by: 1030 Glenanna Rd, Pickering, ON L1V 5E5 Address:


TITLE:

PLUMBING DEMOLITION



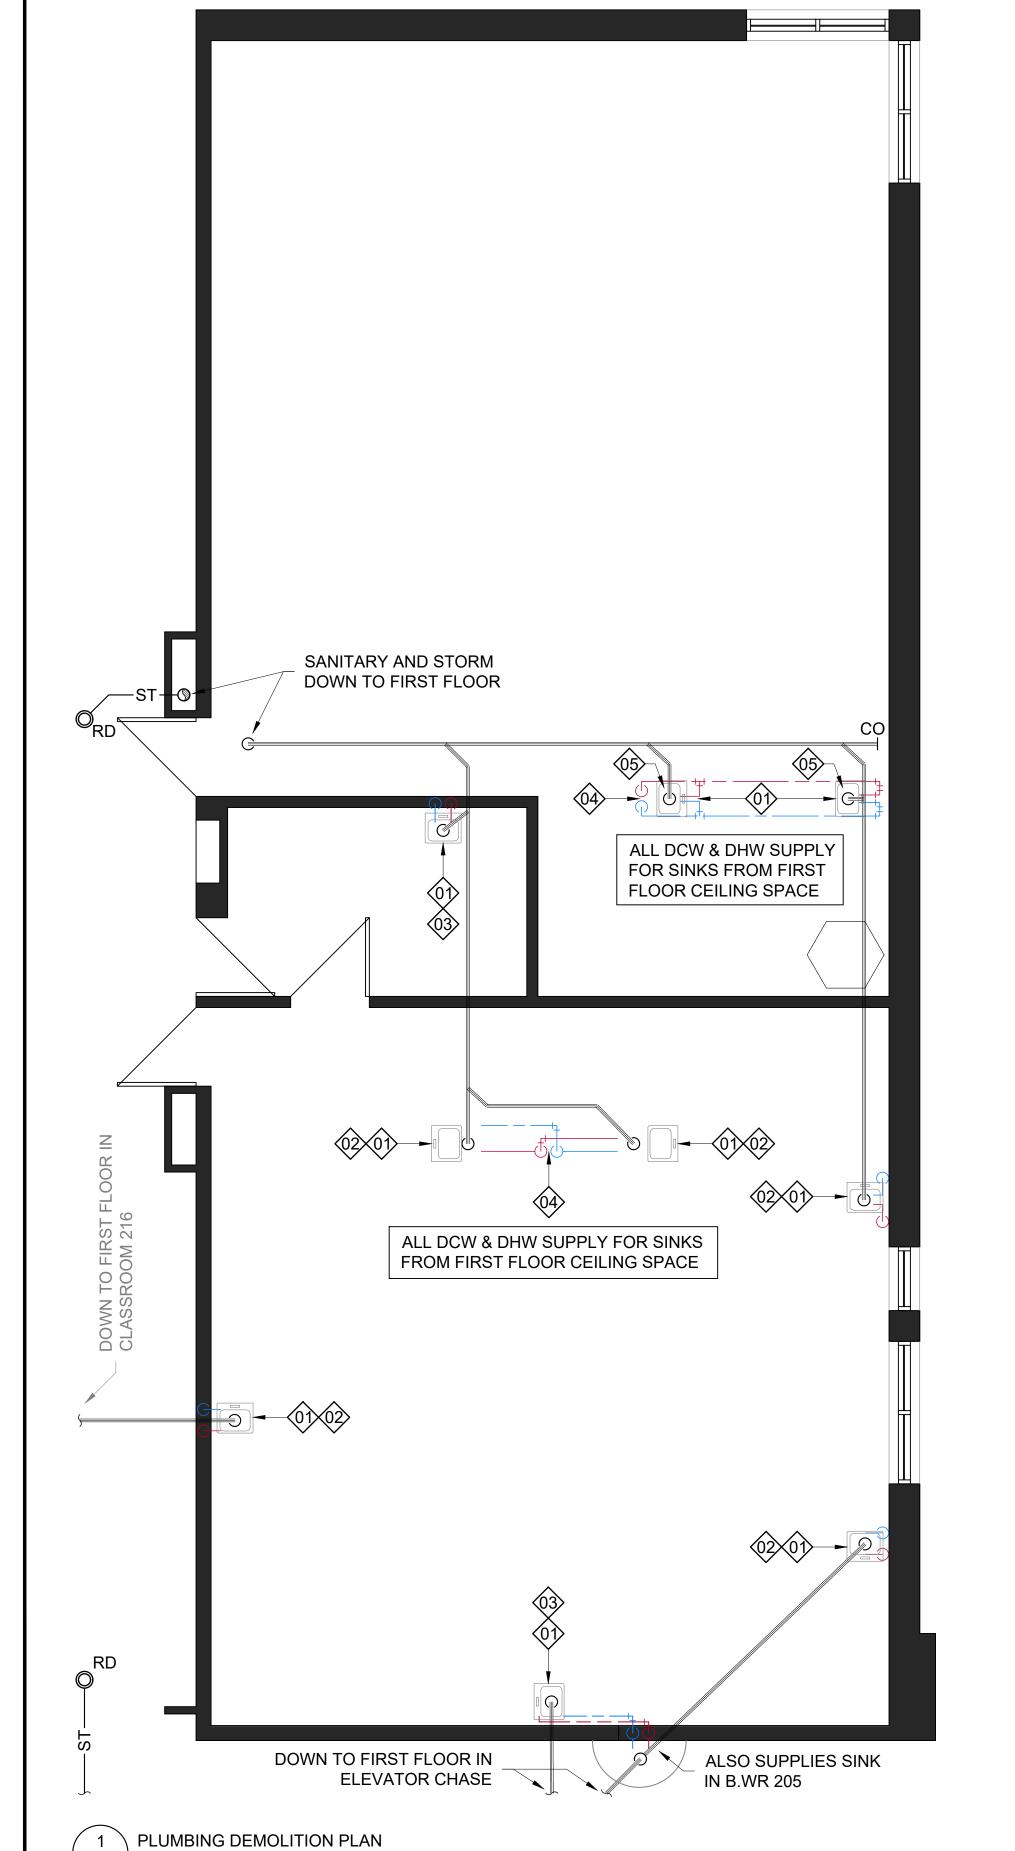

M101 WILLIAM DUNBAR PS - SECOND FLOOR - ART / SCIENCE ROOMS

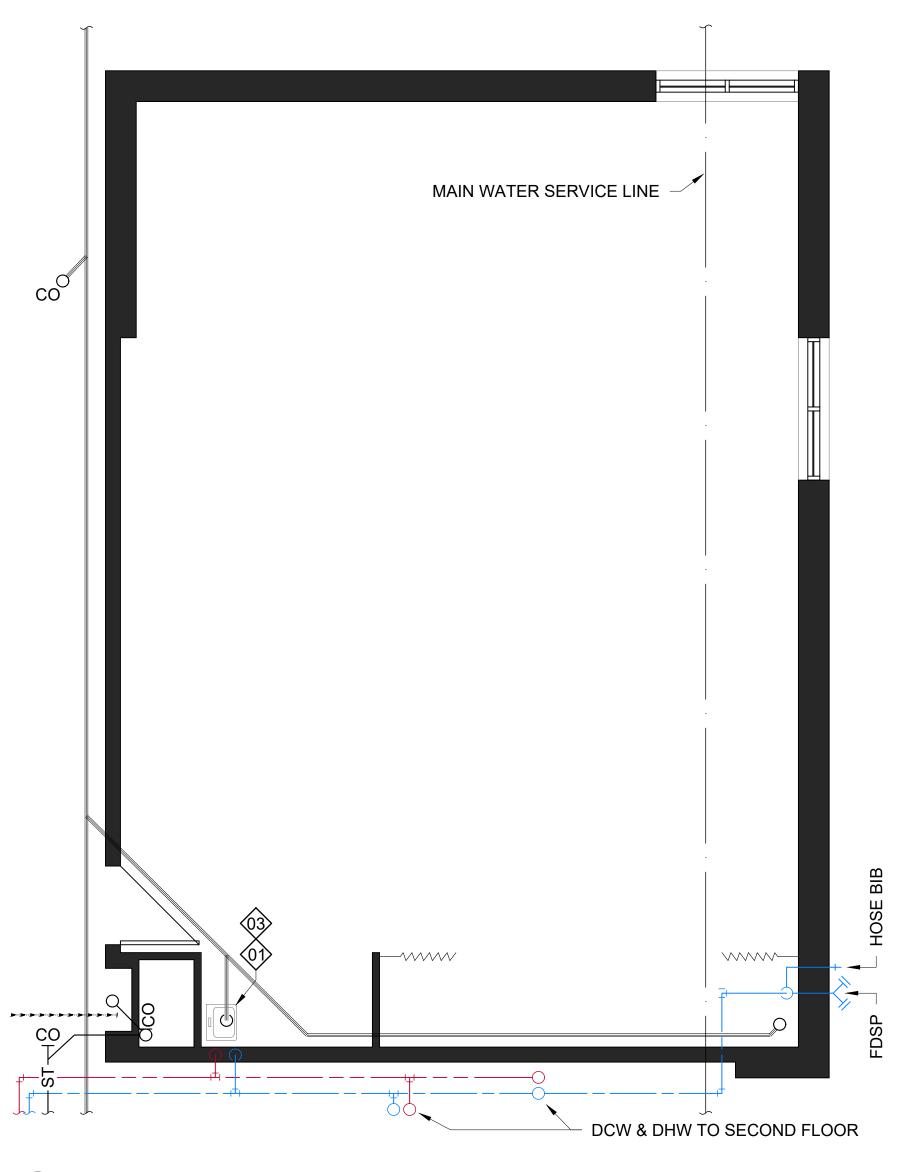

2 PLUMBING DEMOLITION PLAN M101/ WILLIAM DUNBAR PS - FIRST FLOOR - MUSIC ROOM

1/4" = 1'-0"

PROPOSED PLUMBING NOTES:

- 1. PROVIDE AND INSTALL NEW **SK-1** COUNTER-MOUNT SINK AND EQUIPMENT. MAKE USE OF EXISTING PLUMBING AND RUN NEW LINES AS REQUIRED.
- 2. PROVIDE AND INSTALL NEW **SK-2** COUNTER-MOUNT SINK AND EQUIPMENT. MAKE USE OF EXISTING PLUMBING AND RUN NEW LINES AS REQUIRED.
- 3. PROVIDE AND INSTALL NEW **SK-3** FLOOR-MOUNT SINK AND EQUIPMENT. MAE USE OF EXISTING PLUMBING AND RUN NEW LINES AS REQUIRED.
- 4. PROVIDE AND INSTALL NEW **SK-4** BARRIER FREE COUNTER-MOUNT SINK AND EQUIPMENT. MAKE USE OF EXISTING PLUMBING AND RUN NEW LINES AS REQUIRED.
- 5. DRAIN BUILDING & INSTALL NEW **R19SS** BRASSCRAFT SHUTOFFS.
- 6. REINSTALL EXISTING SEDIMENT TRAP ON DRAINAGE, UNDER COUNTER. DISPOSE OF REDUNDANT MATERIALS & EQUIPMENT.



INDICATES 1800mm DIA.

BARRIER FREE TURNING

RADIUS (2130mm IN BARRIER


FREE WASHROOMS) REQUIRED

P-1


DENOTES 118mm FURRING W:
92mm METAL STUD,
13mm PLYWOOD,
13mm GYPSUM.

(P-2)

DENOTES 13mm GYPSUM ON EXISTING CMU:
EXISTING CMU WALL,
13mm GYPSUM.

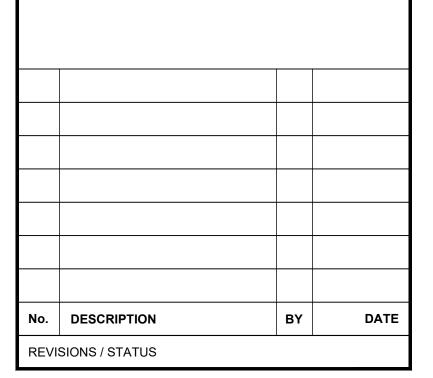

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PROJEC

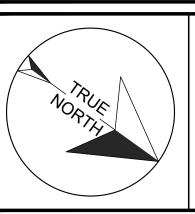WILLIAM DUNBAR ART, SCIENCE, MUSIC, & CLASSROOM ALTERATIONS

Scale: AS NOTED

Drawn by: lain Meldrum

Drawn by: lain Meldrum


Checked by: Chris Thaler


Address: 1030 Glenanna Rd, Pickering, ON L1V 5E5

TITLE:

PROPOSED PLUMBING



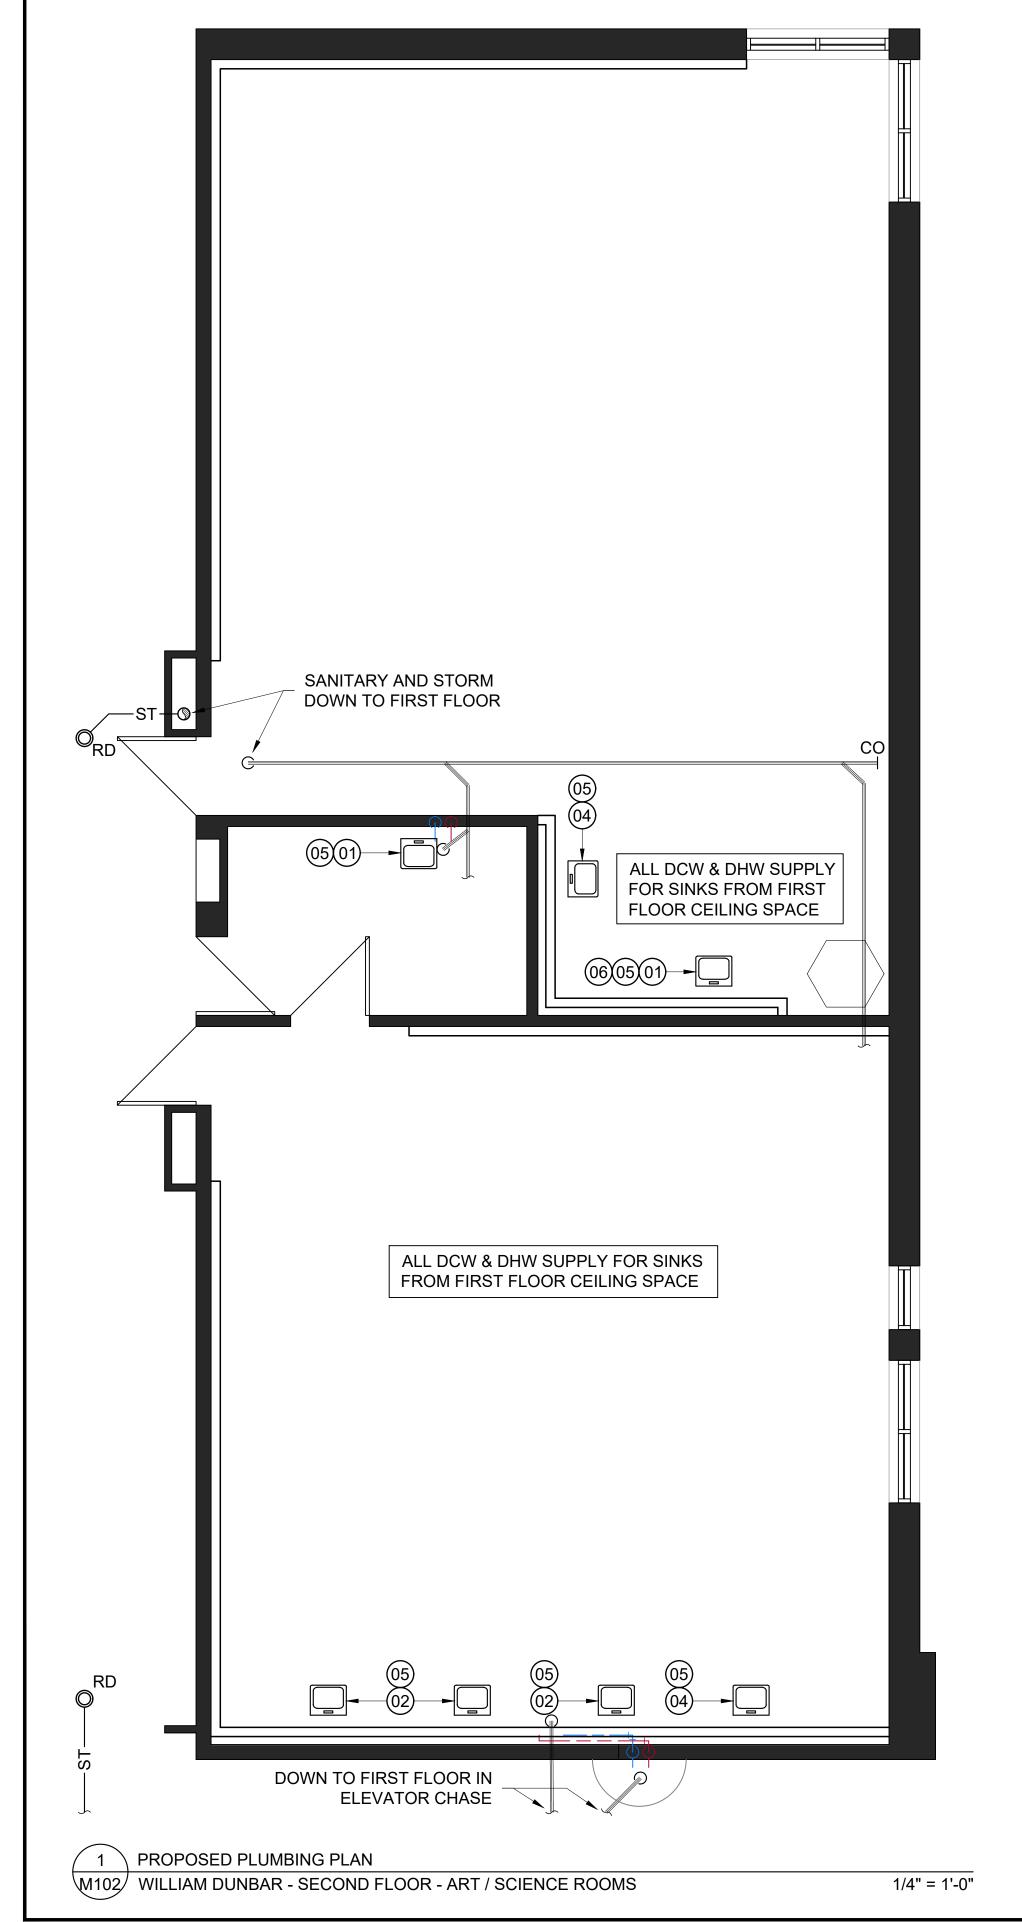

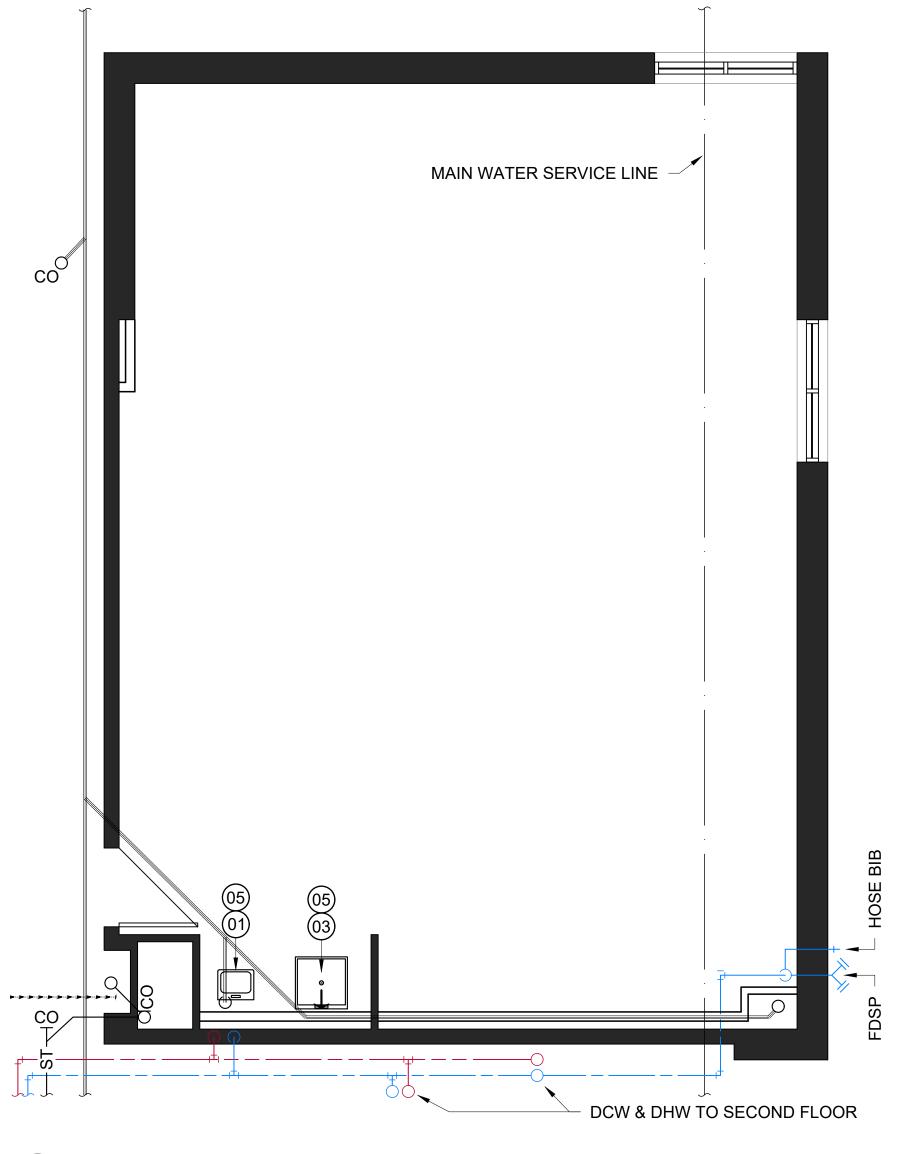

GENERAL ELECTRICAL NOTES:

- NO SURFACE MOUNT BOXES TO BE INSTALLED AS PART OF NEW WORK.
- GFCI RECEPTACLES TO BE USED IN PROXIMITY TO SINKS AND OTHER PLUMBING FIXTURES.
- CUTOUTS TO BE COORDINATED BETWEEN ELECTRICAL & GENERAL CONTRACTORS.
- ALL NEW POWER & DATA TO BE RUN IN $\frac{3}{4}$ " EMT CONDUIT WHERE EVER POSSIBLE. CONSULT WITH DDSB PROJECT SUPERVISOR WHERE EVER NOT POSSIBLE.
- ALL THERMOSTATS / CONTROLS SHALL BE DISCONNECTED, RELOCATED, ALTERED, REINSTALLED, AND/OR OTHERWISE HANDLED BY A CERTIFIED CONTROLS CONTRACTOR. NO WIRES SHALL BE CUT, UNLESS REQUIRED AND NOTED AS PART OF THE SCOPE OF WORK. DISCONNECT ALL EQUIPMENT APPROPRIATELY, SECURE AND BAG ABOVE CEILING AS NEEDED FOR RELOCATES AND TEMPORARY UNINSTALLS.

ELECIKIC	CAL LEGEND	
SYMBOL	DESCRIPTION	MAKE / MODEL
	15A 120V 1PH GROUNDED DUPLEX RECEPTACLE • "USB" DENOTES ADDITION OF TWO(2) USB PORTS ON FACEPLATE (x1) USB-A & (x1) USB-C, ON SAME RECEPTACLE	
	20A 120V 1PH GROUNDED DUPLEX RECEPTACLE	
	15A 120V 1PH GROUNDED QUAD RECEPTACLE • "USB" DENOTES ADDITION OF TWO (2) MIX-USB PORTS ON FACEPLATE, (x1) USB-A & (x1) USB-C, ON SAME RECEPTACLE	
	DATA ONLY OUTLET BOX	NEW TO BE: CAT6A CABL
	HDMI OUTLET BOX	NEW TO BE: FT-6 (US) / CMP (CANADA)
V	VOICE ONLY OUTLET • "FAX" DENOTES A FAX LINE WITHIN BOX	NEW TO BE: CAT6A CABL
S	CEILING MOUNTED P.A. SPEAKER	
S	WALL MOUNTED P.A. SPEAKER	
MS	SECURITY MOTION SENSOR	
os	OCCUPANCY SENSOR	
ES	SECURITY SYSTEM ELECTRIC STRIKE	
H	HEAT DETECTOR	
S	SMOKE DETECTOR	
Р	FIRE ALARM PULL STATION WITH CLEAR, TAMPER-PROOF, POLYCARBONATE SHIELD THAT EMITS AN ALARM WHEN ACCESSED	
	FIRE ALARM HORN AND/OR STROBE	
T	THERMOSTAT	
\$ ³	WALL-MOUNTED LIGHT SWITCH • "3" DENOTES 3-WAY LAMP • MOUNTING HEIGHT TO COMPLY WITH CODE FOR ANY NEW	
CAM	SECURITY CAMERA	
	BATTERY OPERATED ANALOG CLOCK	
	EMERGENCY EXIT SIGN FILLED IN QUADRANT DENOTES FACING ARROWS DENOTE DIRECTION OF EXIT SIGN	NEW: "RUNNING-MAN STYLE"

TAG	DESCRIPTION	MAKE / MODEL
	EMERGENCY EXIT SIGN FILLED IN QUADRANT DENOTES FACING, ARROWS DENOTE DIRECTION	NEW: "RUNNING-MAN STYLE"
	2x4 CEILING-MOUNTED LED LIGHT FIXTURE, LETTER DENOTES SWITCHING • EXISTING: 2-BALLAST, 3-LAMP	NEW: ● PHILLIPS 2TG8214 - 12 - 120 - 1/2EB
	1x4 CEILING-MOUNTED LED LIGHT FIXTURE	NEW: ■ LITHONIA LIGHTING 5000K, LED, 1x4, WHITE
	RECESSED POT LIGHT	
$\triangle \!$	REMOTE EMERGENCY LIGHTING HEAD(S) • DENOTED AS WALL OR CEILING MOUNTED	
	2x2 AIR SUPPLY DIFFUSER	NEW: PRICE INDUSTRIES SCD - 31 - 33, WHITE IN COLOUR
	2x2 AIR RETURN "EGG CRATE" GRILLE	
	NEW 1x2 CEILING-MOUNTED P.A. SPEAKER	NEW: ◆ VALCOM V9021 1'x2' LAY IN SPEAKER

ELECTRICAL ABBREVIATIONS		
AFF	ABOVE FINISHED FLOOR	
BFC	BELOW FINISHED CEILING	
CP	EMPTY BACK BOX WITH COVER PLATE	
C/W	COMPLETE WITH	
D	EXISTING EQUIPMENT TO BE REMOVED	
EMT	ELECTRICAL METALLIC TUBING	
EX	EXISTING EQUIPMENT, TO REMAIN	
H/L	HIGH LEVEL MOUNTING HEIGHT (COMPARED TO STANDARD)	
N	NEW EQUIP. TO BE INSTALLED, REUSE EQUIP. FROM DEMO IF AVAILABLE	
NL	INDICATES LIGHT FIXTURE TIED INTO NIGHT LIGHT	
RL	EXISTING EQUIP. TO BE RELOCATED. EXTEND FEED AS REQUIRED	
RR	EXISTING EQUIP. TO BE UNINSTALLED & REINSTALLED IN SAME LOCATION	
SC	SEPARATE CIRCUIT	
SM	SURFACE MOUNTED	
TR	TAMPER RESISTANT	
USB	UNIVERSAL SERIAL BUS (DENOTING SPECIFIC PORT)	
WG	PROVIDE WIRE GUARD OR VANDAL COVER	
WP	WEATHER PROOF	
x #	QUANTITY OF DEVICES	



INDICATES 1800mm DIA. BARRIER FREE TURNING RADIUS (2130mm IN BARRIER FREE WASHROOMS) REQUIRED



DENOTES 118mm FURRING \overline{W} : 92mm METAL STUD, 13mm PLYWOOD, 13mm GYPSUM.



DENOTES 13mm GYPSUM ON **EXISTING CMU:** EXISTING CMU WALL, 13mm GYPSUM.

No.	DESCRIPTION	BY	DATE
REVISIONS / STATUS			

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WILLIAM DUNBAR ART, SCIENCE, MUSIC, & **CLASSROOM ALTERATIONS**

E001

Scale:	AS NOTED
Drawn by:	lain Meldrum
Checked by:	Chris Thaler
Address:	1030 Glenanna Rd, Pickering, ON L1V 5E5
•	·

ELECTRICAL LEGEND & SYMBOLS



PROJECTOR RESPONSIBILITIES:

- THE GENERAL CONTRACTOR AND/OR ELECTRICAL CONTRACTOR SHALL BE RESPONSIBLE FOR RELOCATING ALL EQUIPMENT, INCLUDING: THE MOUNTING-PAN, PROJECTOR, SCREEN, AND ALL ASSOCIATED POWER, DATA, HDMI, & OTHER AUDIO / VIDEO CONNECTIONS.
- ALL PROJECTOR RELOCATIONS SHALL INCLUDE REPLACING THE EXISTING NETWORK CABLE WITH A NEW CAT6A, IF NOT ALREADY CAT6 OR BETTER.
- THE GENERAL CONTRACTOR AND/OR ELECTRICAL CONTRACTOR SHALL BE RESPONSIBLE FOR PROVIDING AND INSTALLING ALL POWER, DATA (CAT6A NETWORK CABLE), HDMI, & OTHER AUDIO / VIDEO CONNECTIONS FOR NEW DEVICE INSTALLS.
- 4. THE GENERAL CONTRACTOR AND/OR ELECTRICAL CONTRACTOR SHALL INSTALL ANY NEW MOUNTING-PAN, SUPPLIED BY DDSB IT SERVICES WITH COORDINATION FROM THE DDSB PROJECT SUPERVISOR.
- ANY NEW PROJECTORS AND/OR SCREENS SHALL BE SUPPLIED AND INSTALLED BY IT SERVICES WITH COORDINATION FROM THE DDSB PROJECT SUPERVISOR.
- THE DDSB PROJECT SUPERVISOR SHALL NOTIFY IT SERVICES OF THE COMPLETION OF ALL RELOCATIONS AND/OR NEW INSTALLS.
- IT SERVICES SHALL COMPLETE A FINAL PROJECTOR PROGRAMMING & CALIBRATION FOR ALL RELOCATES AND/OR NEW INSTALLS.

ELECTRICAL DEMOLITION NOTES:

- 1. ADJUST ELECTRICAL DEVICES AS NOTED. REMOVE REDUNDANT CIRCUITS.
- 2. RELOCATE PROJECTOR AND ASSOCIATED WIRING TO ACCOMMODATE NEW SCREEN LOCATION.
- 3. WIRELESS ACCESS POINTS TO BE REMOVED BY *DDSB IT DEPARTMENT* STAFF PRIOR TO PROJECT START.



INDICATES 1800mm DIA.

BARRIER FREE TURNING

RADIUS (2130mm IN BARRIER

FREE WASHROOMS) REQUIRED


P-1 DENOTES 118mm FURRING W: 92mm METAL STUD, 13mm PLYWOOD,


DENOTES 13mm GYPSUM ON EXISTING CMU:

EXISTING CMU WALL,

13mm GYPSUM.

13mm GYPSUM.

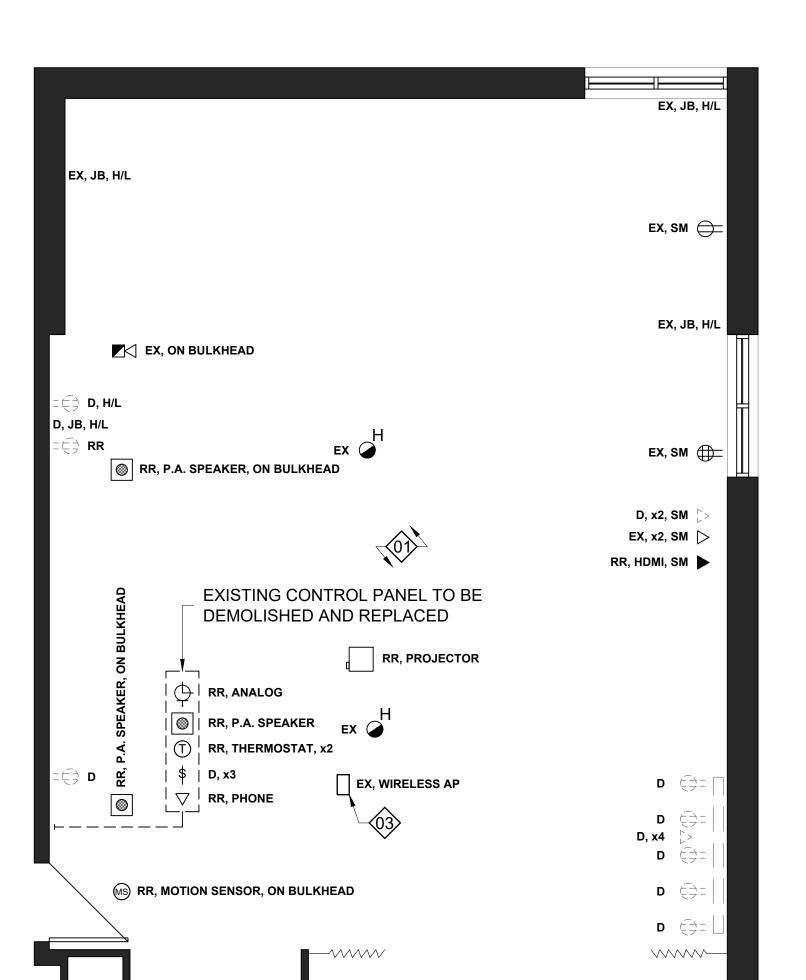

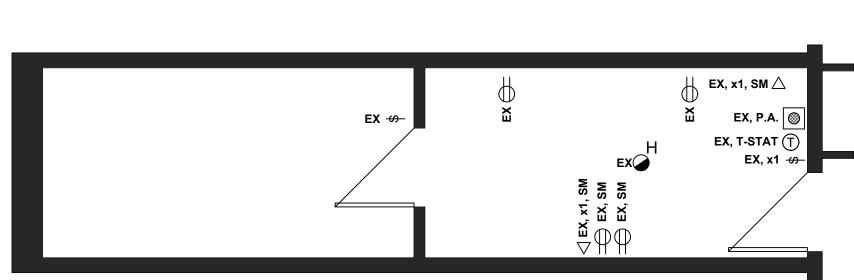





No. DESCRIPTION

REVISIONS / STATUS

one of its properties.

Scale:

Drawn by:

Address:

Checked by:

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WILLIAM DUNBAR ART,

SCIENCE, MUSIC, &

CLASSROOM ALTERATIONS

1030 Glenanna Rd, Pickering, ON L1V 5E5

AS NOTED

lain Meldrum

Chris Thaler



=[] D

(D

EX 🥏

EXISTING CONTROL PANEL TO BE DEMOLISHED AND REPLACED

-∞ D, x1

EX, WIRELESS AP

EX O D, ON CABINET

D, ON CABINET

RR, PROJECTOR

RR, ANALOG

| \$ | D, x2

EX, P.A. SPEAKER

EX, T-STAT EX

| 🕒 | RR, ANALOG

RR, P.A. SPEAKER

| (T) | RR, THERMOSTAT

RR, P.A. SPEAKER

RR, THERMOSTAT, x2

D, ON CABINET (

EXISTING CONTROL PANEL TO BE

EX, WIRELESS AP

DEMOLISHED AND REPLACED



EX 🕽

D, ON

> RL, PROJECTOR

RL, HDMI, SM

D, SM

1/4" = 1'-0"

D, SM

EX -6)

EX, SM, H/L


CABINET FACE

PROPOSED ELECTRICAL NOTES:

- 1. PROVIDE ELECTRICAL DEVICES AS SHOWN. RE-USE EXISTING CIRCUITS WHERE POSSIBLE.
- 2. COORDINATE CUTOUTS FOR CONTROL PANEL WITH MILLWORK CONTRACTOR.
- 3. WIRELESS ACCESS POINTS TO BE REINSTALLED BY *DDSB IT DEPARTMENT* STAFF IN TAIL END OF PROJECT OR POST COMPLETION.
- 4. RELOCATE EXISTING PROJECT, INCLUDING ALL POWER, DATA, AND A/V CONNECTIONS.





INDICATES 1800mm DIA. BARRIER FREE TURNING RADIUS (2130mm IN BARRIER FREE WASHROOMS) REQUIRED

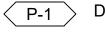

DENOTES 118mm FURRING $\overline{\mathrm{W}}$: 92mm METAL STUD, 13mm PLYWOOD, 13mm GYPSUM.

DENOTES 13mm GYPSUM ON EXISTING CMU: EXISTING CMU WALL, 13mm GYPSUM.

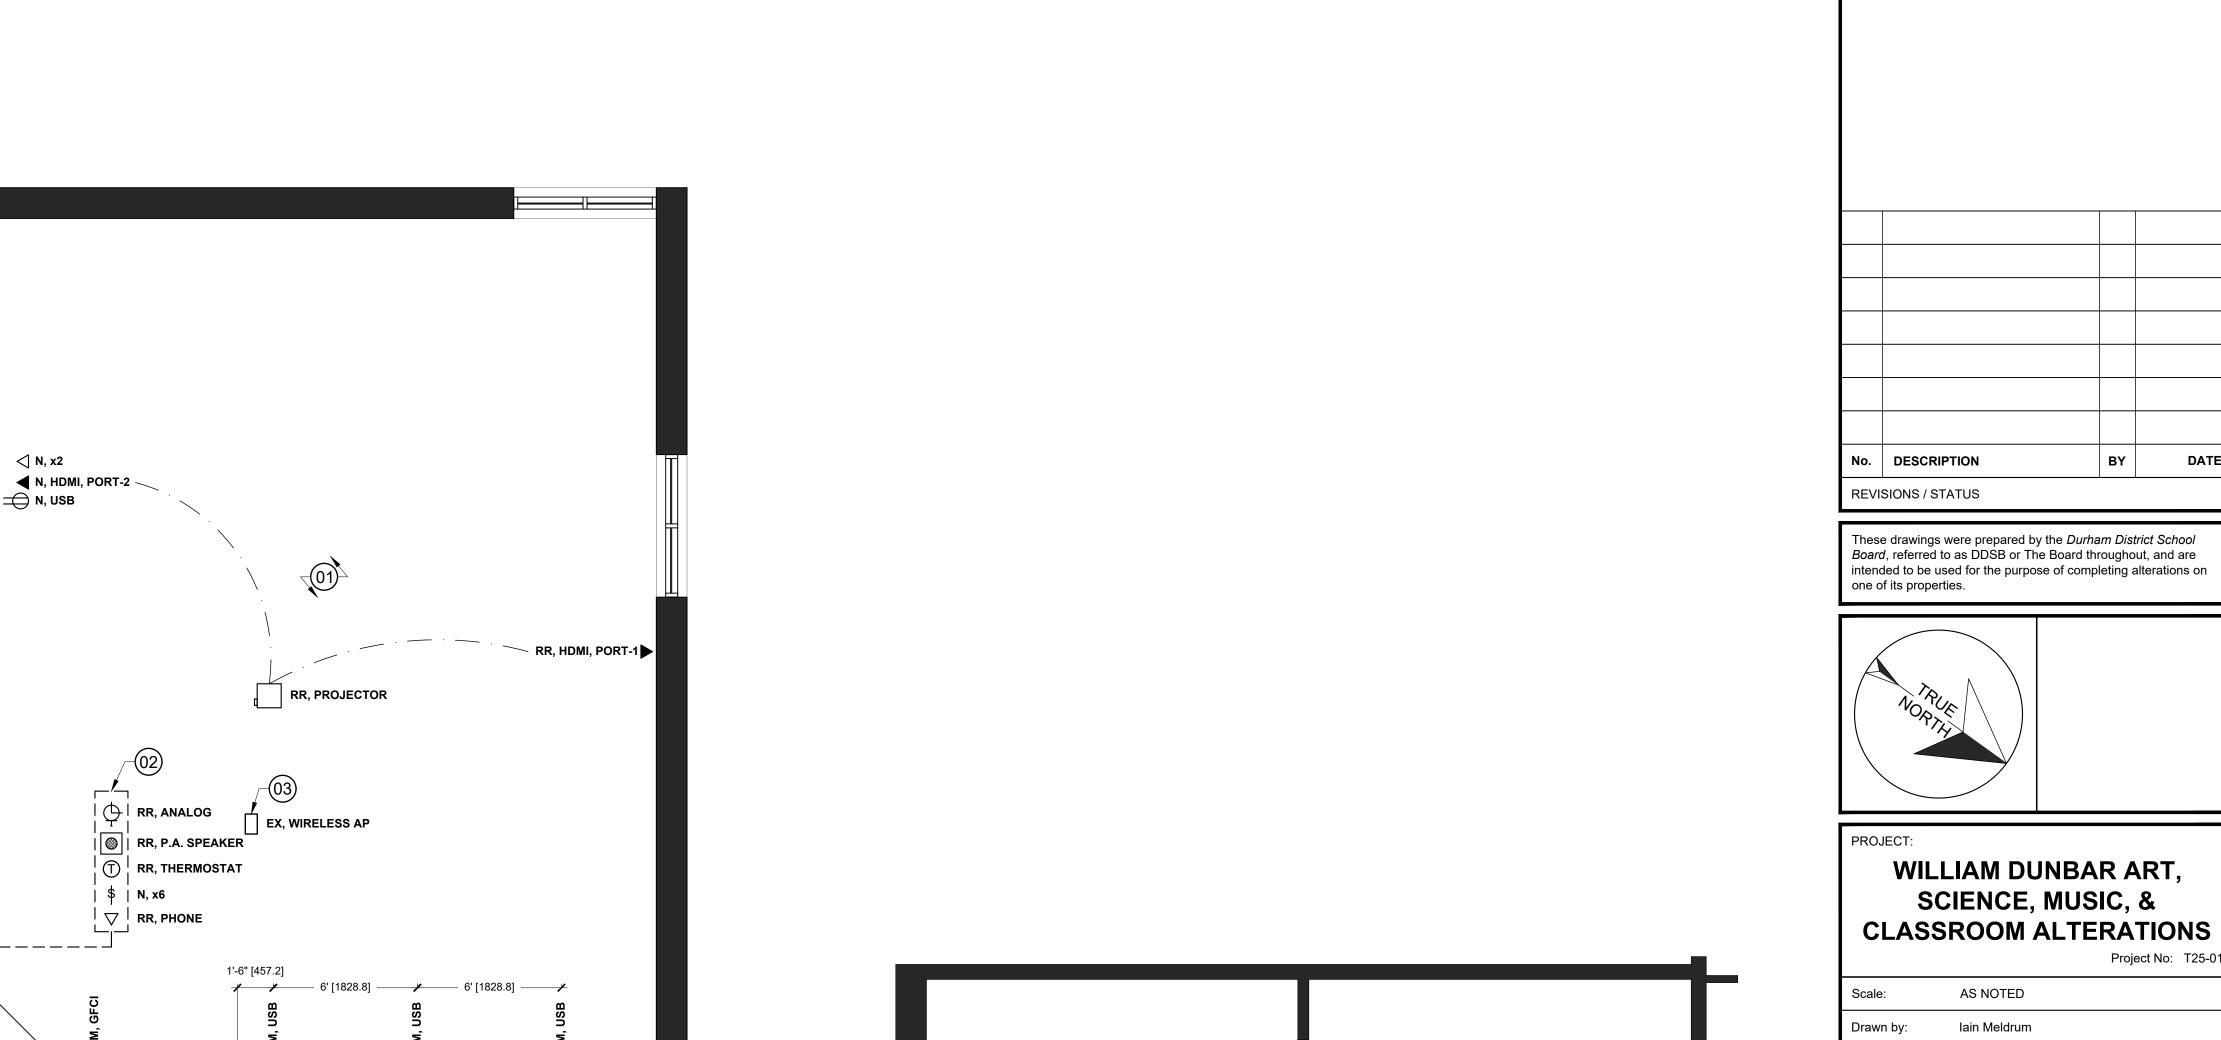

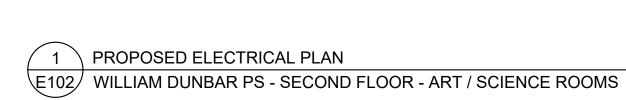

N, TYP.

N, TYP. →

EX 🚰

RR, PROJECTOR

EX, WIRELESS AP

N, 42" BTTM, GFCI

N, 42" BTTM, GFCI

RL, PROJECTOR

EX, WIRELESS AP

—— 6' [1828.8] *-*

—— 7' [2133.6] *—*—

7'-3½" [2224.8] ——

3'-1¹/₂" [952.2]

- 8'-4<mark>1</mark>" [2548.9] *-*

| → N, 42" BTTM, USB →

N, 42" BTTM, USB

RR, ANALOG

| \$ | N, x4

| igtrianglelow | RR, PHONE

RR, ANALOG

RR, P.A. SPEAKER

RR, THERMOSTAT

- 6' [1828.8] - / 6' [1828.8] - /

RR, P.A. SPEAKER

| T | RR, THERMOSTAT

1'-6" [457.2]

Checked by:

Address:

TITLE:

1030 Glenanna Rd, Pickering, ON L1V 5E5

PROPOSED ELECTRICAL

Chris Thaler

LIGHTING DEMOLITION NOTES:


1. REMOVE LIGHTING FIXTURES AND ADJUST SWITCHING AS REQUIRED. TURN OVER ANY REDUNDANT EQUIPMENT TO SCHOOL.




NDICATES 1800mm DIA. BARRIER FREE TURNING RADIUS (2130mm IN BARNILLA FREE WASHROOMS) REQUIRED

DENOTES 118mm FURRING $\overline{\mathrm{W}}$: 92mm METAL STUD, 13mm PLYWOOD, 13mm GYPSUM.

DENOTES 13mm GYPSUM ON EXISTING CMU: EXISTING CMU WALL, 13mm GYPSUM.

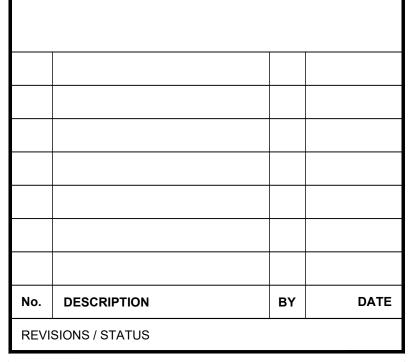

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WILLIAM DUNBAR ART, SCIENCE, MUSIC, & **CLASSROOM ALTERATIONS**

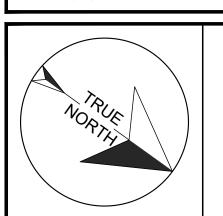AS NOTED Scale:


Drawn by: Chris Thaler Checked by:

1030 Glenanna Rd, Pickering, ON L1V 5E5 Address:


TITLE:

LIGHTING DEMOLITION



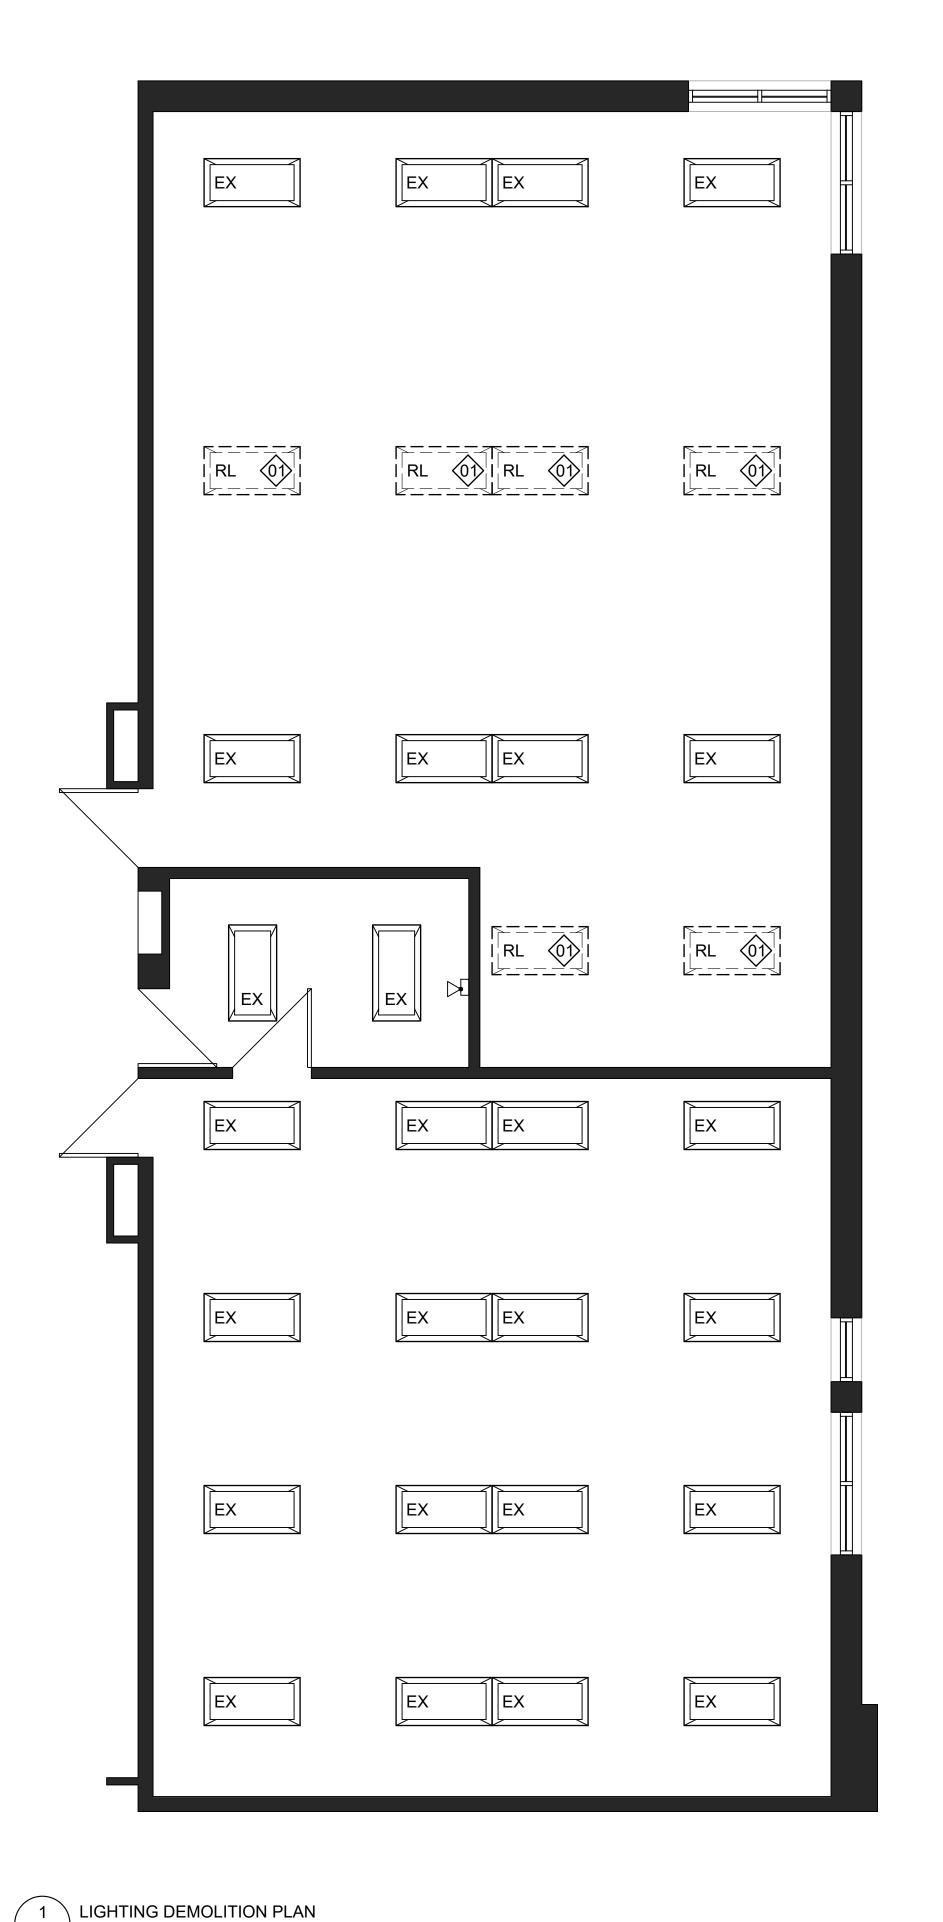

E103 WILLIAM DUNBAR PS - SECOND FLOOR - ART / SCIENCE ROOMS

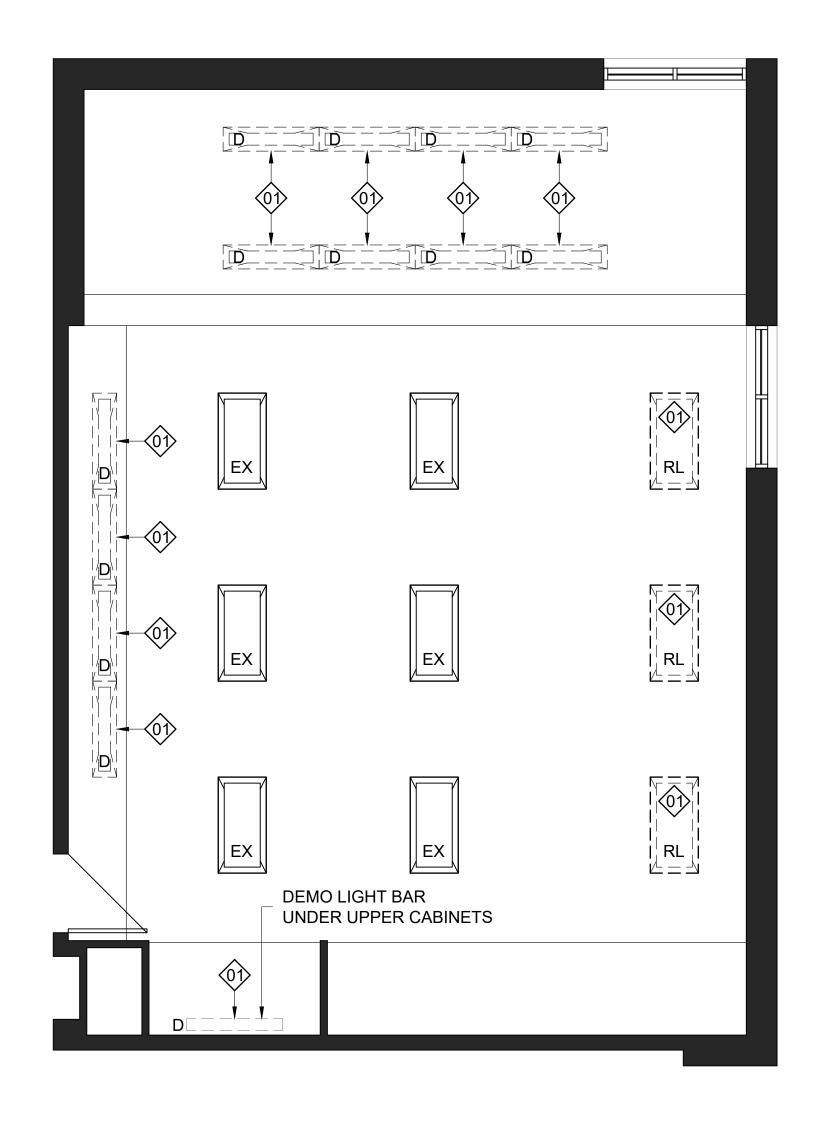

PROPOSED LIGHTING NOTES:

- 1. ADJUST SWITCHING AS SHOWN. CENTER LAMP ON ONE SWITCH, OUTSIDE LAMPS ON SECOND SWITCH WITHIN ART ROOM 225, SCIENCE ROOM 224, AND MUSIC ROOM 104.
- 2. RE-LAMP FIXTURES AS REQUIRED TO ENSURE EACH FIXTURE CONTAINS x3 WORKING LAMPS.




INDICATES 1800mm DIA. BARRIER FREE TURNING RADIUS (2130mm IN BARRIER FREE WASHROOMS) REQUIRED


DENOTES 118mm FURRING \overline{W} : 92mm METAL STUD, 13mm PLYWOOD, 13mm GYPSUM.

13mm GYPSUM.

DENOTES 13mm GYPSUM ON EXISTING CMU: EXISTING CMU WALL,

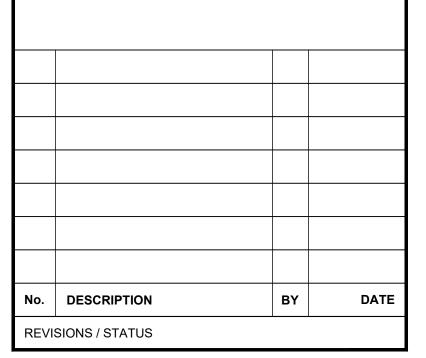

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WILLIAM DUNBAR ART, SCIENCE, MUSIC, & **CLASSROOM ALTERATIONS**

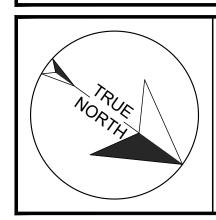AS NOTED Scale: Drawn by:


Chris Thaler Checked by:

Address: 1030 Glenanna Rd, Pickering, ON L1V 5E5

TITLE:

PROPOSED LIGHTING



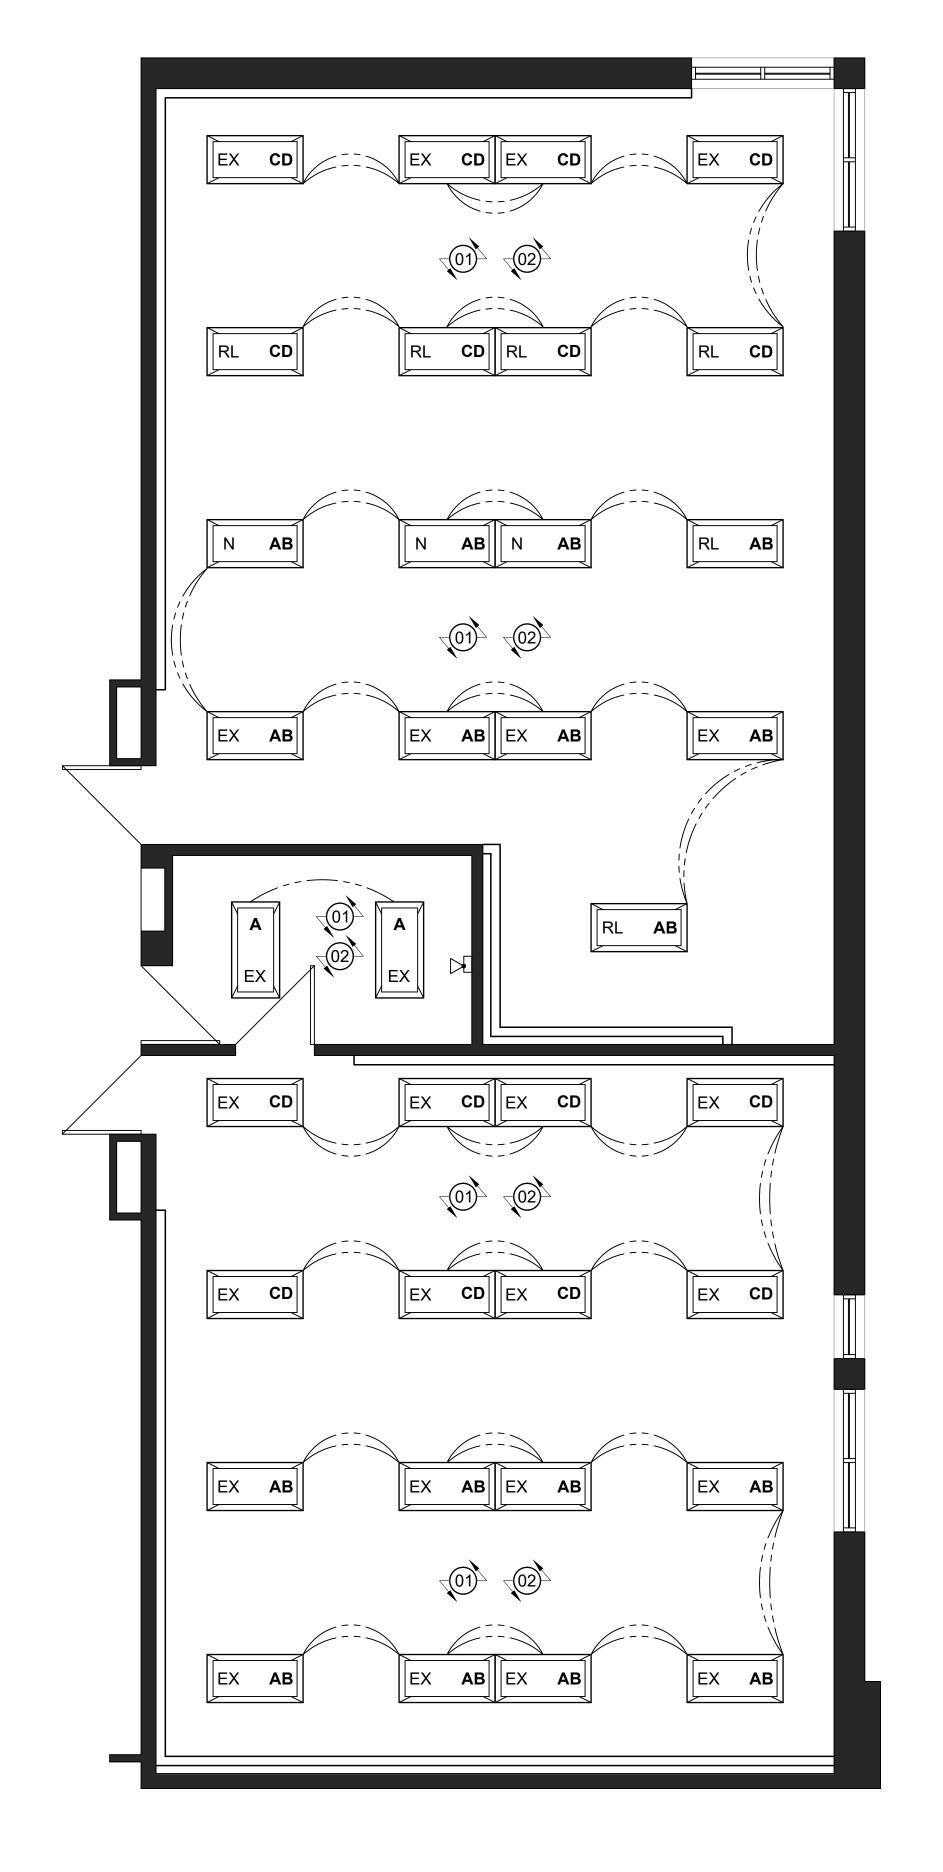

PROPOSED LIGHTING PLAN

E104/ WILLIAM DUNBAR PS - SECOND FLOOR - ART / SCIENCE ROOMS

