

		NEW EQUIPMENT
		EXISTING EQUIPMENT TO BE REMOVED / DEMOLISHED
		EQUIPMENT CONNECTION
		FUSED DISCONNECT SWITCH
	WAP	WIRELESS ACCESS POINT
		FREE STAND PANEL
	VFD	VARIABLE FREQUENCY DRIVE
		SURFACE MOUNTED POWER PANEL
	0	TRANSFORMER
		UNFUSED DISCONNECT SWITCH
	HZ	FUSED DISCONNECT SWITCH
Ĭ		COMBINATION MOTOR STARTER C/W HOA FUNCTION & PILOT LIGHTS
Í		SPLITTER
		TRANSFORMER
		DUCT SMOKE DETECTOR
ė		RELAY MODULE
		ELECTRICAL POWER PANEL
	EXIT	CEILING MOUNTED SINGLE FACE COMPACT EMERGENCY LIGHTING REMOTE HEADS & RUNNING MAN EXIT SIGN C/W BATTERY, STRAIGHT FROM HERE. FACE ON SHADED SIDES, ARROWS AS INDICATED
•	O <mark>FEXILE</mark> O	CEILING MOUNTED DOUBLE FACE COMPACT EMERGENCY LIGHTING REMOTE HEADS & RUNNING MAN EXIT SIGN C/W BATTERY UP FROM HERE. FACE ON SHADED SIDES
Š	BU	EMERGENCY LIGHTING C/W BATTERY UNIT, RECHARGEABLE, 90min
	22	EMERGENCY LIGHTING REMOTE HEADS
	\$3	3 GANG, 3 WAY SWITCH
	\$	2 GANG SWITCH
	\$	3 GANG SWITCH
_	⊗ EXII	EXISTING EXIT SIGN
	(OS)	OCCUPANCY SENSOR
		SMOKE DETECTOR
L		
lule		

LEGEND

EXISTING EQUIPMENT

DRAWING LIST			
E0.01	COVER PAGE		
E1.01	KEYPLAN - FIRST FLOOR		
E1.02	FIRST FLOOR POWER LAYOUT		
E1.03	FIRST FLOOR LIGHTING LAYOUT A - DEMOLITION		
E1.04	FIRST FLOOR LIGHTING LAYOUT B - DEMOLITION		
E1.05	FIRST FLOOR LIGHTING LAYOUT A - NEW CONSTRUCTION		
E1.06	FIRST FLOOR LIGHTING LAYOUT B - NEW CONSTRUCTION		
E2.01	KEYPLAN - SECOND FLOOR		
E2.02	SECOND FLOOR POWER LAYOUT		

ABBREVIATIONS			
CTE	CONNECT TO EXISTING		
EX	EXISTING DEVICE TO REMAIN		
RE	REMOVE AND REINSTALL EXISTING DEVICE		
RP	REPLACE EXISTING DEVICE WITH NEW DEVICE		
R/R	REUSE AND RELOCATE		
ER	EXISTING DEVICE TO REMOVE		
AFF	ABOVE FINISHED FLOOR		
AFG	ABOVE FINISHED GRADE		
CM	CEILING MOUNTED		
WM	WALL MOUNTED		
FM	FLOOR MOUNTED		
EM	EMERGENCY		
SLD	SINGLE LINE DIAGRAM		



GENERAL NOTES

- 1. THESE DRAWINGS ARE DIAGRAMMATIC ONLY. PRIOR TO 10. CONTRACTOR TO PERFORM SITE INSPECTION, INCLUDING TO AVOID ANY CONFLICTS WITH OTHER TRADES DURING ANY ELECTRICAL ROUGH IN, VERIFY THE EXACT LOCATIONS OF NEW EQUIPMENT AND DEVICES AS INDICATED ON DRAWINGS. ELEVATIONS AND/OR DETAILS ON THE ELECTRICAL DRAWINGS. WHERE DETAILED INFORMATION IS NOT INDICATED ON THE DRAWINGS, VERIFY THE EXACT LOCATION ON THE SITE WITH THE DIRECTION FROM THE RESPECTIVE CONSULTANT OR THE OWNER'S REPRESENTATIVE.
- 2. ANY DISCREPANCIES BETWEEN DRAWINGS AND SPECIFICATIONS AND/OR EXISTING CONDITIONS ARE TO BE REFERRED TO THE DESIGNER FOR INSTRUCTIONS BEFORE ANY WORK IS BEGUN.
- 3. DETAILS ON ELECTRICAL DRAWINGS ARE INTENDED TO BE FOR GENERAL ARRANGEMENT ONLY. DETAILS MAY DO 12. THE CONTRACTOR SHALL REPLACE OR REPAIR ANY NOT SHOW ALL COMPONENTS BUT ARE MERELY A GUIDE AS TO THE ORIENTATION OF EQUIPMENT THAT IS REQUIRED TO ASSIST THE INSTALLATION..
- 4. THE CONTRACTOR SHALL ASSUME FULL RESPONSIBILITY FOR ANY DISRUPTION TO THE EXISTING SERVICES. THE EXISTING BUILDING MUST BE KEPT IN OPERATION AT ALL THE TIMES. ARRANGE WORK IN SUCH A MANNER THAT INTERRUPTIONS TO THE SERVICES OCCUR ONLY AT SCHEDULED TIMES. UNAVOIDABLE INTERRUPTIONS SHALL BE SCHEDULED WITH THE BOARD AT LEAST 48 HOURS IN ADVANCE. OVERTIME WORK THAT MAY BE REQUIRED TO TIE-IN SERVICES AT NIGHT OR ON
- 5. ELECTRICAL CONTRACTOR SHALL APPLY & OBTAIN ALL NECESSARY PERMITS AND OBTAIN INSPECTION CERTIFICATE. ELECTRICAL CONTRACTOR IS RESPONSIBLE TO PAY ANY RELATED FEES.
- 6. CARRY OUT CHANGES AS INDICATED TO THE
- DISTRIBUTION SYSTEM AS INDICATED ON THE DRAWINGS. 7. PENETRATION THROUGH FLOORS, CEILINGS AND WALLS SHALL BE PACKED WITH GLASS FIBER FIRE RETARDANT INSULATION AND OR FIRE STOP CAULKING TO MAINTAIN FIRE RATING.
- 8. GENERAL CONTRACTOR WILL BE RESPONSIBLE FOR ALL COORDINATION TO ACCESS THE SITE FOR DELIVERY AND REMOVAL OF GOODS WITH OWNER.
- 9. ALL EXISTING MECHANICAL EQUIPMENT NOTED AS TO BE REMOVED HERE OR ON THE MECHANICAL DRAWINGS, SHALL BE DISCONNECTED AND ALL WIRING MADE SAFE.

- CEILING SPACES DURING THE TENDER PERIOD AND ENSURE THAT ALL WORK THAT IS VISIBLE IS INCLUDED IN THE DEMOLITION CONTRACT.
- 11. THE CONTRACTOR SHALL BE RESPONSIBLE FOR DISCONNECTING AND REMOVING ALL ELECTRICAL EQUIPMENT FROM AREAS BEING ALTERED OR DEMOLISHED. WIRING, CONDUIT AND EQUIPMENT REQUIRED TO MAINTAIN SERVICE IN OTHER PARTS OF THE BUILDING SHALL BE TEMPORARILY SUPPORTED, REROUTED, SERVICED OR RELOCATED AS REQUIRED. OBSOLETE CONDUITS AND CABLES SHALL BE REMOVED. ALL EXISTING WIRING WHICH ARE NOT REMOVED SHALL BE DISCONNECTED, BLANKED-OFF AND MADE SAFE.
- ITEMS WHICH ARE DAMAGED DUE TO THIS WORK AT NO EXTRA COST TO THE BUILDING OWNER.
- 13. WORK PERFORMED SHALL BE IN CONFORMITY WITH ALL LAWS, BYLAWS, OR REGULATIONS OF THE MUNICIPAL, PROVINCIAL OR OTHER AUTHORITIES HAVING JURISDICTION. NOTHING CONTAINED IN THESE DRAWINGS SHALL BE CONSTRUCTED AS TO BE IN CONFLICT WITH ANY SUCH LAWS.
- 14.ELECTRICAL CONTRACTOR MUST COORDINATE FOR THE CABLE ROUTING AND INSTALLATION OF CONDUIT FOR THE NEW EQUIPMENT.
- WEEKENDS SHALL BE INCLUDED IN THE TENDER AMOUNT. 15. CONTRACTOR SHALL PROVIDE POWER TO THE NEW INDICATED ON THE DRAWINGS. REFER TO MECHANICAL SCHEDULE FOR MORE DETAILS.
 - 16. DOCUMENT ALL FUSE SIZES, TYPES, WIRE AND CONDUIT SIZES.
 - 17. ALL JUNCTION BOXES ARE TO BE IDENTIFIED PER THE SPECIFICATION SECTION. ELECTRICAL CONTRACTOR SHALL ENSURE ACCESS TO ALL JUNCTION BOXES ARE NOT IMPEDED.
 - 18.ELECTRICAL CONTRACTOR SHALL TAKE NOTE OF THE DRAWING SCALES AND GOVERN HIMSELF ACCORDINGLY. ALSO COORDINATE ALL DIMENSIONS WITH EQUIPMENT SHOP DRAWINGS.
 - 19. ALL NEW WALL MOUNTED ELECTRICAL PANELS TO BE PROVIDED WITH THE FIRE RETARDANT BACK BOARDS.
 - 20.ALL WORKS SHALL BE SCHEDULED AND COORDINATED

OR AFTER CONSTRUCTION.


AREA OF WORK

- 21.ELECTRICAL CONTRACTOR TO INCLUDE SCANNING FOR ALL CORE DRILLING AND TO BE CARRIED OUT AFTER HOURS. PRIOR PERMISSION TO BE OBTAINED.
- 22.OUTDOOR MATERIAL TO BE WEATHERPROOF 23.CONTRACTOR TO CARRY COST FOR ANY ADDITIONAL STRUCTURAL SUPPORTS FOR INSTALLING NEW ELECTRICAL EQUIPMENT INCLUDING NOT LIMITED TO DISCONNECT SWITCHES, BOXES, VFDs, SPLITTERS,

PANELS AND ETC.

- 24.EXACT LOCATION OF THE NEW ELECTRICAL EQUIPMENT TO BE DEFINED ON-SITE. CONTRACTOR TO COORDINATE WITH OTHER TRADES FOR THE EXACT LOCATION BEFORE COMMENCING THE WORK AND CARRY COST FOR ANY RELOCATIONS TO EXISTING EQUIPMENT FOR INSTALLING NEW ELECTRICAL EQUIPMENT.
- 25.CONTRACTOR TO REPLACE AND UPDATE AFFECTED PANELS DIRECTORY WITH TYPED DIRECTORY/SCHEDULE TO REFLECT CHANGE.
- 26.CONTRACTOR TO CARRY ADDITIONAL COSTS TO RE-INSTATE THE FIRE ALARM, FIRE SUPPRESSION, PA SPEAKERS, WAP, ETC DUE TO CONSTRUCTION ACTIVITY WITHIN THIS PROJECT SCOPE. COORDINATE WITH MECHANICAL AND GENERAL CONTRACTOR FOR THE EXACT SCOPE OF THE WORK.
- MECHANICAL EQUIPMENT AND BAS CONTROL EQUIPMENT 27.ALL LIGHTING FIXTURES, DIMMABLE KEYPAD SWITCHES AND OCCUPANCY SENSORS TO BE COMPATIBLE TO IMPLEMENT THE LIGHTING SEQUENCE. COORDINATE WITH HWDSB FOR THE SCENE SELECTION.

Luminaire Schedule							
Symbol	Qty	AREA	Lumens	Watts	Description	[MANUFAC]	TEMPERATURE
	52	CLASSROOM	3820	27	2FGXG38L840-4-RS-UNV	SIGNIFY by DAY-BRITE	4000K
	30	GYM	8318	54	FLP480LHE840-R-UNV-DIM	SIGNIFY by DAY-BRITE	4000K
	11	STAFF ROOM	3042	21	1FGXG30L840-4-RS-UNV-DIM	SIGNIFY by DAY-BRITE	4000K
0 0	05	STORAGE ROOM	3084	20	FLP430L840-R-UNV-DIM	SIGNIFY by DAY-BRITE	4000K

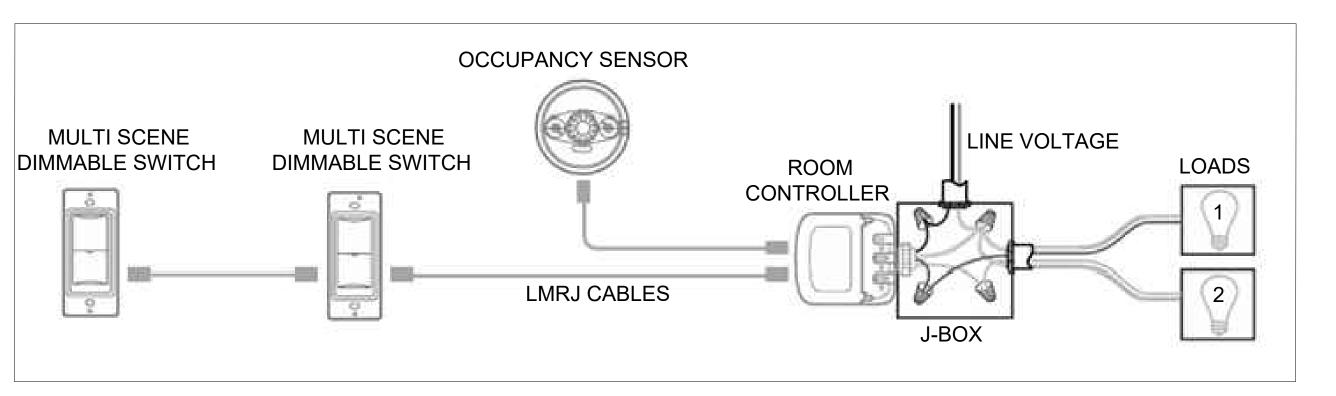

TYPICAL LIGHTING CONTROL SCHEMATIC USING SWITCHES, MOTION SENSOR, AND ROOM CONTROLLER.

2	RE-ISSUED FOR TENDER	2025-02-0
1	ISSUED FOR TENDER	2025-01-2
0	ISSUED FOR PERMIT	2024-12-0
Α	ISSUED FOR 33%	2024-08-0
No	Revisions	Date
Orientation	n Seal	·

The Contractor shall check and verify all dimensions and report all errors and omissions to the IO-Owner's/MBS Designee (as applicable) for his/her written direction before proceeding with the Work.





709 – 2550 VICTORIA PARK AVE. TORONTO, ON, CANADA M2J 5A9 EMAIL: INFO@CESGROUPGLOBAL.COM TEL: +437 747 0171 EXT. 212



STOWBRIDGE CRESCENT HAMILTON, ON, CANADA L9G 5E1 EMAIL: INFO@AJA.DESIGN TEL: +1 905 920 5121



HÖLBROOK ELEMENTARY SCHOOL GYM RENOVATION

450 SANITORIUM ROAD HAMILTION, ONTARIO

Building No


HAMILTON-WENWORTH DISTRICT S.B


Drawing Title


COVER PAGE


Scale N.T.S.	Project Start Date
Drawn by ML	Substantial Performance Date
Designed by FZ	Drawing No
Approved by Floor No FZ	of of
	CADD File NAME

610x914mm

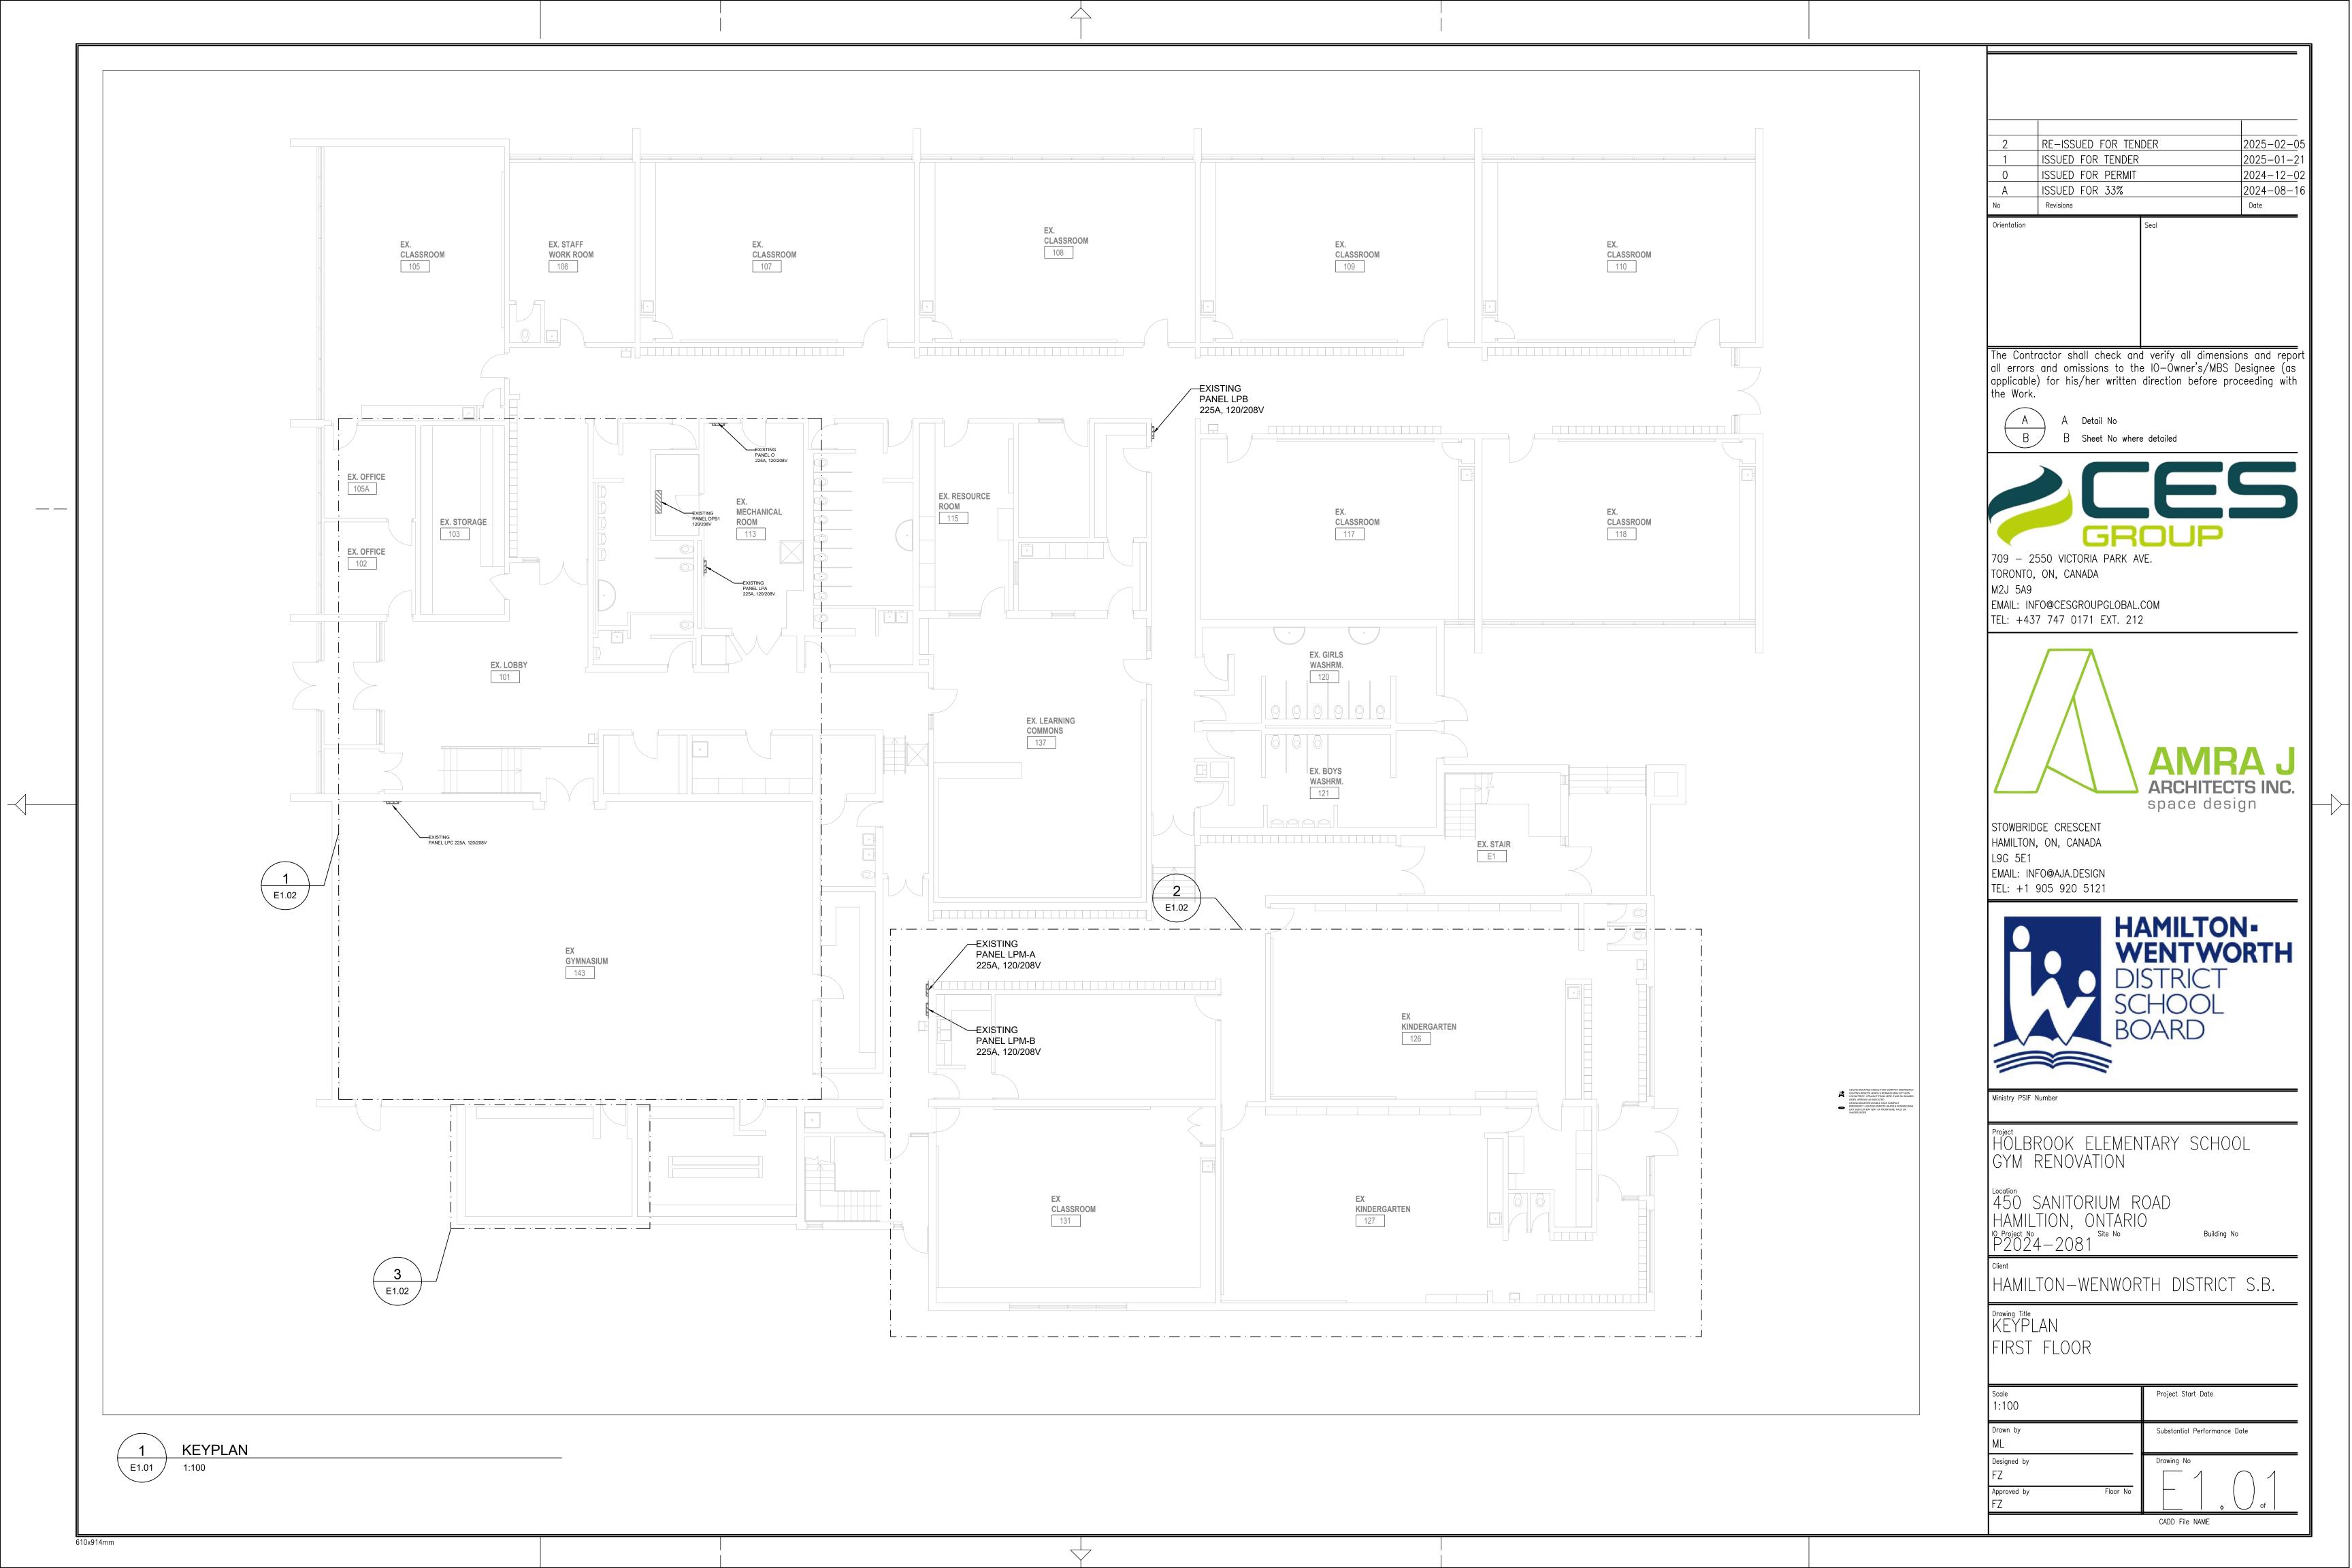

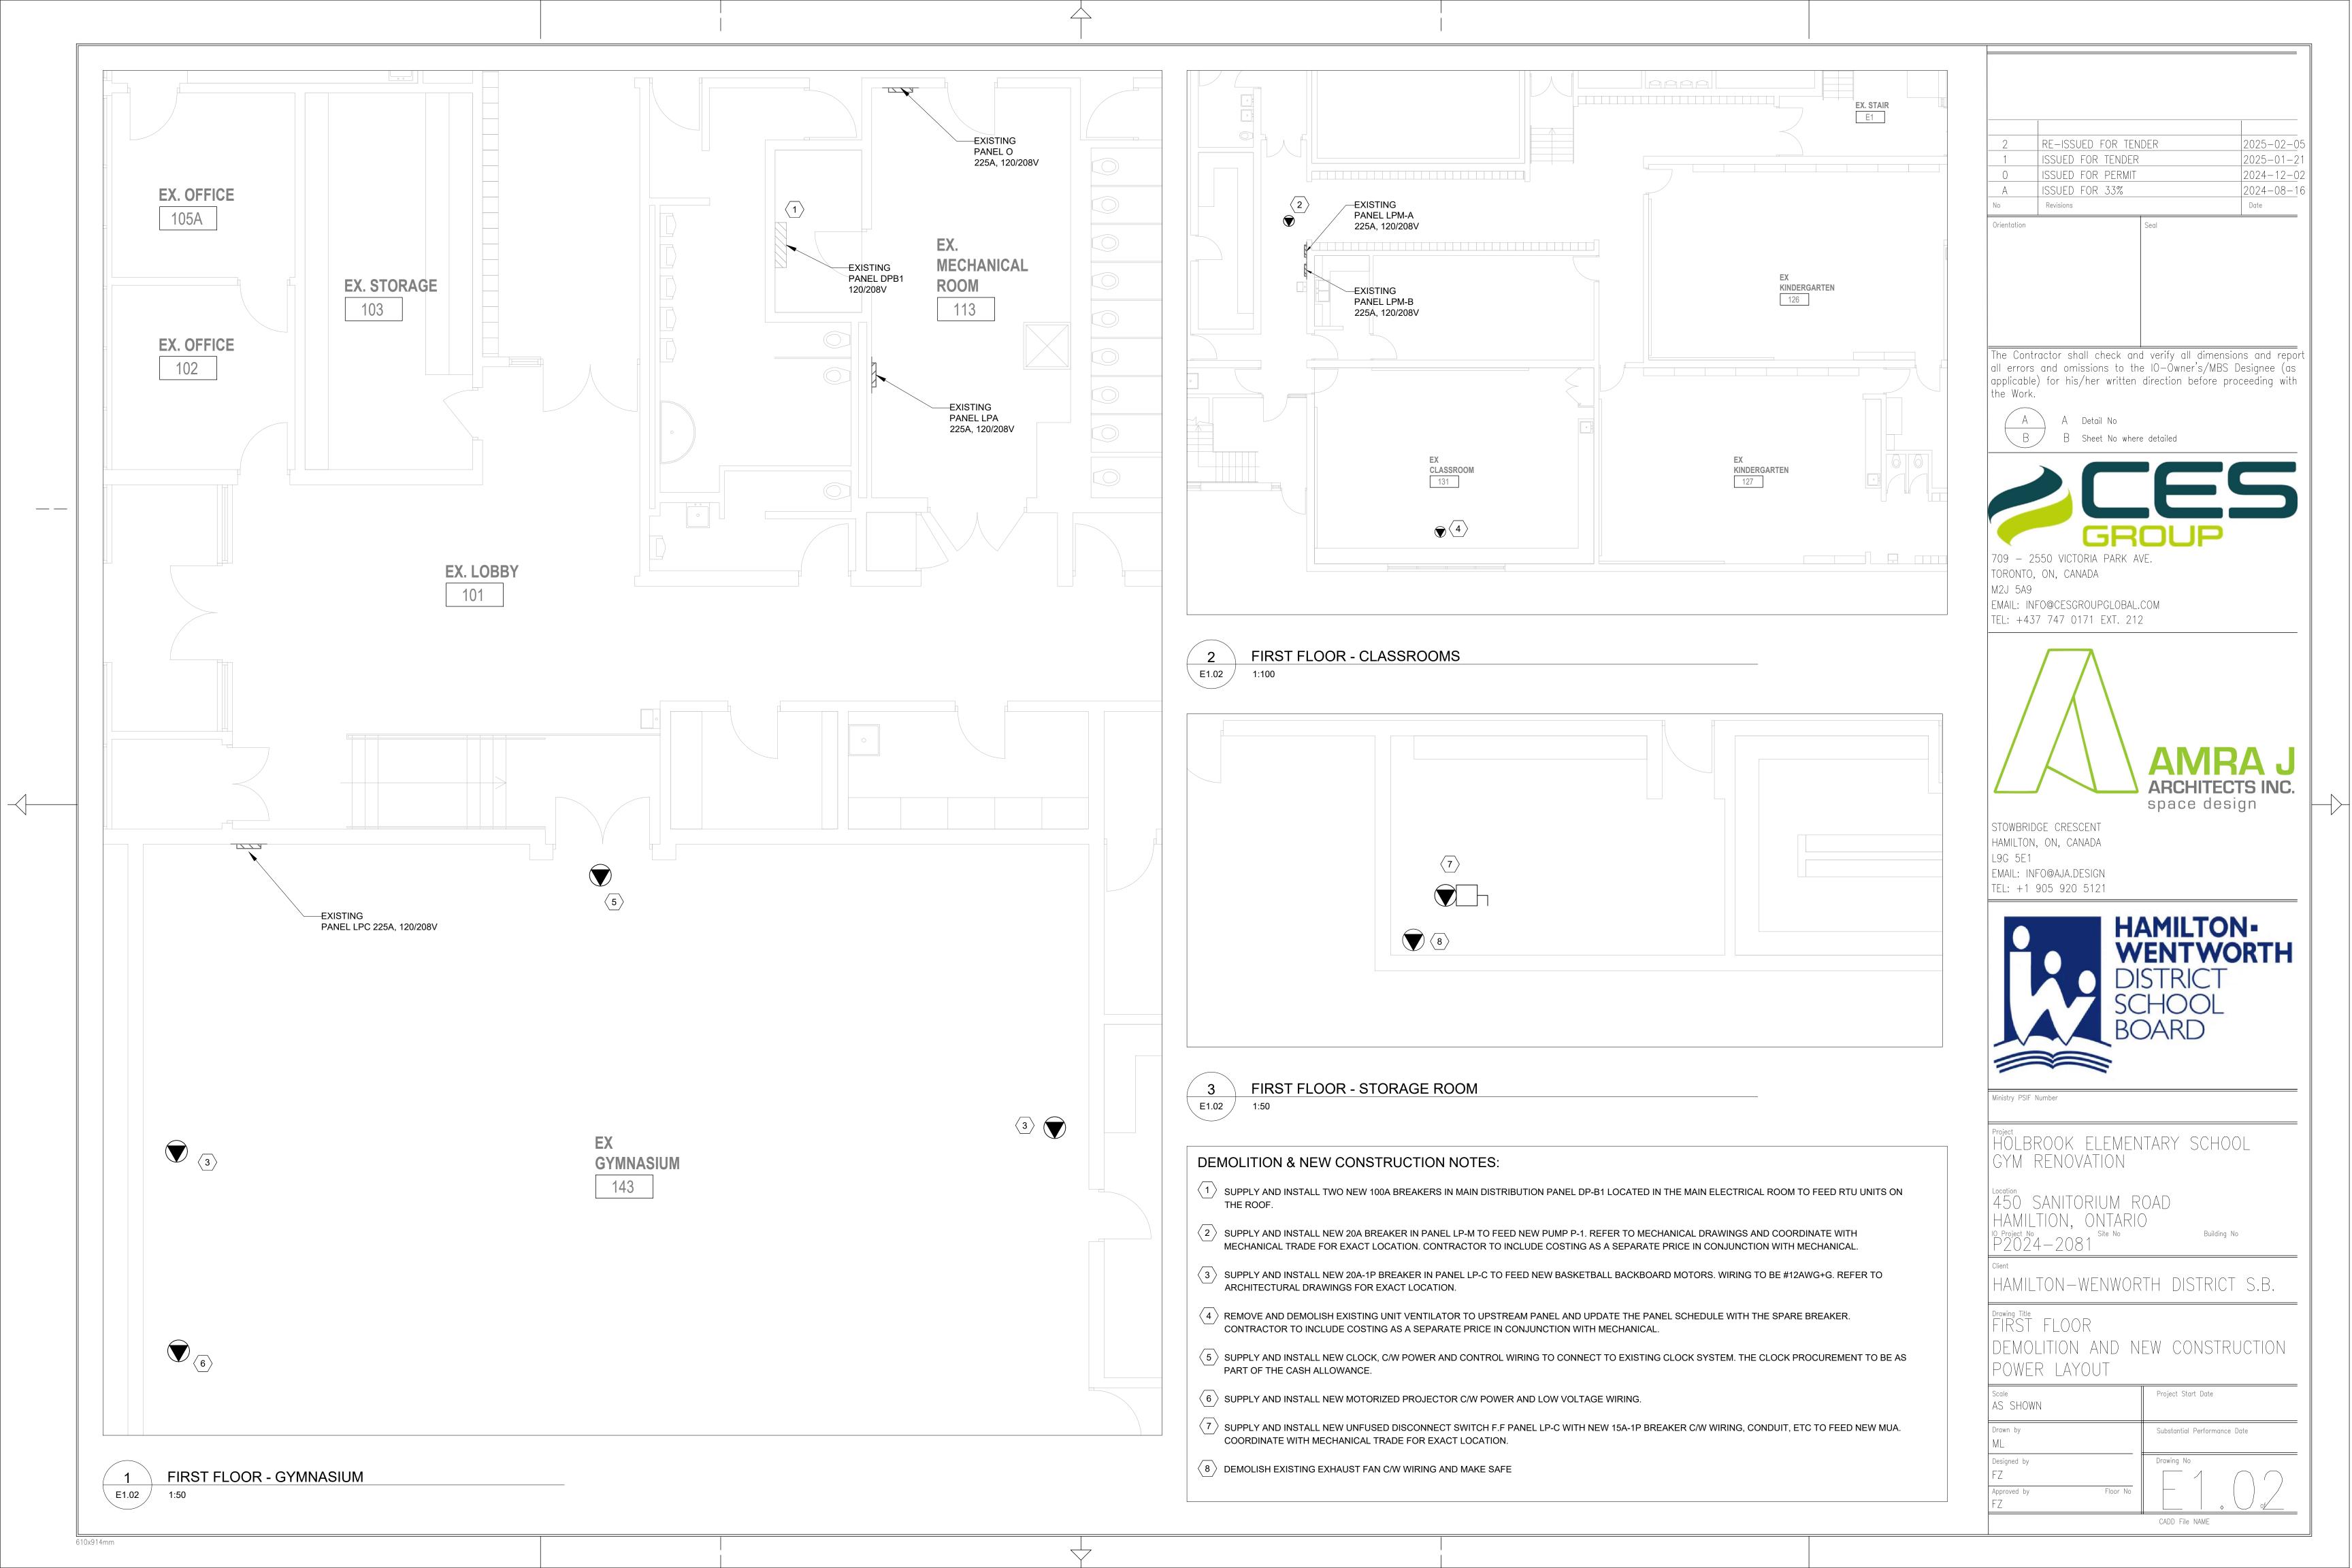

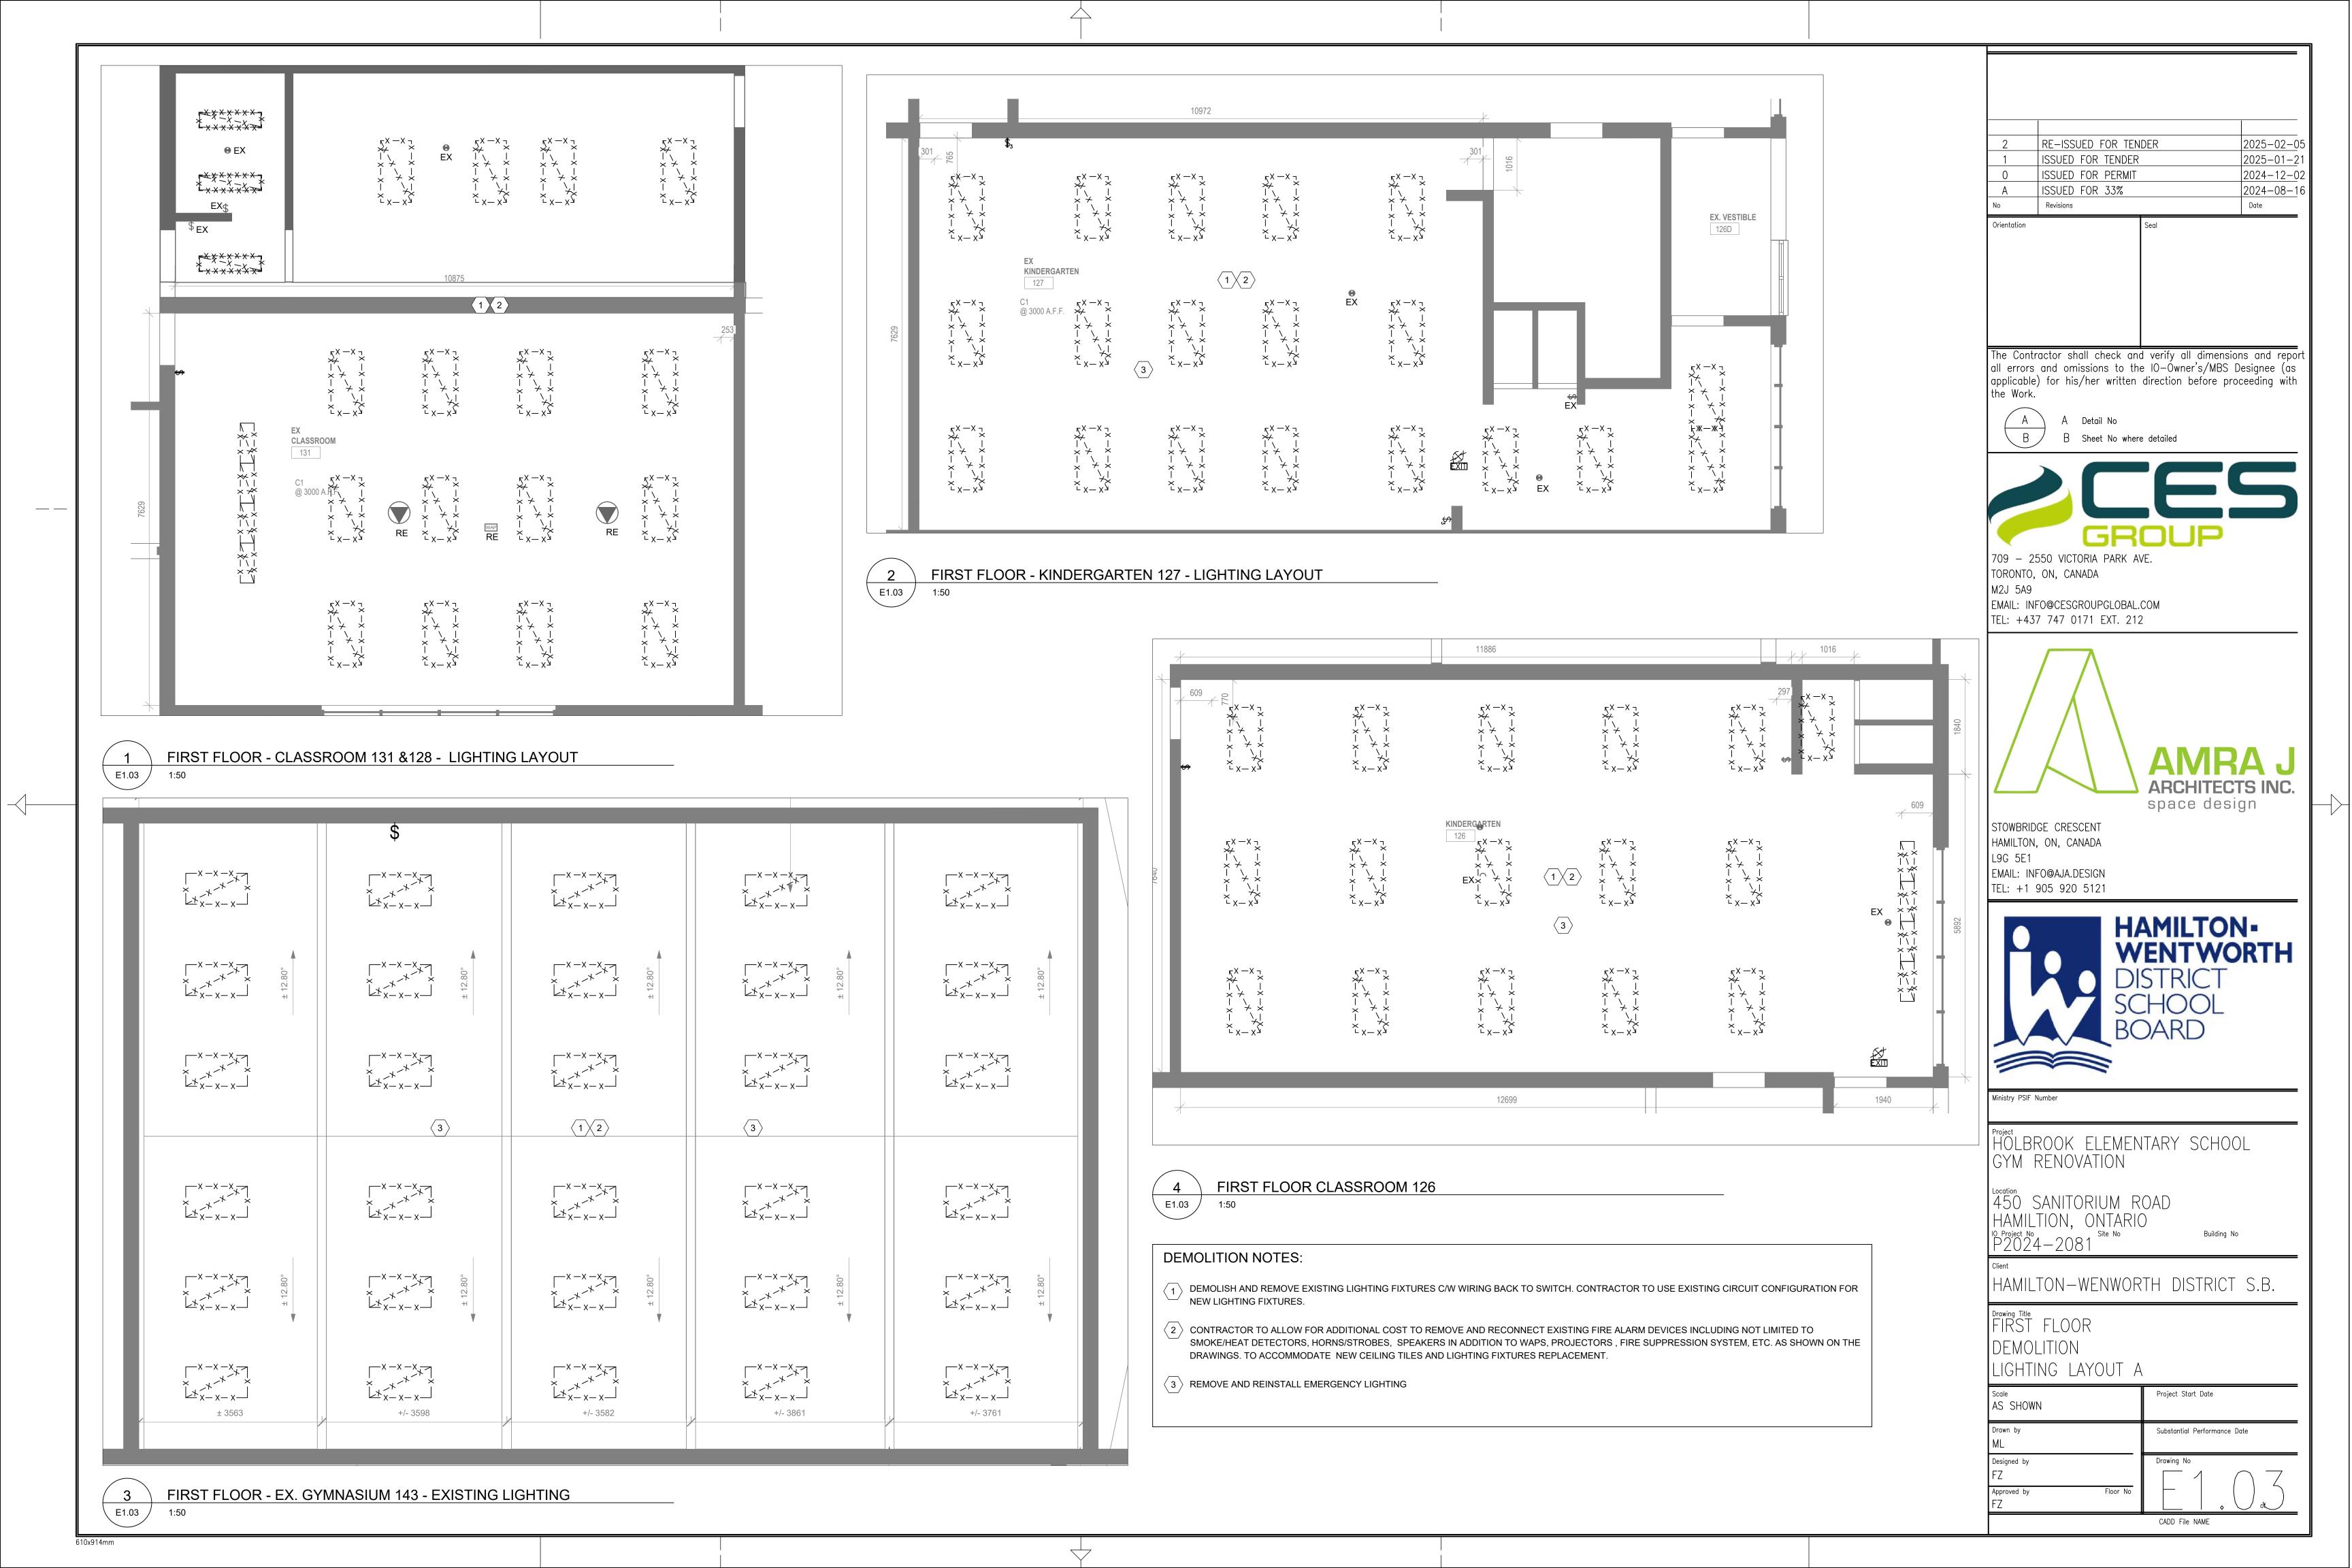

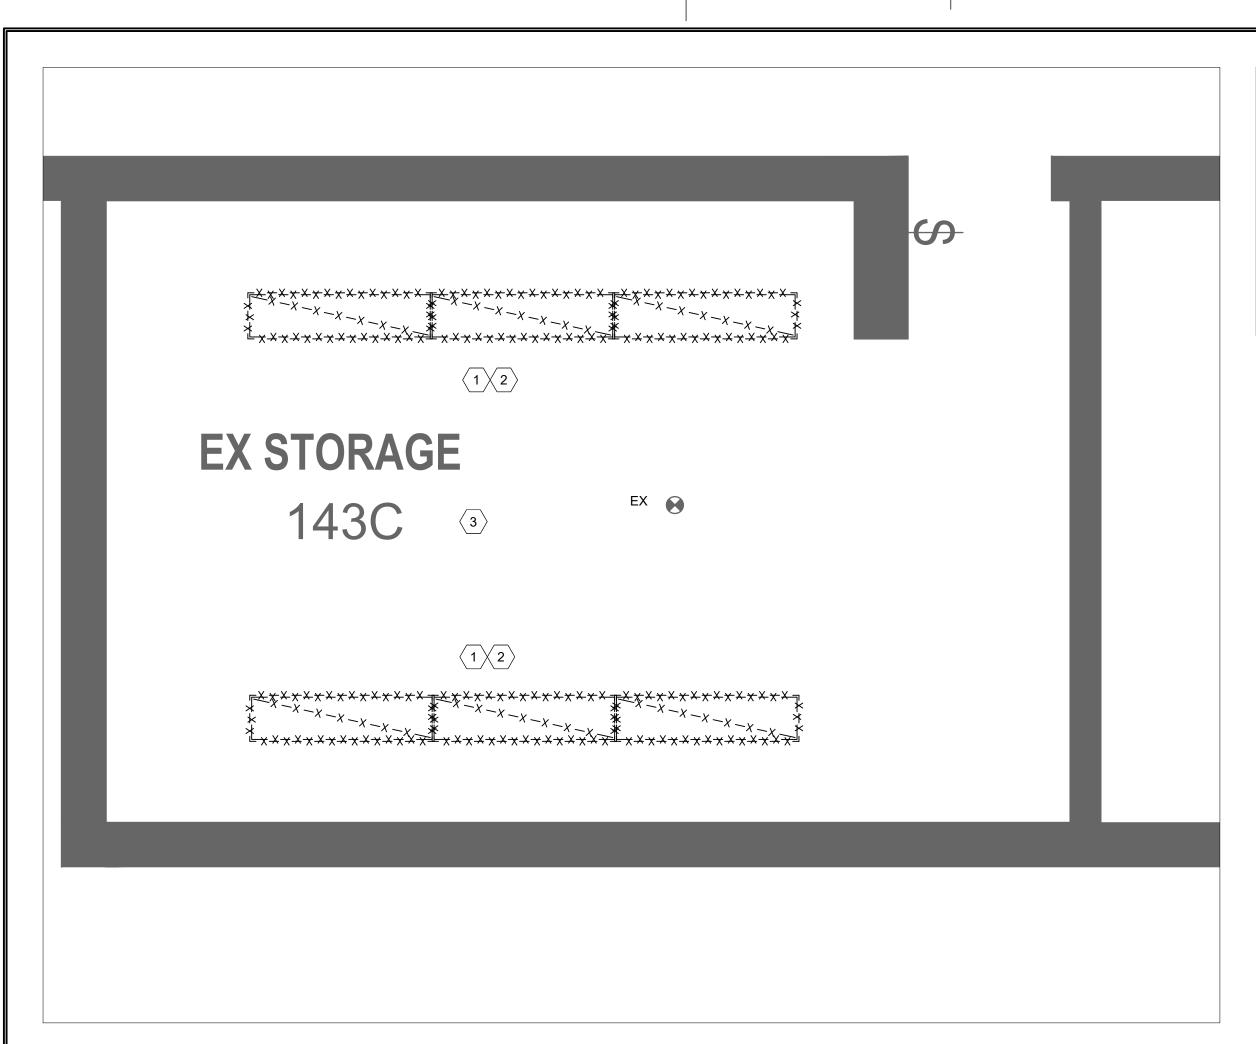

DEMOLITION NOTES:

- DEMOLISH AND REMOVE EXISTING LIGHTING FIXTURES C/W WIRING BACK TO SWITCH. CONTRACTOR TO USE EXISTING CIRCUIT CONFIGURATION FOR NEW LIGHTING FIXTURES.
- \langle 2 angle CONTRACTOR TO ALLOW FOR ADDITIONAL COST TO REMOVE AND RECONNECT EXISTING FIRE ALARM DEVICE, EMERGENCY LIGHTING FIXTURE TO ACCOMMODATE NEW CEILING TILES AND LIGHTING FIXTURES REPLACEMENT.
- (3) REMOVE AND REINSTALL EMERGENCY LIGHTING

2025-02-05 2025-01-21 RE-ISSUED FOR TENDER ISSUED FOR TENDER 2024-12-02 ISSUED FOR PERMIT ISSUED FOR 33% 2024-08-16

Orientation

The Contractor shall check and verify all dimensions and report all errors and omissions to the IO—Owner's/MBS Designee (as applicable) for his/her written direction before proceeding with the Work.



B Sheet No where detailed



TORONTO, ON, CANADA M2J 5A9 EMAIL: INFO@CESGROUPGLOBAL.COM TEL: +437 747 0171 EXT. 212

709 – 2550 VICTORIA PARK AVE.



STOWBRIDGE CRESCENT HAMILTON, ON, CANADA L9G 5E1 EMAIL: INFO@AJA.DESIGN TEL: +1 905 920 5121



Ministry PSIF Number

HOLBROOK ELEMENTARY SCHOOL GYM RENOVATION

450 SANITORIUM ROAD HAMILTION, ONTARIO | No Project No | Site No | P2024—2081

Building No


HAMILTON-WENWORTH DISTRICT S.B.


Prawing Title FIRST FLOOR DEMOLITION LIGHTING LAYOUT


Scale AS SHOWN	Project Start Date
Drawn by ML	Substantial Performance Date
Designed by FZ	Drawing No
Approved by Floor No FZ	→ Of
	CADD File NAME

FIRST FLOOR - STORAGE - LIGHTING LAYOUT DEMOLITION E1.04 / 1:25

610x914mm

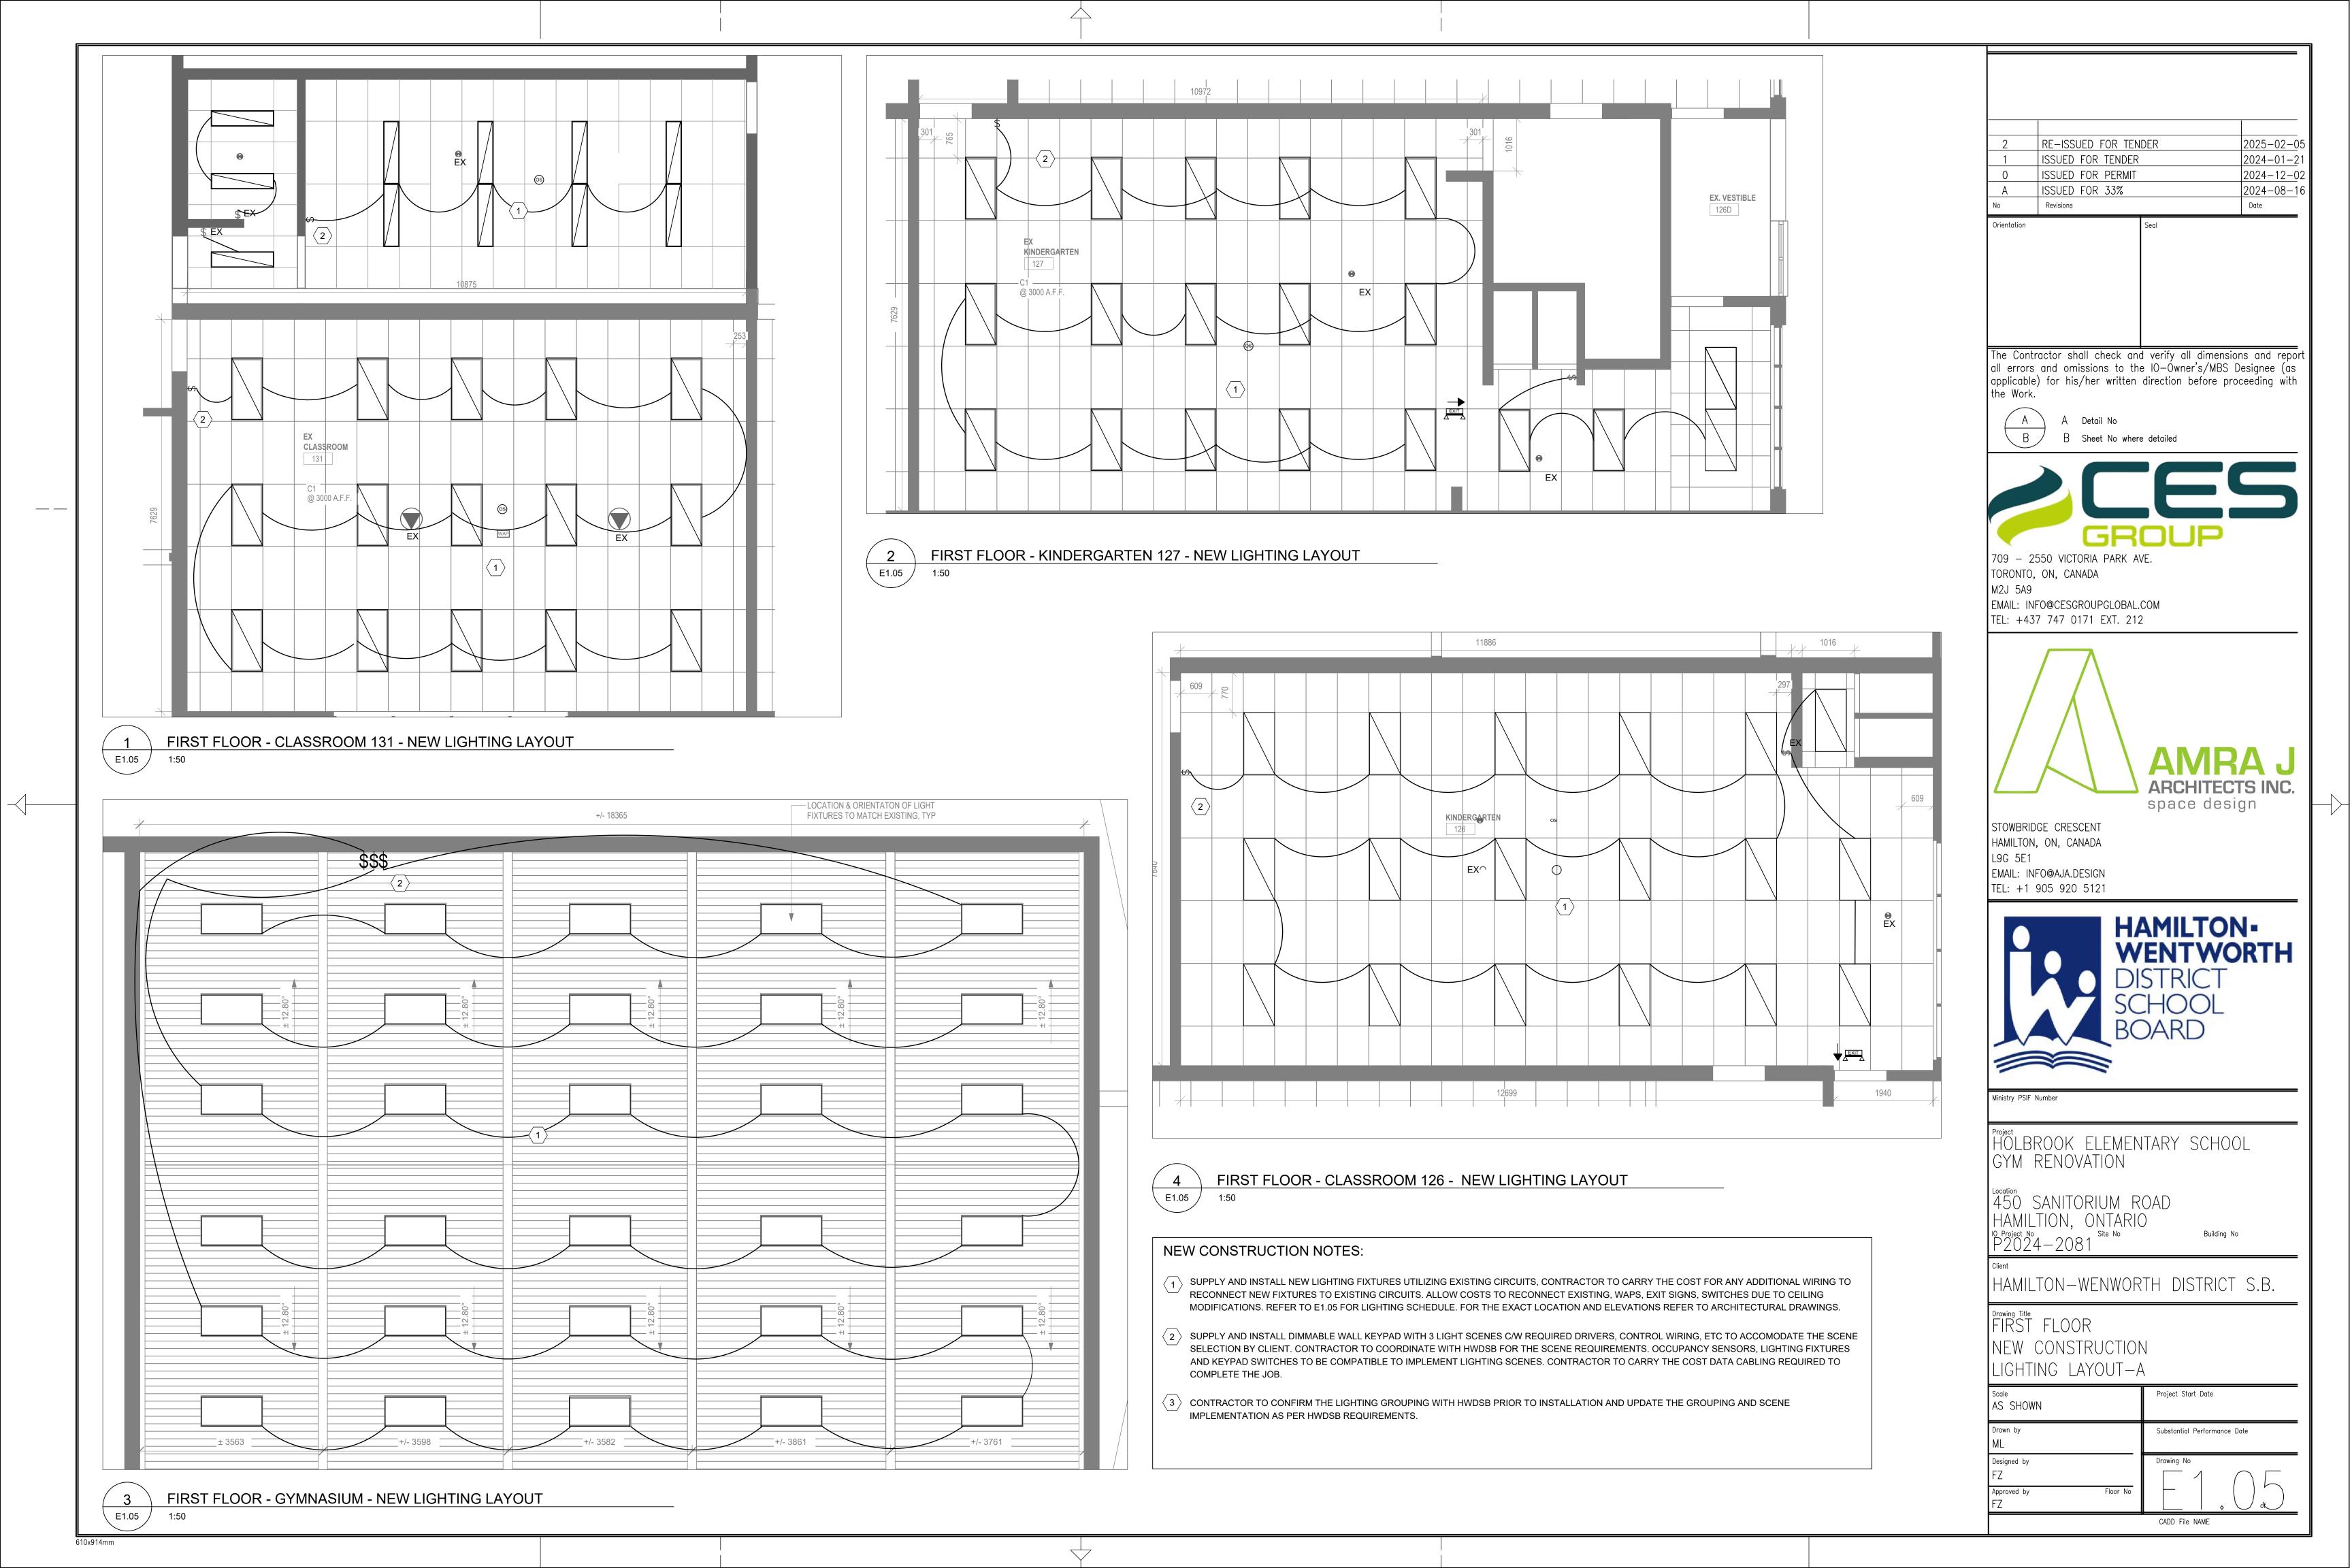

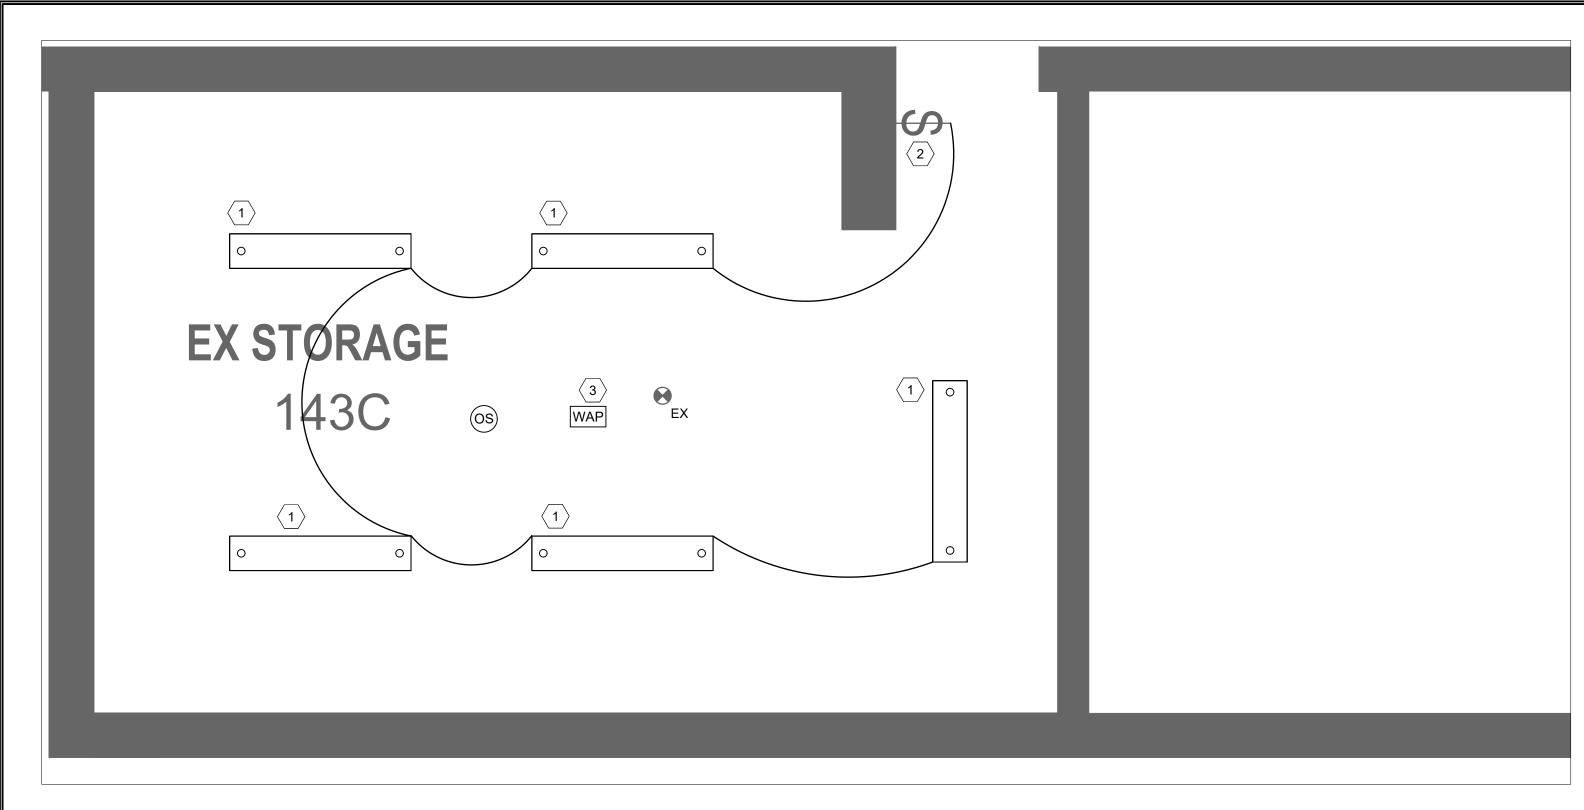

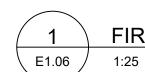

FIRST FLOOR - STORAGE ROOM - NEW LIGHTING LAYOUT

NEW CONSTRUCTION NOTES:

SUPPLY AND INSTALL NEW LIGHTING FIXTURES UTILIZING EXISTING CIRCUITS, CONTRACTOR TO CARRY THE COST FOR ANY ADDITIONAL WIRING TO RECONNECT NEW FIXTURES TO EXISTING CIRCUITS. ALLOW COSTS TO RECONNECT EXISTING, WAPS, EXIT SIGNS, SWITCHES DUE TO CEILING MODIFICATIONS. REFER TO E1.05 FOR LIGHTING SCHEDULE. FOR THE EXACT LOCATION AND ELEVATIONS REFER TO ARCHITECTURAL DRAWINGS.


2 SUPPLY AND INSTALL SINGLE POLE SWITCH C/W WIRING. COORDINATE WITH CLIENT AND ARCHITECT FOR THE COLOR AND AESTHETIC.


 $\left\langle 3 \right\rangle$ SUPPLY AND INSTALL NEW WIRELESS ACCESS POINT, C/W REQUIRED CABLING, POWER ,ETC.

2025-02-05 2024-01-21 RE-ISSUED FOR TENDER ISSUED FOR TENDER 2024-12-02 ISSUED FOR PERMIT ISSUED FOR 33% 2024-08-1

Orientation

The Contractor shall check and verify all dimensions and report all errors and omissions to the IO—Owner's/MBS Designee (as applicable) for his/her written direction before proceeding with the Work.

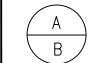

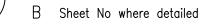



709 – 2550 VICTORIA PARK AVE. TORONTO, ON, CANADA M2J 5A9 EMAIL: INFO@CESGROUPGLOBAL.COM

TEL: +437 747 0171 EXT. 212



STOWBRIDGE CRESCENT HAMILTON, ON, CANADA L9G 5E1 EMAIL: INFO@AJA.DESIGN TEL: +1 905 920 5121



Ministry PSIF Number

HOLBROOK ELEMENTARY SCHOOL GYM RENOVATION

450 SANITORIUM ROAD HAMILTION, ONTARIO 10 Project No P2024-2081 Site No


HAMILTON-WENWORTH DISTRICT S.B.


Building No

Prowing Title FIRST FLOOR NEW CONSTRUCTION LIGHTING LAYOUT-B

Scale 1:25	Project Start Date
Drawn by ML	Substantial Performance Date
Designed by FZ	Drawing No
Approved by Floor No FZ	
	CADD File NAME

610x914mm

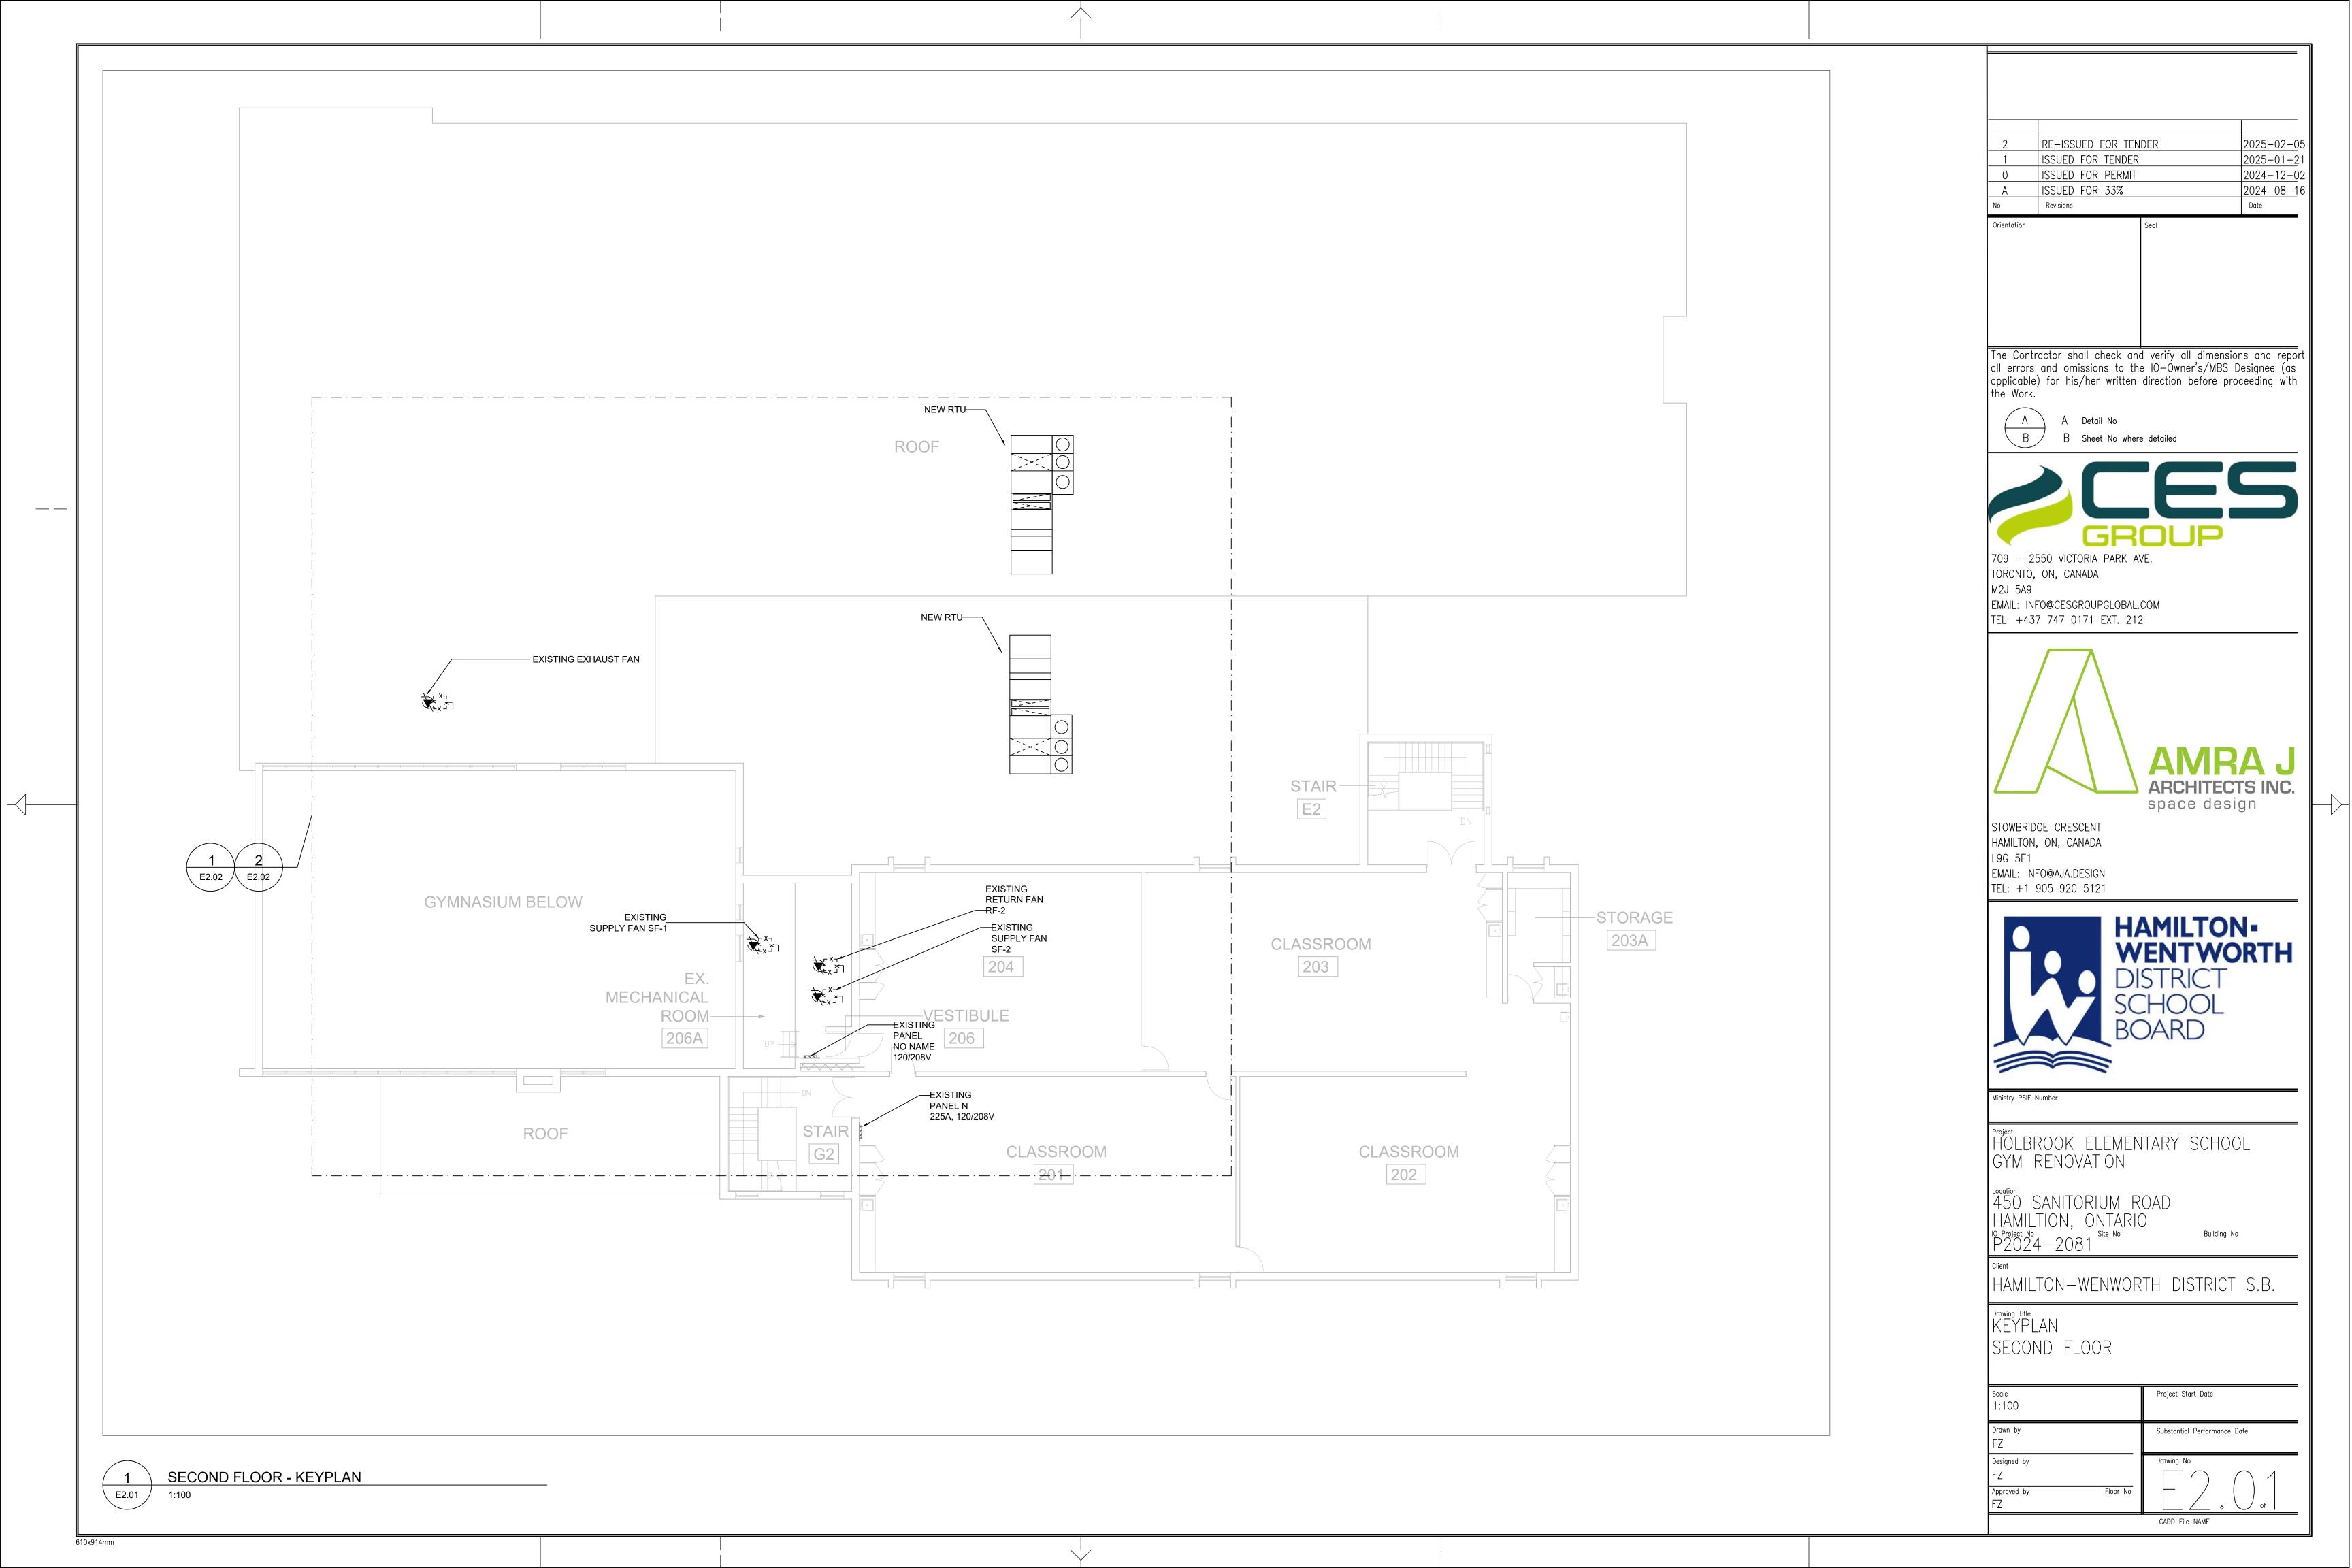

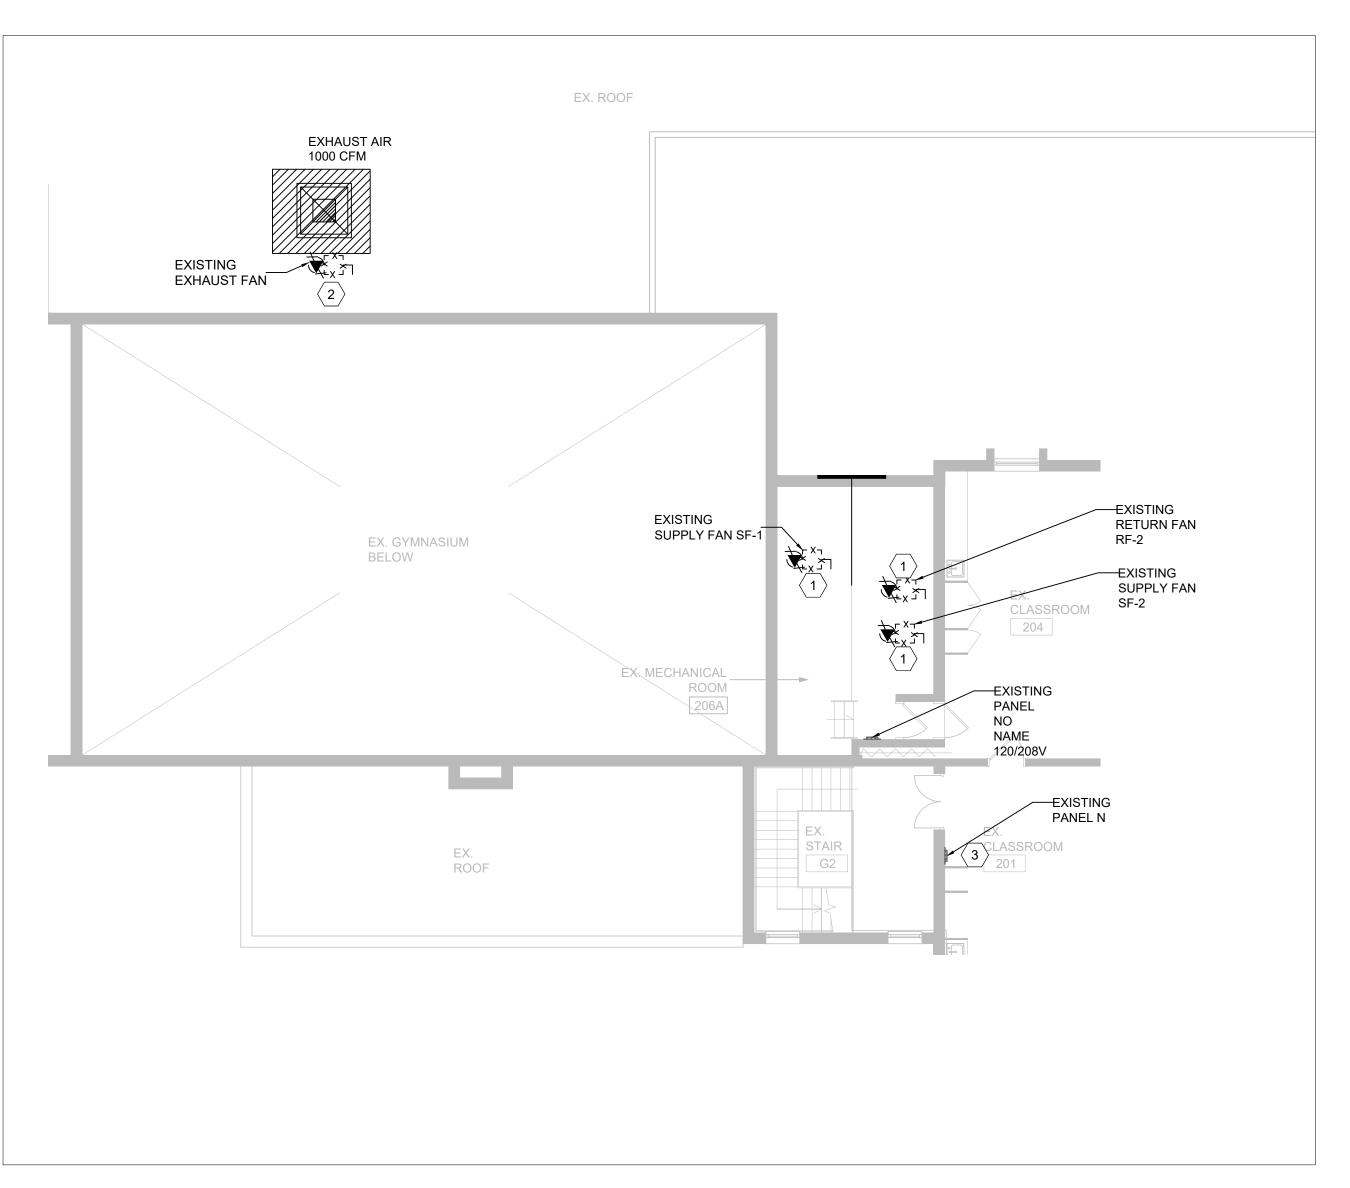

E2.02


DEMOLITION NOTES:

 \langle 1 \rangle DISCONNECT ALL EXISTING UNITS (SF-1, SF-2 AND RF-2)

 \langle 2 \rangle DISCONNECT EXISTING EXHAUST FAN SERVING GYM, LOCATED ON ROOF.

SECOND FLOOR AND ROOF DEMOLITION

 \langle 3 \rangle DISCONNECT, DEMOLISH AND DISPOSE EXISTING SUIT CIRCUIT BREAKERS EXISTING FEEDER CIRCUIT AND OUTGOING CIRCUIT FEEDS TO REMAIN (OTHER THAN CIRCUITS FOR REDUNDANT EQUIPMENT WHICH ARE TO BE REMOVED).

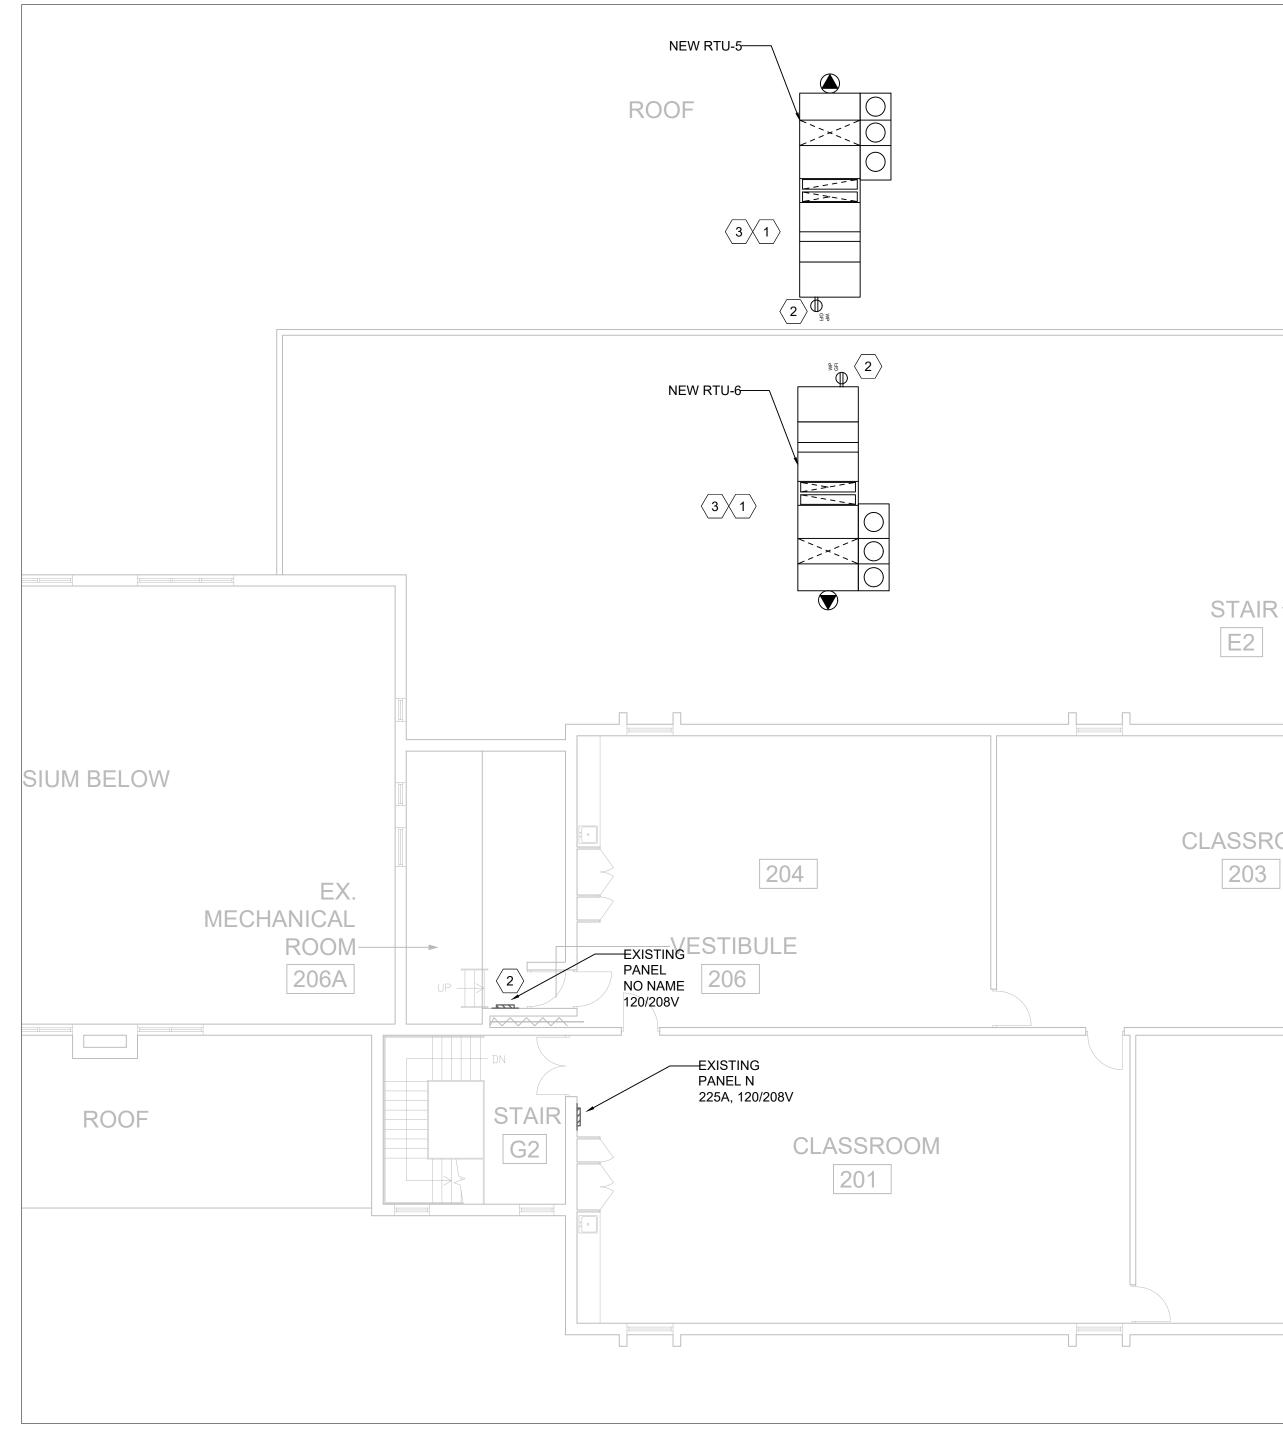

E2.02


SECOND FLOOR - NEW CONSTRUCTION

NEW CONSTRUCTION NOTES:

- \langle 1 \rangle SUPPLY AND INSTALL NEW WIRING, CONDUITS, FITTINGS TO CONNECT TO NEW RTU FROM A NEW 100A BREAKER IN MAIN DISTRIBUTION PANEL DP-B1 LOCATED IN THE MAIN ELECTRICAL ROOM. WIRING TO BE 3X#2AWG+G. OUTSIDE CONDUIT TO BE WEATHER PROOF AND SUPPORTED BY UNISTRAT.
- 2 SUPPLY AND INSTALL NEW 20A BREAKER IN SECOND FLOOR MECHANICAL ROOM PANEL TO FEED RTU MAINTENANCE RECEPTACLE WITH #12 AWG WIRING.
- \langle $_3$ \rangle SUPPLY AND INSTALL NEW DUCT SMOKE DETECTOR IN THE STRAIGHT PORTION OF MAIN SUPPLY DUCT, DOWNSTREAM OF MIXING BOX, FILTERS AND FANS IN ADDITION TO REQUIRED MODULES TO INTEGRATE FIRE ALARM FAN SHUTDOWNS TO NEW RTU UNIT IN CASE OF FIRE ALARM.DUCT SMOKE DETECTOR TO BE CONNECTED TO NEAREST FA INDICATING LINE CIRCUIT OF EXISTING BASE BUILDING FACP. COORDINATE WITH MECHANICAL TRADE FOR THE EXACT LOCATION OF DETECTOR. LOCATION OF THE DETECTORS TO BE ACCESSIBLE FOR MAINTENANCE.
- \langle 4 angle ELECTRICAL CONTRACTOR SHALL CARRY THE COST OF THE BASE BUILDING FIRE ALARM SERVICE PROVIDER HAMILTON FIRE CONTROL AND THE REQUIRED COORDINATION TO FULLY INTEGRATE THE NEW SMOKE DETECTORS TO THE EXISTING FIRE ALARM SYSTEM. CARRY THE COST TO UPDATE/EXPAND THE EXISTING FIRE ALARM CONTROL PANEL ZONING, PASSIVE GRAPHICS REPROGRAMMING AND ETC. TO COMPLETE THE NEW SCOPE OF THE WORK AS REQUIRED.

		<u> </u>
2	RE-ISSUED FOR TENDER	2025-02-0
1	ISSUED FOR TENDER	2025-01-2
0	ISSUED FOR PERMIT	2024-12-0
Α	ISSUED FOR 33%	2024-08-1
No	Revisions	Date

The Contractor shall check and verify all dimensions and report all errors and omissions to the IO—Owner's/MBS Designee (as applicable) for his/her written direction before proceeding with the Work.

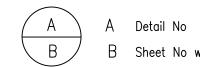



709 – 2550 VICTORIA PARK AVE. TORONTO, ON, CANADA M2J 5A9 EMAIL: INFO@CESGROUPGLOBAL.COM TEL: +437 747 0171 EXT. 212



HAMILTON, ON, CANADA L9G 5E1 EMAIL: INFO@AJA.DESIGN TEL: +1 905 920 5121



Ministry PSIF Number

HOLBROOK ELEMENTARY SCHOOL GYM RENOVATION

450 SANITORIUM ROAD HAMILTION, ONTARIO P2024-2081

HAMILTON-WENWORTH DISTRICT S.B.

DEMOLITION AND NEW CONSTRUCTION POWER LAYOUT

Scale 1:100	Project Start Date
Drawn by FZ	Substantial Performance Date
Designed by FZ	Drawing No
Approved by Floor No FZ	
	CADD File NAME

Drawing Title SECOND FLOOR