



Hamilton - Wentworth District School Board

P02085 Franklin Elementary School

Music Room, Corridors, and Student Washrooms Renovations

500 Franklin Rd., Hamilton, Ontario



DRAWING LIST

ARCHITECTURAL DRAWINGS

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E0-00 ELECTRICAL LEGEND & DRAWING LIST


E0-01 CONSTRUCTION BIDDING PLAN

E1-00 OVERALL PLAN DEMO - ELECTRICAL E1-01 ENLARGED PLANS #1 DEMO - ELECTRICAL

E1-02 ENLARGED PLANS #2 DEMO - ELECTRICAL

E2-00 OVERALL PLAN NEW - ELECTRICAL

E4-00 ELECTRICAL SPECIFICATIONS

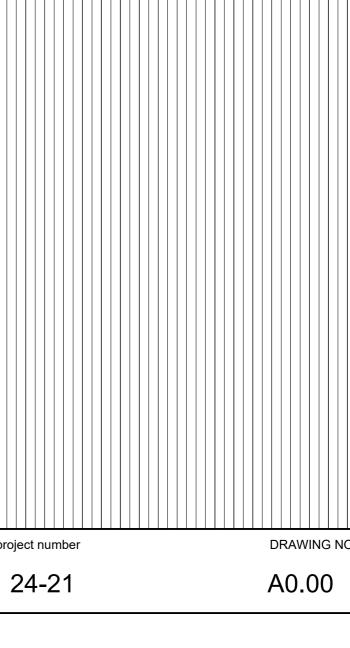

11.15 Compliance

11.16 Notes:

Alternatives

Proposed:

info@aja.design

Name of Project: P02085 Franklin Elementary School Music Room, Corridors, and Student Washroom Renovations

Location:

	P	Ontario Building Code Data Matrix art 11 – Renovation of Existing Building	Building Code Reference ¹
11.00	Building Code Version:	O. Reg. 332/12 Last Amendment O. Reg. 191/14	-
11.01	Project Type:	□ Addition □ Renovation □ Addition and renovation □ Change of use Description: Interior Renovation of Existing Music Room and Existing Washrooms, and Replacement of Existing Corridor Ceilings.	[A] 1.1.2.
11.02	Major Occupancy Classification:	Occupancy Use A-2 Elementary School	3.1.2.1.(1)
11.03	Superimposed Major Occupancies:	No □ Yes Description:	3.2.2.7.
11.04	Building Area (m²) Insert additional lines as needed	Description: Existing New Total Existing School 4,517 0 4,517	[A] 1.4.1.2.
11.05	Building Height	1 Storeys above grade Existing (m) Above grade0 Storeys below grade	[A] 1.4.1.2. & 3.2.1.1.
11.06	Number of Streets/ Firefighter access	Existing street(s)	3.2.2.10. & 3.2.5
11.07	Building Size	☐ Small ☐ Medium ☐ Large ☐ > Large	T.11.2.1.1.BN.
11.08	Existing Building Classification:	Change in Major Occupancy: ☐ Yes ☒ Not Applicable (no change of major occupancy) Construction Index: Hazard Index: Importance Category : ☐ Low ☐ Normal ☐ High ☐ Post-disaster	11.2.1.1. T 11.2.1.1A T 11.2.1.1B to N 4.2.1.(3), 5.2.2.1.(2)
11.09	Renovation type:	☐ Basic Renovation ☐ Extensive Renovation	11.3.3.1. 11.3.3.2.
11.10	Occupant Load	Floor Level/Area Occupancy Based On Occupant Load Type (Persons)	3.1.17.
	Insert additional lines as needed	<u>1 storey – 4, 517</u> <u>A-2</u> <u>persons</u> <u>805</u>	
11.11	Plumbing Fixture Requirements	Ratio: 1 fixture / 30 males & 1 fixture / 26 females	3.7.4.
		Floor Level/Area Occupant OBC Fixtures Fixtures Load Reference Required Provided	
	Insert additional lines as needed	1 403 3.7.4.3.(14) 14 18 (males)	
11.12	Barrier-free Design:		_ 11.3.3.2.(2)
11.13	Reduction in	Structural: No Yes	11.4.2.1.
11.13	Performance Level:	By Increase in occupant load: No □ Yes	11.4.2.2.
		By change of major occupancy: No □ Yes	11.4.2.3.
		Plumbing: No □ Yes	11.4.2.4.
		Sewage-systems: ⊠ No □ Yes	11.4.2.5.
		Extension of combustible construction:	11.4.2.6.
11.14	Compensating	⊠ No □ Yes	11.4.3.1,
	Construction:	Structural: No Yes	11.4.3.2,
		Increase in occupant load: ⊠ No □ Yes	11.4.3.3,
		Change of major occupancy: ⊠ No ☐ Yes	11.4.3.4,
		Plumbing: No Yes	11.4.3.5,
		Sewage systems: No Yes	11.4.3.6,
		Extension of combustible construction:	11.4.3.7.
		[2] [3] [3] [3] [3] [4] [4] [4] [4] [4] [4] [4] [4] [4] [4	

The scope of work is renovation of the existing music room and existing

There is no change in occupant load and occupancy classification

washrooms and replacing of existing corridor ceilings.

The total area of renovation is 783 Sq. M.

All references are to Division B of the OBC unless preceded by [A] for Division A and [C] for Division C.

NOTES AND SPECIFICATIONS

1. GENERAL:

THE PROJECT SCOPE INCLUDES RENOVATION OF EXISTING MUSIC ROOM AND EXISTING WASHROOMS, AND REPLACEMENT OF EXISTING CORRIDOR CEILINGS.

THE AREA OF RENOVATION IS 783 SQ. M.

REVIEW THE ENTIRE SET OF DRAWINGS, INCLUDING MECHANICAL AND ELECTRICAL FOR THE FULL SCOPE OF WORK.

INCLUDE PROVISIONS FOR ALL REPAIRS OF MATERIALS DISTURBED BY MECHANICAL/ELECTRICAL WORK.

ENSURE THAT THE CONSTRUCTION COMPLIES WITH CURRENT ONTARIO BUILDING CODE REQUIREMENTS AND THAT EXISTING FIRE RATING IS MAINTAINED WHERE APPLICABLE.

VERIFY ALL DIMENSIONS ON-SITE AND NOTIFY ARCHITECT IF ANY MODIFICATIONS ARE REQUIRED TO SUIT THE EXISTING SITE CONDITIONS. REPORT ANY CONTEMPLATED DEVIATIONS FROM THE DRAWINGS PRIOR TO MAKING CHANGES.

ENSURE THAT ALL AREAS DISTURBED OR DAMAGED DURING CONSTRUCTION, WHETHER SHOWN ON THE DRAWINGS OR NOT, ARE RESTORED TO THEIR ORIGINAL CONDITION.

CONTRACTOR SHALL FULLY ENCLOSE CONSTRUCTION AREA AND COORDINATE ALL DEMOLITION AND NEW WORK IN SUCH MANNER NOT TO DISTURB DAY-TO-DAY OPERATION OF THE SURROUNDING AREAS.

2. DEMOLITION

ALL DEMOLITION WORK TO BE COORDINATED WITH THE HARZARDOUS MATERIALS ABATEMENT SCOPE OF WORK. REFER TO APPLICABLE DOCUMENTATION INCLUDED WITHIN THE SPECIFICATIONS.

REFER TO DEMOLITION PLAN AND NOTES ON DRAWINGS A1.00 - A1.02 AND ALSO MECHANICAL AND ELECTRICAL DEMOLITION DRAWINGS AND

REPAIR AND MAKE GOOD ALL EXISTING FLOORS, WALLS AND CEILINGS DAMAGED DURING THE DEMOLITION AND CONSTRUCTION PROCESS.


WASHROOM FIXTURES COUNT


	ROO	WC	URINAL		
	BASE BID	SEPARATE PRICE 1	SEPARATE PRICE 2		
		BOYS WASHROOM 114		5	3
	BOYS WASHROOM 128A		8585858585858	1	2
EXISTING			BOYS WASHROOM 135	2	3
EXISTING		GIRLS WASHROOM 120	755555555555555	8	
			GIRLS WASHROOM 134	5	
	GIRLS WASHROOM 146A		856565656565666	3	
		STAFF WASHROOM 123		1	
		STAFF WASHROOM 121		1	
NEW	STAFF WASHROOM 128B		9595959595959	1	
	STAFF WASHROOM 146A			1	
	TOTAL:			28	8

MAX OCCUPANT LOAD OBC REQUIREMENT (MALE) OBC REQUIREMENT (FEMALE)

WASHROOM TYPE	TOTAL REQUIRED	TOTAL PROVIDED
BOYS WASHROOM	14	16
GIRLS WASHROOM	16	16
STAFF WASHROOM		4

	JLE	łEDI	S	DOOF	D							
		AME	F							OOR	D	
HARDWARE & REMARKS	GLAZING	FINISH	MATERIAI	TYPE	GLAZING	FINISH	MATERIAL	THICKNESS	HEIGHT	WIDTH	TYPE	NUMBER
EXISTING DOOR & FRAME TO BE PAINTED	EX١	PTD	E	4 F1	X N/A	EXTLE	EX (45 I	2135	950	A	D104
LOCK SET, DOOR CLOSER	N/A	PTD	Н	4 F1	N/A	PTD	HM	45	2135	950	Α	D128B
LOCK SET, DOOR CLOSER	N/A	PTD	Н	4 F1	N/A	PTD	НМ	45	2135	950	Α	D146B
EXISTING DOOR & FRAME TO BE PAINTED	EΧ\	PTD	E	4 F1	X N/A	EXTLE	EX (45 I	2135	900	Α	D123
LOCK SET, DOOR CLOSER	N/A	PTD	Н	4 F1	N/A	PTD	НМ	45	2135	950	Α	D124
LOCK SET, DOOR CLOSER	N/A	PTD	Н	4 F1	N/A	PTD	НМ	45	2135	950	Α	D121

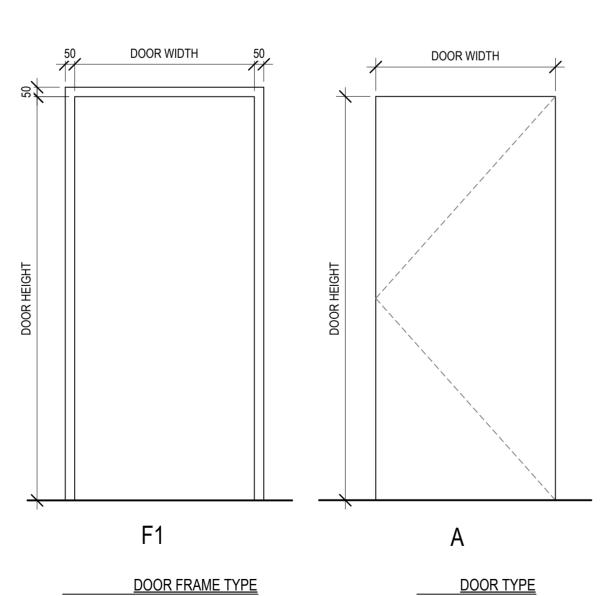

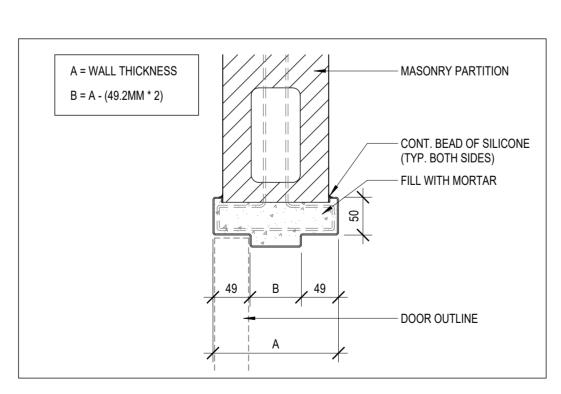

DOOR FRAME DETAILS

SCALE: 1:5

ENTRANCE

BASE BID SEPARATE PRICE 1 SEPARATE PRICE 2 EX CORRIDOR 102 EX MUSIC ROOM -104 **EX BOYS** EX GIRLS EX BOYS WASHROOM-WASHROOM EX CORRIDOR EX CORRIDOR WASHROOM WASHROOM--WASHROOM 114 135 **ENTRANCE**

EX GIRLS


WASHROOM

146

CEILING SCHEDULE

EX CORRIDOR

129

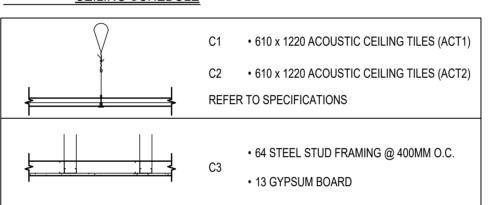

PHASING LEGEND

EX CORRIDOR

133

PHASING KEY PLAN


PARTITION SCHEDULE GENERAL NOTE:

ALL PARTITIONS EXTEND TO UNDERSIDE OF STRUCTURAL SLAB OR ROOF DECKING (± 3650) UNLESS OTHERWISE NOTED.


GYPSUM WALLBOARD FINISH TO EXTEND TO 100mm ABOVE FINISHED CEILING NOTED ON RCPS, TYP AT LOCATIONS WHERE MASONRY UNITS ARE TO INFILL AN OPENING AT AN EXISTING WALL, MASONRY UNIT DIMENSIONS TO MATCH EXISTING (IMPERIAL OR METRIC AS APPLICABLE).

ALL EXPOSED CORNERS IN MASONRY WALLS TO BE ROUNDED BULLNOSE. AT NEW OPENING IN EXISTING MASONRY WALLS, KEY IN NEW MASONRY UNITS AS REQUIRED FOR FINISH WITH BULLNOSE OPENING.

PARTITION SCHEDULE

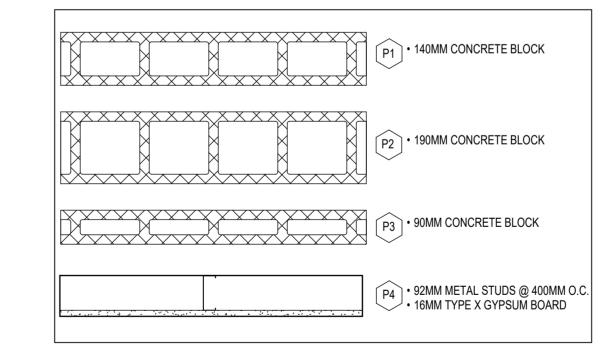


EXTERIOR WALL INFILL

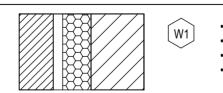


 90MM FACE BRICK 25MM AIR SPACE • 75MM CLOSED CELL SPRAY FOAM (R18) 140MM BLOCK

FURRING WALL SCHEDULE

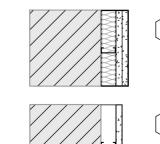

 EXISTING CONCRETE BLOCK WALL • 38mm FURRING CHANNELS @ 400mm O.C. ACOUSTIC INSULATION • 2 LAYERS OF 16mm TYPE X GYPSUM BOARD


 EXISTING CONCRETE BLOCK WALL • 38mm FURRING CHANNELS @ 400mm O.C. 16mm TYPE X GYPSUM BOARD

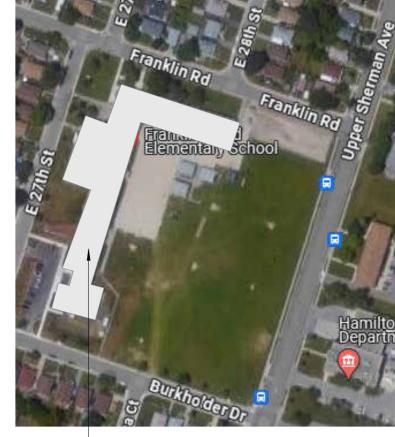

AREA OF WORK

SITE LOCATION

SYMBOL LEGEND

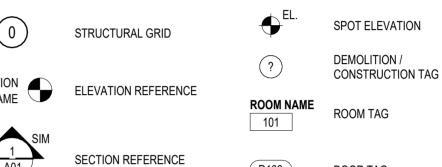



1 A100 3







DOOR TAG

FLOOR TAG

ROOF TAG

REVISION TAG

WINDOW / SCREEN TAG

ABBREVIATION LEGEND

STAND	ARDS	MATER	MATERIAL		
A.F.F. BF c/w DN EL. EX EXP. FIN. FTG G.C. GL G/R H.D.G. N.I.C. N.T.S. SIM. STRU. T/	DOWN ELEVATION EXISTING EXPOSED FINISHED FOOTING GENERAL CONTRACTOR GRID LINE GUARDRAIL HANDRAIL HOT DIPPED GALVENIZED	ACT CAR CMU CONC CT GB GW HM INT PT RB SC SHT S.S. ST TG VCT WR U.N.O.	ACOUSTICAL CEILING TILE CARPET CONCRETE MASONRY UNIT CONCRETE CERAMIC TILE GYPSUM BOARD GEORGIAN WIRE HOLLOW METAL INTEGRAL PAINT RUBBER BASE SOLID CORE SHEET STAINLESS STEEL STAIN TEMPERED GLASS VINYL COMPOSITE TILE WASHROOM UNLESS NOTED OTHERWISE		
TYP.	TYPICAL				

DRAWING LEGEND


WBF WATER BOTTLE FILLER

u/s UNDERSIDE

EXISTING WALL TO


EXISTING TO BE DEMOLISHED

REMAIN

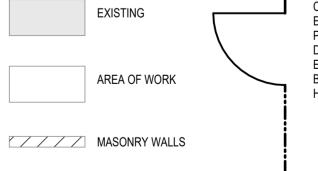

CONSTRUCTION HOARDING PARTITION. EXTEND TO U/S OF EXISTING CEILING. PROVIDE TEMPORARY CONSTRUCTION DOORS WITH LOCKS. PATCH AND REPAIR EXISTING WALL, FLOOR AND CEILING AS MAY BE REQUIRED AFTER REMOVAL OF HOARDING. (TYP)




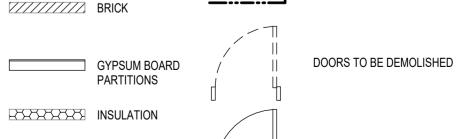


NEW DOORS

EXISTING DOORS TO REMAIN

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ISSUED FOR TENDER 02/06/2025 ISSUED FOR PERMIT 12/16/2024

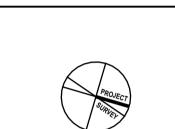No. DESCRIPTION REVISIONS

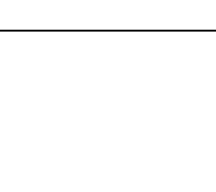

www.aja.design I info@aja.design I 905.920.5121 Hamilton - Wentworth District School Board P02085 Franklin Elementary School Washrooms Renovations

Music Room, Corridors, and Student 500 Franklin Rd., Hamilton, Ontario GENERAL NOTES, SITE

LOCATION, LEGENDS & PHASING RMC As indicated

11/2024 24-21 A0.01



GENERAL DEMOLITION NOTES

ALL DEMOLITION WORK TO BE COORDINATED WITH THE HARZARDOUS MATERIALS ABATEMENT SCOPE OF WORK. REFER TO APPLICABLE DOCUMENTATION INCLUDED WITHIN THE SPECIFICATIONS.

THIS PLAN IS TO BE USED IN CONJUCTION WITH THE ENTIRE SET OF CONSTRUCTION DRAWINGS. REFER TO DRAWINGS A1.00, A1.01 AND A1.02 FOR FULL SCOPE OF DEMOLITION.

DO NOT REMOVE ANY ITEMS WITHOUT VERIFYING AND COORDINATING WITH ALL GENERAL TRADES AS HOW THEY RELATE TO THE OVERALL PROJECT.

FOR THE FULL SCOPE OF DEMOLITION, ALSO REFER TO THE MECHANCIAL, ELECTRICAL AND STRUCTURAL PLANS AND NOTES.


OWNER WILL MARK UP ANY ITEMS THEY WISH TO RETAIN FOR FUTURE USE AND AREA TO BE STORED WITHIN THE EXISTING PREMISES.

PROVIDE TEMPORARY HOARDING AS REQUIRED DURING CONSTRUCTION. REFER TO THE

REPAIR AND MAKE GOOD ALL EXISTING WALLS, FLOORS AND CEILINGS DAMAGED DURING THE DEMOLITION PROCESS AND NOT BEING REPLACED AS PART OF NEW CONSTRUCTION.

GENERAL CONTRACTOR SHALL FULLY ENCLOSED CONSTRUCTION AREA AND AND COORDINATE DEMOLITION AND ALL NEW WORK IN MANNER NOT TO DISTURB DAY TO DAY USE OF THE SURROUNDING AREA.

PHASING LEGEND

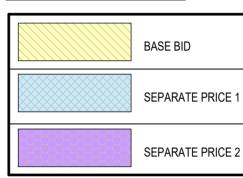

	DEMOLITION NOTES
NUMBER	DESCRIPTION
1	COMPLETELY REMOVE EXISTING SUSPENDED TRANSITE CEILING TILES AND SUPPORTING SYSTEM.
2	COMPLETELY REMOVE EXISTING ACOUSTIC CEILING TILES AND SUPPORTING SYSTEM.
3	COMPLETELY REMOVE EXISTING TERRAZZO FLOORING (± 38mm THICK), RAISED URINAL FLOOR AND TERRAZZO WALL BASE AND PREPARE FOR NEV FINISHES AS SPECIFIED.
4	COMPLETELY REMOVE EXISTING VCT FLOORING AND RUBBER BASE AND PREPARE FOR NEW FINISHES AS SPECIFIED.
5	REMOVE EXISTING MILLWORK C/W PLUMBING FIXTURES & ACCESSORIES, WHERE APPLICABLE.
6	DEMOLISH / REMOVE ALL EXISTING PLUMBING FIXTURES C/W WASHROOM PARTITIONS & ACCESSORIES.
7	COMPLETELY REMOVE EXISTING DOOR & FRAME C/W METAL THRESHOLDS AND FLASHING ABOVE DOORS. STONE SILLS ON EXTERIOR TO REMAIN.
8	DEMOLISH EXISTING MASONRY WALL AND DOOR / FRAME WHERE APPLICABLE.
9	CAREFULLY REMOVE EXISTING MILLWORK & HEATERS BELOW WINDOWS IN IT'S ENTIRETY.
10	REMOVE EXISTING WALL MOUNTED ACOUSTIC PANELS LOCATED ABOVE EXISTING WINDOWS. TAKE CARE NOT TO DAMAGE THE EXISTING MECHANICAL UNIT DURING REMOVAL.
11	CAREFULLY REMOVE ALL EXISTING WALL MOUNTED ACCESSORIES, INCLUDING BUT NOT LIMITED TO, TACKBOARDS, WHITEBOARDS, PULL-UP SCREENS, BLACKBOARDS, PROJECTORS AND ASSOCIATED SCREENS, ETC. REVIEW WITH OWNER ITEMS TO BE REUSED AND DISPOSE ALL OTHER ITEM
12	REMOVE & DISPOSE OF EXISTING DISHWASHER & REFRIGERATOR.
13	REMOVE EXISTING METAL FURRING CHANNELS C/W EXISTING LIGHTING FIXTURES AND PREPARE AREAS TO RECEIVE NEW CEILING.
14	REMOVE EXISTING FLOORING AND PREPARE AREAS TO RECEIVE NEW FLOORING FINISH.
15	REMOVE EXISTING WALL MOUNTED SHELVES. REVIEW WITH OWNER FOR THE STORAGE/ RELOCATION OF CLEANING SUPPLIES & ITEMS TO BE





EXTERIOR DOORS BEING INFILLED

REUSED AND DISPOSE ALL OTHER ITEMS.





EX CORRIDOR 102



ISSUED FOR TENDER 02/06/2025 0 ISSUED FOR PERMIT 12/16/2024 No. DESCRIPTION DATE


REVISIONS


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project title: Hamilton - Wentworth District School Board P02085 Franklin Elementary School Music Room, Corridors, and Student Washrooms Renovations 500 Franklin Rd., Hamilton, Ontario


OVERALL DEMOLITION PLAN

drawn:	scale:	
RMC	As indicated	
	project number:	
11/2024	24-21	
checked:	DRAWING NO:	
SG	A 4 00	4
date:	A1.00	1
11/2024		



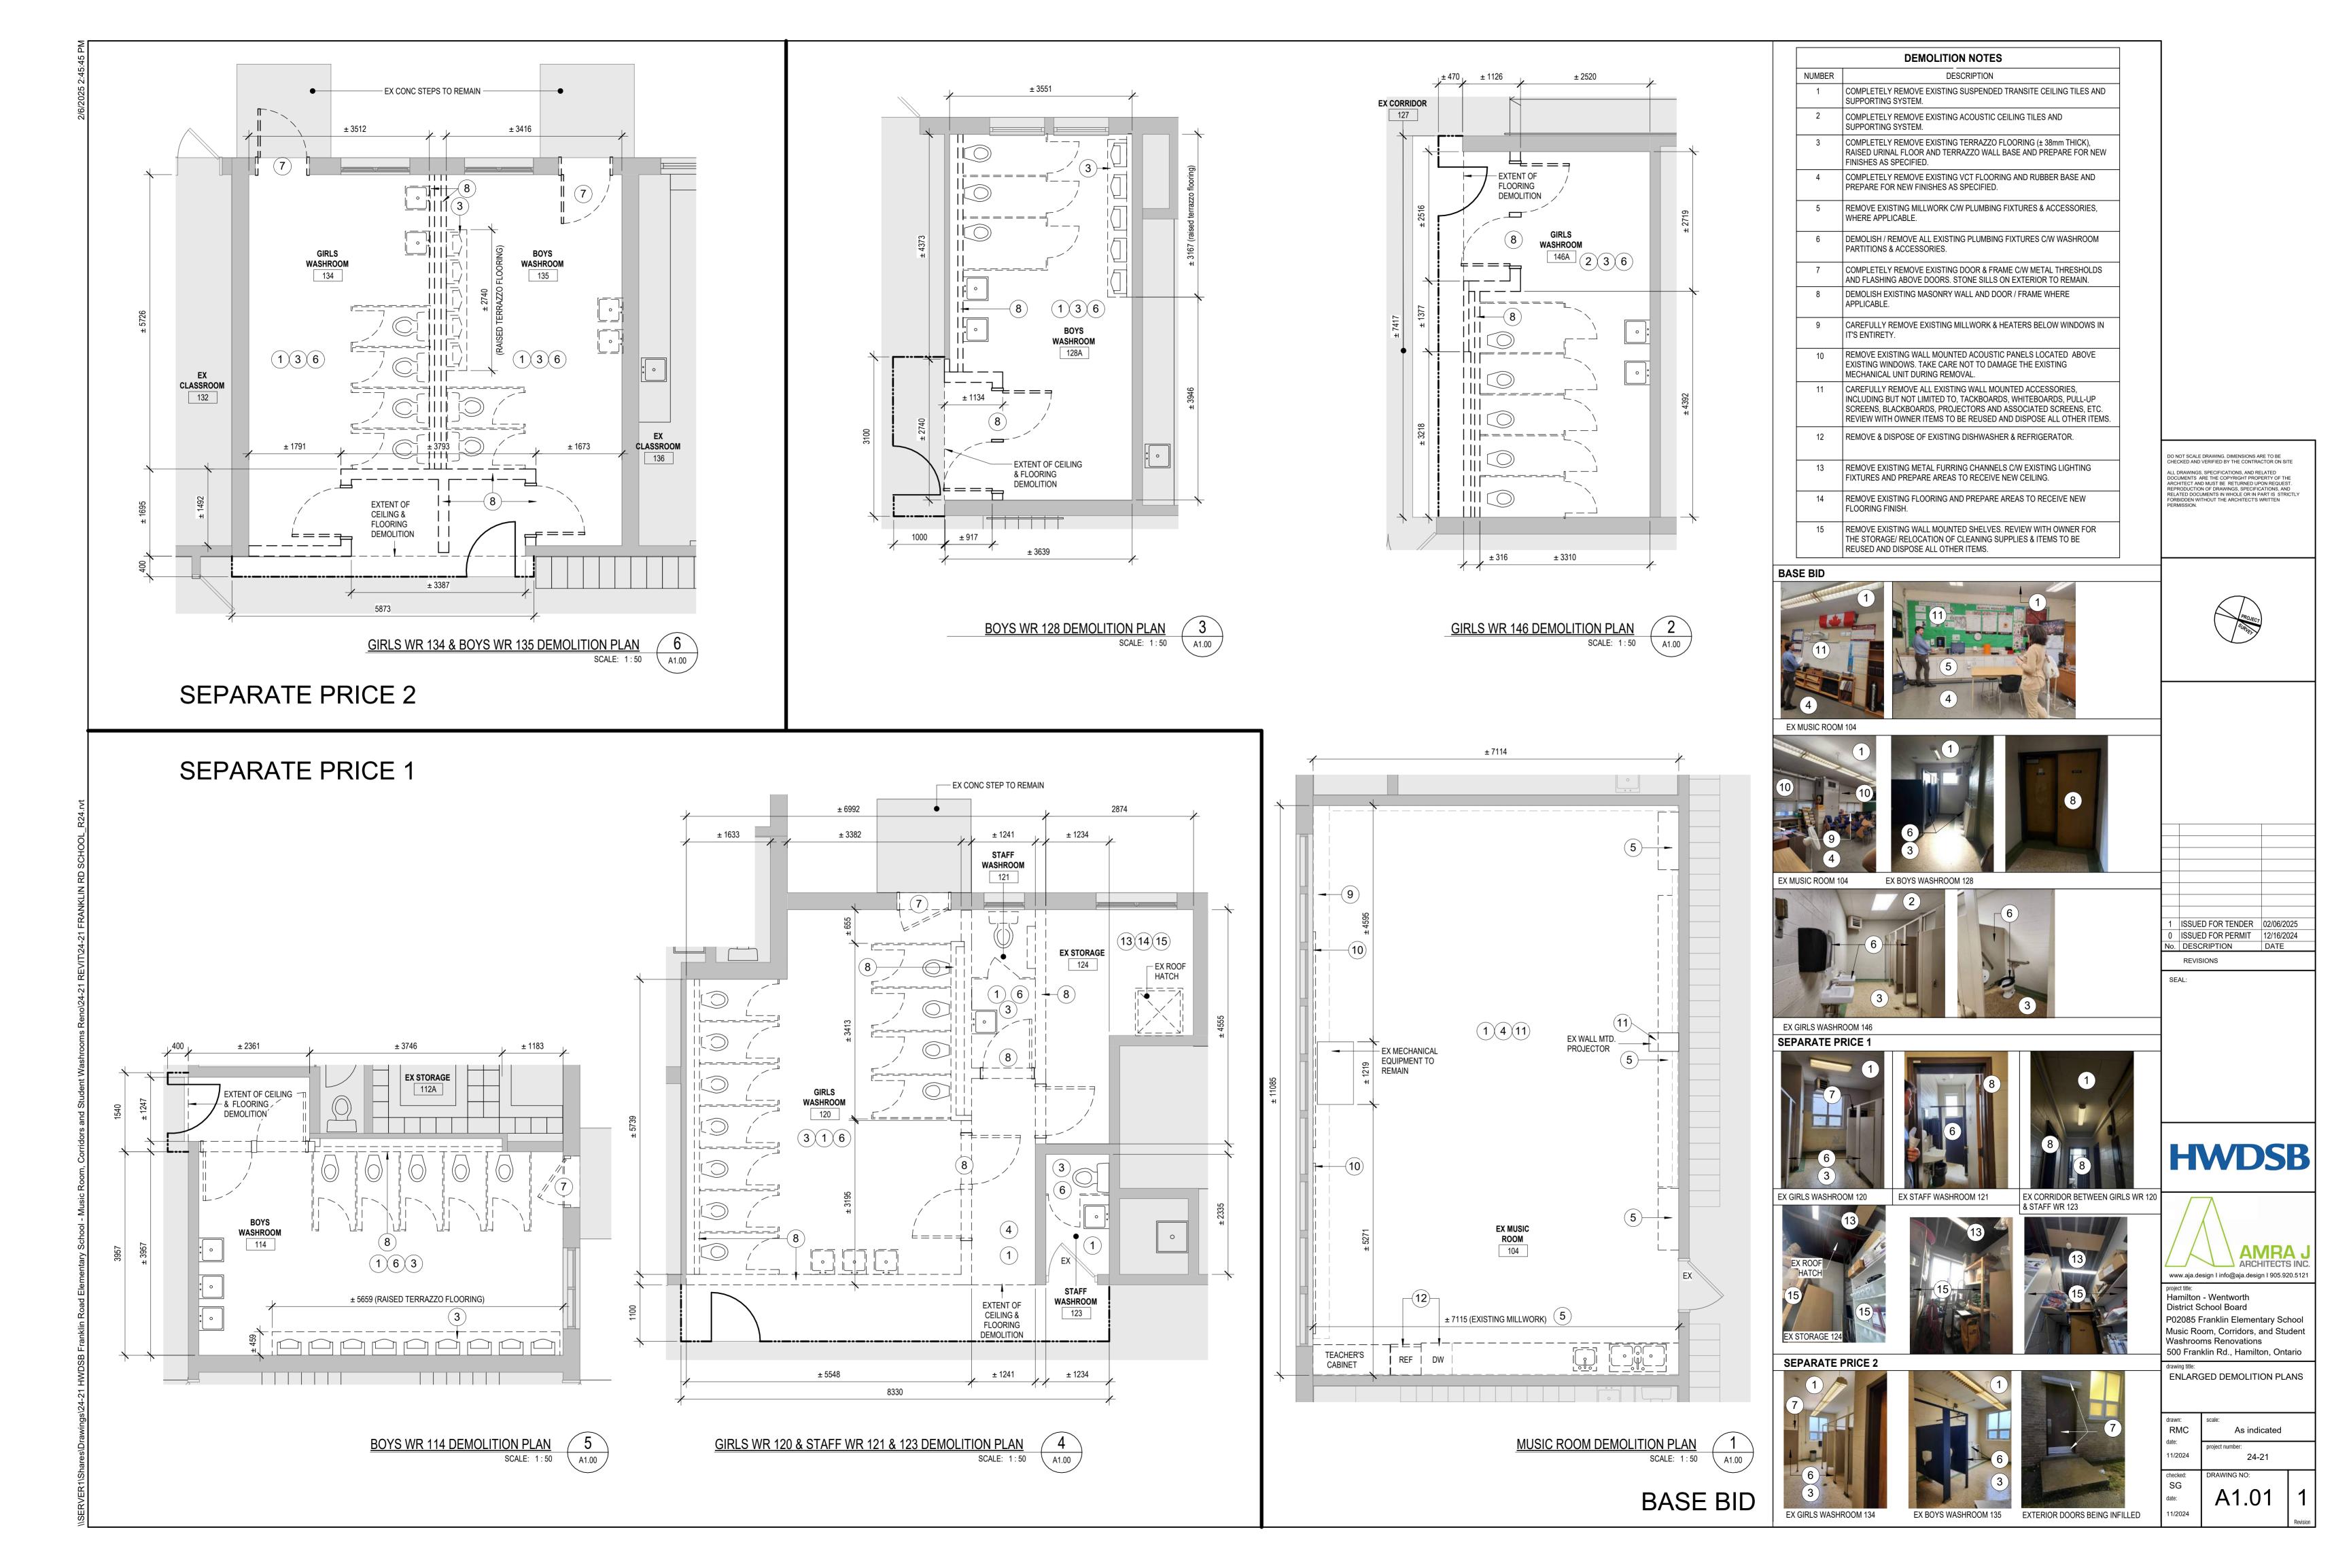

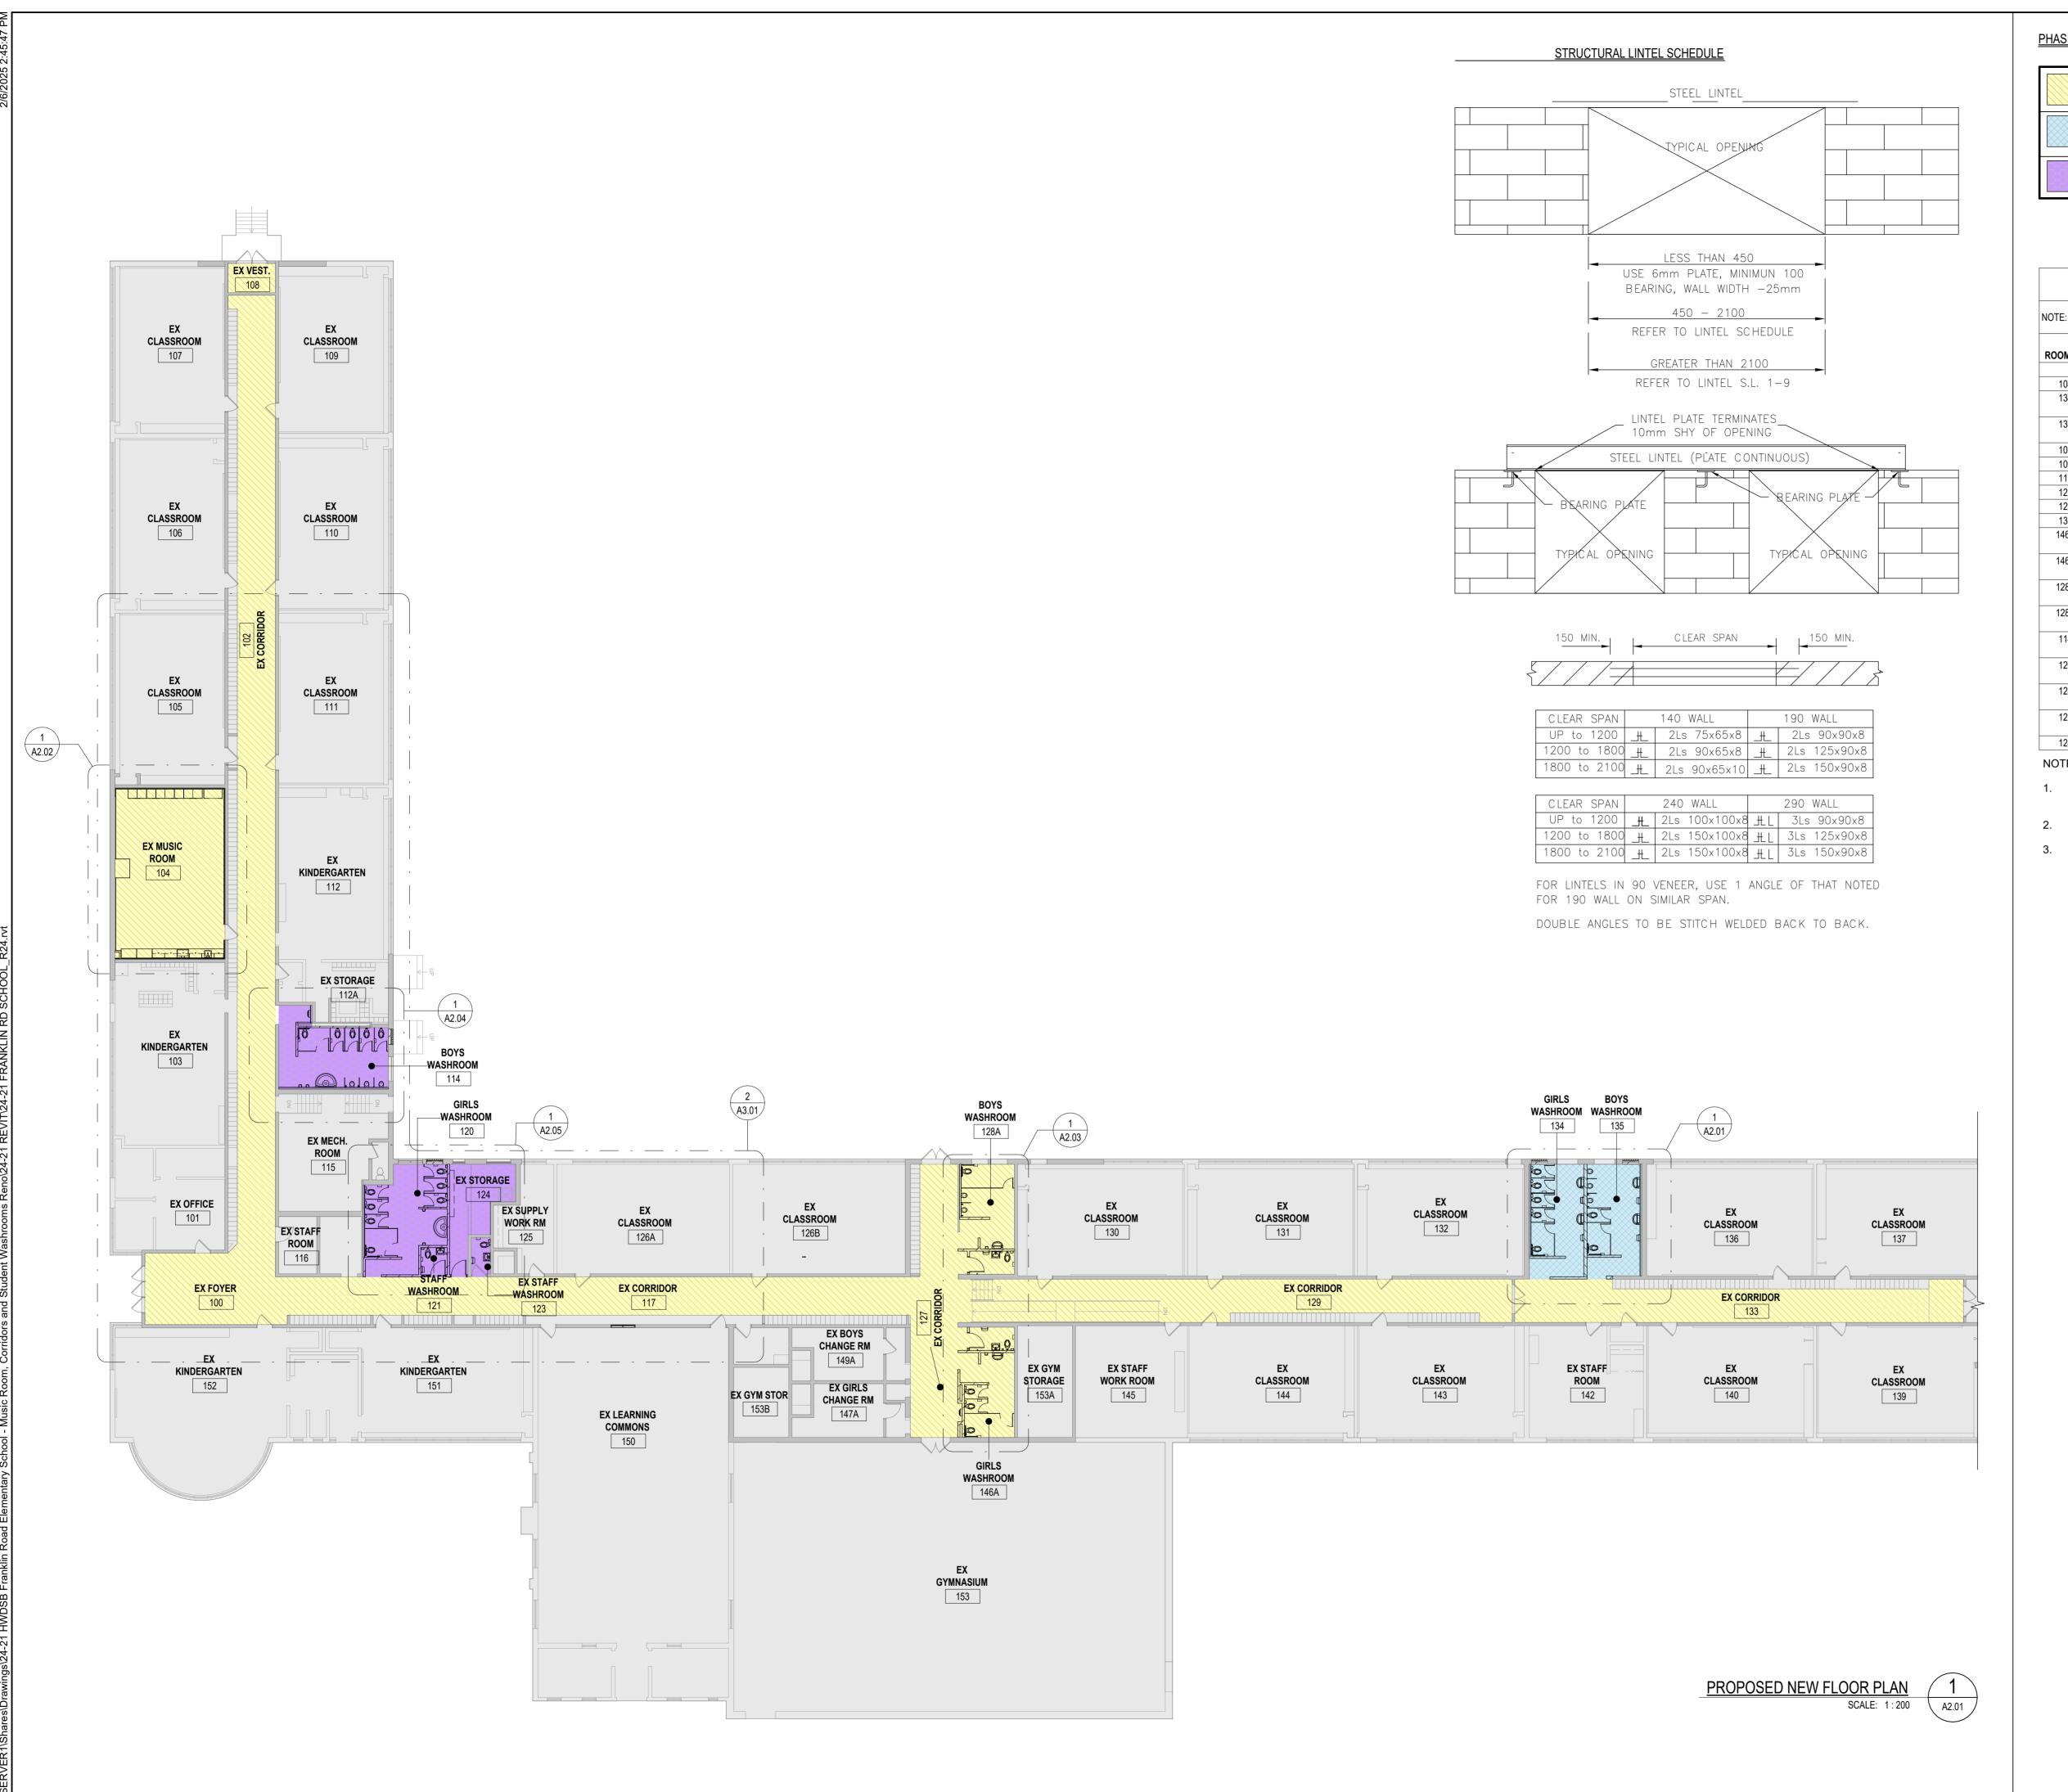PHASING LEGEND

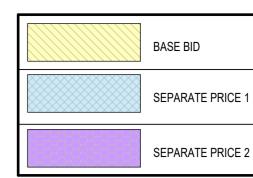

ROOM FINISH SCHEDULE

NOTE: REFER TO MATERIALS SPECIFICATIONS FOR MORE DETAILS OF THE FINISHES.

					CEIL	ING
ROOM NO.	ROOM NAME	FLOOR FINISH	BASE FINISH	WALL FINISH	FINISH	HEIGHT
104	EX MUSIC ROOM	VCT	RB	PT	ACT2	3200
134	GIRLS WASHROOM	PORCELAIN TILES	N/A	CERAMIC TILES/ PT	GB/PT	3000
135	BOYS WASHROOM	PORCELAIN TILES	N/A	CERAMIC TILES/ PT	GB/PT	3000
102	EX CORRIDOR	EX	EX	EX	ACT1	2800
100	EX FOYER	EX	EX	EX	ACT1	2800
117	EX CORRIDOR	EX	EX	EX	ACT1	2800
127	EX CORRIDOR	EX	EX	EX	ACT1	2800
129	EX CORRIDOR	EX	EX	EX	ACT1	2800
133	EX CORRIDOR	EX	EX	EX	ACT1	2800
146A	GIRLS WASHROOM	PORCELAIN TILES	N/A	CERAMIC TILES/ PT	GB/PT	3000
146B	STAFF WASHROOM	PORCELAIN TILES	N/A	CERAMIC TILES/ PT	GB/PT	3000
128B	STAFF WASHROOM	PORCELAIN TILES	N/A	CERAMIC TILES/ PT	GB/PT	3000
128A	BOYS WASHROOM	PORCELAIN TILES	N/A	CERAMIC TILES/ PT	GB/PT	3000
114	BOYS WASHROOM	PORCELAIN TILES	N/A	CERAMIC TILES/ PT	GB/PT	3000
120	GIRLS WASHROOM	PORCELAIN TILES	N/A	CERAMIC TILES/ PT	GB/PT	3000
123	EX STAFF WASHROOM	PORCELAIN TILES	N/A	CERAMIC TILES/ PT	GB/PT	2800
121	STAFF WASHROOM	PORCELAIN TILES	N/A	CERAMIC TILES/ PT	GB/PT	2800
124	EX STORAGE	VCT	RB	PT	ACT1	3000

- AT WALLS RECEIVING A CERAMIC TILE FINISH, THE TILES EXTEND ALL THE WAY TO THE FLOOR FINISH. REFER TO WASHROOM TILE LAYOUT ELEVATIONS.
- REFER TO WASHROOM TILE LAYOUT ELEVATIONS FOR VERTICAL HEIGHT OF CERAMIC TILE FINISH.
- REVIEW WASHROOM PLANS AND TILE LAYOUT ELEVATIONS TOGETHER
- TO UNDERSTAND EXTENT OF WALL FINISHES.

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ISSUED FOR TENDER 02/06/2025 0 ISSUED FOR PERMIT 12/16/2024 No. DESCRIPTION

REVISIONS

HWDSB





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PROPOSED OVERALL FLOORPLAN & ROOM FINISH SCHEDULE


drawn:	scale:	
RMC	As indicated	
date:	project number:	
11/2024	24-21	
checked:	DRAWING NO:	
SG	4000	4

11/2024



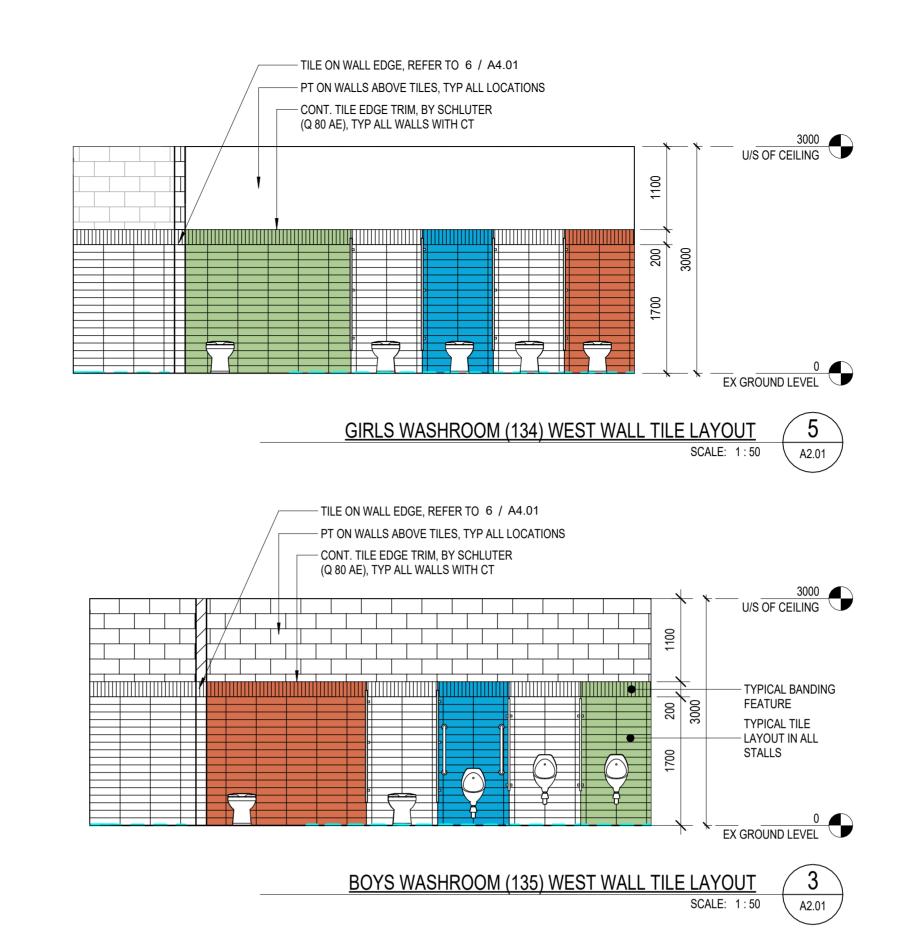

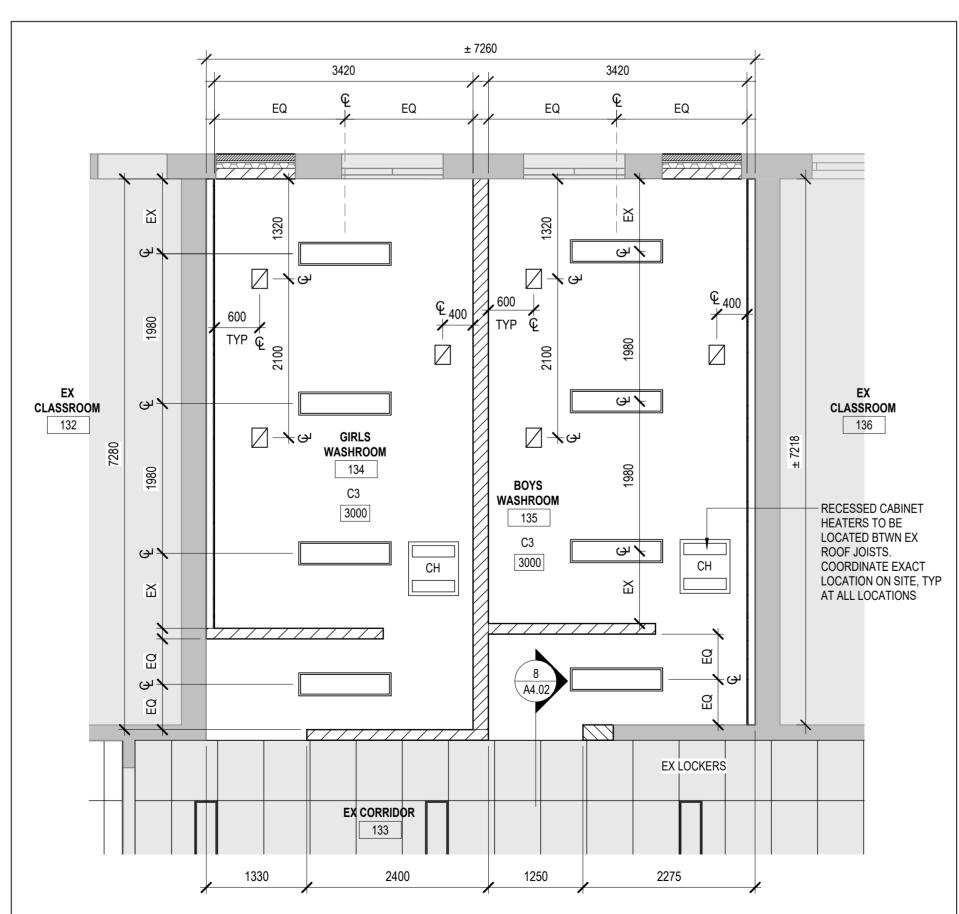BOYS (134) & GIRLS (135) WASHROOMS REFLECTED CEILING

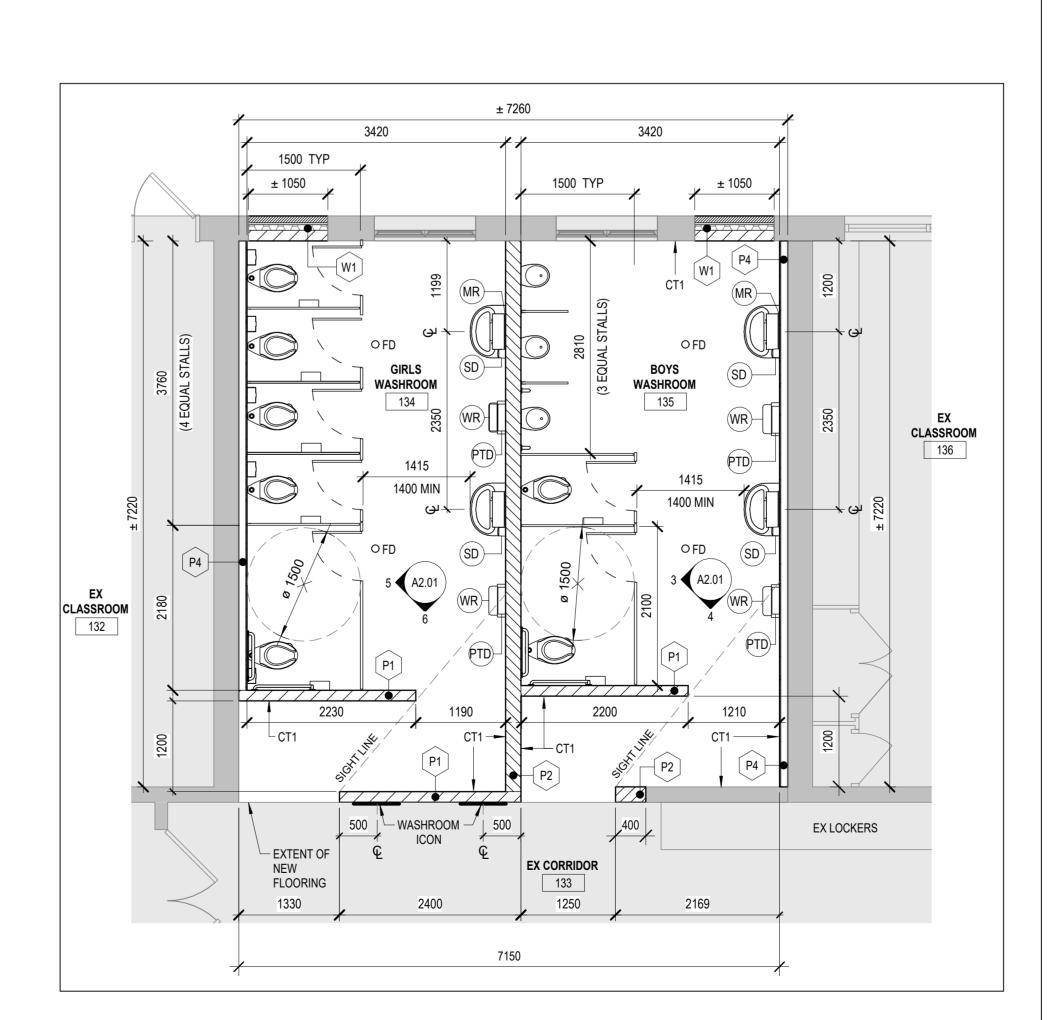

BOYS (134) & GIRLS (135) WASHROOMS FLOOR PLAN SCALE: 1:50



WASHROOM GENERAL NOTES

REFER TO TYPICAL WASHROOM STALL PLANS AND WASHROOM FIXTURES TYPICAL MOUNTING HEIGHTS IN DRAWING A4.01 FOR DIMENSIONS & DETAILED INFORMATION

REFER TO WASHROOM PLANS FOR GRAB BARS & ACCESSORY LOCATIONS (TYP. IN ALL WASHROOM STALLS U.N.O.)

REFER TO SPECIFICATION BOOK FOR THE WASHROOM ACCESSORIES AND FINISHES.

SEE MECHANICAL AND ELECTRICAL DRAWINGS AND COORDINATE ANY DISCREPANCIES BEFORE CONSTRUCTION

REFLECTED CEILING PLAN LEGEND

	ID MECHANICAL DRAWINGS FOR TURE INFORMATION.
	610 X 1220 RECESSED TROFFER LIGHT FIXTURE
	305 X 1220 RECESSED TROFFER LIGHT FIXTURE
	NEW 610 X 1220 ACOUSTIC CEILING TILES IN SUSPENDED PREFINISHED METAL GRID
	RETURN / EXHAUST GRILLE, SIZES VARY (REFER TO MECH DWGS)
CH	CEILING RECESSED CABINET UNIT HEATERS (REFER TO MECH DWGS)


1. LIGHT FIXTURES TO BE CENTRED WITHIN ROOMS UNLESS DIMENSIONED OTHERWISE, TYPICAL

2. DIMENSIONS ARE TAKEN TO THE CENTRE OF LIGHT FIXTURES, TYPICAL

WASHROOM FLOOR PLAN ABBREVIATIONS

CH	COAT HOOK
CT#	CERAMIC TILE (NUMBER SUFFIX DENOTES COLOUR OF TILE, REFER TO LEGEND)
HD	HAND DRYER (SEE ELECTRICAL DWGS)
PTD	PAPER TOWEL DISPENSER
SD	SOAP DISPENSER
TPD	TOILET PAPER DISPENSER
GB1	VERTICAL GRAB BAR
GB2	HORIZONTAL GRAB BAR
GB3	L - SHAPED GRAB BAR
ND	NAPKIN DISPOSAL
MR	MIRROR
WR	WASTE RECEPTACLE
PS	PRIVACY SCREEN
SH	SHELF
WB	WATER BOTTLE FILLER
ADO	AUTOMATIC DOOR OPERATOR
FD	FLOOR DRAIN (REFER TO MECH)

TILE COLOR LEGEND

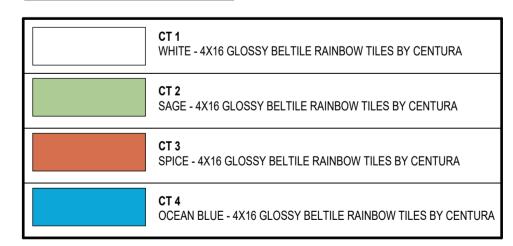

1. COLOUR OF CT NOTED ON PLANS WHERE INTERIOR ELEVATIONS ARE NOT PROVIDED 2. BANDING TILE FEATURE: 2X8 GLOSSY BELTILE RAINBOW TILES BY CENTURA. COLOUR TO MATCH TILES BELOW BANDING, TYP

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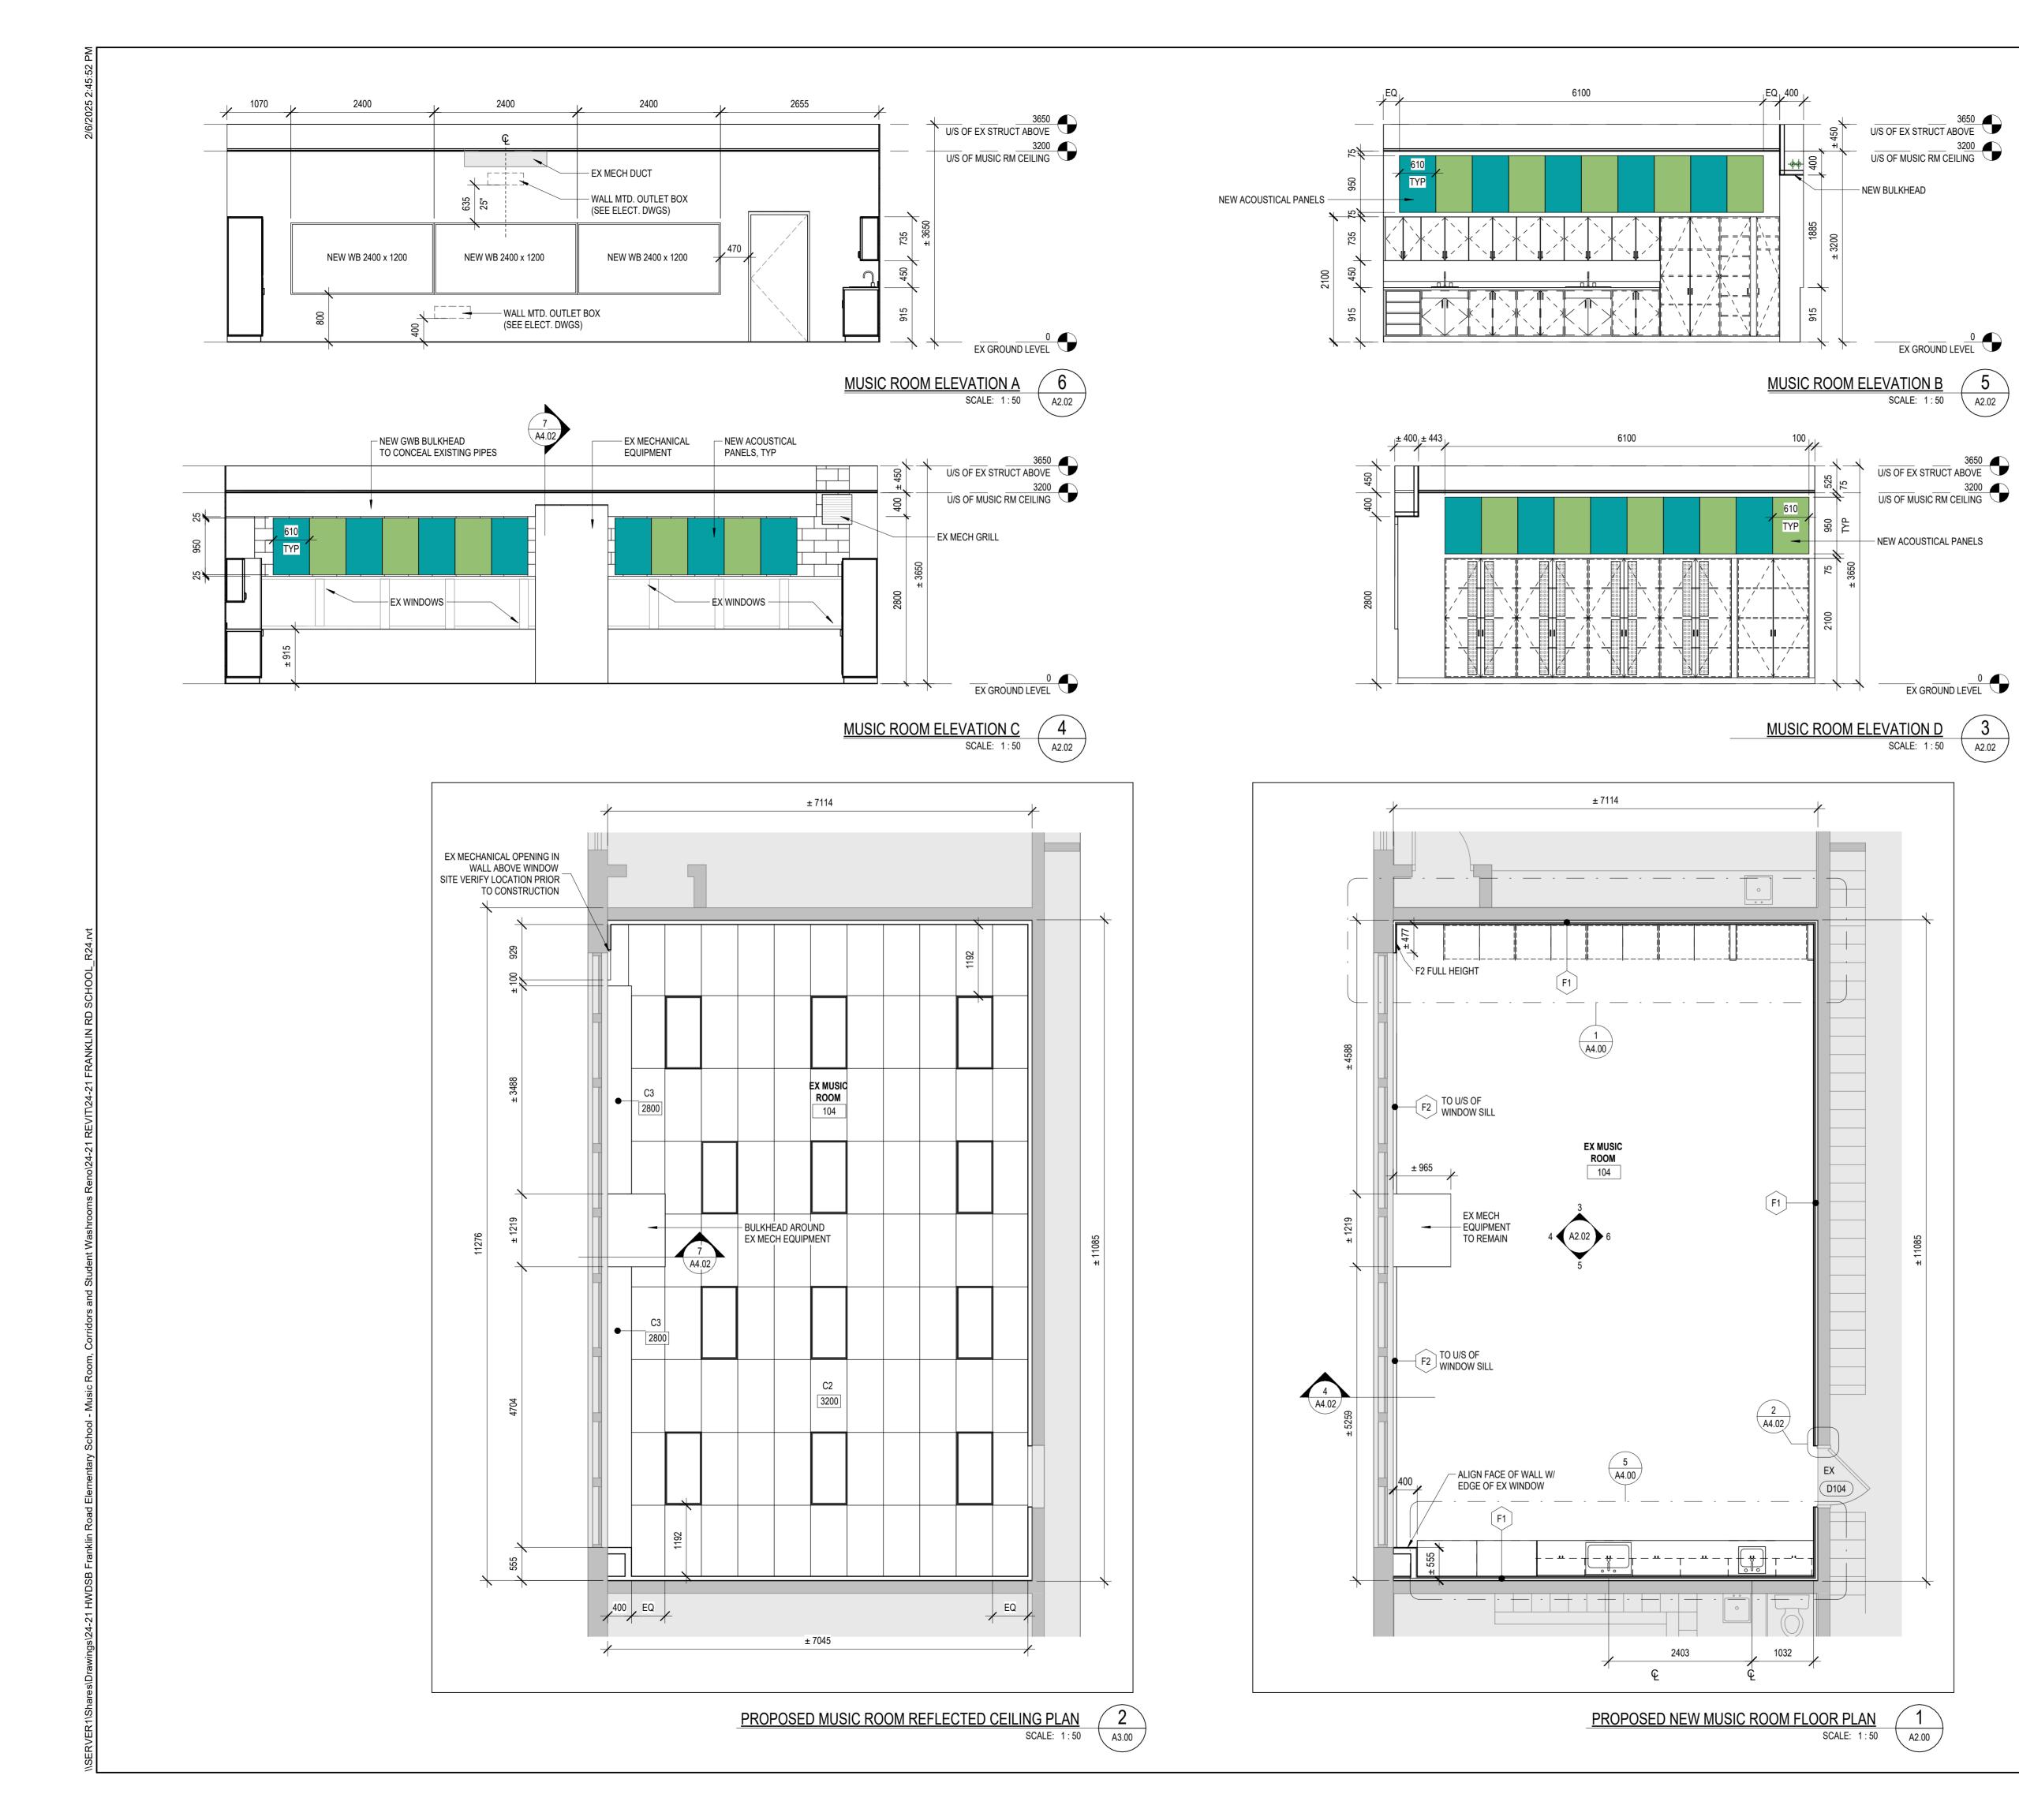



Hamilton - Wentworth District School Board P02085 Franklin Elementary School Music Room, Corridors, and Student Washrooms Renovations


WASHROOM FLOOR PLAN DETAILS, REFLECTED CEILING PLANS & INTERIOR ELEVATIONS

500 Franklin Rd., Hamilton, Ontario

RMC As indicated 10/2024



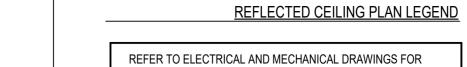

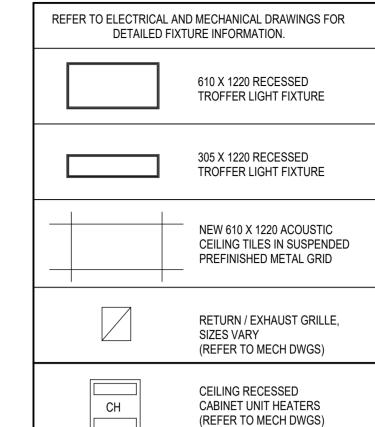

- 1. LIGHT FIXTURES TO BE CENTRED WITHIN ROOMS UNLESS DIMENSIONED OTHERWISE, TYPICAL
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 12/16/2024

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 DATE

REVISIONS

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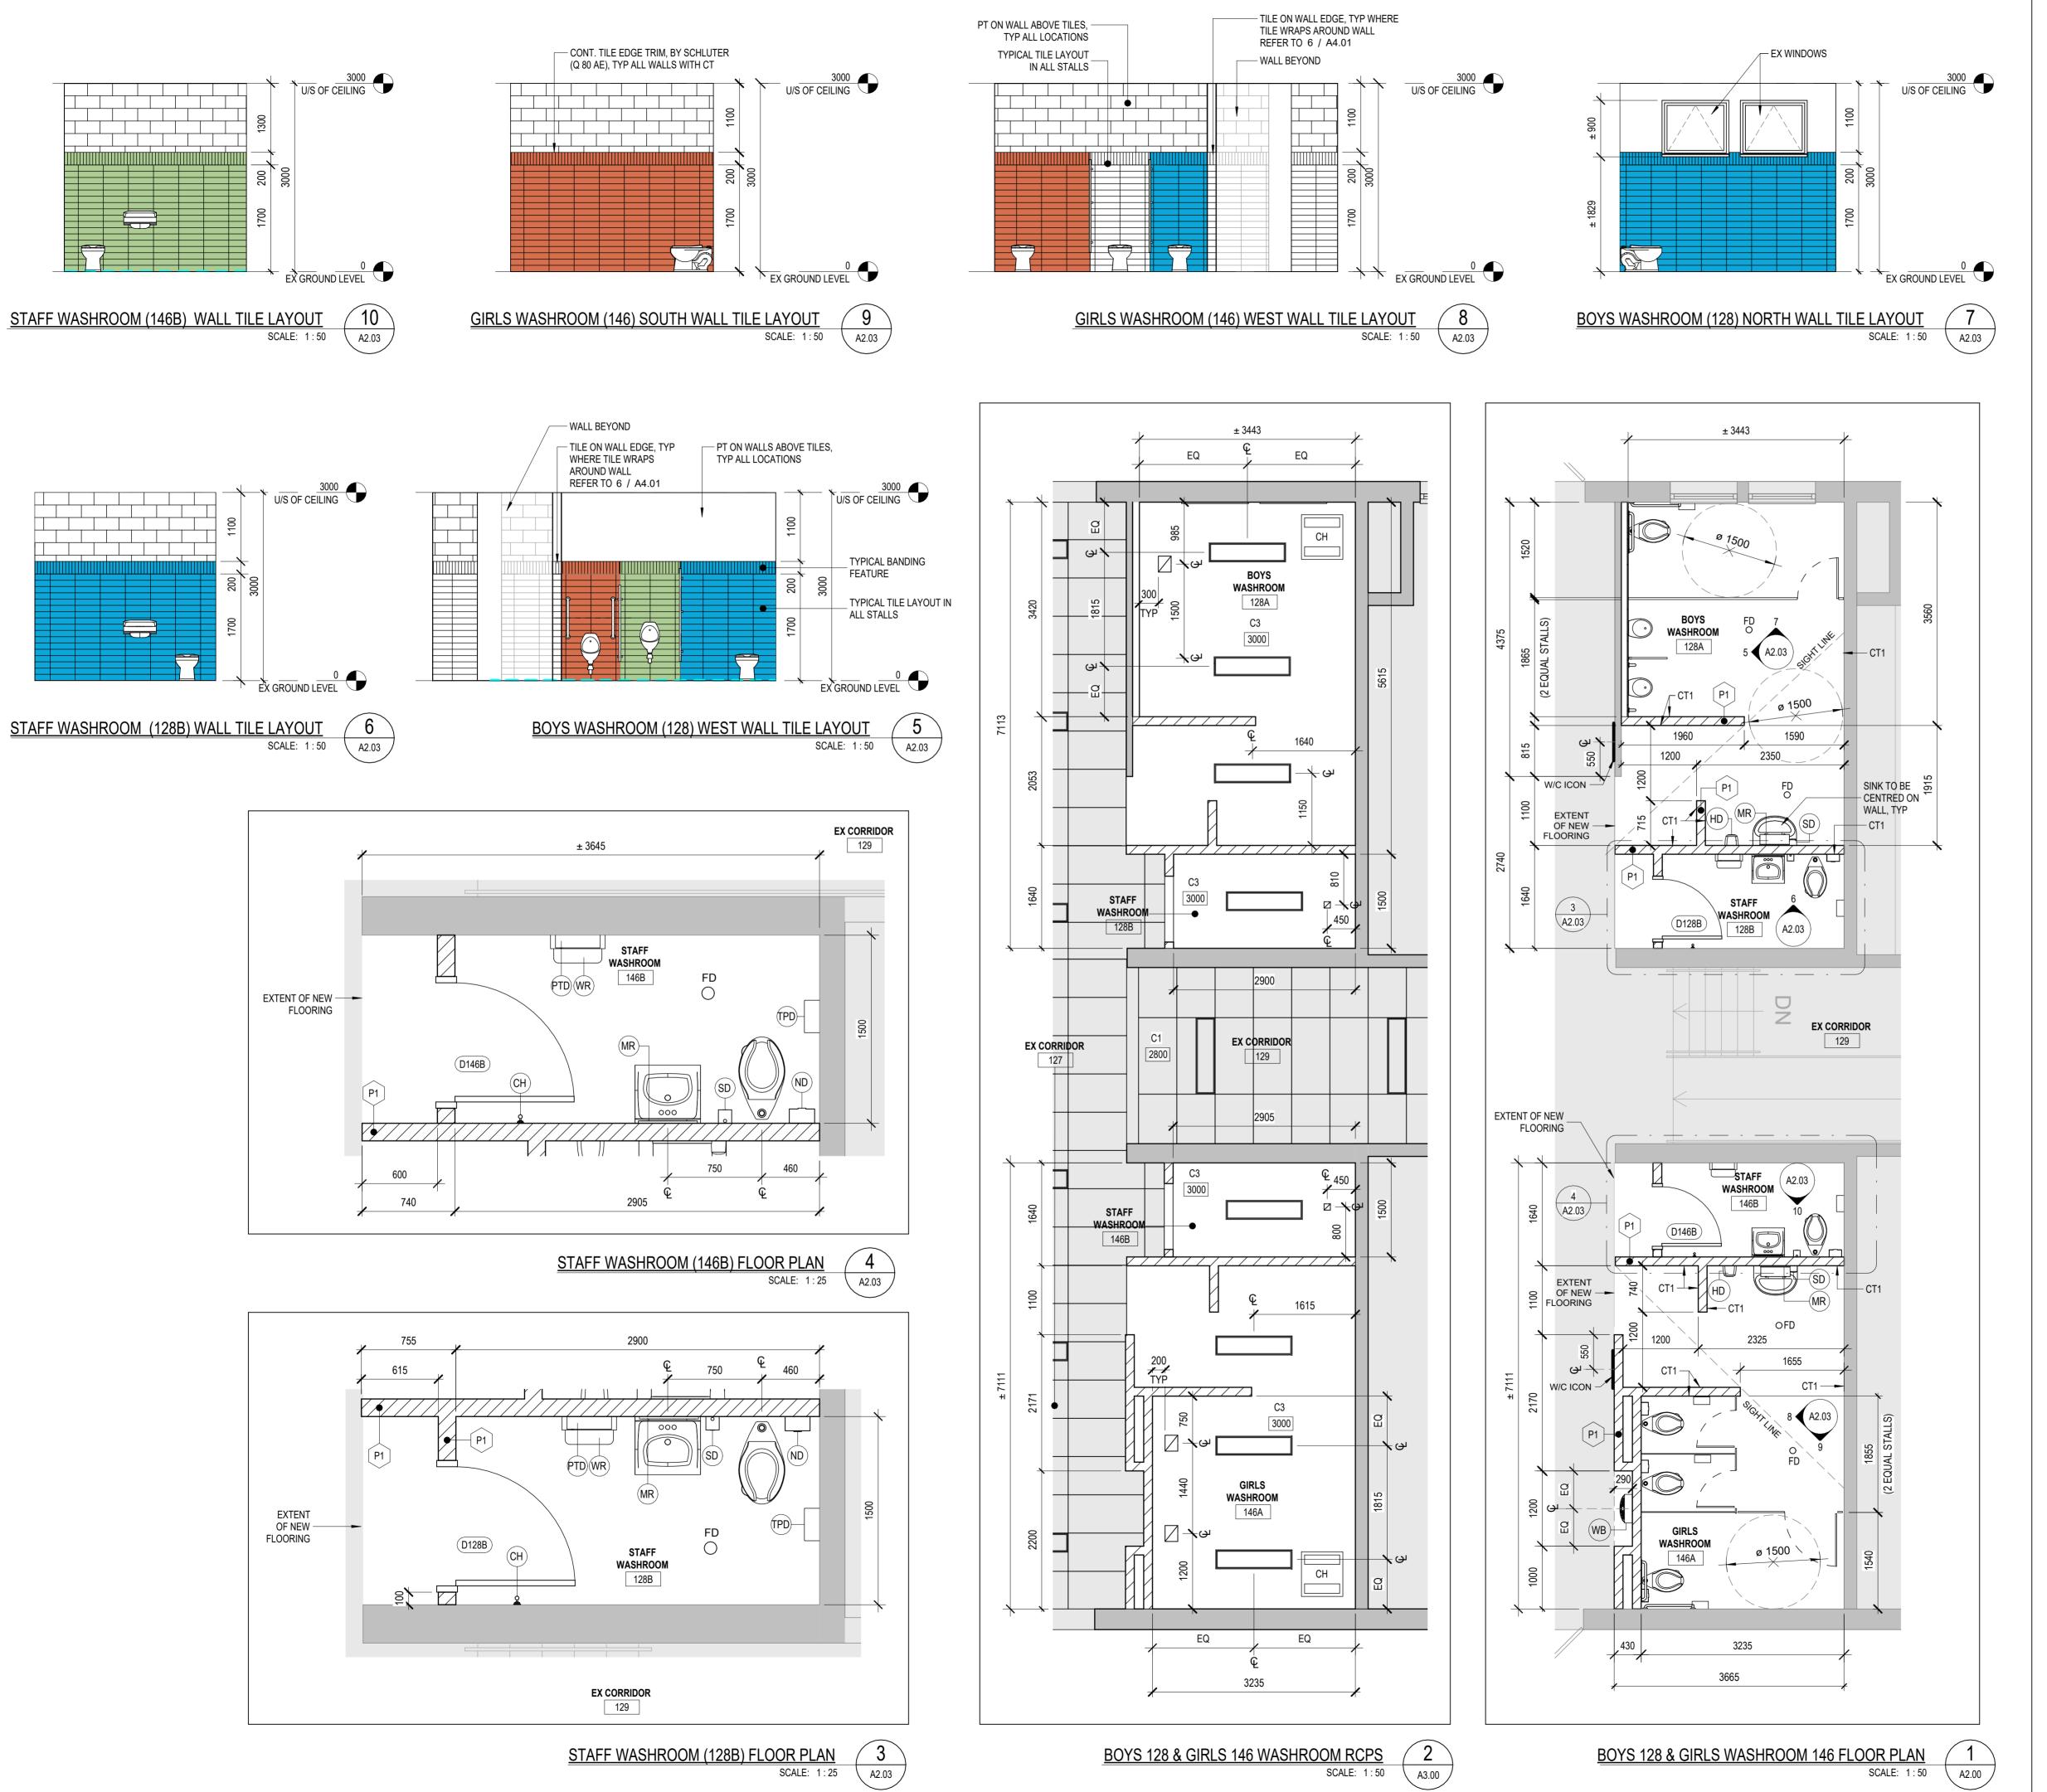


project title: Hamilton - Wentworth District School Board P02085 Franklin Elementary School Music Room, Corridors, and Student Washrooms Renovations

500 Franklin Rd., Hamilton, Ontario MUSIC ROOM PLANS AND INTERIOR ELEVATIONS

drawn: RMC 1:50 11/2024 24-21 A2.02 | 1

checked:



WASHROOM GENERAL NOTES


REFER TO TYPICAL WASHROOM STALL PLANS AND WASHROOM FIXTURES TYPICAL MOUNTING HEIGHTS IN DRAWING A4.01 FOR DIMENSIONS & DETAILED INFORMATION

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SEE MECHANICAL AND ELECTRICAL DRAWINGS AND COORDINATE ANY DISCREPANCIES BEFORE CONSTRUCTION

REFLECTED CEILING PLAN LEGEND




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WR	WASTE RECEPTACLE
PS	PRIVACY SCREEN
SH	SHELF
WB	WATER BOTTLE FILLER
ADO	AUTOMATIC DOOR OPERATOR
FD	FLOOR DRAIN (REFER TO MECH)

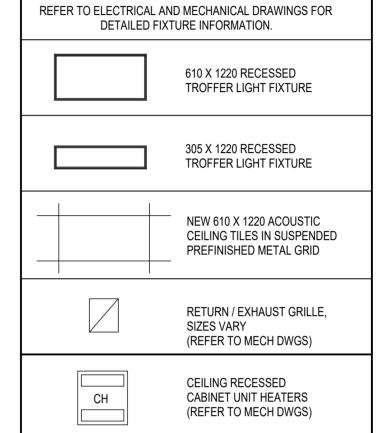TILE COLOR LEGEND




NOTE:

1. COLOUR OF CT NOTED ON PLANS WHERE INTERIOR ELEVATIONS ARE NOT PROVIDED

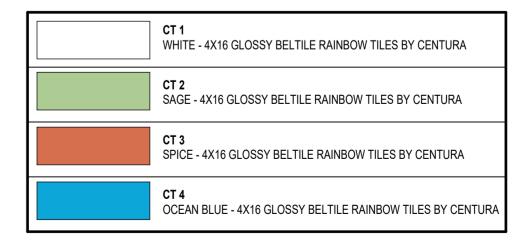2. BANDING TILE FEATURE: 2X8 GLOSSY BELTILE RAINBOW TILES BY CENTURA.

COLOUR TO MATCH TILES BELOW BANDING, TYP

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1 ISSUED FOR TENDER 02/06/2025
0 ISSUED FOR PERMIT 12/16/2024
No. DESCRIPTION DATE

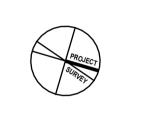REVISIONS
SEAL:

HWDSB



project title:
Hamilton - Wentworth
District School Board
P02085 Franklin Elementary School
Music Room, Corridors, and Student
Washrooms Renovations
500 Franklin Rd., Hamilton, Ontario

drawing title:
WASHROOM FLOOR PLAN
DETAILS, REFLECTED CEILING
PLANS & INTERIOR ELEVATIONS

 drawn:
 scale:

 RMC
 As indicated


 date:
 project number:

 10/2024
 24-21

 checked:
 DRAWING NO:


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 A2 03


 date:
 A2 03

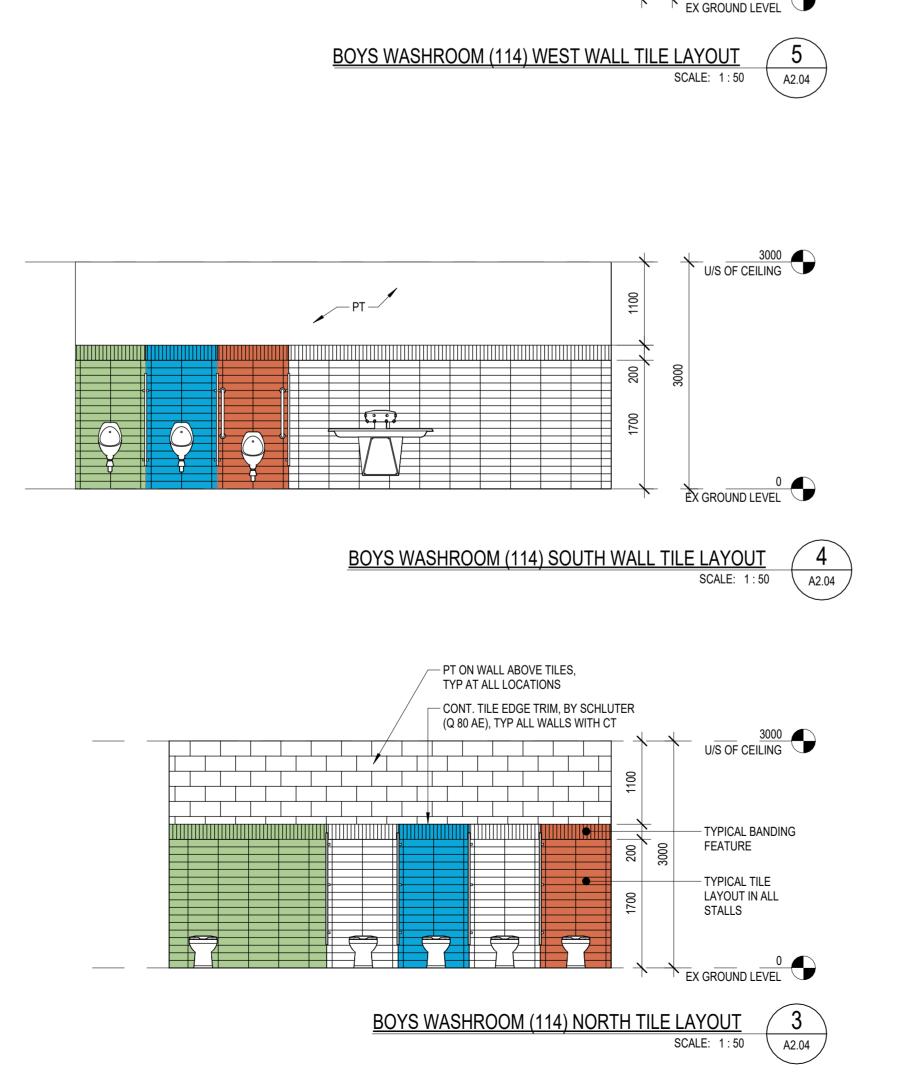

WALL BEYOND —

TILE TO WRAP AROUND -EDGE OF WALL U/S OF CEILING

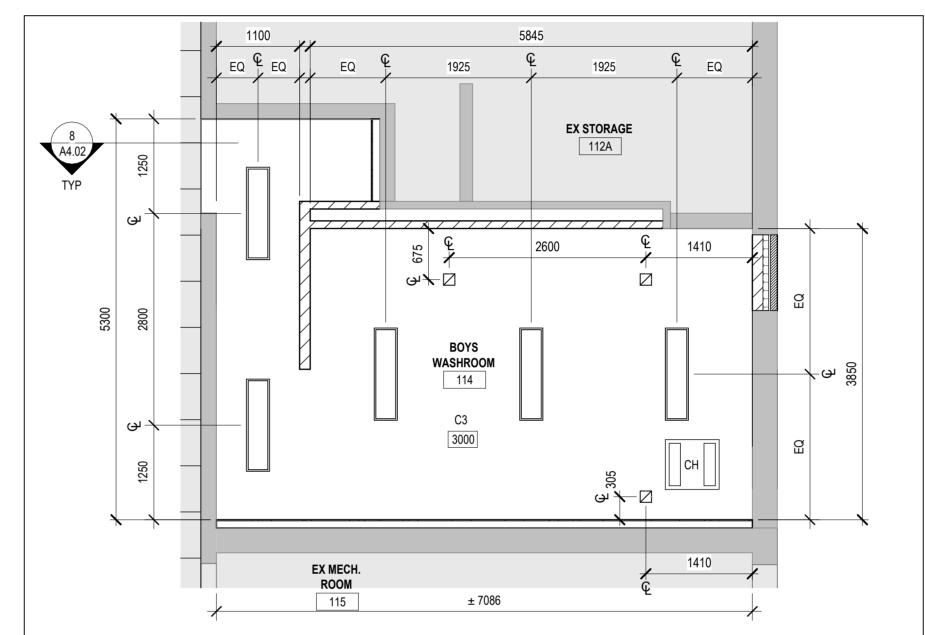

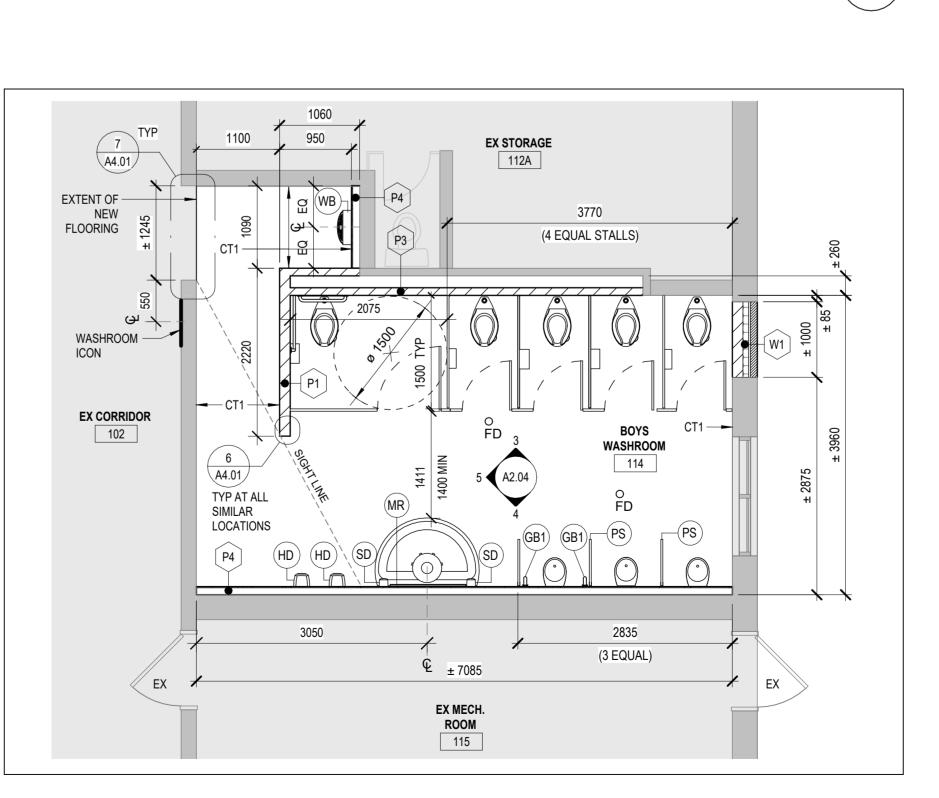

ENLARGED BOYS WASHROOM REFLECTED CEILING PLAN

ENLARGED BOYS WASHROOM 114 FLOOR PLAN

SCALE: 1:50

A2.00

WASHROOM GENERAL NOTES


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REFLECTED CEILING PLAN LEGEND




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WASHROOM FLOOR PLAN ABBREVIATIONS

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TILE COLOR LEGEND

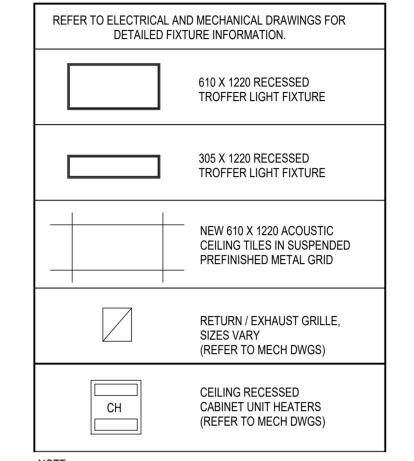

NOTE:

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REVISIONS
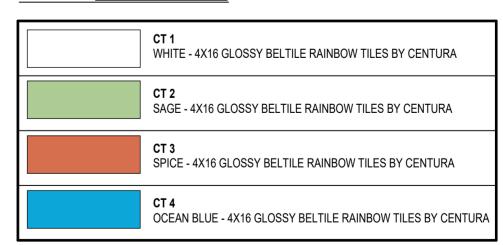
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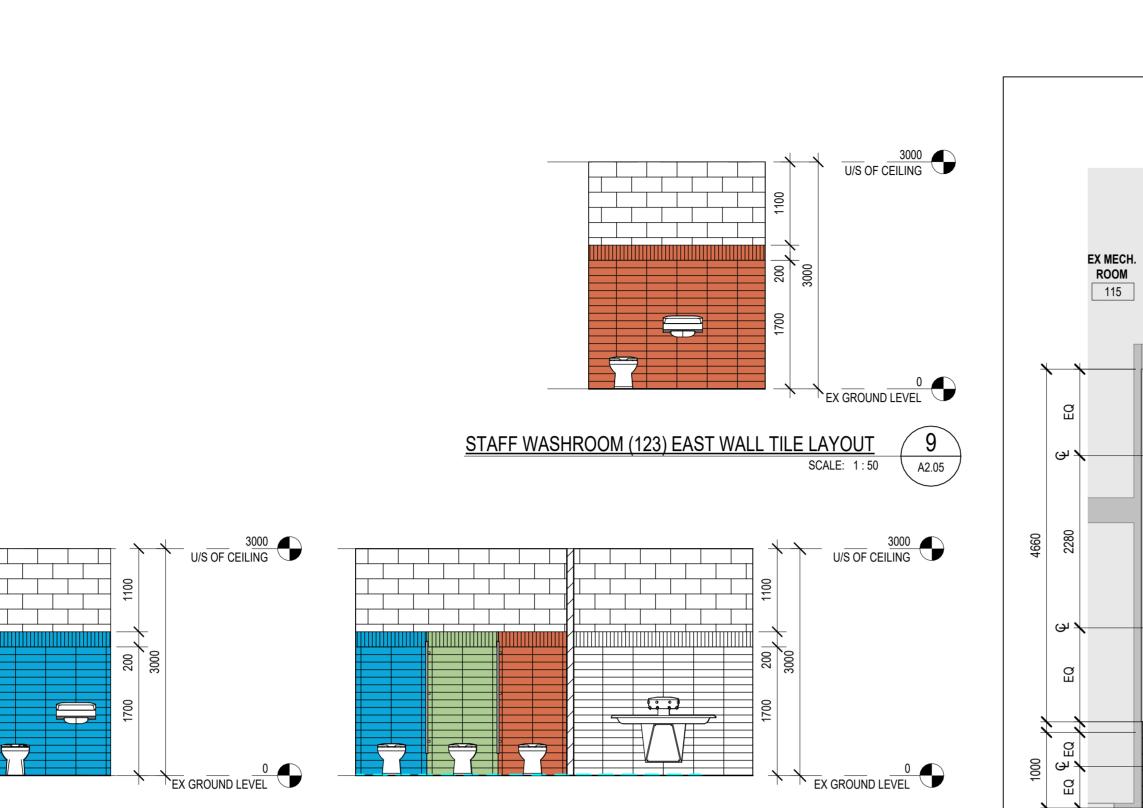
project title:
Hamilton - Wentworth
District School Board
P02085 Franklin Elementary School
Music Room, Corridors, and Student
Washrooms Renovations
500 Franklin Rd., Hamilton, Ontario

drawing title:

BOYS WASHROOM FLOOR PLAN
DETAILS, REFLECTED CEILING
PLAN & INTERIOR ELEVATIONS

drawn: RMC	scale: As indicated	
date: 11/2024	project number: 24-21	
checked: SG date:	DRAWING NO:	1


11/2024







GIRLS WASHROOM (120) WEST WALL TILE LAYOUT

SCALE: 1:50 \ A2.05

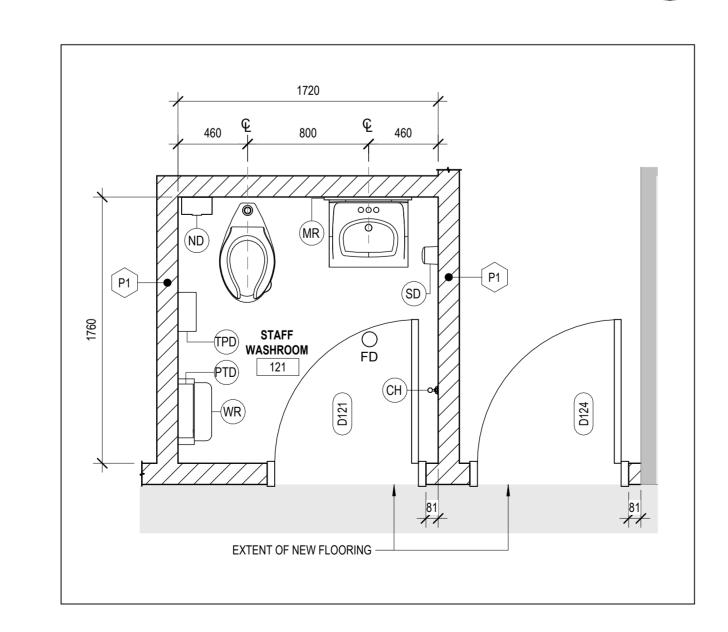

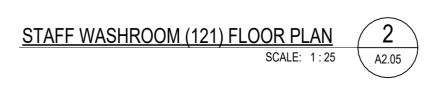

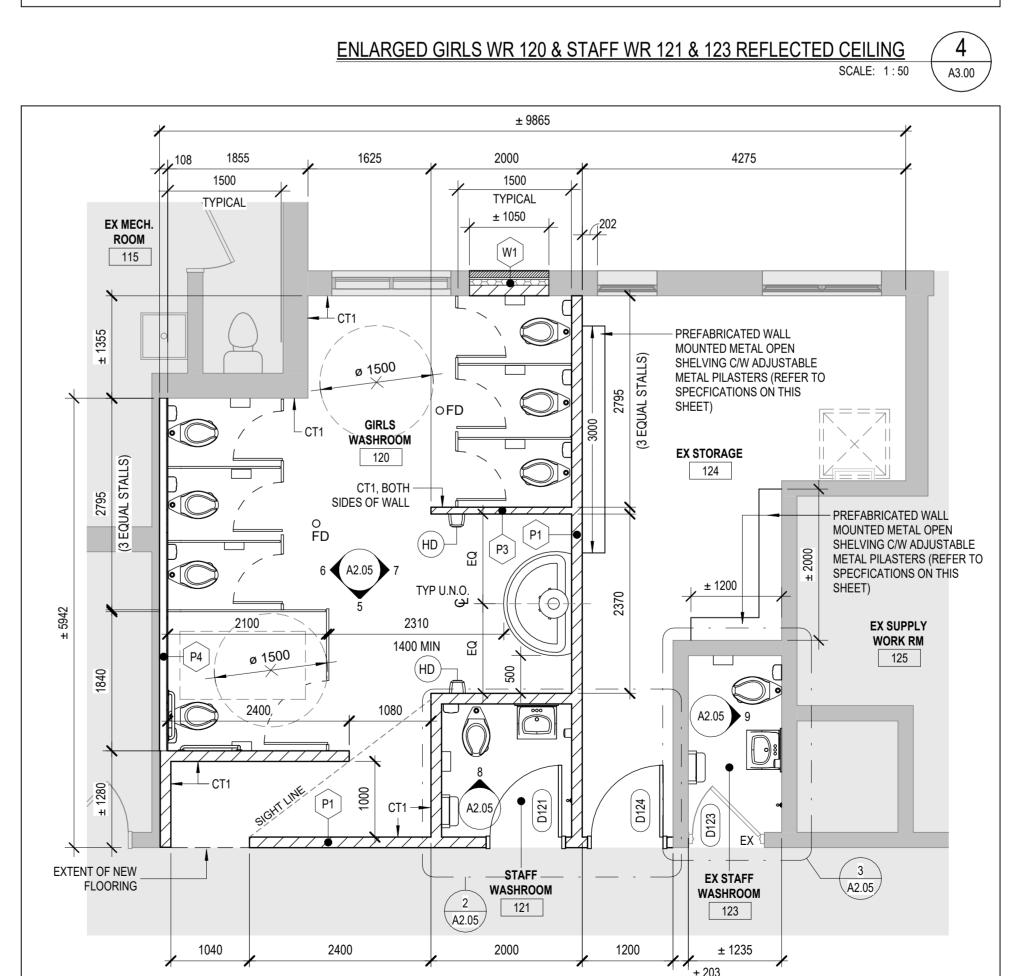

GIRLS WASHROOM 120 & STAFF WR 121 & 123 FLOOR PLAN SCALE: 1:50 \ A2.00

WASHROOM GENERAL NOTES

4275

EX STORAGE

3200

1640

EX ROOF

— EXISTING EXHAUST FAN

(REFER TO MECH)

_WASHROOM

123

EQ

EQ

CH

GIRLS WASHROOM

2750

2400

1450

3000

STAFF WASHROOM

121

3200


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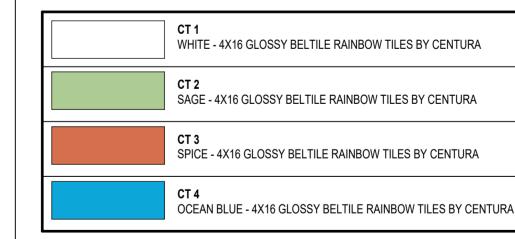
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ADO	AUTOMATIC DOOR OPERATOR
FD	FLOOR DRAIN (REFER TO MECH)

TILE COLOR LEGEND



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WALL MOUNTED SHELVING SPECIFICATIONS (OR APPROVED EQUAL)

SHELVING PILASTERS: TO BE PREFABRICATED FROM MIN. 16 GA. STEEL, 32mm DEEP WITH MOUNTING HOLES AT 330mm O.C., LENGTH TO BE 2134mm. PILASTERS TO BE SPACED AT 1200mm O.C.

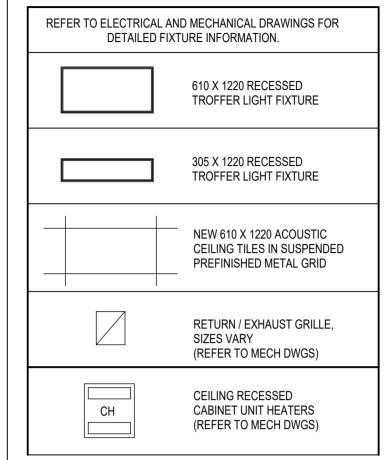SHELVES: OPEN WIRE SHELVES 32mm THICK x 460mm DEEP STARTING 1100mm AFF, CHROME-PLATED CARBON STEEL. 250LBS CAPACITY ALLOW FOR 4 SHELVES SPACED AT 450mm VERTICALLY. REFER TO 'EX STORAGE 124' PLAN FOR LENGTH OF SHELVING AT EACH LOCATION.

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HWDSB



Hamilton - Wentworth District School Board P02085 Franklin Elementary School Music Room, Corridors, and Student Washrooms Renovations 500 Franklin Rd., Hamilton, Ontario

WASHROOM FLOOR PLAN DETAILS, REFLECTED CEILING PLANS & INTERIOR ELEVATIONS

checked: SG date:	A2.05	1
date: 11/2024	project number: 24-21	
drawn: RMC	As indicated	

STAFF WASHROOM (121) NORTH WALL TILE LAYOUT

GIRLS WASHROOM (120) EAST WALL TILE LAYOUT

WASHROOM

123

± 1235

— EXTENT OF NEW FLOORING

SCALE: 1:25

STAFF WASHROOM (123) FLOOR PLAN

SCALE: 1:50

U/S OF CEILING

TYPICAL BANDING **FEATURE**

- TYPICAL TILE


STALLS


LAYOUT IN ALL

EX GROUND LEVEL

A2.05

11/2024

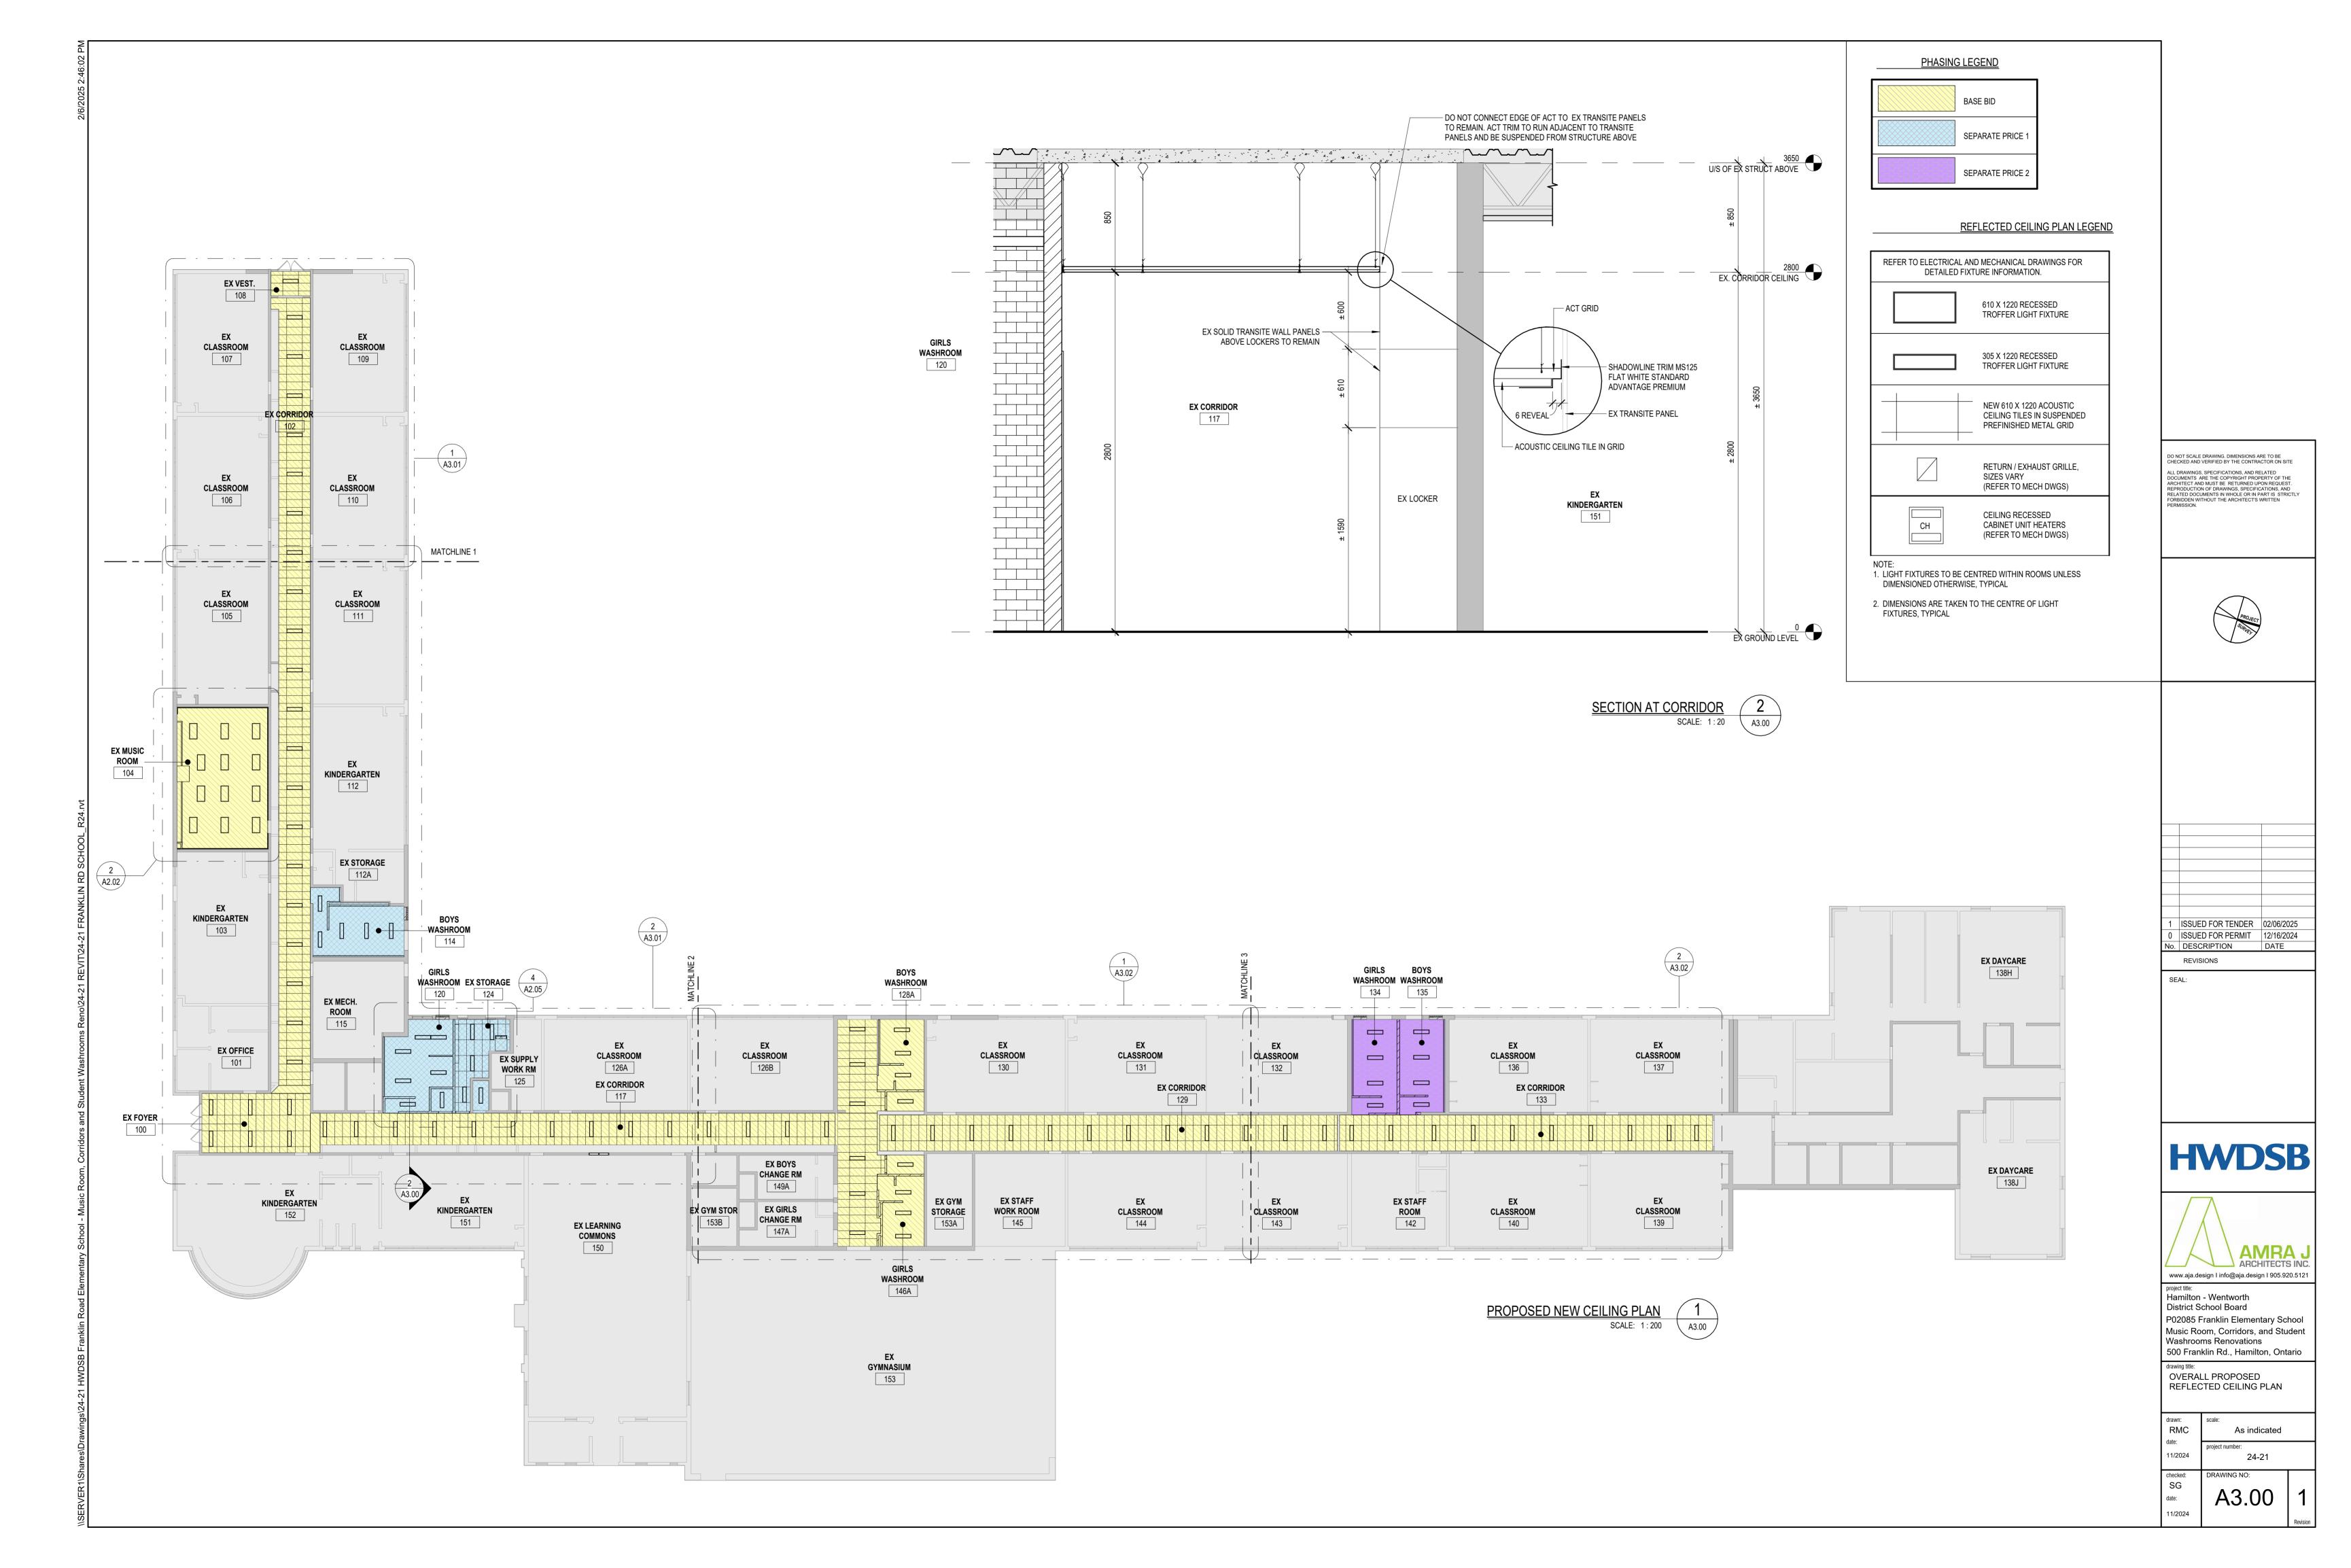

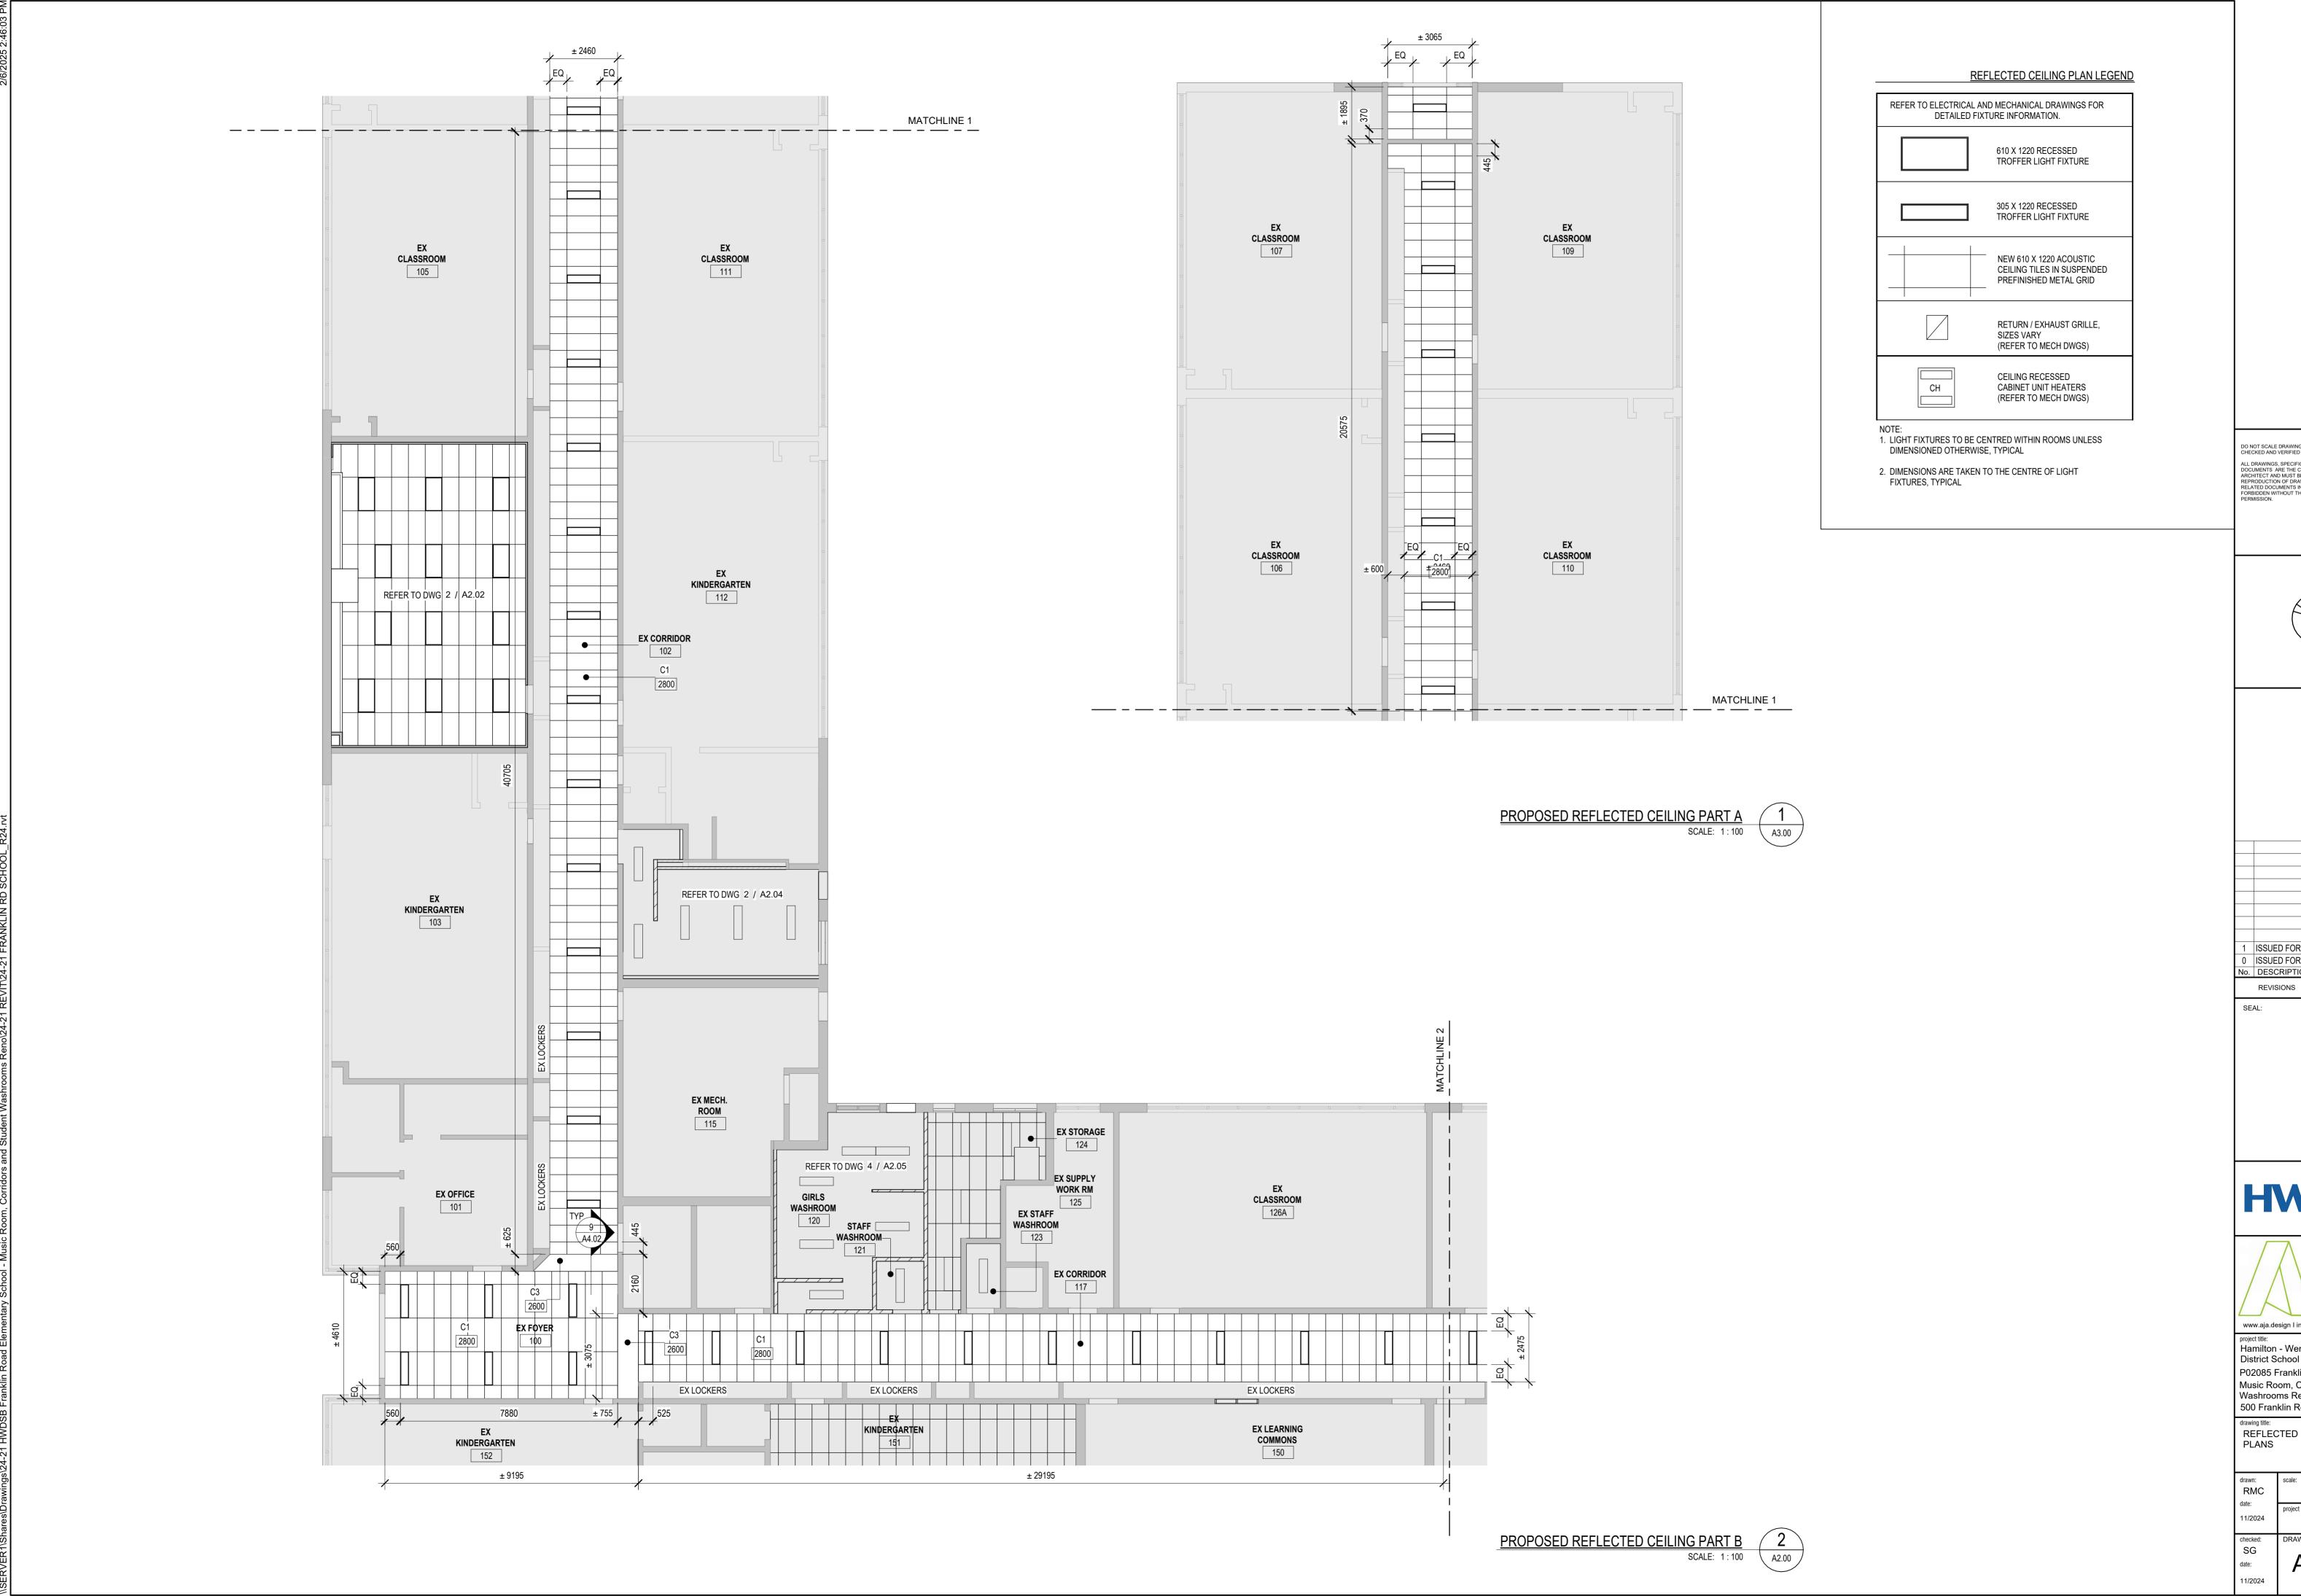

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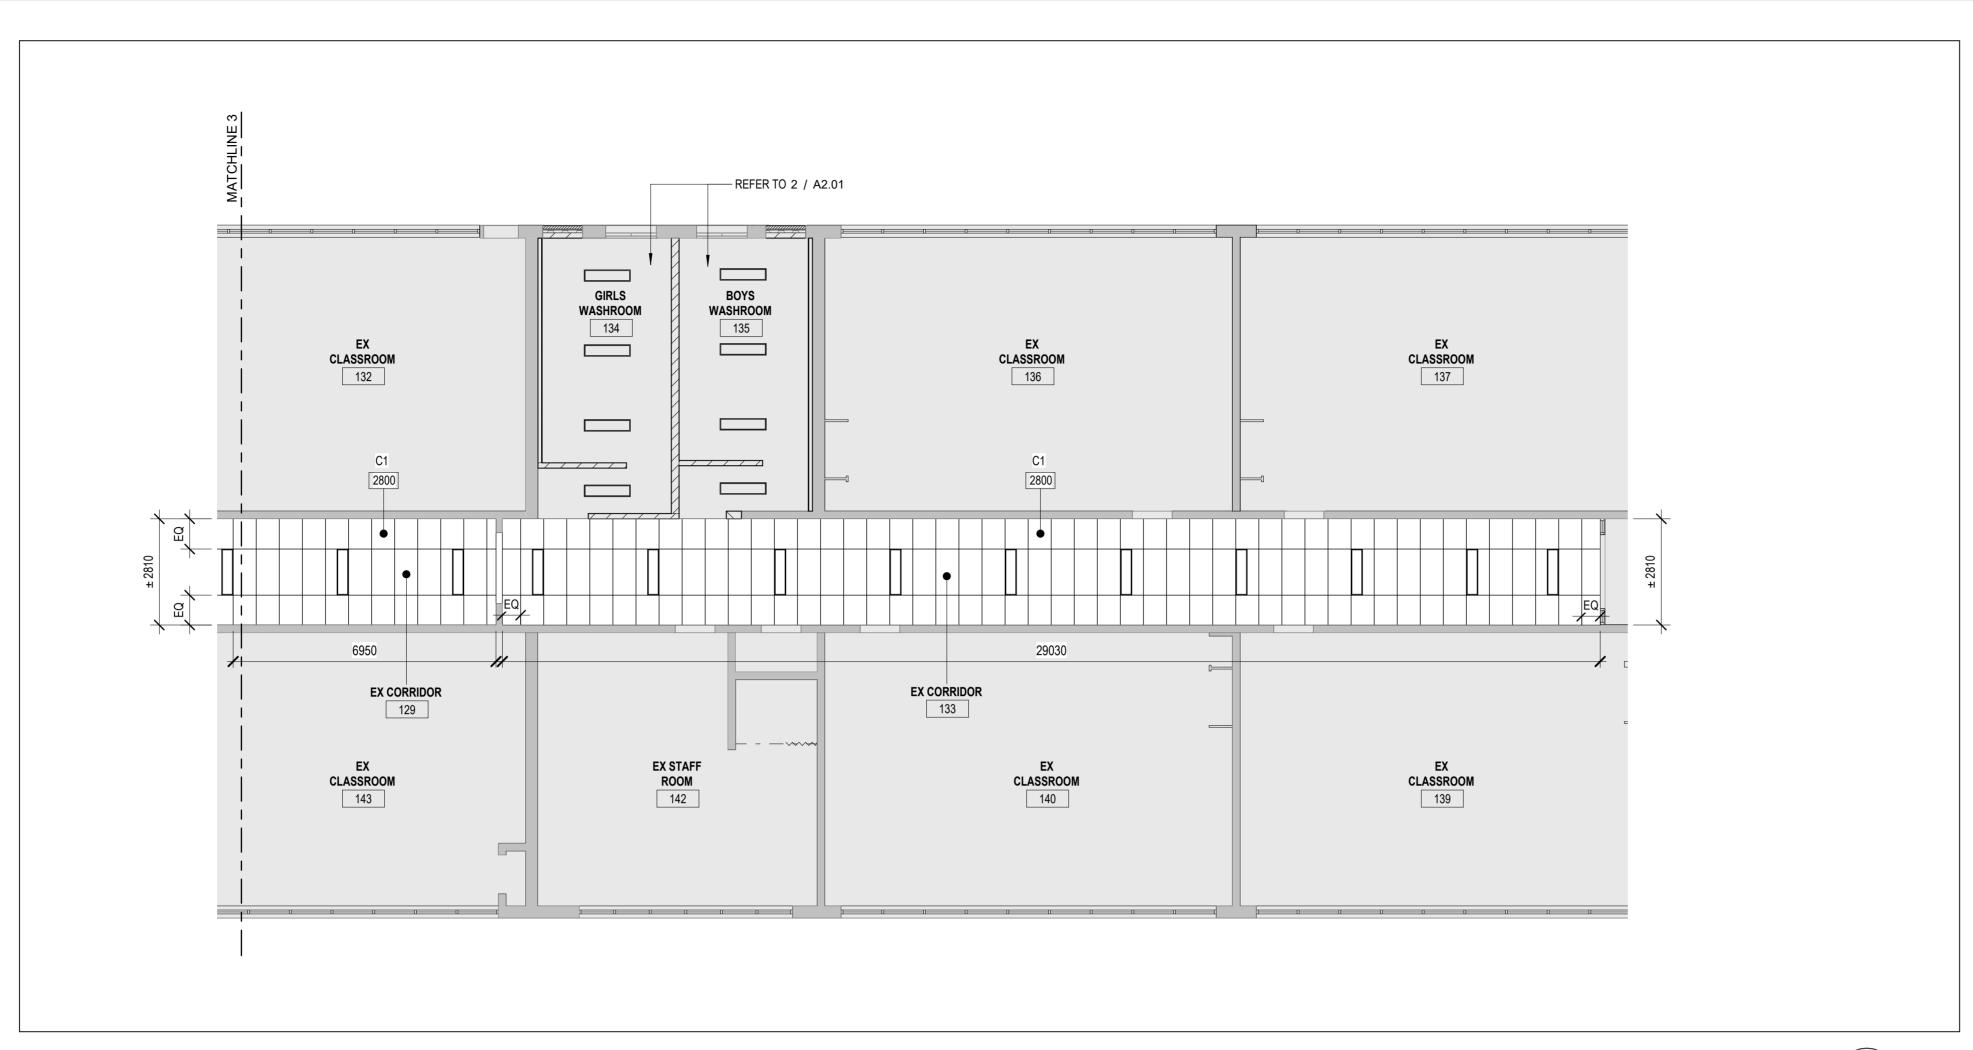
project title: Hamilton - Wentworth District School Board P02085 Franklin Elementary School Music Room, Corridors, and Student Washrooms Renovations 500 Franklin Rd., Hamilton, Ontario

drawing title:


REFLECTED PARTIAL CEILING
PLANS

As indicated 24-21


A3.01



ENLARGED PROPOSED REFLECTED CEILING PLAN PART D

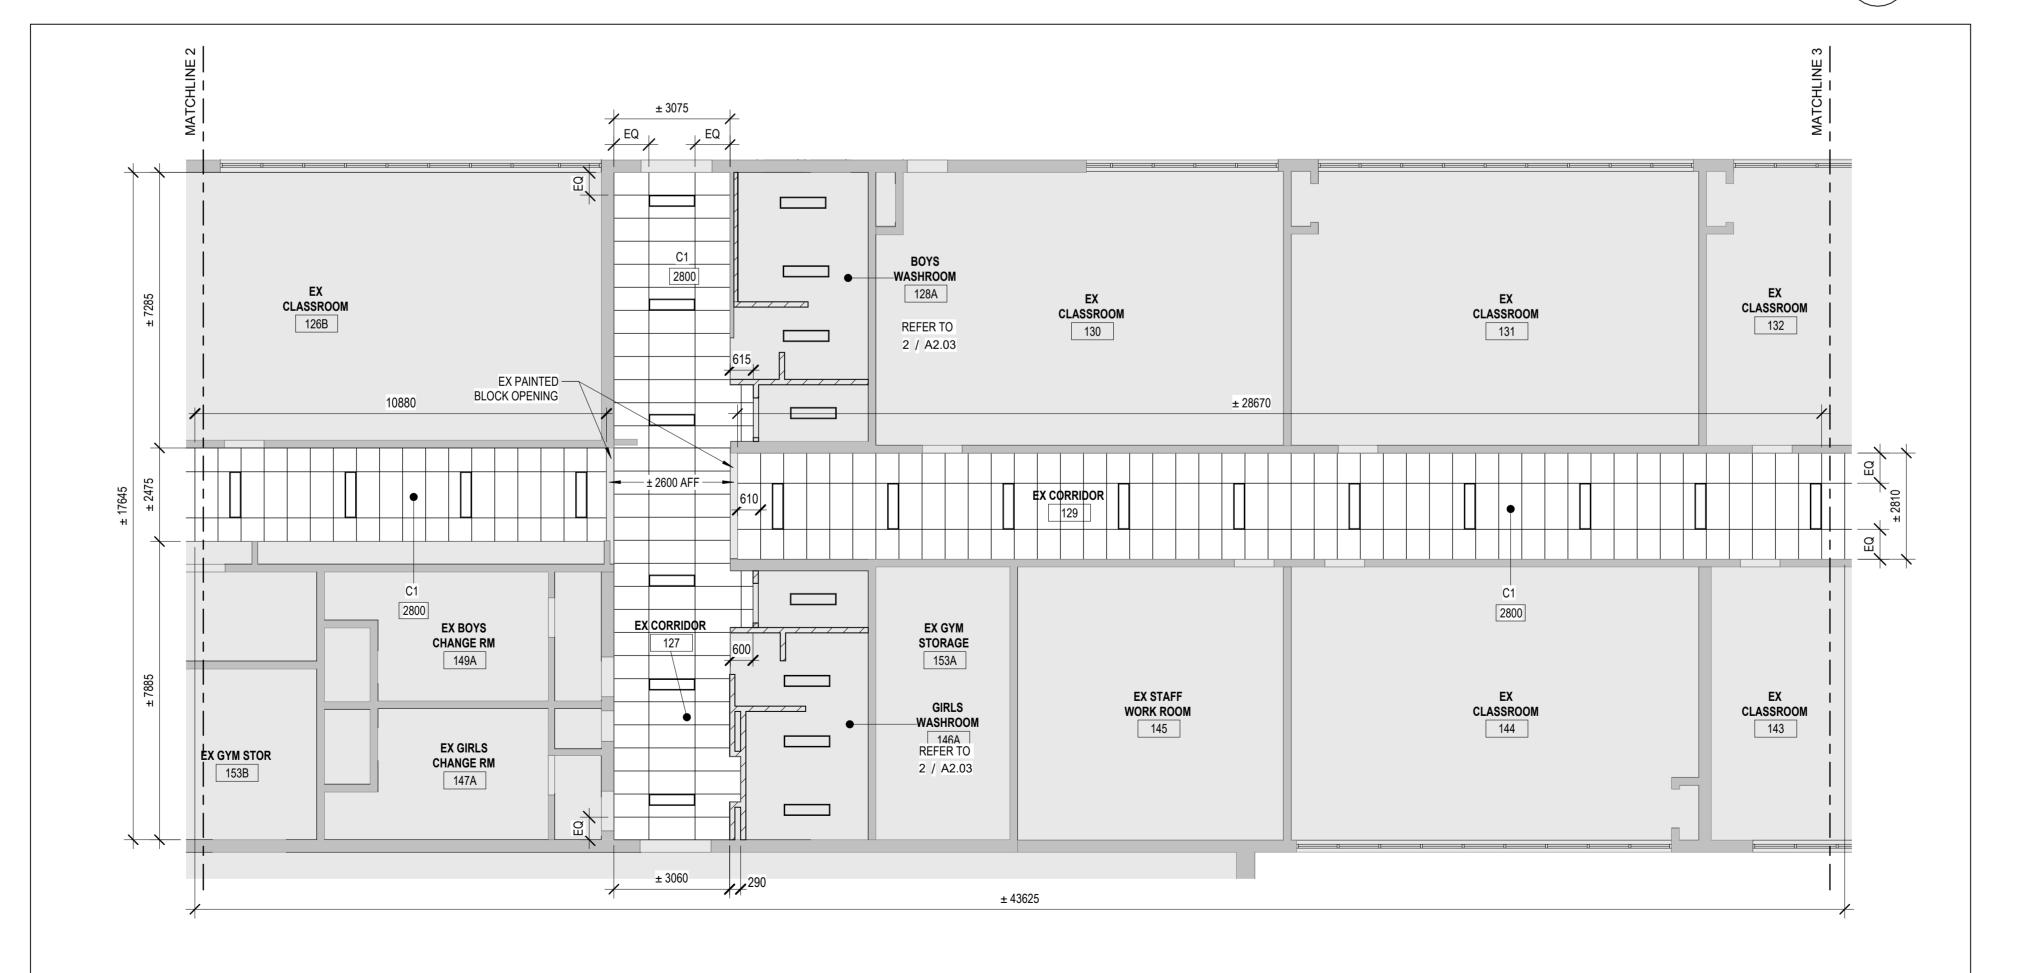

ENLARGED PROPOSED REFLECTED CEILING PLAN PART C SCALE: 1:100 A3.00

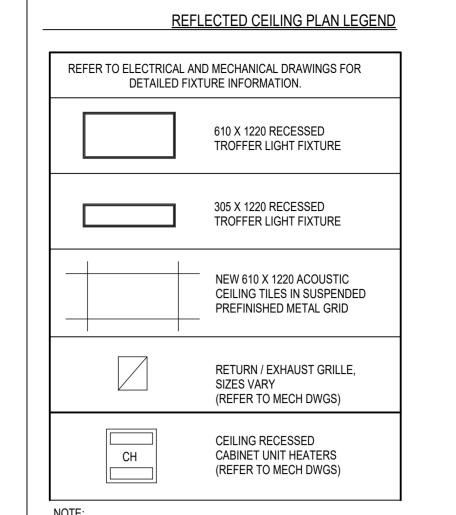

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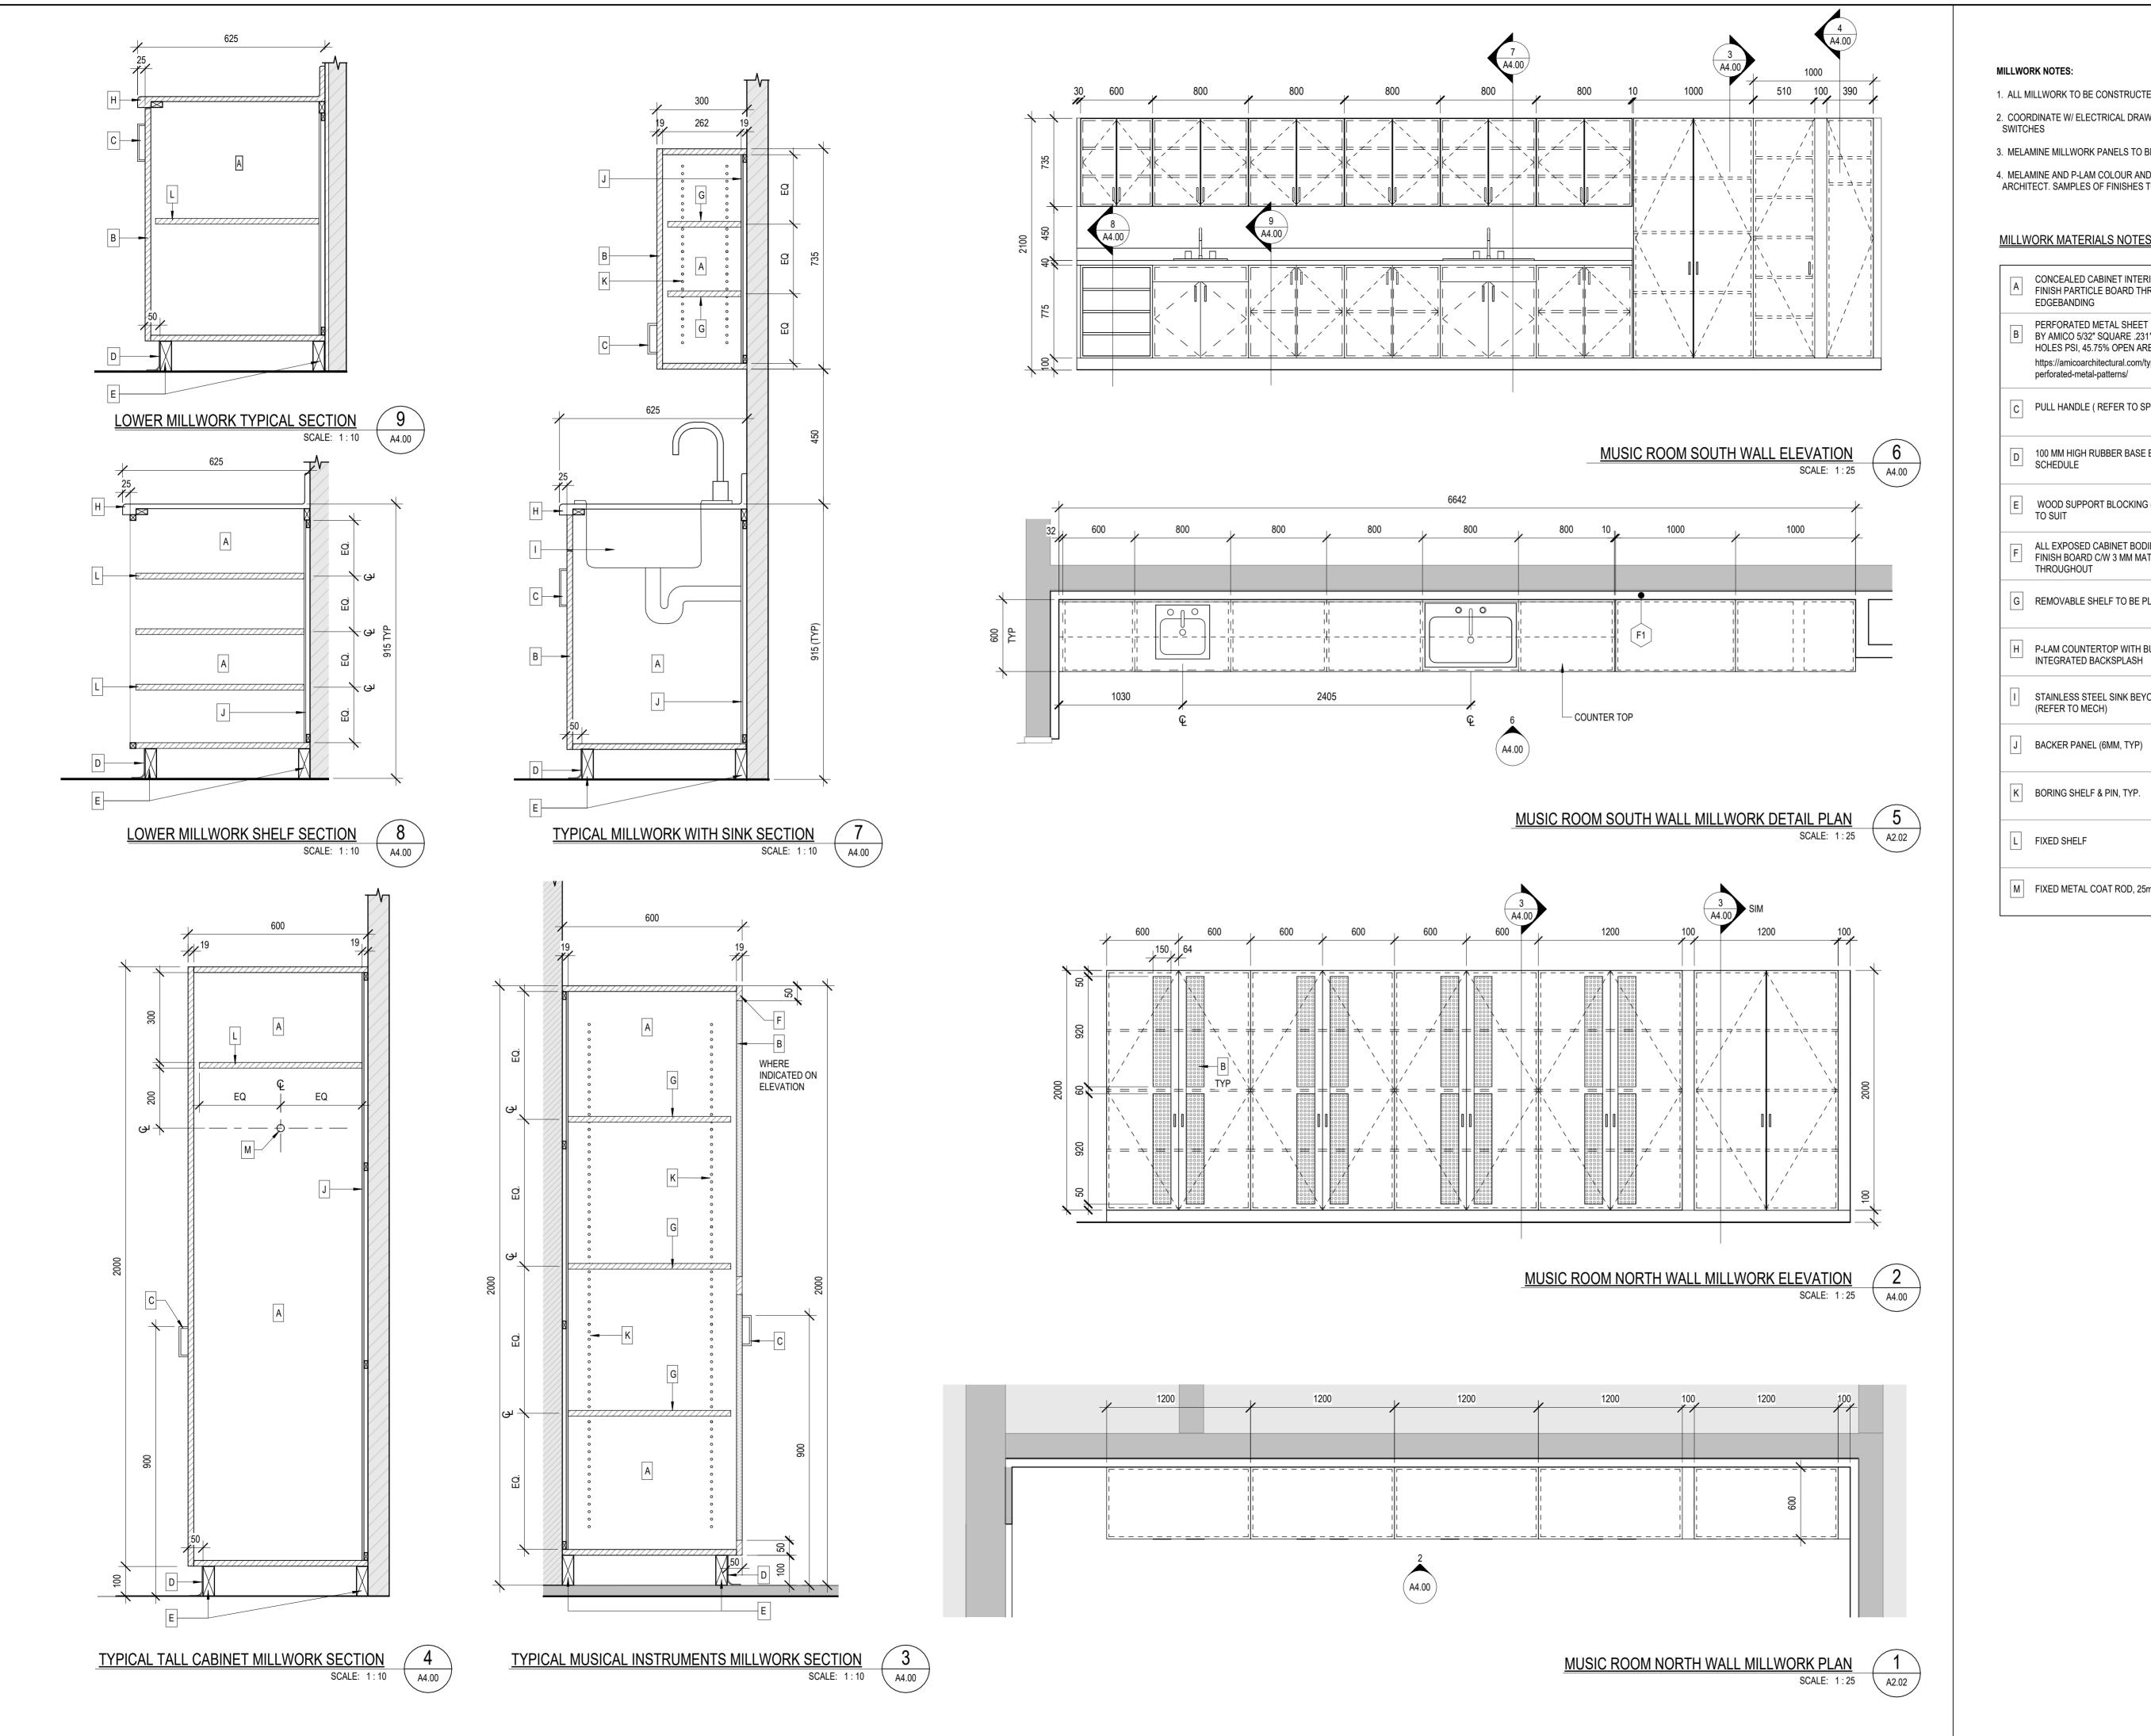
project title: Hamilton - Wentworth District School Board P02085 Franklin Elementary School Music Room, Corridors, and Student Washrooms Renovations 500 Franklin Rd., Hamilton, Ontario

drawing title:

REFLECTED PARTIAL CEILING
PLANS

drawn: As indicated 11/2024 24-21

checked: A3.02 | 1



1. ALL MILLWORK TO BE CONSTRUCTED TO HWDSB CUSTOM STANDARD 2. COORDINATE W/ ELECTRICAL DRAWINGS FOR LOCATIONS OF OUTLETS AND

3. MELAMINE MILLWORK PANELS TO BE 19MM THICK, U.N.O

4. MELAMINE AND P-LAM COLOUR AND STYLE TO BE SELECTED BY ARCHITECT. SAMPLES OF FINISHES TO BE PROVIDED FOR APPROVAL

MILLWORK MATERIALS NOTES

CONCEALED CABINET INTERIORS TO BE WHITE MELAMINE FINISH PARTICLE BOARD THROUGHOUT C/W MATCHING TAPES

PERFORATED METAL SHEET B BY AMICO 5/32" SQUARE .231" STRAIGHT CENTERS, 18.74 HOLES PSI, 45.75% OPEN AREA https://amicoarchitectural.com/typical-square-all-acrossperforated-metal-patterns/

C PULL HANDLE (REFER TO SPECS)

D 100 MM HIGH RUBBER BASE BOARD AS PER ROOM FINISH SCHEDULE

WOOD SUPPORT BLOCKING (OR CABINET LEVELING LEGS)

ALL EXPOSED CABINET BODIES TO BE PLASTIC LAMINATE FINISH BOARD C/W 3 MM MATCHING PVC EDGEBANDING THROUGHOUT

G REMOVABLE SHELF TO BE PLASTIC LAMINATE

H P-LAM COUNTERTOP WITH BULLNOSE EDGE & 100MM

STAINLESS STEEL SINK BEYOND

J BACKER PANEL (6MM, TYP)

K BORING SHELF & PIN, TYP.

L FIXED SHELF

M FIXED METAL COAT ROD, 25mm DIA.

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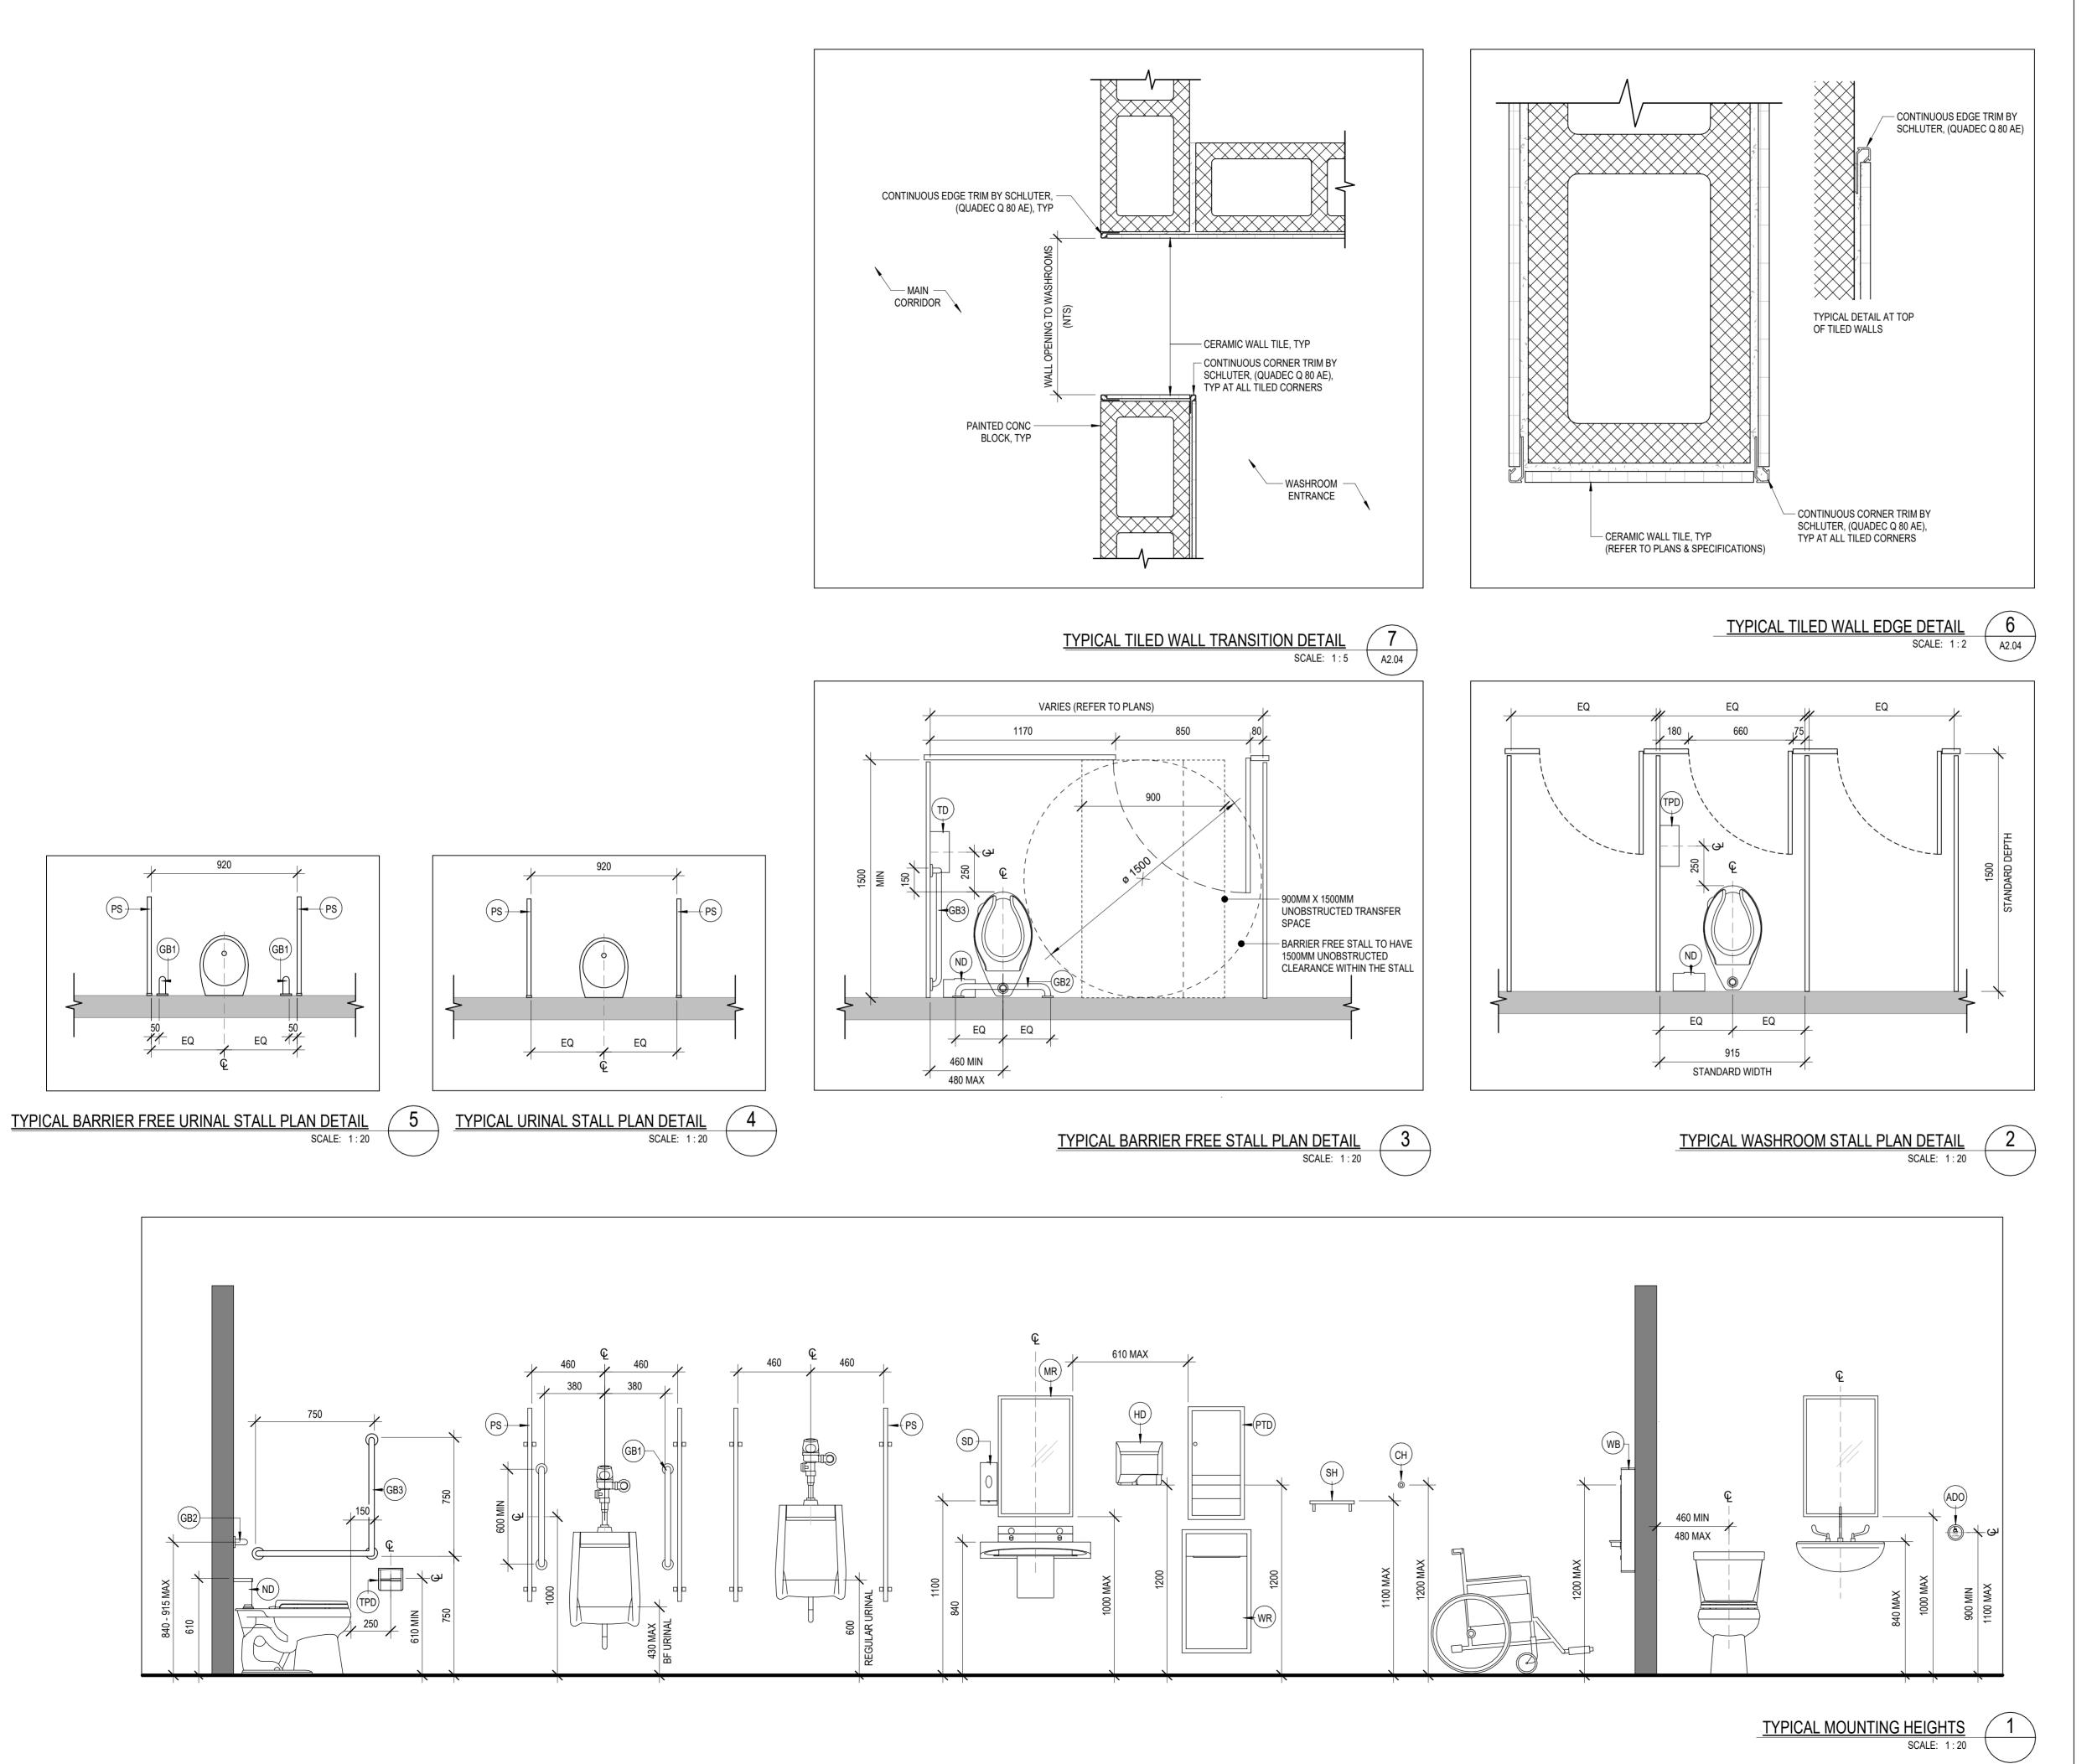


project title: Hamilton - Wentworth District School Board P02085 Franklin Elementary School Music Room, Corridors, and Student Washrooms Renovations 500 Franklin Rd., Hamilton, Ontario

MILLWORK DETAILS

drawn: RMC	scale: As indicated	
4-4		
date:	project number:	
11/2024	24-21	
	2121	
checked:	DRAWING NO:	
SG		
36	A 4 OO	1

A4.00 | 1 | 11/2024



WASHROOM FLOOR PLAN ABBREVIATIONS

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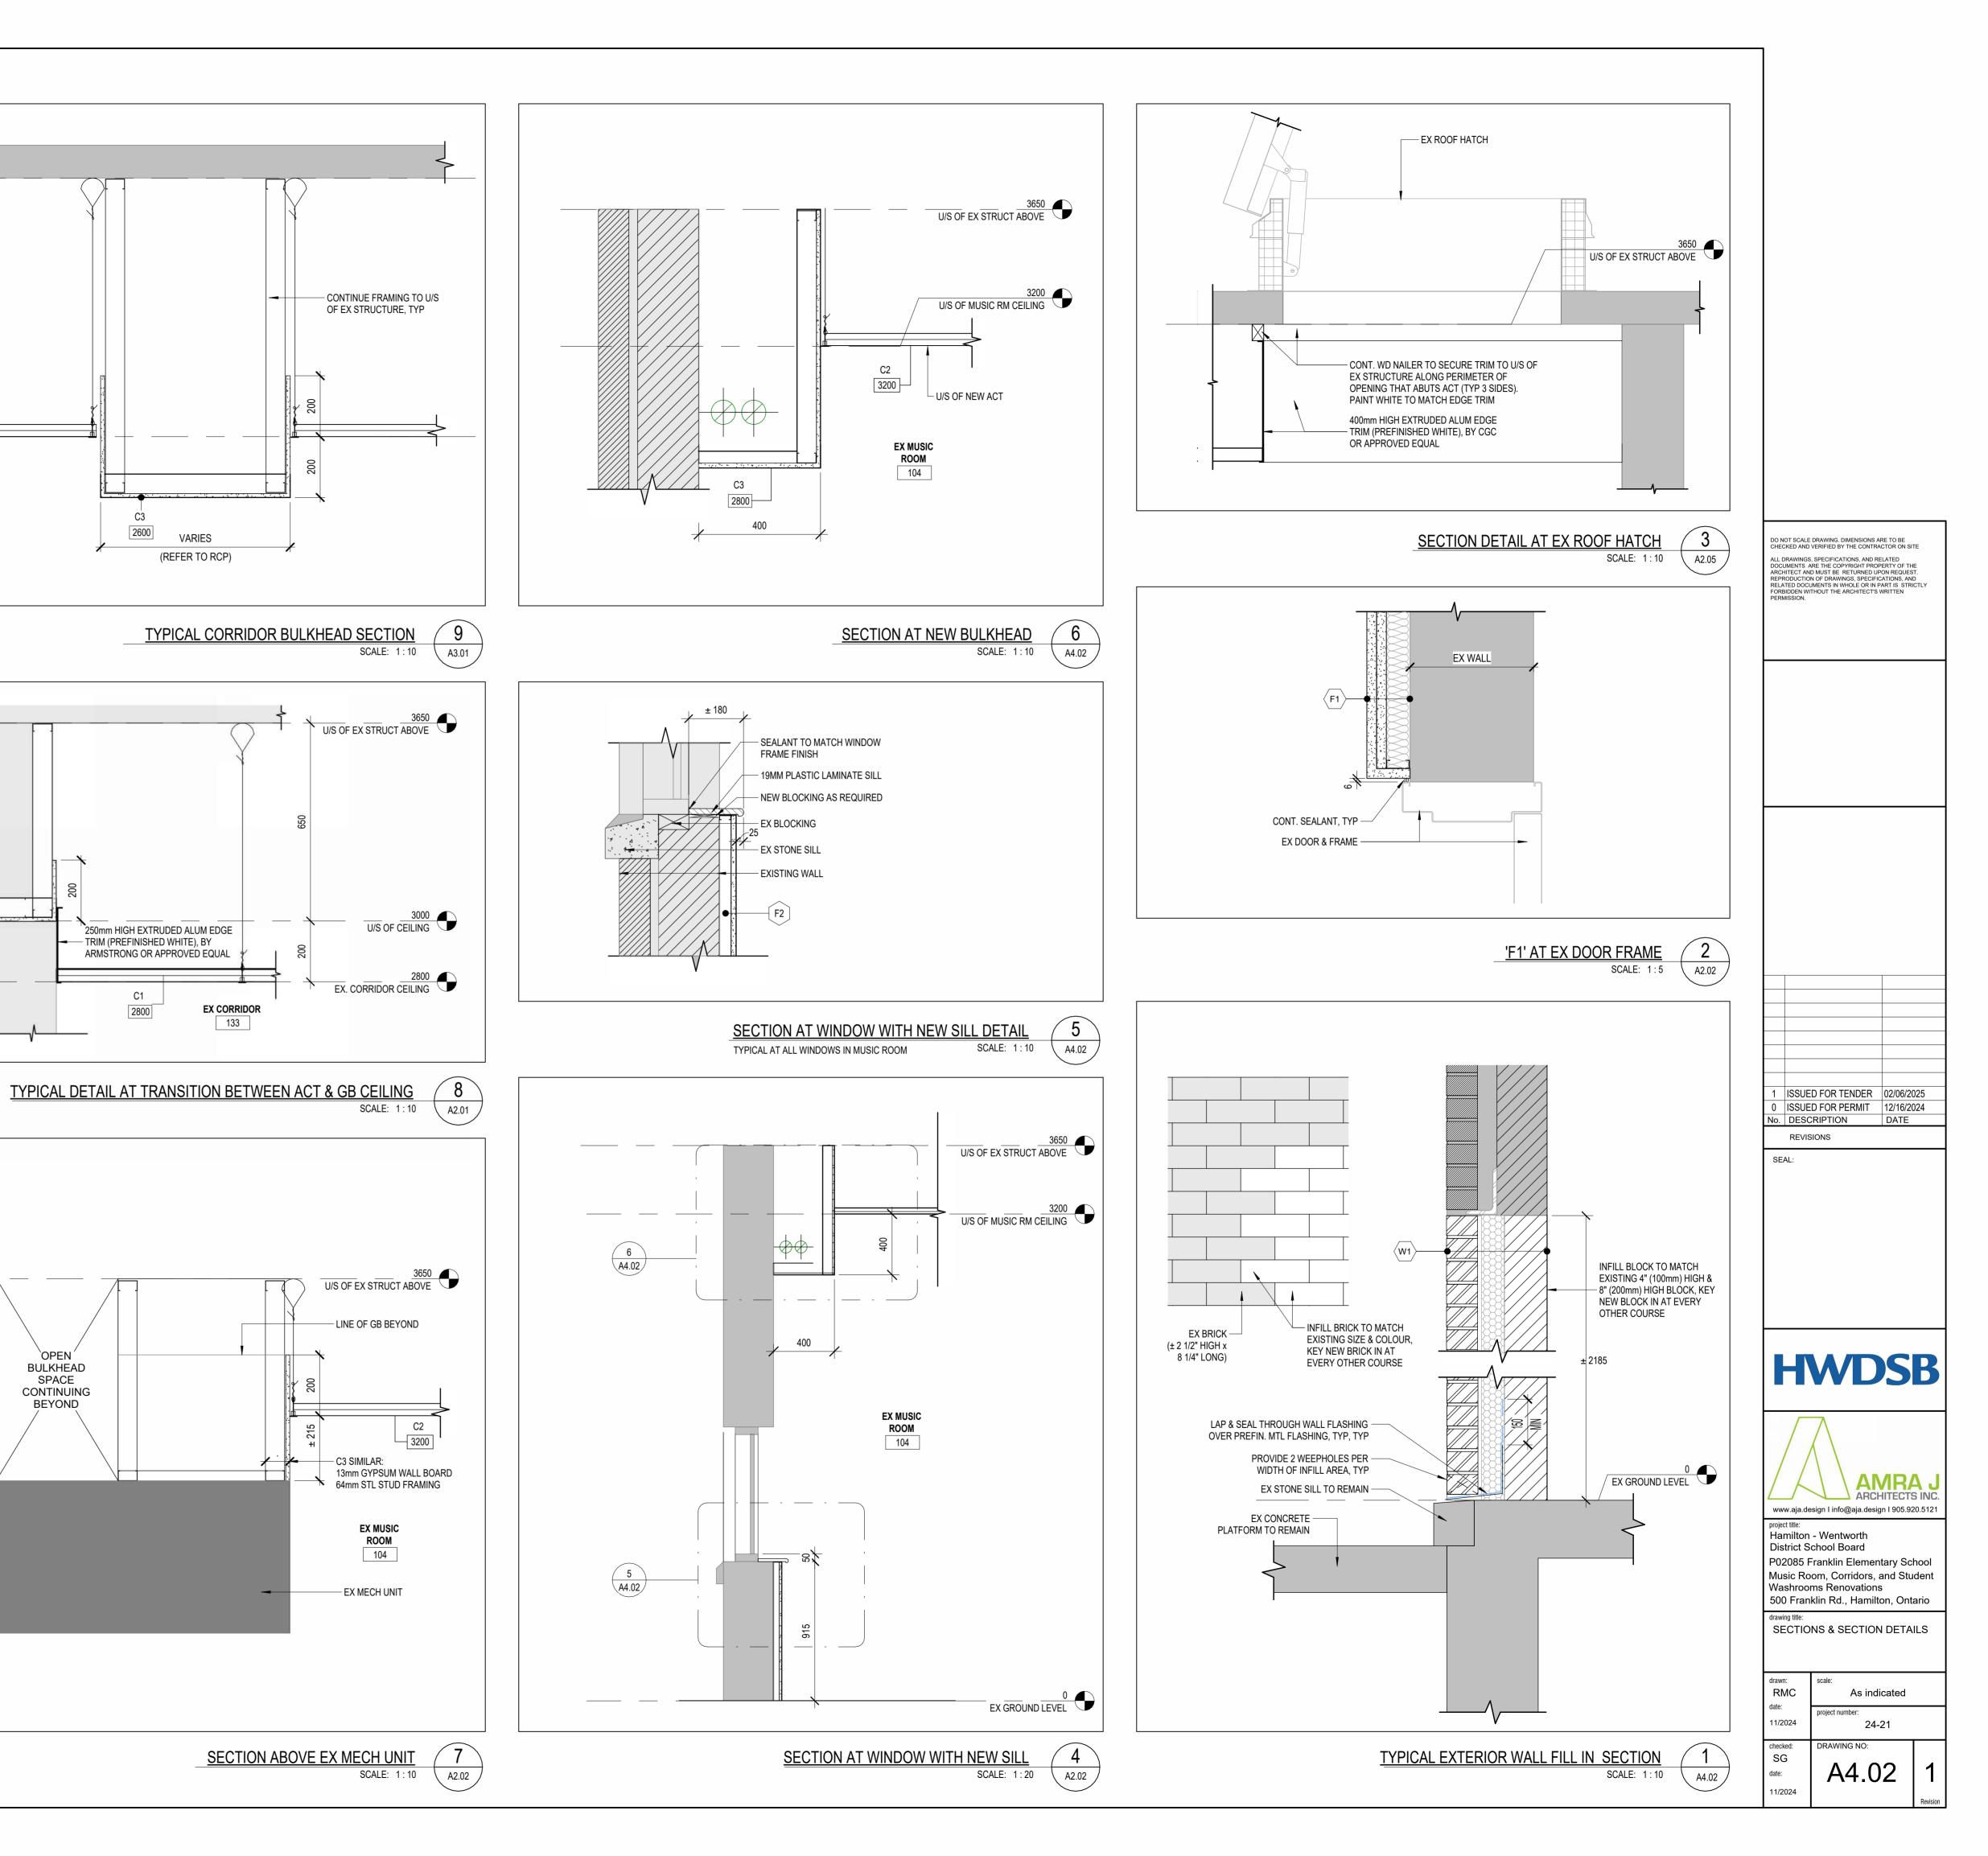


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Washrooms Renovations
500 Franklin Rd., Hamilton, Ontario

drawing title:
WASHROOM INFORMATION AND
TYPICAL DETAILS

drawn:	scale:					
RMC	As indicated					
date:	project number:					
11/2024	24-21					
checked:	DRAWING NO:					

A4.01 1



3650
U/S OF EX STRUCT ABOVE

EX. CORRIDOR CEILING

BOYS

WASHROOM

135

`OPEN [′] BULKHEAD

SPACE CONTINUING BEYOND

			MECHANIC	//\L L				· · · · · · · · · · · · · · · · · · ·		LIST OF DRAWINGS
VENTILATION L	LEGEND	PIPING LE	EGEND	PLUMBING		SPRINKLEF	R LEGEND	MISCELL	ANEOUS ABBREVIATIONS	M0-00 MECHANICAL LEGEND AND DRAWING LI
	SOUND INSULATION		HEATING WATER SUPPLY		STORM DRAIN ABOVE GRADE (STM)		UPRIGHT SPRINKLER	EX	- EXISTING TO REMAIN.	HO OF CONCEDITION DIDDING DIAM
	SOUND INSULATION		HEATING WATER RETURN CHILLED WATER SUPPLY		SANITARY ABOVE GRADE (SAN) STORM DRAIN BURIED (STM)		PENDANT SPRINKLER UPRIGHT SPRINKLER w/GUARD	_	EXISTING TO BE RELOCATED. RELOCATED DEVICE AT NEW LOCATION	M0-01 CONSTRUCTION BIDDING PLAN
		71	CHILLED WATER RETURN		SANITARY BURIED (SAN)		PENDANT SPRINKLER W/GUARD	_	- EXISTING TO BE REMOVED	M1-00 HVAC SYSTEMS-DEMOLITION AND NEW
SL-1	SILENCER		GLYCOL WATER RETURN		WEEPING TILE		UPRIGHT HI-TEMP. SPRINKLER		- EXISTING TO BE REPLACED WITH NEW	M1-01 PLUMBING SYSTEMS-DEMOLITION PLAN
			GLYCOL WATER RETURN		DOMESTIC COLD WATER (DCW)	—	PENDANT HI-TEMP. SPRINKLER			
	LEXIBLE CONNECTION	— CD —	EQUIPMENT CONDENSATE DRAIN LINE		DOMESTIC HOT WATER (DHW)		UPRIGHT HI-TEMP. SPRINKLER w/GUARD			M2-00 MECHANICAL SYSTEMS-NEW OVERALL
	LEXIBLE CONNECTION	— G —	NATURAL GAS		DOMESTIC HOT WATER RECIRC (DHWR)		PENDANT HI-TEMP. SPRINKLER W/GUARD			M2-01 PLUMBING SYSTEMS-NEW OVERALL PL
		s	SUCTION LINE	• T	DOMESTIC TEMPERED WATER (TW)	X	DRY PENDANT SPRINKLER			NO DO BUILDING OVERTER NEW ENGAGES
X DN X D	DUCT OFFSET	L	LIQUID LINE	•••T—	DOMESTIC TEMPERED WATER RECIRC (TWR)		DRY PENDANT SPRINKLER w/GUARD			M2-02 PLUMBING SYSTEM - NEW ENLARGE
			VENT LINE	— GS—	GLYCOL SUPPLY	×	RECESSED SPRINKLER			M3-00 DETAILS
		— F —	FIRE LINE	— GR—	GLYCOL RETURN		CONCEALED SPRINKLER			M4-00 MECHANICAL SPECIFICATION
BD B	BALANCING DAMPER		COMPRESSED AIR		CONDENSATE		HORIZONTAL SIDEWALL SPRINKLER			
		7	DRAIN PIPE		EXPANSION		EXTENDED COVERAGE SIDEWALL SPRINKLER			
FI FI	TIRE DAMPER		SPRINKLER PIPE		CLEANOUT(ABOVE FLOOR)		FLOW SWITCH			
			PIPE ANCHOR		CLEANOUT(UNDERGROUND)		PRESSURE SWITCH OR SENSOR			
			PIPE GUIDE OR SLEEVE EXPANSION COMPENSATOR c/w GUIDES		AREA DRAIN FLOOR DRAIN		APPROVED DOUBLE CHECK VALVE BACKFLOW PREVENTOR ASSEMBLY	_		The second second
SD S	SPLITTER DAMPER		BOTTOM TAKE-OFF		FUNNEL FLOOR DRAIN		ELECTRICALLY MONITORED SHUT-OFF VALVE			
			TOP TAKE-OFF		HUB DRAIN			- 		
BUD	BACKDRAFT DAMPER		ELBOW UP		ROOF DRAIN		CHECK VALVE	_ 		
BDD B	A STOUGHT DAMELIN		ELBOW DOWN		FIRE EXTINGUISHER		ALARM CHECK VALVE			A Part of the second of the se
			VALVE — SEE SPECIFICATIONS		FIRE EXTINGUISHER c/w CABINET		SPRINKI FR RISFR	 		
MD M	MOTORIZED DAMPER		UNION CONNECTION		SHOWER (HANDICAPPED)		SPRINKLER RISER	_ 		
			FLANGED CONNECTION	■ SH	SHOWER		SIAMESE FIRE DEPT. CONNECTION			
s	SUPPLY DUCT SECTION	[PLUG CAP		RUNNING TRAP	-	WATER GONG			
			FLEXIBLE CONNECTION	I	NON- FREEZE HOSE BIBB	— F —	FIRE LINE			
R	RETURN DUCT SECTION		THERMOMETER	 нв	HOSE BIBB		HORIZONTAL SIDEWALL SPRINKLER W/GUARD			
1 1 1 1 1 1 1 1 1 1	SUPPLY DIFFUSER	Ø PG	PRESSURE GAUGE		PIPE REDUCER	VALVE LEG	<u>END</u>	٦		
		→ AV	AIR VENT	P-1	PUMP AND DESIGNATION		VALVE - SEE SPEC			
	XHAUST GRILLE		AUTOMATIC AIR VENT	xxxx	KITCHEN EQUIPMENT IDENTIFICATION					
D-XXX D	DIFFUSER DESIGNATION AND L/S	— PFS	FLOW SWITCH	PR-?	PLUMBING RISER		CHECK VALVE			
0	, 		THERMOSTAT				STRAINER			
$ \begin{array}{ c c } \hline G-XXX\\ \hline 0 \end{array} $	SRILLE DESIGNATION AND L/S		THERMOSTAT w/GUARD	ABBREVIA	<u>IONS</u>					
	CAPPED END DUCT		HUMIDITY SENSOR		- HOSE STATION		PRESSURE REDUCING VALVE (PRV)			
			SWITCH		FIRE HOSE CABINETRAIN WATER LEADER		LOCK SHIELD VALVE			PROJE
	OUCT REDUCER/ENLARGER		CABINET HEATERS "CH"	WC WC	- WATER CLOSET	□ TCV	2-WAY CONTROL VALVE (TCV)			SITE LOCATION ()
TF	RANSITION TO ROUND		CONTINUOUS CONVECTORS "WF"		- WATER CLOSET (HANDICAPPED)					
	PARRONI MONOVIDE DETECTOR				- LAVATORY		3-WAY CONTROL VALVE (TCV)			
	CARBON MONOXIDE DETECTOR		RADIANT PANELS "RP"	LH	- LAVATORY (HANDICAPPED)	R	RELIEF VALVE			
A			TEMPERATURE SENSOR	S MS	STAINLESS STEEL SINKMOP SINK	CBV				
			FIDE DICED	HS	- HAIR SINK		CIRCUIT BALANCE VALVE (CBV)			
	NIR FLOW DIRECTIONS	FR-?	FIRE RISER	FLRS	- FLOOR SINK		PLUG VALVE			
ABBREVIATIONS	S	FCR-?	FAN COIL RISER	НВТ	- BATH TUB (HANDICAPPED)			 		
	EXHAUST FAN	ABBREVIAT	TIONS	EEW LNIV ELEV	- EMERGENCY EYE WASH	□ □SV	SOLENOID VALVE	_		
	SUPPLY FAN WEATHER LOUVRE			INV. ELEV.	— INVERT ELEVATION— OBVERT ELEVATION		NORMALLY CLOSED VALVE			
	CONDENSING UNIT		ABOVE FINISHED FLOORGALLONS PER MINUTE	BFP	- APPROVED BACKFLOW PREVENTOR			-		
	FAN COIL UNIT		- HIGH PRESSURE	TSP	- TRAP SEAL PRIMER	LEGEND N	OTES:			
	MAKE UP AIR	MGSV	- MASTER GAS SOLENOID VALVE	SEP	- SEWAGE EJECTOR PUMP		ARE STANDARD LEGENDS. ALL SYMBOLS MAY NOT			
	AIR CONDITIONING ACCESS DOOR		- EXPANSION TANK	GINT	GREASE INTERCEPTORSOLID INTERCEPTOR	NECESS	SARILY BE USED ON THESE DRAWINGS.			
	ENERGY RECOVERY VENTILATOR		- GLYCOL TANK - HEATING PIPE RISER	SP	- STORM EJECTOR PUMP					
	BRANCH SELECTOR		- LOW WATER CUT OFF	TD	- TRENCH DRAIN					
	INT TRAP	TS ·	- TEMPERATURE SENSOR	HBS	- HOSE BIBB STATION					
	/ARIABLE AIR VOLUME BOOSTER FAN		- PRESSURE SENSOR	WM BFP	WATER METERBACKFLOW PREVENTOR					
	VARIABLE REFRIGERANT FLOW		SNOW MELTINGHEAT EXCHANGER	FCO	- FLOOR CLEAN OUT					
	UNIT HEATER		- BOILER	DCW	- DOMESTIC COLD WATER					
DS - D	DUCT SUPPORT	DHWH	- DOMESTIC HOT WATER HEATER	DHW	- DOMESTIC HOT WATER RECIPC					
	SMOKE DETECTOR		- DOMESTIC WATER STORAGE TANK	DHWR DTW	DOMESTIC HOT WATER RECIRCDOMESTIC TEMPERED WATER					
SD – S	GENERAL EXHAUST AIR		BUILDING AUTOMATION SYSTEMRADIANT FLOOR HEATING	DTWR	DOMESTIC TEMPERED WATER DOMESTIC TEMPERED WATER RECIRC					
SD - S GEN E/A - G	CANITARY FYHALICT AIR OFM	T I INCL	NADIAN LEOUN HEATING							
SD - S GEN E/A - G SA E/A - S	SANITARY EXHAUST AIR CFM SUPPLY AIR	GM	- REMOTE READING GAS METER					-	<u>.</u>	
SD - S GEN E/A - G SA E/A - S SA - S		GM	- REMOTE READING GAS METER							
SD - S GEN E/A - G SA E/A - S SA - S RA - F	SUPPLY AIR	GM	- REMOTE READING GAS METER							
SD - S GEN E/A - G SA E/A - S SA - S RA - F EA - E CFSD - G	SUPPLY AIR RETURN AIR EXHAUST AIR COMBINATION SMOKE AND FIRE	GM	- REMOTE READING GAS METER							
SD - S GEN E/A - G SA E/A - S SA - S RA - F EA - E CFSD - C	SUPPLY AIR RETURN AIR EXHAUST AIR	GM	- REMOTE READING GAS METER							

l	LIST OF DRAWINGS
M0-00	MECHANICAL LEGEND AND DRAWING LIST
M0-01	CONSTRUCTION BIDDING PLAN
M1-00	HVAC SYSTEMS-DEMOLITION AND NEW PLAN
M1-01	PLUMBING SYSTEMS-DEMOLITION PLAN
M2-00	MECHANICAL SYSTEMS-NEW OVERALL PLAN
M2-01	PLUMBING SYSTEMS-NEW OVERALL PLAN



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 2 ISSUED FOR TENDER
 2025-02-11

 1 ISSUED FOR PERMIT
 2024-12-16

 B 85% PROGRESS
 2024-11-27

 A 30% PROGRESS SUBMISSION 2024-11-01
 No. DESCRIPTION

DATE

REVISIONS

E&M

Consulting Engineers Inc.

6004 Osprey Blvd,
Missisauga, ON, L5N 8K1
Canada
www.eandmconsultingeng.com

HWDSB AMRA J ARCHITECTS INC.

www.aja.design I info@aja.design I 905.920.5121

project title:
HAMILTON- WENTWORTH
DISTRICT SCHOOL BOARD
P02085 - FRANKLIN RD
ELEMENTARY SCHOOL
RENOVATIONS.
500 FRANKLIN ROAD
HAMILTON, ONTARIO.

drawing title:

MECHANICAL LEGEND
AND DRAWING LIST

drawn: scale:

MH
date:
2025/01 project number: 24-21 checked: DRAWING NO:

KS date: 2025/01

CONSTRUCTION BIDDING PLAN.

SCALE- 1:200

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1 ISSUED FOR PERMIT B 85% PROGRESS A 30% PROGRESS SUBMISSION 2024-11-01
No. DESCRIPTION DATE

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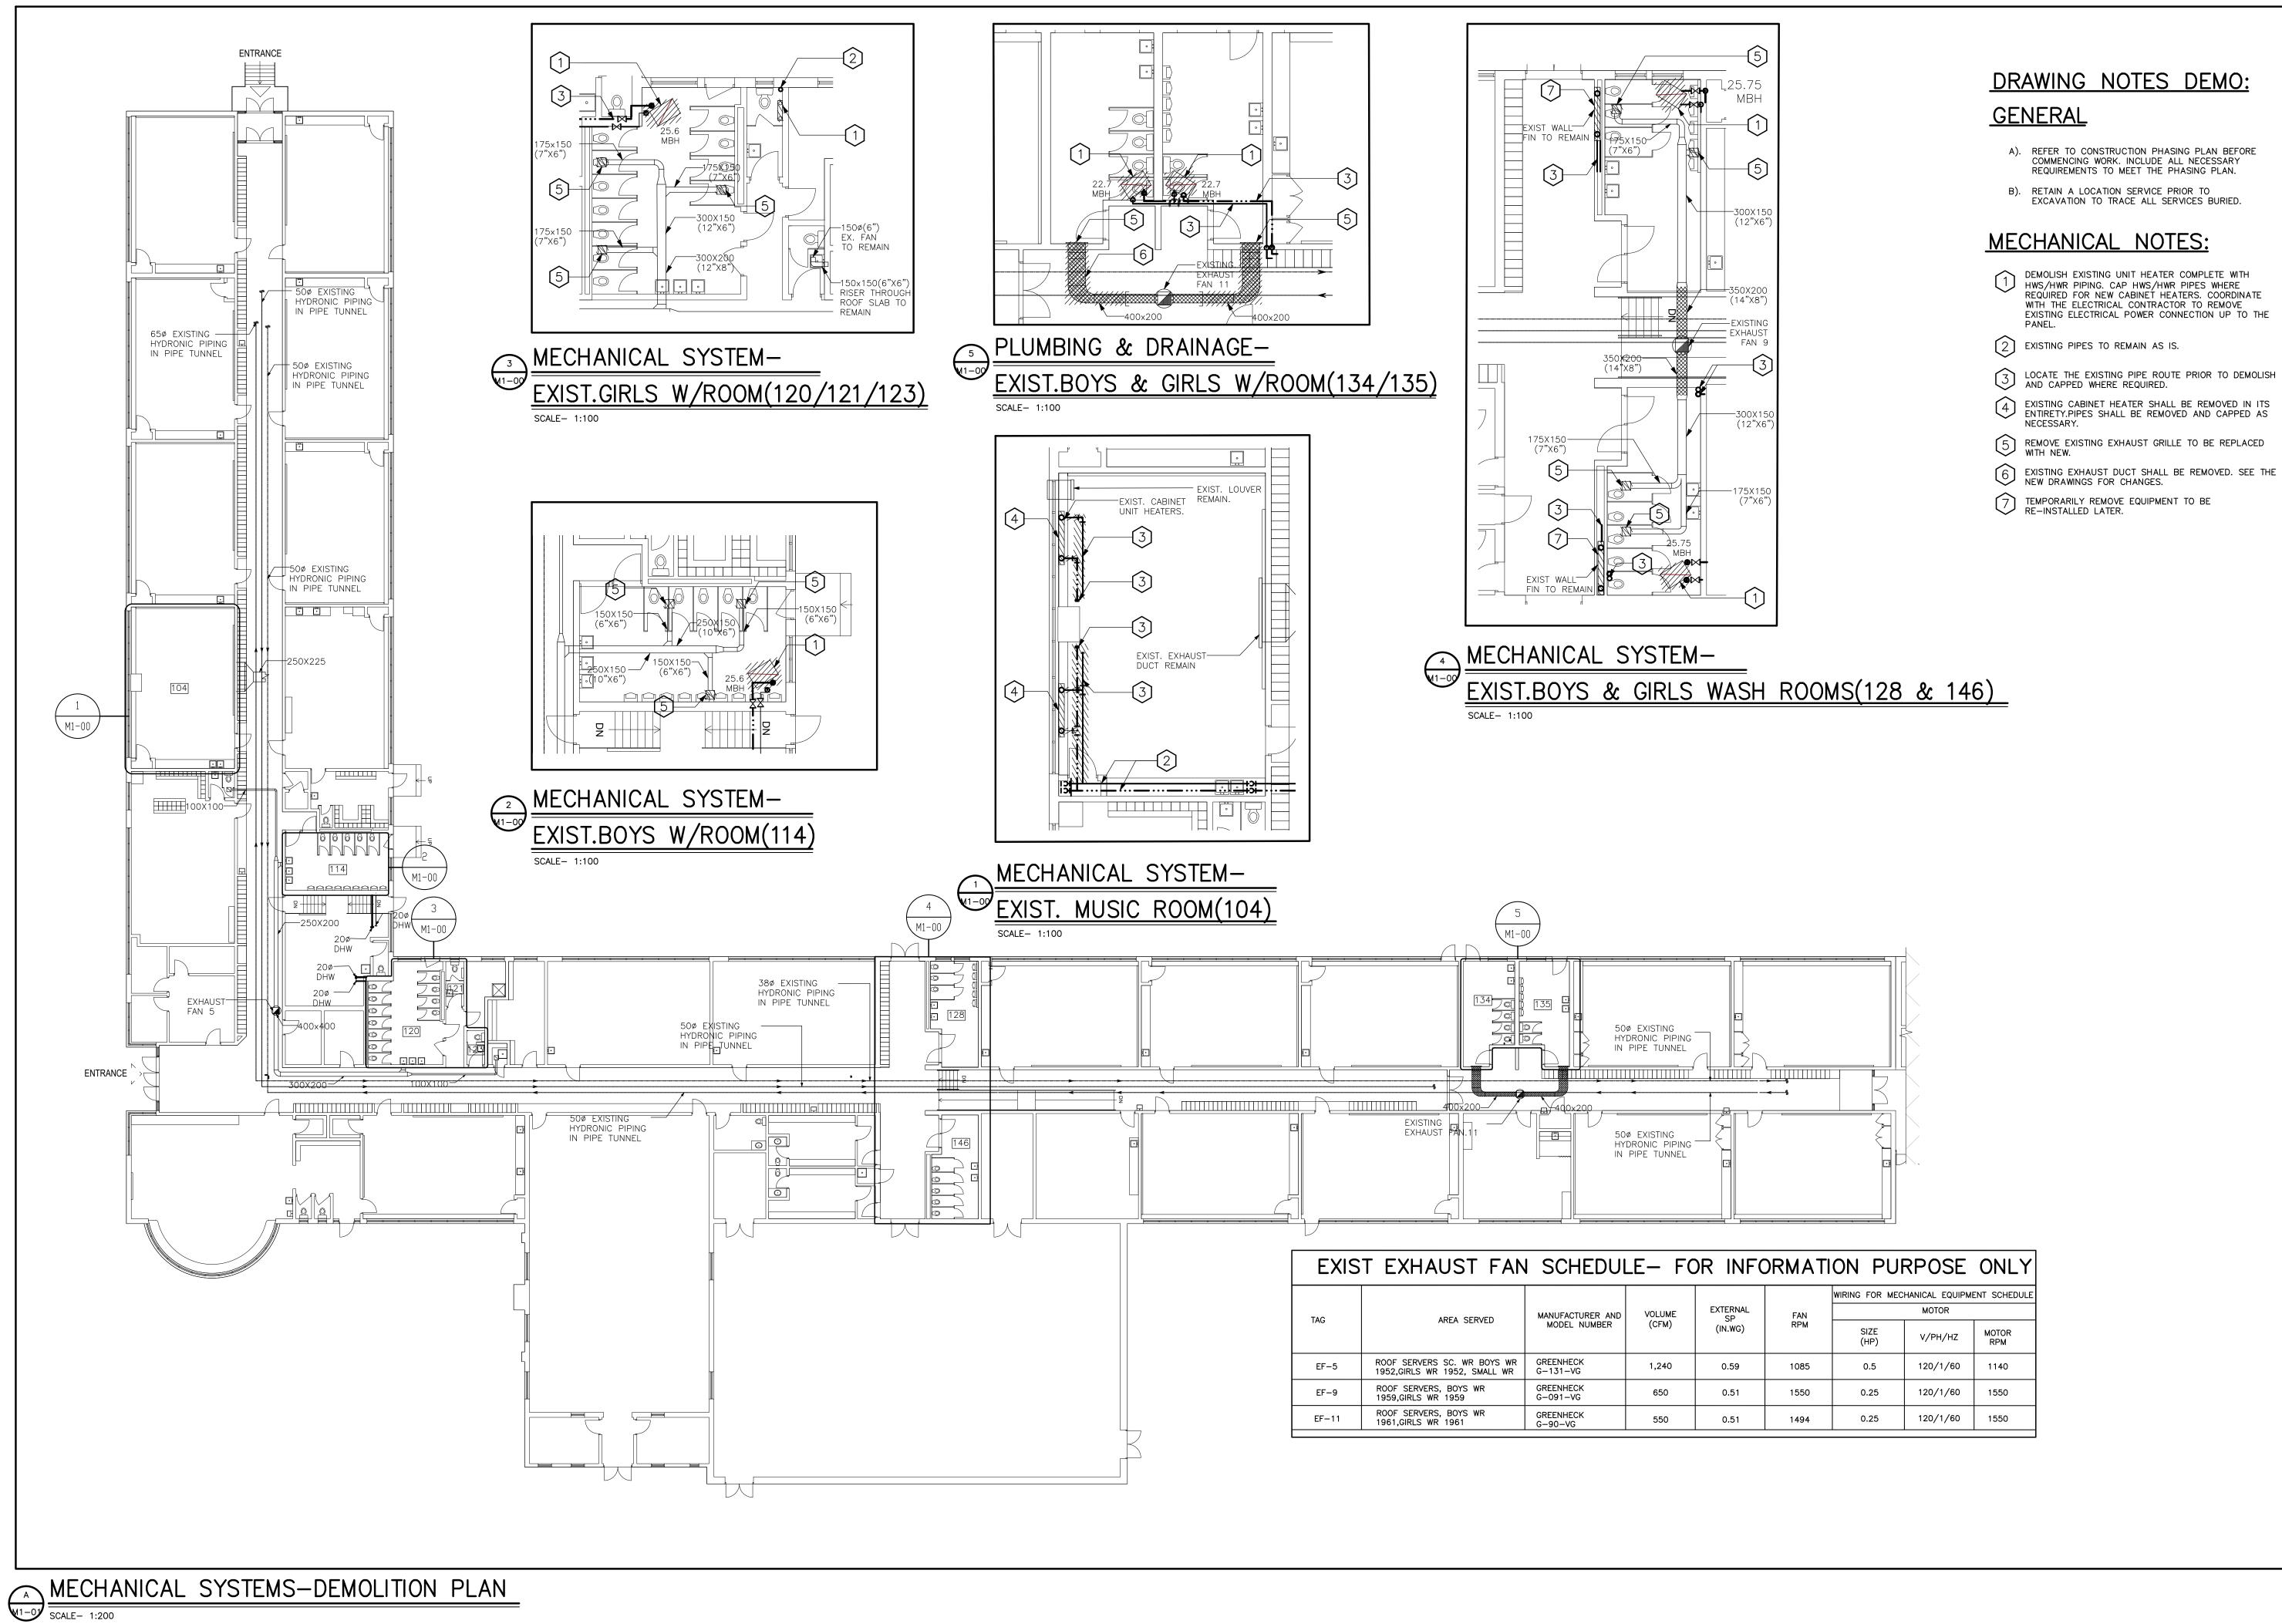
project title:
HAMILTON- WENTWORTH
DISTRICT SCHOOL BOARD P02085 - FRANKLIN RD ELEMENTARY SCHOOL RENOVATIONS. 500 FRANKLIN ROAD

HAMILTON, ONTARIO. CONSTRUCTION BIDDING PLAN.

drawn: MH AS SHOWN project number:

DRAWING NO: 12/2024

M0-01 0



- REQUIRED FOR NEW CABINET HEATERS. COORDINATE WITH THE ELECTRICAL CONTRACTOR TO REMOVE EXISTING ELECTRICAL POWER CONNECTION UP TO THE PANEL.
- EXISTING CABINET HEATER SHALL BE REMOVED IN ITS ENTIRETY. PIPES SHALL BE REMOVED AND CAPPED AS

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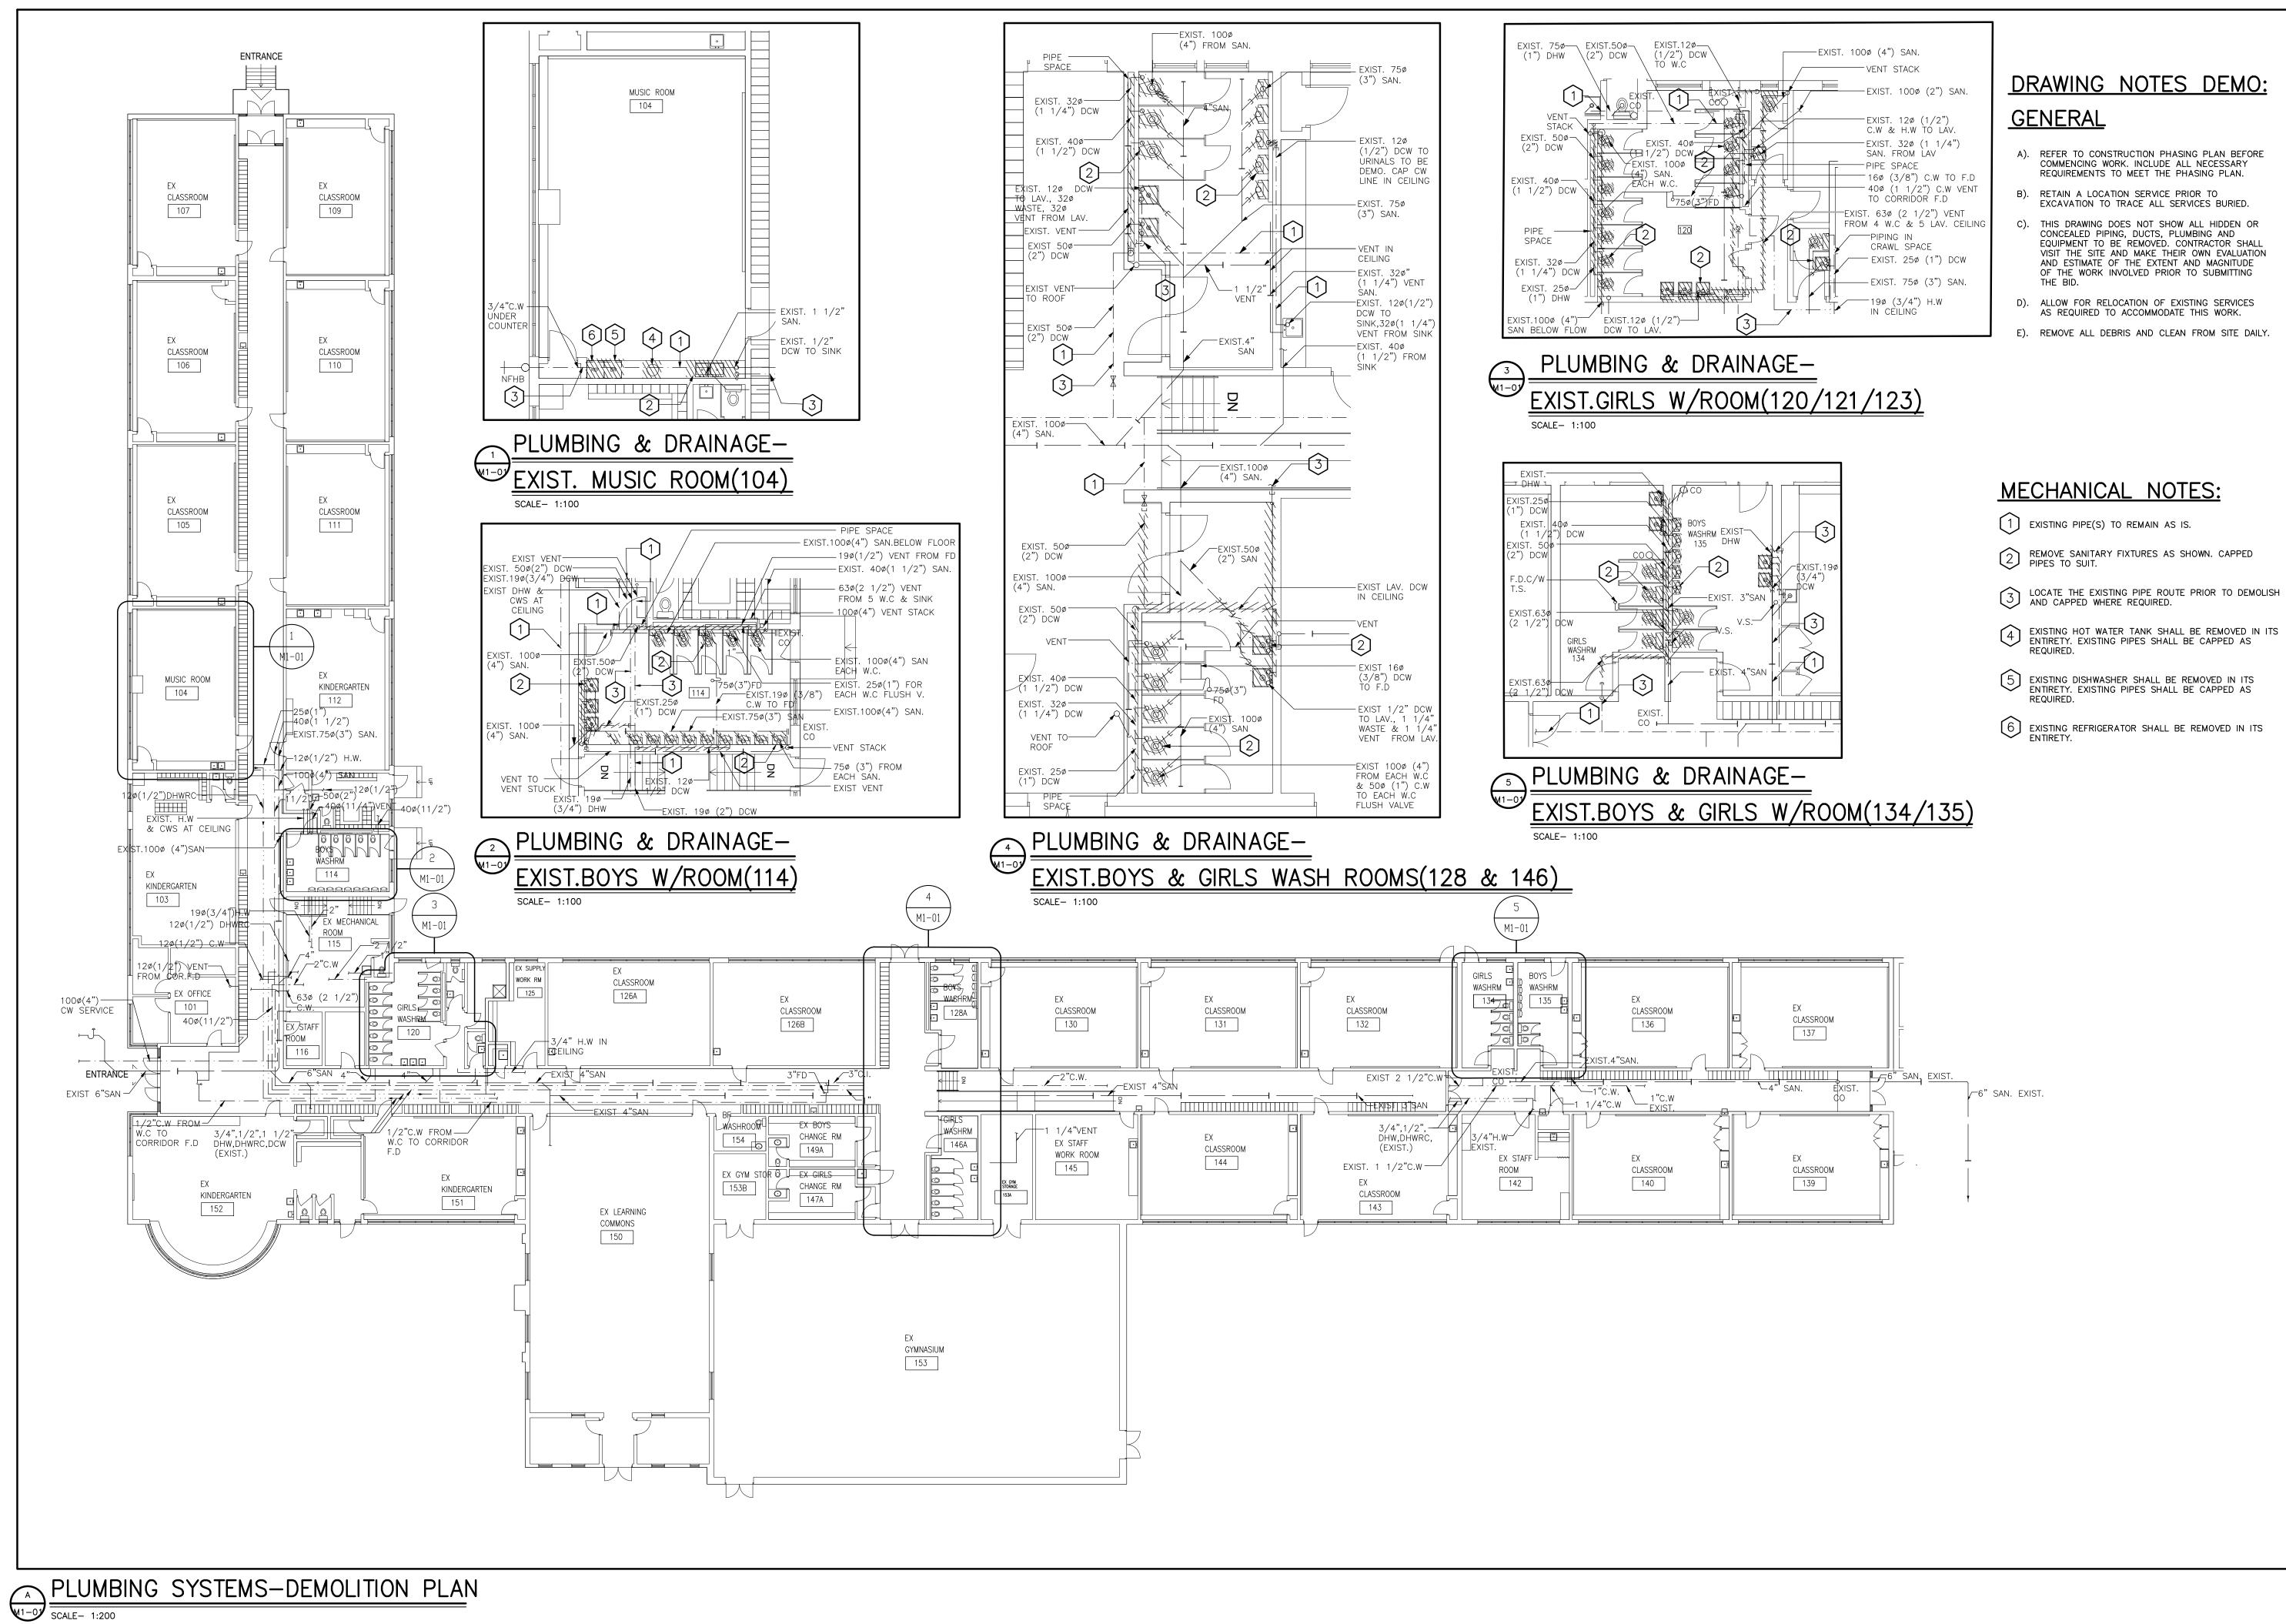
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HAMILTON- WENTWORTH DISTRICT SCHOOL BOARD P02085 - FRANKLIN RD **ELEMENTARY SCHOOL** RENOVATIONS. 500 FRANKLIN ROAD HAMILTON, ONTARIO.

MECHANICAL SYSTEMS -DEMOLITION PLAN

drawn: MH 1:200 project number: 24-21

12/2024



THIS DRAWING DOES NOT SHOW ALL HIDDEN OR CONCEALED PIPING, DUCTS, PLUMBING AND EQUIPMENT TO BE REMOVED. CONTRACTOR SHALL VISIT THE SITE AND MAKE THEIR OWN EVALUATION AND ESTIMATE OF THE EXTENT AND MAGNITUDE OF THE WORK INVOLVED PRIOR TO SUBMITTING

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www.aja.design I info@aja.design I 905.920.5121


HAMILTON- WENTWORTH DISTRICT SCHOOL BOARD P02085 - FRANKLIN RD **ELEMENTARY SCHOOL** RENOVATIONS. 500 FRANKLIN ROAD HAMILTON, ONTARIO

PLUMBING SYSTEMS -**DEMOLITION PLAN**

12/2024

drawn: MH AS SHOWN project number: 24-21 KS

M1-01

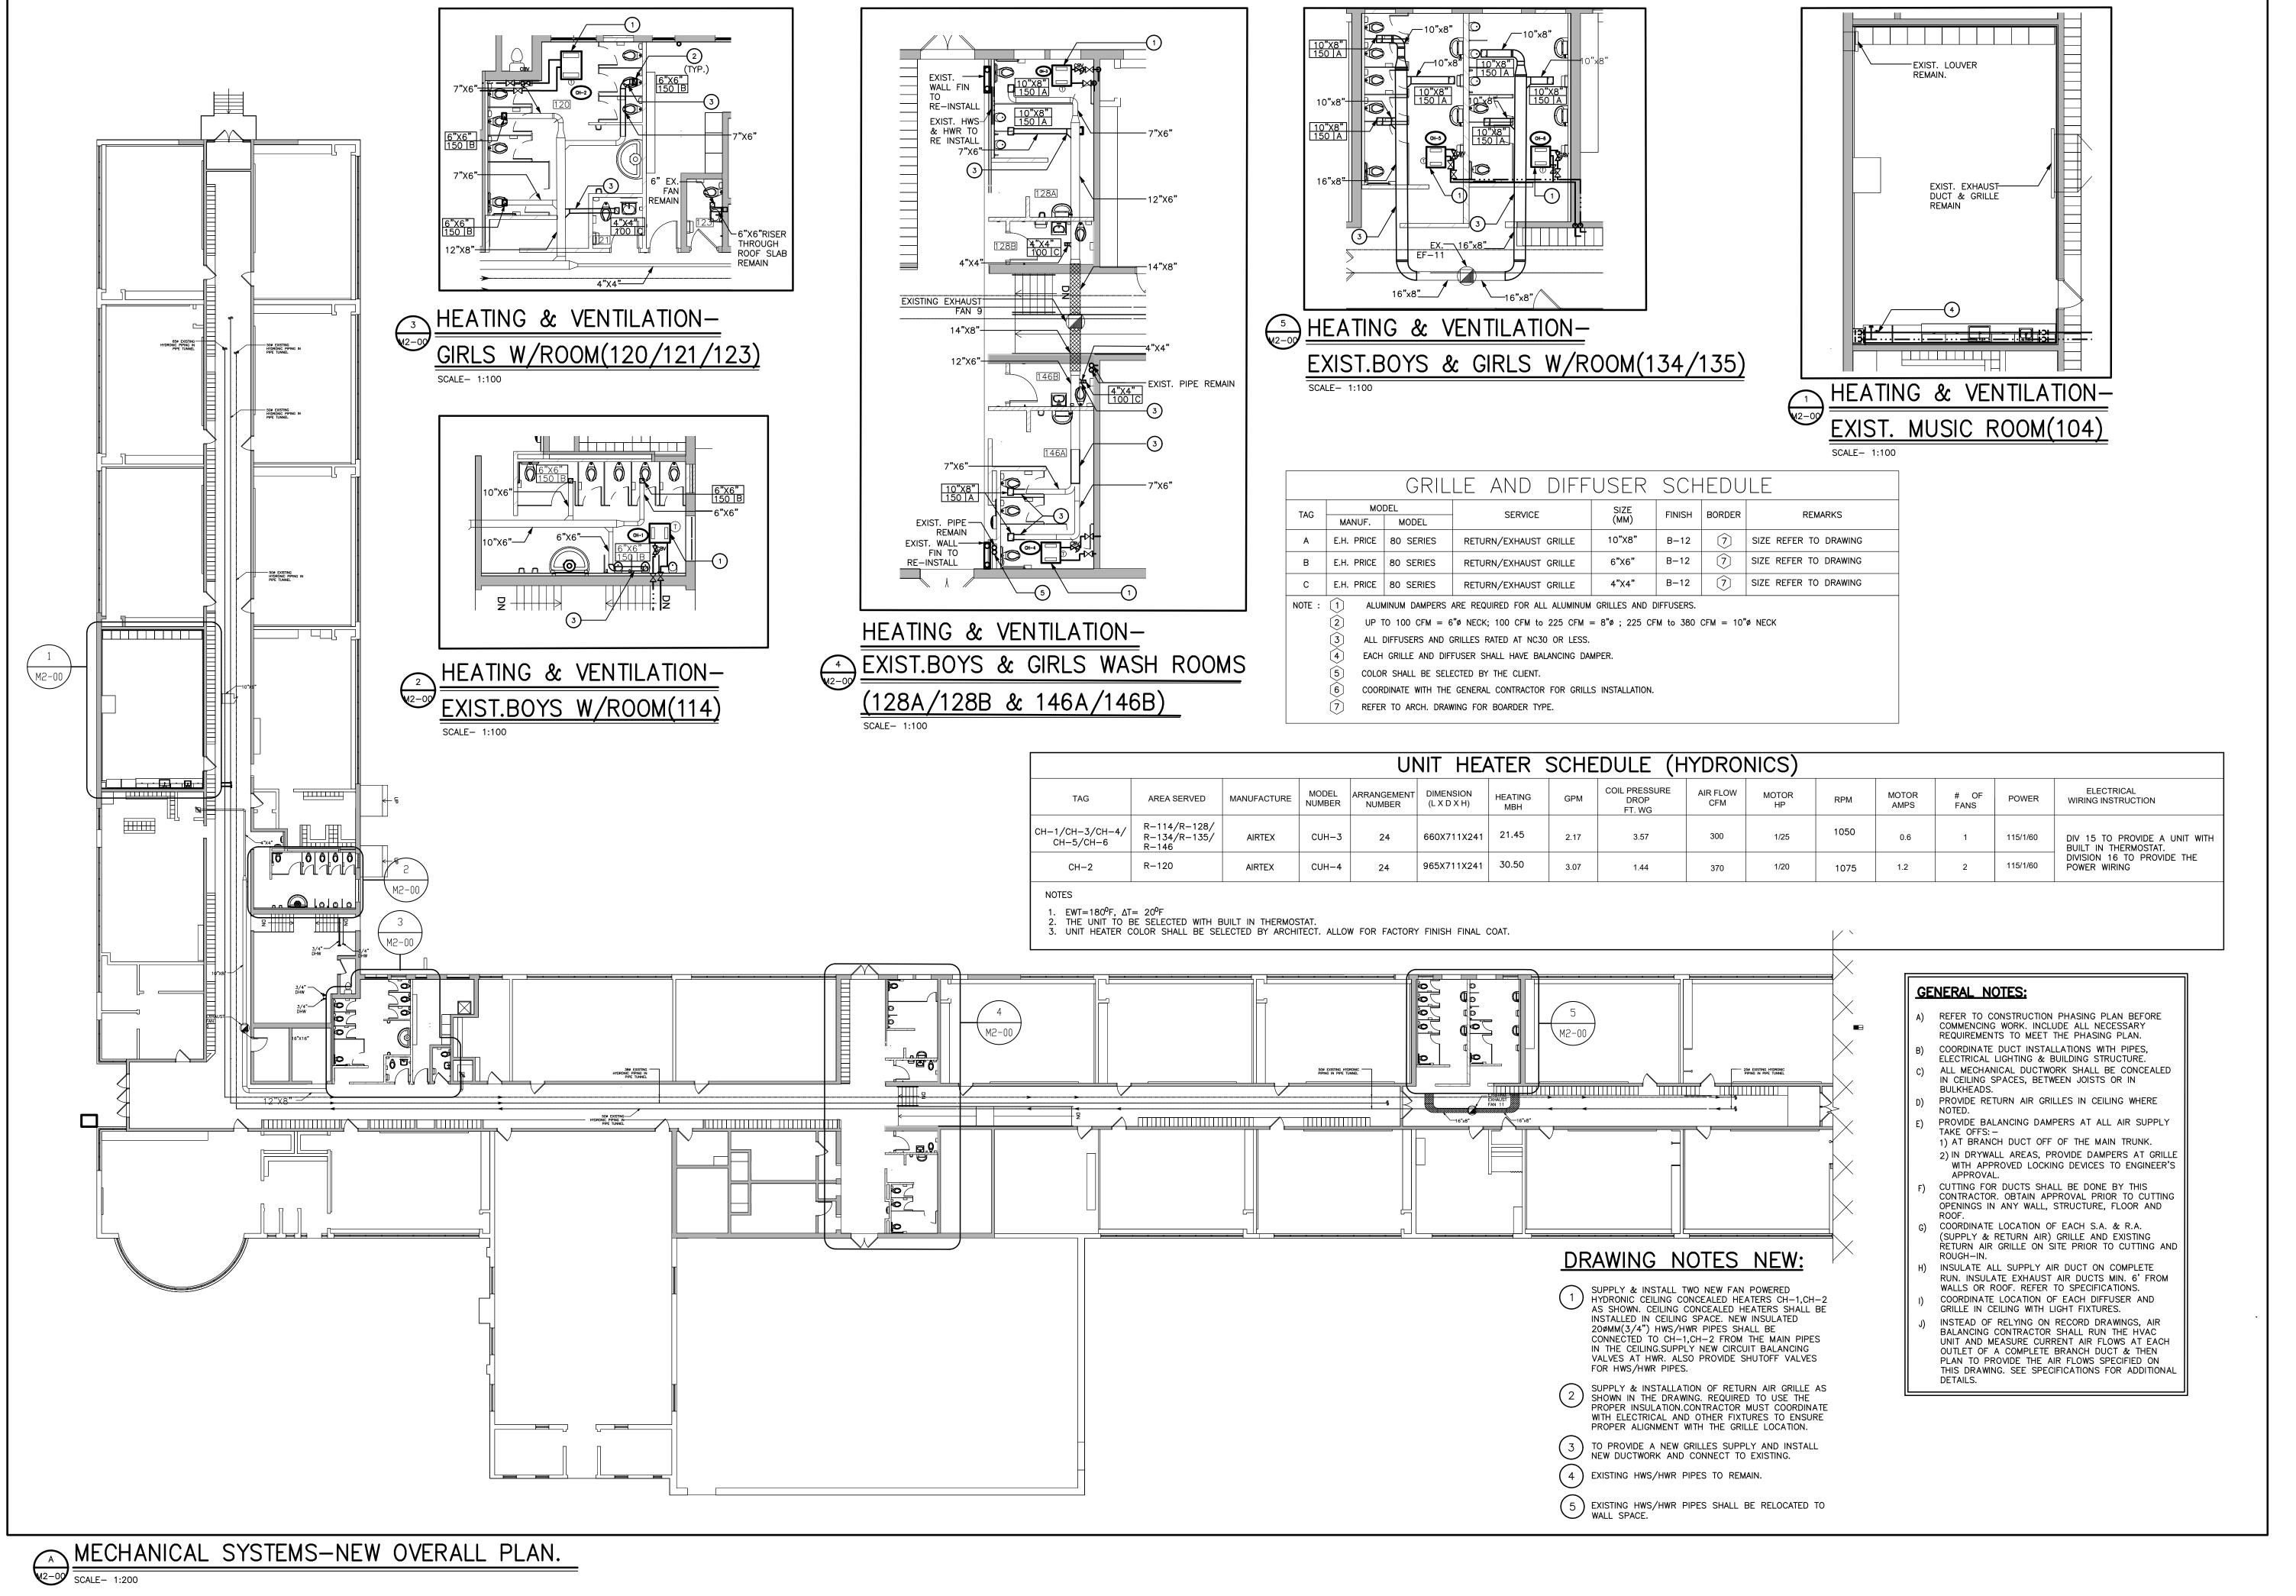

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B 85% PROGRESS 2024-11-27

A 30% PROGRESS SUBMISSION 2024-11-01

No. DESCRIPTION

24076

E&M
Consulting Engineers Inc.
6004 Osprey Blvd,
Mississauga, ON, LSN 8K1
Canada
www.eandm.consultingeng.com

HWDSB

AMRA J

ARCHITECTS INC.

www.aja.design I info@aja.design I 905.920.5121

Project title:
HAMILTON- WENTWORTH
DISTRICT SCHOOL BOARD
P02085 - FRANKLIN RD
ELEMENTARY SCHOOL
RENOVATIONS.
500 FRANKLIN ROAD
HAMILTON, ONTARIO.

drawing title:

MECHANICAL SYSTEMS
NEW OVERALL PLAN.


drawn:
MH
date:

project number:
24-21

Checked:
KS

DRAWING NO:
KS

checked: KS
date: M2-00

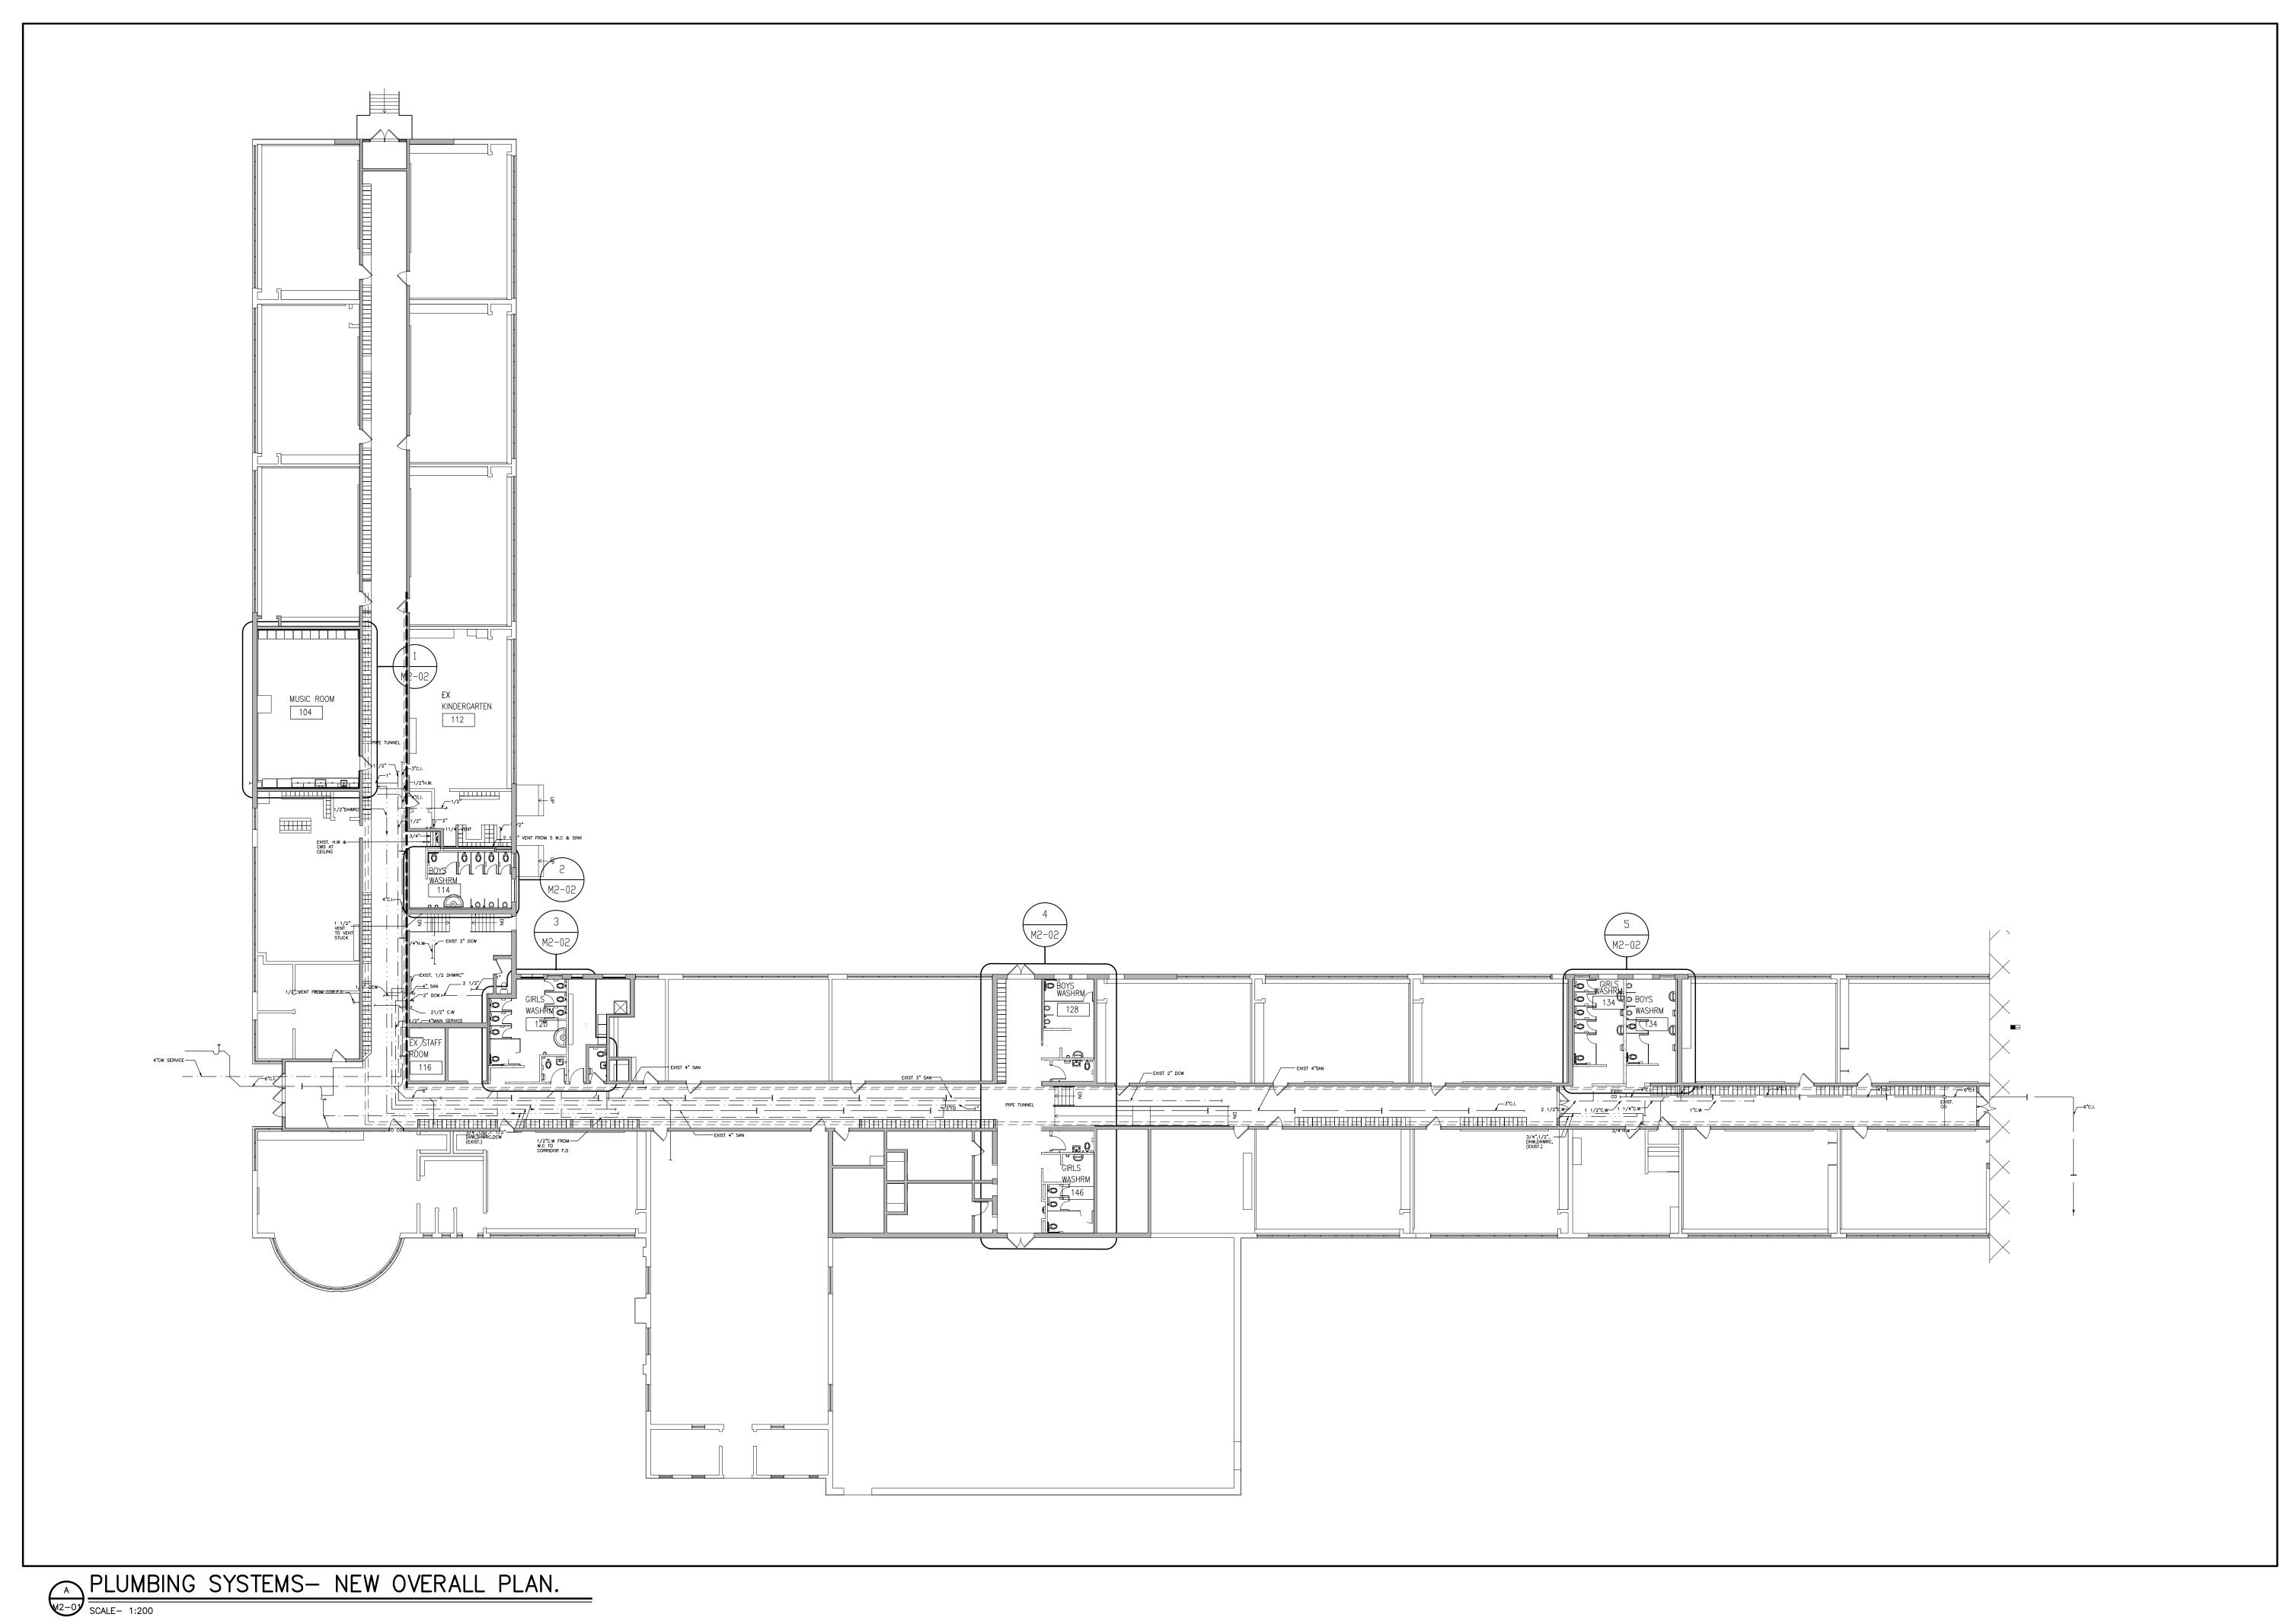

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No. DESCRIPTION DATE

REVISIONS

Seal **E&M Consulting Engineers In**

E&M

Consulting Engineers Inc.
6004 Osprey Blvd,
Mississauge, ON, LSN 8K1
Canada
www.eandmconsultingeng.com

AMRA J ARCHITECTS INC. www.aja.design I info@aja.design I 905.920.5121

project title:
HAMILTON- WENTWORTH
DISTRICT SCHOOL BOARD
P02085 - FRANKLIN RD
ELEMENTARY SCHOOL
RENOVATIONS.
500 FRANKLIN ROAD
HAMILTON, ONTARIO.

drawing title:
PLUMBING SYSTEMS NEW OVERALL PLAN.


drawn: scale:
MH AS SHOWN

project number:


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SS

12/2024


M2-01 C

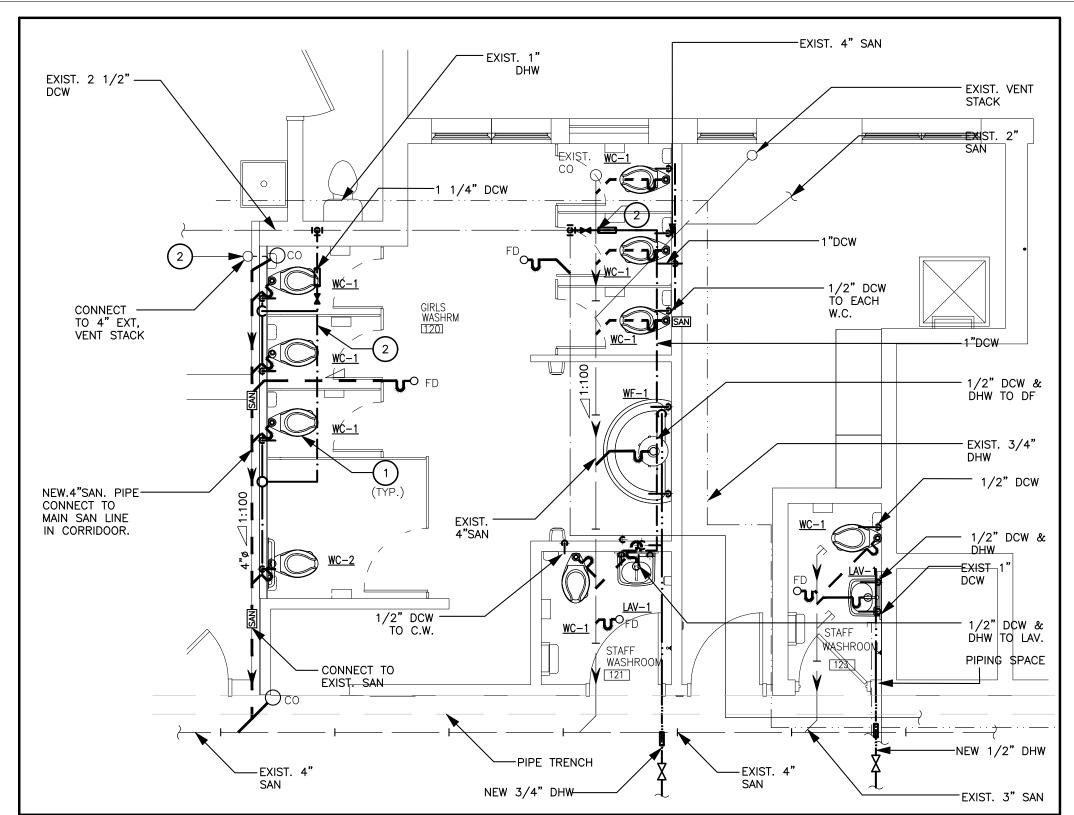


3 PLUMBING & DRAINAGE-GIRLS W/ROOM(120/121/123)

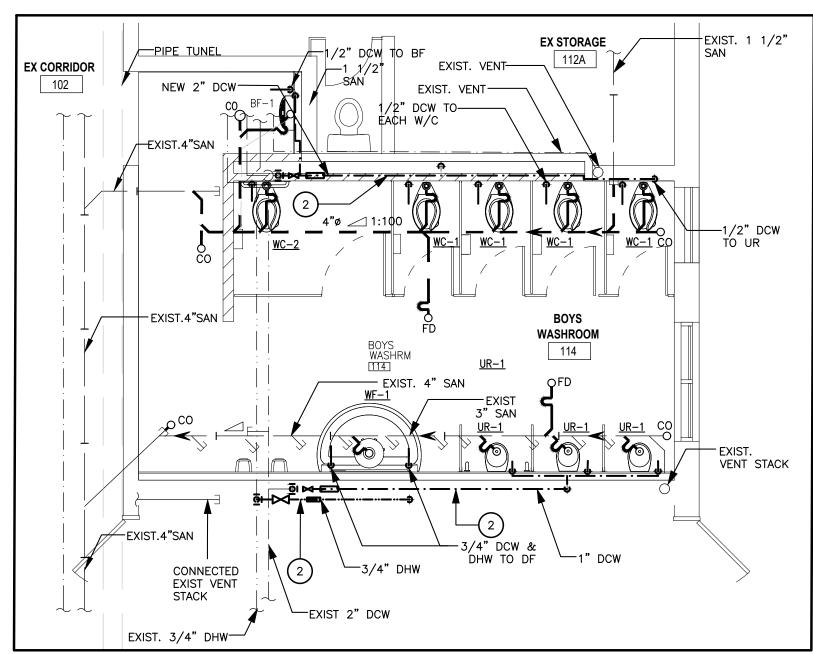

PLUMBING & DRAINAGE-BOYS W/ROOM(114)

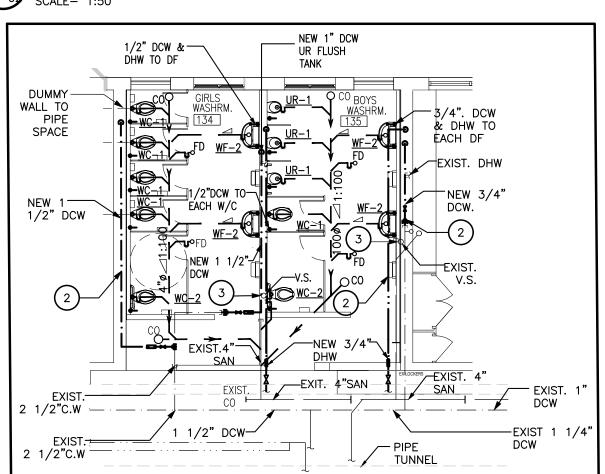

PLUMBING & DRAINAGE-BOYS & GIRLS W/ROOM (134/135)

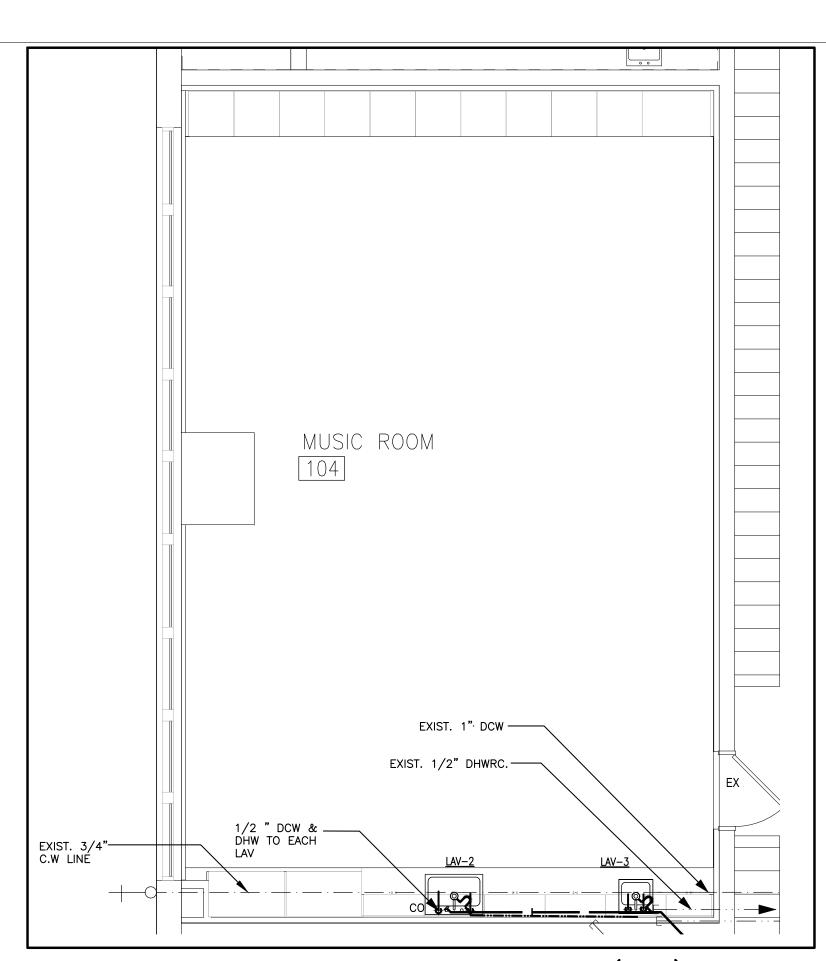

PLUMBING & DRAINAGE-MUSIC ROOM(104) M2-03 SCALE- 1:50


SYMBOL	FIVE DE RECORDE	MANUFA OT UDED		ı	NECTION SIZE	
	FIXTURE DESCRIPTION	MANUFACTURER	DCW	DHW	SANITARY	VENT
	WATER CLOSET	AMERICAN STANDARD MADERA™ FIOWise® 15" HEIGHT ELONGATED WITH EVERCLEAN® PRESSURE—ASSISTED 6L TOILET 3451.001 ELONGATED 15" (381MM) BOWL ONLY,TOP SPUD WITH 2 BOLT CAPS.	1 " ø	-	3 " ø	1 1/4"
WC-1	FLUSH VALVE	DELTA MODEL 81T201 FLUSH VALVE FOR 1-1/2" TOP SPUD WATER CLOSET MAXIMUM 292MM(11-1/2") FROM CENTERLINE OF VALVE INLET TO TOP OF WATER CLOSET,1"FIP/COPPER SWEAT INLET ADAPTOR FOR ANGLE CHECK STOP WITJ PROTECTING CAP ADJUSTABLE 121MM ±11MM INLET/VALVE OUTLET CENTERS, C/W COVER TUBE AND SS WALL FLANGE.	1 " ø	-	_	ı
	WATERCLOSET SEAT	HEAVY DUTY SOLID PLASTIC SEAT CENTOCO #500STSCC (HEAVY-DUTY, OPEN FRONT, LESS COVER FOR ELONGATED BOWL.)	_	-	_	1
WC-2	BARRIER FREE WATER CLOSET	AMERICAN STANDARD MADERA™ FIoWise® 15" HEIGHT ELONGATED WITH EVERCLEAN® PRESSURE—ASSISTED 6L TOILET 3451.001ELONGATED 17" (431.8MM) BOWL ONLY,TOP SPUD WITH 2 BOLT CAPS.	1 " ø	-	3 " ø	1 1/4"
	FLUSH VALVE	DELTA MODEL 81T201 FLUSH VALVE FOR 1-1/2" TOP SPUD WATER CLOSET MAXIMUM 292MM(11-1/2") FROM CENTERLINE OF VALVE INLET TO TOP OF WATER CLOSET,1"FIP/COPPER SWEAT INLET ADAPTOR FOR ANGLE CHECK STOP WITJ PROTECTING CAP ADJUSTABLE 121MM ±11MM INLET/VALVE OUTLET CENTERS, C/W COVER TUBE AND SS WALL FLANGE.	1"ø	-	-	-
	WATERCLOSET SEAT	HEAVY DUTY SOLID PLASTIC SEAT CENTOCO #500STSCC (HEAVY-DUTY, OPEN FRONT, LESS COVER FOR ELONGATED BOWL.)	_	-	-	ı
	LAVATORY	_	_	1 1/2*ø	1 1/4"	
	FAUCET	DELTA MIXING METERING HANDWASH FAUCET MODEL No. 86T1153	1/2 " ø	1/2"ø	-	-
LAV-1	DRAIN AND P-TRAP	'OS&B' 19HOLE GRID p.o BODY ASSEMBLY 17 GAUGE TAILPIECE DRAIN, ZURN SEMI-CAST P-TRAPS WITH WALL BEND PRODUCT NUMBER Z8700-PC CHROME-PLATED CAST BRASS (COPPER ALLOY) BODY P-TRAP WITH CLEANOUT	-	-	1 1/4 " ø	1
	THERMOSTATIC MIXING VALVE	HAWS MODEL No. 9201H OR EQUIVALENT	-	_	-	-
	LAVATORY	'KINDRED' TOP MOUNT/DROP IN STAINLESS STEEL LAVATORY MODEL No. QSLA2031-8-1, FAUCET HOLES ON 203MM (8") CENTERS.	_	_	1 1/4"ø	1 1/4"9
	FAUCET	CHICAGO MANUAL SINK FAUCET MODEL No. 431-ABCP c/w ACCESSORIES.	1/2"ø	1/2 " ø	-	-
LAV-2	DRAIN AND P-TRAP	'OS&B' 19HOLE GRID p.o BODY ASSEMBLY 17 GAUGE TAILPIECE DRAIN, ZURN SEMI-CAST P-TRAPS WITH WALL BEND PRODUCT NUMBER Z8700-PC CHROME-PLATED CAST BRASS (COPPER ALLOY) BODY P-TRAP WITH CLEANOUT	_	-	1 1/4 " ø	_
	THERMOSTATIC MIXING VALVE	HAWS MODEL No. 9201H OR EQUIVALENT	_	1	ı	ı
	LAVATORY	'KINDRED' TOP MOUNT/DROP IN STAINLESS STEEL LAVATORY MODEL No. QSL2020/10, FAUCET ONE HOLE ON CENTER.	_	-	1 1/4"ø	1 1/4"
	FAUCET	CHICAGO MANUAL SINK FAUCET MODEL No. 434-ABCP c/w ACCESSORIES.	1/2 " ø	1/2 " ø	-	-
LAV-3	DRAIN AND P-TRAP	'OS&B' 19HOLE GRID p.o BODY ASSEMBLY 17 GAUGE TAILPIECE DRAIN, ZURN SEMI-CAST P-TRAPS WITH WALL BEND PRODUCT NUMBER Z8700-PC CHROME-PLATED CAST BRASS (COPPER ALLOY) BODY P-TRAP WITH CLEANOUT	_	ı	1 1/4"ø	-
	THERMOSTATIC MIXING VALVE	HAWS MODEL No. 9201H OR EQUIVALENT	_	ı	_	_
	URINAL	'AMERICAN STANDARD' WASHBROOK® FloWise® UNIVERSAL URINAL WITH EVERCLEAN 6590.001 TOP SPUD	3/4 " ø	-	2"0ø	1 1/2"
UR-1	FLUSH VALVE	SLOAN MODEL 186-0.5 FLUSHOMETER EXPOSED URINAL FLUSHOMETER FOR 34° TOP SPUD URINALS.	3/4"ø	-	-	_
	ACCESSORIES	DRAIN, P-TRAP, ALL ACCESSORIES AND WALL MOUNTING BRACKET.		ı	1 1/4"ø	_
BF-1	BOTTLE FILLER	MURDOCK® BF16 SERIES SURFACE MOUNT SENSOR OPERATED NON-REFRIGERATED BOTTLE FILLER,1.0GPM FILL RATE, 100-MESH INLET STRAINER, 120VAC/9VDC PLUG-IN TRANSFORMER.	_	1/2*ø	1 1/4 " ø	_
WF-1	WASHING FOUNTAIN	BRADLEY TERREON® QUADRA—FOUNT® WASHFOUNTAINS MF2944, ONTARIO BUILDING CODE HEIGHT, INFRARED, NAVIGATOR® THERMOSTATIC MIXING ASSEMBLY (HOT & COLD SUPPLIES). 120VAC/12VDC PLUG IN ADAPTER, PLUGS INTO A STANDARD GFCI PROTECTED ELECTRICAL OUTLET.	1/2"ø	1/2 " ø	1 1/2 " ø	1 1/4"
WF-2	WASHING FOUNTAIN	BRADLEY BRADMATE™ WASHFOUNTAINS S93-574, ONTARIO BUILDING CODE HEIGHT, INFRARED, NAVIGATOR® THERMOSTATIC MIXING ASSEMBLY (HOT & COLD SUPPLIES). 120VAC/12VDC PLUG IN ADAPTER, PLUGS INTO A STANDARD GFCI PROTECTED ELECTRICAL OUTLET.	1/2"ø	1/2 " ø	1 1/2"ø	1 1/4"
FD	FLOOR DRAIN	WATTS FD-100-C-A 125mm NICKEL BRONZE STRAINER	_	-	3 " ø	_
2. II 3. P	NCLUDING THERMOSTATIC I	AL QUANTITIES HAVE NOT BEEN GIVEN ACCURATELY. 7. INCREASE VENT SIZING AS	RM TO O	BC PART D WHERE	TOTAL	

PLUMBING GENERAL NOTES:

- A) REFER TO CONSTRUCTION PHASING PLAN BEFORE COMMENCING WORK. INCLUDE ALL NECESSARY REQUIREMENTS TO MEET THE PHASING PLAN.
- B) ALL PLUMBING WORK TO CONFORM TO ONTARIO BUILDING CODE, ONTARIO WATER REGULATION ACT No. 615/64, CONSTRUCTION SAFETY ACT AND REGULATIONS OF THE CITY AND LOCAL
- C) ALL SANITARY DRAINS TO BE INSTALLED BURIED (MIN. 300mm BELOW FIN. FLOOR) AND SLOPED AS SHOWN UNLESS OTHERWISE
- D) COORDINATE PIPE INSTALLATION WITH ELECTRICAL CONDUITS, DUCT & STRUCTURAL MEMBERS. OFFSET PIPES AS REQUIRED.
- E) CONTRACTOR TO FIELD VERIFY WORKSITE CONDITIONS.
- F) PROVIDE ACCESS DOOR FOR EACH WATER VALVE INSTALLED IN CONCEALED SPACES.
- G) DO NOT INSTALL DHW & DCW PIPES IN EXPOSED EXTERIOR OR PERIMETER WALLS.
- H) SANITARY DRAINAGE AND VENT PIPES ABOVE GRADE SHALL BE CERTIFIED TO CAN/CSA-B181.2 "PVC DRAIN, WASTE, AND VENT
- DOMESTIC HOT AND COLD WATER PIPES SHALL BE TYPE "L" HARD COPPER TUBING WITH SOLDERED FITTINGS.
- J) INSULATE ALL NEW DOMESTIC WATER PIPES WITH MINIMUM 50 mm THICK INSULATION. COVER EXPOSED PIPES WITH PVC JACKETS.
- K) PRIOR TO ANY INSTALLATION SURVEY THE EXISTING SPACE AND NOTE DOWN ALL EXISTING MECHANICAL AND ELECTRICAL EQUIPMENT UNDERGROUND AND BURIED CABLES AND CONDUITS WITH THE ASSISTANCE OF A LOCATION SERVICE.

PLUMBING DRAWING NOTES

- 1) PROVIDE COMPLETE SANITARY PLUMBING FIXTURES & SERVICE PIPING AS
- 2 CONNECTED TO THE EXISTING SERVICE LINE AS SHOWN WITH REQUIRED INSULATION. PROVIDE NEW SHUTOFF VALVE IN DCE/DHW PIPE FOR NEW
- 3 CONNECTED TO THE EXISTING VENT STACK

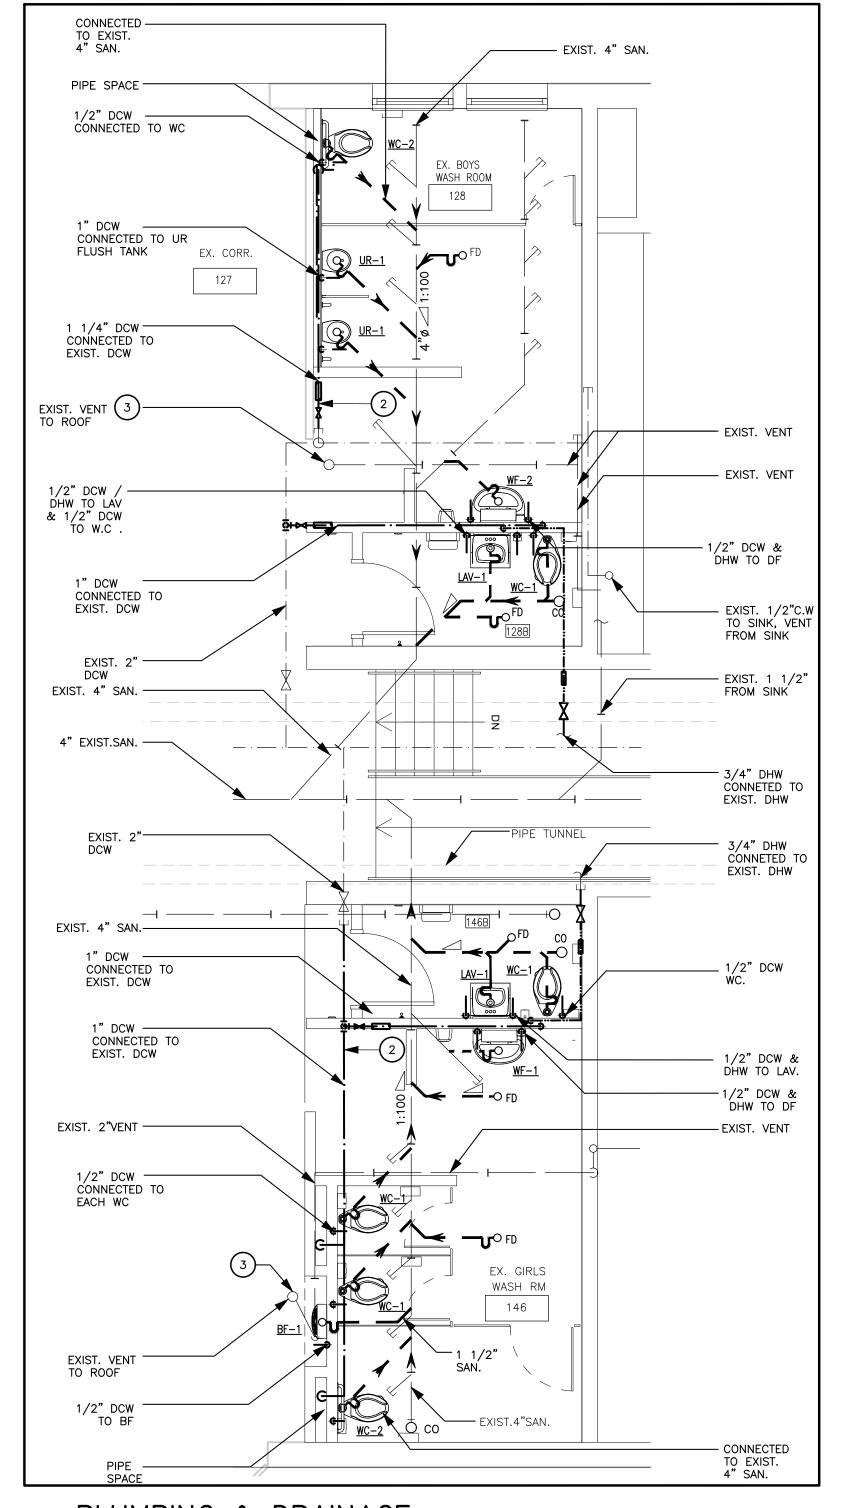

PLUMBING & DRAINAGE— BOYS & GIRLS W/ROOM (128A/128B,146A/146B) ALL DRAWINGS, SPECIFICATIONS, AND RELATED DOCUMENTS ARE THE COPYRIGHT PROPERTY OF THE ARCHITECT AND MUST BE RETURNED UPON REQUEST. REPRODUCTION OF DRAWINGS, SPECIFICATIONS, AND RELATED DOCUMENTS IN WHOLE OR IN PART IS STRICTLY FORBIDDEN WITHOUT THE ARCHITECT'S WRITTEN DEPUNSORY.

ISSUED FOR TENDER B 85% PROGRESS A 30% PROGRESS SUBMISSION 2024-11-01 No. DESCRIPTION

E&M

Consulting Engineers Inc.

6004 Osprey Blvd,
Mississauga, ON, LSN 8K1

Canada
www.eandmconsultingeng.com **HWDSB**


AMRA J www.aja.design I info@aja.design I 905.920.5121 HAMILTON- WENTWORTH DISTRICT SCHOOL BOARD P02085 - FRANKLIN RD **ELEMENTARY SCHOOL** RENOVATIONS. 500 FRANKLIN ROAD HAMILTON, ONTARIO.


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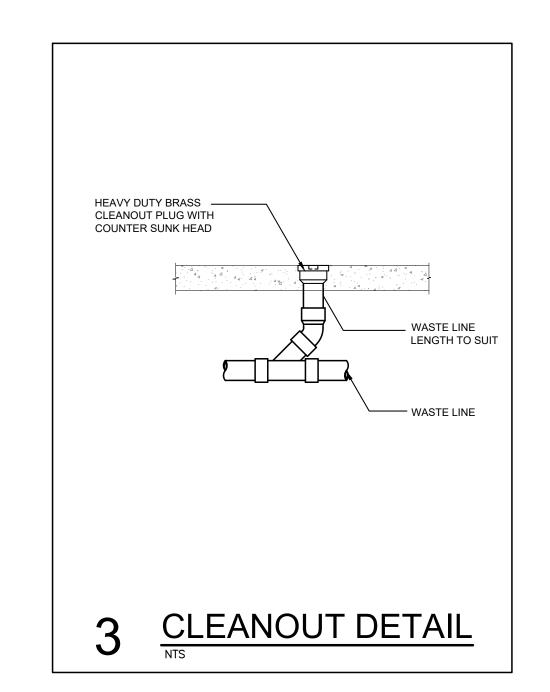
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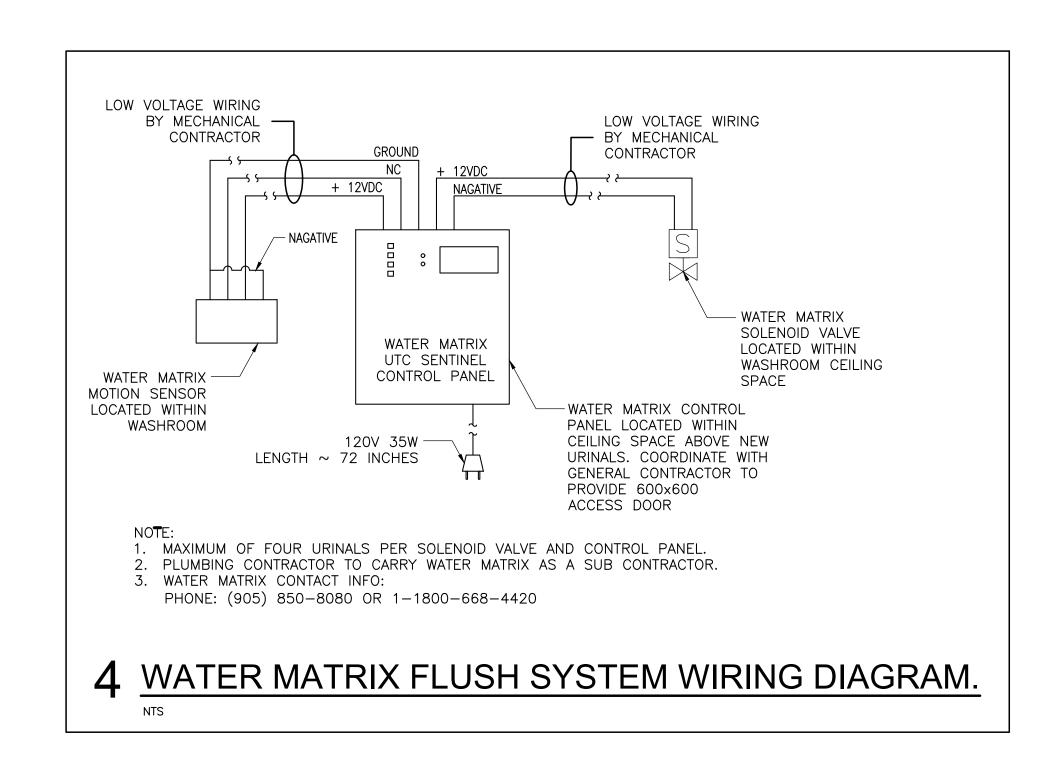
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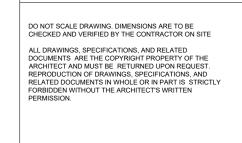
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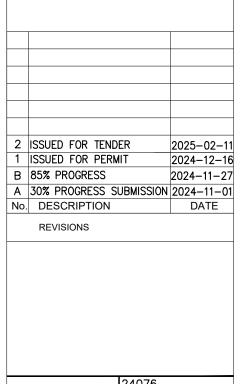









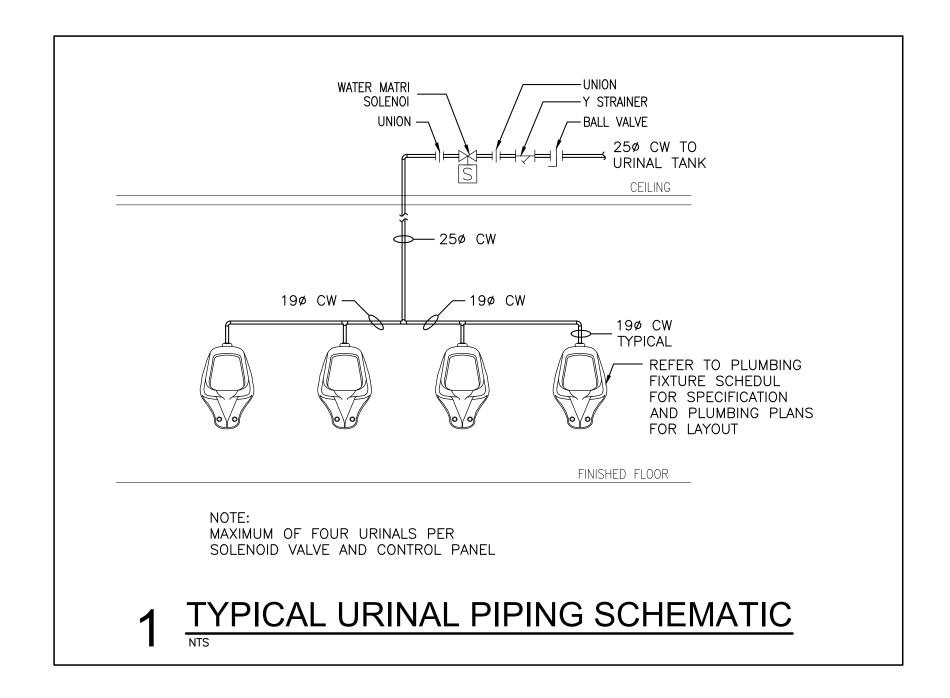

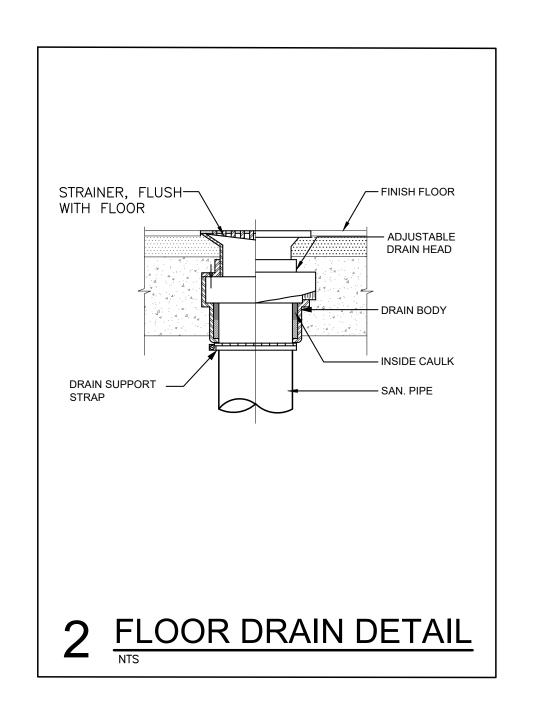

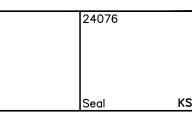





project title:
HAMILTON- WENTWORTH DISTRICT SCHOOL BOARD P02085 - FRANKLIN RD ELEMENTARY SCHOOL RENOVATIONS. 500 FRANKLIN ROAD HAMILTON, ONTARIO.

drawing title: DETAIL

drawn: MH NTS project number: 24-21

DRAWING NO: M3-00 0 12/2024

MECHANICAL SPECIFICATIONS

A GENERAL CONDITIONS

1.1 <u>GENERAL</u>

- .1 THE WORK SHALL BE DONE IN ACCORDANCE WITH THE REQUIREMENTS OF THE ONTARIO BUILDING CODE, THE ONTARIO WATER RESOURCES ACT, THE MINISTRY OF LABOUR, THE CITY OF HAMILTON AND ALL CODES HAVING JURISDICTION, WHICH ARE TO BE CONSIDERED AN INTEGRAL PART OF THESE SPECIFICATIONS. THE GENERAL CONDITIONS OF THE ARCHITECTURAL SPECIFICATIONS ARE HEREBY MADE PART OF THESE SPECIFICATIONS.
- .2 ALL LABOUR, MATERIALS, EQUIPMENT, FEES, PERMITS AND CHARGES TO PERFORM THE OPERATIONS FOR THE COMPLETE INSTALLATION OF THE PLUMBING, PIPING, VENTILATION AND HEATING WORK, AS INDICATED ON THE DRAWINGS.
- .3 VISIT THE JOB SITE AND EXAMINE ALL EXISTING CONDITIONS WHICH AFFECT THE WORK.
- .4 PAY FOR AND OBTAIN ALL REQUIRED PERMITS, FEES. LICENCES, CERTIFICATES OF INSPECTION, ETC. PROVIDE AND SUBMIT REQUIRED DRAWINGS TO THE AUTHORITIES HAVING JURISDICTION. ALL WORK SHALL BE IN ACCORDANCE WITH LAWS AND OF THE AUTHORITIES HAVING JURISDICTION. PROVIDE THE EQUIPMENT WITH APPLICABLE CGA,
- .5 CONFORM TO THE ONTARIO BUILDING CODE, CSA STANDARDS, MINISTRY OF ENVIRONMENT (MOE), LOCAL BY-LAWS AND AUTHORITIES HAVING JURISDICTION.
- .6 CO-ORDINATE WITH OTHER TRADES REGARDING THE LOCATIONS OF EQUIPMENT, CONTROL DEVICES, LOCATIONS, DISTRIBUTION SYSTEM, ETC.
- .7 SCHEDULE WORKING HOURS WITH THE OWNER.
- .8 THE CONTRACTOR IS TO LOCATE THE EXACT DIMENSIONS AND POSITIONS OF OPENINGS AND HOLES WHERE CUTTING MAY BE REQUIRED IN FLOORS, ROOFS, CEILINGS AND/OR WALLS FOR THE PASSAGE OF PIPES, DUCTS, ETC. WHERE CUTTING, PATCHING IS NECESSARY, IT SHALL BE DONE BY THE MECHANICAL.
- .9 CONNECTIONS INTO EXISTING SYSTEMS TO BE MADE AT TIME APPROVED BY OWNER. REQUEST WRITTEN APPROVAL OF TIME WHEN CONNECTIONS CAN BE MADE. BE RESPONSIBLE FOR DAMAGE TO EXISTING PLANT BY THIS WORK.
- .10 CLEAN INTERIOR AND EXTERIOR OF ALL SYSTEMS. VACUUM INTERIOR OF DUCTWORK AND AIR HANDLING UNITS. IN PREPARATION FOR FINAL ACCEPTANCE CLEAN AND REFURBISH ALL EQUIPMENT AND LEAVE IN OPERATING CONDITION INCLUDING REPLACEMENTS OF ALL FILTERS IN ALL SYSTEMS.
- .11 FOR ALL CONCEALED VALVES AND VOLUME DAMPERS, PROVIDE ACCESS DOORS AND ARRANGE THESE DOORS TO BE INSTALLED BY THE RESPECTIVE TRADES SUCH AS
- MAINTENANCE INSTRUCTIONS FROM THE MANUFACTURER .12 PROVIDE MANUFACTURER RECOMMENDED SPACE FOR SERVICING, DISASSEMBLY AND
- .13 PROVIDE SCHEDULE 40 PIPE SLEEVES AT POINTS WHERE PIPES PASS THROUGH MASONRY, CONCRETE OR FIRE RATED ASSEMBLIES. SLEEVE SIZES: MINIMUM 6 MM CLEARANCE ALL AROUND, BETWEEN SLEEVE AND UNINSULATED PIPEOR BETWEEN SLEEVES AND PIPE IN FOUNDATION WALLS AND BELOW GRADE FLOORS WITH WATERPROOF FIRE RETARDANT NON-HARDENING MASTIC. WHERE SLEEVES PASS THROUGH WALLS OR FLOORS. PROVIDE SPACE FOR FIRE STOPPING. WHERE PIPES/DUCTS PASS THROUGH FIRE RATED WALLS, FLOORS AND PARTITIONS, MAINTAIN

REMOVAL OF EQUIPMENT AND COMPONENTS. PIPE EQUIPMENT DRAINS TO NEAREST

- .14 SUPPLY TOOLS, EQUIPMENT AND PERSONNEL TO DEMONSTRATE AND INSTRUCT OPERATING AND MAINTENANCE PERSONNEL IN OPERATING, CONTROLLING, ADJUSTING, TROUBLE-SHOOTING AND SERVICING OF ALL SYSTEMS AND EQUIPMENT DURING REGULAR WORK HOURS, PRIOR TO ACCEPTANCE.
- .15 GUARANTEE IN WRITING FOR THE MATERIAL AND WORKMANSHIP INCLUDING THE MANUFACTURER'S GUARANTEE FOR THE PERIOD OF ONE (1) YEAR FROM THE DATE OF ACCEPTANCE.
- .16 CERTIFY IN WRITING FOR ALL WORK COMPLETED IN ACCORDANCE WITH THE SPECIFICATIONS AND DRAWINGS. SUBMIT AS-BUILT DRAWINGS WHERE REVISIONS
- .17 WHERE THESE STANDARDS ARE SUPERCEDED BY PUBLISHED LOCAL MUNICIPAL STANDARDS AND DESIGN CRITERIA, THE MUNICIPAL STANDARDS SHALL APPLY. THESE STANDARDS APPLY TO ALL PHASES OF THE WORK.
- 1.2 DESCRIPTION OF WORK
- SELECTIVE DEMOLITION WORK.
- RENOVATION OF WASHROOM PLUMBING SYSTEMS. RENOVATION OF WASHROOM AND MUSIC ROOM HVAC SYSTEMS. 4. OTHER MISCELLANEOUS WORK AS SHOWN ON DRAWING.
- 1.3 <u>SHOP DRAWINGS</u>
- SUBMIT SHOP DRAWINGS FOR THE FOLLOWING: 1 HVAC EQUIPMENT INCLUDING HEATERS.
- .2 AIR GRILLE .3 PLUMBING FIXTURES DESIGNATED.
- 1.4.1 STANDARDS OF MATERIAL AND EQUIPMENT

MATERIAL AND EQUIPMENT ARE SPECIFICALLY DESCRIBED AND NAMED IN THIS SPECIFICATION AS EITHER BASE BID, BASE BID ALTERNATES AND ACCEPTABLE PRODUCTS.

- .2 WHERE THE TERM "ACCEPTABLE PRODUCTS" IS USED, THE BID MAY BE BASED ON ANY OF THE ACCEPTABLE PRODUCTS.
- .3 WHERE THE "BASE BID" SPECIFICATION IS USED, THE BID MUST BE BASED ON THE SPECIFIED EQUIPMENT. THE "ALTERNATE PRODUCTS" SHALL BE LISTED ON THE SUPPLEMENTARY TENDER FORM WITH THE COST SAVING (IF ANY), AND THE OWNER SHALL HAVE THE FINAL OPTION OF ACCEPTING OR REJECTING ALTERNATE EQUIPMENT.
- .4 IF THIS DIVISION STATES THE USE OF "ALTERNATE PRODUCTS", THE BIDDER SHALL HAVE MADE ALLOWANCE IN HIS SAVINGS FOR ANY STRUCTURAL OR ELECTRICAL CHANGES NECESSARY, AND SAID CHANGES SHALL BE AT THE EXPENSE OF THIS DIVISION.

1.5 <u>INTERRUPTION OF EXISTING SERVICES</u>

- ALL INTERRUPTIONS OF EXISTING MECHANICAL SYSTEMS MUST BE APPROVED BY AND CO-ORDINATED WITH THE OWNER.
- .2 DISRUPTION OF NORMAL OPERATIONS WILL NOT BE ALLOWED. ALL INTERRUPTIONS SHALL OCCUR AFTER THE CLOSE OF NORMAL HOURS. PREMIUM TIME TO BE INCLUDED IN THE TENDER PRICE.

1.6 <u>SLEEVES, CUTTING, PATCHING AND FIRE STOPPING</u>

- .1 INSTALL SLEEVES AND FRAMES FOR PIPING AND SIMILAR EQUIPMENT TO BE BUILT INTO THE BUILDING AS THE CONSTRUCTION PROGRESSES. IF THESE ARE NOT INSTALLED AT THE TIME OF CONSTRUCTION, THE COST OF CUTTING AND PATCHING AT A LATER DATE, WILL BE AT THE EXPENSE OF THIS CONTRACTOR.
- .2 THE PRIME MECHANICAL CONTRACTOR IS RESPONSIBLE FOR THE CUTTING AND PATCHING OF ALL HOLES AND OPENINGS UP TO AND INCLUDING 200 mm (8")
- .3 THE PRIME MECHANICAL CONTRACTOR IS TO LOCATE THE EXACT POSITIONS AND
- DIMENSIONS OF LARGER OPENINGS FOR CUTTING BY THE GENERAL DIVISION. .4 THE PRIME MECHANICAL CONTRACTOR IS RESPONSIBLE FOR THE SUPPLY AND INSTALLATION OF APPROVED FIRE STOPPING FOR ALL NEW MECHANICAL PENETRATIONS THROUGH BOTH EXISTING AND NEW FIRE SEPARATIONS. VERIFY ALL FIRE SEPARATIONS WITH THE ARCHITECTURAL DRAWINGS. FIRE STOPPING IS TO BE RATED TO MATCH AND MAINTAIN THE INTEGRITY OF THE RATED ASSEMBLY.
- 1.7 <u>RECORD DRAWINGS AND EQUIPMENT MANUALS</u>
- .1 AS THE PROJECT PROGRESSES, RECORD, ON A SET OF WHITE PRINTS, ALL ADDENDA, CHANGES TO AND DEVIATIONS FROM THE PLANS MADE DURING THE CONSTRUCTION PERIOD. ALSO, RECORD THE LOCATION OF ALL DIFFUSERS, GRILLES AND OTHER MECHANICAL EQUIPMENT.
- .2 MAKE THESE PROGRESS RECORD DRAWING WHITE PRINTS AVAILABLE TO THE CONSULTANTS FOR THEIR REVIEW AT ALL TIMES DURING THE CONSTRUCTION PERIOD.
- .3 AT THE CONCLUSION OF THE PROJECT, TRANSFER ALL RECORD DRAWING INFORMATION ONTO AUTOCAD RELEASE 2010 OR LATER TO A UNIVERSAL SERIAL BUS STICK (USB).
- .4 THE CONSULTANT SHALL PROVIDE TO THE CONTRACTOR A USB CONTAINING GRAPHIC (ELECTRONIC) REPRESENTATION OF THE DRAWINGS. A RELEASE FORM "TRANSFER OF ÒF FILES ON ELECTRONIC MEDIA" WILL BE PROVIDED BY THE CONSULTANT TO THE CONTRACTOR FOR SIGNING IN ORDER TO RECEIVE AND USE THE ELECTRONIC FILES
- .5 BEFORE SUBSTANTIAL PERFORMANCE OF THE CONTRACT, COMPLY WITH THE FOLLOWING: .1 PROVIDE CD CONTAINING ALL UPDATED RECORD DRAWING INFORMATION AS SPECIFIED
- .2 PROVIDE TWO (2) SETS OF EQUIPMENT DATA SHEETS AND/OR MANUFACTURER'S MAINTENANCE MANUALS COVERING EACH SYSTEM AND ITS COMPONENTS IN ACCORDANCE WITH REQUIREMENTS OF EACH APPROPRIATE SECTION. THE BINDER IS TO BE DIVIDED INTO SECTIONS WITH TABS CLEARLY MARKED INDICATING THE SYSTEMS, ETC.

B. <u>BALANCING IDENTIFICATION AND START-UP</u>

- OBTAIN EXISTING RECORD DRAWINGS FROM THE OWNER FOR INFORMATION BEYOND THIS PROJECT AND USE IT FOR AIR AND WATER BALANCING AS REQUIRED.
- IDENTIFICATION IS TO BE CARRIED OUT BY THE RESPECTIVE TRADE WITH NAME TAGS IDENTIFYING THE USE OR SERVICE OF ALL NEW MAIN VALVES AND NEW EQUIPMENT.
- CLEAN ALL NEW EQUIPMENT AND OTHER INSTALLATIONS.
- PROVIDE MAINTENANCE INSTRUCTIONS IN ACCORDANCE WITH MANUFACTURER'S RECOMMENDATIONS
- SUBMIT TWO (2) COPIES OF MANUFACTURER'S MAINTENANCE MANUALS TO OWNER FOR ALL NEW EQUIPMENT.
- PROVIDE TWO BOUND COPIES OF THE AIR BALANCING REPORT TO OWNER.
- AIR BALANCING SHALL BE DONE BY PROFESSIONAL TESTING AND BALANCING FIRM. AIR QUANTITIES OF EACH OUTLET SHALL BE AS INDICATED ON THE DRAWINGS. THE AIR BALANCING REPORT SHALL SHOW THE QUANTITIES, VELOCITIES, AND AREA OF EACH OUTLET, TYPE AND MODEL NUMBER OF FANS AND MOTORS INSTALLED, ACTUAL AIR DELIVERED BY THE FAN WITH TOTAL STATIC PRESSURE AND VOLTAGE DRAWN BY THE MOTORS. ADJUST AND RETEST THE SYSTEMS TO THE SATISFACTION OF THE PROJECT CO-ORDINATOR. PROVIDE AN ADDITIONAL COPY OF THE AIR BALANCING REPORT TO THE MECHANICAL CONSULATANT.
- APPLICATION TOLERANCES: HVAC SYSTEMS: PLUS 5%, MINUS 5%
- AIR SYSTEMS: TO TAB STANDARDS OF AABC.
- THE HVAC CONTRACTOR SHALL CO-OPERATE WITH TAB AGENCY. PROVIDE REQUIRED PERSONNEL ATTENDANCE AND AT NO ADDITIONAL COST, CHANGE OR ADJUST THE SHEAVES, MOTOR AND BELTS IF NECESSARY TO ACHIEVE THE SPECIFIED AIR VOLUME.
- SUBMIT THREE (3) COPIES OF TAB REPORT WITH SCHEMATICS FOR ENGINEERS

C <u>VENTILATION</u>

- .1 <u>VENTILATION MATERIALS</u>
- ALL MATERIALS AND EQUIPMENT SHALL BE NEW AND FREE FROM DEFECTS, CSA APPROVED.
- ALL DUCTWORK SHALL BE FABRICATED TO SMACNA DUCT MANUAL STANDARDS, SECTION NO. 1, AND AS FOLLOWS
- .3 <u>MATERIAL AND THICKNESS</u>

DUCTWORK SHALL BE FABRICATED FROM BEST QUALITY LOCK-FORMING GALVANIZED STEEL SHEETS AS MANUFACTURED BY STELCO OR DOFASCO OF THE FOLLOWING THICKNESS:

SIZE OF DUCT	GAUGE OF SHEET STEEL
300 OR LESS IN WIDTH OR DEPTH OF UP TO 200 DIAMETER	NO.26 US
325 TO 750 IN WIDTH OR DEPTH OF 225 TO 550 DIAMETER	NO.24 US
750 TO 1350 IN WIDTH OR DEPTH	NO.22 US

.4 <u>CONSTRUCTION</u>

LONGITUDINAL SEAMS SHALL BE MADE WITH PITTSBURGH LOCK OR BUTTON PUNCH SEAMS IN ALL SIZES. ALL DUCTWORK SHALL BE CROSS BROKEN OR BEADED 12" O.C. FOR RIGIDITY.

DUCTS SHALL HAVE PLAIN "S" SLIPS ON THE LONG SIDES, AND DRIVE CLEATS ON THE SHORT SIDES, FOLDED OVER TO PREVENT AIR LEAKAGE. MINIMUM END JOINT SPACING IS 3000mm ALL BENDS OR ELBOWS SHALL BE MADE WITH A RADIUS OF NOT LESS THAN 1-1/2 TIMES THE WIDTH OF THE DUCT. WHERE IT IS NOT POSSIBLE, TURNING VANES SHALL BE USED. VANES SHALL BE OF SINGLE VANE CONSTRUCTION WITH SPACE UP TO 600 WIDTH AND 80mm SPACING OVER 600

DUCTWORK SHALL HAVE SUBSTANTIAL HANGERS ATTACHED TO STRUCTURE WITH CONCRETE INSERTS TO SECURE THE DUCTS IN PLACE AND PREVENT VIBRATION, NO CADD CLIPS OR PLUMBERS TAPE PERMITTED FOR HANGING

HORIZONTAL DUCTWORK UP TO 725 WIDE SHALL BE SUPPORTED BY GALVANIZED 25mm 16 GAUGE OR HEAVIER HANGERS PLACED NOT OVER 1800mm APART. WITH ENDS TURNED UNDER THE DUCT. SECURE TO DUCT WITH SHEET METAL SCREWS, TWO (2) PER SIDE, AND ONE (1) IN BOTTOM. HORIZONTAL DUCTWORK OVER 750 mm WIDE SHALL

REST ON GALVANIZED ANGLE IRON SUPPORTS OR UNISTRUT CHANNELS, WITH ROD HANGERS AT 1800mm SPACING AS FOLLOWS:

DUCT SIZE <u>ROD</u> 750 TO 1225 6mm 40mm X 40mm X 3mm

.6 <u>DUCT SEALING</u> ALL JOINTS DURING MANUFACTURE OF LOW VELOCITY DUCTWORK SHALL BE SEALED WITH 3-M, HIGH VELOCITY SEALER, TOUGH BOND OR DURO DYNE S-2H.V. SEALER ON THE FACES OF THE JOINTS AND AFTER CLEATS HAVE BEEN INSTALLED.

.7 <u>BALANCING DAMPERS</u>

PROVIDE BALANCING DAMPERS IN DUCTWORK WHERE SHOWN AND WHERE REQUIRED FOR PROPER ADJUSTMENT OF AIR QUANTITIES. OPEN AND CLOSED POSITIONS MUST BE CLEARLY MARKED.

- .1 SPLITTER DAMPERS: SHALL BE AIRFOIL SHAPE DOUBLE THICKNESS ON GAUGE HEAVIER THAN DUCT WITH LOCKING QUADRANT ON EXTERIOR OF DUCT.
- .2 SINGLE BLADE ROUND BUTTERFLY U.S. 22 GA THICK WITH LOCKING QUADRANT.
- .3 MULTI-LEAF OPPOSED BLADE DAMPERS DESIGNED TO SMACNA DETAILS WITH LOCKING QUADRANT.

.8 <u>DUCT INSULATION</u>

COMPONENTS OF INSULATION SYSTEM TO HAVE MAXIMUM FLAME SPREAD RATING OF 25 AND MAXIMUM SMOKE DEVELOPED RATING OF 50 IN ACCORDANCE WITH CAN/ULC-S102 MATERIALS TO BE TESTED IN ACCORDANCE WITH ASTM C411.

PROVIDE CAN/CGSB-51.10. RIGID MINERAL FIBRE BOARD: CGSB 51-GP-52MA VAPOUR BARRIER. JACKET AND FACING MATERIAL INSULATION ON RECTANGULAR DUCTING LARGER THAN 300x150 SIZE FOR SUPPLY AIR DUCTING, FROM FAN TO SUPPLY GRILLE. THICKNESS: ONE 25 MM LAYER ON SUPPLY AIR DUCTS. INSTALL IN ACCORDANCE WITH ANSI/NFPA 90A AND ANSI/NFPA 90B.

PROVIDE 25mm THICKNESS MINERAL FIBRE BLANKET WITH RRFRK FACING TO CAN/ CGSB-51.11 ON ROUND AND RECTANGULAR SUPPLY AIR DUCTWORK UP TO 300x150 SIZE.

INDOOR EXPOSED: ULC LISTED PLAIN WEAVE COTTON FABRIC OUTDOOR: GLASSFAB MEMBRANE FINISHED WITH TWO (2) COATS BAKELITE #110-14.

ALL SUPPLY AIR DUCTWORK INCLUDING DUCTS IN CEILING RETURN AIR PLENUMS. DO NOT INSULATE: RETURN AIR DUCTS, ACOUSTICALLY LINED DUCTS

D <u>PIPE AND FITTINGS - PRODUCTS</u>

- 1.1 PLUMBING & DRAINAGE
- .1 <u>PIPE MATERIALS</u>
- .1 SOIL, VENT AND RAINWATER LEADERS NOT BURIED 3" (80 MM) AND LARGER: .1 CLASS 4000 CAST IRON SHALL BE CERTIFIED TO CSA B70 - MECHANICAL JOINT.
- .2 DRAINAGE VENTS AND WASTES 2-1/2" (65 MM) AND SMALLER: .1 CLASS 4000 CAST IRON SHALL BE CERTIFIED TO CAN/CSA B70-M91 - MECHANICAL JOINT. 2 DRAINAGE COPPER PIPE DWV SHALL COMPLY WITH ASTM B306 — SOLDER JOINTS.
- .3 SCHEDULE 40 GALVANIZED STEEL THREADED JOINTS. .3 ALL BURIED DRAINAGE PIPING WITHIN BUILDING;
- .1 CLASS 4000 CAST IRON SHALL BE CERTIFIED TO CAN/CSA B70-M91 MECHANICAL JOINT. .2 DWV PLASTIC PIPE ABS AND SOLVENT WELD, 4" (100 MM) AND SMALLER.

1.2 STEEL PIPE AND FITTINGS .1 SERVICE: HOT WATER HEATING.

.2 PIPING: CONTINUOUS WELDED SCHEDULE 40 ASTM-A120 FOR SCREWED PIPING AND MECHANICAL JOINTS AND ASTM-A53 FOR WELDING.

.3 PVC SDR. 6" (150 MM) AND LARGER.

- .1 15 MM TO 65 MM CLASS 150 MI THREADED UNIONS, CLASS
- 150 DART PATTERN MI THREADED BRASS TO IRON GROUND SEAT.
- .1 ALL INSULATED VALVES SHALL HAVE EXTENDED NECKS OR SHAFTS WHERE THE THICKNESS OF THE INSULATION INTERFERES WITH THE OPERATING HANDLE.
- .1 15 MM TO 50 MM CLASS 150 STANDARD PORT BRONZE BODY BRONZE FITTED SCREWED ENDS PTFE SEATS AND PACKING, LEVER HANDLE.
- ACCEPTABLE PRODUCTS: 1 CRANE 9202
- JENKINS 201J .3 NEWMAN-HATTERSLEY 1969
- .4 VICTAULIC 726 .5 MILWAUKEE BA-200
- .3 CHECK:
- .1 15 MM TO 65 MM CLASS 125 BRONZE BODY, SCREWED ENDS, SWING DISC, SCREW-ON CAP.
 - ACCEPTABLE PRODUCTS: .1 CRANE 37/1707
 - 2 JENKINS 4092 MILWAUKEE 509
- .4 NEWMAN-HATTERSLEY A60
- .4 STRAINERS: .1 15 mm TO 50 mm CAST IRON 'Y' BODY PATTERN, SCREWED ENDS AND CAP WITH BRASS PLUG, STAINLESS STEEL SCREEN WITH 0.125 PERFORATIONS FOR WATER SERVICE. ACCEPTABLE PRODUCTS:

.1 SARCC

- 1.3 <u>COPPER PIPE AND FITTINGS</u> .1 SERVICE: ALL DOMESTIC WATER PIPING
- .2 PIPING: PLAIN END TYPE "L" HARD DRAWN COPPER.
- .3 FITTINGS: SOLDER END WROUGHT COPPER.
- .4 JOINTS: ALL DOMESTIC HOT AND COLD POTABLE WATER PIPING SHALL BE JOINED USING 95/5 SOLDER CONTAINING NO LEAD COMPOUNDS (95% TIN/5% ANTIMONY). NON-POTABLE WATER PIPING SHALL BE JOINED USING A STANDARD 50/50 TIN/LEAD COMPOUND SOLDER.
- .5 VALVES: .1 BALL: 15 MM TO 65 MM FULL PORT BRASS OR BRONZE BODY,
- BRONZE FITTED SOLDER ENDS, PTFE SEATS AND PACKING, LEVER HANDLE. .2 ACCEPTABLE PRODUCTS:
- 1 CRANE F9222 JENKINS 902
- APOLLO 77FLF-200 .4 NIBCO 585-80-LF

E <u>PIPES AND FITTINGS - EXECUTION</u>

1.1 PIPING INSTALLATION

- .1 PROVIDE ALL NECESSARY PIPING INCLUDING FITTINGS AND UNIONS TO COMPLETE SYSTEMS SHOWN. CUT PIPES TRUE AND SQUARE, REAM FILE ENDS TO SMOOTH SURFACE, ALL TO PIPE MANUFACTURER'S AND ACCEPTED TRADE STANDARDS. FITTINGS SHALL BE OF EQUIVALENT BORE AS PIPE, OF EQUAL STRENGTH AND WEIGHT, INSTALL PIPING TO MANUFACTURER'S SPECIFICATIONS AND PUBLISHED DIRECTIONS. INSTALL PIPING TO CONFORM TO ONTARIO BUILDING CODE (CHAPTER 7).
- .2 INSTALL ABOVE GROUND PIPING TO CLEAR OTHER PIPING, INSULATION, OBSTRUCTIONS, ACCESS DOORS AND CONTROLS. TAKE BRANCHES OFF MAINS WITH FITTINGS AND 45° AND 90 'ELBOWS. LOCATE VALVES FOR EACH OPERATION. LOCATE CLEANOUTS IN ACCESSIBLE LOCATIONS TO APPROVAL AND TO SUIT ACCESS.
- .3 DO NOT USE FERROUS PIPING, FITTINGS, BUSHINGS, NIPPLES OR PLUGS IN COPPER PIPING. PROVIDE DIELECTRIC BUSHINGS AT CONNECTIONS TO FERROUS MATERIALS OR
- EQUIPMENT ON WATER SYSTEMS. .4 SUPPLY AND INSTALL FLANGES, UNIONS OR COMPRESSION FITTINGS ON EQUIPMENT SIDE OF SHUT-OFF VALVES IN PIPING CONNECTIONS TO EQUIPMENT, TANKS AND FIXTURES SO SAME CAN BE DISCONNECTED FOR SERVICE. FLANGES AND UNIONS SHALL BE OF SAME MATERIAL AS PIPING
- .5 CO-ORDINATE ROUTING OF PIPING WITH OTHER TRADES. PROVIDE INTERFERENCE DRAWINGS AS REQUIRED.
- .6 REFER TO MANUFACTURER'S INSTALLATION DRAWINGS.
- .7 INSTALL SYSTEMS SO THAT THEY CAN BE THOROUGHLY DRAINED AND ALL AIR ELIMINATED.
- .8 DURING WELDING OR SOLDERING PROCEDURES, PROVIDE A FIRE RETARDANT CLOTH, MAT OR BLANKET TO PROTECT THE STRUCTURE, AND ADEQUATE FIRE PROTECTION EQUIPMENT AT ALL LOCATIONS WHERE WORK IS BEING DONE.
- .9 PLUG AND/OR CAP ALL PIPE OPENINGS/FITTINGS DURING CONSTRUCTION.
- .10 CAST IRON PIPE TO HAVE ANTHES RUBBER GASKET MECHANICAL JOINTS, PC4 COLD CAULKING COMPOUND HUB AND SPIGOT JOINTS, CAULKED LEAD JOINTS WITH OAKUM AND SOFT PIG LEAD, OR BIBBY BISEAL. CONFINED SPACES TO BE MECHANICAL JOINTS.
- .11 THREADED PIPE JOINTS TO BE TRUE AND ROUND WITH FULL CUT THREADS, ENDS REAMED AND FILED WITH ALL BURRS REMOVED IRON TO IRON WITH A FILLER OF GRAPHITE AND OIL.

.12 SOLDER JOINTS SHALL BE CAREFULLY CLEANED WITH EMERY CLOTH. USE "SILFOS"

SILVER SOLDER FOR BURIED PIPING. SEE SECTION 15700 FOR TYPE OF SOLDER TO BE USE ON VARIOUS PIPING SYSTEMS. .13 MAKE JOINTS IN COPPER PIPING WITH 95/5 TIN/ANTIMONY SOLDER WITH NON-CORROSIVE

SOLDERING FLUX. CLEAN, REAM AND THOROUGHLY TIN EACH JOINT AND REMOVE EXCESS

- .14 GRADING: UNLESS OTHERWISE NOTED, DRAINAGE AND WASTE SHALL GRADE DOWN IN THE DIRECTION OF FLOW, AS FOLLOWS: .1 UP TO AND INCLUDING 3" (80 MM): 1/4" IN 1 FOOT (1:50).
- .2 4" (100 MM) AND LARGER: 1/8" IN 1 FOOT (1:100). .15 GRADE VENT PIPING UP FROM FIXTURES SO IT IS SELF DRAINING.
- .16 IN ADDITION TO TESTS REQUIRED BY LOCAL AUTHORITIES, TEST PIPING AND DRAINS IN THE PRESENCE OF CONSULTANT AS HEREINAFTER DESCRIBED.
- .17 NOTIFY THE CONSTRUCTION MANAGER IN WRITING AT LEAST FORTY-EIGHT (48) HOURS PRIOR TO START OF TESTS. FAILURE TO DO SO MAY REQUIRE TEST TO BE RE-DONE.
- .18 PERFORM TESTS BEFORE APPLICATION OF PIPE INSULATION AND COVERING. TEST BURIED AND CONCEALED PIPING BEFORE BACKFILLING OR CONCEALING IN STRUCTURE. PROTECT EQUIPMENT AND PARTS NOT CAPABLE OF WITHSTANDING TEST PRESSURE DURING TESTS. MAKE LEAKS TIGHT WHILE SYSTEMS ARE STILL UNDER TEST. IF THIS IS IMPOSSIBLE, REMOVE AND RE-FIT DEFECTIVE PARTS. CAULKING OF THREADED JOINTS OR WELDS WILL NOT BE PERMITTED.
- .19 AFTER LEAKS HAVE BEEN REPAIRED, REPEAT TESTS AS OFTEN AS NECESSARY, AND TO ENSURE TIGHTNESS OF EACH SYSTEM.
- .20 INSTALL PIPING TO ALLOW FOR EXPANSION AND CONTRACTION COMPLETE WITH SWING JOINTS, EXPANSION LOOPS, AND ANCHORS AS NECESSARY. SILVER SOLDER EACH JOINT IN EXPANSION LOOPS WHERE USED.
- .21 PRESSURE TEST HOT WATER HEATING PIPING WITH 150 PSI (1034 KPA) FOR NOT LESS THAN FOUR (4) HOURS WITHOUT DECREASE IN PRESSURE.


- .1 ALL HORIZONTAL PIPING SHALL BE SUPPORTED AT LEAST EVERY 10'-0" (3000 MM), EXCEPT FOR PIPE 1-1/4" (32 MM) AND SMALLER WHERE 8'-0" (2400 MM) SPACING IS REQUIRED. PIPE HANGERS FOR COPPER PIPING SHALL BE ADJUSTABLE CLEVIS TYPE ANVIL FIG. 260 COMPLETE WITH INSULATION SHIELD SIMILAR TO ANVIL FIG. 168. HANGER RO SHALL BE STEEL WITH COPPER NUT. CLEVIS HANGERS TO BE OUTSIDE PIPE INSULATION. BETWEEN THE SHIFLD AND THE PIPE. INSTALL A SECTION OF HIGH DENSITY INSULATION FOLIA TO FOAMED GLASS (3.75 TO 5.0 LB DENSITY MATERIAL) COMPLETE WITH CONTINUOUS VAPOUR BARRIER. EXTEND HIGHER DENSITY INSULATION 2" (50 MM) BEYOND SHIELD. PIPE HANGERS AND SUPPORTS SHALL BE SECURED TO BEAMS, STEEL JOISTS, WALLS, FLOORS, ETC. DO
- .2 ALL HANGERS AND RODS SHALL BE OF A SIZE AND WEIGHT TO SAFELY SUPPORT THE
- .3 ALL HANGER RODS SHALL BE RUST RESISTANT GALVANIZED DIPPED.
- .4 ACCEPTABLE PRODUCTS: ANVIL, MYATT, TAYLOR

NOT SUPPORT FROM METAL DECK.

- 1.3 <u>PIPING INSULATION</u> .1 INSULATION SHALL CONFORM TO ASHRAE STANDARD 90.1 (LATEST EDITION)
- .2 ALL NEW PIPING AND FITTINGS SHALL BE INSULATED WITH INORGANIC GLASS FIBRES, BONDED WITH A THERMOSETTING RESIN COMPLETE WITH SELF SEALING LAP, "ASJ" ALL SERVICE JACKET AND 3" (80 MM) WIDE "ASJ" BUTT STRIPS.

.3 DOMESTIC COLD AND HOT WATER PIPING INSULATION THICKNESS TO BE 1/2" (15 MM) FOR

- PIPE SIZES 1/2" TO 3" (13 MM TO 80 MM), COMPLETE WITH VAPOUR BARRIER, USING INSULATION K FACTOR .24 AT 75°F (24°C). .4 HOT WATER HEATING PIPING INSULATION THICKNESS TO BE 1" (25 MM) FOR PIPE SIZES 1/2" TO 3" (13 MM TO 80 MM), 1 1/2" (40 MM) THICK FOR PIPES SIZES 4"
- (100 MM) AND LARGER COMPLETE WITH VAPOUR BARRIER, USING INSULATION K FACTOR .24 AT 75°F (24°C). .5 ACCEPTABLE PRODUCTS: KNAUF, MANVILLE SCHULLER INTERNATIONAL, MANSON
- .6 ALL INSULATION SHALL BE APPLIED OVER A CLEAN, DRY SURFACE, AFTER ALL PRESSURE TESTING HAS BEEN CARRIED OUT AND REVIEWED BY THE CONSULTANT.
- .7 INSTALL INSULATION SHIELDS SUPPLIED BY MECHANICAL DIVISION. .8 THE INSULATION JOINTS SHALL BE BUTTED TIGHTLY. ADHERE THE VAPOUR BARRIER JACKET LAP WITH VAPOUR BARRIER ADHESIVE AND ADHERE THE 3" (80 MM) WIDE BUTT JOINT STRIPS OVER ALL END JOINTS WITH ADHESIVE TO ENSURE CONTINUOUS VAPOUR BARRIER. INSULATE ALL FITTINGS UP TO 2" (50 MM) WITH MITRE-CUT PIECES OF INSULATION AND PRESSURE-SENSITIVE, COLOUR-MATCHING TAPE. ALL EXPOSED FITTINGS 2" (50 MM) AND LARGER SHALL HAVE PRE-MOLDED "PVC" INSULATING FITTINGS COVERS.
- .9 ALL EXPOSED INSULATED PIPING AND FITTINGS SHALL BE FINISHED WITH A FIRE RETARDANT PVC JACKET. .10 NO ADDITIONAL FINISH NEED BE APPLIED TO CONCEALED PIPING.

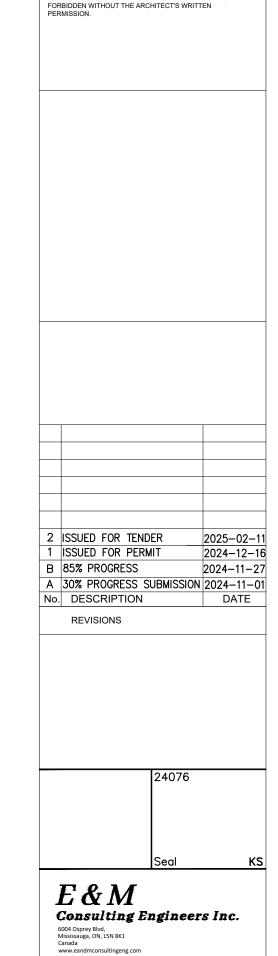

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HAMILTON- WENTWORTH

DISTRICT SCHOOL BOARD

MH AS SHOWN 24-21 DRAWING NO: KS 12/2024

				L	ELECTRICAL LEGEND					
POWER &	DISTRIBUTION SYSTEMS	<u>KITCHEN</u> ,	/LAUNDRY APPLICANCES	FIRE ALA	RM SYSTEM	LIGHTING		MISCE	LLANEOUS A	BBREVIATIONS/SUBSCRIPTS/SYMBOLS
W		(D)	15A, 120V-1ø DUPLEX RECEPTACLE FOR DISHWASHER, LOCATED AS PER ARCHITECTURAL DRAWINGS.		MANUAL PULL STATION C/W PROTECTIVE 9VDC BATTERY OPERATED LEXAN COVER.	\$	LIGHT SWITCH		A	MOUNTING HEIGHT FOR DEVICES ABOVE COUNTER/SINK MILLWORK TO BE 1020mm
\$	UTILITY DISCONNECT.	F	15A, 120V-1ø DUPLEX RECEPTACLE FOR FRIDGE, LOCATED AS PER ARCHITECTURAL DRAWINGS.	⊘ ⊘ X	HEAT DETECTOR. COMBINATION, FIXED 57°C AND RATE OF RISE. SUBSCRIPT 'X' INDICATES 88°C FIXED TEMPERATURE.		SUBSCRIPTS: 2 — DOUBLE POLE (DPST). 3 — THREE WAY.			FROM TOP OF DEVICE TO A.F.F. (UNLESS NOTED OTHERWISE).
Q	DELTA STAR POWER TRANSFORMER.	U/F	15A, 120V-1ø DUPLEX RECEPTACLE FOR UNDER-COUNTER FRIDGE, LOCATED AS PER ARCHITECTURAL DRAWINGS.	⊗ ⊗ X	HEAT DETECTOR. FIXED ONLY (57°C) SUBSCRIPT 'X' INDICATES 88°C RATING.		4 — FOUR WAY. D — DIMMER. K — KEY OPERATED.		1-3 E1-3	 TYPICAL NORMAL POWER CIRCUIT NUMBER EG. PANELBOARD LP-1 CIRCUIT NUMBER 3. TYPICAL ESSENTIAL POWER CIRCUIT NUMBER
	CIRCUIT BREAKER.	(H)	15A, 120V-1ø DUPLEX RECEPTACLE FOR KITCHEN HOOD, LOCATED AS PER ARCHITECTURAL DRAWINGS.	₽ ₽ R	SMOKE DETECTOR. IONIZATION TYPE. SUBSCRIPT "R" INDICATES RELAY BASE.		P — PILOT. S — SPEED SWITCH. LV — LOW VOLTAGE		1A-3	EG. PANELBOARD LPE-1 CIRCUIT NUMBER 3. - TYPICAL CONTROL PANEL CIRCUIT NUMBER
		(x)	30A. 120V/208V-1ø(14-30R) RECEPTACLE FOR DRYER.	\bigcirc	120V LOCAL SMOKE ALARM CEILING MOUNTED. IONIZATION TYPE.		2LVD — MULTI—ZONE/MULTI—BUTTON LOW VOLTAGE DIMMING SWITCH. NUMBER REPRESENTS NUMBER OF BUTTONS TO BE PROVIDED PLUS DIMMER.		3P+N	EG. PANELBOARD LP-1A CIRCUIT NUMBER 3. - 3 POLE & UNSWITCHED NEUTRAL.
*	CIRCUIT BREAKER. (DRAW OUT TYPE).	W	LOCATED AS PER ARCHITECTURAL DRAWINGS. 15A, 120V-1ø DUPLEX RECEPTACLE FOR WASHER,	×	120V LOCAL SMOKE ALARM WITH STROBE.	#	MULTIPLE SWITCH INSTALLATION UNDER COMMON PLATE.	S U B	AFF	ABOVE FINISHED FLOOR.ABOVE COUNTER
	CIRCUIT BREAKER. (DRAW OUT TYPE) WITH MICROPROCESSOR		LOCATED AS PER ARCHITECTURAL DRAWINGS. 15A, 120V-1ø DUPLEX RECEPTACLE FOR WASHER, AND 30A,	\otimes	CARBON MONOXIDE.	\$	LOW VOLTAGE COMBINATION SWITCH AND OCCUPANCY SENSOR.	S C R	В	- BENCH MOUNTED.
	BASED TRIP UNIT.	W/D	120/280V-1ø(14-30R) RECEPTACLE FOR DRYER. LOCATED AS PER ARCHITECTURAL DRAWINGS.	×	COMBINATION SMOKE/CARBON MONOXIDE/STROBE.	A B	LIGHTING FIXTURES. LETTER WITHIN INDICATES TYPE.	P T	CL	CEILING SPACE MOUNTED.CONTROLLED LOAD.
1/	FUOED DIGGONNEGT	S	50A, 120V/208V-1ø(14-50R) RECEPTACLE FOR STOVE, LOCATED AS PER ARCHITECTURAL DRAWINGS.	€	AIR DUCT TYPE SMOKE DETECTOR.		CROSS HATCHING INDICATES WIRED TO EMERGENCY CIRCUIT.		D/I EXP/E	 WITH DISCONNECT AND VISIBLE ISOLATION. P = EXPLOSION PROOF.
\$	FUSED DISCONNECT.	M	20A, 120V-1Ø DUPLEX RECEPTACLE FOR MICROWAVE, LOCATED AS PER ARCHITECTURAL DRAWINGS.	R	REMOTE INDICATING LIGHT. SUBSCRIPT INDICATES FAN SYSTEM.		SUBSCRIPT "NL" INDICATES NIGHT LIGHT.		F	- FLOOR MOUNTED.
7	NON FUSED DISCONNECT.	0	20A, 120V-1Ø DIRECT CONNECTION FOR BUILT-IN OVEN, LOCATED AS PER ARCHITECTURAL DRAWINGS.		FIRE ALARM HORN.		EXIT_SIGNS ARROWS INDICATE DIRECTION		GF IG	GROUND FAULT CIRCUIT INTERUPTER.ISOLATED GROUND TYPE.
	HI OR LOW VOLTAGE FUSE.	E	15A, 120V/208V-1Ø DUPLEX RECEPTACLE FOR EXHAUST FAN, LOCATED AS PER ARCHITECTURAL DRAWINGS.		FIRE ALARM BELL. FIRE ALARM STROBE		CEILING MOUNT, SINGLE FACE		MH NL	MOUNTING HEIGHT.NIGHT LIGHT
E-W	CUSTOMER OR UTILITY ENERGY METER.	СТ	40A, 120V/208V-1Ø DIRECT CONNECTION FOR BUILT-IN COOKTOP, LOCATED AS PER ARCHITECTURAL DRAWINGS.	FA	COMBINATION FIRE HORN/STROBE LIGHT.		CEILING MOUNT, DOUBLE FACE WALL MOUNT, SINGLE FACE		HL	- MOUNT AT 1188mm A.F.F.(TO THE BOTTOM)
			ICATION SYSTEMS	(SV)	SUPERVISED VALVE — SPRINKLER. SUBSCRIPT 'P' DENOTES STANDPIPE.	● ●	WALL MOUNT, DOUBLE FACE		S T	SURGE SUPRESSION TYPE DEVICE.LOCKING TYPE (TWISTLOCK).
<u>+</u>	ELECTRICAL GROUND.	W 1 F−2	COMBINATION DATA/TELEPHONE OUTLET.	FS	SPRINKLER FLOW SWITCH.		END WALL MOUNT, DOUBLE FACE		v	- MOUNT IN VERTICAL FACE.
3-LA	LIGHTNING, ARRESTORS(03) AND GROUND.		SECOND DIGIT (NUMBER 2.") INDICATES QUANTITY OF TELEPHONE CABLES AND TELEPHONE JACKS IN OUTLET.	PS	SPRINKLER LOW PRESSURE SWITCH.		EXIT SIGN & REMOTE HEAD COMBO		WG WP	WIREGUARD.WEATHERPROOF TYPE.
<u> </u>			FIRST DIGIT (NUMBER 1.") INDICATES QUANTITY OF DATA CABLES	(b)	MAGNETIC DOOR HOLD OPEN DEVICE.				Z	- MOUNT 42" (1065mm) A.F.F.
	PANELBOARD (SURFACE MOUNT).		AND DATA JÀCKS IN OUTLET. IF FIRST DIGIT INCLUDES A SUFFIX "F", IT INDICATES "FITLINXX" DATA CABLE AND OUTLET.		RECESSED FIRE ALARM SPEAKER (CEILING MOUNTED).		DUAL TECHNOLOGY OCCUPANCY SENSOR LV — DENOTES LOW VOLTAGE		PTZ	- PAN, TILT, ZOOM
	PANELBOARD (RECESSED MOUNT).		ALL JACKS UNDER ONE(1) COMMON PLATE. REFER TO FLOOR PLANS FOR CABLE AND JACKS QUANTITIES.	Ø	RECESSED FIRE ALARM SPEAKER AND STROBE (CEILING MOUNTED).		W - DENOTES WALL MOUNT		E	- EXISTING TO REMAIN.
	ENCLOSED BUS ASSEMBLY. CABLE TRAY (LADDER OR TROUGH)		SUBSCRIPT "W" INDICATES C/W VOICE JACK FOR WALL	HD	FIRE ALARM SPEAKER (WALL MOUNTED).		PHOTOCELL		ER RF	EXISTING TO BE RELOCATED.RELOCATED DEVICE AT NEW LOCATION
RECEPTAC	CLE/DIRECT CONNECTIONS		MOUNTED TELEPHONE AT 1500mm A.F.F. SUBSCRIPT "P" INDICATES PAY TELEPHONE.	Η®	FIRE ALARM SPEAKER AND STROBE (WALL MOUNTED).				R	- EXISTING TO BE REMOVED
Ф	120V, 2P, 3W, 15A DUPLEX RECEPTACLE (CSA #5 SERIES).			F	SURFACE FIRE ALARM SPEAKER (CEILING MOUNTED).		DAYLIGHT SENSOR		N	- EXISTING TO BE REPLACED WITH NEW
+	120V, 2P, 3W, 15A SPLIT TYPE DUPLEX RECEPTACLE.		DATA OUTLET — COMPUTER OR PRINTER. TELEPHONE — SUBSCRIPT "P" INDICATES PAY TELEPHONE.		SURFACE FIRE ALARM SPEAKER AND STROBE (CEILING MOUNTED).	\[\dot{\phi} \overline{\phi}	WALL MOUNTED EMERGENCY LIGHTS. ARROW DENOTES AIMING		SR	 MOUNTED ON SURFACE RACEWAY
₩	120V, 2P, 3W, 15/20A T-SLOT TYPE DUPLEX RECEPTACLE. CSA#5 SERIES FOR OFFICE AND GENERAL AREAS.		COMBINATION MULTI-FUNCTION COMMUNICATION OUTLET.	FH	FIREFIGHTER HANDSET.		DIRECTION.			
Φ	120V, 2P, 3W, 15A FOUR PLEX RECEPTACLE 2. DUPLEXES UNDER COMMON PLATE).	W	WIRELESS ACCESS POINT	F.A.Z.1.	FIRE ALARM ZONE DEMARCATION FIRE ALARM ZONE. NUMBER INDICATES ZONE NUMBER.		BATTERY UNIT (REFER TO LIGHTING FIXTURE SCHEDULE FOR DETAILS)		ACB	- AIR CIRCUIT BREAKER.
	120V, 2P, 3W, 15A DUPLEX RECEPTACLE WITH USB CHARGING	INTERCO	M SYSTEM			SMART BO	OARD/PROJECTOR REQUIREMENTS		ATS	- AUTOMATIC TRANSFER SWITCH.
	PORT.	4	INTERCOM MASTER STATION		AL CAR CHARGING STATION PROVIDE SINGLE GANG BOX, 20mm@C CONDUIT AND 20A,		15A, 120V, 1P, ISOLATED GROUND RECEPTACLE, 1 DATA		AV	AUDIO VISUAL.COFFEE MAKER.
Φ	120V, 2P, 3W SINGLE RECEPTACLE (CSA #5 SERIES).	$oxed{\Phi}$	INTERCOM STATION	₩	120V-1ø (5-20R) RECEPTACLE FOR 'TYPE 1' ELECTRICAL CAR CHARGE STATION. LOCATED AS SHOWN ON FLOOR PLANS.	§1)	OUTLET(COMPUTER) W/ 4 PORT COVER.		CR	- CASH REGISTER.
	250V, 2P, 3W SINGLE RECEPTACLE (CSA #6 SERIES). 125/250V, 3P, 4W SINGLE RECEPTACLE (CSA #14 SERIES).	PAGING	AND SOUND SYSTEM	€V2	PROVIDE TWO GANG BOX, 25mm@C CONDUIT AND 50A, 208V-1@ (5-60R) RECEPTACLE FOR 'TYPE 2' ELECTRICAL CAR CHARGE STATION. LOCATED AS SHOWN ON FLOOR PLANS.	\$2	15A, 120V, 1P, ISOLATED GROUND RECEPTACLE, 2 DATA OUTLET(COMPUTER) W/ 4 PORT COVER.		CS	COMMUNICATION STATION.DISTRIBUTION PANEL.
	250VDC/600VAC, 3P, 4W SINGLE RECEPTACLE (CSA #L17 SERIES).		RECESSED CEILING MOUNTED SPEAKER. COMBINATION WALL MOUNTED SPEAKER AND TALK-LISTEN	SECURIT			4"x4" RECESSED BOX W/ BLANK COVER PLATE		EVR	- ELECTRONIC VOLTAGE REGULATOR.
(4)	1 PHASE, 3W DIRECT CONNECTION (L, N, G) OR (L1, L2, G).		SPEAKER MOUNTED IN ROOM MODULAR CONTROL PANEL.	ES	ELECTRIC DOOR STRIKE.			l D	FR	- FRIDGE.
	3 PHASE, 4W DIRECT CONNECTION (L1, L2, L3, G).	1	RECESSED WALL MOUNTED SPEAKER.	SKP	SECURITY SYSTEM KEY PAD			N T	GEN HWD	ELECTRICAL GENERATOR.HOT WATER DISPENSER
0	3 PHASE, 5W DIRECT CONNECTION (L1, L2, L3, N, G).		RECESSED CEILING MOUNTED SPEAKER COMPLETE WITH HANDSFREE MIC. AND INTERCONNECTED TO WALL MOUNTED	EB	REQUEST TO EXIT BUTTON			F I	IM	- ICE MACHINE
(A)	1 PHASE, 4W DIRECT CONNECTION (L1, L2, N, G).		EMERGENCY PULLCORD ALARM DEVICE.	<u></u>	AUTOMATIC DOOR OPERATOR.			C A T	MCB MCCB	MINIATURE CIRCUIT BREAKER.MOULDED CASE CIRCUIT BREAKER.
	FLOOR FLUSH MOUNTED OUTLET BOX C/W THREE(3) 120V, 2P, 3W, 15A DUPLEX RECEPTACLE, TWO(2) DATA OUTLETS.	®	SURFACE WALL MOUNTED SPEAKER. SURFACE CEILING MOUNTED SPEAKER.	(DA)	DOOR ACTUATOR MAGNETIC DOOR LOCK.]		ON	MSB	 MOULDED CASE CIRCUIT BREAKER. MAIN SWITCH BOARD (SERVICE ENTRANCE RATED).
	FLOOR FLUSH MOUNTED OUTLET BOX C/W TWO(2) 120V, 2P,	CS CS	P.A. CALL SWITCH OR HANDSET.	(P)	LOW VOLTAGE POWER SUPPLY FOR THE DOOR STRIKE.				PC	- PHOTOCOPIER.
	3W, 15A DUPLEX RECEPTACLE		ADMINISTRATIVE CONSOLE UNIT OUTLET.	PB	PUSH BUTTON.				PF PR	- POWER FACTOR CORRECTION CAPACITOR BANKS.
	MODULAR SYSTEM FURNITURE POWER & COMMUNICATION CABLING CONNECTION POINT OUTLET BOX. SUBSCRIPT 'F' DENOTES FLUSH MOUNTED IN FLOOR.		LOCAL VOLUME CONTROLLER.	k₽ ∩	KEY PAD.				SB	PRINTER.SMARTBOARD.
	FLOOR MOUNTED STATIC GROUNDING RECEPTACLE	AMP M	MICROPHONE OUTLET	(K)	SECURITY KEYSWITCH FOR ALARM SHUT OFF CARD READER]			SP	- SPLITTER.
	I LOOK MOUNTED STATIC GROUNDING RECEPTACLE			(R)	INFRA RED AUTOMATIC DOOR OPERATOR.]			SPD TR	SURGE PROTECTION DEVICELOW VOLTAGE TRANSFORMER.
		TEI EVISIO	ON AND A.V.	• 1 [HV]					''`	- TELEVISION.
(H)	HAND DRYER	TELEVISION TV]		EGRESS MOTION DETECTOR.]			TV	
(F)	HAND DRYER THERMOSTAT.	(v)	TELEVISION OUTLET. AUDIO/VIDEO STATION		EGRESS MOTION DETECTOR. AUDIBLE ALARM (BUZZER)				TV TVSS	- TRANSIENT VOLTAGE SURGE SUPPRESSOR.
		\(\bar{\alpha}\)	TELEVISION OUTLET. AUDIO/VIDEO STATION	EM]				UPS	- UNINTERRUPTIBLE POWER SUPPLY.
	THERMOSTAT.	© (AV)	TELEVISION OUTLET. AUDIO/VIDEO STATION SYSTEM CLOCK RECEPTACLE. 120V, 15A, 1-GANG RECESSED SINGLE		AUDIBLE ALARM (BUZZER)					
	THERMOSTAT. MAGNETIC DOOR HOLD OPEN DEVICE. 1. DIRECT CONNECTION VOLTAGE INFORMATION INDICATION BY CIRCUIT No. 2. UNLESS NOTED OTHERWISE MOUNTING HEIGHT OF ALL	© (A) CLOCK S	TELEVISION OUTLET. AUDIO/VIDEO STATION SYSTEM CLOCK RECEPTACLE. 120V, 15A, 1-GANG RECESSED SINGLE RECEPTACLE		AUDIBLE ALARM (BUZZER) INTRUSION ALARM WITH STROBE				UPS	UNINTERRUPTIBLE POWER SUPPLY.VENDING MACHINE.
	THERMOSTAT. MAGNETIC DOOR HOLD OPEN DEVICE. 1. DIRECT CONNECTION VOLTAGE INFORMATION INDICATION BY CIRCUIT No. 2. UNLESS NOTED OTHERWISE MOUNTING HEIGHT OF ALL OUTLETS IS 455mm (18") A.F.F. 3. UNLESS NOTED OTHERWISE (IE: 30A, 20A) ALL	CLOCK S CLOCK S MECHANI	TELEVISION OUTLET. AUDIO/VIDEO STATION SYSTEM CLOCK RECEPTACLE. 120V, 15A, 1-GANG RECESSED SINGLE		AUDIBLE ALARM (BUZZER) INTRUSION ALARM WITH STROBE GLASS BREAK DETECTOR				UPS	UNINTERRUPTIBLE POWER SUPPLY.VENDING MACHINE.
	THERMOSTAT. MAGNETIC DOOR HOLD OPEN DEVICE. 1. DIRECT CONNECTION VOLTAGE INFORMATION INDICATION BY CIRCUIT No. 2. UNLESS NOTED OTHERWISE MOUNTING HEIGHT OF ALL OUTLETS IS 455mm (18") A.F.F.	CLOCK S CHANI	TELEVISION OUTLET. AUDIO/VIDEO STATION SYSTEM CLOCK RECEPTACLE. 120V, 15A, 1—GANG RECESSED SINGLE RECEPTACLE CAL WIRING SYSTEMS MECHANICAL EQUIPMENT/MOTOR. DISCONNECT SWITCH (UNFUSED). SUBSCRIPT INDICATES SIZE.		AUDIBLE ALARM (BUZZER) INTRUSION ALARM WITH STROBE GLASS BREAK DETECTOR SECURITY SYSTEM MONITORING STATION PANIC ALARM MOTION DETECTOR. SUBSCRIPT 'G' DENOTES GLASS BREAK				UPS	UNINTERRUPTIBLE POWER SUPPLY.VENDING MACHINE.
N O T E S	THERMOSTAT. MAGNETIC DOOR HOLD OPEN DEVICE. 1. DIRECT CONNECTION VOLTAGE INFORMATION INDICATION BY CIRCUIT No. 2. UNLESS NOTED OTHERWISE MOUNTING HEIGHT OF ALL OUTLETS IS 455mm (18") A.F.F. 3. UNLESS NOTED OTHERWISE (IE: 30A, 20A) ALL RECEPTACLES/DIRECT CONNECTIONS RATED FOR 15A.	© (AV) CLOCK S MECHANI	TELEVISION OUTLET. AUDIO/VIDEO STATION CLOCK RECEPTACLE. 120V, 15A, 1—GANG RECESSED SINGLE RECEPTACLE CAL WIRING SYSTEMS MECHANICAL EQUIPMENT/MOTOR. DISCONNECT SWITCH (UNFUSED). SUBSCRIPT INDICATES SIZE. SUBSCRIPT 'N' INDICATES COMPLETE WITH SOLID NEUTRAL. DISCONNECT SWITCH (FUSED). SUBSCRIPT INDICATES FUSE RATING.		AUDIBLE ALARM (BUZZER) INTRUSION ALARM WITH STROBE GLASS BREAK DETECTOR SECURITY SYSTEM MONITORING STATION PANIC ALARM MOTION DETECTOR. SUBSCRIPT 'G' DENOTES GLASS BREAK DOOR/WINDOW CONTACT.				UPS	UNINTERRUPTIBLE POWER SUPPLY.VENDING MACHINE.
N O T E S	THERMOSTAT. MAGNETIC DOOR HOLD OPEN DEVICE. 1. DIRECT CONNECTION VOLTAGE INFORMATION INDICATION BY CIRCUIT No. 2. UNLESS NOTED OTHERWISE MOUNTING HEIGHT OF ALL OUTLETS IS 455mm (18") A.F.F. 3. UNLESS NOTED OTHERWISE (IE: 30A, 20A) ALL RECEPTACLES/DIRECT CONNECTIONS RATED FOR 15A. NEOUS ROOM MODULAR CONTROL PANEL.	© (AV) CLOCK S MECHANI	TELEVISION OUTLET. AUDIO/VIDEO STATION CLOCK RECEPTACLE. 120V, 15A, 1—GANG RECESSED SINGLE RECEPTACLE CAL WIRING SYSTEMS MECHANICAL EQUIPMENT/MOTOR. DISCONNECT SWITCH (UNFUSED). SUBSCRIPT INDICATES SIZE. SUBSCRIPT 'N' INDICATES COMPLETE WITH SOLID NEUTRAL. DISCONNECT SWITCH (FUSED). SUBSCRIPT INDICATES FUSE RATING. SUBSCRIPT 'N' INDICATES COMPLETE WITH SOLID NEUTRAL.		AUDIBLE ALARM (BUZZER) INTRUSION ALARM WITH STROBE GLASS BREAK DETECTOR SECURITY SYSTEM MONITORING STATION PANIC ALARM MOTION DETECTOR. SUBSCRIPT 'G' DENOTES GLASS BREAK				UPS	UNINTERRUPTIBLE POWER SUPPLY.VENDING MACHINE.
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	DRAWING LIST
E0-00	ELECTRICAL LEGEND & DRAWINGS LIST
E0-01	CONSTRUCTION BIDDING PLAN
E1-00	OVERALL PLAN DEMO - ELECTRICAL
E1-01	ENLARGED PLANS #1 DEMO - ELECTRICAL
E1-02	ENLARGED PLANS #2 DEMO - ELECTRICAL
E2-00	OVERALL PLAN NEW — ELECTRICAL
E2-01	ENLARGED PLANS #1 DEMO - ELECTRICAL
E2-02	ENLARGED PLANS #2 DEMO - ELECTRICAL
E3-00	ELECTRICAL DETAILS
E4-00	ELECTRICAL SPECIFICATION

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P02085 - FRANKLIN RD
ELEMENTARY SCHOOL
RENOVATIONS.
500 FRANKLIN ROAD
HAMILTON, ONTARIO.

drawing title:
ELECTRICAL LEGEND
& DRAWING LIST

 drawn:
 scale:

 MD
 NTS


 date:
 project number:

 24-21
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A 30% PROGRESS SUBMISSION 2024-11-01
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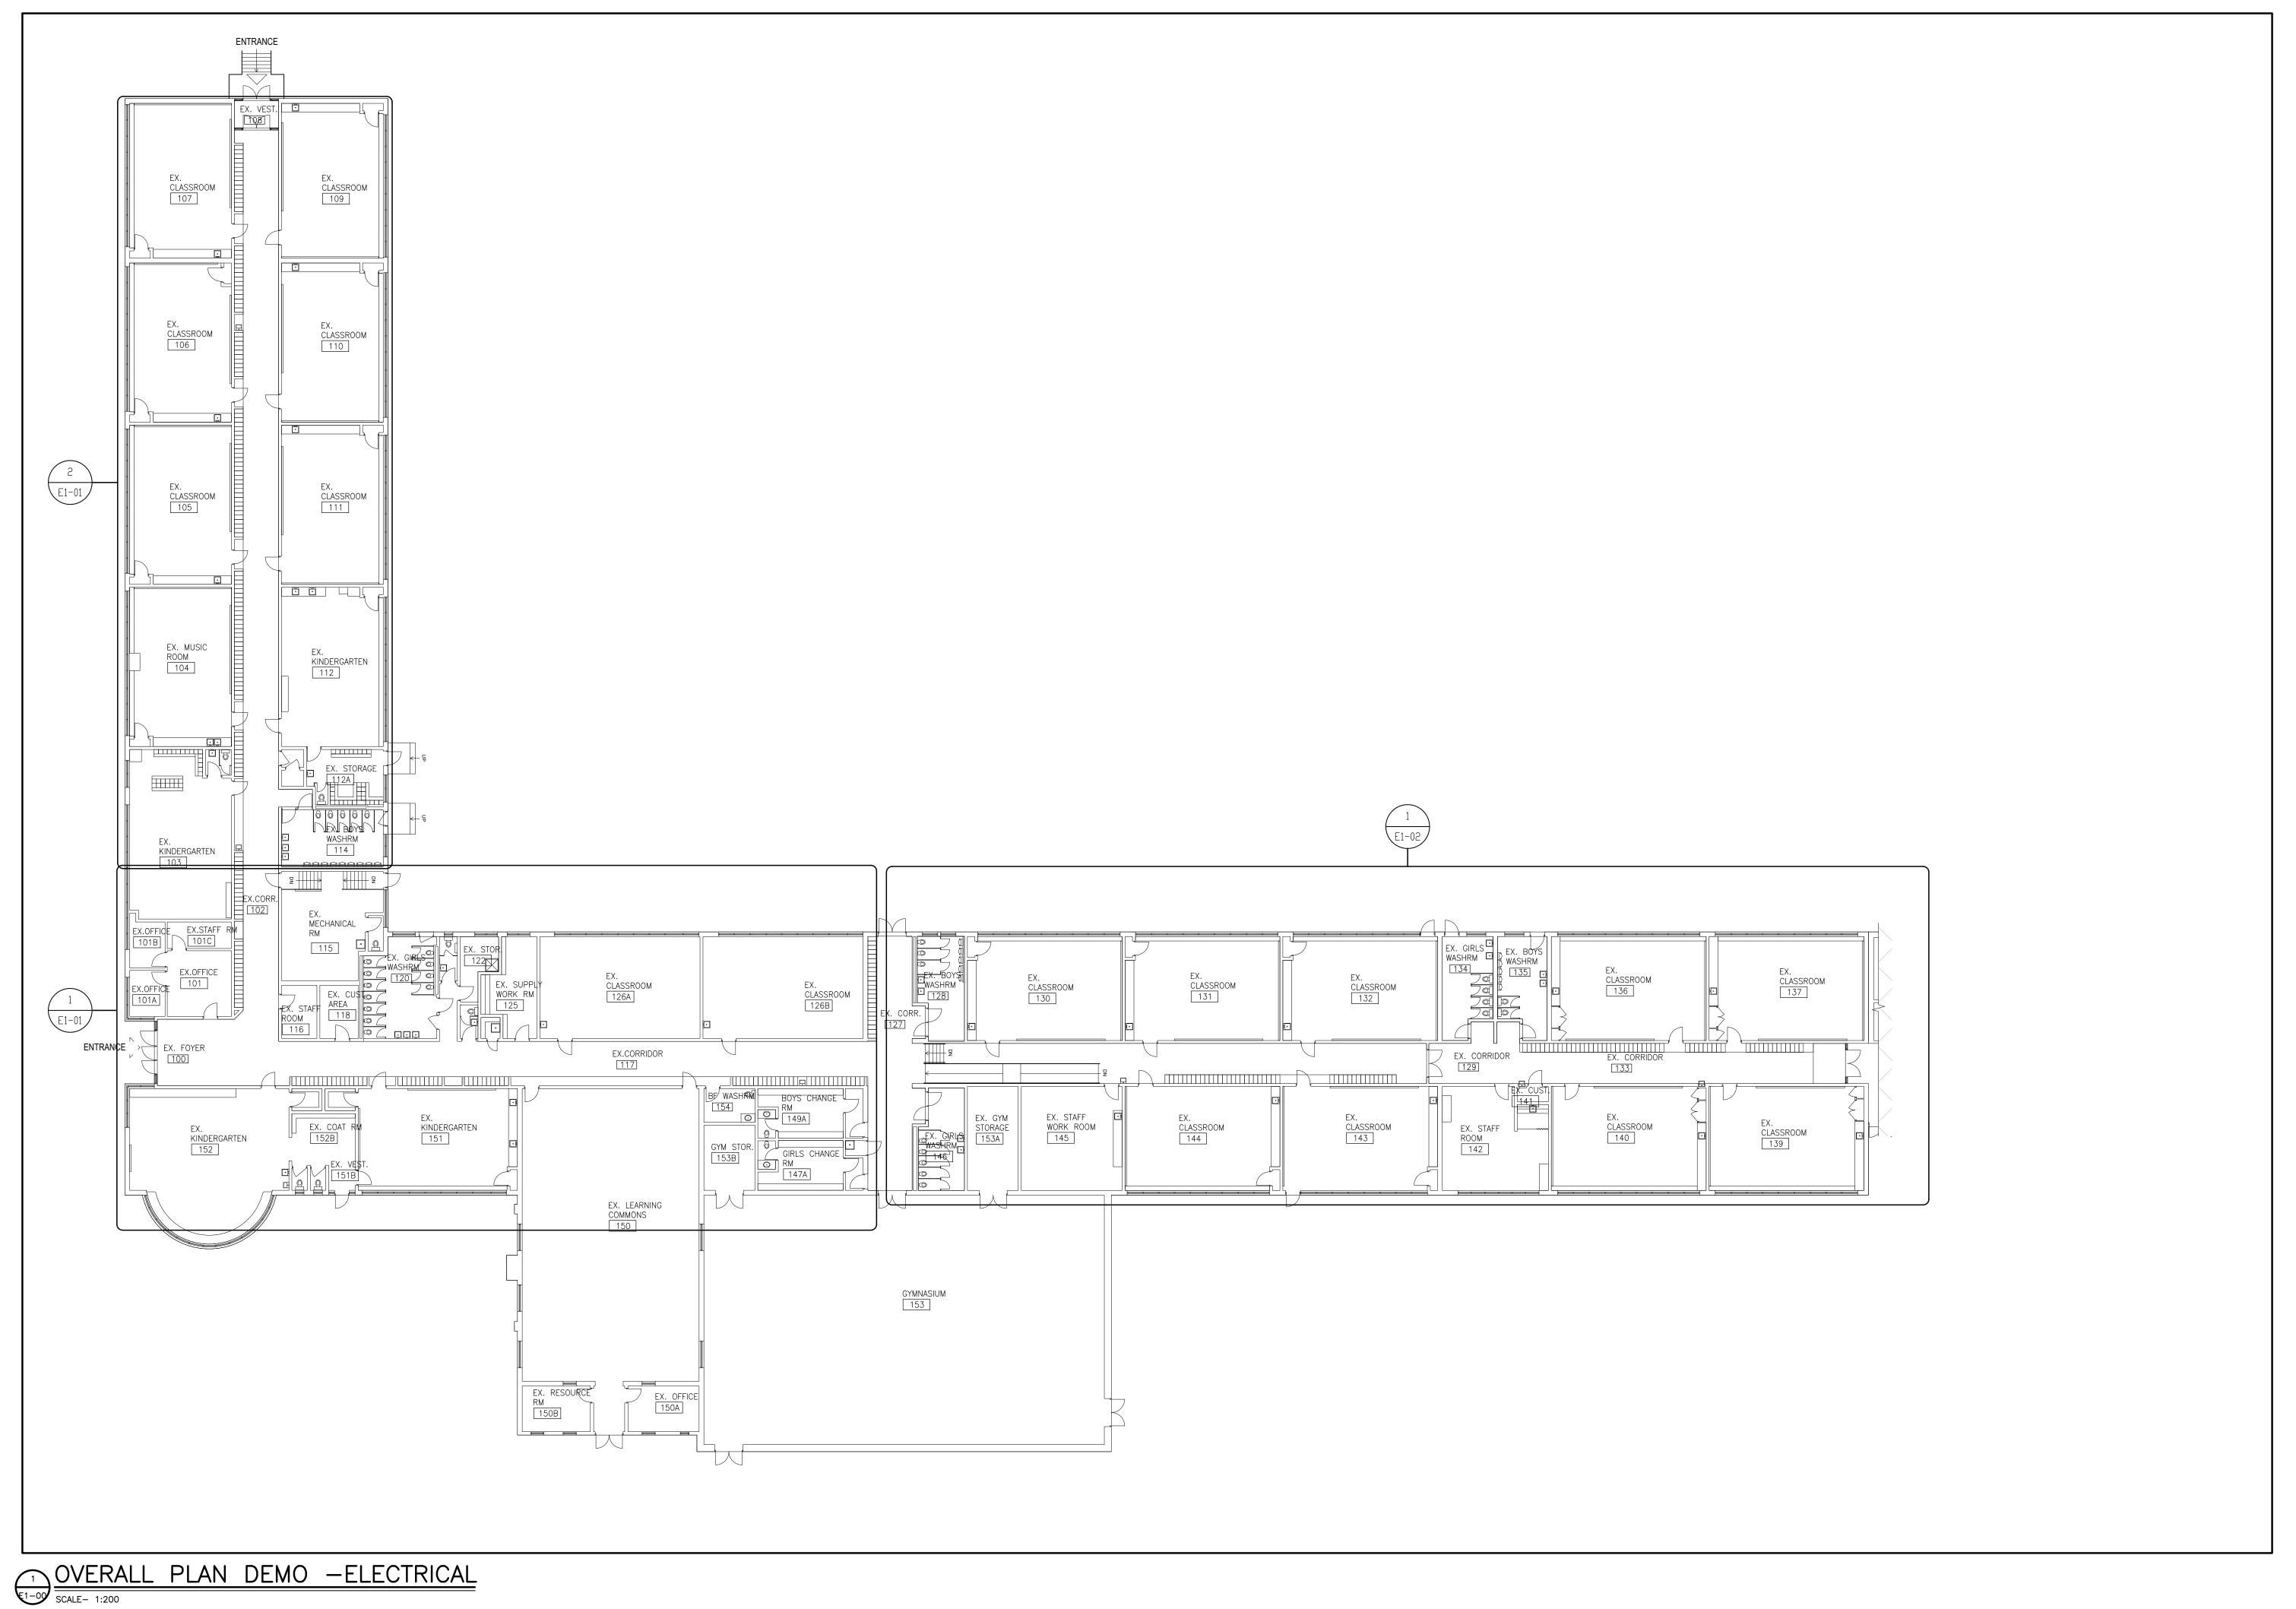
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project title:
HAMILTON- WENTWORTH
DISTRICT SCHOOL BOARD
P02085 - FRANKLIN RD
ELEMENTARY SCHOOL
RENOVATIONS. 500 FRANKLIN ROAD HAMILTON, ONTARIO.

CONSTRUCTION BIDDING PLAN

drawn: AS SHOWN project number: 24-21

MD date: E0-01

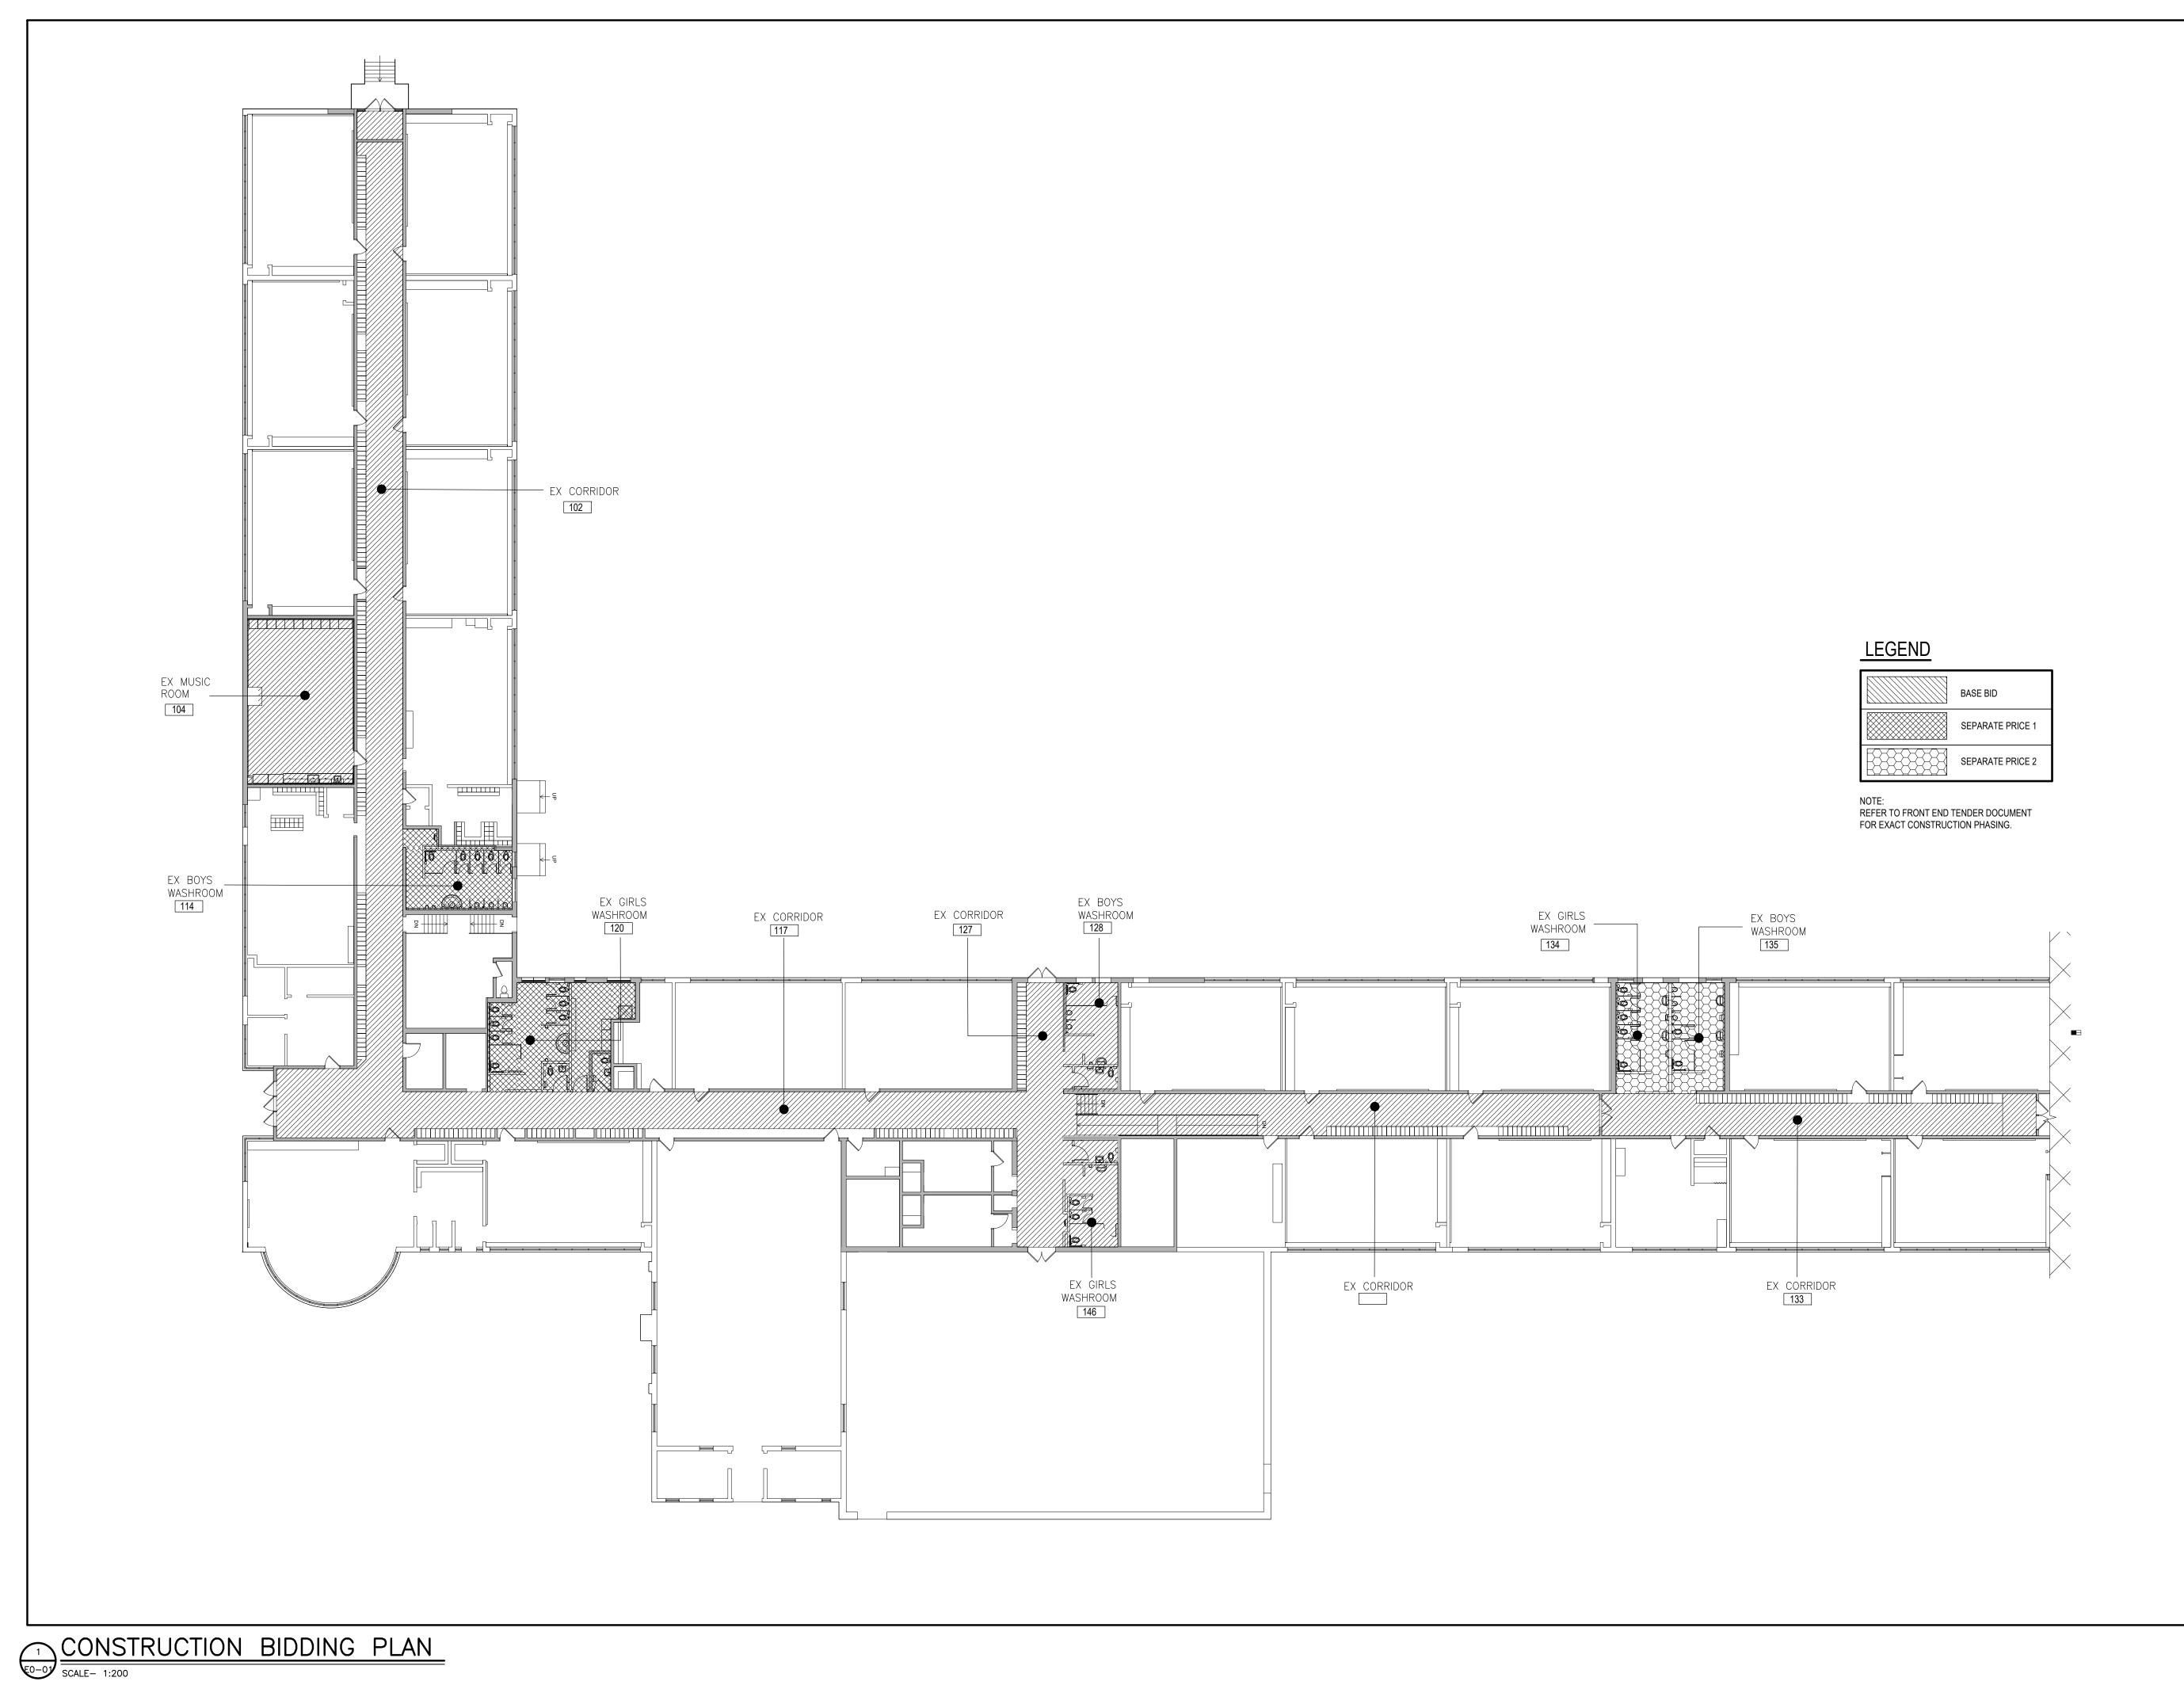

2 ISSUED FOR TENDER 1 ISSUED FOR PERMIT B 85% PROGRESS 2024-11-27 A 30% PROGRESS SUBMISSION 2024-11-01
No. DESCRIPTION DATE REVISIONS E&M

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P02085 - FRANKLIN RD
ELEMENTARY SCHOOL
RENOVATIONS. 500 FRANKLIN ROAD HAMILTON, ONTARIO. OVERALL PLAN DEMO -

ELECTRICAL

drawn: **AS SHOWN** project number: 24-21

www.aja.design I info@aja.design I 905.920.5121

MD date:

DRAWING NOTES ALL FIRE ALARM DEVICES LOCATED ON CEILING SHALL BE DISCONNECTED AND RELOCATED TO THE NEW DISCONNECT & REMOVE ALL LIGHTING AS SHOWN. EXISTING CIRCUITS SHALL BE RE-USED FOR NEW LIGHTING. EXISTING SWITCHES SHALL BE DISCONNECTED & REMOVED. PROVIDE STAINLESS STEEL WALL PLATES FOR ALL RECESSED BACK BOXES. DISCONNECT POWER TO EXISTING UNIT HEATER. RE-CONNECT TO NEW HYDRONIC HEATER. EXTEND WIRING AS REQUIRED.



GENERAL NOTES

1. AS PART OF THIS WORK, RELOCATE ALL EXISTING SURFACE CONDUITS & IT CABLING MOUNTED TO THE EXISTING CEILING/WALLS TO ABOVE NEW

RATED. REFER TO SOME OF THE REFERENCE PHOTO ON THIS DRAWING. THE PHOTOS DO NOT

SHALL HAVE A THOROUGH LOOK DURING THE

BIDDERS WALK-THROUGH TO DETERMINE THE ENTIRE SCOPE OF CONDUIT/IT CABLING


RELOCATION. COORDINATE ALL IT WORK WITH


2. ALL EXISTING LIGHTING CONTROL SWITCHES THAT ARE CONNECTED TO EXISTING LIGHTS THAT ARE BEING DEMOLISHED SHALL BE DISCONNECTED &


SCHOOL BOARD IT REPRESENTATIVE.

CEILING. ENSURE ALL DATA CABLES ARE PLENUM

SHOW THE ENTIRE SCOPE OF WORK. CONTRACTOR

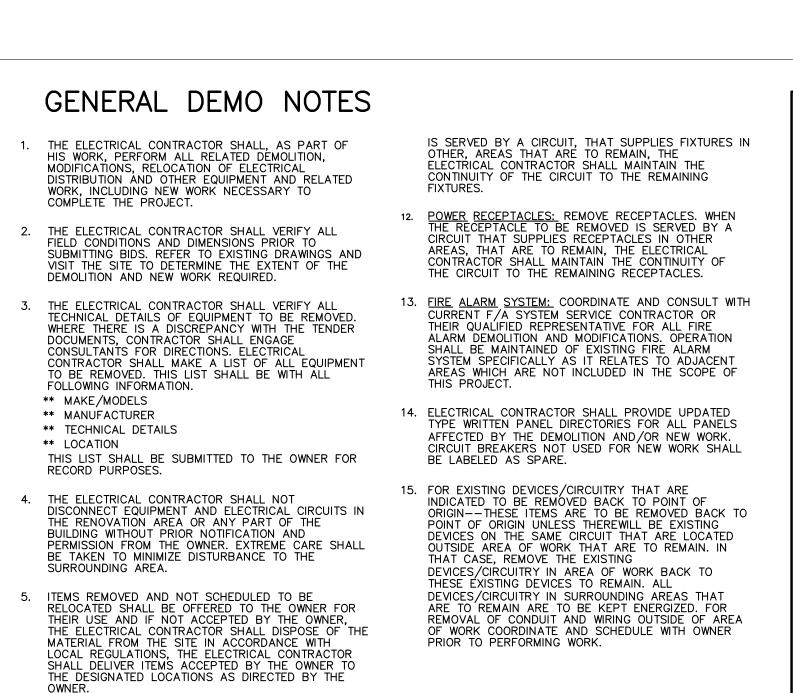

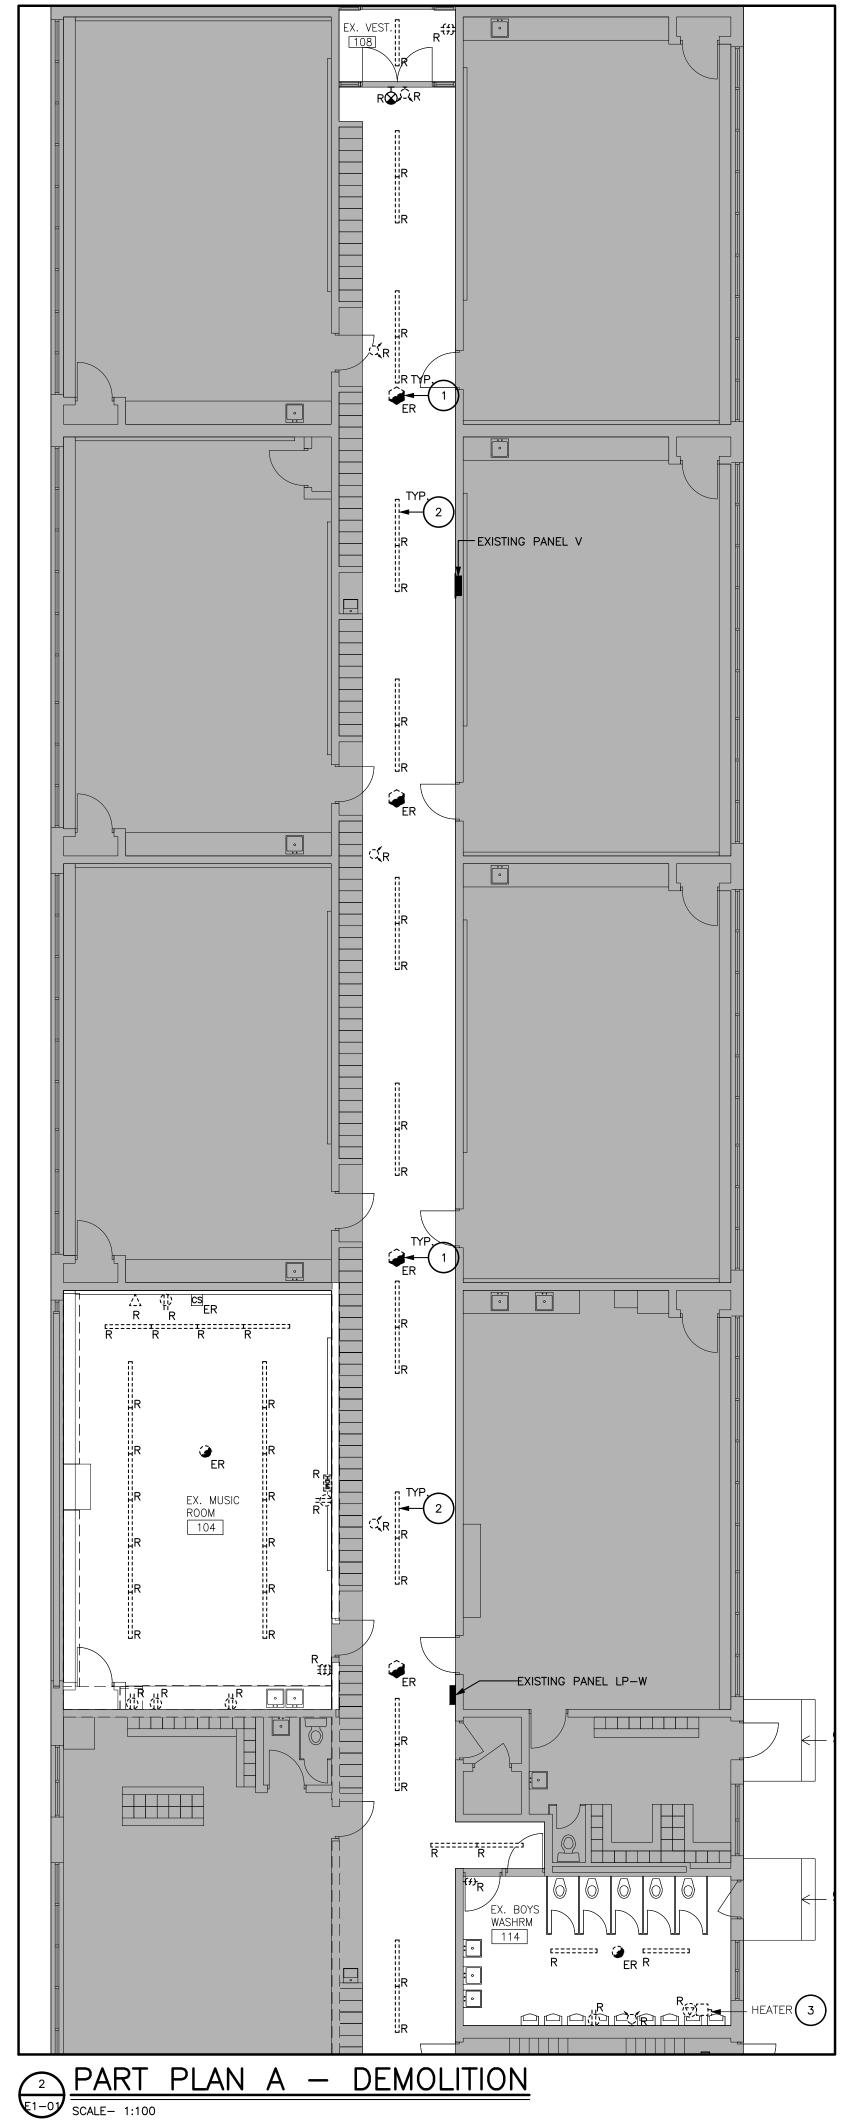


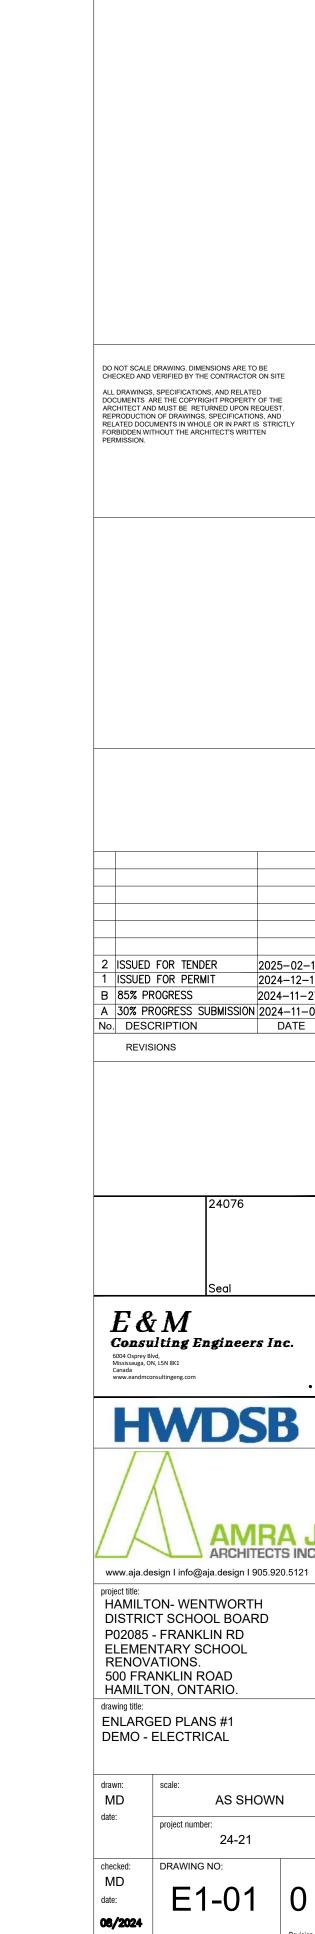

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AS SHOWN

24-21

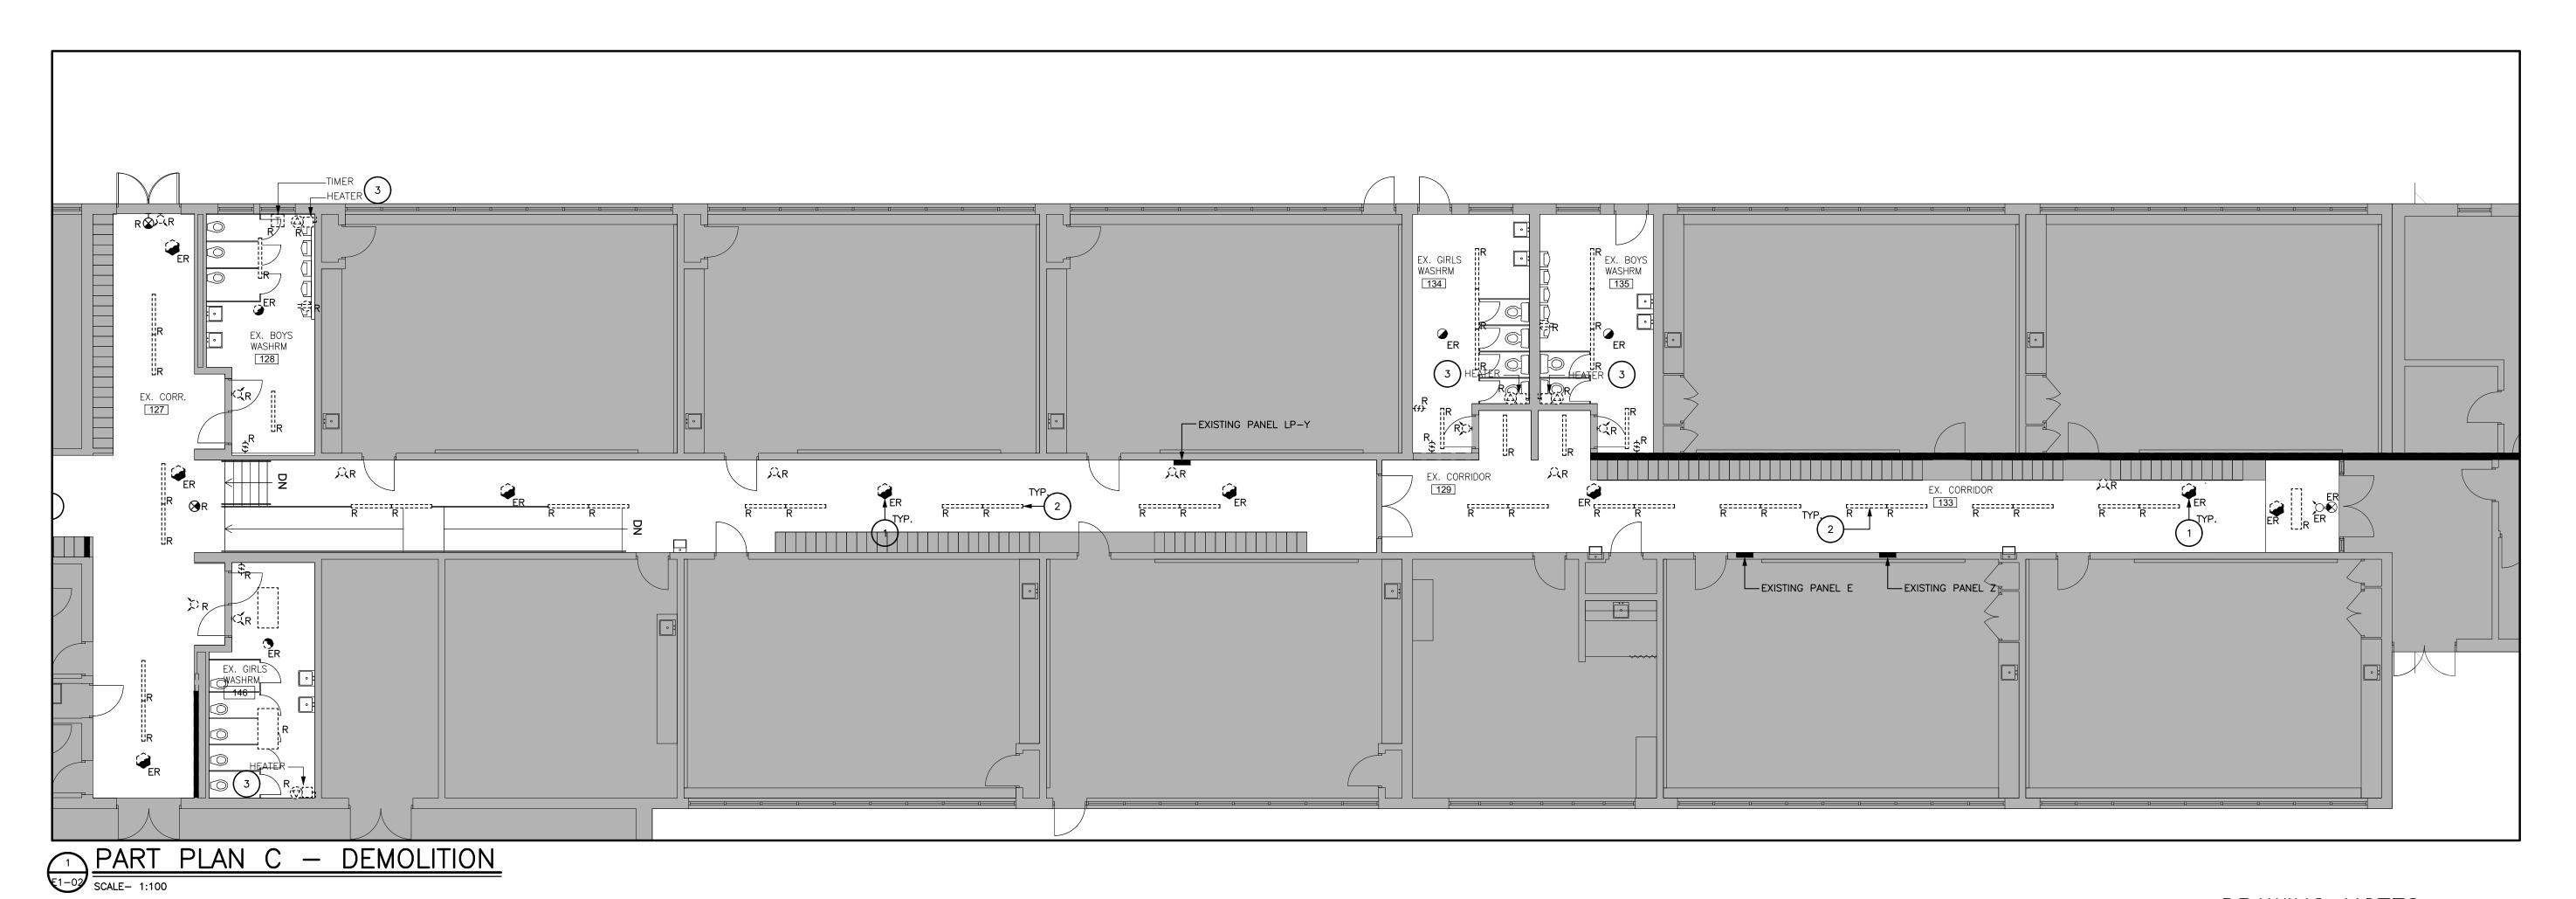


GENERAL NOTES


- 1. AS PART OF THIS WORK, RELOCATE ALL EXISTING SURFACE CONDUITS & IT CABLING MOUNTED TO THE EXISTING CEILING TO ABOVE NEW CEILING. ENSURE ALL DATA CABLES ARE PLENUM RATED. CONTRACTOR SHALL HAVE A THOROUGH LOOK DURING THE BIDDERS WALK—THROUGH TO DETERMINE THE ENTIRE SCOPE OF CONDUIT/IT CABLING RELOCATION. COORDINATE ALL IT WORK WITH SCHOOL BOARD IT REPRESENTATIVE.
- 2. ALL EXISTING LIGHTING CONTROL SWITCHES THAT ARE CONNECTED TO EXISTING LIGHTS THAT ARE BEING DEMOLISHED SHALL BE DISCONNECTED & REMOVED.

DRAWING NOTES

- ALL FIRE ALARM DEVICES LOCATED ON CEILING SHALL BE DISCONNECTED AND RELOCATED TO THE NEW CEILING.
- DISCONNECT & REMOVE ALL LIGHTING AS SHOWN.
 EXISTING CIRCUITS SHALL BE RE-USED FOR NEW
 LIGHTING. EXISTING SWITCHES SHALL BE DISCONNECTED
 & REMOVED. PROVIDE STAINLESS STEEL WALL PLATES
 FOR ALL RECESSED BACK BOXES.
- DISCONNECT POWER TO EXISTING UNIT HEATER. RE—CONNECT TO NEW HYDRONIC HEATER. EXTEND WIRING AS REQUIRED.

DO NOT SCALE DRAWING. DIMENSIONS ARE TO BE CHECKED AND VERIFIED BY THE CONTRACTOR ON SITE ALL DRAWINGS, SPECIFICATIONS, AND RELATED DOCUMENTS ARE THE COPYRIGHT PROPERTY OF THE ARCHITECT AND MUST BE RETURNED UPON REQUEST. REPRODUCTION OF DRAWINGS, SPECIFICATIONS, AND RELATED DOCUMENTS IN WHOLE OR IN PART IS STRICTLY FORBIDDEN WITHOUT THE ARCHITECT'S WRITTEN PERMISSION.

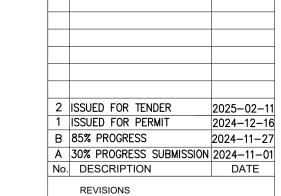

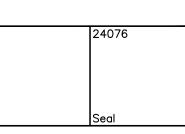

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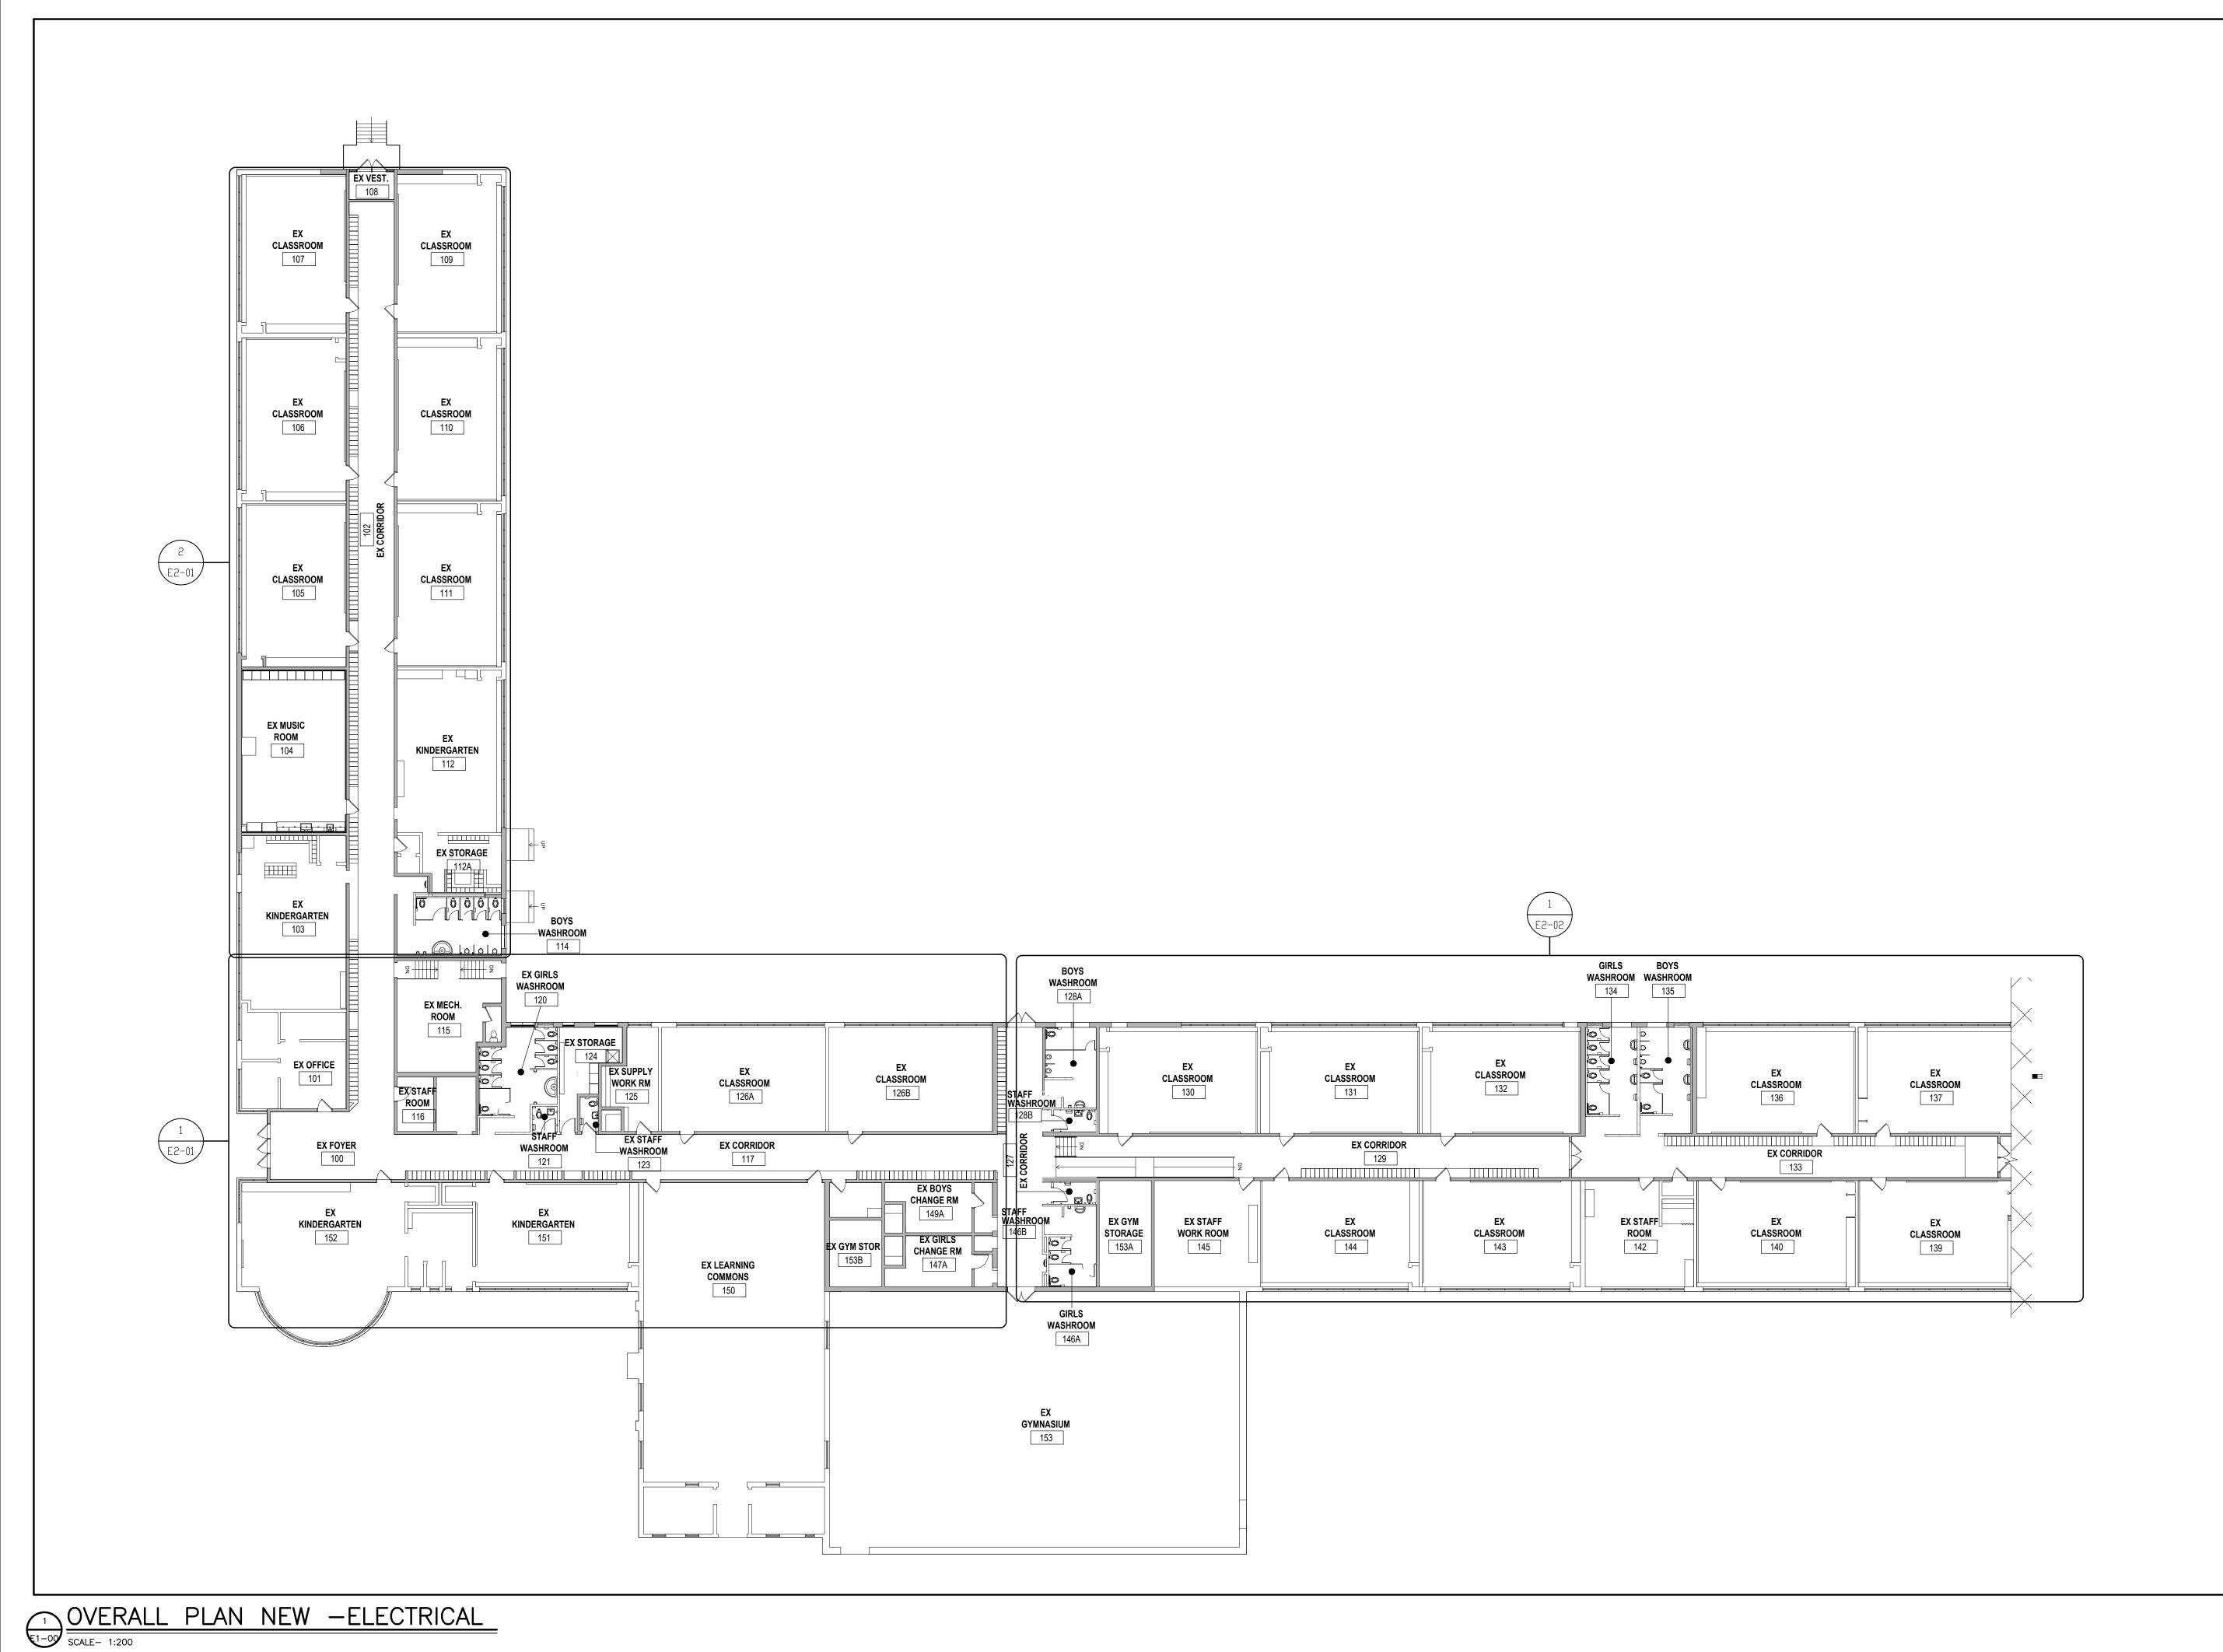
project title:

HAMILTON- WENTWORTH
DISTRICT SCHOOL BOARD

DISTRICT SCHOOL BOARD
P02085 - FRANKLIN RD
ELEMENTARY SCHOOL
RENOVATIONS.
500 FRANKLIN ROAD
HAMILTON, ONTARIO.
drawing title:

drawing title:
ENLARGED PLANS #2
DEMO - ELECTRICAL

drawn:	scale: AS SHOWN	1
date:	project number: 24-21	
checked:	DRAWING NO:	
date:	□ 1-()2	(



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2 ISSUED FOR TENDER 1 ISSUED FOR PERMIT B 85% PROGRESS 2024-11-27 A 30% PROGRESS SUBMISSION 2024-11-01 No. DESCRIPTION

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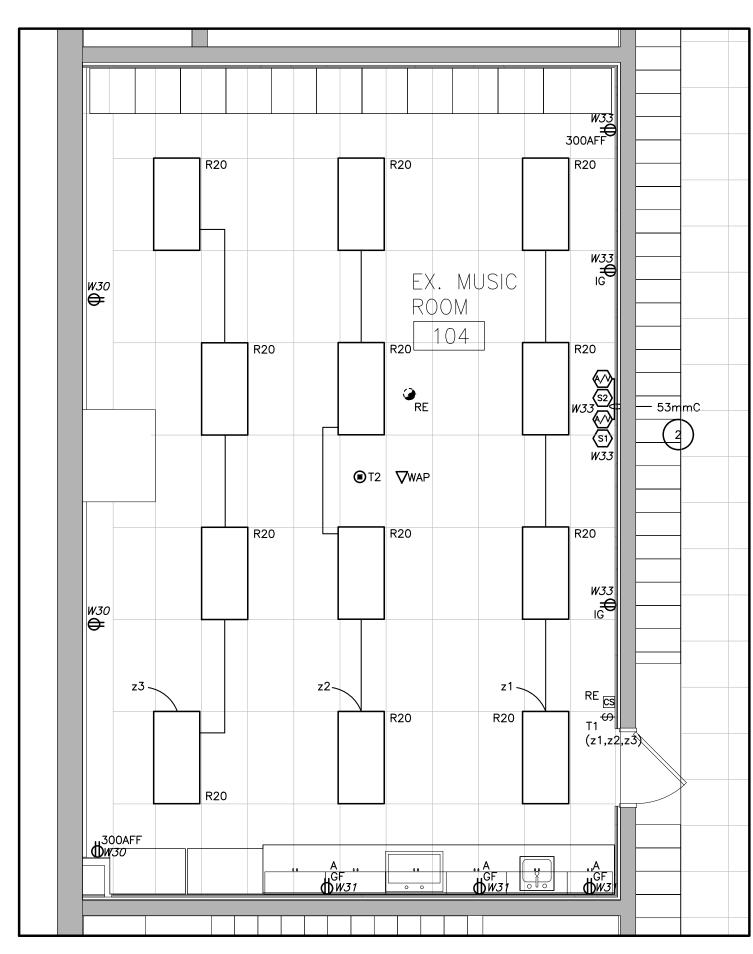
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OVERALL PLAN NEW -ELECTRICAL

drawn: **AS SHOWN** project number: 24-21

MD date:



DRAWING NOTES


- PROVIDE ADA COMPLIANT HAND DRYER. WORLD DRYER SLIMDRI OR APPROVED EQUAL. HAND DRYER SHALL BE POLISHED STAINLESS STEEL. COORDINATE MOUNTING HEIGHT WITH ARCHITECT. PROVIDE 2004-ETTELY. BREAKER IN PANEL AND WIRE COMPLETELY.
- 2 REFER TO 'TYPICAL TEACHING WALL DETAIL' ON E3-00 DRAWING.
- 3 EXISTING BAS PANEL. LIGHTING CONTROLS IN THE CORRIDOR TO BE TIED INTO THE BAS PANEL AS PER PER E3-00 DRAWING. SEE BELOW FOR BAS CONTACT INFORMATION.

DEVIN COUSINEAU - 519-281-9132 DEVIN.COUSINEAU@CONVERGINT.COM

- CONNECT NEW CABINET HEATER TO EXISTING HEATER CIRCUIT THAT WAS DISCONNECTED. EXTEND WIRING AS REQUIRED.
- 5 RECEPTACLE FOR WATER MATRIX FLUSH SYSTEM CONTROL PANEL. COORDINATE EXACT LOCATION ON SITE WITH MECHANICAL DIVISION. RE-USE CIRCUIT USED FOR DEMOLISHED FLUSH SYSTEM RECEPTACLE. EXTEND WIRING AS REQUIRED TO NEW LOCATION.
- PROVIDE HAND/OFF/AUTO SWITCH FOR CORRIDOR LIGHTING: HAND: CORRIDOR LIGHTS 'ON' OFF: CORRIDOR LIGHTS 'OFF' AUTO: CORRIDOR LIGHTS CONTROLLED BY BAS


GENERAL NOTES

- THIS DRAWING ILLUSTRATES INTENT AND DOES NOT REPRESENT ALL REQUIRED CONTROL COMPONENTS, FINAL WIRING METHODS OR FIXTURE MOUNTING LOCATIONS. DETERMINE THE FINAL SYSTEM INSTALLATION BASED ON THE PRODUCT MANUFACTURER'S SHOP DRAWINGS.
- 2. EXIT SIGNS SHALL BE MOUNTED SO THEY ARE VISIBLE UPON APPROACH. NO HIGHER THAN 3050 AFF AND NO LOWER THAN 2100 AFF.
- 3. OCCUPANCY SENSORS SHALL BE MOUNTED IN ACCORDANCE WITH MANUFACTURER'S RECOMMENDATIONS SO THEY ARE CAPABLE OF OPERATING PROPERLY WITHOUT FALSE 'ON' OR PREMATURE 'OFF' OPERATIONS. DUAL TECHNOLOGY OCCUPANCY SENSORS SHALL NOT BE MOUNTED WITHIN 610mm OF ANY HVAC DIFFUSERS.
- 4. REMOTE MOUNTED POWER SUPPLIES AND CONTROL DEVICES SHALL BE MOUNTED IN ACCESSIBLE LOCATIONS OUT OF VIEW OF
- 5. CEILING SPACE IS A RETURN AIR PLENUM. ANY DEVICES LOCATED IN CEILING SPACES SHALL BE PLENUM RATED.
- 6. ALL WIRING IN FINISHED AREAS SHALL BE RUN CONCEALED IN WALLS/CEILINGS WHERE POSSIBLE. OTHERWISE PROVIDE SURFACE RACEWAYS SUCH AS WIREMOLD OR EQUIVALENT. EMT WILL NOT BE ACCEPTED UNLESS OTHERWISE NOTED.
- 7. FINAL LIGHTING DIMMING PRE-SETS TO BE DETERMINED ON SITE WITH THE OWNER DURING COMMISSIONING.
- 8. ALL RECEPTACLES SHALL BE TAMPER RESISTANT TYPE.
- 9. ALL NEW LIGHTING SHALL BE RE-CONNECTED TO THE EXISTING CIRCUITS. UPDATE EXISTING PANEL SCHEDULE TO MATCH ANY CHANGES TO CIRCUITS.
- 10. PROVIDE ACCESS PANELS FOR ANY JUNCTION BOXES, POWER PACKS ETC IN DRYWALL CEILINGS. COORDINATE EXACT LOCATION OF ACCESS HATCH WITH ARCHITECT PRIOR TO PLACING ANY

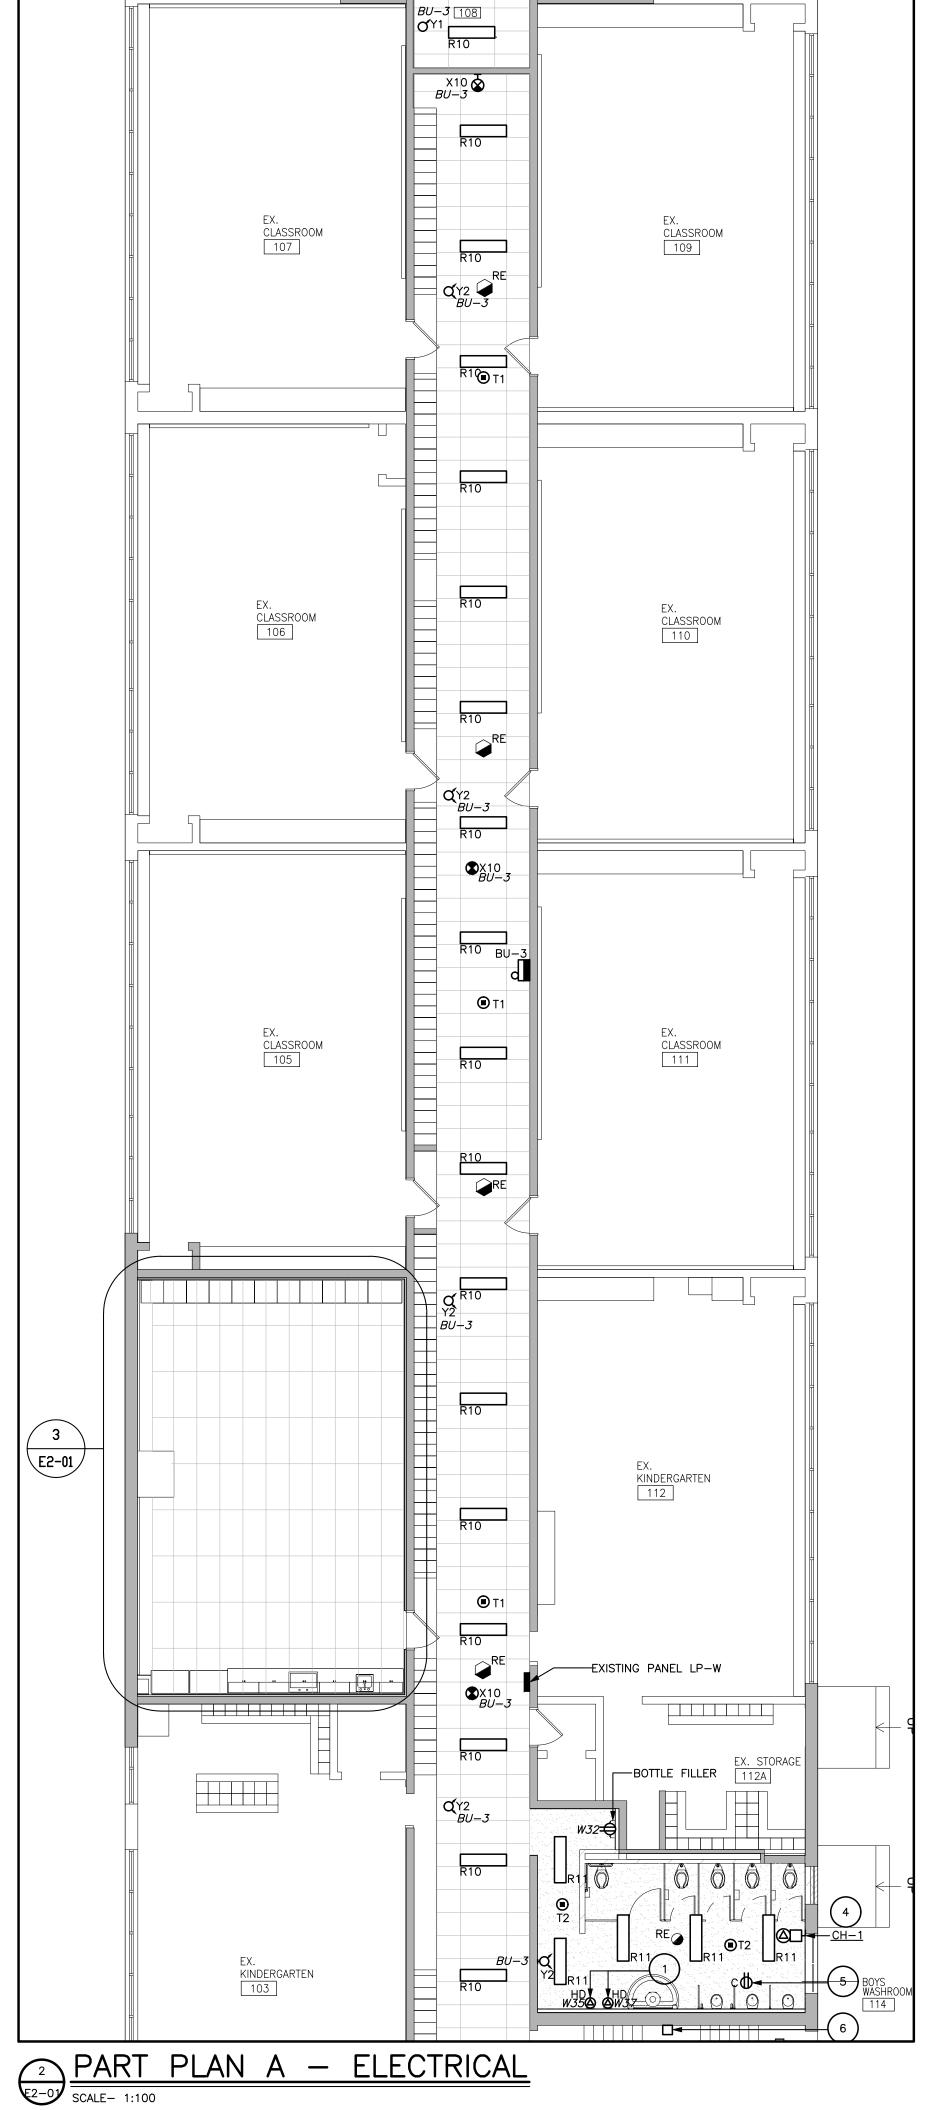

MUSIC ROOM 104 — ELECTRICAL

SCALE- 1:100

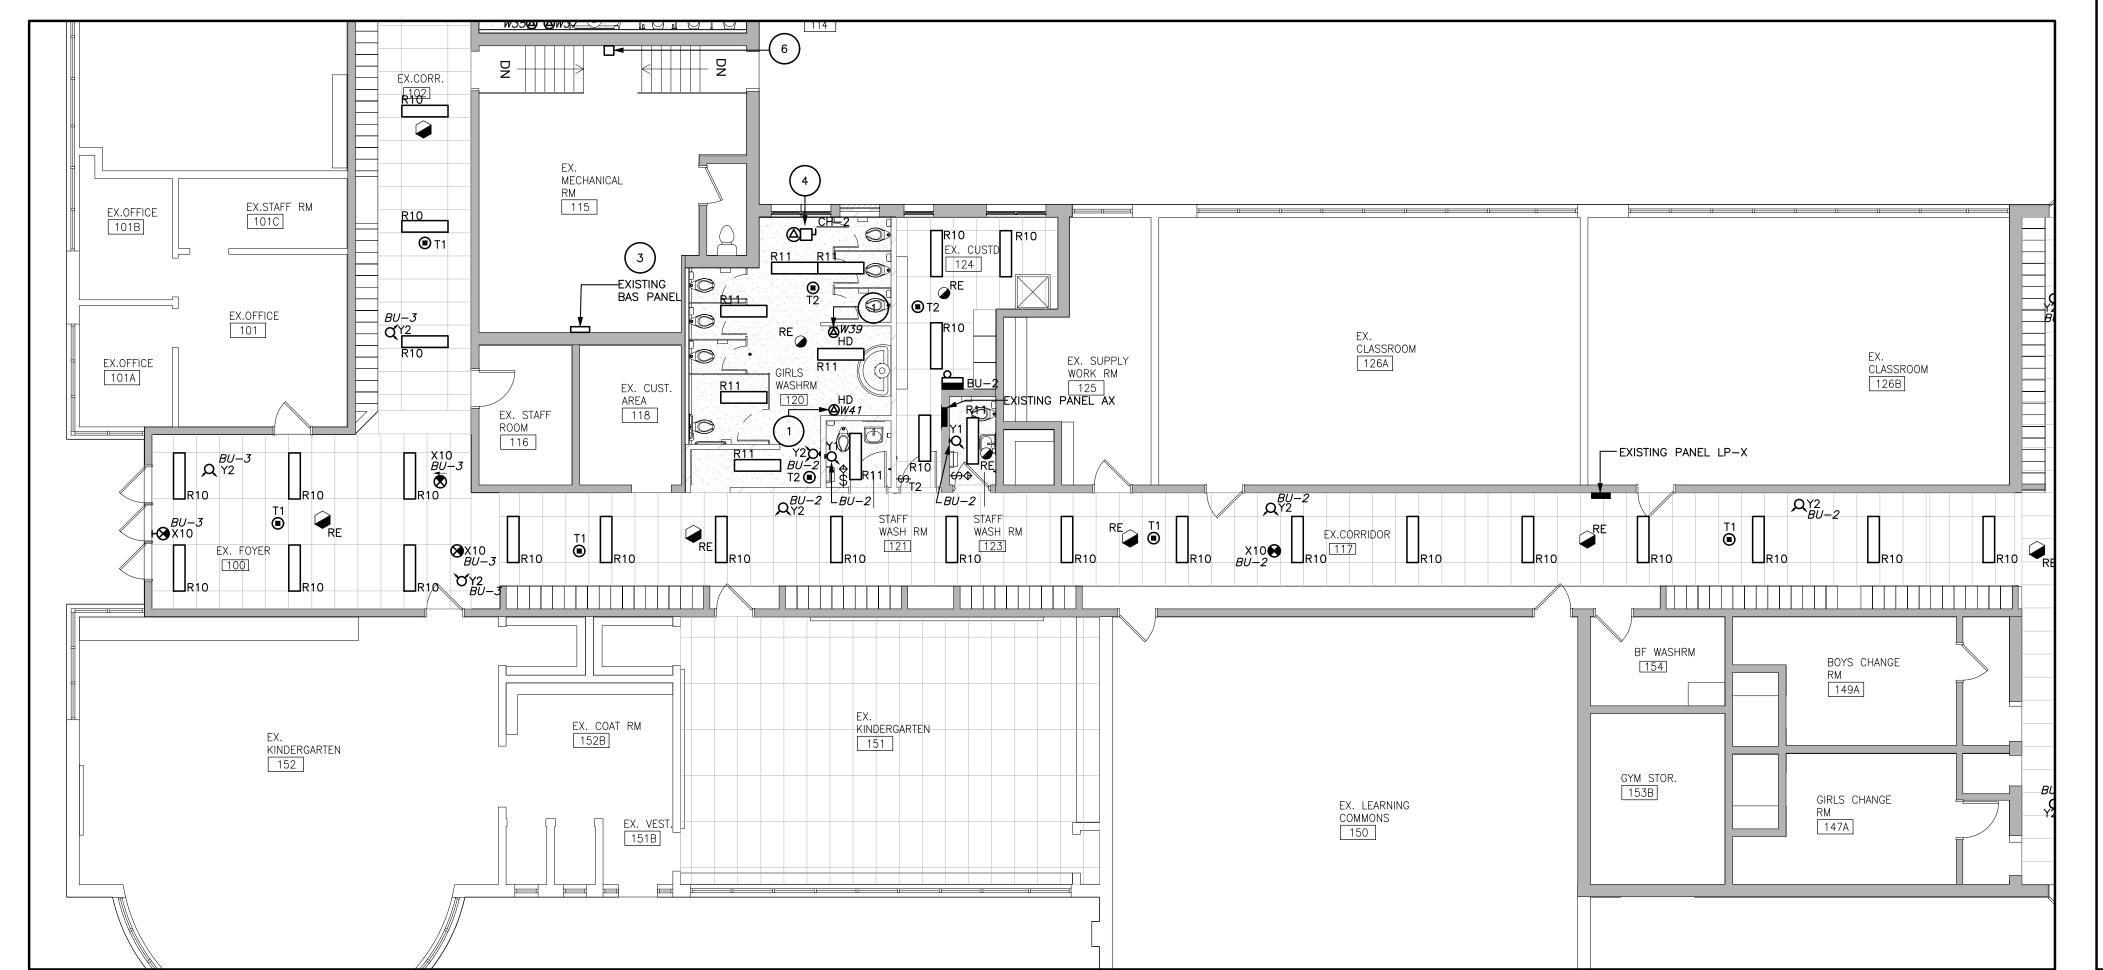

2 ISSUED FOR TENDER B 85% PROGRESS A 30% PROGRESS SUBMISSION 2024-11-01 No. DESCRIPTION E&M

Consulting Engineers Inc.
6004 Osprey Blvd,
Mississauga, ON, LSN 8K1
Canada
www.eandmconsultingeng.com **HWDSB** AMRA J ARCHITECTS INC. Project title:

HAMILTON- WENTWORTH
DISTRICT SCHOOL BOARD
P02085 - FRANKLIN RD
ELEMENTARY SCHOOL
RENOVATIONS. 500 FRANKLIN ROAD HAMILTON, ONTARIO. ENLARGED PLANS #1 NEW - ELECTRICAL drawn: MD AS SHOWN


24-21

CHECKED AND VERIFIED BY THE CONTRACTOR ON SITE

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PART PLAN B — ELECTRICAL

SCALE- 1:100

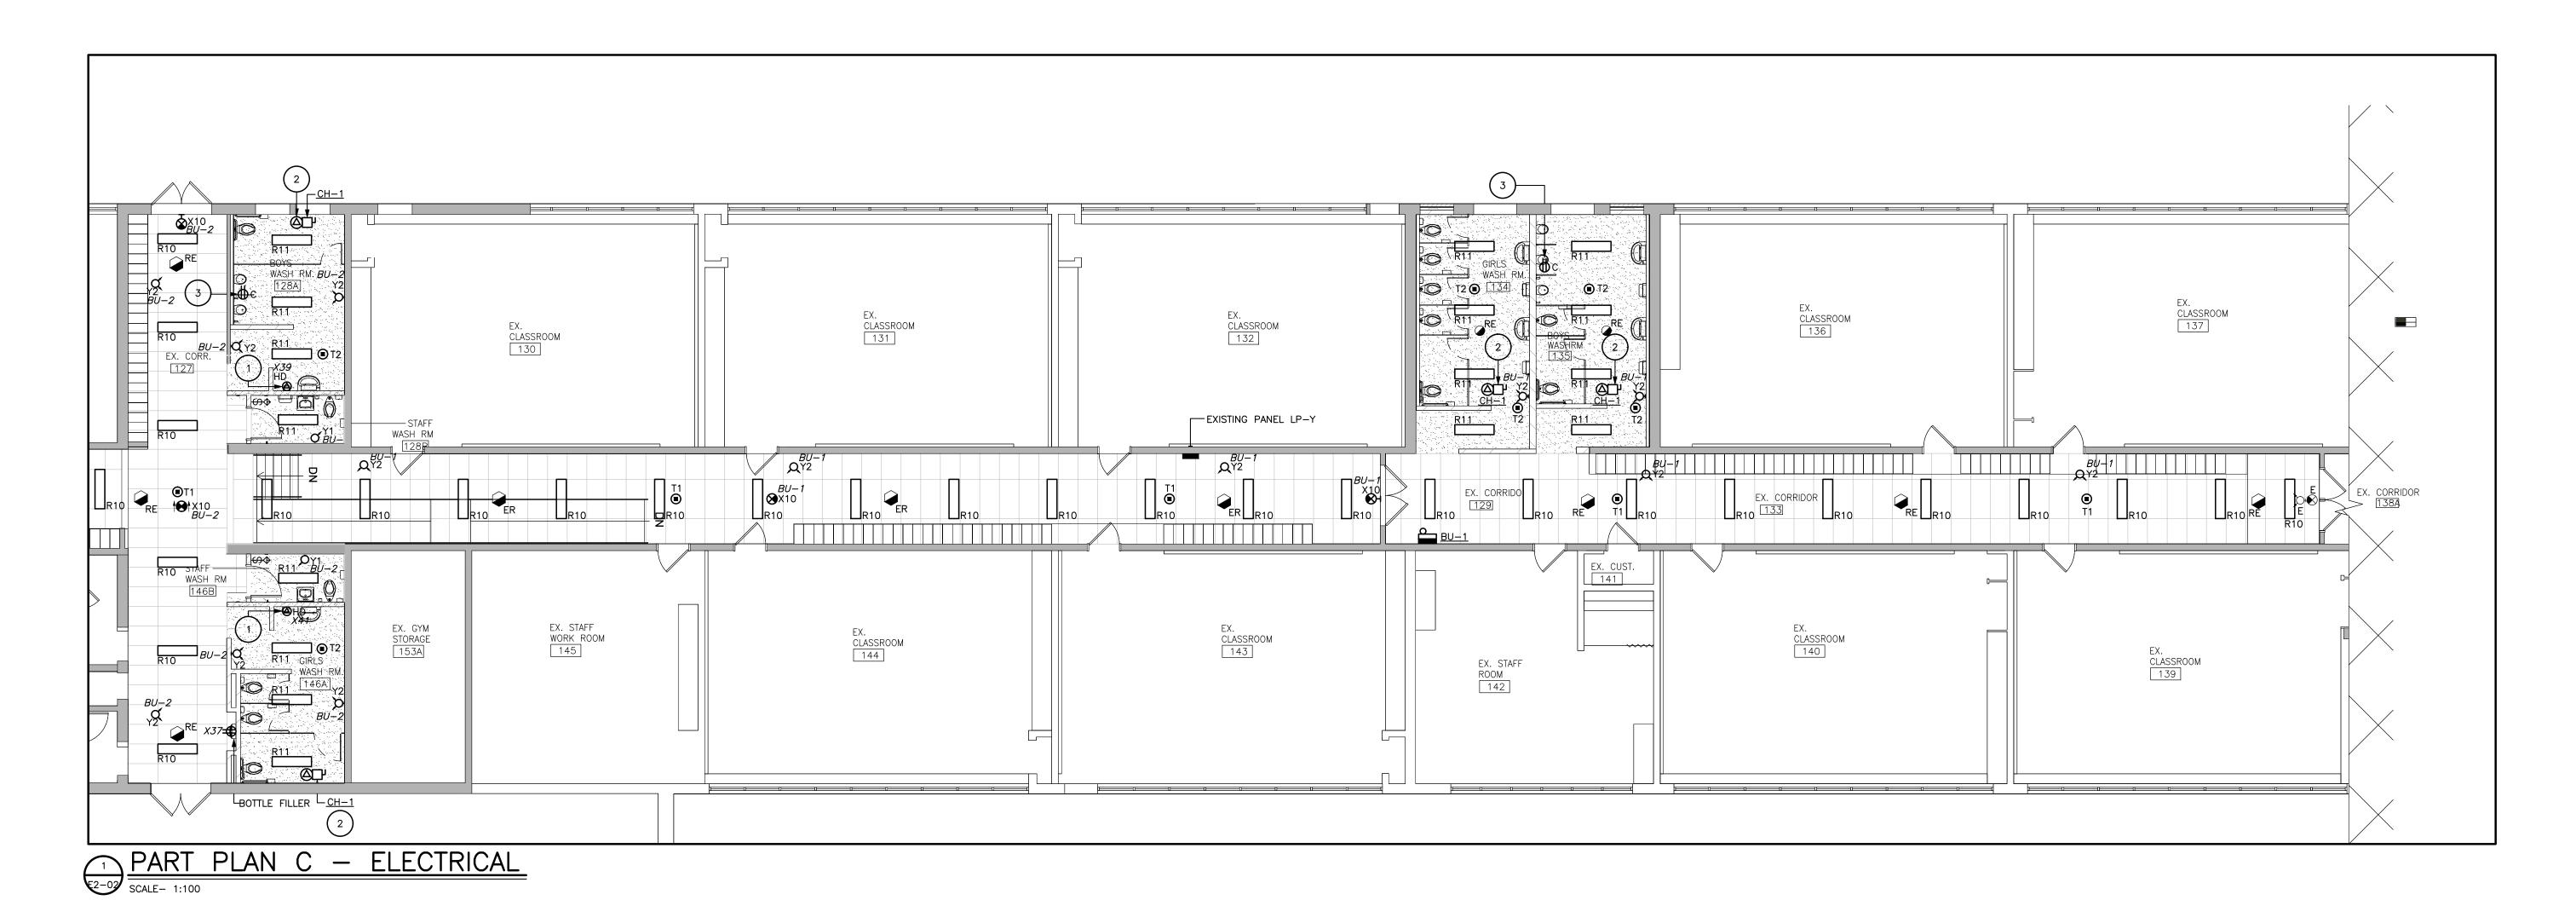

DRAWING NOTES

PROVIDE ADA COMPLIANT HAND DRYER. WORLD DRYER SLIMDRI OR APPROVED EQUAL. HAND DRYER SHALL BE POLISHED STAINLESS STEEL. COORDINATE MOUNTING HEIGHT WITH ARCHITECT. PROVIDE 20A-1P GFCI BREAKER IN PANEL AND WIRE COMPLETELY.

- CONNECT NEW CABINET HEATER TO EXISTING HEATER CIRCUIT THAT WAS DISCONNECTED. EXTEND WIRING AS REQUIRED.
- 3 RECEPTACLE FOR WATER MATRIX FLUSH SYSTEM CONTROL PANEL. COORDINATE EXACT LOCATION ON SITE WITH MECHANICAL DIVISION. RE—USE CIRCUIT USED FOR DEMOLISHED FLUSH SYSTEM RECEPTACLE.

EXTEND WIRING AS REQUIRED TO NEW LOCATION.

GENERAL NOTES

- THIS DRAWING ILLUSTRATES INTENT AND DOES NOT REPRESENT ALL REQUIRED CONTROL COMPONENTS, FINAL WIRING METHODS OR FIXTURE MOUNTING LOCATIONS. DETERMINE THE FINAL SYSTEM INSTALLATION BASED ON THE PRODUCT MANUFACTURER'S SHOP DRAWINGS.
- 2. EXIT SIGNS SHALL BE MOUNTED SO THEY ARE VISIBLE UPON APPROACH. NO HIGHER THAN 3050 AFF AND NO LOWER THAN 2100 AFF.
- 3. OCCUPANCY SENSORS SHALL BE MOUNTED IN ACCORDANCE WITH MANUFACTURER'S RECOMMENDATIONS SO THEY ARE CAPABLE OF OPERATING PROPERLY WITHOUT FALSE 'ON' OR PREMATURE 'OFF' OPERATIONS. DUAL TECHNOLOGY OCCUPANCY SENSORS SHALL NOT BE MOUNTED WITHIN 610mm OF ANY HVAC DIFFUSERS.
- 4. REMOTE MOUNTED POWER SUPPLIES AND CONTROL DEVICES SHALL BE MOUNTED IN ACCESSIBLE LOCATIONS OUT OF VIEW OF
- 5. CEILING SPACE IS A RETURN AIR PLENUM. ANY DEVICES LOCATED IN CEILING SPACES SHALL BE PLENUM RATED.
- 6. ALL WIRING IN FINISHED AREAS SHALL BE RUN CONCEALED IN WALLS/CEILINGS WHERE POSSIBLE. OTHERWISE PROVIDE SURFACE RACEWAYS SUCH AS WIREMOLD OR EQUIVALENT. EMT WILL NOT BE ACCEPTED UNLESS OTHERWISE NOTED.
- 7. EXISTING BAS PANEL BY SIEMENS.
- 8. FINAL LIGHTING DIMMING PRE-SETS TO BE DETERMINED ON SITE WITH THE OWNER DURING COMMISSIONING.
- 9. ALL RECEPTACLES SHALL BE TAMPER RESISTANT TYPE.
- 10. ALL NEW LIGHTING SHALL BE RE-CONNECTED TO THE EXISTING CIRCUIT. UPDATE EXISTING PANEL SCHEDULE TO MATCH ANY CHANGES TO CIRCUITS.

2 ISSUED FOR TENDER 1 ISSUED FOR PERMIT 2024-12-16 B 85% PROGRESS 2024-11-27 A 30% PROGRESS SUBMISSION 2024-11-01 No. DESCRIPTION

REVISIONS

E&MConsulting Engineers Inc. 6004 Osprey Blvd, Mississauga, ON, L5N 8K1 Canada www.eandmconsultingeng.com

ARCHITECTS INC. www.aja.design I info@aja.design I 905.920.5121

HAMILTON- WENTWORTH DISTRICT SCHOOL BOARD P02085 - FRANKLIN RD ELEMENTARY SCHOOL RENOVATIONS. 500 FRANKLIN ROAD HAMILTON, ONTARIO.


ENLARGED PLANS #2 **NEW - ELECTRICAL**

drawn: MD AS SHOWN date: 24-21

MD date:

08/2024

DRAWING NO:

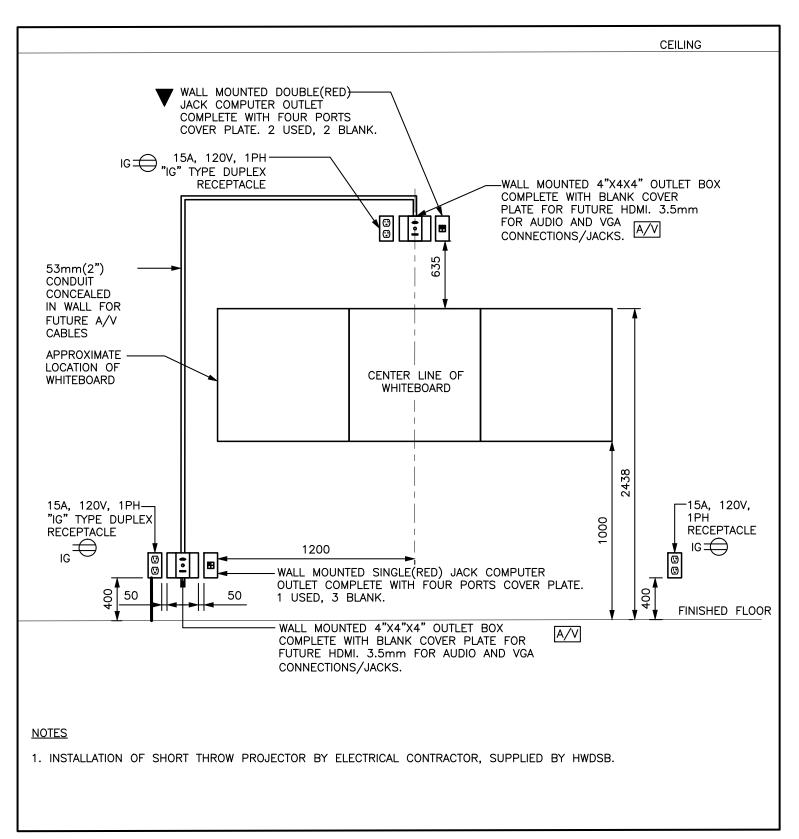

TYPICAL TEACHING WALL DETAIL

PANEL LOCATION: HALL WAY MAINS: 225A 120/208V 3ø 4W BUSSING: DTHER:						. —	RCUIT PANELBOARD SURE: TYPE-1 (SPRINKLER PROO =10KA
LOAD DESCRIPTION	VA		BRKR 45A	BRKR		VA	LOAD DESCRIPTION
EXISTING	_	3		45A	2	_	EXISTING
		5	45A	45A	6		
EXISTING	_	9	1		10	_	EXISTING
		11	45A	45A	12		
EXISTING	_	15 17	1		16	_	EXISTING
		19	20A	20A	20		
EXISTING	_	21			22	_	EXISTING
SPARE	-	25	20A	20A	26	_	SPARE
SPARE	-	27	20A	20A	28	_	SPARE
SPARE	-	29	20A	15A	30	600	RECEP - 104
ABOVE COUNTER RECEP - 104	600	31	15A	15A	32	500	BOTTLE FILLER
RECEP - 104	1000	33	15A *15A	15A	34	_	SPARE
HAND DRYER - 114	1000	35	*15A *15A	 	36		SPACE
HAND DRYER - 114	1000	37	*15A	<u> </u>	38		SPACE
HAND DRYER - 120	1000	39	├ ── 	 	40		SPACE
HAND DRYER - 120	1000	41	*15A	↓ –	42		SPACE
CONNECTED LOAD (L.H.)	_		•			_	CONNECTED LOAD (R.H.)

MAINS: 225A 120/208V 3ø 4W BUSSING: DTHER:							RCUIT PANELBOARD SURE: TYPE—1 (SPRINKLER PRO =10KA
LOAD DESCRIPTION	VA		BRKR 45A	BRKR		VA	LOAD DESCRIPTION
		1		45A	2		
EXISTING	-	3	-1-	+1	4	_	EXISTING
		5	45A	45A	6		
		7	- T	+7	- 8		
EXISTING	-	9		+1	10	_	EXISTING
		11	45A	45A	12		
		13		+~~	14		
EXISTING	_	15	-1-	+1	16	-	EXISTING
		17	20A	20A	18		
		19		$+\overline{T}$	20		
EXISTING	_	21		+1	22	-	EXISTING
		23	20A	15A	24		
SPARE	-	25	20A	15A	26	_	EXISTING
SPARE	-	27	20A	15A	28	_	EXISTING
SPARE	-	29	15A	15A	- 30	_	EXISTING
SPARE	-	31	15A	15A	32	_	EXISTING
SPARE	_	33	15A	+~~	34	_	EXISTING
SPARE	-	35		+	- 36		EXISTING
BOTTLE FILLER	500	37		+ -	- 38		SPACE
HAND DRYER - 128A	1000	39		+ -	40		SPACE
HAND DRYER - 128A	1000	41		<u> </u>	42		SPACE
CONNECTED LOAD (L.H.)	_		_			_	CONNECTED LOAD (R.H.)

OCCUPANCY SENSOR/SWITCH SCHEDULE

SYMBOL	DESCRIPTION	ACCEPTABLE PRODUCTS
® ^{T1}	NETWORKED LOW VOLTAGE ULTRASONIC CEILING SENSOR (CORRIDOR APPLICATION)	WATTSTOPPER LMUC-100 OR APPROVED EQUIVALENT
● _{T2}	LOW VOLTAGE DUAL TECHNOLOGY CEILING MOUNT OCCUPANCY SENSOR.	WATTSTOPPER DT-300 OR APPROVED EQUIVALENT
\$ ^{T1}	LOW VOLTAGE 4 SCENE SWITCH WITH DIMMING	WATTSTOPPER LMSW-241 OR APPROVED EQUIVALENT
\$ ^{T2}	LOW VOLTAGE 1 SCENE SWITCH	WATTSTOPPER LMSW-210 OR APPROVED EQUIVALENT
\$	LINE VOLTAGE DUAL TECHNOLOGY WALL SWITCH TYPE OCCUPANCY SENSOR WITH MANUAL ON/OFF	WATTSTOPPER DWS-301 OR APPROVED EQUIVALENT

LIGHTING CONTROL TYPES

NOT ALL CONTROL TYPES MAY HAVE BEEN USED. REFER TO LIGHTING DRAWINGS FOR ALL REQUIREMENTS. FOR ALL TYPES BELOW; 'UNOCCUPIED DURATION SHALL BE 5 MINUTES.

CTO - NO CONTROL ALWAYS 'ON' 24/7

CT1 — BAS CONTROLLED BASED ON SECURITY PANEL
IF SYSTEM IS ARMED; LIGHTS ARE OFF
WHEN SYSTEM IS DISARMED:
— ON TO PRE—SET LEVEL
— DIM TO 50% WHEN NO OCCUPANCY IS DETECTED
UPON BURGLAR ALARM TURN LIGHTS ON UNTIL SYSTEM IS
CLEARED

CT2 - MANUAL 'ON' / AUTOMATIC 'OFF'
AUTO 'OFF' BY OCCUPANCY AFTER 15 MINUTES
MANUAL 'RAISE/LOWER'

CT3 — AUTOMATIC 'ON' / AUTOMATIC 'OFF'
AUTO 'OFF' BY OCCUPANCY AFTER 15 MINUTES
LOCAL MANUAL OVERRIDE KEY SWITCH

LIGHTING CONTF	ROLS
ROOM	TYPE
CORRIDOR	CT1
CLASSROOMS	CT2
WASHROOMS	CT3
CUSTODIAL	CT3

PRESET 'ON' TO 75%

LIGHTING FIXTURE SCHEDULE

TYPE	DESCRIPTION	ACCEPTABLE PRODUCT
X10	LED RUNNING MAN EXIT SIGN COMPLETE WITH THE FOLLOWING ATTRIBUTES.	1. LUMACELL LA SERIES
	- CEILING/WALL MOUNTED AS PER PLANS - SINGLE/DOUBLE FACE AS PER PLANS - EXTRUDED ALUMINUM HOUSING - 120/347V INPUT - 24V DC INPUT	
BU-1 BU-2	EMERGENCY BATTERY UNIT	1. LUMACELL RGS SERI
ĬŬ−3̄	 120V INPUT/24VDC OUTPUT 2 HEAD WITH 5W LED LAMPS EACH 144W FOR 30 MINUTE OPERATING TIME AUTOMATIC SELF TEST 	
Y1,2	INDOOR REMOTE HEAD (NUMBER RELATES TO # OF HEADS)	1. LUMACELL MQM SERIE OR APPROVED
	- 24VDC INPUT - METAL HOUSING - 5W LED LAMP - 1,2,3 HEADS AS SPECIFIED IN DRAWINGS - 7' MOUNTING HEIGHT	EQUIVALENT
R10	LED RECESSED TROFFER WITH THE FOLLOWING ATTRIBUTES: - 1'X4' - 34W, 4500 LUMENS, 3000K, 120V - 80+ CRI, ROUND SMOOTH DIFFUSER - DLC LISTED, 50K+ HOURS L70, EFFICACY > 110LPW - 0-10V DIMMING (1%) - T-GRID CEILING MOUNT - MIN. 5 YEAR WARRANTY	SIGNIFY CFI FLUXPAN LED GEN 2 OR APPROVED EQUIVALEN
R11	SAME AS TYPE 'R10' EXCEPT THE FOLLOWING ATTRIBUTES:	1. SIGNIFY CFI FLUXPAN LED GEN 2 OR
R20	- DRYWALL KIT LED RECESSED TROFFER WITH THE FOLLOWING ATTRIBUTES: - 2'X4' - 36W, 4800 LUMENS, 3000K, 120V - 80+ CRI, SMOOTH DIFFUSER - DLC LISTED, 50K+ HOURS L70, EFFICACY > 110LPW - 0-10V DIMMING (1%) - T-GRID CEILING MOUNT - MIN. 5 YEAR WARRANTY	APPROVED EQUIVALE 1. SIGNIFY CFI FLUXPAI LED GEN 2 OR APPROVED EQUIVALE

DO NOT SCALE DRAWING. DIMENSIONS ARE TO BE CHECKED AND VERIFIED BY THE CONTRACTOR ON SITE ALL DRAWINGS, SPECIFICATIONS, AND RELATED DOCUMENTS ARE THE COPYRIGHT PROPERTY OF THE ARCHITECT AND MUST BE RETURNED UPON REQUEST. REPRODUCTION OF DRAWINGS, SPECIFICATIONS, AND RELATED DOCUMENTS IN WHOLE OR IN PART IS STRICTLY FORBIDDEN WITHOUT THE ARCHITECT'S WRITTEN PERMISSION.

2 ISSUED FOR TENDER 2025-02-11
1 ISSUED FOR PERMIT 2024-12-16
B 85% PROGRESS 2024-11-27
A 30% PROGRESS SUBMISSION 2024-11-01
No. DESCRIPTION DATE

REVISIONS

24076

E&M

Consulting Engineers Inc.

6004 Osprey Blvd,
Missisauga, ON, LSN 8K1
Canada
www.eandmconsultingeng.com



www.aja.design I info@aja.design I 905.920.5121

project title:
HAMILTON- WENTWORTH
DISTRICT SCHOOL BOARD
P02085 - FRANKLIN RD

ELEMENTARY SCHOOL RENOVATIONS. 500 FRANKLIN ROAD HAMILTON, ONTARIO.

ELECTRICAL DETAILS

MD NTS

date:

project number:
24-21

checked: DRAWING NO:

checked: DRAWING NO: MD date: E3-00

0

ELECTRICAL SPECIFICATIONS

1. RELATED INSTRUCTIONS

- 1.1. THIS SPECIFICATION SHALL APPLY TO AND GOVERN ALL WORK BY
- 1.2. FURNISH ALL LABOUR, MATERIAL, TOOLS, EQUIPMENT, ETC., REQUIRED TO COMPLETE ALL WORK SHOWN ON THE DRAWINGS AND HEREIN SPECIFIED. THE WORK SHALL BE IN ACCORDANCE WITH RULES AND REGULATIONS OF ALL AUTHORITIES HAVING LEGAL JURISDICTION OVER THE WORK. PROVIDE ANY SMALL ITEMS OF WORK NOT SPECIFICALLY CALLED FOR BUT REQUIRED TO COMPLETE THE INTENDED
- 1.3. DEVICE/EQUIPMENT LOCATIONS ARE APPROXIMATE. CHANGE LOCATION OF ANY DEVICE/EQUIPMENT WITHIN 3M OF INDICATED LOCATION AT NO ADDITIONAL COST TO OWNER PROVIDED INSTRUCTIONS ARE RECEIVED. PRIOR TO COMMENCING ROUGH-IN WORK, PRIOR TO COMMENCING ANY ROUGH-IN OR INSTALLATION WORK VISIT SITE, MEET WITH THE OWNERS REPRESENTATIVE AND CONFIRM EXACT LOCATION OF ALL

2. LIABILITY INSURANCE

2.1. OBTAIN AND CARRY PROPER INSURANCE TO FULLY PROTECT BOTH THE OWNER AND HIMSELF FROM ANY AND ALL CLAIMS DUE TO ACCIDENTS, MISFORTUNES, ACTS OF GOD, ETC.

3. CODES, PERMITS AND INSPECTION

- 3.1. BUILDING PERMIT SHALL BE OBTAINED BY OWNER.
- ELECTRICAL CONTRACTOR SHALL BE RESPONSIBLE FOR, AND OBTAIN ALL OTHER PERMITS. INSPECTIONS. VERIFICATIONS. ETC.. AS REQUIRED BY ALL AUTHORITIES HAVING JURISDICTION OVER THIS WORK AND PAY
- 3.2. DELIVER ALL PERMITS TO THE OWNER AS SOON AS THEY BECOME
- 3.3. AT THE CONCLUSION OF THE PROJECT, SUBMIT TO THE OWNER, THE ELECTRICAL SAFETY AUTHORITY FINAL ACCEPTANCE CERTIFICATE.

4. RECORD DRAWINGS AND EQUIPMENT MANUALS

FOR ALL FEES RELATED TO SAME.

- 4.1. AS THE PROJECT PROGRESSES, RECORD, ON A SET OF WHITE PRINTS, ALL ADDENDA, CHANGES TO AND DEVIATIONS FROM THE PLANS MADE DURING THE CONSTRUCTION PERIOD, ALSO, RECORD THE LOCATION OF ALL LIGHT FIXTURES AND OTHER ELECTRICAL EQUIPMENT AND WIRING FOR SAME.
- 4.2. MAKE THESE PROGRESS RECORD DRAWING WHITE PRINTS AVAILABLE TO THE CONSULTANTS FOR THEIR REVIEW AT ALL TIMES DURING THE CONSTRUCTION PERIOD.
- 4.3. AT THE CONCLUSION OF THE PROJECT, TRANSFER ALL RECORD DRAWING INFORMATION TO A USB FLASH DRIVE.
- 4.4. THE CONSULTANT SHALL PROVIDE TO THE CONTRACTOR A COPY OF THE DRAWINGS IN AUTOCAD FORMAT. COMPLETE AND RETURN THE RELEASE FORM "TRANSFER OF FILES ON ELECTRONIC MEDIA" IN ORDER TO RECEIVE AND USE THE ELECTRONIC FILES. (SAMPLE OF THE FORM CAN BE PROVIDED ON REQUEST).
- 4.5. BEFORE SUBSTANTIAL PERFORMANCE OF THE CONTRACT, COMPLY WITH THE FOLLOWING:
- 4.5.1. PROVIDE USB FLASH DRIVE CONTAINING ALL UPDATED RECORD DRAWING INFORMATION IN AUTOCAD FORMAT AS SPECIFIED HEREIN.
- 4.5.2. PROVIDE TWO (2) SETS OF EQUIPMENT DATA SHEETS AND/OR MANUFACTURER'S MAINTENANCE MANUALS COVERING EACH SYSTEM AND ITS COMPONENTS IN ACCORDANCE WITH REQUIREMENTS OF EACH APPROPRIATE SECTION. THESE SETS ARE TO BE IN GOOD QUALITY BINDERS EQUAL TO VYN-L-LINE #VL-3096-B 2", (51mm) RINGS. THE BINDER IS TO BE DIVIDED INTO SECTIONS WITH TABS CLEARLY MARKED INDICATING THE SYSTEMS, ETC.

5. EQUIPMENT AND MATERIAL

5.1. ALL EQUIPMENT AND MATERIAL, UNLESS SPECIFICALLY NOTED OTHERWISE, SHALL BE NEW AND WITHOUT BLEMISH OR DEFECT. ALL MATERIAL AND EQUIPMENT SHALL BEAR ULC. OR CSA LABELS.

6. ACCESSIBILITY

6.1. INSTALL ALL WORK SO AS TO BE READILY ACCESSIBLE FOR OPERATION MAINTENANCE AND REPAIRS.

7. RESPONSIBILITY

7.1. BE RESPONSIBLE FOR WORK UNTIL COMPLETION AND FINAL ACCEPTANCE, FOR REPLACING ANY ITEM THAT MAY BE DEFECTIVE. DAMAGED, LOST OR STOLEN WITHOUT ADDITIONAL COST TO THE OWNER OR DELAY TO THE COMPLETION OF THE PROJECT.

8. CONDUIT, AND WIRING

- 8.1. USE EMT CONDUIT FOR ALL WIRING UNLESS NOTED OTHERWISE. ALL CONDUIT SHALL BE INSTALLED PARALLEL TO BUILDING LINES AND
- 8.2. UNLESS NOTED OTHERWISE, CONDUITS SHALL BE CONCEALED EMT COMPLETE WITH STEEL SET SCREW TYPE CONNECTORS AND
- 8.3. DO NOT RUN CONDUITS IN FIRE RATED CEILING ASSEMBLIES.
- 8.4. SURFACE RACEWAY SYSTEM WITH WIRING LAID IN SHALL BE ACCEPTABLE BUT KEPT TO A MINIMUM IN AREAS WHERE EMT CONDUIT CAN NOT BE CONCEALED. TWO PIECE STEEL ASSEMBLY MANUFACTURED AS LAY-IN TYPE RACEWAY C/W TEES, ELBOWS AND HANGER FITTING AND SUPPORTS REQUIRED FOR A COMPLETE SYSTEM WIREMOLD OR APPROVED EQUAL.
- 8.6. ALL SURFACE MOUNTED RACEWAYS IN AREAS OTHER THAN SERVICE ROOMS SHALL BE WIREMOLD OR EQUIVALENT. COLOUR TO MATCH
- 8.7. ALL CONDUCTORS SHALL BE COPPER, RW90 XLPE #12 AWG MINIMUM UNLESS NOTED OTHERWISE. WHERE THE DISTANCE FROM THE PANELBOARD TO THE LAST OUTLET EXCEEDS 50', #10 AWG CONDUCTOR MUST BE USED FOR THE FULL LENGTH OF THE CIRCUIT.

9. WIRING DEVICES

- 9.1. SWITCHES: RATED 125VAC, 20 AMPERES AND LOW VOLTAGE WHITE TOGGLE TYPE COMPATIBLE WITH EXISTING.
- 9.2. INSTALL SINGLE THROW SWITCHES WITH HANDLE IN "UP" POSITION WHEN SWITCH CLOSED (ON).
- 9.3. INSTALL SWITCHES IN GANG-TYPE OUTLET BOX WHEN MORE THAN ONE SWITCH IS REQUIRED IN ONE LOCATION AND AT 1200mm(48") ABOVE FINISHED FLOOR UNLESS INDICATED OTHERWISE.
- 9.4. 125V SWITCHES AS SHOWN SHALL BE LOW VOLTAGE COMPLETE WITH TRANSFORMERS AND CONTROL RELAYS LOCATED CONCEALED IN
- 9.5. RECEPTACLES: 3-WIRE, U-GROUND TYPE GENERAL PURPOSE, HEAVY DUTY, NEMA 5-15R.
- 9.6. INSTALL RECEPTACLES IN GANG-TYPE OUTLET BOX WHEN MORE THAN ONE SWITCH IS REQUIRED IN ONE LOCATION AND AT 450mm(18") ABOVE FINISHED FLOOR UNLESS NOTED OTHERWISE.
- 9.7. FLOOR BOX: RFB4 SERIES BY LEGRAND WITH ALL REQUIRED ACCESSORIES FOR A COMPLETE SYSTEM. PROVIDE FLOOR SCANNING PRIOR TO CUTTING INTO EXISTING FLOORS.

9.8. COVERPLATES:

- 9.8.1. PROVIDE No.301 STAINLESS STEEL, BRUSHED COVERPLATES C/W PROTECTIVE PLASTIC FILM UNTIL PAINTING AND OTHER WORK IS FINISHED FOR ALL WIRING DEVICES MOUNTED IN A FLUSH MOUNTED OUTLET BOX. PROVIDE COMMON COVERPLATE WHEN WIRING DEVICES ARE GROUPED TOGETHER.
- 9.8.2. PROVIDE FITTING SHEET METAL (CAST) COVERPALTES FOR WIRING DEVICES MOUNTED IN SURFACE FS OR FD TYPE CONDUIT
- 9.8.3. DO NOT USE COVERPLATES MEANT FOR FLUSH OUTLET BOXES ON SURFACE MOUNTED BOXES.
- 9.9. ACCEPTABLE MANUFACTURERS ARE:
- BRYANT 9.9.2. CROUSE-HINDS
- HUBBELL 9.9.4. LEVITON

9.9.7.

9.9.5. PASS & SEYMOUR 9.9.6. LEGRAND OR OTHER APPROVED EQUALS

10. WIRING FOR MECHANICAL EQUIPMENT

- 10.1. SUPPLY AND INSTALL ALL STARTERS, DISCONNECTS, RELAYS, WIRING, ETC., TO ACCOMMODATE THE COMPLETE MECHANICAL SYSTEM, UNLESS NOTED OTHERWISE.
- 10.2. OTHER DIVISIONS SUPPLYING MOTOR-DRIVEN EQUIPMENT SHALL SUPPLY AND INSTALL ALL NECESSARY MOTORS WITH SUCH EQUIPMENT. ALL INTERNAL CONTROL WIRING IN SUCH EQUIPMENT SHALL BE FACTORY INSTALLED, OR SHALL BE SUPPLIED AND INSTALLED BY THOSE SUPPLYING THE EQUIPMENT.
- 10.3. REFER TO MECHANICAL DRAWINGS AND SPECIFICATIONS DURING TENDERING AND CONSTRUCTION TO ENSURE ENTIRE MECHANICAL EQUIPMENT WIRING SCOPE OF WORK IS UNDERSTOOD.
- 10.4. THIS DIVISION IS RESPONSIBLE FOR THE FOLLOWING:
- 10.4.1. SUPPLY AND INSTALLATION OF ALL STARTERS, DISCONNECT SWITCHES, PUSHBUTTON STATIONS, SPLITTER TROUGHS, JUNCTION BOXES AND TIME SWITCHES, ETC., AS NOTED ON DRAWING.
- 10.4.2. INSTALLATION AND WIRING OF ALL SEPARATELY MOUNTED THERMOSTATS, MOTOR CONTROLLERS AND CONTROL UNITS WHICH ARE SUPPLIED BY MECHANICAL.
- 10.4.3. SUPPLY AND INSTALLATION OF ALL POWER WIRING AND CONDUITS FROM THE DISTRIBUTION PANEL THROUGH THE STARTER AND DISCONNECT SWITCH ONTO THE MOTOR (OR EQUIPMENT)
- 10.4.4. SUPPLY AND INSTALLATION OF ALL CONTROL WIRING FROM REMOTE SWITCHES OR PUSHBUTTON STATIONS TO CONTROL
- 10.4.5. SUPPLY AND INSTALLATION OF ALL WIRING TO PROVIDE INTERLOCKING BETWEEN STARTERS COMPLETE WITH NECESSARY DOUBLE VOLTAGE RELAYS.
- 10.4.6. SUPPLY AND INSTALLATION OF TRANSIENT (SURGE) SUPPRESSERS ON HOLDING COILS OF MAGNETIC STARTERS, RELAYS, ETC., WHERE INDICATED FOR PROTECTION TO SOLID STATE EQUIPMENT THAT IS SENSITIVE TO SURGES. SPIKES. ETC.

11. MOTOR STARTERS

- 11.1. MANUAL STARTER SHALL HAVE QUICK-MAKE, QUICK-BREAK, SWITCHING MECHANICAL COMPLETE WITH OVERLOAD HEATERS, MANUAL RESET, TRIP INDICATING HANDLE, AND LOCKING TAB TO PERMIT PADLOCKING IN "ON" OR "OFF" POSITION.
- 11.2. MAGNETIC AND COMBINATION MOTOR STARTERS TO BE MINIMUM SIZE 1 TYPE. AND RATING TO SUIT MOTOR LOAD. C/W CONTROL TRANSFORMER, CONTACTOR SOLENOID OPERATED, MOTOR OVERLOAD PROTECTIVE DEVICE IN EACH PHASE, MANUALLY RESET, POWER AND CONTROL TERMINALS. PUSHBUTTONS AND SELECTOR SWITCHES. TWO N/O AND TWO N/C AUXILIARY CONTACTS, PROVISION FOR PREVENTING SWITCHING TO "ON" POSITION WHILE ENCLOSURE DOOR IS OPEN.

- 12.1. REFER TO LIGHTING FIXTURE SCHEDULE ON DRAWINGS FOR DETAILS. 12.2. MINIMUM CRI OF 80
- 12.3. 50,000+ HOURS L70 LUMEN PERFORMANCE 12.4. EFFICACY OF >110 LUMENS PER WATT 12.5. MINIMUM 5 YEARS WARRANTY
- 12.6. PROVIDE DLC LISTING NUMBER AND ENERGY STAR CERTIFICATION

13. FIRE ALARM SYSTEM

- 13.1. ALL NEW FIRE ALARM DEVICES SHALL BE COMPATIBLE WITH THE EXISTING SIMPLEX 4010 FIRE ALARM PANEL. CONTRACTOR SHALL OBTAIN ADDITIONAL INFORMATION FROM THE SYSTEM MAINTENANCE COMPANY(SEE BELOW). TEST AND VERIFY SYSTEM UPON COMPLETION AND SUBMIT REPORT TO CONSULTANTS.
 - PASSWORD AT 1800-561-3009 TO PERFORM ALL MODIFICATIONS & ADDITIONS TO THE EXISTING SYSTEM AND INCLUDE ALL ASSOCIATED COSTS. CONFIRM SPACE FOR NEW DEVICES IN THE PANEL.
- 13.2. UPGRADE, RE-PROGRAM EXISTING CONTROL PANEL AND ALL REMOTE ANNUNCIATOR PANELS AS REQUIRED TO ACCOMMODATE NEW DEVICES AND INITIATING ZONES AS INDICATED ON PLANS FOR THE ADDITION OF NEW DEVICES AND NEW INITIATING ZONES TO THE EXISTING.
- 13.3. UNLESS INDICATED OTHERWISE ON PLANS, WIRE NEW DEVICES TO EXISTING LOCAL FIRE ALARM INITIATING ZONE AND NEW SPEAKERS TO EXISTING LOCAL SIGNAL CIRCUITS.

13.4. CODES AND STANDARDS

- .1 AUDIBLE SIGNAL APPLIANCES STANDARD ULC-S525
- .2 SMOKE DETECTORS STANDARD ULC-S529 .3 SYSTEM INSTALLATION STANDARD CAN/ULC-S524 .4 SYSTEM VERIFICATION STANDARD CAN/ULC-S537

13.5. PRODUCTS

- .1 FIRE ALARM PULL STATION
- .1 PANEL # .2 SMOKE DETECTOR IONIZATION TYPE .1 PANEL #
- .3 HEAT DETECTOR FIXED TEMPERATURE .1 PANEL # .4 HEAT DETECTOR FIXED TEMPERATURE AND RATE OF RISE
- .1 PANEL #
- .5 HORN & STROBE .6 CONTROL RELAY MODULES
- .1 PANEL # (RELAY IAM) WITH ONE FORM "C" DRY RELAY PER MODULE WITH CONTACTS RATED: 2A @24VDC AND 1.0A @120VAC.
- 13.6. TESTING AND VERIFICATION .1 PERFORM SYSTEM TESTING AND VERIFICATION AND SUBMIT REPORT TO CONSULTANTS.

14. REVISIONS TO EXISTING PANEL BOARDS

14.1. ALL EXISTING PANEL BOARDS ON DRAWINGS TO REMAIN AND BE REUSED TO FEED NEW DEVICES. FOR IDENTIFIED PANELBOARDS WHERE APPLICABLE ELECTRICAL CONTRACTOR SHALL SUPPLY AND INSTALL NEW BRANCH AND FEEDER BREAKERS, TYPE, QUANTITY AND CAPACITY AS IDENTIFIED ON DRAWING AND INSTALL IN EXISTING PANEL. ON EACH PANEL BOARD MODIFIED PROVIDE REVISED AND UPDATED PANEL BOARD SCHEDULE TO REFLECT NEW LOADS. RE-USE ALL SPARE BREAKERS MADE REDUNDANT IN DEMOLITION PHASE AND UPDATE PANEL BOARD SCHEDULES TO REFLECT ALL NEW AND REVISED CIRCUITS.

15. MILLWORK, FURNITURE, AND EQUIPMENT WIRING

15.1. ALL EQUIPMENT MUST BE CAREFULLY COORDINATED FOR EXACT FLOOR OR WALL LOCATIONS PRIOR TO DRILLING CONDUIT SLEEVES THROUGH FLOOR SLABS OR WALLS.

16. LIGHTING CONTROL

- 16.1. BASIS OF DESIGN IS A WATTSTOPPER DLM LOW VOLTAGE CONTROLS FOR A COMPLETE SYSTEM.
- 16.2. EXTENT OF LIGHTING CONTROL SYSTEM WORK IS INDICATED ON DRAWINGS ALONG WITH SEQUENCE OF OPERATIONS. THE SYSTEM IS DEFINED TO INCLUDE, BUT NOT BY WAY OF LIMITATION.
- 16.2.1. OCCUPANCY SENSORS
- 16.2.2. DAYLIGHT SENSORS 16.2.3. DIGITAL ROOM CONTROLLERS
- 16.2.4. NETWORK DEVICES
- 16.2.5. WALL STATIONS 16.2.6. SOFTWARE
- 16.3. CORRIDOR LIGHTING SHALL BE TIED INTO BAS. REFER TO DRAWINGS FOR MORE DETAILS.
- 16.4. ACCEPTABLE MANUFACTURERS
- 16.4.1. LEGRAND WATTSTOPPER

16.4.2. ACUITY N-LIGHT 16.4.3. COOPER

17. COMMUNICATION

- 17.1. THE CABLE INFRASTRUCTURE SPECIFICATION IS TO BE READ IN CONJUNCTION WITH THE HWDSB NETWORK INFRASTRUCTURE STANDARDS FOR SCHOOL TELECOMMUNICATION VOICE AND DATA
- 17.2. IT IS THE ELECTRICAL CONTRACTORS RESPONSIBILITY TO COORDINATE ALL ASPECTS OF WORK UNDER THIS SECTION WITH THE BOARD APPROVED DATA SUBCONTRACTOR AND BOARD'S I.T REPRESENTATIVE.
- 7.3. THE SUPPLY, INSTALLATION, AND USE OF RACETRAYS AND CABLING PATHWAYS SHALL COMPLY WITH ANSI/TIA/EIA-569-A,
- 7.4. THE CATEGORY 6 PORTION OF THE CABLING SYSTEM SHALL COMPLY WITH THE LINK AND CHANNEL PERFORMANCE REQUIREMENTS OF TIA/EIA-568- B.
- 7.5. THE CONTRACTOR SHALL CONFORM TO CERTIFICATION IN THE INSTALLATION OF PANDUIT, COMMSCOPE (SYSTIMAX) WHERE UPON COMPLETION THE CONTRACTOR MUST PROVIDE OFFICIAL CERTIFICATION DOCUMENTS.
- 7.6. UNCONDITIONALLY GUARANTEE IN WRITING THE MATERIALS, EQUIPMENT, AND WORKMANSHIP FOR A PERIOD OF NOT LESS THAN FIFTEEN (15) YEARS FROM DATE OF ACCEPTANCE BY THE THE OWNER SHALL DEEM
- 7.7. TRANSFER MANUFACTURER'S WARRANTIES TO THE OWNER IN ADDITION TO THE GENERAL SYSTEM GUARANTEE. SUBMIT THESE WARRANTIES ON EACH ITEM IN LIST FORM WITH SHOP DRAWINGS. DETAIL SPECIFIC PARTS WITHIN EQUIPMENT THAT ARE SUBJECT TO SEPARATE CONDITIONAL WARRANTY. WARRANTY PROPRIETARY EQUIPMENT AND SYSTEMS INVOLVED IN THIS CONTRACT DURING THE GUARANTEE PERIOD. FINAL PAYMENT SHALL NOT RELIEVE YOU OF THESE
- 7.8. SUBMIT SCHEDULE FOR INSTALLATION OF EQUIPMENT AND CABLING.
- 7.9. APPROVED CABLING CONTRACTORS ARE:

OBLIGATIONS.

ACCEPTANCE AS BENEFICIAL USE.

- 7.9.1. COMU NETWORKS MIKE ONEAL, 289-253-9289, MIKEJ.ONEAL@COMU.CA
- 7.9.2. CONNEX TELECOMMUNICATIONS INC. ED BALIAN, 905-944-6516, ESTIMATING@CONNEXSERVICE.CA
- 7.9.3. M ARCOMM INTEGRATED BUSINESS SOLUTIONS ADAM LUCIA, 416-938-3730. ADAM.LUCIA@TELECON.CA
- 7.9.4. RAMCOM COMMUNICATIONS INC. STEPHEN STIPAC, 647-404-5811, STIPACS@RAMCOM.CA
- 416-244-2525, ESTIMATING@TELECOMBYDESIGN.CA 7.10. PROVIDE PRODUCTS OF MANUFACTURERS AS NAMED IN INDIVIDUAL

7.9.5. TBD TELECOM BY DESIGN INC. - JAMES PATARAN,

PRODUCTS OF MANUFACTURERS IN COMPLIANCE WITH REQUIREMENTS. 7.11. VOICE AND DATA CABLE ARE SOLID COPPER, 24AWG, FT6 PLENUM, 1000HM BALANCED TWISTED PAIR (UTP) CATEGORY 6 CABLES WITH FOUR INDIVIDUALLY TWISTED PAIRS WHICH MEET OR EXCEED THE MECHANICAL AND TRANSMISSION PERFORMANCE SPECIFICATIONS IN

ARTICLES, WHERE NO MANUFACTURER IS SPECIFIED, PROVIDE

7.12. ALL OUTLETS SHALL BE INSTALLED WITH CABLES COILED IN THE WALL (OR IN SURFACE MOUNTED BOXES) IF ADEQUATE SPACE IS PRESENT TO HOUSE THE CABLE COIL WITHOUT EXCEEDING THE MANUFACTURER'S BEND RADIUS. NO MORE THAN 12" OF SLACK

SHALL BE STORE IN AN IN WALL BOX OR INSULATED WALL.

ANSI/TIA/EIA-568-B.2 UP TO 100 MHz.

- 7.13. VOICE JACKS, UNLESS NOTED OTHERWISE SHALL BE LOCATED IN THE BOTTOM POSITION(S) OF EACH FACEPLATE. VOICE JACKS IN HORIZONTALLY ORIENTED FACEPLATES SHALL OCCUPY THE RIGHT
- MOST POSITION(S) (WHITE IN COLOUR). 7.14. DATA JACKS SHALL OCCUPY THE TOP POSITION(5) ON THE FACEPLATE. DATA JACKS IN THE HORIZONTALLY ORIENTED FACEPLATES SHALL OCCUPY THE LEFT MOST POSITION(S) (RED IN COLOUR).
- 7.15. VOICE AND DATA PATCH CABLES SHALL BE STRANDED COPPER, 24AWG, 1000HM BALANCED TWISTED PAIR (UTP) CATEGORY 6 CABLES WITH FOUR INDIVIDUALLY TWISTED PAIRS WHICH MEET OR EXCEED THE MECHANICAL AND TRANSMISSION PERFORMANCE SPECIFICATIONS IN ANSI/TIA/EIA-568- B.2 UP TO 100 MHz. PATCH CABLES ARE TO BE PROVIDED IN THE FOLLOWING QUANTITIES BASED ON THE TOTAL NUMBER OF DATA DROPS MULTIPLED BY 2 TO ACCOMMODATE NODE AND PATCH PANEL 50% ARE 7FT; 25% ARE 5FT; 15% ARE 3FT;
- 10% ARE 10 FT. 7.16. PATCH PANELS SHALL BE 19" RACK MOUNTABLE, 8 PIN MODULAR TO INULATION DISPLACEMENT CONNECTOR (IDC) MEETING CATEGORY 6 PERFORMANCE STANDARDS, AND PINNED TO EITHER T568 (A OR B)
- 7.17. PRIOR TO STANT OF SYSTEMS INSTALLATION, MEET AT THE PROJECT SITE WITH THE OWNER'S REPRESENTATIVE AND REPRESENTATIVES OF TRADES PERFORMING RELATED WORK TO COORDINATE EFFORTS. REVIEW AREAS OF POTENTIAL INTERFERENCE AND RESOLVE CONFLICTS BEFORE PROCEEDING WITH THE WORK.
- 7.18. HORIZONTAL DISTRIBUTION CABLE SHALL BE INSTALLED IN ACCORDANCE WITH THE MANUFACTURER'S RECOMMENDATIONS AND BEST INDUSTRY PRACTICES.

- 7.19. ATTACH CABLE TO PERMANENT STRUCTURE WITH SUITABLE ATTACHMENTS AT INTERVALS OF 48". SUPPORT CABLES INSTALLED ABOVE REMOVABLE CEILINGS.
- 7.20. INSTALL ADEQUATE SUPPORT STRUCTURES FOR 10 FOOT OF SERVICE SLACK AT TERMINATION ROOM.
- 7.21. DO NOT SPLICE CABLES.

BLOCK.

- 7.22. INSTALL STATION CABLING TO THE NEAREST WIRING CLOSET UNLESS OTHERWISE NOTED.
- 7.23. CABLES SHALL NOT BE ATTACHED TO THE CEILING GRID OR LIGHTING
- SUPPORT WIRES, 7.24. REPLACE ALL DAMAGED OR DEFECTIVE PRODUCT.
- 7.25. LABEL EACH CABLE WITH PERMANENT SELF ADHESIVE ON FRONT RECEPTACLE BOX FOR EACH JACK AT COMPUTER NODE END AND ON FRONT PANEL OF THE WIRING CLOSET PATCH PANEL OR PUNCH
- 7.26. NAMING CONVENTION USED SHALL BE AS FOLLOWS FOR THE COMPUTER NODE END: CLOSETS#- PATCHPANEL#- PORT#.
- 7.27. NAMING CONVENTION USED SHALL BE AS FOLLOWS FOR THE WIRING CLOSET END: EACH RACK LABELED WITH A NUMBER STARTING AT 1 PER CLOSET; EACH PATCH PANEL LABELED WITH A NUMBER STARTING AT 1 PER CLOSET; EACH PORT ON PATCH PANEL LABELED WITH A NUMBER STARTING AT 1 PER PATCH PANEL.
- 7.28. LABELS SHALL BE MACHINE PRINTED. HAND LETTERED LABELS SHALL NOT BE ACCEPTABLE.
- 7.29. TESTING SHALL CONFORM TO ANSI/TIA/EIA-568-B.1 STANDARD. TESTING SHALL BE ACCOMPLISHED USING LEVEL IIE OR HIGHER FIELD
- 7.30. TEST EACH PAIR AND SHIELD OF EACH CABLE FOR OPENS. SHORTS. GROUNDS, AND PAIR REVERSAL. CORRECT GROUNDED, AND REVERSED PAIRS. EXAMINE OPEN AND SHORTED PAIRS TO DETERMINE IF PROBLEM IS CAUSED BY IMPROPER TERMINATION. IF TERMINATION IS PROPER, TAG BAD PAIRS AT BOTH ENDS AND NOTE ON TERMINATION SHEETS, IF CABLE CONTAINS BAD CONDUCTORS OR SHIELD, REMOVE AND REPLACE CABLE.
- 7.31. SUBMIT USB WITH TEST RESULTS AND PROGRAM TO VIEW RESULTS.
- 7.32. WHEN REPAIRS AND RE-TESTS ARE PERFORMED, THE PROBLEM FOUND AND CORRECTIVE ACTION TAKEN SHALL BE NOTED, AND BOTH THE FAILED AND PASSED TEST DATA SHALL BE COLLOCATED IN THE
- 7.33. THE CONTRACTOR SHALL PROVIDED A SYSTEM WARRANTY COVERING THE INSTALLED CABLING SYSTEM AGAINST DEFECTS IN WORKSMANSHIP. COMPONENTS, AND PERFORMANCE, AND FOLLOW- ON SUPPORT
- 7.34. THE CONTRACTOR SHALL WARRANT THE CABLING SYSTEM AGAINST DEFECTS IN WORKMANSHIP FOR A PERIOD OF ONE YEAR FROM THE DATE OF SYSTEM ACCEPTANCE. THE WARRANTY SHALL COVER ALL LABOR AND MATERIALS NECESSARY TO CORRECT A FAILED PORTION OF THE SYSTEM AND TO DEMONSTRATE PERFORMANCE WITHIN THE ORIGINAL INSTALLATION SPECIFICATIONS AFTER REPAIRS ARE ACCOMPLISHED. THIS WARRANTY SHALL BE PROVIDED AT NO ADDITIONAL COST TO THE OWNER.

AFTER PROJECT COMPLETION.

- 7.35. THE CONSULTANT WILL MAKE PERIODIC INSPECTION OF THE PROJECT IN PROGRESS. ONE INSPECTION WILL BE PERFORMED AT THE CONCLUSION OF CABLE PULLING. PRIOR TO CLOSING OF THE FALSE CEILING. TO INSPECT THE METHOD OF CABLE ROUTING AND SUPPORT AND THE FIRESTOPPING OF PENETRATIONS. A SECOND INSPECTION WILL BE PERFORMED AT COMPLETION OF CABLE TERMINATION TO VALIDATE THAT CABLES WERE DRESSED AND TERMINATED IN ACCORDANCE WITH TIA/EIA SPECIFICATIONS FOR JACKET REMOVAL AND PAIR UNTWIST, COMPLIANCE WITH MANUFACTURER'S MINIMUM BEND RADIUS, AND THAT CABLE ENDS ARE DRESSED NEATLY AND ORDERLY.
- 7.36. UPON COMPLETION OF THE PROJECT, THE CONSULTANT WILL PERFORM A FINAL INSPECTION OF THE INSTALLED CABLING SYSTEM WITH THE CONTRACTOR'S PROJECT FOREMAN. THE FINAL INSPECTION WILL BE PERFORMED TO VALIDATE THAT ALL HORIZONTAL AND BACKBONE CABLES WERE INSTALLED AS DEFINED IN THE DRAWING PACKAGE, AND THAT THE INSTALLATION MEETS THE AESTHETIC

EXPECTATIONS OF THE CONSULTANT.

7.37. UPON RECEIPT OF THE TEST DOCUMENT, THE CONSULTANT RESERVES THE RIGHT TO PERFORM SPOT TESTING OF THE CABLING SYSTEM TO VALIDATE RESULTS FROM THE TEST DOCUMENTATION.

INSPECTIONS; RECEIPT OF THE TEST AND AS-BUILT DOCUMENTATION;

AND SUCCESSFUL PERFORMANCE OF THE SYSTEM FOR THREE WEEK

7.38. DURING THE THREE WEEK PRIOR BETWEEN FINAL INSPECTION AND DELIVERY OF THE TEST AND AS- BUILT DOCUMENTATION. THE OWNER WILL ACTIVATE THE CABLING SYSTEM. THE CONSULTANT WILL VALIDATE OPERATION OF THE CABLING SYSTEM DURING THIS PERIOD.

7.39. COMPLETION OF: THE INSTALLATION, IN PROGRESS AND FINAL

PERIOD WILL CONSTITUTE ACCEPTANCE OF THE SYSTEM.

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REVISIONS

E&M

6004 Osprey Blvd, Mississauga, ON, L5N 8K1 Canada

dmconsultingeng.com ARCHITECTS INC

www.aja.design I info@aja.design I 905.920.512

Consulting Engineers Inc.

HAMILTON- WENTWORTH DISTRICT SCHOOL BOARD P02085 - FRANKLIN RD **ELEMENTARY SCHOOL** RENOVATIONS. 500 FRANKLIN ROAD HAMILTON, ONTARIO. drawing title:

ELECTRICAL SPECIFICATION

MD

24-21 DRAWING NO: MD

AS SHOWN