LEGEND DISTRIBUTION PANEL JUNCTION BOX MOTOR CONNECTION DISCONNECT SWITCH TRANSFORMER EXISTING UNDERGROUND CONDUIT (PREVIOUS SCOPE OF WORK) NEW CONDUIT RUN EXISTING CONDUIT RUN ALREADY INSTALLED (PREVIOUS SCOPE OF WORK) NEW POWER CONDUIT RUN EXISTING POWER CONDUIT RUNS ALREADY INSTALLED (PREVIOUS SCOPE OF WORK) C---- CONDUIT DOWN ○ CONDUIT UP EMERGENCY EXIT LIGHT

4. EXCEPT AS OTHERWISE NOTED ALL EQUIPMENT TO BE DEMOLISHED IS SHOWN IN THICK DASHED LINES.

## GENERAL NOTES

PRIOR TO DEMOLITION.

1. THIS DRAWING SHALL BE READ IN CONJUNCTION WITH ALL DRAWINGS AND SPECIFICATIONS FROM THIS AND ALL OTHER DISCIPLINES.

2. THESE GENERAL NOTES APPLY TO ALL ELECTRICAL DRAWINGS. 3. EXCEPT AS OTHERWISE NOTED ALL EQUIPMENT EXISTING TO REMAIN IS SHOWN IN THIN LIGHT GREY SOLID LINES.

5. EXCEPT AS OTHERWISE NOTED ALL NEW EQUIPMENT IS SHOWN IN THICK SOLID LINES. 6. EXCEPT AS OTHERWISE NOTED ALL EQUIPMENT TO BE RELOCATED IS SHOWN IN THICK DASHED LINES AND

INDICATED WITH 'R'. 7. THE CONTRACTOR SHALL VERIFY AND BE RESPONSIBLE FOR ALL DIMENSIONS.

8. IT IS THE CONTRACTOR'S RESPONSIBILITY TO VERIFY ALL EXISTING INFORMATION AND TO CONFIRM CIRCUITS BY

TRACING THEM TO THE SOURCE. 9. ELECTRICAL WIRING, CABLING, AND EQUIPMENT ARE SHOWN ON PLANS DIAGRAMMATICALLY. IT WILL BE THE CONTRACTOR'S RESPONSIBILITY TO CONFIRM CONDITIONS ON SITE FOR THEIR EXACT LOCATION AND ROUTING

10. INSTALLATION DETAILS TO BE VERIFIED AND COORDINATED ON SITE BY THE CONTRACTOR. THE CONTRACTOR SHALL PROVIDE ALL REQUIRED EQUIPMENT AND TOOLS FOR DEMOLITION. 11. EXISTING CIRCUITS, EQUIPMENT AND COMPONENTS SHOWN ON PLANS WERE RETRIEVED FROM AS-BUILT DRAWINGS AND VISUAL INSPECTION AND ARE PROVIDED FOR INFORMATION ONLY. IT IS THE CONTRACTORS

RESPONSIBILITY TO VERIFY ALL EXISTING INFORMATION AND TO CONFIRM CIRCUITS BY TRACING THEM. 12. NOT ALL EXISTING CONDUIT AND CONDUCTORS ARE SHOWN ON DRAWINGS. ALL CONDUIT AND CONDUCTORS ASSOCIATED WITH THAT EQUIPMENT INCLUDING POWER, CONTROLS AND AUXILIARY ARE REQUIRED TO BE INSTALLED TO SUIT LOCATIONS TO MEET REQUIRED FUNCTIONALITY.

13. PATCH AND SEAL ALL OPENINGS IN FLOORS, WALLS AND PARTITIONS. IF FLOORS, WALLS, OR PARTITIONS ARE FIRE RATED, PATCH AND SEAL PENETRATIONS WITH FIRE RESISTANT INSULATION OR APPROVED FIRE STOP SYSTEMS TO ENSURE THE CONTINUITY AND INTEGRITY OF THE FIRE SEPARATION ARE MAINTAINED.

14. CONTRACTOR RESPONSIBLE FOR CAREFUL AND DETAILED COORDINATION OF ALL ELECTRICAL POWER OUTAGES FOR NEW OR EXISTING SERVICES WITH DCC REPRESENTATIVE. ASSUME ALL POWER SHUTDOWNS ARE TO HAPPEN OUTSIDE OF NORMAL WORKING HOURS.

15. PROVIDE NEW CONDUIT AND WIRING BACK TO SOURCE PANEL, WHEREVER A CIRCUIT IS SHOWN ON THE PLANS. 16. ENSURE COMPONENTS (IE. WIRING, CONDUIT, ETC.) RELATING TO THE AREA, ARE INDEPENDENTLY SECURED TO STRUCTURE COMPLY WITH CODE REQUIREMENTS. IT IS NOT ACCEPTABLE TO SECURE THE COMPONENTS TO DUCTWORK, DUCT WORK TO CONDUIT, OR ANY OTHER SYSTEMS.

17. AT COMPLETION OF WORK, WITH ALL LOADS IN OPERATION, INCLUDING LOADS ON SUB-PANELS, MEASURE CURRENT VALUES IN AMPERES PER PHASE AND NEUTRAL IN FEEDER TO EACH OF THE NEW AND EXISTING PANELS. ENSURE LOADS ARE PROPERLY BALANCED AND SUBMIT REPORT IN LETTER FORM TO ENGINEER. 18. PROVIDE WALL SLEEVE FOR ALL CONDUIT PENETRATIONS THROUGH A WALL. COORDINATE LOCATION ON SITE.

19. SCAN CONCRETE FLOOR/WALLS WHEN MOUNTING OR CORING THROUGH FOR NEW ELECTRICAL EQUIPMENT IN ORDER TO AVOID EXISTING SYSTEMS.

20. ALL EXISTING CAMERAS TO BE REMOVED, CONTRACTOR TO REMOVE EXISTING CONDUITS AND WIRING BACK TO NEAREST JUNCTION BOX.

21. ALL SURFACE MOUNT CONDUITS TO MATCH ADJACENT SURFACE COLOUR ON SITE.

22. REFER TO SECURITY DRAWINGS FOR CAMERA MOUNTING HEIGHT AND INSTALLATION DETAIL.

23. ALL WORK SHOWN IN THIN GREY LINE IN CONTRACT DRAWINGS IS WORK COMPLETED UNDER OTHER CONTRACT. CONTRACTOR TO INSPECT ALL WORK SHOWN IN GREY THIN LINES PRIOR TO STARTING NEW WORK. CONTRACTOR TO INFORM DCC REPRESENTATIVE OF ANY CONDITION WHICH DIFFERS FROM CONTRACT DRAWINGS IMMEDIATELY UPON DISCOVERY. ALL WORK SHOWN ON CONTRACT DRAWINGS IN THICK DARK LINES TO BE COMPLETED FOLLOWING THE INSPECTION AND REMEDIATION OF PREVIOUS SCOPE OF WORK

LEVEL OF SECURITY | NIVEAU DE SÉCURITÉ

TO BE REVIEWED | À ÊTRE RÉVISÉ This design is an instrument of service and is protected by copyright, copyright for the consultant's instrument of service belongs to the consultant. Copies including electronic copies, may only be used for the purpose intended and for a one-time use, on the same site, and for the same project and may not be offered for sale or transfer without the express written consent of the consultant.



Cette conception est un instrument de service protégé par le droit d'auteur. Le droit d'auteur sur

l'instrument de service de l'expert-conseil appartient à ce dernier. Les exemplaires de ce dessin,


y compris les exemplaires électroniques, ne peuvent servir qu'aux fins prévues, et ce, qu'une fois,

sur le même chantier et pour le même projet. Ils ne peuvent être offerts en vente ni transférés sans

375, Roland-Therrien Blvd, suite 400 Longueuil (Québec) J4H 4A 6 Tel. 514.281.1010 www.stantec.com

le consentement écrit exprès de l'expert-conseil.

The Contractor shall verify and be responsible for all dimensions. DO NOT scale the drawing any errors or omissions shall be reported to Stantec without delay. The Copyrights to all designs and drawings are the property of Stantec. Reproduction or use for any purpose other than that authorized by Stantec is forbidden.

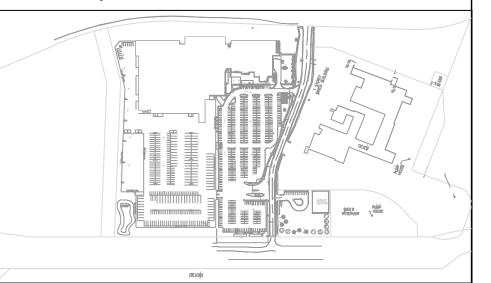

)3	2024/10/16	ISSUED FOR TENDER	JC
)2	2024/04/18	ISSUED FOR TENDER	JC
)1	2024/03/08	ISSUED FOR 100%	JC
00	2023/12/08	ISSUED FOR 99%	JC
Ο.	DATE	REVISION	APPR.
CAL	E   ÉCHELLE		

LOCATION | EMPLACEMENT 1 YUKON LANE, TORONTO ONTARIO

PROJECT | PROJET

SUBJECT | SUJET


DENISON ARMOURY CCTV UPGRADE

TRADE | MÉTIER Electrical 2021/03/26

GENERAL NOTES AND LEGEND

PRODUCTION	REVIEWED   REVU						
DESIGNED   ÉTUDIÉ	XX   XX		DES O   AGENT CONC X.X.				
J.Czyzewski	X.X.						
DRAWN   DESSINÉ			PROJ MGR   GEST PROJ				
C.Mcdonald			X.X.				
CHECKED   VÉRIFIÉ			DES MGR   GEST CONC				
E.Lafleur			X.X. FIRE   INCENDIE				
COORDINATION							
X.X.			X.X.				
WBS NO.   NO. OTP		PF NO.   NO. TT1800					
DWG. NO.   NO. DESSIN		TT1	00002				

TT180003 - 501 Canadä

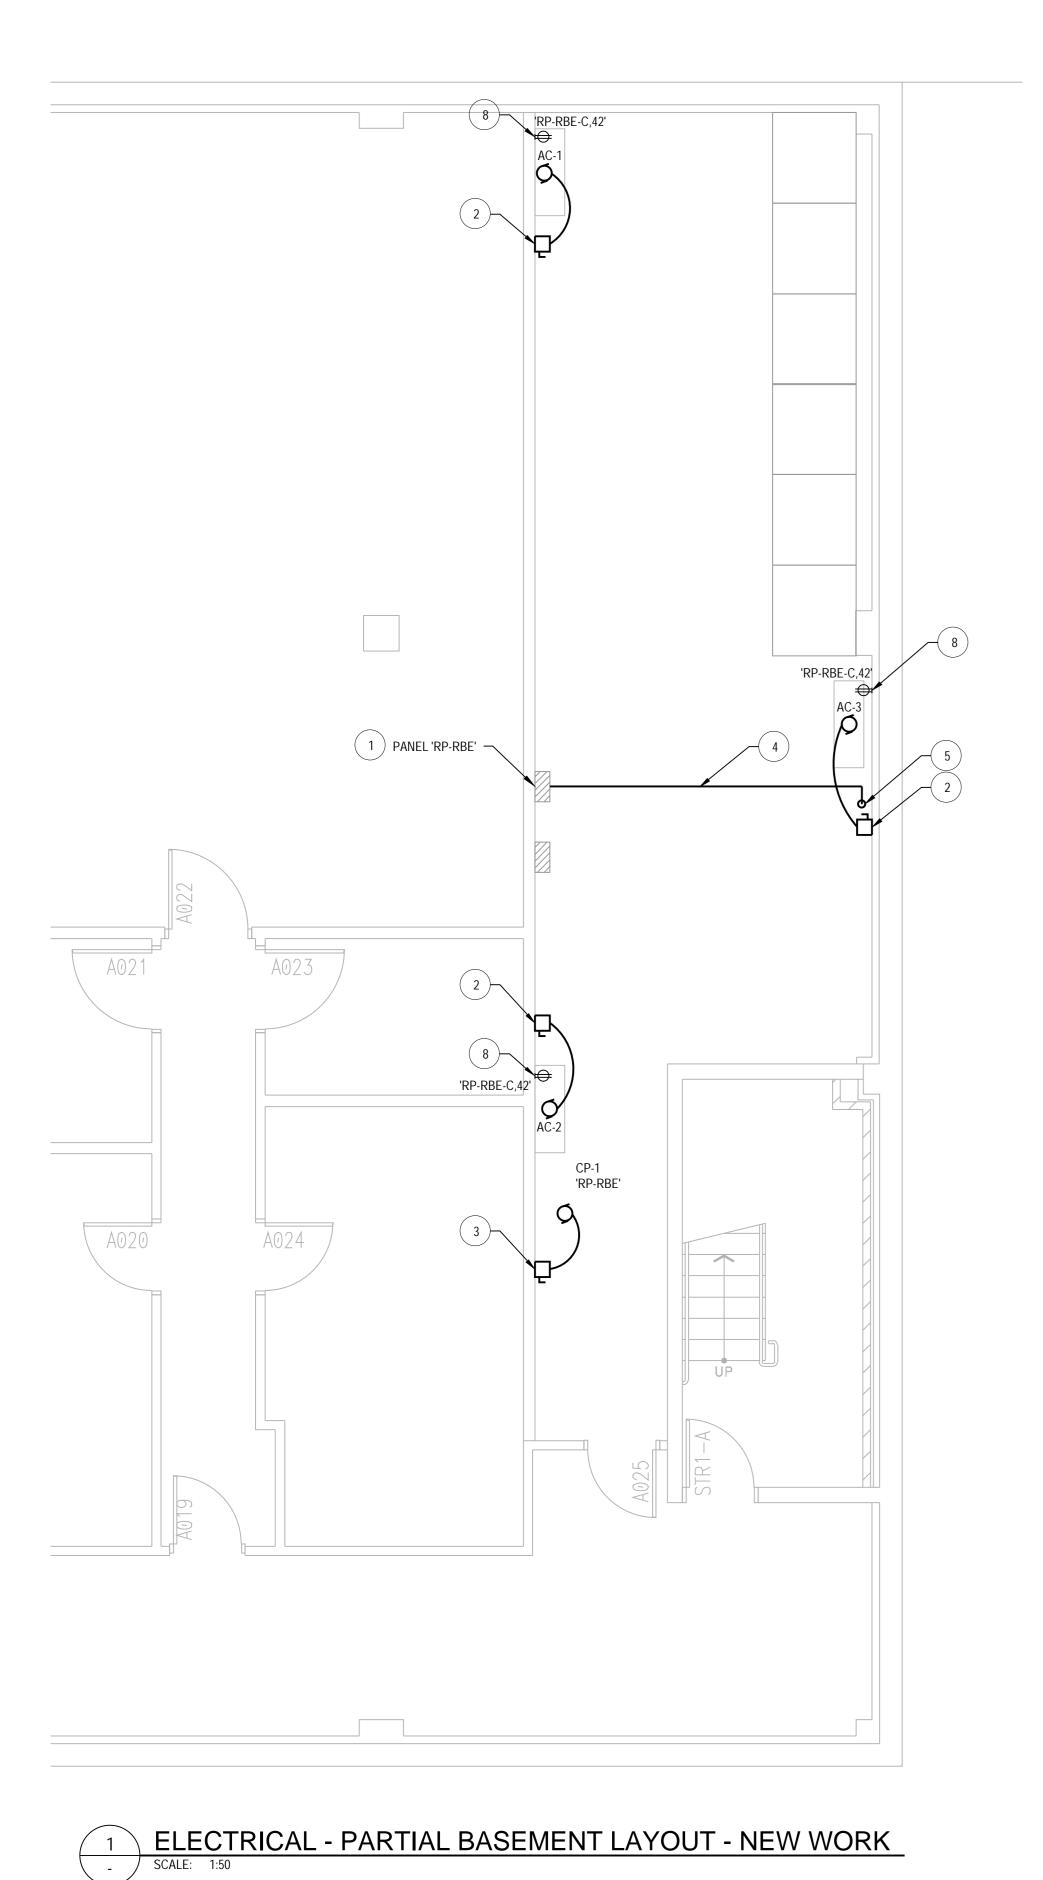

2 ELECTRICAL - PARTIAL FIRST FLOOR LAYOUT - NEW WORK

SCALE: 1:50

'RP-RBE'- C,45/47

## SHEET KEYNOTES

- SUPPLY AND INSTALL NEW BREAKERS IN PANEL 'RP-RBE' AT CIRCUITS AS INDICATED IN ON DRAWING. BREAKERS SHALL BE SIZED ACCORDING TO PANEL RP-RBE SCHEDULE. BREAKERS TO MATCH EXISTING TYPE AND KA RATING OF EXISTING BREAKERS. CONTRACTOR TO UPDATE PANEL SCHEDULE IN ACCORDANCE WITH THE NEW CHANGES
- PANEL SCHEDULE IN ACCORDANCE WITH THE NEW CHANGES

  TYPICAL: SUPPLY AND INSTALL 4#12AWG + BOND IN 21mm EMT FROM OUTDOOR UNIT CU-1 TO NEW AC UNITS AC-1, AC2, AND AC-3. CONNECT TO NEW DISCONNECT SWITCH PROVIDED BY MECHANICAL TRADE. EXACT LOCATION AND CONDUIT ROUTING TO BE DETERMINED ON SITE.
- 3 SUPPLY AND INSTALL 2#12AWG + BOND IN 21mm EMT FROM PANEL 'RP-RBE' TO NEW CONDENSATE PUMP CP-1. CONNECT TO NEW DISCONNECT SWITCH PROVIDED BY MECHANICAL TRADE. EXACT LOCATION AND CONDUIT ROUTING TO BE DETERMINED ON SITE.

  SUPPLY AND INSTALL 2#6AWG + 8 BOND IN 27mm EMT FROM PANEL 'RP-RBE' TO NEW WALL
- SUPPLY AND INSTALL 2#6AWG + 8 BOND IN 27mm EMT FROM PANEL 'RP-RBE' TO NEW WALL MOUNTED JUNCTION BOX LOCATED IN FIRST FLOOR OFFICE FOR NEW OUTDOOR COOLING UNIT CU-1.

  CORE DRILL THROUGH CEILING TO ALLOW FOR CONDUIT PENETRATIONS. XRAY SCAN PRIOR
- TO CORE DRILLING TO AVOID REBAR AND EXISTING SERVICES. COORDINATE EXACT LOCATION FOR PENETRATION WITH MECHANICAL PIPING TO ENSURE MINIMAL DISTURBANCE TO THE STRUCTURE AND THE OFFICE FUNCTIONALITY ON FIRST FLOOR. SEAL CONDUIT PENETRATION AROUND PVC SLEEVE WITH NON SHRINK WEATHERPROOF GROUT.
- 6 SUPPLY AND INSTALL NEW WALL MOUNTED JUNCTION BOX TO ALLOW FOR TRANSITION TO TECK CABLE FOR EXTERIOR WALL PENETRATION AND CONNECTION TO UNIT DISCONNECT.

  CORE DRILL THROUGH EXTERIOR WALL TO ALLOW FOR TECK CABLE PENETRATIONS. XRAY
- SCAN PRIOR TO CORE DRILLING TO AVOID REBAR AND EXISTING SERVICES. REUSE EXISTING PENETRATIONS IF POSSIBLE. FILL EXISTING CORE HOLES THAT ARE NOT REQUIRED OR NOT IN USE WITH FIRE RATED NON SHRINK WEATHERPROOF GROUT. COORDINATE EXACT LOCATION FOR PENETRATION WITH MECHANICAL PIPING TO ENSURE MINIMAL DISTURBANCE TO THE STRUCTURE AND THE OFFICE FUNCTIONALITY ON FIRST FLOOR. SEAL CONDUIT PENETRATION AROUND TECK CABLES WITH NON SHRINK WEATHERPROOF GROUT.
- SUPPLY AND INSTALL THREE (3) DUPLEX RECEPTACLES AS INDICATED COMPLETE WITH 2#12AWG + BOND IN 21mm EMT FROM RECEPTACLES TO EXISTING PANEL 'RP-RBE'. NEW RECEPTACLES TO PROVIDE POWER FOR NEW EVAPORATOR CONDENSATE PUMPS. REFER TO MECHANICAL DRAWINGS FOR ADDITIONAL INFORMATION



of Canada

LEVEL OF SECURITY | NIVEAU DE SÉCURITÉ

OF SECURITY | NIVEAU DE SÉCURITÉ

TO BE REVIEWED | À ÊTRE RÉVISÉ

This design is an instrument of service and is protected by copyright, copyright for the consultant's instrument of service belongs to the consultant. Copies including electronic copies, may only be used for the purpose intended and for a one-time use, on the same site, and for the same project and may not be offered for sale or transfer without the express written consent of the consultant.

Cette conception est un instrument de service protégé par le droit d'auteur. Le droit d'auteur sur

l'instrument de service de l'expert-conseil appartient à ce dernier. Les exemplaires de ce dessin,

sur le même chantier et pour le même projet. Ils ne peuvent être offerts en vente ni transférés sans


y compris les exemplaires électroniques, ne peuvent servir qu'aux fins prévues, et ce, qu'une fois,



Stantec Consulting Ltd 375, Roland-Therrien Blvd, suite 400 Longueuil (Québec) J4H 4A 6 Tel. 514.281.1010 www.stantec.com

e consentement écrit exprès de l'expert-conseil.

The Contractor shall verify and be responsible for all dimensions. DO NOT scale the drawing - any errors or omissions shall be reported to Stantec without delay. The Copyrights to all designs and drawings are the property of Stantec. Reproduction or use for any purpose other than that authorized by Stantec is forbidden.

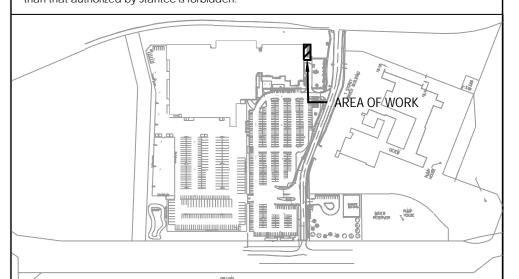

tantec															
ame:	RP-RBE				Volts:	208/120		Mains	Type:				Type:	XXXX	
ocation:	XXXX				Phases:	3		Main Bu	s Rating:	225 A			A.I.C. Rating	;: 22 kA	
upply From:	RP-BRE TRANSFORMER 45kVA				Wires:	4		MCB F	Rating:				Mounting:	XXXX	
erves:	XXXX							Lu	gs:				Enclosure:	Type 1	
Notes:															
CKT	Circuit Description	Trip	Poles	СВ	i	4		В		С	СВ	Poles	Trip	Circuit Description	СКТ
1	EXISTING LOAD	Х	Х		0	0						Х	Х	EXISTING LOAD	2
3	EXISTING LOAD	Х	Х				0	0				Х	Х	EXISTING LOAD	4
5	EXISTING LOAD	Х	Х						0	0		Х	Х	EXISTING LOAD	6
7	EXISTING LOAD	Х	Х		0	0						Х	Х	EXISTING LOAD	8
9	EXISTING LOAD	Х	Х				0	0				Х	Х	EXISTING LOAD	10
11	EXISTING LOAD	Х	Х						0	0		Х	Х	EXISTING LOAD	12
13	EXISTING LOAD	Х	Х		0	0						Х	Х	EXISTING LOAD	14
15	EXISTING LOAD	Х	Х				0	0				Х	Х	EXISTING LOAD	16
17	EXISTING LOAD	Х	Х						0	0		Х	Х	EXISTING LOAD	18
19	EXISTING LOAD	Х	Х		0	0						Х	Х	EXISTING LOAD	20
21	EXISTING LOAD	Х	Х				0	0				Х	Х	EXISTING LOAD	22
23	EXISTING LOAD	Х	Х						0	0		Х	Х	EXISTING LOAD	24
25	EXISTING LOAD	Х	Х		0	0						Х	Х	EXISTING LOAD	26
27	EXISTING LOAD	Х	Х				0	0				Х	Х	EXISTING LOAD	28
29	EXISTING LOAD	Х	Х						0	0		Х	Х	EXISTING LOAD	30
31	EXISTING LOAD	Х	Х		0	0						Х	Х	EXISTING LOAD	32
33	EXISTING LOAD	Х	Х				0	0				Х	Х	EXISTING LOAD	34
35	EXISTING LOAD	Х	Х						0	0		Х	Х	EXISTING LOAD	36
37	EXISTING LOAD	Х	Х		0	0						Х	Х	EXISTING LOAD	38
39	EXISTING LOAD	Х	Х				0	0				Х	Х	EXISTING LOAD	40
41	EXISTING LOAD	Х	X						0	0		1	15A RI	ECEPTACLES FOR EVAPORATOR CONDENSATE PUMPS	42
43	CONDENS ATE PUMP CP-1	15A	1		0	0								SPACE	44
45	COOLING UNIT CU-1	50A	2				0	0						SPACE	46
47	COOLING ON 1 CO-1								0	0				SPACE	48
49	SPACE				0	0								SPACE	50
51	SPACE						0	0						SPACE	52
53	SPACE								0	0				SPACE	54
55	SPACE				0	0								SPACE	56
57	SPACE						0	0						SPACE	58
59	SPACE								0	0				SPACE	60
		•		tal Load:	0.00	kVA	0.00 kVA		0.00 kVA			•	•	·	
			То	tal Amps:	0.00	Amps	0.00 Amps		0.00	0.00 Amps					

 03
 2024/10/16
 ISSUED FOR TENDER
 JC

 02
 2024/04/18
 ISSUED FOR TENDER
 JC

 01
 2024/03/08
 ISSUED FOR 100%
 JC

 00
 2023/12/08
 ISSUED FOR 99%
 JC

 NO.
 DATE
 REVISION
 APPR.

 SCALE | ÉCHELLE

 LOCATION | EMPLACEMENT
 1 YUKON LANE,

 TORONTO
 TORONTO

DENISON ARMOURY CCTV UPGRADE

Electrical 2021/03/26

SUBJECT | SUJET

PARTIAL BASEMENT & FIRST FLOOR

PROJECT | PROJET

PARTIAL BASEMENT & FIRST FLOOR
POWER - NEW WORK

PRODUCTION REVIEWED | REVU

DESIGNED | ÉTUDIÉ XX | XX DES O | AGENT CONC

J.Czyzewski X.X. X.X.

DRAWN | DESSINÉ PROJ MGR | GEST PROJ

C.Mcdonald X.X.

CHECKED | VÉRIFIÉ DES MGR | GEST CONC

E.Lafleur X.X.

COORDINATION FIRE | INCENDIE

X.X.


WBS NO. | NO. OTP

PF NO. | NO. DP

TT180003

DWG. NO. | NO. DESSIN TT180003 - 502

Canadä

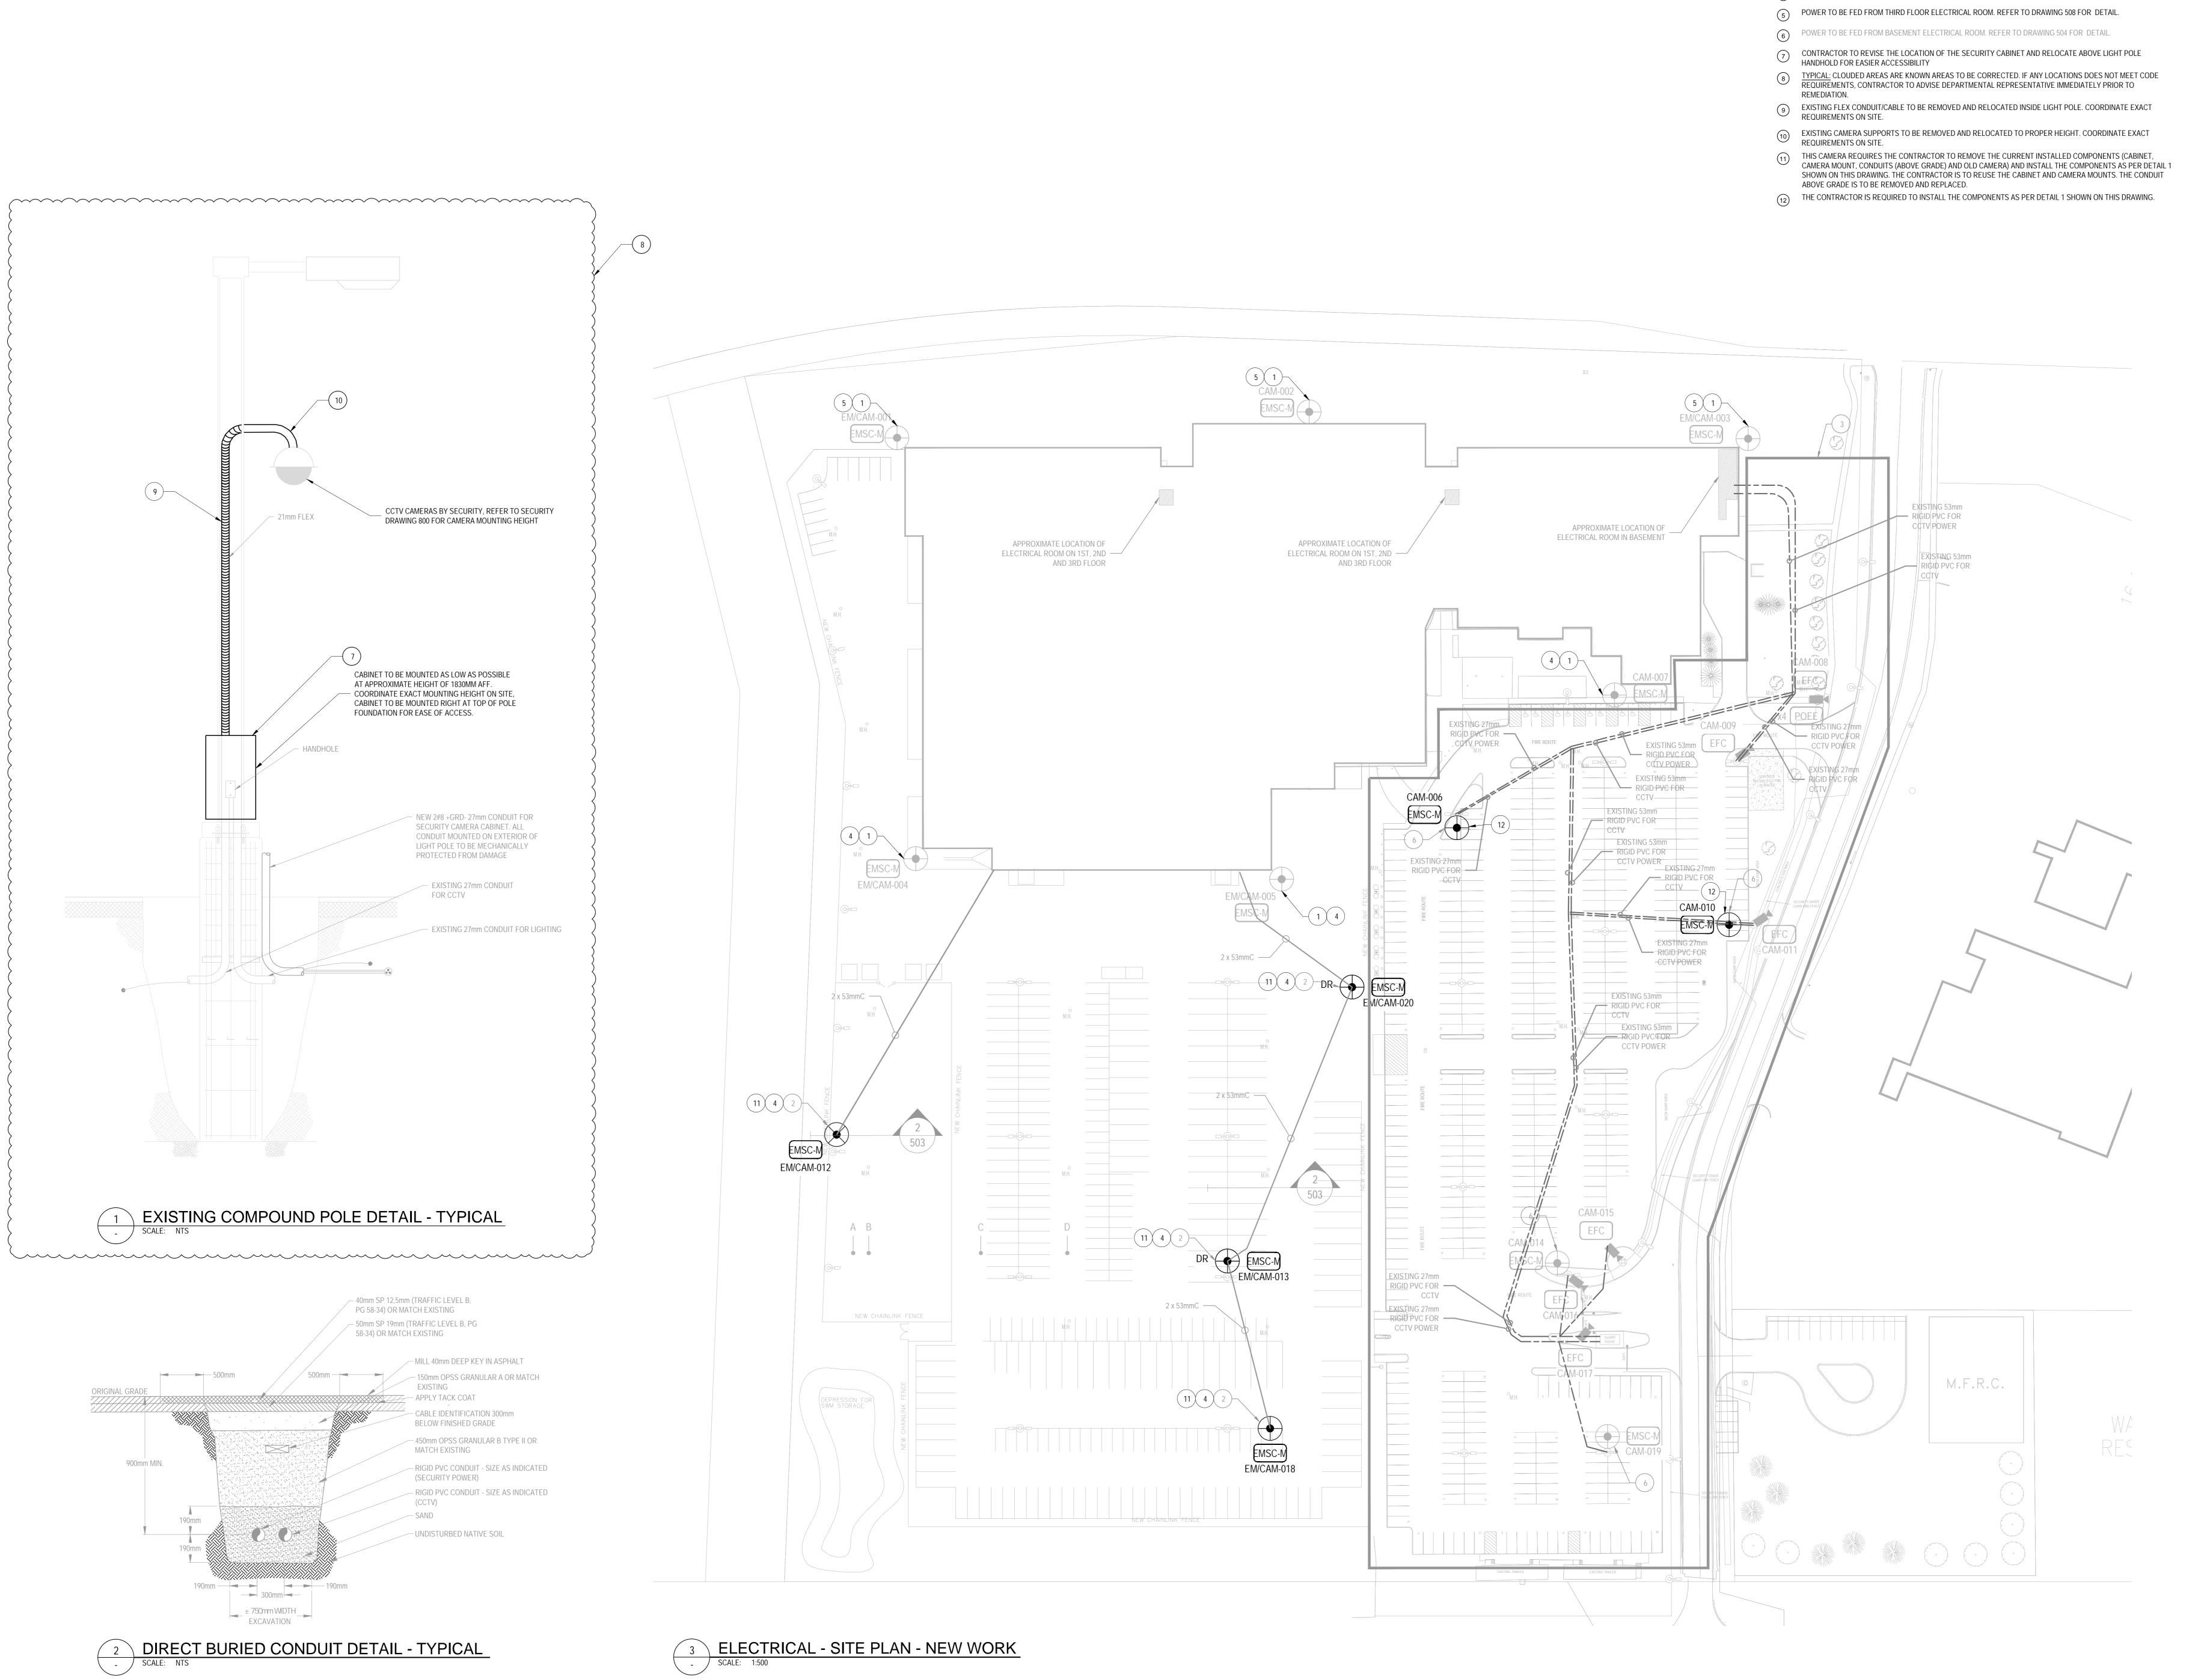

SHEET KEYNOTES

ROOF MOUNTED CAMERAS FED FROM INTERIOR OF BUILDING. REFER TO DRAWING 504 AND 507 FOR CONDUIT

DETAIL.

PARKING LOT CAMERAS FED FROM INTERIOR OF BUILDING. REFER TO DRAWING 504 FOR INTERIOR CONDUIT RUN DETAIL AND REFER TO DETAIL 1/503 FOR INSTALLATION DETAIL.

CONDUITS FOR NEW PARKING LOT ALREADY INSTALLED AND NOT IN SCOPE. WIRING AND DEVICES WILL BE NEW AS DEED SECURITY DRAWINGS. EXISTING CONDUITS DETAILS.

PER SECURITY DRAWINGS. EXISTING CONDUITS RETRIEVED FROM AS-BUILT DRAWINGS SHOWN FOR REFERENCE ONLY.

POWER TO BE FED FROM FIRST FLOOR ELECTRICAL ROOM. REFER TO DRAWING 505/506 FOR DETAIL.

**Stantec** 

not be offered for sale or transfer without the express written consent of the consultant.

TO BE REVIEWED | À ÊTRE RÉVISÉ

This design is an instrument of service and is protected by copyright, copyright for the consultant's instrument of service belongs to the consultant. Copies including electronic copies, may only be used

for the purpose intended and for a one-time use, on the same site, and for the same project and may

Cette conception est un instrument de service protégé par le droit d'auteur. Le droit d'auteur sur l'instrument de service de l'expert-conseil appartient à ce dernier. Les exemplaires de ce dessin,


y compris les exemplaires électroniques, ne peuvent servir qu'aux fins prévues, et ce, qu'une fois, sur le même chantier et pour le même projet. Ils ne peuvent être offerts en vente ni transférés sans

LEVEL OF SECURITY | NIVEAU DE SÉCURITÉ

e consentement écrit exprès de l'expert-conseil.

375, Roland-Therrien Blvd, suite 400 Longueuil (Québec) J4H 4A 6 Tel. 514.281.1010 www.stantec.com

The Contractor shall verify and be responsible for all dimensions. DO NOT scale the drawing - any errors or omissions shall be reported to Stantec without delay. The Copyrights to all designs and drawings are the property of Stantec. Reproduction or use for any purpose other than that authorized by Stantec is forbidden.

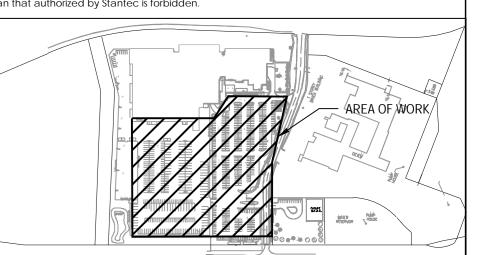



 03
 2024/10/16
 ISSUED FOR TENDER
 JC

 02
 2024/04/18
 ISSUED FOR TENDER
 JC

 01
 2024/03/08
 ISSUED FOR 100%
 JC

 00
 2023/12/08
 ISSUED FOR 99%
 JC

 NO.
 DATE
 REVISION
 APPR.

 SCALE | ÉCHELLE

LOCATION | EMPLACEMENT

1 YUKON LANE,

TORONTO ONTARIO

PROJECT | PROJET

DENISON ARMOURY CCTV UPGRADE

Electrical 2021/03/26

SUBJECT | SUJET

SITE PLAN

SITE PLAN CCTV - NEW WORK

PRODUCTION REVIEWED | REVU

DESIGNED | ÉTUDIÉ XX | XX DES O | AGENT CONC J.Czyzewski X.X. X.X. X.X.

DRAWN | DESSINÉ PROJ MGR | GEST PROJ X.X.

C.Mcdonald X.X.

CHECKED | VÉRIFIÉ DES MGR | GEST CONC X.X.

COORDINATION FIRE | INCENDIE X.X.

WBS NO. | NO. OTP PF NO. | NO. DP

DWG. NO. | NO. DESSIN TT180003 - 503

Canadä

TT180003

Sheet # of #

SHEET KEYNOTES 4) TYPICAL: SCAN FLOOR/WALL BEFORE CORE DRILL. PRIOR TO INSTALLATION. IMMEDIATELY PRIOR TO REMEDIATION. BOX TO ACCOMMODATE

— 6 STRAND mm FIBRE NEW

1 ELECTRICAL - BASEMENT LAYOUT - NEW WORK

- 1 TYPICAL: CORE SWITCH, EDGE SWITCH, NETWORK VIDEO RECORDER, FIBRE OPTIC FUSION BOX, CAMERA AND CAT6 CABLES BY OTHERS, REFER TO SECURITY DRAWINGS FOR CABLE AND DEVICE REQUIREMENTS.
- 2 TYPICAL: ELECTRICAL CONTRACTOR TO SUPPLY AND INSTALL 250mm X 250mm X 150mm JUNCTION BOX IN CEILING SPACE OR ON WALL ADJACENT TO CAMERA AND CONDUIT AS SHOWN. REFER TO SECURITY DRAWINGS FOR
- CAMERA LOCATIONS, INSTALLATION HEIGHTS, AND INSTALLATION DETAIL. 3 TYPICAL: CONDUIT TO BE RUN IN DROPPED CEILING SPACE AT APPROXIMATE HEIGHT OF 2700mm AFF.
- APPROXIMATE LOCATION OF EXISTING CONDUITS TO NEW PARKING LOT FOR CCTV SYSTEM. REFER TO DRAWING 503 FOR EXTERIOR CONDUIT RUNS. TRANSITION TO EMT CONDUIT FOR INTERIOR CONDUIT RUNS.
- 6 SUPPLY AND INSTALL NEW 15A/1P BREAKER IN EXISTING EMERGENCY PANEL C/W 2#10AWG + GND TO FEED CAMERAS IN NEW PARKING LOT. PROVIDE NEW 27mm EMT CONDUIT FROM ROOM A008 TO ROOM A025 AND TRANSITION TO EXISTING CONDUIT IN ROOM A025 TO EXTERIOR POLES. CONFIRM SPACE AVAILABLE IN EXISTING PANEL AND ANNOTATE CIRCUIT NUMBER ON AS-BUILT DRAWINGS. CONDUIT ROUTING TO BE CONFIRMED ON SITE
- 7 TYPICAL: CONTRACTOR TO FOLLOW ALL EXISTING CONDUIT ROUTES AS INDICATED AND ENSURE ALL CONDUITS ARE LABELED WITH PLASTIC TAPE WHERE CONDUIT ENTER WALLS, CEILINGS, FLOOR AND AT 15m INTERVALS COLOUR CODING PER SPECIFICATIONS 26 05 00 SECTION 2.8
- 8 TYPICAL: CONTRACTOR TO FOLLOW ALL CONDUIT ROUTES AS INDICATED AND ENSURE ALL CONDUIT INFRASTRUCTURE MEETS LATEST CODE. CLOUDED AREAS ARE KNOWN AREAS TO BE CORRECTED. IF ANY LOCATIONS DOES NOT MEET CODE REQUIREMENTS, CONTRACTOR TO ADVISE DEPARTMENTAL REPRESENTATIVE
- 9 TYPICAL: CONTRACTOR TO FOLLOW ALL EXISTING CONDUIT ROUTES AND ENSURE JUNCTION BOX OPENING ARE ACCESSIBLE FOR MAINTENANCE. CONTRACTOR TO REVISE JUNCTION BOX INSTALLATION OR REPLACE JUNCTION
- TYPICAL: CONTRACTOR TO FOLLOW AND REVIEW ALL EXISTING CONDUIT ROUTES AND EXISTING CAMERA INSTALLATIONS AS INDICATED. CONTRACTOR TO ENSURE THAT NO MORE THAN 1m (ie: ALL STAIRWELLS, HALLWAYS, ETC.) OF FLEXIBLE CONDUIT BE INSTALLED BETWEEN A JUNCTION BOX AND CAMERA FOR ALL EXPOSED CAMERA INSTALLATIONS. CONTRACTOR TO ENSURE THAT NO MORE THAN 3m (SUSPENDED CEILING INSTALLATIONS) OF FLEXIBLE CONDUIT BE INSTALLED BETWEEN A JUNCTION BOX AND CAMERA FOR ALL CEILING MOUNTED INSTALLATIONS. CONTRACTOR TO CORRECT ALL DEFICIENCIES.
- TYPICAL: VISUALLY INSPECT ALL JUNCTION BOXES CONNECTED TO THE SECURITY CAMERA SYSTEM. IF ANY JUNCTION BOXES HAVE UNUSED PUNCH OUTS THEY ARE TO BE REMOVED AND REPLACED WITH NEW INCLUDING
- TYPICAL: REINSTATE ALL CEILING TILES. ANY TILES DAMAGED AS PART OF WORK OF THIS PROJECT ARE TO BE REPLACED. THE CONTRACTOR SHALL EXPECT TO REPLACED 100 CEILING TILES.
- TYPICAL: VISUALLY INSPECT ALL COMMUNICATIONS CONDUIT RUNS CONNECTED TO THE SECURITY CAMERA SYSTEM. THE CONTRACTOR IS TO PERFORM THE LABELLING ON ALL CONDUITS AS PER THE REQUIREMENTS OUTLINED IN THE SPECIFICATIONS. ALL EXISITNG LABELLING WILL NOT TO BE REMOVED AND NEW LABELLING TO BE INSTALLED.
- CONTRACTOR TO REMOVE 5M OF FLEX CONDUIT AND INSTALL NEW 4M OF EMT, JUNCTION BOX AND 1M OF FLEX CONDUIT THAT MEETS THE DESCRIBED BELOW. CONTRACTOR TO ENSURE THAT NO MORE THAN 1M (IE: ALL STAIRWELLS, HALLWAYS, ETC.) OF FLEXIBLE CONDUIT BE INSTALLED BETWEEN A JUNCTION BOX AND CAMERA FOR ALL EXPOSED CAMERA INSTALLATIONS. CONTRACTOR TO ENSURE THAT NO MORE THAN 3M (SUSPENDED CEILING INSTALLATIONS) OF FLEXIBLE CONDUIT BE INSTALLED BETWEEN A JUNCTION BOX AND CAMERA FOR ALL CEILING MOUNTED INSTALLATIONS. CONTRACTOR TO CORRECT ALL DEFICIENCIES.
- THE CURRENT CONDUIT INSTALLATION IN THE IDENTIFIED AREA WAS INSTALLED TIGHTLY AGAINST A HOT PLUMBER PIPE. THIS CONDUIT IS TO BE REMOVED AND RELOCATED TO BE INSTALLED IN A LOCATION THAT MEETS THE SPECIFICATIONS AND CODE. THE CONTRACTOR WILL BE REQUIRED TO REMOVE 5M FROM EACH OF THE CONDUIT PRESSING AGAINST THE HOT PLUMBER PIPE.

ELEV. 2700mm AFF —

6 STRAND mm FIBRE NEW —

— 6 STRAND mm FIBRE NEW

LEVEL OF SECURITY | NIVEAU DE SÉCURITÉ

TO BE REVIEWED | À ÊTRE RÉVISÉ This design is an instrument of service and is protected by copyright, copyright for the consultant's instrument of service belongs to the consultant. Copies including electronic copies, may only be used for the purpose intended and for a one-time use, on the same site, and for the same project and may not be offered for sale or transfer without the express written consent of the consultant.


Cette conception est un instrument de service protégé par le droit d'auteur. Le droit d'auteur sur l'instrument de service de l'expert-conseil appartient à ce dernier. Les exemplaires de ce dessin,

y compris les exemplaires électroniques, ne peuvent servir qu'aux fins prévues, et ce, qu'une fois, sur le même chantier et pour le même projet. Ils ne peuvent être offerts en vente ni transférés sans



375, Roland-Therrien Blvd, suite 400 Longueuil (Québec) J4H 4A6 Tel. 514.281.1010 www.stantec.com

The Contractor shall verify and be responsible for all dimensions. DO NOT scale the drawing any errors or omissions shall be reported to Stantec without delay. The Copyrights to all designs and drawings are the property of Stantec. Reproduction or use for any purpose other than that authorized by Stantec is forbidden.

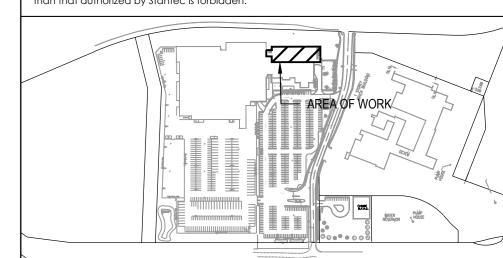



LOCATION | EMPLACEMENT TORONTO ONTARIO

PROJECT | PROJET

DENISON ARMOURY CCTV UPGRADE

SUBJECT | SUJET

BASEMENT CCTV - NEW WORK


PRODUCTION REVIEWED | REVU DESIGNED | ÉTUDIÉ DES O | AGENT CONC PROJ MGR | GEST PROJ C.Mcdonald DES MGR | GEST CONC CHECKED | VÉRIFIÉ COORDINATION FIRE | INCENDIE PF NO. | NO. DP TT180003

WBS NO. | NO. OTP DWG. NO. | NO. DESSIN

TT180003 - 504

Canadä

2021/03/26

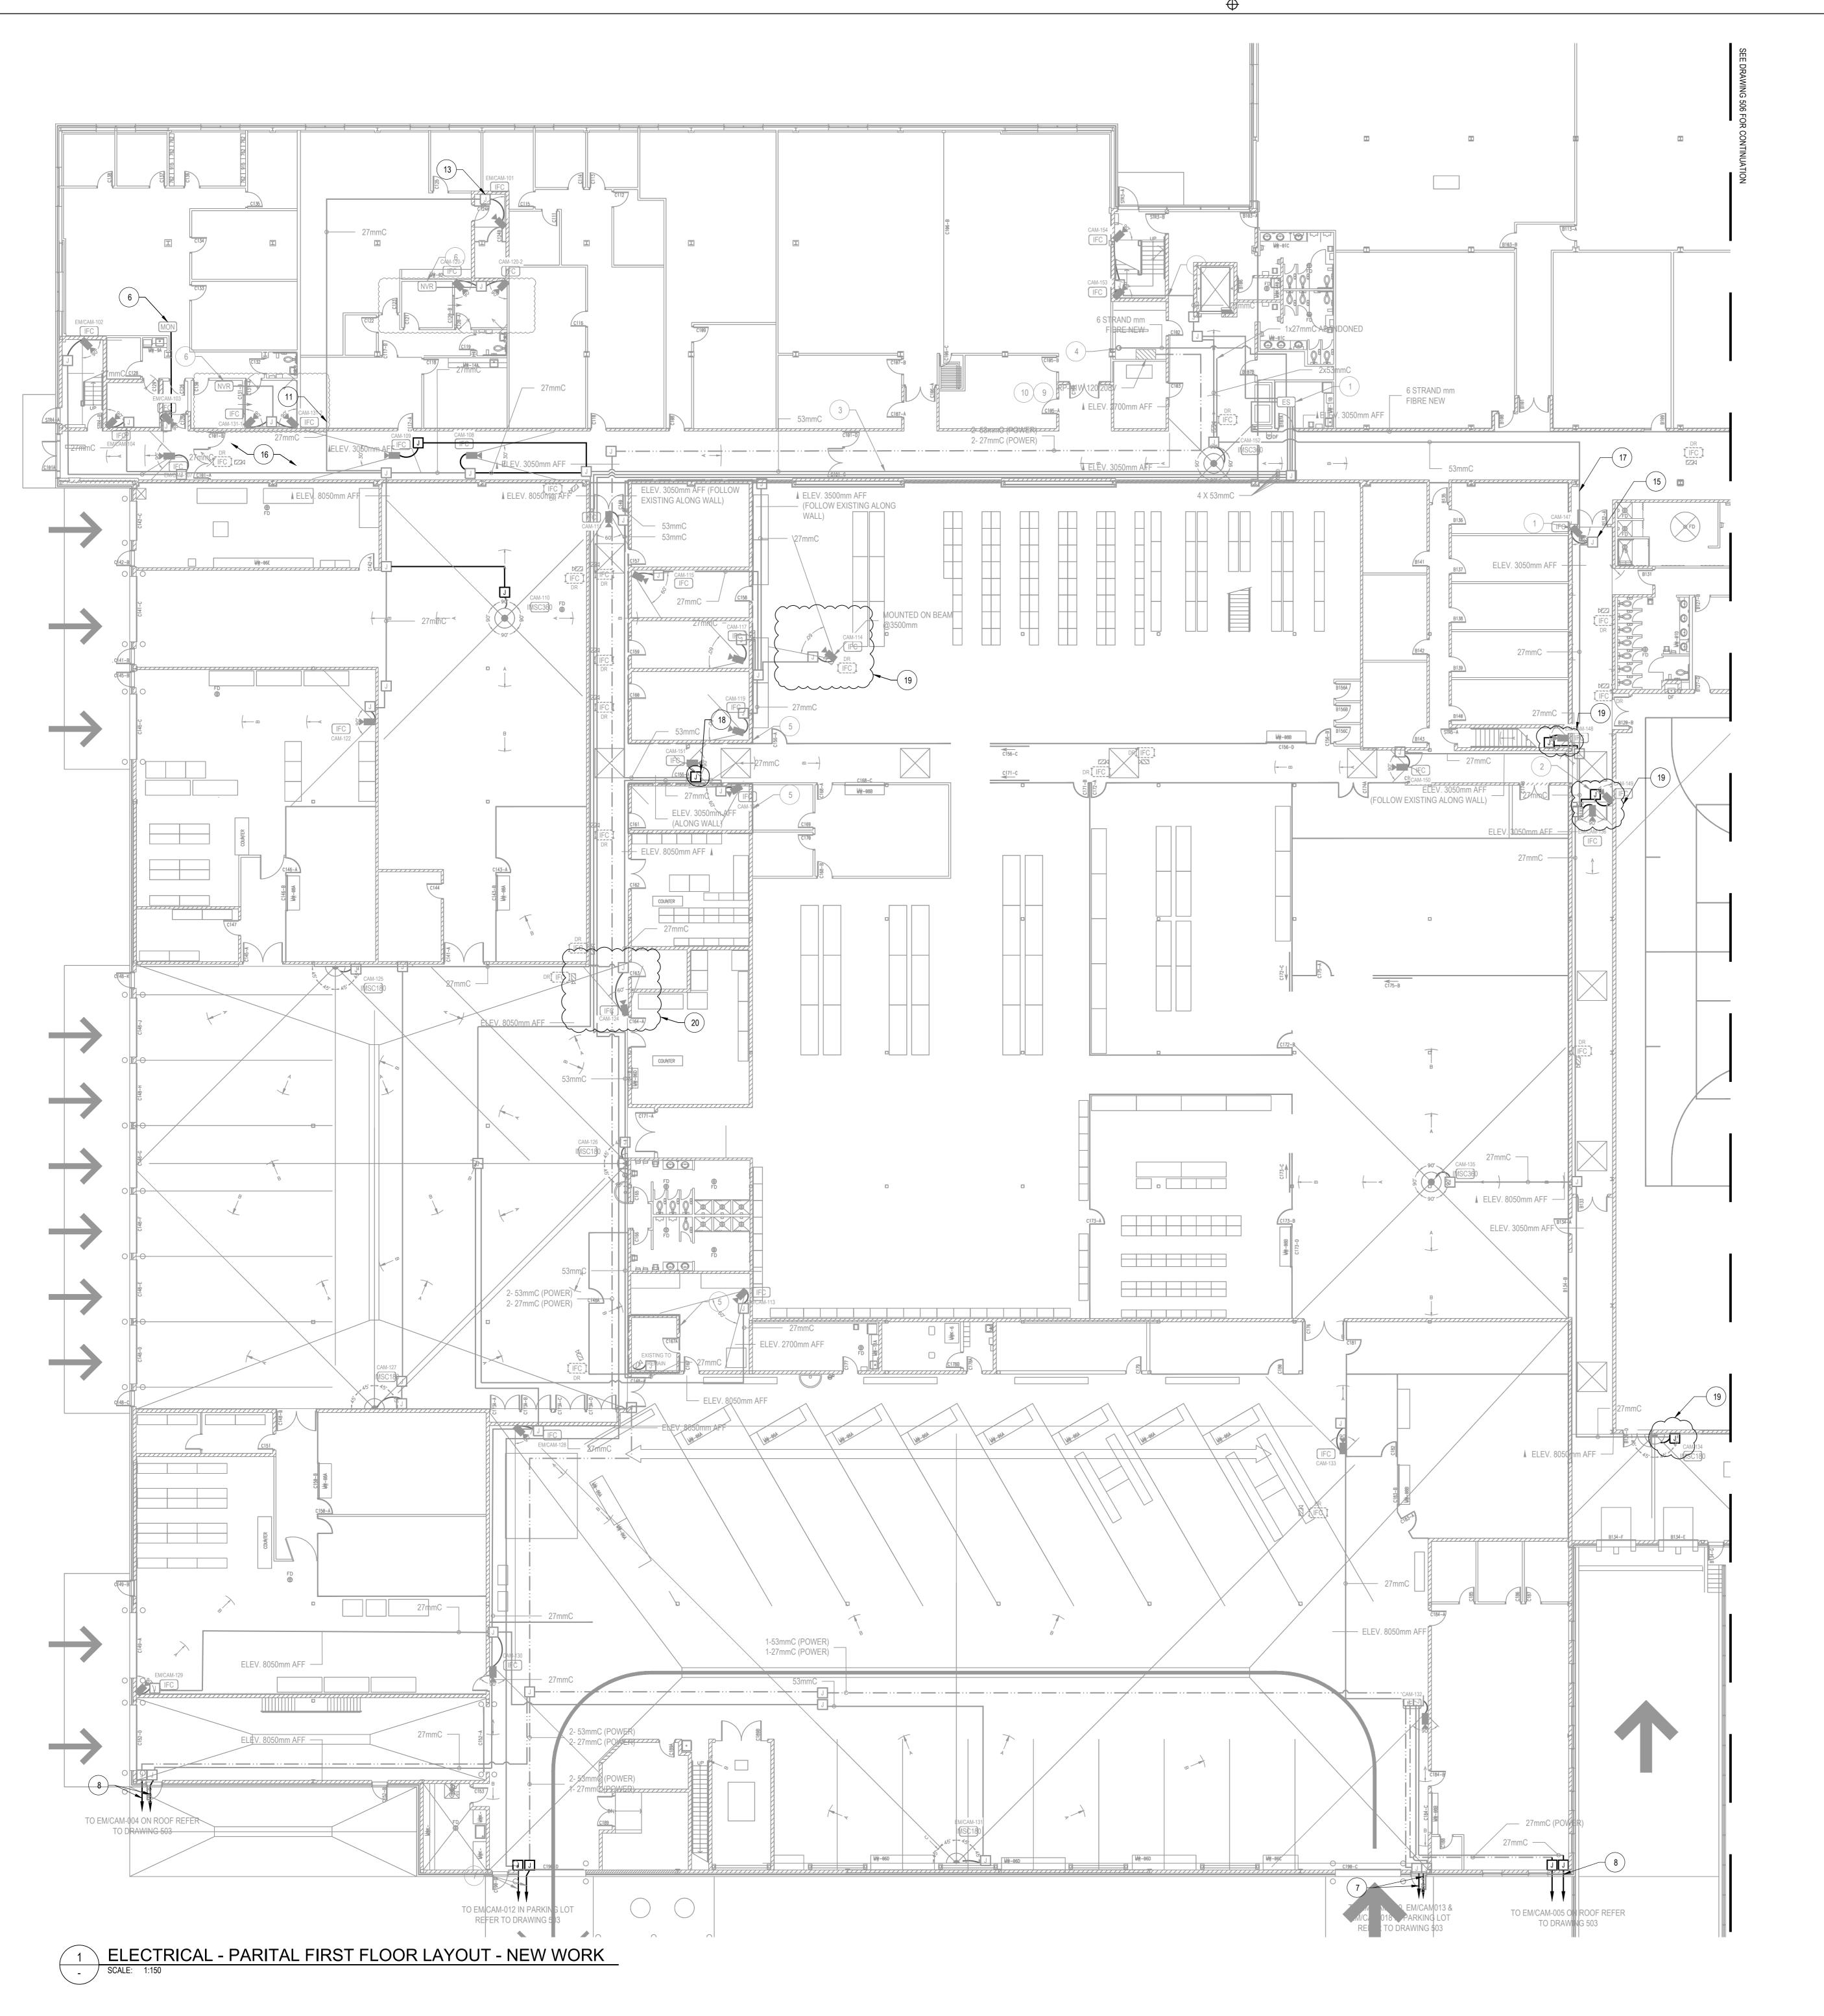

## SHEET KEYNOTES

- TYPICAL: EDGE SWITCH, CAMERA AND CAT6 CABLES BY OTHERS, REFER TO SECURITY DRAWINGS FOR CABLE AND DEVICE REQUIREMENTS.
- TYPICAL: ELECTRICAL CONTRACTOR TO SUPPLY AND INSTALL 250mm X 250mm X 150mm JUNCTION BOX IN CEILING SPACE OR ON WALL ADJACENT TO CAMERA AND CONDUIT AS SHOWN. REFER TO SECURITY DRAWINGS FOR
- CAMERA LOCATIONS, INSTALLATION HEIGHTS, AND INSTALLATION DETAIL.

  TYPICAL: CONDUIT TO BE RUN IN DROPPED CEILING SPACE AT APPROXIMATE HEIGHT OF 2700mm AFF.
- (4) TYPICAL: SCAN FLOOR/WALL BEFORE CORE DRILL.
- CLASS 1 DIVISION 2 AREA. CONTRACTOR TO REUSE EXISTING PENETRATIONS. SEALS SUCH AS EYS FITTINGS SHALL
- BE INSTALLED AS REQUIRED BY CODE.

  STAND ALONE SYSTEM. REFER TO SECURITY DRAWINGS FOR DETAIL
- PENETRATE THROUGH WALL AT CEILING HEIGHT, ROUTE CONDUIT ALONG EXTERIOR WALL TRANSITION TO DUCT PRIOR TO ENTERING TRENCH. REFER TO DRAWING 503 FOR EXTERIOR CONDUIT RUNS.

TYPICAL: SCAN WALL BEFORE CORE DRILL. REFER TO SECURITY DRAWINGS FOR ROOF MOUNTED CAMERA

- INSTALLATION DETAIL.

  SUPPLY AND INSTALL NEW 15A/1P BREAKER IN EXISTING EMERGENCY PANEL C/W 2#10AWG + GND 27mmC TO FEED CAMERAS ON ROOF, CONFIRM SPACE AVAILABLE IN EXISTING PANEL AND ANNOTATE CIRCUIT NUMBER ON
- AS-BUILT DRAWINGS. CONDUIT ROUTING TO BE CONFIRMED ON SITE PRIOR TO INSTALLATION.

  SUPPLY AND INSTALL NEW 15A/1P BREAKER IN EXISTING EMERGENCY PANEL C/W 2#10AWG + GND 53mmC TO FEED IN EXISTING PARKING LOT, CONFIRM SPACE AVAILABLE IN EXISTING PANEL AND ANNOTATE CIRCUIT NUMBER ON
- IN EXISTING PARKING LOT. CONFIRM SPACE AVAILABLE IN EXISTING PANEL AND ANNOTATE CIRCUIT NUMBER ON AS-BUILT DRAWINGS. CONDUIT ROUTING TO BE CONFIRMED ON SITE PRIOR TO INSTALLATION.

  TYPICAL: CONTRACTOR TO FOLLOW ALL EXISTING CONDUIT ROUTES AS INDICATED AND ENSURE ALL CONDUITS

  ARE LARGE ON ANTI- DIAGRAM LEDGE CONDUIT TO THE PART OF THE PART
- ARE LABELED WITH PLASTIC TAPE WHERE CONDUIT ENTER WALLS, CEILINGS, FLOOR AND AT 15m INTERVALS COLOUR CODING PER SPECIFICATIONS 26 05 00 SECTION 2.8
- TYPICAL: CONTRACTOR TO FOLLOW ALL CONDUIT ROUTES AS INDICATED AND ENSURE ALL CONDUIT INFRASTRUCTURE MEETS LATEST CODE. CLOUDED AREAS ARE KNOWN AREAS TO BE CORRECTED. IF ANY LOCATIONS DOES NOT MEET CODE REQUIREMENTS, CONTRACTOR TO ADVISE DEPARTMENTAL REPRESENTATIVE IMMEDIATELY PRIOR TO REMEDIATION.
- TYPICAL: CONTRACTOR TO FOLLOW ALL EXISTING CONDUIT ROUTES AND ENSURE JUNCTION BOX OPENING ARE ACCESSIBLE FOR MAINTENANCE. CONTRACTOR TO REVISE JUNCTION BOX INSTALLATION OR REPLACE JUNCTION BOX TO ACCOMMODATE

  TYPICAL: CONTRACTOR TO FOLLOW AND REVIEW ALL EXISTING CONDUIT ROUTES AND EXISTING CAMERA
- INSTALLATIONS AS INDICATED. CONTRACTOR TO ENSURE THAT NO MORE THAN 1m (ie: ALL STAIRWELLS, HALLWAYS, ETC.) OF FLEXIBLE CONDUIT BE INSTALLED BETWEEN A JUNCTION BOX AND CAMERA FOR ALL EXPOSED CAMERA INSTALLATIONS. CONTRACTOR TO ENSURE THAT NO MORE THAN 3m (SUSPENDED CEILING INSTALLATIONS) OF FLEXIBLE CONDUIT BE INSTALLED BETWEEN A JUNCTION BOX AND CAMERA FOR ALL CEILING MOUNTED INSTALLATIONS. CONTRACTOR TO CORRECT ALL DEFICIENCIES.
- TYPICAL: VISUALLY INSPECT ALL JUNCTION BOXES CONNECTED TO THE SECURITY CAMERA SYSTEM. IF ANY JUNCTION BOXES HAVE UNUSED PUNCH OUTS THEY ARE TO BE REMOVED AND REPLACED WITH NEW INCLUDING
- TYPICAL: REINSTATE ALL CEILING TILES. ANY TILES DAMAGED AS PART OF WORK OF THIS PROJECT ARE TO BE REPLACED. THE CONTRACTOR SHALL EXPECT TO REPLACED 100 CEILING TILES.
- TYPICAL: VISUALLY INSPECT ALL COMMUNICATIONS CONDUIT RUNS CONNECTED TO THE SECURITY CAMERA SYSTEM. THE CONTRACTOR IS TO PERFORM THE LABELLING ON ALL CONDUITS AS PER THE REQUIREMENTS OUTLINED IN THE SPECIFICATIONS. ALL EXISITING LABELLING WILL NOT TO BE REMOVED AND NEW LABELLING TO BE
- BOX IS KNOWN TO HAVE A PUNCH OUT THAT IS NOT FILLED WITH A CONDUIT AND IS REQUIRED TO BE REPLACED.

  CONTRACTOR TO REMOVE 5M OF FLEX CONDUIT AND INSTALL NEW 4M OF EMT, JUNCTION BOX AND 1M OF FLEX CONDUIT THAT MEETS THE DESCRIBED BELOW. CONTRACTOR TO ENSURE THAT NO MORE THAN 1M (IE: ALL STAIRWELLS, HALLWAYS, ETC.) OF FLEXIBLE CONDUIT BE INSTALLED BETWEEN A JUNCTION BOX AND CAMERA FOR ALL EXPOSED CAMERA INSTALLATIONS. CONTRACTOR TO ENSURE THAT NO MORE THAN 3M (SUSPENDED CEILING

INSTALLATIONS) OF FLEXIBLE CONDUIT BE INSTALLED BETWEEN A JUNCTION BOX AND CAMERA FOR ALL CEILING

JUNCTION BOXES ARE NOT TO HAVE ANY PUNCH OUTS THAT ARE NOT BEING USED BY CONDUITS. THIS JUNCTION

THE CONTRACTOR IS TO REPLACE THE JUNCTION BOX BECAUSE THE EXISTING JUNCTION BOX ORIENTATION HAS THE BOX DOOR OPENING DOWN WHICH MAKES IT DIFFICULT TO SERVICE. DUE TO NO PUNCHOUTS ALLOWED IN JUNCTION BOXES, THE CONTRACTOR IS TO REPLACE THIS JUNCTION BOX WITH A NEW JUNCTION BOX AND PULL BACK CABLES AND RE-INSTALL.

MOUNTED INSTALLATIONS. CONTRACTOR TO CORRECT ALL DEFICIENCIES.

Gover

da du Canac

LEVEL OF SECURITY | NIVEAU DE SÉCURITÉ

TO BE REVIEWED | À ÊTRE RÉVISÉ

This design is an instrument of service and is protected by copyright, copyright for the consultant's instrument of service belongs to the consultant. Copies including electronic copies, may only be used for the purpose intended and for a one-time use, on the same site, and for the same project and may

not be offered for sale or transfer without the express written consent of the consultant.

Cette conception est un instrument de service protégé par le droit d'auteur. Le droit d'auteur sur l'instrument de service de l'expert-conseil appartient à ce dernier. Les exemplaires de ce dessin,

y compris les exemplaires électroniques, ne peuvent servir qu'aux fins prévues, et ce, qu'une fois,


sur le même chantier et pour le même projet. Ils ne peuvent être offerts en vente ni transférés sans



375, Roland-Therrien Blvd, suite 400 Longueuil (Québec) J4H 4A6 Tel. 514.281.1010 www.stantec.com

le consentement écrit exprès de l'expert-conseil.

The Contractor shall verify and be responsible for all dimensions. DO NOT scale the drawing - any errors or omissions shall be reported to Stantec without delay. The Copyrights to all designs and drawings are the property of Stantec. Reproduction or use for any purpose other

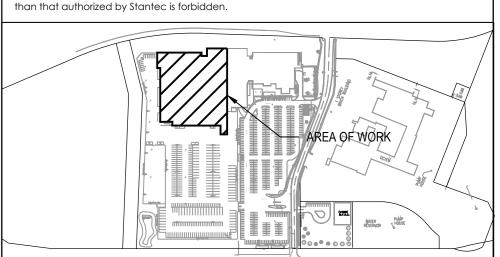

 04
 2024/11/14
 ISSUED FOR TENDER
 JC

 03
 2024/10/16
 ISSUED FOR TENDER
 JC

 02
 2024/04/18
 ISSUED FOR TENDER
 JC

 01
 2024/03/08
 ISSUED FOR 100%
 JC

 00
 2023/12/08
 ISSUED FOR 99%
 JC

 NO.
 DATE
 REVISION
 APPE

 SCALE | ÉCHELLE

1 YUKON LANE, TORONTO ONTARIO

PROJECT | PROJET

DENISON ARMOURY CCTV UPGRADE

TRADE | MÉTIER
Electrical
SUBJECT | SUJET

PARTIAL FIRST FLOOR CCTV - NEW WORK (1 OF 2)

DESIGNED | ÉTUDIÉ XX | XX DES O | AGENT CONC J.Czyzewski X.X. X.X.

DRAWN | DESSINÉ PROJ MGR | GEST PROJ X.X.

CHECKED | VÉRIFIÉ DES MGR | GEST CONC X.X.

COORDINATION X.X.

WBS NO. | NO. OTP PF NO. | NO. DP

DWG. NO. | NO. DESSIN

PRODUCTION


TT180003 - 505

Sheet # of #


TT180003

Canadä

<del>}</del>

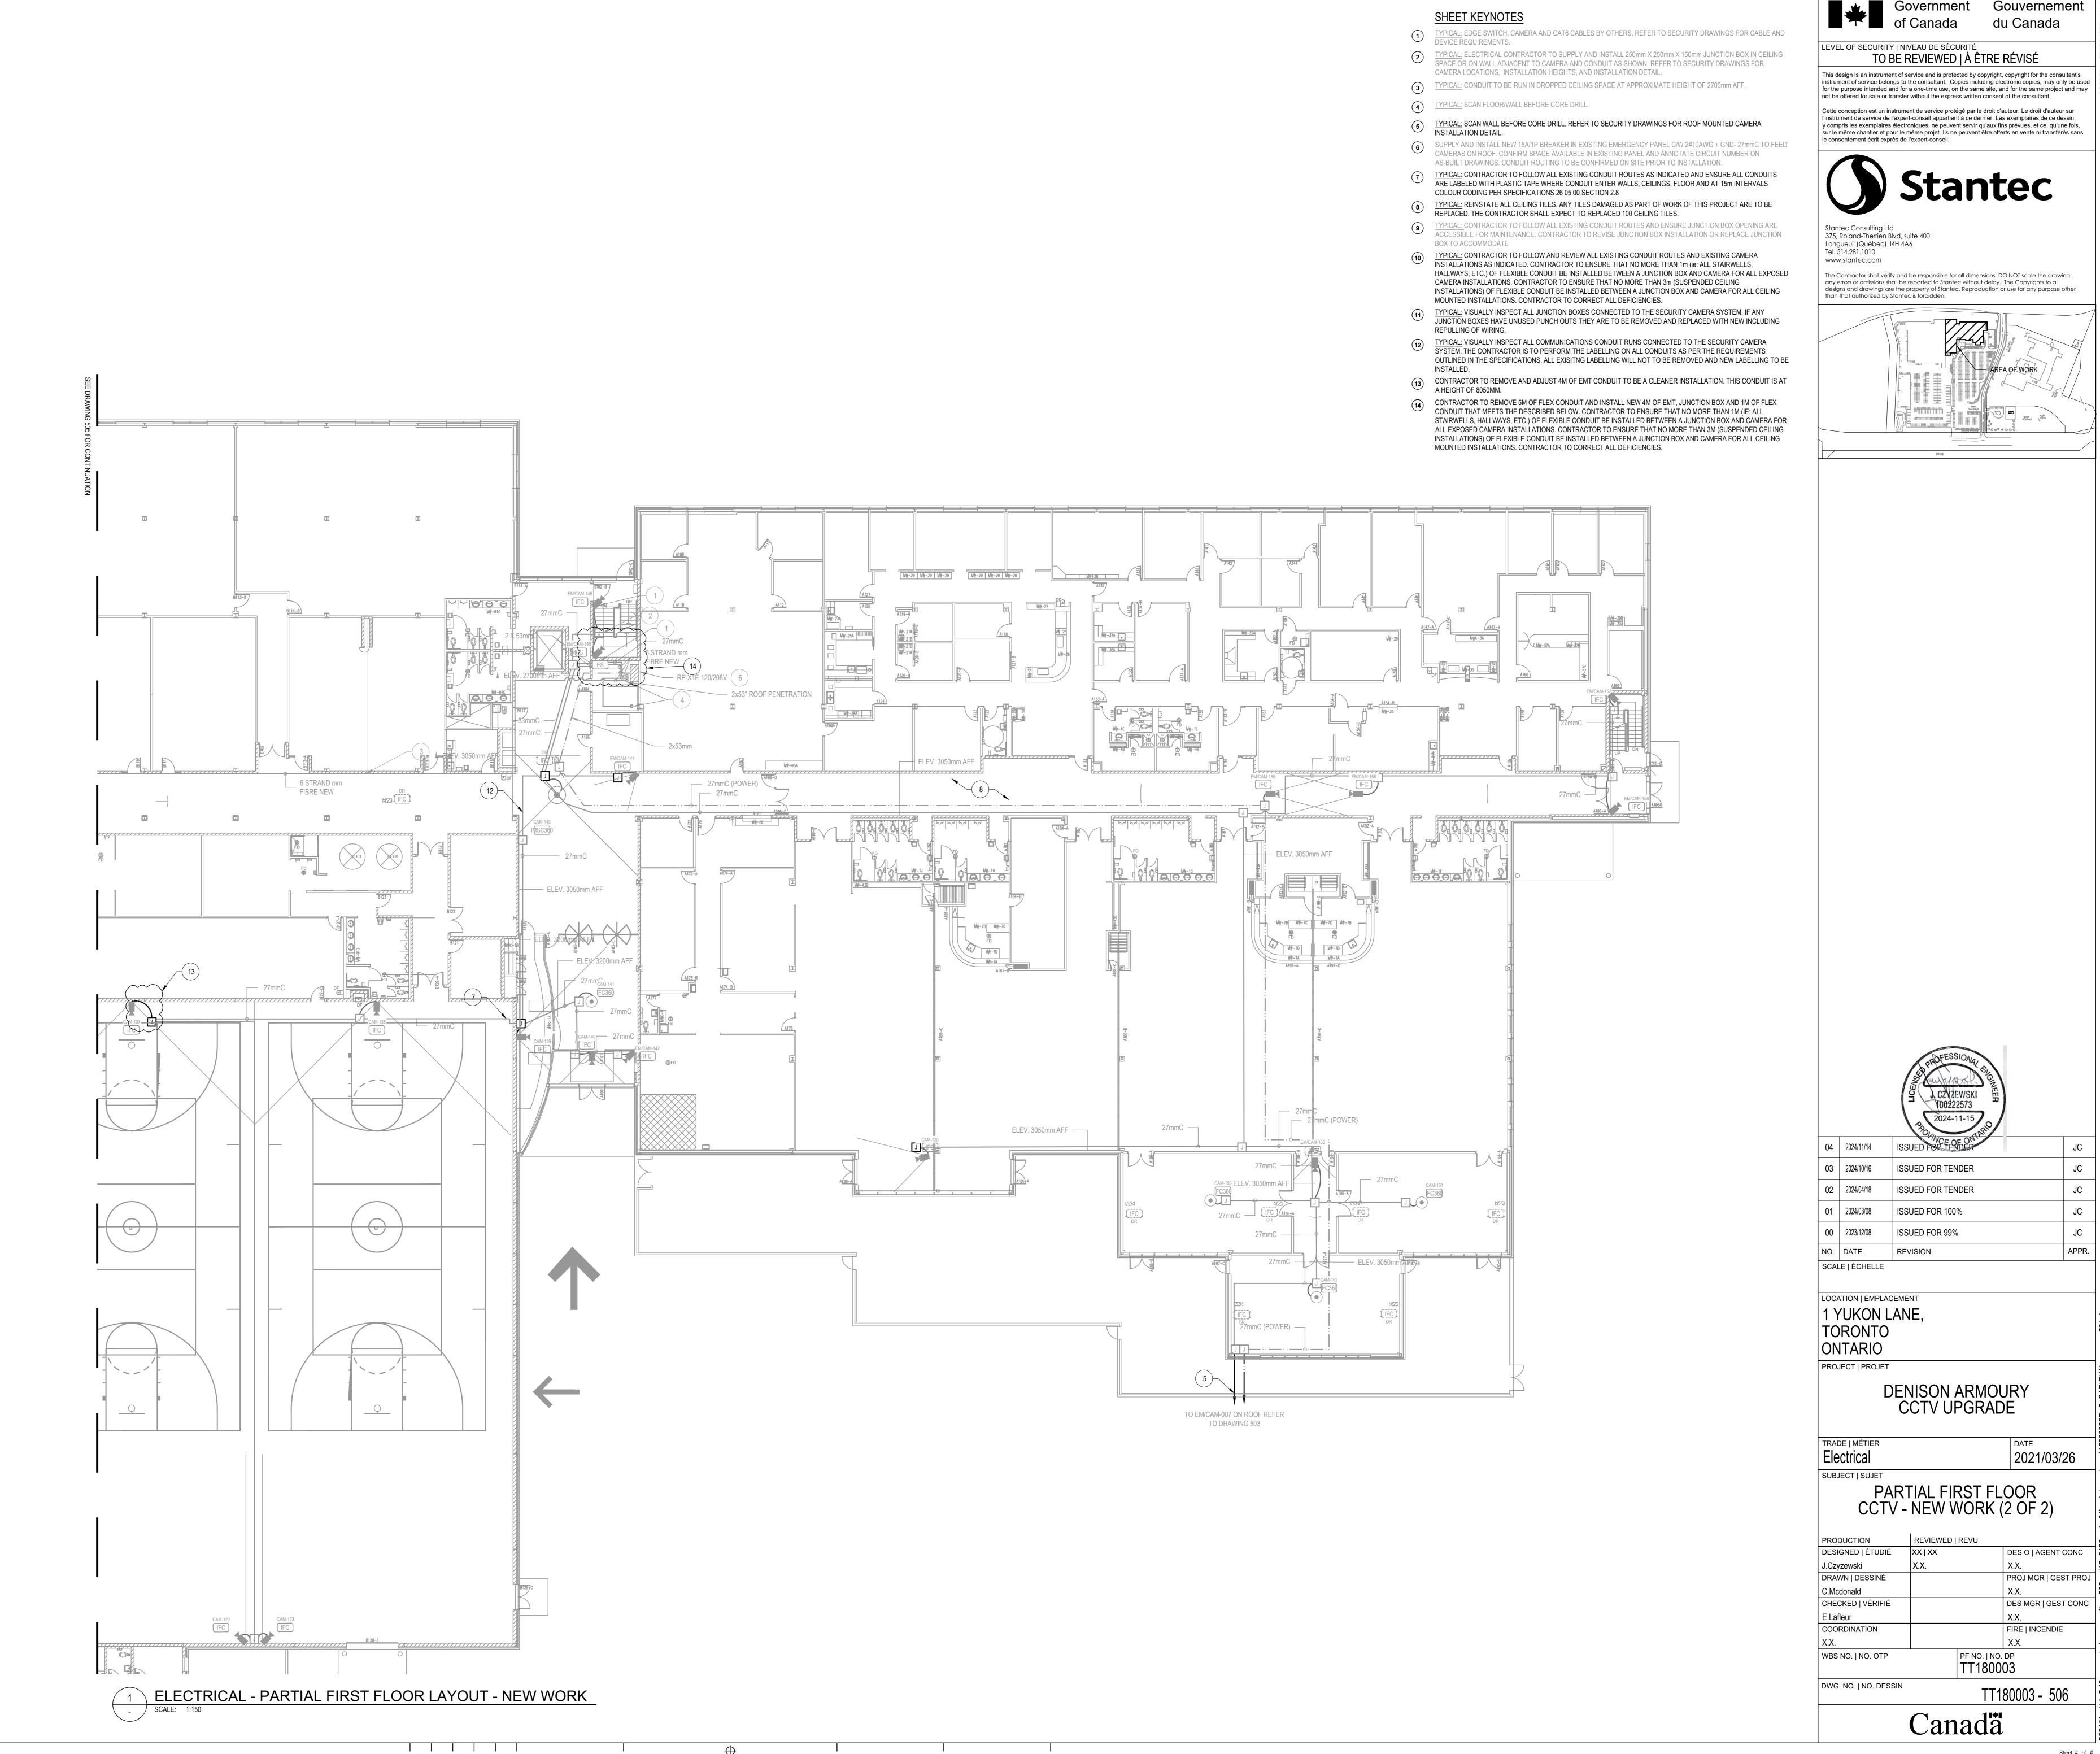

any errors or omissions shall be reported to Stantec without delay. The Copyrights to all designs and drawings are the property of Stantec. Reproduction or use for any purpose other

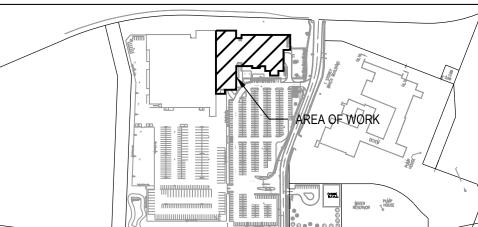

Sheet # of #

