CROSSEY ENGINEERING LTD.

MECHANICAL

MONTGOMERY SISAM ARCHITECTS INC.

ARCHITECTURAL

BAS CONTROLS UPGRADE

PROJECT No.: 21504.M04

CUMMER LODGE

HOME FOR THE AGED 205 CUMMER AVENUE WILLOWDALE, ONTARIO M2M-2E8



Toronto Long Term Care Homes & Services Division

DRAWING LIST			
DWG. NO.	DESCRIPTION	SCALE	
M-1.0	MECHANICAL DRAWING LIST, GENERAL NOTES AND EQUIPMENT TAG LEGEND PG. 1	N.T.S	
M-1.1	MECHANICAL DRAWING LIST, GENERAL NOTES AND EQUIPMENT TAG LEGEND PG. 2		
M-1.2 TO M-1.14	MECHANICAL PHOTOS		
M-2.1	NETWORK CONNECTIONS 1		
M-2.2	NETWORK CONNECTIONS 2		
M-2.3	BOILER AND HEAT EXCHANGER UPGRADES		
M-3.1	GROUND FLOOR BAS NEW WORK		
M-3.2	2ND FLOOR BAS NEW WORK		
M-3.3	3RD FLOOR BAS NEW WORK		
M-3.4	4TH FLOOR BAS NEW WORK		
M-3.5	ROOF LEVEL AHU EQUIPMENT LAYOUT		
M-3.6	ROOF LEVEL HVAC PIPING LAYOUT		
M-3.7	BASEMENT LEVEL HVAC PIPING LAYOUT		
M-4.1.1	GROUND FLOOR NW POD HVAC LAYOUT		
M-4.1.2	GROUND FLOOR NE WING HVAC LAYOUT		
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M-4.1.4	GROUND FLOOR SW POD HVAC LAYOUT		
M-4.1.5	GROUND FLOOR CORE HVAC LAYOUT		
M-4.2.1	2ND & 3RD FLOOR NW POD HVAC LAYOUT		
M-4.2.2	2ND & 3RD FLOOR NE WING HVAC LAYOUT		
M-4.2.3	2ND & 3RD FLOOR SE WING HVAC LAYOUT		
M-4.2.4	4 2ND & 3RD FLOOR SW POD HVAC LAYOUT		
M-4.2.5	2ND & 3RD FLOOR CORE HVAC LAYOUT		
M-4.3.1	4TH FLOOR NW POD HVAC LAYOUT		
M-4.3.2	4TH FLOOR NE WING HVAC LAYOUT		
M-4.3.3	4TH FLOOR SE WING HVAC LAYOUT		
M-4.3.4	4TH FLOOR SW POD HVAC LAYOUT		

DWG. NO.	DESCRIPTION	SCALE
M-4.3.5	4TH FLOOR CORE HVAC LAYOUT	N.T.S
M-5.1.20	TYPICAL REHEAT COIL 3-WAY	
M-5.1.21	TYPICAL HEATERS	
M-5.1.25	TYPICAL VAV/FPB UNIT	
M-5.1.26	TYPICAL REHEAT COILS	
M-6.1	SCHEMATIC DIAGRAM HEATING PLANT	

EQUIPMENT TAG LEGEND				
(AH _X)	AIR HANDLING UNIT	BX	HEATING BOILER	
HEX	PLATE HEAT EXCHANGER	(AC _X)	PACKAGED AIR CONDITIONING UNIT	
(W) x	DHW TANKS (HEATING WATER TO DHW)	MUA X	MAKE UP AIR UNIT	
PX	PRIMARY HEATING PUMPS	EF X	EXHAUST FAN	
(ET X	EXPANSION TANK	\$\$A\$X	SPLIT SYSTEM AIR CONDITIONING UNIT	
(\$F X	SUPPLY FAN	(Ts)	TEMPERATURE SENSOR	
(RF X	RETURN FAN	\mathbb{C}	CONVECTOR	
		RH	REHEAT COIL	

R	EVISIONS	
No.	DESCRIPTION	DATE
3	ISSUED FOR TENDER	2024-09-23
2	ISSUED FOR COOR WITH MSA	2024-05-09
1	ISSUED FOR COSTING	2022-07-11
No.	DESCRIPTION	DATE

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PROJECT:

CUMMER LODGE

Home For The Aged

CONTROLS UPGRADE

205 Cummer Avenue Willowdale, Ontario M2M 2E8

TITLE:

MECHANICAL DRAWING LIST PAGE 1

DATE:

SCALE: N.T.S

DRAWN BY: D.M/M.G

CHECKED BY: M.H/V.S

DRAWING No.

GENERAL NOTES

- 1. CONTRACTOR IS RESPONSIBLE FOR COORDINATING WORK WITH EXISTING CONDITIONS IN THE BUILDING.
- 2. ALL CURRENT MECHANICAL EQUIPMENT AND CURRENT BAS SYSTEMS ARE PRESENTLY IN GOOD WORKING CONDITIONS. ALL NEW BAS CONTROLS SHALL BE INTEGRATED WITH EX. BAS SYSTEM AND SHALL PERFORM TO A BETTER LEVEL UPON COMPLETION OF THIS PROJECT.
- THE CONTRACTOR SHALL BE RESPONSIBLE FOR THE OPERATIONS OF ALL EQUIPMENT AS PER SEQUENCE OF OPERATIONS.
- 4. THE CONTRACTOR SHALL PERFORM A JOINT INSPECTION OF THE FACILITY WITH THE BUILDING OWNER, PROJECT CONSULTANT AND ARCHITECT OF ALL EXISTING SERVICES AND EQUIPMENT TO DETERMINE THEIR CURRENT STATUS OF OPERATION AND REPORT ANY UNUSUAL PERFORMANCE IN TERMS OF CONTROLS.
- 5. CONTRACTOR SHALL COORDINATE WITH ARCH HARD CEILINGS DWGS FOR CUTTING & PATCHING OF WALLS, REMOVALS & REINSTALLATIONS OF T—BAR CEILINGS FOR ALL NEW SENSORS & DEVICES.
- 6. PRIOR TO START OF CONSTRUCTION, CONTRACTOR SHALL SUBMIT DWGS INDICATING EXTENT OF CUTTING & PATCHING SO THAT THIS WORK CAN BE DISCUSSED & COORDINATED. CONTRACTOR SHALL INCLUDE IN TENDER PRICE ALL CUTTING & PATCHING WORK INVOLVED.
- 7. TENDER PRICE SHALL INCLUDE ALL CONDUITS, WIRING AND RELATED WORK REQUIRED TO PROVIDE A FULLY FUNCTIONAL BAS SYSTEM AT THE END OF THE PROJECT.
- 8. PERFORM AIR AND WATER BALANCING OF ALL AIR DISTRIBUTION SYSTEMS THAT HAVE BEEN IDENTIFIED IN THE DRAWINGS AND SPECIFICATIONS.
- 9. THE BAS SHOP DRAWINGS RELATED TO THE JCT SYSTEM AND THE RMP SYSTEM HAS BEEN INCLUDED ALONG WITH THE SPECIFICATIONS. THERE ARE NO ARCHIVE DOCUMENTS AVAILABLE THAT IS RELATED TO THE VCI SYSTEM.
- 10. CONTRACTORS ARE RESPONSIBLE TO FAMILIARIZE THEMSELVES WITH THE SEQUENCE OF OPERATION OF THE VARIOUS SYSTEM IN THE FACILITY. THIS IS BECAUSE IN THE EVENT OF AN ISSUE WIT THE PERIMETER HEATING SYSTEMS, THE OPERATIONAL REQUIREMENTS OF SUCH SYSTEMS MAY NEED TO BE OPTIMIZED TO MEET SPACE REQUIREMENTS. SUCH OPTIMIZATION WILL BE THE RESPONSIBILITY OF THE CONTRACTOR. THE DESIGN TEAM WILL PROVIDE THE INFORMATION AND GUIDANCE TO ACHIEVE THIS OPTIMIZATION. THE BUILDING MANAGER OF THE HOME AND THE BAS MAINTENANCE CONTRACTOR CURRENTLY SERVICING THE HOME WILL ALSO BE INVOLVED IN PROVIDING THIS INFORMATION. CONTRACTORS SHALL ALLOW TIME REQUIRED FOR SUCH OPTIMIZATION IN THEIR BIDS. CONTRACTORS WILL NOT BE PAID EXTRAS TO FULFILL THIS RESPONSIBILITY.
- 11. THE GEN CONTRACTOR AND THE BAS CONTRACTOR SHALL COORDINATE TO ENSURE THAT THEY HAVE ALL THE NECESSARY TRADES REQUIRED FOR THE BAS ASPECTS OF THIS PROJECT, WHICH INCLUDES BUT NOT LIMITED TO:
- a) ELECTRICAL CONTRACTOR TO COMPLETE ALL NECESSARY ELECTRICAL WIRING REQUIRED TO POWER BAS CONTROLLERS, END DEVICES AND OTHER RELATED EQUIPMENT.
- b) BALANCING CONTRACTOR.
- c) ARCH AND GEN TRADES.
- 12. THE MECHANICAL CONTRACTOR SHALL ALLOW FOR WATER TREATMENT OF THE ENTIRE HYDRONIC HEATING SYSTEM THAT SERVES THE PERIMETER HEATING LOOP (CONVECTORS/RADIATORS) AND THE HYDRONIC HEATING SYSTEM THAT SERVES THE REHEAT COIL LOOP. THIS IS BECAUSE THESE LOOPS MAY NEED TO BE DRAINED TO REPLACE THE CONTROL VALVES SERVING THE TERMINAL DEVICES. THE HEATING SYSTEM THAT SERVES THE AHU SYSTEM AND OTHER HEATING LOOPS ARE NOT PART OF THIS PROJECT. HOWEVER, IF THERE IS ANY ACCIDENTAL DAMAGE TO THE PIPING SYSTEM OR DRAINING OF THE HEATING LOOP, THE CONTRACTOR WILL REFILL THE SYSTEM AND PROVIDE WATER TREATMENT AT NO ADDITIONAL COST TO THE PROJECT.
- 13. THE MECHANICAL CONTRACTOR SHALL ALLOW FOR COMPLETE BALANCING OF THE REHEAT COIL HEATING LOOP AND THE PERIMETER/CONVECTOR HEATING LOOP.

OVERVIEW OF CURRENT BAS SYSTEMS

- 1. THE CUMMER LODGE CURRENT BAS SYSTEM COMPRISES OF THE FOLLOWING MAJOR SYSTEMS.
- a. JOHNSON CONTROLS TRIDIUM (JCT), FACILITY EXPLORER FX80 c/w NIAGARA FX14 (N4) SYSTEM SUPPLIED AND INSTALLED BY YORKLAND CONTROLS.
- RELIABLE MACH PRO WEB SYSTEM (RMP) SUPPLIED AND INSTALLED BY ENERGY CONCEPTS (1-866-636-1066).
- c. LEGACY VCI SYSTEM.
- 2. THE JCT SYSTEM CONTROLS THE FOLLOWING MAJOR SYSTEMS IN THE FACILITY
- a. ALL SYSTEMS ASSOCIATED WITH THE AIR HANDLING UNITS (AHUS) AND ROOF TOP AIR HANDING UNITS (RTUS) COMPRISING OF THE FANS, COILS AND HUMIDIFIERS.
- b. THE CHILLER PLANT COMPRISING OF THE CHILLER, HEAT EXCHANGERS AND PUMPS.
- c. ALL THE SECONDARY HEATING PUMPS.
- 3. THE RMP SYSTEM CONTROLS THE FOLLOWING MAJOR SYSTEMS IN THE FACILITY
- a. THE HEATING BOILERS, PRIMARY PUMPS AND SECONDARY PUMPS.
- b. THE DOMESTIC HOT WATER HEAT EXCHANGERS AND PUMPS.
- 4. THE LEGACY VCI SYSTEM CONTROLS THE FOLLOWING MAJOR SYSTEMS IN THE FACILITY

 a. ALL RESIDENT ROOM SYSTEMS COMPRISING OF ROOM SIDE THERMOSTATS, CONVECTORS
 IN THE RESIDENT ROOM AND REHEAT COILS IN THE RESIDENT ROOMS.
- b. ALL VAV BOXES, FAN POWERED BOXES (FPB) REHEAT COILS ASSOCIATED WITH VAVS AND FPBs AND THEIR ASSOCIATED THERMOSTATS.

OVERVIEW OF PROJECT SCOPE

- 1. THE SCOPE OF THIS BAS PROJECT INVOLVES THE FOLLOWING MAJOR UPGRADES
- a. UPGRADE OF TERMINAL HEATING CONTROL ELEMENTS SERVING TYPICAL RESIDENT ROOMS INVOLVING REPLACEMENT OF CONTROL VALVES FOR CONVECTORS AND REHEAT COILS.
- b. REPLACEMENT OF STAND-ALONE THERMOSTATS IN THE TYPICAL RESIDENT ROOMS WITH BAS COMPATIBLE TEMPERATURE SENSORS.
- REPLACEMENT OF VAV BOXES AND FPBS SERVING VARIOUS ADMINISTRATION OFFICES AND COMMON AREAS.
- d. REPLACEMENT OF THERMOSTATS SERVING THE VAV BOXES AND FPBS WITH BAS COMPATIBLE TEMPERATURE SENSORS.
- e. INTEGRATING THE ABOVE SYSTEMS WITH THE EXISTING BAS SYSTEMS IN THE FACILITY.
- REPLACE THE RELIABLE MACH PRO SYSTEM AND REPLACE ALL THE RELIABLE CONTROLLERS WITH JCT CONTROLLERS. RE-PROGARM THE JCT CONTROLLERS TO MATCH AND IMPROVE THE CURRENT SEQUENCE OF OPERATION OF THE HEATING PLANT AND THE DHW PLANT.

2. PHASED CONSTRUCTION

- a. THE SCOPE OF WORK IN THE DESIGN DRAWINGS IDENTIFIES THE PHASED MANNER IN WHICH THE PROJECT CAN BE EXECUTED. THE PHASING IDENTIFIED IN THE DOCUMENTS IS A SUGGESTIVE APPROACH.
- b. PHASING IS SUGGESTED SO THAT ONLY PORTIONS OF THE FACILITY AND PARTIAL SYSTEMS ARE IMPACTED BY SYSTEM SHUT DOWNS.
- c. WHEN PHASED SHUT DOWNS ARE IMPLEMENTED THE REST OF THE FACILITY SHALL NOT BE IMPACTED BY THE AREA UNDER SHUT DOWN.
- I. CONTRACTORS ARE REQUESTED TO EVALUATE THE PHASING SUGGESTED. CONTRACTORS ARE WELCOME TO SUGGEST ALTERNATE PHASING MEASURES. THE SUGGESTIONS WILL BE DISCUSSED WITH THE SUCCESSFUL CONTRACTOR SO THAT AN APPROPRIATE CONSTRUCTION SCHEDULE CAN BE DEVELOPED.

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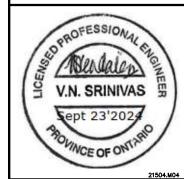
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CUMMER LODGE

Home For The Aged

CONTROLS UPGRADE

205 Cummer Avenue Willowdale, Ontario M2M 2E8

PROJECT:

TITLE:

MECHANICAL DRAWING LIST PAGE 2

DATE:

SCALE: N.T.S

DRAWN BY: D.M/M.G

CHECKED BY: M.H/V.S

DRAWING No.


1.1 PHOTO BELOW SHOWS THE ENTRANCE DOOR TO ROOM N242. N242 IS A SINGLE BED RESIDENT ROOM.



1.3 PHOTOS BELOW INDICATE THE FINISHED NATURE OF THE RESIDENT ROOMS. CONTRACTOR SHALL ALLOW FOR DRY WALL AND CEILING, CUTTING, PATCHING AND FINISHING TO INSTALL NEW WIRING BETWEEN THE TEMPERATURE SENSOR AND THE CONTROL VALVES.



ITEM 1.3.2

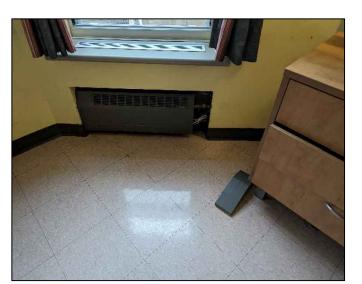

GENERAL NOTE:
NOTES INCLUDED IN THIS DRAWING
IS APPLICABLE FOR ALL THE
RESIDENT ROOM AREAS IN THIS
FACILITY. THE PHOTOS BELOW ARE
PROVIDED AS AN EXAMPLE FOR THE
WORK THAT WILL BE REQUIRED IN
ALL THE ROOMS.

1.2 PHOTO BELOW INDICATES THE MOTORIZED CONTROL VALVE ASSOCIATED WITH THE CONVECTOR IN THE RESIDENT ROOM. THERE ARE WIRES ATTACHED TO THE CONTROL VALVES. REPLACE THE THERMOSTAT WITH A NEW BAS COMPATIBLE TEMPERATURE SENSOR AND CONTROL VALVE. PROVIDE NEW WIRING BETWEEN THE THERMOSTAT AND THE CONTROL VALVE.



REVISIONS No. DESCRIPTION DATE 3 ISSUED FOR TENDER 2024–09–23 2 ISSUED FOR COOR WITH MSA 2024–05–09 1 ISSUED FOR COSTING 2022–07–11 No. DESCRIPTION DATE

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21504.

PROJECT:

CUMMER LODGE
Home For The Aged

CONTROLS UPGRADE

205 Cummer Avenue Willowdale, Ontario M2M 2E8

TITLE:

MECHANICAL PHOTOS

DATE:

SCALE: N.T.S

DRAWN BY: D.M/M.G

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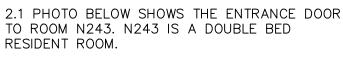
1.4 PHOTO BELOW INDICATES THE CURRENT LOCATION OF THE THERMOSTAT ON THE WELL. THE THERMOSTAT IS LOCATED NEXT TO THE CLOSET. THE CONVECTOR CONTROL VALVE IS LOCATED BESIDE THE WINDOW, IN THE OPPOSITE WALL.


THE BAS UPGRADE WILL REQUIRE REPLACEMENT OF THE THERMOSTAT, THE CONTROL VALVE AND THE WIRING BETWEEN THE TWO. THIS WILL REQUIRE MULTIPLE DRY WALL AND CEILING OPENINGS TO BE MADE TO INSTALL NEW WIRES. CONTRACTOR SHALL MAKE PROVISIONS FOR APPROPRIATE DRY WALL OPENINGS.

1.5 PHOTO BELOW INDICATES THE DUCTWORK REHEAT COIL WITHIN THE CEILING SPACE. REPLACE THE EX. REHEAT COIL CONTROL VALVE. PROVIDE NEW CONTROL WIRING BETWEEN THE REHEAT CONTROL VALVE AND THE NEW TEMPERATURE SENSOR. THIS WILL REQUIRE MULTIPLE DRY WALL AND CEILING OPENINGS TO BE MADE TO INSTALL NEW WIRES.

TO ROOM N243. N243 IS A DOUBLE BED RESIDENT ROOM.





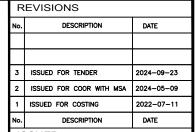

ISSUED

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PROJECT: CUMMER LODGE Home For The Aged

CONTROLS UPGRADE

205 Cummer Avenue Willowdale, Ontario M2M 2E8

TITLE:

MECHANICAL PHOTOS


DATE:

SCALE: N.T.S

DRAWN BY: D.M/M.G

CHECKED BY: M.H/V.S

DRAWING No.

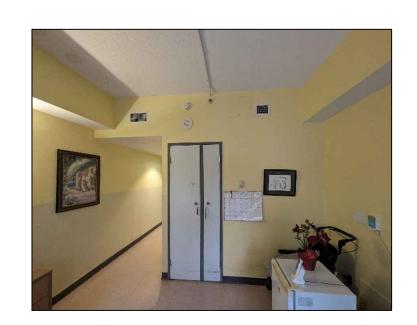



2.2 PHOTO BELOW INDICATES THE CURRENT LOCATION OF THE THERMOSTAT ON THE WELL. THE THERMOSTAT IS LOCATED NEXT TO THE CLOSET. THE CONVECTOR CONTROL VALVE IS LOCATED BESIDE THE WINDOW, IN THE OPPOSITE WALL.

THE BAS UPGRADE WILL REQUIRE REPLACEMENT OF THE THERMOSTAT, THE CONTROL VALVE AND THE WIRING BETWEEN THE TWO. THIS WILL REQUIRE MULTIPLE DRY WALL AND CEILING OPENINGS TO BE MADE TO INSTALL NEW WIRES. CONTRACTOR SHALL COORDINATE SUCH WALL OPENINGS.

2.3 PHOTO BELOW INDICATES THE GENERAL LAYOUT OF THE ROOM INDICATING THE EXTENT OF DRY WALLS AND CEILINGS THAT NEED TO BE PROVIDED WITH ACCESS OPENINGS TO INSTALL NEW WIRING.







ITEM 2.3.1 ITEM 2.3.2

R	EVISIONS	
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PROJECT:

CUMMER LODGE

Home For The Aged

CONTROLS UPGRADE

205 Cummer Avenue Willowdale, Ontario M2M 2E8

TITLE:

MECHANICAL PHOTOS

DATE:

SCALE: N.T.S

DRAWN BY: D.M/M.G

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DRAWING No.

2.4 PHOTO BELOW INDICATES THE DUCTWORK REHEAT COIL WITHIN THE CEILING SPACE. REPLACE THE EX. REHEAT COIL CONTROL VALVE. PROVIDE NEW CONTROL WIRING BETWEEN THE REHEAT CONTROL VALVE AND THE NEW TEMPERATURE SENSOR. THIS WILL REQUIRE MULTIPLE DRY WALL AND CEILING OPENINGS TO BE MADE TO INSTALL NEW WIRES.



ITEM 2.4.1





ITEM 2.4.3

- [REVISIONS		
N	lo.	DESCRIPTION	DATE
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205 Cummer Avenue Willowdale, Ontario M2M 2E8

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MECHANICAL PHOTOS

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SCALE: N.T.S

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CHECKED BY: M.H/V.S

DRAWING No.

3.1 PHOTO BELOW SHOWS THE ENTRANCE DOOR TO ROOM S241. S241 IS A DOUBLE BED RESIDENT ROOM.






ITEM 3.1.2





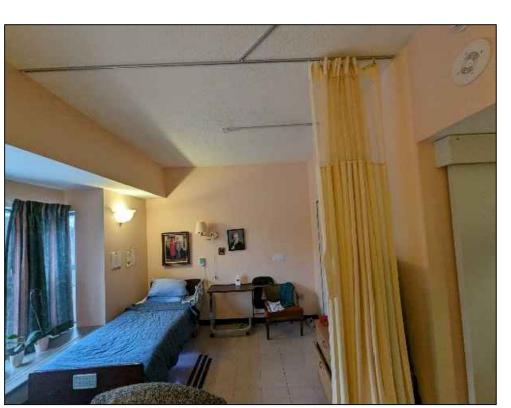

ITEM 3.1.4

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CUMMER LODGE Home For The Aged

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205 Cummer Avenue Willowdale, Ontario M2M 2E8

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GENERAL NOTE:

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PHOTOS ALSO INDICATE THE GENERAL LAYOUT OF THE ROOM INDICATING THE EXTENT OF DRY WALLS AND CEILINGS THAT NEED TO BE PROVIDED WITH ACCESS OPENINGS TO INSTALL NEW WIRING.







ITEM 3.1.7



ITEM 3.1.6



ITEM 3.1.8

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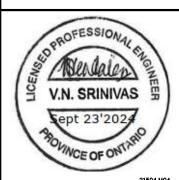
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ITEM 3.1.10



ITEM 3.1.12

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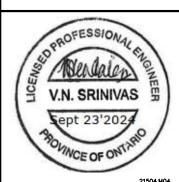
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ITEM 3.1.14





ITEM 3.1.16



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2	ISSUED FOR COOR WITH MSA	2024-05-09	
1	ISSUED FOR COSTING	2022-07-11	
No.	DESCRIPTION	DATE	

ISSUED


DO NOT SCALE DRAWINGS.
ALL DRAWINGS.
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CROSSEY

ENGINEERING L⊤D.



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PROJECT:

CUMMER LODGE Home For The Aged

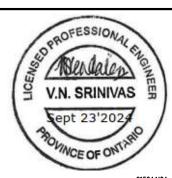CONTROLS UPGRADE

205 Cummer Avenue Willowdale, Ontario M2M 2E8

TITLE:

MECHANICAL PHOTOS

DATE:

SCALE: N.T.S

DRAWN BY: D.M/M.G

CHECKED BY: M.H/V.S

DRAWING No.

PHOTO BELOW INDICATES THE DUCTWORK REHEAT COIL WITHIN THE CEILING SPACE. REPLACE THE EX. REHEAT COIL CONTROL VALVE. PROVIDE NEW CONTROL WIRING BETWEEN THE REHEAT CONTROL VALVE AND THE NEW TEMPERATURE SENSOR. THIS WILL REQUIRE MULTIPLE DRY WALL AND CEILING OPENINGS TO BE MADE TO INSTALL NEW WIRES.





ITEM 3.1.18 ITEM 3.1.19





ITEM 3.1.21 ITEM 3.1.22

		1
47		

REVISIONS				
No.	DESCRIPTION	DATE		
3	ISSUED FOR TENDER	2024-09-23		
2	ISSUED FOR COOR WITH MSA	2024-05-09		
1	ISSUED FOR COSTING	2022-07-11		

ISSUED


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PROJECT:

CUMMER LODGE
Home For The Aged

CONTROLS UPGRADE

205 Cummer Avenue Willowdale, Ontario M2M 2E8

TITLE:

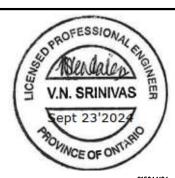MECHANICAL PHOTOS

DATE:


SCALE: N.T.S

DRAWN BY: D.M/M.G

CHECKED BY: M.H/V.S

DRAWING No.

3.2 PHOTO BELOW INDICATES THE DUCTWORK REHEAT COIL WITHIN THE CEILING SPACE.

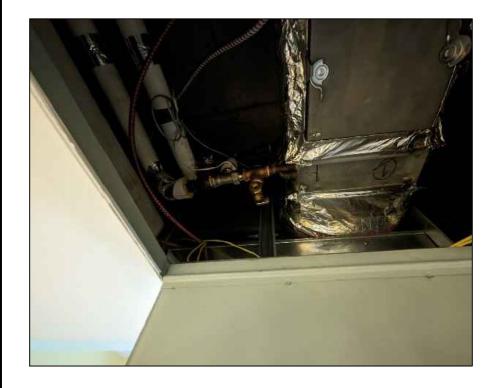

3.3 ITEM 3.3.1 INDICATES THE CONVECTOR.



ITEM 3.3.1



ITEM 3.3.2

	R	REVISIONS				
	No.	DESCRIPTION	DATE			
	3	ISSUED FOR TENDER	2024-09-23			
	2	ISSUED FOR COOR WITH MSA	2024-05-09			
	1	ISSUED FOR COSTING	2022-07-11			
	No.	DESCRIPTION	DATE			

ISSUED


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PROJECT:

CUMMER LODGE Home For The Aged

CONTROLS UPGRADE

205 Cummer Avenue Willowdale, Ontario M2M 2E8

TITLE:

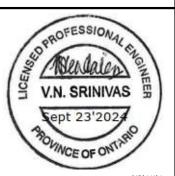MECHANICAL PHOTOS

DATE:

SCALE: N.T.S

DRAWN BY: D.M/M.G

CHECKED BY: M.H/V.S

DRAWING No.

- 4.1 THE MECHANICAL ROOM HAS:
- 1. A PAIR OF DEDICATED RETICULATION PUMPS THAT PROVIDE HEATING WATER TO THE CONVECTORS IN THE RESIDENT ROOMS.
- 2. A PAIR OF DEDICATED RETICULATION PUMPS THAT PROVIDE HEATING WATER TO THE REHEAT COILS IN THE RESIDENT ROOMS.

 CHRIS (CUMMER LODGE) STATED THAT THEY ADJUST THE 3-WAY MIXING VALVE OF THESE PUMPS TO ADJUST THE TEMPERATURE OF THE CONVECTOR LOOP AND THE REHEAT COIL LOOP BASED ON THE TEMPERATURE THEY OBSERVE IN THE RESIDENT ROOMS.

THE VCI SYSTEM IS NOT ACCESSIBLE ON THE BAS GRAPHICS. THEREFORE, THE ROOM SENSORS ARE NOT VISIBLE ON THE BAS. CHRIS STATED THAT THE HOME MONITORS THE ROOM TEMPERATURES BASED ON THE ZONE TEMPERATURE SENSORS.

THE ABOVE NOTES APPLY TO DWGS M-1.12, M-1.13, M-1.14



ITEM 4.1.1



ITEM 4.1.2

	R	REVISIONS				
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PROJECT:

CUMMER LODGE
Home For The Aged

CONTROLS UPGRADE

205 Cummer Avenue Willowdale, Ontario M2M 2E8

TITLE:

MECHANICAL PHOTOS

DATE:

SCALE: N.T.S


DRAWN BY: D.M/M.G

CHECKED BY: M.H/V.S

DRAWING No.



ITEM 4.1.3

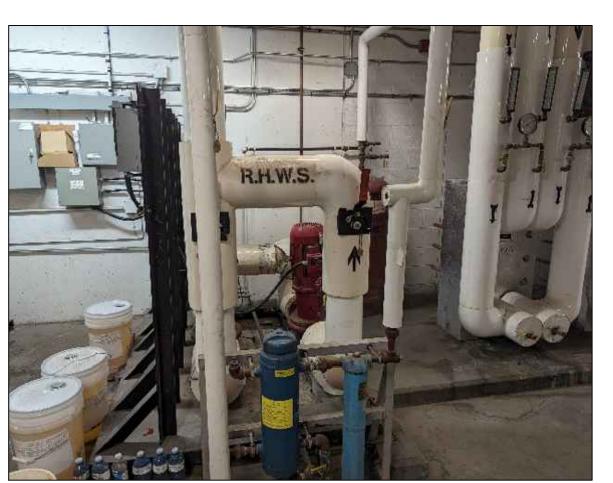

ITEM 4.1.4

	R	REVISIONS				
	No.	DESCRIPTION	DATE			
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	2	ISSUED FOR COOR WITH MSA	2024-05-09			
	1	ISSUED FOR COSTING	2022-07-11			
	No.	DESCRIPTION	DATE			

ISSUED

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PROJECT:

CUMMER LODGE Home For The Aged

CONTROLS UPGRADE

205 Cummer Avenue Willowdale, Ontario M2M 2E8

TITLE:

MECHANICAL PHOTOS

DATE:

SCALE: N.T.S

DRAWN BY: D.M/M.G

CHECKED BY: M.H/V.S


DRAWING No.







ITEM 4.1.7

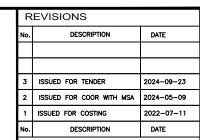

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PROJECT:

CUMMER LODGE Home For The Aged

CONTROLS UPGRADE

205 Cummer Avenue Willowdale, Ontario M2M 2E8

TITLE:

MECHANICAL PHOTOS

DATE :

SCALE: N.T.S

DRAWN BY: D.M/M.G

CHECKED BY: M.H/V.S

DRAWING No.

CONSTRUCTION NOTES

- 1.THE NETWORK LAYOUT INDICATED IS THE CURRENT LAYOUT IN THE CUMMER LODGE FACILITY. THIS NETWORK ONLY INCLUDES THE JCT BAS SYSTEM.
- 2.THE BIDDING CONTRACTORS SHALL PERFORM THE FOLLOWING TASKS PRIOR TO BIDDING THE PROJECT. THE CONTRACTORS WILL NOT BE ALLOWED TO SUBMIT EXTRAS TO EVALUATE THESE CONTROLLERS ONCE THE PROJECT HAS BEEN AWARDED.
- VERIFY THE ABOVE NETWORK LAYOUT AND ESTABLISH THE LOCATION AND OPERATION OF THE VARIOUS BAS CONTROLLERS.
- VERIFY THE LOCATION AND OPERATION OF THE VCI LEGACY SYSTEM CONTROLLERS.
- REFER TO SPECIFICATIONS. THE SHOP DRAWINGS OF THIS SYSTEM HAS BEEN PROVIDED ALONG WITH THE SPECIFICATIONS.

GENERAL NOTES

THE CONTRACTOR SHALL SUBMIT SHOP DRAWINGS THAT CLEARLY INDICATES THE LOCATION OF ALL NEW BAS CONTROLLERS FOR THE UPGRADES BEING IMPLEMENTED IN THIS PROJECT. ALL CONTROLLERS SHALL BE FIN COMPATIBLE AND SHALL BE INTEGRATED TO THE FIN SERVER.

ALL CONTROLLERS SHALL BE CONNECTED DIRECTLY TO THE CITY WAN. CONTRACTOR SHALL COORDINATE WITH THE CITY BAS TEAM FOR THE INSTALLATION OF THE WAN DROPS AND CONNECTION TO THE NEW CONTROLLERS.

REVISIONS DATE ISSUED FOR TENDER 2024-09-23 ISSUED FOR COOR WITH MSA 2024-05-09 ISSUED FOR COSTING 2022-07-11 DATE

ISSUED

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NETWORK LAYOUT - 1

BILL OF MATERIALS

System	Designation	Qty	Code Number	Description
SUPERVISORY	ENCLOSURE	1	567-351	SIEMENS PANEL 24x24x9
SUPERVISORY	LICENSE	1	FX-SC8CL025-0	FX80 SUPERVISORY CONTROLLER CORE DEVICE LICENSE, 25 FIELD DEVICES, 1,250 POINTS
SUPERVISORY	LICENSE	1	FX-SC8DL10-0	FX80 SUPERVISORY CONTROLLER ADDITIONAL 10 FIELD DEVICES, 500 POINTS
SUPERVISORY	MAINTENANCE	1	FX-SC8D025M3-0	INITIAL 3 YEAR SOFTWARE MAINTENANCE FOR FX80 SUPERVISORY CONTROLLER WITH 25-99 FIELD DEVICE CAPACITY
SUPERVISORY	LICENSE	1	FX-SC8LAX-0	LICENSE ENABLING AX3.8 DOWNGRADE
SUPERVISORY	BASE	1	FX-SC8BASE-0	FX80 SUPERVISORY CONTROLLER AND MICRO SECURE DIGIRAL(SD) CARD



F - EOL



NAME: RTU-4



DEVICE: PCX2721

NAME: CHWS

MS/TP ADD: 5

DEVICE: PCG2611

DEVICE ID: 1005 LOCATION: BASEMENT





DEVICE: PCX2721

DEVICE: PCX2721 DEVICE: PCX4711

SA ADD: 5

SA ADD: 4



DEVICE: PCX2721



NAME: RTU-5

NAME: AHU-2

MS/TP ADD: 6

DEVICE: PCA3611

LOCATION: BASEMENT



DEVICE: PCX2721

DEVICE: PCX2721 DEVICE: PCX2721

SA ADD: 5

SA ADD: 4



DEVICE: PCX2721







NAME: RTU-6

NAME: AHU-4

MS/TP ADD: 8

LOCATION: BASEMENT

DEVICE: PCA3611 DEVICE: PCX2721

SA ADD: 4





DEVICE: PCX2721



DEVICE: PCX2721

NAME: AHU-5

MS/TP ADD: 9

DEVICE: PCX2721

SA ADD: 5

DEVICE: PCA3611

LOCATION: BASEMENT



DEVICE: PCX2721



NAME: RTU-7

DEVICE: PCX2721 DEVICE: PCX4711

SA ADD: 5

SA ADD: 4



DEVICE: PCX4711





CUMMER LODGE Home For The Aged

CONTROLS UPGRADE

205 Cummer Avenue Willowdale, Ontario M2M 2E8

TITLE:

NETWORK **CONNECTIONS 1**

DATE

SCALE: N.T.S

DRAWN BY: D.M/M.G

CHECKED BY: M.H/V.S DRAWING No.

M-2.1



DEVICE: PCX2721

SA ADD: 4

NAME: AHU-3

MS/TP ADD: 7

DEVICE: PCA3611

DEVICE ID: 1007 LOCATION: BASEMENT

DEVICE: PCX2721 DEVICE: PCX4711

CONSTRUCTION NOTES

NETWORK LAYOUT - 1

1.THE NETWORK LAYOUT INDICATED IS THE CURRENT LAYOUT IN THE CUMMER LODGE FACILITY. THIS NETWORK ONLY INCLUDES THE JCT BAS SYSTEM.

2.THE BIDDING CONTRACTORS SHALL PERFORM THE FOLLOWING TASKS PRIOR TO BIDDING THE PROJECT. THE CONTRACTORS WILL NOT BE ALLOWED TO SUBMIT EXTRAS TO EVALUATE THESE CONTROLLERS ONCE THE PROJECT HAS BEEN AWARDED.

- 1. VERIFY THE ABOVE NETWORK LAYOUT AND ESTABLISH THE LOCATION AND OPERATION OF THE VARIOUS BAS CONTROLLERS.
- 2. VERIFY THE LOCATION AND OPERATION OF THE VCI LEGACY SYSTEM CONTROLLERS.

-Trunk-2

3. REFER TO SPECIFICATIONS. THE SHOP DRAWINGS OF THIS SYSTEM HAS BEEN PROVIDED ALONG WITH THE SPECIFICATIONS.

NAME: AHU-4 RF DEVICE: ACH550-PDR-02A7-6

MS/TP ADD: 4

DEVICE ID: 2004

(BACnet MS/TP)

NAME: AHU-2 RF DEVICE: ACH550-PDR-03A9-6

MS/TP ADD: 5 DEVICE ID: 2005 NAME: AHU-4 SF DEVICE: ACH550-PDR-06A1-6

MS/TP ADD: 6

GENERAL NOTES

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ALL CONTROLLERS SHALL BE CONNECTED DIRECTLY TO THE CITY WAN. CONTRACTOR SHALL COORDINATE WITH THE CITY BAS TEAM FOR THE INSTALLATION OF THE WAN DROPS AND CONNECTION TO THE NEW CONTROLLERS.

NAME: AHU-2 SF DEVICE: ACH550-PDR-011A-6

MS/TP ADD: 7

<u>-</u>
NAME: RTU-7 SF DEVICE: ACH550-PDR-027A-6 MS/TP ADD: 8 DEVICE ID: 2008
BOILER
NAME: HEATING SYSTEM MS/TP ADD: 9 DEVICE ID: 2009

 No.
 DESCRIPTION
 DATE

 3
 ISSUED FOR TENDER
 2024-09-23

 2
 ISSUED FOR COOR WITH MSA
 2024-05-09

 1
 ISSUED FOR COSTING
 2022-07-11

 No.
 DESCRIPTION
 DATE

ISSUED

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PROJECT:
CUMMER LODGE

Home For The Aged

CONTROLS UPGRADE

205 Cummer Avenue Willowdale, Ontario M2M 2E8

TITLE:

NETWORK CONNECTIONS 2

DATE:

SCALE: N.T.S

DRAWN BY: D.M/M.G

CHECKED BY: M.H/V.S

DRAWING No.

M-2.2

CUMMER LODGE BOILER AND HEAT EXCHANGERS UPGRADES SYSTEM ARCHITECTURE

ows

CAT5 ETHERNET TO OPERATOR'S WORKSTATION

BOILER1

PUMP

BOILER2


PUMP

BOILER3

PUMP

THE NETWORK LAYOUT PROVIDED BELOW INDICATES THE HEATING BOILER PLANT AND THE DHW PLANT CONTROLLED BY THE RELIABLE MACH PRO SYSTEM.

REPLACE THE RELIABLE MACH PRO SYSTEM AND REPLACE ALL THE RELIABLE CONTROLLERS WITH JCT CONTROLLERS. RE-PROGARM THE JCT CONTROLLERS TO MATCH AND IMPROVE THE CURRENT SEQUENCE OF OPERATION OF THE HEATING PLANT AND THE DHW PLANT. REFER TO SPECIFICATIONS FOR SEQUENCE OF OPERATIONS.

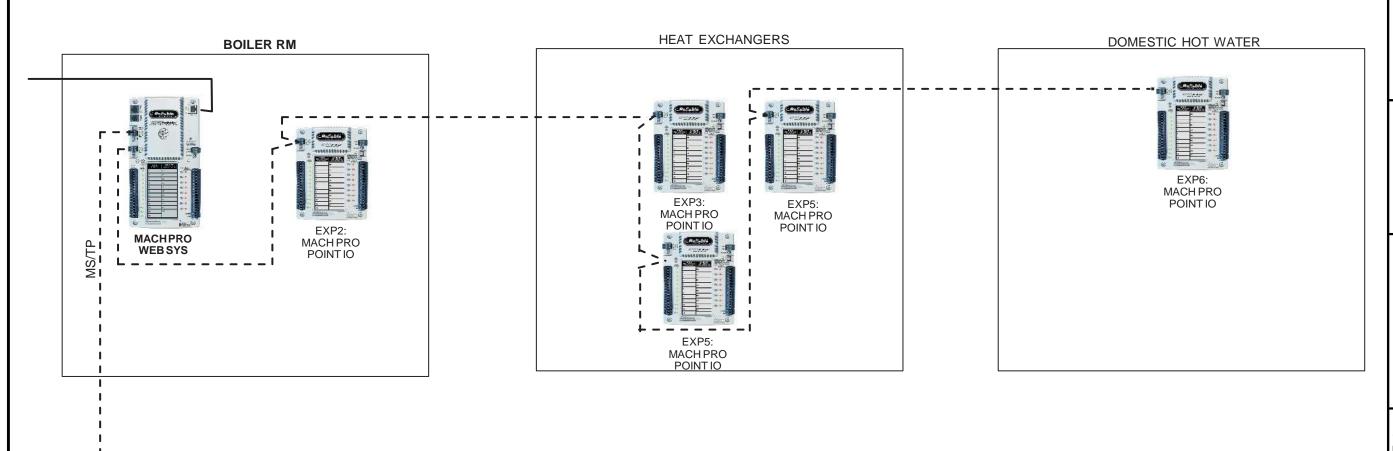

BOILER4

PUMP

GENERAL NOTES

THE CONTRACTOR SHALL SUBMIT SHOP DRAWINGS THAT CLEARLY INDICATES THE LOCATION OF ALL NEW BAS CONTROLLERS FOR THE UPGRADES BEING IMPLEMENTED IN THIS PROJECT. ALL CONTROLLERS SHALL BE FIN COMPATIBLE AND SHALL BE INTEGRATED TO THE FIN SERVER.

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1	ISSUED FOR COSTING	2022-07-11			
No	DESCRIPTION	DATE			

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PROJECT:

CUMMER LODGE Home For The Aged

CONTROLS UPGRADE

205 Cummer Avenue Willowdale, Ontario M2M 2E8

TITLE:

BOILER AND HEAT EXCHANGER UPGRADES

DATE:


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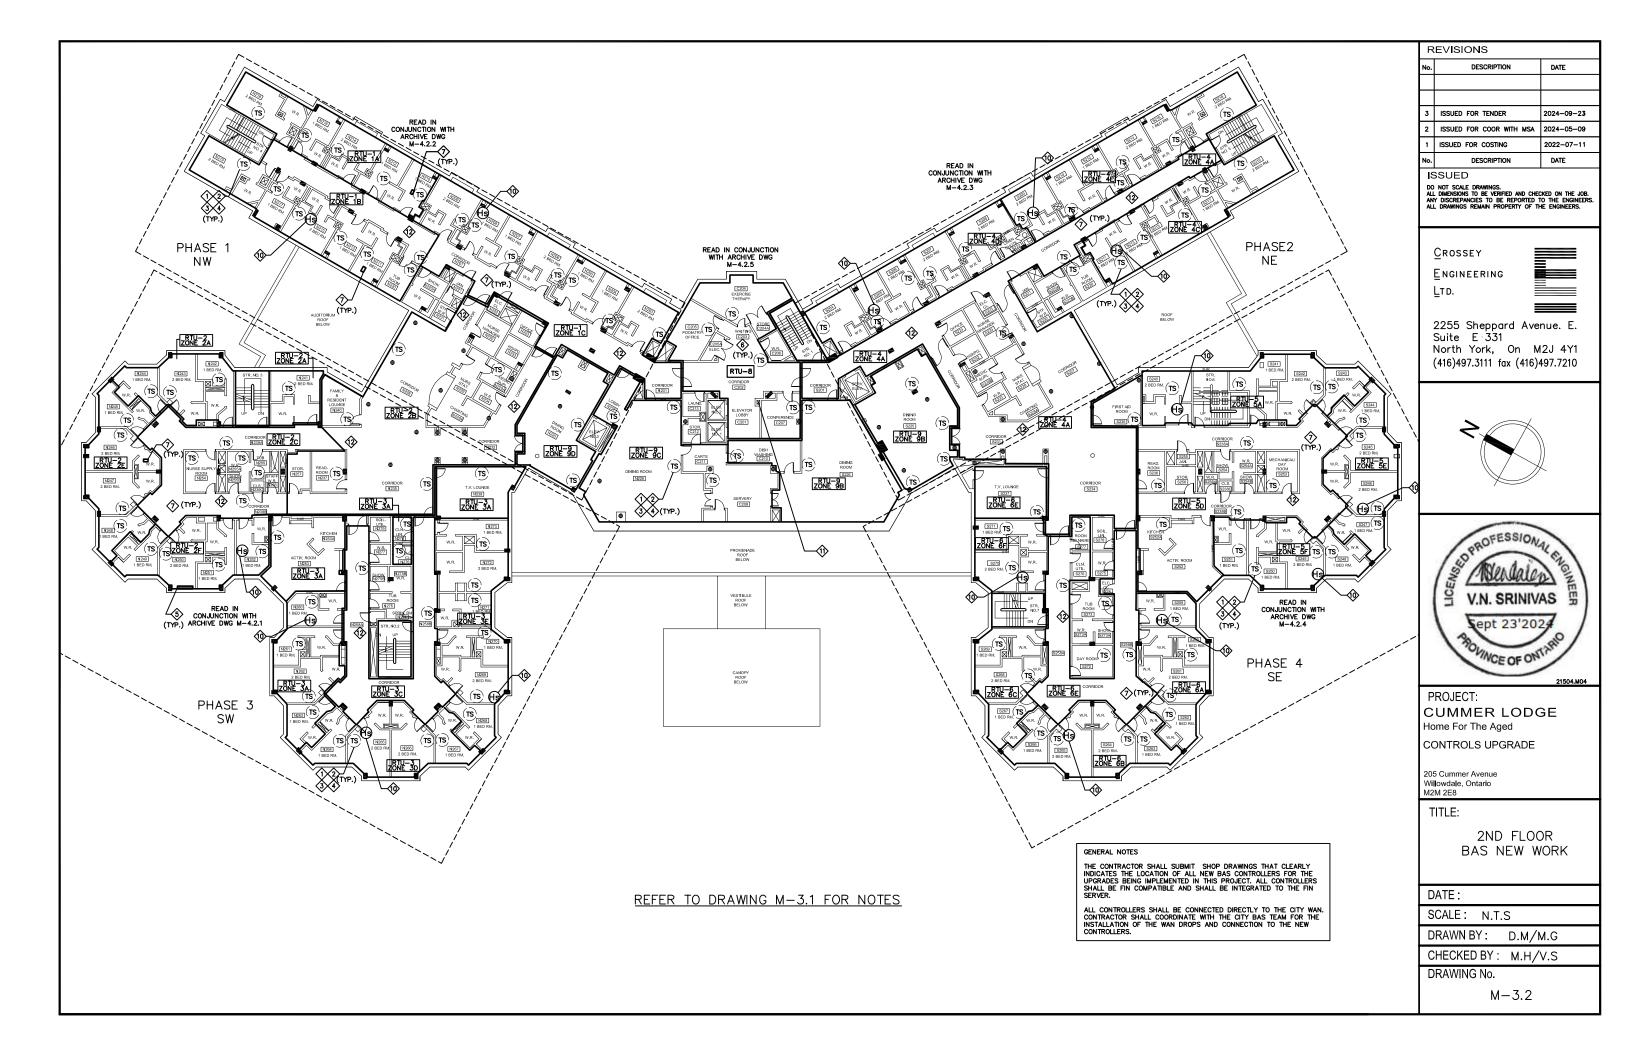
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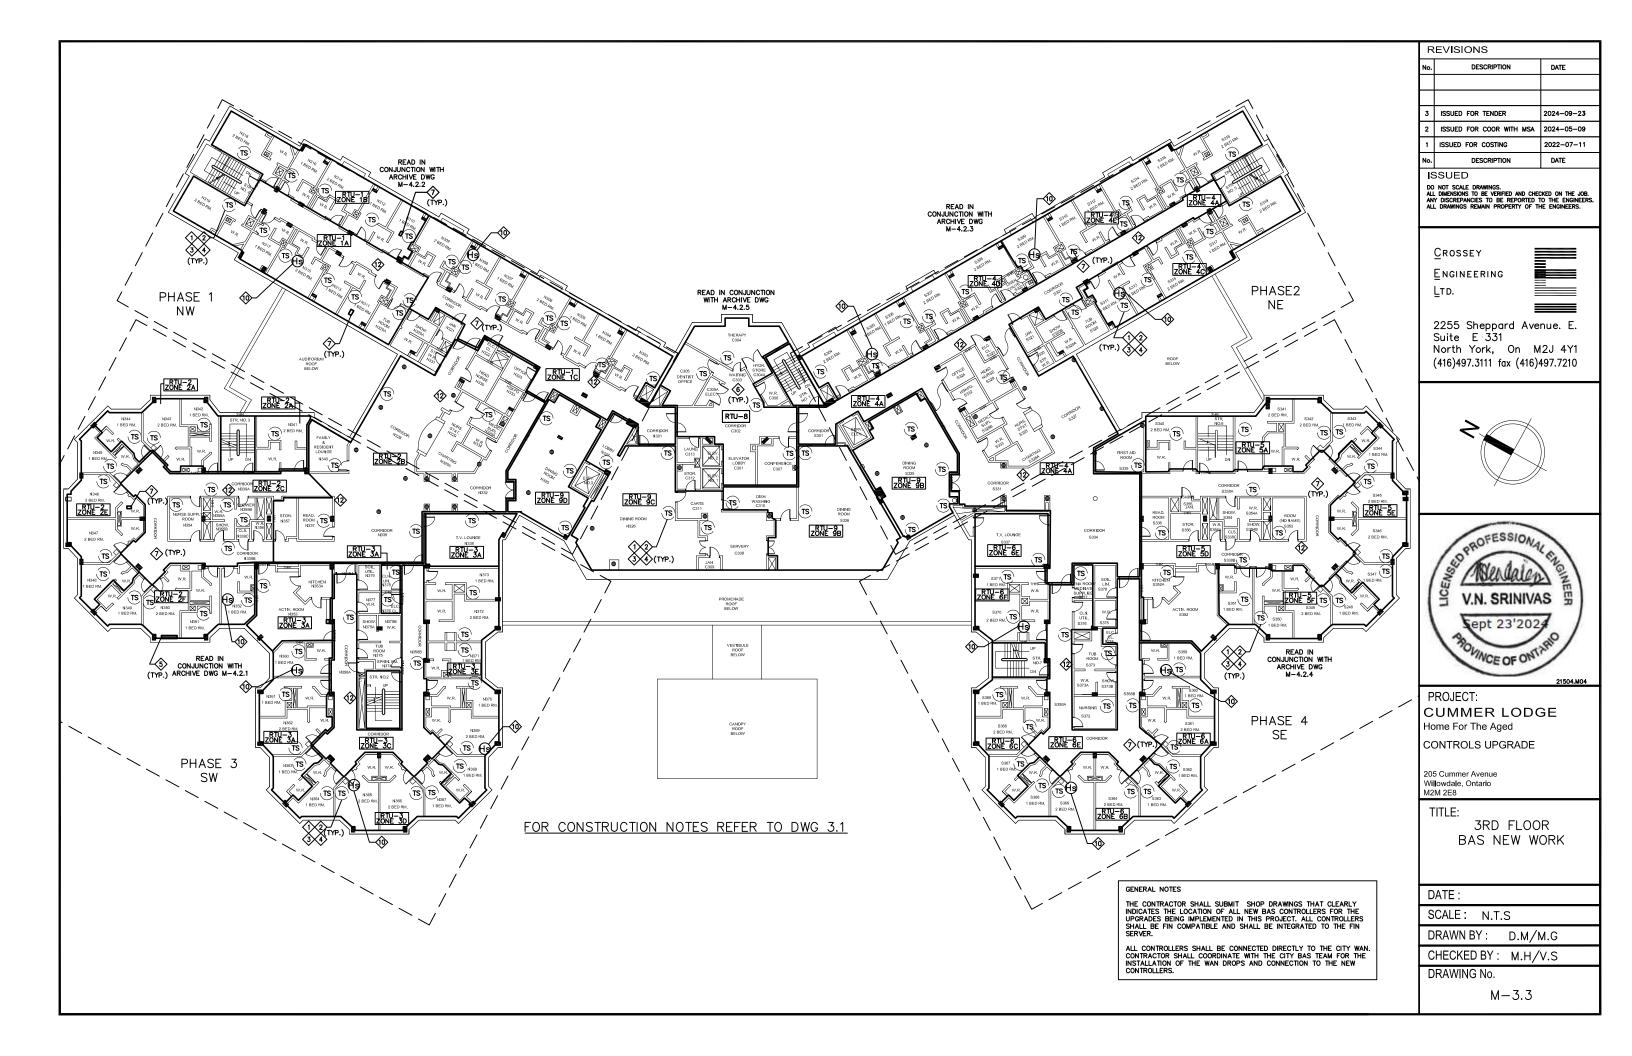
CHECKED BY: M.H/V.S


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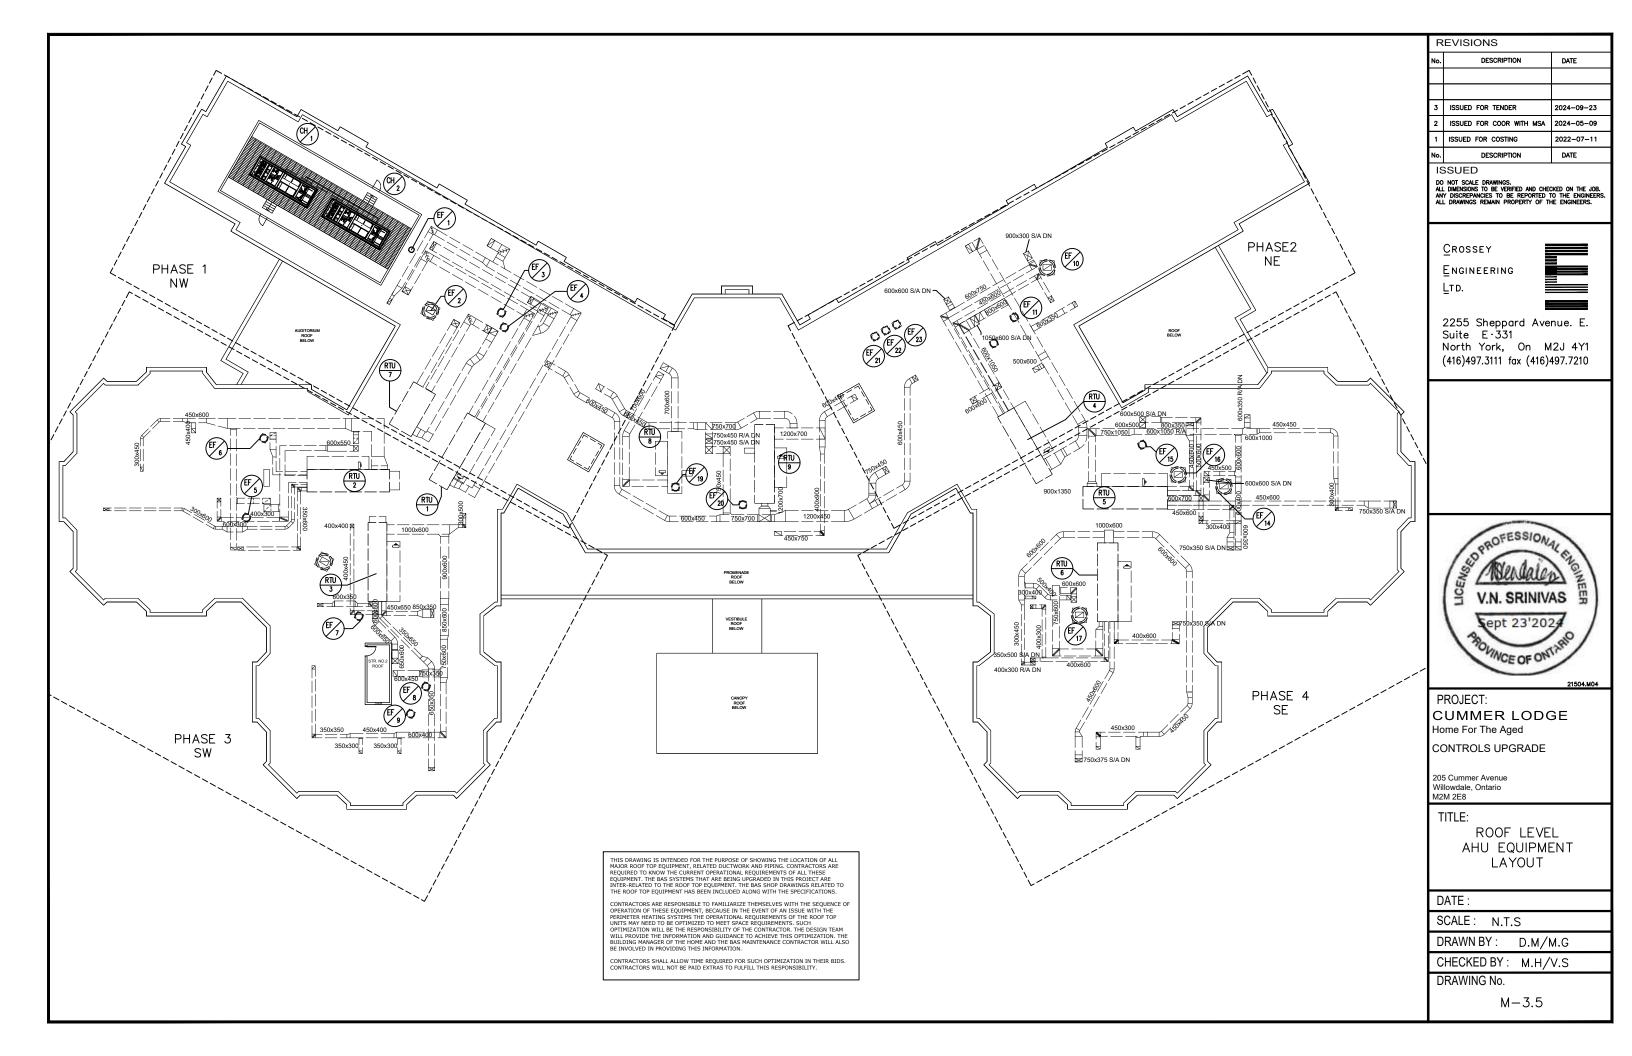
M-2.3










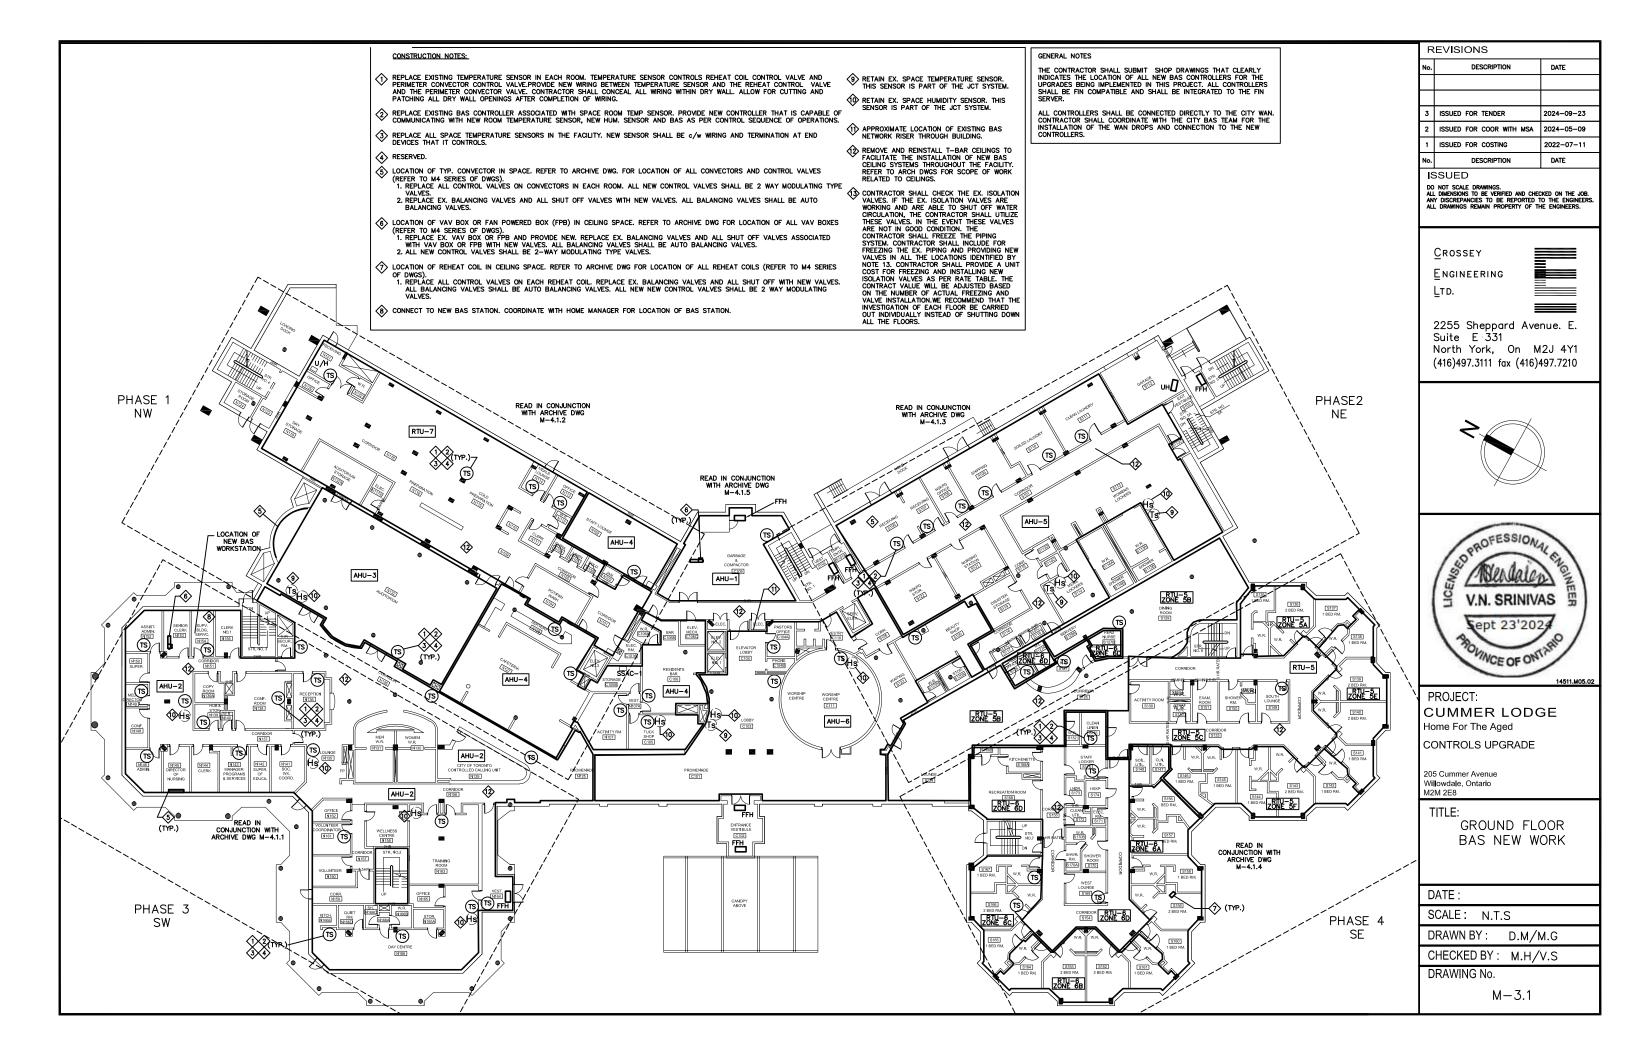

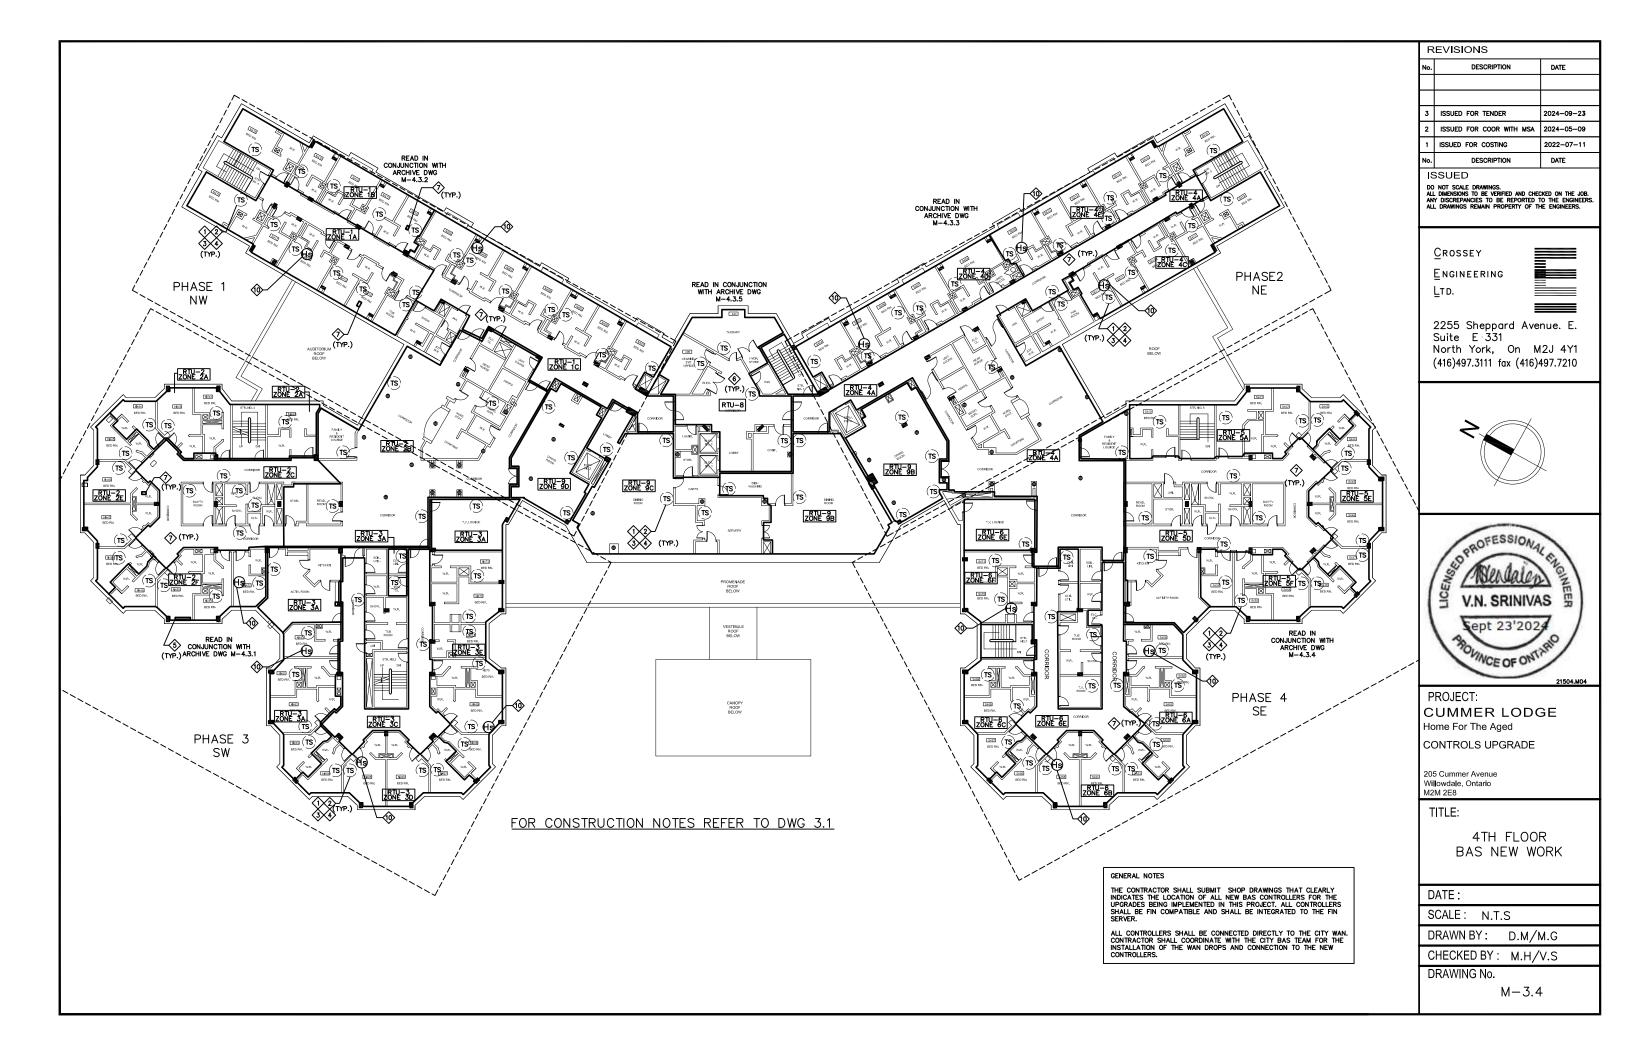

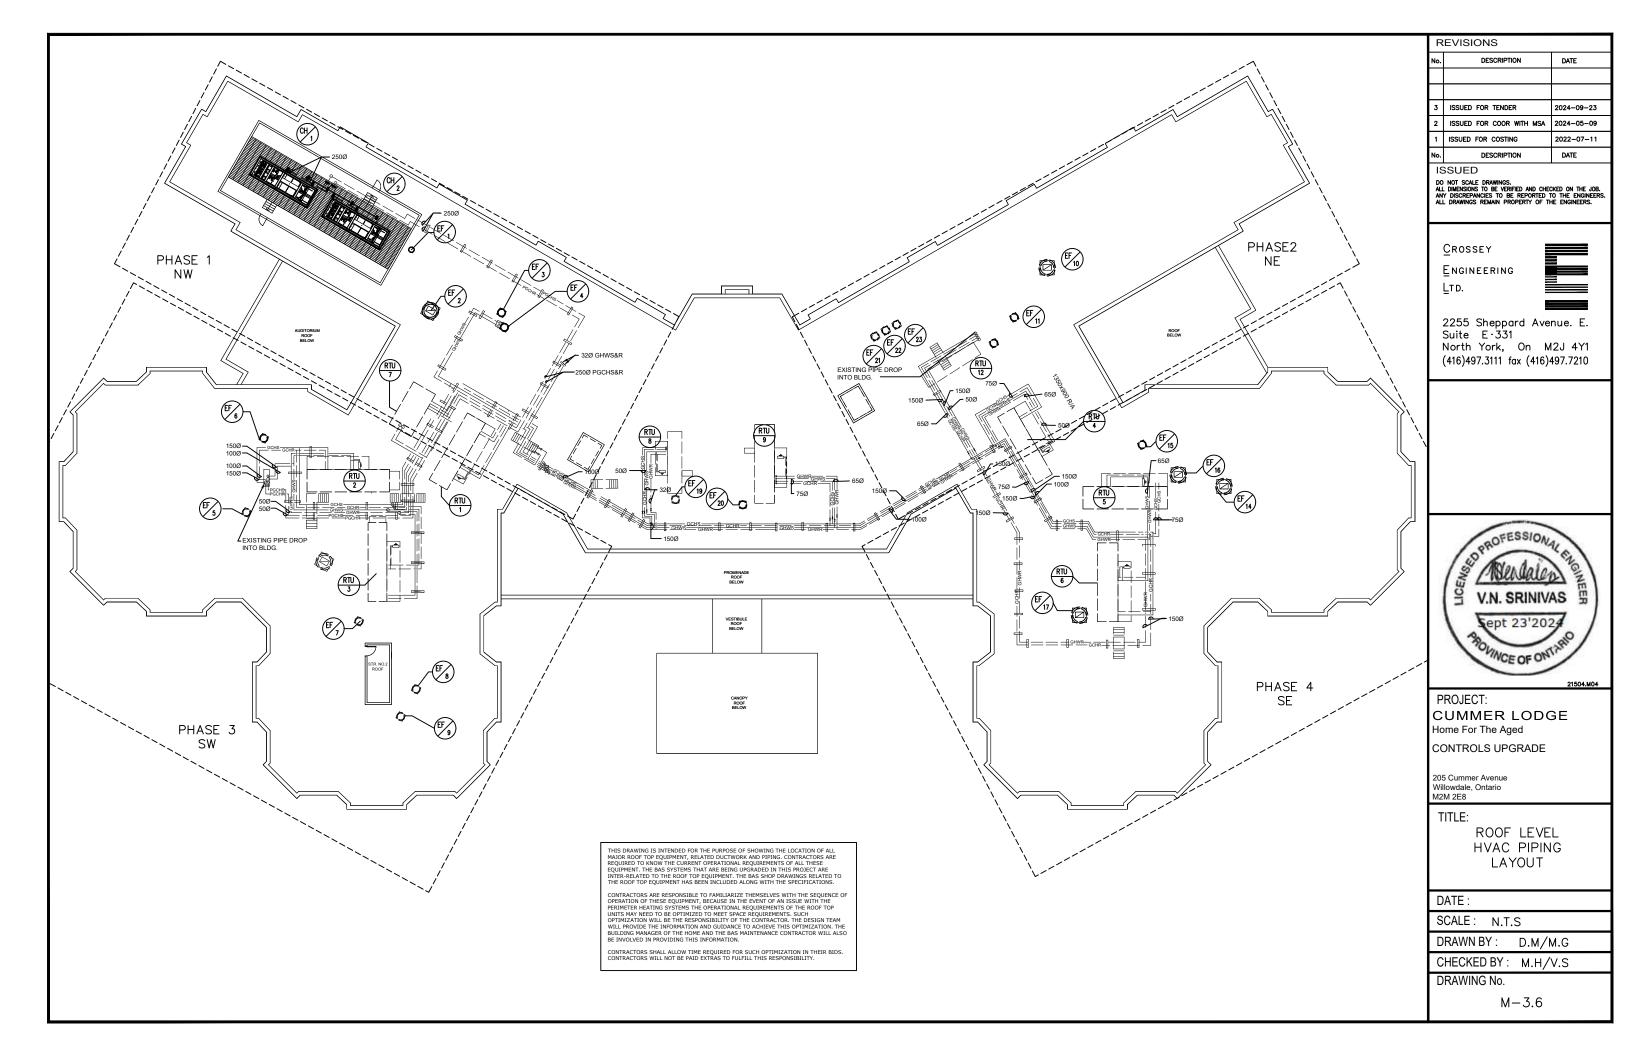

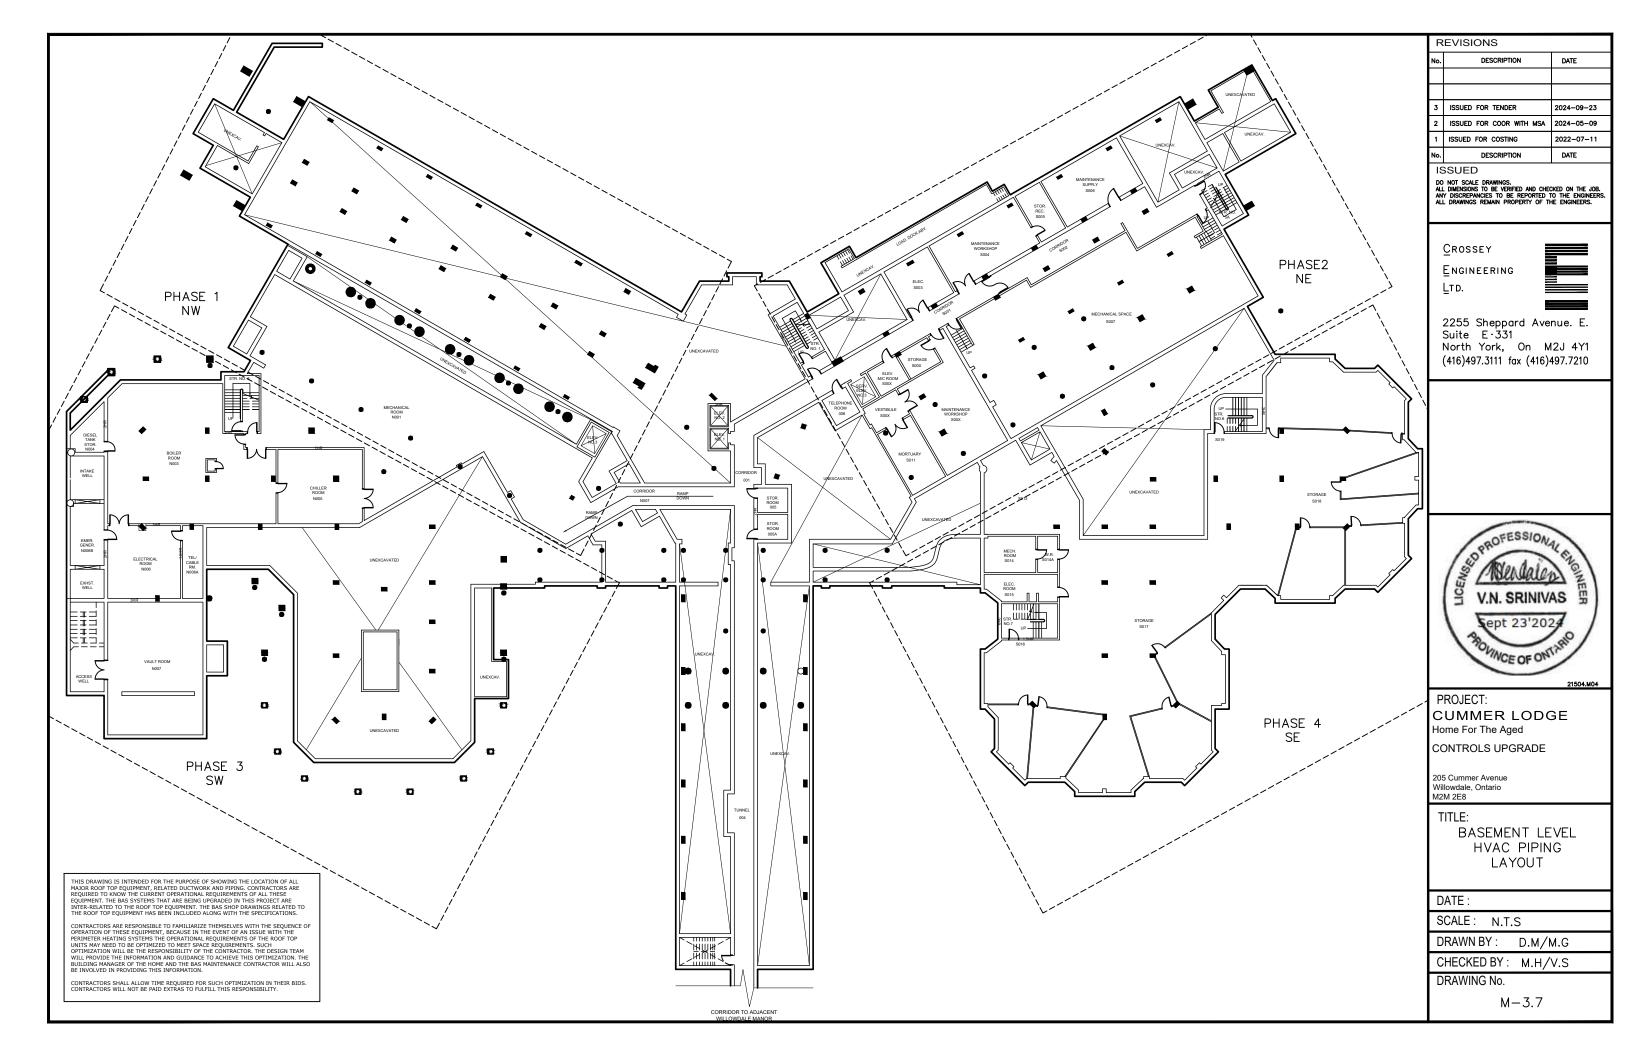

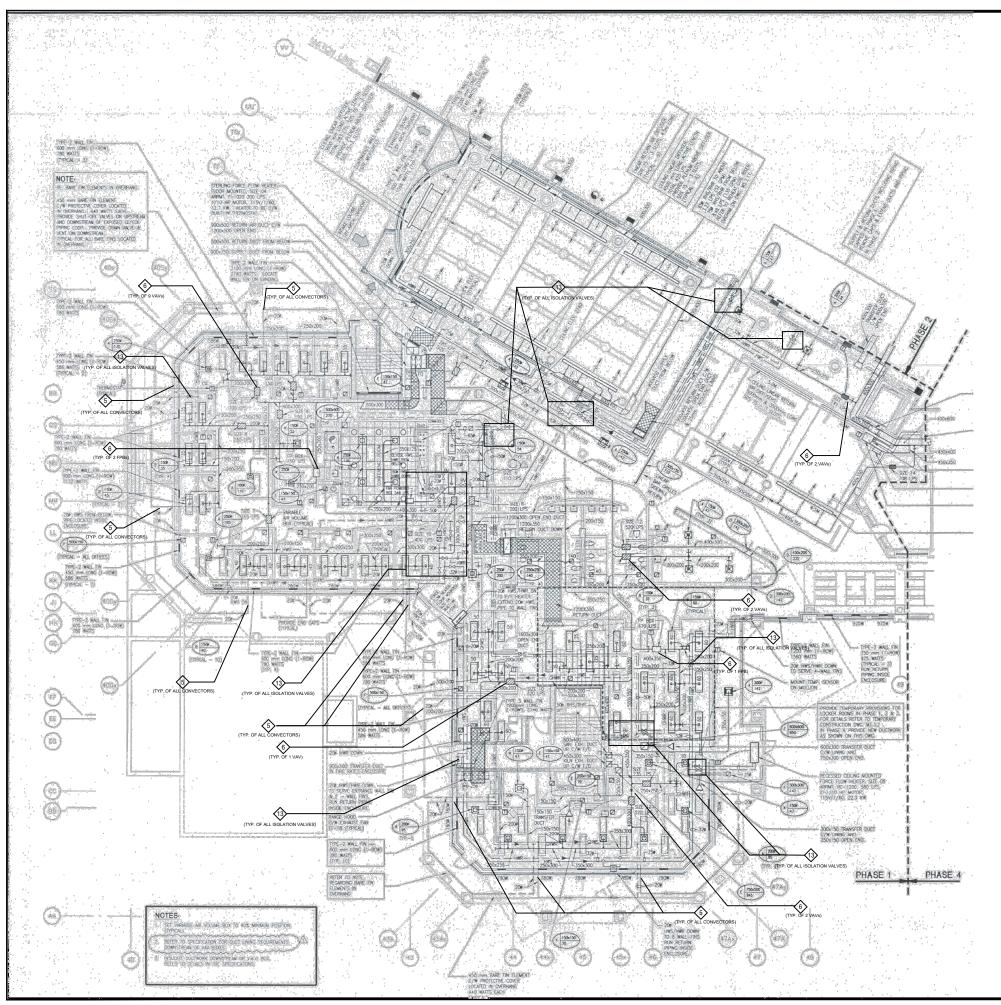

<u>GENERAL NOTES:</u> (APPLICABLE TO DWGS. FROM 4.1.1 TO 4.3.5)

- . THESE ARCHIVE DRAWINGS M-4.1.1 TO M-4.3.5 ARE INCLUDED FOR REFERENCE TO ASSIST THE CONTRACTOR WITH THE LOCATION OF CONVECTORS, WALL FIN RADIATORS, FORCED FLOW HEATERS, REHEAT COILS, VAV BOXES, DISTRIBUTION SYSTEM AND BASE BUILDING CONDITIONS.
- 2. FULL SCALE DRAWINGS CAN BE MADE AVAILABLE ON REQUEST.
- 3. FOR CONSTRUCTION NOTES, PLEASE REFER TO DWG M-3.1

LIST OF EQUIPMENT WITH CONTROL VALVES:			
FLOOR		WALL FIN CONVECTOR	REHEAT COILS
GROUND	NW	56	1
	NE	10	2
	SE	11	2
	SW	24	6
	CORE	15	3
LEVEL-2	NW	57	37
	NE	26	21
	SE	26	19
	SW	54	38
	CORE	0	0
LEVEL-3	NW	56	37
	NE	10	21
	SE	11	19
	SW	24	38
	CORE	15	0
LEVEL-4	NW	56	33
	NE	25	21
	SE	25	19
	SW	54	38
	CORE	15	0
TOTAL		570	341

THE QUANTITY INDICATED ABOVE IS BASED ON ARCHIVE DOCUMENTATION.THE QUANTITY HOWEVER, MAY NOT ACCURATELY REFLECT ACTUAL SITE CONDITIONS AS A RESULT OF RENOVATIONS THAT ARE NOT SHOWN IN THE ARCHIVE DWGS. CONTRACTOR SHALL ALLOW FOR A MIN. OF +10% QUANTITY OF VALVES IN THE TENDER PRICE.

- 1. CONTRACTOR SHALL SUBMIT A FINAL LIST OF VALVE QUANTITIES REPLACED AT THE END OF THE PROJECT. THE CONTRACTOR SHALL HAND OVER THE BALANCE OF THE VALVES TO THE CLIENT TO BE KEPT AS SPARES. THE CONTRACTOR SHALL PROVIDE CREDIT FOR THE LABOUR THAT WAS NOT UTILIZED FOR THE INSTALLATION OF THE SPARE VALVES. THE LABOUR RATES WILL BE AS IDENTIFIED IN THE BID-FORM.
- 2. IF THE ACTUAL QUANTITY OF VALVES IS MORE THAN THE 10%, THE CONTRACTOR WILL BE PAID FOR THE ADDITIONAL VALVES AS PER UNIT RATE IDENTIFIED IN THE BID-FORM.

# OF VAV BOXES	VAV	FPB
GRND LVL	-	-
LVL 2	-	-
LVL 3	-	-
LVL 4	-	-

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PROJECT: CUMMER LODGE Home For The Aged

CONTROLS UPGRADE

205 Cummer Avenue Willowdale, Ontario M2M 2E8

TITLE:

GROUND FLOOR NW POD **HVAC**


DATE:

SCALE: N.T.S

DRAWN BY: D.M/M.G

CHECKED BY: M.H/V.S

DRAWING No.

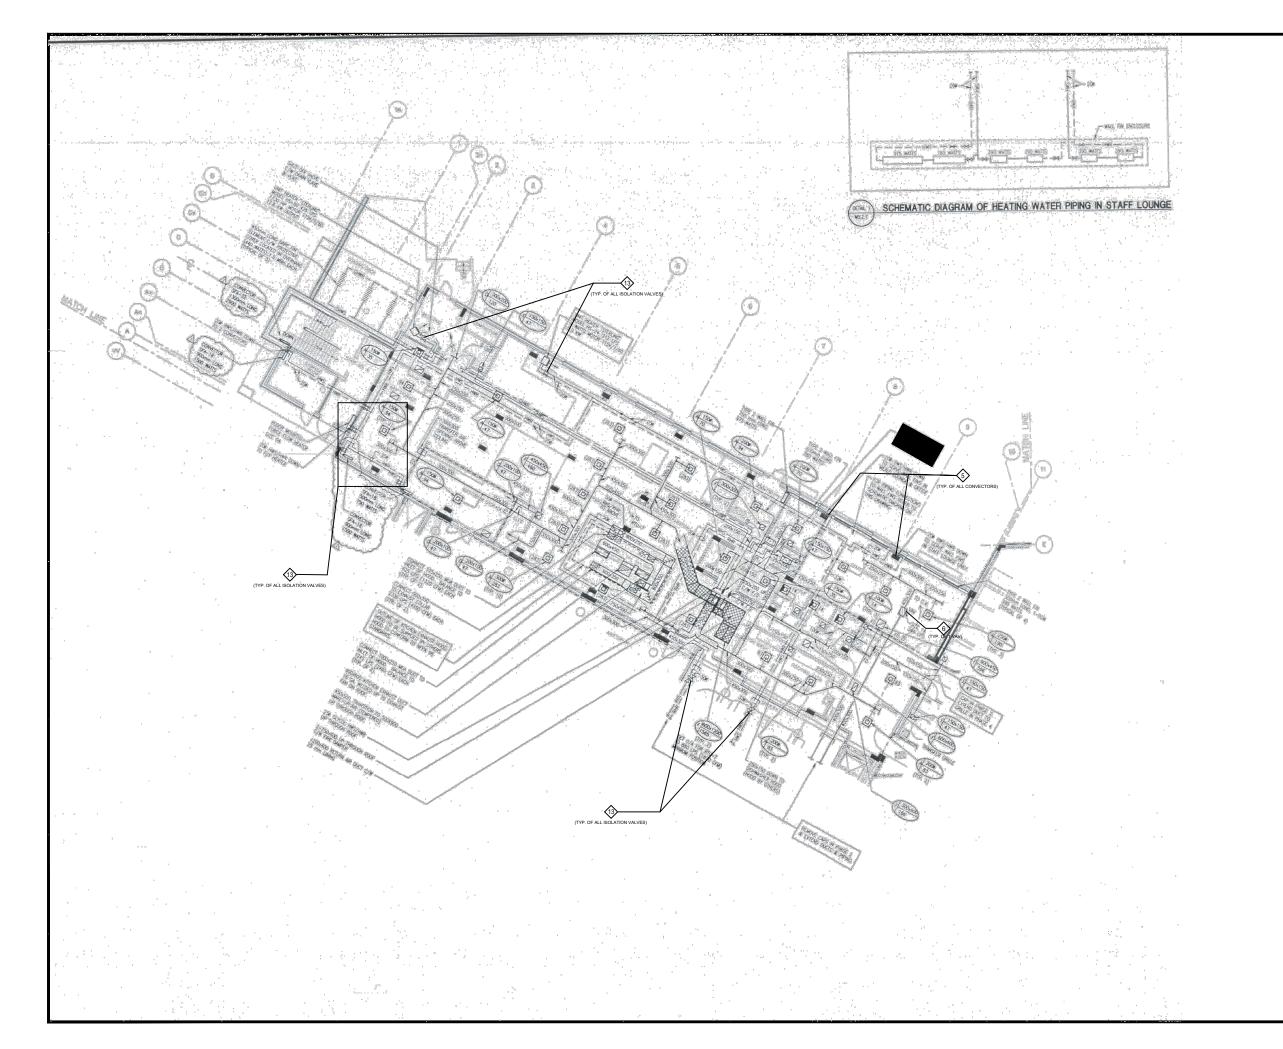

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PROJECT:

CUMMER LODGE

Home For The Aged

CONTROLS UPGRADE

205 Cummer Avenue Willowdale, Ontario M2M 2E8

TITLE:

GROUND FLOOR NE WING HVAC

DATE:

SCALE: N.T.S

DRAWN BY: D.M/M.G

CHECKED BY: M.H/V.S

DRAWING No.



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PROJECT:

CUMMER LODGE Home For The Aged

CONTROLS UPGRADE

205 Cummer Avenue Willowdale, Ontario M2M 2E8

TITLE:

GROUND FLOOR SE WING HVAC


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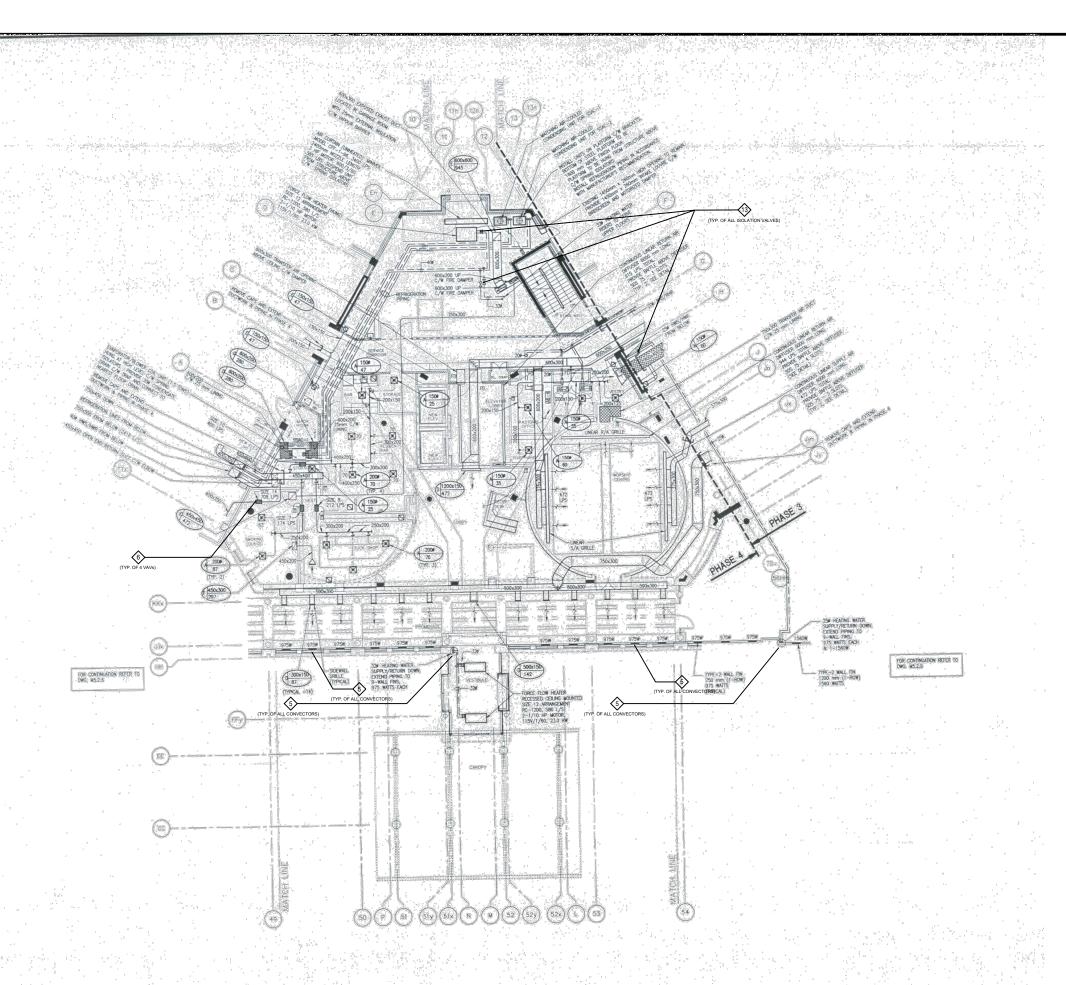
SCALE: N.T.S

DRAWN BY: D.M/M.G

CHECKED BY: M.H/V.S

DRAWING No.



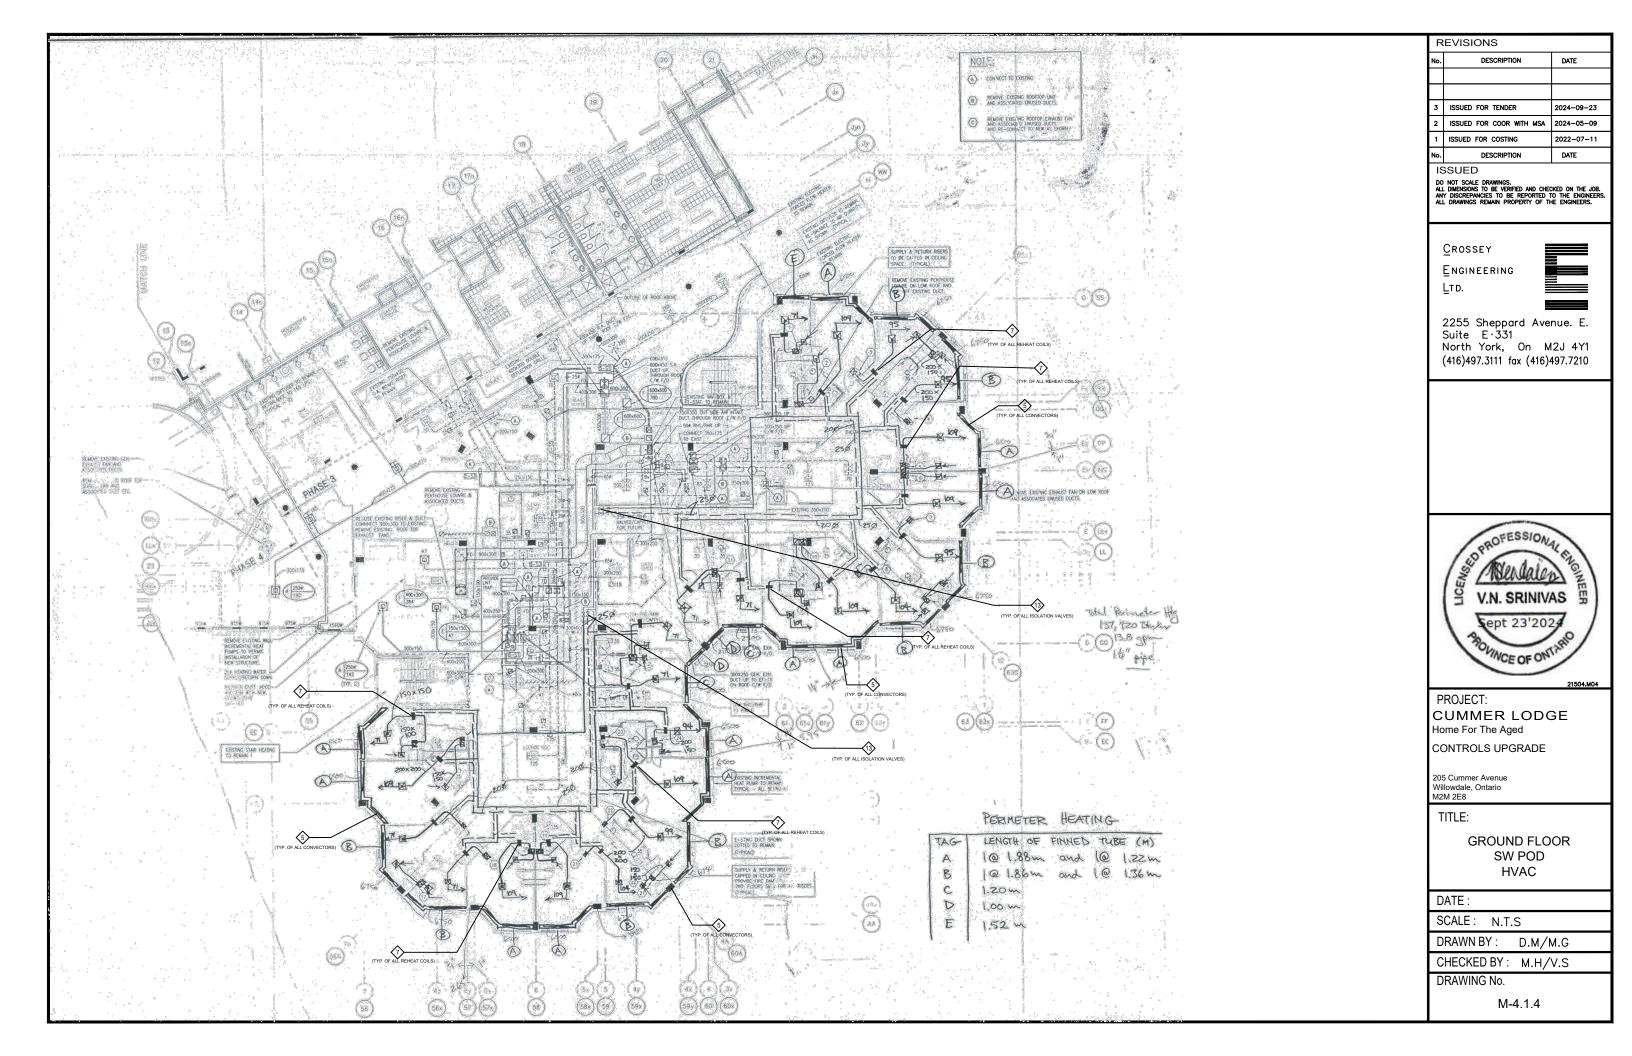

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CROSSEY

ENGINEERING L⊤D.



2255 Sheppard Avenue. E. Suite E·331 North York, On M2J 4Y1 (416)497.3111 fax (416)497.7210



PROJECT:

CUMMER LODGE

Home For The Aged

CONTROLS UPGRADE

205 Cummer Avenue Willowdale, Ontario M2M 2E8

TITLE:

GROUND FLOOR CORE HVAC


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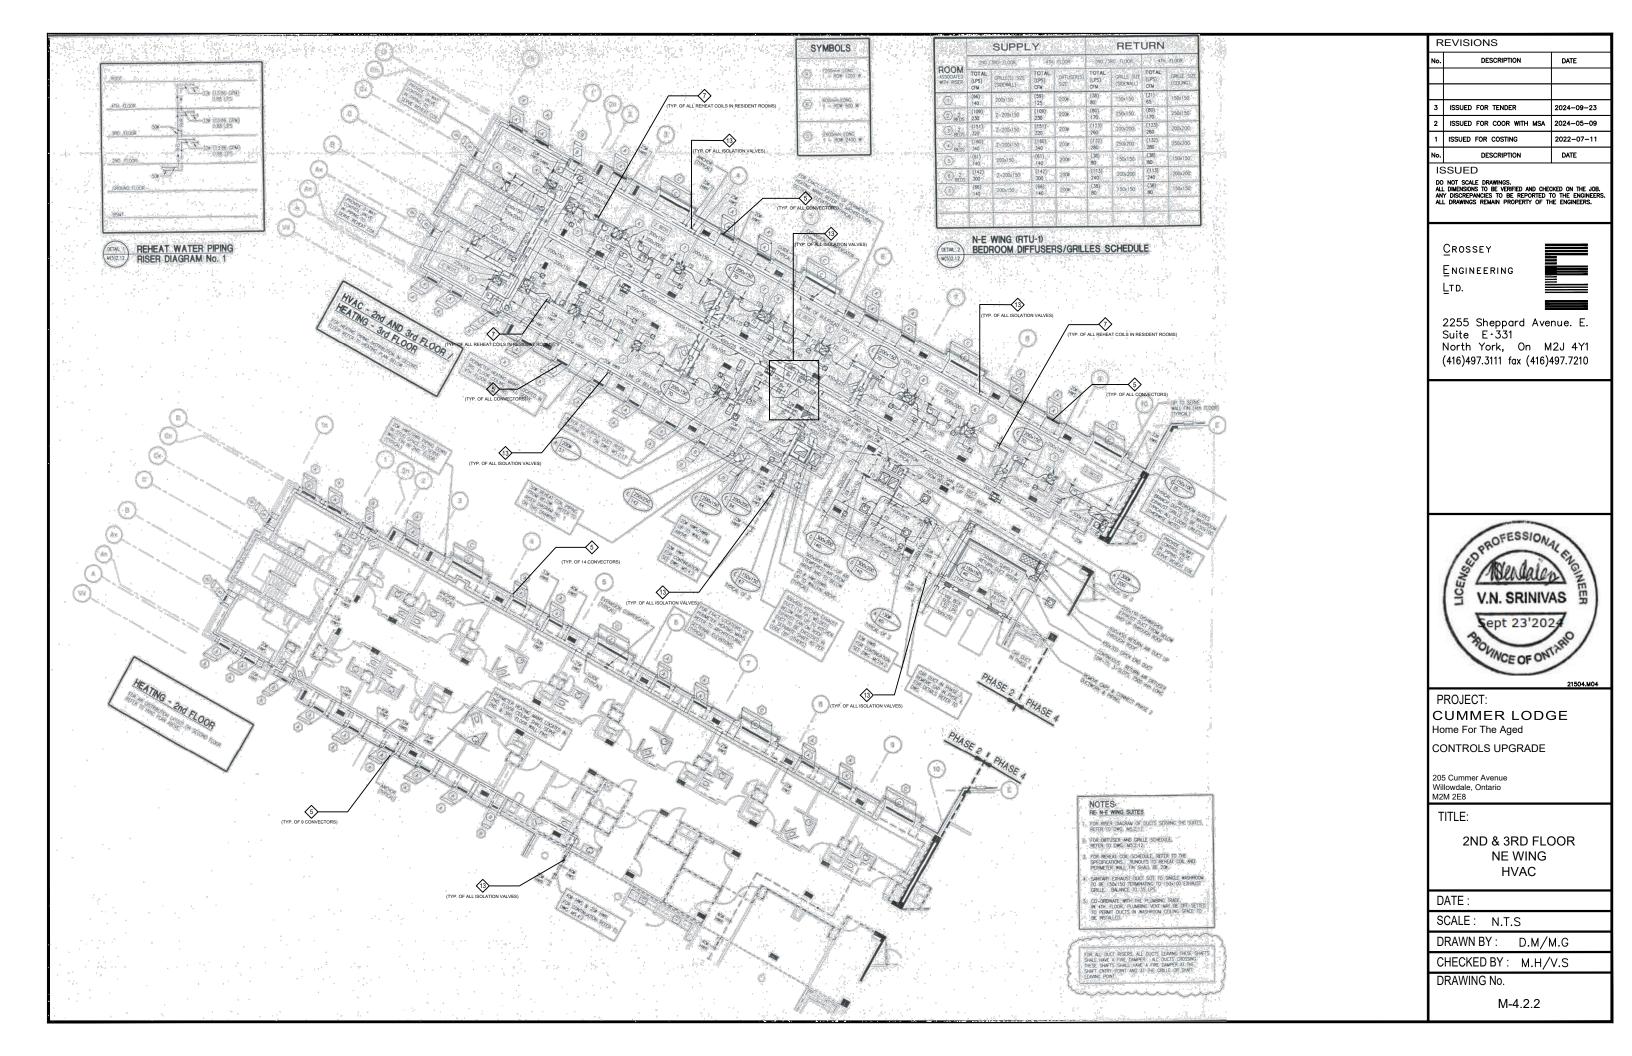
SCALE: N.T.S


DRAWN BY: D.M/M.G

CHECKED BY: M.H/V.S

DRAWING No.



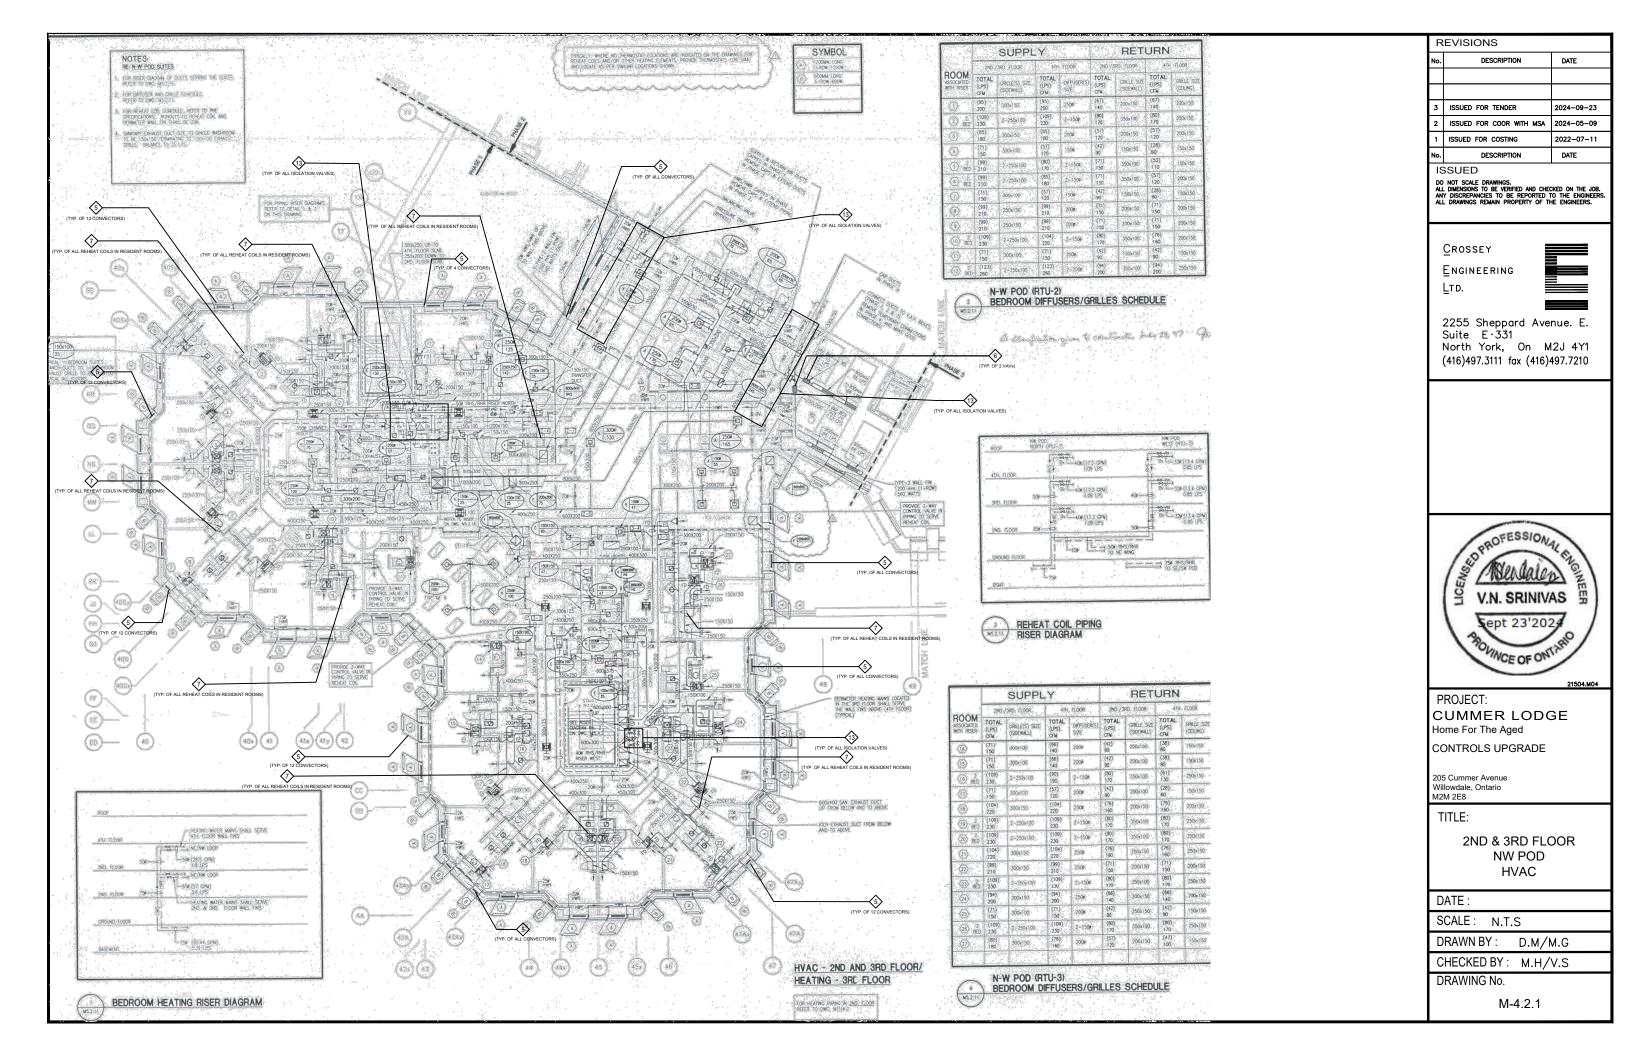

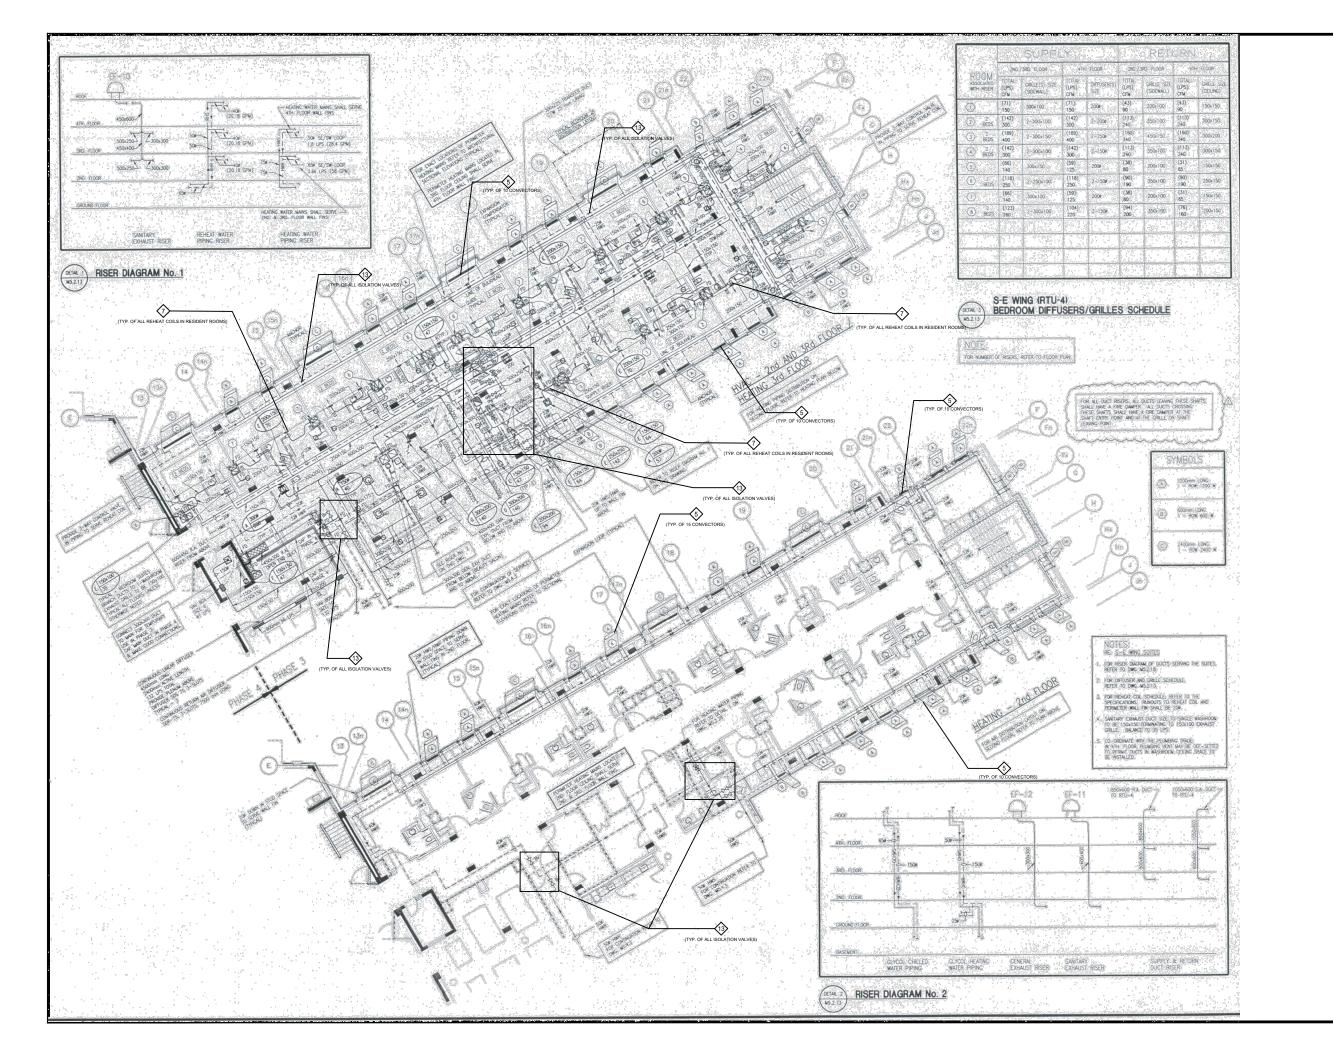

REVISIONS DATE 2024-09-23 ISSUED FOR TENDER 2024-05-09 ISSUED FOR COSTING 2022-07-11 DATE

ISSUED

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PROJECT:

CUMMER LODGE

Home For The Aged

CONTROLS UPGRADE

205 Cummer Avenue Willowdale, Ontario M2M 2E8

TITLE:

2ND & 3RD FLOOR SE WING HVAC

DATE:


SCALE: N.T.S

DRAWN BY: D.M/M.G

CHECKED BY: M.H/V.S

DRAWING No.

M-4.2.3

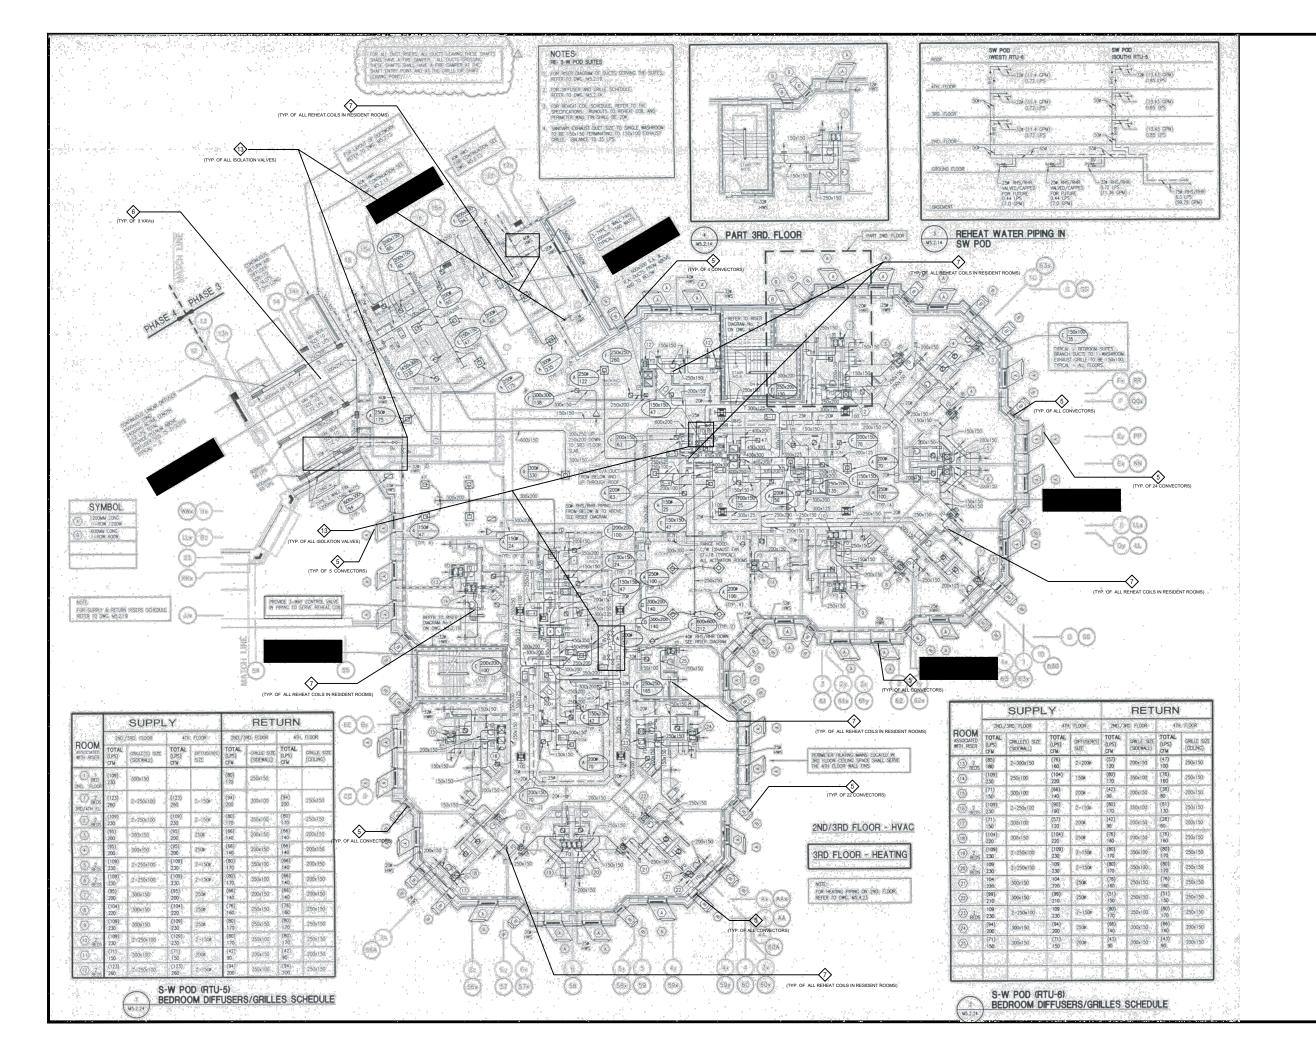

R	EVISIONS	
No.	DESCRIPTION	DATE
3	ISSUED FOR TENDER	2024-09-23
2	ISSUED FOR COOR WITH MSA	2024-05-09
1	ISSUED FOR COSTING	2022-07-11
No.	DESCRIPTION	DATE

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PROJECT:

CUMMER LODGE

Home For The Aged
CONTROLS UPGRADE

205 Cummer Avenue

Willowdale, Ontario M2M 2E8

TITLE:

2ND & 3RD FLOOR SW POD HVAC

DATE:


SCALE: N.T.S

DRAWN BY: D.M/M.G

CHECKED BY: M.H/V.S

DRAWING No.

M-4.2.4

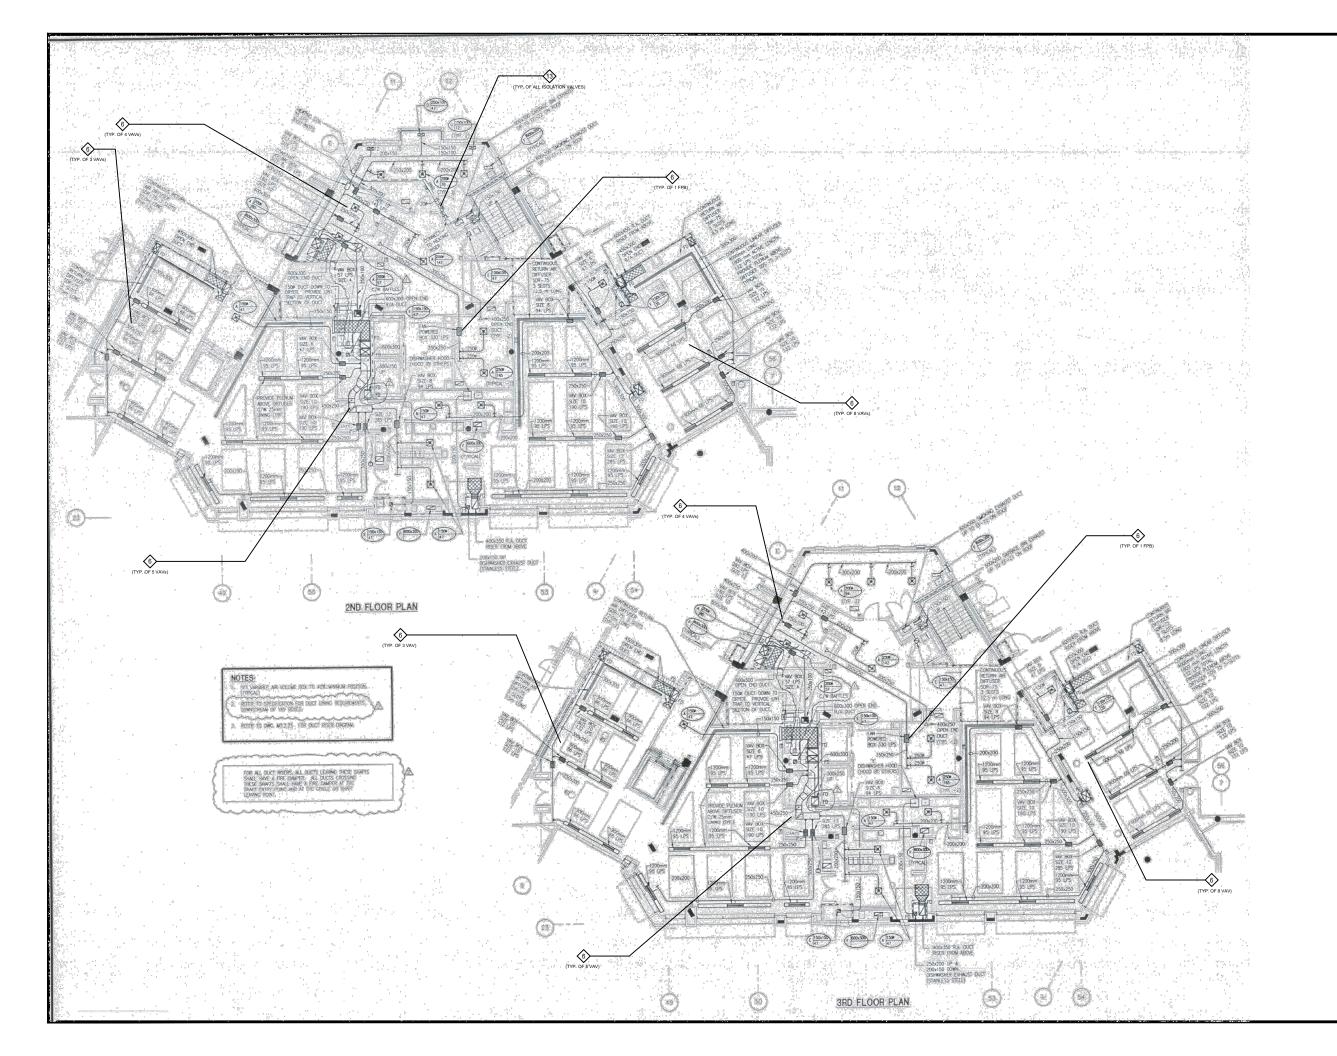

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PROJECT:

CUMMER LODGE

Home For The Aged

CONTROLS UPGRADE

205 Cummer Avenue Willowdale, Ontario M2M 2E8

TITLE:

2ND & 3RD FLOOR CORE HVAC

DATE:


SCALE: N.T.S

DRAWN BY: D.M/M.G

CHECKED BY: M.H/V.S

DRAWING No.

M-4.2.5

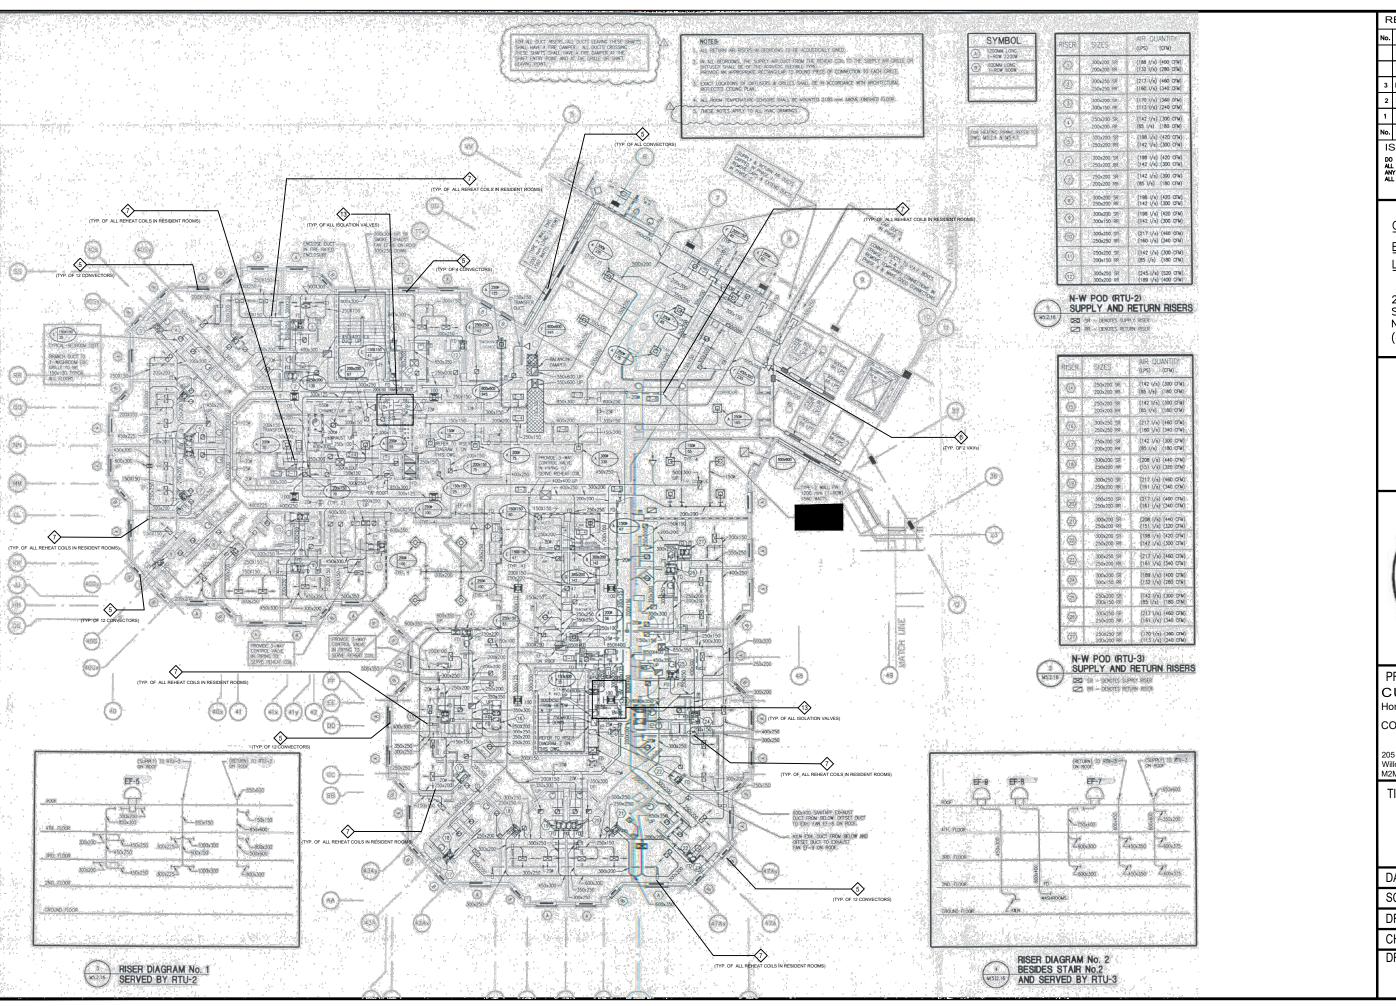

R	REVISIONS		
No.	DESCRIPTION	DATE	
3	ISSUED FOR TENDER	2024-09-23	
2	ISSUED FOR COOR WITH MSA	2024-05-09	
1	ISSUED FOR COSTING	2022-07-11	
No	DESCRIPTION	DATE	

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PROJECT:

CUMMER LODGE

Home For The Aged

CONTROLS UPGRADE

205 Cummer Avenue Willowdale, Ontario M2M 2E8

TITLE:

4TH FLOOR NW POD HVAC


DATE:

SCALE: N.T.S

DRAWN BY: D.M/M.G

CHECKED BY: M.H/V.S

DRAWING No.

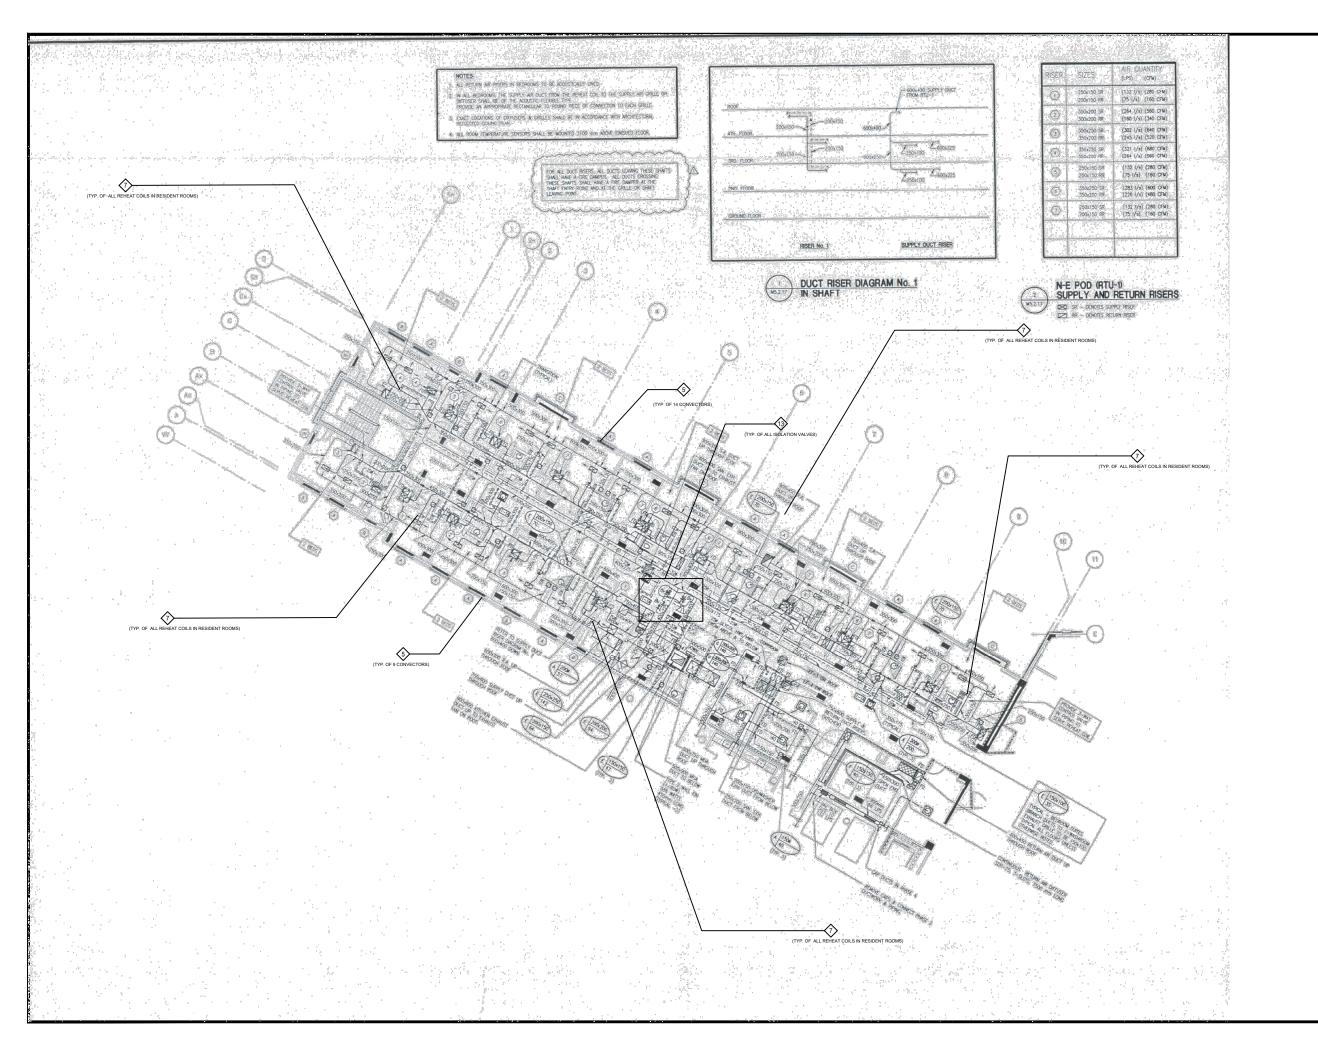

F	REVISIONS	
No	. DESCRIPTION	DATE
3	ISSUED FOR TENDER	2024-09-23
2	ISSUED FOR COOR WITH MSA	2024-05-09
1	ISSUED FOR COSTING	2022-07-11
No	. DESCRIPTION	DATE

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PROJECT:

CUMMER LODGE

Home For The Aged

CONTROLS UPGRADE 205 Cummer Avenue Willowdale, Ontario M2M 2E8

TITLE:

4TH FLOOR **NE WING** HVAC


DATE:

SCALE: N.T.S

DRAWN BY: D.M/M.G

CHECKED BY: M.H/V.S

DRAWING No.

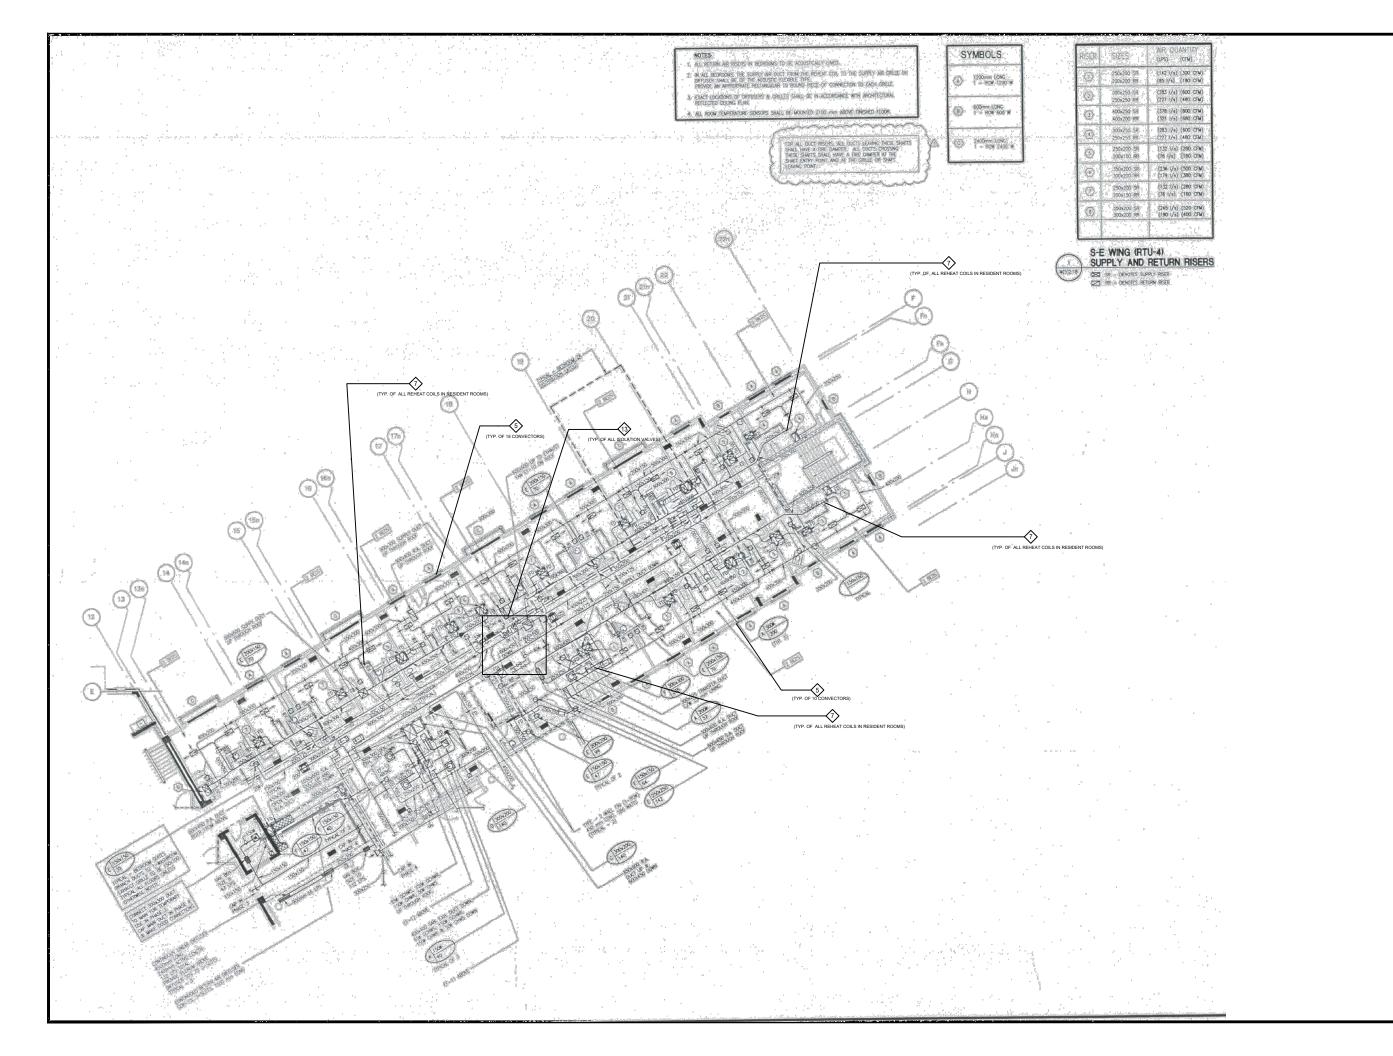

REVISIONS		
No.	DESCRIPTION	DATE
3	ISSUED FOR TENDER	2024-09-23
2	ISSUED FOR COOR WITH MSA	2024-05-09
1	ISSUED FOR COSTING	2022-07-11
No	DESCRIPTION	DATE

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PROJECT:

CUMMER LODGE

Home For The Aged

CONTROLS UPGRADE

205 Cummer Avenue Willowdale, Ontario M2M 2E8

TITLE:

4TH FLOOR SE WING HVAC


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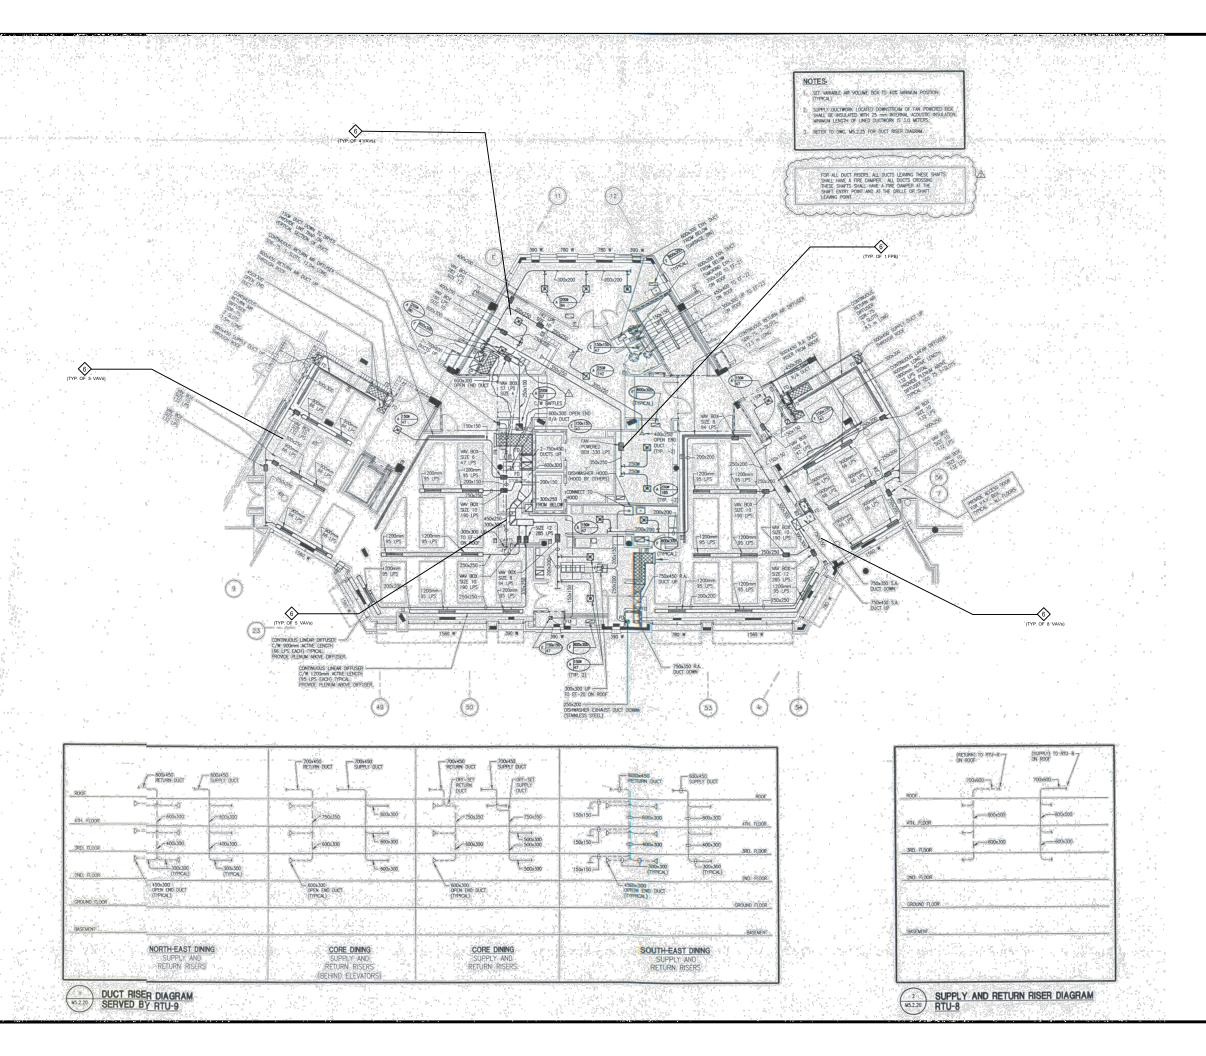
SCALE: N.T.S

DRAWN BY: D.M/M.G

CHECKED BY: M.H/V.S

DRAWING No.



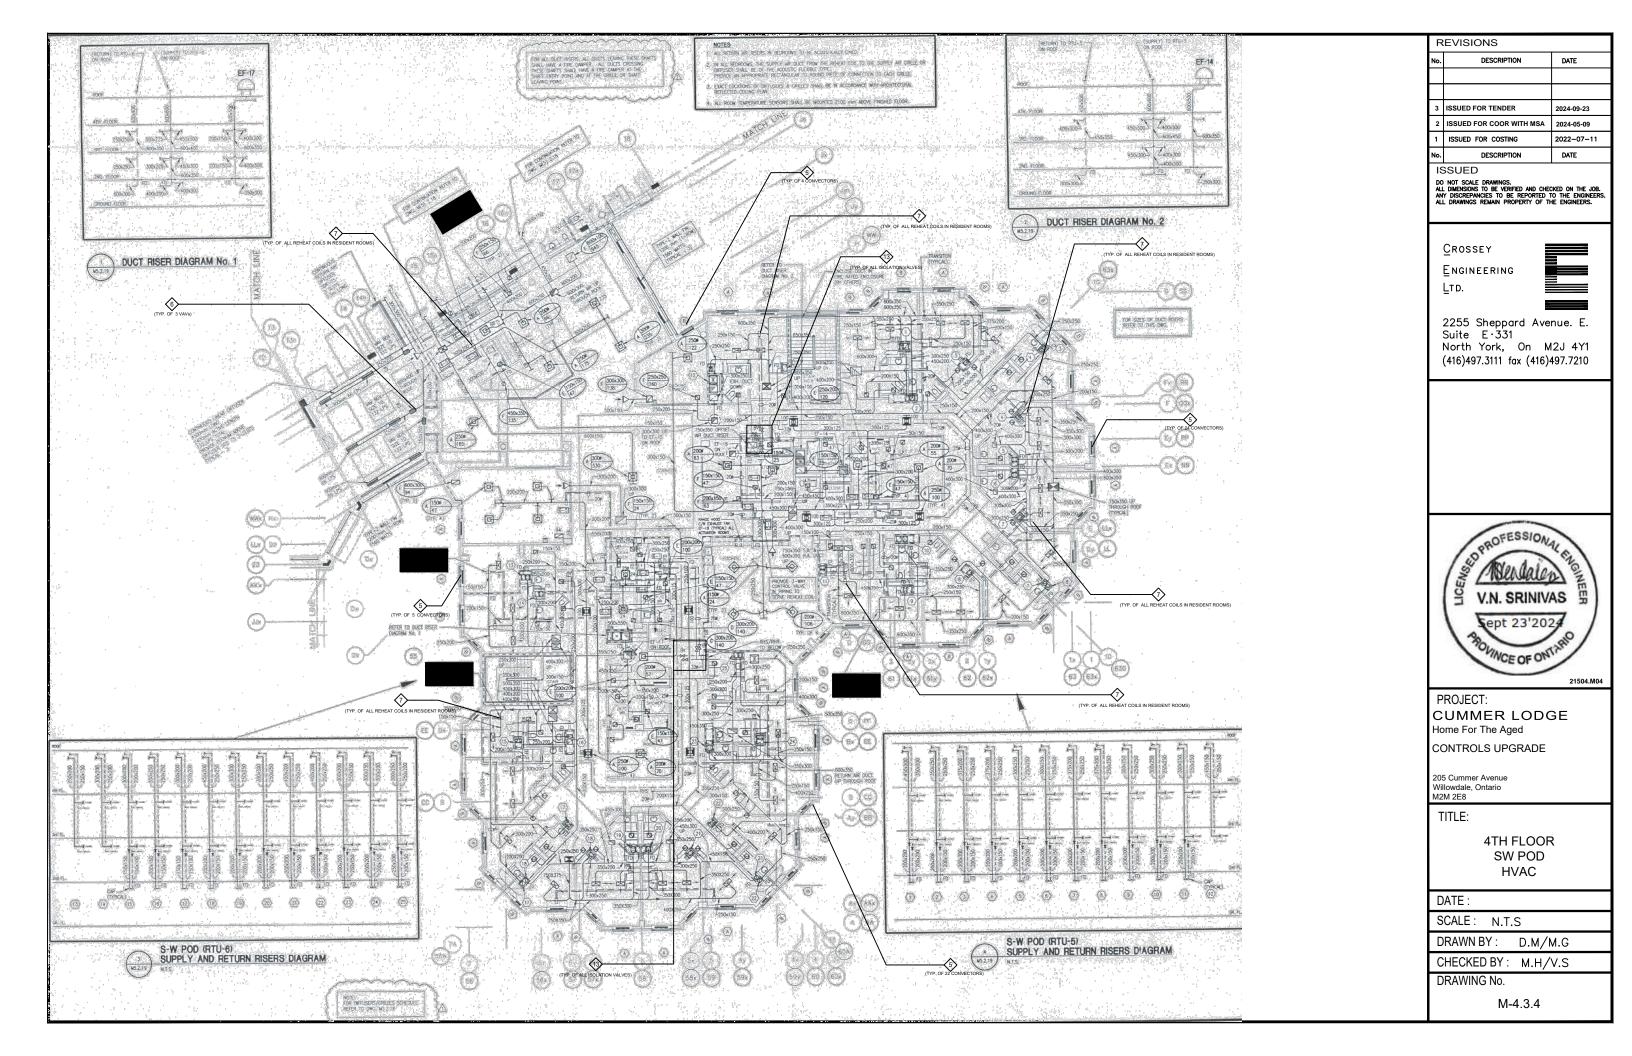

REVISIONS DATE ISSUED FOR TENDER 2024-09-23 2024-05-09 2022-07-11 ISSUED FOR COSTING DATE

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PROJECT:

CUMMER LODGE

Home For The Aged

CONTROLS UPGRADE 205 Cummer Avenue

Willowdale, Ontario M2M 2E8

TITLE:

4TH FLOOR CORE HVAC


DATE:


SCALE: N.T.S

DRAWN BY: D.M/M.G

CHECKED BY: M.H/V.S

DRAWING No.

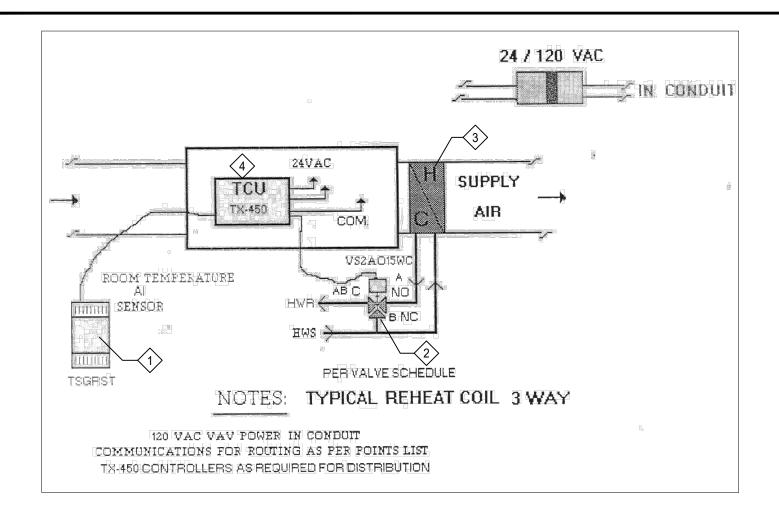

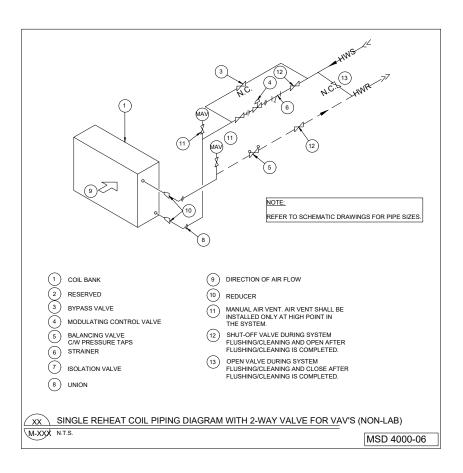

CONSTRUCTION NOTES:

REPLACE ROOM TEMPERATURE SENSOR AS FOLLOWS:

1. REPLACE ALL SENSORS INCLUDING CONNECTED WIRING BETWEEN SENSOR AND TERMINAL DEVICES.

- $\langle 2
 angle$ REPLACE REHEAT CONTROL AS FOLLOWS:
 - 1. ALL NEW CONTROL VALVES SHALL BE 2-WAY MODULATING TYPE VALVE.
 - 2. PROVIDE PIPING AND VALVING AS PER STANDARD DETAIL IN THIS DRAWING.
- CLEAN ALL REHEAT COILS TO ENSURE THAT AIR FLOW FROM THE VAV BOXES IS AT DESIGN SET POINT.
- (4) REPLACE ALL VAV c/w NEW VAV BOX AND CONTROLS. CONNECT NEW SPACE TEMP. SENSOR TO VAV BOX CONTROLLER . PROVIDE NEW BAS NETWORK CABLING BETWEEN VAV BOX TCU & BAS FLOOR CONTROLLER. PROVIDE AN ITEMIZED PRICE FOR REPLACING ALL VAV BOXES. ALL TERMINAL BOXES (VAV AND FPB) SHALL BE INTEGRATED WITH FIN SERVER SO THAT THEY COMMUNICATED WITH CoT FIN SERVER THROUGH BUILDING CONTROLLERS.

GENERAL NOTES

1. UPDATE EX.BAS GRAPHICS TO ADDRESS ALL NEW DEVICES BEING INSTALLED AND ALL EX.DEVICES BEING REPLACED

R	EVISIONS	
No.	DESCRIPTION	DATE
3	ISSUED FOR TENDER	2024-09-23
2	ISSUED FOR COOR WITH MSA	2024-05-09
1	ISSUED FOR COSTING	2022-07-11
No.	DESCRIPTION	DATE

ISSUED

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PROJECT:

CUMMER LODGE Home For The Aged

CONTROLS UPGRADE

205 Cummer Avenue Willowdale, Ontario M2M 2E8

TITLE:

TYPICAL REHEAT COIL 3-WAY

DATE:

SCALE: N.T.S


DRAWN BY: D.M/M.G


CHECKED BY: M.H/V.S

DRAWING No.

TYPICAL UNIT HEATER

TYPICAL CABINET HEATER

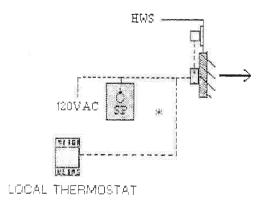

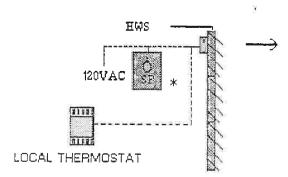

* SECTION: 15312 & 15315 C | W & INSTALLED ISP SPEED SW THERMOSTAT

GENERAL NOTES

- 1. RETAIN EXISTING CONTROL VALVES AND LOCAL THERMOSTATS FOR UNIT HEATERS AND CABINET HEATERS.
- 2. PROVIDE FOR NEW GRAPHICS ON NEW BAS SYSTEM.
- 3. UPDATE EX.BAS GRAPHICS TO ADDRESS ALL NEW DEVICES BEING INSTALLED AND ALL EX.DEVICES BEING REPLACED

REVISIONS			
No.	DESCRIPTION	DATE	
3	ISSUED FOR TENDER	2024-09-23	
-	ISSUED FOR TENDER ISSUED FOR COOR WITH MSA	2024-09-23	
-			

ISSUED

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PROJECT:

CUMMER LODGE

Home For The Aged

CONTROLS UPGRADE

205 Cummer Avenue Willowdale, Ontario M2M 2E8

TITLE:

TYPICAL HEATERS


DATE:

SCALE: N.T.S

DRAWN BY: D.M/M.G

CHECKED BY: M.H/V.S

DRAWING No.

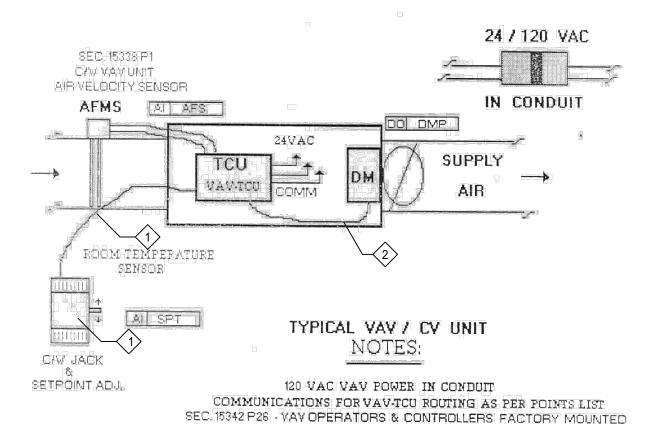

CONSTRUCTION NOTES:

REPLACE ALL ROOM TEMPERATURE SENSORS c/w WIRING BETWEEN SENSOR AND TCU.

REPLACE ALL VAV BOXES c/w NEW VAV BOX AND CONTROLS. CONNECT NEW SPACE TEMP. SENSOR TO VAV BOX CONTROLLER. PROVIDE NEW BAS NETWORK CABLING BETWEEN VAV BOX TCU & BAS FLOOR CONTROLLER. PROVIDE AN ITEMIZED PRICE FOR REPLACING ALL VAV BOXES.

3 UPDATE EX.BAS GRAPHICS TO ADDRESS ALL NEW DEVICES BEING INSTALLED AND ALL EX.DEVICES BEING REPLACED. ALL TERMINAL BOXES (VAV AND FPB) SHALL BE INTEGRATED WITH FIN SERVER SO THAT THEY COMMUNICATED WITH CoT FIN SERVER THROUGH BUILDING CONTROLLERS.

GENERAL NOTES

1. UPDATE EX.BAS GRAPHICS TO ADDRESS ALL NEW DEVICES BEING INSTALLED AND ALL EX.DEVICES BEING REPLACED

# OF VAV BOXES	VAV	FPB
N-W POD GRND LVL	16	3
N-E POD GRND LVL	1	-
S-E POD GRND LVL	1	-
S-W POD GRND LVL	-	-
CORE GRND LVL	4	-

THE QUANTITY INDICATED ABOVE IS
BASED ON ARCHIVE DRAWINGS.
CONTRACTORS SHALL PROVIDE UNIT
PRICE TO PROVIDE A NEW VAV BOX AS
PER THIS DETAIL. IN THE EVENT
ADDITIONAL VAV BOXES NEED TO BE
REPLACED, THE UNIT PRICE WILL BE USED
TO DETERMINE THE EXTRA COST.

R	EVISIONS	
No.	DESCRIPTION	DATE
3	ISSUED FOR TENDER	2024-09-23
2	ISSUED FOR COOR WITH MSA	2024-05-09
1	ISSUED FOR COSTING	2022-07-11
Ma	DECODIDATION	DATE

ISSUED

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PROJECT:
CUMMER LODGE

Home For The Aged

CONTROLS UPGRADE

205 Cummer Avenue Willowdale, Ontario M2M 2E8

TITLE:

TYPICAL VAV/FPB UNIT


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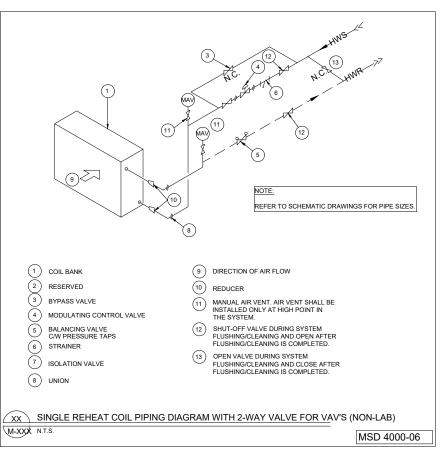
SCALE: N.T.S

DRAWN BY: D.M/M.G

CHECKED BY: M.H/V.S

DRAWING No.



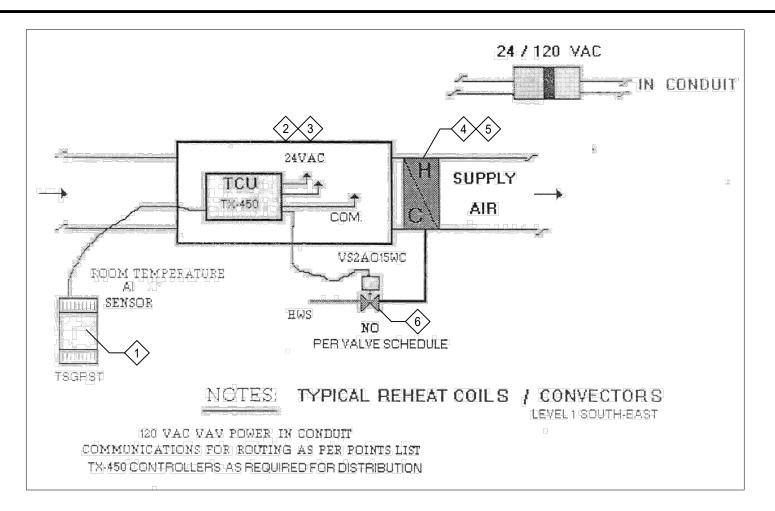

CONSTRUCTION NOTES:

REPLACE ALL ROOM TEMPERATURE SENSORS c/w WIRING BETWEEN SENSOR AND TCU.

REPLACE ALL VAV BOXc/w NEW VAV BOX AND CONTROLS. CONNECT NEW SPACE TEMP. SENSOR TO VAV BOX CONTROLLER. PROVIDE NEW BAS NETWORK CABLING BETWEEN VAV BOX TCU & BAS FLOOR CONTROLLER. PROVIDE AN ITEMIZED PRICE FOR REPLACING ALL VAV BOXES.

(3) RESERVED.

4 REPLACE ALL REHEAT COILS. DISCONNECT FROM EX. DUCTWORK & RECONNECT TO NEW.

(5) RESERVED.

6 REPLACE EX. REHEAT COIL CONTROL VALVE c/w WIRING BETWEEN CONTROL VALVE AND TCU.

GENERAL NOTES

 UPDATE EX.BAS GRAPHICS TO ADDRESS ALL NEW DEVICES BEING INSTALLED AND ALL EX.DEVICES BEING REPLACED

# OF RH COILS	RH
N-W POD GRND LVL	1
N-E POD GRND LVL	2
S-E POD GRND LVL	2
S-W POD GRND LVL	6
CORE GRND LVL	3
·	

THE QUANTITY INDICATED ABOVE IS BASED ON ARCHIVE DRAWINGS. CONTRACTORS SHALL PROVIDE UNIT PRICE TO PROVIDE A NEW VAV BOX AND REHEAT COIL AS PER THIS DETAIL. IN THE EVENT ADDITIONAL VAV BOXES NEED TO BE REPLACED, THE UNIT PRICE WILL BE USED TO DETERMINE THE EXTRA COST.

R	EVISIONS	
No.	DESCRIPTION	DATE
3	ISSUED FOR TENDER	2024-09-23
2	ISSUED FOR COOR WITH MSA	2024-05-09
1	ISSUED FOR COSTING	2022-07-11
No	DESCRIPTION	DATE

ISSUED


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PROJECT:

CUMMER LODGE
Home For The Aged

CONTROLS UPGRADE

205 Cummer Avenue Willowdale, Ontario M2M 2E8

TITLE:

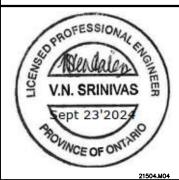TYPICAL REHEAT COILS


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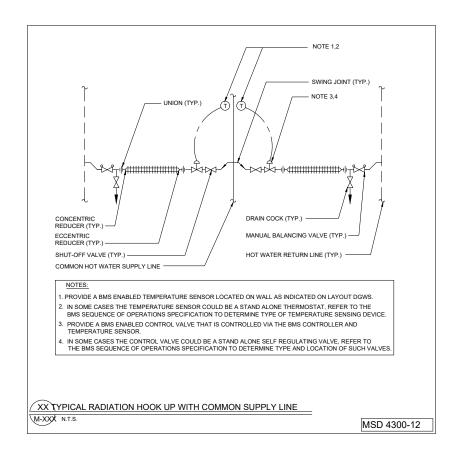
SCALE: N.T.S

DRAWN BY: D.M/M.G

CHECKED BY: M.H/V.S

DRAWING No.




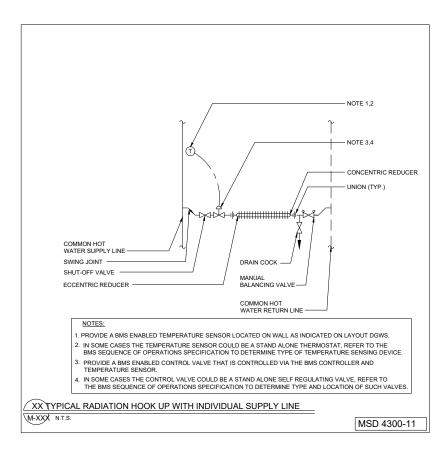

GENERAL NOTES:

1. THE STANDARD DETAILS INDICATED IN THIS DRAWING SHOW DIFFERENT COMBINATION AND ARRANGEMENT OF PERIMETER RADIATORS.

2. PROVIDE NEW VALUING ARRANGEMENT FOR ALL PERIMETER RADIATORS AS PER THE STANDARD DETAILS ON THIS DRAWING.

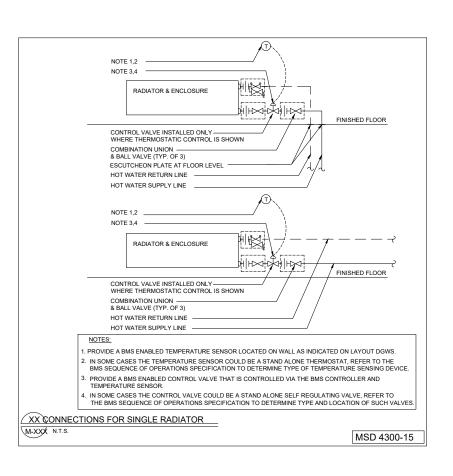

ISSUED

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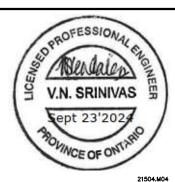
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PROJECT:

CUMMER LODGE

Home For The Aged

CONTROLS UPGRADE

205 Cummer Avenue Willowdale, Ontario M2M 2E8

TITLE:

TYPICAL RADIATOR

DATE:

SCALE: N.T.S

DRAWN BY: D.M/M.G

CHECKED BY: M.H/V.S

DRAWING No.

