



LIST OF DRAWINGS :			3.0 RENOVATION NOTES :	8.0 TEMPORARY WORK :
COVER PAGE AND GENERAL NOTES ELEC	TRICAL DRAWING LIST	16. IT IS THE CONTRACTOR'S RESPONSIBILITY TO ENSURE THAT ALL ENTRANCE AND EXIT WAYS TO THE BUILDING, (INCLUDING STORAGE ROOMS, MECHANICAL ROOMS, STAIRWELLS, ETC.) REMAIN OPEN AT ALL TIMES (INCLUDING GARAGE RAMPS).	1. THE CONTRACT DOCUMENTS ARE BASED ON THE ASSUMED AS-BUILT DIMENSIONS FOR THE EXISTING BUILDING STRUCTURE AND ASSUMPTIONS IN ACCORDANCE WITH DETAILING AND PLACING PRACTICES. THESE ASSUMPTIONS MAY VARY FROM THE ON-SITE CONDITIONS. THE CONTRACTOR SHALL IMMEDIATELY INFORM THE CONSULTANTS OF	1. THE CONTRACTOR SHALL DESIGN, PROVIDE, ERECT, MAINTAIN, REMOVE AND ASSUME FULL AND SOLE RESPONSIBILITY FOR ALL TEMPORARY WORK REQUIRED FOR THE SAFE AND COMPLETE EXECUTION OF THE WORK.
S1.1SITE PLANE0.1S2.1PODIUM DECK DEMOLITION PLANE0.0	KEY PLANS AND SCHEDULE	17. THIS SET OF DRAWINGS ALONG WITH THE SPECIFICATIONS FORM THE CONTRACT DOCUMENTS AND MUST BE READ AND INTERPRETED IN CONJUNCTION WITH ONE ANOTHER.	ANY ACTUAL VARIATIONS FROM THE ASSUMED CONDITIONS. 2. ENSURE THAT ALL NECESSARY DIMENSIONS ARE TAKEN AND ALL TRADES ARE COORDINATED FOR THE PROPER EXECUTION OF THE WORK. THE CONTRACTOR SHALL ASSUME COMPLETE RESPONSIBILITY FOR THE ACCURACY AND	2. IN THE EXECUTION OF THE TEMPORARY WORK AND FOR THE DURATION OF THE CONTRACT, THE CONTRACTOR SHALL MAKE ADEQUATE PROVISION FOR ALL LIKELY CONSTRUCTION LOADING AND PROVIDE SUFFICIENT BRACING AND PROPS TO KEEP THE WORK PLUMB, ALIGNED AND FREE FROM EXCESSIVE DEFLECTION.
S2.2 PODIUM DECK RESTORATION PLAN	LAYOUT	18. PROVIDE MEANS FOR PROTECTING OCCUPIED AREAS BELOW THE WORK FROM WATER AND MEMBRANE LEAKAGE BETWEEN THE REMOVAL AND REINSTALLATION OF THE WATERPROOFING SYSTEMS.	3. PRIOR TO FABRICATION OF ANY MEMBERS. THE CONTRACTOR SHALL ASSUME COMPLETE A SITE REVIEW OF CRITICAL	3. ACCESS OF HEAVY CONSTRUCTION EQUIPMENT AND ACCUMULATION OF CONSTRUCTION MATERIALS ON THE FLOORS ARE NOT PERMITTED, UNLESS SUCH HAVE BEEN CATERED FOR IN THE CONTRACTOR'S TEMPORARY WORK DESIGN TO THE SATISFACTION OF THE ENGINEER.
S2.3 BASEMENT REFLECTED CEILING E0.3 DEMOLITION AND RESTORATION PLAN S3.1 SECTIONS AND DETAILS	ELECTRICAL SFECTION	.1 THE CONTRACTOR IS TO SUBMIT THE METHOD OF PROTECTION TO BE USED TO THE CONSULTANT FOR REVIEW PRIOR TO REMOVAL OF EXISTING SYSTEMS.	"TIE-IN" DIMENSIONS AND CONFIRM ALL DIMENSIONS TO ENSURE PROPER FIT OF NEW WORK TO EXISTING. REPORT ANY DISCREPANCIES TO RJC PRIOR TO STARTING THE WORK.	4. COSTS OF ALL TEMPORARY WORK IS TO BE INCLUDED IN THE CONTRACT PRICE.
S3.2 SECTIONS AND DETAILS		19. CONCRETE WORK SHALL CONFORM TO THE LATEST EDITION OF CAN3-A23.1, A23.2, A23.3 AND DOCUMENTS REFERENCED THEREIN.	4.0 HOARDING AND PROTECTION NOTES :	5. SUBMIT SHOP DRAWINGS FOR ALL TEMPORARY WORK FOR REVIEW BEFORE FABRICATION COMMENCES. SHOP DRAWINGS SHALL BE SEALED BY A PROFESSIONAL ENGINEER LICENSED IN THE PROVINCE OF ONTARIO.
S3.3 SECTIONS AND DETAILS S3.4 SECTIONS AND DETAILS		20. ALL WORK IS TO BE IN ACCORDANCE WITH THE 2024 ONTARIO BUILDING CODE.	 THE CONTRACTOR IS TO INSTALL AND MAINTAIN MIN. 6'-0" HIGH CHAIN LINK FENCING OR (i.e "FAST-FENCE") AND DUST PROTECTION AROUND EACH PHASE OF THE EXTERIOR WORK AS OUTLINED IN SPECIFICATION SECTION 01 56 00 AND THESE DRAWINGS. 	9.0 SIGNAGE NOTES :
		2.0 GENERAL SCOPE OF WORK :	2. INSTALL FULL-HEIGHT DUST PROTECTION AROUND INTERIOR AREAS OF WORK DURING PERFORMANCE OF DUST	" \star " denotes construction sign location
1.0 GENERAL NOTES :		1. IN GENERAL, THIS REHABILITATION PROGRAM INCLUDES THE REPAIR AND PROTECTION OF THE PODIUM DECK	GENERATING WORK AND PROVIDE DROP CLOTHS AND PROTECTION FOR INTERIOR FINISHES, SERVICES, AND EQUIPMENT TO REMAIN THROUGH THE WORK.	 THE CONTRACTOR SHALL PROVIDE ALL REQUIRED SIGNAGE NECESSARY TO PROTECT THE PUBLIC FROM THE CONSTRUCTION, CONTROL PEDESTRIAN TRAFFIC FLOW THROUGH THE SITE AND AROUND THE WORK AREA, AND TO INFORM PATRONS THAT CONSTRUCTION ACTIVITY IS IN PROGRESS.
(THESE NOTES APPLY TO ALL PHASES / ASPECTS OF THE PROJE	,	/BASEMENT ROOF SLAB AND INTERIOR AREAS BELOW AT THE FAIRBANK MEMORIAL COMMUNITY CENTE IN TORONTO, ONTARIO.	3. POSITION HOARDING TO MAINTAIN PEDESTRIAN TRAFFIC FLOW.4. WALKWAYS SHALL BE CONSTRUCTED TO MAINTAIN SAFE ACCESS TO ALL BUILDING ENTRANCES/EXITS AND OTHER	2. ADDITIONAL SIGNS MAY BE REQUIRED AT THE DISCRETION OF THE OWNER OR THE CONSULTANT AS CONSTRUCTION PROGRESSES TO ENSURE PEDESTRIAN TRAFFIC FLOW IS MAINTAINED. NO EXTRAS WILL BE ENTERTAINED FOR
THESE DRAWINGS ARE TO PROVIDE A SCHEMATIC REPRESENTATION DECK/ BASEMENT ROOF SLAB IN THE AREA OF WORK.		2. IN PARTICULAR, THE WORK, BRIEFLY DESCRIBED BELOW, INCLUDES, BUT IS NOT NECESSARILY LIMITED TO THE FOLLOWING:	SERVICES, ETC., THAT REQUIRE ACCESS SO AS TO PROTECT PEDESTRIANS USING SUCH ENTRANCE WAYS, ROOMS, AND SERVICES.	SIGNAGE REQUIREMENTS AFTER TENDER CLOSES. 3. SIGNAGE WILL BE REQUIRED AT ALL ENTRANCES TO THE AREA OF WORK. THIS SIGNAGE SHALL CONSIST OF THE
THE CONTRACTOR MUST REVIEW AND CONFIRM THE EXTENT OF EX VILL REQUIRE ADJUSTMENT IN ORDER TO COMPLETE THE WORK A BIDDING.		.1 THE INSTALLATION AND MAINTENANCE OF HOARDING, DUST PROTECTION, AND CONSTRUCTION SIGNAGE AROUND THE AREAS OF WORK TO PREVENT UNAUTHORIZED ACCESS AND TO CONTAIN CONSTRUCTION DUST AND DEBRIS.	5.0 PHASING NOTES :	STANDARD "MEN AT WORK" SIGN WITH AN ADDITIONAL SIGN (SPECIAL ORDER) INDICATING THAT THE "SITE IS TEMPORARILY UNDER CONSTRUCTION" AND "WE ARE SORRY FOR THE INCONVENIENCE".
DISCREPANCIES, AMBIGUITIES OR OMISSIONS IN THE DRAWINGS SH CONSULTANT IMMEDIATELY.	ALL BE BROUGHT TO THE ATTENTION OF THE	.2 THE INSTALLATION AND MAINTENANCE OF VENTILATION AND EXHAUST SYSTEMS FOR ENCLOSED INTERIOR WORK AREAS.	 IN GENERAL, THE WORK IS TO BE UNDERTAKEN IN A SINGLE MAJOR PHASE. MAINTAIN THE PHASING REQUIREMENTS SHOWN ON THE DRAWINGS AND AS OUTLINED IN SPECIFICATION SECTIONS 	4. THE LOCATION AND TYPE OF SITE SPECIFIC CONSTRUCTION SIGNAGE IS INDICATED ON THE PHASING DRAWINGS WHICH INCLUDES, BUT IS NOT NECESSARILY LIMITED TO THE FOLLOWING:
PARTIAL COPIES OF PREVIOUS RENOVATION /ADDITION CONSTRUCT REFERENCE PURPOSES ONLY. DO NOT SCALE FROM THIS DRAWING REFLECTING THE AS-BUILT CONDITION.		.3 TARGETED REMOVAL AND DISPOSAL OF DETERIORATED INTERIOR FINISHES, LIGHTWEIGHT STEEL FRAMING, AND INSULATION.	01 11 00 AND 01 11 01. THE CONTRACTOR'S WORK AREA IS TO BE FULLY ENCLOSED DURING EACH PHASE. 3. THE CONTRACTOR IS TO ENSURE ACCESS TO THE WORK AREA IS RESTRICTED TO THE CONTRACTOR'S STAFF, THE	.1 THIS ENTRANCE IS TEMPORARILY UNDER CONSTRUCTION – SORRY FOR THE INCONVENIENCE .2 THIS ENTRANCE/EXIT IS CLOSED DUE TO CONSTRUCTION – PLEASE USE OTHER ENTRANCE/EXIT (WITH DIRECTIONAL ARROW)
HE EXTENT OF WORK IS AS SHOWN ON THE DRAWINGS.		.4 REMOVAL AND DISPOSAL OF THE PODIUM DECK LANDSCAPING, DRAINAGE BOARD, AND WATERPROOFING SYSTEMS TO EXPOSE THE STRUCTURAL SLAB BELOW. THE SCOPE WILL INCLUDE DEMOLITION OF THE RAISED PLANTER BEDS AND SKYLIGHTS. ON-GRADE AREAS AROUND THE BURIED PODIUM DECK FOUNDATION WALLS	 CONSULTANT AND THE OWNER. 4. ENSURE PEDESTRIAN TRAFFIC FLOW IS MAINTAINED, REFER TO SPECIFICATION SECTION 01 56 00 FOR CONSTRUCTION SIGNAGE REQUIREMENTS. 	.3 DANGER – OPEN EXCAVATIONS
OARDING, DUST PROTECTION, SITE PROTECTION AND CONSTRUCTION THE AND PHASES OF WORK IN ACCORDANCE WITH SPECIFICATION RAWINGS PRIOR TO COMMENCING THE WORK.		WILL ALSO BE EXCAVATED. DEMOLITION OF ON-GRADE HARD AND SOFT LANDSCAPING IS ALSO INCLUDED AS REQUIRED TO EXPOSE THE FOUNDATION WALL DOWNTURN.	6.0 CONCRETE / SHORING REPAIR NOTES :	
THIS SET OF DRAWINGS DOES NOT INCLUDE COMPONENTS THAT N THE CONTRACTOR IS RESPONSIBLE FOR SAFETY IN AND AROUND THE DESIGN AND ERECTION OF ALL TEMPORARY STRUCTURES REG	THE JOB SITE DURING CONSTRUCTION, AND FOR	.5 INSTALLATION OF NEW FRAMING AND INFILL SKYLIGHT OPENINGS FABRICATOR TO DESIGN FULL SHEAR CONNECTOR AT EXISTING BEAMS. PROVIDE BASE PLATE AND ALTERNATE CONNECTION WHERE WELDING IS NOT FEASIBLE. CONFIRM AND VERIFY DIMENSIONS AND EXISTING CONDITIONS AS PART OF SHOP DRAWING PREPARATION.	1. BEFORE STARTING CONCRETE REMOVALS, REVIEW WITH RJC THE EFFECT OF DEMOLITION ON STRUCTURAL INTEGRITY. PROVIDE SHORING OF STRUCTURAL MEMBERS AS REQUIRED TO FACILITATE THE WORK.	
HE USE OF THESE DRAWINGS IS LIMITED TO THE EXTENT IDENTIF ONSTRUCT FROM THESE DRAWINGS UNLESS MARKED "ISSUED FO		.6 INSTALLATION OF NEW CAST-IN-PLACE CURBS AT THE PODIUM DECK PERIMETER AND EXTERIOR BRICK WALLS. WORK TO INCLUDE TEMPORARY REMOVAL AND REINSTATEMENT OF BRICK MASONRY TO FACILIATE INSTALLATION.	2. THE CONTRACTOR IS TO SUBMIT SHORING DESIGN FOR RJC TO REVIEW PRIOR TO INSTALLATION. ALL REQUIRED SHORING MUST BE INSTALLED PRIOR TO CONCRETE REMOVAL.	
CHRISTOFFERSEN LTD. ILL DIMENSIONS TAKEN FROM THE DRAWINGS SHALL BE CHECKED CONTRACTOR SHALL BE RESPONSIBLE FOR THE CORRECTNESS OF		.7 INSTALLATION OF ELASTOMERIC ACRYLIC COATING ON ALL CURBS AND CONCRETE SURFACES AS SHOWN IN THE DRAWINGS.	3. IN ADDITION TO REPAIRS SHOWN ON THE DRAWINGS, RANDOMLY LOCATED CONCRETE DELAMINATION REPAIRS ARE TO BE PERFORMED IN LOCALIZED AREAS IN ACCORDANCE WITH THE APPROPRIATE DETAIL AS DIRECTED BY THE CONSULTANT.	
NGINEARTOR SHALL BE RESPONSIBLE FOR THE CORRECTNESS OF NGINEER IN WRITING ALL DISCREPANCIES BETWEEN THE MEASURE THE DRAWINGS PRIOR TO COMMENCING THE WORK.		.8 INSTALLATION OF NEW AODA COMPLIANT RAMP COMPLETE WITH GUARDS AND HANDRAILS .9 INSTALLATION OF NEW CODE COMPLIANT STEEL GUARDS AT THE PODIUM DECK PERIMETER.	7.0 SITE REVIEW RESPONSIBILITY :	
THE CONTRACTOR SHALL REVIEW ALL THE DRAWINGS AND CHECK REPORT ANY DISCREPANCIES BETWEEN THESE DRAWINGS AND THE MMEDIATELY.	SITE CONDITION TO THE CONSULTANT	.10 INSTALLATION OF SLAB SURFACE AREA DRAINS TO REPLACE EXISTING DRAINS AND WHERE REQUIRED TO PROVIDE ADEQUATE SUPPLEMENTAL DRAINAGE AS DIRECTED BY THE CONSULTANT. SLOPED BONDED CONCRETE TOPPING WILL BE INSTALLED WHERE REQUIRED TO IMPROVE SLOPES TO DRAIN WHERE DIRECTED.	READ JONES CHRISTOFFERSEN LIMITED ("RJC") WILL PROVIDE GENERAL REVIEW OF CONSTRUCTION IN ACCORDANCE WITH THE PERFORMANCE STANDARDS OF THE ASSOCIATION OF PROFESSIONAL ENGINEERS OF ONTARIO BY MEANS OF A RATIONAL SAMPLING PROCEDURE TO DETERMINE WHETHER THE CONSTRUCTION OF THAT	
ECTION MARK SHOWN THUS $\begin{pmatrix} 1 \\ S1.1 \end{pmatrix}$ denotes section 1 on DR/ HE ENGINEERING FIELD SERVICES: THE ENGINEER WILL PROVIDE	FIELD SERVICE DURING THE CONSTRUCTION	.11 SURFACE PREPARATION AND INSTALLATION OF A 2-PLY HOT RUBBERIZED WATERPROOFING SYSTEM COMPLETE WITH A 24-INCH DOWNTURN AT BURIED PERIMETER FOUNDATION WALLS. THE WATERPROOFING SYSTEM WILL BE UPTURNED AT ALL OTHER VERTICAL SURFACES AND PROTECTED AT EXPOSED AREAS WITH PREFINISHED	WORK SHOWN ON RJC'S DRAWINGS IS IN GENERAL CONFORMANCE WITH THE PLANS, SKETCHES, DRAWINGS, AND SPECIFICATIONS FORMING PART OF THE CONTRACT DOCUMENTS PREPARED BY RJC. THE CONTRACTOR IS SOLELY RESPONSIBLE FOR QUALITY CONTROL AND THE PERFORMANCE OF THE WORK IN ACCORDANCE WITH THE CONTRACT. RJC SHALL NOT BE RESPONSIBLE FOR THE ACTS OR OMISSIONS OF THE CONTRACTOR, SUBCONTRACTOR OR ANY OTHER PERSONS PERFORMING ANY OF THE WORK OR FOR THE FAILURE OF ANY OF	SUPPROFESSIONAL EN
HASE OF THE WORK TO SATISFY THEMSELVES, BY MEANS OF A HEIR SOLE DISCRETION CONSIDER NECESSARY, TO DETERMINE TH ORK IN GENERAL CONFORMANCE WITH THE CONTRACT DOCUMENT D THAT WORK SHOWN ON RJC'S DRAWINGS. THE PERFORMANCE	AT THE CONTRACTOR IS CARRYING OUT THAT TS. THE FIELD SERVICES PROVIDED APPLY ONLY OF THE CONTRACT IS NOT THE ENGINEER'S	METAL FLASHING. .12 INSTALLATION OF NEW CONCRETE TOPPING HARD LANDSCAPING FINISHES. WORK TO INCLUDE INSTALLATION OF TOOLED CONTROL JOINTS ON A 90" SQUARE GRID AT 1/3" TOPPING DEPTH. TOOLED JOINTS TO BE SEALED WITH FLEXIBLE SEALANT BETWEEN 1/8" AND 1/4" BELOW TOPPING SURFACE.	THEM TO CARRY OUT THE WORK IN ACCORDANCE WITH THE CONTRACT DOCUMENTS.	C. J. CHAN 100546096
ESPONSIBILITY, NOR ARE THE FIELD SERVICES RENDERED FOR TH OLELY RESPONSIBLE FOR QUALITY CONTROL AND PERFORMING TH OCUMENTS.		.13 INSTALLATION OF NEW ELECTRICAL LIGHTING ON THE EAST BUILDING ELEVATION.		2025-02-28 0 ///////////////////////////////////
HE CONTRACTOR WILL BE RESPONSIBLE TO REPAIR/RESTORE/REI AMAGED AS A RESULT OF CONSTRUCTION OR REMOVED IN ORDE	R TO ALLOW CONSTRUCTION TO BE	.14 INSTALLATION OF A NEW FENCED ENCLOSURE COMPLETE WITH OPERABLE ACCESS GATE BENEATH THE NORTH ACCESS WALKWAY.		
NDERTAKEN. THE CONTRACTOR IS ALSO RESPONSIBLE FOR REINS HE EXTENT SHOWN ON THE DRAWINGS AND IN ACCORDANCE WIT		.15 REMOVAL AND DISPOSAL OF EXISTING DIMENSIONED STONE UPSTAND WALLS.		ISSUED FOR PERMIT - February 28 , 2025 ISSUED FOR TENDER - February 28 , 2025
PROVIDE SIGNAGE AS REQUIRED TO ENSURE PEDESTRIAN TRAFFIC		.16 RELOCATION OF EXISTING SITE SIGNAGE.		ISSUED FOR TENDER - February 28 , 2025 ISSUED FOR CLIENT REVIEW - January 16, 2025
IAINTAINED. ENSURE BUILDING ENTRANCES HAVE PROPER SIGNAGE SPECIFICATION SECTION 01 56 00. THE CONTRACTOR IS TO PROV		.17 FLUSHING AND CLEANING OF THE PODIUM DECK AND STAIRWELL ROOF DRAINAGE SYSTEMS.		
EACH SIGN. APPROXIMATE TYPE AND LOCATION OF CONSTRUCTION SIGNAGE HA MAY BE REQUIRED.	AS BEEN SHOWN, HOWEVER ADDITIONAL SIGNAGE	.18 REINSTATEMENT OF INTERIOR FINISHES. .19 CLEANING OF ALL AREAS AFFECTED BY THE WORK PER ORIGINAL CONDITIONS PLUS SKYLIGHT INFILL AREAS.		RJC PROJECT No. TOR.140332.0001

Fairbank Memorial Community Center Ontario Toronto, PODIUM DECK REHABILITATION





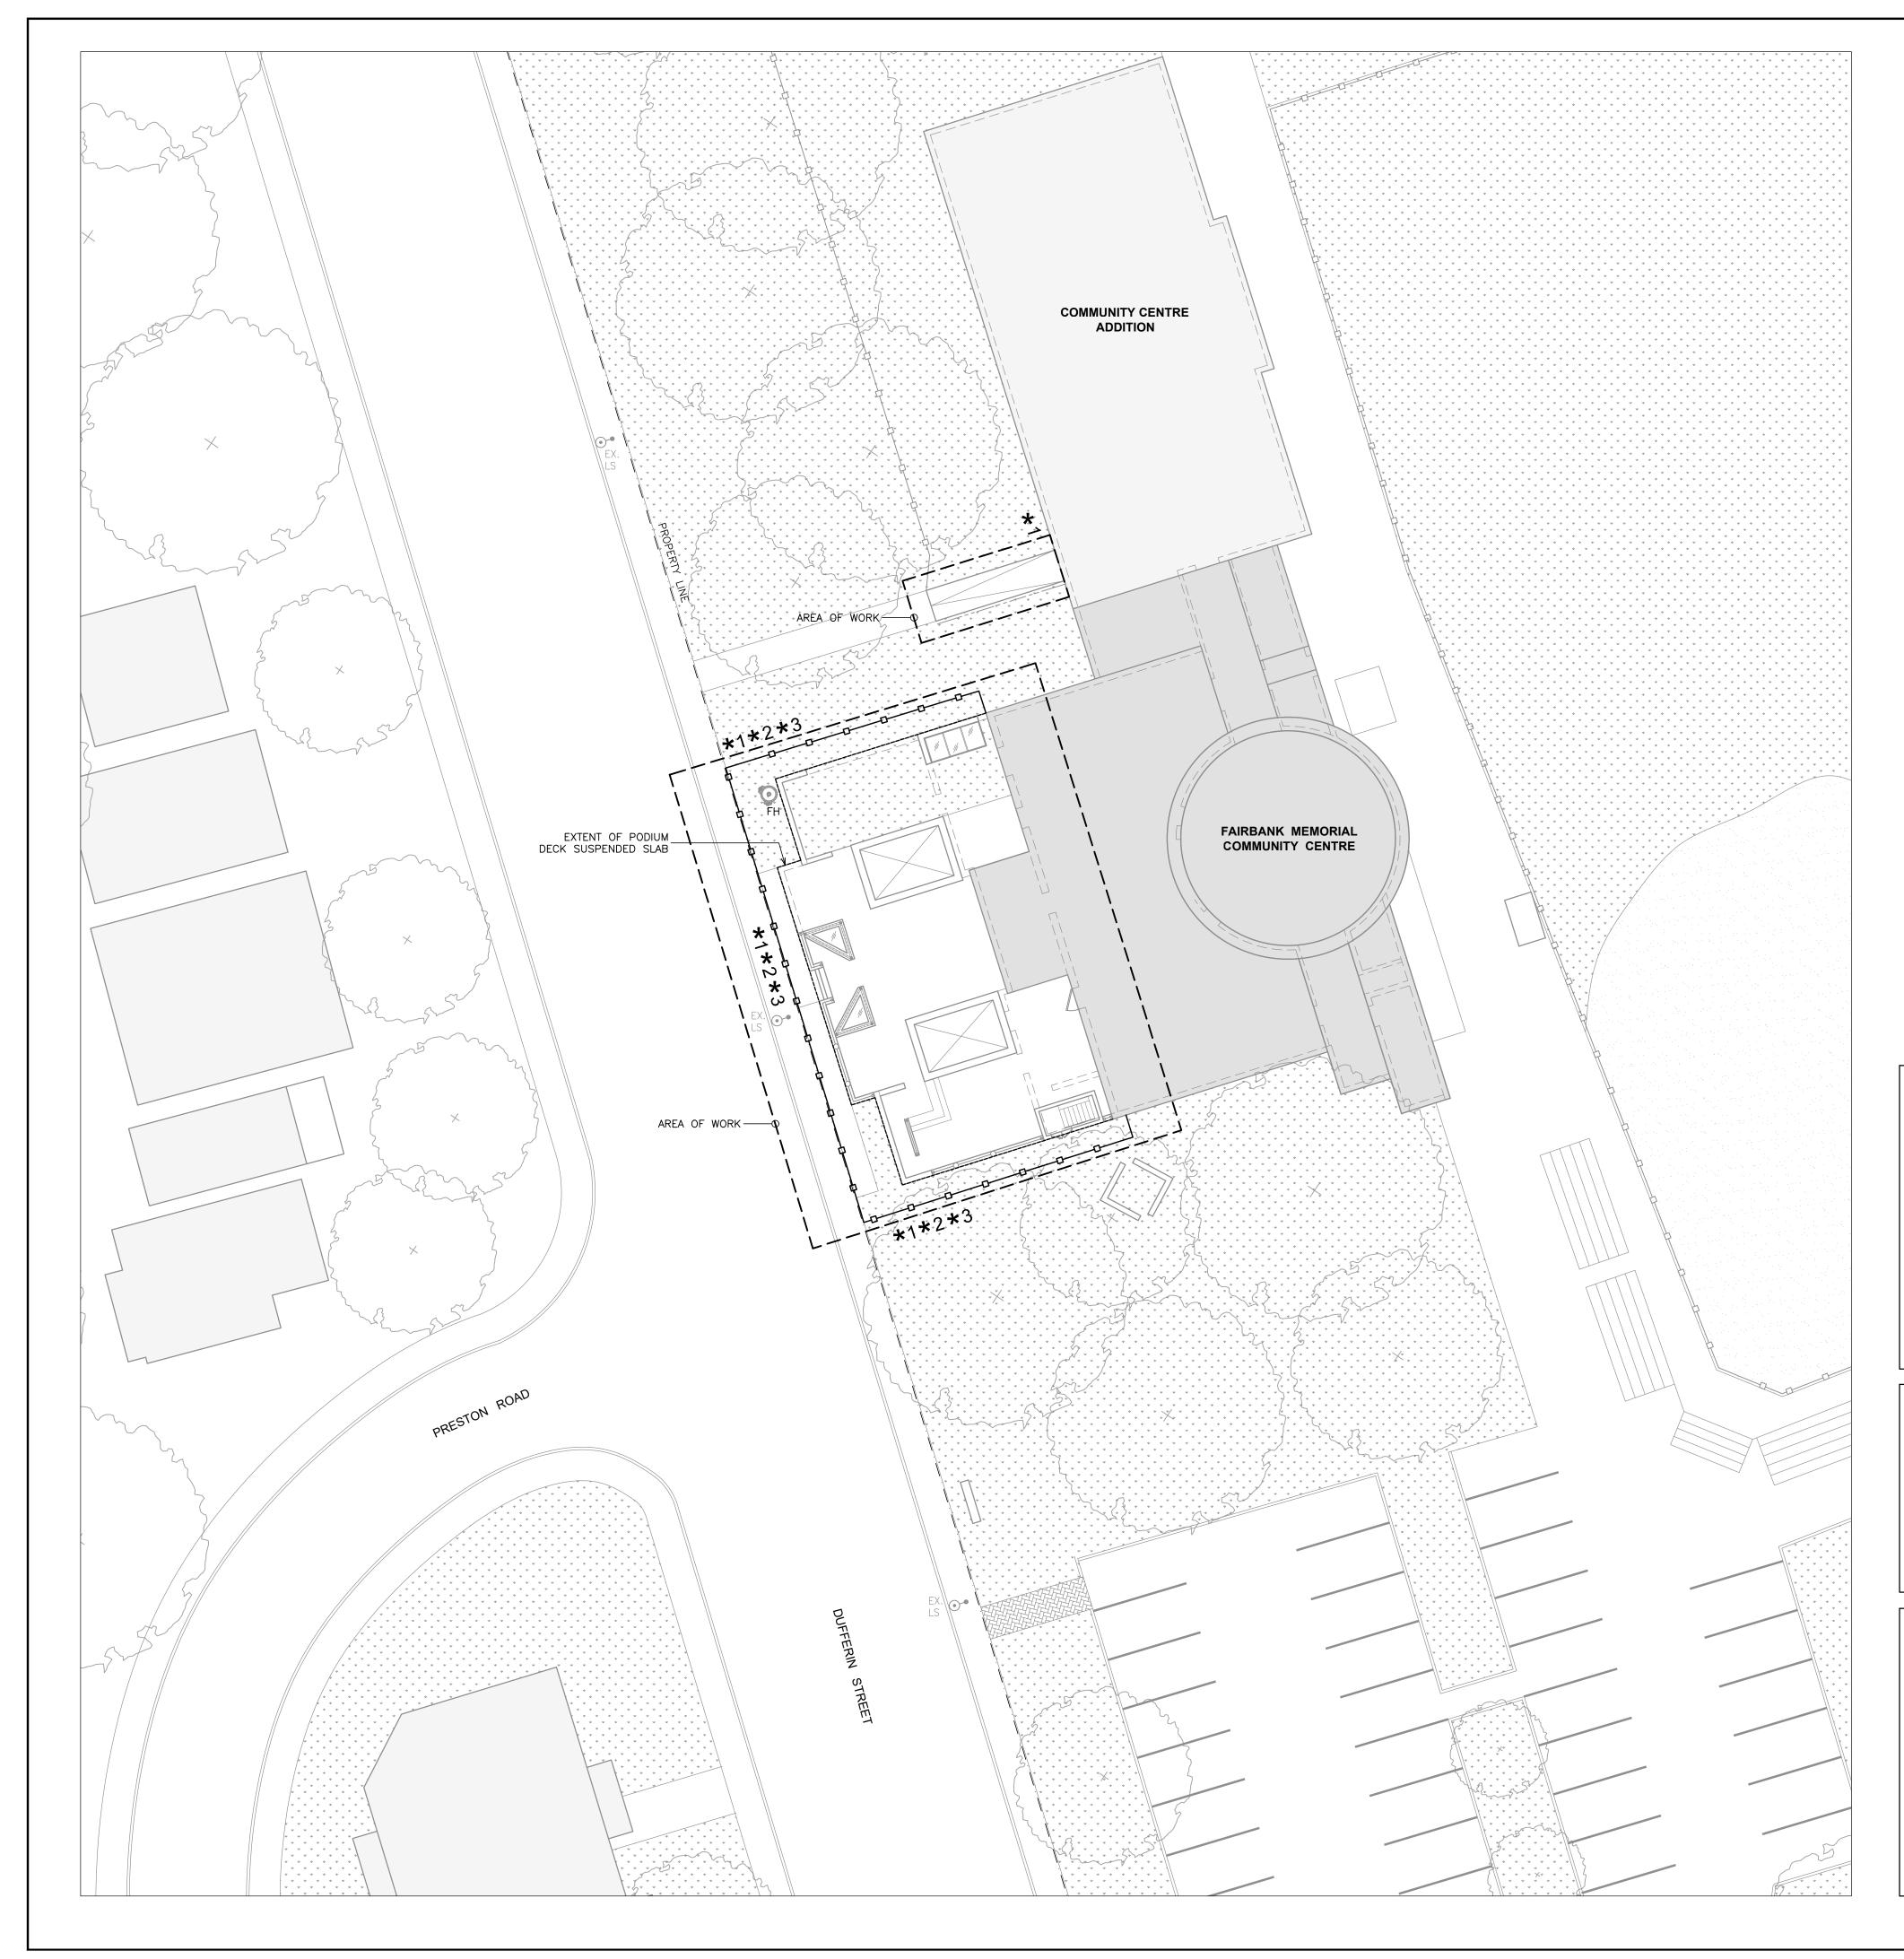
Creative Thinking Practical Results

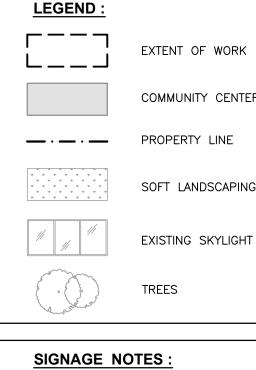
Read Jones Christoffersen Ltd. Engineers

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- .3 "DANGER OPEN EXCAVATIONS"

- REPRESENTATIVE.

- 6. DO NOT OBSTRUCT CITY SIDEWALK.

. MAINTAIN INTERIOR DOORS SECURED AND DUST-TIGHT DURING CONSTRUCTION AND PROVIDE FULL-HEIGHT DUST ENCLOSURE. REFER TO SPECIFICATION SECTION 01 56 00.

. THE CONTRACTOR IS RESPONSIBLE FOR CITY ROAD DAMAGE DEPOSIT AND COST OF ALL REQUIRED PERMITS, EXCLUDING THE BUILDING PERMIT, WHICH WILL BE PAID FOR BY THE OWNER.

ENSURE PEDESTRIAN TRAFFIC FLOW IS MAINTAINED, REFER TO SPECIFICATION SECTION 01 56 00 FOR CONSTRUCTION SIGNAGE REQUIREMENTS.

STAFF, THE CONSULTANT AND THE OWNER.

3. THE CONTRACTOR IS TO ENSURE ACCESS TO THE WORK AREA IS RESTRICTED TO THE CONTRACTOR'S

MAINTAIN THE PHASING REQUIREMENTS SHOWN ON THE DRAWINGS AND AS OUTLINED IN

SPECIFICATION SECTIONS 01 10 01. THE CONTRACTOR'S WORK AREA IS TO BE FULLY ENCLOSED.

THE CONTRACTOR WILL BE REQUIRED TO COORDINATE ALL CLOSURES WITH THE OWNER'S

. IN GENERAL, THE WORK IS TO BE UNDERTAKEN IN ONE PHASE.

PHASING AND HOARDING /PROTECTION NOTES :

(WITH DIRECTIONAL ARROW)"

.1 "SITE TEMPORARILY UNDER CONSTRUCTION - SORRY FOR THE INCONVENIENCE" .2 "THIS ENTRANCE/EXIT IS CLOSED DUE TO CONSTRUCTION - PLEASE USE OTHER ENTRANCE/EXIT

REFER TO COVER PAGE AND GENERAL NOTES FOR ADDITIONAL SIGNAGE REQUIREMENTS. . THE LOCATION AND TYPE OF SITE SPECIFIC CONSTRUCTION SIGNAGE IS INDICATED ON THE PHASING DRAWINGS WHICH INCLUDES, BUT IS NOT NECESSARILY LIMITED TO THE FOLLOWING:

" \star " denotes construction sign location

MMUNITY CENTER BUILDING		TO SECTION 01 56 00)
OPERTY LINE	-00	CONSTRUCTION HOARDING
	oo	HANDRAILING
FT LANDSCAPING	O FH	FIRE HYDRANT
STING SKYLIGHT	EXIST. 🗩 🛛	LIGHTING POLE
EES	CB	CATCH BASIN

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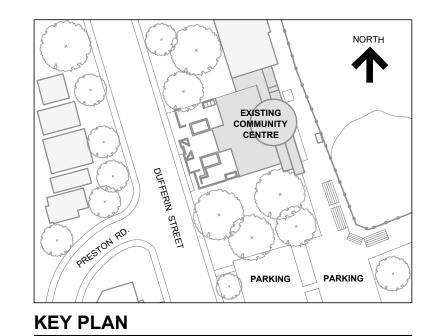
EXTENTS OF PODIUM DECK SUSPENDED SLAB LOCATION AND TYPE OF TEMPORARY SIGNAGE (REFER N 01 56 00)



Creative Thinking Practical Results



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Engineers

____ ____ ____ -

3.	ISSUED FOR PERMIT	Feb. 28, 25	C.J.C.
2.	ISSUED FOR TENDER	Feb. 28, 25	C.J.C.
1.	ISSUED FOR CLIENT REVIEW	Jan.16, 25	C.J.C.

3.	ISSUED FOR PERMIT	Feb. 28, 25	C.J.C.
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No.	Revision	Date	Ву

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	ig Notes		

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	i g Notes Irawings, plans, models, designs, specifications a	nd other docume	ents
prep	ared by Read Jones Christoffersen Ltd. ("RJC") a	ind used in conn	ection

with this project are instruments of service for the work shown in them (the

"Work") and as such are and remain the property of RJC whether the Work

is executed or not, and RJC reserves the copyright in them and in the Work

executed from them, and they shall not be used for any other work or project.

use as shop drawings. Use of these drawings as base drawings for "shop drawings" is not permitted unless written permission containing certain conditions and limitations is obtained from RJC. The work "as constructed"

2. These drawings are "design drawings" only. They may not be suitable for

3. Use of these drawings is limited to that identified in the Revision column. Do not construct from these drawings unless marked "Issued for

Construction" by RJC in the Revision column, and then only for the parts noted. The drawings shall not be used for "pricing", "costing", or "tender" unless so indicated in the Revision column. "Pricing" or "Costing" drawings are not complete and any prices based on such drawings must allow for this.

may vary from what is shown on these drawings.

C. J. CHAN 100546096

2025-02-28

Toronto, Ontario

2213 Dufferin Street,

FAIRBANK MEMORIAL

COMMUNITY CENTRE -

Project Name

Sheet Title

Drawn By **S.S.** Scale **1/16"=1'-0"** Designed By C.J.C. Date February 26, 2025 TOR.140332.0001 RJC Project Number

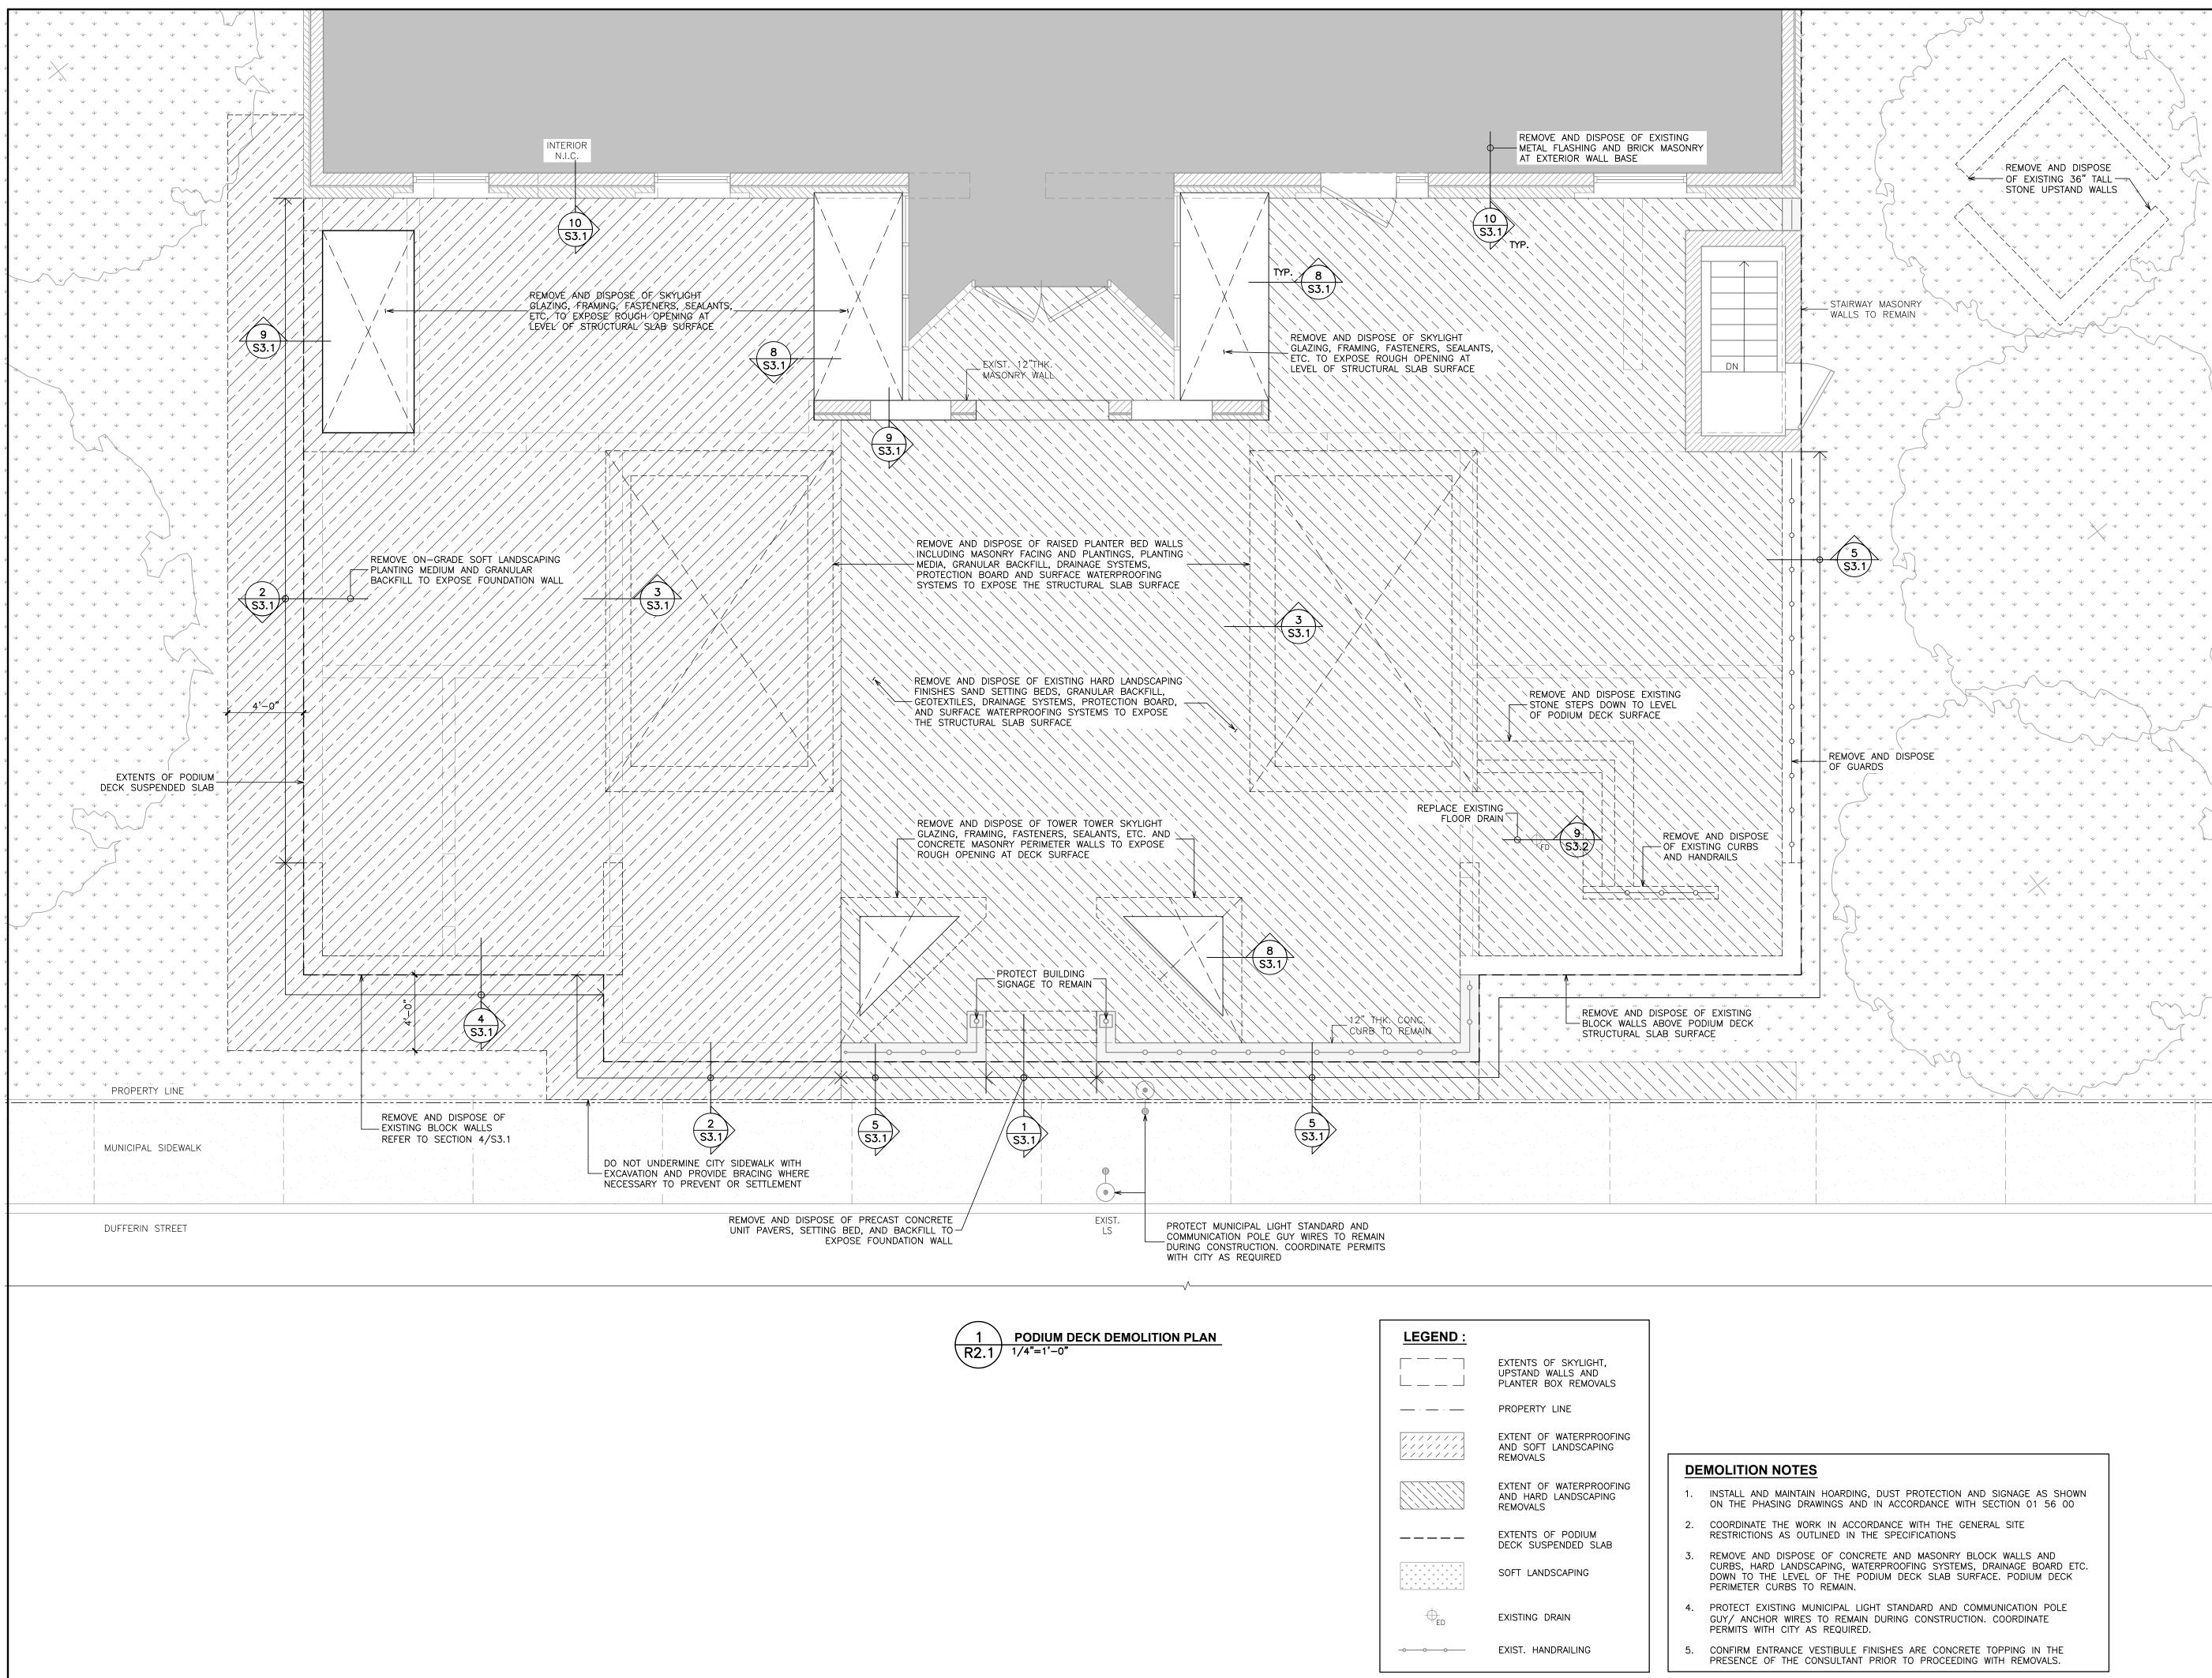
PODIUM DECK REHABILITATION

Revision

S1.1

Sheet Number

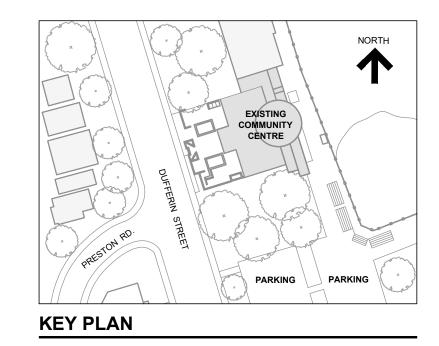
SITE PLAN







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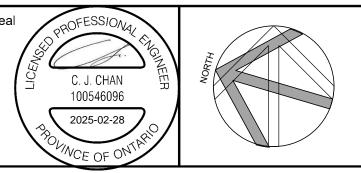
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-	3.	ISSUED FOR PERMIT	Feb. 28, 25	C.J.C.
	2.	ISSUED FOR TENDER	Feb. 28, 25	C.J.C.
	1.	ISSUED FOR CLIENT REVIEW	Jan.16, 25	C.J.C.
	No.	Revision	Date	Ву

Drawing Notes

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Project Name

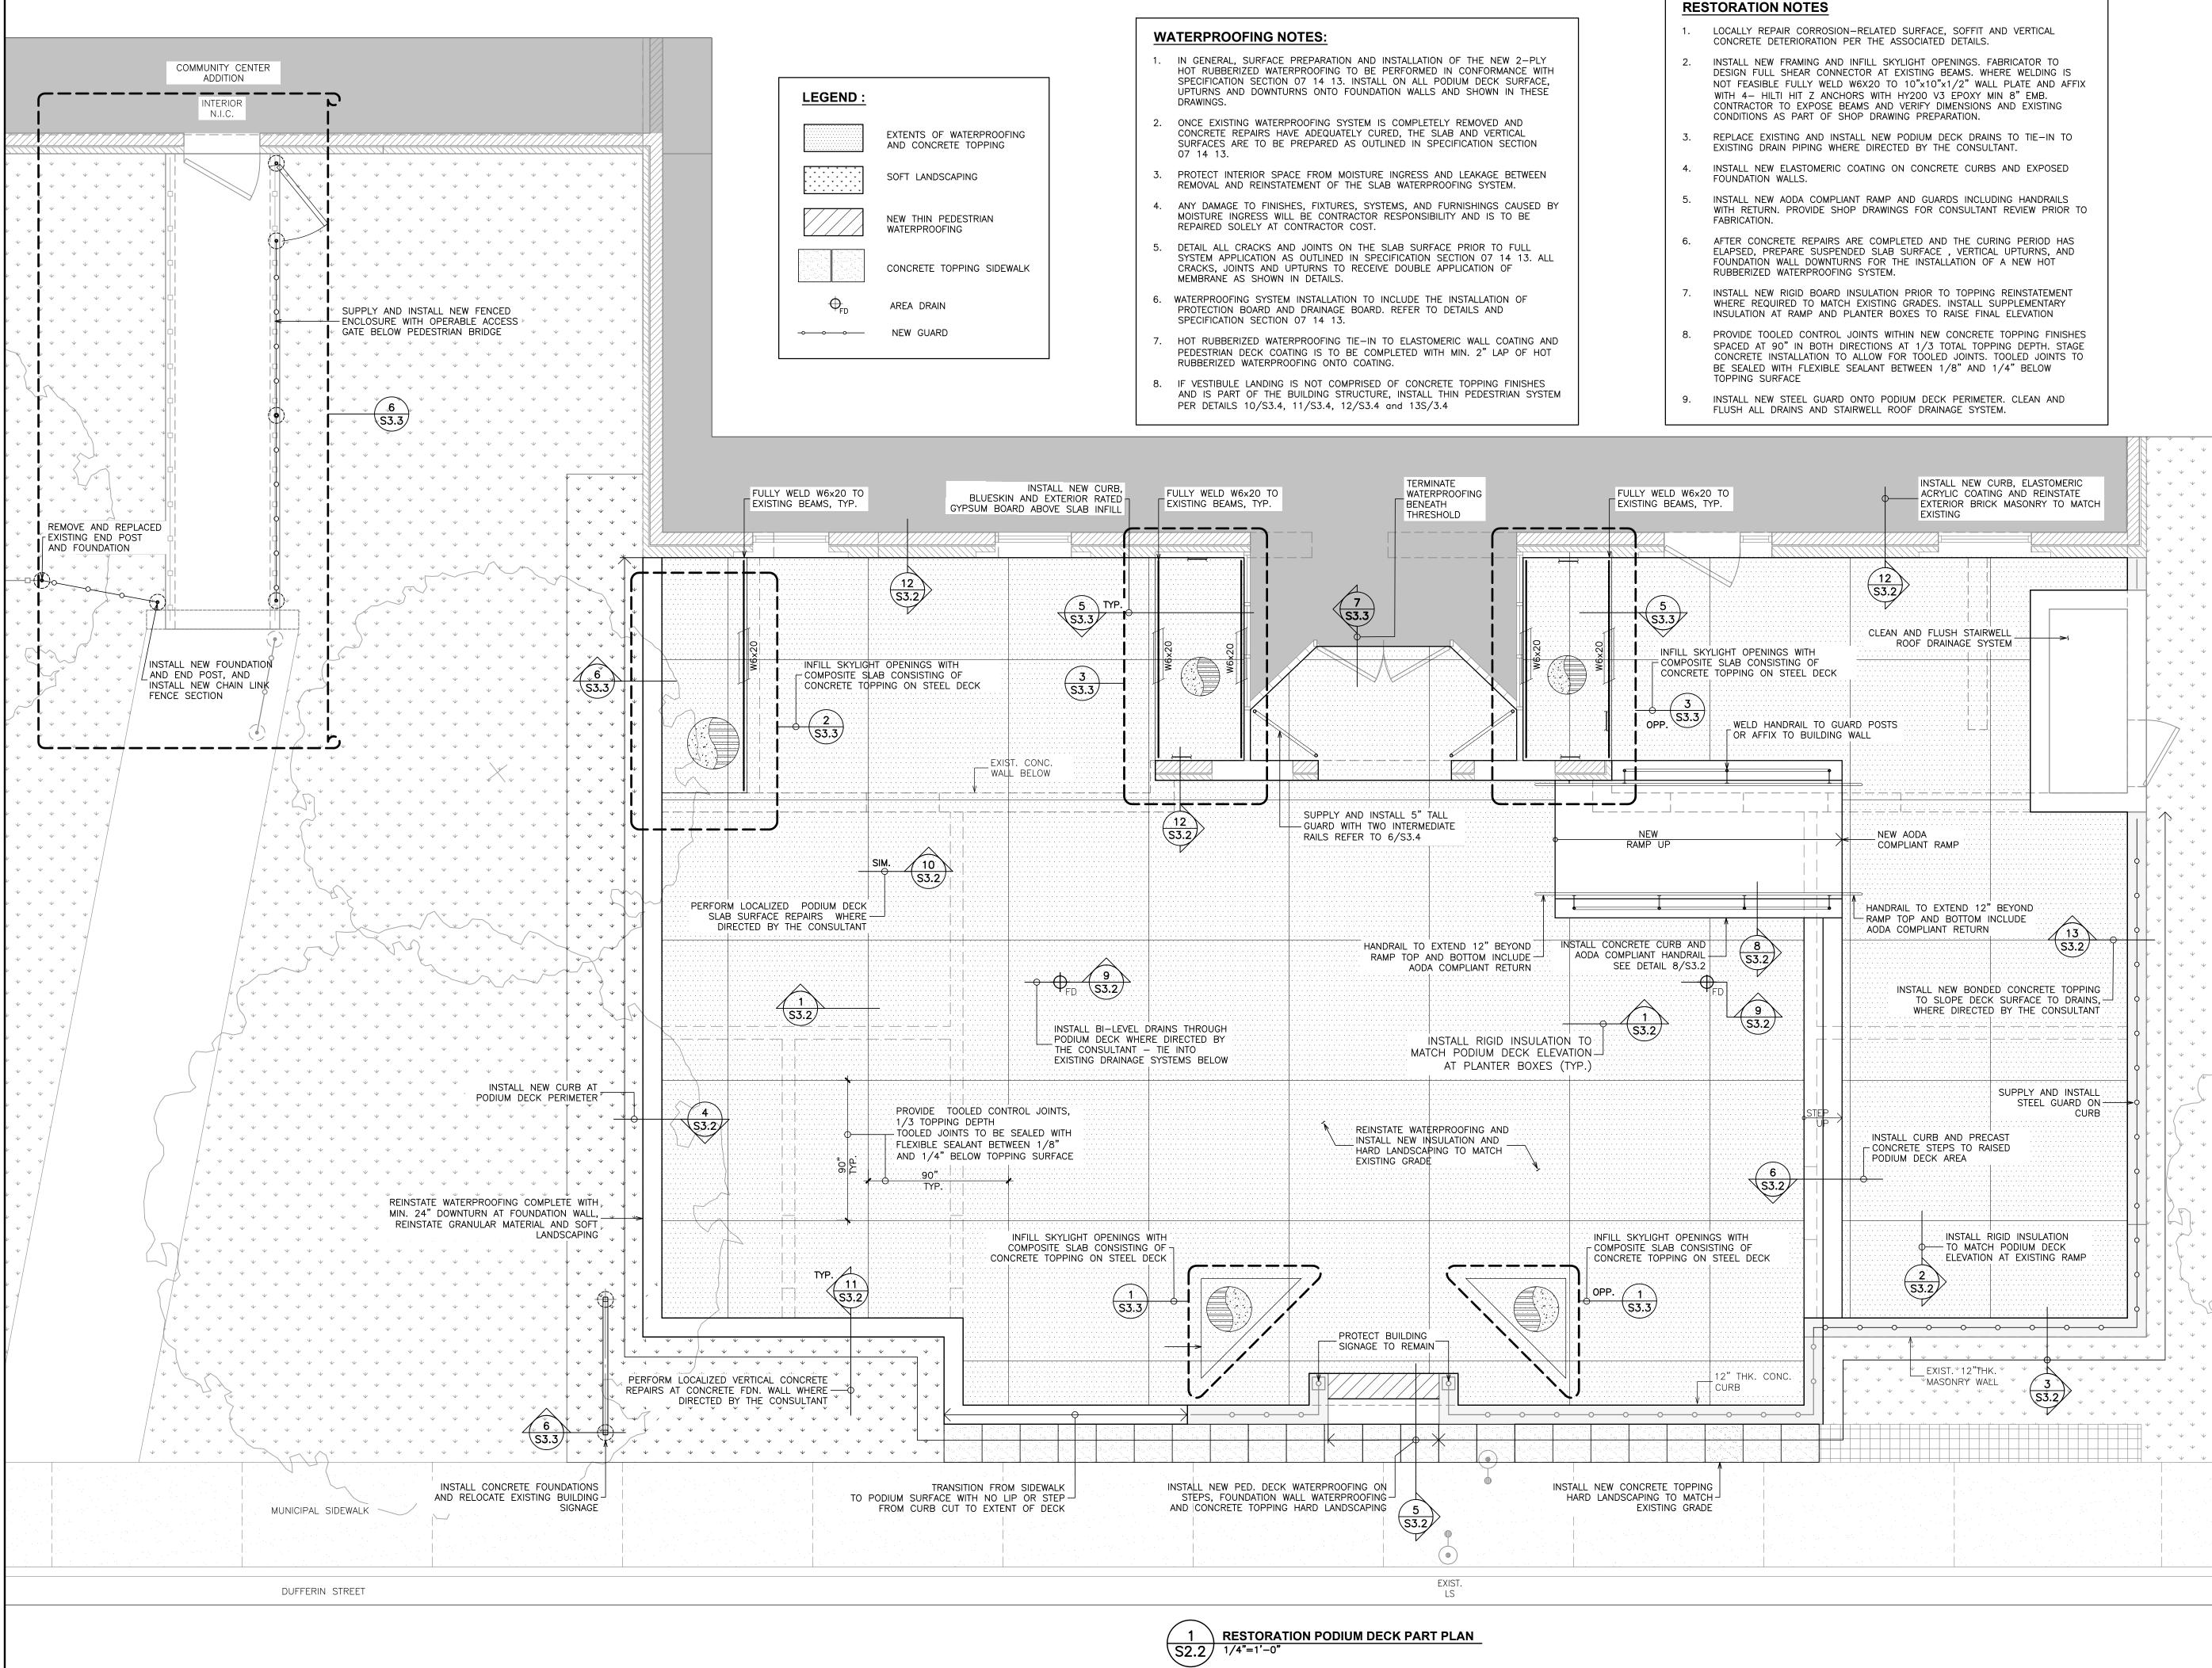
2213 Dufferin Street, Toronto, Ontario

FAIRBANK MEMORIAL **COMMUNITY CENTRE -**PODIUM DECK REHABILITATION

Sheet Title

PODIUM DECK **DEMOLITION PLAN**

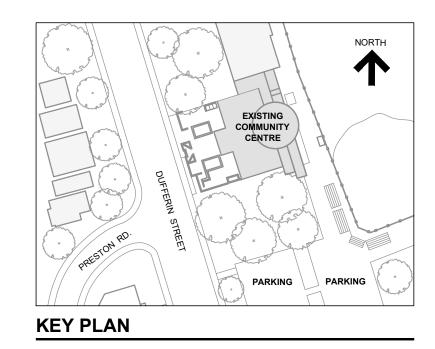
Drawn By	S.S.	Scale	1/4"=1'-0"
Designed By	C.J.C.	Date	February 26, 2025
RJC Project Number		TOR	.140332.0001
Sheet Number			Revision
S2.1			







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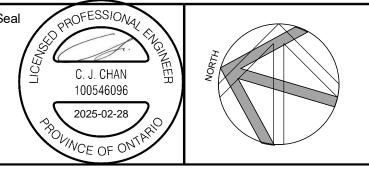
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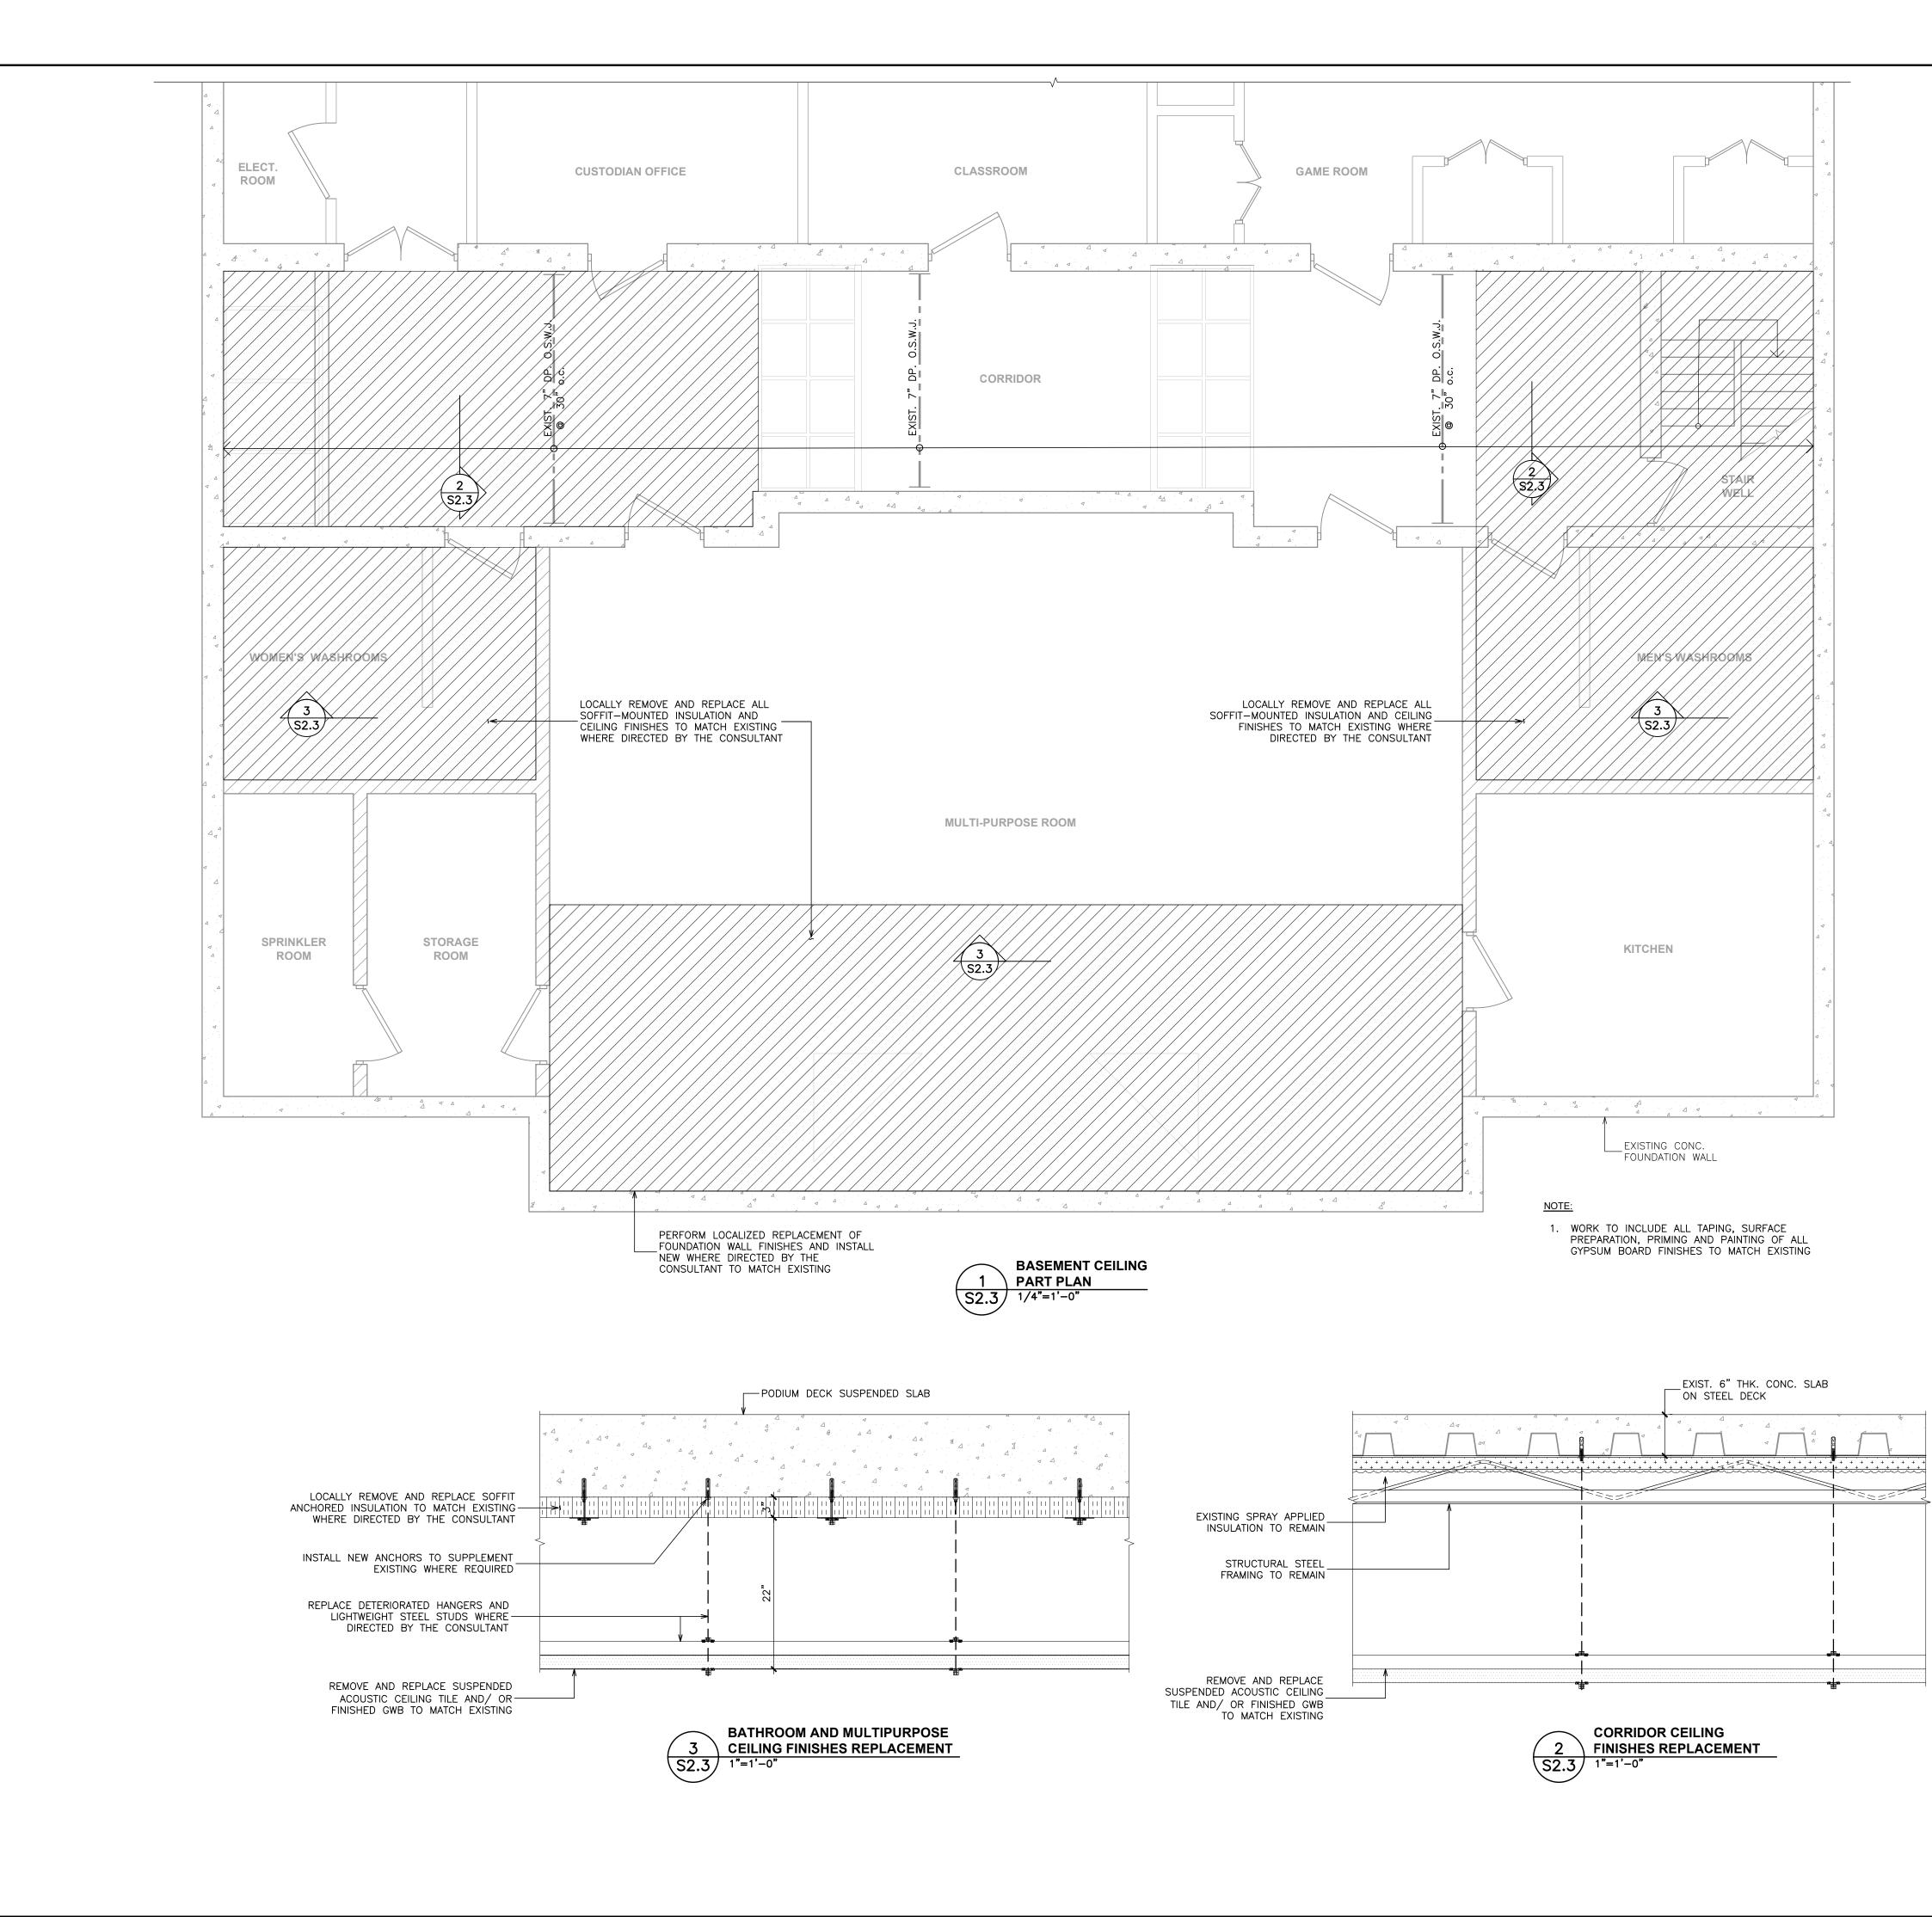
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FAIRBANK MEMORIAL **COMMUNITY CENTRE -**PODIUM DECK REHABILITATION

Sheet Title

PODIUM DECK RESTORATION PLAN

Drawn By	S.S.	Scale	1/4"=1'-0"
Designed By	C.J.C.	Date	February 26, 2025
RJC Project Number		TOR	.140332.0001
Sheet Number			Revision
S2.2			-



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LEGEND :

EXTENTS OF LOCALIZED INSULATION AND CEILING FINISHES REPLACEMENT

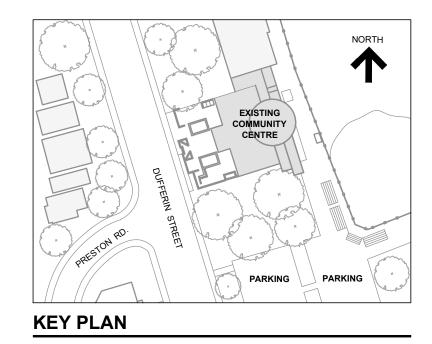


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Toronto, ON M5J 1V6 Canada tel 416-977-5335 email toronto@rjc.ca



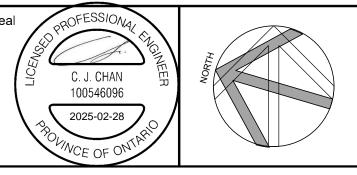
3.	ISSUED FOR PERMIT	Feb. 28, 25	C.J.C.
2.	ISSUED FOR TENDER	Feb. 28, 25	C.J.C.
1.	ISSUED FOR CLIENT REVIEW	Jan.16, 25	C.J.C.
No.	Revision	Date	Ву

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Project Name 2213 Dufferin Street, Toronto, Ontario

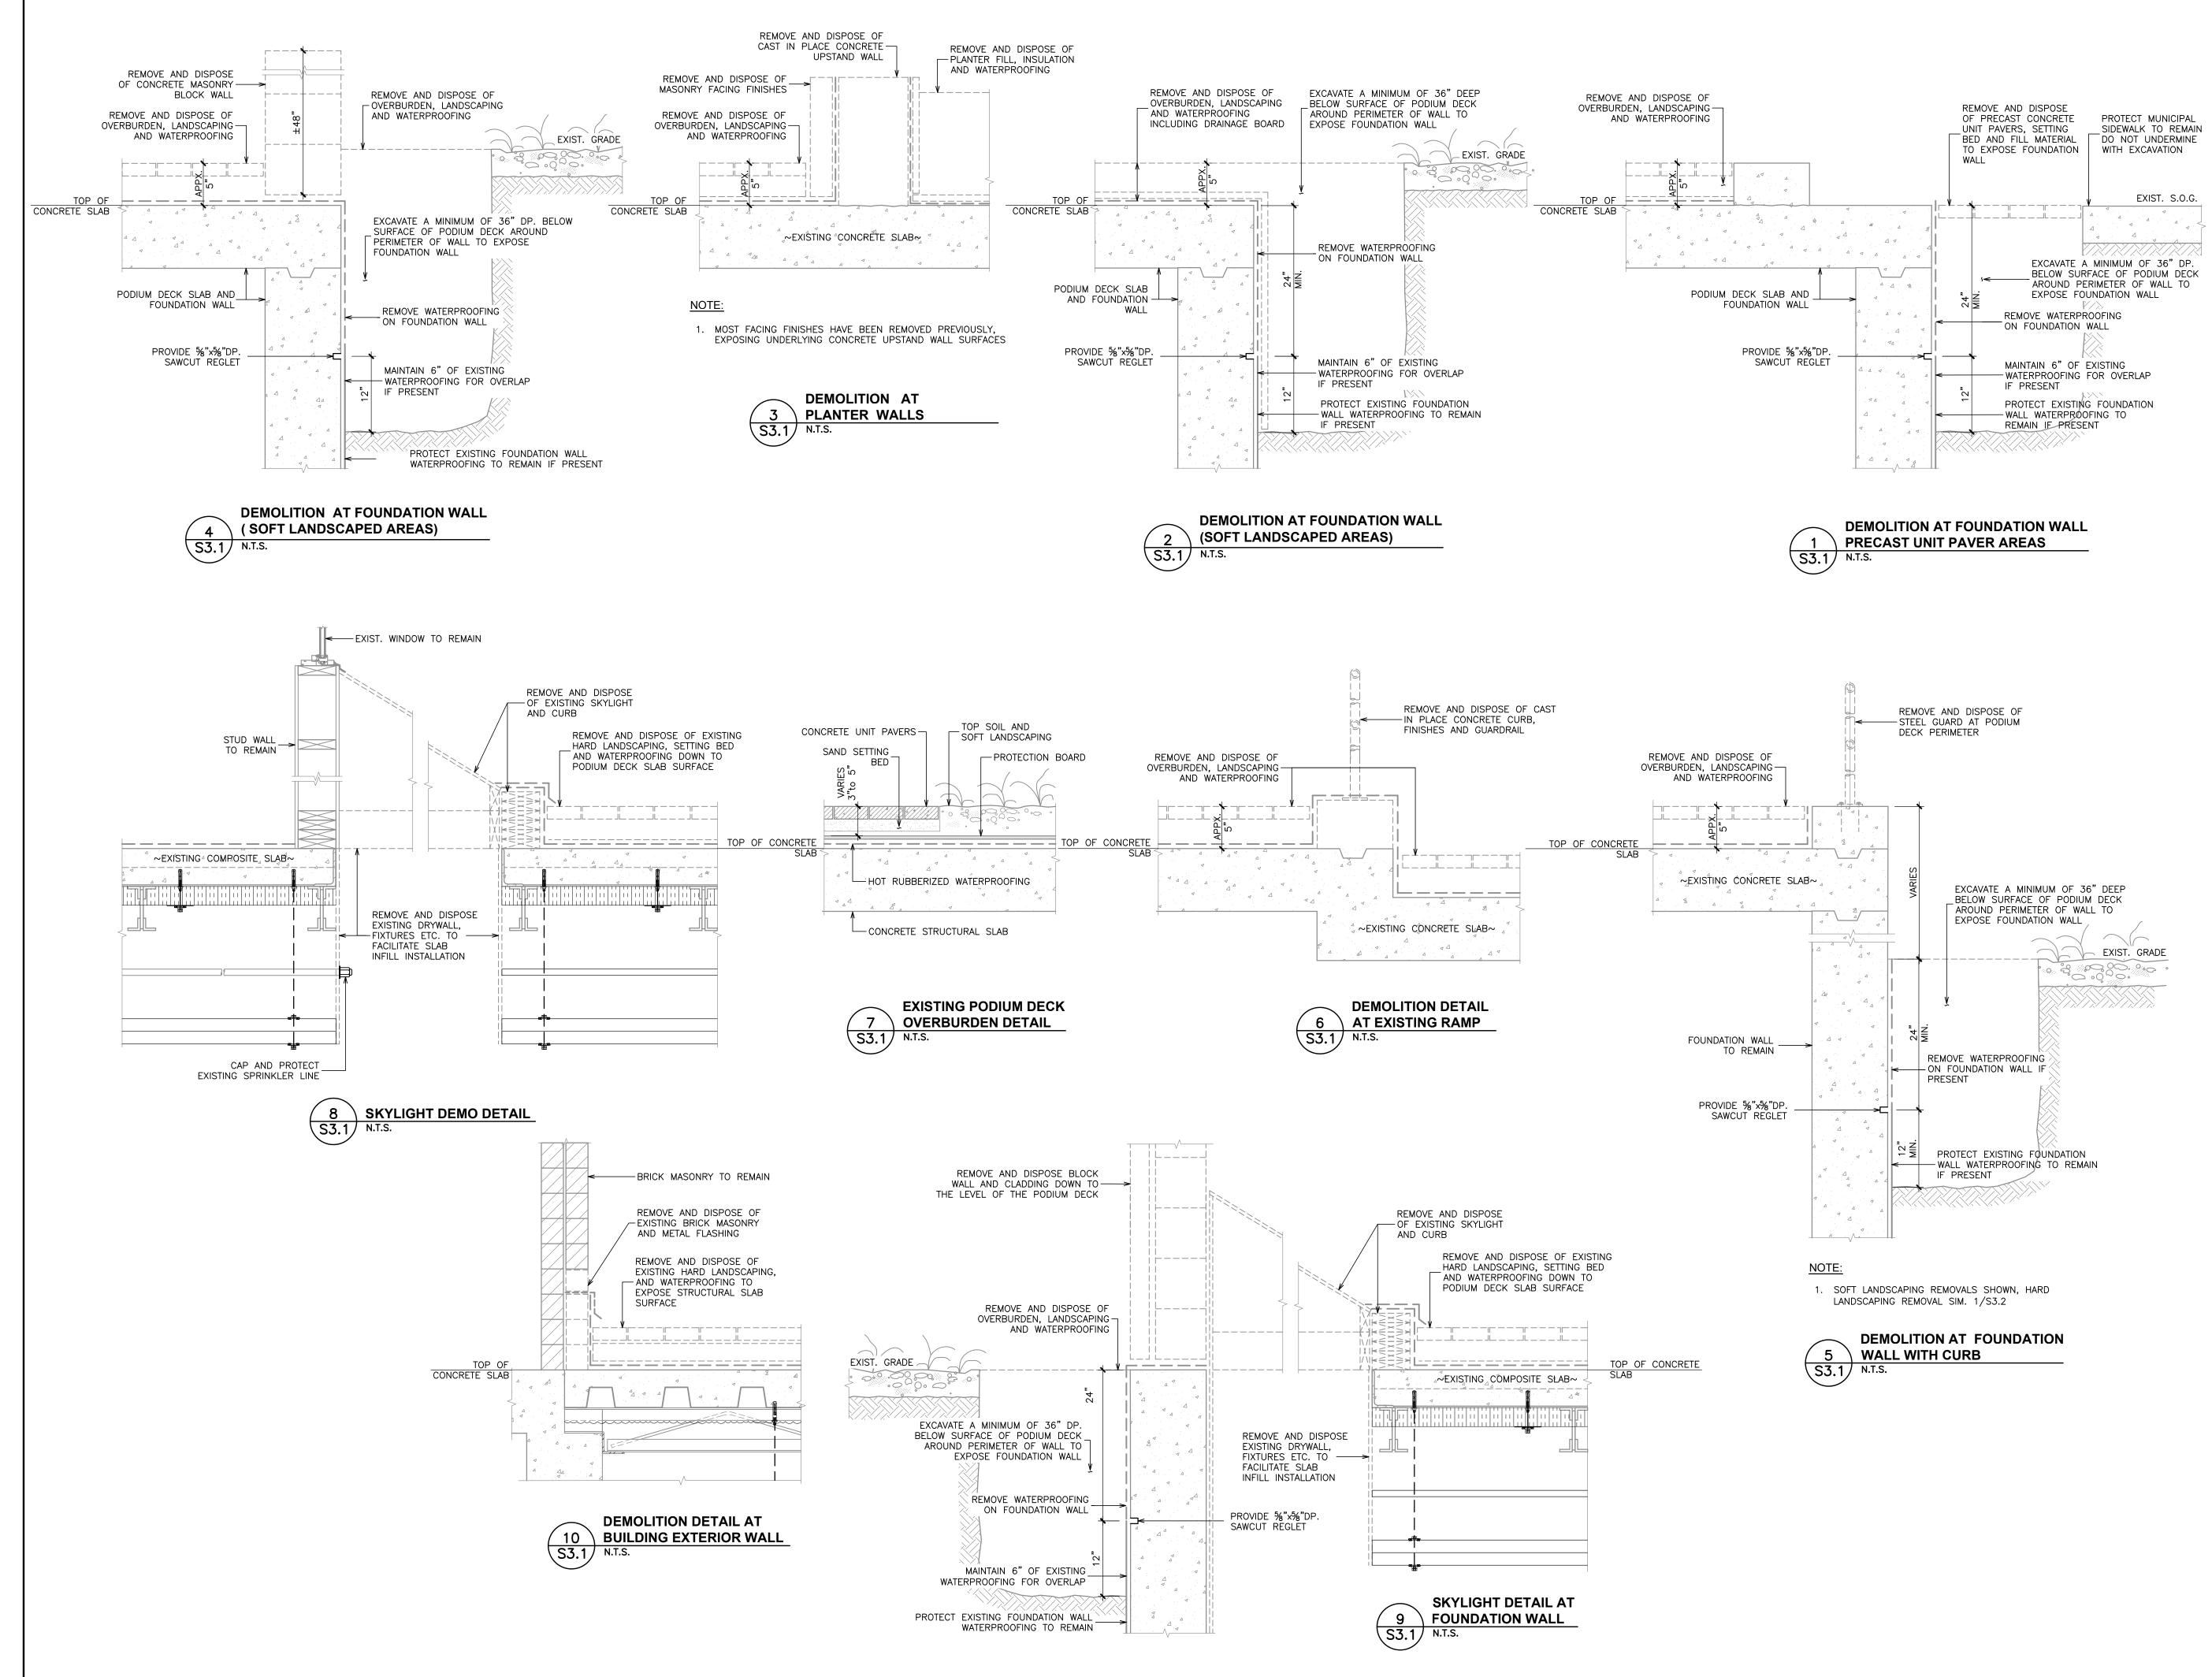
FAIRBANK MEMORIAL **COMMUNITY CENTRE -**

PODIUM DECK REHABILITATION Sheet Title

BASEMENT REFLECTED **CEILING DEMOLITION AND**

Drawn By	S.S.	Scale	AS SHOWN
Designed By	C.J.C.	Date	February 26, 2025
RJC Project Number		TOR	.140332.0001

S2.3

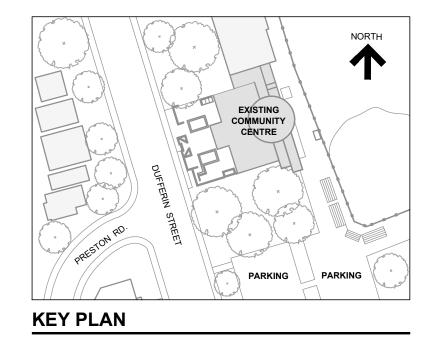






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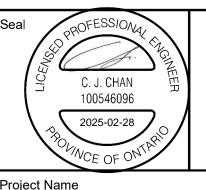
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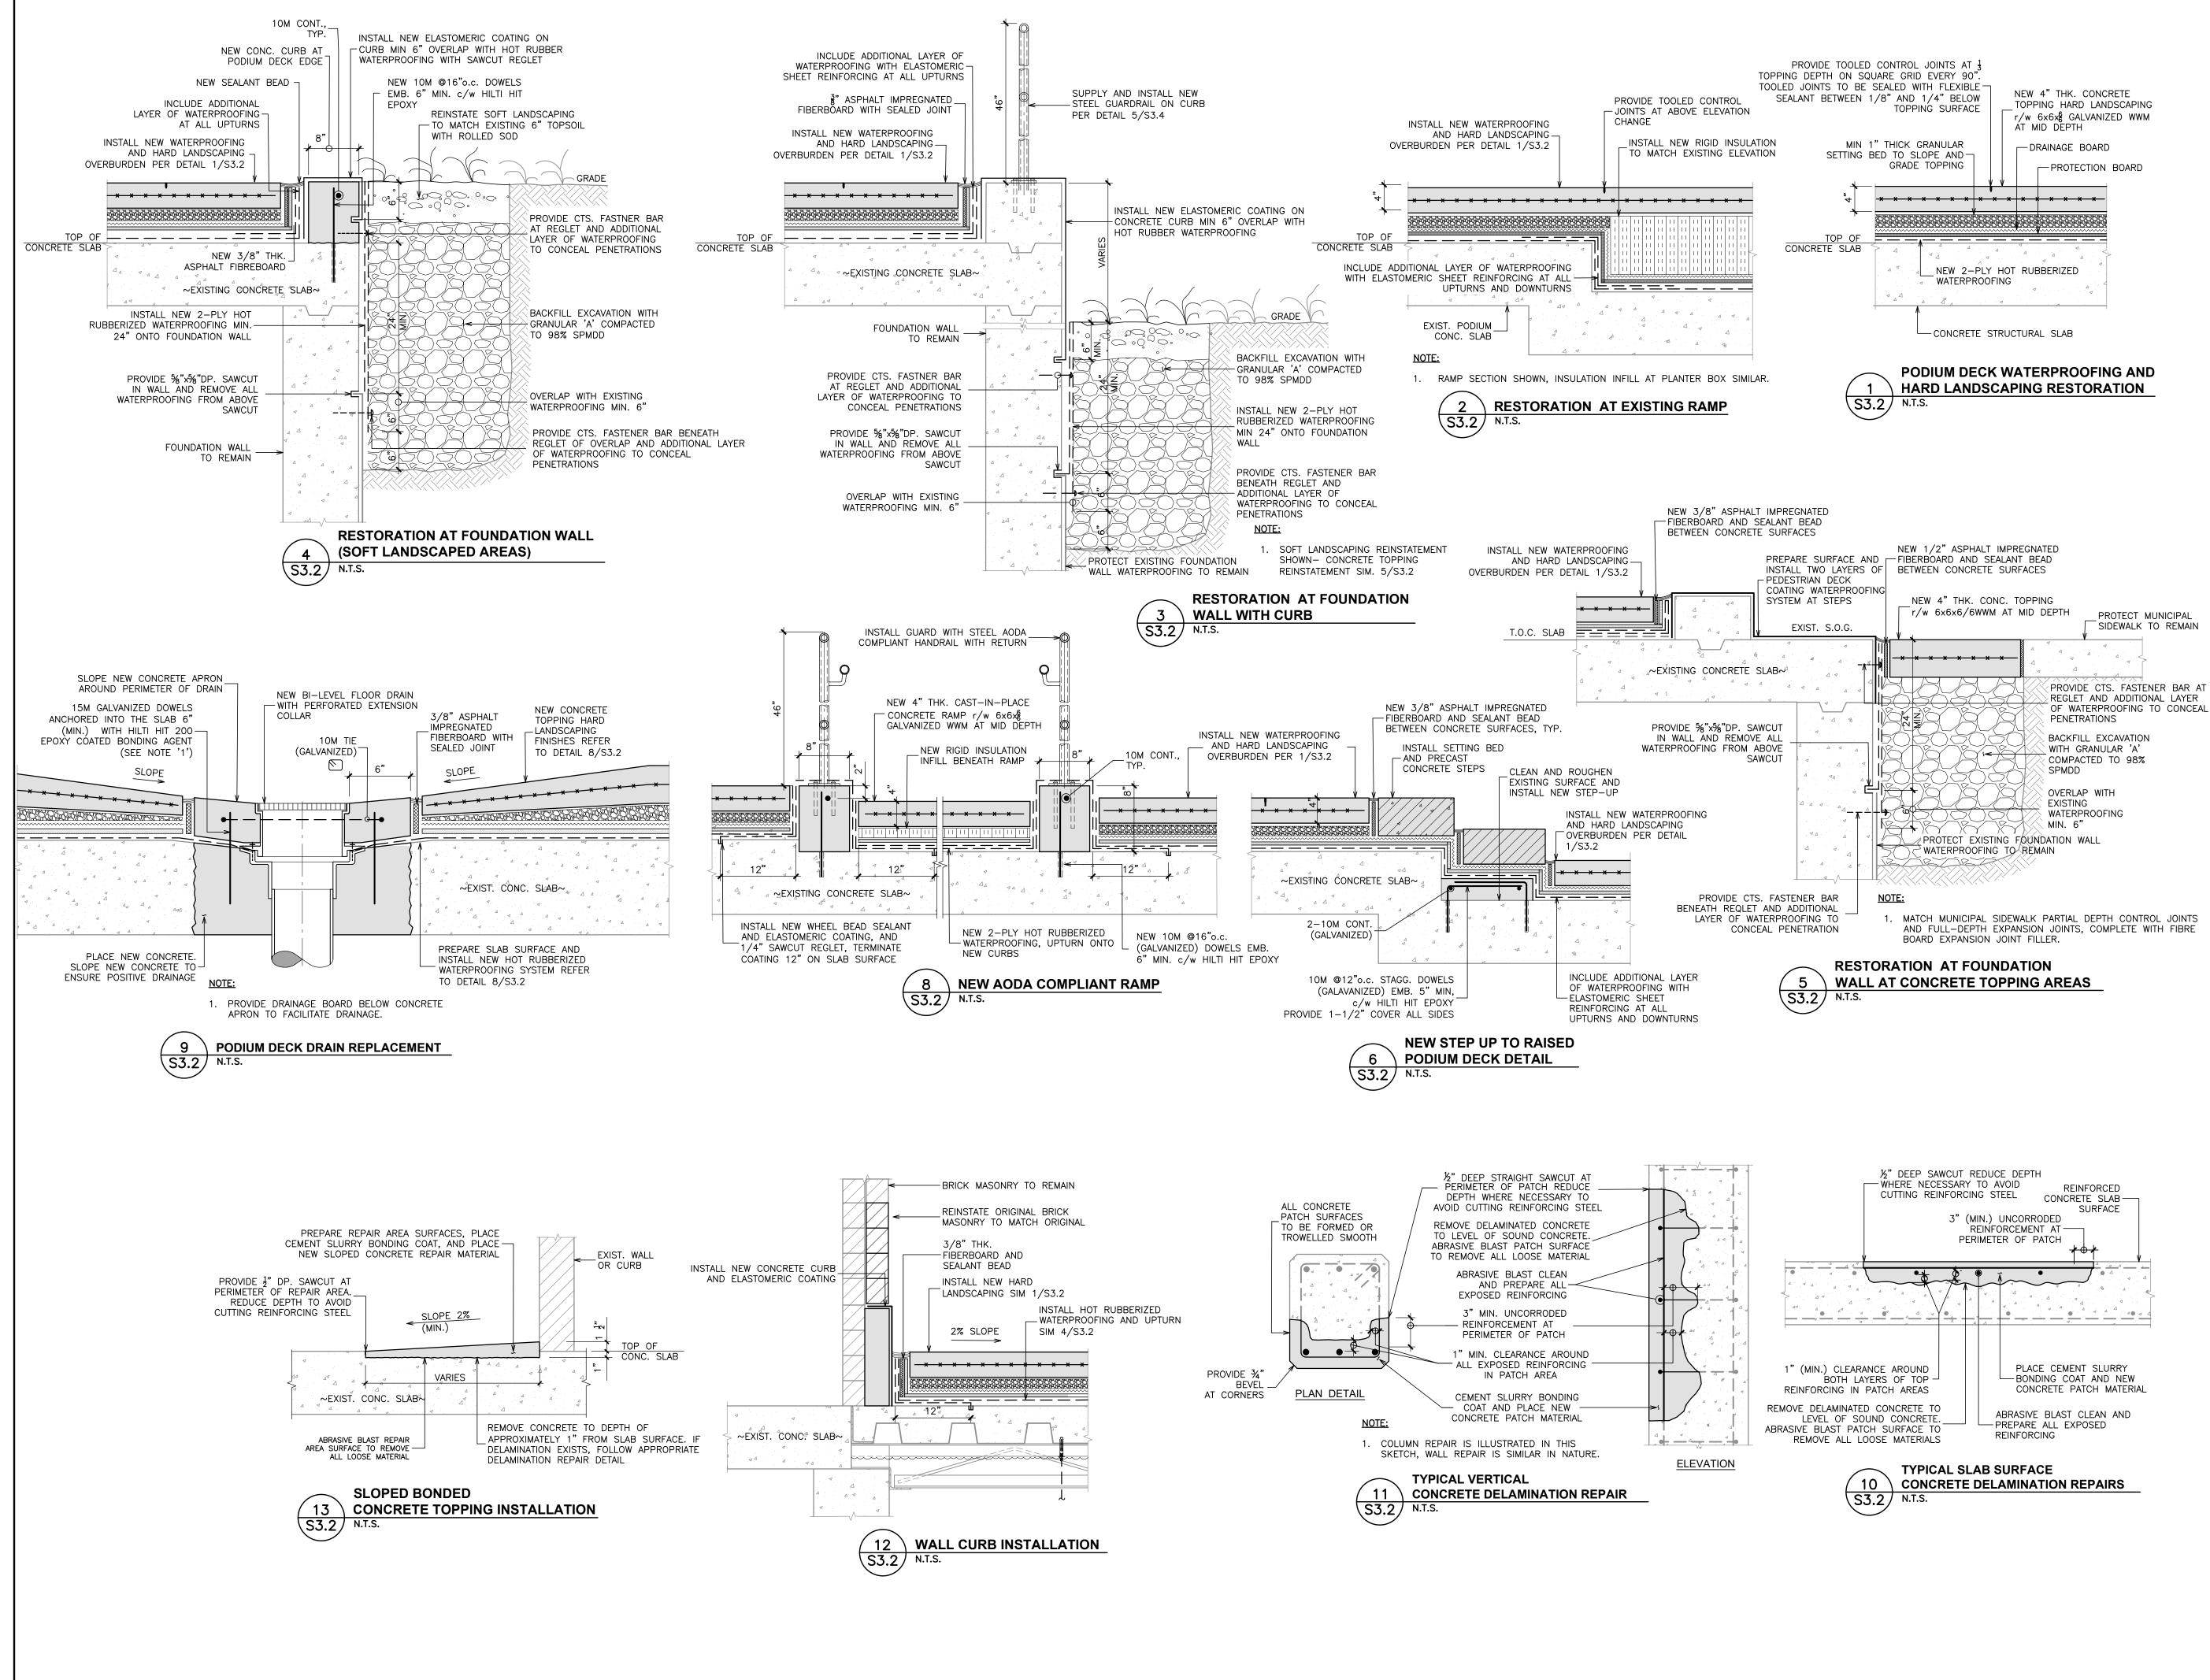
FAIRBANK MEMORIAL **COMMUNITY CENTRE -**PODIUM DECK REHABILITATION

Sheet Title

SECTIONS AND DETAILS

Drawn By	S.S.	Scale	N.T.S.
Designed By	C.J.C.	Date	February 26, 2025
RJC Project Number		TOR	.140332.0001
Sheet Number			Revision
624			

53.1

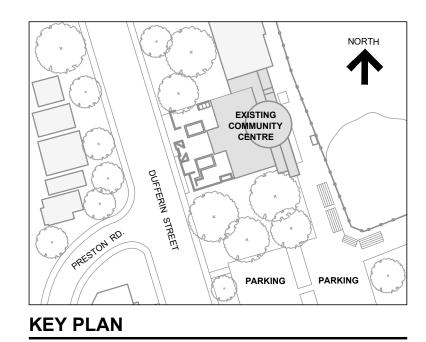






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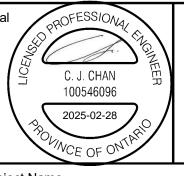
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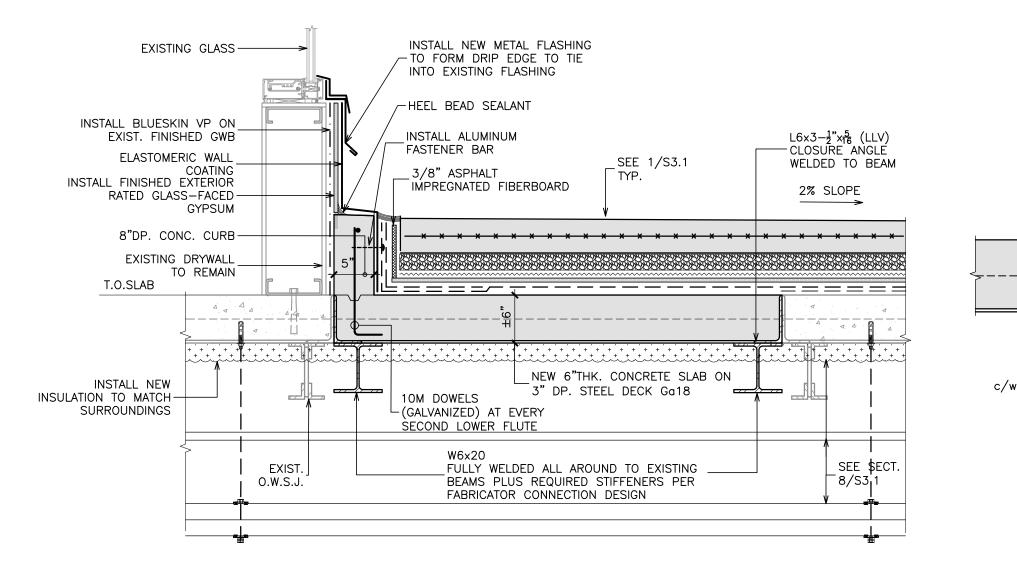
Project Name 2213 Dufferin Street, Toronto, Ontario

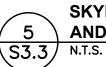
FAIRBANK MEMORIAL **COMMUNITY CENTRE -**PODIUM DECK REHABILITATION

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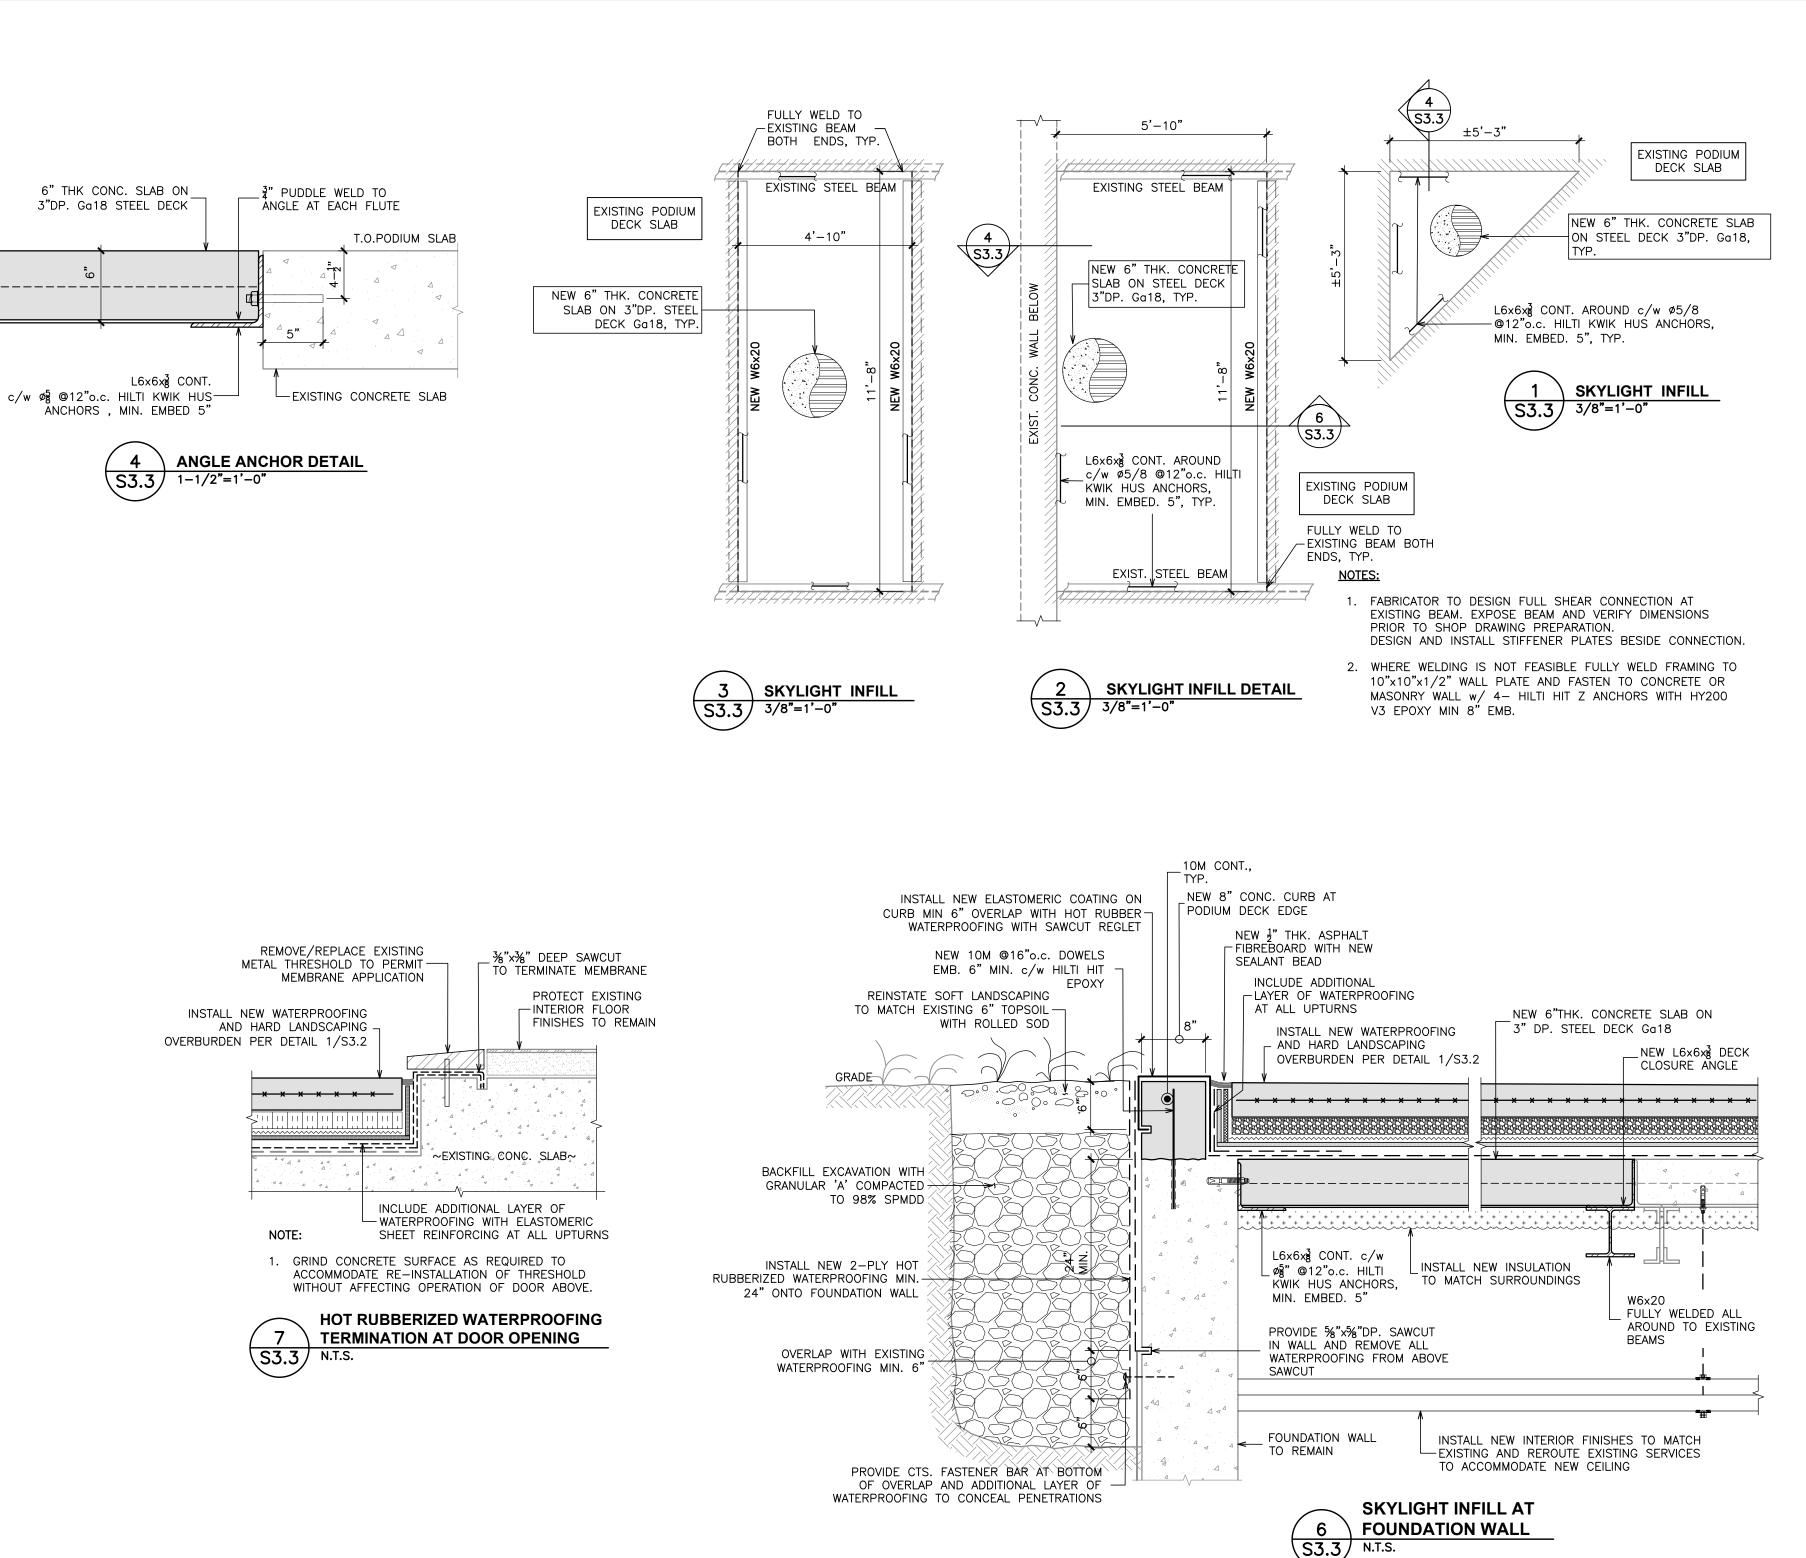
SECTIONS AND DETAILS

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Designed By	C.J.C.	Date	February 26, 2025
RJC Project Number		TOR	.140332.0001
Sheet Number			Revision
S3.2			





SKYLIGHT INFILL AND UPTURN

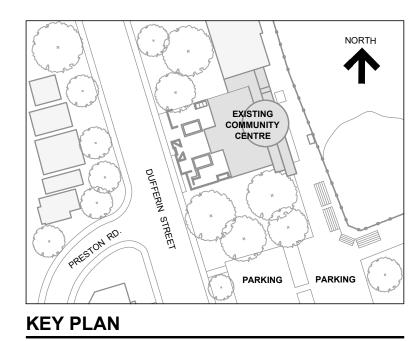


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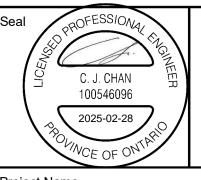
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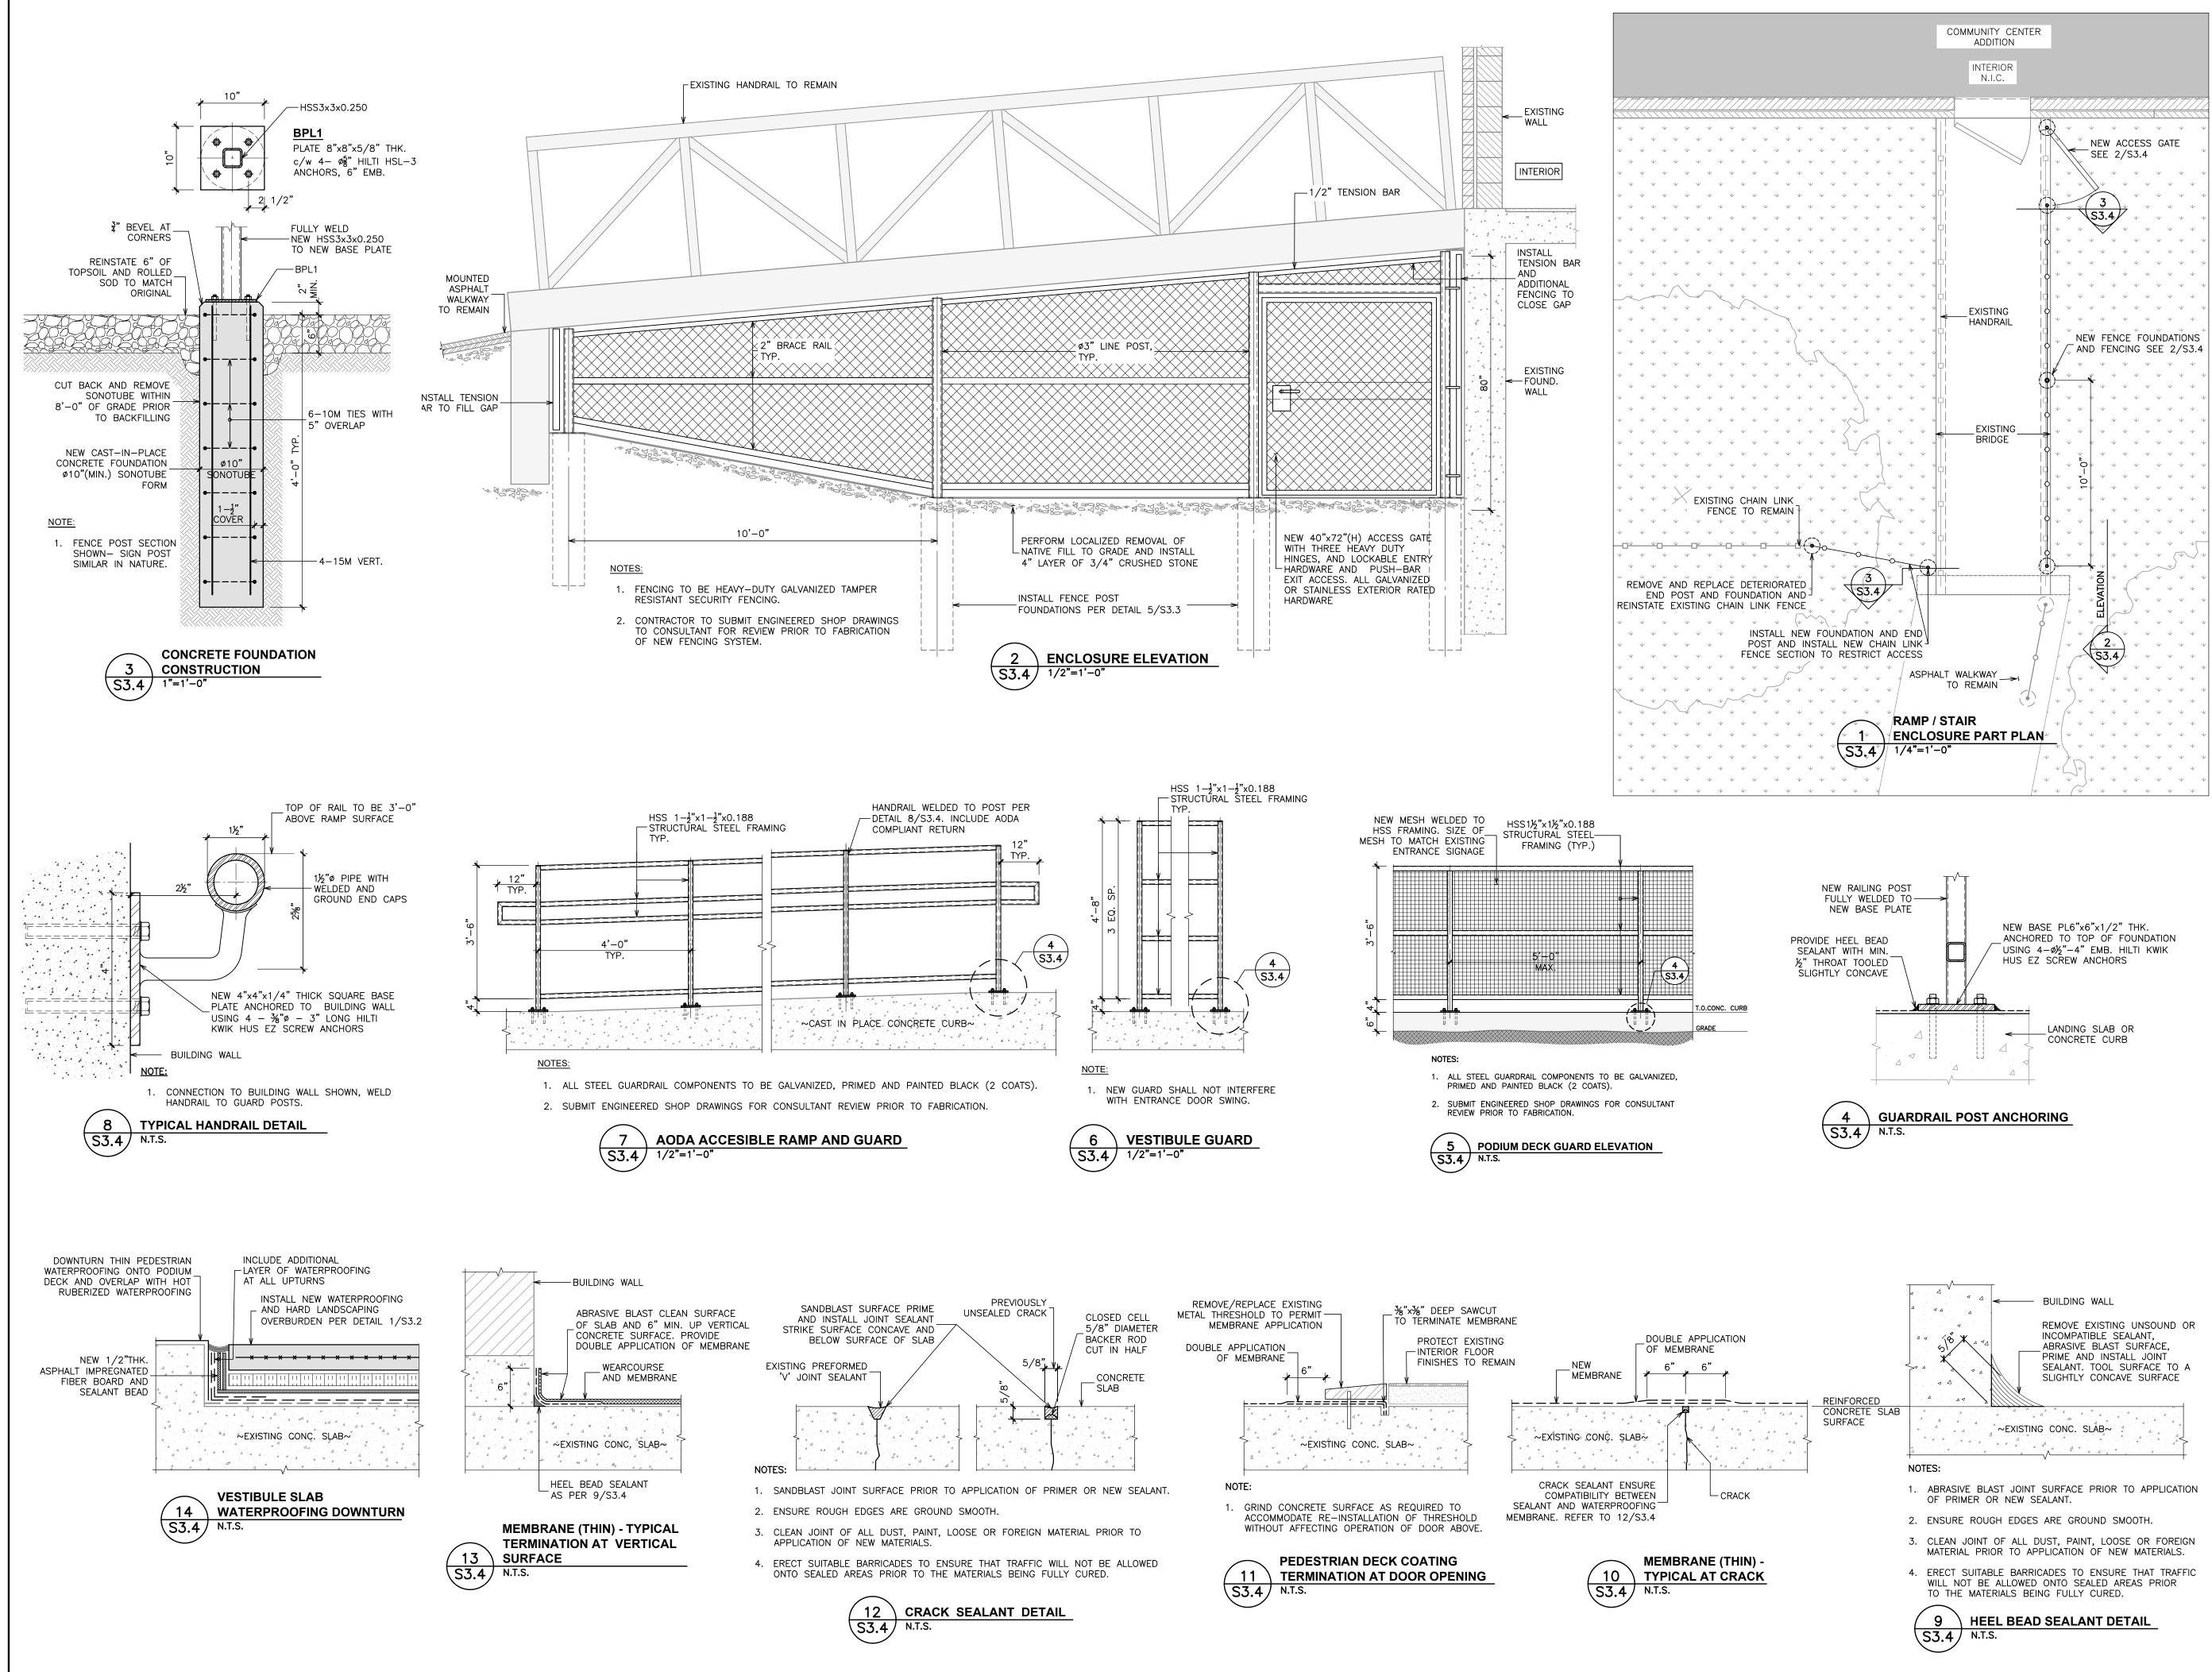
FAIRBANK MEMORIAL **COMMUNITY CENTRE -**PODIUM DECK REHABILITATION

Sheet Title

SECTIONS AND DETAILS

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Designed By	C.J.C.	Date	February 26, 2025
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S3.3

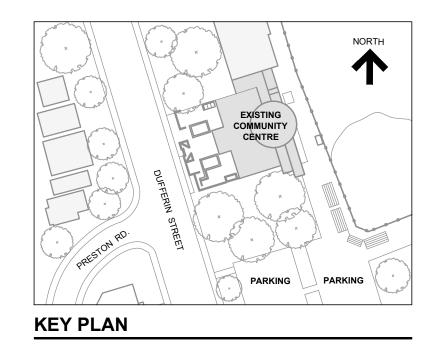






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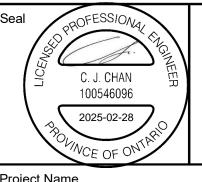
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FAIRBANK MEMORIAL **COMMUNITY CENTRE -**PODIUM DECK REHABILITATION

Sheet Title

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RJC Project Number		TOR	.140332.0001
Sheet Number			Revision
S3.4			-

ELECTRICAL LEGEND

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	POWER		
SYMBOL	DESCRIPTION		
Φ	125V, 15A DUPLEX U-GROUND RECEPTACLE UNLESS OTHERWISE NOTED.		
P 20A	DUPLEX RECEPTACLE AS ABOVE, CSA 5–20A TYPE.		
Ø Ø Ø	RECEPTACLES AS ABOVE BUT MOUNTED ABOVE COUNTER OR 42"AFF.		
gfi \oplus wp \oplus tl \oplus	RECEPTACLE AS ABOVE SUBSCRIPTS DENOTE SPECIAL TYPE AS PER ABBREVIATION LIST.		
	UNFUSED DISCONNECT SWITCH. SIZE TO SUIT OR AS NOTED. SEE ABBREVIATION FOR OTHER SUBCRIPTS.		
\sim	MOTOR AS INDICATED. INCLUDE FINAL CONNECTION.		
Ľ-	COMBINATION LINE VOLTAGE MOTOR STARTER AND SWITCH.		
J	JUNCTION BOX AS INDICATED.		
PL	120V DIRECT CONNECTION FOR USE AS NOTED. INCLUDE FINAL CONNECTION. 'PL' DENOTES FOR ELECTRONIC PLUMBING FIXTURES.		
۲	SPECIAL DIRECT CONNECTION FOR USE AS NOTE. INCLUDE FINAL CONNECTION.		
LP"A" LP"B"	FLUSH OR SURFACE MOUNTED ELECTRICAL PANEL RESPECTIVELY.		
	LIGHTING		
SYMBOL	DESCRIPTION		
F2 F3 -	LUMINAIRE, CEILING OR WALL MOUNTED RESPECTIVELY. LETTER DENOTES TYPE.		
L1L2	CEILING OR WALL MOUNTED LUMINAIRE RESPECTIVELY. LETTER DENOTES TYPE.		
\$\$\$	15A/20A 120V SINGLE POLE TOGGLE SWITCH(ES) WITH ONE, TWO OR THREE-GANG COVERPLATE RESPECTIVELY. SWITCHES RATING TO SUIT LIGHTING LOADS & BREAKER SIZE.		
D	DIMMER. LUTRON NOVA "T", 120V OR 347V AND CAPACITY TO SUIT LOADS.		
\cap			

ELECTRICAL DRAWING LIST

PHOTOCELL.

NUMBER	DESCRIPTION
E0.1	ELECTRICAL LEGEND, DRAWING LIST, KEY PLANS AND SCHEDULES
E0.2	ELECTRICAL - DEMOLITION AND NEW LAYOUT
E0.3	ELECTRICAL - SPECIFICATION

LUMINAIRE SCHEDULE

TYPE 'AA' (OUTDOOR) OUTDOOR CUT-OFF WALL PACK, LED, WP-LED SERIES WITH VISOR, SELECTABLE COLOUR TEMPERATURE, 5 ADJUSTABLE POWER SETTINGS

FINISH: BRONZE LAMP: LED, 3000K, 5712LM, 41W VOLTAGE: 120V (TO BE CONFIRMED ON SITE) MANUFACTURER: RAB DESIGN LIGHTING INC. CAT#WP-LED80A40 WITH CUTOFF VISOR BRZ

PC

TYPE 'BB' (OUTDOOR) OUTDOOR CEILING MOUNTED, LED, BLIZ SQUARE 40 SERIES FINISH: TEXTURED BLACK

LAMP: LED, 3000K, 2495LM, 40W VOLTAGE: 120V (TO BE CONFIRMED ON SITE) MANUFACTURER: PERFORMANCE IN LIGHTING CAT#BS4-0-40-BK-3K-120-NA OR APPROVED EQUAL

TYPE 'CC' (OUTDOOR) OUTDOOR CEILING MOUNTED, LED, ADJUSTABLE ANGLE, PROSPOT 3 SERIES FINISH: TEXTURED BLACK LAMP: LED, 3000K, 1212LM, 10W VOLTAGE: 120V (TO BE CONFIRMED ON SITE) OPTICS: 55* CORROSION RESISTANT FINISH

MANUFACTURER: INSIDE LIGHTING CAT#PS3-SO-30K-55 OR APPROVED EQUAL

THIS CONTRACTOR TO CONFIRM ON SITE EXISTING LIGHTS VOLTAGE. NEW LIGHTS VOLTAGE TO MATCH EXISTING.

SCOPE OF WORK AND GENERAL NOTES:

- THERE ARE TWO SPOTLIGHTS (ONE ON EACH SIDE OF THE ENTRANCE ALCOVE) AND ONE CEILING MOUNTED FIXTURE BENEATH THE ALCOVE AT THE FRONT ENTRANCE TO THE FAIRBANK HALL. REFER TO THE PHOTO ON DETAIL 3 OF DRAWING E0.2. 2 SPOTLIGHTS ILLUMINATE EAST AND WEST AREA IN FRONT OF THE BUILDING.
- . TWO (2) SPOTLIGHTS AND CEILING MOUNTED LIGHTS TO BE REPLACED. TWO (2) NEW WALL MOUNTED FIXTURES TO BE PROVIDED - REFER TO FLOOR PLAN FOR MORE DETAILS. WIRING FOR 2 NEW WALL FIXTURES TO BE EXTENDED FROM EXISTING CIRCUIT.
- ANY NEW WIRING TO BE INSTALLED "HIDDEN" ABOVE ALCOVE BOTTOM PANEL, DOWN ALONG EXTERIOR WALL IN RACEWAY, THRU WALL TO BACK BOX OF NEW WALLPACKS. RACEWAY TO BE CUSTOM COLOUR TO MATCH EXISTING BRICK WALL COLOUR. PROVIDE ALL REQUIRED FITTING, TRANSITIONS ETC. FOR RACEWAY FOR NEAT APPEARANCE.

WHERE EXISTING LIGHTS REPLACED WITH NEW INCLUDE IN CONTRACT FOR DECORATIVE PLATES TO COVER ANY GAPS AROUND NEW FIXTURES LEFT AFTER BIGGER EXISTING LIGHTS ARE REMOVED. COVER PLATE COLOUR TO MATCH ALCOVE PANEL COLOUR

- PRIOR TO ANY WORK THIS CONTRACTOR PROVIDE SITE INVESTIGATION TO CONFIRM THE FOLLOWING: STATE OF EXISTING WIRING FOR EXTERIOR LIGHTS. CONFIRM EXISTING WIRING FOR EXTERIOR LIGHTS IS IN GOOD CONDITION AND CAN BE RE-USED EXISTING LIGHTING CUICUIT(S) EXISTING LIGHTING CONTROL
- CONFIRM HOW MANY LIGHTS (IN ADDITION TO IDENTIFIED ON FLOOR PLANS) AND WHAT TYPE OF LIGHTS ARE ON THE SAME POWER AND CONTROLS CIRCUIT. REPORT FINDINGS BACK TO CONSULTANTS
- INCLUDE FOR MINIMUM 10 HOURS OF SITE INVESTIGATION
- . PROVIDE SEPARATE PRICE FOR REPLACEMENT OF EXISTING WIRING. ALL NEW WIRING TO BE INSTALLED BEHIND FINISHED SURFACES (ABOVE EXISTING CEILINGS OR/AND WITHIN WALLS). "SEPARATE PRICE" TO BE IN ADDITIONAL TO BASE BID PRICE. BID PRICE TO BE
- 5. ELECTRICAL CONTRACTOR SHALL ASSUME RESPONSIBILITY FOR ANY DISRUPTION CAUSE BY HIS FORCES TO OPERATIONAL BUILDING SERVICES. REPAIR ANY SYSTEM DAMAGED DURING THE EXECUTION OF THE WORK.
- WHENEVER APPLICABLE: ANY SHUT-DOWN OF BUILDING SERVICES SHALL HAVE THE APPROVAL OF THE CLIENT. COORDINATE WITH THE CLIENT AND THE GENERAL CONTRACTOR TO MINIMIZE DISRUPTION TO THE EVERY OPERATION OF THE BUILDING.
- 5. THE WORK SHALL BE CARRIED OUT AT ALL TIME IN A MANNER THAT DOES NOT DISTURB CURRENT BUILDING OPERATION. THE PREMISES SHALL BE LEFT IN A SAFE CLEAN CONDITION SUITABLE FOR OCCUPANT'S WORK AT THE BEGINNING OF EACH WORK DAY DURING CONSTRUCTION.
- PROVIDE UPDATED PANEL DIRECTORY FOR EACH EXISTING PANEL. PROVIDE NEW TYPED DIRECTORY FOR EXISTING PANEL.
- 8. ALL EXISTING EQUIPMENT AND DEVICES SHALL REMAIN UNLESS OTHERWISE NOTED. 9. ALLOW CUTTING AND PATCHING AT EXISTING WALLS/CEILINGS TO RUN CONDUITS/WIRING.
- 10. ANY NEW PROPOSED SURFACE MOUNTED CONDUIT ROUTING TO BE APPROVED BY THE CONSULTANT OR/AND CLIENT BEFORE INSTALLATION.
- 11. EXISTING TIMER TO BE REPLACED WITH PHOTOCELL. NEW PHOTOCELL TO BE SUITABLE FOR NEW LED LIGHTS AND ANY OTHER EXISTING LIGHTS TYPE ON THE SAME CIRCUIT.

SEPARATE PRICE

PROVIDE SEPARATE PRICE FOR REPLACEMENT OF EXISTING WIRING. PROVIDE NEW WIRING FROM EXISTING PANEL 'E' LOCATED IN THE LOBBY.

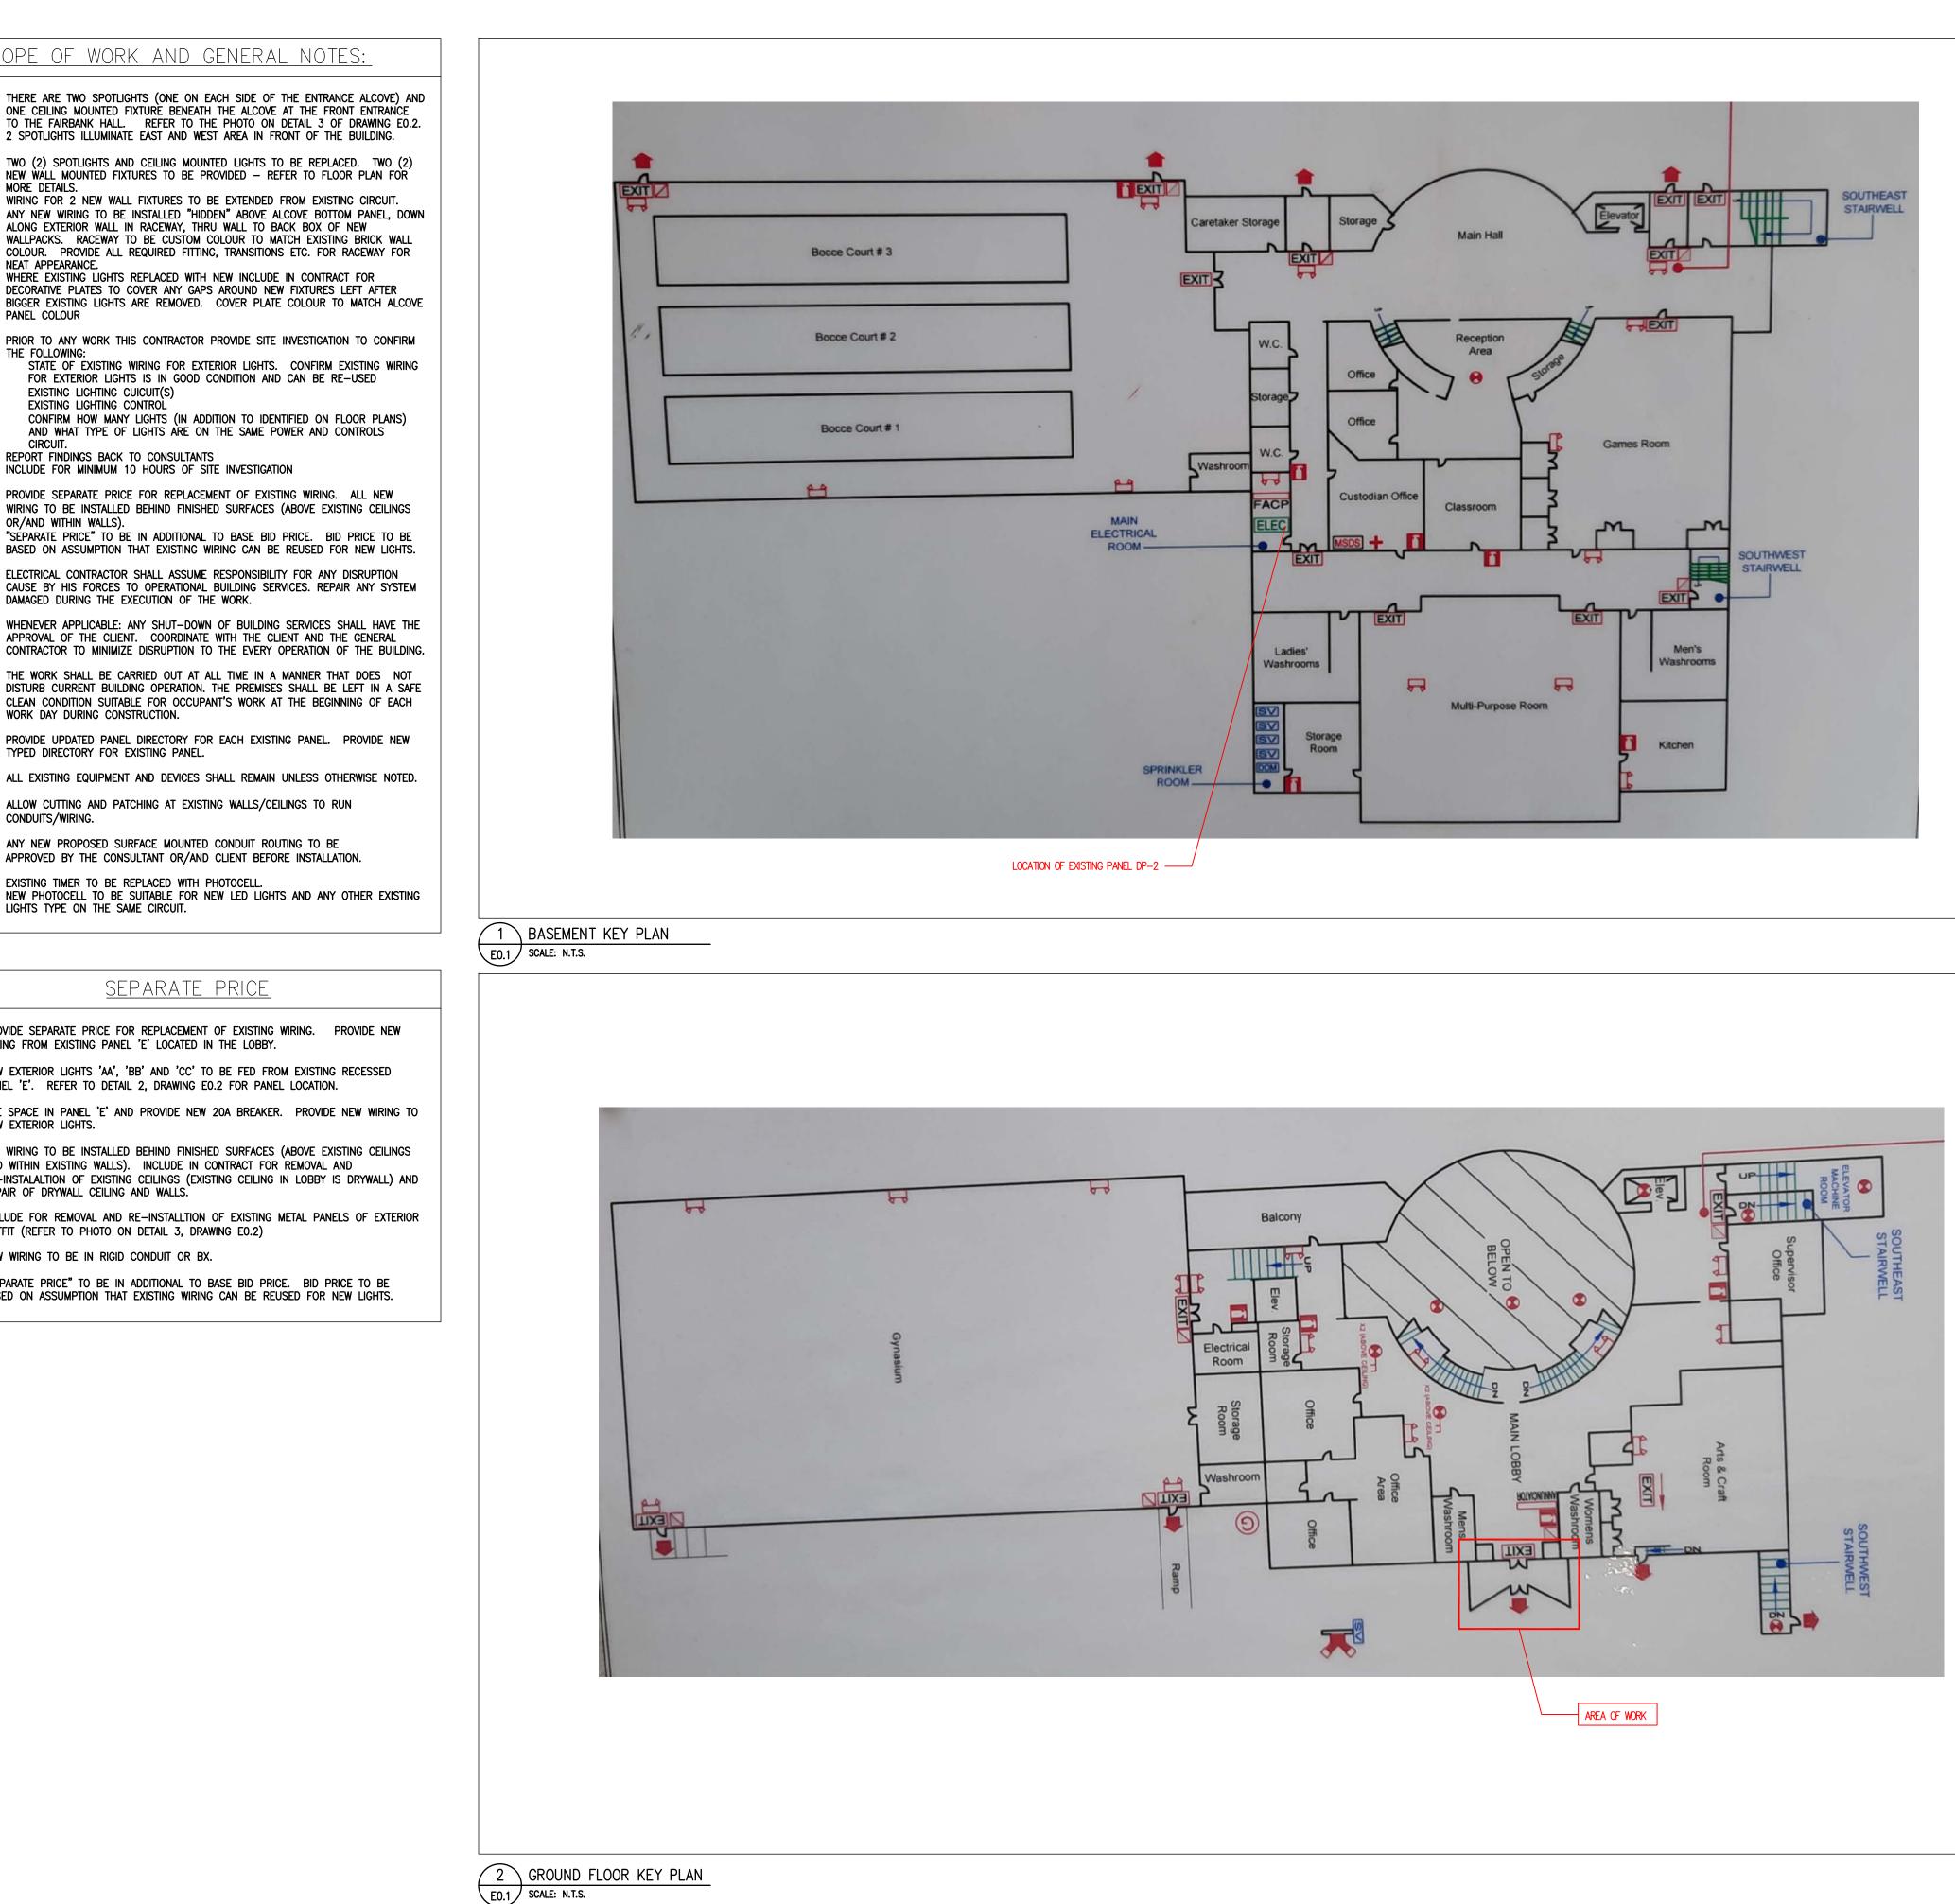
NEW EXTERIOR LIGHTS 'AA', 'BB' AND 'CC' TO BE FED FROM EXISTING RECESSED PANEL 'E'. REFER TO DETAIL 2, DRAWING E0.2 FOR PANEL LOCATION.

USE SPACE IN PANEL 'E' AND PROVIDE NEW 20A BREAKER. PROVIDE NEW WIRING TO NEW EXTERIOR LIGHTS.

ALL WIRING TO BE INSTALLED BEHIND FINISHED SURFACES (ABOVE EXISTING CEILINGS AND WITHIN EXISTING WALLS). INCLUDE IN CONTRACT FOR REMOVAL AND RE-INSTALALTION OF EXISTING CEILINGS (EXISTING CEILING IN LOBBY IS DRYWALL) AND REPAIR OF DRYWALL CEILING AND WALLS.

INCLUDE FOR REMOVAL AND RE-INSTALLTION OF EXISTING METAL PANELS OF EXTERIOR SOFFIT (REFER TO PHOTO ON DETAIL 3, DRAWING E0.2) NEW WIRING TO BE IN RIGID CONDUIT OR BX.

"SEPARATE PRICE" TO BE IN ADDITIONAL TO BASE BID PRICE. BID PRICE TO BE BASED ON ASSUMPTION THAT EXISTING WIRING CAN BE REUSED FOR NEW LIGHTS.

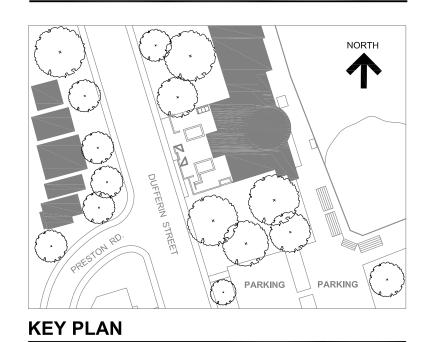




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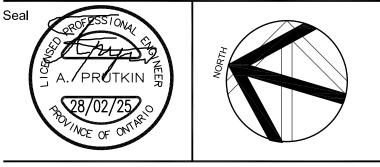


SHARMA & PARTNERS INC. Mechanical and Electrical Engineers 85 Curlew Drive, Unit 108, Toronto, Ontario

M3A 2P8 Tel.:(416) 291–8822

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SPI PROJECT #: 2025-1004



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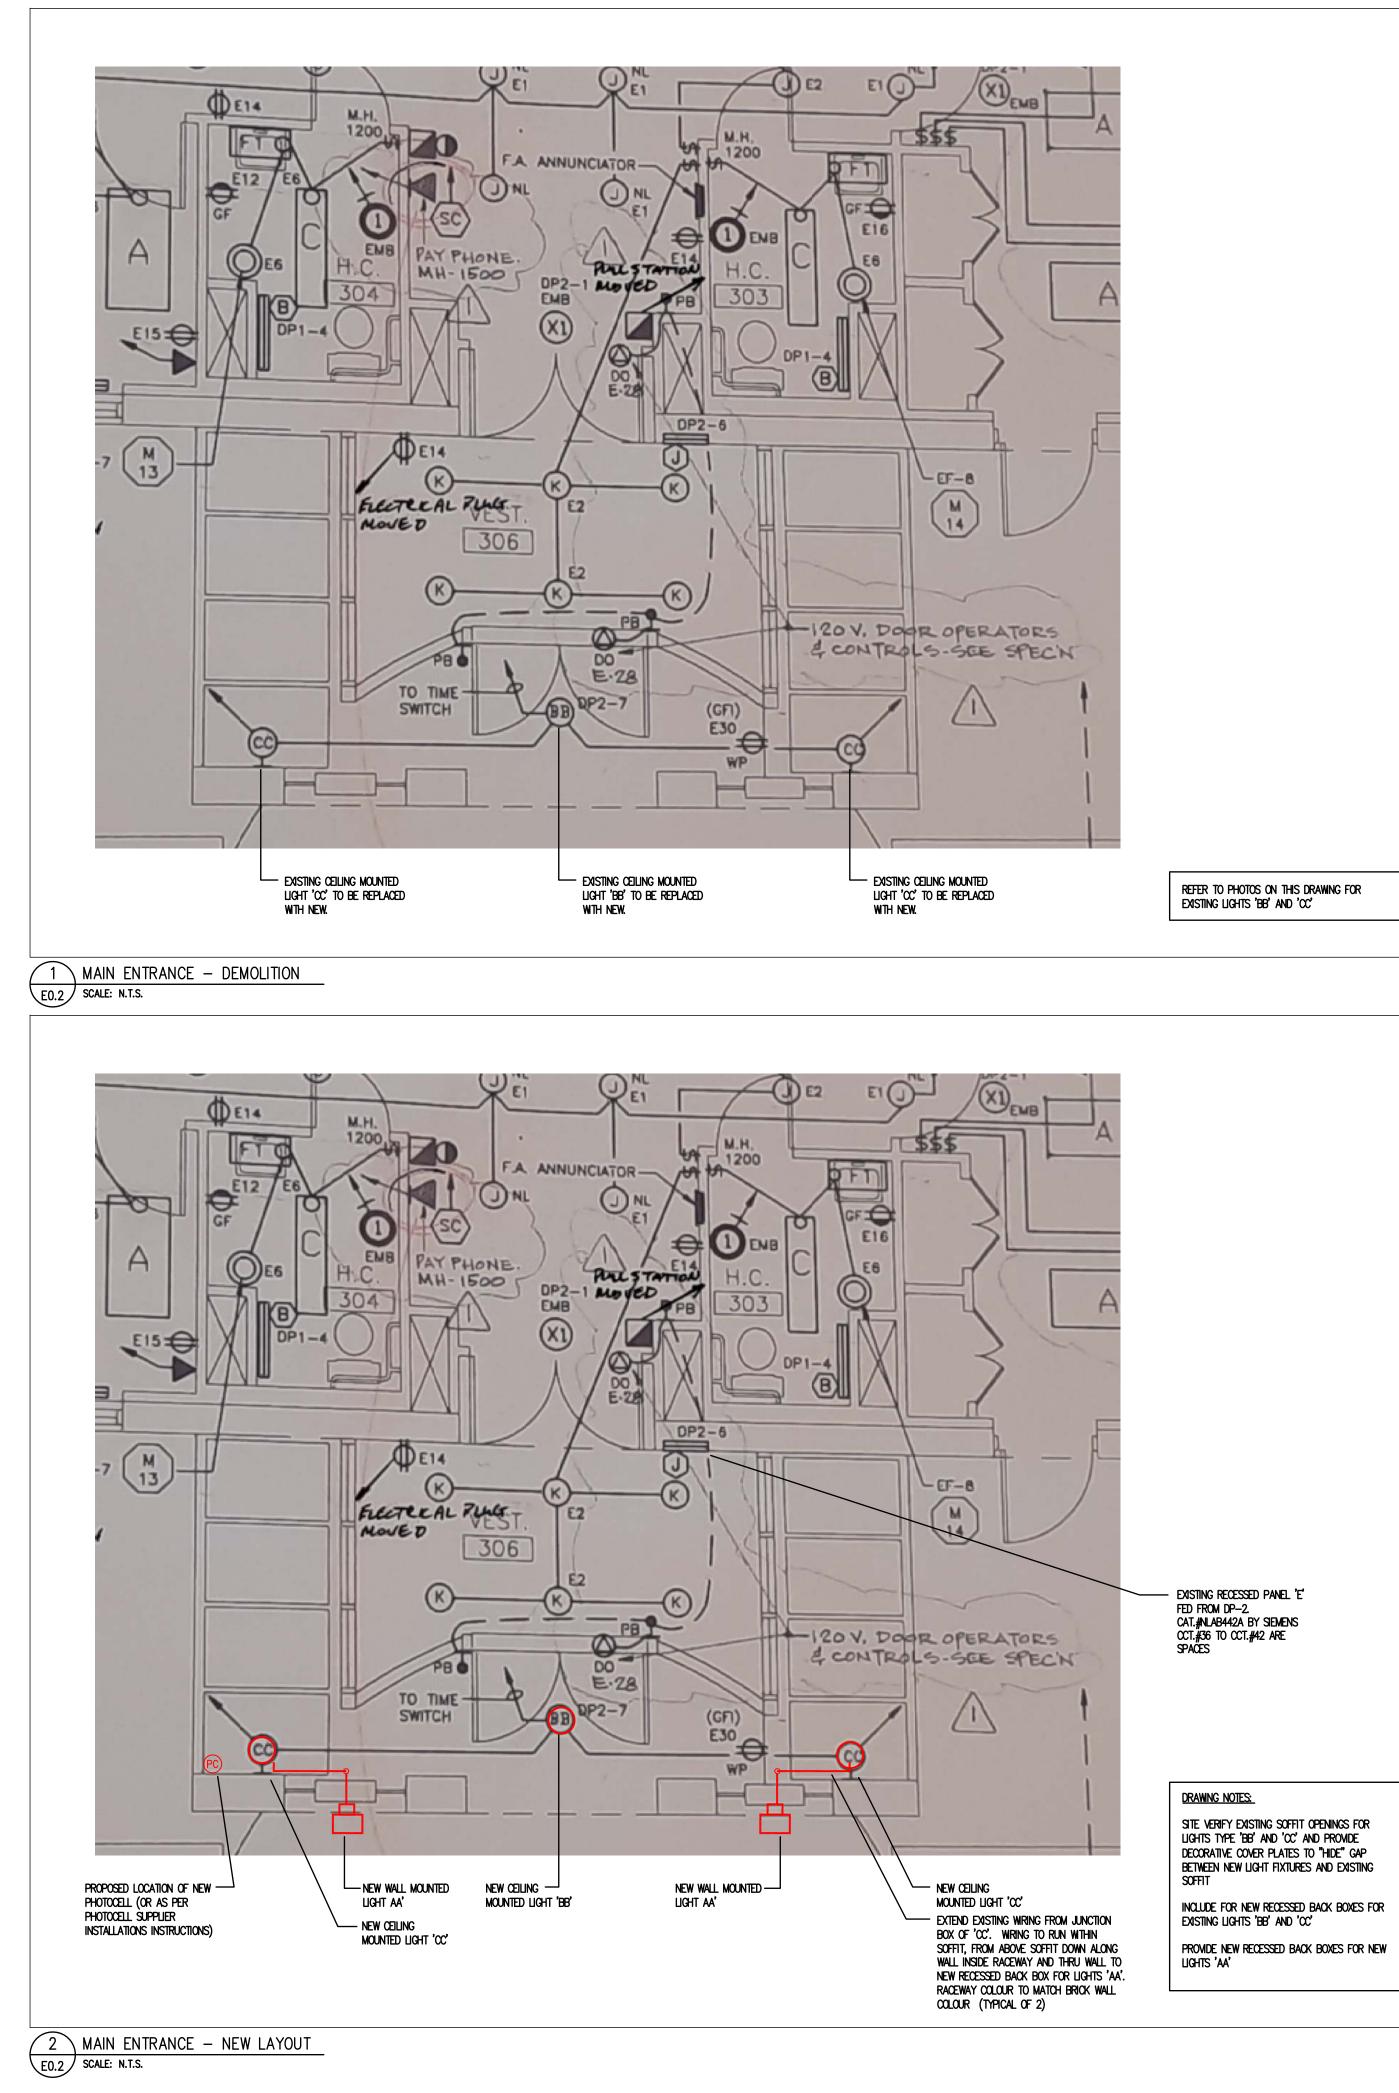
FAIRBANK MEMORIAL **COMMUNITY CENTRE -**PODIUM DECK REHABILITATION

Sheet Title

ELECTRICAL LEGEND, DRAWING LIST, KEY PLANS AND SCHEDULES

Drawn By	CAD	Scale	N.T.S.
Designed By	ΑΡ	Date	February 28, 2025
RJC Project Number		TOR	.140332.0001
Sheet Number			Revision

E0.1



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REFER TO PHOTOS ON THIS DRAWING FOR

SITE VERIFY EXISTING SOFFIT OPENINGS FOR LIGHTS TYPE 'BB' AND 'CC' AND PROVIDE DECORATIVE COVER PLATES TO "HIDE" GAP BETWEEN NEW LIGHT FIXTURES AND EXISTING

INCLUDE FOR NEW RECESSED BACK BOXES FOR EXISTING LIGHTS 'BB' AND 'CC'



3 MAIN ENTRANCE ALCOVE – EXISTING LIGHTS E0.2 SCALE: N.T.S.



4 MAIN ENTRANCE FRONT VIEW - NEW WALL MOUNTED LIGHTS E0.2 SCALE: N.T.S.

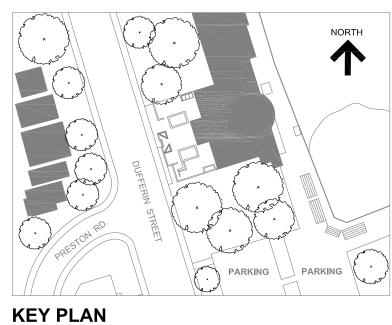


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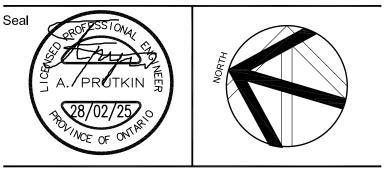
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FAIRBANK MEMORIAL **COMMUNITY CENTRE -**PODIUM DECK REHABILITATION

Sheet Title ELECTRICAL

DEMOLITION AND NEW LAYOUT

Drawn By	CAD	Scale	N.T.S.
Designed By	ΑΡ	Date	February 28, 2025
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Sheet Number			Revision

E0.2

GENERAL ELECTRICAL CONDITIONS - SECTION 26 05 00

1. COMPLY WITH GENERAL CONDITIONS OF THE CONTRACT AND ELECTRICAL DIVISION DRAWINGS AND SPECIFICATIONS.

- 2. THIS SECTION APPLIES TO ALL SECTIONS OF ELECTRICAL DIVISION.
- 3. PROVIDE EACH ITEM MENTIONED OR INDICATED OF QUALITY AND SUBJECT TO QUALIFICATIONS NOTED; PERFORM ACCORDING TO CONDITIONS STATED EACH OPERATION PRESCRIBED; AND PROVIDE THEREFORE ALL LABOUR, MATERIAL, EQUIPMENT, INCIDENTALS AND SERVICES REQUIRED TO COMPLETE THE INSTALLATION.
- 4. OTHER WORK BY THIS DIVISION
- 1. PAINTING OF EXPOSED CONDUITS, UNFINISHED ELECTRICAL EQUIPMENT: UNDER ELECTRICAL DIVISION.

CONCRETE WORK - UNDER ELECTRICAL DIVISION. CUTTING AND PATCHING WILL BE BY ELECTRICAL DIVISION. PATCHING SHALL BE OF SAME MATERIAL AS SURROUNDING AREA AND SHALL BE PAINTED OR FINISHED TO MATCH EXISTING.

- 5. MAKE A SET OF WHITE PRINTS AND AS THE JOB PROGRESSES, MARK ON CHANGES MADE THROUGH ANY APPROVED CHANGE ORDER AS WELL AS THE LOCATION OF FEEDERS, CONDUIT RUNS, JUNCTION BOXES, AND ALL CHANGES IN CIRCUITING, LOCATION OF EQUIPMENT, RUNS OF CONDUITS, WIRING, ETC. FROM THAT ORIGINALLY SHOWN, SO THAT ON THE COMPLETION OF THE JOB THE RECORD DRAWINGS WILL SHOW THE EXACT LOCATION AS ACTUALLY INSTALLED. RECORD DRAWINGS SHALL BE KEPT AT THE SITE AND SHALL BE BROUGHT UP TO DATE AS THE WORK PROGRESSES. SUBMIT COMPLETED RECORD DRAWINGS BEFORE FINAL CERTIFICATE OF JOB ACCEPTANCE IS ISSUED.
- 6. THE FOLLOWING DOCUMENTS SHALL BE SUBMITTED TO THE CONSULTANT ON THE COMPLETION OF THE PROJECT AS DESCRIBED ABOVE:
- ESA ELECTRICAL INSPECTION CERTIFICATE - AS_BUILT DRAWINGS (PDF AND HARD COPY). AS-BUILT DRAWINGS SHALL RECORD ALL CHANGES TO DESIGN. OPERATION AND MAINTENANCE MANUALS.
- GUARANTEE
- 7. ALL MATERIAL SHALL BE STORED NEATLY AND OUT OF THE WAY. CLEAN UP DAILY ALL REFUSE CAUSED BY WORK.
- 8. BIND WITHIN A HARD_COVERED, LOOSE_LEAF BINDER, A COMPLETE SET OF MANUFACTURER'S OPERATING AND MAINTENANCE INSTRUCTIONS SHOWING ALL MAJOR ELECTRICAL EQUIPMENT AND SYSTEMS. INCLUDE SHOP DRAWINGS AND DETAIL DRAWINGS. INSTRUCTIONS SHALL BE COMPLETE FOR INSTALLATION, OPERATION AND MAINTENANCE. SPARE PART SUPPLIERS, LISTS AND ADDRESSES SHALL BE INCLUDED. MAKE ANY ADDITIONS AND/OR CORRECTIONS REQUIRED BY THE CONSULTANT AND SUBMIT TWO CORRECT COPIES TO THE CONSULTANT. INSTRUCTIONS SHALL BE REVIEWED WITH THE OPERATING PERSONNEL TO ENSURE A THOROUGH UNDERSTANDING OF THE EQUIPMENT AND ITS OPERATION.
- 9. EXAMINE THE SITE, EXISTING EQUIPMENT AND THE LOCAL CONDITIONS AFFECTING THE WORK UNDER THIS CONTRACT. NO ALLOWANCE WILL BE MADE SUBSEQUENTLY FOR ANY OBVIOUS CONSIDERATIONS OVERLOOKED.
- 10. AFTER THE WORK IS COMPLETE BUT BEFORE FINAL PAYMENT, GIVE THE OWNER A WRITTEN GUARANTEE THAT YOU WILL, AT NO CHARGE TO THE OWNER, REPLACE OR REPAIR ANY DEFECTS IN WORKMANSHIP AND MATERIALS NOT DUE, IN THE OPINION OF THE PRIME CONSULTANT TO MISUSE OR NEGLECT. GUARANTEE SHALL COVER A PERIOD OF 12 MONTHS FROM THE DATE OF ACCEPTANCE OF THE WORK BY THE PRIME CONSULTANT. THIS GUARANTEE SHALL IN NO WAY SUPPLANT ANY OTHER GUARANTEE OR GUARANTEES OF LONGER PERIOD, BUT SHALL BE BINDING ON ALL OTHER WORK NOT OTHERWISE COVERED.
- 11. ALL WORK SHALL COMPLY STRICTLY TO THE REQUIREMENTS OF THE LATEST EDITIONS OF THE CANADIAN ELECTRICAL CSA CODE AS ADOPTED AND AMENDED BY PROVINCIAL REGULATIONS AND THE BUILDING CODE. THESE CODES AND ANY ADDITIONAL REQUIREMENTS OF THE POWER UTILITY SHALL FORM AN INTEGRAL PART OF THIS SPECIFICATION. WHERE DRAWINGS CALL FOR EQUIPMENT, WIRING OR OTHER REQUIREMENTS EXCEEDING THE MINIMUM REQUIREMENTS OF THE CODE, THE DRAWINGS SHALL BE FOLLOWED.
- 12. BEFORE STARTING ANY WORK, SUBMIT THE REQUIRED NUMBER OF COPIES OF THE ELECTRICAL DRAWINGS TO THE POWER AUTHORITY AND ELECTRICAL INSPECTION DEPARTMENT REGIONAL OFFICE, FOR THEIR APPROVAL AND COMMENTS.
- 13. PAY ALL FEES FOR EXAMINATION OF DRAWINGS AND OBTAIN ALL PERMITS REQUIRED AND PAY ALL PERMIT AND INSPECTION FEES.
- 14. ARRANGE FOR INSPECTION OF ALL WORK BY THE POWER AUTHORITY AND INSPECTION DEPARTMENT. ON COMPLETION OF THE WORK, PRESENT TO THE OWNER THE FINAL UNCONDITIONAL CERTIFICATE OF APPROVAL.
- 15. ON AWARD OF CONTRACT, SUBMIT FOR REVIEW LIST OF DELIVERY DATES AND ELECTRONIC COPY OF SHOP DRAWINGS FOR ALL EQUIPMENT.
- 16. ALL MATERIALS SHALL BE NEW AND FREE FROM DEFECTS, NOISE AND VIBRATION. ALL EQUIPMENT SHALL BE CSA APPROVED.
- 17. SCHEDULE AND COORDINATE ALL WORK WITH OTHER TRADES. RELOCATE OR REPLACE CONDUIT OR EQUIPMENT WHICH INTERFERES WITH OTHER TRADES DUE TO LACK OF COORDINATION WITH OTHER TRADES.
- 18. THE OWNER SHALL HAVE TEMPORARY USE OF INSTALLATION PRIOR TO FINAL ACCEPTANCE.
- 19. ALL CLAIMS FOR EXTRAS SHALL BE SUPPORTED BY WRITTEN AUTHORIZATION AND SHALL BE SUBMITTED WITH ITEMIZED MATERIAL AND LABOUR COSTS BREAKDOWNS. THE FORMAT OF THE BREAKDOWN SHALL FOLLOW THAT OF THE CHANGE DOCUMENT (I.E. THAT OF THE NOTICE OF CHANGE, SITE INSTRUCTION, CHANGE DIRECTIVE, ETC.). MATERIALS SHALL BE PRICED AT COST INCLUDING ANY DISCOUNT. LABOUR UNITS SHALL BE BASED ON CECA AND NECA LABOUR UNIT TABLES SUITABLE FOR THE TYPE OF WORK INVOLVED. THERE SHALL BE NO EXTRA CLAIM FOR RELOCATION OF ANY EQUIPMENT WITHIN 10 FEET (3M) FROM THE ORIGINAL LOCATION, PROVIDED THAT THE CHANGE IS MADE BEFORE INSTALLATION.
- 20. ALL ELECTRICAL EQUIPMENT MOUNTED AND CONNECTED BY THIS CONTRACTOR, WHETHER SUPPLIED BY HIM OR NOT, SHALL BE IDENTIFIED BY MEANS OF PLASTIC NAMEPLATES.

21. WIRING

L

- 1. ALL WIRING SHALL BE CONCEALED EXCEPT IN UNFINISHED AREAS AND IN AREAS NOTED WHERE WIRING MAY BE INSTALLED IN SURFACE CONDUITS. RIGID STEEL CONDUITS SHALL BE USED IN:
- ALL EXPOSED WIRING SUBJECT TO MECHANICAL DAMAGE, ALL AREAS REQUIRED BY CODE.
- 3. EMT CONDUITS MAY BE USED WHERE PERMITTED BY CODE:
- EXPOSED WIRING, IN FURRED WALLS.

4. ARMOURED FLEXIBLE CABLE TYPE AC90 (BX CABLE) MAY BE USED AS DROP CABLE FROM JUNCTION BOX TO LIGHT FIXTURES, RECEPTACLES AND MOTORS IF RUN IN HOLLOW PARTITIONS OR IN DRY ACCESSIBLE CEILING SPACES. MAXIMUM LENGTH 20FT.

FLEXIBLE CONDUIT SHALL BE USED FOR FINAL SHORT CONNECTIONS BETWEEN OUTLET AND ELECTRICAL EQUIPMENT SUCH AS RECESSED FIXTURES, MOTORS, TRANSFORMERS, MOTORIZED EQUIPMENT AND FIXED APPLIANCES. FLEXIBLE CONDUIT IN MECHANICAL ROOMS AND ON THE EXTERIOR WALL SHALL BE PVC JACKETED, LIQUID TIGHT. 6. HOME RUNS OF WIRING TO PANELS SHALL BE IN CONDUITS.

- 22. ALL LOW VOLTAGE AND MULTI CONDUCTOR CABLES SHALL BE INSTALLED IN CONDUIT.
- 23. ALL CONDUCTORS SHALL BE COPPER 600 VOLT GRADE WITH INSULATION TYPE RW90. MINIMUM CONDUCTOR SIZE SHALL BE #12 AWG AND COLOUR CODED. WIRE CONNECTIONS SHALL BE MADE WITH PRESSURE TYPE SOLDERLESS CONNECTOR'S WITH VINYL INSULATING CAPS AND LOCKING RINGS.

1. MAXIMUM LENGTH FOR 15 AMP, 120/208 VOLT BRANCH CIRCUIT HOME RUNS SHALL BE AS FOLLOWS:

LOAD #12 AWG	#10 AWG
RECEPTACLE 65 FT (20M)	OVER 65 FT (20M)
LIGHTING 90 FT (27M)	OVER 90 FT (27M)

- 24. SUPPLY AND INSTALL ALL NECESSARY ACCESS DOORS IN WALLS AND CEILINGS FOR ELECTRICAL DEVICES AND EQUIPMENT INCLUDING BUT NOT LIMITED TO DISCONNECTS, JUNCTION BOXES ETC . WHERE NECESSARY, DOORS SHALL BE RATED TO SUIT FIRE ASSEMBLY RATING.
- 25. IF NUMBER OF CONDUCTORS IN ANY ONE CONDUIT EXCEEDS 6 LINE CONDUCTORS, CONDUCTOR SIZE SHALL BE INCREASED TO ALLOW FOR DERATING AS REQUIRED BY CODE.
- 26. ALL CONDUITS AND OUTLET BOXES SHALL BE SUPPORTED FROM THE BUILDING SURFACES AND SHALL NOT BE SUPPORTED FROM OTHER CONDUITS, DUCTS OR PIPES.
- 27. PROVIDE FIRE STOPS. FIRE STOPS SHALL SEAL OFF ALL FIRE RATED WALLS AND CEILINGS. FIRE STOPS SHALL BE CSA AND UL LISTED AND SHALL BE DESIGNED FOR APPLICATION REQUIRED TO MEET THE VARIOUS FIRE RATED SEPARATIONS. FIRE STOP SHALL BE HILTI, TREMSTOP MANUFACTURED BY TREMCO, 3M OR EQUAL.

LIGHTING - SECTION 26 50 00

- DRAWINGS.
- 2. ALL NEW LIGHT FIXTURES TO BE LED TYPE.
- 3. SUBMIT SHOP DRAWINGS FOR EACH LIGHTING FIXTURE TYPE.
- - LED LIGHTS WITHIN 90 DAYS.

 - SCRATCHES DUE TO HANDLING OR TOOL MARKS SHALL BE REPLACED.
 - 1. PHOTOCELL
 - TO SUIT LIGHTING LOAD RATING WATTS

 - TEMPORARY FLASHES OF LIGHT.
 - (FAIL_SAFE) POSITION.
 - PLATE.

WORKING IN EXISTING BUILDING AND CONTINUITY OF SERVICES - SECTION 26 50 10

- SPECIFICATIONS.
- THROUGH FAILURE TO MAKE THIS EXAMINATION.
- BEFORE REINSTALLATION.

 - MOISTURE IN THE COURSE OF ALTERATIONS OR NEW WORK.
- FOR PANELS.
- HANDED BACK TO THE CLIENT.

1. SUPPLY AND INSTALL ALL LIGHTING FIXTURES, LAMPS, AND ALL REQUIRED ACCESSORIES AS INDICATED ON THE DRAWINGS BY LETTER TYPE AND AS HEREINAFTER SPECIFIED. PROVIDE LIGHTING FIXTURES AS CALLED FOR ON THE

4. REPLACE AND INSTALL WITHOUT EXTRA COST TO THE OWNER:

- ALL DEFECTIVE OR NOISY DRIVERS FOR A PERIOD OF ONE YEAR.

5. DRIVERS FOR LED LIGHTS TO BE DIMMABLE (0-10) WHERE DIMMING CONTROL IS SHOWN.

6. ALL LIGHTING FIXTURES TO BE SUPPORTED FROM BUILDING STRUCTURE. THE SUPPORTS REQUIRED FOR MOUNTING AND INSTALLATION OF LIGHTING FIXTURES SHALL BE SUPPLIED AND INSTALLED BY THIS CONTRACTOR. THE SUPPORTS SHALL BE ATTACHED TO THE STRUCTURE. FOLLOW MANUFACTURE INSTALLATION INSTRUCTIONS.

7. COORDINATE THE INSTALLATION OF LIGHTING FIXTURE WITH ALL TRADES TO PROVIDE SPACING INTENDED. 8. FIXTURES SHALL BE PROPERLY CLEANED AND LEFT CLEAN AND DUST_FREE. ANY FIXTURE SHOWING MARKS OR

.1 PROVIDE NEW PHOTOCELL TO CONTROL NEW LED AND REMAINING EXISTING OUTDOOR LIGHTS ON SAME CIRCUIT. PHOTOCELL TO BE COMPATIBLE WITH LED AND EXISTING LIGHTS TYPE (SITE VERIFY). PHOTOCELL LOAD RATING

.2 PHOTO_ELECTRIC CONTROLS SHALL BE WEATHERPROOF TEMPERATURE COMPENSATED AND SHOCK AND VIBRATION RESISTANT. THE ELECTRIC CELL SHALL BE SCREENED AGAINST ULTRAVIOLET RAYS.

.3 PHOTOCELL SENSOR SHALL BE ADJUSTABLE FROM 10 TO 50 LUX. "OFF" ACTION SHALL BE ADJUSTABLE FROM 30 TO 150 LUX SWITCH SHALL HAVE UP TO 2 MINUTES DELAY TO PREVENT FALSE SWITCHING DUE TO

.4 SHOULD ANY PART OF THE PHOTO_ELECTRIC CONTROL FAIL TO OPERATE, THE SWITCH SHALL BE IN THE "ON"

.5 PHOTO-ELECTRIC CONTROL SHALL BE SUITABLE FOR MOUNTING ON A FLUSH MOUNTED CAST OUTLET BOX COVER

.6 PHOTO-ELECTRIC CONTROL SHALL BE TORK CAT. #2100 SERIES OR EQUAL BY INTERMATIC OR PARAGONE. .7 FOLLOW MANUFACTURE INSTALLATION AND WIRING INSTRUCTIONS

1. ELECTRICAL ALTERATIONS AND ADDITIONS ARE BEING MADE IN THE EXISTING AREAS AS NOTED ON DRAWINGS AND

2. VISIT THE SITE AND EXAMINE THE EXISTING CONDITIONS AND ALL TENDERING DOCUMENTS, DRAWINGS AND SPECIFICATIONS. MAKE ALL NECESSARY ALLOWANCES IN TENDER PRICE FOR REMOVAL, RELOCATION, REROUTING. RECONNECTION OF EXISTING ELECTRICAL EQUIPMENT AND WIRING AS MAY BE NECESSARY FOR THE EXECUTION AND COMPLETION OF THIS PROJECT. NO ALLOWANCE WILL BE MADE LATER FOR ANY EXPENSE INCURRED BY THIS TRADE

3. WIRING LOCATED IN AREAS BEING ALTERED OR DEMOLISHED, BUT FEEDING OUTLETS OR EQUIPMENT REQUIRED TO REMAIN IN SERVICE SHALL BE REROUTED AS REQUIRED TO MAINTAIN THE CONTINUITY OF THESE SERVICES.

4. EXISTING ELECTRICAL EQUIPMENT REMOVED AND INDICATED FOR REUSE SHALL BE CLEANED BEFORE INSTALLATION. ALL UNUSED CONDUIT ENTRANCE OPENINGS SHALL BE SEALED, ALL DEFECTIVE COMPONENTS SHALL BE REPLACED

5. ALL WIRING SHALL BE RUN CONCEALED WHERE POSSIBLE EXCEPT THAT CONDUITS IN UNFINISHED AREAS AND ON EXISTING WALLS AND CEILING MAY BE INSTALLED ON SURFACE.

6. SUPPLY. INSTALL AND MAINTAIN ALL REQUIRED TEMPORARY WIRING TO OCCUPIED AREAS AT ALL TIMES. PROVIDE ADEQUATE PROTECTION TO EXISTING WIRING AND EQUIPMENT SERVING THE EXISTING AND NEW WORK AND PARTICULARLY WHERE WIRING AND ELECTRICAL EQUIPMENT HAVE BECOME EXPOSED TO MECHANICAL INJURY OR

7. POWER SHUTDOWN, IF REQUIRED, MUST BE COORDINATED WITH CLIENT'S REPRESENTATIVE.

8. CERTAIN ITEMS ARE IDENTIFIED ON THE DRAWINGS AS EXISTING EQUIPMENT TO BE "REMOVED". DISCONNECT SAID EQUIPMENT AND MAKE SAFE. OBSOLETE CONDUITS AND CABLES SHALL BE DISCONNECTED FROM THEIR SOURCE OF SUPPLY, CUT BACK TO A SUITABLE POINT.

9. ALL UNUSED FUSED SWITCHES AND CIRCUIT BREAKERS SHALL BECOME SPARE. PROVIDE NEW, UP-DATED DIRECTORIES

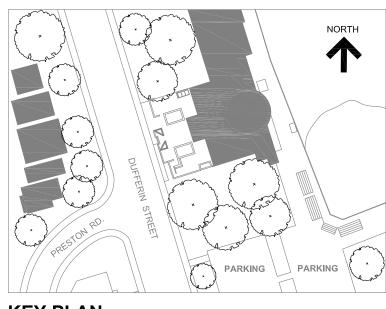
10. ALL EXISTING EQUIPMENT AND MATERIAL NOT REQUIRED IN THE FINAL INSTALLATION SHALL BE CAREFULLY REMOVED AT THE APPROPRIATE TIME AND SHALL BE DISPOSED OF EXCEPT STARTERS FOR MECHANICAL EQUIPMENT BEING



Creative Thinking Practical Results

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FAIRBANK MEMORIAL **COMMUNITY CENTRE -**PODIUM DECK REHABILITATION

Sheet Title

ELECTRICAL SPECIFICATION

Drawn By	CAD	Scale	N.T.S.
Designed By	AP	Date	February 28, 2025
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