Renovations at Ecole Elementaire Jeanne-Lajoie

150 Carnforth Road North York, Ontario

LIST OF DRAWINGS

DRAWING LIST AND OBC MATRIX

ARCHITECTURAL

FIRST FLOOR DEMOLITION AND KEY PLAN SECOND FLOOR DEMOLITION AND KEY PLAN A203 PART FIRST FLOOR DEMOLITION PLANS A204 PART DEMOLITION PLANS A205 PART FLOOR PLANS PART FLOOR PLANS PART REFLECTED CEILING PLANS A208 PART REFLECTED CEILING PLANS A301 PART EAST ELEVATIONS PART WEST ELEVATIONS AND DETAILS A303 PART NORTH AND SOUTH ELEVATIONS STAGE SECTION AND ELEVATION INTERIOR ELEVATIONS INTERIOR ELEVATIONS MILLWORK SECTIONS A901 SCHEDULES **ELEVATION PHOTOS** A906 **ELEVATION PHOTOS ELEVATION PHOTOS** A908 **ELEVATION PHOTOS ELEVATION PHOTOS ELEVATION PHOTOS ELEVATION PHOTOS ELEVATION PHOTOS ELEVATION PHOTOS**

GENERAL NOTES

MECHANICAL

TITLE PAGE MECHANICAL SPECIFICATIONS I MECHANICAL SPECIFICATIONS II AND LEGEND MECHANICAL SCHEDULES AND DETAILS M-1.3 PART 1ST & 2ND FLOOR DEMOLITION PLAN - HVAC PART 1ST FLOOR DEMOLITION PLAN - HVAC M-2.3 PART 1ST & 2ND FLOOR NEW PLAN - HVAC M-2.4 PART 1ST FLOOR NEW PLAN - HVAC M-3.1 PART 1ST FLOOR DEMOLITION PLAN - PLUMBING & DRAINAGE PART 1ST FLOOR DEMOLITION PLAN - PLUMBING & DRAINAGE M - 3.3PART 1ST FLOOR NEW PLAN - PLUMBING & DRAINAGE PART 1ST FLOOR NEW PLAN - PLUMBING & DRAINAGE

ELECTRICAL

ELECTRICAL LEGEND AND DETAILS ELECTRICAL DETAILS E-1.2 ELECTRICAL DETAILS E-1.3 **ELECTRICAL DETAILS** E-2.1 ELECTRICAL FACILITY PLAN - FIRST FLOOR ELECTRICAL FACILITY PLAN - SECOND FLOOR E-5.1 **ELECTRICAL DEMOLITION PLAN - FIRST FLOOR** E-5.2 ELECTRICAL DEMOLITION PLAN - SECOND FLOOR REFLECTED CEILING DEMOLITION PLAN - FIRST FLOOR REFLECTED CEILING DEMOLITION PLAN - SECOND FLOOR E-9.1 ELECTRICAL AND REFLECTED CEILING PLANS - FIRST FLOOR ELECTRICAL AND REFLECTED CEILING PLANS - SECOND FLOOR E-9.2

CONSULTANTS

ARCHITECTURAL / STRUCTURAL:



BARRY BRYAN ASSOCIATES Architects Engineers **Project Managers** Suite 201 Whitby, Ontario L1N 0G5 Tel: (905) 666-5252 Fax: (905) 666-5256 e-mail: bba@bba-archeng.com


MECHANICAL




GIALLONARDO ENGINEERING INC. Tel: (905) 265-1052 220-4550 Highway 7 Woodbridge, Ontario info@giallonardoeng.com L4L 4Y7 Web: http://www.giallonardoeng.com

A000

HCC ENGINEERING DESIGN AND TECHNOLOGY SERVICES GROUP HCC ENGINEERING LIMITED 40 EGLINTON AVENUE EAST, SUITE 600 TORONTO, ONTARIO, M4P 3A2 Tel: (416) 932-2423

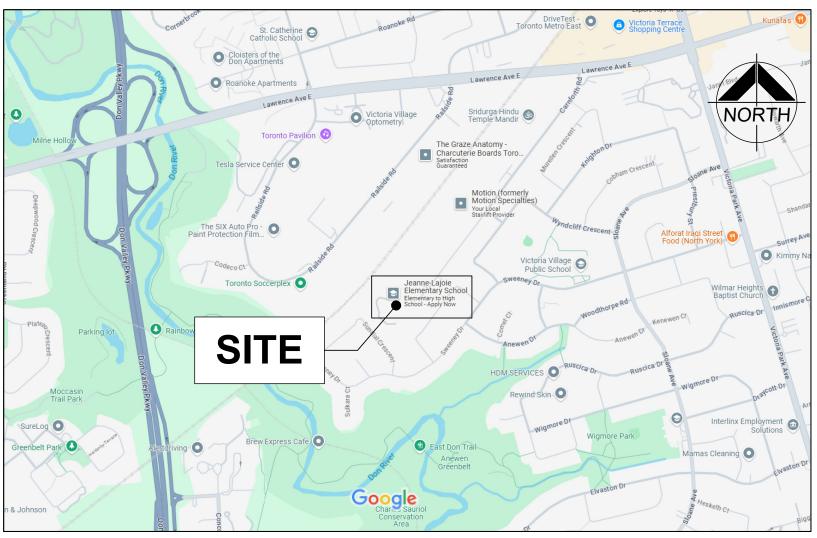

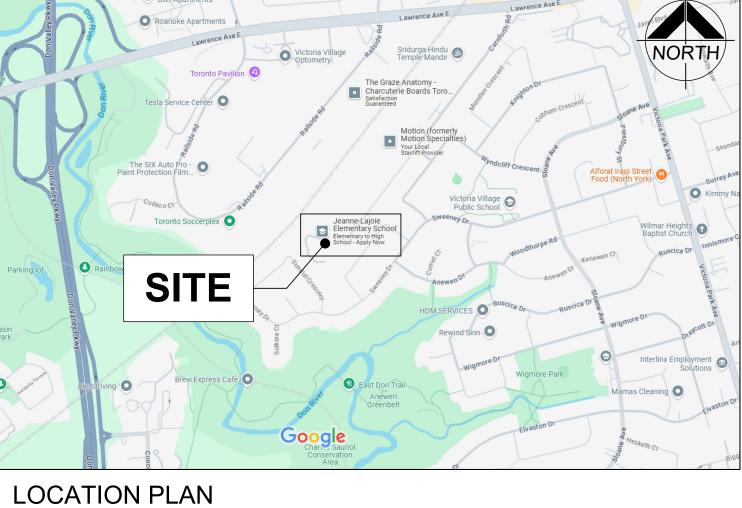

CERTIFICATE OF PRACTICE NUMBER: 5192 250 WATER STREET, SUITE 201 WHITBY, ONTARIO, CANADA. LIN 0G5 TEL: (905) - 666 - 5252 (Toronto) (905) - 427 - 4495 FAX: (905) - 666 - 5256

NAME OF PROJECT : RENOVATIONS AT ECOLE ELEMENTAIRE JEANNE-LAJOII

LOCATION OF PROJECT:

ATION OF PROJEC CARNFORTH ROA E :	CT: LICEN(D, NORTH YORK, ON 4916	CE PRINTER
СН 2025		OBC Reference
	Ontario Building Code Data Matrix Part 3	
Building Code Ve Project Type:	□ New □ Addition ☑ Renovation □ Change of use □ Addition and Renovation	[A] 1.3.3.2
Major Occupancy Classification:	Description	3.1.2
Superimposed Major Occupancie	VZÍ NO ☐ Yes	3.2.2.7
Building Area (m²) <u>Description</u> <u>Existing</u> <u>New</u> <u>Total</u>	[A] 1.4.1.2.
One - Area (w. 2)	EXISTING FIRST FLOOR 4,474.07 4,474.07 EXISTING SECOND FLOOR 1,130.33 1,130.33 EXISTING MECH. PENTHOUSE 180.78 180.78 Total= 5,785.18 5,785.18	
Gross Area (m²)	Description Existing New Total EXISTING FIRST FLOOR 4,474.07 4,474.07 EXISTING SECOND FLOOR 1,130.33 1,130.33 EXISTING MECH. PENTHOUSE 180.78 180.78 Total= 5,785.18 5,785.18	[A] 1.4.1.2.
Mezzanine Area (m²)	Description N/A Total Total=	3.2.1.1
Building Height	2 (two) Storeys above grade 6.0 (m) Above grade 0 (zero) Storeys below grade ✓ No ☐ Yes	[A] 1.4.1.2 & 3.2.1.1
High Building Number of streets fire fighter access Building Classifi	/ <u>1 (one)</u> street(s) Existing	3.2.6 3.2.2.10 & 3.2.5 3.2.2.20 93
Sprinkler System	Required Not Required	3.2.1.5,
No Change.	Proposed:	3.2.2.18, 3.2.2.21, 3.2.2.22, 3.2.2.29, 3.2.4.9, 3.2.4.15 and 3.2.5.12 to .14
Standpipe System		3.2.5.8-11
Fire Alarm Syster No Change	Type Provide: ☐ Single Stage ☐ Two Stage ☐ None	3.2.4
Water Service/ Supply is Adequa	te No Change	3.2.5.7
ConstructionType	: Restriction: □Combustible Permitted ☑Non-combustible Required □Encapsulated mass timber	3.2.2.20 93 & 3.1.6
	Actual: ☐Combustible ☐Non-combustible ☐Encapsulated mass timber ☐Combination of Combustible and non-combustible	
Actual construction	□ Combination of Encapsulated mass timber and non-combustible In Heavy Timber Construction: ☑ No □ Yes	3.1.4.6 to 7 & 3.12.2.16
Importance Category:	☐ Low ☐ Low human Occupancy ☐ Post-disaster shelter ☐ Normal	4.1.2.1. (3) & T4.1.2.1
No Change	☐ High ☐ Miner storage building ☐ Explosives or hazardous substances	
Seismic Category	☐ Post-disaster : Seismic Category:	4.1.8.4.(1) T-4.1.8.5.B
No Change	Site Class: Seismic design required for Table 4.1.1.18_items 6 to 22: Bequired Not Required	4.1.8.18
Occupant Load:	Reasons: Floor Level/ Area Occupancy Based On Occupant Posted limit	3.1.17
	Type	
Barrier-free Desig	n: ☑ Yes □ No Explanation BOYS & GIRLS TO BE B/F. □ No	3.8
Barrier-free Entrances:	UPGRADE EXISTING MAIN ENTRANCE. Number_ONE Explanation DOOR TO BE B/F	3.1.8.2
Hazardous Substances:	☐ Yes Explanation	3.3.1.2
Required Fire Resistance	Horizontal Assembly Rating(H) Supporting Non combustible Assembly (H) in lieu of rating?	3.2.2.20. 93, 3.2.1.2,
Ratings: Unknown	Storeys below grade	3.2.1.4, 3.2.2.15 & 3.3.2.1
	No Yes N/A No Yes N/A No Yes N/A No Yes N/A No Yes N/A No Yes N/A	5.0.2.1
Spatial Separation		3.2.3
Exposed Buillding Face Of El	BF (m) or H/L FRR Openings Openings Openings Proposed	
North South		
East West		
(Addition wall are	as contiued below) n: cont. No Change	3.2.3
Wall EBF (Repeated) Construction Type Cladding Type	
South	Noncombustible Noncombustible	
West	□ Noncombustible	
Plumbing Fixture Requirements:	Ratio: Male/Female = 50:50 Except as noted otherwise Floor level/ Area Occupant OBC WC's WC's	3.7.4, 3.8.2.3
	Load Reference Required Provided 10	
Plumbing Fixture Requirements:	Floor level/ Area B.F. WC's B.F. WC's Universal Universal (Repeated) Required Provided Washrooms Washrooms	Tables 3.8.2.3.A
cont.	(Repeated) Required Provided Washrooms Required Washrooms Provided GROUND FLOOR 2 EXISTING 2 NEW = 4 TOTAL ONE ONE (EXISTING) ONE (EXISTING) SECOND FLOOR 2 EXISTING (NO CHANGE) ONE (EXISTING)	and 3.8.2.3.B
Energy Efficiency Unknown	Compliance Path: - OBC Table:	12.2.1.2 SB-1 TABLE 2
Sound Transmiss	Degree Day Below 18°C ion Is there more than 1 dwelling unit per building?:	SB-3
Design: Unknown	Option Implemented:	5.8.1.2.(2), 5.8.1.4., & 5.8.1.5.
Alternative	Notes:	[A] 1.2.1.1, and
Solutions: Unknown		[C]2.1
Nata	OCUPON PREPATES SUPPENIES	

- SCHOOL PREDATES CURRENT BUILDING CODE.

- ORIGINAL SCHOOL CONSTRUCTED CIRCA 1966

- SCHOOL IS NOT SPRINKLERED.

CERTIFICATE OF PRACTICE NUMBER: 5192 250 WATER STREET, SUITE 201 WHITBY, ONTARIO, CANADA. LIN 0G5 TEL: (905) - 666 - 5252 (Toronto) (905) - 427 - 4495 FAX: (905) - 666 - 5256

NAME OF PROJECT : RENOVATIONS AT ECOLE ELEMENTAIRE JEANNE-LAJOIE

LOCATION OF PROJECT: 150 CARNFORTH ROAD, NORTH YORK, ON

FEBRUARY 2025

MARCHITECTS

ANCHITECTS

WILLIAM WEIMA 33

LICENCE 2

		Part 11 - Renovation of Existing Building	
11.00	Building Code Version	n: <u>O. Reg. 163/24</u> Last Amendment: <u>O. Reg. 447/24</u>	
11.01	Project Type:	☐ Addition ☐ Renovation ☐ Addition and Renovation ☐ Change of use	[A] 1.3.3.3B
11.02	Major Occupancy Classification:	Description RENOVATIONS AT ECOLE ELEMENTAIR JEANNE-LAJOIE Occupancy Use GROUP A, DIV. 2 ELEMENTARY SCHOOL - -	3.1.2.1.(1), 2.1.4.1.(10.1.1.2, and 11.2.1.
11.03	Superimposed Major Occupancies:		11.2, 3.2.2.5 to 3.2.2.8 and 2.2.1
11.04	Building Area (m²)	Description Existing New Total EXISTING FIRST FLOOR 4,474.07 4,474.07 EXISTING SECOND FLOOR 1,130.33 1,130.33 EXISTING MECH. PENTHOUSE 180.78 180.78 Total= 5,785.18 5,785.18	[A] 1.4.1.2., 11.2 and 11.3
11.05	Building Height	2 (two) Storeys above grade6.0 (m) Above grade Storeys below grade	[A] 1.4.1.2, 3.2.1.1, 2.2.2.2 and 11.3
11.06	Number of streets/ fire fighter access:	1 (one) street(s) Existing	3.2.2.10, 3.2.5, 2.2.4.1 and 11.3
11.07	Building Size:	☐ Small ☐ Medium ☑ Large ☐ > Large	11.2.1.1 and T.11.2.1.1.BN.
11.08	Existing Building Classification:	Change in Major Occupancy: ☐ Yes	10.1.1.2, 11.2.1.1 T11.2.1.1A T11.2.1.1B to N, 4.1.2.1(3), 2.3.1 & 5.2.2.1.(2)
11.09	Renovation Type:	☑ Basic Renovation ☐ Extensive Renovation	11.3.3.1 & 11.3.3.2
11.10	Occupant Load:	Floor Level/ Area Occupancy Based On Type Occup. Load (persons) GROUND STAFF COUNT 38 GROUND 5 ELEMENTARY CLASSROOMS 25/ ROOM 125 GROUND 4 TODDLERS (DAYCARE) CLASSROOMS 25/ ROOM 100 2ND FLOOR 9 EXISTING CLASSROOMS 25/ ROOM 225	3.1.17, 2.1.2.2 and 11.4.2.2.
11.11a	Plumbing Fixture Requirements:	Ratio: Male/Female = 50:50 Except as noted otherwise Floor level/ Area Occupant Load 200 OBC Reference Required 100 WC's WC's WC's WC's Reference Required 100 GROUND (STAFF) 38 TABLE 3.7.5.7 4 10 10 GROUND (ELEMENTARY CLASSROOMS) 125 3.7.4.3 (14) M(2.0) F(2.5) M(11) F(13) GROUND (DAYCARE) 100 3.7.4.3.1 M(10) F(10) M(3) F(3) 2ND FLOOR 225 3.7.4.3 (14) M(4) F(4.5) M(4) F(4.5)	3.7.4, 11.3.4, 11.3.5 11.4.2.4 & 11.4.2.5.
11.11b	Plumbing Fixture Requirements: cont.	Floor level/ Area (Repeated)	Tables 3.8.2.3.A and 3.8.2.3.B
11.12	Barrier-free Design: Barrier-free Entrances:	✓ Yes □ No Explaination BOYS & GIRLS TO BE B/F. UPGRADE EXISTING MAIN ENTRANCE. Number ONE Explaination DOOR TO BE B/F	11.3.1.2, 11.3.2, 11.3.3.2
11.13	Reduction in Performance Level:	Structural By Increase in occupant load: By change of major occupancy: Plumbing Sewage - system: Extension of buildings of combustible construction: Yes Yes Yes Yes Yes Yes Yes Ye	11.4.2.1 11.4.2.2 11.4.2.3 11.4.2.4 11.4.2.5 11.4.2.6
11.14	Compensating Construction:	Structural By Increase in occupant load: By change of major occupancy: Plumbing Sewage - system: Extension of buildings of Combustible Construction:	11.4.2.1 11.4.2.2 11.4.2.3 11.4.2.4 11.4.2.5 11.4.2.6 11.4.2.7
11.15	Compliance Alternatives Proposed:	☑ No ☐ Yes	11.5.1.
11.16	Alternative Solutions:		[A] 1.2.1.1, and [C]2.1
11 1-	Natari		1
11.17	Notes:	- SCHOOL PREDATES CURRENT BUILDING CODE SCHOOL IS NOT SPRINKLERED ORIGINAL SCHOOL CONSTRUCTED CIRCA 1966	

DO NOT SCALE THE DRAWINGS CHECK AND VERIFY ALL DIMENSIONS AT THE SITE ALL DRAWINGS, SPECIFICATIONS AND RELATED DOCUMENTS ARE THI COPYRIGHT PROPERTY OF THE CONSULTANT AND MUST BE RETURNED UPON REQUEST. REPRODUCTION OF DRAWINGS IN PART OR WHOLE WITHOUT THE PERMISSION OF THE CONSULTANT IS FORBIDDEN DRAWINGS ARE NOT TO BE USED FOR CONSTRUCTION UNTIL SIGNED AND SEALED BY THE CONSULTANT.

MARCHITECTS Z

WILLIAM WEIM & LICENCE 14910



NO.	ISSUES	DATE	BY
1	ISSUED FOR REVIEW	MAR. 18, 2025	BBA
2	ISSUED FOR PERMIT & TENDER	MAR. 20, 2025	BBA

NO.	REVISIONS	DATE	ВҮ

PROJECT:


RENOVATIONS AT ECOLE ELEMENTAIRE JEANNE-LAJOIE

150 CARNFORTH ROAD NORTH YORK, ONTARIO Conseil scolaire Viamonde

DRAWING:

OBC MATRIX, DRAWING LIST AND LOCATION PLAN



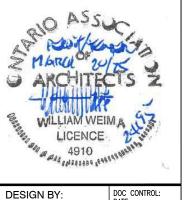


ASSOCIATES Architects Engineers Project Managers 250 Water Street Suite 201 Whitby, Ontario L1N 0G5

CHECKED BY: DEC. 2024 Tel: (905) 666-5252 AS NOTED Fax: (905) 666-5256 e-mail: bba@bba-archeng.com FILE:

DRAWN BY:

PROJECT NO: 24195

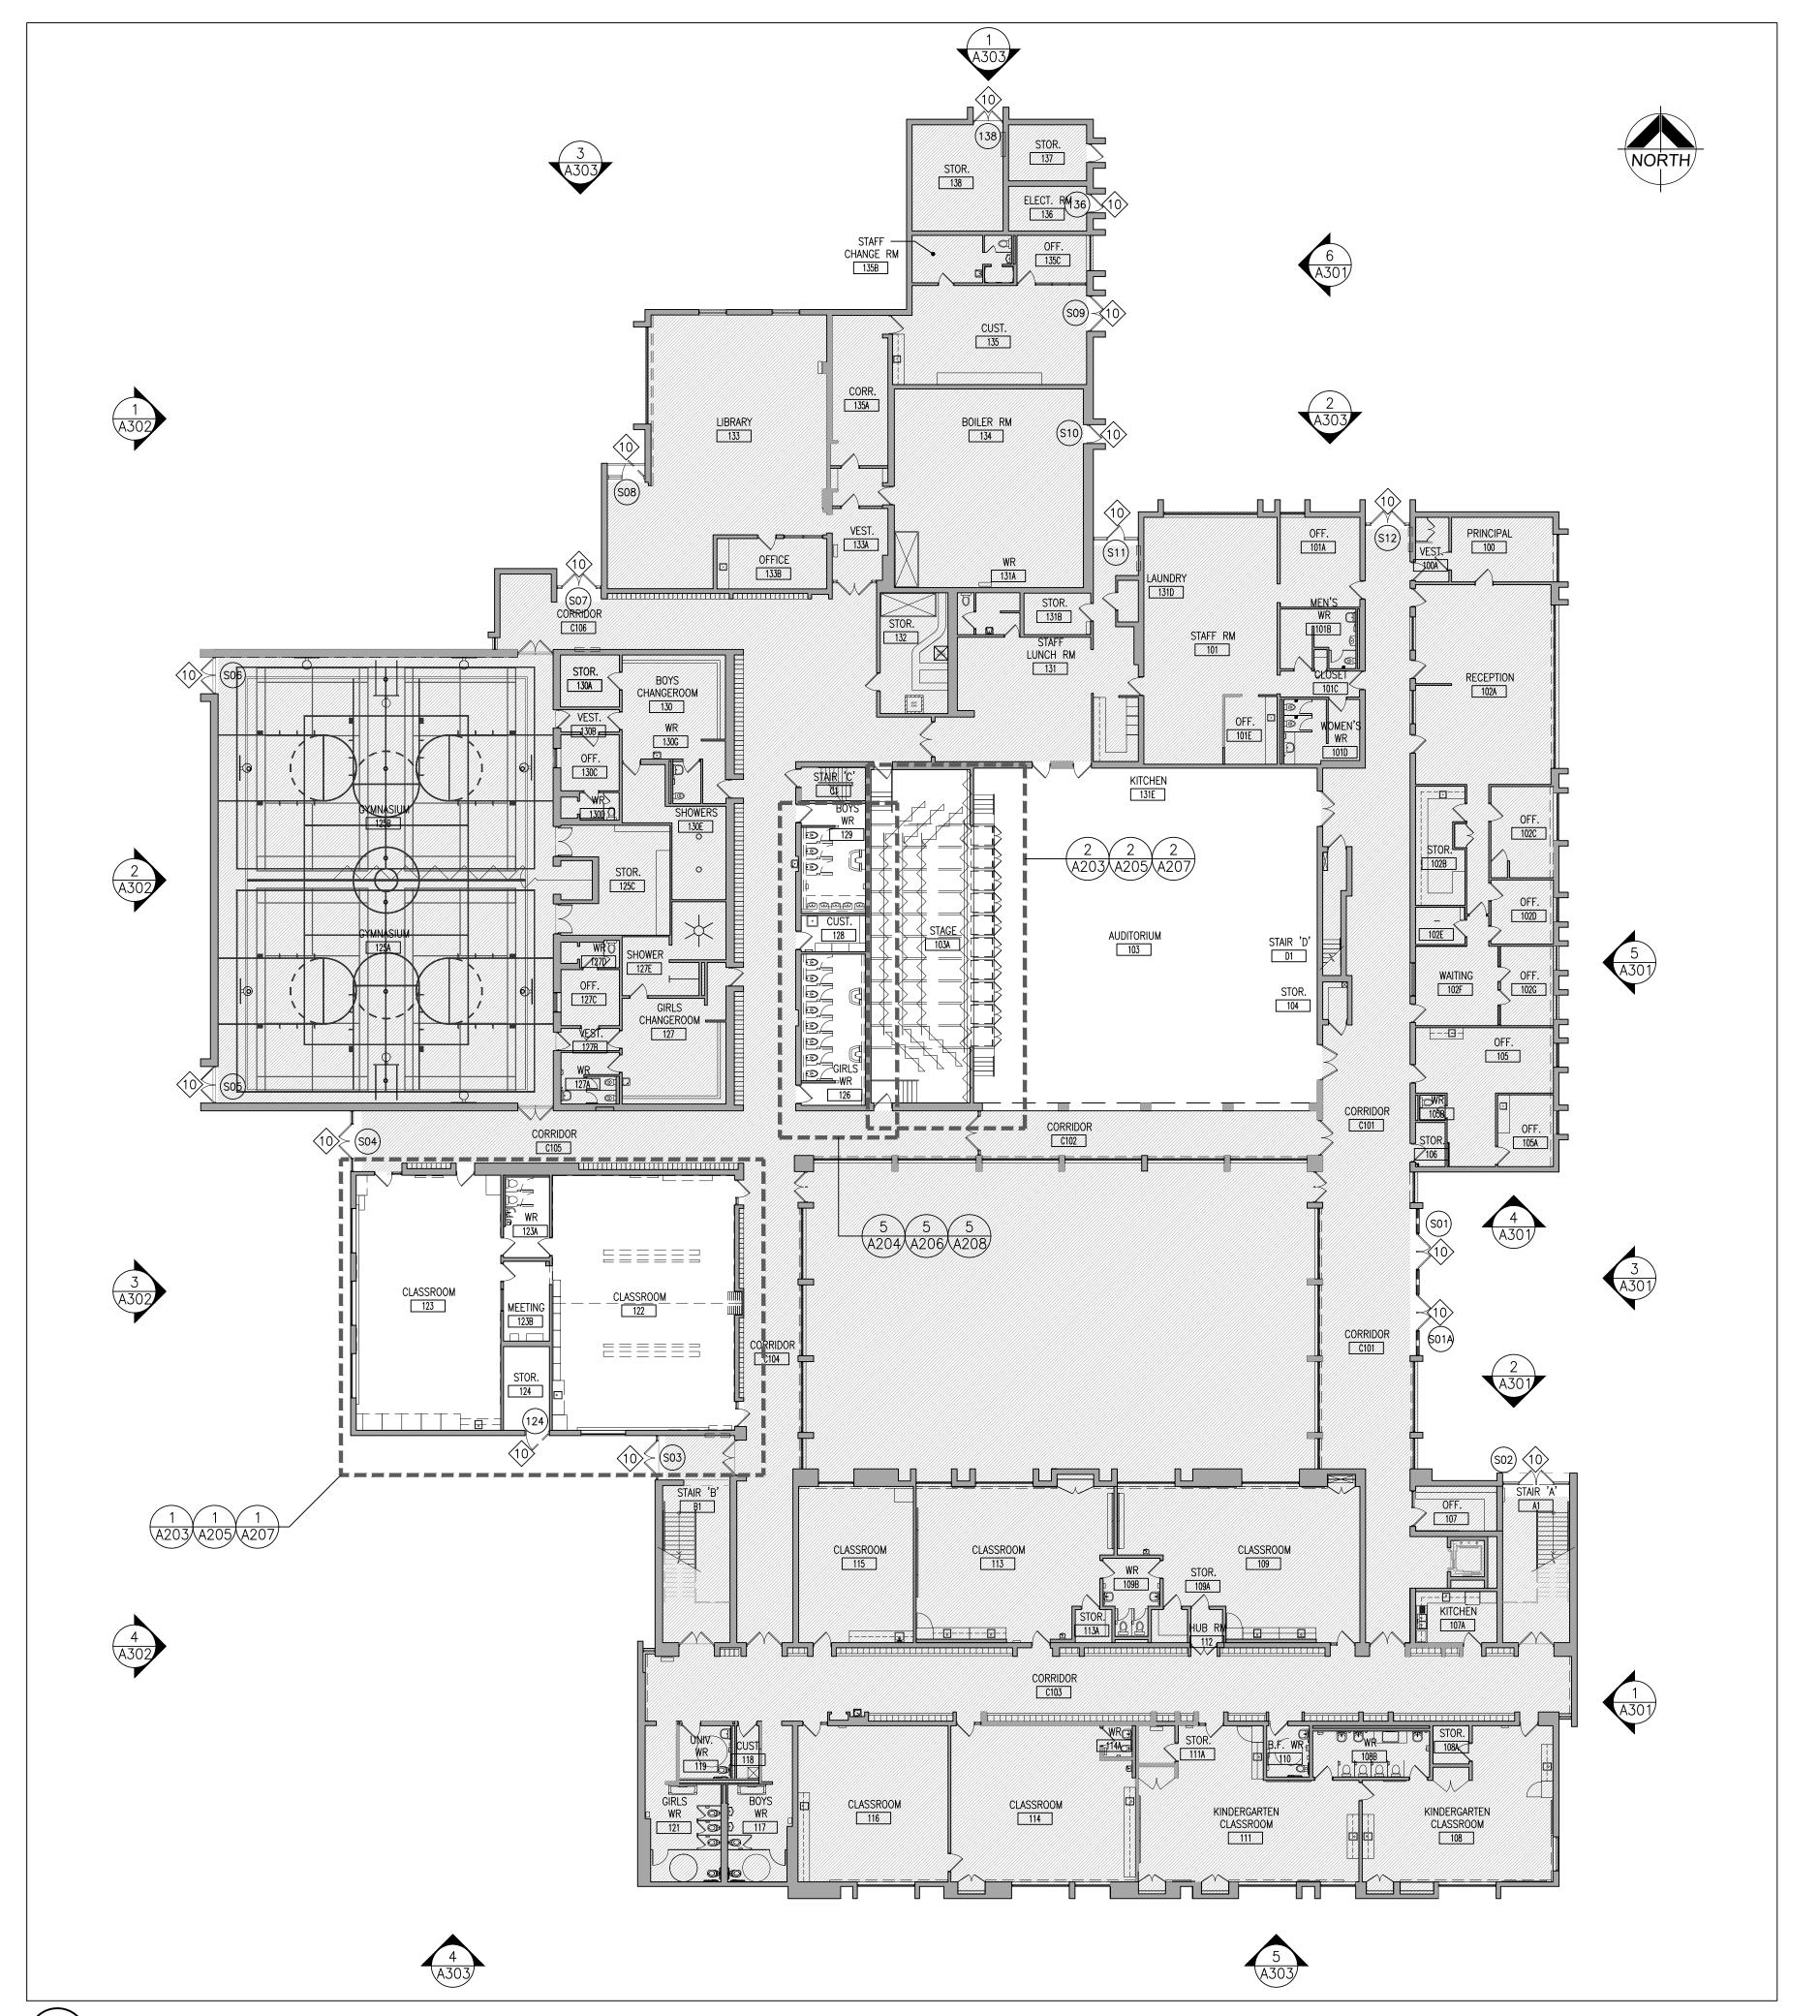

TYPICAL DEMOLITION NOTES

- SITE VERIFY ALL DIMENSIONS AND CONDITIONS. REPORT DISCREPANCIES TO THE CONSULTANTS.
- 2. ALL WORK TO BE IN ACCORDANCE WITH THE ONTARIO BUILDING CODE.
- 3. COMPLY WITH THE OCCUPATIONAL HEALTH AND SAFETY ACT REGULATIONS FOR CONSTRUCTION PROJECTS.
- PROVIDE PROTECTION IN LOCATIONS APPROVED BY THE OWNER AND CONSULTANT SO AS NOT TO DAMAGE EXISTING STRUCTURE, LANDSCAPE OR PART THEREOF.
- COMPLETE ALL DEMOLITION WORK NECESSARY TO COMPLETE THE RENOVATIONS AS SHOWN AND AS REQUIRED. DEMOLITION OF BUILDING ELEMENTS INCLUDES BUT NOT LIMITED TO COMPLETE REMOVAL OF ALL ASSOCIATED FIXTURES, FITTINGS, HARDWARE, FASTENERS, EQUIPMENT AND ACCESSORIES UNLESS NOTED OTHERWISE.
- ARCHITECTURAL, STRUCTURAL, MECHANICAL AND ELECTRICAL DEMOLITION DRAWINGS ARE COMPLEMENTARY AND SHALL BE READ TOGETHER.
- PROVIDE ALL SHORING AS REQUIRED. SHORING SHALL BE DESIGNED BY A REGISTERED PROFESSIONAL ENGINEER.
- NOTIFY CONSULTANT OF LOAD BEARING MEMBERS OR ASSEMBLIES IDENTIFIED OR DISCOVERED DURING WORK AND NOT INDICATED ON DRAWINGS. DO NOT PROCEED WITH REMOVALS WITHOUT PRIOR REVIEW BY THE CONSULTANT.
- PROVIDE TEMPORARY SUPPORT OF PIPES, DUCTS AND ELECTRICAL CHASES AS REQUIRED FOR SAFE REMOVAL. EXISTING AND PROPOSED SUPPORTS ARE TO BE REVIEWED BY THE CONSULTANT PRIOR TO THE REMOVAL OF ANY COMPONENTS WHICH MAY FALL. OR CAUSE OTHERS TO FALL.
- 10. MAINTAIN ALL WORK AREAS AND ALL STORAGE AREAS CLEAN AND ORDERLY AT ALL TIMES INCLUDING EXISTING AREAS THAT REMAIN IN OPERATION DURING CONSTRUCTION. DUST CONTROL MEASURES ARE TO BE IN PLACE AT ALL TIMES AND NOISY WORK SHALL BE COORDINATED AROUND PROGRAM EVENTS.
- REMOVAL OF EXISTING FLOOR FINISHES IS TO INCLUDE COMPLETE REMOVAL OF BASE AND ALL MORTAR AND ADHESIVES AND PREPARATION OF EXISTING SUBSTRATES TO RECEIVE NEW FLOORING, SATISFACTORY TO THE MANUFACTURER OF NEW FLOOR FINISHES. ALLOW FOR EXCESSIVE LEVELING OF SLABS.
- 12. DEMOLITION INCLUDES ALL ASSOCIATED MECHANICAL AND ELECTRICAL SERVICES, EQUIPMENT, FITTINGS, FIXTURES, HANGERS, BRACKETS, TRIM AND ACCESSORIES AS REQUIRED TO COMPLETE THE WORK.
- 13. SAWCUT, BREAK OUT AND MAKE GOOD (MATCH EXISTING U.N.O.) ALL EXISTING FLOOR SLABS WHERE REQUIRED TO INSTALL NEW UNDERGROUND PLUMBING AND OTHER BURIED SERVICES AS INDICATED AND AS REQUIRED ON MECHANICAL AND ELECTRICAL DRAWINGS.
- 14. REMOVAL OF DOORS AND FRAMES IS TO INCLUDE REMOVAL OF ALL HARDWARE.
- 15. REMOVE ALL PROTRUSIONS IN FLOOR SLAB AND GRIND DOWN TO FLOOR LEVEL.
- 16. CLEAN, PATCH / REPAIR ALL EXISTING SURFACES TO REMAIN TO RECEIVE NEW FINISHES, ALLOW FOR REMOVAL OR SCARIFICATION OF EXISTING PAINT FINISH ON WALLS THAT ARE TO RECEIVE NEW WALL TILE FINISH. REMOVE ALL MORTAR, ADHESIVES AND RUST AS REQUIRED TO PREPARE EXISTING SUBSTRATES TO RECEIVE NEW PAINT FINISHES.
- 17. DISCONNECT AND CAP OFF ALL SERVICES PRIOR TO DEMOLITION.
- 18. DISPOSE OF MATERIALS OFF SITE.
- 19. CONTRACTOR SHALL BE RESPONSIBLE FOR ANY DAMAGE TO THE EXISTING STRUCTURE OR FINISHES SHOWN TO REMAIN AND REPAIR / REPLACE SAME TO THE SATISFACTION OF THE OWNER AND CONSULTANT.
- 20. BUILDING TO BE SECURED BY THE G.C. AT ALL TIMES.
- 21. REFER TO "DESIGNATED SUBSTANCES SURVEY-PRE-RENOVATION. ECOLE ELEMENTAIRE JEANNE-LAJOIE, 150 CARNFORTH ROAD, TORONTO, ONTARIO" DATED MARCH 24 2025, AND "ASBESTOS ABATEMENT SPECIFICATIONS, ECOLE ELEMENTAIRE JEANNE-LAJOIE, 150 CARNFORTH ROAD, TORONTO, ONTARIO" DATED MARCH 2025, PREPARED BY ARCADIS PROFESSIONAL SERVICES (CANADA) INC. DESIGNATED SUBSTANCES AND HAZARDOUS MATERIALS REMOVALS SHALL COMPLY WITH CURRENT
- 22. PATCH, REPAIR & MAKE GOOD ALL SURFACES AFFECTED BY THE WORK, INCLUDING BUT NOT LIMITED TO WALL, PATCHING, PAINTING, MILLWORKS, FLOORING AND

DEMOLITION LEGEND

EXISTING WALL,
PARTITION OR COLUMN

DENOTES DEMOLITION OF

DEMOLITION NOTES

EXISTING DOOR & FRAME TO REMAIN

EXISTING DOOR & FRAME TO

BUILDING ELEMENT BE CAREFULLY REMOVED AND DISPOSED OF.

- REMOVE AND DISPOSE OF EXISTING PLUMBING FIXTURES. PATCH, REPAIR & MAKE GOOD ALL SURFACES FOR NEW WORK.
- 2 REMOVE AND DISPOSE OF EXISTING TOILET PARTITIONS. PATCH, REPAIR & MAKE GOOD ALL SURFACES FOR NEW WORK.
- REMOVE AND DISPOSE OF EXISTING WALL TILES. PATCH, REPAIR AND MAKE GOOD AFFECTED SURFACES. PARGE WALLS AS REQUIRED FOR RECEIPT OF NEW FINISHES
- REMOVE AND DISPOSE OF EXISTING VCT FLOORING & BASE. PATCH, REPAIR AND MAKE GOOD SURFACES AS REQUIRED FOR NEW FINISH. AND MAKE GOOD SURFACES AS REQUIRED FOR NEW FINISH.
- REMOVE AND DISPOSED OF EXISTING ACOUSTIC CEILING IN IT'S ENTIRETY INCLUDING PANELS, GRID, LIGHT FIXTURES, DIFFUSERS, GRILLES, FIRE ALARM AND ELECTRICAL DEVICES. SEE ALSO MECHANICAL AND ELECTRICAL DWGS FOR
- 7 REMOVE AND DISPOSED OF EXISTING MILLWORK. PATCH, REPAIR & MAKE GOOD ALL SURFACES.
- 8 REMOVE EXISTING ROLLER SHADES AND REINSTALL AS REQUIRED TO COMPLETE NEW WORK.
- REMOVE AND REPLACE ALL EXISTING EXTERIOR DOORS AND FRAME. PATCH,
 REPAIR & MAKE GOOD ALL AS REQUIRED FOR NEW DOOR AND FRAME.

9 REMOVE AND DISPOSED OF EXISTING BLACK BOARDS AND TACK BOARDS.

- REPAIR & MAKE GOOD ALL AS REQUIRED FOR NEW DOOR AND FRAME. SAND EXISTING WOOD FLOORING DOWN TO BARE WOOD. PATCH, REPAIR AND MAKE GOOD FOR NEW SATIN AND POLYURETHANE COATING.
- 12) REMOVE & DISPOSE OF UNDER STAGE STORAGE DOORS & HARDWARE. PATCH,
 REPAIR & MAKE GOOD ALL SURFACES FOR INSTALLATION OF NEW DOORS
- REPAIR & MAKE GOOD ALL SURFACES FOR INSTALLATION OF NEW DOORS. (13) SCHOOL BOARD TO REMOVE & STORE EXISTING TV/ SMART BOARD. EXISTING
- TV/ BOARD TO BE REINSTALLED BY SCHOOL BOARD. (14) REMOVE AND DISPOSED OF EXISTING METAL SHELVING IN IT'S ENTIRETY.
- MAKE GOOD ALL AREAS FOR NEW WORK. REMOVE EXISTING CERAMIC TILE FLOORING & BASE. PATCH, REPAIR & MAKE GOOD FOR NEW FINISHES.
- REMOVE & DISPOSE OF EXISTING FOLDING PANEL PARTITION IN IT'S ENTIRETY INCLUDING FLOOR & CEILING RAILS AND WALL PANEL TRACK.
- REMOVE & DISPOSE OF EXISTING STAGE CURTAINS AND RIGGING AND MAKE GOOD FOR NEW CURTAIN INSTALLATION.
- 18 SAWCUT AND REMOVE EXISTING MASONRY WALL AS REQUIRED FOR NEW OPENING, PATCH, REPAIR AND MAKE GOOD AFFECTED SURFACES AS REQU OPENING. PATCH. REPAIR AND MAKE GOOD AFFECTED SURFACES AS REQUIRED

FOR NEW WORK (SHORE STRUCTURE AS REQUIRED)

- (19) REMOVE EXISTING HANGING CEILING BARS.
- REMOVE AND DISPOSE INTERIOR DOORS & FRAMES. PATCH, REPAIR AND MAKE GOOD ALL SURFACES AS REQUIRED FOR NEW FINISHES.
- REMOVE EXISTING LIGHTING FIXTURES AND SOUND SYSTEMS. REFER TO ELECTRICAL DRAWINGS FOR MORE DETAILS. ELECTRICAL DRAWINGS FOR MORE DETAILS.

DO NOT SCALE THE DRAWINGS CHECK AND VERIFY ALL DIMENSIONS AT THE SITE.

ALL DRAWINGS, SPECIFICATIONS AND RELATED DOCUMENTS ARE THE COPYRIGHT PROPERTY OF THE CONSULTANT AND MUST BE RETURNED UPON REQUEST. REPRODUCTION OF DRAWINGS IN PART OR WHOLE WITHOUT THE PERMISSION OF THE CONSULTANT IS FORBIDDEN. DRAWINGS ARE NOT TO BE USED FOR CONSTRUCTION UNTIL SIGNED AND SEALED BY THE CONSULTANT.



Conseil scolaire Viamonde

NO.	ISSUES	DATE	BY
1	ISSUED FOR REVIEW	MAR. 18, 2025	BBA
2	ISSUED FOR PERMIT & TENDER	MAR. 20, 2025	BBA

PROJECT:

NO. REVISIONS

RENOVATIONS AT ECOLE ELEMENTAIRE JEANNE-LAJOIE

150 CARNFORTH ROAD NORTH YORK, ONTARIO Conseil scolaire Viamonde

DRAWING:

FIRST FLOOR DEMOLITION AND KEY PLAN



alo ASSU MARCHITECTS Z WILLIAM WEIMA 3 LICENCE 2 DESIGN BY:

% COMPLETE:

DATE BY

BARRY BRYAN ASSOCIATES Architects Engineers

Project Managers 250 Water Street Suite 201 Whitby, Ontario L1N 0G5

PROJECT NO:

Tel: (905) 666-5252

e-mail: bba@bba-archeng.com

24195

Fax: (905) 666-5256

FILE:


1:200

DRAWN BY:

CHECKED BY: CM

NOV. 2024

A201

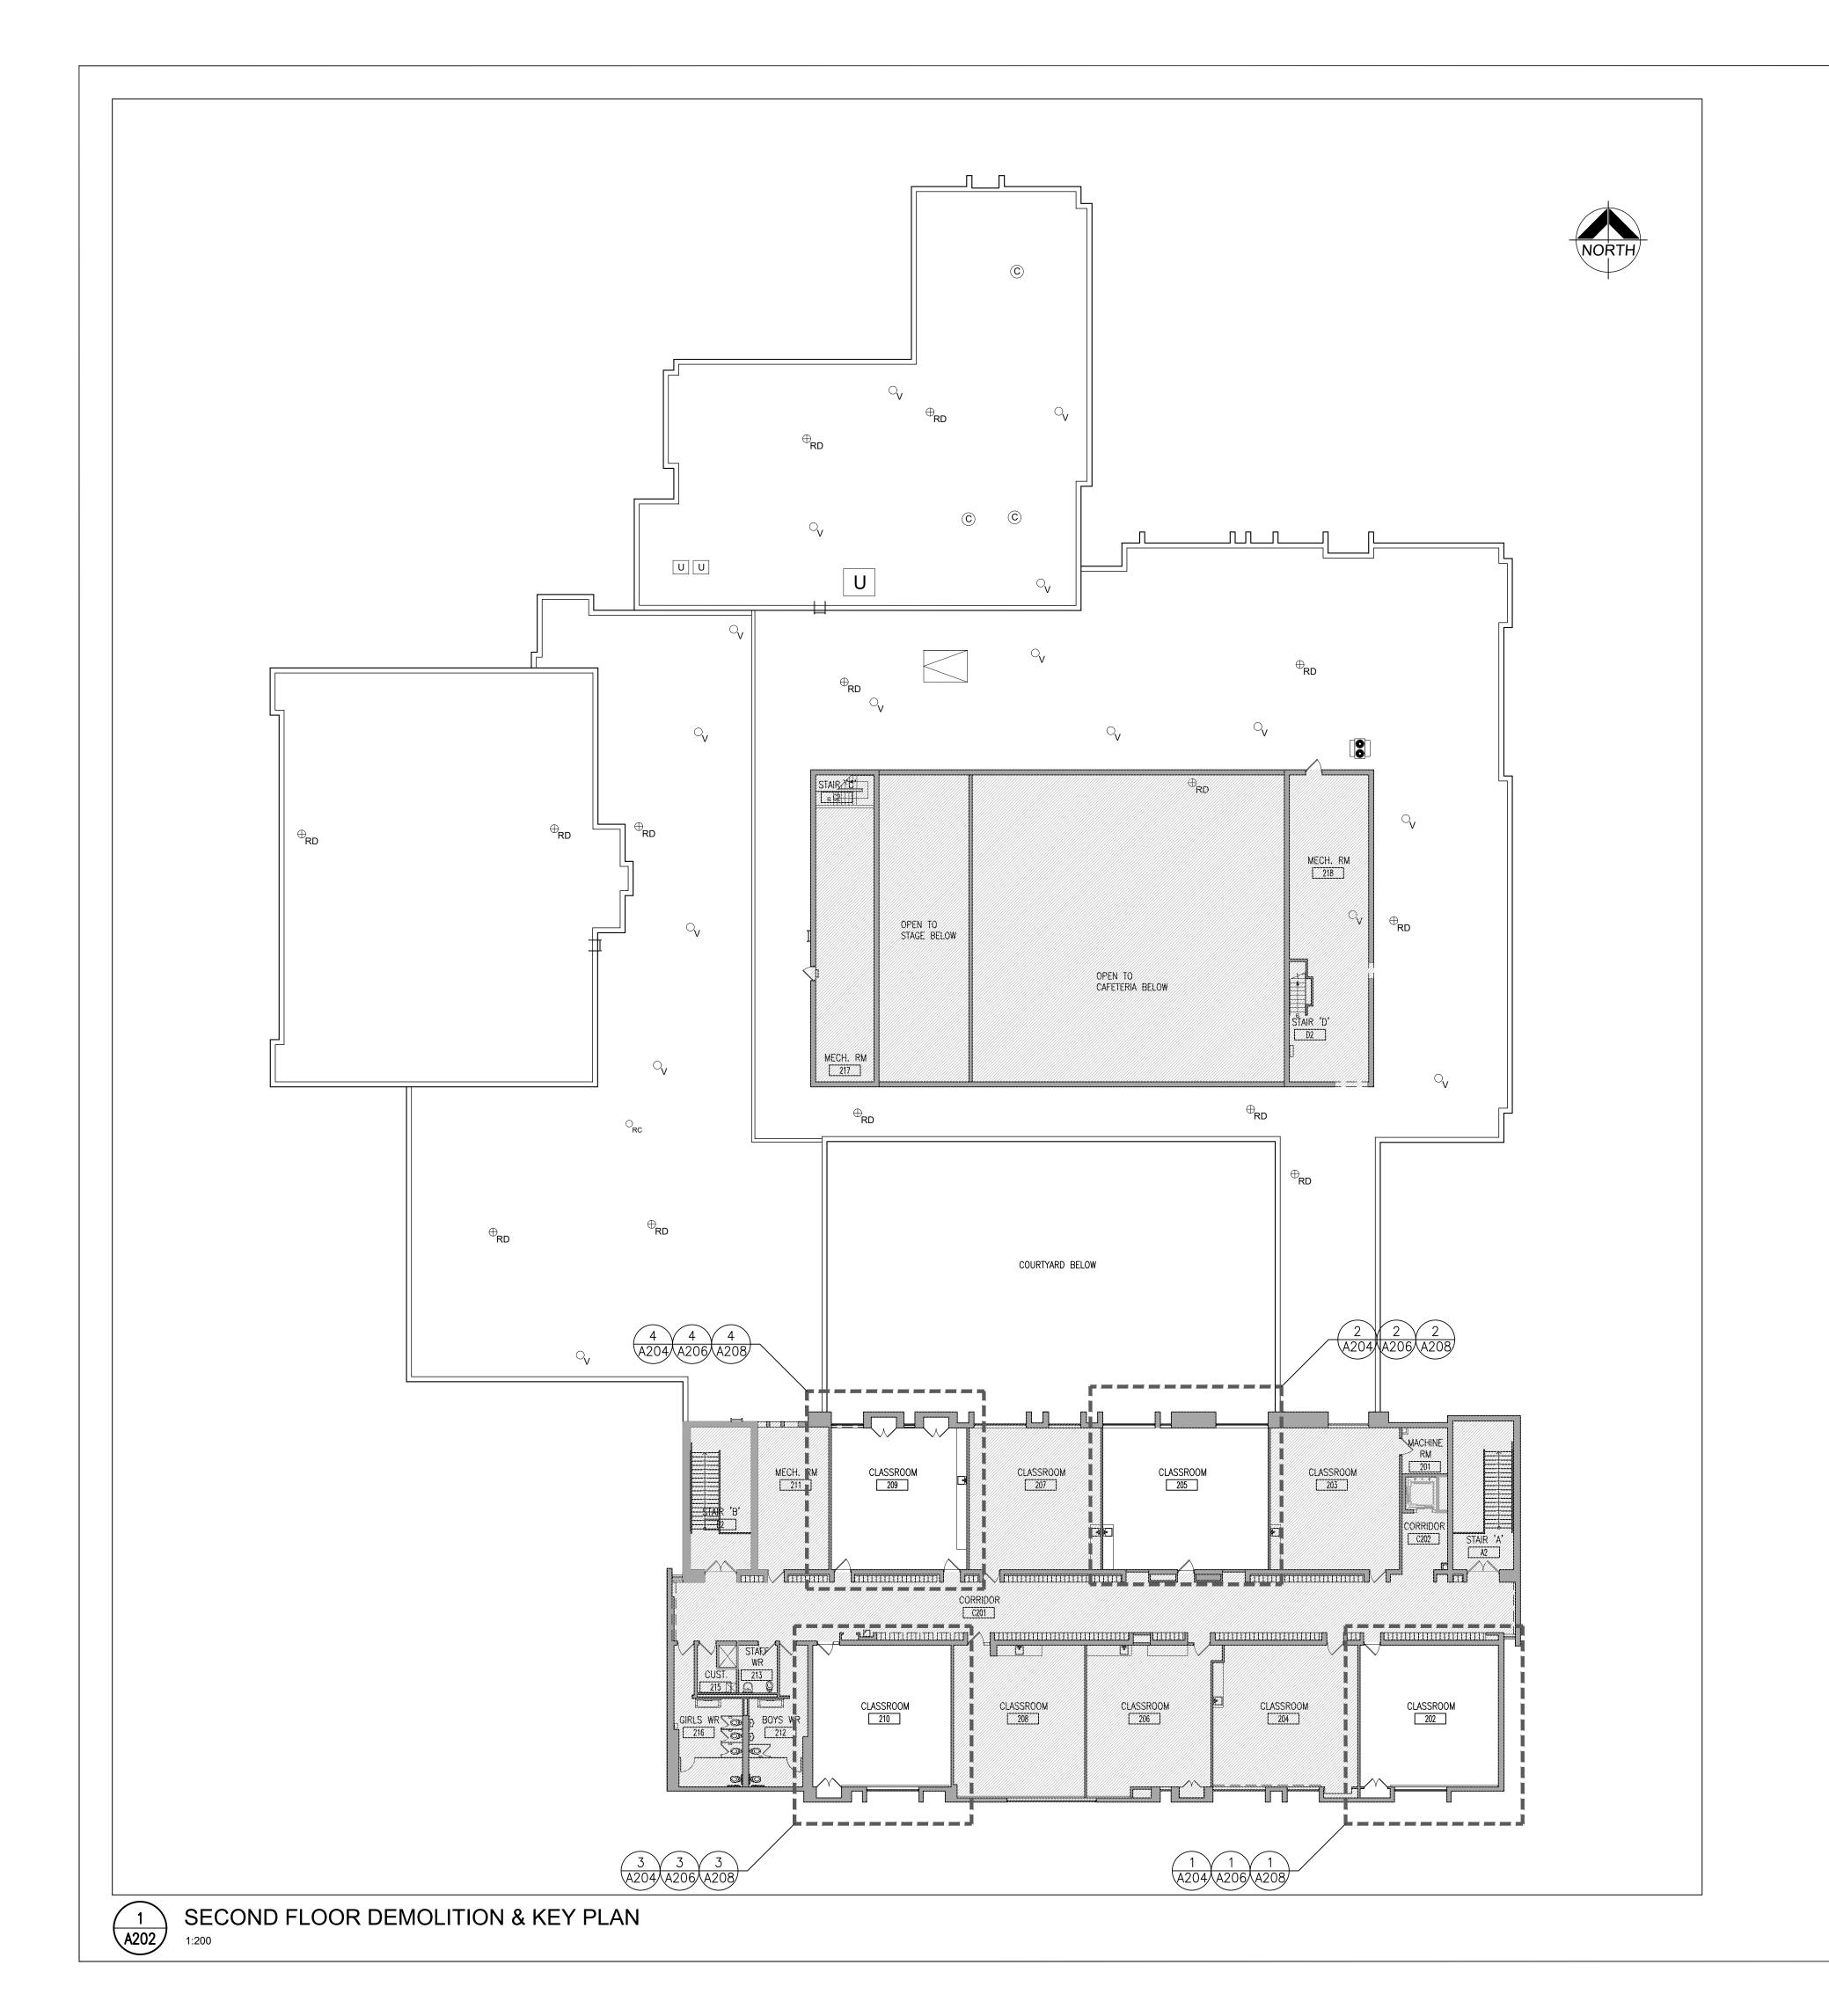


TYPICAL DEMOLITION NOTES

- SITE VERIFY ALL DIMENSIONS AND CONDITIONS. REPORT DISCREPANCIES TO THE CONSULTANTS.
- 2. ALL WORK TO BE IN ACCORDANCE WITH THE ONTARIO BUILDING CODE.
- 3. COMPLY WITH THE OCCUPATIONAL HEALTH AND SAFETY ACT REGULATIONS FOR CONSTRUCTION PROJECTS.
- PROVIDE PROTECTION IN LOCATIONS APPROVED BY THE OWNER AND CONSULTANT SO AS NOT TO DAMAGE EXISTING STRUCTURE, LANDSCAPE OR PART THEREOF.
- COMPLETE ALL DEMOLITION WORK NECESSARY TO COMPLETE THE RENOVATIONS AS SHOWN AND AS REQUIRED. DEMOLITION OF BUILDING ELEMENTS INCLUDES BUT NOT LIMITED TO COMPLETE REMOVAL OF ALL ASSOCIATED FIXTURES, FITTINGS, HARDWARE, FASTENERS, EQUIPMENT AND ACCESSORIES UNLESS NOTED OTHERWISE.
- ARCHITECTURAL, STRUCTURAL, MECHANICAL AND ELECTRICAL DEMOLITION DRAWINGS ARE COMPLEMENTARY AND SHALL BE READ TOGETHER.
- PROVIDE ALL SHORING AS REQUIRED. SHORING SHALL BE DESIGNED BY A REGISTERED PROFESSIONAL ENGINEER.
- NOTIFY CONSULTANT OF LOAD BEARING MEMBERS OR ASSEMBLIES IDENTIFIED OR DISCOVERED DURING WORK AND NOT INDICATED ON DRAWINGS. DO NOT PROCEED WITH REMOVALS WITHOUT PRIOR REVIEW BY THE CONSULTANT.
- . PROVIDE TEMPORARY SUPPORT OF PIPES, DUCTS AND ELECTRICAL CHASES AS REQUIRED FOR SAFE REMOVAL. EXISTING AND PROPOSED SUPPORTS ARE TO BE REVIEWED BY THE CONSULTANT PRIOR TO THE REMOVAL OF ANY COMPONENTS WHICH MAY FALL. OR CAUSE OTHERS TO FALL.
- 10. MAINTAIN ALL WORK AREAS AND ALL STORAGE AREAS CLEAN AND ORDERLY AT ALL TIMES INCLUDING EXISTING AREAS THAT REMAIN IN OPERATION DURING CONSTRUCTION. DUST CONTROL MEASURES ARE TO BE IN PLACE AT ALL TIMES AND NOISY WORK SHALL BE COORDINATED AROUND PROGRAM EVENTS.
- SUBSTRATES TO RECEIVE NEW FLOORING, SATISFACTORY TO THE MANUFACTURER OF NEW FLOOR FINISHES. ALLOW FOR EXCESSIVE LEVELING OF SLABS. 12. DEMOLITION INCLUDES ALL ASSOCIATED MECHANICAL AND ELECTRICAL SERVICES,

. REMOVAL OF EXISTING FLOOR FINISHES IS TO INCLUDE COMPLETE REMOVAL OF BASE AND ALL MORTAR AND ADHESIVES AND PREPARATION OF EXISTING

- EQUIPMENT, FITTINGS, FIXTURES, HANGERS, BRACKETS, TRIM AND ACCESSORIES AS REQUIRED TO COMPLETE THE WORK. 13. SAWCUT, BREAK OUT AND MAKE GOOD (MATCH EXISTING U.N.O.) ALL EXISTING FLOOR SLABS WHERE REQUIRED TO INSTALL NEW UNDERGROUND PLUMBING AND
- OTHER BURIED SERVICES AS INDICATED AND AS REQUIRED ON MECHANICAL AND ELECTRICAL DRAWINGS. 14. REMOVAL OF DOORS AND FRAMES IS TO INCLUDE REMOVAL OF ALL HARDWARE.
- 15. REMOVE ALL PROTRUSIONS IN FLOOR SLAB AND GRIND DOWN TO FLOOR LEVEL.
- 16. CLEAN, PATCH / REPAIR ALL EXISTING SURFACES TO REMAIN TO RECEIVE NEW FINISHES. ALLOW FOR REMOVAL OR SCARIFICATION OF EXISTING PAINT FINISH ON WALLS THAT ARE TO RECEIVE NEW WALL TILE FINISH. REMOVE ALL MORTAR, ADHESIVES AND RUST AS REQUIRED TO PREPARE EXISTING SUBSTRATES TO RECEIVE NEW PAINT FINISHES.
- 17. DISCONNECT AND CAP OFF ALL SERVICES PRIOR TO DEMOLITION.
- 18. DISPOSE OF MATERIALS OFF SITE.
- 19. CONTRACTOR SHALL BE RESPONSIBLE FOR ANY DAMAGE TO THE EXISTING STRUCTURE OR FINISHES SHOWN TO REMAIN AND REPAIR /REPLACE SAME TO THE SATISFACTION OF THE OWNER AND CONSULTANT.
- 20. BUILDING TO BE SECURED BY THE G.C. AT ALL TIMES.
- 21. REFER TO "DESIGNATED SUBSTANCES SURVEY-PRE-RENOVATION, ECOLE ELEMENTAIRE JEANNE-LAJOIE, 150 CARNFORTH ROAD, TORONTO, ONTARIO" DATED MARCH 24 2025, AND "ASBESTOS ABATEMENT SPECIFICATIONS, ECOLE ELEMENTAIRE JEANNE-LAJOIE, 150 CARNFORTH ROAD, TORONTO, ONTARIO" DATED MARCH 2025, PREPARED BY ARCADIS PROFESSIONAL SERVICES (CANADA) INC. DESIGNATED SUBSTANCES AND HAZARDOUS MATERIALS REMOVALS SHALL COMPLY WITH CURRENT
- 22. PATCH, REPAIR & MAKE GOOD ALL SURFACES AFFECTED BY THE WORK, INCLUDING BUT NOT LIMITED TO WALL, PATCHING, PAINTING, MILLWORKS, FLOORING AND

DEMOLITION LEGEND

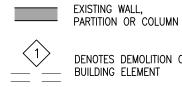

DENOTES DEMOLITION OF

EXISTING DOOR & FRAME TO REMAIN EXISTING DOOR & FRAME TO BE CAREFULLY REMOVED AND DISPOSED OF.

DEMOLITION NOTES

- REMOVE AND DISPOSE OF EXISTING PLUMBING FIXTURES. PATCH, REPAIR & MAKE GOOD ALL SURFACES FOR NEW WORK.
- 2 REMOVE AND DISPOSE OF EXISTING TOILET PARTITIONS. PATCH, REPAIR & MAKE GOOD ALL SURFACES FOR NEW WORK.
- REMOVE AND DISPOSE OF EXISTING WALL TILES. PATCH, REPAIR AND MAKE GOOD AFFECTED SURFACES. PARGE WALLS AS REQUIRED FOR RECEIPT OF NEW FINISHES
- 4 NOT USED
- REMOVE AND DISPOSE OF EXISTING VCT FLOORING & BASE. PATCH, REPAIR AND MAKE GOOD SURFACES AS REQUIRED FOR NEW FINISH. AND MAKE GOOD SURFACES AS REQUIRED FOR NEW FINISH.
- REMOVE AND DISPOSED OF EXISTING ACOUSTIC CEILING IN IT'S ENTIRETY INCLUDING PANELS, GRID, LIGHT FIXTURES, DIFFUSERS, GRILLES, FIRE ALARM AND ELECTRICAL DEVICES. SEE ALSO MECHANICAL AND ELECTRICAL DWGS FOR
- 7 REMOVE AND DISPOSED OF EXISTING MILLWORK. PATCH, REPAIR & MAKE GOOD ALL SURFACES.
- 8 REMOVE EXISTING ROLLER SHADES AND REINSTALL AS REQUIRED TO COMPLETE NEW WORK.
- 9 REMOVE AND DISPOSED OF EXISTING BLACK BOARDS AND TACK BOARDS.
- REMOVE AND REPLACE ALL EXISTING EXTERIOR DOORS AND FRAME. PATCH, REPAIR & MAKE GOOD ALL AS REQUIRED FOR NEW DOOR AND FRAME.
- SAND EXISTING WOOD FLOORING DOWN TO BARE WOOD. PATCH, REPAIR AND MAKE GOOD FOR NEW SATIN AND POLYURETHANE COATING.
- REMOVE & DISPOSE OF UNDER STAGE STORAGE DOORS & HARDWARE. PATCH, REPAIR & MAKE GOOD ALL SURFACES FOR INSTALLATION OF NEW DOORS.
- (13) SCHOOL BOARD TO REMOVE & STORE EXISTING TV/ SMART BOARD. EXISTING TV/ BOARD TO BE REINSTALLED BY SCHOOL BOARD.
- (14) REMOVE AND DISPOSED OF EXISTING METAL SHELVING IN IT'S ENTIRETY. MAKE GOOD ALL AREAS FOR NEW WORK.
- GOOD FOR NEW FINISHES.

(15) REMOVE EXISTING CERAMIC TILE FLOORING & BASE. PATCH, REPAIR & MAKE

- REMOVE & DISPOSE OF EXISTING FOLDING PANEL PARTITION IN IT'S ENTIRETY INCLUDING FLOOR & CEILING RAILS AND WALL PANEL TRACK.
- REMOVE & DISPOSE OF EXISTING STAGE CURTAINS AND RIGGING AND MAKE GOOD FOR NEW CURTAIN INSTALLATION.
- 18 SAWCUT AND REMOVE EXISTING MASONRY WALL AS REQUIRED FOR NEW OPENING, PATCH, REPAIR AND MAKE GOOD AFFECTED SURFACES AS REQU OPENING. PATCH. REPAIR AND MAKE GOOD AFFECTED SURFACES AS REQUIRED FOR NEW WORK (SHORE STRUCTURE AS REQUIRED)
- (19) REMOVE EXISTING HANGING CEILING BARS.
- REMOVE AND DISPOSE INTERIOR DOORS & FRAMES. PATCH, REPAIR AND MAKE GOOD ALL SURFACES AS REQUIRED FOR NEW FINISHES.
- REMOVE EXISTING LIGHTING FIXTURES AND SOUND SYSTEMS. REFER TO ELECTRICAL DRAWINGS FOR MORE DETAILS. ELECTRICAL DRAWINGS FOR MORE DETAILS.

DO NOT SCALE THE DRAWINGS CHECK AND VERIFY ALL DIMENSIONS AT THE SITE.

ALL DRAWINGS, SPECIFICATIONS AND RELATED DOCUMENTS ARE THE COPYRIGHT PROPERTY OF THE CONSULTANT AND MUST BE RETURNED UPON REQUEST. REPRODUCTION OF DRAWINGS IN PART OR WHOLE WITHOUT THE PERMISSION OF THE CONSULTANT IS FORBIDDEN. DRAWINGS ARE NOT TO BE USED FOR CONSTRUCTION UNTIL SIGNED AND SEALED BY THE CONSULTANT.



Conseil scolaire Viamonde

NO.	ISSUES	DATE	BY
1	ISSUED FOR REVIEW	MAR. 18, 2025	BBA
2	ISSUED FOR PERMIT & TENDER	MAR. 20, 2025	BBA

PROJECT:

NO. REVISIONS

RENOVATIONS AT ECOLE ELEMENTAIRE JEANNE-LAJOIE

150 CARNFORTH ROAD NORTH YORK, ONTARIO Conseil scolaire Viamonde

DRAWING:

2ND FLOOR DEMOLITION AND KEY PLAN



MARCHITECTS Z WILLIAM WEIMA LICENCE 1 DESIGN BY:

% COMPLETE:

alo ASSU

DATE BY

ASSOCIATES Architects Engineers Project Managers 250 Water Street Suite 201

BARRY BRYAN

Whitby, Ontario L1N 0G5

PROJECT NO:

Tel: (905) 666-5252 Fax: (905) 666-5256


NOV. 2024 1:200 e-mail: bba@bba-archeng.com FILE:

DRAWN BY:


CHECKED BY:

CM



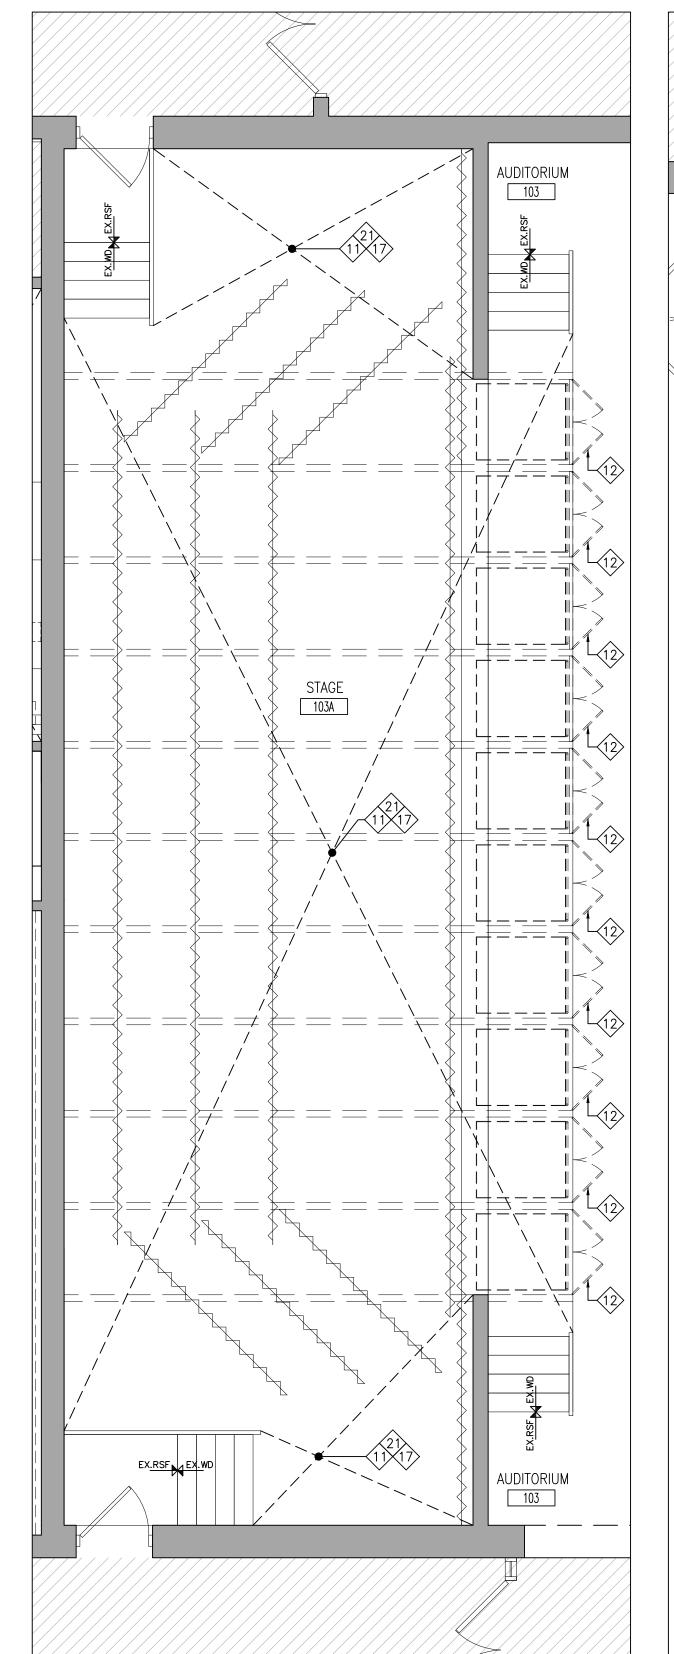

A203

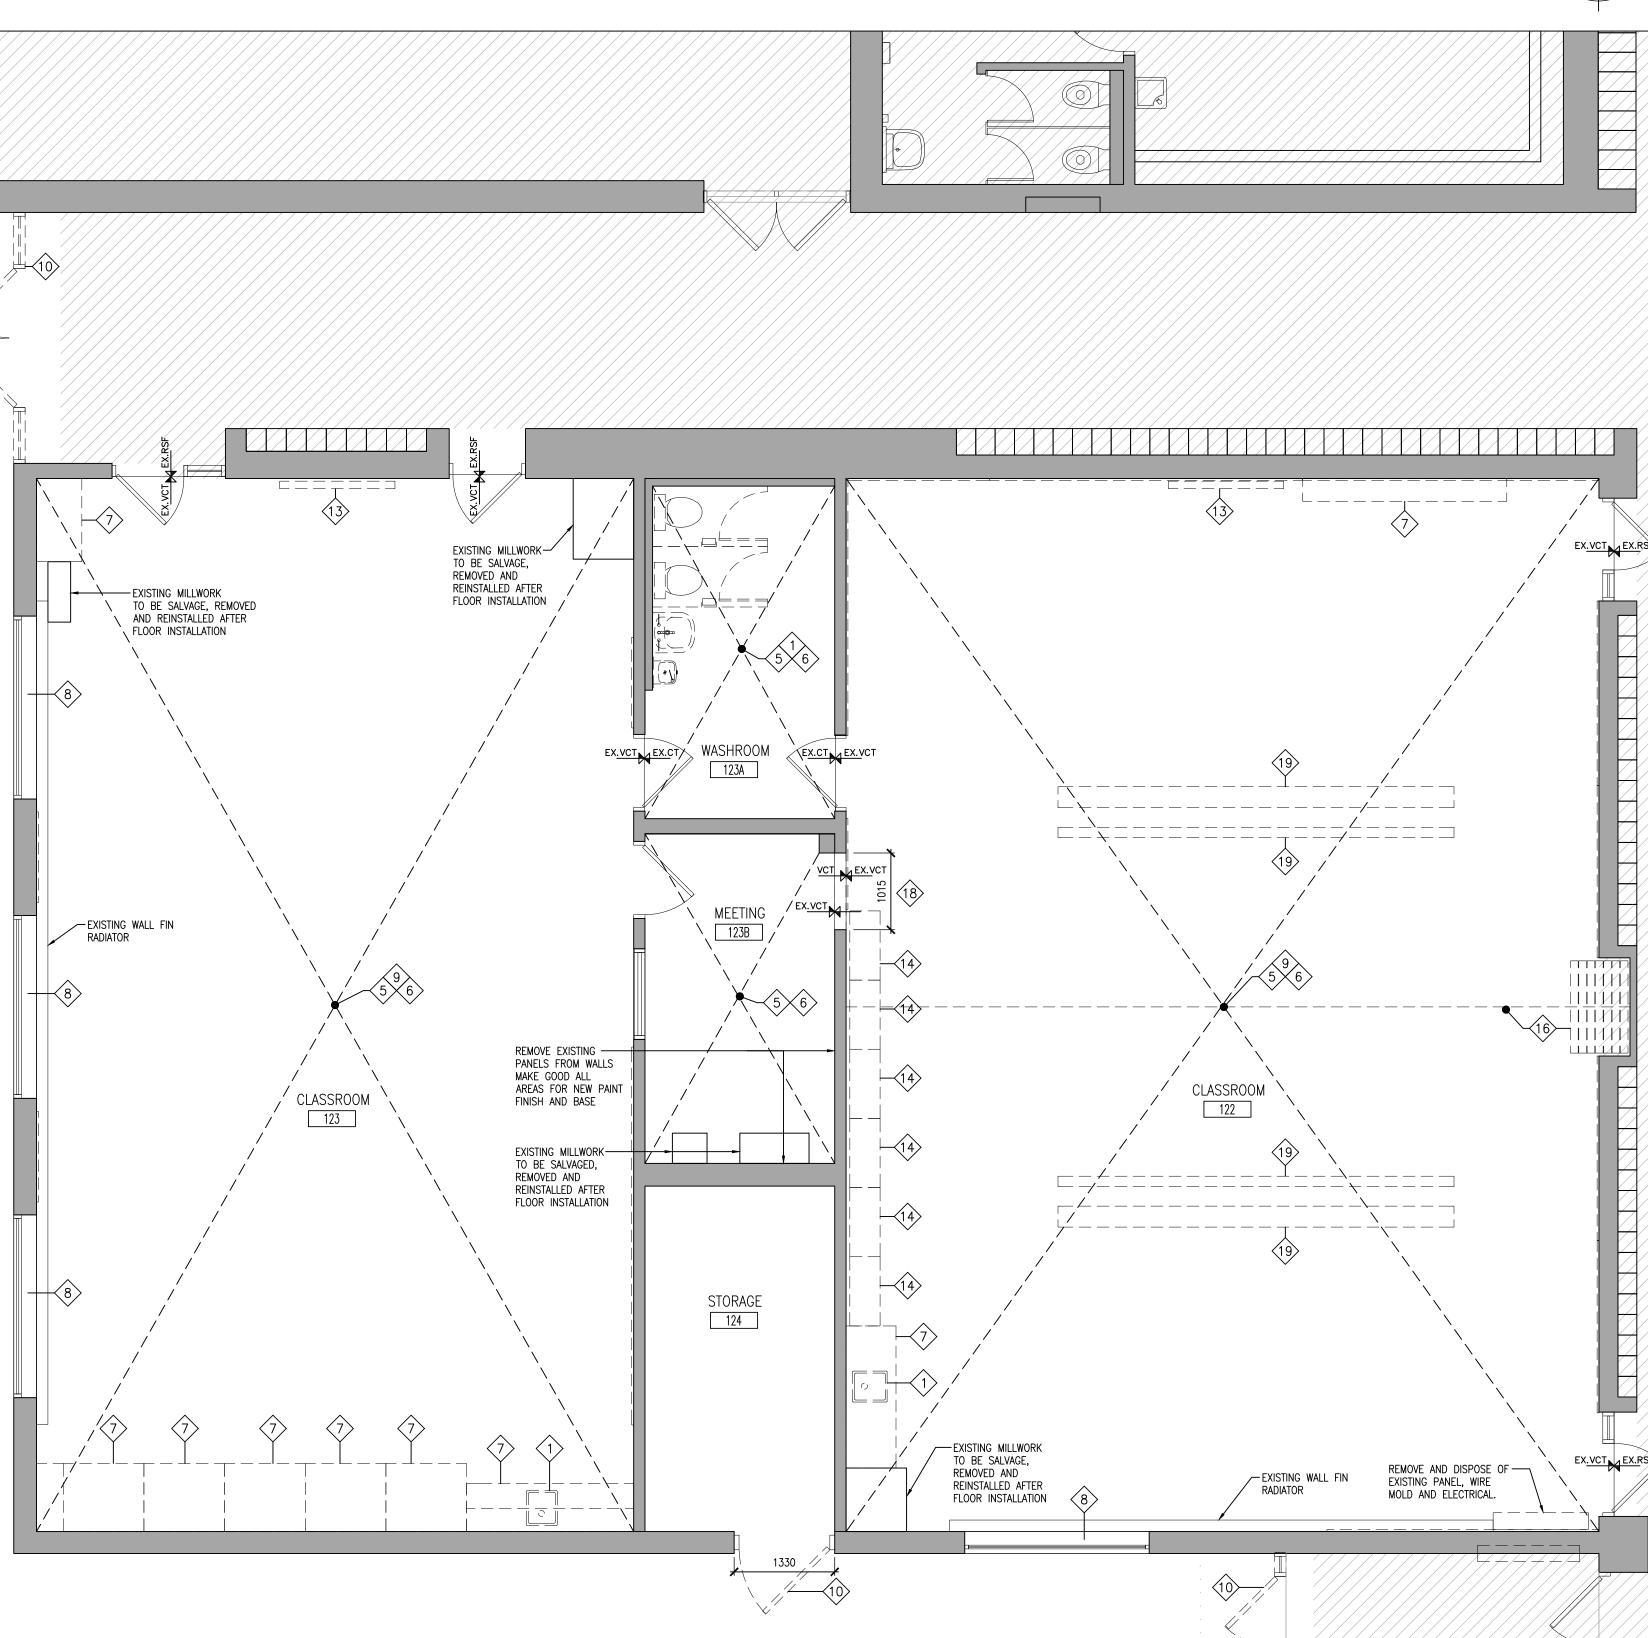

TYPICAL DEMOLITION NOTES

- SITE VERIFY ALL DIMENSIONS AND CONDITIONS. REPORT DISCREPANCIES TO THE CONSULTANTS.
- 2. ALL WORK TO BE IN ACCORDANCE WITH THE ONTARIO BUILDING CODE.
- 6. COMPLY WITH THE OCCUPATIONAL HEALTH AND SAFETY ACT REGULATIONS FOR CONSTRUCTION PROJECTS.
- PROVIDE PROTECTION IN LOCATIONS APPROVED BY THE OWNER AND CONSULTANT SO AS NOT TO DAMAGE EXISTING STRUCTURE, LANDSCAPE OR PART THEREOF.
- COMPLETE ALL DEMOLITION WORK NECESSARY TO COMPLETE THE RENOVATIONS AS SHOWN AND AS REQUIRED. DEMOLITION OF BUILDING ELEMENTS INCLUDES BUT NOT LIMITED TO COMPLETE REMOVAL OF ALL ASSOCIATED FIXTURES, FITTINGS, HARDWARE, FASTENERS, EQUIPMENT AND ACCESSORIES UNLESS NOTED OTHERWISE.
- . ARCHITECTURAL, STRUCTURAL, MECHANICAL AND ELECTRICAL DEMOLITION DRAWINGS ARE COMPLEMENTARY AND SHALL BE READ TOGETHER.
- PROVIDE ALL SHORING AS REQUIRED. SHORING SHALL BE DESIGNED BY A REGISTERED PROFESSIONAL ENGINEER.
- NOTIFY CONSULTANT OF LOAD BEARING MEMBERS OR ASSEMBLIES IDENTIFIED OR DISCOVERED DURING WORK AND NOT INDICATED ON DRAWINGS. DO NOT PROCEED WITH REMOVALS WITHOUT PRIOR REVIEW BY THE CONSULTANT.
- PROVIDE TEMPORARY SUPPORT OF PIPES, DUCTS AND ELECTRICAL CHASES AS REQUIRED FOR SAFE REMOVAL. EXISTING AND PROPOSED SUPPORTS ARE TO BE REVIEWED BY THE CONSULTANT PRIOR TO THE REMOVAL OF ANY COMPONENTS WHICH MAY FALL. OR CAUSE OTHERS TO FALL.
- O. MAINTAIN ALL WORK AREAS AND ALL STORAGE AREAS CLEAN AND ORDERLY AT ALL TIMES INCLUDING EXISTING AREAS THAT REMAIN IN OPERATION DURING CONSTRUCTION. DUST CONTROL MEASURES ARE TO BE IN PLACE AT ALL TIMES AND NOISY WORK SHALL BE COORDINATED AROUND PROGRAM EVENTS.
- REMOVAL OF EXISTING FLOOR FINISHES IS TO INCLUDE COMPLETE REMOVAL OF BASE AND ALL MORTAR AND ADHESIVES AND PREPARATION OF EXISTING SUBSTRATES TO RECEIVE NEW FLOORING, SATISFACTORY TO THE MANUFACTURER OF NEW FLOOR FINISHES. ALLOW FOR EXCESSIVE LEVELING OF SLABS.
- DEMOLITION INCLUDES ALL ASSOCIATED MECHANICAL AND ELECTRICAL SERVICES, EQUIPMENT, FITTINGS, FIXTURES, HANGERS, BRACKETS, TRIM AND ACCESSORIES AS REQUIRED TO COMPLETE THE WORK.
- 13. SAWCUT, BREAK OUT AND MAKE GOOD (MATCH EXISTING U.N.O.) ALL EXISTING FLOOR SLABS WHERE REQUIRED TO INSTALL NEW UNDERGROUND PLUMBING AND OTHER BURIED SERVICES AS INDICATED AND AS REQUIRED ON MECHANICAL AND ELECTRICAL DRAWINGS.
- 14. REMOVAL OF DOORS AND FRAMES IS TO INCLUDE REMOVAL OF ALL HARDWARE. 15. REMOVE ALL PROTRUSIONS IN FLOOR SLAB AND GRIND DOWN TO FLOOR LEVEL.
- 16. CLEAN, PATCH / REPAIR ALL EXISTING SURFACES TO REMAIN TO RECEIVE NEW FINISHES. ALLOW FOR REMOVAL OR SCARIFICATION OF EXISTING PAINT FINISH ON WALLS THAT ARE TO RECEIVE NEW WALL TILE FINISH. REMOVE ALL MORTAR, ADHESIVES AND RUST AS REQUIRED TO PREPARE EXISTING SUBSTRATES TO RECEIVE NEW PAINT FINISHES.
- 17. DISCONNECT AND CAP OFF ALL SERVICES PRIOR TO DEMOLITION. 18. DISPOSE OF MATERIALS OFF SITE.
- 19. CONTRACTOR SHALL BE RESPONSIBLE FOR ANY DAMAGE TO THE EXISTING STRUCTURE OR FINISHES SHOWN TO REMAIN AND REPAIR /REPLACE SAME TO THE SATISFACTION OF THE OWNER AND CONSULTANT.
- 20. BUILDING TO BE SECURED BY THE G.C. AT ALL TIMES.
- 21. REFER TO "DESIGNATED SUBSTANCES SURVEY-PRE-RENOVATION, ECOLE ELEMENTAIRE JEANNE-LAJOIE, 150 CARNFORTH ROAD, TORONTO, ONTARIO" DATED MARCH 24 2025, AND "ASBESTOS ABATEMENT SPECIFICATIONS, ECOLE ELEMENTAIRE JEANNE-LAJOIE, 150 CARNFORTH ROAD, TORONTO, ONTARIO" DATED MARCH 2025, PREPARED BY ARCADIS PROFESSIONAL SERVICES (CANADA) INC. DESIGNATED SUBSTANCES AND HAZARDOUS MATERIALS REMOVALS SHALL COMPLY WITH CURRENT
- 22. PATCH, REPAIR & MAKE GOOD ALL SURFACES AFFECTED BY THE WORK, INCLUDING BUT NOT LIMITED TO WALL, PATCHING, PAINTING, MILLWORKS, FLOORING AND

DEMOLITION LEGEND

EXISTING WALL,
PARTITION OR COLUMN

EXISTING DOOR & FRAME TO REMAIN

EXISTING DOOR & FRAME TO DENOTES DEMOLITION OF BUILDING ELEMENT BE CAREFULLY REMOVED AND DISPOSED OF.

DEMOLITION NOTES

- 1> REMOVE AND DISPOSE OF EXISTING PLUMBING FIXTURES. PATCH, REPAIR & MAKE GOOD ALL SURFACES FOR NEW WORK.
- 2 REMOVE AND DISPOSE OF EXISTING TOILET PARTITIONS. PATCH, REPAIR & MAKE GOOD ALL SURFACES FOR NEW WORK.
- REMOVE AND DISPOSE OF EXISTING WALL TILES. PATCH, REPAIR AND MAKE GOOD AFFECTED SURFACES. PARGE WALLS AS REQUIRED FOR RECEIPT OF NEW FINISHES
- REMOVE AND DISPOSE OF EXISTING VCT FLOORING & BASE. PATCH, REPAIR AND MAKE GOOD SURFACES AS DECUMED FOR AND
- AND MAKE GOOD SURFACES AS REQUIRED FOR NEW FINISH. REMOVE AND DISPOSED OF EXISTING ACOUSTIC CEILING IN IT'S ENTIRETY $\stackrel{ullet}{\sim}$ including panels, grid, light fixtures, diffusers, grilles, fire alarm AND ELECTRICAL DEVICES. SEE ALSO MECHANICAL AND ELECTRICAL DWGS FOR
- 7 REMOVE AND DISPOSED OF EXISTING MILLWORK. PATCH, REPAIR & MAKE GOOD ✓ ALL SURFACES.
- 8 REMOVE EXISTING ROLLER SHADES AND REINSTALL AS REQUIRED TO COMPLETE
- 9 REMOVE AND DISPOSED OF EXISTING BLACK BOARDS AND TACK BOARDS.
- REMOVE AND REPLACE ALL EXISTING EXTERIOR DOORS AND FRAME. PATCH,
- (11) SAND EXISTING WOOD FLOORING DOWN TO BARE WOOD. PATCH, REPAIR AND MAKE GOOD FOR NEW SATIN AND POLYURETHANE COATING.

REPAIR & MAKE GOOD ALL AS REQUIRED FOR NEW DOOR AND FRAME.

- 12 REMOVE & DISPOSE OF UNDER STAGE STORAGE DOORS & HARDWARE. PATCH, REPAIR & MAKE GOOD ALL SURFACES FOR INSTALLATION OF NEW DOORS.
- (13) SCHOOL BOARD TO REMOVE & STORE EXISTING TV/ SMART BOARD. EXISTING TV/ BOARD TO BE REINSTALLED BY SCHOOL BOARD.
- (14) REMOVE AND DISPOSED OF EXISTING METAL SHELVING IN IT'S ENTIRETY. MAKE GOOD ALL AREAS FOR NEW WORK.
- GOOD FOR NEW FINISHES. (16) REMOVE & DISPOSE OF EXISTING FOLDING PANEL PARTITION IN IT'S ENTIRETY

(15) REMOVE EXISTING CERAMIC TILE FLOORING & BASE. PATCH, REPAIR & MAKE

- INCLUDING FLOOR & CEILING RAILS AND WALL PANEL TRACK. (17) REMOVE & DISPOSE OF EXISTING STAGE CURTAINS AND RIGGING AND MAKE GOOD FOR NEW CURTAIN INSTALLATION.
- 18 SAWCUT AND REMOVE EXISTING MASONRY WALL AS REQUIRED FOR NEW OPENING PATCH REPAIR AND MAKE GOOD AFFECTED SURFACES AS REQU OPENING. PATCH, REPAIR AND MAKE GOOD AFFECTED SURFACES AS REQUIRED FOR NEW WORK (SHORE STRUCTURE AS REQUIRED)
- (19) REMOVE EXISTING HANGING CEILING BARS.
- REMOVE AND DISPOSE INTERIOR DOORS & FRAMES. PATCH, REPAIR AND MAKE GOOD ALL SURFACES AS REQUIRED FOR NEW FINISHES.
- REMOVE EXISTING LIGHTING FIXTURES AND SOUND SYSTEMS. REFER TO ELECTRICAL DRAWINGS FOR MODE DETAILS ELECTRICAL DRAWINGS FOR MORE DETAILS.

DO NOT SCALE THE DRAWINGS CHECK AND VERIFY ALL DIMENSIONS AT THE SITE.

ALL DRAWINGS, SPECIFICATIONS AND RELATED DOCUMENTS ARE THE COPYRIGHT PROPERTY OF THE CONSULTANT AND MUST BE RETURNED UPON REQUEST. REPRODUCTION OF DRAWINGS IN PART OR WHOLE WITHOUT THE PERMISSION OF THE CONSULTANT IS FORBIDDEN. DRAWINGS ARE NOT TO BE USED FOR CONSTRUCTION UNTIL SIGNED AND SEALED BY THE CONSULTANT.



NO.	ISSUES	DATE	BY
1	ISSUED FOR REVIEW	MAR. 18, 2025	BBA
2	ISSUED FOR PERMIT & TENDER	MAR. 20, 2025	BBA

PROJECT:

NO. REVISIONS

RENOVATIONS AT ECOLE ELEMENTAIRE JEANNE-LAJOIE

150 CARNFORTH ROAD NORTH YORK, ONTARIO Conseil scolaire Viamonde

DRAWING:

PART FIRST FLOOR **DEMOLITION PLANS**





DATE BY

BARRY BRYAN DESIGN BY: **ASSOCIATES** DRAWN BY: Architects Engineers

% COMPLETE: Project Managers CHECKED BY: CM 250 Water Street NOV. 2024

Whitby, Ontario L1N 0G5 Tel: (905) 666-5252 Fax: (905) 666-5256 e-mail: bba@bba-archeng.com


Suite 201

1:50 FILE:


PROJECT NO: 24195 **A203**

PART 1ST FLOOR DEMOLITION PLAN


PART 1ST FLOOR DEMOLITION PLAN A203

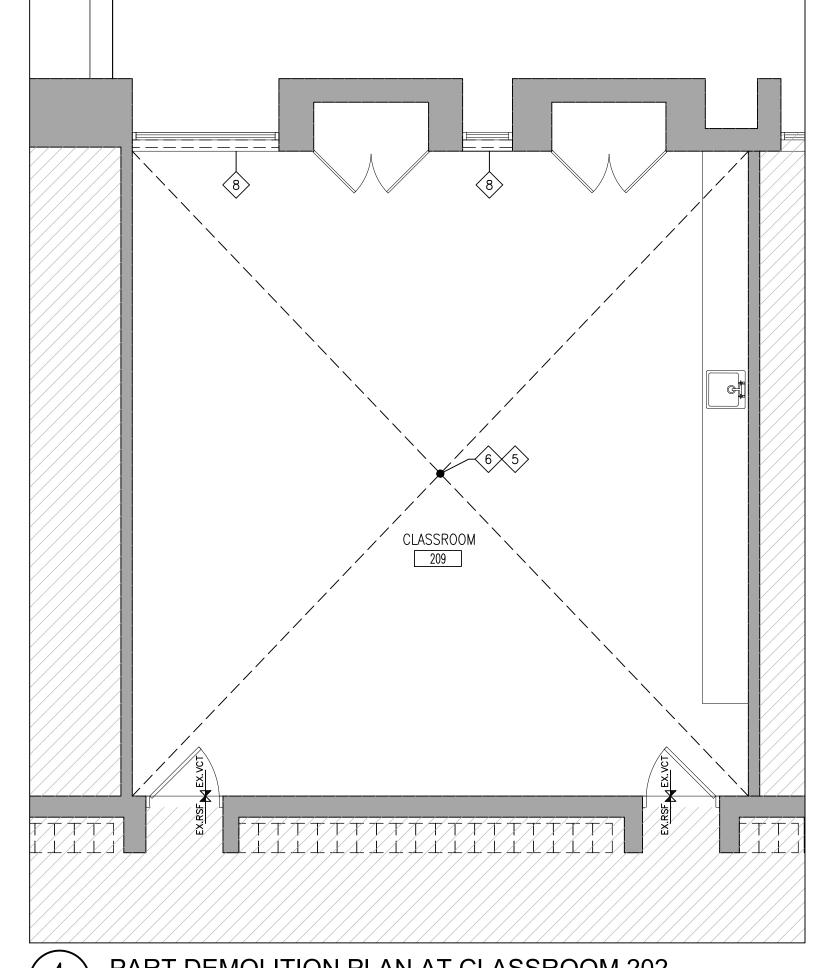




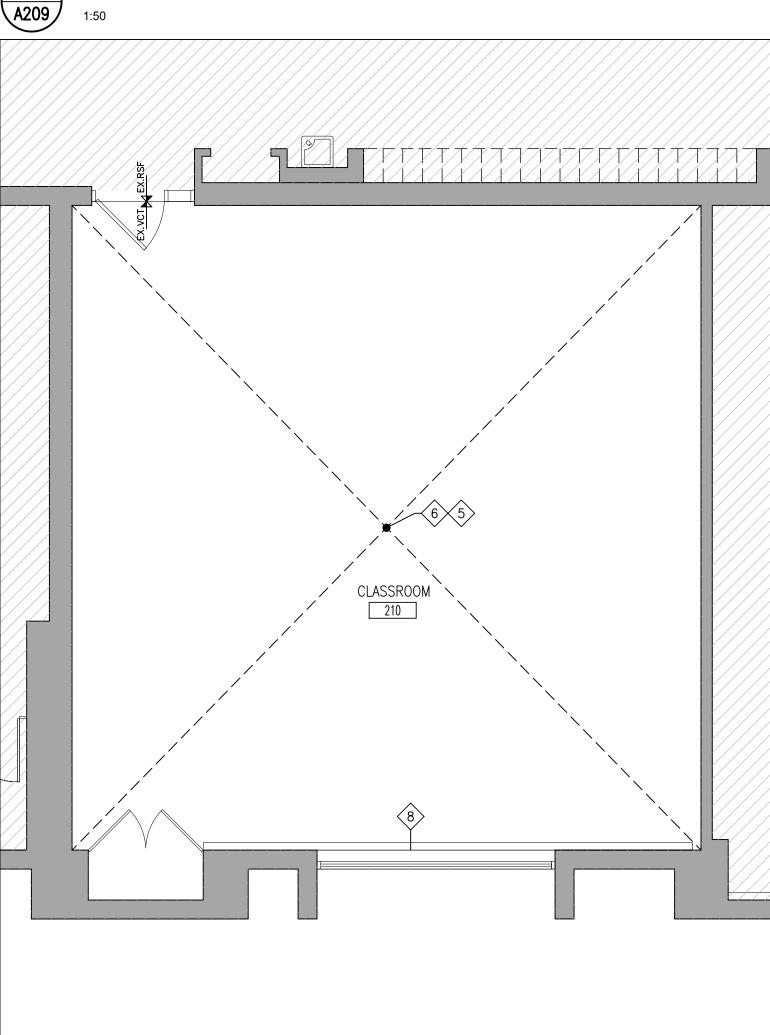

PART DEMOLITION PLAN AT CLASSROOM 2102

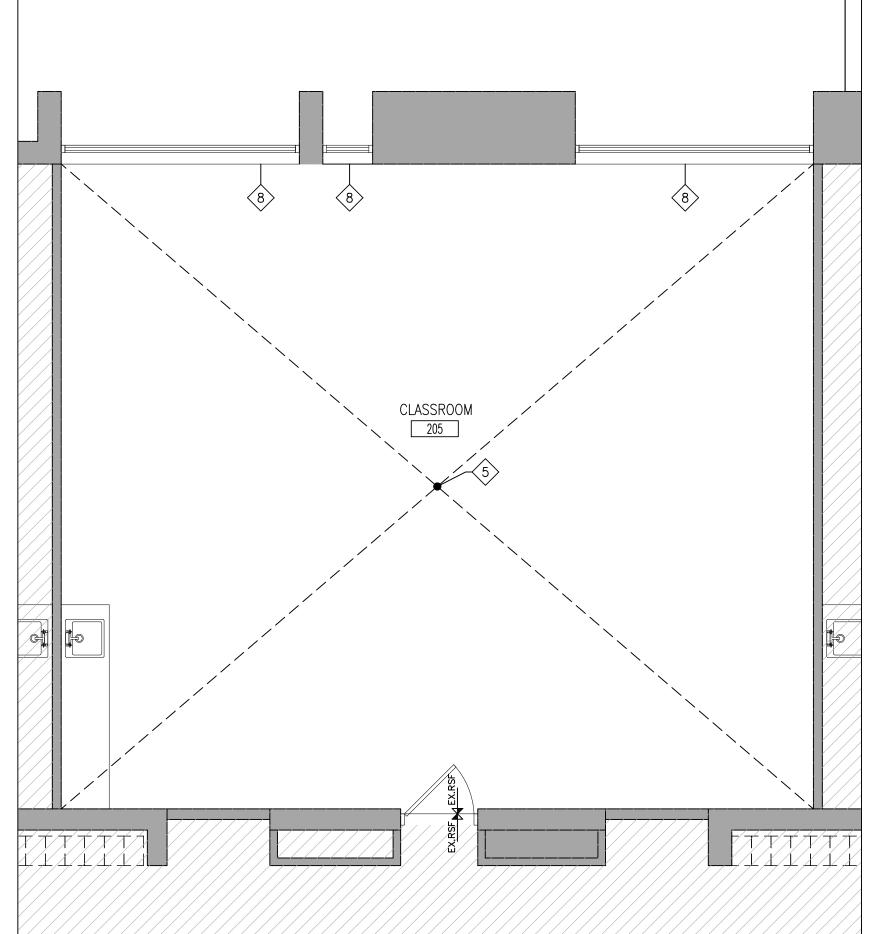

PART DEMOLITION PLAN AT CLASSROOM 205 A204

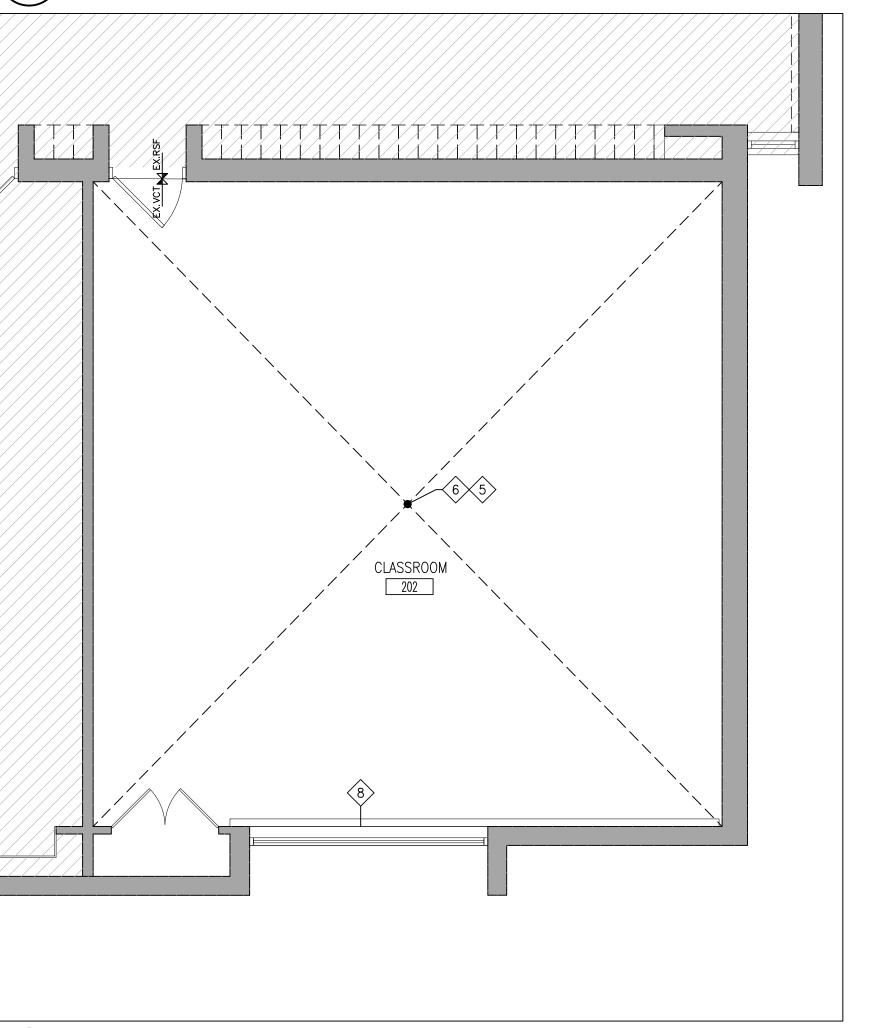

PART DEMOLITION PLAN AT CLASSROOM 202

TYPICAL DEMOLITION NOTES

- SITE VERIFY ALL DIMENSIONS AND CONDITIONS. REPORT DISCREPANCIES TO THE CONSULTANTS.
- ALL WORK TO BE IN ACCORDANCE WITH THE ONTARIO BUILDING CODE.
- COMPLY WITH THE OCCUPATIONAL HEALTH AND SAFETY ACT REGULATIONS FOR CONSTRUCTION PROJECTS.
- PROVIDE PROTECTION IN LOCATIONS APPROVED BY THE OWNER AND CONSULTANT SO AS NOT TO DAMAGE EXISTING STRUCTURE, LANDSCAPE OR PART THEREOF.
- COMPLETE ALL DEMOLITION WORK NECESSARY TO COMPLETE THE RENOVATIONS AS SHOWN AND AS REQUIRED. DEMOLITION OF BUILDING ELEMENTS INCLUDES BUT NOT LIMITED TO COMPLETE REMOVAL OF ALL ASSOCIATED FIXTURES, FITTINGS, HARDWARE, FASTENERS, EQUIPMENT AND ACCESSORIES UNLESS NOTED OTHERWISE.
- ARCHITECTURAL, STRUCTURAL, MECHANICAL AND ELECTRICAL DEMOLITION DRAWINGS ARE COMPLEMENTARY AND SHALL BE READ TOGETHER.
- PROVIDE ALL SHORING AS REQUIRED. SHORING SHALL BE DESIGNED BY A REGISTERED PROFESSIONAL ENGINEER.
- NOTIFY CONSULTANT OF LOAD BEARING MEMBERS OR ASSEMBLIES IDENTIFIED OR DISCOVERED DURING WORK AND NOT INDICATED ON DRAWINGS. DO NOT PROCEED WITH REMOVALS WITHOUT PRIOR REVIEW BY THE CONSULTANT.
- PROVIDE TEMPORARY SUPPORT OF PIPES, DUCTS AND ELECTRICAL CHASES AS REQUIRED FOR SAFE REMOVAL. EXISTING AND PROPOSED SUPPORTS ARE TO BE REVIEWED BY THE CONSULTANT PRIOR TO THE REMOVAL OF ANY COMPONENTS WHICH MAY FALL. OR CAUSE OTHERS TO FALL.
- 10. MAINTAIN ALL WORK AREAS AND ALL STORAGE AREAS CLEAN AND ORDERLY AT ALL TIMES INCLUDING EXISTING AREAS THAT REMAIN IN OPERATION DURING CONSTRUCTION. DUST CONTROL MEASURES ARE TO BE IN PLACE AT ALL TIMES AND NOISY WORK SHALL BE COORDINATED AROUND PROGRAM EVENTS.
- REMOVAL OF EXISTING FLOOR FINISHES IS TO INCLUDE COMPLETE REMOVAL OF BASE AND ALL MORTAR AND ADHESIVES AND PREPARATION OF EXISTING SUBSTRATES TO RECEIVE NEW FLOORING, SATISFACTORY TO THE MANUFACTURER OF NEW FLOOR FINISHES. ALLOW FOR EXCESSIVE LEVELING OF SLABS.
- 2. DEMOLITION INCLUDES ALL ASSOCIATED MECHANICAL AND ELECTRICAL SERVICES, EQUIPMENT, FITTINGS, FIXTURES, HANGERS, BRACKETS, TRIM AND ACCESSORIES AS REQUIRED TO COMPLETE THE WORK.
- 13. SAWCUT, BREAK OUT AND MAKE GOOD (MATCH EXISTING U.N.O.) ALL EXISTING FLOOR SLABS WHERE REQUIRED TO INSTALL NEW UNDERGROUND PLUMBING AND OTHER BURIED SERVICES AS INDICATED AND AS REQUIRED ON MECHANICAL AND ELECTRICAL DRAWINGS.
- 14. REMOVAL OF DOORS AND FRAMES IS TO INCLUDE REMOVAL OF ALL HARDWARE. 15. REMOVE ALL PROTRUSIONS IN FLOOR SLAB AND GRIND DOWN TO FLOOR LEVEL.
- 16. CLEAN, PATCH / REPAIR ALL EXISTING SURFACES TO REMAIN TO RECEIVE NEW FINISHES. ALLOW FOR REMOVAL OR SCARIFICATION OF EXISTING PAINT FINISH ON WALLS THAT ARE TO RECEIVE NEW WALL TILE FINISH. REMOVE ALL MORTAR, ADHESIVES AND RUST AS REQUIRED TO PREPARE EXISTING SUBSTRATES TO RECEIVE NEW PAINT FINISHES.
- 17. DISCONNECT AND CAP OFF ALL SERVICES PRIOR TO DEMOLITION. 18. DISPOSE OF MATERIALS OFF SITE.
- 19. CONTRACTOR SHALL BE RESPONSIBLE FOR ANY DAMAGE TO THE EXISTING STRUCTURE OR FINISHES SHOWN TO REMAIN AND REPAIR / REPLACE SAME TO THE SATISFACTION OF THE OWNER AND CONSULTANT.
- 20. BUILDING TO BE SECURED BY THE G.C. AT ALL TIMES.
- 1. REFER TO "DESIGNATED SUBSTANCES SURVEY-PRE-RENOVATION, ECOLE ELEMENTAIRE JEANNE-LAJOIE, 150 CARNFORTH ROAD, TORONTO, ONTARIO" DATED MARCH 24 2025, AND "ASBESTOS ABATEMENT SPECIFICATIONS, ECOLE ELEMENTAIRE JEANNE-LAJOIE, 150 CARNFORTH ROAD, TORONTO, ONTARIO" DATED MARCH 2025, PREPARED BY ARCADIS PROFESSIONAL SERVICES (CANADA) INC. DESIGNATED SUBSTANCES AND HAZARDOUS MATERIALS REMOVALS SHALL COMPLY WITH CURRENT
- 2. PATCH, REPAIR & MAKE GOOD ALL SURFACES AFFECTED BY THE WORK, INCLUDING BUT NOT LIMITED TO WALL, PATCHING, PAINTING, MILLWORKS, FLOORING AND

DEMOLITION LEGEND

EXISTING WALL,
PARTITION OR COLUMN

EXISTING DOOR & FRAME TO REMAIN

EXISTING DOOR & FRAME TO DENOTES DEMOLITION OF BUILDING ELEMENT BE CAREFULLY REMOVED AND DISPOSED OF.

DEMOLITION NOTES

- 1 REMOVE AND DISPOSE OF EXISTING PLUMBING FIXTURES. PATCH, REPAIR & MAKE GOOD ALL SURFACES FOR NEW WORK.
- 2 REMOVE AND DISPOSE OF EXISTING TOILET PARTITIONS. PATCH, REPAIR & MAKE GOOD ALL SURFACES FOR NEW WORK.
- REMOVE AND DISPOSE OF EXISTING WALL TILES. PATCH, REPAIR AND MAKE GOOD AFFECTED SURFACES. PARGE WALLS AS REQUIRED FOR RECEIPT OF NEW FINISHES
- 4 NOT USED
- REMOVE AND DISPOSE OF EXISTING VCT FLOORING & BASE. PATCH, REPAIR AND MAKE GOOD SURFACES AS REQUIRED FOR VCT.
- AND MAKE GOOD SURFACES AS REQUIRED FOR NEW FINISH. REMOVE AND DISPOSED OF EXISTING ACOUSTIC CEILING IN IT'S ENTIRETY 6 INCLUDING PANELS, GRID, LIGHT FIXTURES, DIFFUSERS, GRILLES, FIRE ALARM AND ELECTRICAL DEVICES. SEE ALSO MECHANICAL AND ELECTRICAL DWGS FOR
- 7 REMOVE AND DISPOSED OF EXISTING MILLWORK. PATCH, REPAIR & MAKE GOOD ALL SURFACES.
- 8 REMOVE EXISTING ROLLER SHADES AND REINSTALL AS REQUIRED TO COMPLETE NEW WORK.
- 9 REMOVE AND DISPOSED OF EXISTING BLACK BOARDS AND TACK BOARDS.

REPAIR & MAKE GOOD ALL AS REQUIRED FOR NEW DOOR AND FRAME.

- REMOVE AND REPLACE ALL EXISTING EXTERIOR DOORS AND FRAME. PATCH, REPAIR & MAKE GOOD ALL AS REQUIRED FOR NEW DOOR AND FRAME.
- SAND EXISTING WOOD FLOORING DOWN TO BARE WOOD. PATCH, REPAIR AND MAKE GOOD FOR NEW SATIN AND POLYURETHANE COATING.
- REMOVE & DISPOSE OF UNDER STAGE STORAGE DOORS & HARDWARE. PATCH, REPAIR & MAKE GOOD ALL SURFACES FOR INSTALLATION OF NEW DOORS.
- \$\langle 13 \rangle SCHOOL BOARD TO REMOVE & STORE EXISTING TV/ SMART BOARD. EXISTING
- TV/ BOARD TO BE REINSTALLED BY SCHOOL BOARD. 14 REMOVE AND DISPOSED OF EXISTING METAL SHELVING IN IT'S ENTIRETY.
- MAKE GOOD ALL AREAS FOR NEW WORK. (15) REMOVE EXISTING CERAMIC TILE FLOORING & BASE. PATCH, REPAIR & MAKE
- (16) REMOVE & DISPOSE OF EXISTING FOLDING PANEL PARTITION IN IT'S ENTIRETY
- INCLUDING FLOOR & CEILING RAILS AND WALL PANEL TRACK.
- (17) REMOVE & DISPOSE OF EXISTING STAGE CURTAINS AND RIGGING AND MAKE GOOD FOR NEW CURTAIN INSTALLATION.
- 18 SAWCUT AND REMOVE EXISTING MASONRY WALL AS REQUIRED FOR NEW OPENING. PATCH, REPAIR AND MAKE GOOD AFFECTED SURFACES AS REQUIRED FOR NEW WORK (SHORE STRUCTURE AS REQUIRED)
- (19) REMOVE EXISTING HANGING CEILING BARS.

GOOD FOR NEW FINISHES.

- REMOVE AND DISPOSE INTERIOR DOORS & FRAMES. PATCH, REPAIR AND MAKE GOOD ALL SURFACES AS REQUIRED FOR NEW FINISHES.
- REMOVE EXISTING LIGHTING FIXTURES AND SOUND SYSTEMS. REFER TO ELECTRICAL DRAWINGS FOR MODE DETAILS ELECTRICAL DRAWINGS FOR MORE DETAILS.

DO NOT SCALE THE DRAWINGS CHECK AND VERIFY ALL DIMENSIONS AT THE SITE.

ALL DRAWINGS, SPECIFICATIONS AND RELATED DOCUMENTS ARE THE COPYRIGHT PROPERTY OF THE CONSULTANT AND MUST BE RETURNED UPON REQUEST. REPRODUCTION OF DRAWINGS IN PART OR WHOLE WITHOUT THE PERMISSION OF THE CONSULTANT IS FORBIDDEN. DRAWINGS ARE NOT TO BE USED FOR CONSTRUCTION UNTIL SIGNED AND SEALED BY THE CONSULTANT.



NO.	ISSUES	DATE	BY
1	ISSUED FOR REVIEW	MAR. 18, 2025	BBA
2	ISSUED FOR PERMIT & TENDER	MAR. 20, 2025	BBA

NO. REVISIONS DATE BY

PROJECT:

RENOVATIONS AT ECOLE ELEMENTAIRE JEANNE-LAJOIE

150 CARNFORTH ROAD NORTH YORK, ONTARIO Conseil scolaire Viamonde

DRAWING:

PART DEMOLITION PLANS





BARRY BRYAN **ASSOCIATES** Architects Engineers

% COMPLETE: DRAWN BY: Project Managers CHECKED BY: CM 250 Water Street NOV. 2024

Whitby, Ontario L1N 0G5 Tel: (905) 666-5252 Fax: (905) 666-5256 e-mail: bba@bba-archeng.com

Suite 201

1:50 FILE:

DRAWING NO: A204

PROJECT NO: 24195



WASHROOM 129

EX.RSF EX.CT

CUSTODIAN 128


GIRLS

WASHROOM


126

EX.RSF EX.WD

A204

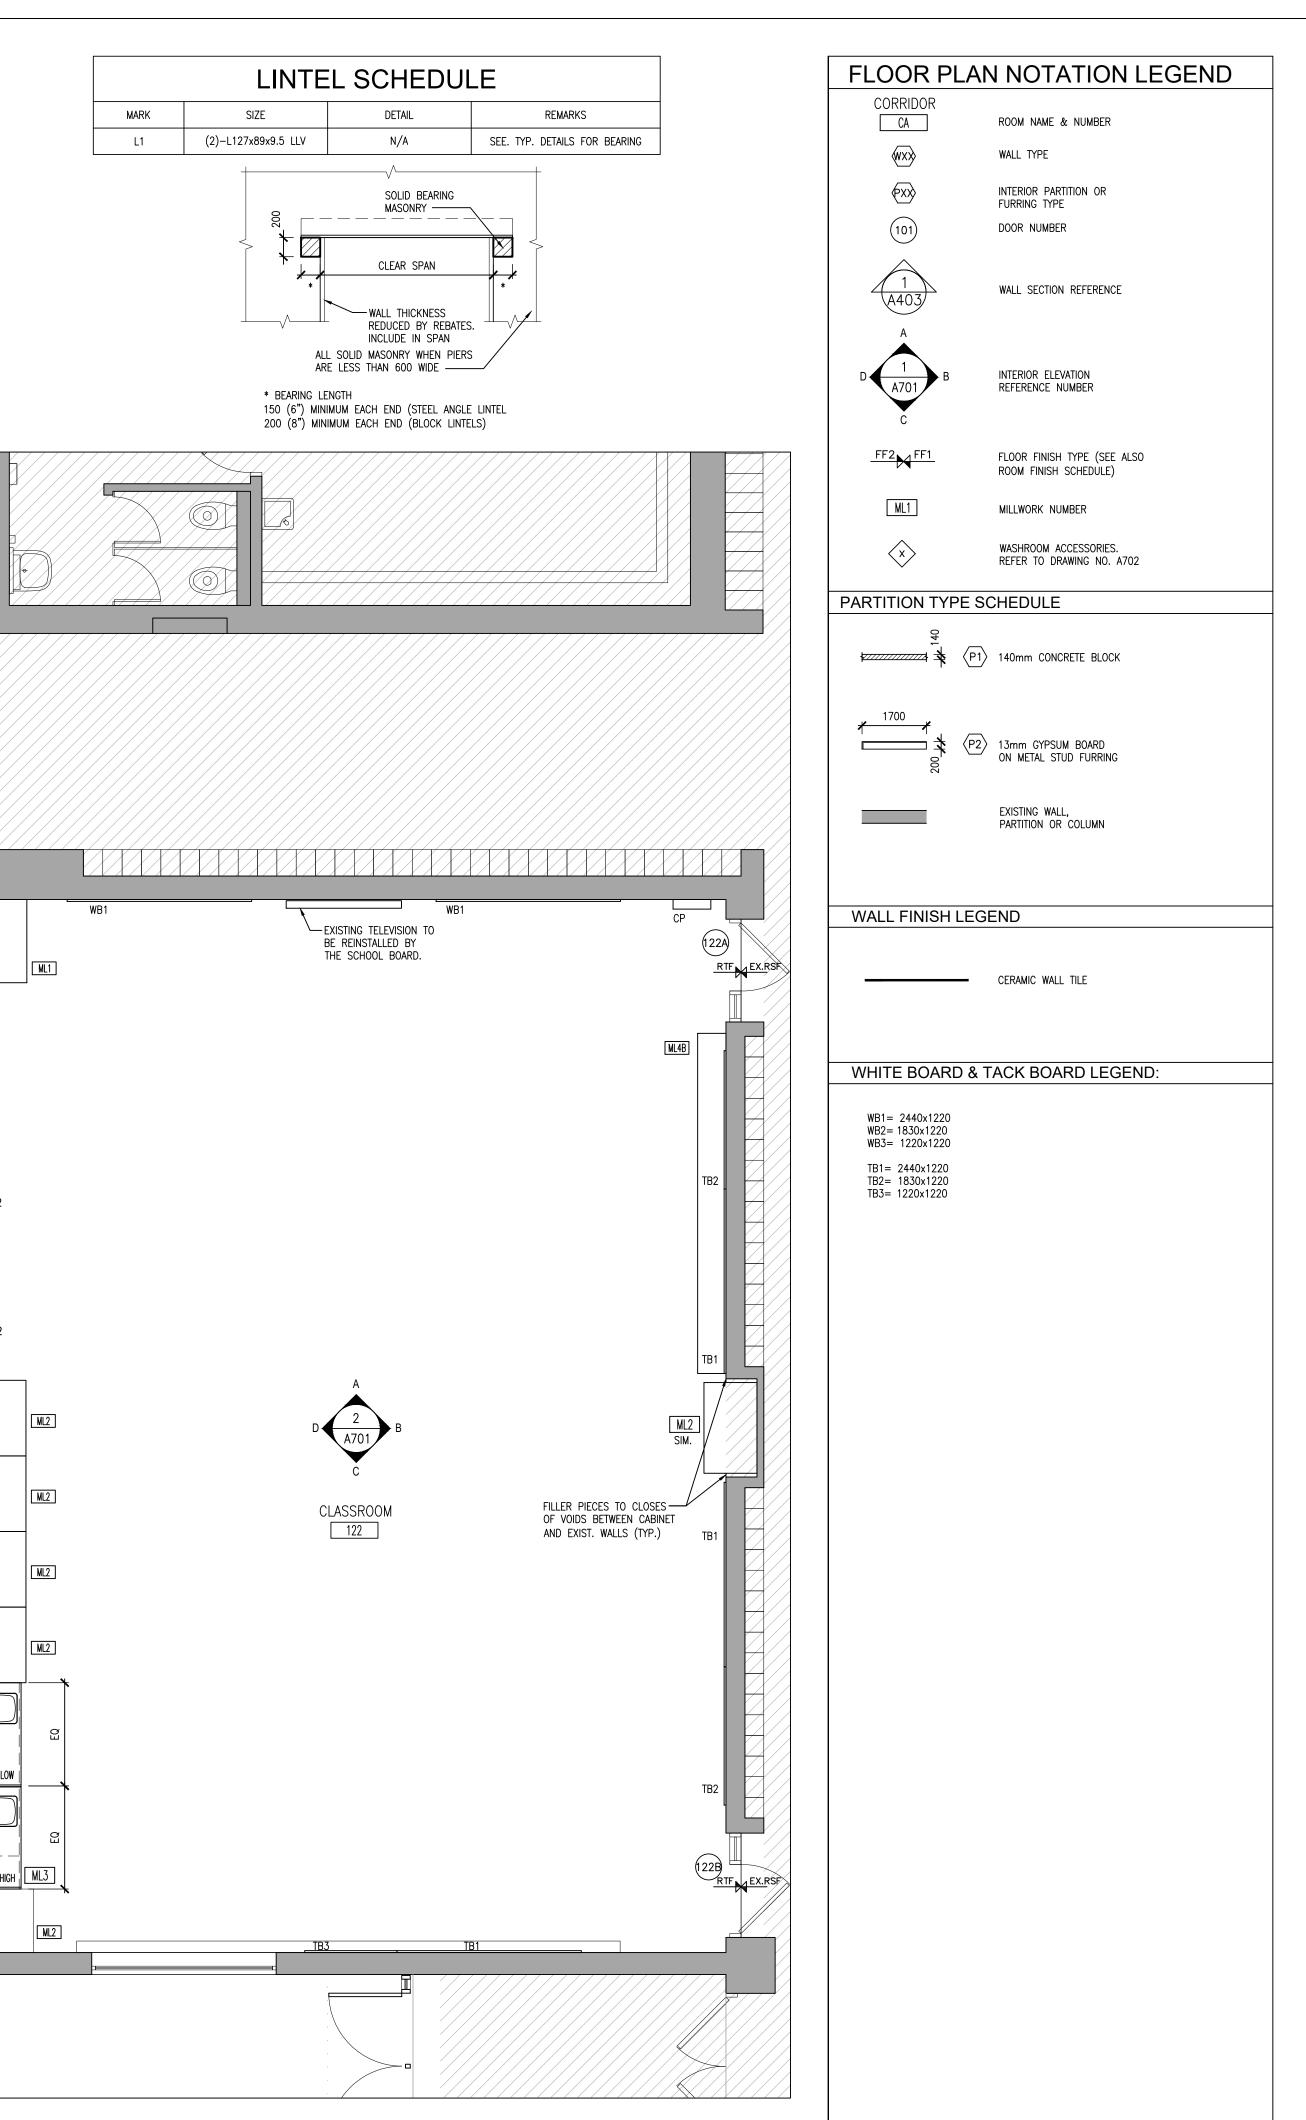




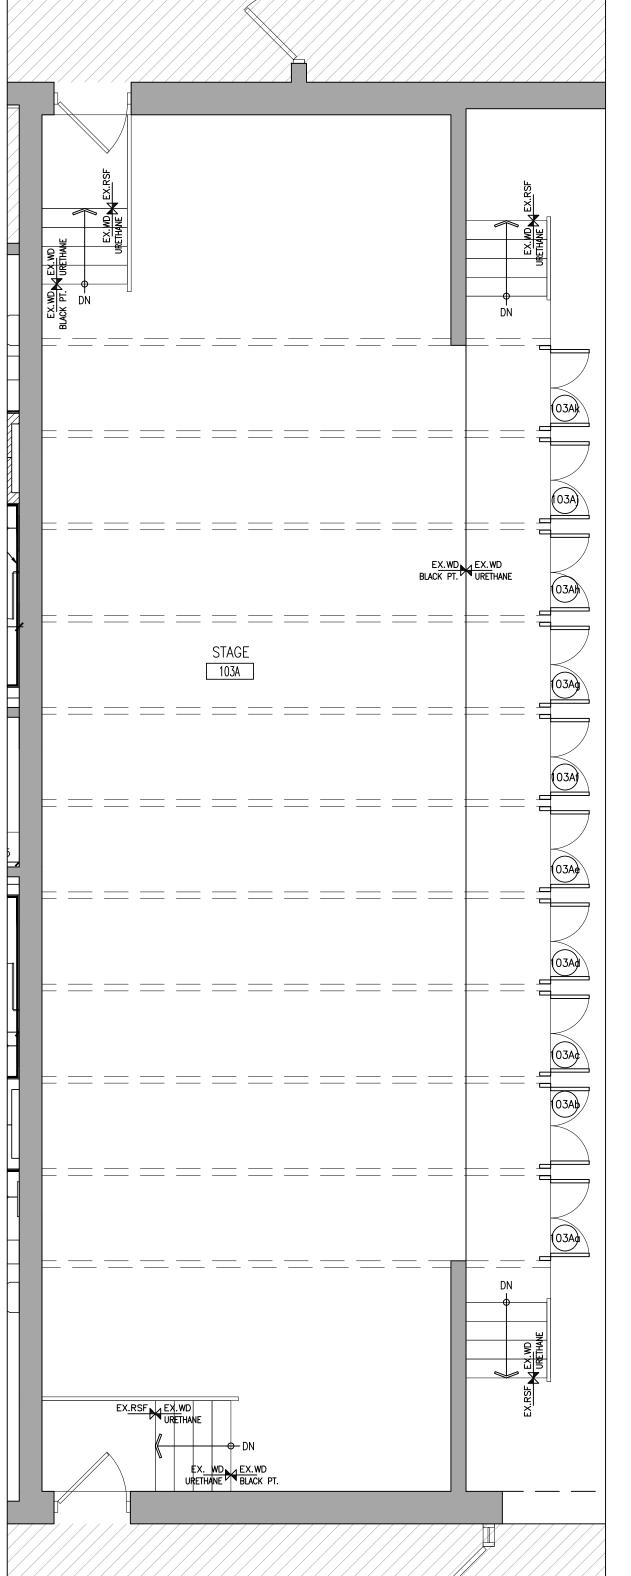

2 A205

PART 1ST FLOOR PLAN

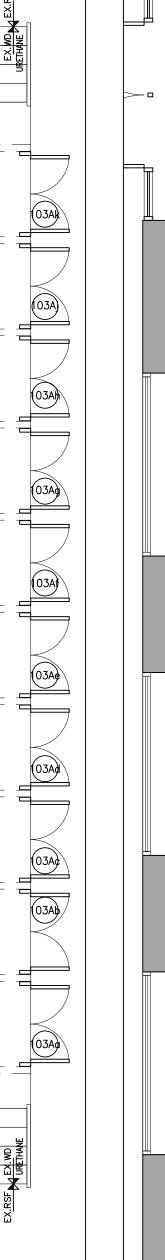

-EXISTING TELEVISION TO

BE REINSTALLED BY THE

WASHROOM 123A

MEETING 123B

124

2730 (SITE VERIFY)

SCHOOL BOARD.

CLASSROOM 123

ML2

ML2

ML2

A205

PART 1ST FLOOR PLAN

FILLER PIECES TO CLOSES
OF VOIDS BETWEEN CABINET
AND EXIST. WALLS (TYP.)

PROJECT NO: 24195

Tel: (905) 666-5252 Fax: (905) 666-5256

e-mail: bba@bba-archeng.com

ASSOCIATES

Architects Engineers Project Managers

L1N 0G5

250 Water Street Suite 201 Whitby, Ontario

DO NOT SCALE THE DRAWINGS CHECK AND VERIFY ALL DIMENSIONS AT THE SITE.

NO. ISSUES

NO. REVISIONS

PROJECT:

DRAWING:

RENOVATIONS AT

JEANNE-LAJOIE

150 CARNFORTH ROAD

NORTH YORK, ONTARIO

Conseil scolaire Viamonde

PART FLOOR PLANS

ECOLE ELEMENTAIRE

1 ISSUED FOR REVIEW

ISSUED FOR PERMIT & TENDER

ALL DRAWINGS, SPECIFICATIONS AND RELATED DOCUMENTS ARE THE COPYRIGHT PROPERTY OF THE CONSULTANT AND MUST BE RETURNED UPON REQUEST. REPRODUCTION OF DRAWINGS IN PART OR WHOLE WITHOUT THE PERMISSION OF THE CONSULTANT IS FORBIDDEN.

DRAWINGS ARE NOT TO BE USED FOR CONSTRUCTION UNTIL SIGNED AND SEALED BY THE CONSULTANT.

Conseil scolaire Viamonde

D. P. MCLAUGHLIN

DATE BY

DATE BY

MAR. 18, 2025 BBA

A205

CHECKED BY:

NOV. 2024


СМ

SCALE: 1:50

FILE:

WILLIAM WEIM A LICENCE ASSOCIATION ASSOCIA


% COMPLETE:

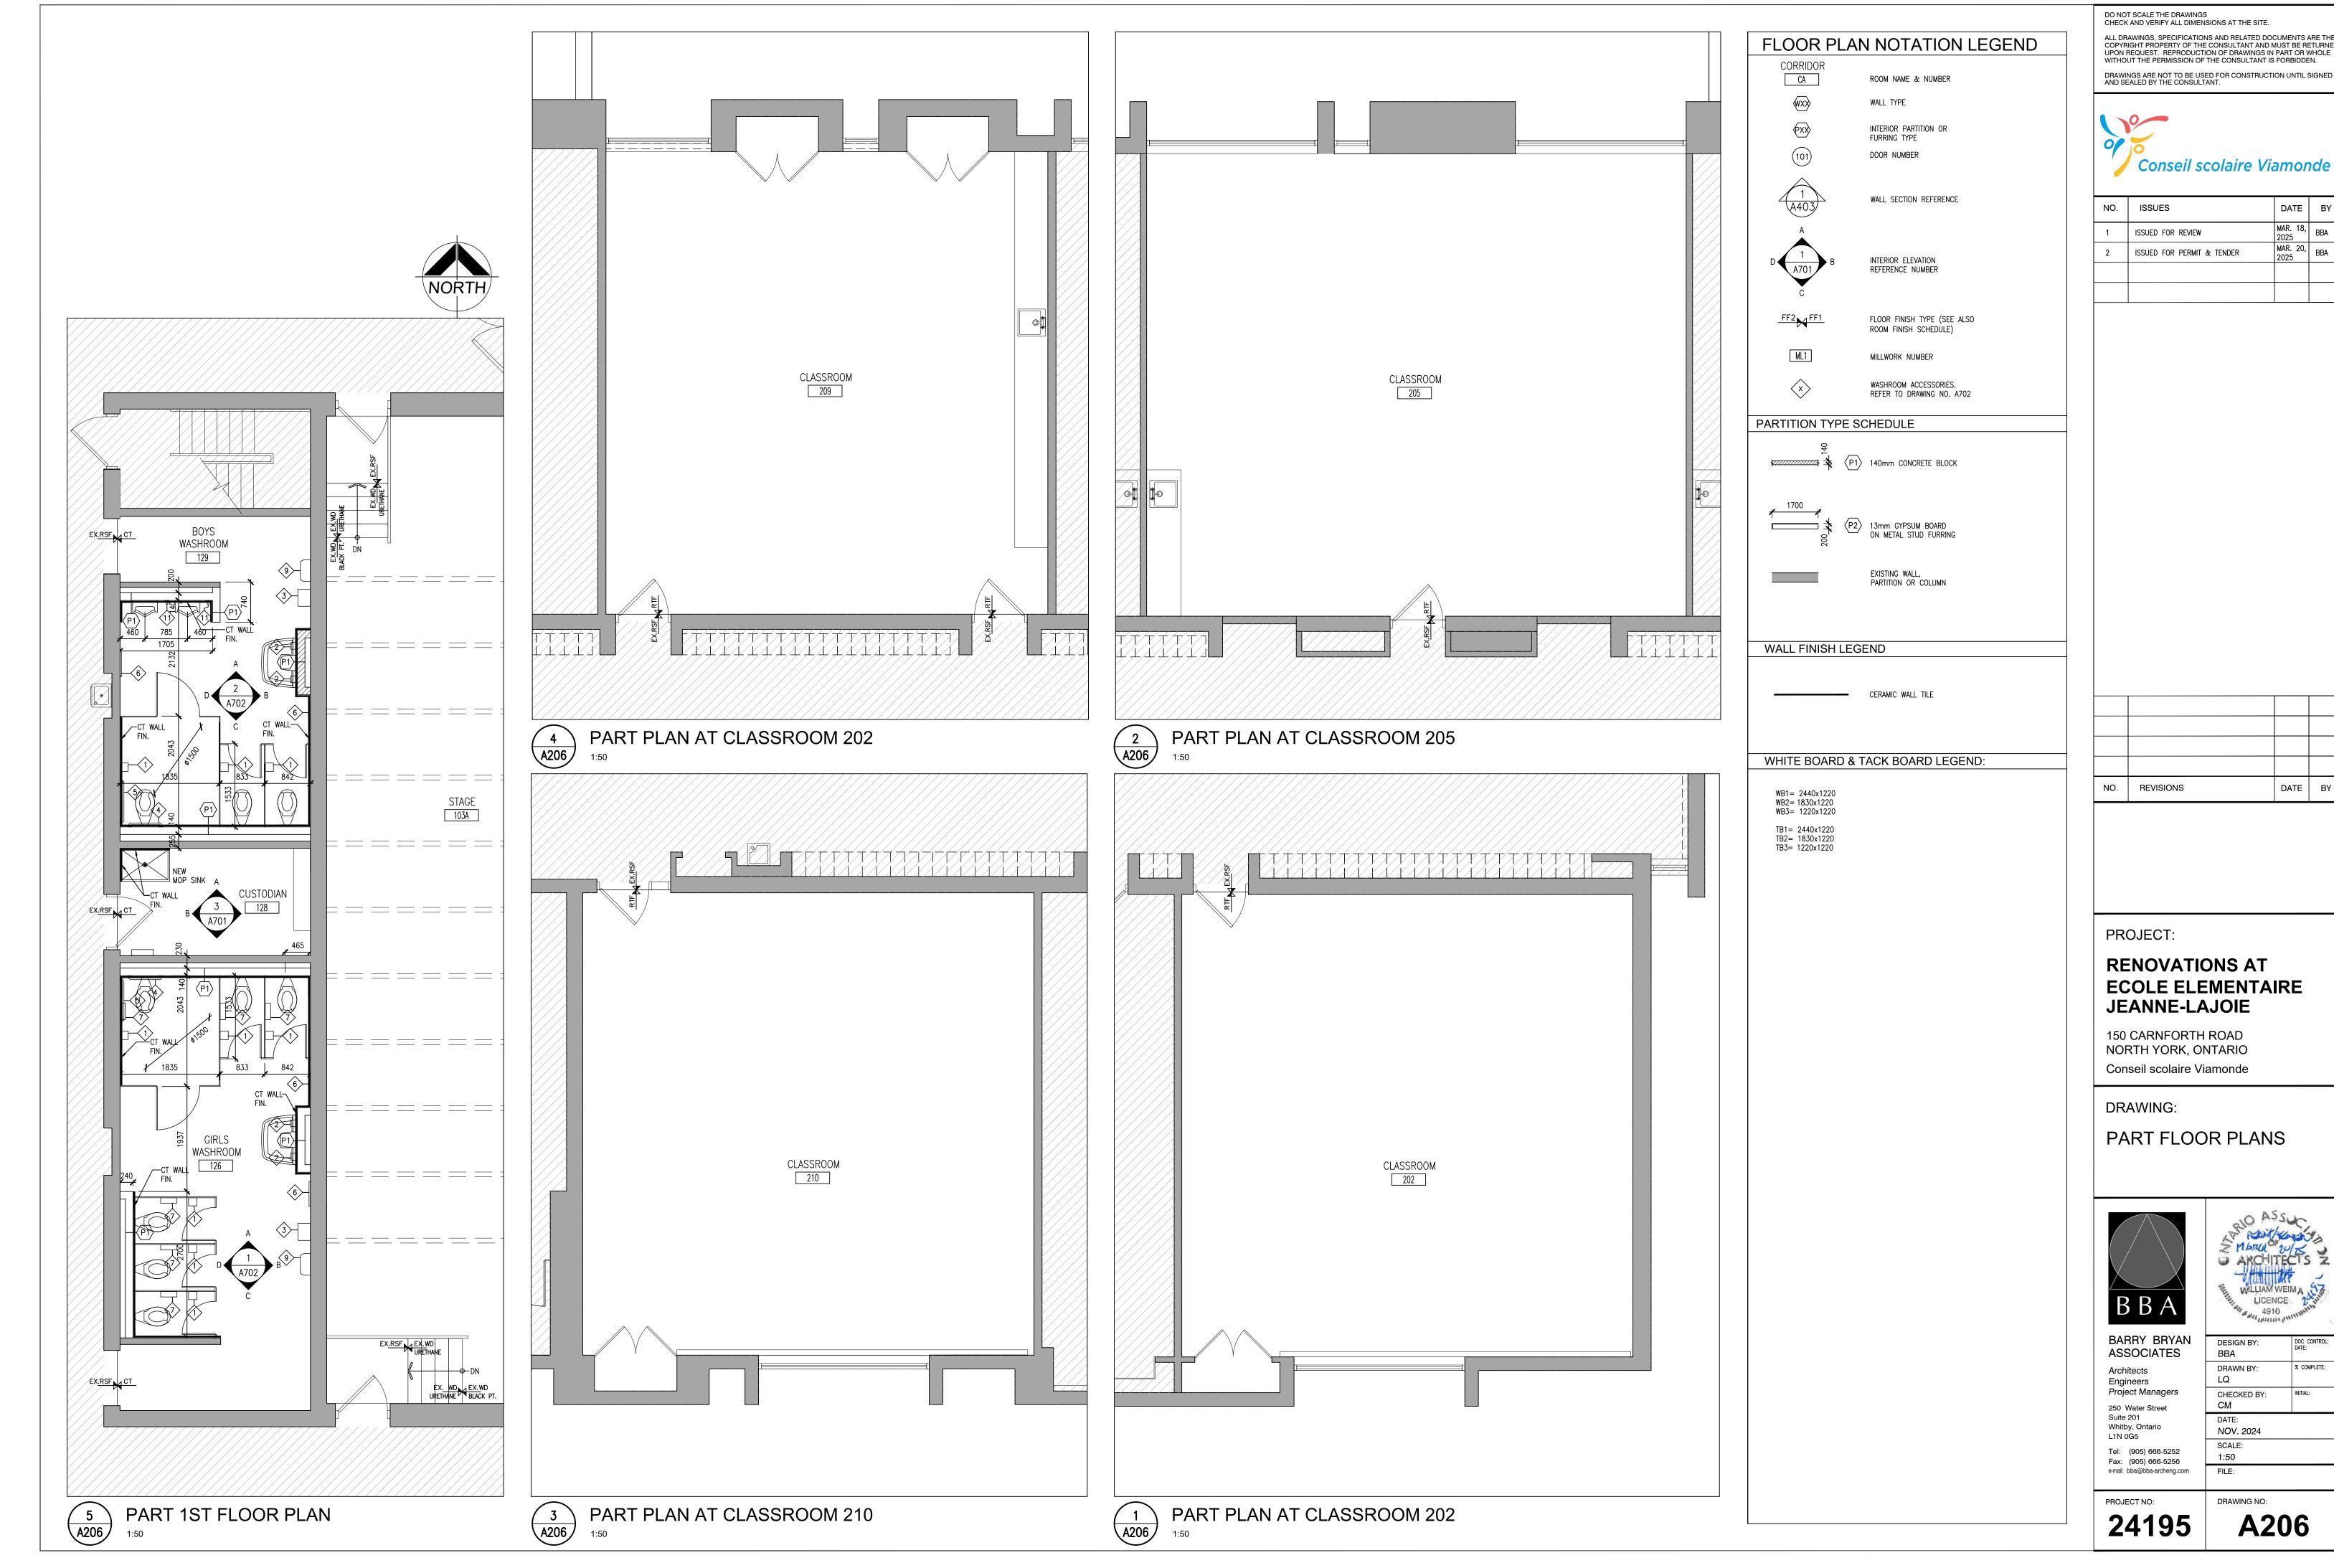

ALL DRAWINGS, SPECIFICATIONS AND RELATED DOCUMENTS ARE THE COPYRIGHT PROPERTY OF THE CONSULTANT AND MUST BE RETURNED UPON REQUEST. REPRODUCTION OF DRAWINGS IN PART OR WHOLE WITHOUT THE PERMISSION OF THE CONSULTANT IS FORBIDDEN.

NO.	ISSUES	DATE	BY
1	ISSUED FOR REVIEW	MAR. 18, 2025	BBA
2	ISSUED FOR PERMIT & TENDER	MAR. 20, 2025	BBA

NO.	REVISIONS	DATE	BY

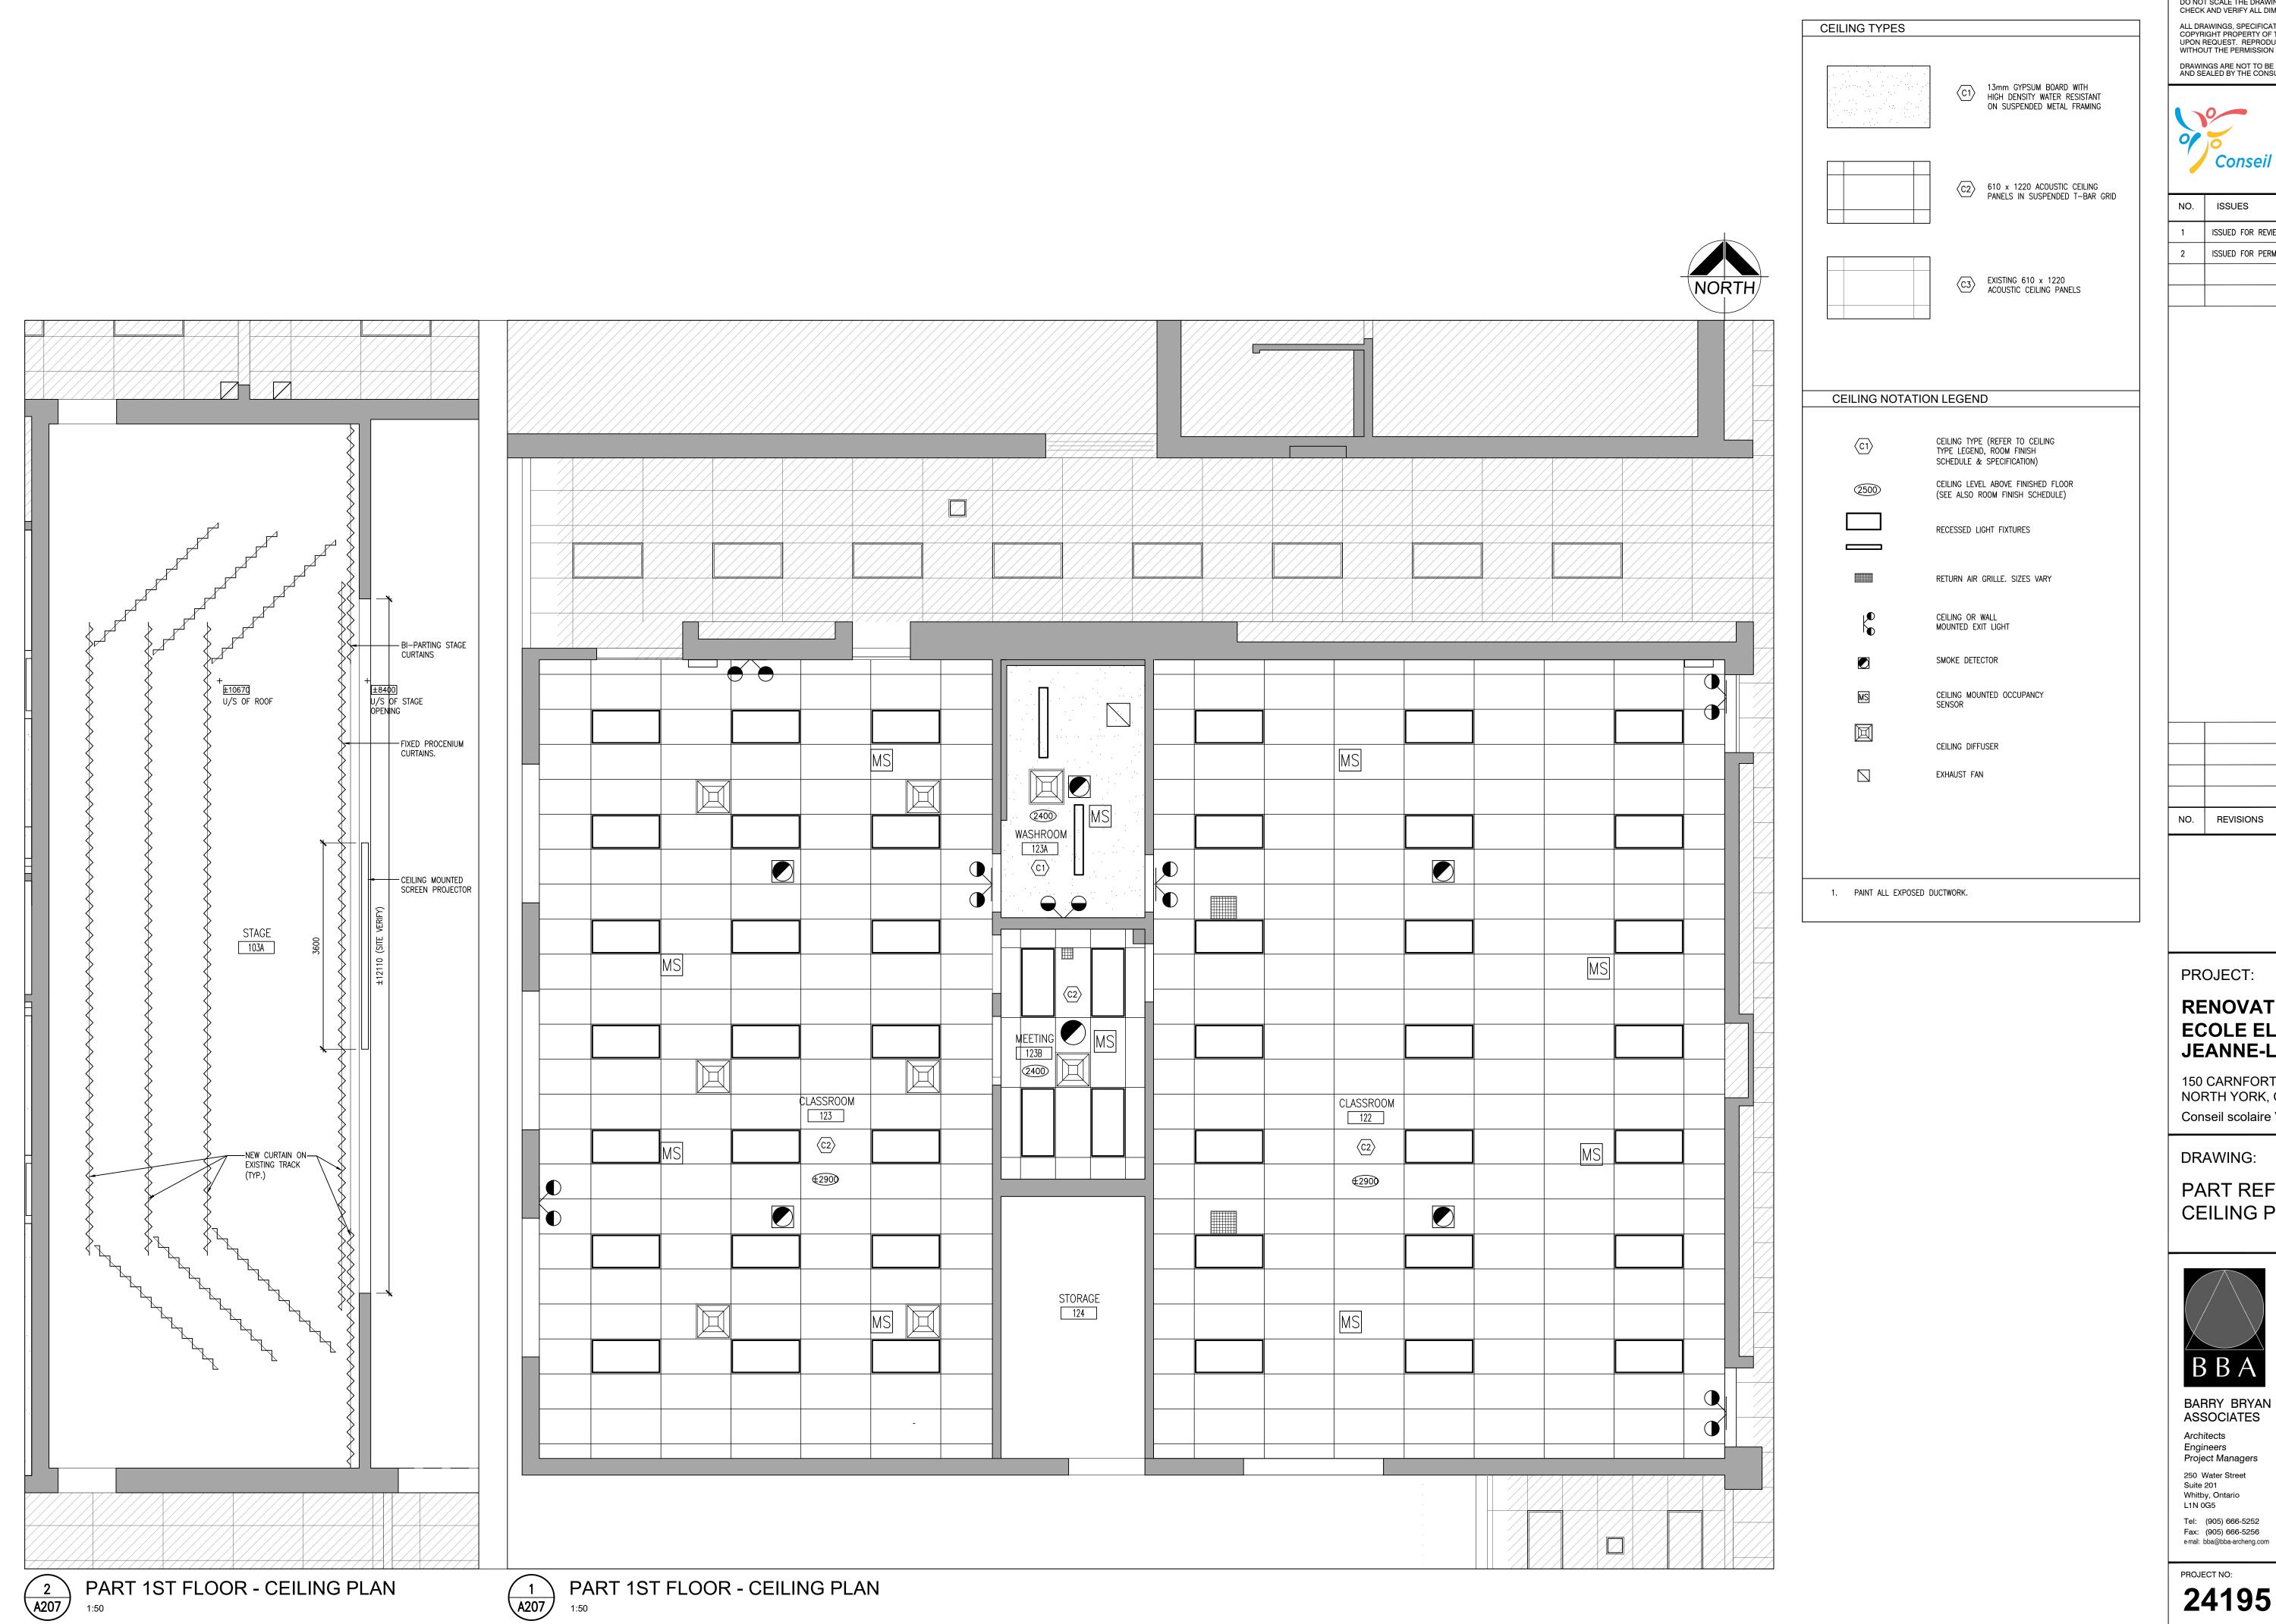

DO NOT SCALE THE DRAWINGS CHECK AND VERIFY ALL DIMENSIONS AT THE SITE. ALL DRAWINGS, SPECIFICATIONS AND RELATED DOCUMENTS ARE THE COPYRIGHT PROPERTY OF THE CONSULTANT AND MUST BE RETURNED UPON REQUEST. REPRODUCTION OF DRAWINGS IN PART OR WHOLE WITHOUT THE PERMISSION OF THE CONSULTANT IS FORBIDDEN. DRAWINGS ARE NOT TO BE USED FOR CONSTRUCTION UNTIL SIGNED AND SEALED BY THE CONSULTANT.



NO.	ISSUES	DATE	BY
1	ISSUED FOR REVIEW	MAR. 18, 2025	BBA
2	ISSUED FOR PERMIT & TENDER	MAR. 20, 2025	BBA

PROJECT:

RENOVATIONS AT ECOLE ELEMENTAIRE JEANNE-LAJOIE

150 CARNFORTH ROAD NORTH YORK, ONTARIO Conseil scolaire Viamonde

DRAWING:

PART REFLECTED **CEILING PLANS**





% COMPLETE:

DATE BY

BARRY BRYAN ASSOCIATES Architects Engineers Project Managers 250 Water Street

Suite 201 Whitby, Ontario L1N 0G5

CHECKED BY: СМ NOV. 2024


DRAWN BY:


PROJECT NO: 24195

A207

1:50

FILE:

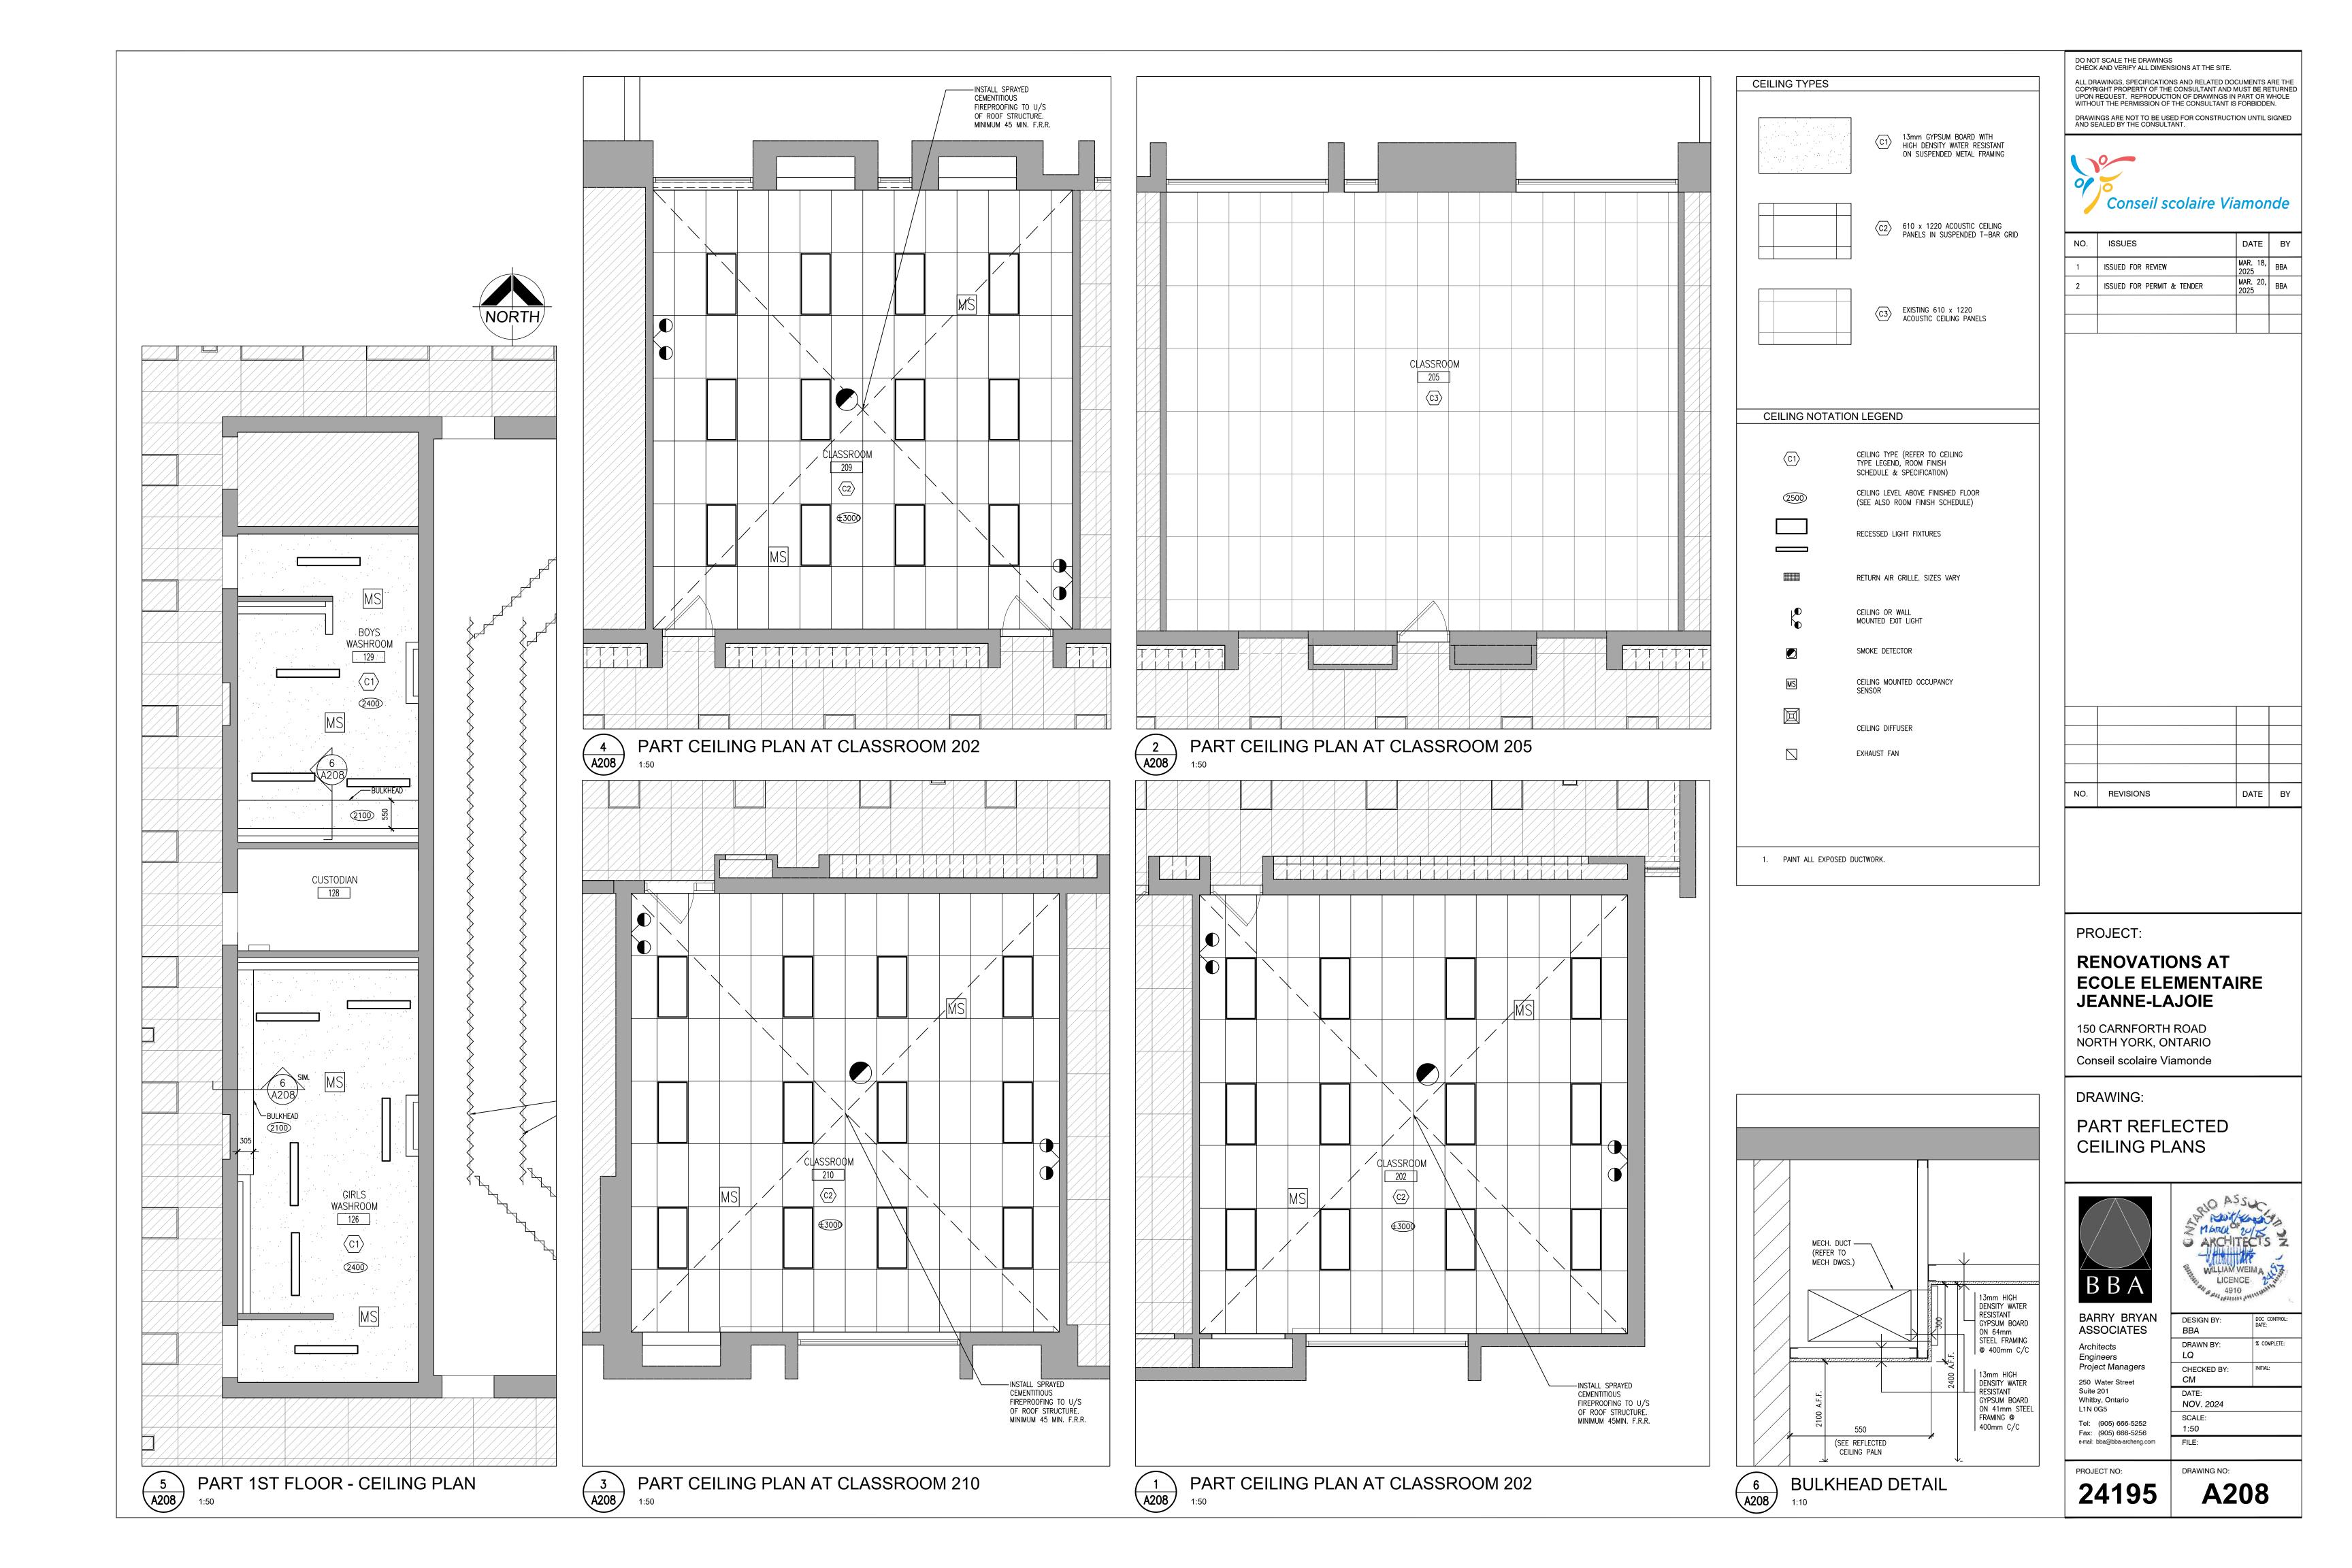

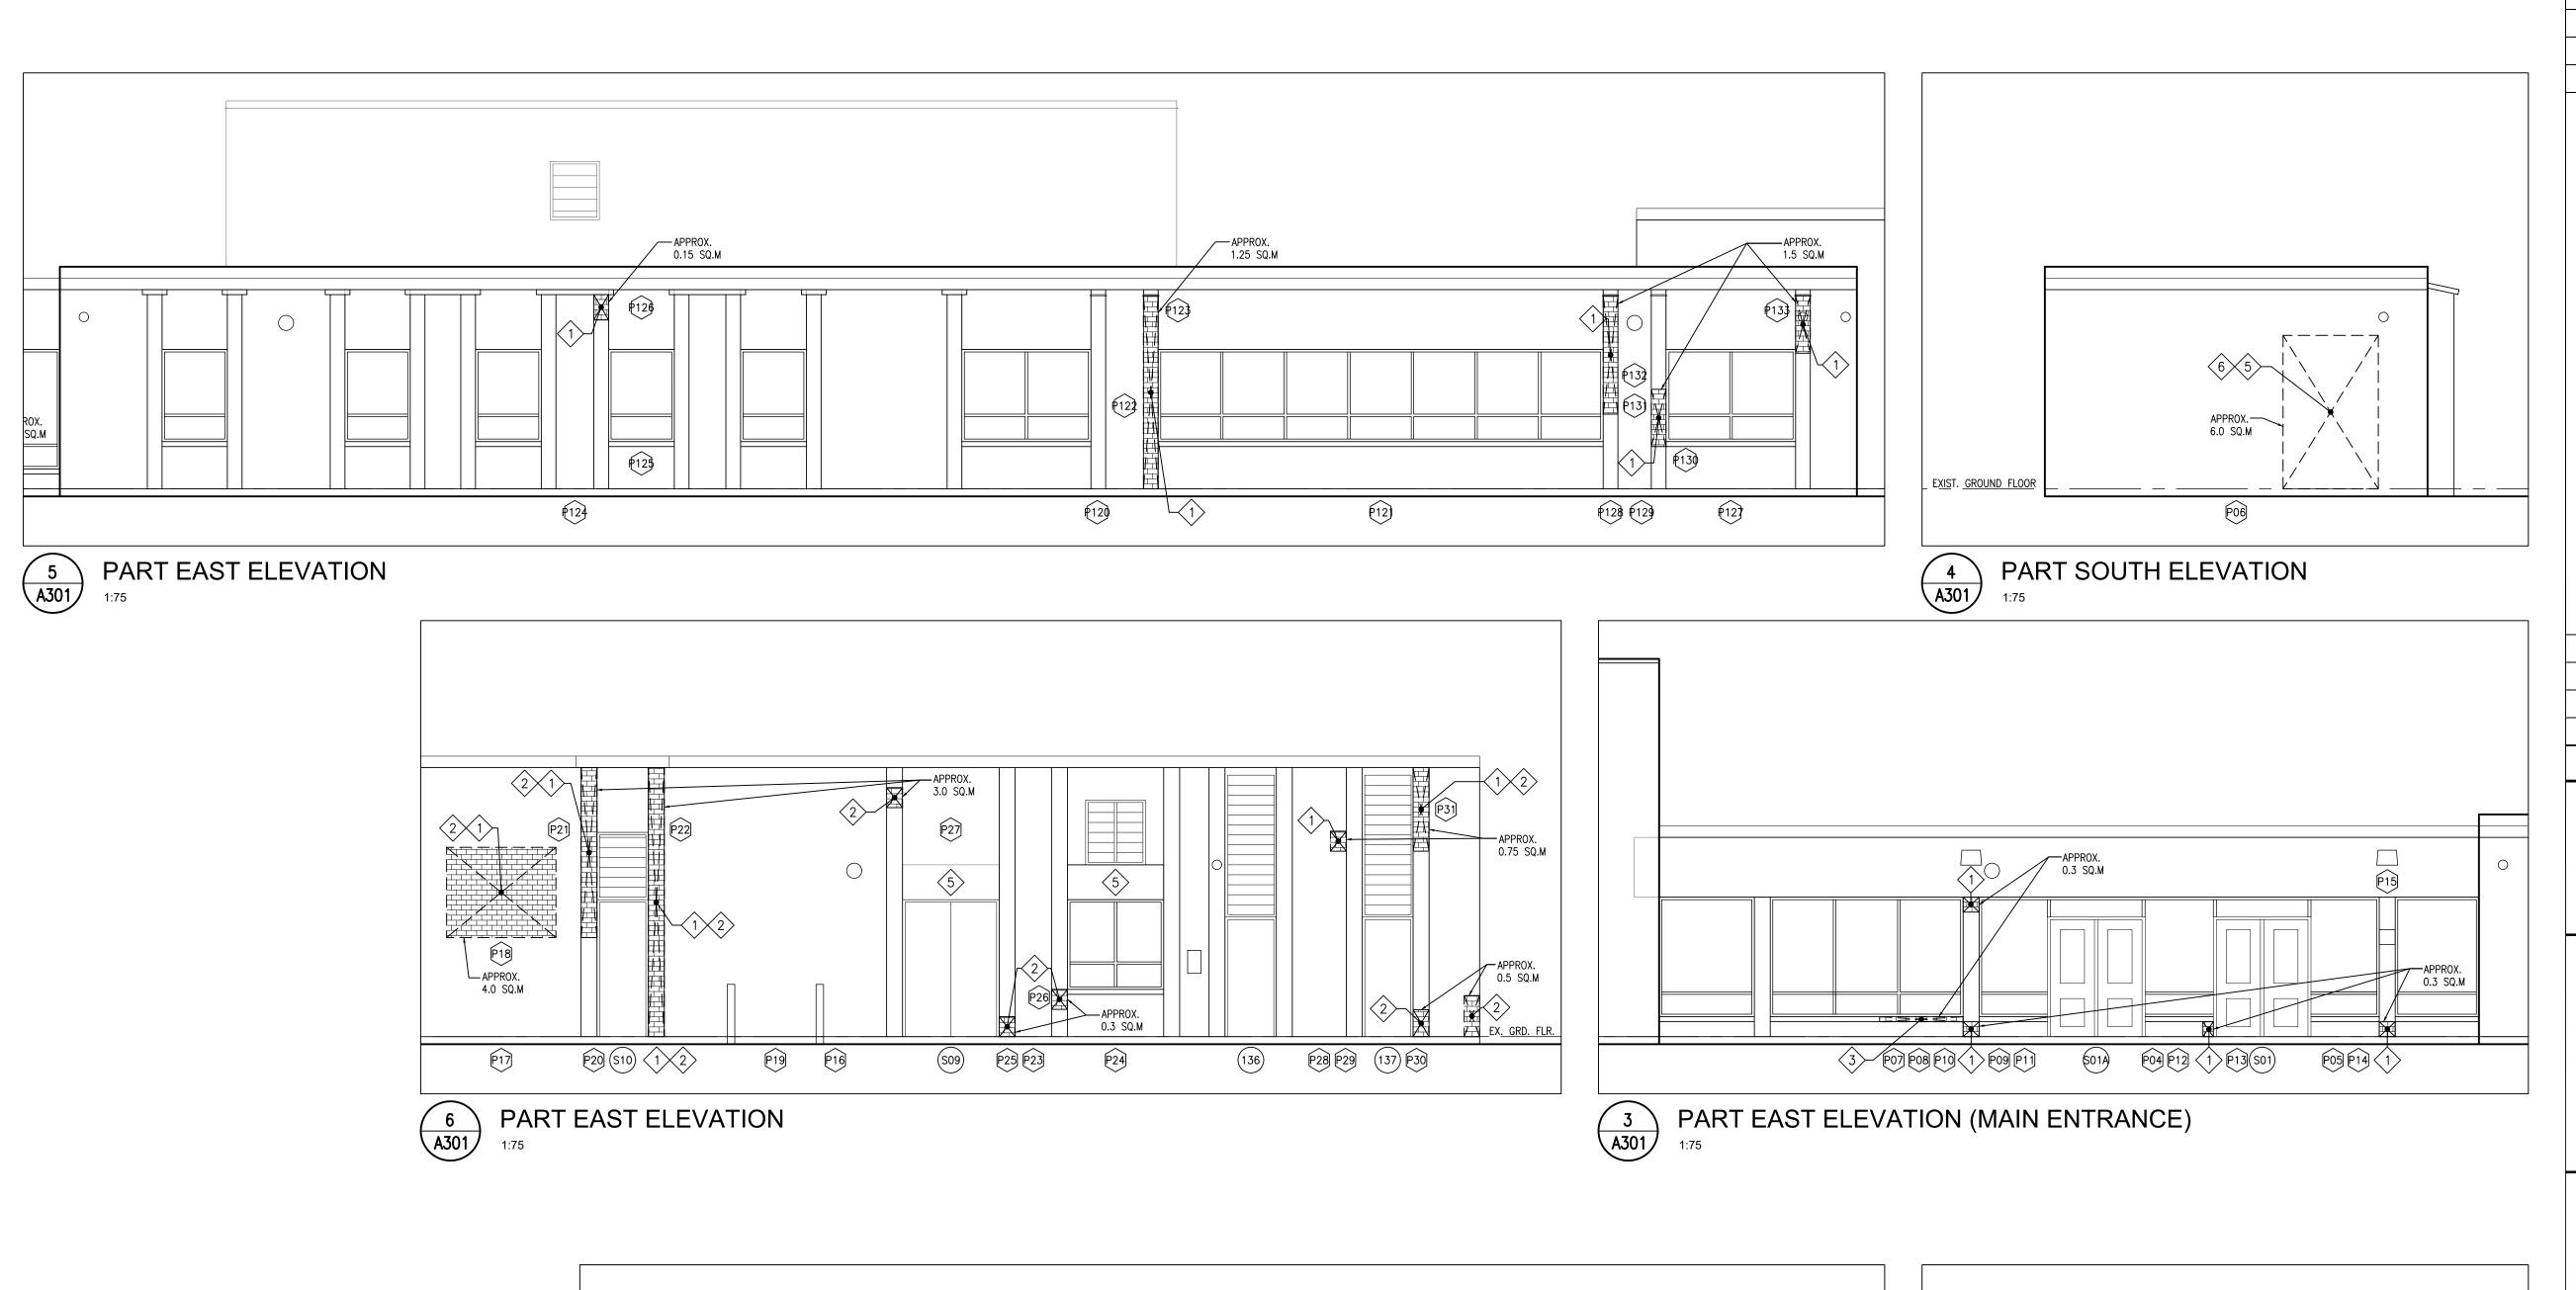

REPAIR LEGEND:

AREAS INDICATED ON ELEVATIONS ARE VISUAL

NOTE AREAS FOR DETERIORATED / SPALLED MASONRY BRICKS (NOT INDICATED ON THESE DRAWINGS) TO

REMOVE AND REPLACE DETERIORATED/SPALLED BRICKS

COLOUR TO MATCH EXISTING BRICK REFER TO

1. ALL BRICKS THAT DO NOT MATCH EXISTING

COLOR AND HERITAGE CONDITION.

ALL NEW BRICKS TO MATCH EXISTING DIMENSIONS, COLOURS AND TEXTURES.

REFER TO A905-A913 SERIES FOR PHOTO

COLOR ARE TO BE STAINED TO MATCH EXISTING

ESTIMATED LOCATIONS. CONFIRM ON SITE.

OWNER AND CONSULTANTS.

ELEVATIONS FOR EXTENTS.

NOTATION LEGEND:

SITE VERIFY (CONFIRM) FOR ALL

LOCATIONS TO BE REPAIRED.

EXISTING DOOR NUMBER

REPAIR NOTES

REPAIR BROKEN AND DAMAGED BRICK.
INSTALL REPLACEMENT BRICK WHERE INDICATED.

2 REPAIR BROKEN MASONRY AT CORNERS OF BRICK RELIEF.

REPAIR BROKEN MASONRY BRICK / MORTAR AT WINDOW SILLS AND REPLACE WITH NEW TO MATCH. PROVIDE DRIP

4 ROUT OUT JOINTS AND RE POINT MATCH EXISTING.

6 REMOVE GRAFFITI FROM BRICK.

FOR NEW AND REPAINT.

5 POWER WASH / CLEAN ALL EXTERIOR BRICK / CONCRETE SURFACES POST NEW CONSTRUCTION.


SCRAPE OFF EXISTING LOOSE PAINT, MAKE SURFACE READY FOR NEW AND REPAINT.

REMOVE ABANDONED STEEL CONDUIT C/W ALL LOCALIZED ABANDONED MOLINTING BOLTS INFILL PRICE VENEED WITH

GROUT, COLOUR TO MATCH EXISTING.

ABANDONED MOUNTING BOLTS. INFILL BRICK VENEER WITH

NOTE: RE-SEAL ALL WINDOW JAMBS FOLLOWING BRICK WALL

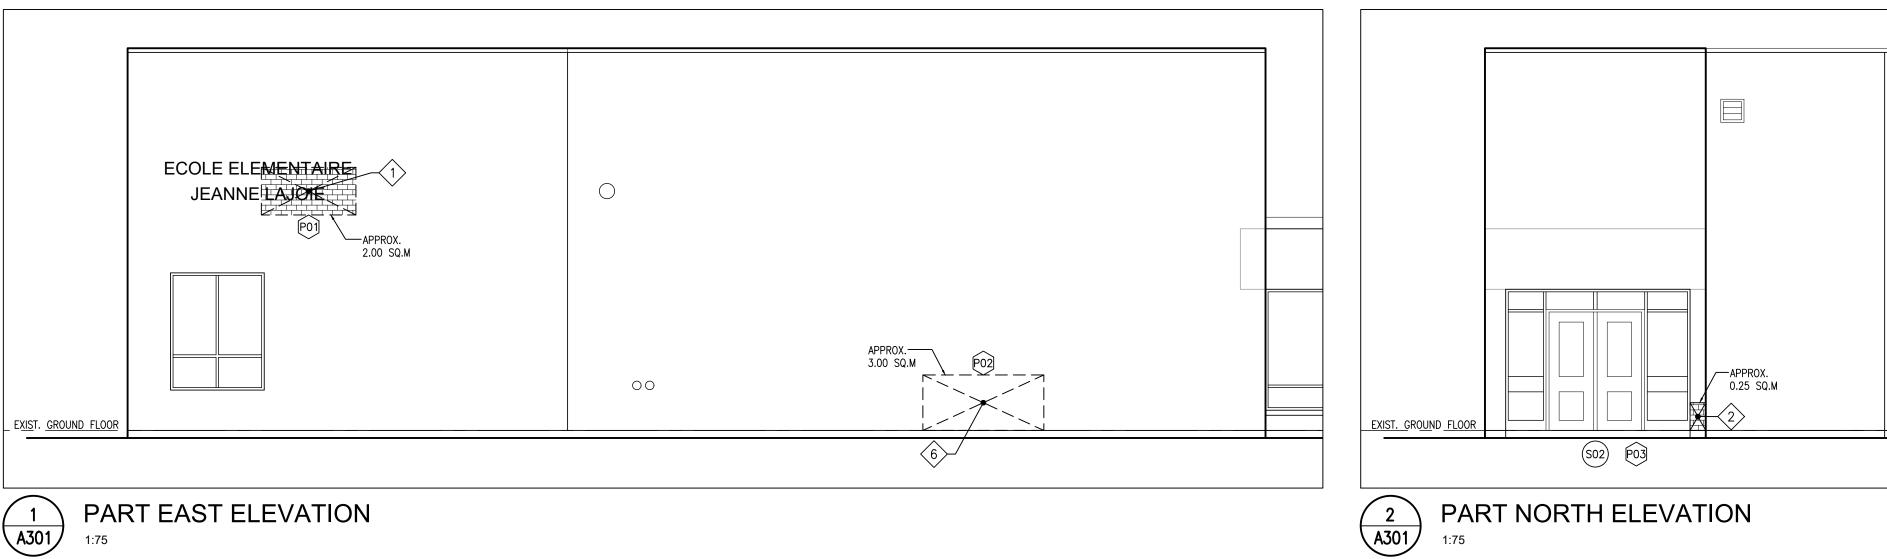


DO NOT SCALE THE DRAWINGS CHECK AND VERIFY ALL DIMENSIONS AT THE SITE.

ALL DRAWINGS, SPECIFICATIONS AND RELATED DOCUMENTS ARE THE COPYRIGHT PROPERTY OF THE CONSULTANT AND MUST BE RETURNED UPON REQUEST. REPRODUCTION OF DRAWINGS IN PART OR WHOLE WITHOUT THE PERMISSION OF THE CONSULTANT IS FORBIDDEN. DRAWINGS ARE NOT TO BE USED FOR CONSTRUCTION UNTIL SIGNED AND SEALED BY THE CONSULTANT.



NO.	ISSUES	DATE	BY
1	ISSUED FOR REVIEW	MAR. 18, 2025	BBA
2	ISSUED FOR PERMIT & TENDER	MAR. 20, 2025	BBA

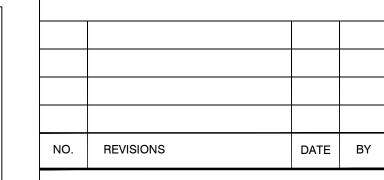


PROJECT:

RENOVATIONS AT ECOLE ELEMENTAIRE JEANNE-LAJOIE

150 CARNFORTH ROAD NORTH YORK, ONTARIO Conseil scolaire Viamonde

DRAWING:

PART EAST ELEVATIONS

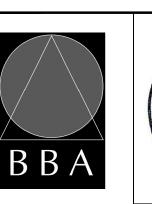




BARRY BRYAN ASSOCIATES Architects Engineers Project Managers 250 Water Street Suite 201

% COMPLETE: DRAWN BY: CHECKED BY: JAN. 2025

Whitby, Ontario L1N 0G5 Tel: (905) 666-5252 1:75 Fax: (905) 666-5256 e-mail: bba@bba-archeng.com


FILE: 24195 A301-A303 DRAWING NO:


PROJECT NO: 24195 **A301**

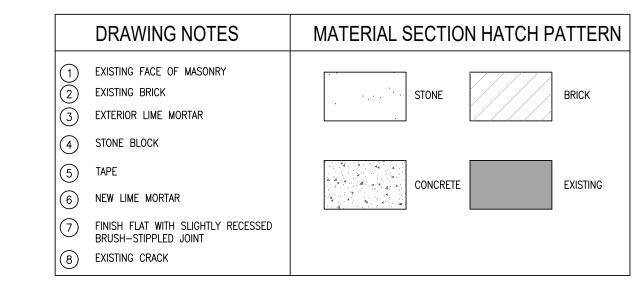



A302


NTS

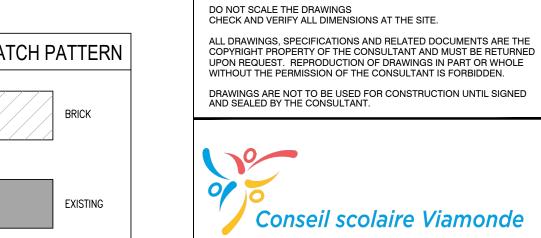


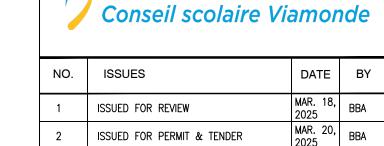

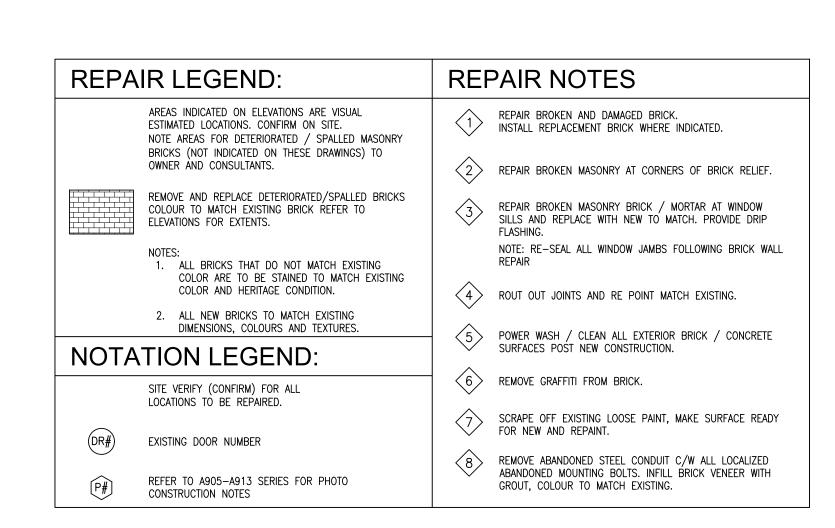

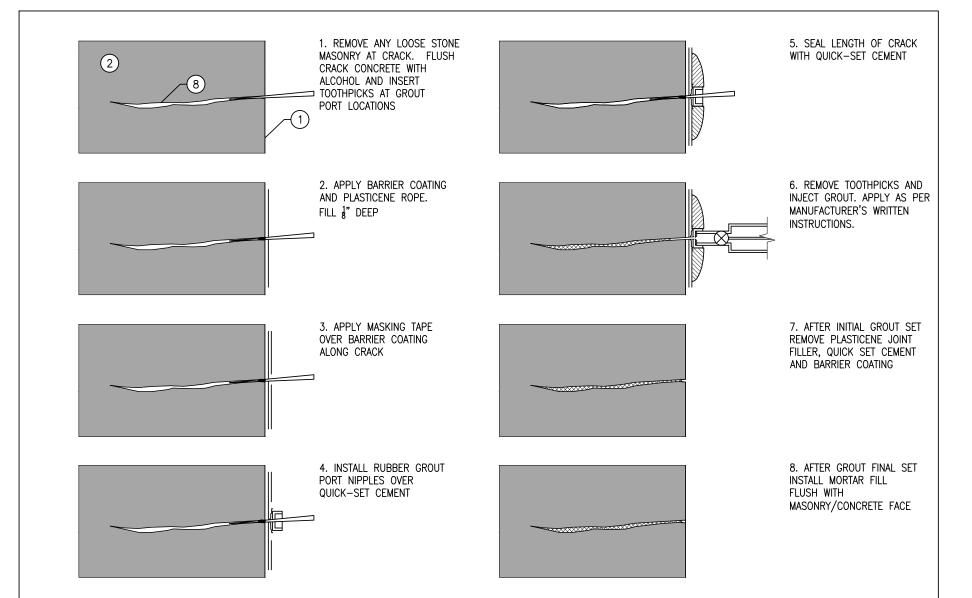

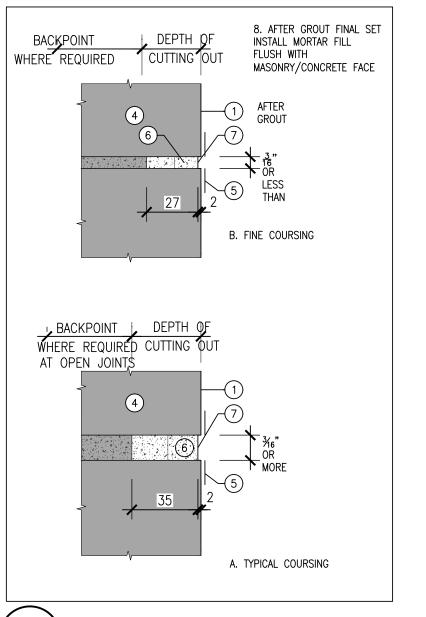


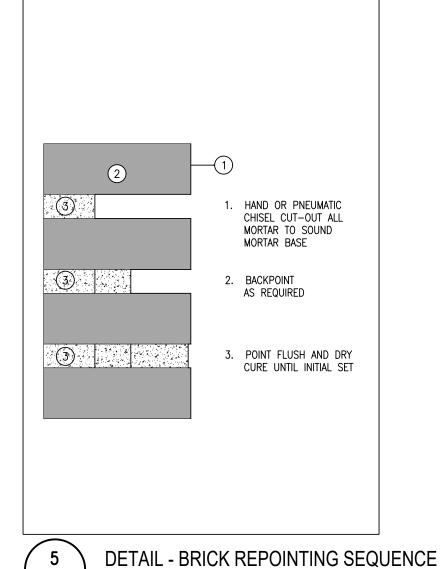

NO. REVISIONS DATE BY

DETAIL - MICRO-INJECTION EPOXY INSTALLATION SEQUENCE A302

DETAIL - STONE REPOINTING SEQUENCE A302

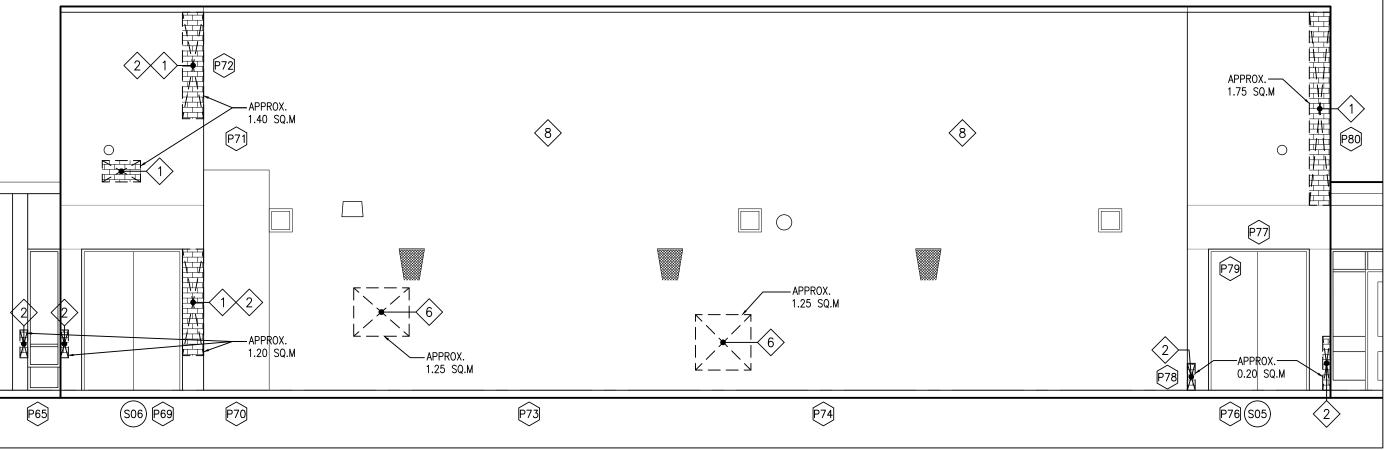

P60

P64

Conseil scolaire Viamonde DRAWING:

PROJECT:




RENOVATIONS AT

JEANNE-LAJOIE

150 CARNFORTH ROAD

NORTH YORK, ONTARIO

ECOLE ELEMENTAIRE

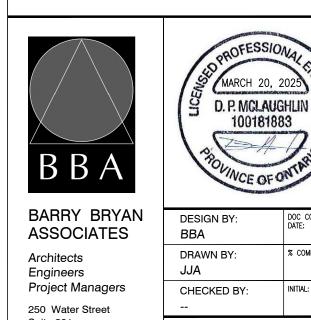


Suite 201 Whitby, Ontario L1N 0G5 Tel: (905) 666-5252

Fax: (905) 666-5256

JAN. 2025 SCALE: 1:75 e-mail: bba@bba-archeng.com 24195 A301-A303

A302

24195

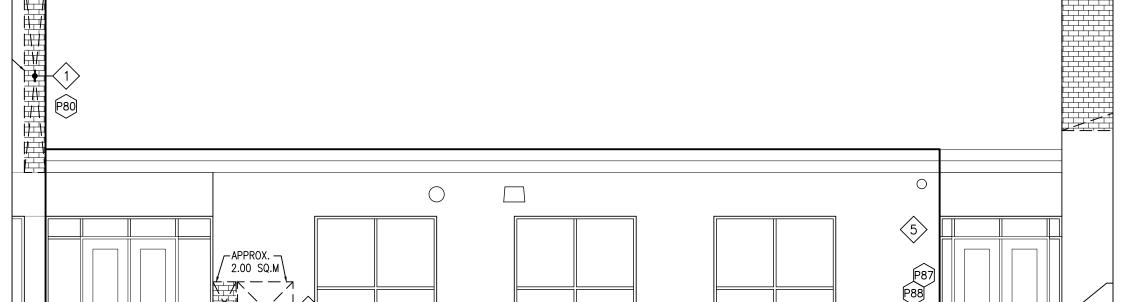

5 6

P94 P95

APPROX. — 0.30 SQ.M 6 2 EXIST. GROUND FLOOR P54 P55

PART WEST ELEVATION A302

3 A302 PART WEST ELEVATION

S04) P83

—APPROX. 26.50 SQ.M

PART WEST ELEVATION

P94 P95


4 A302

P97 P102 APPROX. 0.20 SQ.M

APPROX.

APPROX. 0.40 SQ.M

PART WEST ELEVATION 2 A302

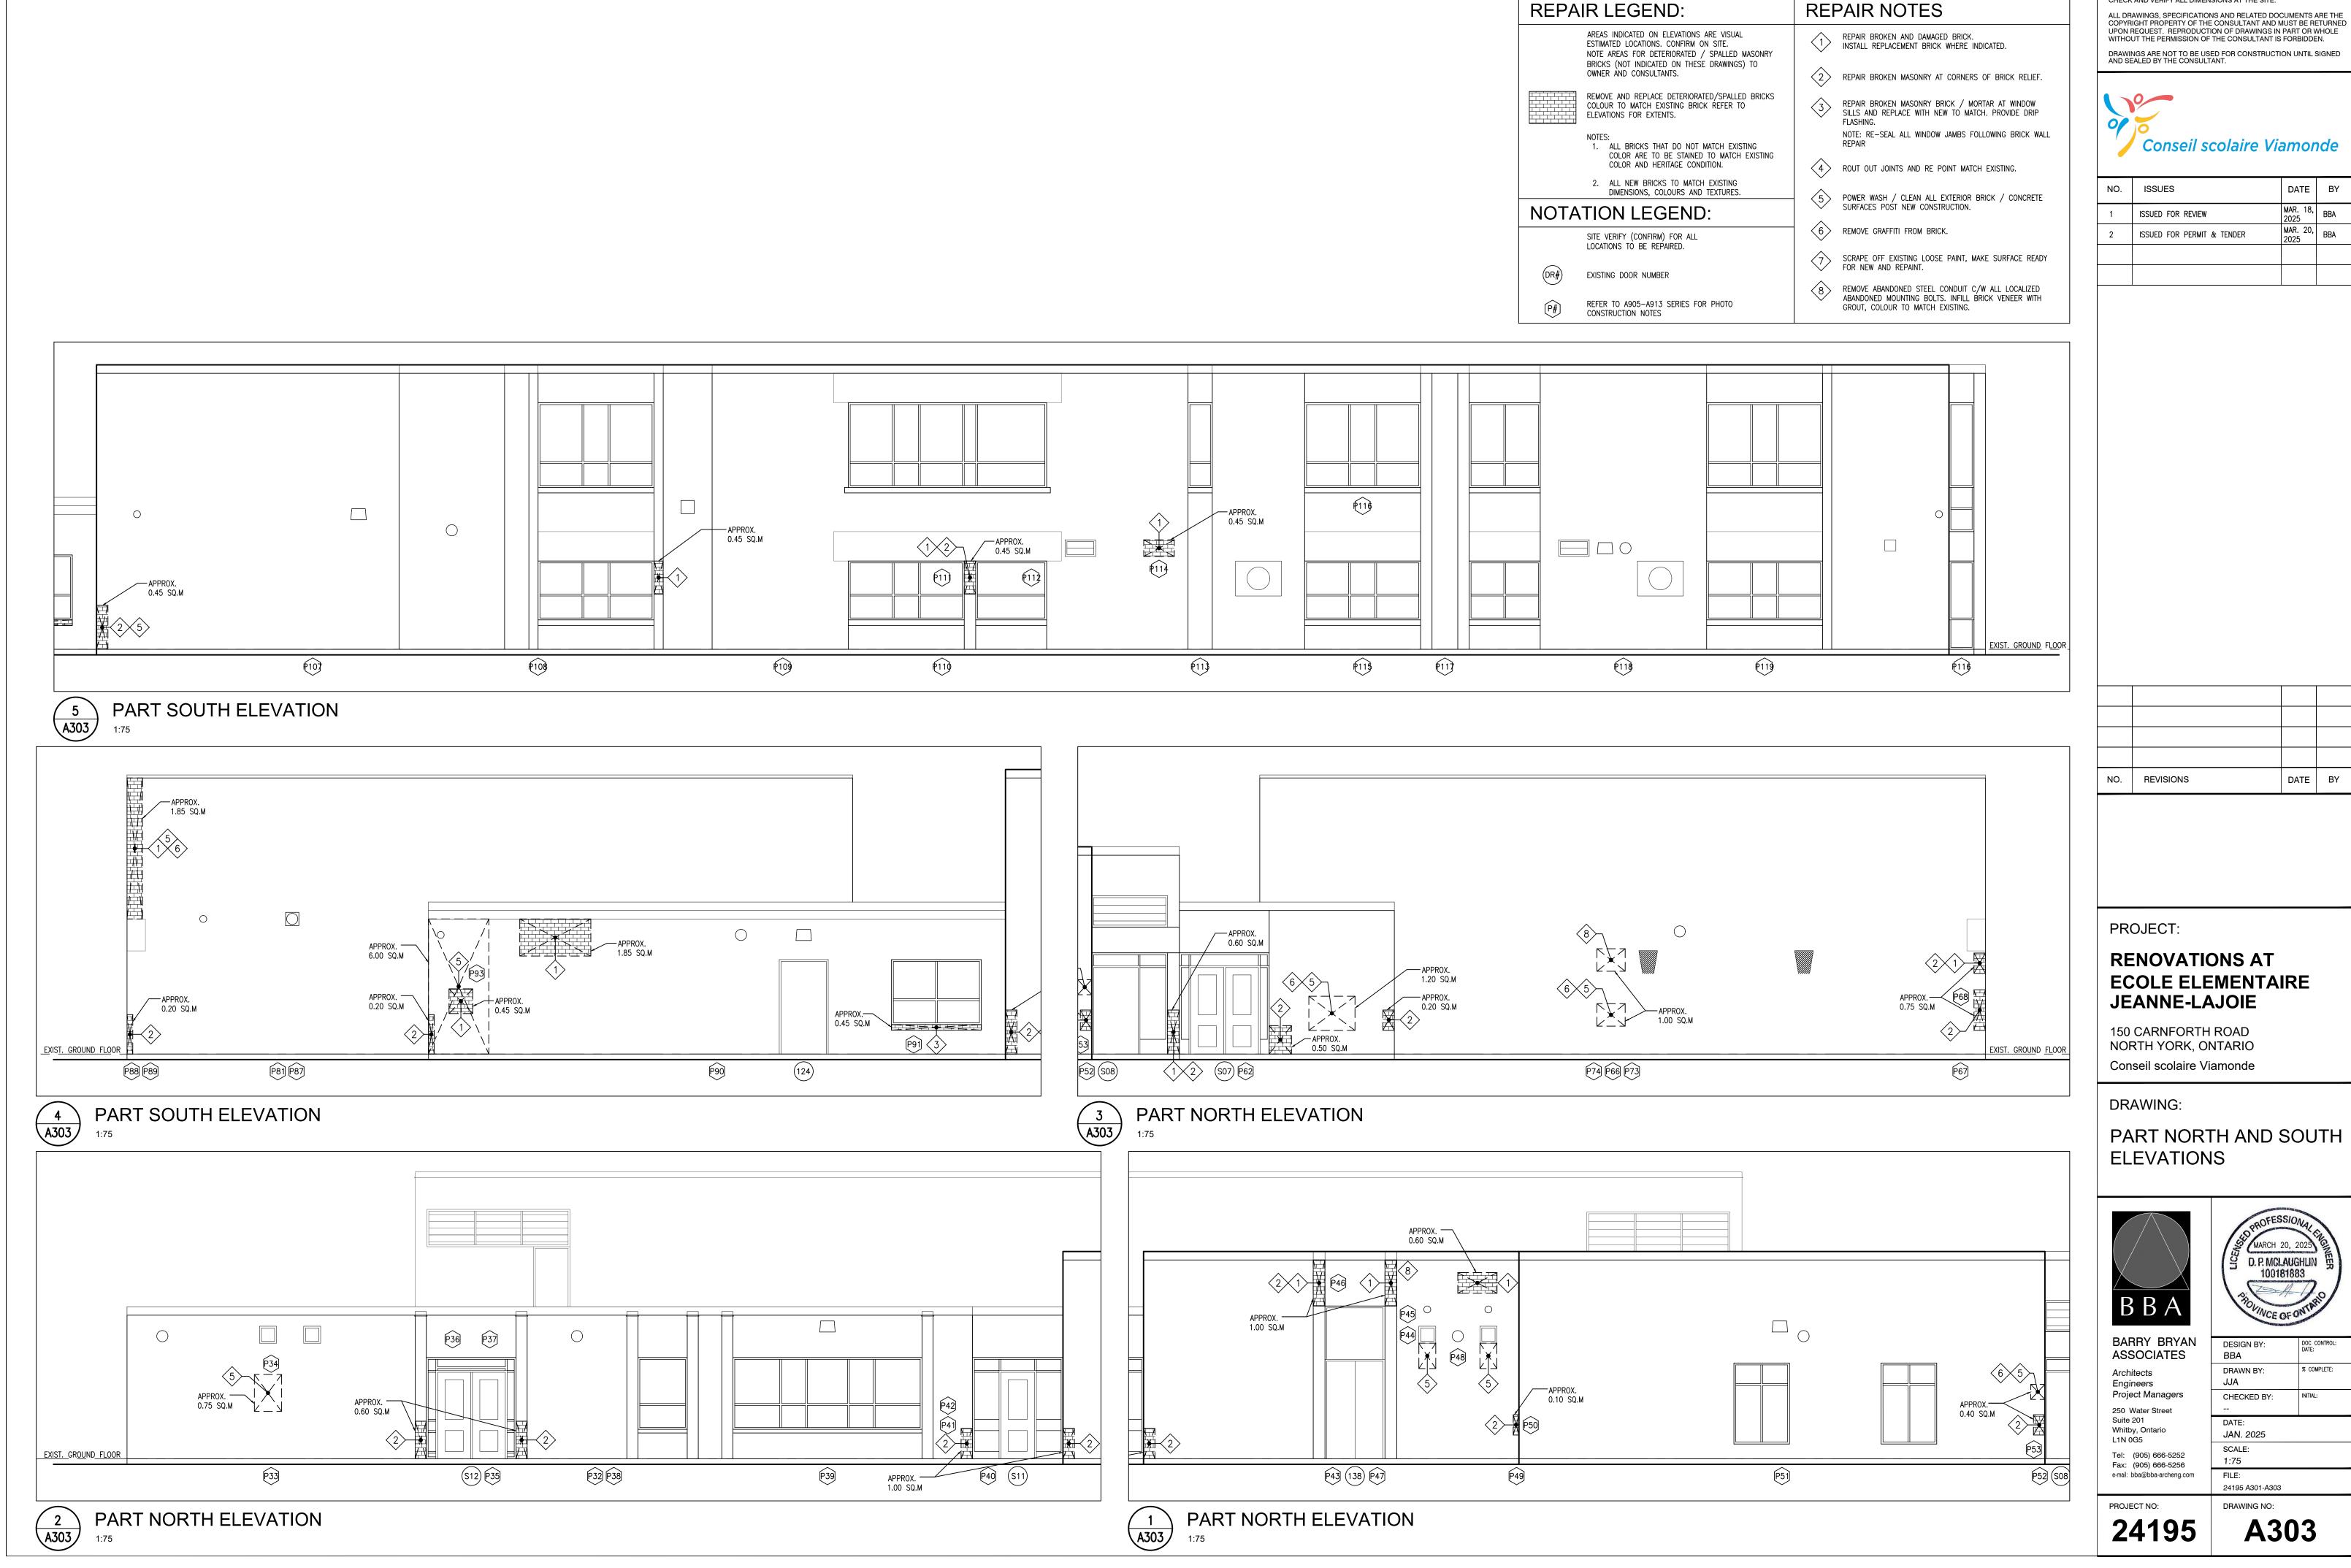


DO NOT SCALE THE DRAWINGS CHECK AND VERIFY ALL DIMENSIONS AT THE SITE.

ALL DRAWINGS, SPECIFICATIONS AND RELATED DOCUMENTS ARE THE


NO.	ISSUES	DATE	BY
1	ISSUED FOR REVIEW	MAR. 18, 2025	BBA
2	ISSUED FOR PERMIT & TENDER	MAR. 20, 2025	BBA

PART NORTH AND SOUTH



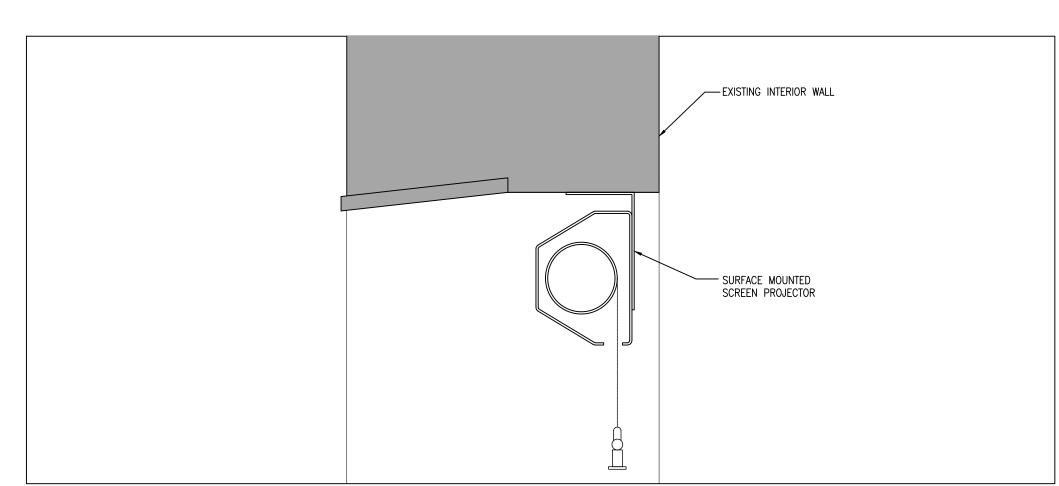


SECTION DETAIL
1:5

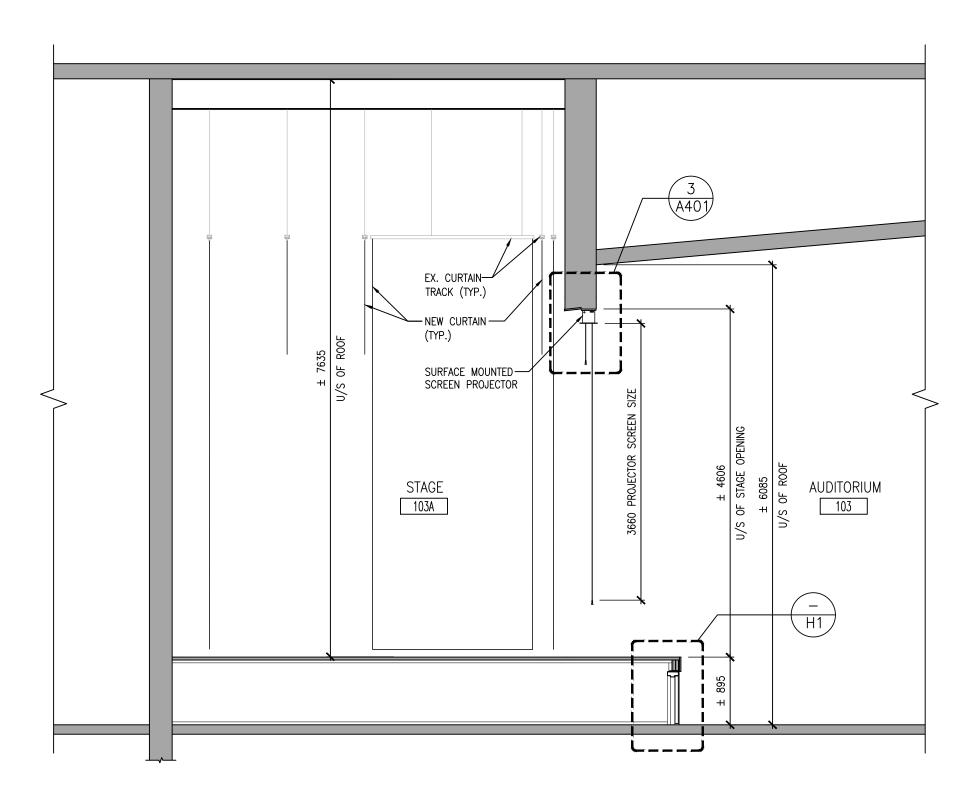



BUILDING SECTION - STAGE #103A

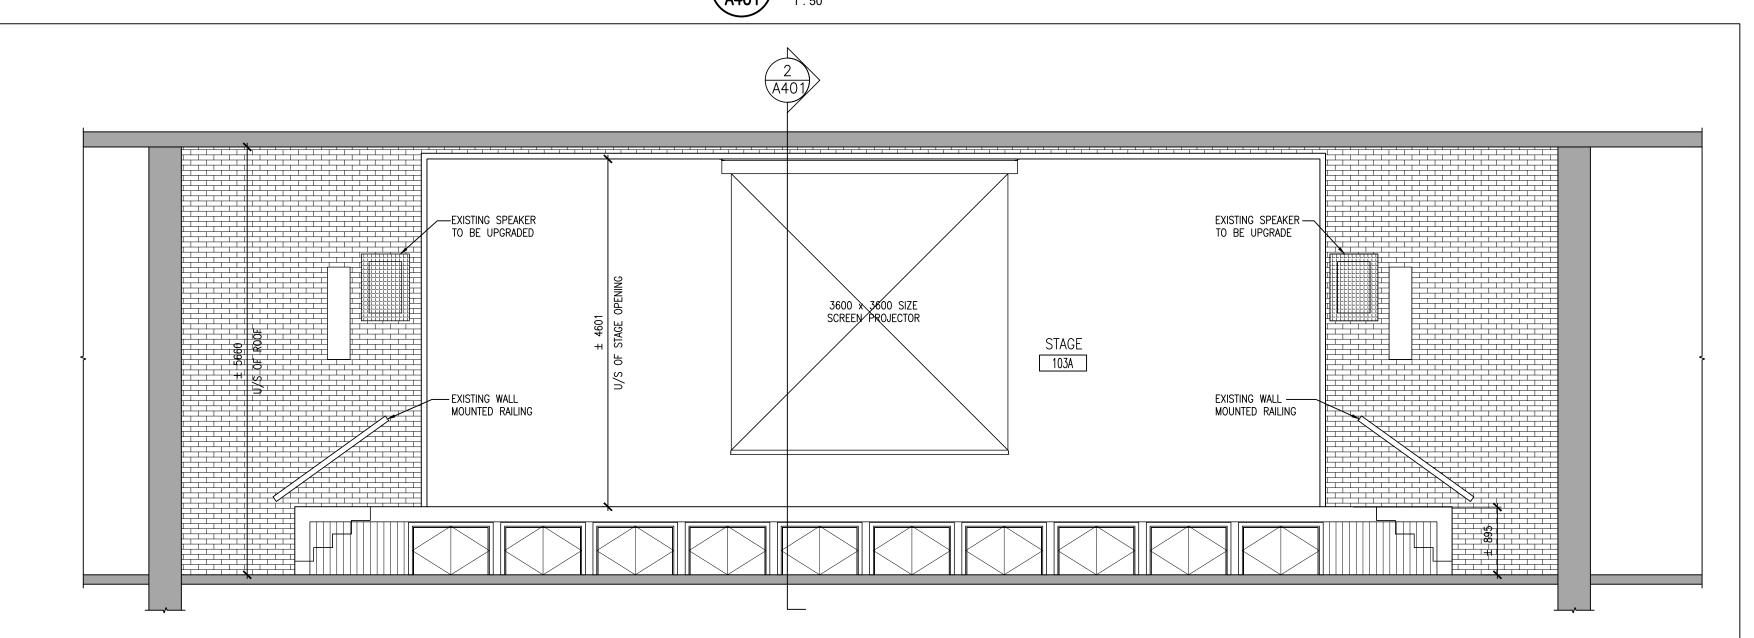


1 INTERIOR ELEVATION - AUDITORIUM #103

DO NOT SCALE THE DRAWINGS CHECK AND VERIFY ALL DIMENSIONS AT THE SITE.

ALL DRAWINGS, SPECIFICATIONS AND RELATED DOCUMENTS ARE THE COPYRIGHT PROPERTY OF THE CONSULTANT AND MUST BE RETURNED UPON REQUEST. REPRODUCTION OF DRAWINGS IN PART OR WHOLE WITHOUT THE PERMISSION OF THE CONSULTANT IS FORBIDDEN. DRAWINGS ARE NOT TO BE USED FOR CONSTRUCTION UNTIL SIGNED AND SEALED BY THE CONSULTANT.



NO.	ISSUES	DATE	ВҮ
1	ISSUED FOR REVIEW	MAR. 18, 2025	BBA
2	ISSUED FOR PERMIT & TENDER	MAR. 20, 2025	BBA

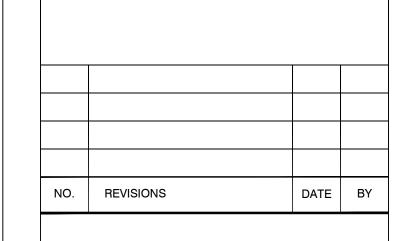

PROJECT:

RENOVATIONS AT ECOLE ELEMENTAIRE JEANNE-LAJOIE

150 CARNFORTH ROAD NORTH YORK, ONTARIO Conseil scolaire Viamonde

DRAWING:

STAGE SECTION AND **ELEVATION**





BARRY BRYAN ASSOCIATES Architects Engineers Project Managers

250 Water Street Suite 201 Whitby, Ontario L1N 0G5

Tel: (905) 666-5252 Fax: (905) 666-5256 e-mail: bba@bba-archeng.com


AS NOTED 24195 A401

DRAWN BY:

CHECKED BY:

DATE: FEB. 05, 2025

PROJECT NO: 24195 A401

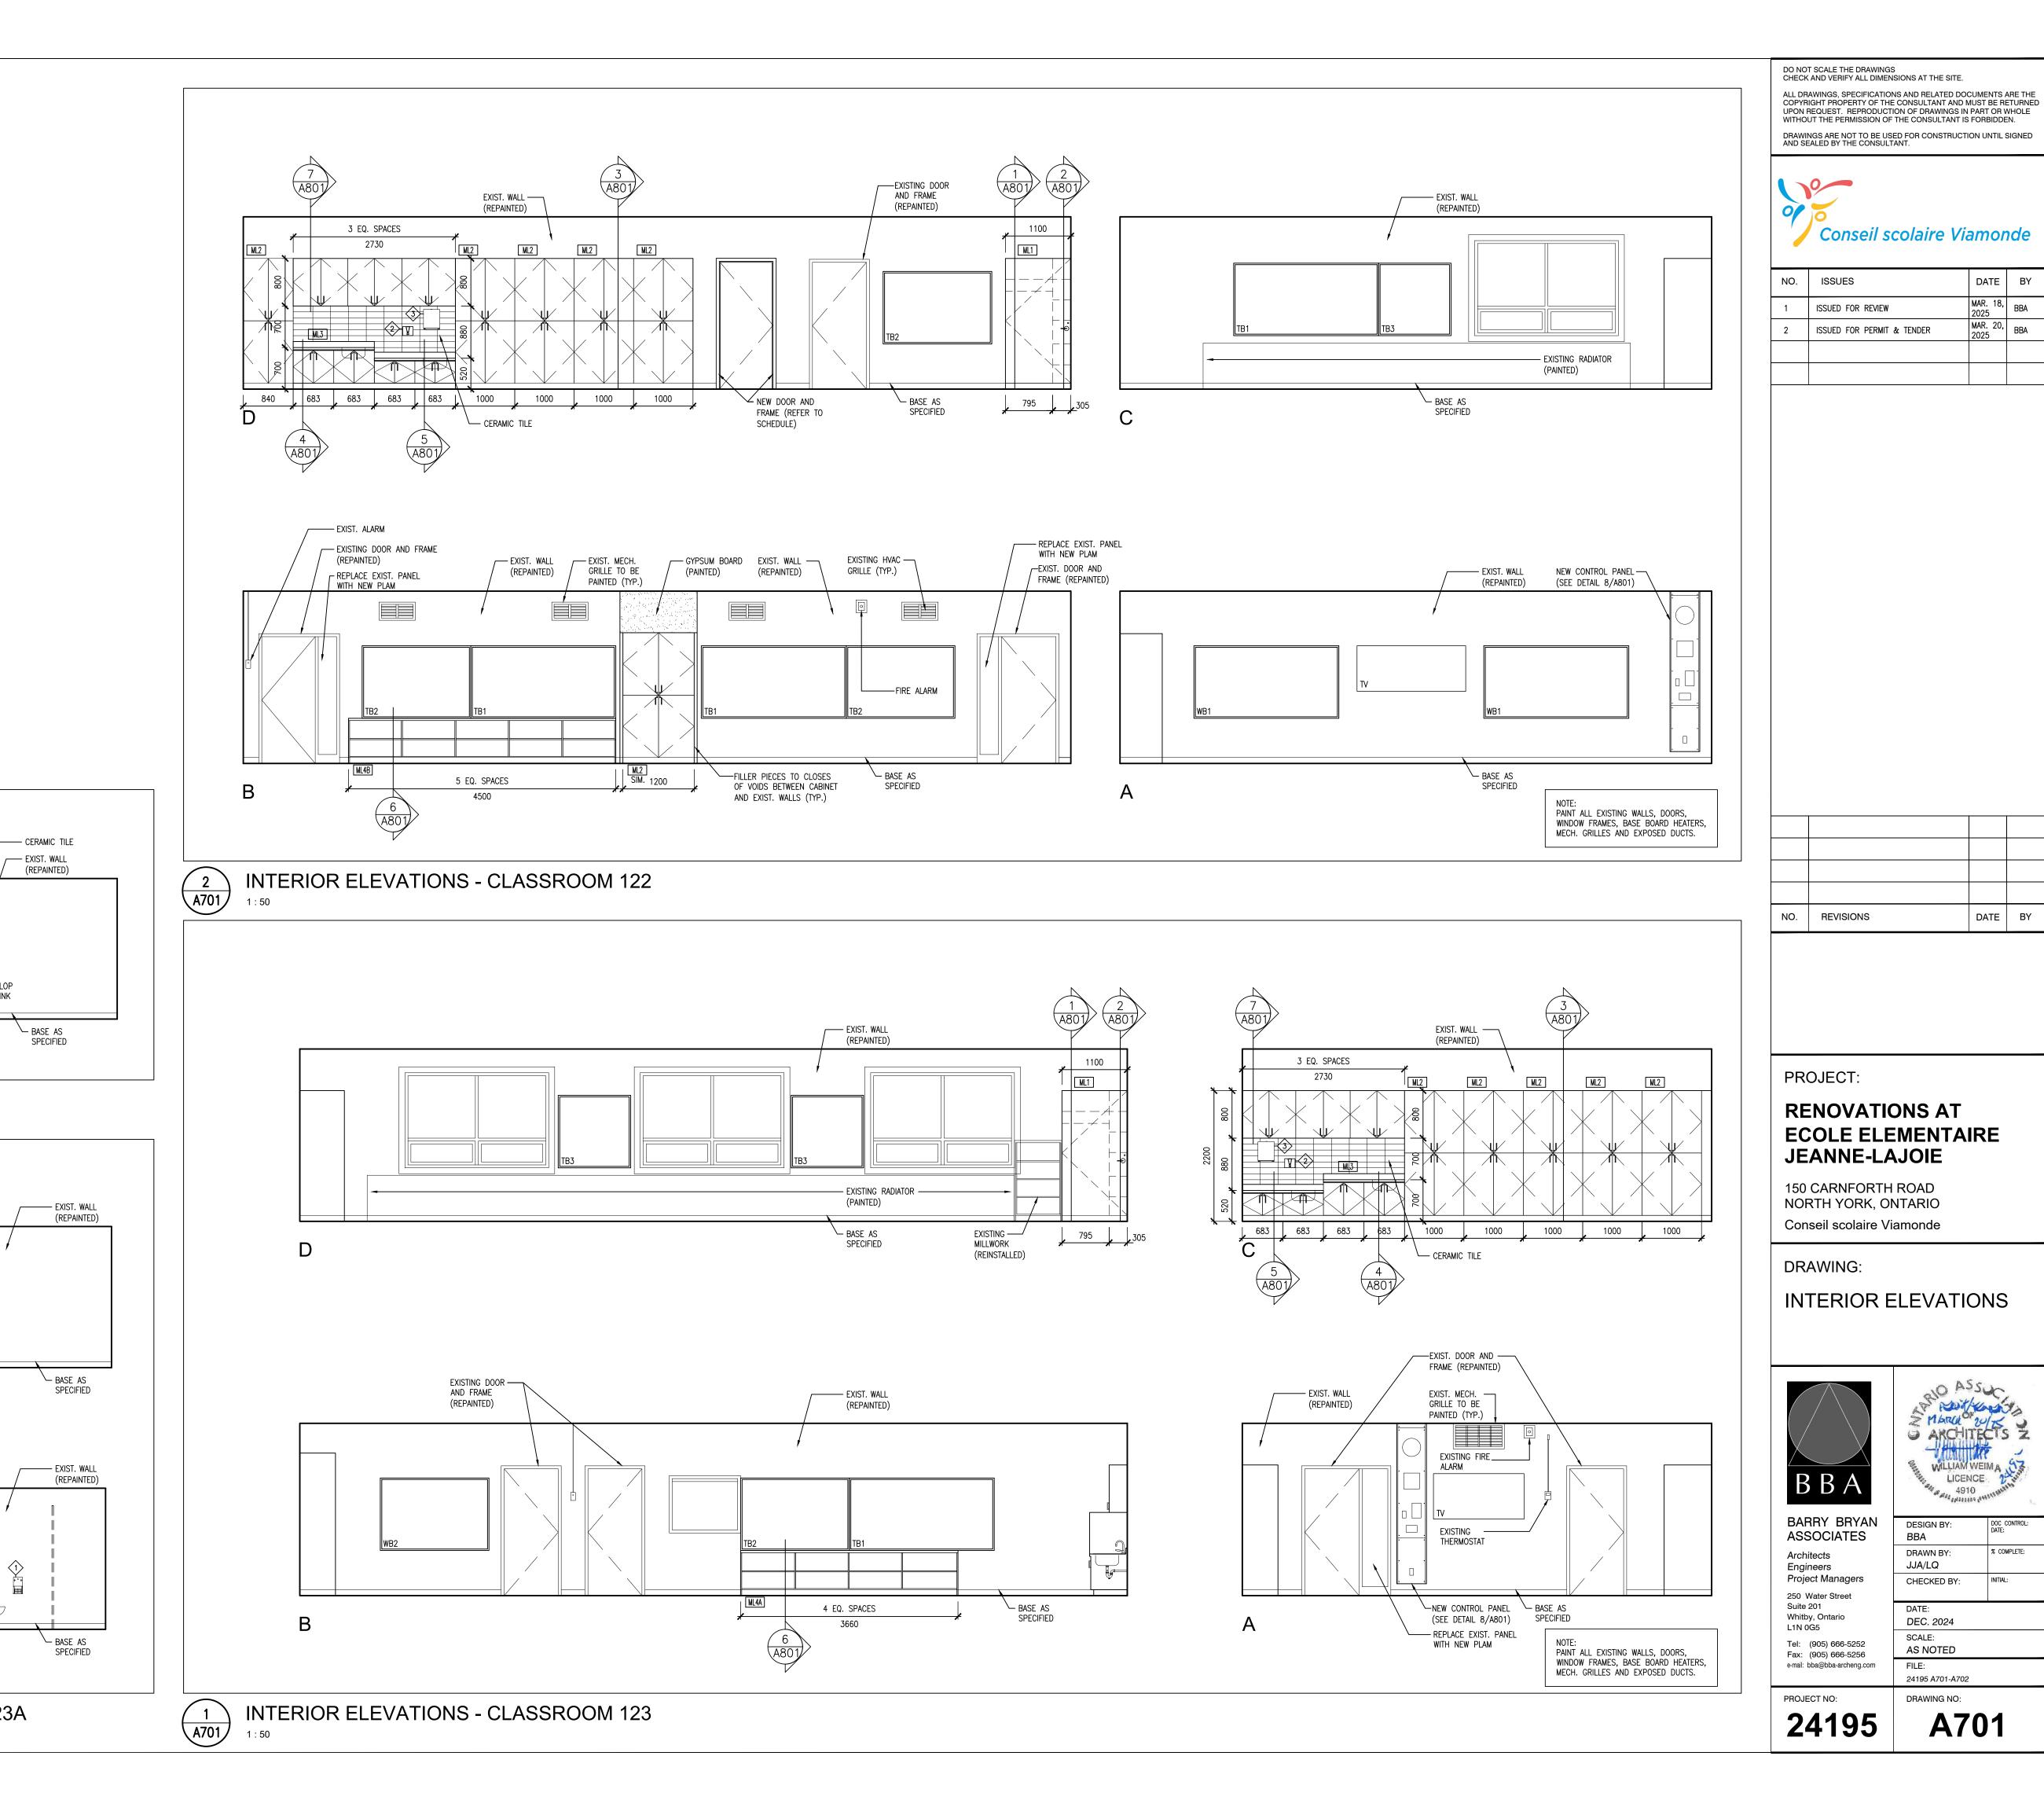

CERAMIC TILE

EXIST. WALL (REPAINTED)

INT. ELEV. - CUSTODIAN 128

___ EXISTING DOOR

AND FRAME

(REPAINTED)

— EXIST. WALL

(REPAINTED)

─ BASE AS

— EXIST. WALL EXISTING DOOR — (REPAINTED) AND FRAME

► BASE AS

SPECIFIED

SPECIFIED

(REPAINTED)

INTERIOR ELEVATIONS - WASHROOM 123A

— TOILET PARTITION

(HIDDEN FOR CLARITY)

5 A701

3 A701

DATE BY

MAR. 18, 2025 BBA

MAR. 20, BBA

DATE BY

WILLIAM WEIM & COMMENTARY OF THE PROPERTY OF T

% COMPLETE:

DESIGN BY:

DRAWN BY:

CHECKED BY:

DEC. 2024


AS NOTED


24195 A701-A702


A701

FILE:


JJA/LQ

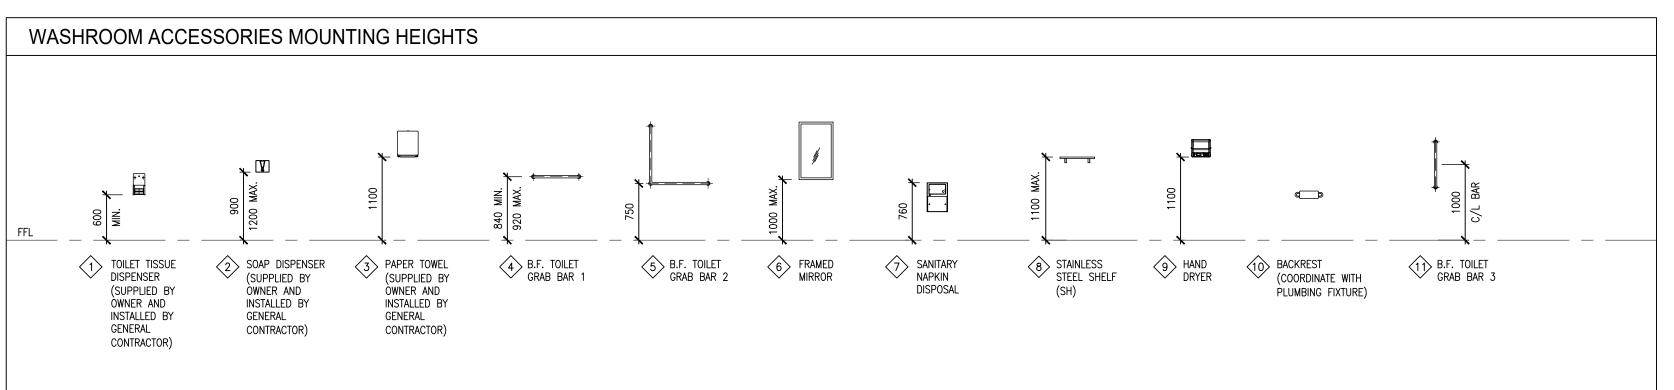

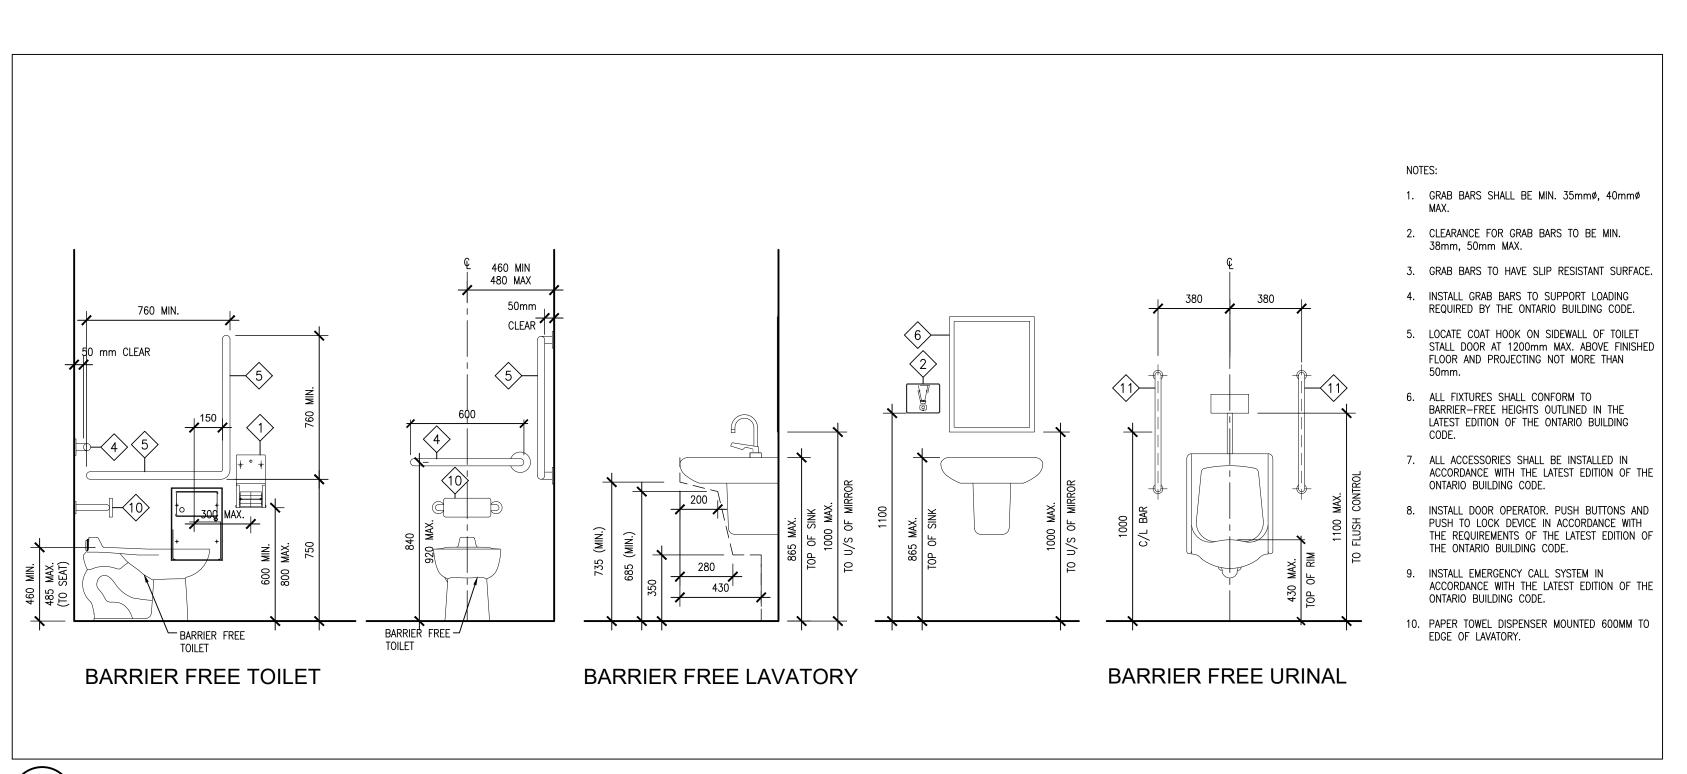

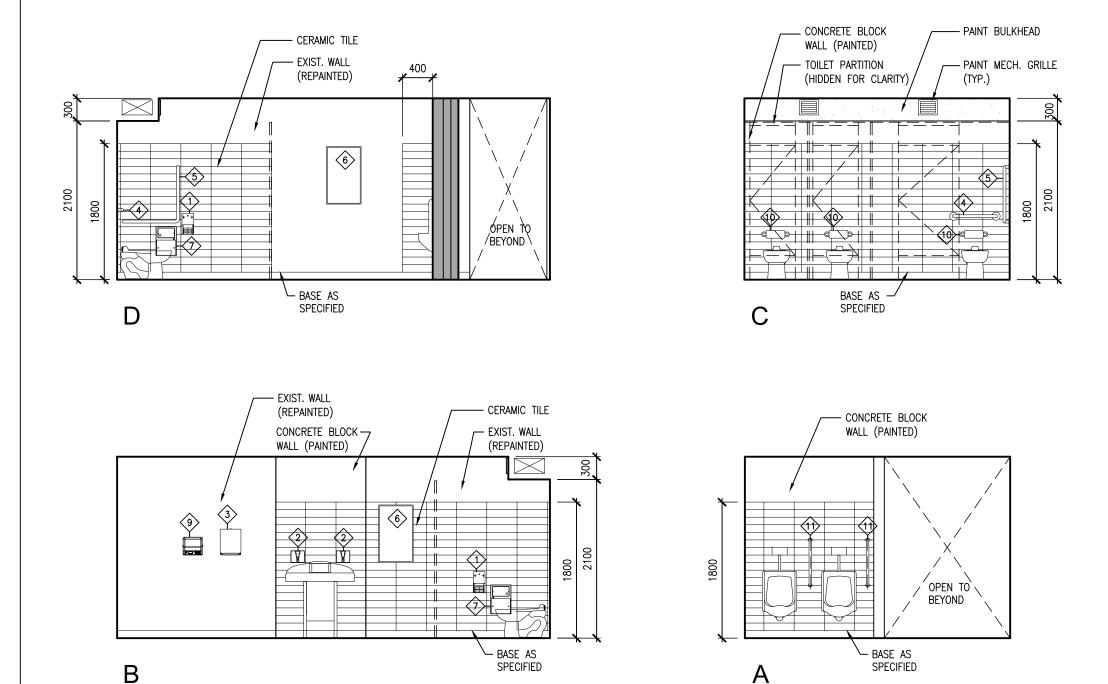



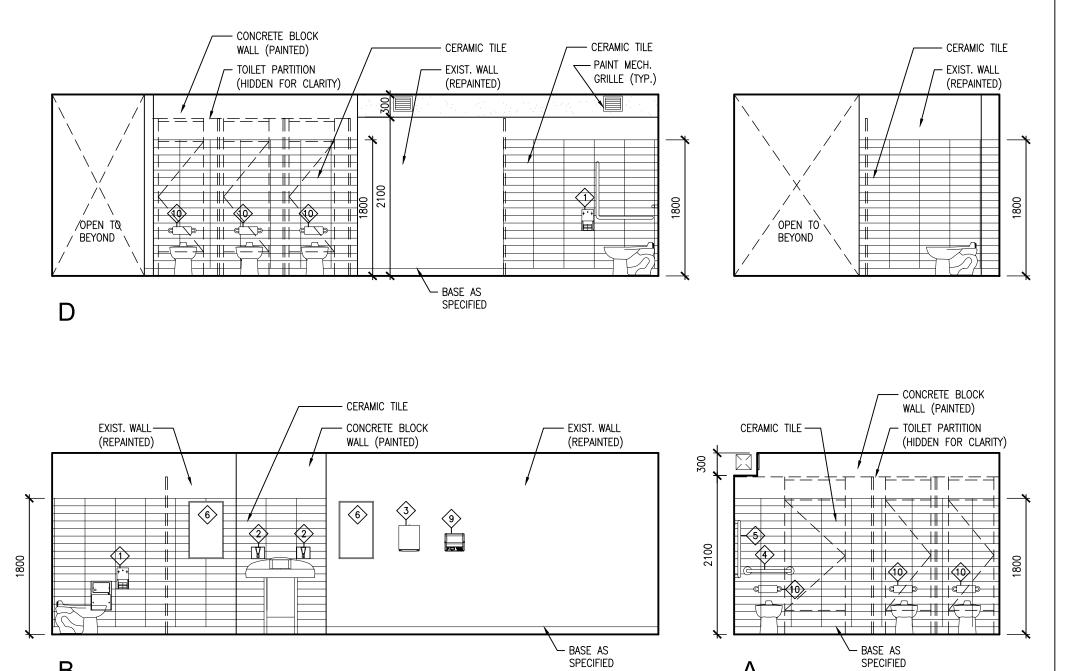


INTERIOR ELEVATIONS - GIRLS' W/R 126 A702

DO NOT SCALE THE DRAWINGS CHECK AND VERIFY ALL DIMENSIONS AT THE SITE. ALL DRAWINGS, SPECIFICATIONS AND RELATED DOCUMENTS ARE THE COPYRIGHT PROPERTY OF THE CONSULTANT AND MUST BE RETURNED UPON REQUEST. REPRODUCTION OF DRAWINGS IN PART OR WHOLE WITHOUT THE PERMISSION OF THE CONSULTANT IS FORBIDDEN. DRAWINGS ARE NOT TO BE USED FOR CONSTRUCTION UNTIL SIGNED AND SEALED BY THE CONSULTANT.



NO.	ISSUES	DATE	BY
1	ISSUED FOR REVIEW	MAR. 18, 2025	BBA
2	ISSUED FOR PERMIT & TENDER	MAR. 20, 2025	BBA

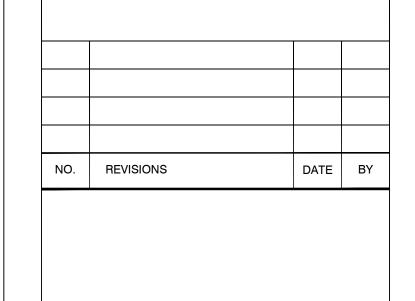


PROJECT:

RENOVATIONS AT ECOLE ELEMENTAIRE JEANNE-LAJOIE

150 CARNFORTH ROAD NORTH YORK, ONTARIO Conseil scolaire Viamonde

DRAWING:

INTERIOR ELEVATONS

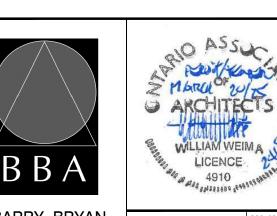

Z MARCH TU/K WILLIAM WEIM A LICENCE 4910 BARRY BRYAN DESIGN BY: ASSOCIATES

DOC CONTROL: DATE: % COMPLETE: DRAWN BY: Architects JJA/LQ Engineers Project Managers CHECKED BY: 250 Water Street Suite 201 Whitby, Ontario


DEC. 2024 Tel: (905) 666-5252 AS NOTED Fax: (905) 666-5256 e-mail: bba@bba-archeng.com FILE:


24195 A701-A702 PROJECT NO: DRAWING NO: A702

24195


L1N 0G5

SPECIFIED

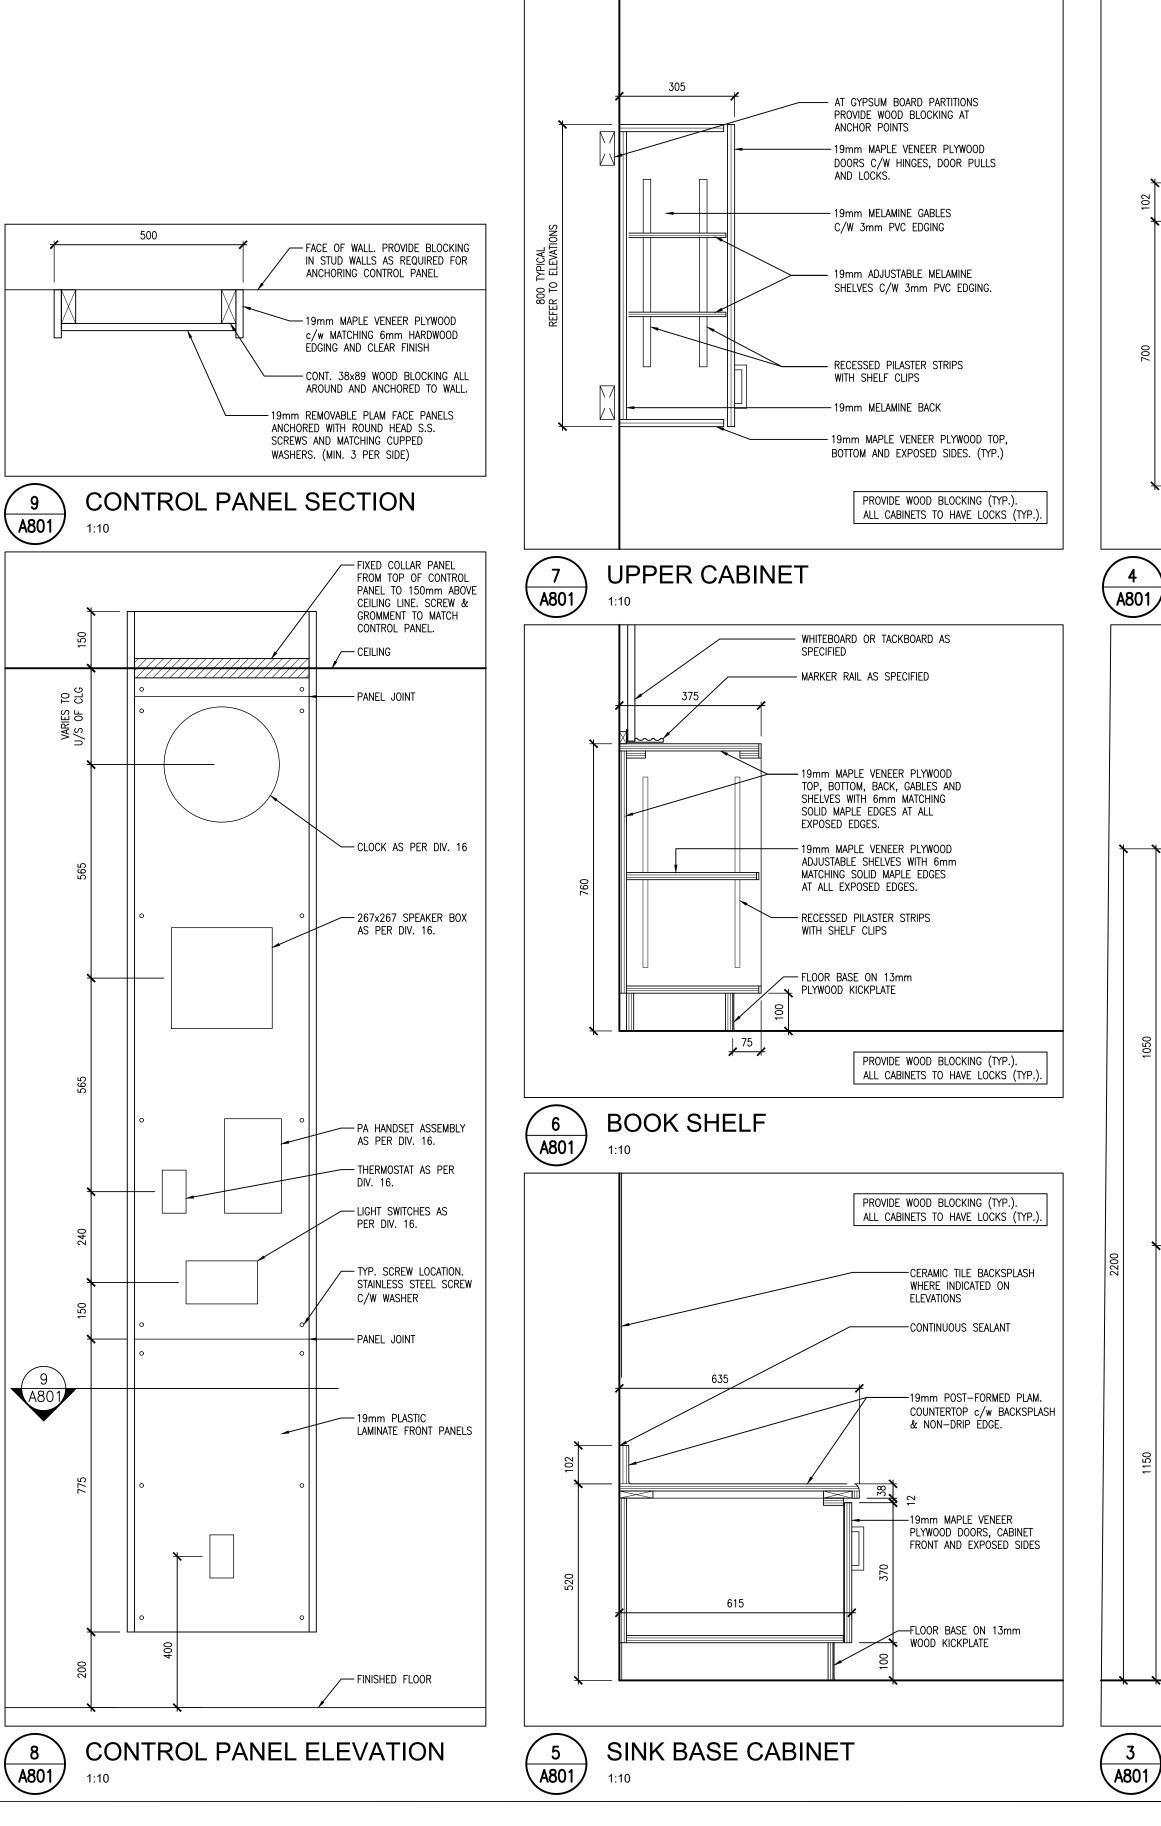


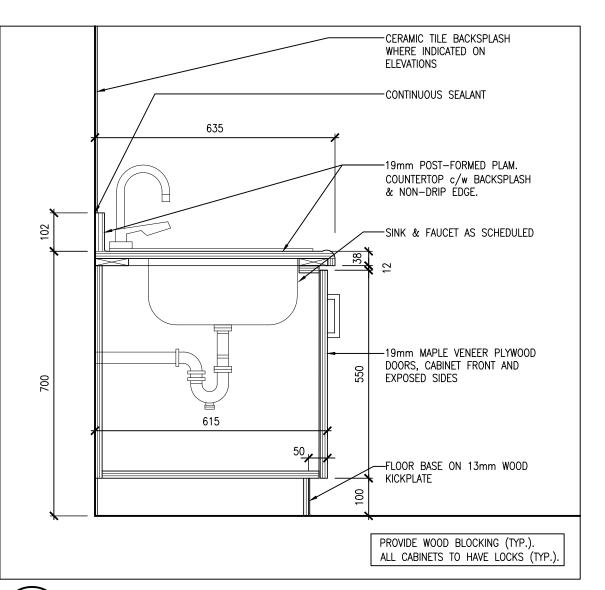





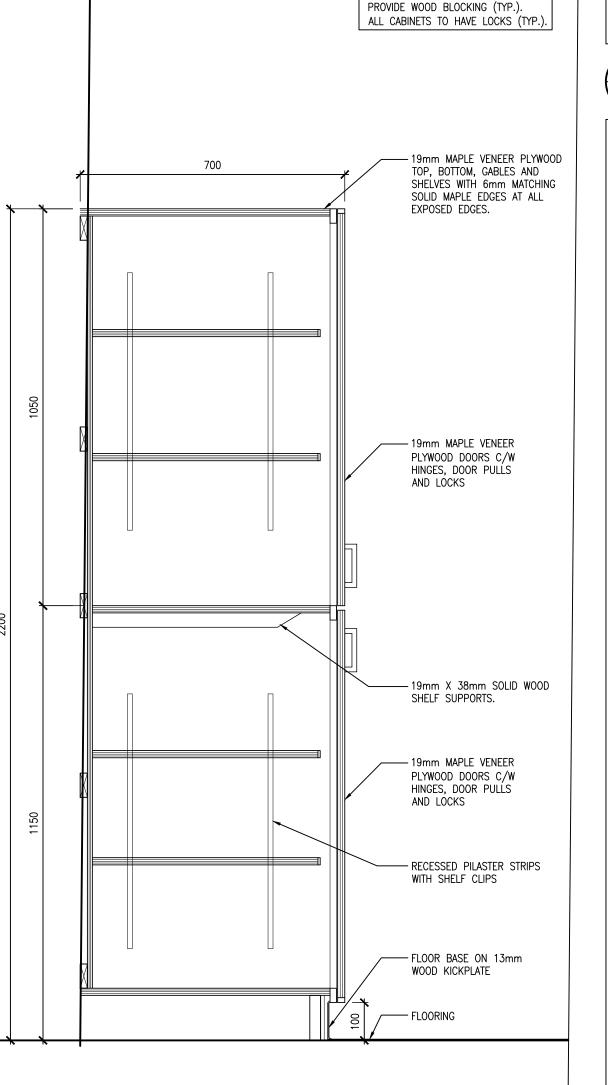

STORAGE SECTION

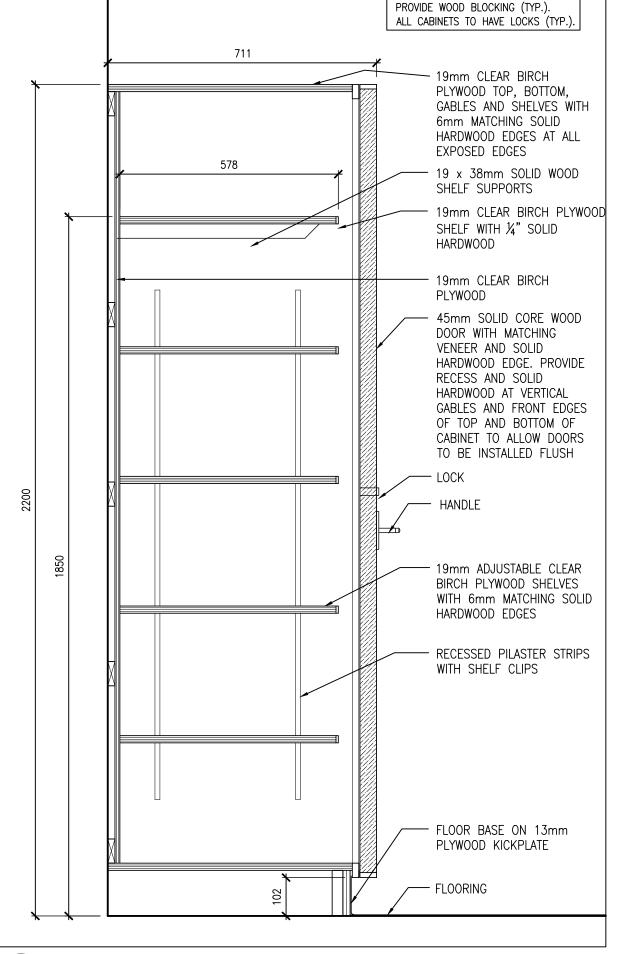

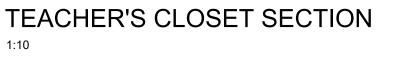

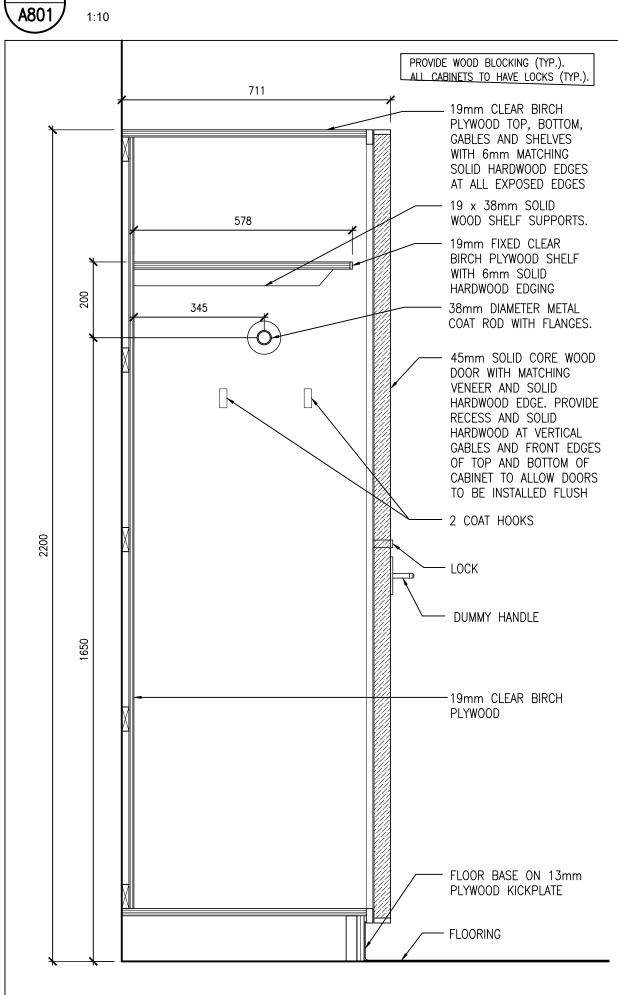

TEACHER'S CLOSET SECTION A801

DO NOT SCALE THE DRAWINGS CHECK AND VERIFY ALL DIMENSIONS AT THE SITE. ALL DRAWINGS, SPECIFICATIONS AND RELATED DOCUMENTS ARE THE COPYRIGHT PROPERTY OF THE CONSULTANT AND MUST BE RETURNED UPON REQUEST. REPRODUCTION OF DRAWINGS IN PART OR WHOLE WITHOUT THE PERMISSION OF THE CONSULTANT IS FORBIDDEN. DRAWINGS ARE NOT TO BE USED FOR CONSTRUCTION UNTIL SIGNED AND SEALED BY THE CONSULTANT.



NO.	ISSUES	DATE	BY
1	ISSUED FOR REVIEW	MAR. 18, 2025	BBA
2	ISSUED FOR PERMIT & TENDER	MAR. 20, 2025	BBA

PROJECT:

NO. REVISIONS

RENOVATIONS AT ECOLE ELEMENTAIRE JEANNE-LAJOIE

150 CARNFORTH ROAD NORTH YORK, ONTARIO Conseil scolaire Viamonde

DRAWING:

MILLWORK SECTIONS



L1N 0G5

Fax: (905) 666-5256

e-mail: bba@bba-archeng.com

NO ASSU MARCHITECTS Z WILLIAM WEIMA LICENCE 1 4910 DOC CONTROL: DATE:

DATE BY


DESIGN BY: ASSOCIATES Architects Engineers Project Managers 250 Water Street Suite 201 Whitby, Ontario

% COMPLETE: DRAWN BY: CHECKED BY: DEC. 2024 Tel: (905) 666-5252 AS NOTED

FILE:

24195 A701-A702 PROJECT NO: 24195

DRAWING NO: A801

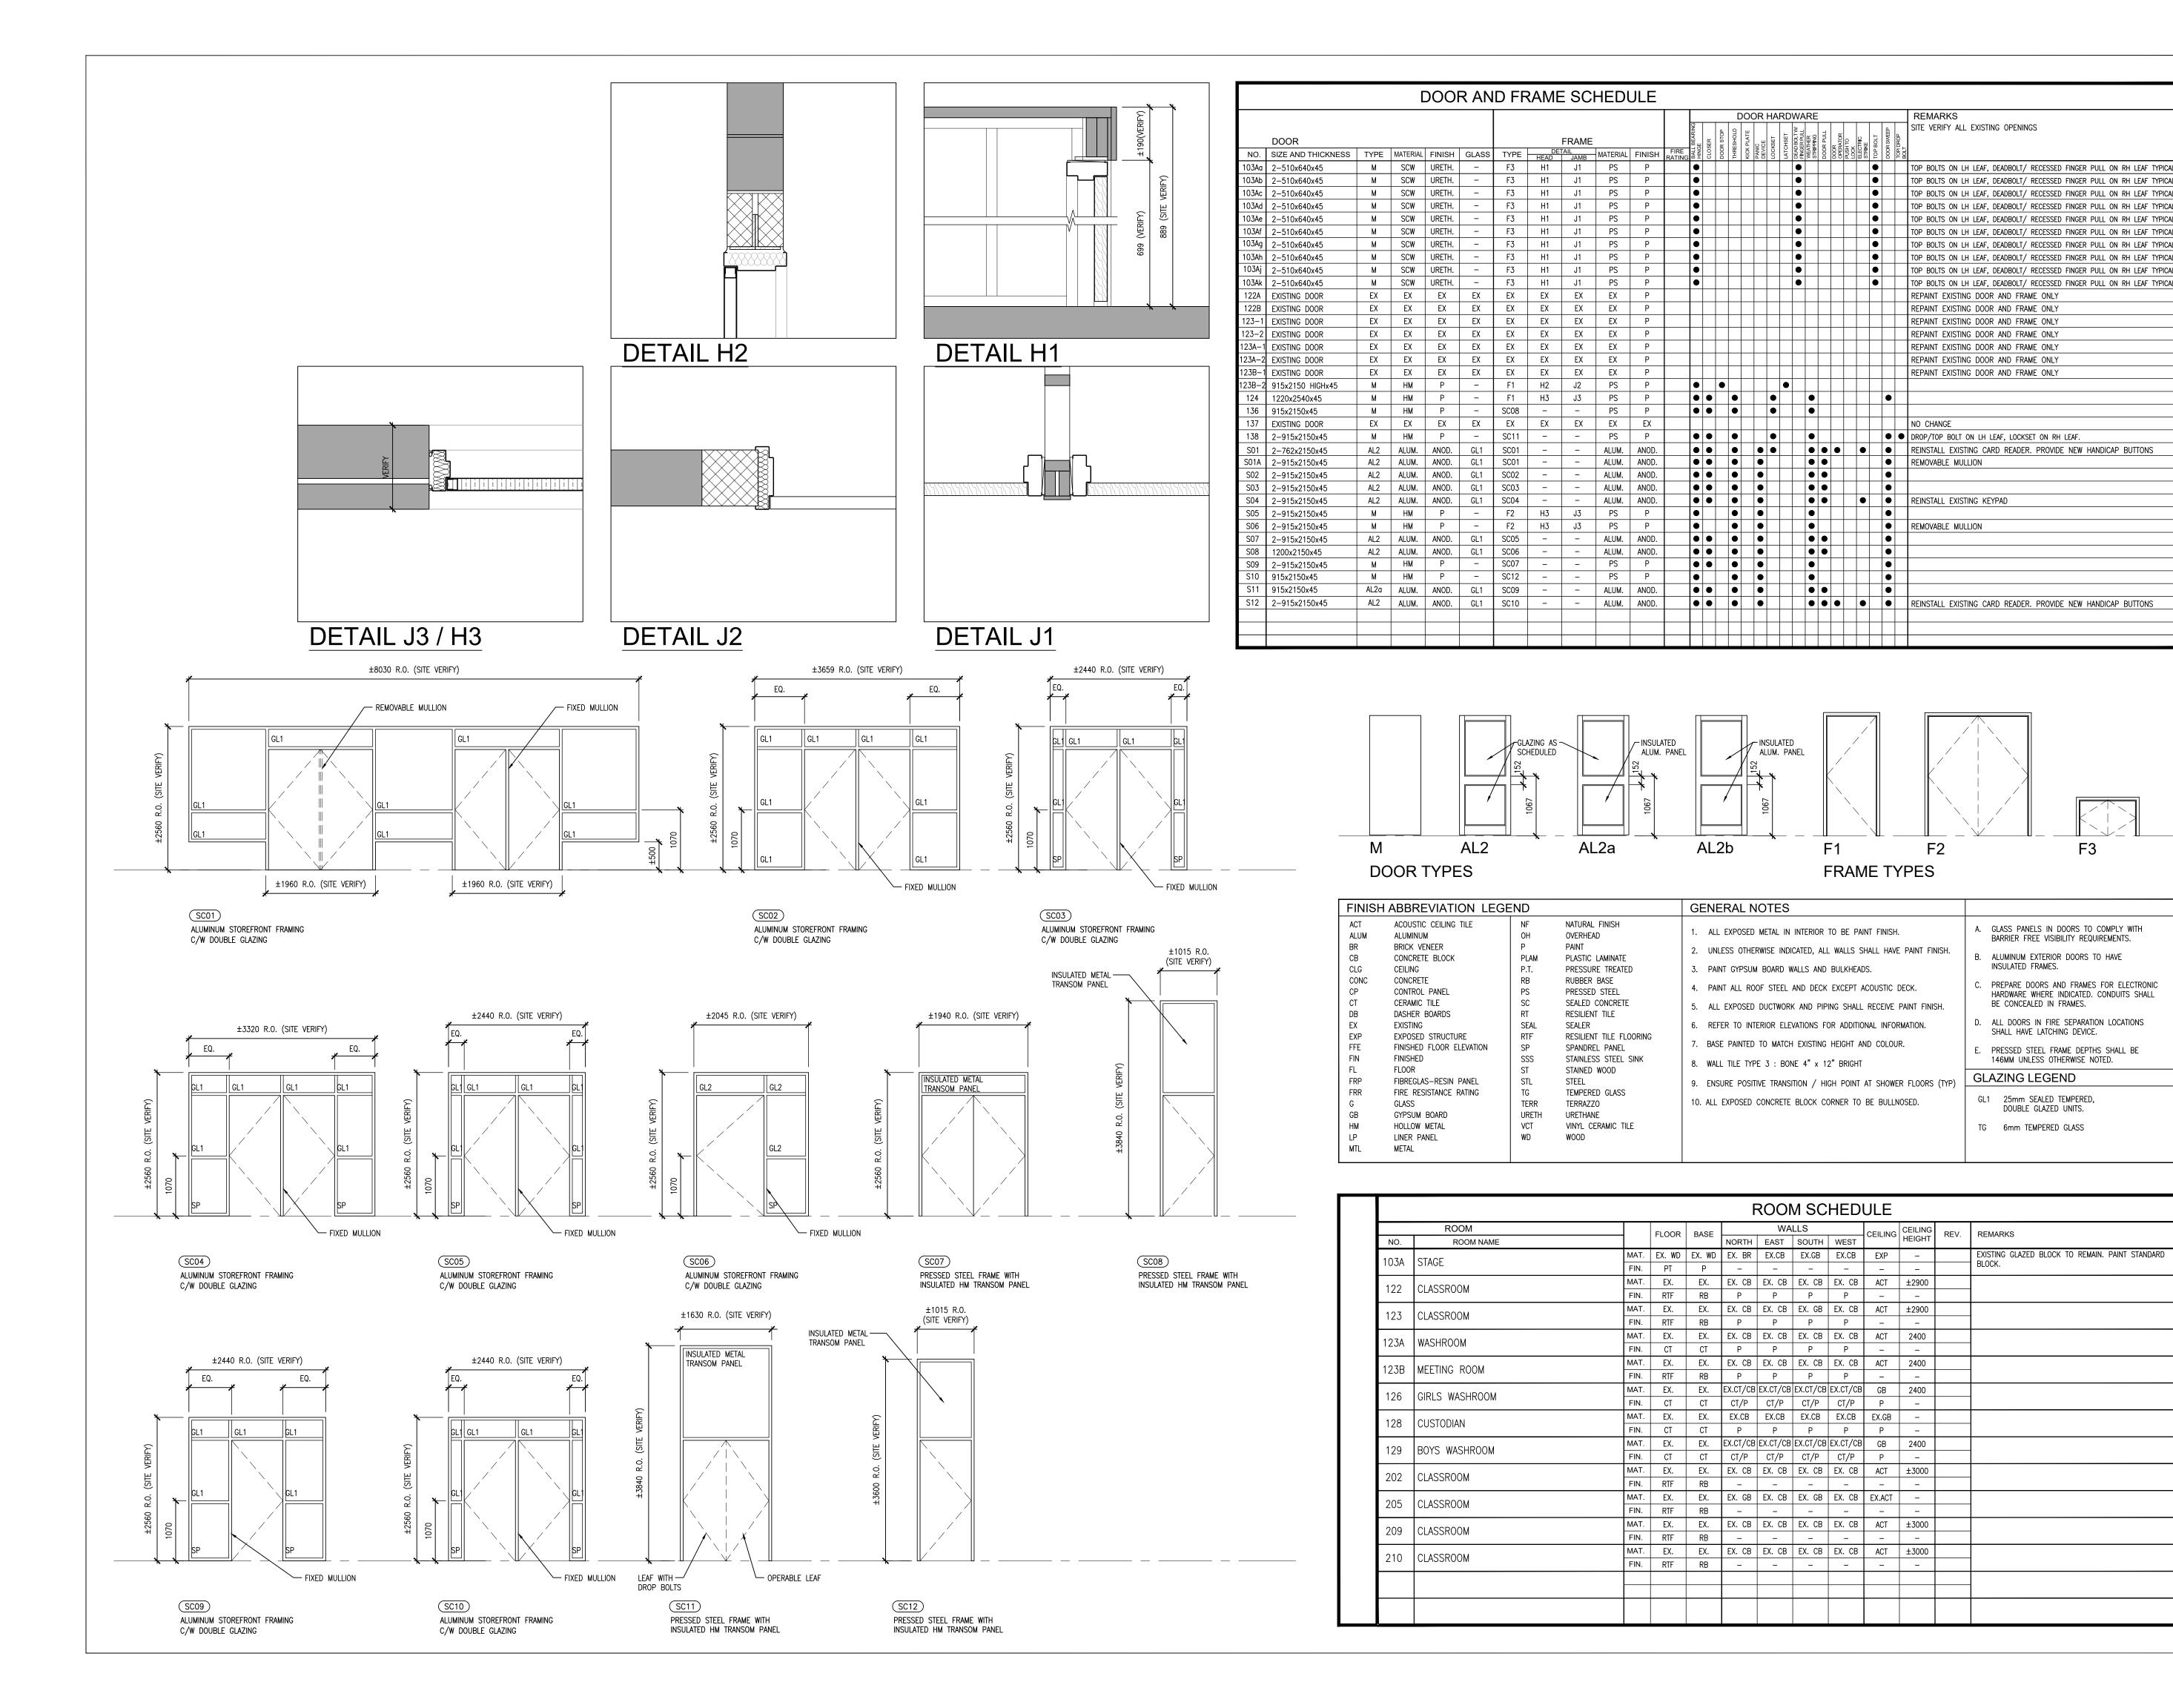

DO NOT SCALE THE DRAWINGS CHECK AND VERIFY ALL DIMENSIONS AT THE SITE. ALL DRAWINGS, SPECIFICATIONS AND RELATED DOCUMENTS ARE THE COPYRIGHT PROPERTY OF THE CONSULTANT AND MUST BE RETURNED UPON REQUEST. REPRODUCTION OF DRAWINGS IN PART OR WHOLE WITHOUT THE PERMISSION OF THE CONSULTANT IS FORBIDDEN. DRAWINGS ARE NOT TO BE USED FOR CONSTRUCTION UNTIL SIGNED AND SEALED BY THE CONSULTANT.



NO.	ISSUES	DATE	BY
1	ISSUED FOR REVIEW	MAR. 18, 2025	BBA
2	ISSUED FOR PERMIT & TENDER	MAR. 20, 2025	BBA

NO.	REVISIONS	DATE	BY

PROJECT:

F3

A. GLASS PANELS IN DOORS TO COMPLY WITH

BARRIER FREE VISIBILITY REQUIREMENTS.

ALUMINUM EXTERIOR DOORS TO HAVE

PREPARE DOORS AND FRAMES FOR ELECTRONIC

HARDWARE WHERE INDICATED. CONDUITS SHALL

ALL DOORS IN FIRE SEPARATION LOCATIONS

PRESSED STEEL FRAME DEPTHS SHALL BE

EXISTING GLAZED BLOCK TO REMAIN. PAINT STANDARD

INSULATED FRAMES.

BE CONCEALED IN FRAMES.

SHALL HAVE LATCHING DEVICE.

GL1 25mm SEALED TEMPERED,

TG 6mm TEMPERED GLASS

DOUBLE GLAZED UNITS.

146MM UNLESS OTHERWISE NOTED.


RENOVATIONS AT ECOLE ELEMENTAIRE JEANNE-LAJOIE

150 CARNFORTH ROAD NORTH YORK, ONTARIO Conseil scolaire Viamonde

DRAWING:

SCHEDULES



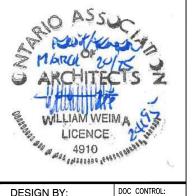

% COMPLETE:

BARRY BRYAN ASSOCIATES	
Architects Engineers Project Managers	_
250 Water Street Suite 201	-


DRAWN BY: CM CHECKED BY: DEC. 2024

BBA

Whitby, Ontario L1N 0G5 Tel: (905) 666-5252 AS NOTED Fax: (905) 666-5256

e-mail: bba@bba-archeng.com FILE: DRAWING NO:

PROJECT NO: 24195 A901

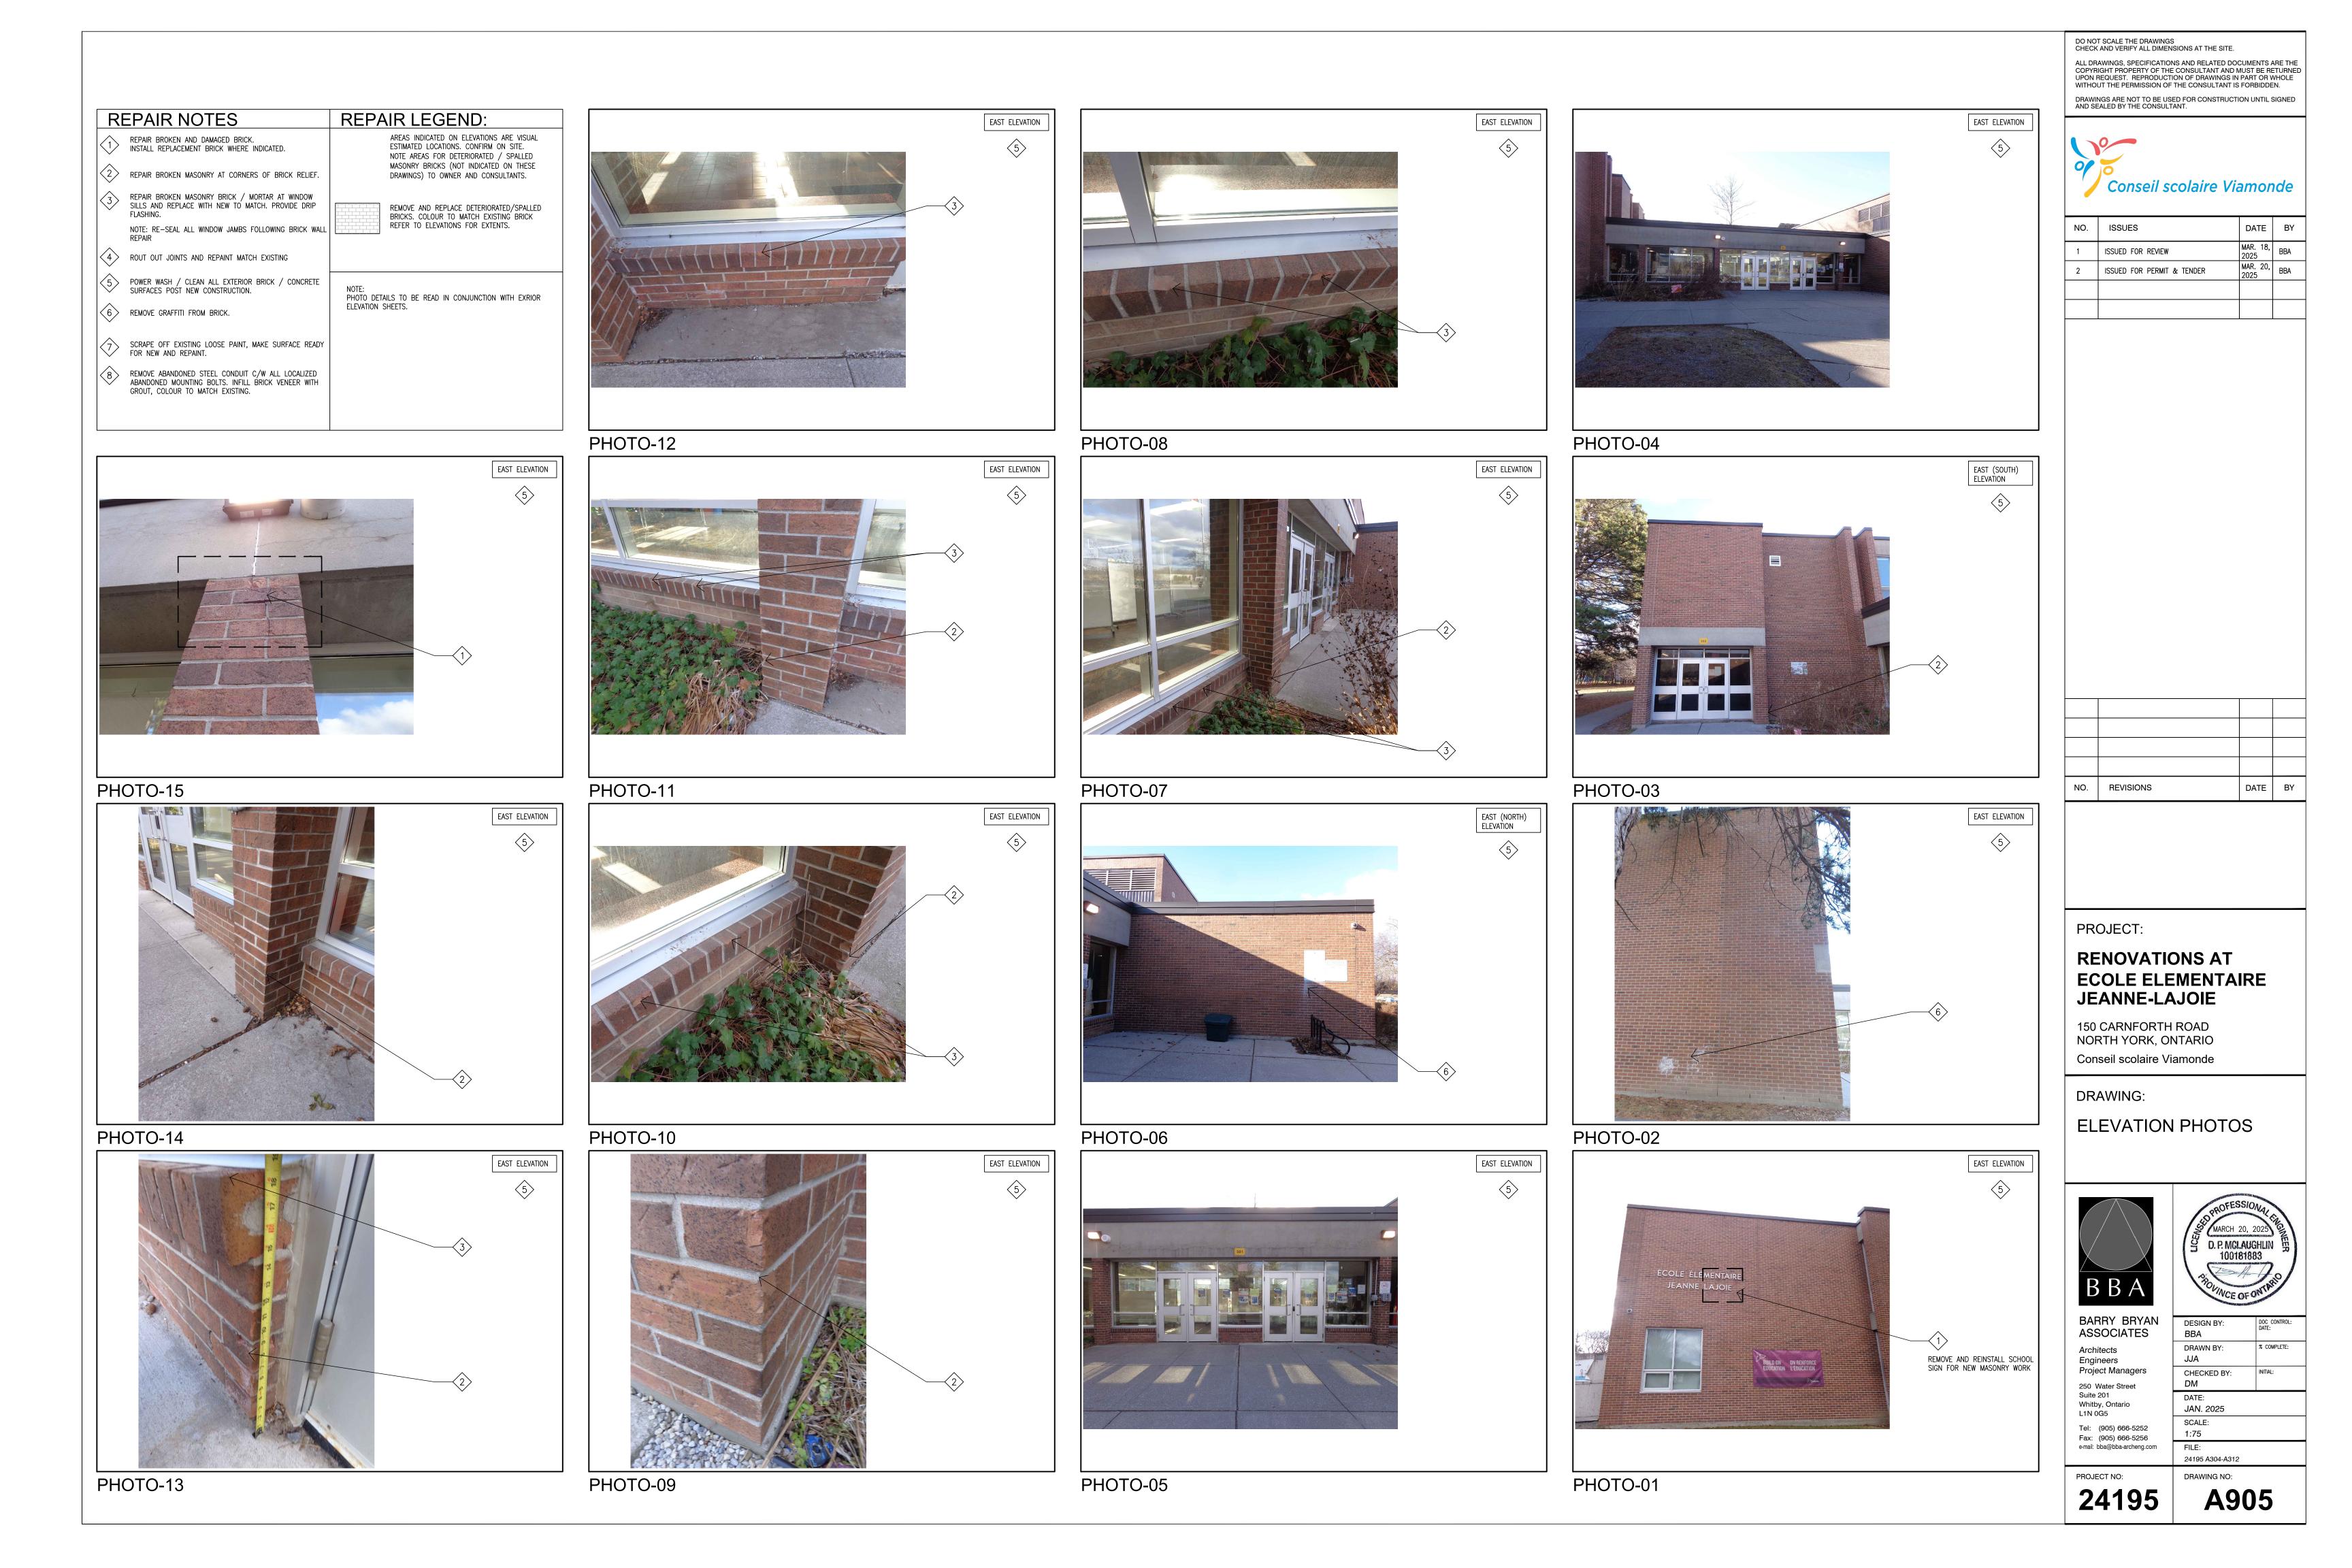








DO NOT SCALE THE DRAWINGS CHECK AND VERIFY ALL DIMENSIONS AT THE SITE. ALL DRAWINGS, SPECIFICATIONS AND RELATED DOCUMENTS ARE THE COPYRIGHT PROPERTY OF THE CONSULTANT AND MUST BE RETURNED UPON REQUEST. REPRODUCTION OF DRAWINGS IN PART OR WHOLE WITHOUT THE PERMISSION OF THE CONSULTANT IS FORBIDDEN.



NO.	ISSUES	DATE	ВҮ
1	ISSUED FOR REVIEW	MAR. 18, 2025	BBA
2	ISSUED FOR PERMIT & TENDER	MAR. 20, 2025	BBA

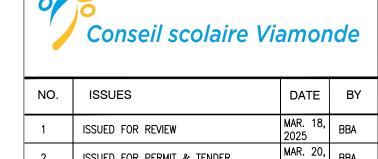

NO.	REVISIONS	DATE	BY

]				
-49		NO.	REVISIONS	DATE	BY
NORTH ELEVATION					
1					





DO NOT SCALE THE DRAWINGS CHECK AND VERIFY ALL DIMENSIONS AT THE SITE. ALL DRAWINGS, SPECIFICATIONS AND RELATED DOCUMENTS ARE THE COPYRIGHT PROPERTY OF THE CONSULTANT AND MUST BE RETURNED UPON REQUEST. REPRODUCTION OF DRAWINGS IN PART OR WHOLE WITHOUT THE PERMISSION OF THE CONSULTANT IS FORBIDDEN.




NO.	ISSUES	DATE	BY
1	ISSUED FOR REVIEW	MAR. 18, 2025	BBA
2	ISSUED FOR PERMIT & TENDER	MAR. 20, 2025	BBA




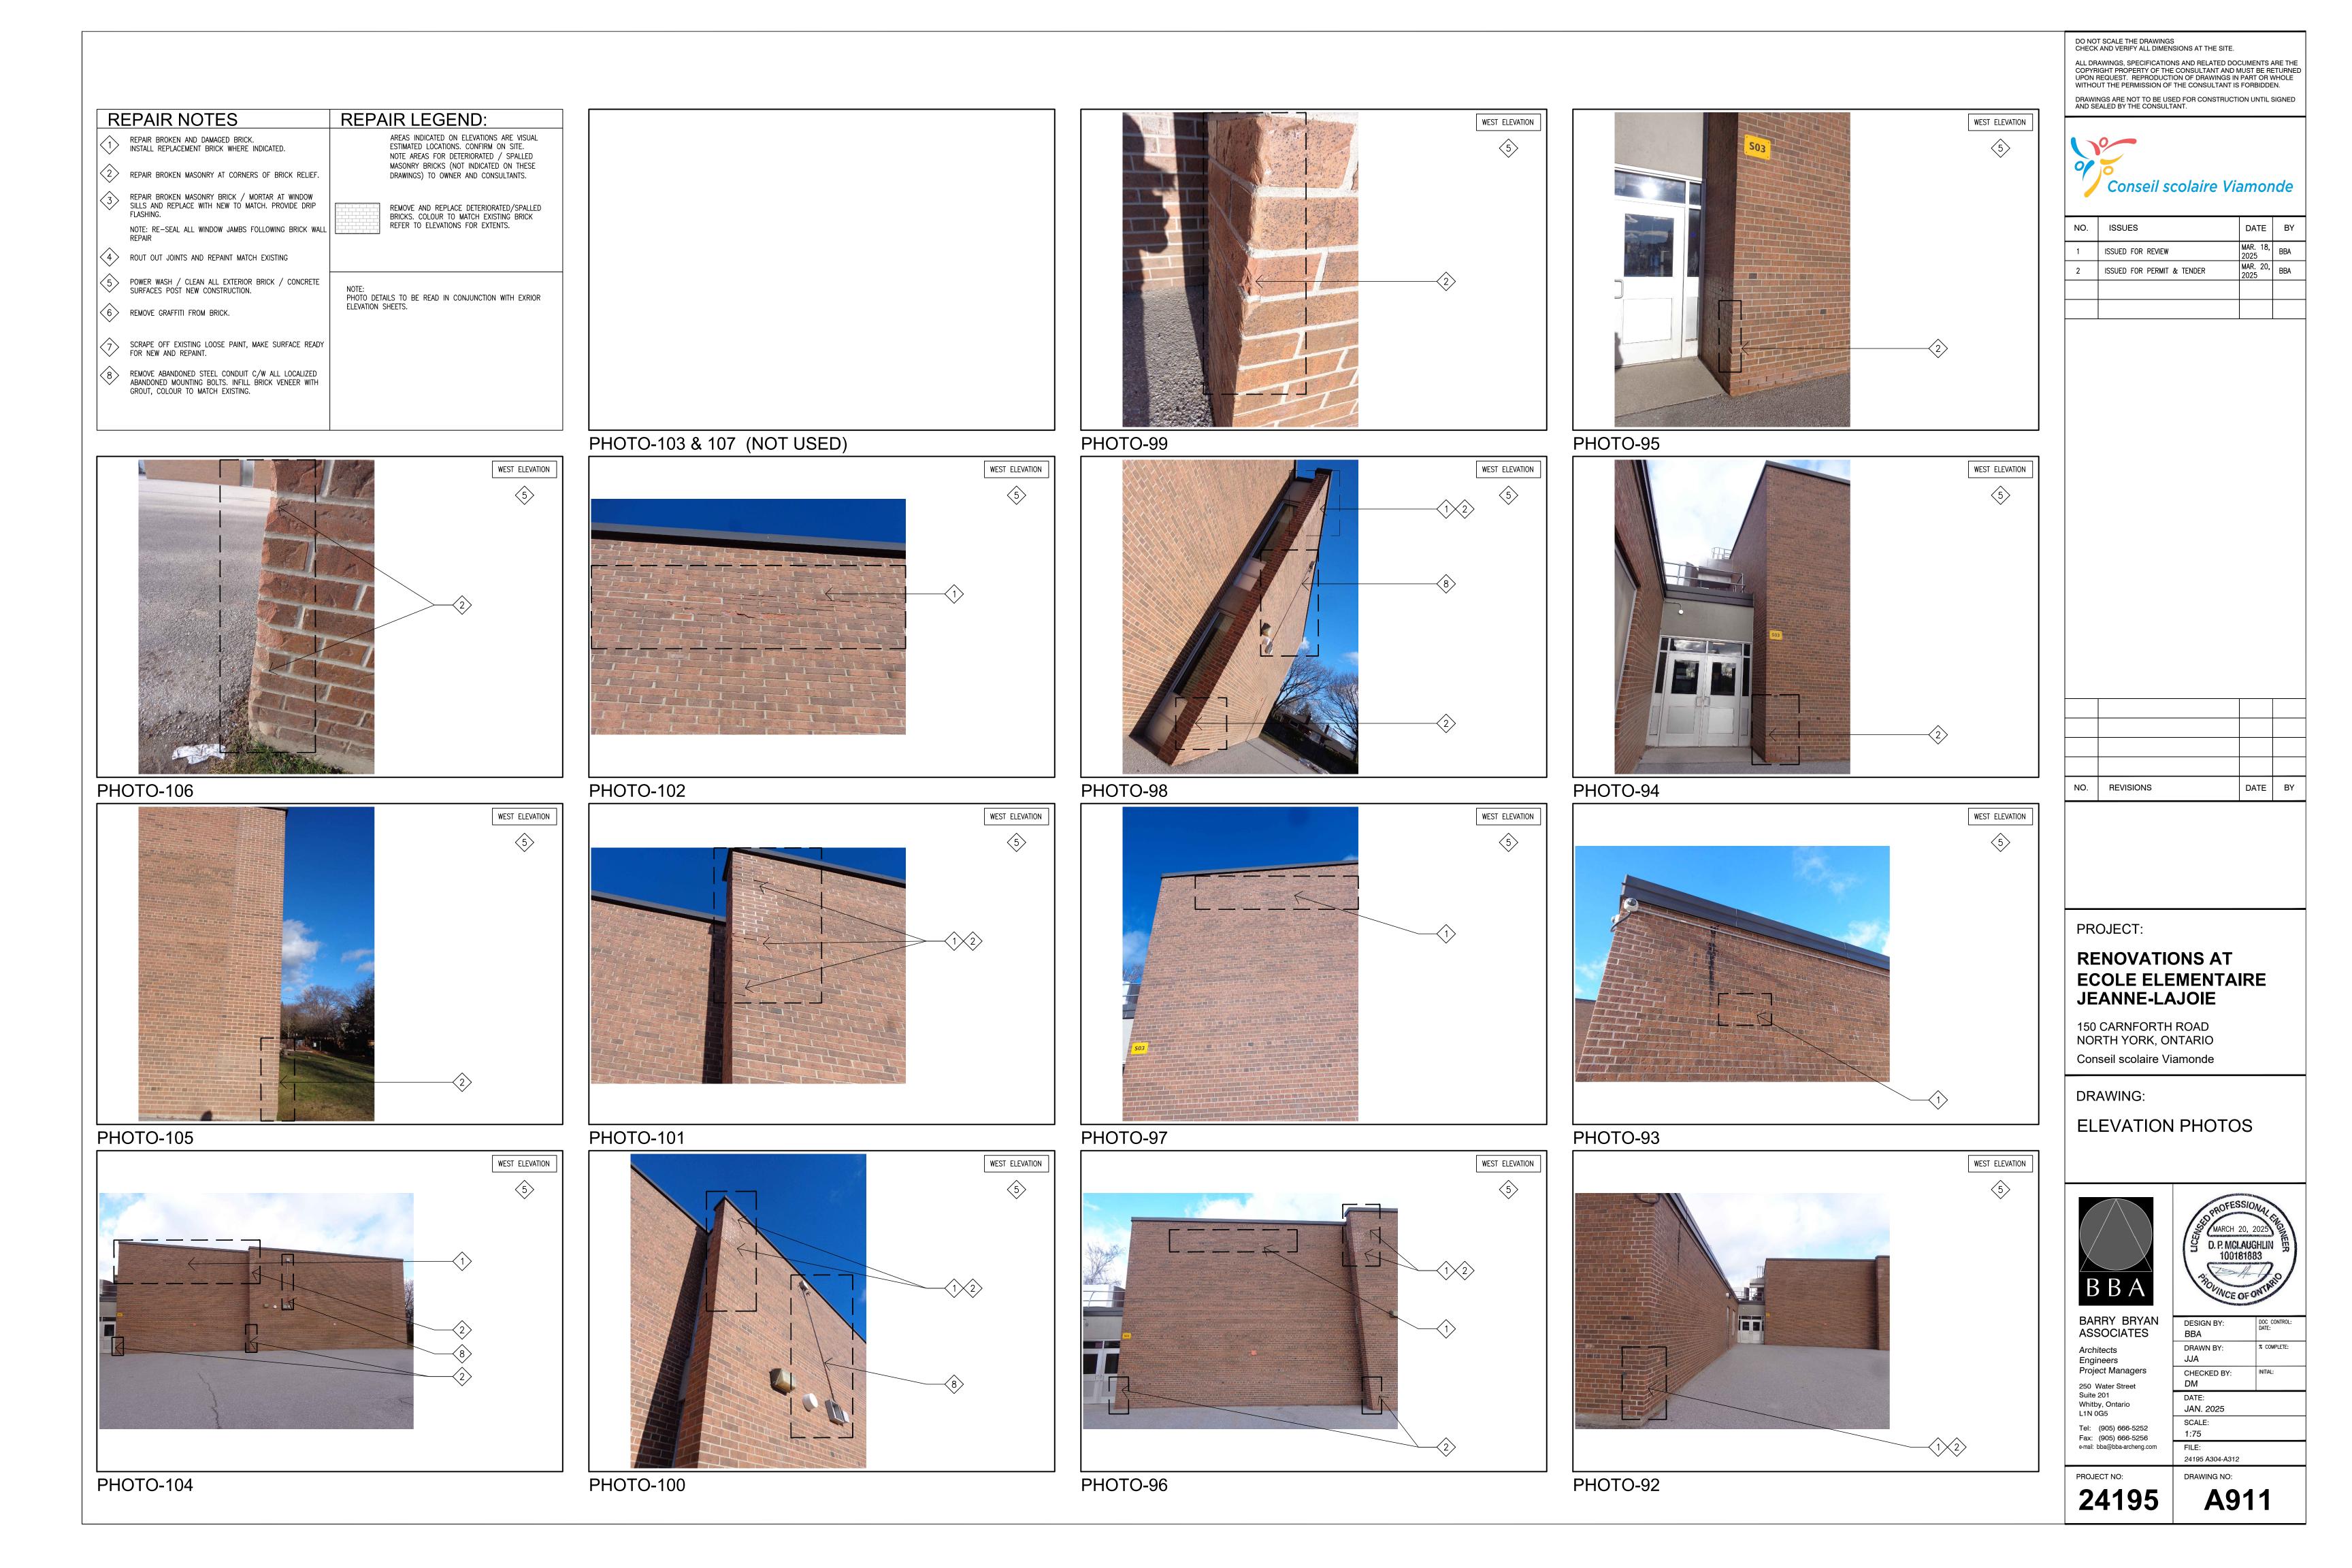

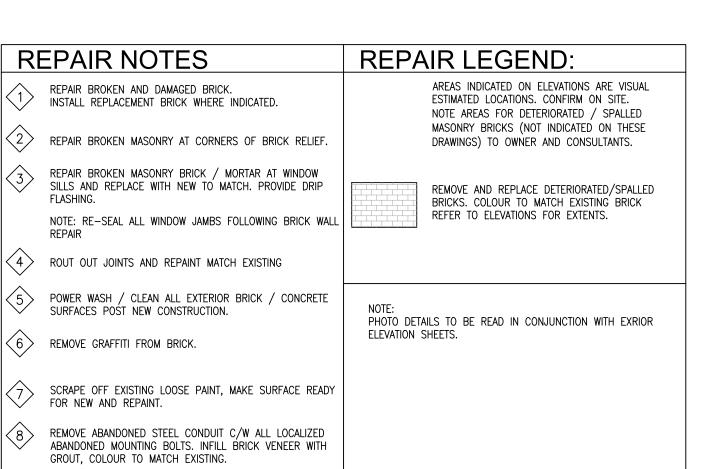



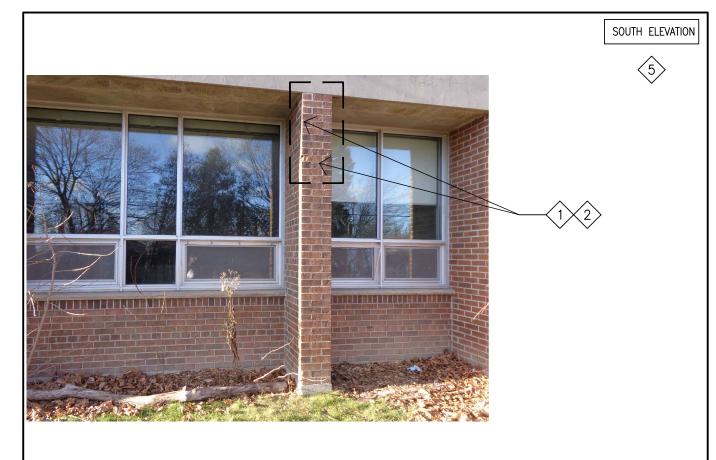


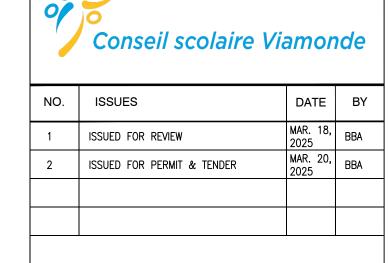



DO NOT SCALE THE DRAWINGS CHECK AND VERIFY ALL DIMENSIONS AT THE SITE.


ALL DRAWINGS, SPECIFICATIONS AND RELATED DOCUMENTS ARE THE COPYRIGHT PROPERTY OF THE CONSULTANT AND MUST BE RETURNED UPON REQUEST. REPRODUCTION OF DRAWINGS IN PART OR WHOLE WITHOUT THE PERMISSION OF THE CONSULTANT IS FORBIDDEN.

DRAWINGS ARE NOT TO BE USED FOR CONSTRUCTION UNTIL SIGNED AND SEALED BY THE CONSULTANT.

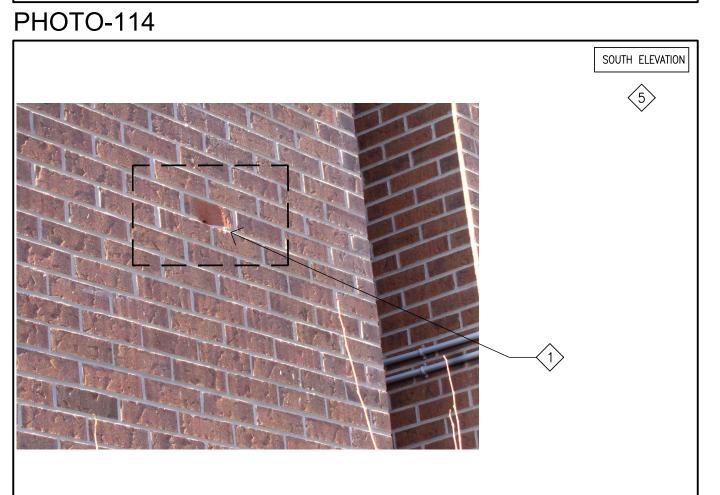


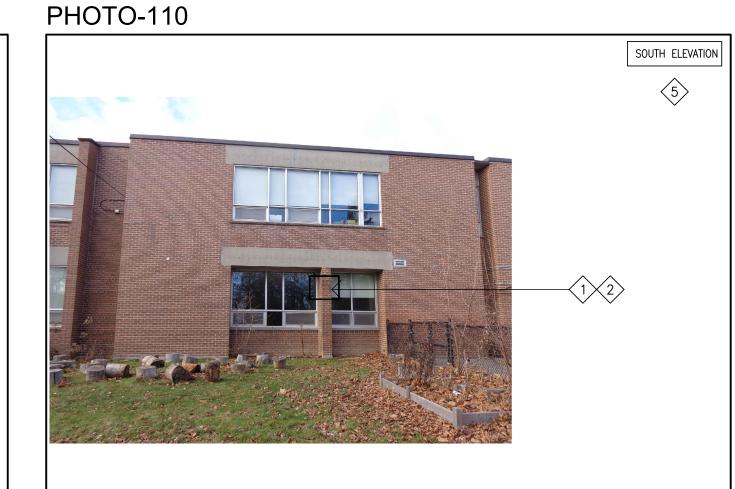

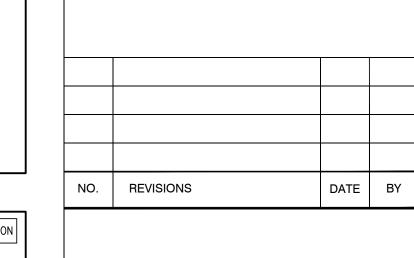


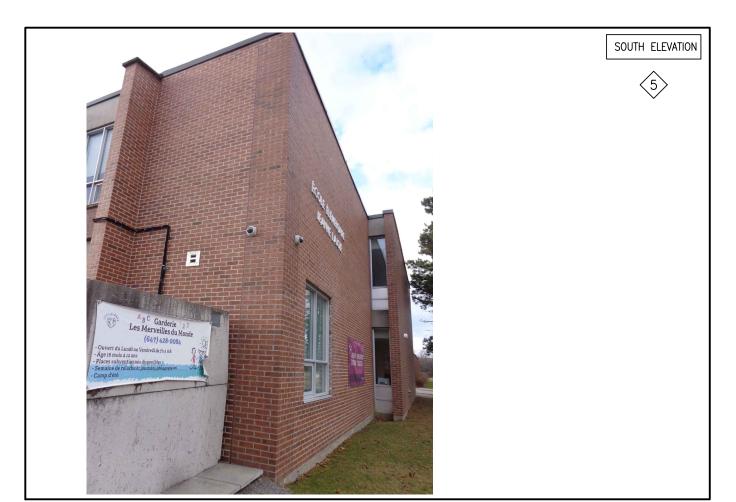



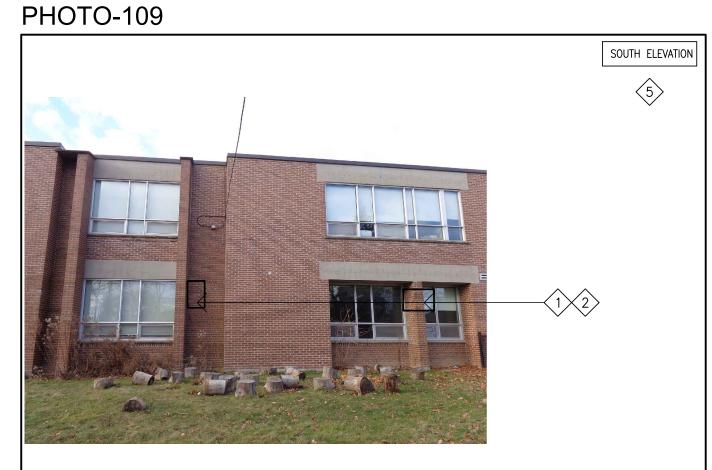


PROJECT:
RENOVATIONS AT ECOLE ELEMENTAIRE JEANNE-LAJOIE
150 CARNFORTH ROAD NORTH YORK, ONTARIO Conseil scolaire Viamonde

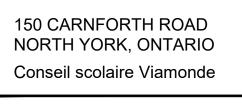

DRAWING:

ELEVATION PHOTOS



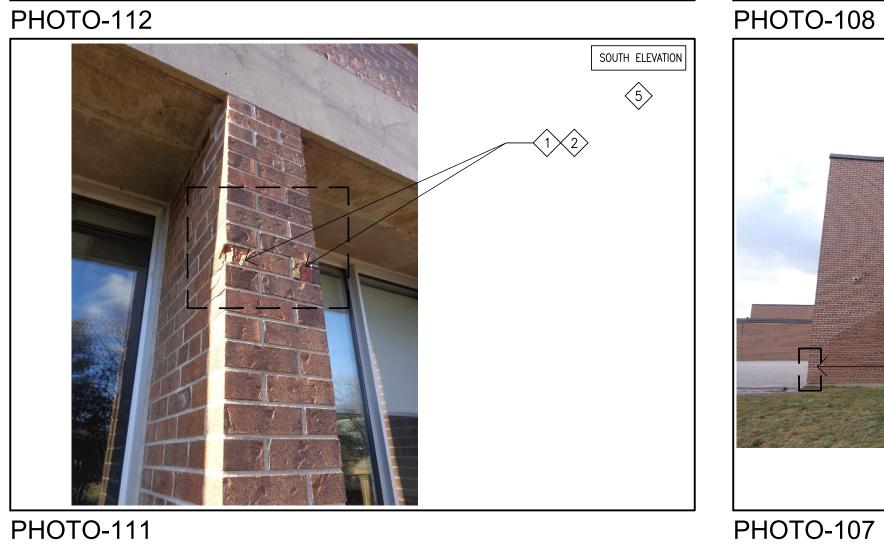



BBA	D. P. MCLAI 100181	2025 UGHLIN ER 883
BARRY BRYAN ASSOCIATES	DESIGN BY: BBA	DOC CONTROL: DATE:
Architects Engineers	DRAWN BY: JJA	% COMPLETE:
Project Managers 250 Water Street	CHECKED BY: DM	INITIAL:
Suite 201 Whitby, Ontario L1N 0G5	DATE: JAN. 2025	
Tel: (905) 666-5252 Fax: (905) 666-5256	SCALE: 1:75	
e-mail: bba@bba-archeng.com	FILE: 24195 A304-A312	

24195 A912

PHOTO-115

PHOTO-111



GENERAL

REQUIREMENTS.

- 1. ALL MATERIALS AND WORKMANSHIP SHALL CONFORM TO THE REQUIREMENTS OF THE ONTARIO BUILDING CODE, LATEST EDITION AND THE OCCUPATIONAL HEALTH AND SAFETY ACT/REGULATIONS FOR CONSTRUCTION PROJECTS.
- 2. CONFORM TO OWNER'S GENERAL SPECIFICATIONS INCLUDING ALL SAFETY
- 3. SITE VERIFY ALL DIMENSIONS AND LEVELS.
- 4. KEEP THE SITE THROUGHOUT THE WORK AREA IN A CLEAN AND ORDERLY CONDITION AT ALL TIMES TO THE SATISFACTION OF THE OWNER.
- 5. THE LATEST EDITION OF ALL CODES AND STANDARDS SHALL BE USED.
- 6. ALL STRUCTURAL DRAWINGS ARE TO BE READ IN CONJUNCTION WITH OTHER CONSULTANTS DRAWINGS.
- 7. SEE SOILS REPORT PREPARED BY: CAMBIUM INC. REFERENCE No. 13732-001 DATED SEPTEMBER 1,2021 FOR INFORMATION ON REUSE/DISPOSAL REQUIREMENTS OF EXCESS

DEMOLITION NOTES

- 1. PROVIDE PROTECTION AS REQUIRED TO PREVENT DAMAGE TO THE EXISTING STRUCTURE AND/OR ADJACENT EQUIPMENT. PROTECT ALL EXISTING FINISHES, GLAZING, FRAMES AND PROPERTY. PROVIDE NECESSARY SHORING DESIGN BY A PROFESSIONAL ENGINEER REGISTERED IN ONTARIO FOR THE SAFE COMPLETION OF THE WORK.
- 2. REMOVE AND DISPOSE OF EXISTING DEMOLISHED MATERIALS OFF-SITE. AS REQUIRED TO COMPLETE THE WORK. HAZARDOUS MATERIALS MUST BE IDENTIFIED AND
- 3. KEEP THE WORK AND STAGING AREAS CLEAN AND ORDERLY AT ALL TIMES AND FREE FROM RUBBLE AND DEBRIS.
- 4. NOTIFY CONSULTANT OF ANY LOAD BEARING MEMBERS OR ASSEMBLIES DISCOVERED OR IDENTIFIED DURING WORK AND NOT INDICATED ON THE DRAWINGS. DO NOT PROCEED WITH REMOVAL WITHOUT PRIOR REVIEW BY CONSULTANT.
- 5. ALLOW FOR REMOVAL OF ALL ABANDONED MECHANICAL AND ELECTRICAL.
- 6. ALL BUILDING MATERIALS TO BE REMOVED FROM THE BUILDING SHALL BECOME THE PROPERTY OF THE CONTRACTOR UNLESS SPECIFIED OTHERWISE AND SHALL BE REMOVED FROM THE SITE INCLUDING THE EXISTING CONSTRUCTION FENCING ONCE WORK HAS BEEN COMPLETED.
- 7. ALL BUILDING SERVICES MUST BE DEACTIVATED AND DISCONNECTED PRIOR TO DEMOLITION START
- 8. CONTRACTOR SHALL EMPLOY A METHOD TO MAINTAIN DUST CONTROL WITHIN THE DEMOLITION AREA..
- 9. CARRY OUT SAFETY MEASURES AS PER THE CONSTRUCTION SAFETY ASSOCIATION OF ONTARIO ACT AND REGULATIONS FOR DEMOLITION.
- 10. THE ONTARIO OCCUPATIONAL HEALTH AND SAFETY MANUAL APPLIES TO THIS PROJECT. THE CONTRACTOR IS RESPONSIBLE TO PERFORM ALL WORK IN ACCORDANCE WITH O.H.S.A.
- 11. REPORT ANY DOUBTFUL, UNFORESEEN AND/OR UNEXPECTED SITE CONDITIONS TO THE ENGINEER PRIOR TO PROCEEDING.
- 12. CONTRACTOR TO BE FULLY AWARE OF HAZARDOUS MATERIALS PRIOR TO STARTING CONSTRUCTION. HAZARDOUS MATERIAL MAY POSE A RISK TO HUMAN HEALTH AND THE ENVIRONMENT DURING CONSTRUCTION. REFER TO DESIGNATED SUBSTANCE SURVEY ASSESSMENT FOR ADDITIONAL INFORMATION.

TEMPORARY WORKS

- 1. THE CONTRACTOR SHALL DESIGN, PROVIDE, ERECT, MAINTAIN REMOVE AND ASSUME FULL AND SOLE RESPONSIBILITY FOR ALL TEMPORARY WORKS REQUIRED FOR THE SAFE AND COMPLETE EXECUTION OF THE WORKS.
- 2. IN THE EXECUTION OF THE TEMPORARY WORKS AND FOR THE DURATION OF THE CONTRACT, THE CONTRACTOR SHALL MAKE ADEQUATE PROVISION FOR ALL LIKELY CONSTRUCTION LOADING AND PROVIDE SUFFICIENT BRACING AND PROPS TO KEEP THE WORKS IN PLUMB AND ALIGNMENT AND FREE FROM EXCESSIVE DEFLECTION.
- ACCESS OF HEAVY CONSTRUCTION EQUIPMENT AND ACCUMULATION OF CONSTRUCTION MATERIALS ON THE FLOORS ARE NOT PERMITTED, UNLESS SUCH HAVE BEEN CATERED FOR IN THE CONTRACTOR'S TEMPORARY WORK DESIGN TO THE SATISFACTION OF THE
- 4. SUBMIT SHOP DRAWINGS FOR ALL TEMPORARY WORKS FOR REVIEW BEFORE FABRICATION COMMENCES. SHOP DRAWINGS SHALL BE SEALED BY A PROFESSIONAL ENGINEER REGISTERED IN THE PROVINCE OF ONTARIO.

MASONRY

INCLUDING:

- 1. MASONRY WORK IN ACCORDANCE WITH CAN/CSA A370 AND CAN/CSA A371 EXCEPT WHERE SPECIFIED OTHERWISE.
- 2. ONLY TYPE 'S' MORTAR SHALL BE USED, MINIMUM STRENGTH SHALL BE 12.4 MPa AT
- GROUT (PEA GRAVEL) AT BOND BEAMS AND GROUTED HOLLOW BLOCKS TO BE A MINIMUM OF 20MPa COMPRESSIVE STRENGTH AT 28 DAYS. IN ACCORDANCE WITH
- 4. MORTAR FOR EXPOSED EXTERIOR MASONRY SHALL BE AIR ENTRAINED.
- A. CONCRETE BLOCK TO CSA-A165.1, TYPE H15/A, SEE ARCH. DWGS. FOR FIREWALL REQUIREMENTS UNLESS NOTED OTHERWISE. (BASED ON NET AREA) — H 15/C FOR FIREWALL.

5. MASONRY WORK SHALL CONFORM TO CAN3-S304 AND ITS REFERENCED DOCUMENTS,

- MORTAR TO CSA-A179M, TYPE 'S' FOR ALL WALLS.
- GROUT TO CSA-A179-M. MASONRY WIRE REINFORCING TO CSA-G30.14.
- REINFORCING BARS TO CSA-G30.18-M-400 MPa. WELDED REINFORCING BARS TO CSA-G30.18-400 MPa.
- CONNECTION TO CAN/CSA A370. H. PRACTICE TO CAN/CSA A371.
- SUBMIT EVIDENCE OF MORTAR AND GROUT STRENGTH. FIELD CONTROL AND TESTING SHALL COMPLY WITH REQUIREMENTS OF CLAUSE 5 OF CAN3-304.
- 9. PROVIDE TEMPORARY BRACING OF MASONRY WORK UNTIL PERMANENT LATERAL SUPPORT IS IN PLACE.
- 10. MINIMUM STANDARD LAP LENGTH: WIRE REINF. 200mm(8")
 - 10M BARS 400mm(16") 15M BARS - 600mm(24") 20M BARS - 800mm(32")
- 11. NO MASONRY WORK SHALL BE PERMITTED WITH TEMPERATURE BELOW 5° CELSIUS, UNLESS PROVISIONS ARE MADE FOR HEATING THE MATERIALS AND PROTECTING THE

BRICK REMEDIATION

- 1. FIELD VERIFY ALL DIMENSIONS. REPORT ALL DISCREPANCIES TO CONSULTANT PRIOR TO COMMENCING WORK.
- 2. ALL MATERIAL REMOVED FROM BUILDING TO BE DISPOSED OF OFF SITE.
- 3. ENSURE AREAS BELOW WORK ARE PROTECTED FROM FALLING DEBRIS AT ALL TIMES
- UNTIL PROJECT CLOSEOUT. 4. CONTRACTOR TO PROTECT THE EXISTING BUILDING FROM WEATHER, PEST AND
- ELEMENTS DURING CONSTRUCTION.
- 5. COMPLETE PAINT REMOVALS AS PER MOL GUIDELINES. REFER TO DESIGNATED SUBSTANCE SURVEY ASSESSMENT FOR ADDITIONAL INFORMATION.
- 6. PREPARE AND SUBMIT MOCK-UPS FOR CONSULTANT REVIEW AND ACCEPTANCE, THE GENERAL CONSTRUCTION AND APPEARANCE OF THE INSTALLED MASONRY WALLS INCLUDING MORTAR COLOURS. MOCK-UP PANEL SHALL INCORPORATE EACH TYPE OF MASONRY UNIT. USE OF REINFORCEMENT, CONNECTORS, THROUGH WALL FLASHINGS, AIR BARRIERS, WEEP HOLES, JOINTING, COURSING, MORTAR AND WORKMANSHIP.

BRICK MASONRY

- PERFORM MASONRY WORK IN ACCORDANCE WITH CAN/CSA A370 AND CAN/CSA A371 EXCEPT WHERE SPECIFIED OTHERWISE.
- 2. ONLY TYPE 'S' MORTAR SHALL BE USED, MINIMUM STRENGTH SHALL BE AIR ENTRAINED 12.4 MPa AT 28 DAYS.
- MASONRY WORK SHALL CONFORM TO CAN3-S304 AND ITS REFERENCED DOCUMENTS.
- 4. NO MASONRY WORK SHALL BE PERMITTED WHEN THE TEMPERATURE FALLS BELOW 5° CELSIUS UNLESS PROVISIONS ARE MADE FOR HEATING THE MATERIALS AND
- 5 FIRST COURSE OF BRICK SHALL BE LAID IN A FULL BED OF MORTAR ALL OTHER COURSES SHALL BE LAID WITH MORTAR AT FACE SHELL BED AND HEAD JOINTS.
- 6. NEW BRICK TO MATCH EXISTING IN SIZE, TEXTURE & COLOUR. CONTRACTOR TO PROVIDE SAMPLE OF REPLACEMENT BRICK PRIOR TO PROCEEDING.

CONCRETE

1. CONCRETE CONSTRUCTION SHALL CONFORM TO THE LATEST EDITION OF CAN/CSA-A23.1 AND CAN/CSA-A23.3 WITH THE FOLLOWING PROVISION:

LOCATION	DESIGN STRENGTH (28 DAYS)	SLUMP	EXPOSURE CLASS
ALL EXTERIOR REINFORCED CONCRETE (STAIRS & RETAINING WALLS)	35 MPa U.N.O.	80± 30	C-1
EXTERIOR UN—REINFORCED CONCRETE (CURBS & CONCRETE WALKWAYS)	32 MPa U.N.O.	80± 30	C-2

- 2. NO ADDITIONAL WATER SHALL BE ADDED AT THE JOB SITE. CONCRETE WHICH HAS BEEN WATERED OR DOES NOT MEET SPECIFICATIONS SHALL BE REJECTED.
- 3. DURING WINTER WEATHER BELOW 5 °C PROVIDE TEMPORARY HEATING OF CONCRETE IN ACCORDANCE WITH THE REQUIREMENTS OF CSA A23.1, LATEST EDITION.

CONCRETE REINFORCEMENT

1. THE CLEAR DISTANCE BETWEEN REINFORCING STEEL AND SURFACE OF CONCRETE SHALL BE AS FOLLOWS UNLESS NOTED OTHERWISE.

LOCATION	CLEAR COVER
FOOTINGS	75mm(3") UNDERSIDE 50mm(2") TOP AND ENDS
SURFACE IN CONTACT WITH GROUND	75mm(3")

- 2. STRUCTURAL GROUT SHALL BE NON-SHRINK, NON METALLIC M-BED STANDARD PREMIX BY SIKA OR APPROVED EQUAL
- 3. DETAIL REINFORCING STEEL IN ACCORDANCE WITH "REINFORCING STEEL MANUAL OF STANDARD PRACTICE" LATEST EDITION.
- 4. REINFORCING BAR SPLICES FOR DEFORMED BARS: COLUMNS - COMPRESSION LAP UNLESS NOTED WALLS - CLASS 'B' TENSION SPLICE UNLESS NOTED ALL OTHERS - CLASS 'B' TENSION LAP UNLESS NOTED
- 5. ALL REINFORCING STEEL SHALL BE DEFORMED HARD GRADE BILLET STEEL CONFORMING TO CSA G30.18 GRADE 400.
- 6. WELDED STEEL WIRE FABRIC, PLAIN TYPE CONFORMING TO ASTM A1064/A1064M-17 IN FLAT SHEETS NOT ROLLED. 7. ALL CONCRETE REINFORCEMENT MUST BE PROPERLY CHAIRED WITH APPROVED BAR
- 8. PROVIDE CHAIRS, SPACER BARS, SUPPORT BARS AND OTHER ACCESSORIES TO SUPPORT REINFORCING IN ACCORDANCE WITH THE LATEST EDITIONS OF CSA A23.1 CSA A23.3 CHAIRS TO BE PLASTIC, PLASTIC TIPPED OR CONCRETE. ALL TIE WIRE, CHAIRS AND BAR SUPPORTS USED FOR COATED REINFORCING SHALL BE NON-METALLIC OR PROTECTED WITH ACCEPTABLE COATING.
- 9. CHAIRS SHALL BE SPACED AT 1200mm(4'-0")0.C. MAXIMUM.

EXCAVATION, BACKFILLING AND GRADING

CODES, REGULATIONS

- 1. CONFORM TO THE REQUIREMENTS OF THE ONTARIO BUILDING CODE, THE ONTARIO PROVINCIAL STANDARD SPECIFICATIONS (OPSS) AND THE WORKPLACE HEALTH AND SAFETY ACT.
- 2. PROVIDE MINIMUM 8" TOPSOIL BELOW ANY DISTURBED GREEN SCAPE AREAS TO BE RESTORED PRIOR TO SODDING.

<u>EXAMINATION</u>

1. BEFORE TENDERING THE WORK, THE CONTRACTOR SHALL EXAMINE THE SITE AND ASCERTAIN THE EXTENT AND NATURE OF THE MATERIAL IT MAY BE NECESSARY TO REMOVE TO PROVIDE FOR THE DEPTHS, LEVELS, AND GRADES REQUIRED, TO ASSURE HIMSELF THAT HIS DETERMINATIONS ARE MADE IN CONFORMITY WITH THE DRAWINGS AND SPECIFICATIONS

SETTING OUT WORK

- 1. THE DRAWINGS INDICATE THE SITE COMPONENTS LOCATION, AND PROPOSED AND FINAL GRADES. BE RESPONSIBLE TO CONSTRUCT THE WORK ACCORDING TO LEVELS AND LOCATIONS SHOWN ON THE DRAWINGS, REPORT ANY FRRORS OR DISCREPANCIES TO THE CONSULTANT BEFORE COMMENCING WITH THE WORK. COMMENCEMENT OF ANY PART OF THE WORK SHALL CONSTITUTE ACCEPTANCE OF DRAWINGS AS BEING CORRECT.
- 2. EMPLOY A COMPETENT INSTRUMENT MAN AND PROVIDE ALL LINES AND LEVELS, LIMIT LINES AND BOUNDARY STAKES FOR THE EXECUTION OF THE WORK AS REQUIRED. ALL BENCH MARKS SHALL BE CAREFULLY PROTECTED.
- 3. PROVIDE ALL SUBCONTRACTORS WITH, AND BE RESPONSIBLE FOR, ALL LINES, LEVELS AND DIMENSIONS WHICH SUCH TRADES REQUIRE TO RELATE THEIR WORK TO THE WORK OF THE CONTRACTOR OR OTHER TRADES. ALL TRADES SHALL BE NOTIFIED THAT ALL SUCH LEVELS AND DIMENSIONS MUST BE OBTAINED FROM THE CONTRACTOR.

- A. PROTECTION OF EXISTING SERVICES
- 1. BEFORE STARTING THE WORK, VERIFY THE LOCATION OF ALL KNOWN UNDERGROUND SERVICES AND UTILITIES OCCURRING IN THE WORK SITE AREA.
- 2. NOTIFY THE OWNER, PUBLIC UTILITY OR MUNICIPAL AUTHORITIES IN ADVANCE OF PLANNED EXCAVATIONS ADJACENT TO THEIR SERVICES.
- 3. TAKE CARE NOT TO DAMAGE OR DISPLACE ENCOUNTERED KNOWN AND UNKNOWN
- 4. WHEN SUCH SERVICES ARE ENCOUNTERED DURING THE EXECUTION OF WORK, IMMEDIATELY NOTIFY THE CONSULTANT AND PROTECT, BRACE AND SUPPORT ACTIVE SERVICES. WHERE REPAIRS TO THESE SERVICES BECOME NECESSARY USE THE FOLLOWING PROCEDURE:
 - a. KNOWN SERVICES, REPAIR AT NO EXPENSE TO THE OWNER. b. UNKNOWN SERVICES, FORWARD TO THE CONSULTANT A COMPLETE BREAKDOWN OF THE ESTIMATED COST OF SUCH WORK. PROCEED ONLY UPON WRITTEN AUTHORIZATION.
- 5. IN THE CASE OF DAMAGE TO, OR CUTTING OFF OF AN ESSENTIAL SERVICE, NOTIFY CONSULTANT, THE OWNER, AND PUBLIC UTILITY OR MUNICIPAL AUTHORITIES IMMEDIATELY AND REPAIR THE SERVICE UNDER THE CONSULTANT'S DIRECTION.
- ASSUME REUSE EXISTING COMPACT SOIL AND INFILL BALANCE OF GRANULAR MATERIAL/TOPSOIL AS REQUIRED TO ACCOMPLISH WORK ON PROJECT. ALL FILL SHALL BE STORED ON SITE IN A LOCATION APPROVED BY THE


OWNER/CONSULTANT AND SHALL BE PROTECTED AS REQUIRED FOR RE-USE.

EXCAVATION WORK


- REMOVE ALL CONCRETE, MASONRY, RUBBLE OR OTHER CONSTRUCTION DEBRIS ENCOUNTERED DURING THE WORK. REFER TO SOILS REPORT FOR DISPOSAL
- 2. KEEP EXCAVATION FREE OF WATER BY BAILING, PUMPING OR A SYSTEM OF DRAINAGE AS REQUIRED AND PROVIDE PUMPS. SUCTION AND DISCHARGE LINES OR WELL POINTS OF SUFFICIENT CAPACITY AND MAINTAIN UNTIL SUCH TIME AS THE PERMANENT DRAINAGE SYSTEM IS INSTALLED OR UNTIL THE CONSULTANT'S APPROVAL OF REMOVAL OF EQUIPMENT IS OBTAINED. TAKE ALL NECESSARY MEASURES TO PREVENT FLOW OF WATER INTO THE EXCAVATION.
- 3. PROTECT THE BOTTOM AND SIDES OF EXCAVATED PITS AND TRENCHES FROM FREEZING. PROTECT ALSO FROM EXPOSURE TO THE SUN AND WET WEATHER TO PREVENT CAVE-INS AND SOFTENING OF THE BED UPON WHICH CONCRETE OR DRAINS REST
- 4. EXCAVATIONS MUST NOT INTERFERE WITH THE NORMAL 45 DEGREE PLANE OF BEARING FROM THE BOTTOM OF ANY FOOTING.
- 5. KEEP BOTTOMS OF EXCAVATIONS CLEAN AND CLEAR OF LOOSE MATERIALS LEVELLED AND STEPPED AT CHANGES OF LEVELS WITH EXCEPTION OF EXCAVATIONS MADE FOR DRAINAGE PURPOSES AND THOSE SLOPE AS REQUIRED.
- 6. IF THE EXCAVATIONS REVEAL SEEPAGE ZONES, SPRINGS OR OTHER UNEXPECTED SUB-SURFACE CONDITIONS WHICH MAY NECESSITATE REVISIONS OR ADDITIONS TO ANY DRAINAGE SYSTEM, INFORM THE CONSULTANT IMMEDIATELY SO THAT REMEDIAL CAN BE

BACK FILLING

- 1. PROCEED PROMPTLY WITH BACKFILLING AS THE BUILDING REPAIRS PROGRESSES. AND AS WORK TO BE BACKFILLED HAS BEEN INSPECTED AND APPROVED BY THE GEOTECHNICAL CONSULTANT. THE BACKFILL SHOULD BE PLACED IN LIFTS NOT GREATER THAN 200mm THICK IN THE LOOSE STATE, EACH LIFT BEING COMPACTED WITH A SUITABLE COMPACTOR TO THE SPECIFIED DENSITY.
- 2. DO NOT COMMENCE BACKFILLING OPERATIONS UNTIL SITE DRAINAGE SYSTEMS AND WATERPROOFING HAS BEEN INSPECTED AND APPROVED BY CONSULTANT.
- 3. WITHDRAW SHORING MATERIAL DURING BACKFILL, LUMBER LEFT IN PLACE WITHOUT THE CONSULTANT'S APPROVAL WILL NOT BE PAID FOR BY THE OWNER.
- 4. WHERE FILL IN PLACED ADJACENT TO STRUCTURES OR VULNERABLE BUILDING COMPONENTS OR IN RESTRICTED AREAS, THE FILL SHALL BE COMPACTED TO THE SAME DEGREE AS SPECIFIED BY SUITABLE EQUIPMENT APPROVED BY THE CONSULTANT. AVOID DAMAGE TO OR DISPLACEMENT OF EXISTING/NEW STRUCTURES.
- 5. ADD WATER IN AMOUNTS REQUIRED ONLY TO ACHIEVE THE OPTIMUM MOISTURE CONTENT, IN ACCORDANCE WITH ASTM D1557.
- 6. BACKFILL SHALL BE FREE OF SNOW AND ICE, TOPSOIL, CONSTRUCTION DEBRIS AND OVERSIZED BOULDERS GREATER THAN 150mm.

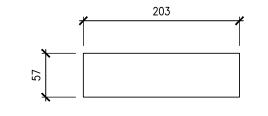

\S101

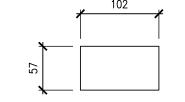




DO NOT SCALE THE DRAWINGS CHECK AND VERIFY ALL DIMENSIONS AT THE SITE. ALL DRAWINGS. SPECIFICATIONS AND RELATED DOCUMENTS ARE THE COPYRIGHT PROPERTY OF THE CONSULTANT AND MUST BE RETURNED UPON REQUEST. REPRODUCTION OF DRAWINGS IN PART OR WHOLE WITHOUT THE PERMISSION OF THE CONSULTANT IS FORBIDDEN. DRAWINGS ARE NOT TO BE USED FOR CONSTRUCTION UNTIL SIGNED



NO.	ISSUES	DATE	BY
1	ISSUED FOR PERMIT AND TENDER	MAR. 20, 2025	BBA

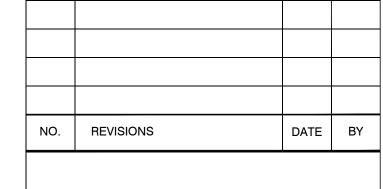


PROJECT:

RENOVATIONS AT ECOLE ELEMENTAIRE JEANNE-LAJOIE

150 CARNFORTH ROAD NORTH YORK, ONTARIO Conseil scolaire Viamonde

DRAWING:

GENERAL NOTES

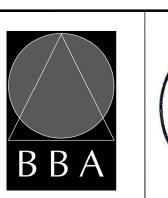

ASSOCIATES

Architects Engineers

Suite 201

L1N 0G5




% COMPLETE: DRAWN BY: Project Managers CHECKED BY: 250 Water Street Whitby, Ontario MARCH 20, 2025 SCALE: Tel: (905) 666-5252 AS NOTED Fax: (905) 666-5256 e-mail: bba@bba-archeng.com

PROJECT NO: DRAWING NO: 24195


RENOVATIONS AT ECOLE ELEMENTAIRE JEANNE-LAJOIE

150 CARNFORTH ROAD NORTH YORK, ON

MECHANICAL DRAWINGS

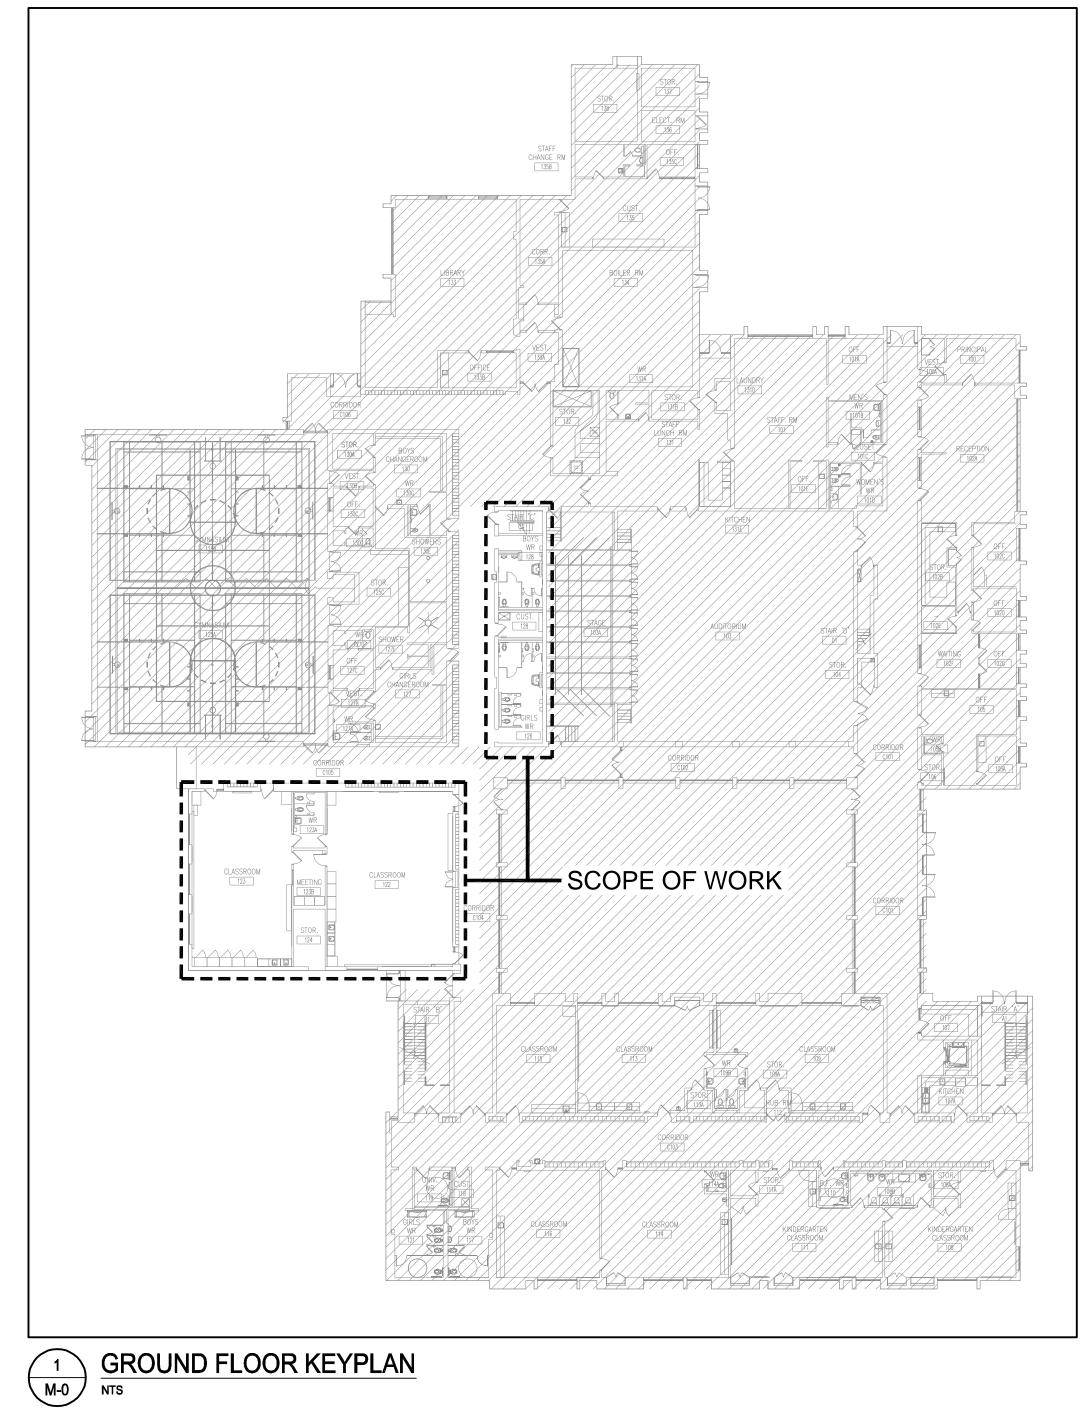

DWG. NO.	DRAWING NAME
M-0	TITLE SHEET
M-1.1	MECHANICAL SPECIFICATIONS I
M-1.2	MECHANICAL SPECIFICATIONS II AND LEGEND
M-1.3	MECHANICAL SCHEDULES AND DETAILS
M-2.1	PART 1ST & 2ND FLOOR DEMOLITION PLAN - HVAC
M-2.2	PART 1ST FLOOR DEMOLITION PLAN - HVAC
M-2.3	PART 1ST & 2ND FLOOR NEW PLAN - HVAC
M-2.4	PART 1ST FLOOR NEW PLAN - HVAC
M-3.1	PART 1ST FLOOR DEMOLITION PLAN - PLUMBING & DRAINAGE
M-3.2	PART 1ST FLOOR DEMOLITION PLAN - PLUMBING & DRAINAGE
M-3.3	PART 1ST FLOOR NEW PLAN - PLUMBING & DRAINAGE
M-3.4	PART 1ST FLOOR NEW PLAN - PLUMBING & DRAINAGE

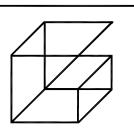

Engineering Inc. info@giallonardoeng.com

This drawing is the property of GIALLONARDO ENGINEERING INC.

This drawing shall be read in conjunction with the architectural, structural, electrical and all other consultant's drawings prior to proceeding with the work. Do not scale the drawings

The contractor is to verify and accept responsibility for all GIALLONARDO ENGINEERING INC. of any variations from the



NO.	ISSUES	DATE
1	ISSUED FOR REVIEW	MAR. 10 2025
2	ISSUED FOR TENDER	MAR. 19 2025
NO.	REVISIONS	DATE

PROJECT:

RENOVATIONS AT ECOLE ELEMENTAIRE JEANNE-LAJOIE

150 CARNFORTH ROAD NORTH YORK, ONTARIO Conseil scolaire Viamond

DRAWING:

TITLE SHEET





DESIGN BY: **SW**

BARRY BRYAN ASSOCIATES

CHECKED BY: 250 Water Street Suite 201 Whitby, Ontario L1N 0G5

JAN 2025 AS SHOWN

Fax: (905) 666-5256


M-0



25-102

GENERAL SPECIFICATIONS GENERAL SPECIFICATIONS **HVAC SPECIFICATIONS** GENERAL SPECIFICATIONS HVAC SPECIFICATIONS PROVIDE ALL LABOUR AND MATERIALS TO SUPPLY AND INSTALL THE DUCTWORK AND OF FIVE (5) YEARS EXPERIENCE AND BE NEBB CERTIFIED. ALL BALANCING, 3.4. THIS CONTRACTOR SHALL BE RESPONSIBLE FOR ALL CUTTING. PATCHING AND <u>GENERAL</u> BE THE MECHANICAL CONTRACTOR'S RESPONSIBILITY TO PROVIDE STRUCTURAL SHEET METAL SYSTEMS AS INDICATED ON MECHANICAL DRAWINGS. THIS INCLUDES TESTING ADJUSTING AND REPORTING SHALL BE CARRIED OUT IN ACCORDANCE RESTORATION. WHERE REQUESTED, THE CONTRACTOR SHALL CONTRACT THE REINFORCING FOR ALL DIV.23 INSTALLATIONS. THE CONTRACTOR SHALL OBTAIN INSTALLING THE DUCTWORK. ACCESSORIES. ASSOCIATED ITEMS AND ALL NECESSARY WITH NEBB, PROCEDURAL STANDARDS FOR TESTING, ADJUSTING AND BALANCING 1.1. ALL WORK PERFORMED SHALL BE IN ACCORDANCE WITH LATEST EDITION OF THE SERVICES OF THE BASE BUILDING TRADES AT DIV.23 EXPENSE. THE SERVICES OF A LICENSED PROFESSIONAL ENGINEER WHO IS TO PROVIDE A CONNECTIONS TO OUTLETS, INLETS AND EQUIPMENT TO PROVIDE A COMPLETE OF ENVIRONMENTAL SYSTEMS, WHERE APPLICABLE, THE MECHANICAL CONTRACTOR ONTARIO BUILDING CODE, CSA, ASHRAE, NFPA, ETC. WHERE CODES/STANDARD DESIGN BEARING THEIR PROFESSIONAL SEAL. THE CONTRACTOR SHALL APPLY FOR SHALL CONTRACT THE SERVICES OF THE BASE BUILDING APPROVED TAB 3.5. PROVISIONS SHALL BE MADE FOR THE PROTECTION OF DIV.23 WORK UNTIL THE ARE PRESENT FORM MULTIPLE SOURCES, THE MOST STRINGENT SHALL BE BUILDING PERMIT AND ASSUME ALL RESPONSIBILITY AND COST FOR THE PERMIT COMPLETION OF THE PROJECT. THIS MAY INCLUDE, BUT NOT LIMITED TO. CONTRACTOR. PROCESS. UPON COMPLETION OF WORK, CONTRACTOR SHALL SUBMIT A LETTER UNLESS OTHERWISE NOTED, FABRICATE ALL DUCTWORK SYSTEMS, INCLUDING COVERING OF EQUIPMENT OPENINGS AND DUCTWORK, PLUMBING FIXTURES, FLOOR FROM THE STRUCTURAL ENGINEER COMPLETE WITH PROFESSIONAL SEAL TO DUCTWORK, HOUSINGS, DAMPERS AND ACCESS DOORS, WITH GALVANIZED STEEL 13.2. PERFORM TESTING AND BALANCING PROCEDURES ON EACH SYSTEM ACCORDING 1.2. THE FOLLOWING SPECIFICATIONS FORM AN ESSENTIAL PART OF THE CONTRACT DRAINS, ETC. INDICATE THAT THE WORK HAS BEEN COMPLETED TO THE ONTARIO BUILDING SHEET METAL MEETING ASTM A653 AND A924. CONSTRUCTION OF THE DUCTWORK TO THE CURRENT EDITION OF THE NEBB STANDARDS. MARK EQUIPMENT AND DOCUMENTS, REFER AND COORDINATE WITH ALL OTHER DIVISIONS, SECTIONS AND CODE, ALL OTHER RELEVANT CODES AND STANDARDS AND TO THE AUTHORITIES SYSTEMS SHALL BE IN STRICT ACCORDANCE WITH SMACNA, SMACNA DUCT BAI ANCING DEVICE SETTING WITH PAINT OR OTHER SUITABLE PERMANENT 3.6. UPON COMPLETION OF CONSTRUCTION, CONTRACTOR SHALL MAKE ALL FINAL SPECIFICATIONS TO PROVIDE A COMPLETE AND OPERATIONAL INSTALLATION. HAVING JURISDICTION. CLEANLINESS AND ASHRAF ALL DUCTWORK SHALL BE SMOOTH ON THE INSIDE AND IDENTIFICATION MATERIAL TO SHOW FINAL SETTINGS. ADJUSTMENTS TO EQUIPMENT AS WELL AS REMOVE ALL PROTECTION. ALL SHALL BE FREE FROM RATTLING OR VIBRATION. DUCTWORK NOT MEETING THESE INSTALLATIONS SHALL BE CLEANED THOROUGHLY AND TESTED FOR PROPER 10.2. IT IS THE RESPONSIBILITY OF THE MECHANICAL CONTRACTOR TO COORDINATE THE 1.3. FOR THE PURPOSE OF THESE SPECIFICATIONS, DRAWINGS AND CONTRACT STANDARDS WILL BE REPLACED AT NO EXTRA CHARGE TO THE OWNER. 13.3. BALANCE AIRFLOW AND HYDRONIC FLOW QUANTITIES WITHIN +/- 10% OF THE DOCUMENTS. THE WORD 'PROVIDE' REFERS TO THE SUPPLY, INSTALLATION AND OPERATION. CHANGE ALL AIR AND WATER FILTERS AS REQUIRED. REQUIREMENTS FOR SEISMIC BRACING AND SUPPORTS WITH STRUCTURAL DESIGN CRITERIA. IN THE EVENT THAT A CONDITION OR DEFICIENCY IS DRAWINGS. DIV.23 SHALL CONTRACT THE SERVICES OF A LICENSED PROFESSIONAL TESTING OF THE RESPECTIVE EQUIPMENT/COMPONENTS. CONSTRUCT DUCTWORK AND SEAL ACCORDING TO THE APPROPRIATE SMACNA PREVENTING THE ACCEPTANCE RANGE FROM BEING ACHIEVED, IT SHALL BE 3.7. IN REGARDS TO INTERRUPTION OF SERVICES, THE CONTRACTOR SHALL CARRY FNGINFER TO DESIGN SUPPORTS AND BRACING IN ACCORDANCE WITH ALL STANDARDS. LOW PRESSUE DUCTWORK SHALL BE CONSTRUCTED WITH THE ONE (1) NOTED WITH DESCRIPTION ON THE TAB REPORT. UPON COMPLETION, SUBMIT A OUT THEIR WORK IN A MANNER THAT CAUSES THE LEAST DISTURBANCE TO THE 1.4. CONTRACTOR IS TO REPORT ALL APPARENT DISCREPANCIES BETWEEN DRAWINGS CURRENT CODES AND THAT MATCHES THE REQUIREMENT OF THE LOCATION IN OWNER. PROVIDE NOTIFICATION TO THE OWNER IN WRITING WITH AT LEAST 72 INCH PRESSURE CLASSIFICATION AND ALL OTHER DUCTWORK SHALL BE CONSTRUCTED FINAL TAB REPORT TO THE CONSULTANT FOR REVIEW. WHICH THE SYSTEMS ARE BEING INSTALLED. UPON COMPLETION OF THE PROJECT, AND SPECIFICATIONS OF ALL DIVISIONS PRIOR TO TENDER SUBMISSION. NO IN ACCORDANCE WITH THE THREE (3) INCH CLASSIFICATION. DUCT PRESSURES SHALL HOURS OF THE SCHEDULED INTERRUPTION. SEISMIC ENGINEER SHALL PROVIDE A LETTER BEARING THEIR PROFESSIONAL SEAL EXCEPTIONS WILL BE GIVEN TO CONTRACTORS WHO DO NOT COMPLETELY 4. CONTROLS BE CLASSIFIED AS FOLLOWS: INDICATING THAT THE INSTALLATION MEETS THE SEISMIC DESIGN DOCUMENT AND UNDERSTAND THE SCOPE OF WORK. 3.8. ARRANGE AND PAY FOR THE SAFE DISPOSAL OF REMOVED ITEMS AS SPECIFIED. CONFORMS TO THE BUILDING CODE AND THE AUTHORITIES HAVING JURISDICTION. 14.1. PROVIDE ALL CONTROLS, WIRING, CONDUIT, ACCESSORIES, ETC. AND INTERLOCK 3.1. LOW: DUCT PRESSURES (LOW) OF 1/2" TO 2" W.C. AND NOT EXCEEDING AN PROVIDE PROOF OF SAFE DISPOSAL FOR ITEMS SUCH AS HVAC REFRIGERANT 1.5. ALL DIV.23 WORK SHALL BE COORDINATED AND SCHEDULED WITH ALL OTHER COORDINATE THE TIME AND METHOD OF DISPOSAL WITH THE OWNER. FOR WITH EQUIPMENT/STARTERS AS INDICATED ON DRAWINGS. AIR VELOCITY OF 2000 FPM. EXAMPLE, CLEARLY INDICATE THE ROUTE THAT WILL BE TAKEN FROM THE INSIDE OF THE BUILDING TO THE OUTDOORS, AS WELL AS THE STORAGE LOCATION 11.1. ALL ELECTRICAL MOTORS, STARTERS, CONTACTORS, DISCONNECT SWITCHES AND 14.2. WHEN INSTALLED IN CEILING PLENUMS, CABLE MAY BE FREE-AIR, UNLESS 3.2. MEDIUM: DUCT PRESSURES EXCEEDING 2" W.C. OR AND AIR VELOCITY OF 2000 1.6. THIS CONTRACTOR SHALL VISIT THE SITE AND COMPLETELY INVESTIGATE AND OTHERWISE NOTED, PROVIDING THE WIRING IS FT-6 PLENUM RATED. CONTROL DEVICES FOR DIV.23 WORK SHALL BE PROVIDED BY DIV.23. UNDERSTAND THE EXISTING CONDITIONS AND THEIR RELATION TO THE DESIGN DRAWINGS/DOCUMENTS. NO CONSIDERATION WILL BE GIVEN TO THE CONTRACTOR 3.9. WHERE COMPONENTS ARE TO BE REUSED, THE CONTRACTOR SHALL CLEAN AND 14.3. WHEN INSTALLED IN OPEN AREAS, PROVIDE EMT CONDUIT, FITTINGS, MOUNTING 11.2. DIV.26 SHALL BE RESPONSIBLE FOR POWERING LOAD SIDE OF STARTERS AND 3.3. THREE INCH: ALL VARIABLE AIR VOLUME (VAV) SUPPLY AIR DUCT SYSTEMS AND FOR ANY HINDRANCES TO THE MECHANICAL INSTALLATION FROM SITE CONDITIONS CONTACTORS, POWER FOR ELECTRICAL HEAT TRACING AND CONTROLS, LINE SIDE TEST THE COMPONENT TO ENSURE PROPER OPERATION. THE CONSULTANT SHALL ACCESSORIES, ETC. TO DELIVER A NEAT AND CLEAN INSTALLATION. AIR DUCTWORK SYSTEMS EXPOSED TO THE OUTDOORS. WHICH EXISTED PRIOR TO TENDER SUBMISSION. AS SUCH AND WHERE REQUIRED, BE NOTIFIED IN THE EVENT THERE IS A DEFICIENCY WITH THE COMPONENT. POWER TO LOOSE STARTERS AND DISCONNECTS. THE CONTRACTOR SHALL PROVIDE INTERFERENCE DRAWINGS AND SHALL SUBMIT 14.4. MOUNTING HEIGHTS: FLEXIBLE DUCTWORK THEM TO THE CONSULTANT FOR REVIEW. 3.10. PERFORM WORK SO AS TO CAUSE MINIMAL DISTURBANCE TO OWNER AND/OR 11.3. ALL LOW VOLTAGE WIRING AND CONNECTION IS TO BE PROVIDED BY THE ADJACENT AREAS. MINIMIZE DUST AND NOISE AND PROVIDE TEMPORARY AIR MECHANICAL CONTRACTOR. 14.4.1. OCCUPANT ADJUSTABLE: MOUNT AT 3'-11" (1200 MM) A.F.F. 4.1. PROVIDE, WHERE INDICATED ON MECHANICAL DRAWINGS, FLEXIBLE DUCTWORK PROVIDE NEW MATERIALS AND EQUIPMENT OF ACCEPTABLE QUALITY THAT ARE FILTERS ON AIR HANDLING SYSTEMS AFFECT BY THE AREA OF WORK. ALL COSTS 14.4.2. NON-AJUSTABLE (SENSOR ONLY): MOUNT AT 5'-0" (1500 MM) A.F.F. EQUAL TO FLEXMASTER TRIPLE LOCK ALUMINUM DUCTWORK. THE PRESSURE MANUFACTURED IN CANADA OR THE UNITED STATES AND BEAR THE APPROVAL OF 11.4. WHERE THERE IS NO DIV.26 (ELECTRICIAN) AS PART OF THE PROJECT. THE ASSOCIATED WITH DAMAGES AS A RESULT OF THE MECHANICAL INSTALLATION RECOGNIZED NORTH AMERICAN STANDARD ASSOCIATIONS SUCH AS CSA, ASME, RATING OF THE DUCTWORK SHALL MATCH THE DUCTWORK SYSTEM TO WHICH IT SHALL BE COVERED BY DIV.23. MAINTAIN SAFETY STANDARDS AND PROVIDE MECHANICAL CONTRACTOR SHALL CONTRACT THE SERVICES OF A LICENSED IS ATTACHED. MATCH THE DUCTWORK SIZE TO THE CONNECTION OUTLET OF THE **CONFIRM MOUNTING HEIGHTS WITH CONSULTANT PRIOR TO INSTALLATION. ETC. THE CONTRACTOR SHALL MAXIMIZE THE UTILIZATION OF CANADIAN ADEQUATE SIGNAGE FOR BOTH WORKERS AND OCCUPANTS. ELECTRICAL CONTRACTOR AND OBTAIN THE APPROPRIATE INSPECTIONS AND EQUIPMENT, MATERIALS, ETC. APPROVALS FOR THE INSTALLATION OF ALL ELECTRICAL WORK REQUIRED FOR 14.5. COORDINATE INSTALLATION OF ALL CONTROL DEVICES/SENSORS WITH 3.11. WHERE CUTTING OR CORE DRILLING OF THE EXISTING CONCRETE STRUCTURE IS 4.2. SECURE FLEXIBLE DUCTWORK USING GEAR CLAMPS WITH AN ADJUSTING WORM MECHANICAL SYSTEMS. ARCHITECTURAL DRAWINGS. 1.8. ALL EQUIPMENT, MATERIALS, ETC. SHALL BE INSTALLED IN STRICT ACCORDANCE REQUIRED, THE MECHANICAL CONTRACTOR SHALL CONTRACT THE SERVICES OF AN DRIVE TYPE SCREW. SEAL AROUND CONNECTION WITH DUCT TAPE TO OBTAIN THE WITH THE MANUFACTURER'S INSTALLATION INSTRUCTIONS AND RECOMMENDATIONS EXPERIENCED AND REPUTABLE COMPANY TO CARRY OUT X-RAYING. THE RESULTS 12. PROJECT CLOSEOUT APPROPRIATE SMACNA SEAL CLASS. 14.6. INSTALL CONTROL DEVICES/SENSORS CLEAR OF DIMMERS SO AS TO AVOID SHALL BE SUBMITTED TO THE BASE BUILDING STRUCTURAL ENGINEER AND NOT 1.9. THE MECHANICAL DRAWINGS DISPLAY A GENERAL DESIGN AND INSTALLATION. INTERFERENCE. CUTTING OR CORING SHALL TAKE PLACE UNTIL WRITTEN APPROVAL IS RECEIVED. 12.1. PRIOR TO THE ISSUING OF A PROJECT COMPLETION NOTICE OR A SIGN-OFF 4.3. MAXIMUM LENGTH OF FLEXIBLE DUCTWORK PERMITTED IN LOW PRESSURE THEREFORE THE CONTRACTOR SHALL OBTAIN CLARIFICATION FROM THE THE CONTRACTOR SHALL PROVIDE A WRITTEN REQUEST TO PERFORM X-RAYING LETTER, THE FOLLOWING DOCUMENTS, AT A MINIMUM, MUST BE PROVIDED TO THE SYSTEMS IS 10'-0" AND 4'-0" IN ALL OTHER HIGHER PRESSURE SYSTEMS. 14.7. THE MECHANICAL CONTRACTOR SHALL TEST ALL CONTROLS/INTERLOCKS FOR CONSULTANT PRIOR TO INSTALLATION. WITH AT LEAST 72 HOURS IN ADVANCE. ENGINEER FOR REVIEW: GOOD OPERATION PRIOR TO PROJECT CLOSE-OUT. PROVIDE A REPORT FOR CONTRACTOR TO TAKE INTO ACCOUNT DUCT LINERS, ETC. WHEN PERFORMING DUCT DIMENSIONS SHOWN ON DRAWINGS ARE CLEAR INSIDE DIMENSIONS. REVIEW TO THE ENGINEER INDICATING DEFICIENCIES. 1.10. THESE DRAWINGS HAVE BEEN PREPARED FOR DIV.23 AND DO NOT ACCURATELY IDENTIFICATION OF MECHANICAL SERVICES - AIR BALANCING REPORT DISPLAY ALL ELECTRICAL, STRUCTURAL AND ARCHITECTURAL ELEMENTS. REFER TO NFPA-13 LETTER TAKE-OFFS. 14.8. WIRE ALL DEVICES TO THEIR RESPECTIVE MAGNETIC STARTERS AND PROVIDE OTHER DIVISION'S DRAWINGS FOR CLARIFICATION. 4.1. PROVIDE SMS WRAP-MARK ON ALL PIPE COVERINGS WITH FLOW ARROW AND - APPLICABLE SYSTEM/EQUIPMENT TESTING REPORT POWER TO DIV.23 CONTROL PANELS FROM NEAREST AND MOST SUITABLE ALTERNATING WORDING. COVERING COLOURS SHALL MATCH BASE BUILDING. IN MAKE ALL DUCT CONNECTIONS, CONCENTRIC AND ECCENTRIC TRANSITIONS, ETC., IN 1.11. IN NO CASE SHALL THESE DRAWINGS BE SCALED. ALL ROUGH-IN'S SHALL BE ELECTRICAL PANEL. THE CASE WHERE THERE IS NO EXISTING STANDARD, INDUSTRY STANDARDS SHALL ACCORDANCE WITH SMACNA. COORDINATED WITH OTHER DIVISIONS. BE FOLLOWED. 14.9. CONTRACT THE SERVICES OF THE BASE BUILDING APPROVED CONTROLS PROVIDE <u>DUCT ACCESS DOORS</u> AT LOCATIONS AS SHOWN ON DRAWINGS, AS WELL AS CONTRACTOR WHERE APPLICABLE. 1.12. DO NOT PROCEED WITH WORK OUTSIDE THE SCOPE OF THE DESIGN DRAWINGS 2. USE STENCILS AND STENCIL PAINT ON DUCTWORK AND DUCTWORK INSULATION AT THE LINKAGE SIDE OF AUTOMATIC DAMPERS, FIRE DAMPERS AND ANY OTHER AND SPECIFICATIONS WITHOUT WRITTEN CONSENT FROM THE OWNER. THIS APPLIES WITH BLACK CAPITALIZED LETTERS 2" (50 MM) HIGH AND SOLID BLACK FLOW SERVICE, BALANCE OR CONTROL DEVICE REQUIRING PERIODIC MAINTENANCE. THE TO ALL DIV.23 CHANGE NOTICES AS ISSUED BY THE CONSULTANT. DOORS SHALL BE CONSTRUCTED IN ACCORDANCE WITH SMACNA AND SHALL MATCH THE PRESSURE RATING OF THE DUCTWORK SYSTEM TO WHICH IT IS BEING 1.13. IN REGARDS TO DIV.23 CHANGE NOTICES, CONTRACTOR SHALL PROVIDE A 4.3. IDENTIFICATION OF PIPING AND DUCTWORK SHALL BE PROVIDED AT THE BREAKDOWN INCLUDING, BUT NOT LIMITED TO, MATERIALS, LABOUR, MARK-UP, FOLLOWING LOCATIONS ETC. QUOTATIONS SHALL BE BASED ON ALLPRISER FOR EQUIPMENT AND THE PROVIDE FLEXIBLE CONNECTIONS AT THE INLET AND OUTLET CONNECTION FOR EACH MECHANICAL CONTRACTORS OF AMERICA, SMACNA, AND NATIONAL ELECTRICAL - AT LEAST ONCE IN EACH ROOM FAN BETWEEN DUCTWORK AND INLET AND OUTLET COLLARS. FLEXIBLE CONNECTIONS CONTRACTORS FOR LABOUR RATES. AT EACH PIECE OF EQUIPMENT SHALL BE CONSTRUCTED OF NON-COMBUSTIBLE NEOPRENE COATED FIBERGLASS - AT EACH BRANCH CLOSE TO THE CONNECTION POINT AT MAIN FABRIC. FOR OUTDOOR CONNECTIONS, PROVIDE A CONNECTOR THAT IS SUITABLE FOR 1.14. WHERE EQUIPMENT HAS BEEN PRE-PURCHASED, DIV.23 SHALL ACCEPT ALL - AT NOT GREATER INTERVALS OF 50 FT. (15 M) ON STRAIGHT RUNS OF EXPOSURE TO SUNLIGHT AND THE ELEMENTS. RESPONSIBILITY FOR EQUIPMENT DELIVERY, INSTALLATION, TESTING AND WARRANTY, EXPOSED PIPING AND DUCTWORK SIMILAR TO AS IF THE EQUIPMENT WAS PURCHASED BY DIV.23. PROVIDE <u>FIRE DAMPERS</u> WHERE INDICATED ON MECHANICAL DRAWINGS. ALL DAMPERS - AT ENTRY AND LEAVING POINT TO PIPE AND DUCT CHASES, OR OTHER SHALL BE SELECTED TO SUIT THE RATING OF THE FLOOR OR WALL ASSEMBLY IN CONCEALED SPACES 1.15. THE CONTRACTOR SHALL WARRANTY ALL MATERIALS, EQUIPMENT, INSTALLATION - BOTH SIDES WHERE PIPING AND DUCTWORK PASSES THROUGH WALL, WHICH IT WILL BE INSTALLED. FIRE DAMPERS SHALL BE ULC LISTED AND INSTALLED AND QUALITY OF WORKMANSHIP FOR A MINIMUM OF ONE (1) YEAR UNLESS PARTITIONS AND FLOORS IN STRICT ACCORDANCE WITH THE MANUFACTURER'S INSTALLATION INSTRUCTIONS, OTHERWISE NOTED. - ON VERTICAL PIPES AND DUCTS APPROXIMATELY 6 FT. (1800 MM) A.F.F. NFPA 90A AND THE AUTHORITIES HAVING JURISDICTION. TYPE A FIRE DAMPERS ARE - BEHIND EACH ACCESS DOOR AND PANEL PERMITTED FOR NON-DUCTED TRANSFER DUCTWORK. TYPE B FIRE DAMPERS SHALL 1.16. IT IS THE MECHANICAL CONTRACTOR'S RESPONSIBILITY TO PAY FOR ALL CHARGES BE USED IN ALL OTHER CASES UNLESS OTHERWISE NOTED. AND DAMAGES ASSOCIATED WITH EQUIPMENT THAT IS NOT PROVIDED AS SPECIFIED 4.4. PROVIDE IDENTIFICATION FOR PIPING CONTAINING ELECTRICAL HEAT TRACING. AND INCLUDES NOT MEETING THE MANUFACTURER'S RATINGS, PUBLISHED DATA 9.1. REMOVABLE DUCT SECTIONS FOR FIRE AND SMOKE DAMPER ACCESS: WHERE A AND/OR THE APPLICABLE GOVERNING STANDARDS. 4.5. TAG ALL VALVES, EXCEPT SMALL VALVES ISOLATING EQUIPMENT, WITH BRASS TAGS MINIMUM 12"X12" ACCESS PANEL CAN NOT BE INSTALLED ON DUCTWORK, A AND HIGH DIE-STAMPED BLACK LETTERS ATTACHED TO VALVES WITH 4" BRASS REMOVABLE DUCTWORK SECTION FOR DAMPER INSPECTION AND MAINTENANCE 1.17. THE CONTRACTOR MAY SUBMIT FOR ALTERNATE MATERIALS AND EQUIPMENT ONLY SHALL BE PROVIDED. REMOVABLE DUCTWORK SECTION TO FUNCTION WITHOUT WHEN THE SPECIFIED ARE NOT AVAILABLE OR WILL ADVERSELY IMPACT THE THE USE OF TOOLS AND SHALL NOT BE MORE THAN 4" AWAY FROM THE FIRE COMPLETION SCHEDULE. THE CONTRACTOR SHALL COMPENSATE THE CONSULTANT 6. PROVIDE IDENTIFICATION FOR ALL NEW EQUIPMENT, STARTERS AND REMOTE DAMPER SLEEVE BREAK AWAY CONNECTION FOR THEIR TIME REQUIRED TO REVIEW THE ALTERNATE SUBMITTALS CONTROL DEVICES WITH LAMACOID LABELS ENGRAVED WITH WHITE LETTERING AND A BLACK BACKGROUND. THE MINIMUM LETTERING SIZE SHALL BE 3/8" (10 MM). . MANUAL BALANCING DAMPERS INSTALLED IN DUCTWORK NOT EXCEEDING 12" ON THE <u>SUBMITTALS</u> LONGEST SIDE SHALL BE CONSTRUCTED AS PER SMACNA. PROVIDE OPPOSED BLADE ACCESS DOORS AND PANELS DAMPERS WHERE THE DIMENSION OF THE LONGEST SIDE OF THE DUCTWORK 2.1. THE CONTRACTOR SHALL SUBMIT THREE (3) HARD COPIES OF MECHANICAL SHOP EXCEEDS 12". OPPOSED BLADE DAMPERS SHALL BE OF GALVANIZED STEEL DRAWINGS TO THE CONSULTANTS FOR REVIEW. ELECTRONIC SUBMISSION OF SHOP 5.1. PROVIDE ADEQUATE ACCESS TO CONCEALED EQUIPMENT AND COMPONENTS THAT CONSTRUCTION WITH LOCK SCREWS AT OPPOSITE ENDS. PROVIDE BALANCING DRAWINGS SHALL BE DEEMED ACCEPTABLE UPON APPROVAL FROM CONSULTANT. REQUIRE ACCESS FOR MAINTENANCE ADJUSTMENT AND INSPECTION PROVIDE DAMPERS WHERE SHOWN ON DRAWING AS WELL AS ON BRANCHES OFF OF MAIN THE CONTRACTOR SHALL BEAR ALL COSTS ASSOCIATED WITH THE DOCUMENT MARKING TO THE OWNER'S SATISFACTION THE LOCATIONS WHERE CONCEALED DUCTWORK WITH ADEQUATE ACCESS. SUBMITTAL PROCESS. . PROVIDE ALL DIFFUSERS, REGISTERS, GRILLES, ETC. OF TYPE AND SIZE AS INDICATED 2.2. ALL SHOP DRAWINGS SUBMITTED FOR REVIEW MUST BEAR THE REVIEW STAMP OF 5.2. ENSURE THAT THE SIZE OF THE DOOR COMPLIES WITH THE MANUFACTURER'S ON MECHANICAL DRAWINGS, CONFIRM ALL AIR TERMINAL COLOURS WITH THE MECHANICAL CONTRACTOR. SHOP DRAWINGS THAT DO NOT BEAR THE SUGGESTED ACCESS REQUIREMENTS. ARCHITECT/INTERIOR DESIGNER, REGARDLESS OF SPECIFICATION ON MECHANICAL CONTRACTOR'S STAMP WILL, WITHOUT QUESTION, BE REJECTED BY THE DRAWINGS, MECHANICAL CONTRACTOR IS TO COORDINATE INSTALLATION OF DOOR 5.3. COORDINATE ALL ACCESS DOOR AND PANEL SIZES AND LOCATIONS WITH GRILLES WITH ARCHITECTURAL DRAWINGS AND GENERAL CONTRACTOR. ARCHITECT/INTERIOR DESIGNER. 2.3. SHOP DRAWINGS SHALL INCLUDE ALL INFORMATION REQUIRED FOR THE 2. PROVIDE <u>DUCTWORK INSULATION AND LINERS</u> WHERE NOTED ON MECHANICAL CONSULTANT TO PERFORM A REASONABLE REVIEW OF THE SUBMITTALS AS THEY DRAWINGS, AS PER THE FOLLOWING: FLASHING, CURBS AND CONCRETE PERTAIN TO THE MECHANICAL DESIGN DRAWINGS AND SPECIFICATIONS. 6.1. FLASHING SHALL BE CARRIED OUT AS SHOWN ON ARCHITECTURAL AND/OR 12.1. ACOUSTIC LINING: 2.4. SHOP DRAWINGS SHALL HAVE THE SAME IDENTIFYING NUMBER AS NOTED IN THE STRUCTURAL DRAWINGS AT THE EXPENSE OF DIV.23. MECHANICAL DRAWINGS. 12.1.1. DUCT LINING SHALL COMPLY WITH NFPA 90A AND DUCT LINER MATERIALS STANDARD OF THE THERMAL INSULATION MANUFACTURER'S ASSOCIATION. 6.2. ALL CURBS REQUIRED FOR MECHANICAL EQUIPMENT SHALL BE CARRIED OUT AS 2.5. PROVIDE SHOP DRAWINGS WITH TECHNICAL SUBMITTALS ON ALL TYPES OF SHOWN ON ARCHITECTURAL AND/OR MECHANICAL DRAWINGS AT THE EXPENSE OF INSULATION TO BE INSTALLED. 12.1.2. RECTANGULAR DUCTWORK: PROVIDE ONE INCH (1") THICK ACOUSTIC LINING DIV.23. CURBS SHALL BE INSTALLED AT LEAST 14" ABOVE THE ROOF LEVEL. EQUAL TO JOHNS MANVILLE LINACOUSTIC RC COMPLETE WITH PERMACOTE 2.6. THE CONTRACTOR SHALL MAINTAIN ON SITE ONE (1) RECORD OF MECHANICAL ACRYLIC ANTI-MICROBIAL COATING. 6.3. PREMANUFACTURED EQUIPMENT CURBS SHALL BE SUPPLIED BY THE EQUIPMENT DRAWINGS THAT SHALL INDICATE WITH RED LINES ALL PROJECT CONDITIONS, LOCATIONS, CONFIGURATIONS AND ANY OTHER CHANGES OR DEVIATIONS WHICH 12.1.3. SPIRAL DUCTWORK: PROVIDE ONE INCH (1") THICK ACOUSTIC LINING EQUAL MAY VARY FROM THE ORIGINAL CONTRACT DOCUMENTS AND DRAWINGS. IN TO JOHNS MANVILLE SPINACOUSTIC PLUS ROUND DUCT LINER SYSTEM 6.4. PROVIDE 4" (100 MM) THICK CONCRETE HOUSEKEEPING PADS WHERE INDICATED ADDITION. THIS SET SHALL INCLUDE REVISIONS AS A RESULT OF ALL ADDENDAS COMPLETE WITH PERMACOTE ANTI-MICROBIAL COATING. CHANGE NOTICES, SITE INSTRUCTIONS, ETC. UPON COMPLETION OF THE PROJECT ON ARCHITECTURAL AND/OR STRUCTURAL DRAWINGS. THE CONTRACTOR SHALL SUBMIT TO THE OWNER AND ENGINEER ONE (1) COPY 12.1.4. PROVIDE ACOUSTIC LINING AS SPECIFIED ON ALL SUPPLY, RETURN AND <u>FIRESTOPPING</u> EACH OF A HARDCOPY AND ELECTRONIC COPY (PDF) FOR REVIEW. ONE (1) SET EXHAUST FAN EQUIPMENT FOR 10'-0" (3.0 M) FROM THE INLET/OUTLET. OF BOTH COPIES SHALL ALSO BE INCLUDED IN THE CLOSEOUT DOCUMENT 7.1. PROVIDE FIRE STOPPING SYSTEMS AND PRODUCTS FOR ALL DUCTS, PIPING, ETC. PENETRATING FIRE SEPARATIONS THAT ARE ULC LISTED AND COMPLY WITH 12.2. THERMAL INSULATION CAN4-S115S AND THE AUTHORITIES HAVING JURISDICTION. 2.7. TWO (2) COPIES OF OPERATION AND MAINTENANCE MANUALS SHALL BE 12.2.1. PROVIDE THERMAL INSULATION WHERE NOTED ON MECHANICAL DRAWINGS. SUBMITTED TO THE CONSULTANT FOR REVIEW UPON PROJECT COMPLETION. THE 7.2. MAINTAIN ALL FLOOR AND WALL FIRE RATINGS TO COMPLY WITH BASE BUILDING INSULATE ALL DUCTWORK LEAVING OR ENTERING THE BUILDING FOR THE MANUALS SHALL CONTAIN THE FOLLOWING WHERE APPLICABLE: FIRST 6 FT. FROM THE BUILDING PENETRATION WITH 2" OF THERMAL STANDARDS AND THE AUTHORITIES HAVING JURISDICTION. DESCRIPTION OF EACH SYSTEM INSULATION. - DESCRIPTION OF EACH MAJOR COMPONENT OF SYSTEM PIPE, DUCT AND EQUIPMENT INSTALLATION ALL SHOP DRAWINGS WITH APPROVAL STAMPS 12.2.2. RECTANGULAR DUCTWORK: PROVIDE ONE INCH (1") JOHNS MANVILLE SERIES - EQUIPMENT MANUFACTURER'S INSTALLATION AND OPERATION 8.1. INSTALL ALL PIPING, DUCTWORK AND EQUIPMENT TO PROVIDE ADEQUATE 814 SPIN-GLAS FIBER GLASS DUCT BOARD INSULATION WITH FSK FACING. MANUALS AND SPARE PARTS LIST CLEARANCES FOR SERVICING AS WELL AS MAXIMUM USABLE SPACE FOR ALL IMPALE ON MECHANICALLY FASTENED PINS LOCATED AT NOT MORE THAN 12" WIRING DIAGRAMS OTHER DIVISIONS. ON CENTRE, AND SECURE WITH SPEED WASHERS. LUBRICATION SCHEDULE EQUIPMENT IDENTIFICATION LIST WITH SERIAL NUMBERS 8.2. INSTALL PIPING AND DUCTWORK STRAIGHT, IN A NEAT AND CLEAN FASHION AND 12.2.3. RIGID ROUND (SPIRAL) DUCTWORK: PROVIDE ONE INCH (1") JOHNS MANVILLE VALVE TAG SCHEDULES AND FLOW DIAGRAMS TIGHT TO STRUCTURES ABOVE (UNLESS OTHERWISE NOTED). MICROLITE EQ FSK FIBER GLASS DUCT WRAP INSULATION WHERE INDICATED FINAL AND REVIEWED BALANCING REPORTS (AIR AND WATER) ON DRAWINGS. ADHERE INSULATION TO DUCT SURFACE AND LAP ALL EDGES WATER TREATMENT PROCEDURE AND TESTS 8.3. TAKE MEASURES TO PROTECT COPPER PIPING CORROSION FROM CONTACT WITH AT LEAST 2". SEAL JOINTS WITH 4" WIDE ALUMINUM FOIL TAPE. CONTROL DRAWINGS AND SEQUENCES OF OPERATION DISSIMILAR METALS. AS-BUILT DRAWINGS (HARDCOPY AND ELECTRONIC) 12.2.4. FLEXIBLE DUCTWORK: PROVIDE ONE INCH (1.25") JOHNS MANVILLE WARRANTY DOCUMENTATION HANGERS AND SUPPORTS FLEX-GLAS EQ FLEXIBLE DUCTWORK INSULATION WITH FSK FACING. LAP **EXECUTION** JOINTS AND SEAL WITH 4" WIDE ALUMINUM FOIL TAPE. 9.1. PROVIDE HANGER SYSTEMS FOR ALL DUCTWORK, PIPING AND EQUIPMENT TO RENDER A SAFE AND FUNCTIONAL INSTALLATION. HANGER RODS SHALL BE 12.2.5. WHERE DUCTWORK IS INSTALLED OUTSIDE THE BUILDING OR EXPOSED TO 3.1. PERIODIC INSPECTIONS OF THE WORK WILL BE CONDUCTED OVER THE COURSE ATTACHED DIRECTLY TO THE STRUCTURE AND IN NO WAY SHALL BE ATTACHED TO OF THE PROJECT. ALL REPORTED DEFICIENCIES SHALL BE RECTIFIED BY THE THE ELEMENTS, PROVIDE TWO INCHES (2") OF THERMAL INSULATION, BUTT OTHER MECHANICAL COMPONENTS OR CEILING SYSTEMS. WHERE COMPONENTS CONTRACTOR IN A TIMELY FASHION, FAILURE TO DO SO WILL RESULT IN THE JOINTS TIGHTLY TOGETHER AND SEAL WASHERS, BREAKS AND JOINTS WITH ARE TO BE SUSPENDED BETWEEN JOISTS OR BEAMS, PROVIDE AUXILIARY STEEL CONTRACTOR NOT MEETING THE REQUIREMENTS OF THE CONTRACT DOCUMENTS. SELF-ADHERING FOUR INCHES (4") WIDE PLAIN ALUMINUM TAPE, OR CHANNELS TO SUIT. ADHERE FOIL WITH CHILDERS CP82 OR BAKELITE 230-39 ADHESIVE. 3.2. IT SHALL BE THE RESPONSIBILITY OF THE CONTRACTOR TO COORDINATE ALL 9.2. FOR GENERAL CONDITIONS, PROVIDE ROUND STEEL THREADED RODS CONFORMING INSPECTIONS WITH CITY AND/OR MUNICIPAL OFFICIALS AND ALL OTHER 12.3. JACKETING TO ASTM A-36. WHERE SPECIAL CONDITIONS EXIST, SUCH AS HIGH HUMIDITY OR AUTHORITIES HAVING JURISDICTION. EXPOSURE TO ELEMENTS, PROVIDE HANGER COMPONENTS TO SUIT. 12.3.1. RECOVER ALL DUCTWORK OUTSIDE THE BUILDING OR EXPOSED TO THE 3.3. IN REGARDS TO TEMPORARY SERVICES, PROVIDE. AS REQUIRED BY THE ELEMENTS WITH ALUMINUM JACKETING TO ASTM B209 WITH MOISTURE 9.3. IN REGARDS TO ALL PIPING, PROVIDE SUPPORTS AT CONNECTION (SUCH AS HUB) AUTHORITY HAVING JURISDICTION, TEMPORARY FIRE PROTECTION SYSTEMS. BARRIER, THICKNESS 0.50MM SHEET, STUCCO EMBOSSED FINISH, JACKET AND AT EVERY CHANGE IN DIRECTION. REFRAIN FROM USING INSTALLED SYSTEMS FROM THE CONTRACT DOCUMENTS AS BANDING AND MECHANICAL SEALS 12MM WIDE AND 0.5MM THICK STAINLESS A TEMPORARY SERVICES. THIS SHALL APPLY TO ALL MECHANICAL SYSTEMS 10. <u>STRUCTURAL AND SEISMIC</u> INCLUDING HVAC, PLUMBING AND DRAINAGE, ETC. 13. HVAC BALANCING 10.1. WHERE THERE IS NO STRUCTURAL DIVISION AS PART OF THE PROJECT, IT SHALL 13.1. PROVIDE BALANCING OF ALL AIR AND WATER SYSTEMS AS INDICATED ON

MECHANICAL DRAWINGS. THE BALANCING CONTRACTOR SHALL HAVE A MINIMUM

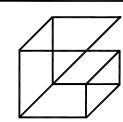

Giallonardo — **Engineering Inc** 220-4550 Highway 7 Woodbridge, ON L4L 4Y7 (905) 265 - 1052 info@giallonardoeng.com www.giallonardoeng.com

This drawing is the property of GIALLONARDO ENGINEERING INC.

This drawing shall be read in conjunction with the architectural, structural, electrical and all other consultant's drawings prior to

proceeding with the work. Do not scale the drawings.

The contractor is to verify and accept responsibility for all dimensions and conditions on site and must notify GIALLONARDO ENGINEERING INC. of any variations from the drawings.



NO.	ISSUES		DATE	BY
1	ISSUED FOR	REVIEW	MAR. 10 2025	RC
2	ISSUED FOR	TENDER	MAR. 19 2025	SW
NO.	REVISION:	 S	DATE	BY

PROJECT:

RENOVATIONS AT ECOLE ELEMENTAIRE JEANNE-LAJOIE

150 CARNFORTH ROAD NORTH YORK, ONTARIO Conseil scolaire Viamond

DRAWING:

MECHANICAL SPECIFICATIONS I



R.GIALLONARDO

DESIGN BY

BARRY BRYAN **ASSOCIATES** Architects Engineers Project Managers 250 Water Street Suite 201

Whitby, Ontario

L1N 0G5

% COMPLETE: DRAWN BY CHECKED BY: JAN 2025

DOC_CONTROL:

Tel: (905) 666-5252 Fax: (905) 666-5256 e-mail: bba@bba-archeng.com

AS SHOWN FILE

DRAWING NO:

PROJECT NO: 25-102 M-1.1

PLUMBING SPECIFICATIONS

- PROVIDE PLUMBING SYSTEMS AS PER DRAWINGS, SPECIFICATIONS, THE LATEST EDITION OF THE ONTARIO BUILDING CODE, MUNICIPAL BY-LAWS AND THE AUTHORITY HAVING JURISDICTION. THE TERM "SYSTEMS" REFERS TO ALL PIPING, FITTINGS, SUPPORTS, CURBS, ACCESSORIES, ETC.
- ALL ITEMS REQUIRED FOR PLUMBING SYSTEMS SHALL BE CSA APPROVED UNLESS OTHERWISE NOTED.
- CLEANING, FLUSHING AND DISINFECTING OF DOMESTIC WATER PIPING
- 3.1. FOLLOW PROCEDURES AS OUTLINED IN THE LATEST EDITION OF STANDARD AWWA C651. ENSURE THAT THE METHODS COMPLY WITH LOCAL BY-LAWS.
- 3.2. PREVENT CONTAMINATING MATERIAL FROM ENTERING THE SYSTEM DURING STORAGE, CONSTRUCTION AND REPAIR.
- 3.3. REMOVE AND FLUSH ALL FOREIGN MATTER THAT HAS ENTERED THE PIPING.
- 3.4. PROTECT THE EXISTING DISTRIBUTION SYSTEM FROM BACKFLOW DUE TO HYDROSTATIC PRESSURE AND DISINFECTION PROCEDURES.
- 3.5. CHLORINATE RESIDUAL CONTAMINATION THAT MAY REMAIN AND FLUSH THE CHLORINATED WATER WHEN COMPLETE. FOLLOWING THIS, DETERMINE THE BACTERIOLOGICAL QUALITY OF THE WATER BY LABORATORY TESTING. CONNECT THE WATER SYSTEM ONLY WHEN TEST RESULTS INDICATE AN APPROVED AND DISINFECTED SYSTEM.

. <u>PIPING INSULATION</u>

- 4.1. PROVIDE PIPING INSULATION FOR PLUMBING SYSTEMS AS FOLLOWS:
- DCW: TYPE 'A', FOR ALL PIPE SIZES 1" THICK - DHW(R): TYPE 'A', UP TO 2"ø - 1" THICK, 2-1/2"ø AND UP - 1-1/2"
- CD (HORIZONTAL): TYPE 'A', 1/2"Ø THROUGHOUT
- 4.2. TYPE 'A': JOHNS MANVILLE MICRO-LOK FIBER GLASS PIPE INSULATION COMPLETE WITH JACKET AND VAPOUR RETARDER. CONNECT SECTIONS OF INSULATION WITH BUTT STRIPS SUPPLIED BY THE INSULATION MANUFACTURER.
- 4.3. FOR NEW EXPOSED PIPING INSTALLED INDOORS AND/OR IN MECHANICAL ROOMS, RECOVER INSULATION WITH HEAVY-GAUGE PVC FITTINGS, COVER AND JACKETING EQUAL TO JOHNS MANVILLE ZESTON 300 SERIES.
- 4.4. PROVIDE INSULATION ON PIPES GOING THROUGH FIRE RATED FLOORS AND WALLS, AND <u>FIT TIGHT TO THE FIRE STOP MATERIAL</u>.
- 4.5. <u>HEATING WATER PIPING</u> SHALL HAVE GLASS FIBRE PIPE INSULATION.
- MAKE ALL PIPING AND ELECTRICAL CONNECTION TO PUMPS AND MOTOR ASSEMBLIES AS SPECIFIED. REFER TO PUMP SCHEDULE (WHERE APPLICABLE).
- PIPING MATERIALS (SEE BELOW FOR MATERIALS SPECIFICATIONS)
- 6.1. <u>DCW AND DHW(R)</u> 6.1.1. ABOVE GROUND: TYPE 1
- 6.1.2. UNDERGROUND: TYPE 2
- 6.2. <u>SANITARY & STORM DRAINAGE PIPING</u>
 6.2.1. ABOVE GROUND: TYPE 3, TYPE 4, TYPE 6 (WHERE PERMITTED)

6.2.2. UNDERGROUND: TYPE 4 (2"Ø MIN.), TYPE 5, TYPE 7

- 6.3.1. ABOVE GROUND: TYPE 3, TYPE 4, TYPE 6 (WHERE PERMITTED) 6.3.2. UNDERGROUND: TYPE4, TYPE 5, TYPE 7
- TYPE 1: TYPE L HARD DRAWN COPPER TUBING WITH WROUGHT COPPER FITTINGS AND LEAD-FREE SOLDER, CONTAINING LESS THAN .02 PERCENT LEAD, CONFORMING
- TYPE 2: TYPE K SOFT ANNEALED COPPER TUBING WITH NO JOINTS.
- TYPE 3: TYPE DWV COPPER TUBE AND FITTINGS WITH 95:5 TIN:ANTIMONY SOLDER JOINTS.

TYPE 4: CAST IRON PIPING AND FITTINGS COMPLYING WITH CAN/CSA-B70. FOR MECHANICAL JOINTS ABOVE GRADE, USE NEOPRENE OR BUTYL RUBBER COMPRESSION GASKETS TO CAN/CSA-B70 WITH STAINLESS STEEL CLAMPS. FOR MECHANICAL JOINTS BELOW GRADE, USE MISSION HEAVYWEIGHT COUPLINGS FOR HUB AND SPIGOT CONNECTIONS, PROVIDE NEOPRENE GASKET TO CAN/CSA-B70 AND COLD CAULKING COMPOUNDS. DO NOT USE HUB AND SPIGOT FOR ABOVE GROUND

TYPE 5: IPEX RING-TITE PVC SDR 35 SEWER PIPE IN COMPLIANCE WITH CSA B182.2 AND CSA B182.7. LATERALS WILL BE IPEX RING-TITE PVC SDR 28 IN COMPLIANCE WITH CSA B182.2.

TYPE 6: IPEX XFR PIPING AND FITTINGS COMPLYING WITH CSA B181.2, SCHEDULE 40 WITH A FLAME SPREAD RATING OF NOT GREATER THAN 25 AND A SMOKE DEVELOPED CLASSIFICATION OF LESS THAN 50.

TYPE 7: ROYAL ABS-DWV PIPING AND FITTINGS CERTIFIED TO CSA B181.1.


- <u>VALVES</u>
- 7.1. PROVIDE ASTM DOMESTIC WATER VALVES TO THE FOLLOWING KITZ FIGURE NUMBERS:
- 7.1.1. <u>GATE VALVES</u> 7.1.1.1. 2"ø AND SMALLER: SOLDERED, 1400 kPa [200psi] W.O.G. FIG. 44 7.1.1.2. 2-1/2"Ø AND LARGER: FLANGED, 1400 kPa [200psi] W.O.G. FIG. 44
- 7.1.2. <u>GLOBE VALVES</u> 7.1.1.1. 2"Ø AND SMALLER: SOLDERED, 2070 kPa [300 psi], W.O.G. FIG. 10 WITH
- SUITABLE COMPOSITION DISC. 2—1/2"ø AND LARGER: FLANGED, 1400 kPa [200 psi], W.O.G. FIG. 76
- 7.1.2. <u>STANDARD CHECK VALVES</u>
- 2°¢ AND SMALLER: SOLDERED, 2070 kPa [300 psi], W.O.G. FIG. 23 7.1.1.2. 2-1/2"Ø AND LARGER: FLANGED, 1400 kPa [200 psi], W.O.G. FIG. 78
- 7.1.2. <u>BALL VALVES</u>
 7.1.1.1. 2"ø AND SMALLER: BALL VALVES MAY BE PROVIDED AS A SUBSTITUTE FOR GATE AND GLOBE VALVES. PROVIDE BALL VALVES WITH BRASS OR BRONZE BODY, CHROME PLATED SOLID BALL, PTFE SEATS AND SEALS AND FULL PORT, KITZ FIG. 59
- 7.2. PROVIDE ISOLATION VALVES FOR DOMESTIC HOT AND COLD WATER SYSTEMS AT MAIN PIPING, BRANCH PIPING AND AT FIXTURES AND EQUIPMENT.
- <u>VERIFY ALL SITE CONDITIONS</u> AFTER CONTRACT AWARD TO ENSURE THAT PIPING INVERTS ARE SUFFICIENT FOR THE RUNS SHOWN ON MECHANICAL DRAWINGS. REPORT DISCREPANCIES TO ENGINEER IMMEDIATELY.
- CARRY OUT TESTING ON ALL SYSTEMS INCLUDING SANITARY DRAINAGE SYSTEMS, STORM DRAINAGE SYSTEMS AND DOMESTIC WATER SYSTEMS AS PER PART 7.3.6 OF THE ONTARIO BUILDING CODE AND THE AUTHORITIES HAVING JURISDICTION. TESTS MAY INCLUDE, BUT ARE NOT LIMITED TO, A WATER TEST, BACKFLOW TEST, PRESSURE TEST, BALL TEST AND FINAL TEST.
- D. MAKE PROVISIONS FOR <u>MAINTAINING THE SEAL</u> OF ALL HUB DRAINS, FLOOR DRAINS, ETC, IN ACCORDANCE WITH THE ONTARIO BUILDING CODE. WHERE MECHANICAL OR ELECTRICAL DEVICES ARE USED, THE MINIMUM TUBING SIZE SHALL BE 3.8".
- . PROVIDE <u>FIRESTOPPING</u> AT ALL FIRE—RATED WALL AND FLOOR ASSEMBLIES AS PER THE 'GENERAL SPECIFICATIONS'.
- 2. COORDINATE EXACT LOCATIONS OF ALL PLUMBING FIXTURES WITH ALL TRADES AND ARCHITECTURAL/INTERIOR DESIGN DRAWINGS. DO NOT SCALE MECHANICAL DRAWINGS.
- 3. WHERE PLUMBING FIXTURES ARE SPECIFIED, THE CONTRACTOR SHALL PROVIDE ALL ACCESSORIES AND APPURTENANCES TO PROVIDE A FULL AND COMPLETE INSTALLATION OF THE RESPECTIVE FIXTURE. THIS MAY INCLUDE, BUT IS NOT LIMITED TO, STOP
- 4. PROVIDE VENTING SYSTEMS IN ACCORDANCE WITH PART 7 OF THE ONTARIO BUILDING

VALVES, RISER PIPING, ESCUTCHEON PLATES, ETC.

	HVAC LEGEND
SYMBOL	DESCRIPTION
	EXISTING DUCTWORK/EQUIPMENT
	EXISTING DUCTWORK/EQUIPMENT TO BE REMOVED
	NEW RIGID DUCTWORK
	EXISTING FLEXIBLE DUCTWORK
	NEW FLEXIBLE DUCTWORK
	SUPPLY AIR DUCTWORK UP
	SUPPLY AIR DUCTWORK DOWN
	RETURN AIR DUCTWORK UP
	RETURN AIR DUCTWORK DOWN
S/A	'SUPPLY AIR'
R/A	'RETURN AIR'
E/A	'EXHAUST AIR'
O/A	'OUTSIDE AIR'
T/A	'TRANSFER AIR'
F/D	'FIRE DAMPER'
L BD	'BALANCING DAMPER'
BDD	'BACKDRAFT DAMPER'
┦ M/D	'MOTORIZED DAMPER'
	SQUARE SUPPLY AIR DIFFUSER
	SUPPLY AIR GRILLE
	RETURN AIR GRILLE
	SLOT DIFFUSER
Ō	THERMOSTAT
$_{igoplus}$	HUMIDISTAT
©	CARBON DIOXIDE SENSOR
<u></u>	CARBON MONOXIDE DETECTOR
0	ZONE SENSOR
\$	WALL SWITCH
A-6"ø 150CFM	DIFF TYPE/SIZE AIR CAPACITY
TYP.	'TYPICAL'
<u>X-XX</u>	EQUIPMENT TAG
CTE	'CONNECT TO EXISTING'
	FAN-POWERED TERMINAL UNIT
	VAV TERMINAL UNIT
	CABINET EXHAUST FAN
IH Z HI	INLINE EXHAUST FAN
	ELECTRIC DUCT HEATER
	CIRCULAR EXHAUST FAN
	BASEBOARD HEATER
	FORCE FLOW HEATER
<u>_</u>	UNIT HEATER
<u></u>	DUCTWORK WITH ACOUSTIC OR THERMAL INSULATION (SEE SPECS.)
<u></u>	DUCTWORK WITH ACOUSTIC INSULATION
<u> </u>	DUCTWORK WITH ACCUSTIC INSULATION DUCTWORK WITH THERMAL INSULATION
<u> </u>	
	CONTINUATION OF DUCTWORK/PIPING EVISTING CONTROL WIRING
	EXISTING CONTROL WIRING
	NEW CONTROL WIRING
	SPIN-ON DUCT CONNECTION WITH BALANCING DAMPER
<u>▽</u>	DRAWING NOTE
	ROUND SUPPLY AIR DIFFUSER
<u> </u>	LOUVERED FACE SUPPLY/RETURN GRILLE
CAP 🗖	CAP ON DUCTWORK
∇	BRANCH ON DUCTWORK
	İ

	PIPING LEGEND
SYMBOL	DESCRIPTION
— EX.HWS —	EXISTING HEATING WATER SUPPLY
EX.HWR	EXISTING HEATING WATER RETURN
—— HWS ——	HEATING WATER SUPPLY
— — HWR — —	HEATING WATER RETURN
— EX.CHWS —	EXISTING CHILLED WATER SUPPLY
EX.CHWR	EXISTING CHILLED WATER RETURN
—— CHWS ——	CHILLED WATER SUPPLY
— — CHWR — —	CHILLED WATER RETURN
EX.CWS	EXISTING CONDENSER WATER SUPPLY
- — EX.CWR	EXISTING CONDENSER WATER RETURN
cws	CONDENSER WATER SUPPLY
— CWR——	CONDENSER WATER RETURN
REFL —	REFRIGERANT LIQUID LINE
	REFRIGERANT SUCTION LINE
<u> </u>	3-PORT CONTROL VALVE
	2-WAY CONTROL VALVE
M	GATE VALVE
M	GLOBE VALVE
Z	CHECK VALVE
CBV ⋈	CIRCUIT BALANCING VALVE
×	BALL VALVE
焓	SAFETY RELIEF VALVE
1	STRAINER
ф	UNION
-⊅-	CONCENTRIC REDUCER
4	ECCENTRIC REDUCER
N.O.	'NORMALLY OPEN'
N.C.	'NORMALLY CLOSED'
· · · · · · · · · · · · · · · · · · ·	PRESSURE GAUGE
	THERMOMETER
⊗	AQUASTAT
PRV ♣	PRESSURE REDUCING VALVE
∨B	VACUUM BREAKER
	BACKFLOW PREVENTER
FS Ø	FLOW SWITCH
	AUTOMATIC AIR VENT
AAV Ū	
LWCO	LOW WATER CUT-OFF
▼	PLUG/COCK VALVE
7	BUTTERFLY VALVE
Ų	TEST PORT
©	PUMP
CAP 🗖	CAP ON PIPING
7	DRAWING NOTE
×	ISOLATION VALVE
_	

PLUMBING LEGEND				
SYMBOL	DESCRIPTION			
—— EX.SAN ——	EXISTING ABOVE GROUND SANITARY DRAINAGE PIPING			
— — EX.SAN ——	EXISTING UNDERGROUND SANITARY DRAINAGE PIPING			
SAN	ABOVE GROUND SANITARY DRAINAGE PIPING			
— — SAN — —	UNDERGROUND SANITARY DRAINAGE PIPING			
EX.STM	EXISTING ABOVE GROUND STORM DRAINAGE PIPING			
EX.STM	EXISTING UNDERGROUND STORM DRAINAGE PIPING			
STM	ABOVE GROUND STORM DRAINAGE PIPING			
— — STM — —	UNDERGROUND STORM DRAINAGE PIPING			
—— EX.V ——	EXISTING ABOVE GROUND VENT PIPING			
EX.V	EXISTING UNDERGROUND VENT PIPING			
V	ABOVE GROUND VENT PIPING			
V	UNDERGROUND VENT PIPING			
—— EX.CD ——	EXISTING CONDENSATE DRAINAGE PIPING			
CD	CONDENSATE DRAINAGE PIPING			
	EXISTING DOMESTIC COLD WATER PIPING			
	DOMESTIC COLD WATER PIPING			
	EXISTING DOMESTIC HOT WATER PIPING			
	DOMESTIC HOT WATER PIPING			
	EXISTING DOMESTIC HOT WATER RETURN PIPING			
	DOMESTIC HOT WATER RETURN PIPING			
—— EX.G ——	EXISTING GAS PIPING			
G	LOW PRESSURE GAS PIPING			
HPG ——	HIGH PRESSURE GAS PIPING			
	EXISTING PIPING/EQUIPMENT TO BE REMOVED			
SSSS	HEAT TRACING ON PIPE			
	CONTINUATION OF DUCTWORK/PIPING			
₹	GAS COCK VALVE			
FD 🖨 FFD	FLOOR DRAIN/FUNNEL FLOOR DRAIN			
HD O	HUB DRAIN			
AD 🖸	AREA DRAIN			
RD 📵	ROOF DRAIN			
СВ	CATCH BASIN			
co a —	BURIED CLEANOUT			
co I —	EXPOSED CLEANOUT			
ೡ	SANITARY 'P' TRAP			
—	PIPE UP			
	PIPE DOWN			
VTR	VENT THROUGH ROOF			
CAP T	CAP ON PIPING			
7	DRAWING NOTE			
\bowtie	ISOLATION VALVE			
0	PIPING DROPDOWN			
<u>M</u>	WATER METER			

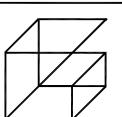

Giallonardo — Engineering Inc. 220-4550 Highway 7 Woodbridge, ON L4L 4Y7 (905) 265 - 1052 info@giallonardoeng.com www.giallonardoeng.com

This drawing is the property of GIALLONARDO ENGINEERING INC.

This drawing shall be read in conjunction with the architectural, structural, electrical and all other consultant's drawings prior to proceeding with the work. Do not scale the drawings.

The contractor is to verify and accept responsibility for all dimensions and conditions on site and must notify GIALLONARDO ENGINEERING INC. of any variations from the



NO.	ISSUES	DATE	В
1	ISSUED FOR REVIEW	MAR. 10 2025	RC
2	ISSUED FOR TENDER	MAR. 19 2025	SW
NO	REVISIONS	DATE	B'

PROJECT:


RENOVATIONS AT ECOLE ELEMENTAIRE JEANNE-LAJOIE

150 CARNFORTH ROAD NORTH YORK, ONTARIO Conseil scolaire Viamond

DRAWING:

MECHANICAL SPECIFICATIONS II AND LEGEND



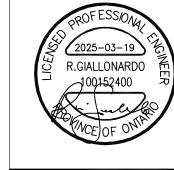

% COMPLETE:

BARRY BRYAN ASSOCIATES Architects Engineers Project Managers 250 Water Street

Suite 201 Whitby, Ontario L1N 0G5 Tel: (905) 666-5252 Fax: (905) 666-5256

e-mail: bba@bba-archeng.com

CHECKED BY: JH JAN 2025 AS SHOWN

DESIGN BY:

DRAWN BY:

SW

25-102 M-1.2

FILE:

	FIXTURES		PIPE	(IN [MM])	TION	
TAG	SPECIFICATION	TRAP	COLD WATER	HOT WATER	DRAIN	VENT
WC1	FLOOR MOUNTED TOILET - VITREOUS CHINA - FOR FLUSHOMETER - EXPOSED - MANUAL - BARRIER FREE	3"ø	1"ø	_	3"ø	1-1/2
	AMERICAN STANDARD 3461001.020 TOILET — MADERA FLOWISE, TOILET, FLOOR MOUNTED WITH FLOOR OUTLET, TOILET OPERATES IN THE RANGE OF 4.2 TO 6.0 LPF (1.1 — 1.6 GPF), WHITE FINISH VITREOUS CHINA, EVERCLEAN ANTIMICROBIAL SURFACE, ELONGATED BOWL.	[75ø]	[25ø]		[75ø]	[38ø]
	CENTOCO 500STSCCFE-001 SEAT - FAST-N-LOCK, FOR ELONGATED BOWL, OPEN FRONT, HEAVY-DUTY, POLYPROPYLENE, TOILET SEAT, LESS SEAT COVER, PLASTIC COMMERCIAL CHECK HINGES, WHITE FINISH, FAST-N-LOCK MOUNTING SYSTEM. THE BOLT AND NUT MATERIAL SHALL BE STAINLESS STEEL.					
	SLOAN ROYAL 111-YO-1.28 FLUSH VALVE - ROYAL MANUAL EXPOSED WATER CLOSET FLUSHOMETER, CONSTRUCTED FROM SEMI-RED BRASS, POLISHED CHROME FINISH, HIGH EFFICIENCY 4.8 LPF (1.28 GPF).					
	FRANKE COMMERCIAL CM-16104 - BACK REST SUPPORT, TYPE 304 STAINLESS STEEL, CONCEALED ANCHORING.					
	PROVIDE TOILET FLANGE AND ALL OTHER ACCESSORIES REQUIRED FOR A FULL AND COMPLETE INSTALLATION.					
WC2	FLOOR MOUNTED TOILET - VITREOUS CHINA - FOR FLUSHOMETER - EXPOSED - MANUAL	3"ø	1"ø	-	3"ø	1-1/2
	AMERICAN STANDARD 3451001.020 TOILET — MADERA FLOWISE, TOILET, FLOOR MOUNTED WITH FLOOR OUTLET, TOILET OPERATES IN THE RANGE OF 4.2 TO 6.0 LPF (1.1 — 1.6 GPF), WHITE FINISH VITREOUS CHINA, EVERCLEAN ANTIMICROBIAL SURFACE, ELONGATED BOWL.	[75ø]	[25ø]		[75ø]	[38ø]
	CENTOCO 500STSCCFE-001 SEAT - FAST-N-LOCK, FOR ELONGATED BOWL, OPEN FRONT, HEAVY-DUTY, POLYPROPYLENE, TOILET SEAT, LESS SEAT COVER, PLASTIC COMMERCIAL CHECK HINGES, WHITE FINISH, FAST-N-LOCK MOUNTING SYSTEM. THE BOLT AND NUT MATERIAL SHALL BE STAINLESS STEEL.					
	SLOAN ROYAL 111-YO-1.28 FLUSH VALVE - ROYAL MANUAL EXPOSED WATER CLOSET FLUSHOMETER, CONSTRUCTED FROM SEMI-RED BRASS, POLISHED CHROME FINISH, HIGH EFFICIENCY 4.8 LPF (1.28 GPF).					
	PROVIDE TOILET FLANGE AND ALL OTHER ACCESSORIES REQUIRED FOR A FULL AND COMPLETE INSTALLATION.					
WC3	FLOOR MOUNTED TOILET - VITREOUS CHINA - TANK TYPE - MANUAL	3"ø [75ø]	1/2"ø [12ø]	-	3"ø [75ø]	1-1/2 ¹ [38ø]
	AMERICAN STANDARD 215DA004.020 TOILET — CADET PRO, TANK TYPE TOILET, FLOOR MOUNTED WITH FLOOR OUTLET, LOW CONSUMPTION 6.0 LPF (1.6 GPF), WHITE FINISH VITREOUS CHINA, EVERCLEAN ANTIMICROBIAL SURFACE, ROUND FRONT BOWL, MANUAL, POLISHED CHROME LEFT—HAND TRIP LEVER (7381231—200.0020A).	[,0]	[127]		[,02]	
	CENTOCO 300CC-001 SEAT - FOR ROUND BOWL, OPEN FRONT, HEAVY-DUTY, FOR COMMERCIAL APPLICATIONS, POLYPROPYLENE, TOILET SEAT, LESS SEAT COVER, STAINLESS STEEL SELF-SUSTAINING HINGE, SPECIFIED IN WHITE FINISH, INCLUDES PLASTIC HARDWARE, DIMENSIONS: 25 MM (1") HIGH, 413 MM (16-1/4") LONG, 368 MM (14-1/2") WIDE.					
	PROVIDE HEAVY DUTY LOOSE KEY ANGLE STOPS, FLEXIBLE RISERS, ESCUTCHEON PLATE, TOILET FLANGE AND ALL OTHER ACCESSORIES REQUIRED FOR A FULL AND COMPLETE INSTALLATION.					
L1	WALL MOUNT BASIN — LEVER HANDLE METERING FAUCET — MANUAL — BARRIER FREE	1-1/4"ø [32ø]	1/2"ø [12ø]	1/2"ø [12ø]	1-1/4"ø [32ø]	1-1/4 [32ø]
	AMERICAN STANDARD 0955001EC.020 0059020EC.020 BASIN — MURRO, WALL—HUNG LAVATORY, VITREOUS CHINA, EVERCLEAN ANTIMICROBIAL SURFACE, WHITE FINISH, VITREOUS CHINA SHROUD WITH EVERCLEAN.	[]	[]	[]	[]	
	AMERICAN STANDARD 7075104.002 FAUCET — COLONY, COUNTER MOUNTED, MANUAL, SINGLE HANDLE, LAVATORY FAUCET, POLISHED CHROME FINISH, SINGLE HOLE CENTERSET, 610 MM (24") COLOUR—CODED BRAIDED FLEXIBLE SUPPLY HOSES WITH 10 MM (3/8") COMPRESSION CONNECTIONS, CERAMIC DISC CARTRIDGE, 4.5 LPM (1.2 GPM) MAXIMUM FLOWRATE, PRESSURE COMPENSATING AERATOR, FIXED MID—ARC SPOUT, 111 MM (4-3/8") SPOUT REACH, 157 MM (6-3/16") HIGH, LEVER HANDLE, LESS DRAIN, LESS POP—UP HOLE & ROD.					
	LAWLER TMM-1070-87500 MIXING VALVE - POINT OF USE MECHANICAL MIXING VALVE WITH THERMOSTATIC LIMIT STOP, MECHANICAL MIXING VALVE, 1.8 LPM (0.5 GPM) TEMPERED FLOWRATE 9 5 PSI PRESSURE DROP, 8 LPM (2.1 GPM) FLOWRATE 45 PSI.					
	PROVIDE FIXTURE DRAIN, P-TRAP, HEAVY DUTY LOOSE KEY ANGLE STOPS, FLEXIBLE RISERS, WALL CARRIER AND ALL OTHER ACCESSORIES REQUIRED FOR A FULL AND COMPLETE INSTALLATION.					
S1	SINGLE BOWL SINK - DROP-IN - TWO HANDLE FAUCET - MANUAL	1-1/2"ø		1/2"ø	1-1/2"ø	
	FRANKE COMMERCIAL LBS6808P-1-3 SINK - COUNTER MOUNTED, SINGLE COMPARTMENT SINK, CONSTRUCTED FROM 18 GAUGE TYPE 304 STAINLESS STEEL, 203 MM (8") CENTERSET, WITH OVERALL DIMENSION 508 MM (20") LONG, 521 MM (20-1/2") WIDE, 203 MM (8") HIGH.	[38ø]	[12ø]	[12ø]	[38ø]	[32ø]
	AMERICAN STANDARD 6409170.002 FAUCET — MONTERREY, MANUAL, TWO HANDLES, SINK FAUCET.					
	LAWLER TMM-1070-87500 MIXING VALVE - POINT OF USE MECHANICAL MIXING VALVE WITH THERMOSTATIC LIMIT STOP, MECHANICAL MIXING VALVE, 1.8 LPM (0.5 GPM) TEMPERED FLOWRATE © 5 PSI PRESSURE DROP, 8 LPM (2.1 GPM) FLOWRATE © 45 PSI.					
	PROVIDE FIXTURE DRAIN, P-TRAP, HEAVY DUTY LOOSE KEY ANGLE STOPS, FLEXIBLE RISERS AND ALL OTHER ACCESSORIES REQUIRED FOR A FULL AND COMPLETE INSTALLATION.					
WF1	FLOOR MOUNTED WASHFOUNTAIN - THREE USER	1-1/2"ø		1/2"ø	1-1/2"ø	
	TERREON MF2933 TRI—FOUNT WASHFOUNTAIN — FLOOR MOUNTED, SERVES 1—3 USERS AT A TIME, 0.50 GPM (1.9 LPM) FLOW PER STATION, SOLID SURFACE MATERIAL, HIGHLY VANDAL RESISTANT, INFRARED ACTIVATION TYPE, NO SOAP DISPENSER, THERMOSTATIC MIXING ASSEMBLY.	[38ø]	[12ø]	[12ø]	[38ø]	[32ø]
MS1	MOP SINK	3"ø	1/2"ø	1/2"ø	3"ø	1-1/2
	STERN WILLIAMS SB-300-T-10-VB-T-35-T-40-BP SINK - SINGLE COMPARTMENT MOP SERVICE SINK, WITH OVERALL DIMENSION 914 MM (36") LONG, 610 MM (24") WIDE, 305 MM (12") HIGH, CONSTRUCTED FROM PRECAST TERRAZZO, BOWL DIMENSIONS ARE 851 MM (33-1/2") LONG, 546 MM (21-1/2") WIDE, 254 MM (10") DEEP, 76 MM (3") PIPE SIZE, CAST INTEGRALLY AND PROVIDES FOR A CAULKED LEAD CONNECTION NOT LESS THAN 25 MM (1") DEEP TO A 76 MM (3") PIPE, FLAT STAINLESS STEEL STRAINER, WITHOUT TILING FLANGE, WITH STAINLESS STEEL CAP, T-10-VB MOP SERVICE SINK FITTING, T-35 HOSE AND WALL HOOK, T-40 MOP HANGER, BP SPLASH CATCHER.	[75ø]	[12ø]	[12¢]	[75ø]	[38ø]
TSP1	ELECTRONIC TRAP SEAL PRIMING ASSEMBLY	_	3/4" [19ø]	-	_	_
	P.P.P. PTS-4 TRAP PRIMER - SURFACE MOUNTED, ELECTRONIC TRAP PRIMING ASSEMBLY, 3/4" NPT FEMALE INLET, SERVING 4 DRAINS (ID WIDTH 14" X HEIGHT 16" CABINET), 5/8" COMP. FOR 1/2" ID COPPER LINE OUTLET, 120 VOLT 60 HZ, 2 AMP CIRCUIT BREAKER, MANUAL OVER RIDE SWITCH/TEST BUTTON, TIMER, SOLENOID VALVE. CONTRACTOR TO CONFIRM MANIFOLD SIZING GIVEN SITE CONDITIONS.		[196]			


	DIFFUSER SCHEDULE					
TAG	MAKE/MODEL	FINISH	REMARKS			
Α	EH PRICE MODEL SCD 24/24 SQUARE S/A DIFFUSER	_	3 CONE, STEEL CONSTRUCTION FOR T-BAR LAY-IN. SIZE AND BALANCE AS INDICATED ON DRAWINGS.			
В	EH PRICE MODEL 530 LOUVERED FACE R/A GRILLE	_	STEEL CONSTRUCTION, 45° DEFLECTION, 3/4" BLADE SPACING, FOR SURFACE MOUNTING C/W OPPOSED BLADE DAMPER. SIZE AND BALANCE AS REQUIRED ON DRAWINGS.			
С	EH PRICE MODEL SCD 24/24 SQUARE S/A DIFFUSER	_	3 CONE, STEEL CONSTRUCTION FOR T-BAR LAY-IN C/W BALANCING DAMPER AT DIFFUSER NECK. SIZE AND BALANCE AS INDICATED ON DRAWINGS.			
D	EH PRICE MODEL 520 LOUVERED FACE S/A GRILLE	_	STEEL CONSTRUCTION, 3/4" BLADE SPACING, FRONT BLADES PARALLEL TO LONG DIMENSION, FOR SURFACE MOUNTING C/W OPPOSED BLADE DAMPER. SIZE AND BALANCE AS INDICATED ON DRAWINGS.			
NOTES:	L GRILLES, DIFFUSERS, ETC. AS P	L ER MECHA	ANICAL DRAWINGS.			


	FAN SCHEDULE													
TAG	MANU.	MODEL	LOCATION	SERVICE	CAP. (CFM [L/S])	ESP (IN.WC [PA])	RPM	DRIVE	TYPE	MOTOR (HP [W])	V/PH/HZ	STARTER	WEIGHT (LBS [KG])	REMARKS
EF-SAN	GREENHECK	SQ-120-VG	MECH. ROOM 217	SANITARY EXHAUST	1100 [520]	1.2 [299]	1638	DIRECT	CENTRIFUGAL BACKWARD INCLINED WHEEL BLOWER	1/2 [373]	115/1/60	H/O/A	61 [28]	CENTRIFUGAL BACKWARD INCLINED WHEEL BLOWER C/W BACKDRAFT DAMPER, SUPPORTS, HANGERS, VIBRATION ISOLATION, AND FLEXIBLE INLET AND OUTLET CONNECTIONS, DIRECT DRIVE INLINE FAN, GALVANIZED STEEL HOUSING. CONNECT TO EXISTING H/O/A PANEL.
EF-1	CARNES	VCDD025C	WR 123A	SANITARY EXHAUST	200 [94]	0.25 [62]	830	DIRECT	CEILING CABINET FAN	1/4 [169]	120/1/60	-	-	CABINET EXHAUST FAN C/W BACKDRAFT DAMPER, SUPPORTS, HANGERS, VIBRATION ISOLATION, AND FLEXIBLE OUTLET CONNECTIONS. PROVIDE SPEED CONTROLLER FOR FAN ADJUSTMENT AND MOUNT TO FAN HOUSING. CONNECT TO EXISTING FAN STARTER.


2. CONFIRM ALL FINISHES WITH ARCHITECT/INTERIOR DESIGNER.


I. ALL MOTORS, STARTERS, CONTACTORS, DISCONNECT SWITCHES AND CONTROL DEVICES SHALL BE PROVIDED BY DIV.23 AND INSTALLED BY DIV.26. 2. ALL LOW VOLTAGE WIRING TO BE PROVIDED BY DIV.23.


1. REFER TO ARCHITECT/INTERIOR DESIGNER'S DRAWINGS FOR SPECIFICATIONS OF PLUMBING FIXTURES NOT LISTED ON MECHANICAL DRAWINGS.

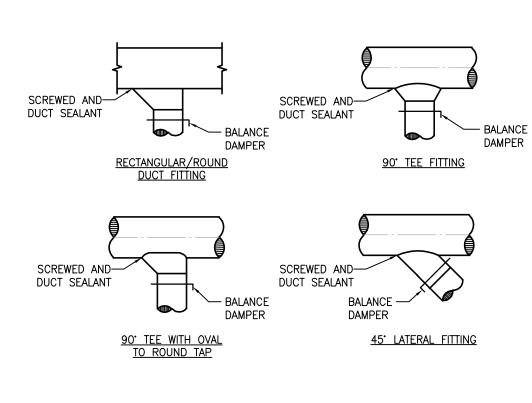


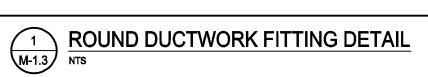


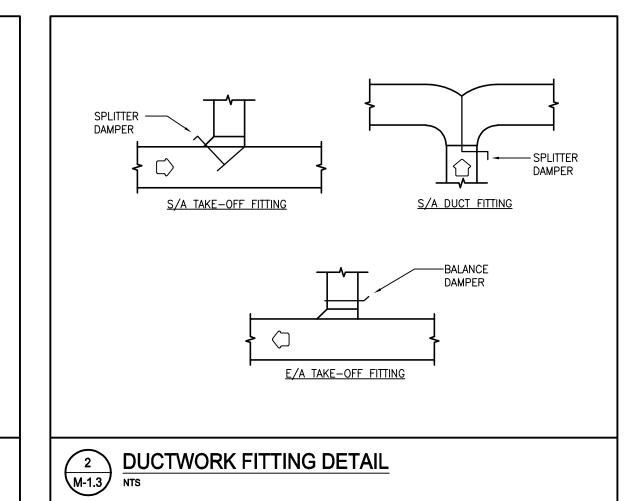


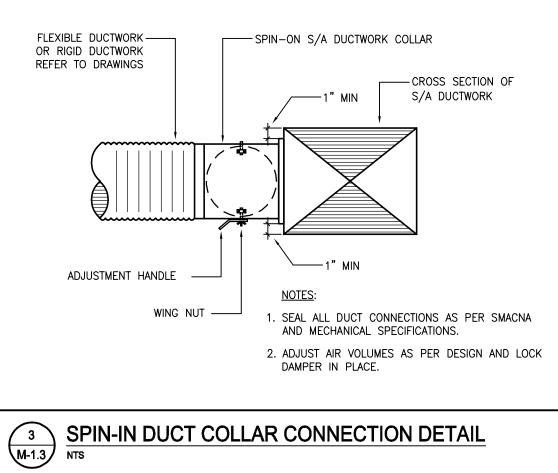

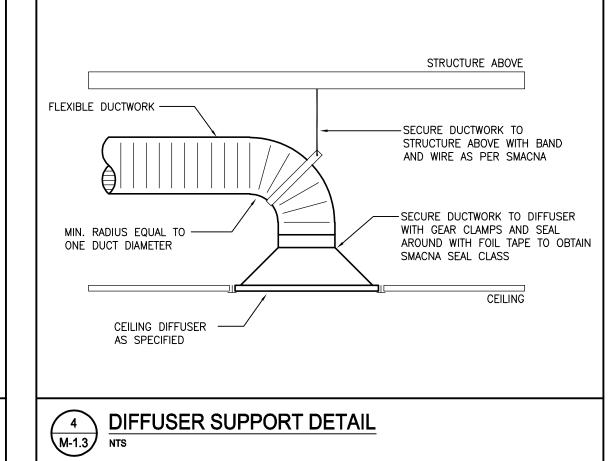

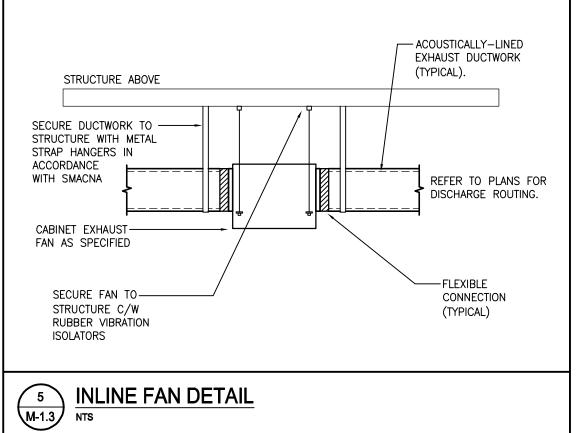

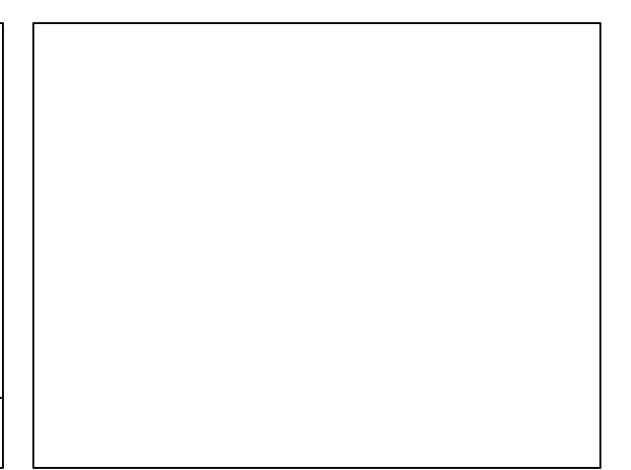

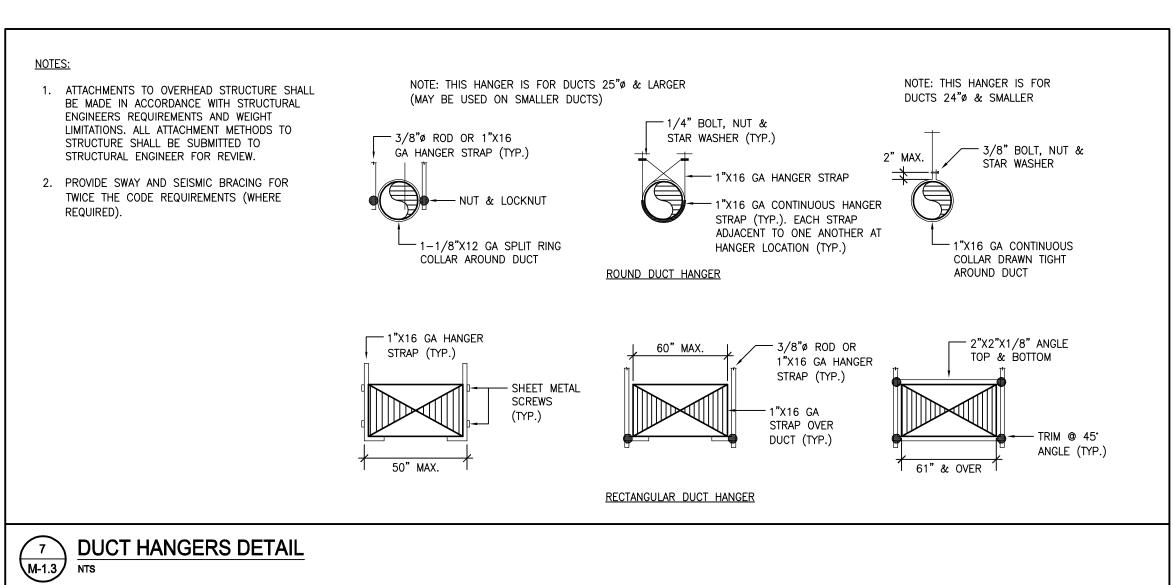



(905) 265 - 1052 i nfo@gi al I onardoeng. com www.giallonardoeng.com

This drawing is the property of GIALLONARDO ENGINEERING INC.

This drawing shall be read in conjunction with the architectural, structural, electrical and all other consultant's drawings prior to proceeding with the work. Do not scale the drawings.

The contractor is to verify and accept responsibility for all dimensions and conditions on site and must notify GIALLONARDO ENGINEERING INC. of any variations from the



NO.	ISSUES	DATE
1	ISSUED FOR REVIEW	MAR. 10 2025
2	ISSUED FOR TENDER	MAR. 19 2025
NO	REVISIONS	DATE


PROJECT:


RENOVATIONS AT ECOLE ELEMENTAIRE JEANNE-LAJOIE

150 CARNFORTH ROAD NORTH YORK, ONTARIO Conseil scolaire Viamond

DRAWING:

MECHANICAL SCHEDULES AND DETAILS

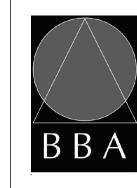

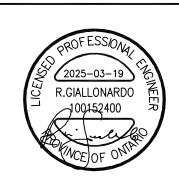

BARRY BRYAN ASSOCIATES Architects Engineers Project Managers 250 Water Street Suite 201 Whitby, Ontario L1N 0G5


% COMPLETE: DRAWN BY: CHECKED BY: JH JAN 2025

DESIGN BY:

SW

Tel: (905) 666-5252 AS SHOWN Fax: (905) 666-5256 e-mail: bba@bba-archeng.com

25-102 M-1.3

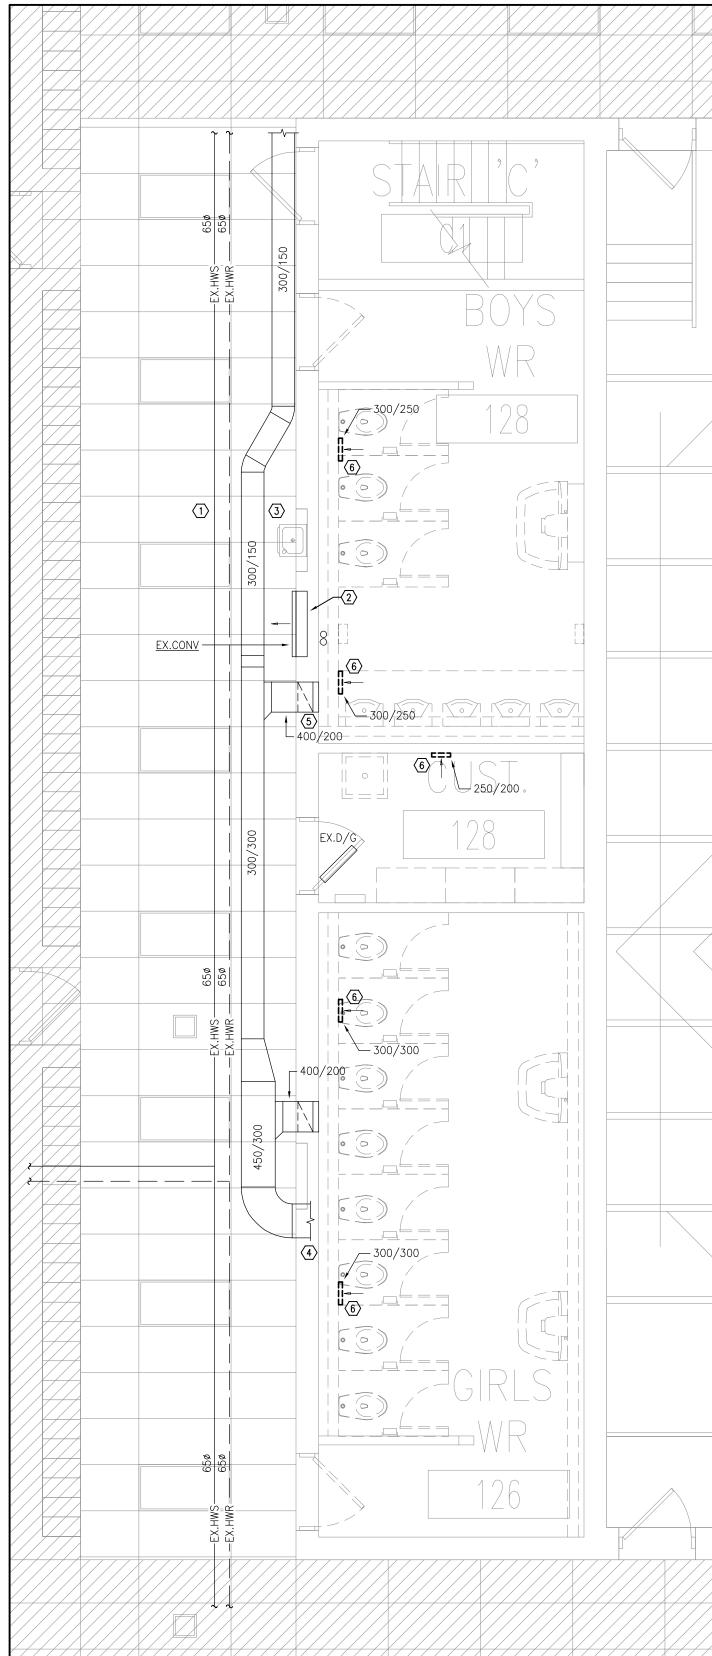


PART 1ST FLOOR DEMOLITION PLAN - HVAC M-2.1 1:50

HVAC NOTES

- (1) EXISTING HWS/HWR PIPING IN CORRIDOR CEILING SPACE TO REMAIN (TYPIĆAL).
- (2) EXISTING CABINET CONVECTOR UNIT TO REMAIN. EXISTING HWS/HWR PIPING IN PIPE CHASE TO BE REMOVED FROM CONVECTOR UNIT UP TO HIGH LEVEL.
- $\overline{3}$ EXISTING E/A DUCTWORK IN CORRIDOR CEILING SPACE TO REMAIN (TYPICAL).
- $\overline{\langle 4 \rangle}$ REFER TO DRAWING 2/M-2.1 FOR CONTINUATION OF DUCTWORK INTO MECHANICAL ROOM.
- (5) EXISTING E/A TAKE-OFF AND ASSOCIATED DUCT DROP WITHIN WALL TO REMAIN. PREPARE FOR CONNECTION OF NEW DUCTWORK. REFER TO NEW PLANS.
- (6) EXISTING E/A GRILLE TO BE REMOVED AND DISPOSED OF.

GENERAL HVAC NOTES

- . WHERE COMPONENTS ARE TO BE REUSED, THE CONTRACTOR SHALL CLEAN AND TEST THE COMPONENT TO ENSURE PROPER OPERATION. THE CONSULTANT SHALL BE NOTIFIED IN THE EVENT THERE IS A DEFICIENCY WITH THE COMPONENT.
- 2. PERFORM DEMOLITION WORK SO AS TO CAUSE MINIMAL DISTURBANCE TO OWNER AND/OR ADJACENT AREAS. MINIMIZE DUST AND NOISE AND PROVIDE TEMPORARY AIR FILTERS ON AIR HANDLING SYSTEMS AFFECT BY THE AREA OF WORK. ALL COSTS ASSOCIATED WITH DAMAGES AS A RESULT OF THE MECHANICAL DEMOLITION SHALL BE COVERED BY DIV.23. MAINTAIN SAFETY STANDARDS AND PROVIDE ADEQUATE SIGNAGE FOR BOTH WORKERS AND OCCUPANTS.
- 3. THE MECHANICAL DRAWINGS DISPLAY A GENERAL DESIGN AND INSTALLATION. THEREFORE, IF REQUIRED, THE CONTRACTOR SHALL OBTAIN CLARIFICATION FROM THE CONSULTANT PRIOR
- 4. THESE DRAWINGS HAVE BEEN PREPARED FOR DIV.23 AND DO NOT ACCURATELY DISPLAY ALL ELECTRICAL, STRUCTURAL AND ARCHITECTURAL ELEMENTS. REFER TO OTHER DIVISION'S DRAWINGS FOR CLARIFICATION.
- 5. THIS CONTRACTOR SHALL VISIT THE SITE AND COMPLETELY INVESTIGATE AND UNDERSTAND THE EXISTING CONDITIONS AND THEIR RELATION TO THE DESIGN DRAWINGS/DOCUMENTS. NO CONSIDERATION WILL BE GIVEN TO THE CONTRACTOR FOR ANY HINDRANCES TO THE MECHANICAL INSTALLATION FROM SITE CONDITIONS WHICH EXISTED PRIOR TO TENDER SUBMISSION. AS SUCH AND WHERE REQUIRED, THE CONTRACTOR SHALL PROVIDE INTERFERENCE DRAWINGS AND SHALL SUBMIT THEM TO THE CONSULTANT FOR REVIEW.

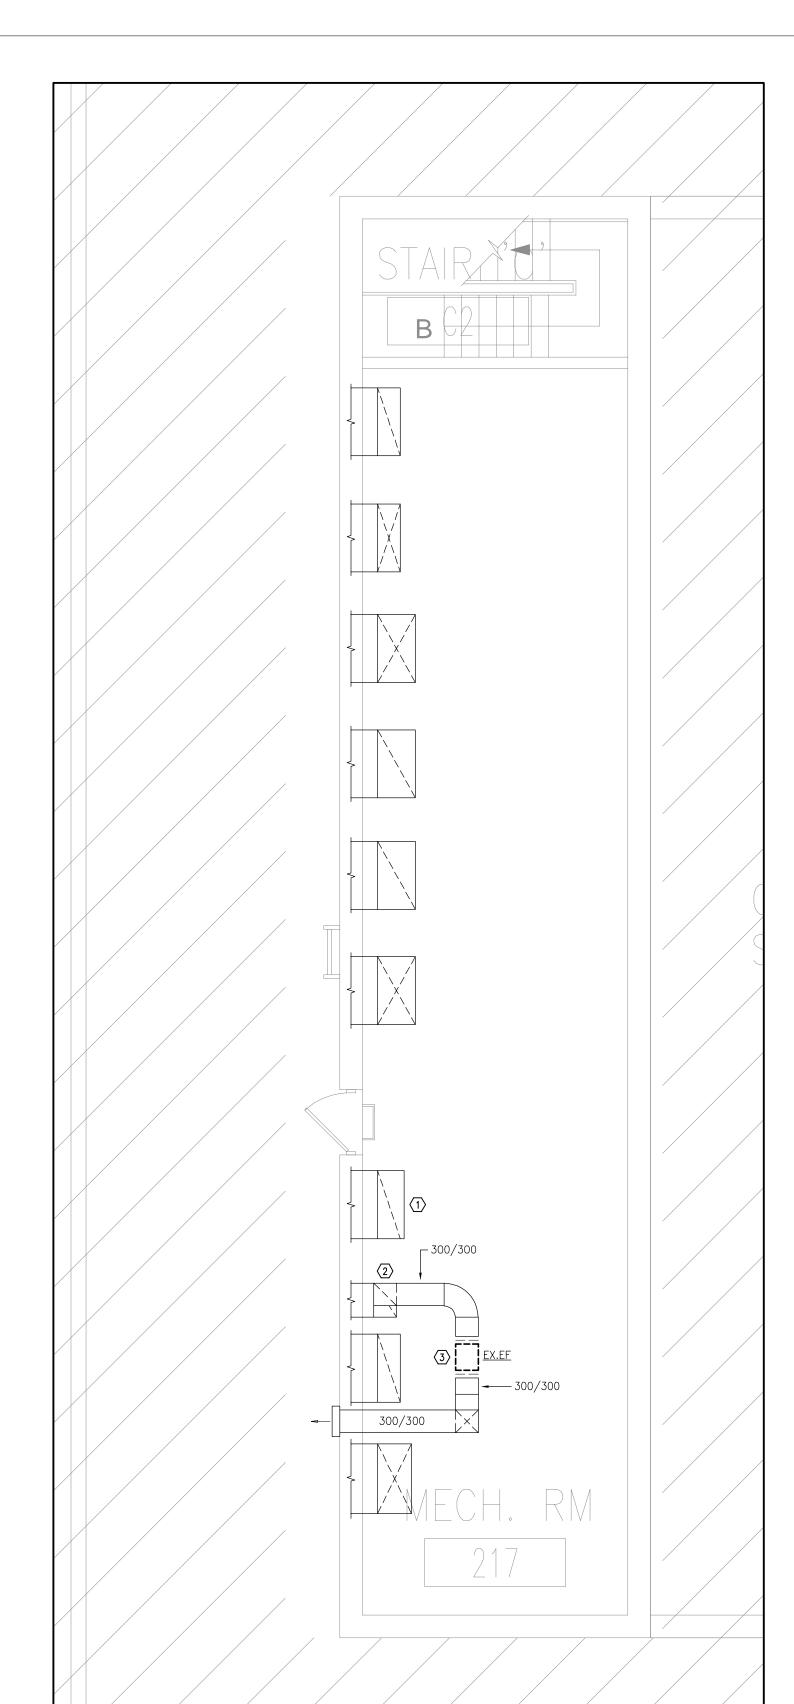

PART 2ND FLOOR MECH ROOM DEMOLITION PLAN - HVAC 2 M-2.1 PA 1:50

HVAC NOTES


1 EXISTING DUCT DROPS IN MECHANICAL ROOM TO REMAIN

(2) EXISTING SANITARY E/A DUCTWORK TO REMAIN (TYPICAL).

(3) EXISTING SANITARY EXHAUST FAN TO BE REMOVED AND DISPOSED OF. PREPARE DUCTWORK CONNECTION FOR CONNECTION OF NEW FAN. REFER TO NEW PLANS.

GENERAL HVAC NOTES

- . WHERE COMPONENTS ARE TO BE REUSED, THE CONTRACTOR SHALL CLEAN AND TEST THE COMPONENT TO ENSURE PROPER OPERATION. THE CONSULTANT SHALL BE NOTIFIED IN THE EVENT THERE IS A DEFICIENCY WITH THE COMPONENT.
- 2. PERFORM DEMOLITION WORK SO AS TO CAUSE MINIMAL DISTURBANCE TO OWNER AND/OR ADJACENT AREAS. MINIMIZE DUST AND NOISE AND PROVIDE TEMPORARY AIR FILTERS ON AIR HANDLING SYSTEMS AFFECT BY THE AREA OF WORK. ALL COSTS ASSOCIATED WITH DAMAGES AS A RESULT OF THE MECHANICAL DEMOLITION SHALL BE COVERED BY DIV.23. MAINTAIN SAFETY STANDARDS AND PROVIDE ADEQUATE SIGNAGE FOR BOTH WORKERS AND OCCUPANTS.
- 3. THE MECHANICAL DRAWINGS DISPLAY A GENERAL DESIGN AND INSTALLATION. THEREFORE, IF REQUIRED, THE CONTRACTOR SHALL OBTAIN CLARIFICATION FROM THE CONSULTANT PRIOR
- 4. THESE DRAWINGS HAVE BEEN PREPARED FOR DIV.23 AND DO NOT ACCURATELY DISPLAY ALL ELECTRICAL, STRUCTURAL AND ARCHITECTURAL ELEMENTS. REFER TO OTHER DIVISION'S DRAWINGS FOR CLARIFICATION.
- 5. THIS CONTRACTOR SHALL VISIT THE SITE AND COMPLETELY INVESTIGATE AND UNDERSTAND THE EXISTING CONDITIONS AND THEIR RELATION TO THE DESIGN DRAWINGS/DOCUMENTS. NO CONSIDERATION WILL BE GIVEN TO THE CONTRACTOR FOR ANY HINDRANCES TO THE MECHANICAL INSTALLATION FROM SITE CONDITIONS WHICH EXISTED PRIOR TO TENDER SUBMISSION. AS SUCH AND WHERE REQUIRED, THE CONTRACTOR SHALL PROVIDE INTERFERENCE DRAWINGS AND SHALL SUBMIT THEM TO THE CONSULTANT FOR REVIEW.

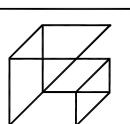

Giallonardo — Engineering Inc. 220-4550 Highway 7 Woodbridge, ON (905) 265 - 1052 i nfo@gi al I onardoeng. com www.giallonardoeng.com

This drawing is the property of GIALLONARDO ENGINEERING INC.

This drawing shall be read in conjunction with the architectural, structural, electrical and all other consultant's drawings prior to proceeding with the work. Do not scale the drawings.

The contractor is to verify and accept responsibility for all dimensions and conditions on site and must notify GIALLONARDO ENGINEERING INC. of any variations from the



NO.	ISSUES	DATE	BY
1	ISSUED FOR REVIEW	MAR. 10 2025	RC
2	ISSUED FOR TENDER	MAR. 19 2025	SW
NO.	REVISIONS	DATE	BY

PROJECT:

RENOVATIONS AT ECOLE ELEMENTAIRE JEANNE-LAJOIE

150 CARNFORTH ROAD NORTH YORK, ONTARIO Conseil scolaire Viamond

DRAWING:

PART 1ST & 2ND FLOOR **DEMOLITION PLAN -**HVAC





% COMPLETE:

DESIGN BY:


CHECKED BY:

BARRY BRYAN ASSOCIATES Engineers Project Managers

250 Water Street Whitby, Ontario L1N 0G5

Tel: (905) 666-5252 Fax: (905) 666-5256

JAN 2025 AS SHOWN

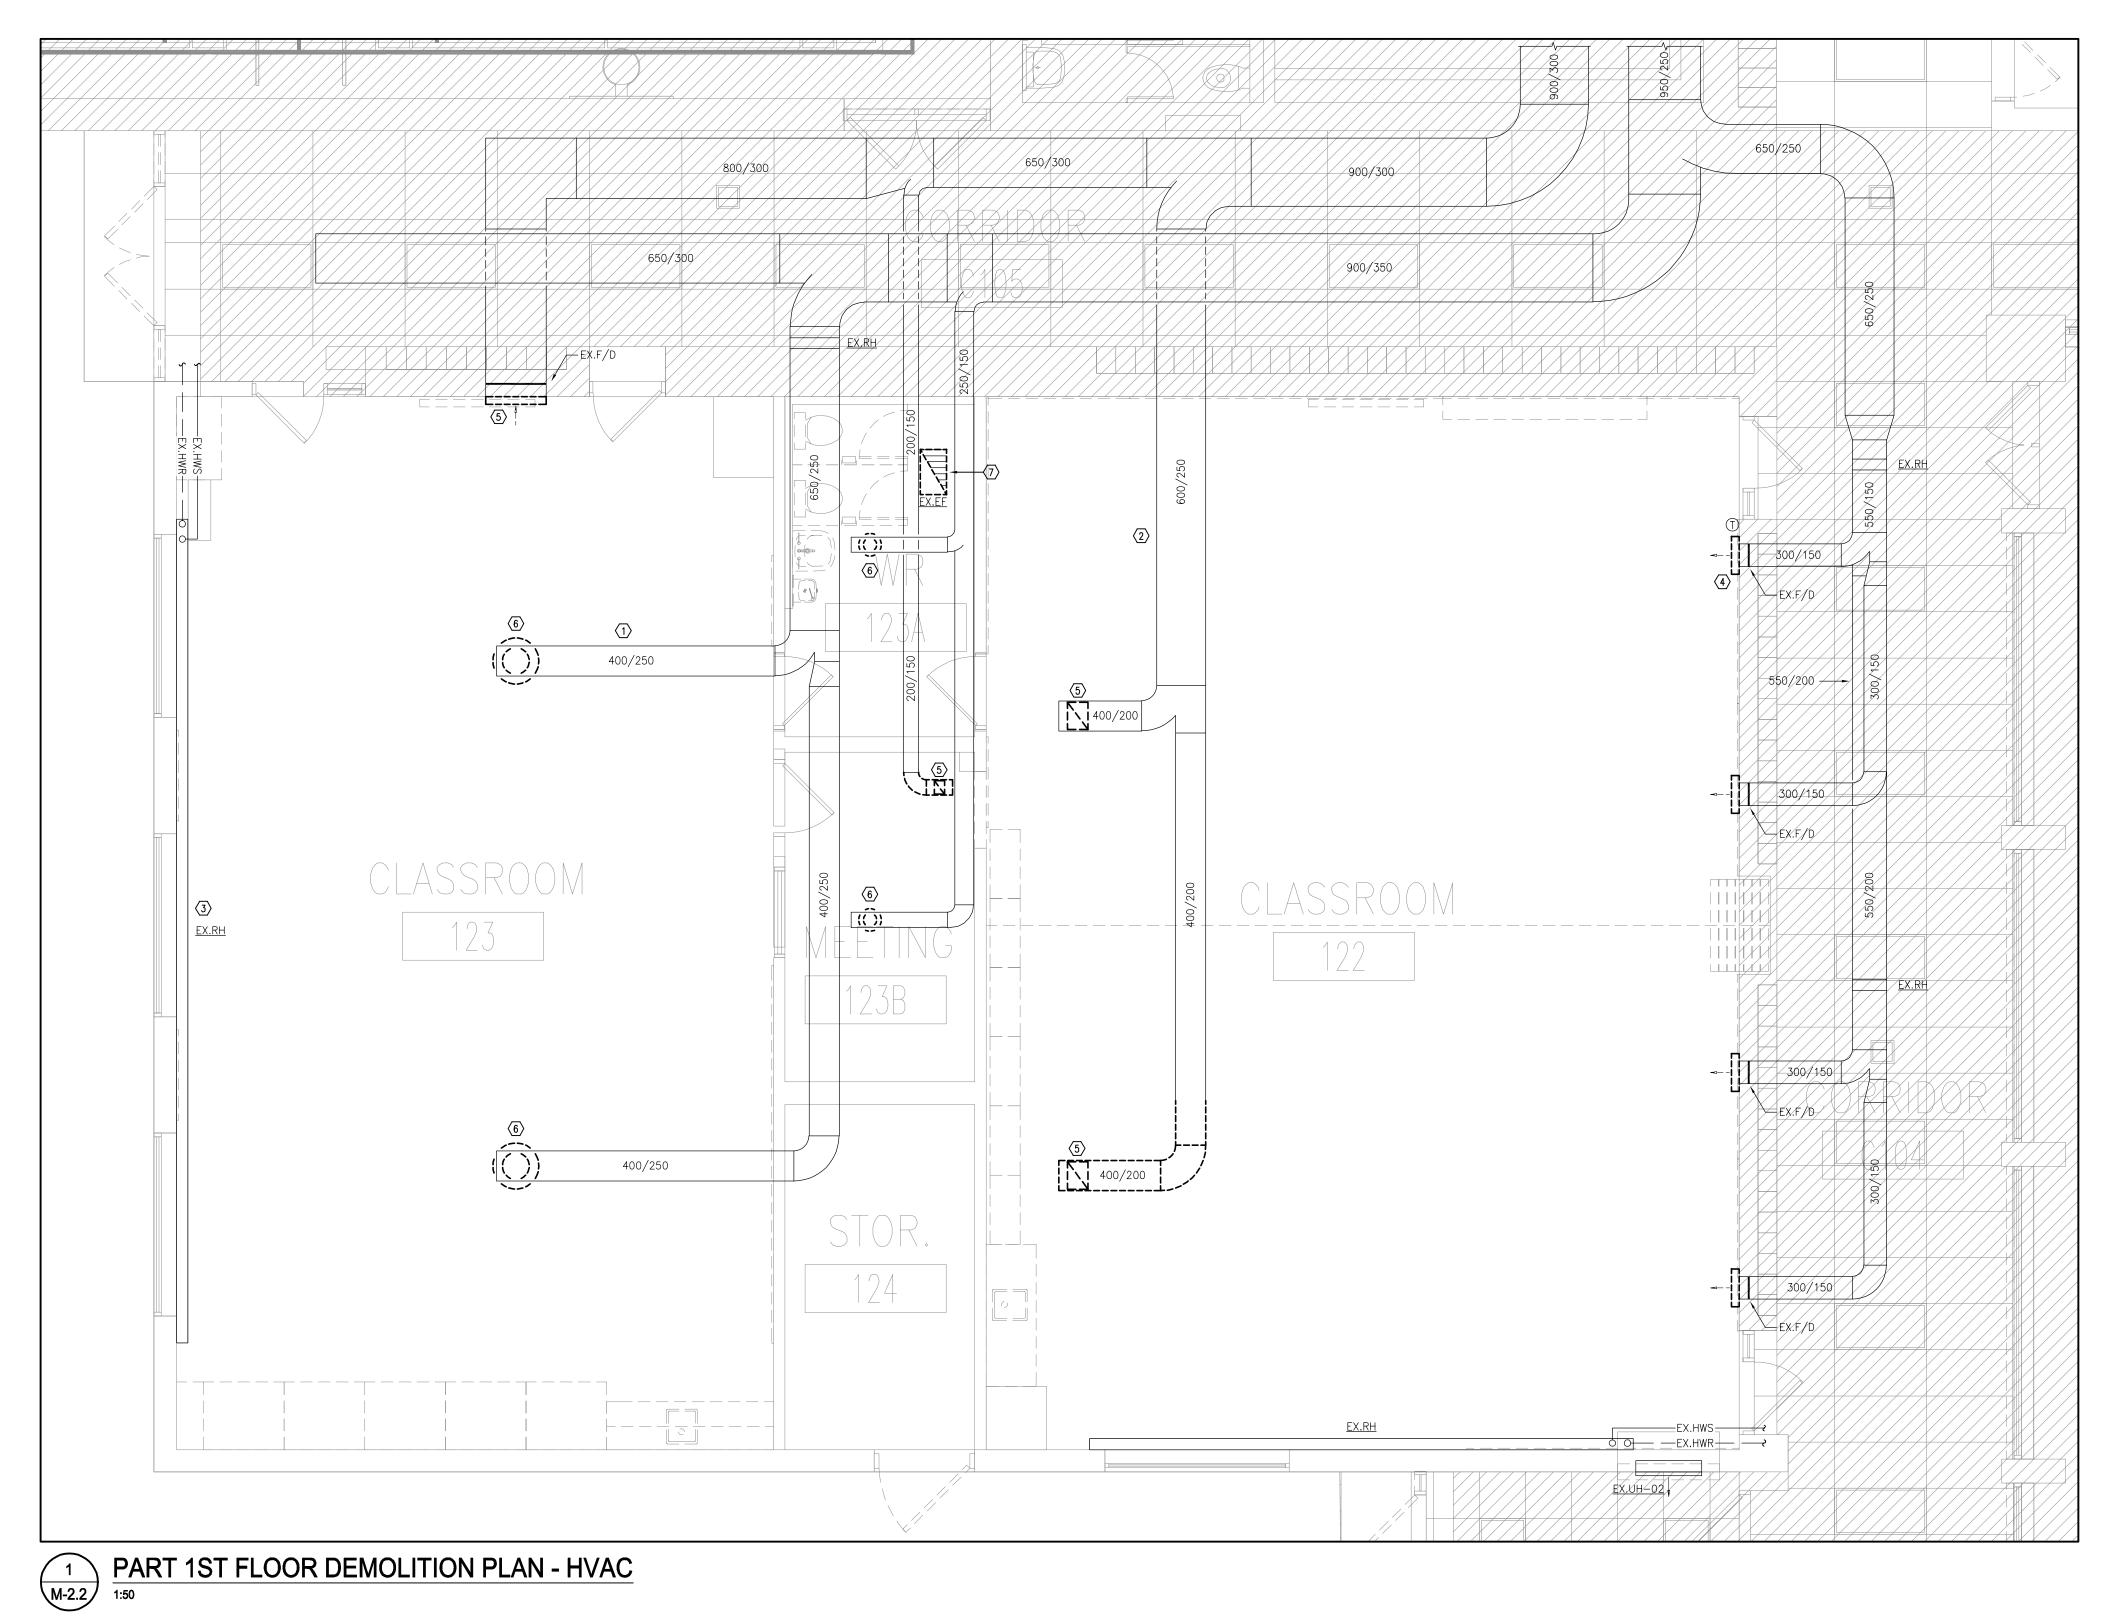


HVAC NOTES

- 1 EXISTING S/A DUCTWORK IN CEILING SPACE TO REMAIN
- (2) EXISTING R/A DUCTWORK IN CEILING SPACE TO REMAIN
- (3) EXISTING WALL FIN HEATER TO REMAIN (TYPICAL).
- (4) EXISTING WALL MOUNTED S/A GRILLE TO BE REMOVED AND DISPOSED OF. PREPARE FOR CONNECTION OF NEW GRILLE, REFER TO NEW PLANS (TYPICAL).
- (5) EXISTING R/A GRILLE TO BE REMOVED AND DISPOSED OF. PREPARE DUCTWORK FOR CONNECTION OF NEW GRILLE. REFER TO NEW PLANS.
- 6 EXISTING S/A DIFFUSER TO BE REMOVED AND DISPOSED OF. CAP DUCTWORK AT MAIN IN CEILING SPACE.
- (7) EXISTING CABINET EXHAUST FAN TO BE REMOVED AND DISPOSED OF. PREPARE DUCTWORK IN CEILING SPACE FOR CONNECTION TO NEW FAN. REFER TO NEW PLANS.

GENERAL HVAC NOTES

- WHERE COMPONENTS ARE TO BE REUSED, THE CONTRACTOR SHALL CLEAN AND TEST THE COMPONENT TO ENSURE PROPER OPERATION. THE CONSULTANT SHALL BE NOTIFIED IN THE EVENT THERE IS A DEFICIENCY WITH THE COMPONENT.
- 2. PERFORM DEMOLITION WORK SO AS TO CAUSE MINIMAL DISTURBANCE TO OWNER AND/OR ADJACENT AREAS. MINIMIZE DUST AND NOISE AND PROVIDE TEMPORARY AIR FILTERS ON AIR HANDLING SYSTEMS AFFECT BY THE AREA OF WORK. ALL COSTS ASSOCIATED WITH DAMAGES AS A RESULT OF THE MECHANICAL DEMOLITION SHALL BE COVERED BY DIV.23. MAINTAIN SAFETY STANDARDS AND PROVIDE ADEQUATE SIGNAGE FOR BOTH WORKERS AND OCCUPANTS.
- 3. THE MECHANICAL DRAWINGS DISPLAY A GENERAL DESIGN AND INSTALLATION. THEREFORE, IF REQUIRED, THE CONTRACTOR SHALL OBTAIN CLARIFICATION FROM THE CONSULTANT PRIOR TO INSTALLATION.
- 4. THESE DRAWINGS HAVE BEEN PREPARED FOR DIV.23 AND DO NOT ACCURATELY DISPLAY ALL ELECTRICAL, STRUCTURAL AND ARCHITECTURAL ELEMENTS. REFER TO OTHER DIVISION'S DRAWINGS FOR CLARIFICATION.
- 5. THIS CONTRACTOR SHALL VISIT THE SITE AND COMPLETELY INVESTIGATE AND UNDERSTAND THE EXISTING CONDITIONS AND THEIR RELATION TO THE DESIGN DRAWINGS/DOCUMENTS. NO CONSIDERATION WILL BE GIVEN TO THE CONTRACTOR FOR ANY HINDRANCES TO THE MECHANICAL INSTALLATION FROM SITE CONDITIONS WHICH EXISTED PRIOR TO TENDER SUBMISSION. AS SUCH AND WHERE REQUIRED, THE CONTRACTOR SHALL PROVIDE INTERFERENCE DRAWINGS AND SHALL SUBMIT THEM TO THE CONSULTANT FOR REVIEW.

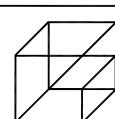

Giallonardo — Engineering Inc. 220-4550 Highway 7 Woodbridge, ON L4L 4Y7 (905) 265 - 1052 i nfo@gi al I onardoeng. com www.giallonardoeng.com

This drawing is the property of GIALLONARDO ENGINEERING INC.

This drawing shall be read in conjunction with the architectural, structural, electrical and all other consultant's drawings prior to

proceeding with the work. Do not scale the drawings.

The contractor is to verify and accept responsibility for all dimensions and conditions on site and must notify GIALLONARDO ENGINEERING INC. of any variations from the



NO.	ISSUES	DATE	ВҮ
1	ISSUED FOR REVIEW	MAR. 10 2025	RC
2	ISSUED FOR TENDER	MAR. 19 2025	SW
NO.	REVISIONS	DATE	BY

PROJECT:

RENOVATIONS AT ECOLE ELEMENTAIRE JEANNE-LAJOIE

150 CARNFORTH ROAD NORTH YORK, ONTARIO Conseil scolaire Viamond

DRAWING:

PART 1ST FLOOR DEMOLITION PLAN -HVAC





% COMPLETE:

BARRY BRYAN ASSOCIATES Architects Engineers Project Managers


250 Water Street Suite 201 Whitby, Ontario L1N 0G5

Tel: (905) 666-5252 Fax: (905) 666-5256 e-mail: bba@bba-archeng.com

JAN 2025 AS SHOWN

DESIGN BY: **SW**

CHECKED BY:

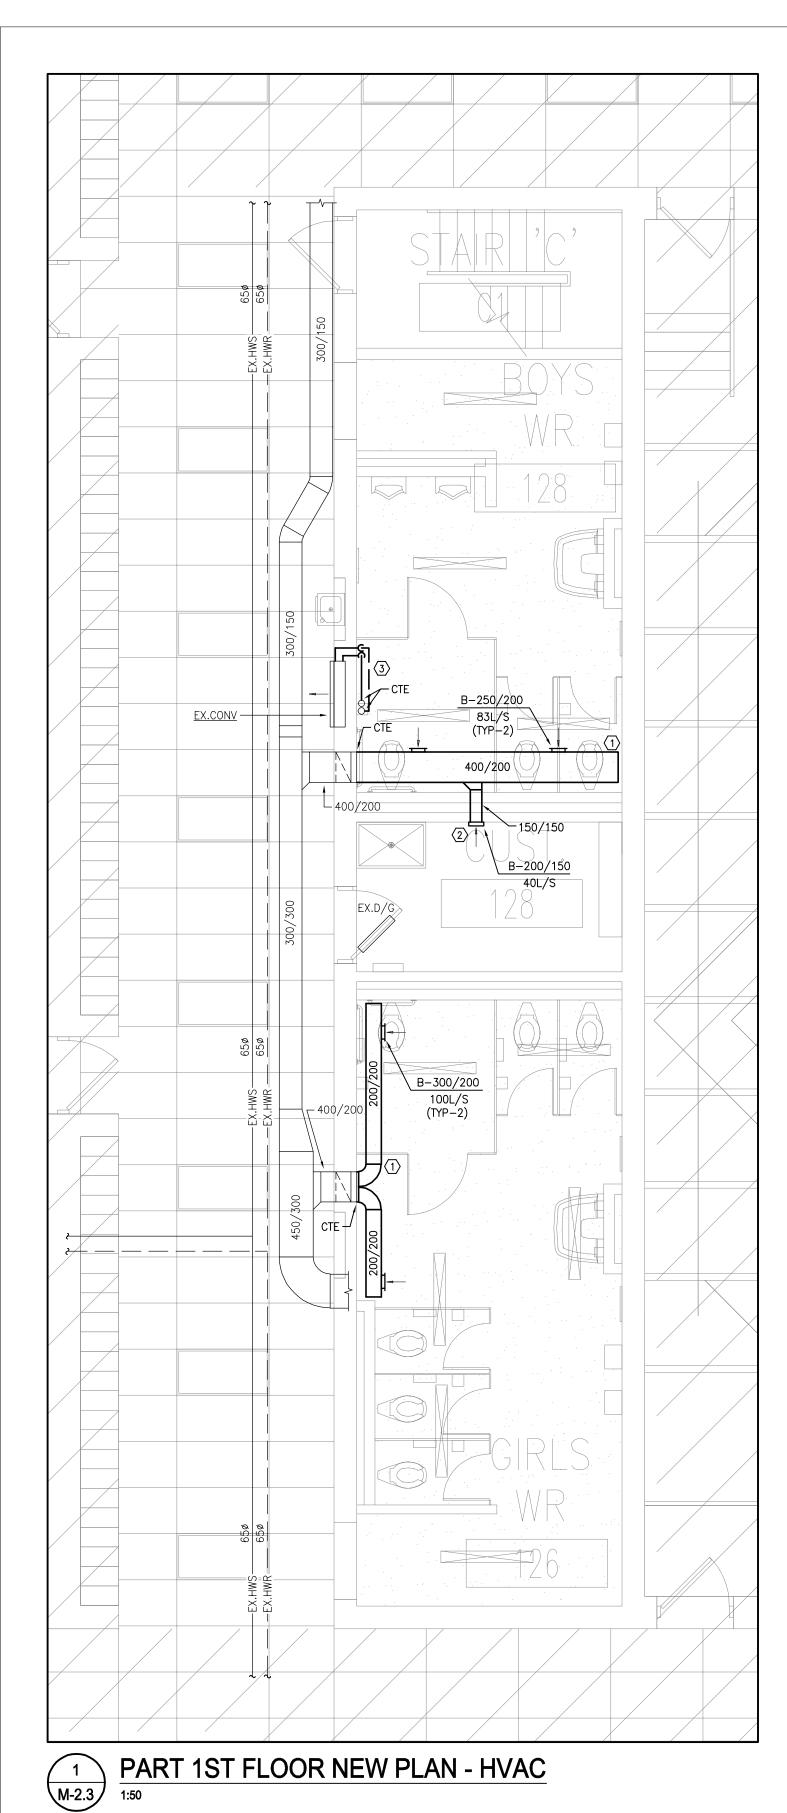

HVAC NOTES


1) PROVIDE NEW E/A DUCTWORK IN BULKHEAD. CONNECT TO EXISTING DUCT PENETRATION AT WALL AS SHOWN. (2) PROVIDE NEW E/A GRILLE AS SPECIFIED. SIZE AND

BALANCE AS INDICATED (TYPICAL).

(3) CONNECT NEW HWS/HWR PIPING TO EXISTING AT HIGH LEVEL, OFFSET PIPING AT CEILING AND DROP DOWN TO CABINET CONVECTOR UNIT WHERE SHOWN. RECONNECT TO EXISTING HWS/HWR CONNECTIONS AT UNIT.

GENERAL HVAC NOTES

- . THE MECHANICAL DRAWINGS DISPLAY A GENERAL DESIGN AND INSTALLATION. THEREFORE, IF REQUIRED, THE CONTRACTOR SHALL OBTAIN CLARIFICATION FROM THE CONSULTANT PRIOR TO INSTALLATION.
- . THESE DRAWINGS HAVE BEEN PREPARED FOR DIV.23 AND DO NOT ACCURATELY DISPLAY ALL ELECTRICAL, STRUCTURAL AND ARCHITECTURAL ELEMENTS. REFER TO OTHER DIVISION'S DRAWINGS FOR CLARIFICATION.
- THIS CONTRACTOR SHALL VISIT THE SITE AND COMPLETELY INVESTIGATE AND UNDERSTAND THE EXISTING CONDITIONS AND THEIR RELATION TO THE DESIGN DRAWINGS/DOCUMENTS. NO CONSIDERATION WILL BE GIVEN TO THE CONTRACTOR FOR ANY HINDRANCES TO THE MECHANICAL INSTALLATION FROM SITE CONDITIONS WHICH EXISTED PRIOR TO TENDER SUBMISSION. AS SUCH AND WHERE REQUIRED, THE CONTRACTOR SHALL PROVIDE INTERFERENCE DRAWINGS AND SHALL SUBMIT THEM TO THE CONSULTANT FOR REVIEW.

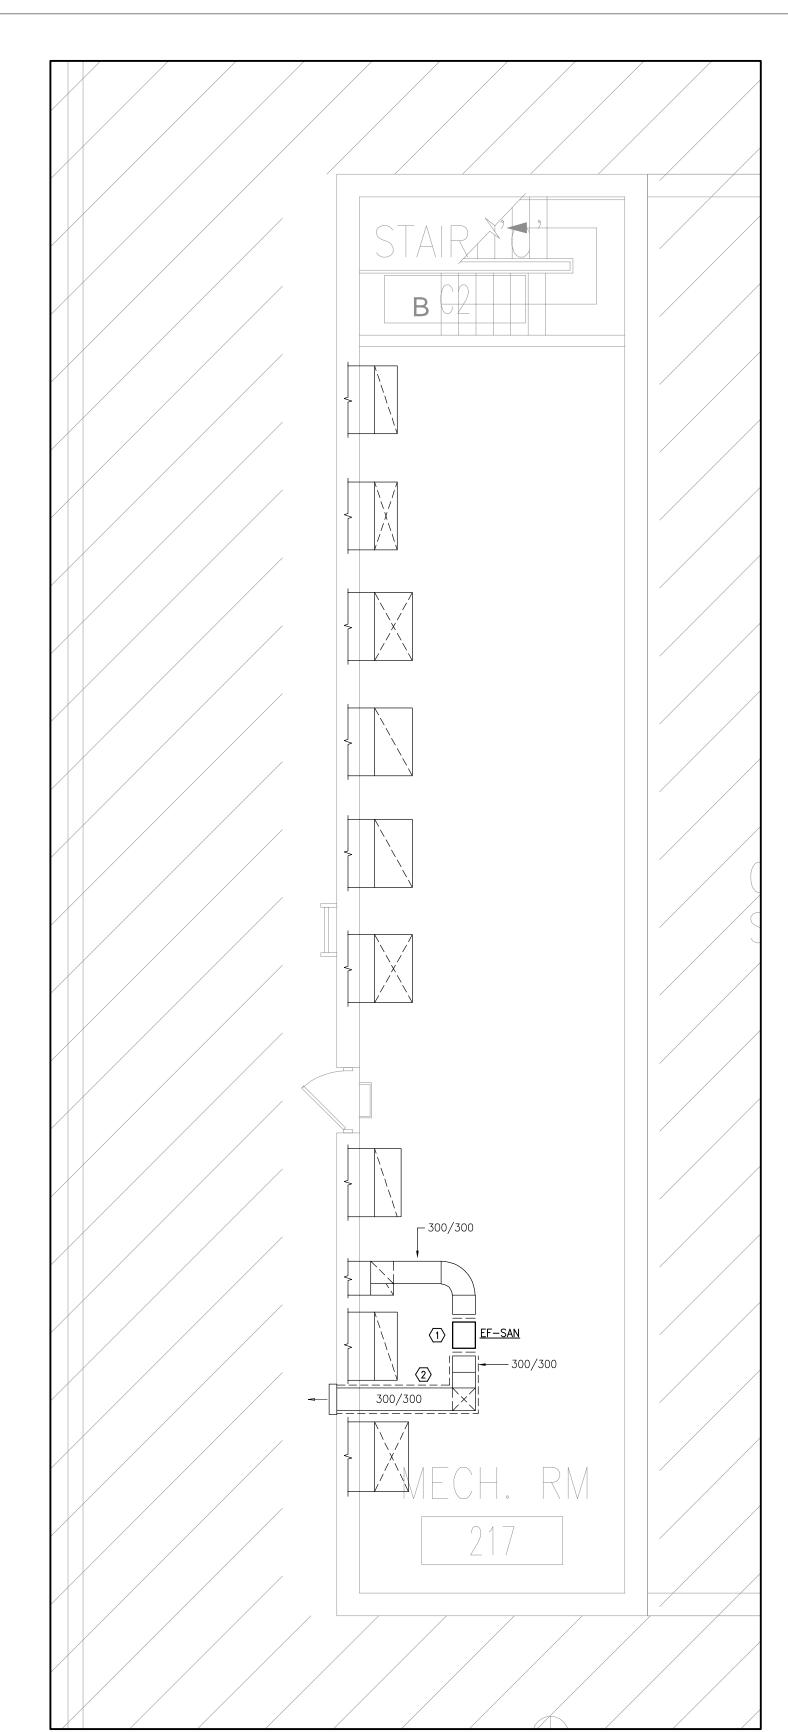

PART 2ND FLOOR MECH ROOM NEW PLAN - HVAC 2 M-2.3 PA 1:50

HVAC NOTES

(1) PROVIDE NEW INLINE EXHAUST FAN AS SPECIFIED C/W NEW FLEXIBLE DUCT CONNECTIONS. CONNECT TO EXISTING E/A DUCTWORK IN MECHANICAL ROOM AS SHOWN AND MODIFY EXISTING DUCTWORK AS REQUIRED TO SUIT NEW INLET/OUTLET CONNECTIONS. CONNECT FAN TO EXISTING H/O/A PANEL FOR BAS CONTROL. CONTRACTOR TO CONFIRM EXACT LOCATION OF EXISTING H/O/A PANEL ON

2 PROVIDE NEW THERMAL INSULATION ON E/A DUCTWORK FROM FAN OUTLET TO WALL PENETRATION.

GENERAL HVAC NOTES


1. WHERE COMPONENTS ARE TO BE REUSED, THE CONTRACTOR SHALL CLEAN AND TEST THE COMPONENT TO ENSURE PROPER OPERATION. THE CONSULTANT SHALL BE NOTIFIED IN THE EVENT THERE IS A DEFICIENCY WITH THE COMPONENT.

2. PERFORM DEMOLITION WORK SO AS TO CAUSE MINIMAL DISTURBANCE TO OWNER AND/OR ADJACENT AREAS. MINIMIZE DUST AND NOISE AND PROVIDE TEMPORARY AIR FILTERS ON AIR HANDLING SYSTEMS AFFECT BY THE AREA OF WORK. ALL COSTS ASSOCIATED WITH DAMAGES AS A RESULT OF THE MECHANICAL DEMOLITION SHALL BE COVERED BY DIV.23. MAINTAIN SAFETY STANDARDS AND PROVIDE ADEQUATE SIGNAGE FOR BOTH WORKERS AND OCCUPANTS.

3. THE MECHANICAL DRAWINGS DISPLAY A GENERAL DESIGN AND INSTALLATION. THEREFORE, IF REQUIRED, THE CONTRACTOR SHALL OBTAIN CLARIFICATION FROM THE CONSULTANT PRIOR TO INSTALLATION.

4. THESE DRAWINGS HAVE BEEN PREPARED FOR DIV.23 AND DO NOT ACCURATELY DISPLAY ALL ELECTRICAL, STRUCTURAL AND ARCHITECTURAL ELEMENTS. REFER TO OTHER DIVISION'S DRAWINGS FOR CLARIFICATION.

5. THIS CONTRACTOR SHALL VISIT THE SITE AND COMPLETELY INVESTIGATE AND UNDERSTAND THE EXISTING CONDITIONS AND THEIR RELATION TO THE DESIGN DRAWINGS/DOCUMENTS. NO CONSIDERATION WILL BE GIVEN TO THE CONTRACTOR FOR ANY HINDRANCES TO THE MECHANICAL INSTALLATION FROM SITE CONDITIONS WHICH EXISTED PRIOR TO TENDER SUBMISSION. AS SUCH AND WHERE REQUIRED, THE CONTRACTOR SHALL PROVIDE INTERFERENCE DRAWINGS AND SHALL SUBMIT THEM TO THE CONSULTANT FOR REVIEW.

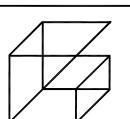

Giallonardo — Engineering Inc. 220-4550 Highway 7 Woodbridge, ON L4L 4Y7 (905)265-1052 i nfo@gi al Í onardoeng.com www.giallonardoeng.com

This drawing is the property of GIALLONARDO ENGINEERING INC.

This drawing shall be read in conjunction with the architectural, structural, electrical and all other consultant's drawings prior to proceeding with the work. Do not scale the drawings.

The contractor is to verify and accept responsibility for all dimensions and conditions on site and must notify GIALLONARDO ENGINEERING INC. of any variations from the



NO.	ISSUES	DATE	ВҮ
1	ISSUED FOR REVIEW	MAR. 10 2025	RC
2	ISSUED FOR TENDER	MAR. 19 2025	SW
NO.	REVISIONS	DATE	ВҮ

PROJECT:

RENOVATIONS AT ECOLE ELEMENTAIRE JEANNE-LAJOIE

150 CARNFORTH ROAD NORTH YORK, ONTARIO Conseil scolaire Viamond

DRAWING:

PART 1ST & 2ND FLOOR NEW PLAN - HVAC





% COMPLETE:

BARRY BRYAN ASSOCIATES Engineers Project Managers

250 Water Street Suite 201 Whitby, Ontario L1N 0G5


Tel: (905) 666-5252 Fax: (905) 666-5256 e-mail: bba@bba-archeng.com

JAN 2025 AS SHOWN

DESIGN BY: **SW**

DRAWN BY:

CHECKED BY:

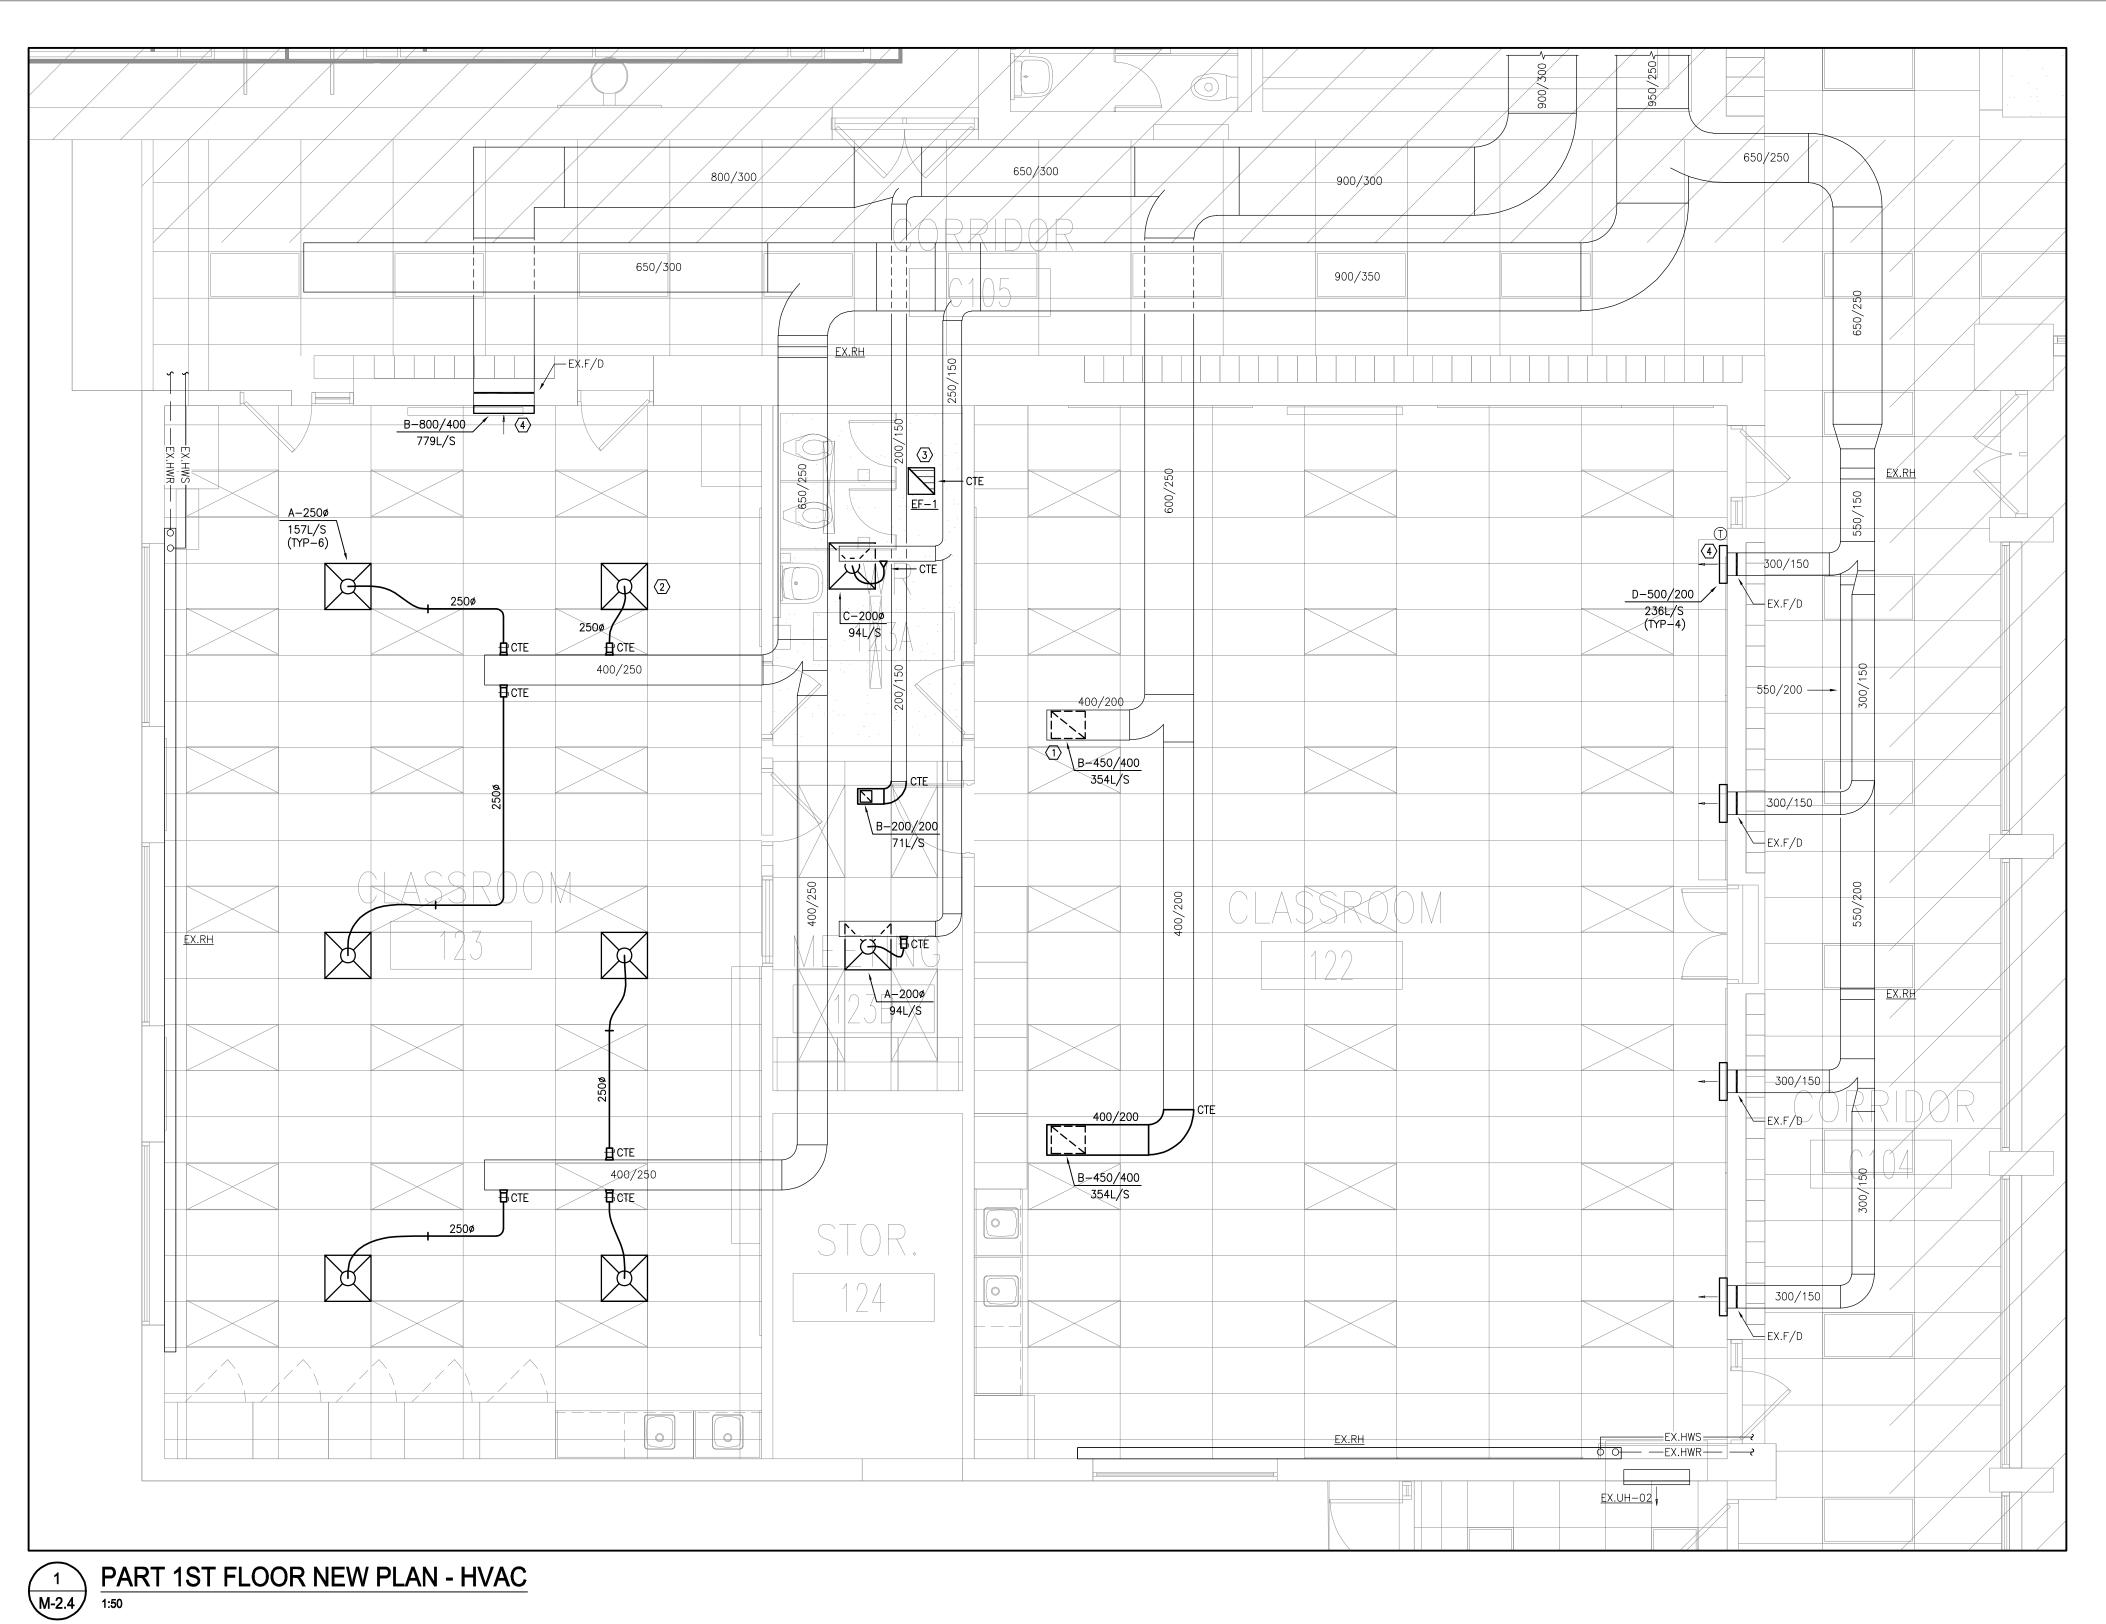


HVAC NOTES

- (1) PROVIDE NEW R/A GRILLE AS SPECIFIED. PROVIDE NEW/MODIFY EXISTING DUCTWORK TO SUIT NEW CEILING. SIZE AS INDICATED (TYPICAL).
- 2 PROVIDE NEW S/A DIFFUSER AS SPECIFIED. CONNECT TO EXISTING S/A DUCTWORK IN CEILING SPACE. SIZE AND BALANCE AS INDICATED (TYPICAL).
- (3) PROVIDE NEW CABINET EXHAUST FAN AS SPECIFIED.
 CONNECT TO EXISTING DUCTWORK IN CEILING SPACE. REFER
- 4 PROVIDE NEW LOUVERED FACE GRILLE AS SPECIFIED IN EXISTING WALL OPENING, CONNECT TO EXISTING DUCTWORK. SIZE AND BALANCE AS INDICATED (TYPICAL).

GENERAL HVAC NOTES

- THE MECHANICAL DRAWINGS DISPLAY A GENERAL DESIGN AND INSTALLATION. THEREFORE, IF REQUIRED, THE CONTRACTOR SHALL OBTAIN CLARIFICATION FROM THE CONSULTANT PRIOR TO INSTALLATION.
- THESE DRAWINGS HAVE BEEN PREPARED FOR DIV.23 AND DO NOT ACCURATELY DISPLAY ALL ELECTRICAL, STRUCTURAL AND ARCHITECTURAL ELEMENTS. REFER TO OTHER DIVISION'S DRAWINGS FOR CLARIFICATION.
- THIS CONTRACTOR SHALL VISIT THE SITE AND COMPLETELY INVESTIGATE AND UNDERSTAND THE EXISTING CONDITIONS AND THEIR RELATION TO THE DESIGN DRAWINGS/DOCUMENTS. NO CONSIDERATION WILL BE GIVEN TO THE CONTRACTOR FOR ANY HINDRANCES TO THE MECHANICAL INSTALLATION FROM SITE CONDITIONS WHICH EXISTED PRIOR TO TENDER SUBMISSION. AS SUCH AND WHERE REQUIRED, THE CONTRACTOR SHALL PROVIDE INTERFERENCE DRAWINGS AND SHALL SUBMIT THEM TO THE CONSULTANT FOR REVIEW.

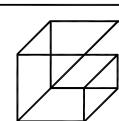

Giallonardo — Engineering Inc. 220-4550 Highway 7 Woodbridge, ON L4L 4Y7 (905)265-1052 i nfo@gi alĺonardoeng.com www.giallonardoeng.com

This drawing is the property of GIALLONARDO ENGINEERING INC.

This drawing shall be read in conjunction with the architectural, structural, electrical and all other consultant's drawings prior to proceeding with the work. Do not scale the drawings.

The contractor is to verify and accept responsibility for all dimensions and conditions on site and must notify GIALLONARDO ENGINEERING INC. of any variations from the



NO.	ISSUES	DATE	ВҮ
1	ISSUED FOR REVIEW	MAR. 10 2025	RC
2	ISSUED FOR TENDER	MAR. 19 2025	SW
NO.	REVISIONS	DATE	ВҮ


PROJECT:

RENOVATIONS AT ECOLE ELEMENTAIRE JEANNE-LAJOIE

150 CARNFORTH ROAD NORTH YORK, ONTARIO Conseil scolaire Viamond

DRAWING:

PART 1ST FLOOR NEW PLAN - HVAC

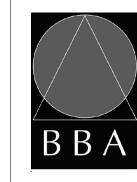



% COMPLETE:

DESIGN BY:

DRAWN BY:

JH


CHECKED BY:

BARRY BRYAN ASSOCIATES

Architects Engineers Project Managers 250 Water Street Suite 201 Whitby, Ontario L1N 0G5

Tel: (905) 666-5252 Fax: (905) 666-5256 e-mail: bba@bba-archeng.com

JAN 2025 AS SHOWN

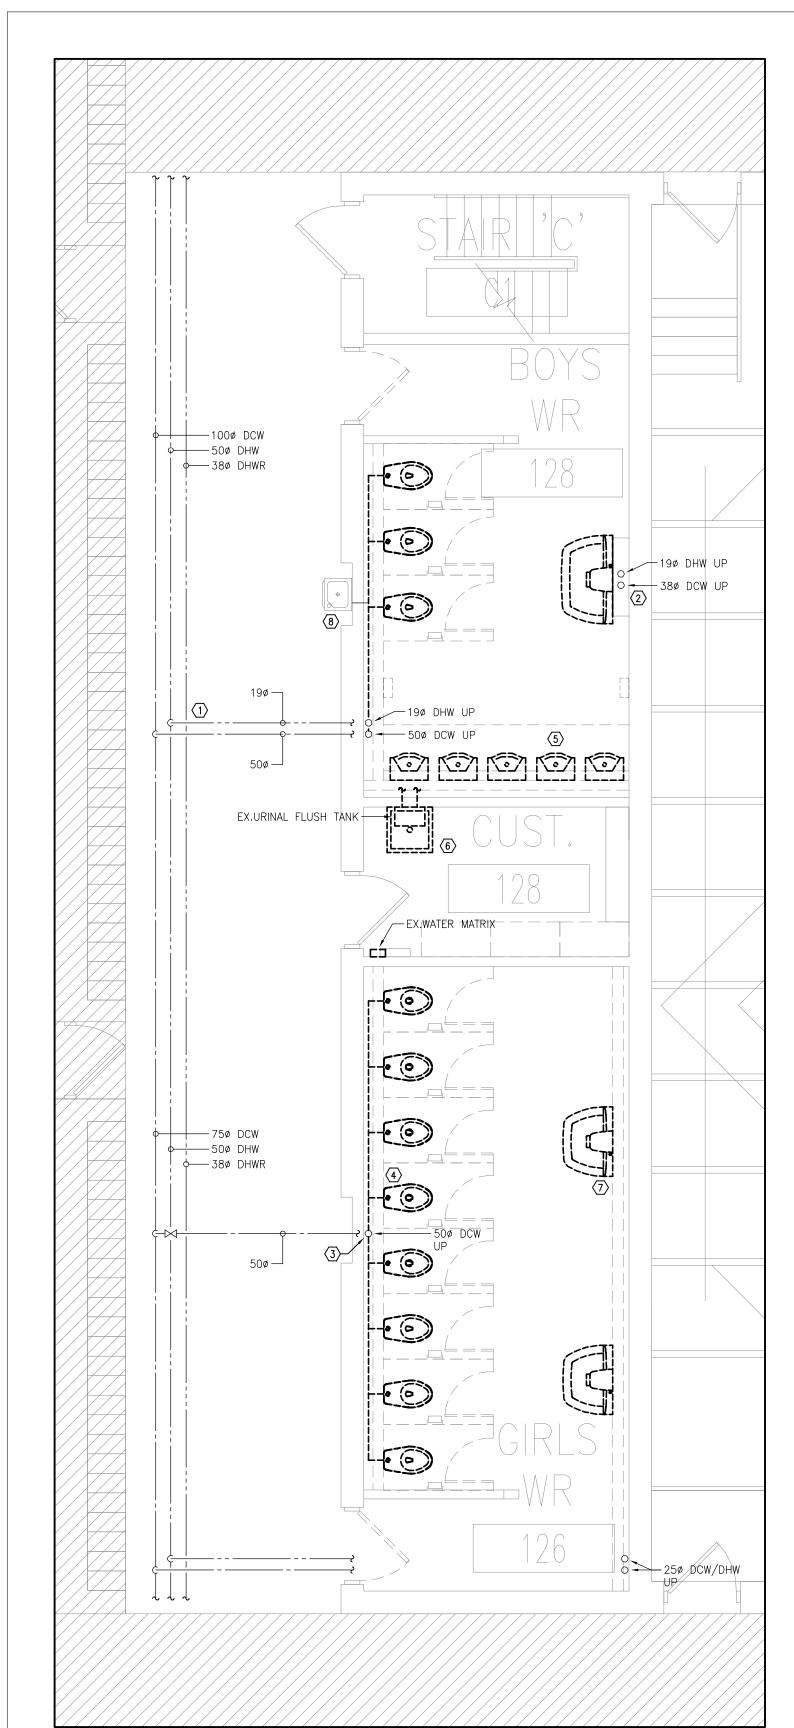

PART 1ST FLOOR DEMOLITION PLAN - PLUMBING

M-3.1 1:50

DRAINAGE DRAWING NOTES


- (1) EXISTING DCW/DHW/DHWR PIPING IN CORRIDOR CEILING SPACE TO REMAIN (TYPICAL).
- (2) EXISTING DCW/DHW PIPING FROM MECHANICAL ROOM ABOVE TO REMAIN (TYPICAL).
- (3) EXISTING DCW PIPING FROM MECHANICAL ROOM ABOVE TO REMAIN (TYPICAL).
- 4 EXISTING WATER CLOSET TO BE REMOVED AND DISPOSED OF. ASSOCIATED DCW PIPING IN PIPE CHASE TO BE REMOVED AND DISPOSED OF BACK TO MAIN AT HIGH LEVEL FROM MECHANICAL ROOM ABOVE (TYPICAL).
- (5) EXISTING URINAL TO BE REMOVED AND DISPOSED OF. ASSOCIATED DCW PIPING, FLUSH TANK, AND WATER MATRIX TO BE COMPLETELY REMOVED AND DISPOSED OF (TYPICAL).
- (6) EXISTING MOP SINK TO BE REMOVED AND DISPOSED OF. ASSOCIATED DCW/DHW PIPING IN PIPE CHASE TO BE REMOVED AND DISPOSED OF BACK TO MAIN AT HIGH LEVEL FROM MECHANICAL ROOM ABOVE (TYPICAL).
- (7) EXISTING WASH FOUNTAIN TO BE REMOVED AND DISPOSED OF. ASSOCIATED DCW/DHW PIPING IN PIPE CHASE TO BE REMOVED AND DISPOSED OF BACK TO MAIN AT HIGH LEVEL FROM MECHANICAL ROOM ABOVE (TYPICAL).
- (8) EXISTING DRINKING FOUNTAIN TO REMAIN. EXISTING DCW PIPING IN PIPE CHASE TO BE REMOVED FROM DRINKING FOUNTAIN BACK TO MAIN AT HIGH LEVEL. PREPARE FOR CONNECTION OF NEW PIPING, REFER TO NEW PLANS.

GENERAL NOTES

- ALL EXISTING SERVICES SHOWN ARE A GENERAL REPRESENTATION ONLY OF ACTUAL ONSITE CONDITIONS. CONTRACTOR TO VERIFY EXACT LOCATION OF EXISTING SERVICES PRIOR TO CONSTRUCTION AND REPORT ALL DISCREPANCIES TO ENGINEER IN A TIMELY MANNER.
- PROVIDE VENTING SYSTEMS IN ACCORDANCE WITH PART 7 OF THE NATIONAL PLUMBING CODE.
- PROVIDE ADEQUATE ACCESS FOR ALL EQUIPMENT, VALVES, ETC. LOCATED BEHIND WALLS AND CEILINGS. REFER TO

SPECIFICATIONS.

- PROVIDE TRAP PRIMING AND ASSOCIATED EQUIPMENT AS SPECIFIED AND/OR REQUIRED. ENSURE THAT TRAP PRIMER MECHANISM IS INSTALLED IN AN ACCESSIBLE LOCATION.
- PROVIDE APPROPRIATE MEANS FOR FIRESTOPPING FOR ALL PENETRATIONS THROUGH FIRE-RATED ASSEMBLIES.
- . PATCH ALL FLOOR/WALL PENETRATIONS FROM REMOVED PIPING/EQUIPMENT TO BASE BUILDING STANDARDS.

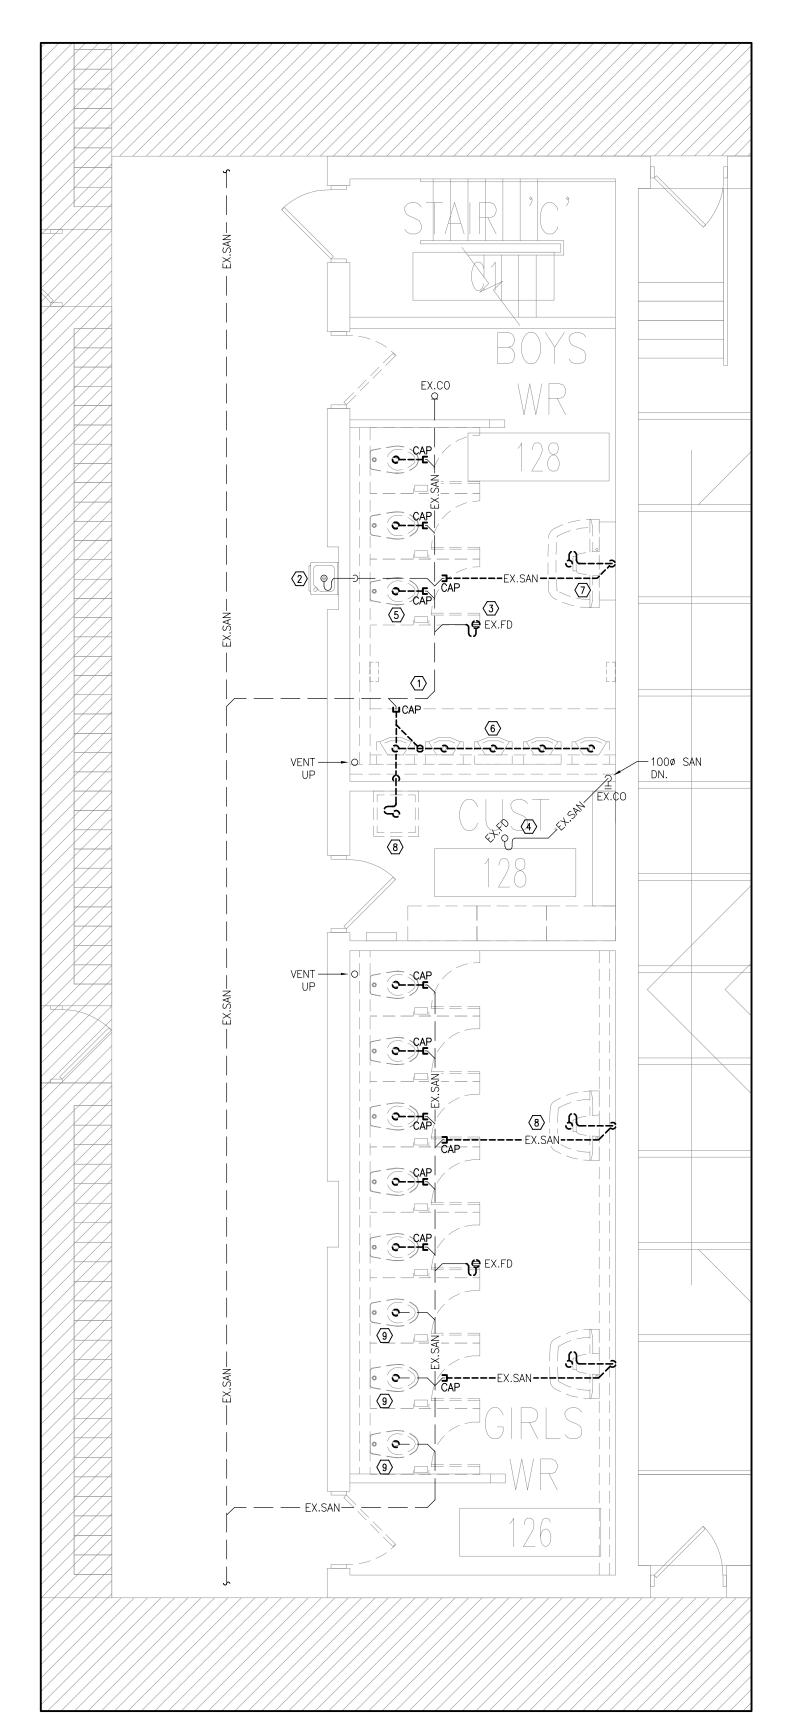

PART 1ST FLOOR DEMOLITION PLAN - DRAINAGE 2 M-3.1

DRAINAGE DRAWING NOTES

- (1) APPROXIMATE LOCATION OF EXISTING UNDERGROUND SANITARY DRAINAGE PIPING. CONTRACTOR TO VERIFY EXACT LOCATION, SIZES AND DIRECTION OF FLOW PRIOR TO START OF CONSTRUCTION AND/OR CUTTING OF SLAB. CONTRACTOR SHALL CARRY SERVICES FOR SCOPING OF EXISTING UNDERGROUND DRAINAGE PIPING IN THEIR BASE BID. PROVIDE A DRAWING INDICATING THE ROUTING, SIZES AND INVERTS OF EXISTING UNDERGROUND PIPING TO ENGINEER FOR REVIEW (TYPICAL).
- (2) EXISTING DRINKING FOUNTAIN TO REMAIN.
- (3) EXISTING FLOOR DRAIN AND ASSOCIATED TRAP SEAL PRIMING TO BE REMOVED AND DISPOSED OF (TYPICAL).
- 4 EXISTING SANITARY DRAINAGE PIPING AT HIGH LEVEL SERVING FLOOR DRAIN IN MECHANICAL ROOM ABOVE TO
- (5) EXISTING FLUSH VALVE WATER CLOSET TO BE REMOVED AND DISPOSED OF. CAP UNDERGROUND SANITARY DRAINAGE PIPING AT MAIN (TYPICAL).
- (6) EXISTING FLOOR MOUNT URINAL TO BE REMOVED AND DISPOSED OF. CAP EXISTING SANITARY DRAINAGE PIPING AT MAIN (TYP-5).
- $\langle 7 \rangle$ EXISTING WASHFOUNTAIN, P-TRAP, MOUNTING HARDWARE, ETC. TO BE REMOVED AND DISPOSED OF. CAP UNDERGROUND SANITARY DRAINAGE PIPING AT MAIN
- (8) EXISTING WALL MOUNTED MOP SINK, P-TRAP, SUPPORTS, MOUNTING HARDWARE, ETC. TO BE REMOVED AND DISPOSED OF. CAP UNDERGROUND SANITARY DRAINAGE PIPING AT
- (9) EXISTING WATER CLOSET TO BE REMOVED AND DISPOSED OF. REMOVE TOILET FLANGE AND PREPARE FOR INSTALLATION OF NEW WATER CLOSET. REFER TO NEW

GENERAL NOTES


- ALL EXISTING SERVICES SHOWN ARE A GENERAL REPRESENTATION ONLY OF ACTUAL ONSITE CONDITIONS. CONTRACTOR TO VERIFY EXACT LOCATION OF EXISTING SERVICES PRIOR TO CONSTRUCTION AND REPORT ALL DISCREPANCIES TO ENGINEER IN A TIMELY MANNER.
- PROVIDE VENTING SYSTEMS IN ACCORDANCE WITH PART 7
- OF THE NATIONAL PLUMBING CODE. PROVIDE ADEQUATE ACCESS FOR ALL EQUIPMENT, VALVES, ETC. LOCATED BEHIND WALLS AND CEILINGS. REFER TO
- 4. PROVIDE TRAP PRIMING AND ASSOCIATED EQUIPMENT AS SPECIFIED AND/OR REQUIRED. ENSURE THAT TRAP PRIMER

SPECIFICATIONS.

MECHANISM IS INSTALLED IN AN ACCESSIBLE LOCATION. PROVIDE APPROPRIATE MEANS FOR FIRESTOPPING FOR ALL

PENETRATIONS THROUGH FIRE-RATED ASSEMBLIES.

6. PATCH ALL FLOOR/WALL PENETRATIONS FROM REMOVED PIPING/EQUIPMENT TO BASE BUILDING STANDARDS.

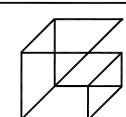

Giallonardo — Engineering Inc. 220-4550 Highway 7 Woodbridge, ON (905) 265 - 1052 info@giallonardoeng.com www.giallonardoeng.com

This drawing is the property of GIALLONARDO ENGINEERING INC.

This drawing shall be read in conjunction with the architectural, structural, electrical and all other consultant's drawings prior to proceeding with the work. Do not scale the drawings.

The contractor is to verify and accept responsibility for all dimensions and conditions on site and must notify GIALLONARDO ENGINEERING INC. of any variations from the



NO.	ISSUES	DATE	BY
1	ISSUED FOR REVIEW	MAR. 10 2025	RC
2	ISSUED FOR TENDER	MAR. 19 2025	SW
NO.	REVISIONS	DATE	BY

PROJECT:

RENOVATIONS AT ECOLE ELEMENTAIRE JEANNE-LAJOIE

150 CARNFORTH ROAD NORTH YORK, ONTARIO Conseil scolaire Viamond

DRAWING:

PART 1ST FLOOR **DEMOLITION PLAN -**PLUMBING & DRAINAGE






BARRY BRYAN ASSOCIATES Engineers Project Managers

250 Water Street Whitby, Ontario L1N 0G5

CHECKED BY: JAN 2025 Tel: (905) 666-5252 AS SHOWN

DESIGN BY:

Fax: (905) 666-5256

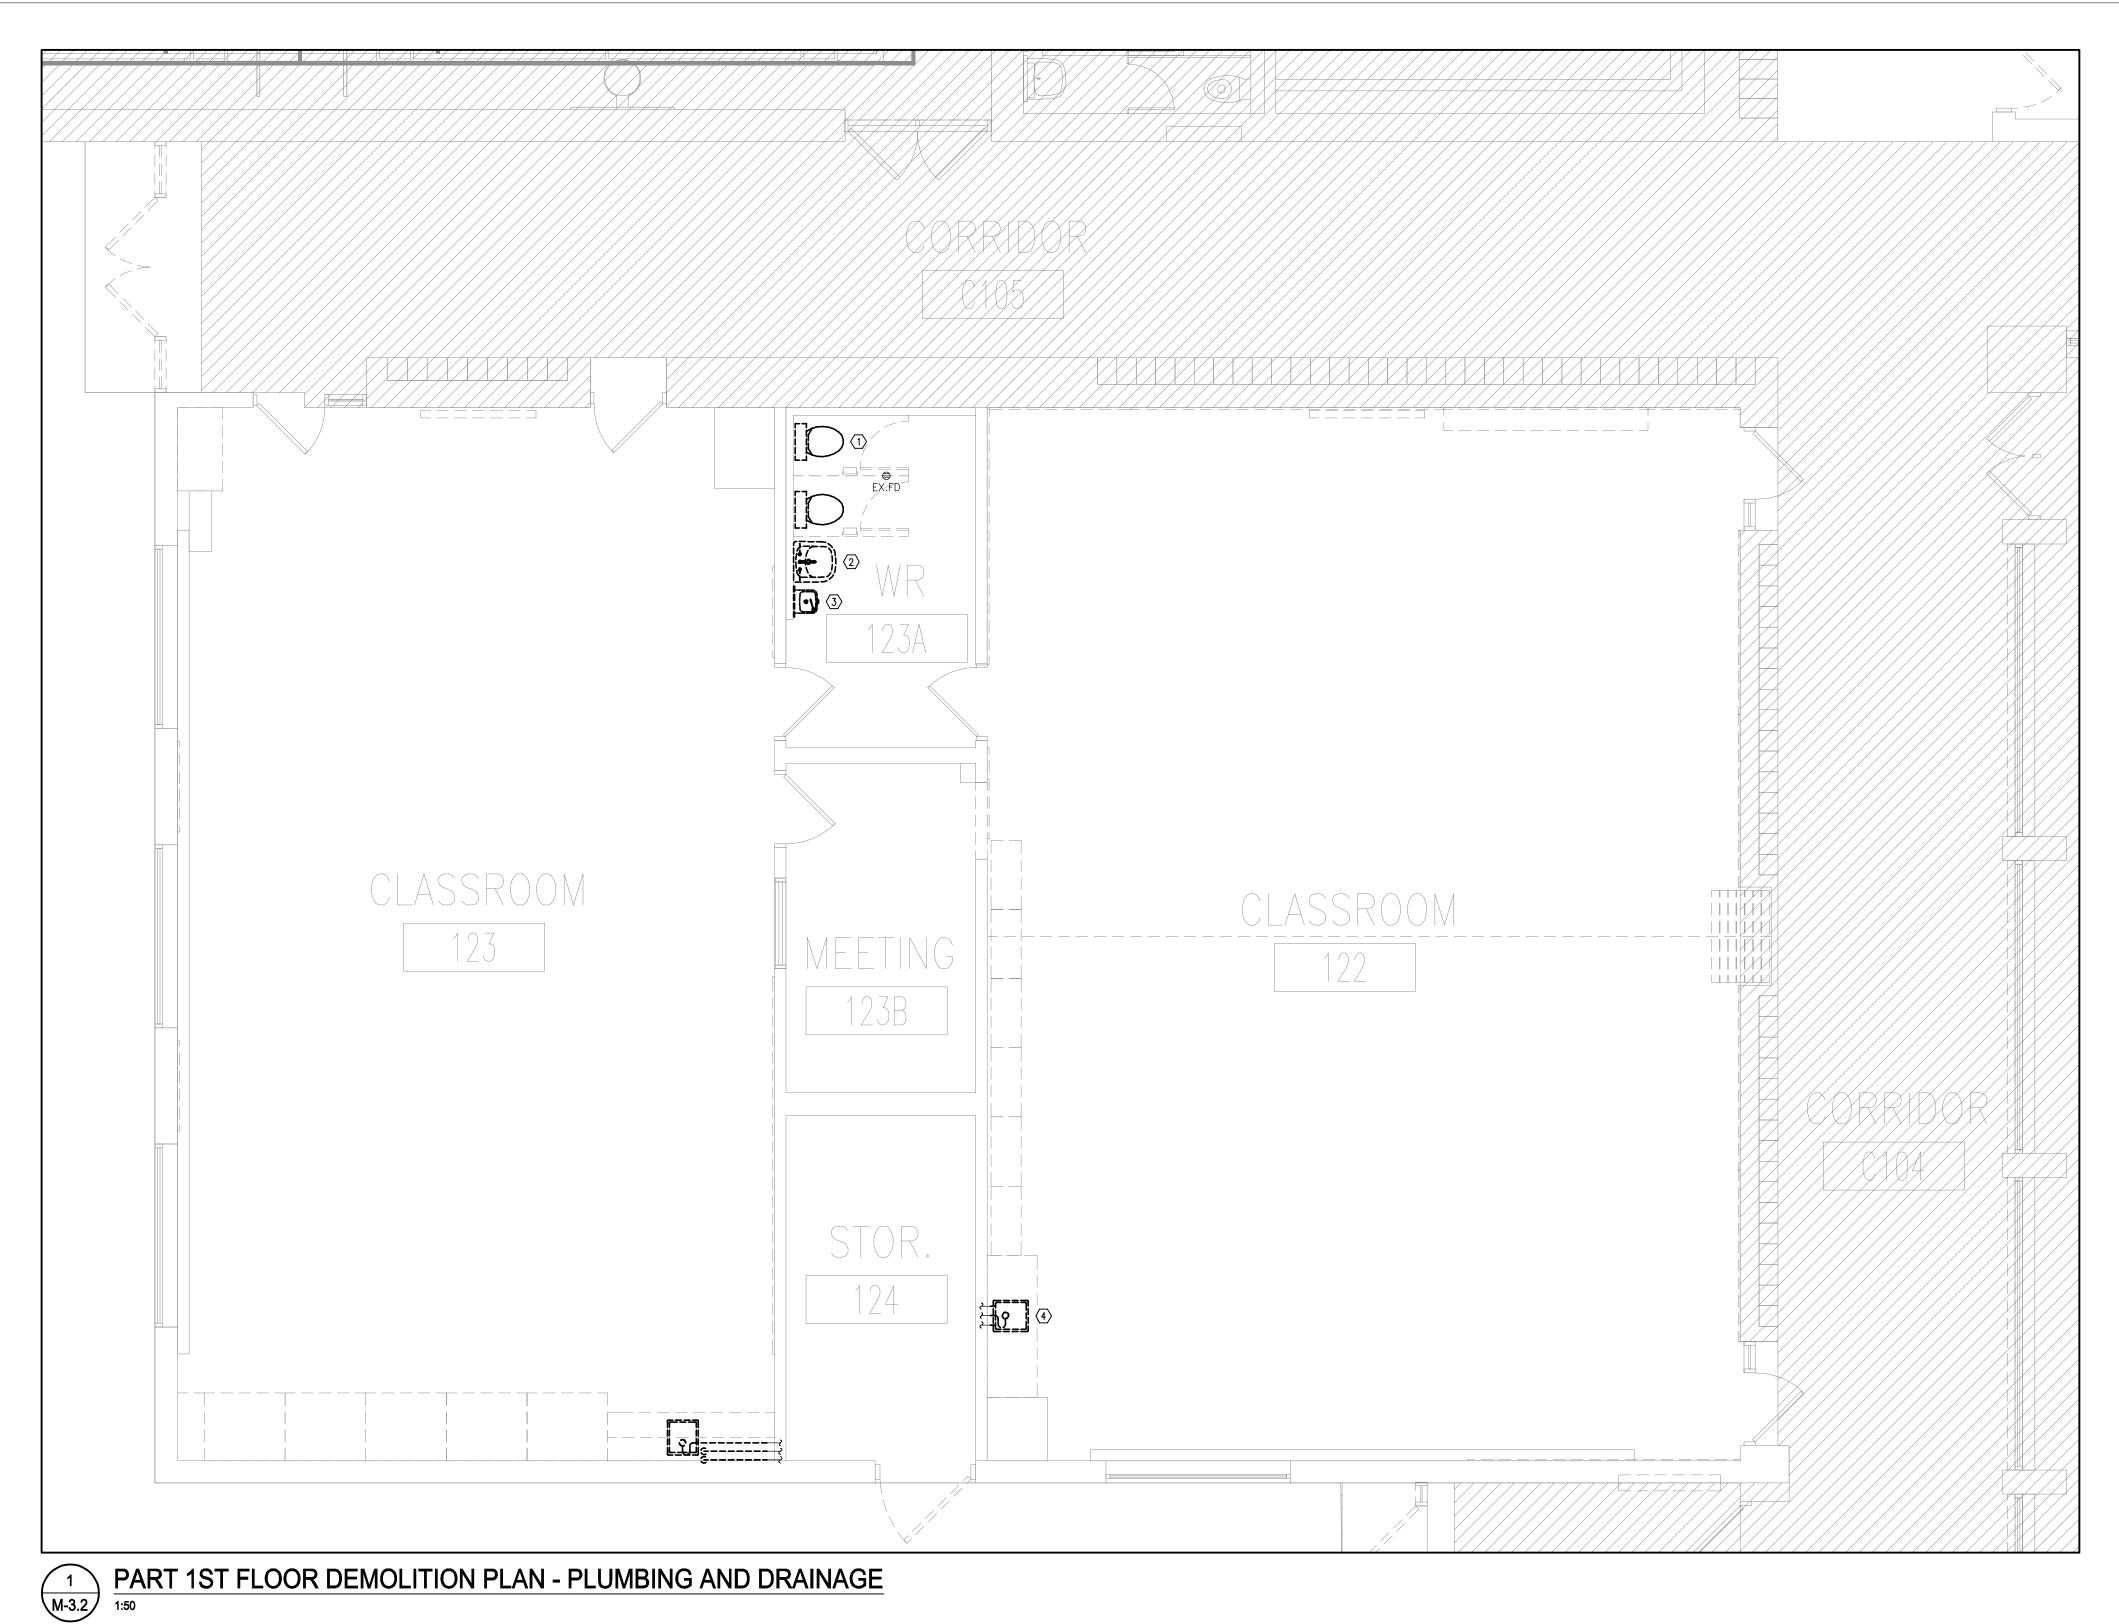

DRAINAGE DRAWING NOTES

1 EXISTING WATER CLOSET TO BE REMOVED AND DISPOSED OF. REMOVE FLEXIBLE RISER, ANGLE STOP AND TOILET FLANGE AND PREPARE ROUGH-IN FOR INSTALLATION OF NEW WATER CLOSET. REFER TO NEW PLANS (TYP-2).


(2) EXISTING LAVATORY TO BE REMOVED AND DISPOSED OF. REMOVE FLEXIBLE RISERS, ANGLE STOPS, AND P-TRAP AND PREPARE FOR INSTALLATION OF NEW LAVATORY. REFER TO NEW PLANS.

3 EXISTING DRINKING FOUNTAIN TO BE REMOVED AND DISPOSED OF. CAP DCW AND SANITARY DRAINAGE PIPING IN

4 EXISTING CLASSROOM SINK TO BE REMOVED AND DISPOSED OF. PREPARE ROUGH-INS FOR CONNECTION OF NEW PIPING. REFER TO NEW PLANS (TYP-2).

GENERAL NOTES

- ALL EXISTING SERVICES SHOWN ARE A GENERAL REPRESENTATION ONLY OF ACTUAL ONSITE CONDITIONS. CONTRACTOR TO VERIFY EXACT LOCATION OF EXISTING SERVICES PRIOR TO CONSTRUCTION AND REPORT ALL DISCREPANCIES TO ENGINEER IN A TIMELY MANNER.
- 2. PROVIDE VENTING SYSTEMS IN ACCORDANCE WITH PART 7 OF THE NATIONAL PLUMBING CODE.
- 3. PROVIDE ADEQUATE ACCESS FOR ALL EQUIPMENT, VALVES, ETC. LOCATED BEHIND WALLS AND CEILINGS. REFER TO SPECIFICATIONS.
- 4. PROVIDE TRAP PRIMING AND ASSOCIATED EQUIPMENT AS SPECIFIED AND/OR REQUIRED. ENSURE THAT TRAP PRIMER MECHANISM IS INSTALLED IN AN ACCESSIBLE LOCATION.
- 5. PROVIDE APPROPRIATE MEANS FOR FIRESTOPPING FOR ALL PENETRATIONS THROUGH FIRE-RATED ASSEMBLIES.
- 6. PATCH ALL FLOOR/WALL PENETRATIONS FROM REMOVED PIPING/EQUIPMENT TO BASE BUILDING STANDARDS.

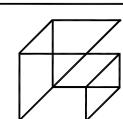

Giallonardo — Engineering Inc. 220-4550 Highway 7 Woodbridge, ON L4L 4Y7 (905) 265-1052 i nfo@gi alĺonardoeng.com www.giallonardoeng.com

This drawing is the property of GIALLONARDO ENGINEERING INC.

This drawing shall be read in conjunction with the architectural, structural, electrical and all other consultant's drawings prior to proceeding with the work. Do not scale the drawings.

The contractor is to verify and accept responsibility for all dimensions and conditions on site and must notify GIALLONARDO ENGINEERING INC. of any variations from the drawings.



NO.	ISSUES	DATE	BY
1	ISSUED FOR REVIEW	MAR. 10 2025	RC
2	ISSUED FOR TENDER	MAR. 19 2025	SW
NO.	REVISIONS	DATE	BY

PROJECT:

RENOVATIONS AT ECOLE ELEMENTAIRE JEANNE-LAJOIE

150 CARNFORTH ROAD NORTH YORK, ONTARIO Conseil scolaire Viamond

DRAWING:

PART 1ST FLOOR **DEMOLITION PLAN -**PLUMBING & DRAINAGE





DESIGN BY: **SW**


BARRY BRYAN ASSOCIATES Engineers Project Managers

250 Water Street Suite 201 Whitby, Ontario L1N 0G5

Tel: (905) 666-5252 Fax: (905) 666-5256

CHECKED BY: JAN 2025 AS SHOWN

% COMPLETE:

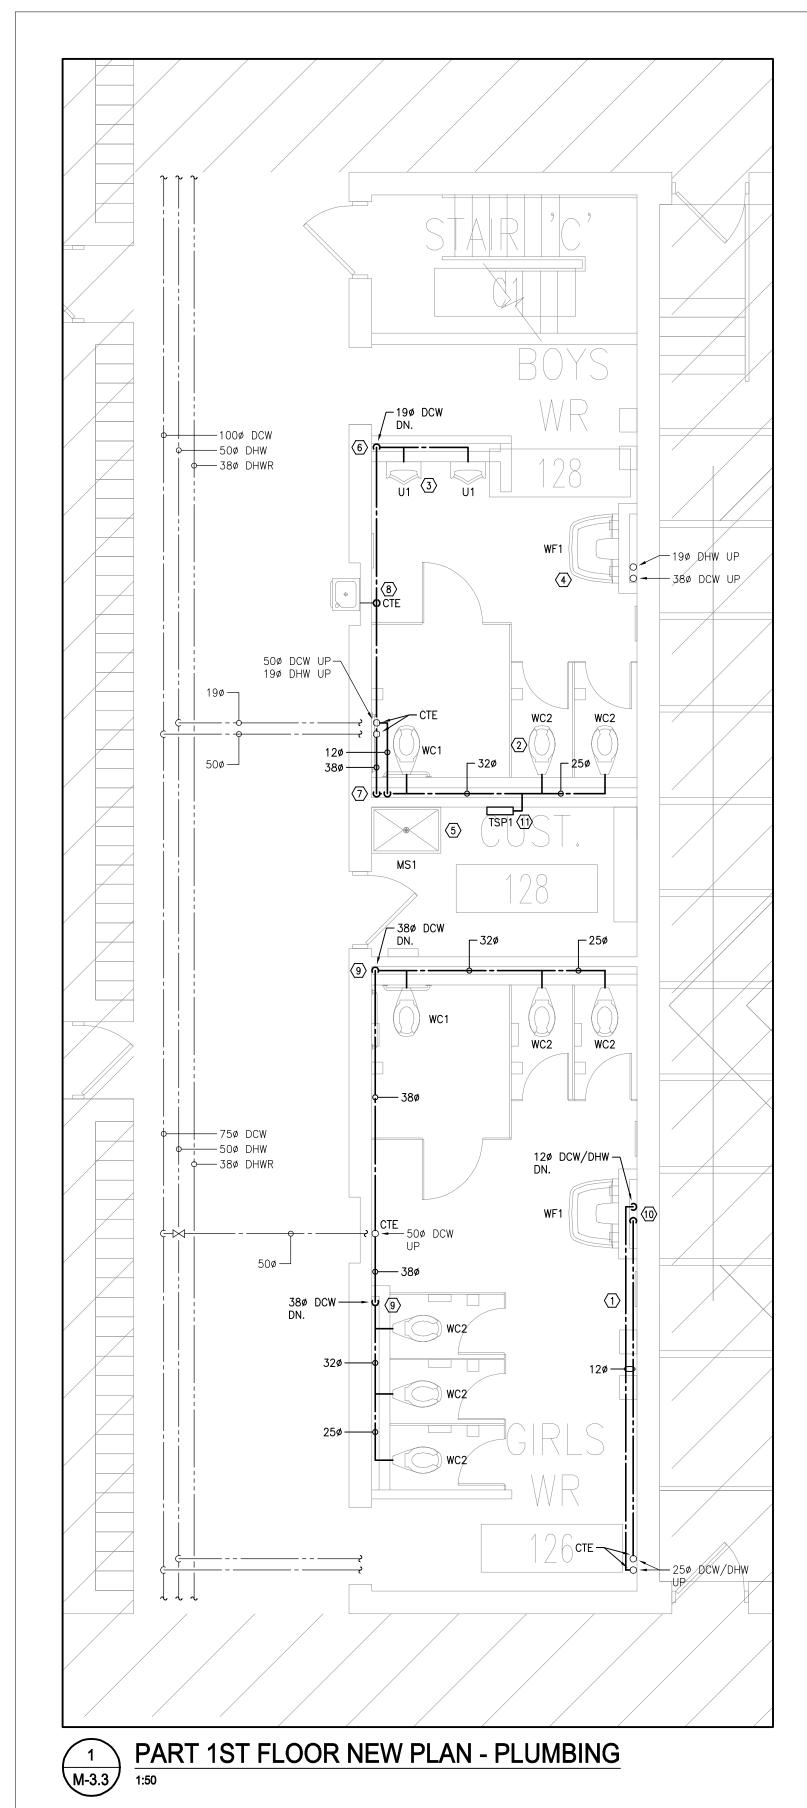

DRAINAGE DRAWING NOTES

(1) PROVIDE NEW DCW/DHW PIPING AT HIGH LEVEL (TYPICAL). $\langle \overline{2} \rangle$ PROVIDE NEW WATER CLOSET AS SPECIFIED (TYPICAL). (3) PROVIDE NEW URINAL AS SPECIFIED (TYPICAL).

4 PROVIDE NEW WASH FOUNTAIN AS SPECIFIED (TYPICAL). (5) PROVIDE NEW MOP SINK AS SPECIFIED.

6 DISTRIBUTE 190 DCW PIPING IN PIPE CHASE TO SERVE NEW (7) 38¢ DCW/12¢ DHW DOWN IN PIPE CHASE TO SERVE NEW

WATER CLOSETS AND MOP SINK. 8 120 DCW PIPING DOWN TO SERVE EXISTING DRINKING

FOUNTAIN. CONNECT TO EXISTING DCW PIPING AT WALL.

(9) 380 DCW PIPING DOWN IN PIPE CHASE TO SERVE NEW WATER CLOSETS.

(10) 12¢ DCW/DHW PIPING DOWN IN PIPE CHASE TO SERVE NEW WASH FOUNTAIN (TYP-2). 11) PROVIDE NEW SURFACE MOUNTED ELECTRONIC TRAP SEAL PRIMING ASSEMBLY AS SPECIFIED.

GENERAL NOTES

- ALL EXISTING SERVICES SHOWN ARE A GENERAL REPRESENTATION ONLY OF ACTUAL ONSITE CONDITIONS. CONTRACTOR TO VERIFY EXACT LOCATION OF EXISTING SERVICES PRIOR TO CONSTRUCTION AND REPORT ALL DISCREPANCIES TO ENGINEER IN A TIMELY MANNER.
- PROVIDE VENTING SYSTEMS IN ACCORDANCE WITH PART 7 OF THE NATIONAL PLUMBING CODE.
- PROVIDE ADEQUATE ACCESS FOR ALL EQUIPMENT, VALVES, ETC. LOCATED BEHIND WALLS AND CEILINGS. REFER TO
- PROVIDE TRAP PRIMING AND ASSOCIATED EQUIPMENT AS SPECIFIED AND/OR REQUIRED. ENSURE THAT TRAP PRIMER MECHANISM IS INSTALLED IN AN ACCESSIBLE LOCATION.
- PROVIDE APPROPRIATE MEANS FOR FIRESTOPPING FOR ALL PENETRATIONS THROUGH FIRE-RATED ASSEMBLIES.
- . PATCH ALL FLOOR/WALL PENETRATIONS FROM REMOVED PIPING/EQUIPMENT TO BASE BUILDING STANDARDS.

100ø@1%——


PART 1ST FLOOR NEW PLAN - DRAINAGE 2 M-3.3 PAI 1:50

DRAINAGE DRAWING NOTES

- (1) PROVIDE NEW UNDERGROUND SANITARY DRAINAGE PIPING. CONNECT TO EXISTING WHERE SHOWN. CONTRACTOR TO CONFIRM EXACT LOCATION ON SITE PRIOR TO CONSTRUCTION (TYPICAL).
- (2) PROVIDE NEW FLOOR DRAIN AS SPECIFIED. CONNECT TO EXISTING UNDERGROUND SANITARY PIPING WHERE SHOWN. PROVIDE NEW TRAP SEAL PRIMING FROM ELECTRONIC TRAP SEAL PRIMING ASSEMBLY IN CUSTODIAN ROOM 128 (TYP-2).
- (3) REPLACE TOILET FLANGE TO SUIT INSTALLATION OF NEW WATER CLOSET AT EXISTING ROUGH-IN.
- (4) PROVIDE NEW VENT PIPING AND CONNECT TO EXISTING VENT PIPING AT HIGH LEVEL. DISTRIBUTE VENT PIPING TO PLUMBING FIXTURES IN ACCORDANCE WITH THE ONTARIO BUILDING CODE (TYPICAL).

GENERAL NOTES

- ALL EXISTING SERVICES SHOWN ARE A GENERAL REPRESENTATION ONLY OF ACTUAL ONSITE CONDITIONS. CONTRACTOR TO VERIFY EXACT LOCATION OF EXISTING SERVICES PRIOR TO CONSTRUCTION AND REPORT ALL DISCREPANCIES TO ENGINEER IN A TIMELY MANNER.
- PROVIDE VENTING SYSTEMS IN ACCORDANCE WITH PART 7 OF THE NATIONAL PLUMBING CODE.
- PROVIDE ADEQUATE ACCESS FOR ALL EQUIPMENT, VALVES, ETC. LOCATED BEHIND WALLS AND CEILINGS. REFER TO
- . PROVIDE TRAP PRIMING AND ASSOCIATED EQUIPMENT AS SPECIFIED AND/OR REQUIRED. ENSURE THAT TRAP PRIMER MECHANISM IS INSTALLED IN AN ACCESSIBLE LOCATION.
- PROVIDE APPROPRIATE MEANS FOR FIRESTOPPING FOR ALL PENETRATIONS THROUGH FIRE-RATED ASSEMBLIES.
- 6. PATCH ALL FLOOR/WALL PENETRATIONS FROM REMOVED PIPING/EQUIPMENT TO BASE BUILDING STANDARDS.

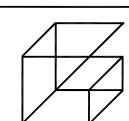

Giallonardo — Engineering Inc. 220-4550 Highway 7 Woodbridge, ON L4L 4Y7 (905) 265 - 1052 i nfo@gi al Í onardoeng. com www.giallonardoeng.com

This drawing is the property of GIALLONARDO ENGINEERING INC.

This drawing shall be read in conjunction with the architectural, structural, electrical and all other consultant's drawings prior to proceeding with the work. Do not scale the drawings.

The contractor is to verify and accept responsibility for all dimensions and conditions on site and must notify GIALLONARDO ENGINEERING INC. of any variations from the



NO.	ISSUES	DATE	BY
1	ISSUED FOR REVIEW	MAR. 10 2025	RC
2	ISSUED FOR TENDER	MAR. 19 2025	SW
NO.	REVISIONS	DATE	ВҮ

PROJECT:

RENOVATIONS AT ECOLE ELEMENTAIRE JEANNE-LAJOIE

150 CARNFORTH ROAD NORTH YORK, ONTARIO Conseil scolaire Viamond

DRAWING:

PART 1ST FLOOR NEW PLAN - PLUMBING & DRAINAGE





% COMPLETE:


BARRY BRYAN ASSOCIATES Engineers Project Managers

CHECKED BY: 250 Water Street Suite 201 Whitby, Ontario L1N 0G5

Tel: (905) 666-5252 Fax: (905) 666-5256

JAN 2025 AS SHOWN

DESIGN BY:

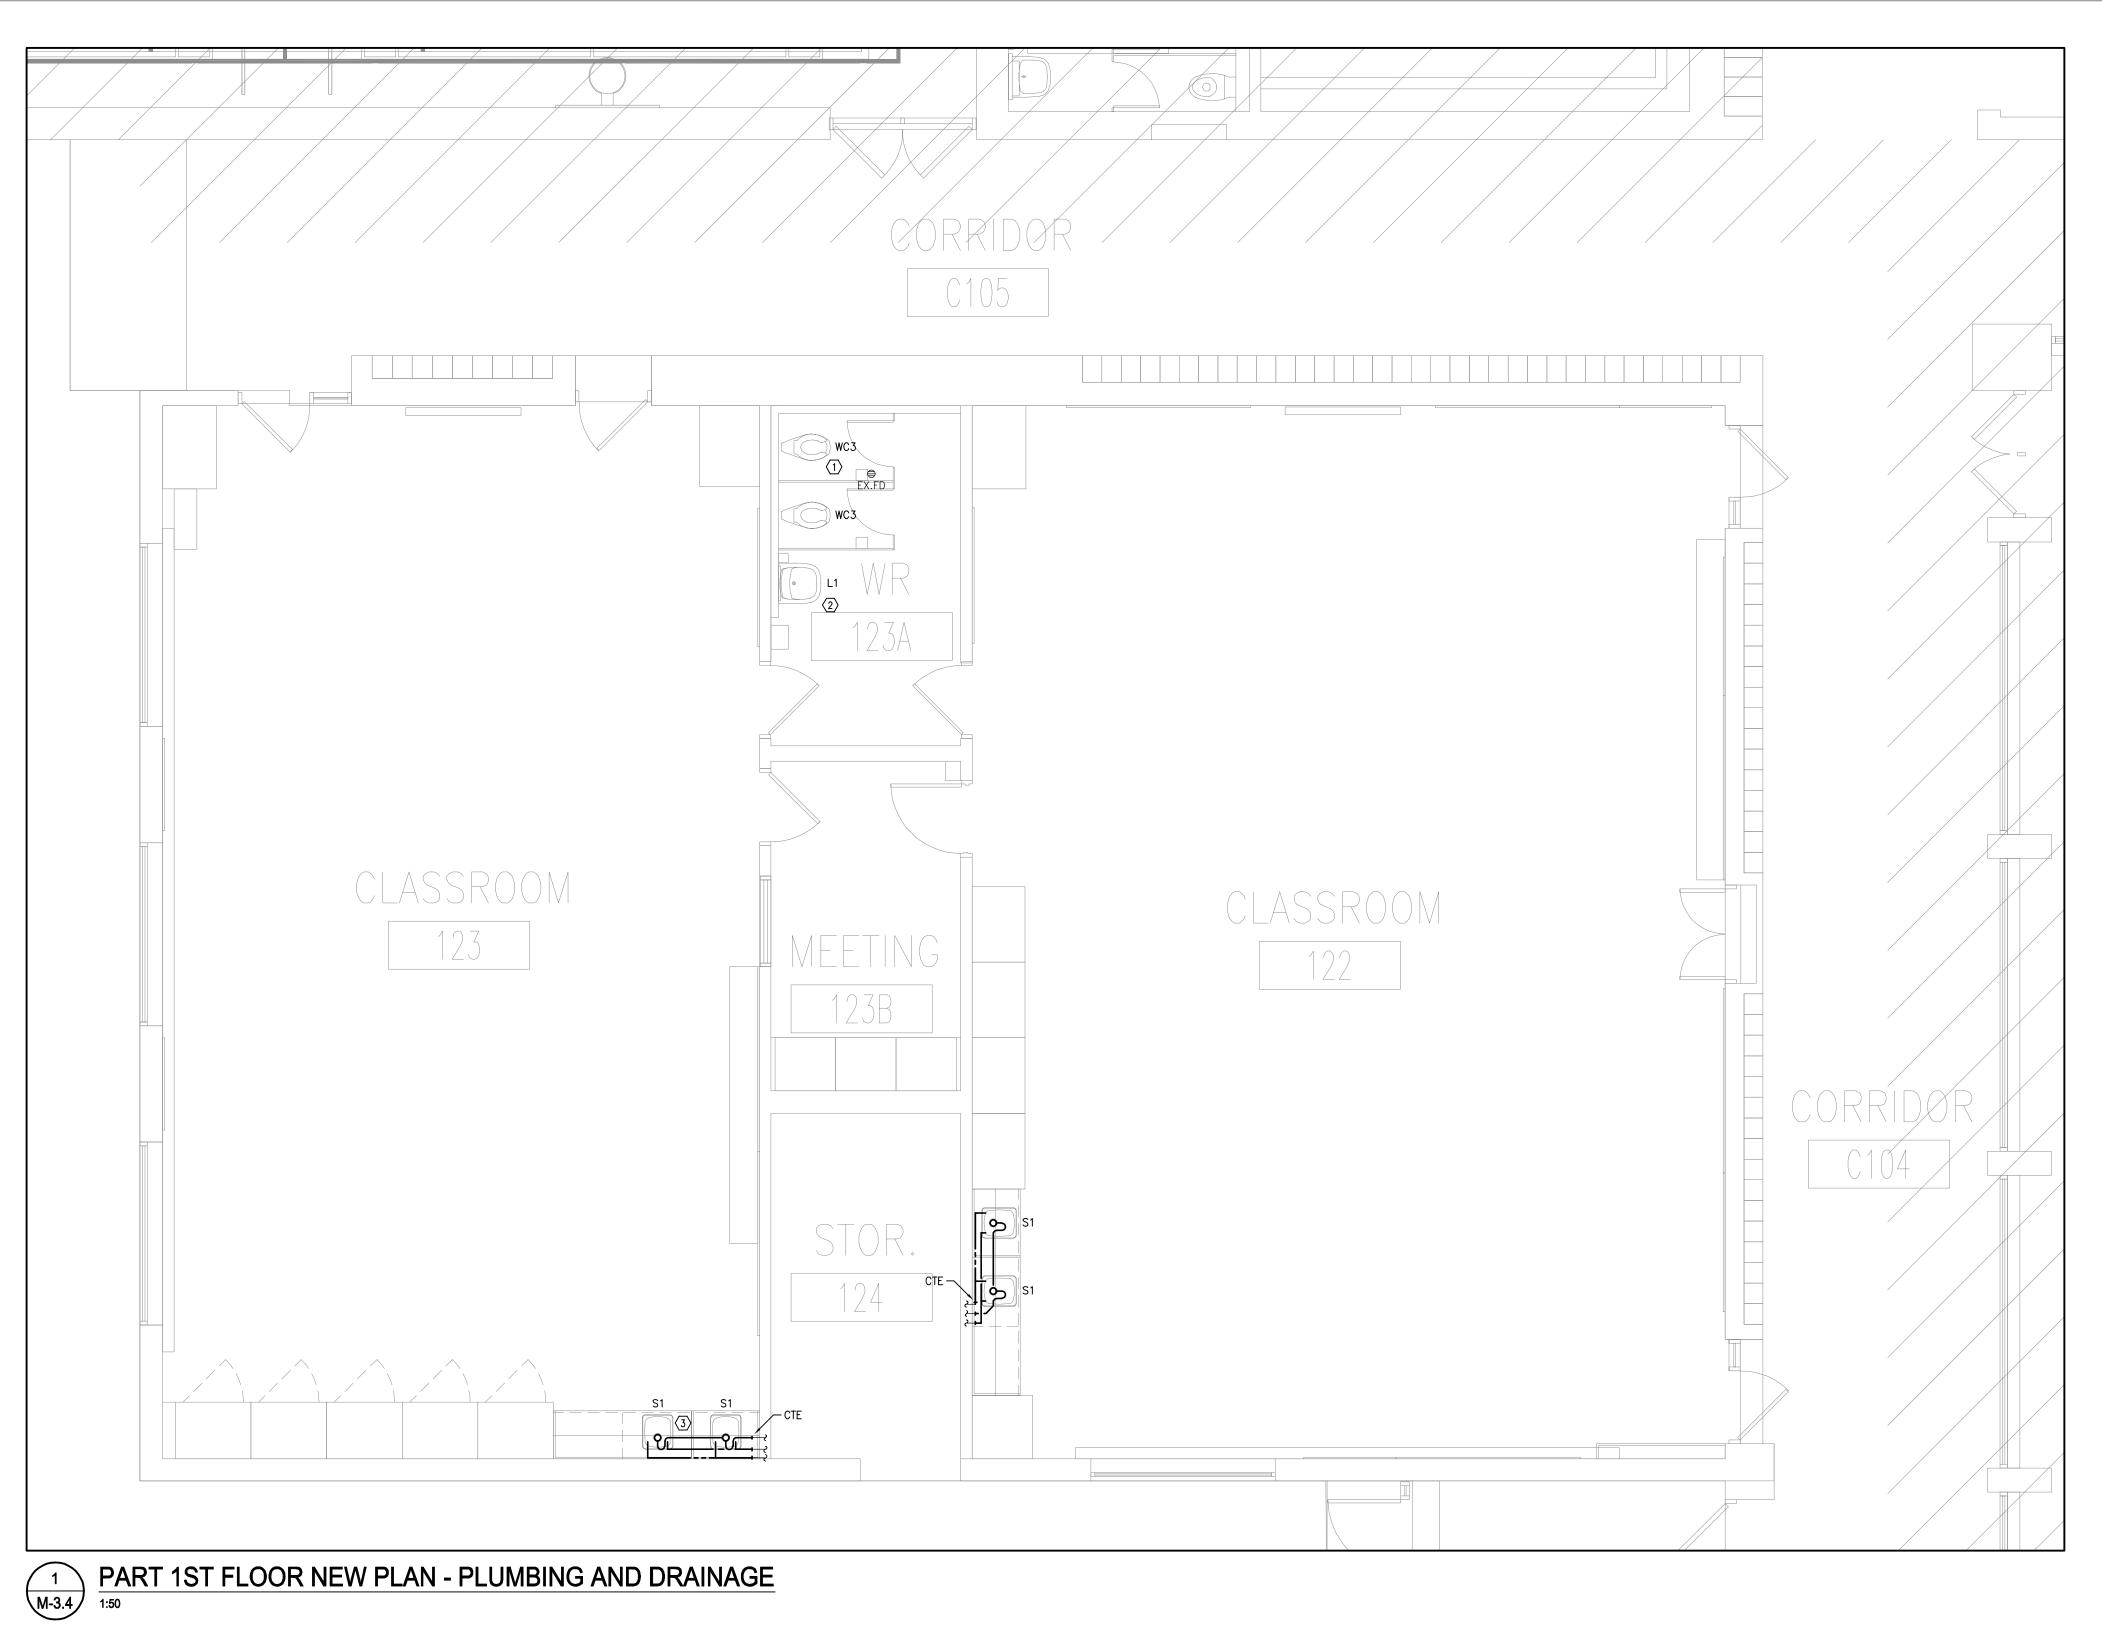

DRAINAGE DRAWING NOTES


1 PROVIDE NEW WATER CLOSET AS SPECIFIED. REWORK EXISTING DOW AND PROVIDE NEW ANGLE STOP, FLEXIBLE RISER AND TOILET FLANGE AS REQUIRED TO SUIT NEW INSTALLATION (TYPICAL).

(2) PROVIDE NEW LAVATORY AS SPECIFIED C/W WALL CARRIER. REWORK EXISTING DCW/DHW AND PROVIDE NEW ANGLE STOPS, FLEXIBLE RISERS, P-TRAP AND SANITARY DRAINAGE PIPING AS REQUIRED TO SUIT NEW INSTALLATION.

(3) PROVIDE NEW SINK AS SPECIFIED C/W NEW ANGLE STOPS, FLEXIBLE RISERS, P-TRAP AND SANITARY DRAINAGE PIPING. CONNECT TO EXISTING PIPING CONNECTIONS IN MILLWORK AS REQUIRED (TYPICAL).

GENERAL NOTES

- ALL EXISTING SERVICES SHOWN ARE A GENERAL REPRESENTATION ONLY OF ACTUAL ONSITE CONDITIONS. CONTRACTOR TO VERIFY EXACT LOCATION OF EXISTING SERVICES PRIOR TO CONSTRUCTION AND REPORT ALL DISCREPANCIES TO ENGINEER IN A TIMELY MANNER.
- 2. PROVIDE VENTING SYSTEMS IN ACCORDANCE WITH PART 7 OF THE NATIONAL PLUMBING CODE.
- . PROVIDE ADEQUATE ACCESS FOR ALL EQUIPMENT, VALVES, ETC. LOCATED BEHIND WALLS AND CEILINGS. REFER TO SPECIFICATIONS.
- 4. PROVIDE TRAP PRIMING AND ASSOCIATED EQUIPMENT AS SPECIFIED AND/OR REQUIRED. ENSURE THAT TRAP PRIMER MECHANISM IS INSTALLED IN AN ACCESSIBLE LOCATION.
- 5. PROVIDE APPROPRIATE MEANS FOR FIRESTOPPING FOR ALL PENETRATIONS THROUGH FIRE-RATED ASSEMBLIES.
- 6. PATCH ALL FLOOR/WALL PENETRATIONS FROM REMOVED PIPING/EQUIPMENT TO BASE BUILDING STANDARDS.

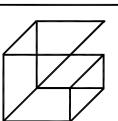

Giallonardo — Engineering Inc. 220-4550 Highway 7 Woodbridge, ON L4L 4Y7 (905)265-1052 i nfo@gi alĺonardoeng.com

www.giallonardoeng.com

This drawing is the property of GIALLONARDO ENGINEERING INC.

This drawing shall be read in conjunction with the architectural, structural, electrical and all other consultant's drawings prior to proceeding with the work. Do not scale the drawings.

The contractor is to verify and accept responsibility for all dimensions and conditions on site and must notify GIALLONARDO ENGINEERING INC. of any variations from the



NO.	ISSUES	DATE	ВҮ
1	ISSUED FOR REVIEW	MAR. 10 2025	RC
2	ISSUED FOR TENDER	MAR. 19 2025	SW
NO.	REVISIONS	DATE	BY

PROJECT:

RENOVATIONS AT ECOLE ELEMENTAIRE JEANNE-LAJOIE

150 CARNFORTH ROAD NORTH YORK, ONTARIO Conseil scolaire Viamond

DRAWING:

PART 1ST FLOOR NEW PLAN - PLUMBING & DRAINAGE





% COMPLETE:

BARRY BRYAN ASSOCIATES Architects Engineers Project Managers

250 Water Street Suite 201 Whitby, Ontario L1N 0G5

Tel: (905) 666-5252 Fax: (905) 666-5256 e-mail: bba@bba-archeng.com

JAN 2025 AS SHOWN

DESIGN BY:

CHECKED BY: