WASHROOM CALCULATION			
Male / Female Count at 50% / 50 % OBC Reference 3.7.4.3. (14)			
EX. OCCUPANT LOAD (Elementary School) 1 PORTABLE CLASSROOM ADDITION	555 Student + 49 Staff 23 Student + 1 Staff		
TOTAL	628		
TOTAL FEMALES	314		
TOTAL FEMALE FIXTURES REQUIRED (1 PER 26 FEMALES) TOTAL FEMALE FIXTURES PROVIDED	13 24		
TOTAL MALES	314		
TOTAL MALE FIXTURES REQUIRED (1 PER 30 MALES) TOTAL MALE FIXTURES PROVIDED	11 23		


ZONING DATA FOR CITY OF HAMILTON		
ITEM DESCRIPTION	PERMITTED A	CTUAL OR PROPOSED
ZONING DESIGNATION	I1-NEIGHBORHOOD INSTITUTIONAL	
NET LOT AREA (MIN)	NONE	26,100± sqm
MINIMUM YARD WHERE LOT LINE ABUTS A RESIDENTIAL ZONE LOT LINE	6.0 m	12.8 m
MAXIMUM BUILDING HEIGHT	10.5m	EX SCHOOL = 9m± PORTABLE= 3.5m
REQUIRED PARKING SPACES:	CLASSROOM X 1.25 = SPACES 28 EXISTING CLASSROOMS + 1 PORTABLE CLASSROOM x 1.25 = 36.25 PARKING SPACE REQUIRED	EXISTING 68 SPACES + 2 BF SPACES TOTAL = 70 SPACES PROVIDED

GENERAL NOTES

- CONTRACTOR IS RESPONSIBLE FOR ENSURING THAT ALL MATERIALS AND WORK ARE FENCED OFF FROM EXISTING PLAY AREA AND PARKING LOT ACCESS IS MAINTAINED.
- 2. AREA OF CONSTRUCTION TO BE COORDINATED WITH ARCHITECT AND SCHOOL BOARD PRIOR TO BEGINNING THE WORK.
- 3. CONTRACTOR IS RESPONSIBLE TO PROVIDE ALL CONNECTIONS FROM EXISTING SCHOOL.
- 4. PORTABLE CONTRACTOR IS RESPONSIBLE FOR PROVIDING ALL FOUNDATIONS, FOOTINGS AND WOODEN STAIRS AS PER DETAILS TO ACCOMMODATE NEW PORTABLES BASED ON LOCATION OR EXISTING FOOTINGS FROM THE SITE WHERE PORTABLE IS BEING RELOCATED FROM. CONTRACTOR IS RESPONSIBLE FOR FIELD VERIFYING PORTABLE STRUCTURE AND COORDINATING LOCATIONS OF NEW SUPPORT PIERS.
- REFER TO AND COORDINATE WITH ELECTRICAL DOCUMENTS FOR EXTENT OF DEMOLITION AND NEW WORK. REPLACE ALL SOD AND / OR ASPHALT PAVING DISTURBED DUE TO ELECTRICAL WORK WITH NEW SOD AND / OR ASPHALT PAVING TO MATCH EXISTING WHERE REQUIRED. SEE SITE PLAN FOR EXISTING SURFACES TO BE REINSTATED.
- 6. PATCH, REPAIR, REPLACE AND MAKE GOOD ALL SURFACES DISTURBED BY CONSTRUCTION ACTIVITIES WITH MATERIALS TO MATCH EXISTING DISTURBED SURFACES.

CONSTRUCTION NOTES

(C1) RELOCATED SINGLE PORTABLE

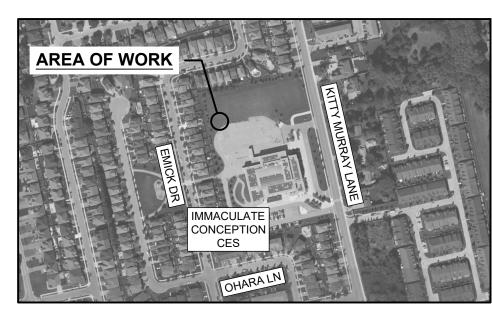

LOCATION MAP N.T.S.



BASKETBALL NET / BACKSTOP BARRIER FREE CATCH BASIN CHAIN LINK FENCE CONC CONCRETE DEPRESSED CURB EXISTING FIRE HYDRANT FLAG POLE HYDRO POLE LIMITING DISTANCE LIGHT STANDARD MAX MAXIMUM MAN HOLE MINIMUM SANITARY STANDARD IRON BAR STM STORM

W/M WATERMAIN ENTRANCE TO BLDG.

TO REMAIN

EXISTING TREE

ISSUED FOR BUILDING PERMIT REVISIONS

RAWINGS ARE NOT TO BE SCALED. CONTRACTOR MUST CHECK AND VERIFY ALL DIMENSIONS AND CONDITIONS ON THE PROJECT: AND MUST REPORT ANY DISCREPANCIES TO HE ARCHITECTS BEFORE PROCEEDING WITH THE WORK. HE USE OF THIS DRAWING OR PART THEREOF IS FORBID ITHOUT THE WRITTEN APPROVAL OF THE ARCHITECTS

> OF O ARCHITECTS Z JOHN I. GRGURIC LICENCE 5550

IMMACULATE CONCEPTION CES RELOCATED PORTABLE CLASSROOM

470 Kitty Murray Ln, Ancaster, ON L9K 0C3


SITE PLAN & **OBC MATRIX**

GRGURIC ARCHITECTS **INCORPORATED**

28 KING STREET EAST, UNIT B STONEY CREEK, ONTARIO, L8G 1J8 Tel. 905-664-8735 Fax. 905-664-8737

Web: www.2gai.com PROJECT: SCALE: AS NOTED 2024-24 START DATE: DEC 2024

DRAWN DRAWING: CHECKED W.P.

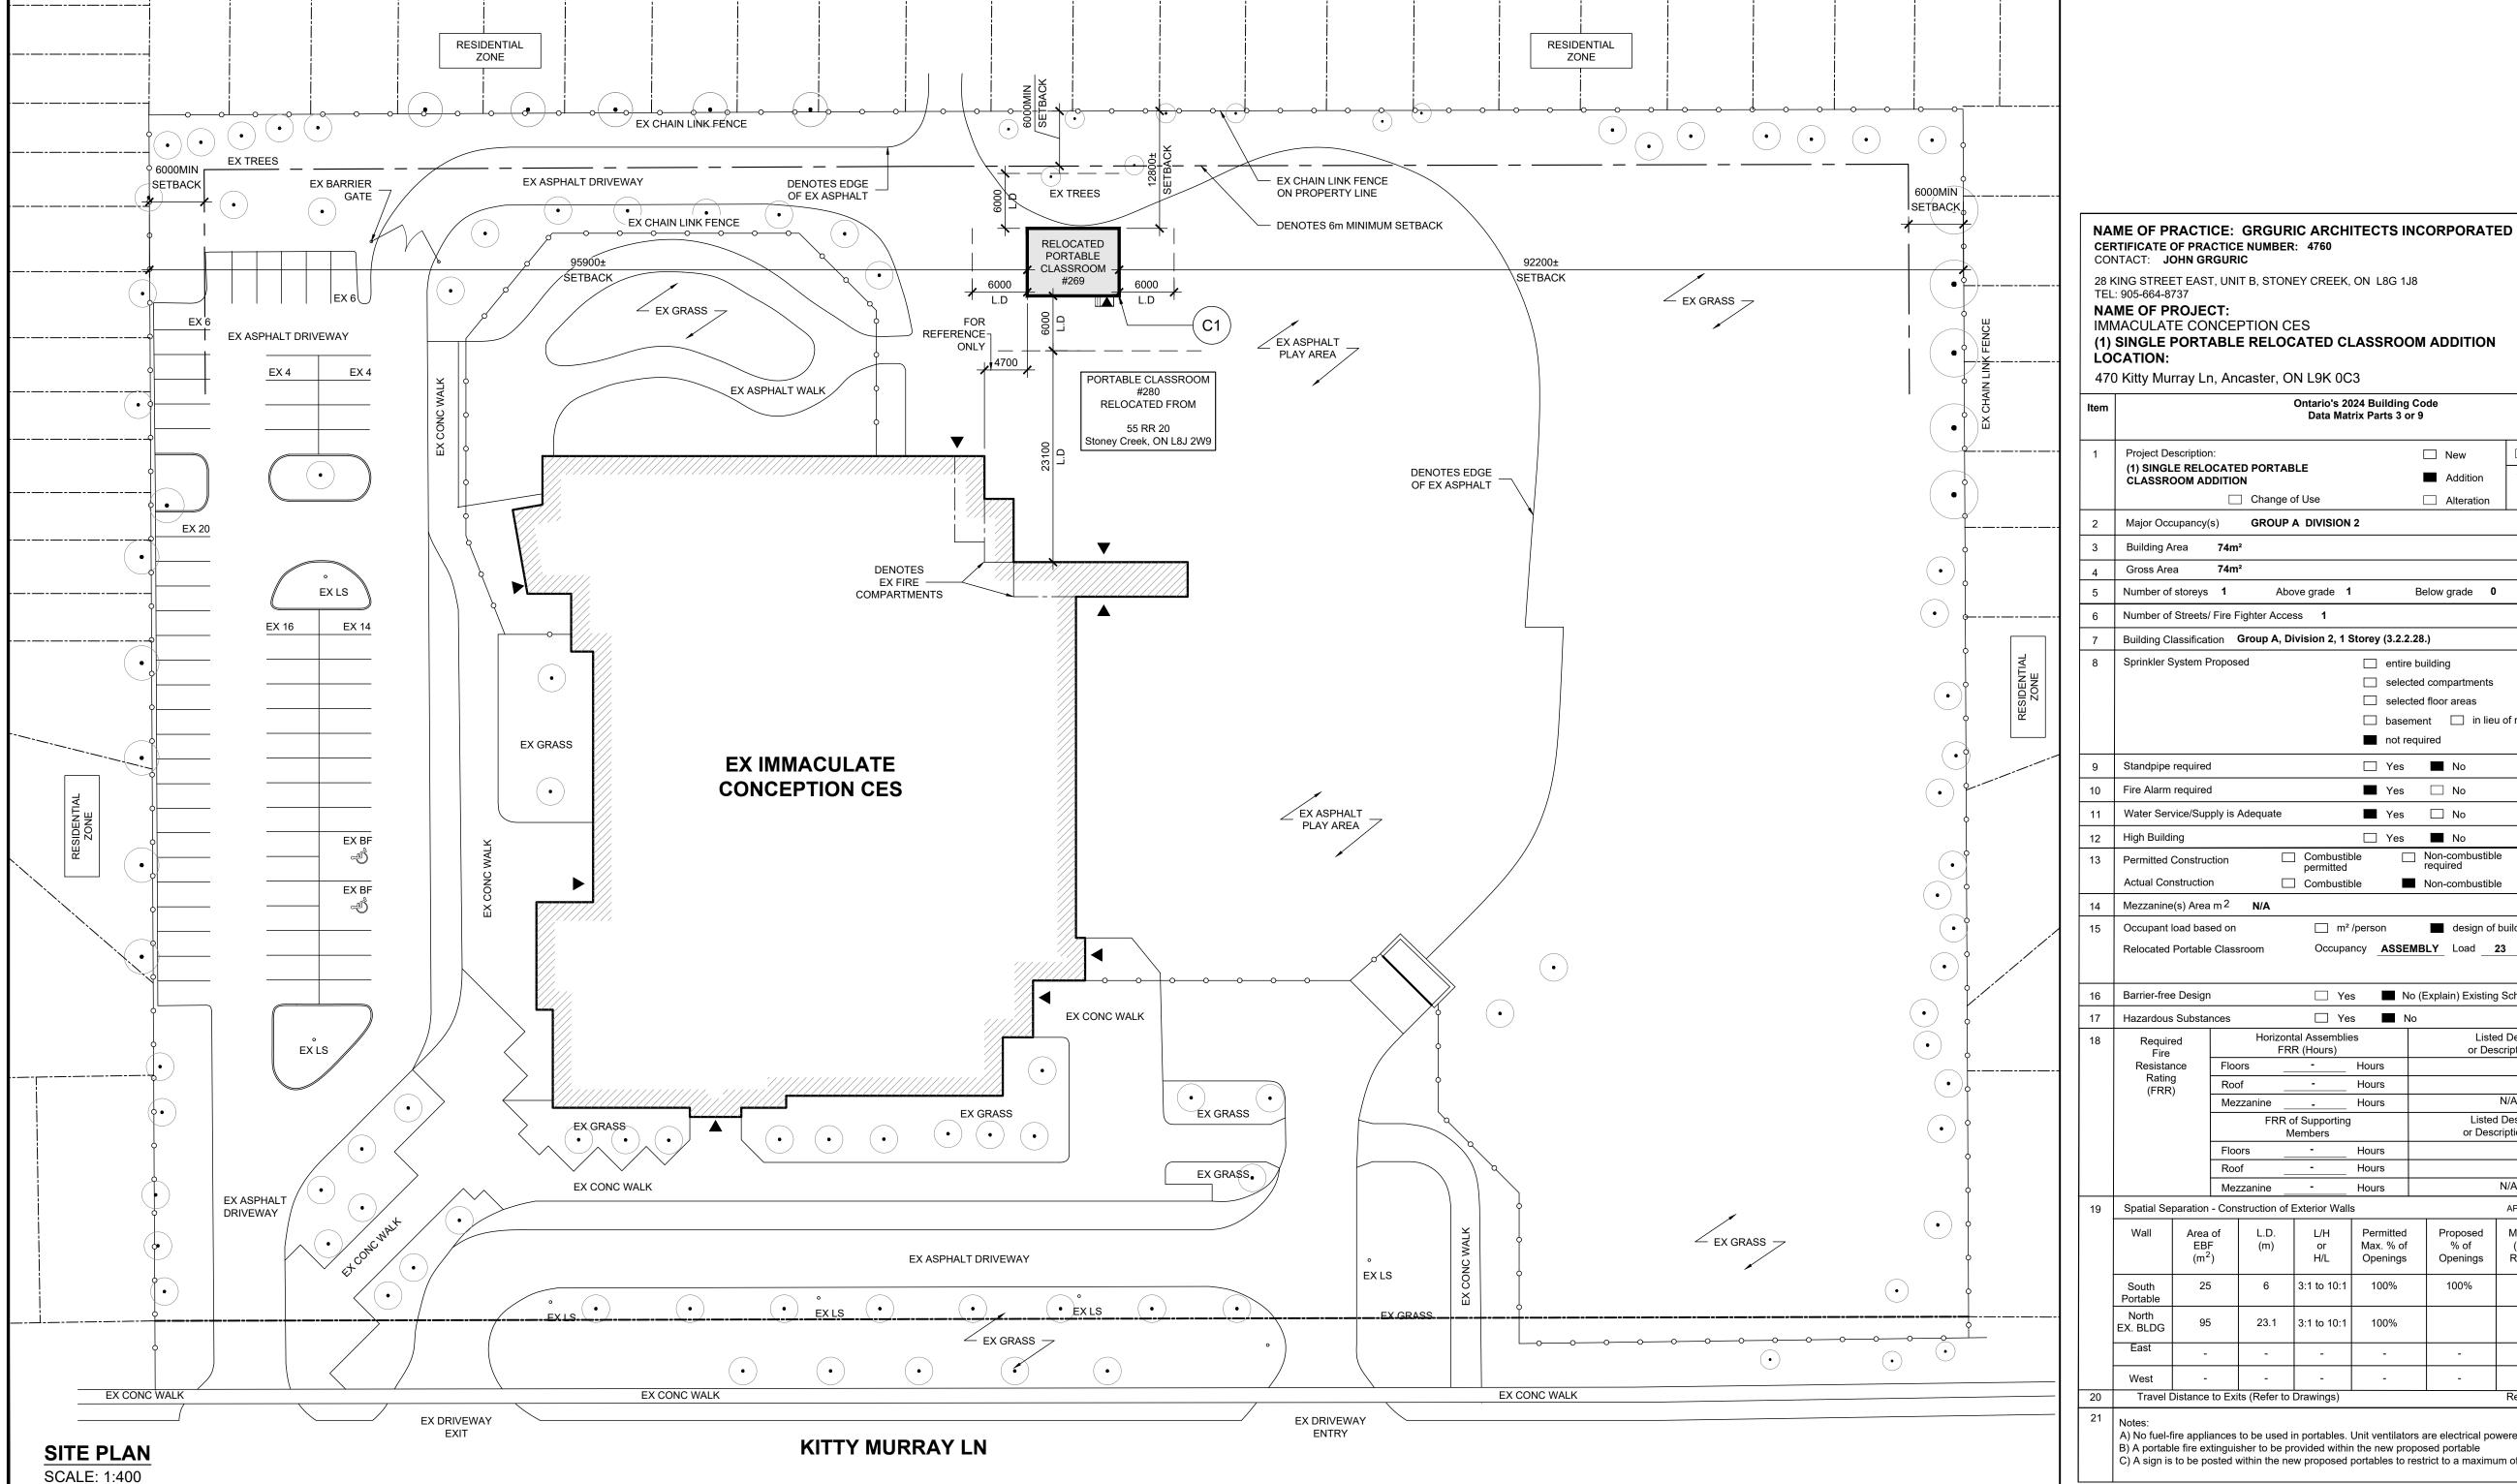

LOCATION: 470 Kitty Murray Ln, Ancaster, ON L9K 0C3 **OBC Reference** Ontario's 2024 Building Code Data Matrix Parts 3 or 9 References are to Division B unless noted [A] for Division A or [C] for Division C Project Description: Part 11 (1) SINGLE RELOCATED PORTABLE 11.1 to 11.4 1.1.2 [A] & CLASSROOM ADDITION 9.10.1.3 Change of Use **GROUP A DIVISION 2** 3.1.2.1.(1) 9.10.2 1.4.1.2.[A] 1.4.1.2.[A] Building Area 1.4.1.2.[A] 1.4.1.2.[A] Gross Area 1.4.1.2.[A] & 3.2.1.1 1.4.1.2.[A] & 9.10.4 Number of storeys 1 Above grade 1 Below grade 0 Number of Streets/ Fire Fighter Access 1 3.2.2.10 & 3.2.5 9.10.20. Building Classification Group A, Division 2, 1 Storey (3.2.2.28.) 3.2.2.20.-.83 9.10.2. Sprinkler System Proposed 3.2.2.20.-.83 9.10.8.2 selected compartments 3.2.1.5. selected floor areas 3.2.2.17. ☐ basement ☐ in lieu of roof rating INDEX INDEX not required ☐ Yes ■ No 9 Standpipe required 3.2.9 N/A 10 Fire Alarm required Yes No 9.10.18 Yes No 3.2.5.7. N/A 11 Water Service/Supply is Adequate N/A ☐ Yes ■ No High Building 3.2.6 Non-combustible required 3.2.2.20.-.83 9.10.6 13 Permitted Construction **Actual Construction** Combustible Non-combustible Mezzanine(s) Area m² N/A 3.2.1.1.(3)-(8) 9.10.4.1 Occupant load based on design of building 9.9.1.3 Relocated Portable Classroom 16 Barrier-free Design ☐ Yes ☐ No (Explain) Existing School is Barrier Free 3.8 9.5.2 ☐ Yes ■ N 3.3.1.2. & 3.3.1.19 9.10.1.3(4) Hazardous Substances Listed Design No. or Description (SB-2) Horizontal Assemblies 3.2.2.20.-.83 & 3.2.1.4 9.10.8. FRR (Hours) 9.10.9. Hours Resistance Hours Hours Listed Design No. FRR of Supporting or Description (SB-2) Hours APPENDIX A - CASE 4 3.2.3 19 Spatial Separation - Construction of Exterior Walls 9.10.14 Proposed % of Openings Construction Type Cladding Type (Hours) Required Design or Description Max. % of Required Openings Combustible or 3:1 to 10:1 100% 100% South drawings Noncombustible Noncombustible Portable 23.1 Combustible or Combustible or 3:1 to 10:1 EX. BLDG drawings Noncombustible Noncombustible East Refer to Combustible or Combustible or West Noncombustible drawings Noncombustible

A) No fuel-fire appliances to be used in portables. Unit ventilators are electrical powered. B) A portable fire extinguisher to be provided within the new proposed portable C) A sign is to be posted within the new proposed portables to restrict to a maximum of 23 persons per portable

Travel Distance to Exits (Refer to Drawings)

GENERAL PIER PLAN NOTES


- 1. ALL PIER HEIGHTS TO BE SITE VERIFIED BY CONTRACTOR, SOLID HARDWOOD SHIMS TO
- 2. DUCKBILL ANCHORS TO BE INSTALLED BY PORTABLE MOVING CONTRACTOR. UNDER CASH ALLOWANCE. DENOTED BY DA. ON PIER PLAN.
- 3. FOUNDATION PIERS AND DUCK BILL ANCHORS TO BE INSTALLED AS PER TYPICAL DETAILS 1, 2 & 3.
- 4. EXISTING SOIL BEARING CAPACITY TO BE FIELD VERIFIED PRIOR TO CONSTRUCTION
- 5. LOCATION OF ALL EXISTING PIERS TO BE SITE VERIFIED BY PORTABLE MOVING CONTRACTOR AT EXISTING SITE WHERE PORTABLE IS BEING RELOCATED FROM. EXISTING PIER SPACING AND LAYOUT IS TO BE RE-USED FOR THIS SITE. PIER PLAN IS SHOWN FOR REFERENCE ONLY. ALL DIMENSIONS MUST BE VERIFIED BEFORE INSTALLATION & ADJUSTMENTS MUST BE MADE TO THE FOUNDATION PLAN TO SUIT PER SITE CONDITIONS. ANY DISCREPANCIES TO BE REPORTED TO ARCHITECT PRIOR

CONSTRUCTION NOTES

ALLOW FOR VCT FLOOR REPAIR UNDER CASH ALLOWANCE


NOTE: FLOOR PLAN SHOWN IS A GENERAL ARRANGEMENT OF A TYPICAL EXISTING PORTABLE UNIT. UNIT VENTILATORS, DEVICES, DAMPERS & DOORS, ETC. MAY DIFFER SLIGHTLY FROM WHAT IS SHOWN ON PLAN. TO BE SITE VERIFIED FOR EACH EXISTING PORTABLE TO BE RELOCATED. THIS IS FOR GENERAL REFERENCE. REFER TO SITE PLAN DRAWING &

BUILDING ELEVATIONS FOR ORIENTATION OF PORTABLES & RELATED DETAILS.

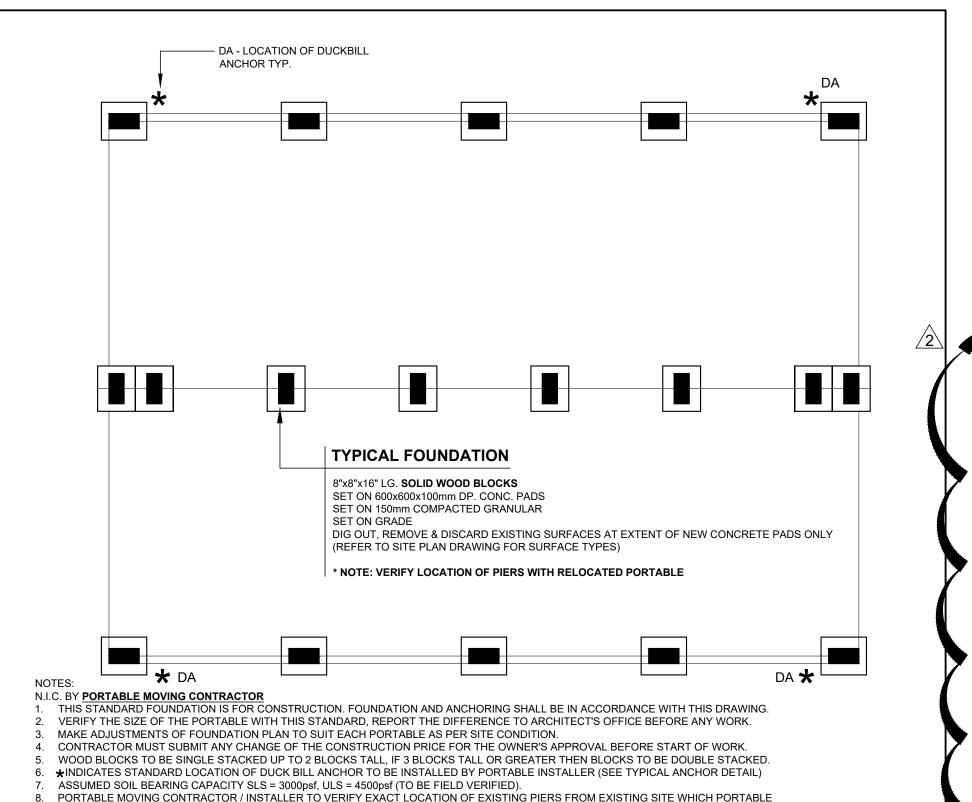

FOUNDATION PIER PLAN (SIMILAR FOR ALL RELOCATED PORTABLES)


IS BEING RELOCATED FROM. EXISTING PIER SPACING AND LAYOUT TO BE RE-USED FOR NEW SITE LOCATION

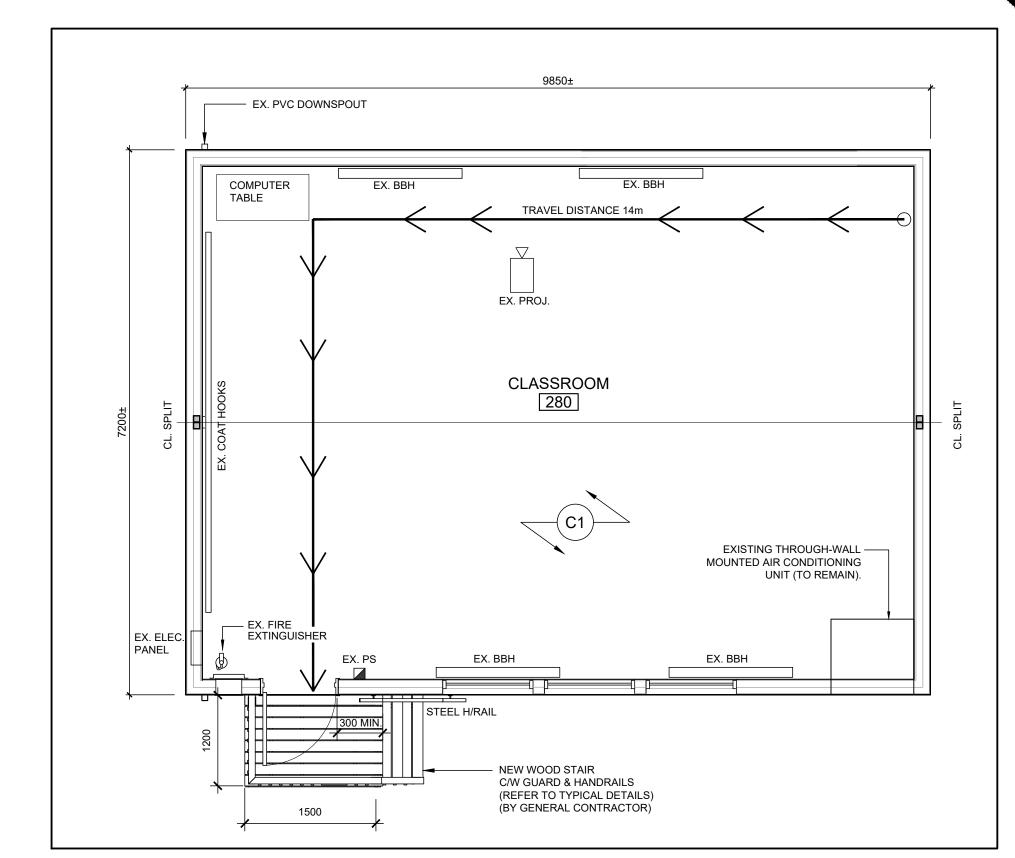

FLOOR PLAN (PORTABLE CLASSROOM)

SCALE: 1:50


PROJECT DESIGN DATA TABLE NORMAL BUILDING IMPORTANCE LIVE LOAD : 2.4 kPa SPECIFIED SNOW AND RAIN LOADS RAIN LOADING DESIGN DATA (1/50) 24 hr. RAIN 108 mm 1.5 kPa SNOW LOADING DESIGN DATA (1/50) Sr 0.4 kPa BASIC ROOF SNOW LOAD 1.6 kPa ADDITIONAL SNOW ACCUMULATION IS SHOWN ON THE DRAWINGS SPECIFIED WIND LOADS HOURLY WIND PRESSURE DESIGN DATA 0.46 kPa WIND DESIGN CATEGORY CATEGORY 2 TERRAIN TYPE 'OPEN' SPECIFIED EARTHQUAKE LOADS SEISMIC LOADING DESIGN DATA PROBABILITY OF EXCEEDANCE IN 50 YEARS = 2% Sa $(2.0, X_D) = 0.0799$ Sa $(0.2, X_D) = 0.375$ Sa $(0.5, X_D) = 0.308$ Sa $(5.0, X_D) = 0.0206$ Sa $(1.0, X_D) = 0.174$ Sa (10.0, X_D) = 0.00636 $PGA(X_D) = 0.235$ $PGV(X_D) = 0.2$ SITE CLASS TO BE CONFIRMED BY GEOTECHNICAL ENGINEER SITE CLASS = D SEISMIC FORCE MODIFICATION FACTORS FOR SEISMIC RESISTING SYSTEM Ro 1.7

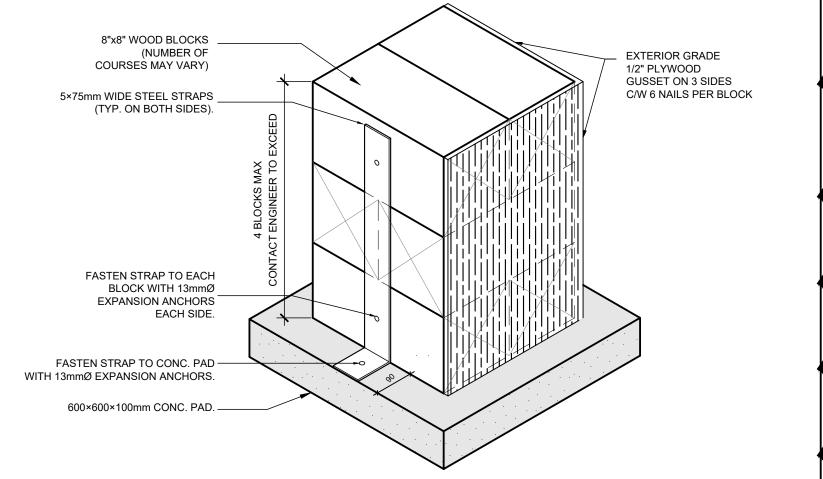


SC3

2 TYP. FOUNDATION PIER PLAN DETAIL (ISOMETRIC) A2.00 SCALE: 1:10


SEISMIC CATEGORY

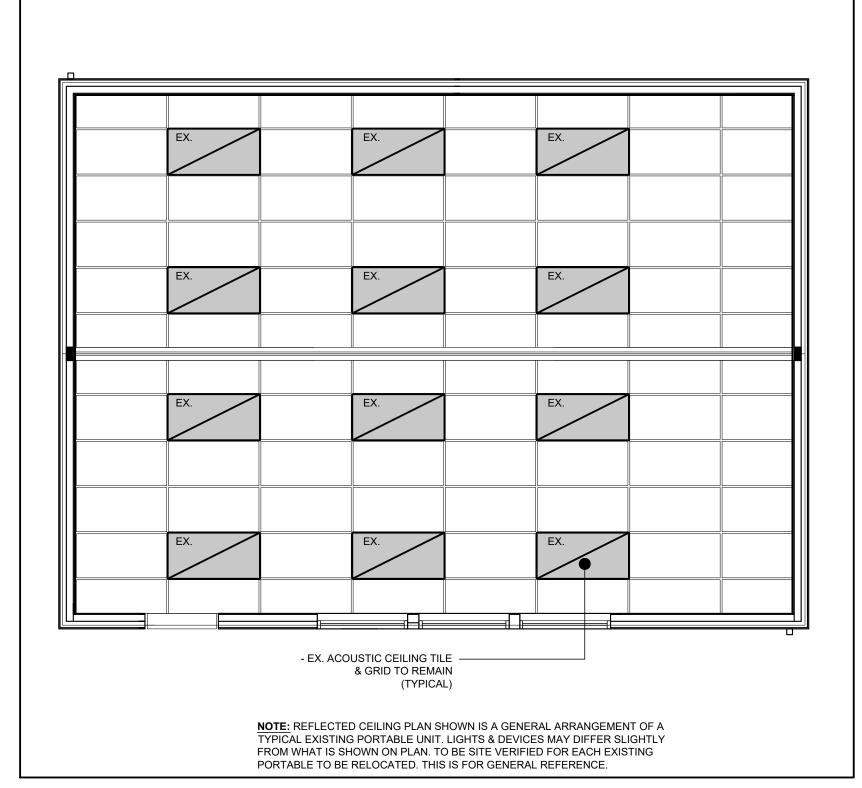

REFLECTED CEILING PLAN (TYPICAL FOR ALL PORTABLES) SCALE: 1:50

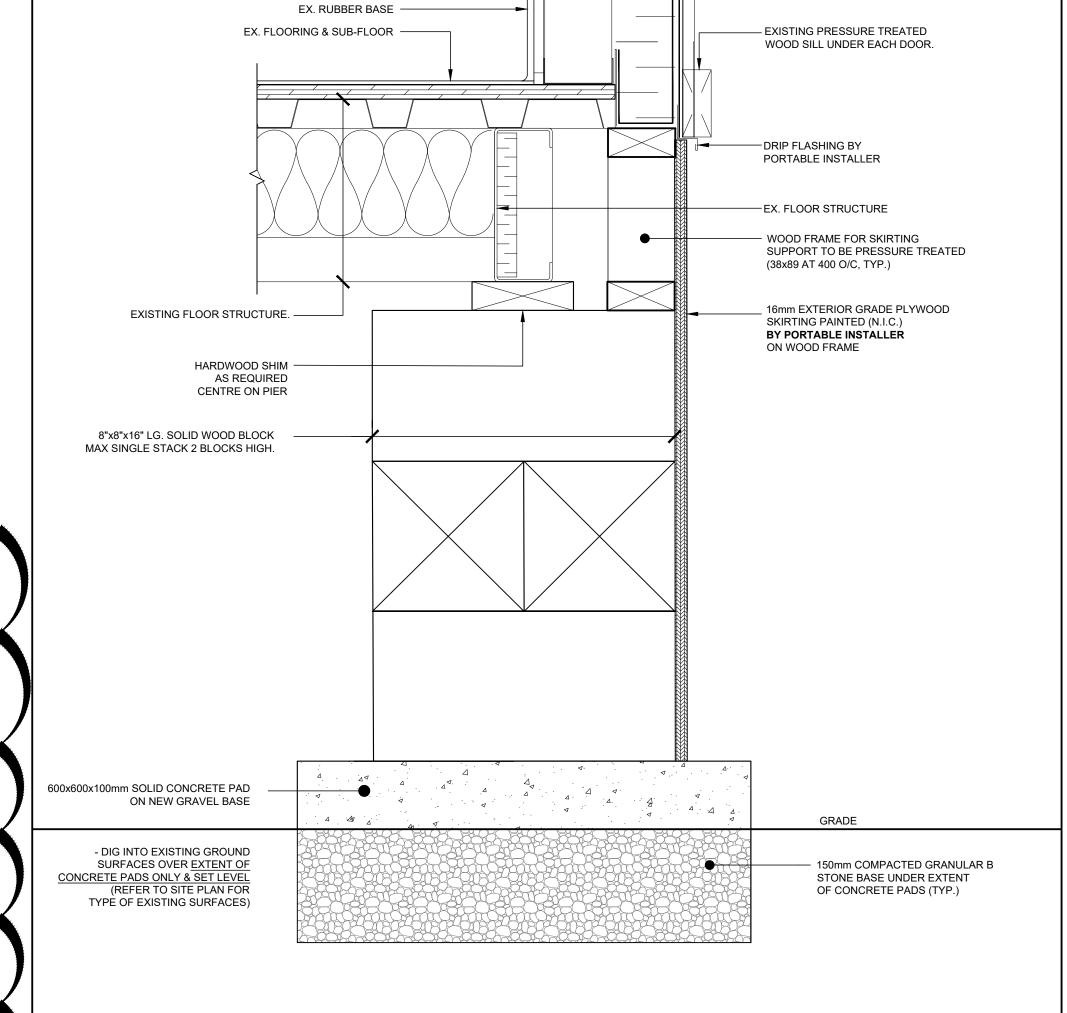

TYP. FOUNDATION PIER DETAIL

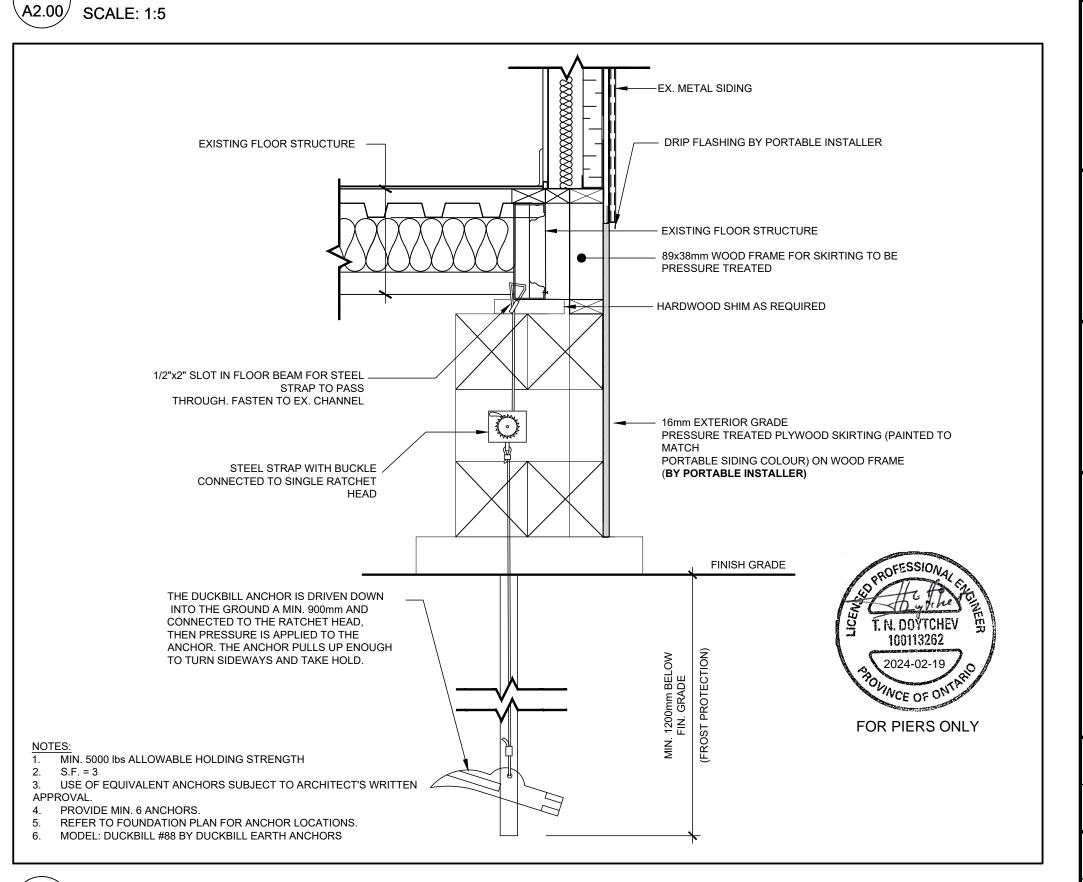

TYPICAL ANCHOR DETAIL



LEGEND

- EXISTING WALL ASSEMBLY.

BF BARRIER FREE CB CATCH BASIN CLF CHAIN LINK FENCE

C/W COMPLETE WITH EX EXISTING

FH FIRE HYDRANT LD LIMITING DISTANCE T/O TOP OF TYP TYPICAL

U/S UNDERSIDE

U/V UNIT VENTILATOR WP WALL PACK

REVISED PER BUILDING DEPT. 2025-02-18 COMMENTS ISSUED FOR BUILDING PERMIT 2025-01-17 REVISIONS

RAWINGS ARE NOT TO BE SCALED. CONTRACTOR MUST CHECK AND VERIFY ALL DIMENSIONS AND CONDITIONS ON THE PROJECT: AND MUST REPORT ANY DISCREPANCIES TO HE ARCHITECTS BEFORE PROCEEDING WITH THE WORK. THE USE OF THIS DRAWING OR PART THEREOF IS FORBIDI /ITHOUT THE WRITTEN APPROVAL OF THE ARCHITECTS



IMMACULATE CONCEPTION CES RELOCATED

PORTABLE CLASSROOM 470 Kitty Murray Ln, Ancaster, ON L9K 0C3

PORTABLE CLASSROOM '280' FLOOR PLANS, PIER PLAN & DETAILS


GRGURIC ARCHITECTS **INCORPORATED**

28 KING STREET EAST, UNIT B STONEY CREEK, ONTARIO, L8G 1J8 Tel. 905-664-8735 Fax. 905-664-8737

Web: www.2gai.com PROJECT: SCALE: AS NOTED 2024-24 START DATE:


DEC 2024 DRAWN CHECKED

A2.00 SCALE: 1:10

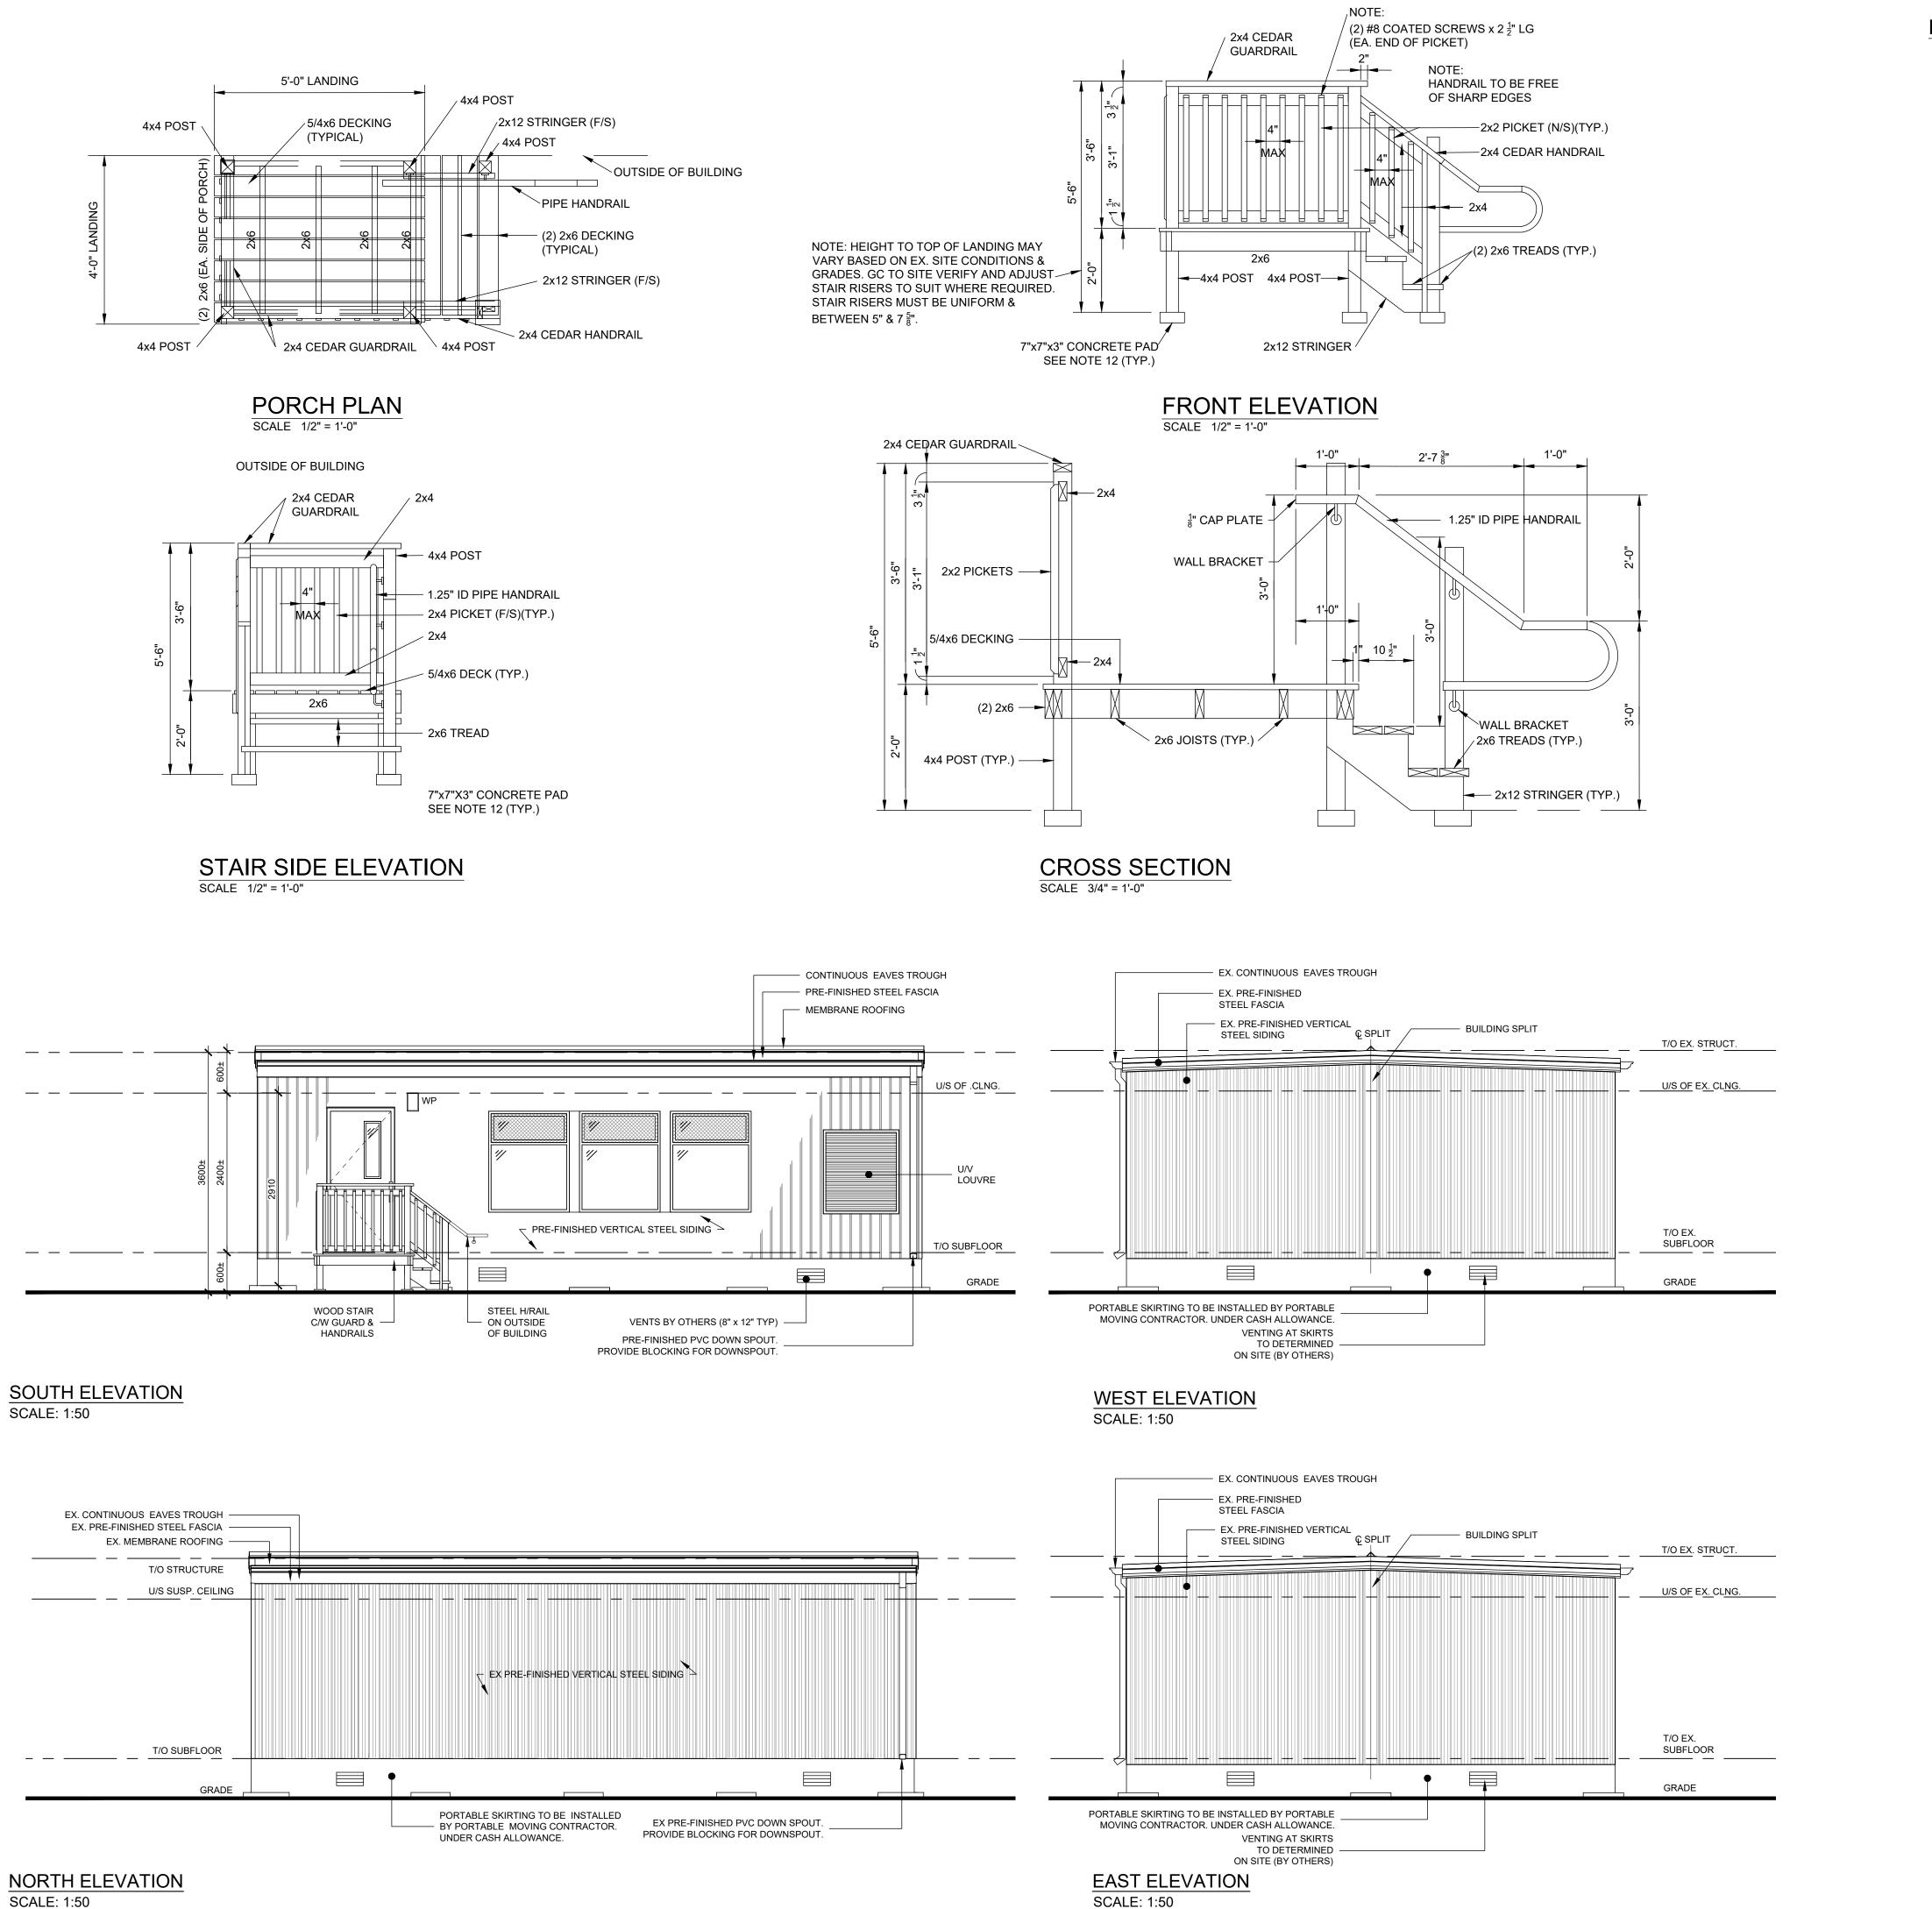


PORCH NOTES


- 1. SCREW PORCH TO POSTS WITH 3" SCREWS, $2\frac{1}{2}$ " SCREWS FOR HANDRAILS, STEPS, AND PICKETS WOOD IS PRESSURE TREATED #2 S.P.F.
- 3. STAIRS MORE THAN 3'-8" IN WIDTH WILL REQUIRE HANDRAILS ON BOTH SIDES, PROVIDE EXTRA
- STRINGER MID POINT OF STAIR.
- 4. STAIR HANDRAIL HEIGHT MUST BE BETWEEN 2'-10" AND 3'-2" MEASURED FROM THE TREAD NOSING. 5. THE LANDING GUARD MUST BE MORE THAN 3'-6" HIGH AND THE STAIR GUARD RAIL MUST BE MORE
- 6. THE LANDING GUARD MUST NOT FACILITATE CLIMBING BETWEEN 5 $\frac{1}{2}$ " TO 3'-0" ABOVE LANDING.
- 7. THE RISE BETWEEN STAIRS MUST BE UNIFORM AND BE BETWEEN 5" AND 7 $\frac{7}{8}$ ".
- ENSURE A CLEAR SPACE OF 1'-0" FROM DOOR TO THE FIRST RISER.
- 9. NOTE: FINAL RISE TO BE SITE VERIFIED PRIOR TO CONSTRUCTION. 10. GUARDS AND RAILINGS TO WITHSTAND 0.75kN/M OR A CONCENTRATED LOAD OF 1.0kN APPLIED AT ANY POINT.
- 11. LIVE LOAD STAIR AND LANDING = 4.80kPa
- 12. SITE CONDITIONS DETERMIN PORCH AND STAIR FOUNDATION. 7"x7"x3" CONCRETE PADS TO BE USED (AS SHOWN ON DRAWING) WHERE AFORMENTIONED STRUCTURE IS PLACED ON GRASS OR DIRT; PT 2x6'S WHERE STRUCTURE IS PLACED ON CONCRETE OR ASPHALT.

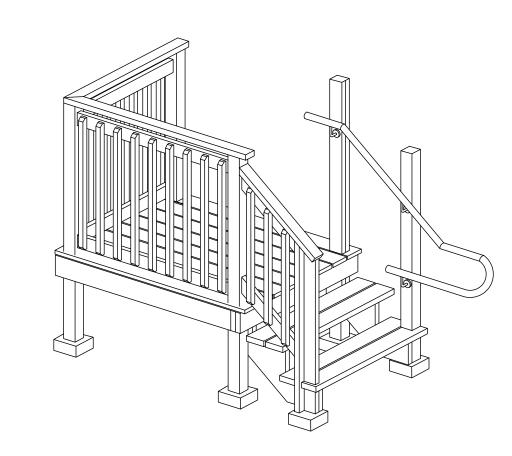

ISOMETRIC VIEW

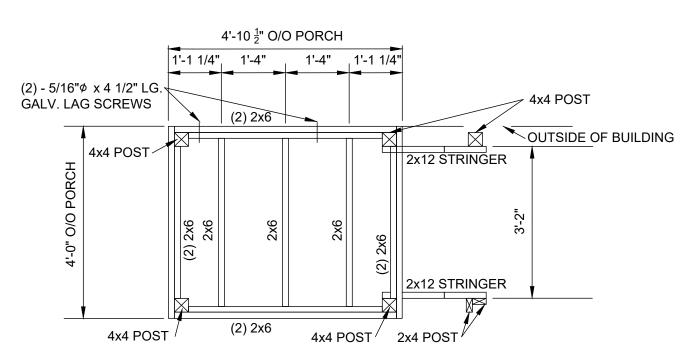

FRAMING PLAN SCALE 1/2" = 1'-0"

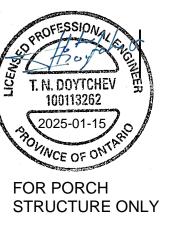




LEGEND

- BF BARRIER FREE CB CATCH BASIN
 CLF CHAIN LINK FENCE
- C/W COMPLETE WITH EX EXISTING
- FH FIRE HYDRANT LD LIMITING DISTANCE
- T/O TOP OF
- TYP TYPICAL U/S UNDERSIDE U/V UNIT VENTILATOR WP WALL PACK

1	ISSUED FOR BUILDING PERMIT	2025-01-17
NO	REVISIONS	DATE

DRAWINGS ARE NOT TO BE SCALED. CONTRACTOR MUST CHECK AND VERIFY ALL DIMENSIONS AND CONDITIONS ON THE PROJECT; AND MUST REPORT ANY DISCREPANCIES TO HE ARCHITECTS BEFORE PROCEEDING WITH THE WORK. THE USE OF THIS DRAWING OR PART THEREOF IS FORBIDI WITHOUT THE WRITTEN APPROVAL OF THE ARCHITECTS.

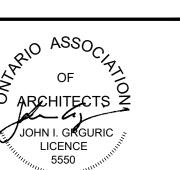

IMMACULATE CONCEPTION CES RELOCATED

PORTABLE CLASSROOM

470 Kitty Murray Ln, Ancaster, ON L9K 0C3

PORTABLE CLASSROOM '280' **ELEVATIONS &** PORCH/STAIR DETAIL

GRGURIC ARCHITECTS **INCORPORATED**




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DEC 2024	
START DATE:	2024-24
AS NOTED	0004 04
SCALE:	PROJECT:

DRAWN CHECKED

W.P. PRINT DATE 01/17/25

EL	ECTRICAL LEGEND		ABBREVIA	TIONS	
	FLUSH MOUNTED, SURFACE MOUNTED PANELBOARDS.	AC	ABOVE COUNTER	NTS	NOT TO SCALE
		AFF	ABOVE FINISHED FLOOR	ОС	ON CENTER
	FIRE ALARM PULL STATION	С	CONDUIT	Р	POLES
	FIRE ALARM HORN/STROBE COMBO	C/B	CIRCUIT BREAKER	PH	PHASE
	FIRE ALARM HEAT DETECTOR	¢	CENTERLINE	STD	STANDARD
		E/EX/EXIST	EXISTING TO REMAIN	SWBD	SWITCHBOARD
		EC	EMPTY CONDUIT	REL	TO BE RELOCATED
		EMT	ELECTRICAL METALLIC TUBING	REM	TO BE REMOVED
		FA	FIRE ALARM	TYP	TYPICAL
		G/GRD/GND	GROUND	UNF	UNFUSED
		HP	HYDRO POLE	UON	UNLESS OTHERWISE NOTED
		MTD	MOUNTED	W	WIRE
		N/NEW	NEW EQUIPMENT	WP	WEATHERPROOF
		NIC	NOT IN CONTRACT		

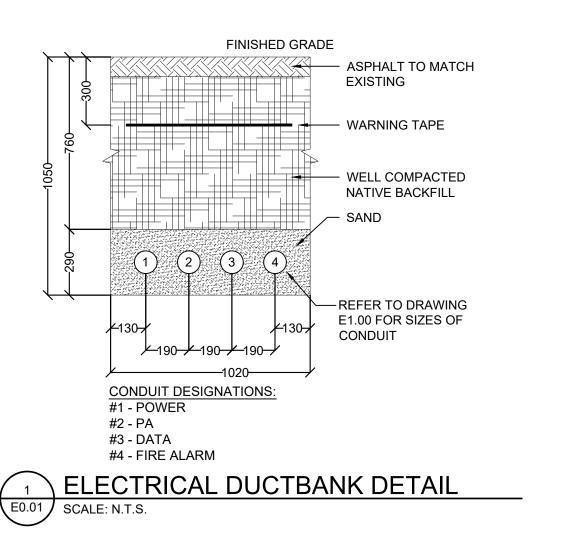

ELECTRICAL SPECIFICATIONS

- ALL WORK SHALL BE PERFORMED IN ACCORDANCE WITH THE CANADIAN ELECTRICAL CODE, THE LATEST ONTARIO ELECTRICAL SAFETY CODE, ONTARIO BUILDING CODE AND THE ONTARIO FIRE CODE.
- 2. ALL FIRE ALARM EQUIPMENT SHALL BE INSTALLED IN ACCORDANCE WITH CAN/ULC-S524M AND SHALL BE TESTED IN ACCORDANCE WITH CAN/ULC S537M. ALL WORK SHALL BE PERFORMED BY AN APPROVED / CERTIFIED CONTRACTOR. ALL FIRE ALARM INSTALLATIONS AND EQUIPMENT SHALL BE IN CONFORMANCE WITH THE LATEST EDITION OF THE CAN/ULC S-524, CAN/ULC-S525, CAN/ULC-S526, CAN/ULC-S527, CAN/ULC-S528, CAN/ULC-S529, CAN/ULC-S530, AND SUBJECT TO THE LOCAL AUTHORITIES HAVING JURISDICTION. ALL TESTING AND VERIFICATION SHALL BE IN CONFORMANCE WITH CAN/ULC S-537. PROVIDE FINAL ACCEPTANCE, VERIFICATION TEST / REPORTS & CERTIFICATION OF ENTIRE SYSTEM. SUPPLY AND INSTALL ALL NECESSARY EQUIPMENT & MATERIALS TO ACCOMMODATE DEVICES WIRING, ETC. ALL WORK SHALL BE PERFORMED BY AN APPROVED / CERTIFIED CONTRACTOR.
- 3. ALL EMERGENCY/EXIT LIGHTING EQUIPMENT TO MEET CSA C22.2 NO.141-M.
- 4. THE WORK SHALL CONSIST OF FURNISHING ALL LABOR, MATERIALS, TOOLS AND EQUIPMENT NECESSARY TO COMPLETE ALL ELECTRICAL WORK AS INDICATED ON THE DRAWINGS AND THE SPECIFICATIONS. ALL EQUIPMENT AND LABOUR TO BE WARRANTED FOR A PERIOD OF ONE (1) YEAR FROM THE DATE OF FINAL ACCEPTANCE OF THE WORK AS OUTLINED IN THE CONTRACT DOCUMENTS.
- 5. PORTABLE SUPPLIER TO PROVIDE ENGINEERED STAMPED AND SIGNED DRAWINGS FOR PERMIT APPLICATION AND SHALL BE RETAIN A LICENSED ELECTRICAL CONTRACTOR TO PERFORM THE WORK AND ARRANGE AND PAY FOR ALL NECESSARY PERMITS, INSPECTIONS AND VERIFICATIONS AS REQUIRED BY CODE INCLUDING ELECTRICAL SAFETY AUTHORITY INSPECTION, FIRE ALARM SYSTEM RE-VERIFICATION BY EQUIPMENT MANUFACTURER, FIRE MARSHALS TESTING AND LOCAL BUILDING DEPARTMENT REVIEW.
- 6. CONTRACTOR TO PROVIDE FOUR (4) SETS OF WRITTEN OPERATING AND MAINTENANCE INSTRUCTIONS FOR SCHOOL BOARDS UPON COMPLETION OF WORK.
- 7. CONTRACTOR SHALL PROVIDE TRAINING BY ALL EQUIPMENT SUPPLIERS TO INSTRUCT SCHOOL BOARD DESIGNATED PERSONNEL ON THE CARE, OPERATION, TESTING AND MAINTENANCE OF NEW EQUIPMENT AND SYSTEMS.
- 8. APPROPRIATE SHOP DRAWINGS TO BE SUBMITTED TO ARCHITECT AND CONSULTANT FOR REVIEW AND APPROVAL PRIOR TO ORDER PLACEMENT.
- 9. ALL CUTTING/PATCHING FOR ELECTRICAL WORK SHALL BE BY DESIGN-BUILDER, THE REPAIR OF ALL OPENINGS MADE IN FIRE SEPARATIONS SHALL BE THE RESPONSIBILITY OF THIS CONTRACTOR. FILL ALL OPENINGS WITH APPROPRIATE LISTED FIRE STOP MATERIAL. (SPRAY FOAM PRODUCTS ARE NOT ALLOWED). ELECTRICAL CONTRACTOR TO LOCATE AND SIZE ALL OPENINGS REQUIRED.
- 10. VERIFY ALL EXISTING CONDITIONS IN THE FIELD AND INCLUDE IN THE BID PRICE ALL WORK REQUIRED TO ACCOMMODATE THE EXISTING INSTALLATION.
- 11. COORDINATE WORK WITH ALL OTHER TRADES.
- 12. ALL WALL MOUNTED POWER, DATA AND TELEPHONE OUTLETS SHALL BE MOUNTED AT BUILDING STANDARD HEIGHT, UNLESS OTHERWISE SHOW ON ARCHITECTURAL DRAWINGS. COLOR AND FINISH OF DEVICES AND PLATES SHALL MATCH EXISTING IN FINISHED AREA, UNLESS OTHERWISE SELECTED BY THE ARCHITECT.
- 13. ALL WIRING SHALL BE RUN IN CONDUIT OR CABLE TO SUIT THE APPLICATION. ALL CONDUIT TO BE EMT CONDUIT C/W STEEL BOXES IN CONCEALED LOCATIONS & SERVICE ROOMS, WHITE WIRE MOLD C/W WIRE MOLD BOXES IF EXPOSED IN STUDENT OR TEACHER AREAS AND PVC DB TYPE II FOR UNDERGROUND APPLICATIONS. ALL CONDUIT SHALL BE 3/4"
- 14. CONCEAL NEW WIRING WHEREVER POSSIBLE. AC TYPE MAY BE USED IN CEILING SPACES, WALL CHASES ETC. SHORT RUN FROM OUTLET BOX TO DEVICE ONLY. ANY EXPOSED WIRING IN CEILING SPACES SHALL BE CSA FT6 RATED. SURFACE MOUNTED WORK IN ALL AREAS SHALL BE MINIMIZED. SEEK ARCHITECT'S APPROVAL.
- 15. ALL WIRE AND CABLE SHALL BE XLPE, RW90 OR RWU90 FOR UNDERGROUND APPLICATIONS, COPPER WITH 600V INSULATION SIZED ACCORDING TO THE APPLICATION. MINIMUM SIZE #12 AWG FOR POWER C/W CSA FT6 LABELED PLENUM RATED JACKET IF RUN EXPOSED IN CEILING SPACES. COLOR OF INSULATION TO MATCH EXISTING INSTALLATION.
- 16. CONDUIT INSTALLATION SHALL PROVIDE GROUND CONTINUITY. PROVIDE SEPARATE GROUND CONDUCTORS WHERE INDICATED ON DRAWINGS AND WHERE REQUIRED BY CODE.
- 17. A UPDATED AND/OR COMPLETE TYPEWRITTEN PANEL DIRECTORY SHALL BE PROVIDED FOR ALL PANELBOARDS. LABEL ALL ELECTRICAL EQUIPMENT WITH MECHANICALLY FASTENED LAMACOID NAMEPLATES, WHITEWITH BLACK LETTERS DEPICTING VOLTAGE, PHASE, FEED BREAKER NUMBER & LOCATION AND DEVICE NAME.
- 18. SAFETY SWITCHES SHALL BE HEAVY DUTY TYPE QMQB, 600 VOLTS AND SHALL BE INDIVIDUALLY MOUNTED IN A NEMA 1 TYPE ENCLOSURE. SIZE SHALL BE AS INDICATED ON THE CONTRACT DRAWINGS. SWITCH SHALL BE SUITABLE AS SERVICE ENTRY EQUIPMENT. SWITCHES SHALL BE BY SQUARE D OR APPROVED EQUAL.
- 19. ALL FUSES SHALL BE BUSSMAN, CURRENT LIMITING TYPE LPS-RK, SIZE AS INDICATED ON THE CONTRACT DRAWINGS.
- 20. PANELBOARD SHALL BE CIRCUIT BREAKER DISTRIBUTION TYPE RATED 240 VOLTS, 400 AMPS, 3 PHASE, 4-WIRE WITH BOLT ON MULTI-POLE CIRCUIT BREAKERS IN NEMA 1 ENCLOSURE. INTERRUPTING RATING SHALL BE 18,000 AMPERES, SYMMETRICAL. PROVIDE 400A, 3-POLE MAIN BREAKER, SIX(6) 100A, 3-POLE BRANCH BREAKER AND FOUR(4) 3-POLE SPACES FOR FUTURE BREAKERS.
- 21. CONDUCTOR SIZES ARE BASED ON CONNECTED EQUIPMENT HAVING A TEMPERATURE MARKING OF 75°C OR HIGHER. WHERE EQUIPMENT DOES NOT HAVE A TEMPERATURE MARKING OR IT HAS A MARKING LOWER THAN 75°C, INCREASE THE SIZE OF THE CONDUCTORS ACCORDINGLY, TO THE SATISFACTION OF THE CONSULTANT.
- 22. FOR WIRES IN CONDUIT, CONDUCTOR SIZES ARE BASED ON NOT MORE THAN 3 CURRENT CARRYING CONDUCTORS IN A CONDUIT. WHERE MORE THAN 3 CURRENT CARRYING CONDUCTORS ARE INSTALLED IN A CONDUIT INCREASE THE CONDUCTOR SIZE ACCORDINGLY, TO THE SATISFACTION OF THE CONSULTANT.
- 23. TRENCH BACKFILLING: PROVIDE A BASE LAYER OF SAND AT LEAST 100MM (4") DEEP. TAMP SAND AROUND AND OVER CONDUITS, DUCTS AND CABLES, IN 150 MM (6") LAYERS TO A HEIGHT OF AT LEAST 300 MM (12") ABOVE TOP OF CONDUITS, DUCTS AND CABLES. COMPACT EACH SAND LAYER. FILL REMAINDER OF TRENCH IN 300 MM (12") LAYERS WITH GRANULAR 'A' MATERIAL, FREE FROM STONE. COMPACT EACH LAYER TO PREVENT UNDUE SETTLEMENT. DO NOT USE MATERIAL FROM EXCAVATION FOR BACKFILLING.

- 24. POWER: PROVIDE NEW 125A 208V/1PH CIRCUIT FROM THE EXISTING SWITCHBOARD 'PP-1' IN THE MAIN ELECTRICAL ROOM OF THE MAIN SCHOOL C/W NEW 125A/2P BREAKER. PROVIDE NEW FEEDER FROM EXISTING PANEL TO RELOCATED PORTABLE LOCATION. REFER TO DRAWING E1.00 AND TRENCH DETAILS FOR MORE INFORMATION.
- **25. LIGHTING**: EXISTING LIGHT FIXTURES WITHIN THE PORTABLES TO REMAIN AS IS. ENSURE PROPER OPERATION OF ALL UNITS. REPLACE ANY DAMAGED PARTS WITH NEW TO MATCH EXISTING.
- 26. EMERGENCY/EXIT LIGHTING: EXISTING EXIT AND EMERGENCY LIGHTING UNITS TO REMAIN AS IS. ENSURE PROPER OPERATION OF ALL UNITS. REPLACE ANY DAMAGED PARTS WITH NEW TO MATCH EXISTING.
- 27. FIRE ALARM: PROVIDE NEW FIRE ALARM HORN/STROBE COMBOS, HEAT DETECTORS AND PULL STATIONS WITH NOTIFIER DEVICES TO BE COMPATIBLE WITH THE EXISTING NOTIFIER PANEL LOCATED IN MAIN ELECTRICAL ROOM IN THE MAIN SCHOOL. PROVIDE NEW CONDUIT AND FEEDER FROM MAIN PANEL TO PORTABLE LOCATION. PROGRAM AND ADD ALL EQUIPMENT TO CONTROL THE NEW DEVICES. PROVIDE SECUREX TYPE CABLE WIRING AS REQUIRED TO CONNECT DEVICES TO THE FIRE ALARM SYSTEM. RETAIN NOTIFIER/ HAMILTON FIRE CONTROL TO RE-VERIFY FIRE ALARM SYSTEM, UPDATE PASSIVE GRAPHIC DIAGRAMS AND FOR DEVICE SPECIFICATIONS AND REQUIREMENTS. PROVIDE NEW UNDERGROUND CONDUIT DEDICATED FOR THE FIRE ALARM FROM THE EXTERIOR OF THE MAIN SCHOOL TO RELOCATED PORTABLE. NEW UNDERGROUND CONDUITS TO BE STUBBED UP AT THE PORTABLE LOCATION. CONTRACTOR TO ROUTE CONDUIT SO AS TO TERMINATE AT THE PORTABLE LOCATIONS.
- 28. PUBLIC ADDRESS: PROVIDE NEW UNDERGROUND CONDUIT FROM THE EXTERIOR OF THE MAIN SCHOOL TO THE RELOCATED PORTABLE. PROVIDE NEW WIRING FROM THE MAIN PA PANEL IN THE MAIN ELECTRICAL ROOM OF THE MAIN SCHOOL. NEW UNDERGROUND CONDUIT TO BE STUBBED UP AT THE PORTABLE LOCATIONS AS REQUIRED. CONTRACTOR TO ROUTE CONDUIT SO AS TO TERMINATE AT THE PORTABLE LOCATIONS. CONTRACTOR TO PROVIDE THE FOLLOWING:
- PROVIDE ONE CAT5e CABLE FROM THE MAIN PA PANEL ABOVE THE CORRIDOR CEILING TO RELOCATED PORTABLE.
- RETAIN HAMILTON VIDEO AND SOUND TO PROGRAM THE NEW SPEAKERS AND FINAL TESTING.
- 28. DATA: PROVIDE NEW DATA CABLES FROM THE IT RACK IN THE EXISTING IT ROOM IN THE DATA ROOM ON THE GROUND FLOOR OF THE MAIN SCHOOL. TERMINATE IN EACH OUTLET IN THE RELOCATED PORTABLE. ELECTRICAL CONTRACTOR SHALL PROVIDE MINIMUM 21MM (3/4") DIA. CONDUIT OF EMT, AND BOXES, INCLUDING PULL STRINGS, FOR ALL NEW DATA DEVICES. PROVIDE NEW UNDERGROUND CONDUIT FROM THE EXTERIOR OF THE MAIN SCHOOL TO RELOCATED PORTABLE FOR NEW DATA LINES. NEW UNDERGROUND CONDUIT TO BE STUBBED UP AT THE PORTABLE LOCATION. CONTRACTOR TO ROUTE CONDUIT SO AS TO TERMINATE AT THE PORTABLE LOCATIONS.
- 28.1. ELECTRICAL CONTRACTOR SHALL COORDINATE ALL REQUIREMENTS WITH DATA SUBCONTRACTOR AND BOARD'S INFORMATION & COMMUNICATION TECHNOLOGY DEPARTMENT DAVID KNIGHT (905 525-2930 x 2990, dknight@hwdsb.on.ca) PRIOR TO INSTALLING ANY OUTLETS, CONDUIT ETC.

28.2. APPROVED CONTRACTORS

28.2.1. THE FOLLOWING SCHOOL BOARD APPROVED NETWORK AND DATA SUBCONTRACTORS SHALL PROVIDE BIDS TO THE ELECTRICAL CONTRACTORS FOR THIS PROJECT:

28.2.1.1. SECURE SOLUTIONS

TONY WARD 905-869-0999

TONY@SECURESOLUTION.CA

28.2.1.2. NETWORK ACP


CARL STARKES 905-467-0898


CSTARKES@NETWORKACP.COM

28.2.1.3. 3TEC INC.

SCOTT WAINWRIGHT 905-573-3832 SCOTT@3TEC.CA




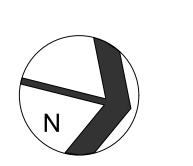

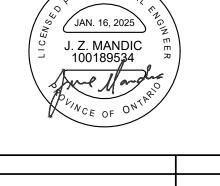

ISSUED FOR PERMIT/TENDER	2025-01-1	
REVISIONS	DATE	
VINGS ARE NOT TO BE SCALED. CONTRACTOR MUST IK AND VERIFY ALL DIMENSIONS AND CONDITIONS ON PROJECT; AND MUST REPORT ANY DISCREPANCIES TO ARCHITECTS BEFORE PROCEEDING WITH THE WORK.		

THE PROJECT; AND MUST REPORT ANY DISCREPANCIES TO THE ARCHITECTS BEFORE PROCEEDING WITH THE WORK.
THE USE OF THIS DRAWING OR PART THEREOF IS FORBIDDE!
WITHOUT THE WRITTEN APPROVAL OF THE ARCHITECTS.

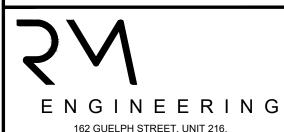

IMMACULATE
CONCEPTION CES
RELOCATED

GEORGETOWN ONTARIO 17G 4A6

TEL: (416) 726-1648 | (905) 617-4808

PORTABLE CLASSROOM

470 Kitty Murray Ln, Ancaster, ON L9K 0C3

ELECTRICAL SPECIFICATIONS, SCHEDULES AND DETAILS

GRGURIC ARCHITECTS INCORPORATED



28 KING STREET EAST, UNIT B STONEY CREEK, ONTARIO, L8G 1J8 Tel. 905-664-8735 Fax. 905-664-8737 Web: www.2gai.com

PROJECT:

SCALE:

START DATE:
JAN 2025

DRAWN
JM

DRAWING:

CHECKED E0.0


PRINT DATE 01/16/25

EQUIPMENT LIST:


- EXISTING 800A 120/208V/3PH/4W SWITCHBOARD 'PP-1' LOCATED IN MAIN ELECTRICAL ROOM TO REMAIN AS IS. PROVIDE ONE (1) NEW 125/2P BREAKER FOR RELOCATE PORTABLE. PROVIDE 3#1AWG + GND IN 41mm (1-1/2") DIA. PVC CONDUIT FOR PORTABLE POWER. CONFIRM EXACT ROUTING ON SITE PRIOR TO TENDERING.
- (B) EXISTING MAIN IT RACK LOCATED IN DATA ROOM TO REMAIN AS IS.
- EXISTING NOTIFIER FIRE ALARM PANEL TO REMAIN AS IS. PROVIDE NEW WIRING FOR NEW PORTABLE DEVICES CONNECTED TO NEW ZONE IN THE FIRE ALARM PANEL. NEW WIRING TO BE ROUTED FROM PANEL THROUGH THE CEILING SPACE OF THE CORRIDOR ON THE GROUND FLOOR.
- EXISTING DUKANE PA MAIN PANEL IN MAIN ELECTRICAL ROOM TO REMAIN AS IS. ALL NEW CABLES FOR THE PA EQUIPMENT IN THE NEW PORTABLES TO BE TERMINATED IN MAIN PANEL. NEW WIRING TO BE ROUTED FROM PANEL THROUGH THE CEILING SPACE OF THE CORRIDOR ON THE GROUND FLOOR.

DRAWING NOTES:

- PROVIDE NEW UNDERGROUND DUCTBANK FROM THE EXTERIOR OF THE MAIN SCHOOL STUBBED UP IN NEW PORTABLE AS INDICATED:
 - 1 53mm (2") DIA. DB2 CONDUIT FOR PORTABLE POWER.
 - 1 53mm (2") DIA. DB2 FOR PORTABLE FIRE ALARM.
 - 1 53mm (2") DIA. DB2 FOR PORTABLE P/A.
 1 53mm (2") DIA. DB2 FOR PORTABLE DATA.
- PROVIDE NEW PULL STRINGS FOR EACH RESPECTIVE CONDUIT FOR PULLING OF NEW CABLES. CONTRACTOR TO PROVIDE LOCATES OF THE AREA TO ENSURE NO DISRUPTION TO EXISTING SERVICES. REFER TO DETAIL 1/E0.01 FOR MORE INFORMATION.
- PROVIDE NEW POWER FEEDER FROM SWITCHBOARD 'PP-1' IN THE MAIN ELECTRICAL ROOM FOR THE RELOCATED PORTABLE. PROVIDE 3#1AWG + GND IN 53mm (2") DIA. CONDUIT TERMINATED IN THE PORTABLE PANEL. CONFIRM ON SITE EXACT ROUTING PRIOR TO TENDERING.
- ALL POWER AND SERVICES FEEDERS/CONDUITS TO BE ROUTED TO THE EXTERIOR OF THE MAIN SCHOOL AND ROUTED UNDERGROUND TO THE PORTABLE LOCATION. REFER TO DRAWING E0.01 FOR DUCTBANK REQUIREMENTS. CONTRACTOR TO CONFIRM EXACT ROUTING OF ALL SERVICES FROM THEIR RESPECTIVE PANELS TO THE EXTERIOR PRIOR TO TENDERING.

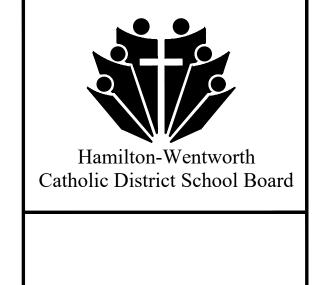



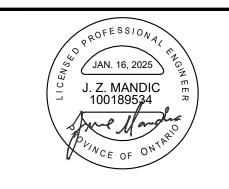

1	ISSUED FOR PERMIT/TENDER	2025-01-
VО	REVISIONS	DATE
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CHECK AND VERIFY ALL DIMENSIONS AND CONDITIONS ON THE PROJECT; AND MUST REPORT ANY DISCREPANCIES TO THE ARCHITECTS BEFORE PROCEEDING WITH THE WORK. THE USE OF THIS DRAWING OR PART THEREOF IS FORBIDDE WITHOUT THE WRITTEN APPROVAL OF THE ARCHITECTS.



ENGINEERING

162 GUELPH STREET, UNIT 216,
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IMMACULATE CONCEPTION CES RELOCATED

PORTABLE CLASSROOM
470 Kitty Murray Ln, Ancaster, ON L9K 0C3

ELECTRICAL SITE PLAN

GRGURIC ARCHITECTS INCORPORATED



28 KING STREET EAST, UNIT B STONEY CREEK, ONTARIO, L8G 1J8 Tel. 905-664-8735 Fax. 905-664-8737 Web: www.2gai.com

SCALE:	PROJECT:
AS NOTED	2405
START DATE:	
JAN 2025	

DRAWN DATE OF THE CHECKED

CHECKED
J.M.

PRINT DATE

01/16/25

