


Location of Work: — Waterloo City Hall 2nd Floor Renovation 100 Regina St S, Waterloo, ON, N2J 4P9



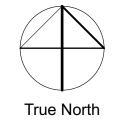

Project Consultants: **Prime Consultant:** John MacDonald Architect Public Utilities Commission Building 195 King Street West, Suite 202 Kitchener, Ontario N2G 1B1 Contact: Scarlett Jang

**Sub-Consultants:** M.A. Bryan Engineering I 285 Weber St. N., Unit B Waterloo, Ontario N2J 3H8 (519)-489-2674 ext.1 Contact: Mark Bryan e-mail: Mark@mabryan.com Mighton Engineering 493 Landcaster St. W, Unit 204 Kitchener, ON, N2K 1L8 (519)-745-3703 ext.114 Contact: Mike Jepson e-mail: mjepson@mighton.com Professional Design:

The design prepared by John MacDonald Architect inc. (the onsultant) and its Subconsultants is intended to govern hanges or alterations as indicated in Documents, solely for the specific project noted, for use by the Owner under the terms nd conditions of an agreement between the Owner and John MacDonald Architect inc. The Documents do not imply a ontractual relationship on the part of John MacDonald Architect inc. or its Subconsultants to any other party for any purpose, including but not limited to their use in the erformance of the Work under agreements between other parties, or the use of the Work by other parties.

General Requirements

his Work includes all measures required for protection of the public, occupants and the Work, including barriers, and protection required for installation of materials and products to nighest standards of quality for workmanship. Contractor shall obtain and conform in all respects to Owner's General Procedures during performance of the Work. See Owner's Operations, Safety, and Security Conditions and Division 1 of the Specification and Sequencing requirements

**Existing Conditions:** 

The design is based upon assumptions regarding existing conditions which are implied in the design. The Contractor is to verify existing conditions as the Work proceeds, and identify mmediately to Owner any condition revealed in the course of the Work which may not conform to initial assumptions xpressed or implied by the Documents. DO NOT PROCEED

nformation shown on drawings is subject to onsite verification. nformation which forms the basis for the preparation of contract documents has been obtained by preliminary site measurement only, and is to be viewed as approximate. Contractor and trades are to investigate existing conditions thoroughly prior to submission of a quotation for the Work, and the submission of such quotation shall be deemed confirmation that the bidder has thoroughly investigated all existing conditions which may affect the performance of work described by the Documents.

Authorities having Jurisdiction Work undertaken is for alterations to an existing D occupancy building, all as described in the Documents. See Sheet A001 for

OBC diagrams & Matrix. It is the Consultant's understanding based upon information from the Owner and onsite confirmation of existing and previous uses that this project does not involve change of use and that no Planning Permissions are required for the Project. All work is to be performed to exceed the standards and regulations of Codes and authorities having jurisdiction. Perform all work in strict accordance with applicable codes and regulations for construction projects, workplace legislation, specifications and reference standards, and WHMIS nstructions for handling and use of materials and site safety. Ensure that the Place of the Work is defined and delineated as required by construction safety and Ministry of Labour regulations. Pay all costs for same.

Specifications and Contract The Drawings shall be read in conjunction with the Contract General Conditions as amended by Supplementary Conditions which are separately bound from the Drawings. The Drawings shall be read in conjunction with the Specifications which are

See also Division 1 of the Specifications

separately bound from the drawings and included in certain instances on the Drawings. All notes and drawings shall be read in conjunction with the Specifications. In case of discrepancy, the more stringent shall apply. Scope of Work:

Renovate existing Group D area to a new office layout as per the Documents. Undertake the work in2 distinct phases for Owner occupancy of each phase to a separate timetable. No change to the use of the building. See Division 1 of the Demolition:

Contractor shall perform all selective demolition required to effect all changes to suit final work as described by the Documents, including removals of plumbing, HVAC, electrical circuits and wiring, as well as alterations to existing architectural, mech. & elec. Relocation of comms panels shall be provided by the Owner. Visit the Site and examine the existing conditions prior to submitting pricing of the Work.

Notes to Flooring: All flooring and base is installed by this contract. Co-ordinate thicknesses and transitions. Confirm products and colours with the Owner prior to ordering.


Notes to Cleaning: Contractor is responsible for all aspects of cleaning operations both during and toward completion of the Work. This includes areas used by the Contractor for access to the Place of the Work. Finished work shall be handed over in occupancy condition. Clean and polish all glass and metal. Vacuum and wipe all surfaces. Prime and finish all board surfaces.

Definitions:

executes the Contract.

Supply" shall mean deliver for assembly and installation, FOB "Install" shall mean receive supply, unload from transport vehicle, transport to location and installation, and assemble and nstall c/w all accessories, fasteners, and items reasonably nferred as required for this work, including cleaning. "Provide" shall mean supply and install. "Owner" shall mean the party with whom the Contractor

List of Documents: Architectural Drawings: A001 General Notes & OBC Matrix A201 2nd Floor Removals Plans A211 2nd Floor Fit-Up Plan A212 Plan Details A213 Section Details A221 2nd Floor Partition Dimension Plan A231 2nd Floor Floor Finishes Plan A501 Removal Reflected Ceiling Plan A511 Reflected Ceiling Plan A711 Millwork Details A801 Interior Elevations A802 Interior Elevations A901 Openings Schedules A911 Room Finishing Schedules M Series Mechanical Drawings: M1 Mechanical Demolition Plan M2 Mechanical HVAC Plan E Series Electrical Drawings: E1 Electrical Schedules 2 Power Plan E3 Life Safety Plan E4 Lighting Plan Note: For required sprinkler system alterations and design, to be furnished by Sprinkler Trade Contractor, see Architectural Sheet A511. List of Abbreviations: See also Specifications section 01090 ANOD Anodized Barrier Free Concrete Block or Catch Basin Centre Line Concrete MasxMonry Unit Control Joint Complete With Dimension Electrical Electrical Panel Existing Existing Expansion Joint Fire Extinguisher F.R.R. Fire Resistance Rating Fire Separation Glass Gridline Gypsum Wallboard Hardwood Inside Lay-in Acoustic Panel Light Fixture Mechanical MG Make Good Not Applicable P.LAM Plastic Laminate Plywood To Be Determined Tempered Glass Unless Noted Otherwise j.c. Job Check: Contractor to confirm measurements to consultant immediately upon completion of selective demolition prior to proceeding with new Work. In case of discrepancy confirm instructions prior to proceedings.

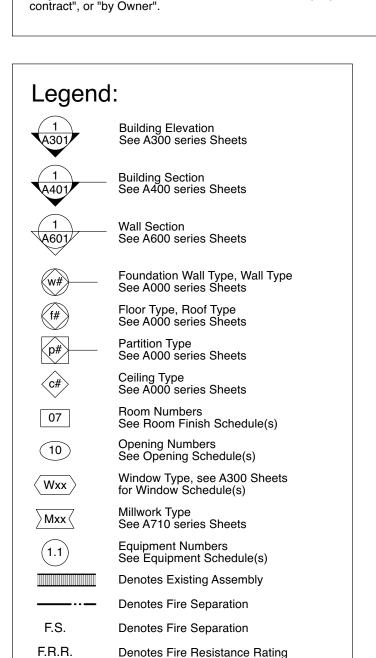


job check indicates dimension which must be confirmed onsite

HOLD Critical dimension: Contractor to maintain exact

N.I.C. Not in Contract: The only means by which something

is by the use of the initials "NIC" or the words "not in (the)

shown or specified shall be indicated as not being in the contract

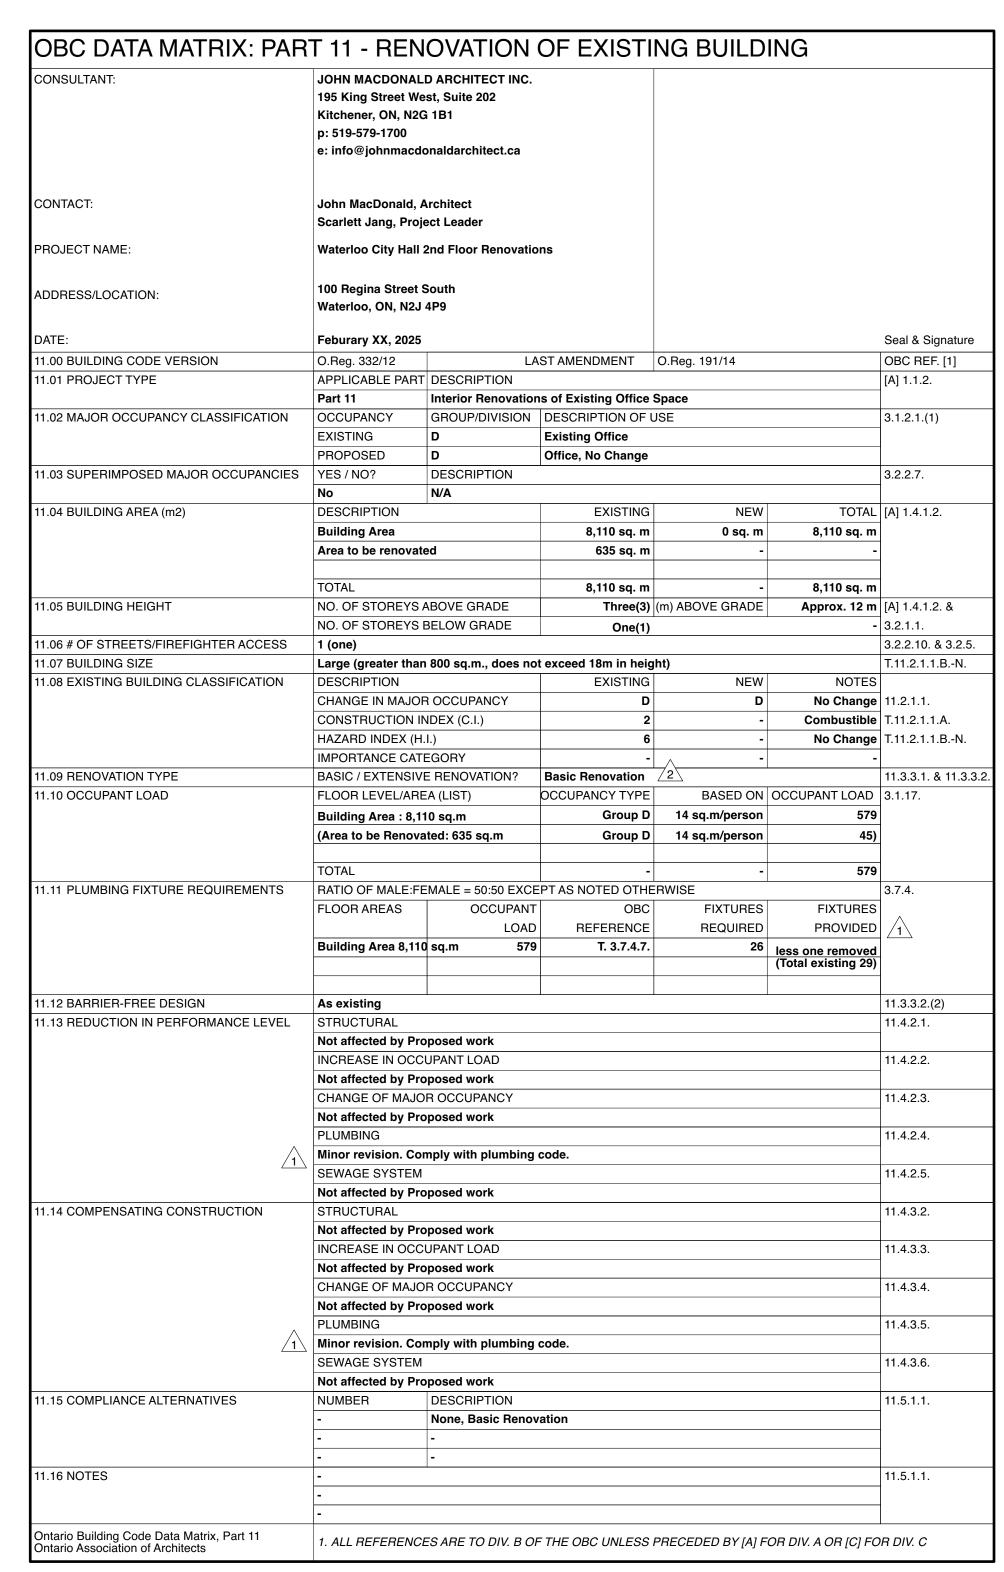

Notes to OBC Matrix:

Plumbing is affected only by the select demolition of an existing washroom, as per Note 1

The plumbing fixture requirements are calculated based upon the total building area and occupancy load even though proposed work is related to only part of 2nd Fl. Building Area = 8,110 sq.m, Occupant Load Based on 8,110/14 = 579 PPL, 579/2 =290 per sex. 13 Water Closets per sex = 26 Total required. 30 Total Existing (Including located on 2nd Fl.) Based on this calculation, one existing washroom on 2nd Fl. will be removed in proposed work, for total of 29.


Note that all exits from the Floor Area remain and are not affected by the Work. Travel distances within the Floor Area have been examined and performance level for access to exit has been maintained. See Electrical and RCP for revisions to emergency lighting and exit signage to suit new paths of access to exit. Work does not affect fire separations. Work affects sprinkler system only for minor revisions to head placement in ceiling and shall be performed for certification to NFPA 13 by

## Wall Type (w):

#	Plan	Description
Ext.  wx1  Int.		Existing Brick Veneer Exterior Wall to Remain u.n.o.  Finish interior wallboard to Finish Schedule after making good any mech or elec work required.

## Partition Types (p):

#	Plan	Description
px1	Varies	Existing Stud Partition to remain or for alteration to 092000.  Finish to Requirements of Finish Schedule.
px2	Ex. 1 HR. FS	Existing Shaft fire-rated Partition to remain.  - 16mm firecode gypsum wallboard on; - 102mm C-H studs at 610 mm on centre; - 25mm Gypsum board between studs; - 75mm batt insulation  (Taken from Existing Documents, to Remain)  Finish to Requirements of Finish Schedule.
<b>(1)</b>	=======================================	New Steel Stud Partition:  - 1 layer 13mm gypsum wallboard taped, spackled, sanded (to 092000) & painted (to 099000)  - 89mm steel studs at 400mm on centre;  - Fill with 75mm Acoustical Batt Insulation;  - 1 layer 13mm gypsum wallboard taped, spackled, sanded (to 092000) & painted (to 099000)
<b>p2</b>	1 HR. FS	New 1.0 hour fire rated Partition:  - 1 layer min. 16mm fire-resistant type 'X' gypsum wallboard taped, spackled, sanded (to 092000) & painted (to 099000)  - 89mm steel studs at 400mm on centre with 75 mm sound attenuation fire blankets;  - 1 layer min. 16mm fire-resistant type 'X' gypsum wallboard taped, spackled, sanded ( to 092000) & painted (to 099000)  - Provide 1hr F.R.R. and F.S. Assembly in accordance with ULC W407.
рЗ		New Steel Stud Partition:  - 1 layer 13mm gypsum wallboard taped, spackled, sanded (to 092000) & painted (to 099000)  - 64mm steel studs at 400mm on centre;  - Fill with 63mm Acoustical Batt Insulation;  - 1 layer 13mm gypsum wallboard taped, spackled, sanded ( to 092000) & painted (to 099000)

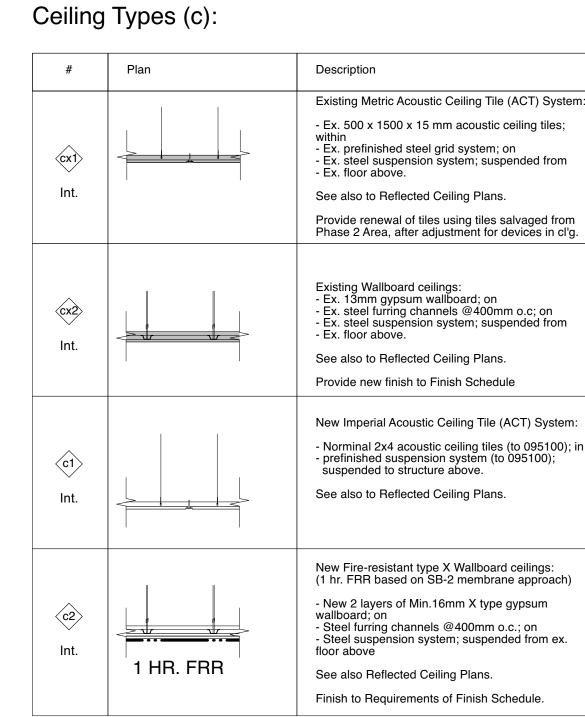

## Furring Type (fr):

#	Plan	Description
fr1		New 90 Steel Framed Furring:  - 13mm wallboard, taped, sanded & spackled; on - 90mm steel studs @ 400mm o.c Provide paint finish to interior. See interior elevations and Finish Schedules.

on	
	Notes to Ceiling (C) Types:
Stud Partition to remain or for alteration to	Label Description
Requirements of Finish Schedule.	Indicates ceiling type, all partitions to u/s deck including boardwork unless noted otherwise.
Shaft fire-rated Partition to remain.	Indicates ceiling type, all partitions to u/s deck including boardwork unless noted otherwise.
irecode gypsum wallboard on; C-H studs at 610 mm on centre; Gypsum board between studs; patt insulation	General Notes to Ceilings:
om Existing Documents, to Remain)	See Reflected Ceiling Plan and schedules for ceiling heights above datum.
Requirements of Finish Schedule.	
el Stud Partition:	Note Regarding Wallboard:
13mm gypsum wallboard taped, spackled, to 092000) & painted (to 099000)	Wallboard
steel studs at 400mm on centre; 75mm Acoustical Batt Insulation; 13mm gypsum wallboard taped, spackled, to 092000) & painted (to 099000)	The term "wallboard" may refer to GWB, Type 'X' GWB, cement board, tilebacker board, gypsum sheathing (Dens GP or similar), abuse-resistant GWB, water-resistant GWB, or other panel product as the case may require. Note that the Contract requires that wallboard be selected in accordance with the partition, wall, and ceiling requirements as well as the finishes that will be applied to the panel products and the end use of the adjacent areas and environments. See Section 092000 for more specific requirements.
hour fire rated Partition:	
min. 16mm fire-resistant type 'X' gypsum d taped, spackled, sanded (to 092000) & to 099000)	General Notes to Walls, Partitions and Furring:
to 699000)  to 699000)  to 699000)  to 699000)  to 699000)	Unless otherwise noted, all partitions shall terminate at the underside of roof deck, floor slab or

constructed in accordance with applicable ULC designs to achieve ratings or in accordance with D.B.C. SB-2 requirements for material thicknesses & component additive methods. Submit copies of ULC designs upon request of Consultant. Acoustic Insulated Assemblies (to 090500) All assemblies requiring sound transmission class ratings and/or are constructed as acoustically insulated separations shall be constructed in accordance with applicable OBC designs to achieve STC ratings. Wherever acoustic assemblies are penetrated by Work of these Documents, provide complete seal of the penetration in order to maintain STC rating of assembly. Fire Stopping (to 078400) Wherever fire-rated assemblies are penetrated by Work of these Documents, the Trade Contractor

structure above (refer to floor plans, sections, and structural documents for additional information).

Provide blocking to mount all wall fastened items. Review complete documents and ensure blocking

is reviewed by the Trade installing the finish item, prior to enclosing partitions and ceiling framing.

All assemblies requiring fire-resistance ratings and/or are constructed as fire separations shall be

Allow for movement of structure and provide lateral anchorage.

Fire-Rated Assemblies (to 019522)

installing penetrating elements shall provide fire-stopping to complete fire-stopping of the penetration. Where assemblies meet u/s of deck, differing construction, and at movement joints, provide Finishing (to 090500, 099000 and as applicable) Unless otherwise noted, finish all walls, partitions, furrings, ceilings as per Finish Schedule.

## Partition Symbol Modifiers:

Includes lateral bracing to ceiling, c/w blocking. Indicates framing & wallboard to u/s of structure above. Indicates framing & wallboard to 150mm (6") above highest adjacent ceiling. Includes lateral bracing to u/s structure over.

Structural Load-Bearing Partition: Indicates framing & wallboard to u/s ceiling only. - same as 'p1' or 'p2' above except constructed as part of the Building Structural System, to receive and transmit forces to foundations See Structural documents.

General Notes:

For General Notes and OBC Matrix see Sheet A001 For Removal Plan see Sheet A201 For 2nd Floor Fit-Up Plan see Sheet A211 For Plan Details see Sheet A212 For Section Details see Sheet A213 For 2nd Floor Partition Dimension Plan see Sheet A221 For 2nd Floor Floor Finishes Plan see Sheet A231 For Removal Reflected Ceiling Plan see Sheet A50 For Reflected Ceiling Plans see Sheet A511 For Millwork Details see Sheet A711 For Interior Elevations see A800 series Sheets For Openings Schedules see Sheet A901 For Room Finishes Schedules see Sheet A911 For Mechanical Drawings see M series Sheets For Electrical Drawings see E series Sheets

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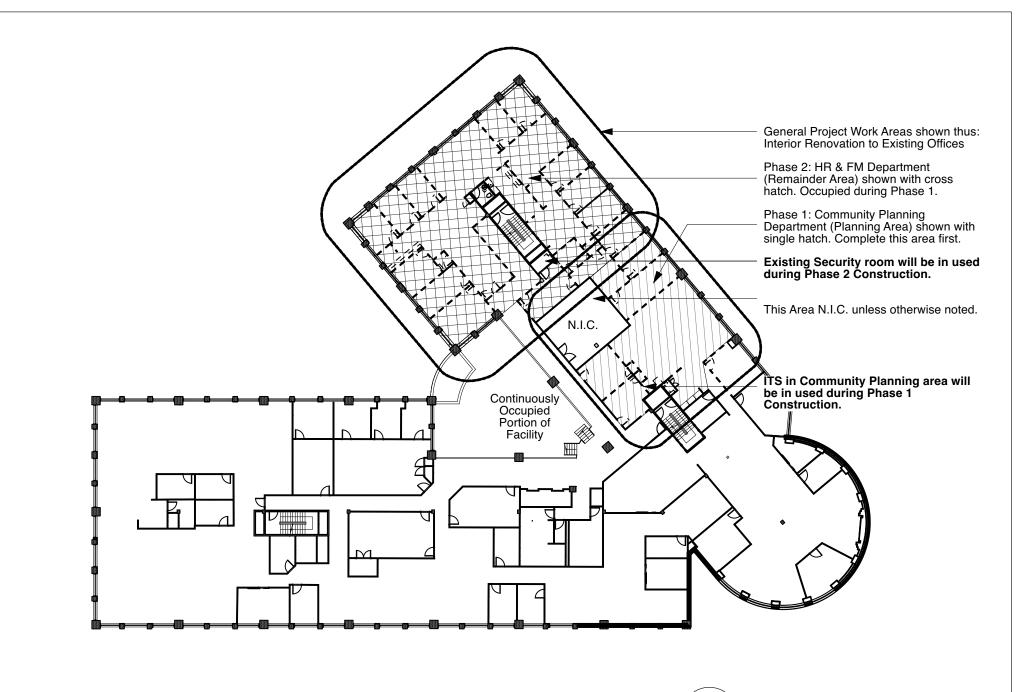
the relation of portions of the work are not

immediately apparent, the reader shall not

specific purpose noted.

referenced therein.

proceed in uncertainty.



## Required Sequence of Construction:

of demolished materials from the Building.

noted otherwise.

Contractor takes over Planning portion of William st. wing on 2nd floor of building, remainder of building is occupied at all times. Areas of the building not under construction will be occupied. Working in the building shall be done in a manner which minimizes the impact of construction on the adjacent tenants and preserves MoL required separation of the Place of the Work. Work that is noisy shall be performed outside of regular hours. Pay all costs for this required timing. Special permission for noise or noxious operations may be granted by the Owner in exceptional circumstances only, with permission of Owner's Project Manager in each case. Shutdowns of systems shall be performed outside of regular hours and systems affecting occupied portions of the building shall be returned to operation prior to beginning of next business day.

Phase 1 (Planning Area) shall be turned over to the Owner prior to July 1, 2025. Phase 2 (Remaining Areas) shall be turned over to the Owner prior to August 29, 2025. See Division 1 of the Specification.

Phase 1 and 2 must occur sequentially for all aspects of the Work. Contractor can start working within the area of Phase 2 only after completion of Phase 1. However, Contractor may salvage select metric acoustic ceiling tiles and lighting fixtures from the Phase 2 area for use in Phase 1, after coordination with the Owner. ITS in Community Planning Area will be in used during the Phase 1 construction. Existing Security room will be in used during the Phase 2 construction.

may only be used for deliveries and access to the Place of the Work with special permission of Owner and agreement of Owner's Project Manager in each instance. Entry points and the external and internal building paths to the renovation areas are to be cleaned on a daily basis to ensure that public access points and pathways remain free from construction debris at all times. Contractor may establish a bin onsite to location agreed with Owner for duration of the Work. Make good all damage to finishes and property from such operations to Owner's satisfaction and pay all costs. For Phase 1 of the Work, select demolition operations may involve the use of atrium and elevator for removals

For Phase 2 of the Work all demolished materials and deliveries may be accomplished by the removal of an


Contractor may park construction vehicles on the property but number of passes will be restricted by Owner,

with access through the Ground floor exit stair facing the parking lot. Main entries, atrium, and one elevator

existing window facing the parking lot, with bin placed below, at Contractor's option. Provide all temporary work for window removal, protect and store the glazed unit, protect the frame opening and building wall, and restore to "as existing" condition. Pay all costs for this work. Alternatively the select demolition and removals must be accomplished by permission of the Owner through occupied spaces only outside of normal facility All loose furnishings relocations and removals are by Owner at each stage of sequence of contruction unless Access to Exit and Services:

Throughout all phases and project the Contractor shall maintain access to exits for all occupied portions of the facility, without exception. Any work which interferes with existing access to exit from occupied areas must occur outside of facility operation hours and be restored by next business day. Any proposed alternative access to exit by the Contractor must be accompanied by a design to be submitted to Building and Fire authorities for approval prior to interrupting existing paths of egress or access to exit. Provide temporary lighting and exit signage to requirements of authorities for all access to exit pathways. Submit all proposals for shutdown of any life safety system to authorities for approval prior to implementation, and obtain Pay all costs for this work, including for design of alternative measures. Consultant does not provide design of ways and

means or temporary measures.

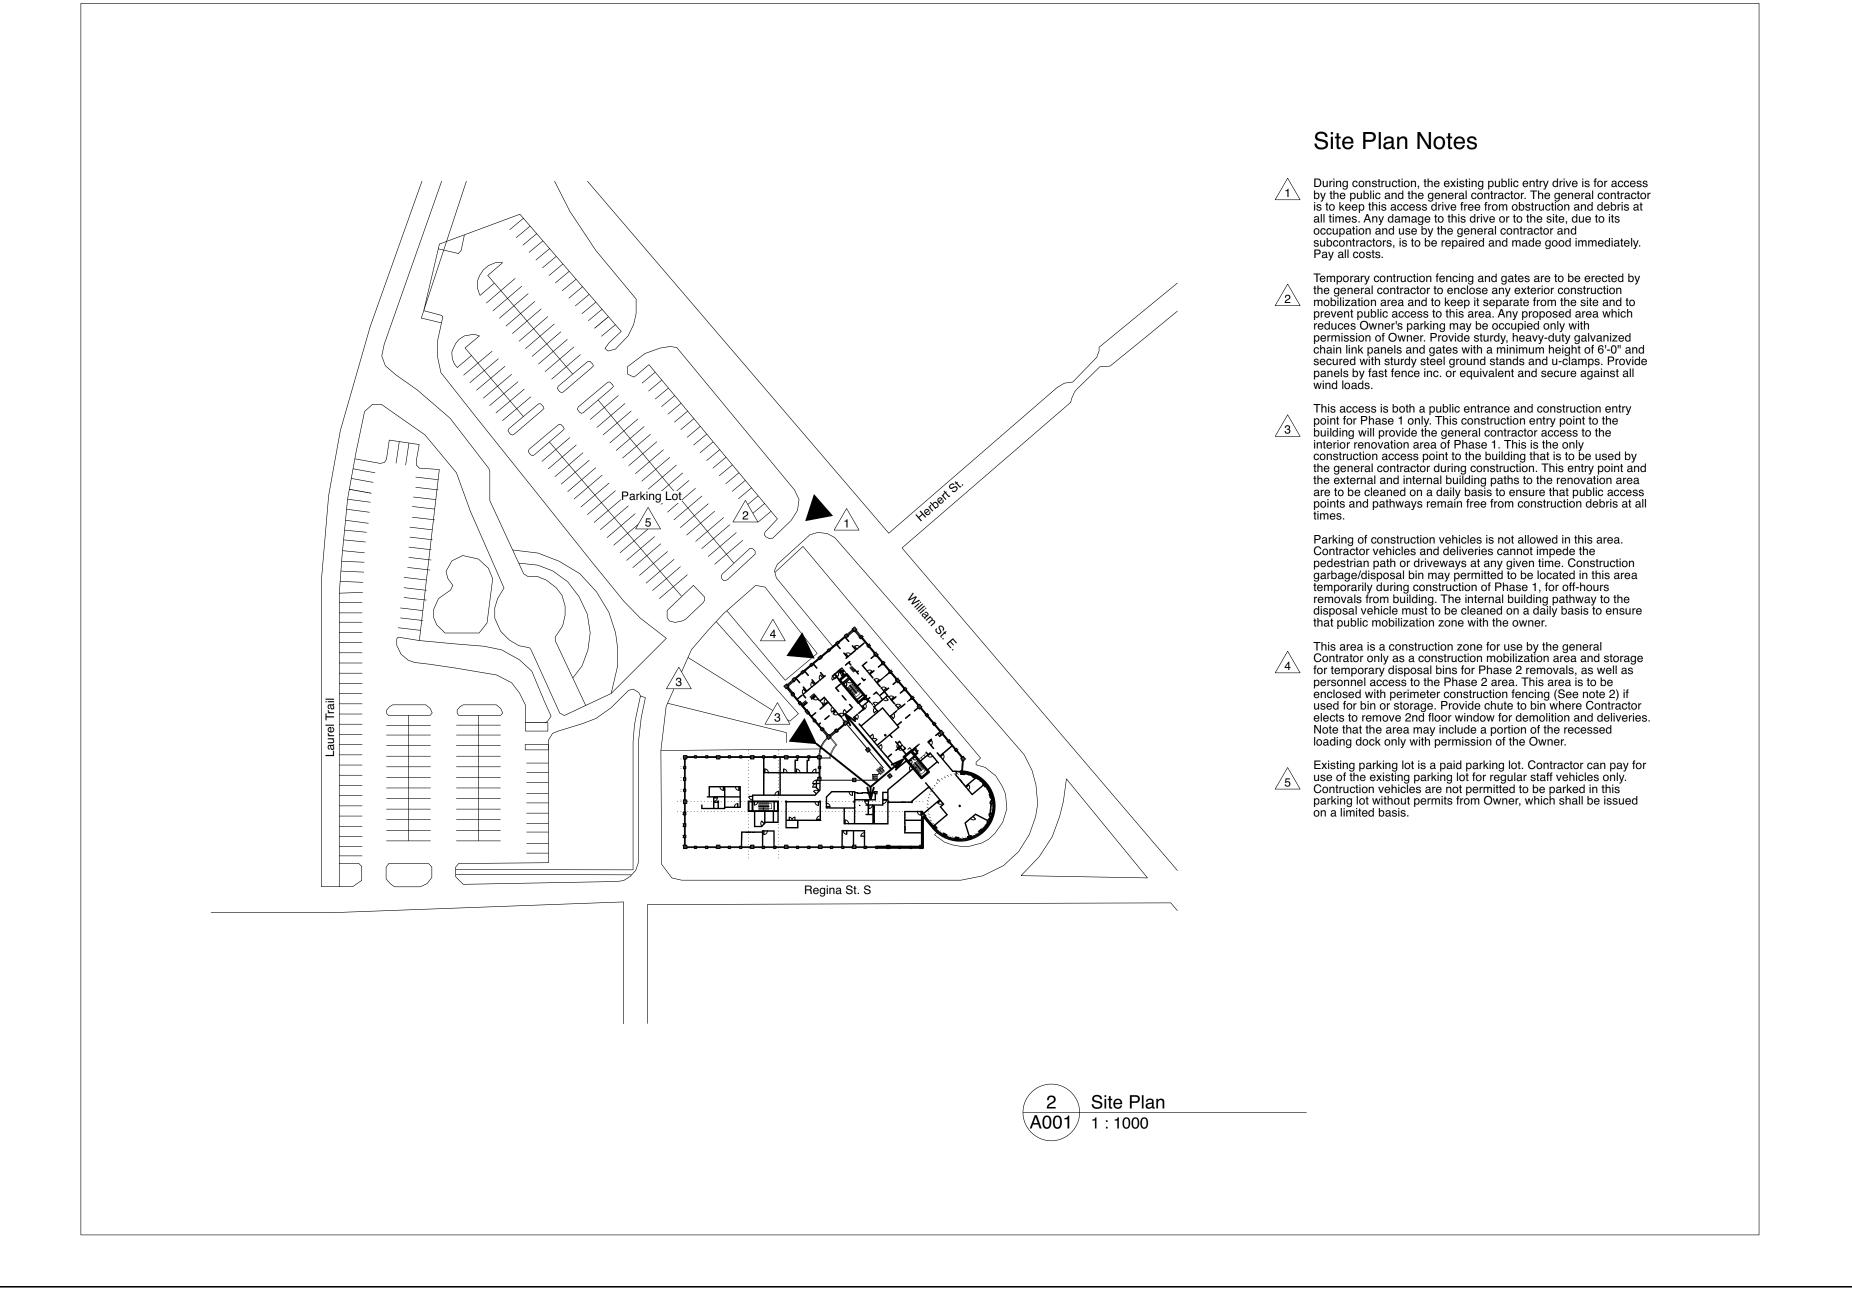

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General Notes & OBC Matrix

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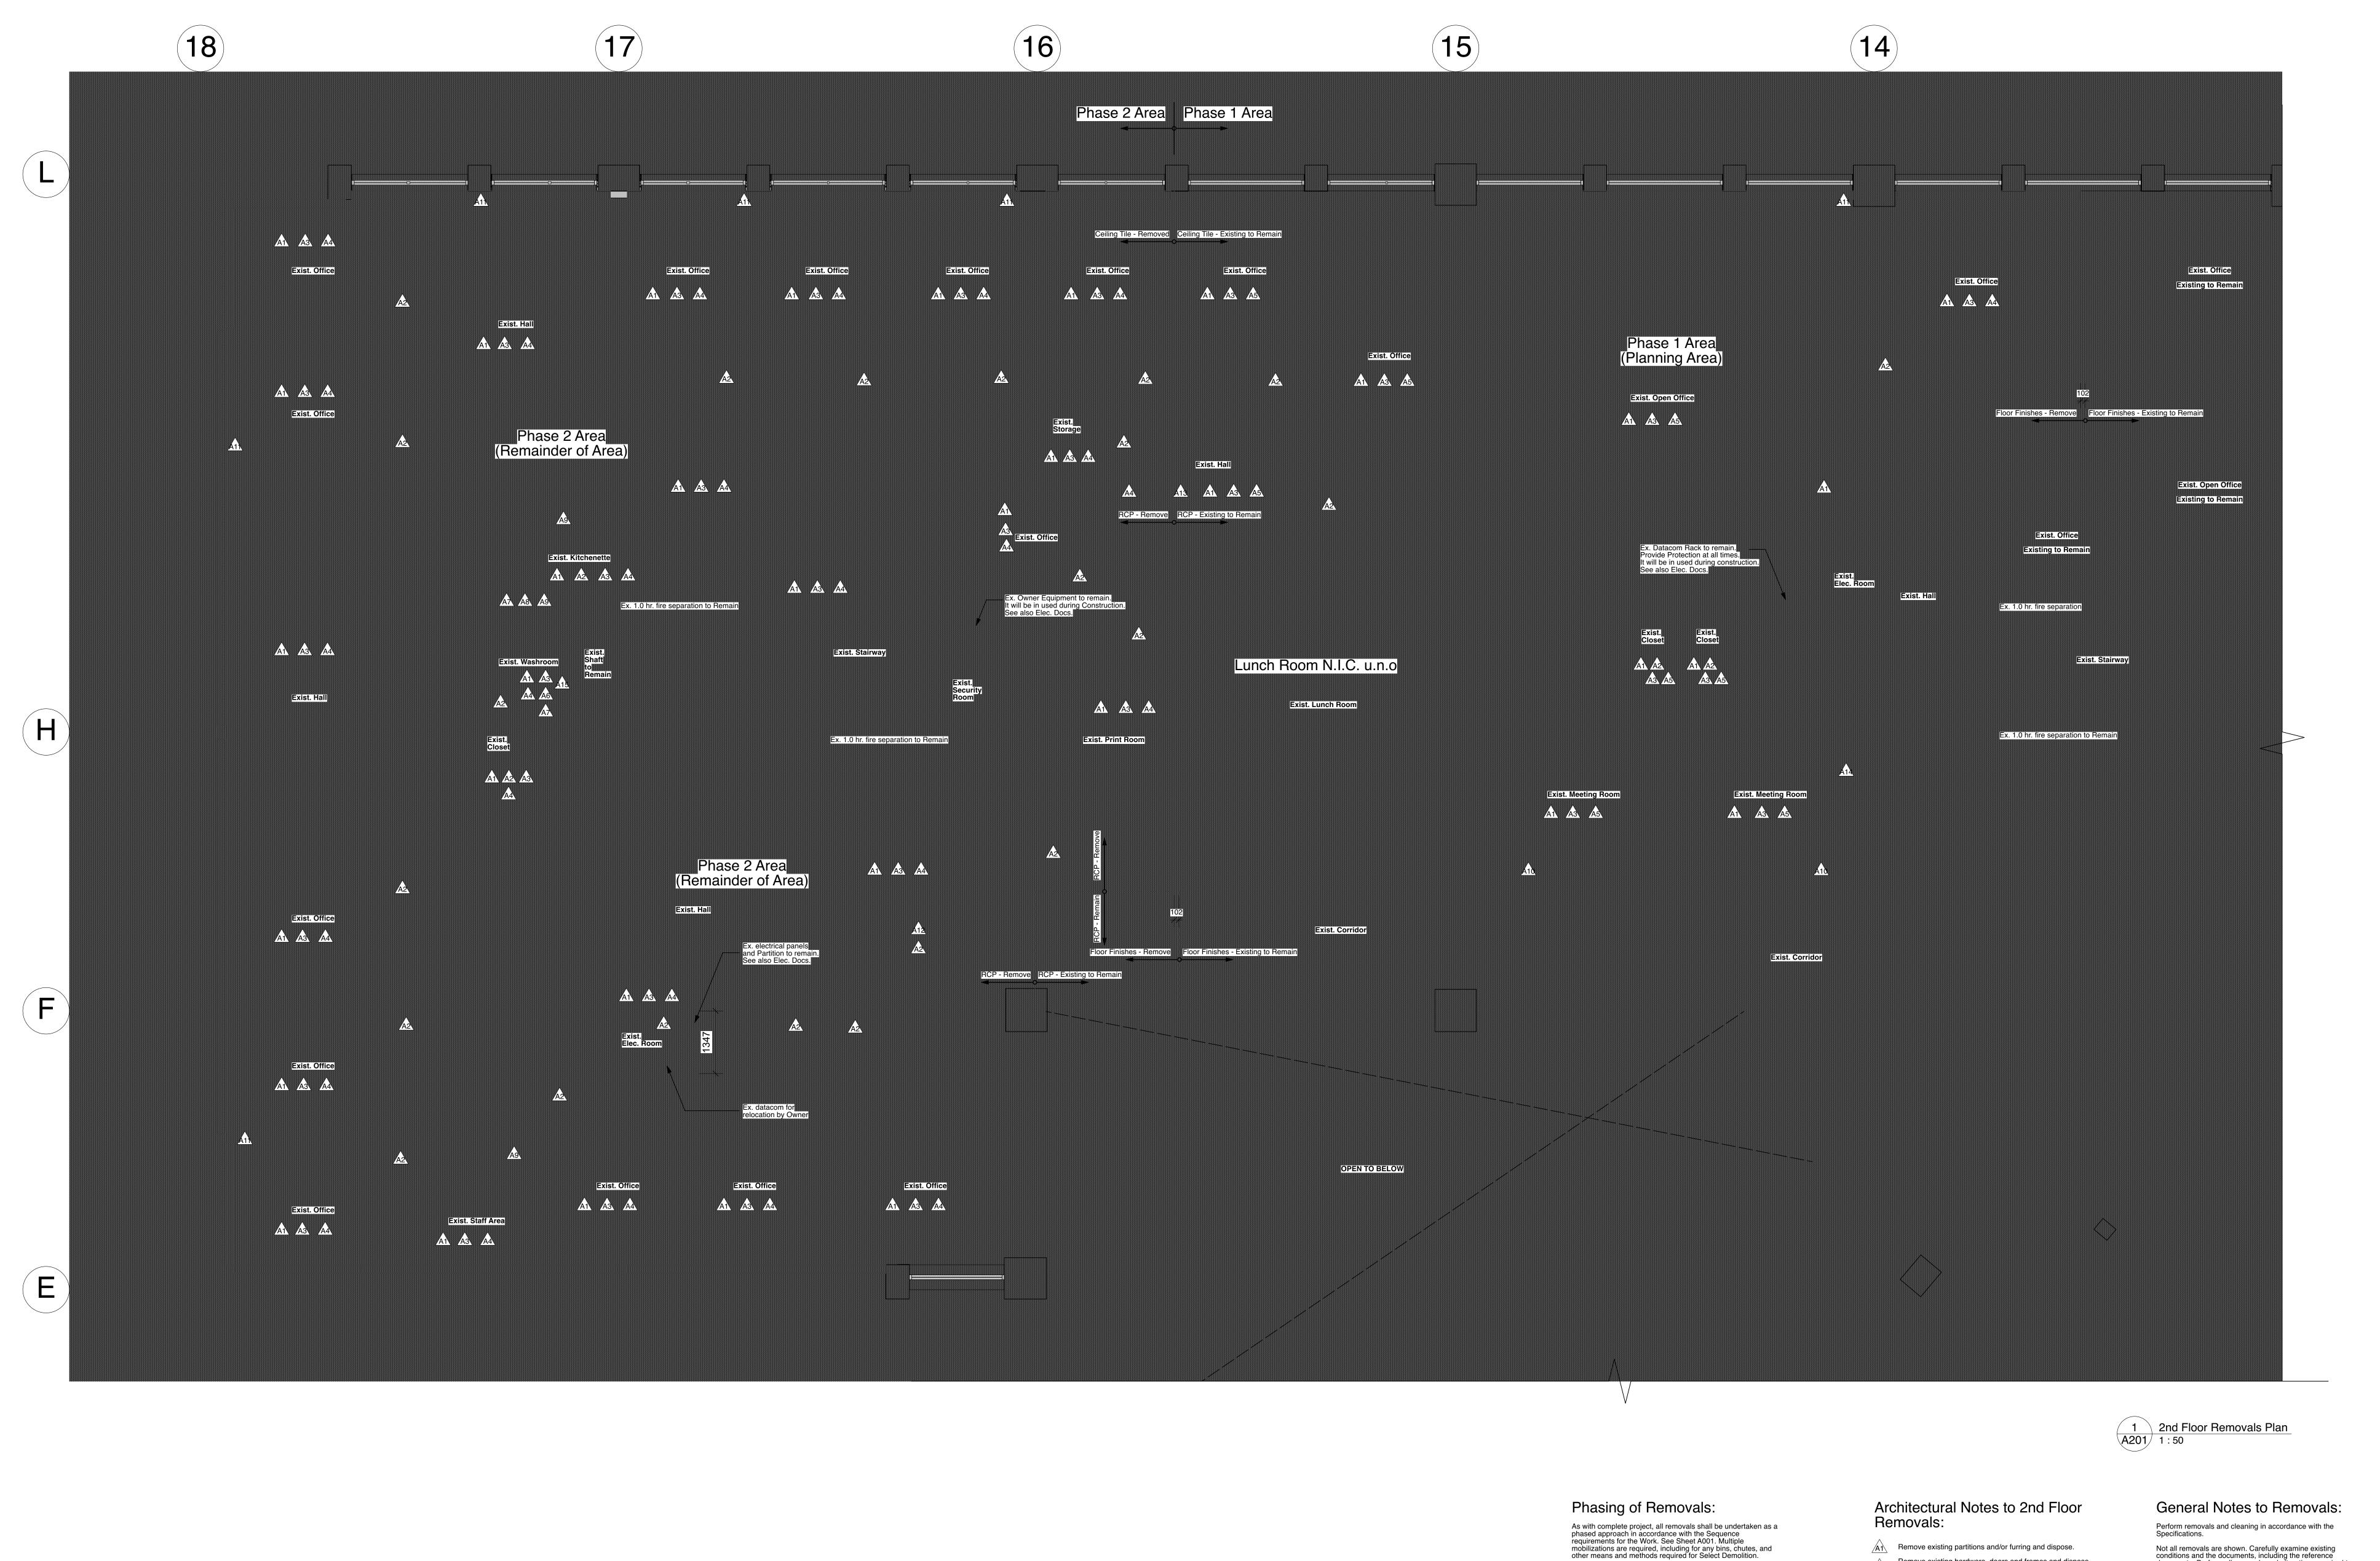
City of Waterloo

100 Regina St South

Drawing Title

Waterloo, ON N2J 4P9

2nd Floor Renovations



Temporary Protection for Removals and Subsequent Construction in Each Phase:

As with complete project, all work must be separated by adjacent occupied spaces in the building with sealed dust-proof temporary enclosures, including within ceiling spaces. All HVAC serving the area under demolition or construction must be isolated from remaining portions of the functioning systems prior to beginning demolition operations. All IT and other system equipment and devices must be protected from damage by dust and demolition operations. The installed isolation measures shall be reviewed and accepted by the Owner's representative prior to beginning demolition

These measures are required for each of the Phase 1 and Phase 2 mobilizations as separate isolations and mobilizations. Pay all costs for this work.

Remove existing hardware, doors and frames and dispose.

Onlye hardware salvage for turnover to the Owner. If Owner declines, dispose at no cost to Owner. Remove existing floor finishes including base and dispose c/w all wall base. Grind Floor as necessary to receive new finishes.

Remove all existing lay-in-panel ceiling system complete, and dispose. Salvage all existing suitable ceiling tiles for re-use in Phase 1 and turnover to Owner. In Phase 1 remove only those tiles as required for Phase 1 work, during after hours visit to Phase 2 area.

Existing T-bar to remain. Spot remove and replace all existing stained or otherwise damaged ceiling tiles. Carefully remove ceiling tiles as necessary for above-ceiling work, protect and store for re-installation.

A6 Remove all washroom accessories, and turnover to Owner. Remove plumbing fixtures complete with all piping, and dispose. Remove vanity c/w sink and trim, and dispose. Make good

Remove millwork, and dispose. Make good surfaces.

Remove existing door and frames and salvage for turnover to the Owner. Prep for wall infill to match existing adjacent electric strike, and turn over to Owner.

construction and finish. Remove and salvage card reader and Provide all removals necessary for electrical within furred exterior wall assembly, to suit new electrical. Make good. See

Remove existing door and frames and salvage for turnover

A12 to the Owner. Remove grid as necessary for layout of new full height partition and to facilitate new perimeter trim to existing grid on Phase 1

Remove portion of existing partition as required for new opening. Make good framing to suit jamb and head support. Make good any penetrations to existing Fire Separation after removals are complete. Remove all accessories and other washroom elements and dispose.

conditions and the documents, including the reference documents. Perform all removals and alterations required to perform the Work. Perform all demolition in accordance with construction sequencing requirements. Provide all select removals, cutting and patching required for the structural, mechanical and electrical work for this contract. Coordinate requirements and costs with Trade Contractors. All costs for this work are included in the Contract Price. Dashed lines or notations indicate items for removal. Dispose as noted. Salvage as noted. Turn over to Owner as noted. Turn over to Owner's Tenant as noted. Owner shall remove all loose furniture, appliances, and loose equipment prior to handover of the facility to the Contractor.

Provide all removals to suspended ceilings, within ceiling spaces, and to flooring materials to facilitate the alterations. This includes rework of existing building systems such as distribution wiring and similar where necessary to accommodate mechanical or electrical changes. Where elements such as partitions are graphically indicated as

existing, such elements may still be subject to removals of finishes, to cutting and patching, and other work necessary for All such removals required to perform the Work are included in the Contract Price. See also Architectural Reflected Ceiling Removals Plan A501 & the Mechanical and Electrical

City of Waterloo

2nd Floor Renovations 100 Regina St South Waterloo, ON N2J 4P9

Revision

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General Notes:

For General Notes and OBC Matrix see Sheet A001

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For Removal Plan see Sheet A201
For 2nd Floor Fit-Up Plan see Sheet A211
For Plan Details see Sheet A212
For Section Details see Sheet A213
For 2nd Floor Partition Dimension Plan see Sheet A221
For 2nd Floor Finishes Plan see Sheet A231
For Removal Reflected Ceiling Plan see Sheet A501
For Reflected Ceiling Plans see Sheet A511
For Millwork Details see Sheet A711
For Interior Elevations see A800 series Sheets
For Openings Schedules see Sheet A901
For Room Finishes Schedules see Sheet A911

For Mechanical Drawings see M series Sheets For Electrical Drawings see E series Sheets

Project North

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referenced therein.

proceed in uncertainty.


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2nd Floor Removals Plan

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Notes to Second Floor Plan:

Provide a transfer grill. See Mechanical drawings.

Provide all modifications to existing interior wall assembly to suit new floor plan. Provide new steel stud

wall assembly at the existing opening spaces. Make

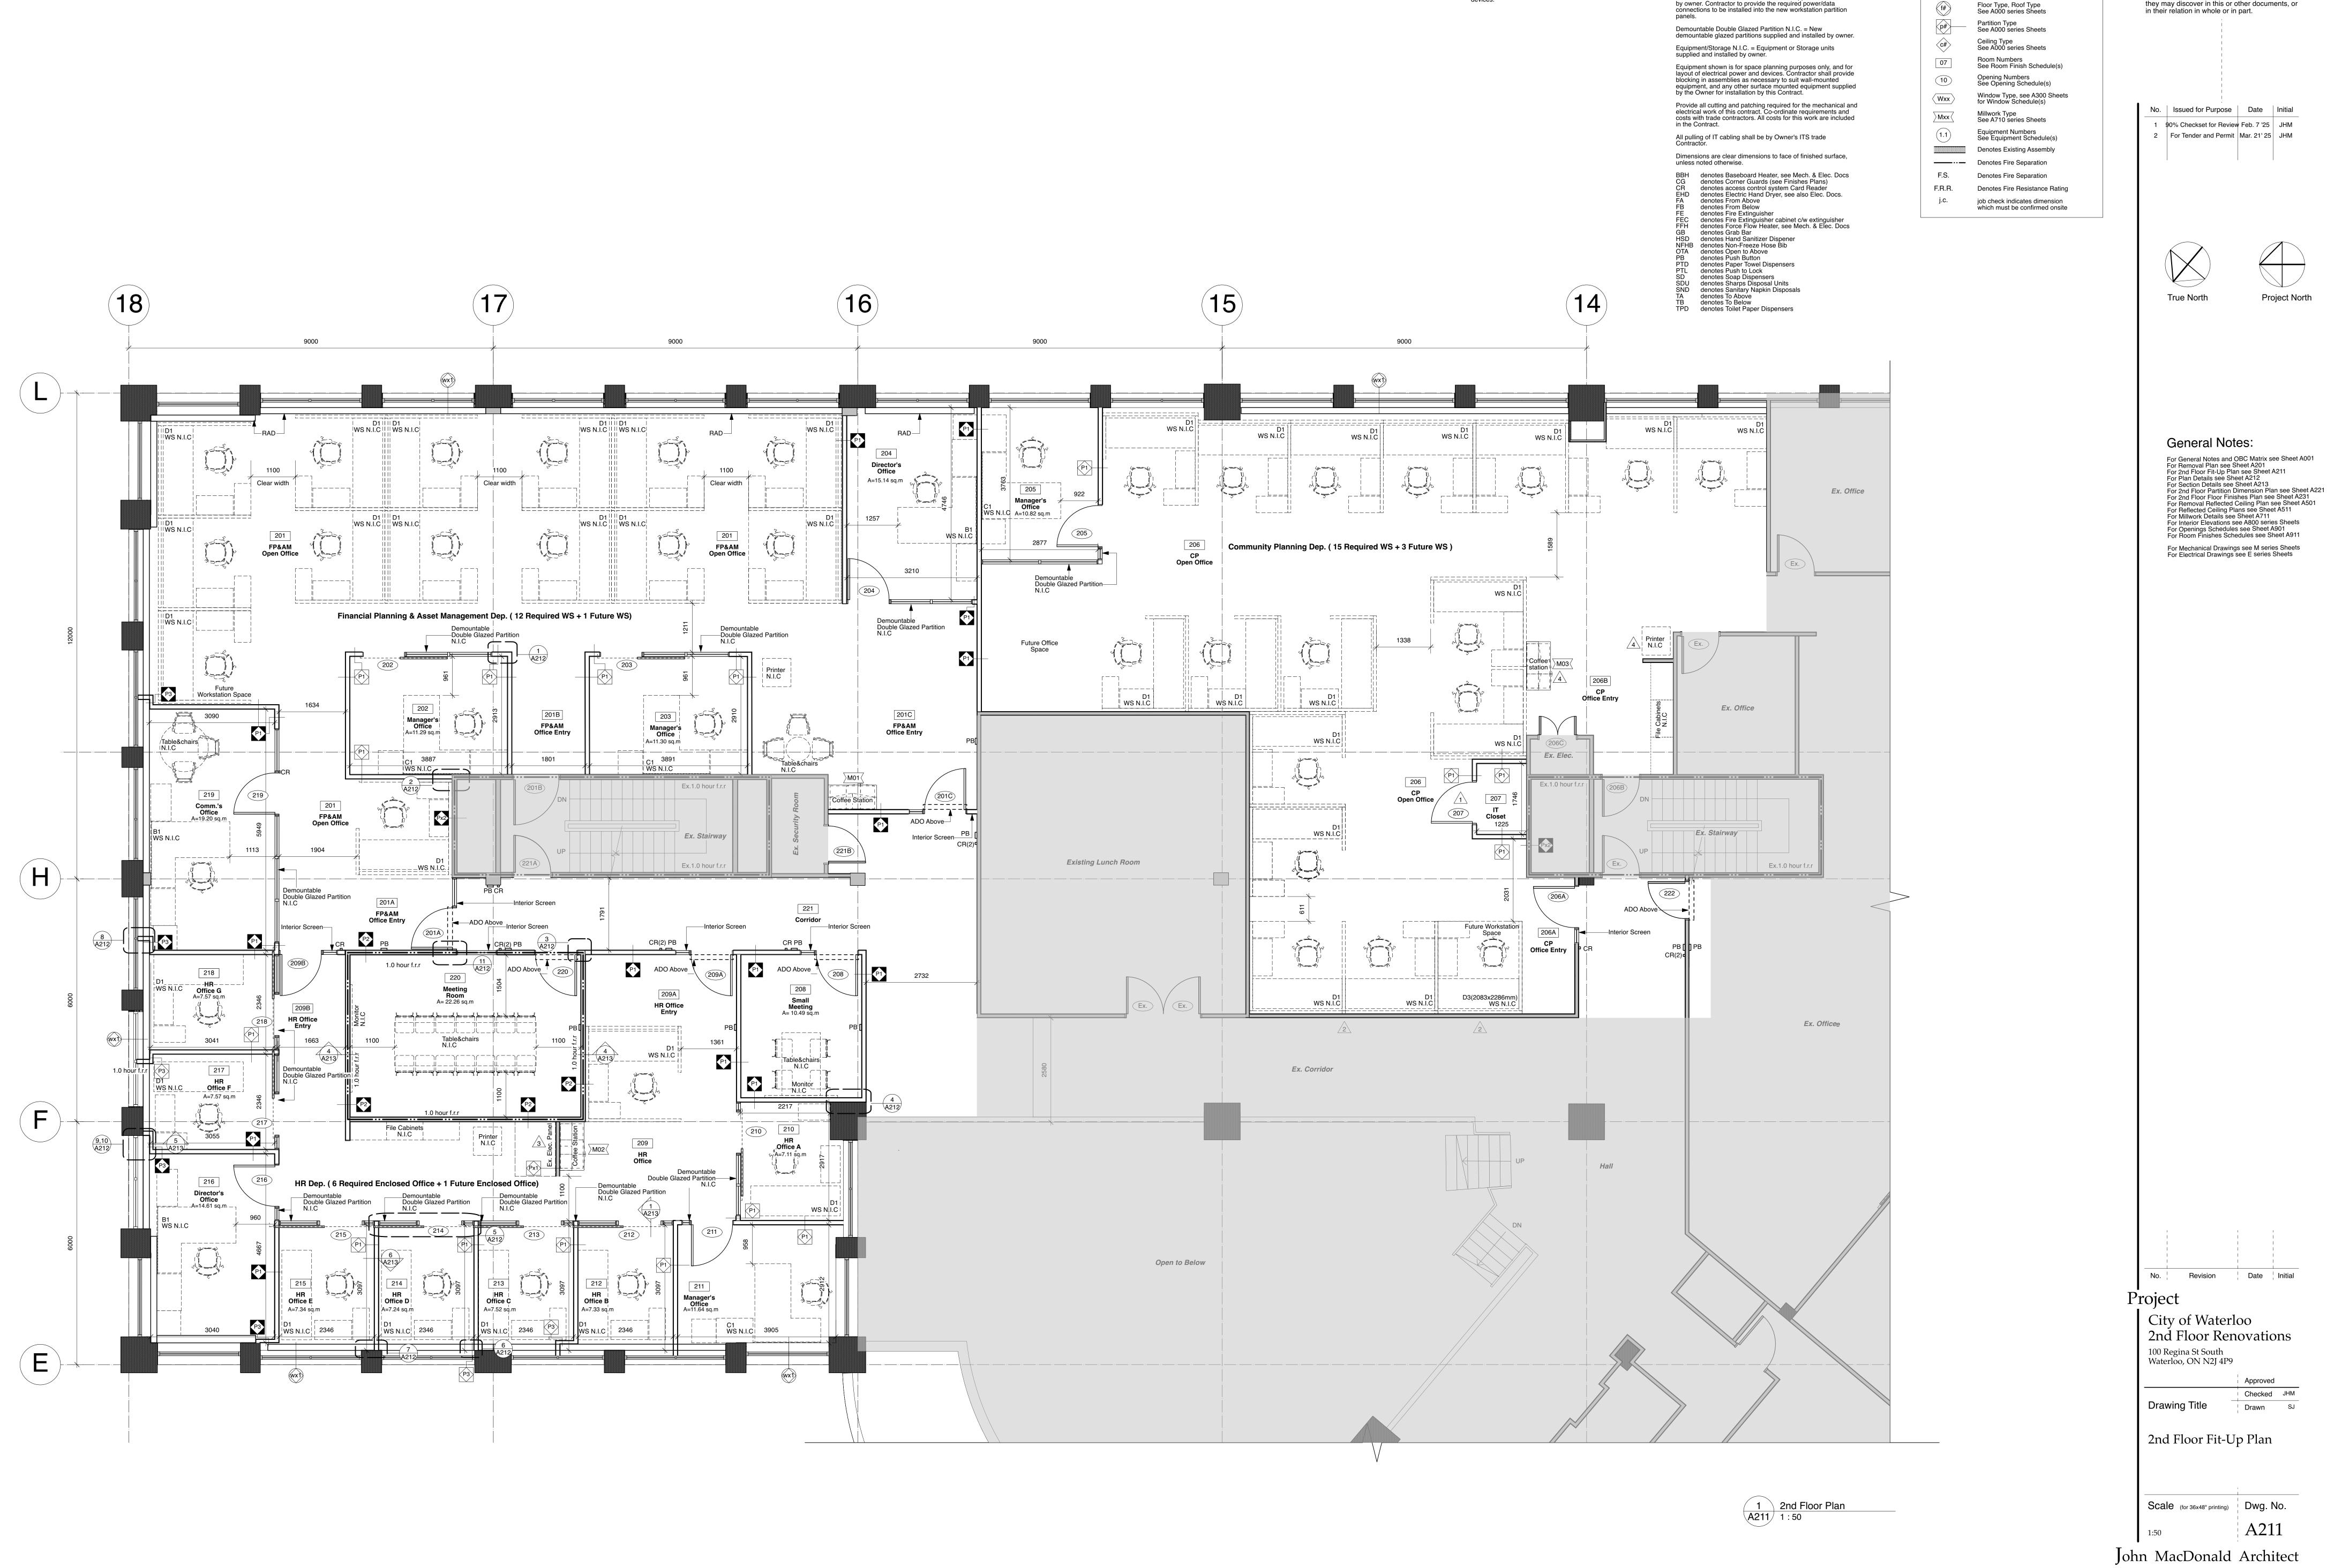Furniture system provider shall provide dedicate socket

and outlet to this location for printer or other owner

Existing Electrical Panel should be relocated by the City. See also Elec. Docs.

General Notes to Floor Plans:

Comply with Division One and General Requirements of the specifications, and the Conditions of the Contract, which form part of the accomplishement of the Work as if repeated here.

Construction Sequence, and to the Construction Schedule

Provide all repairs to existing wallboard (to 092000) required

to at wall bases, exisitng and new openings, as may be

required to ensure continuity of existing fire separations.

For Floor Finishes, see Floor Finishes Plans.

following removal of existing elements, including but not limited

WS N.I.C. = New furniture work stations supplied and installed

Perform all work in strict conformance with the

Legend:

Building Elevation See A300 series Sheets

Building Section
See A400 series Sheets

See A600 series Sheets

See A000 series Sheets

Foundation Wall Type, Wall Type

Wall Section


A301


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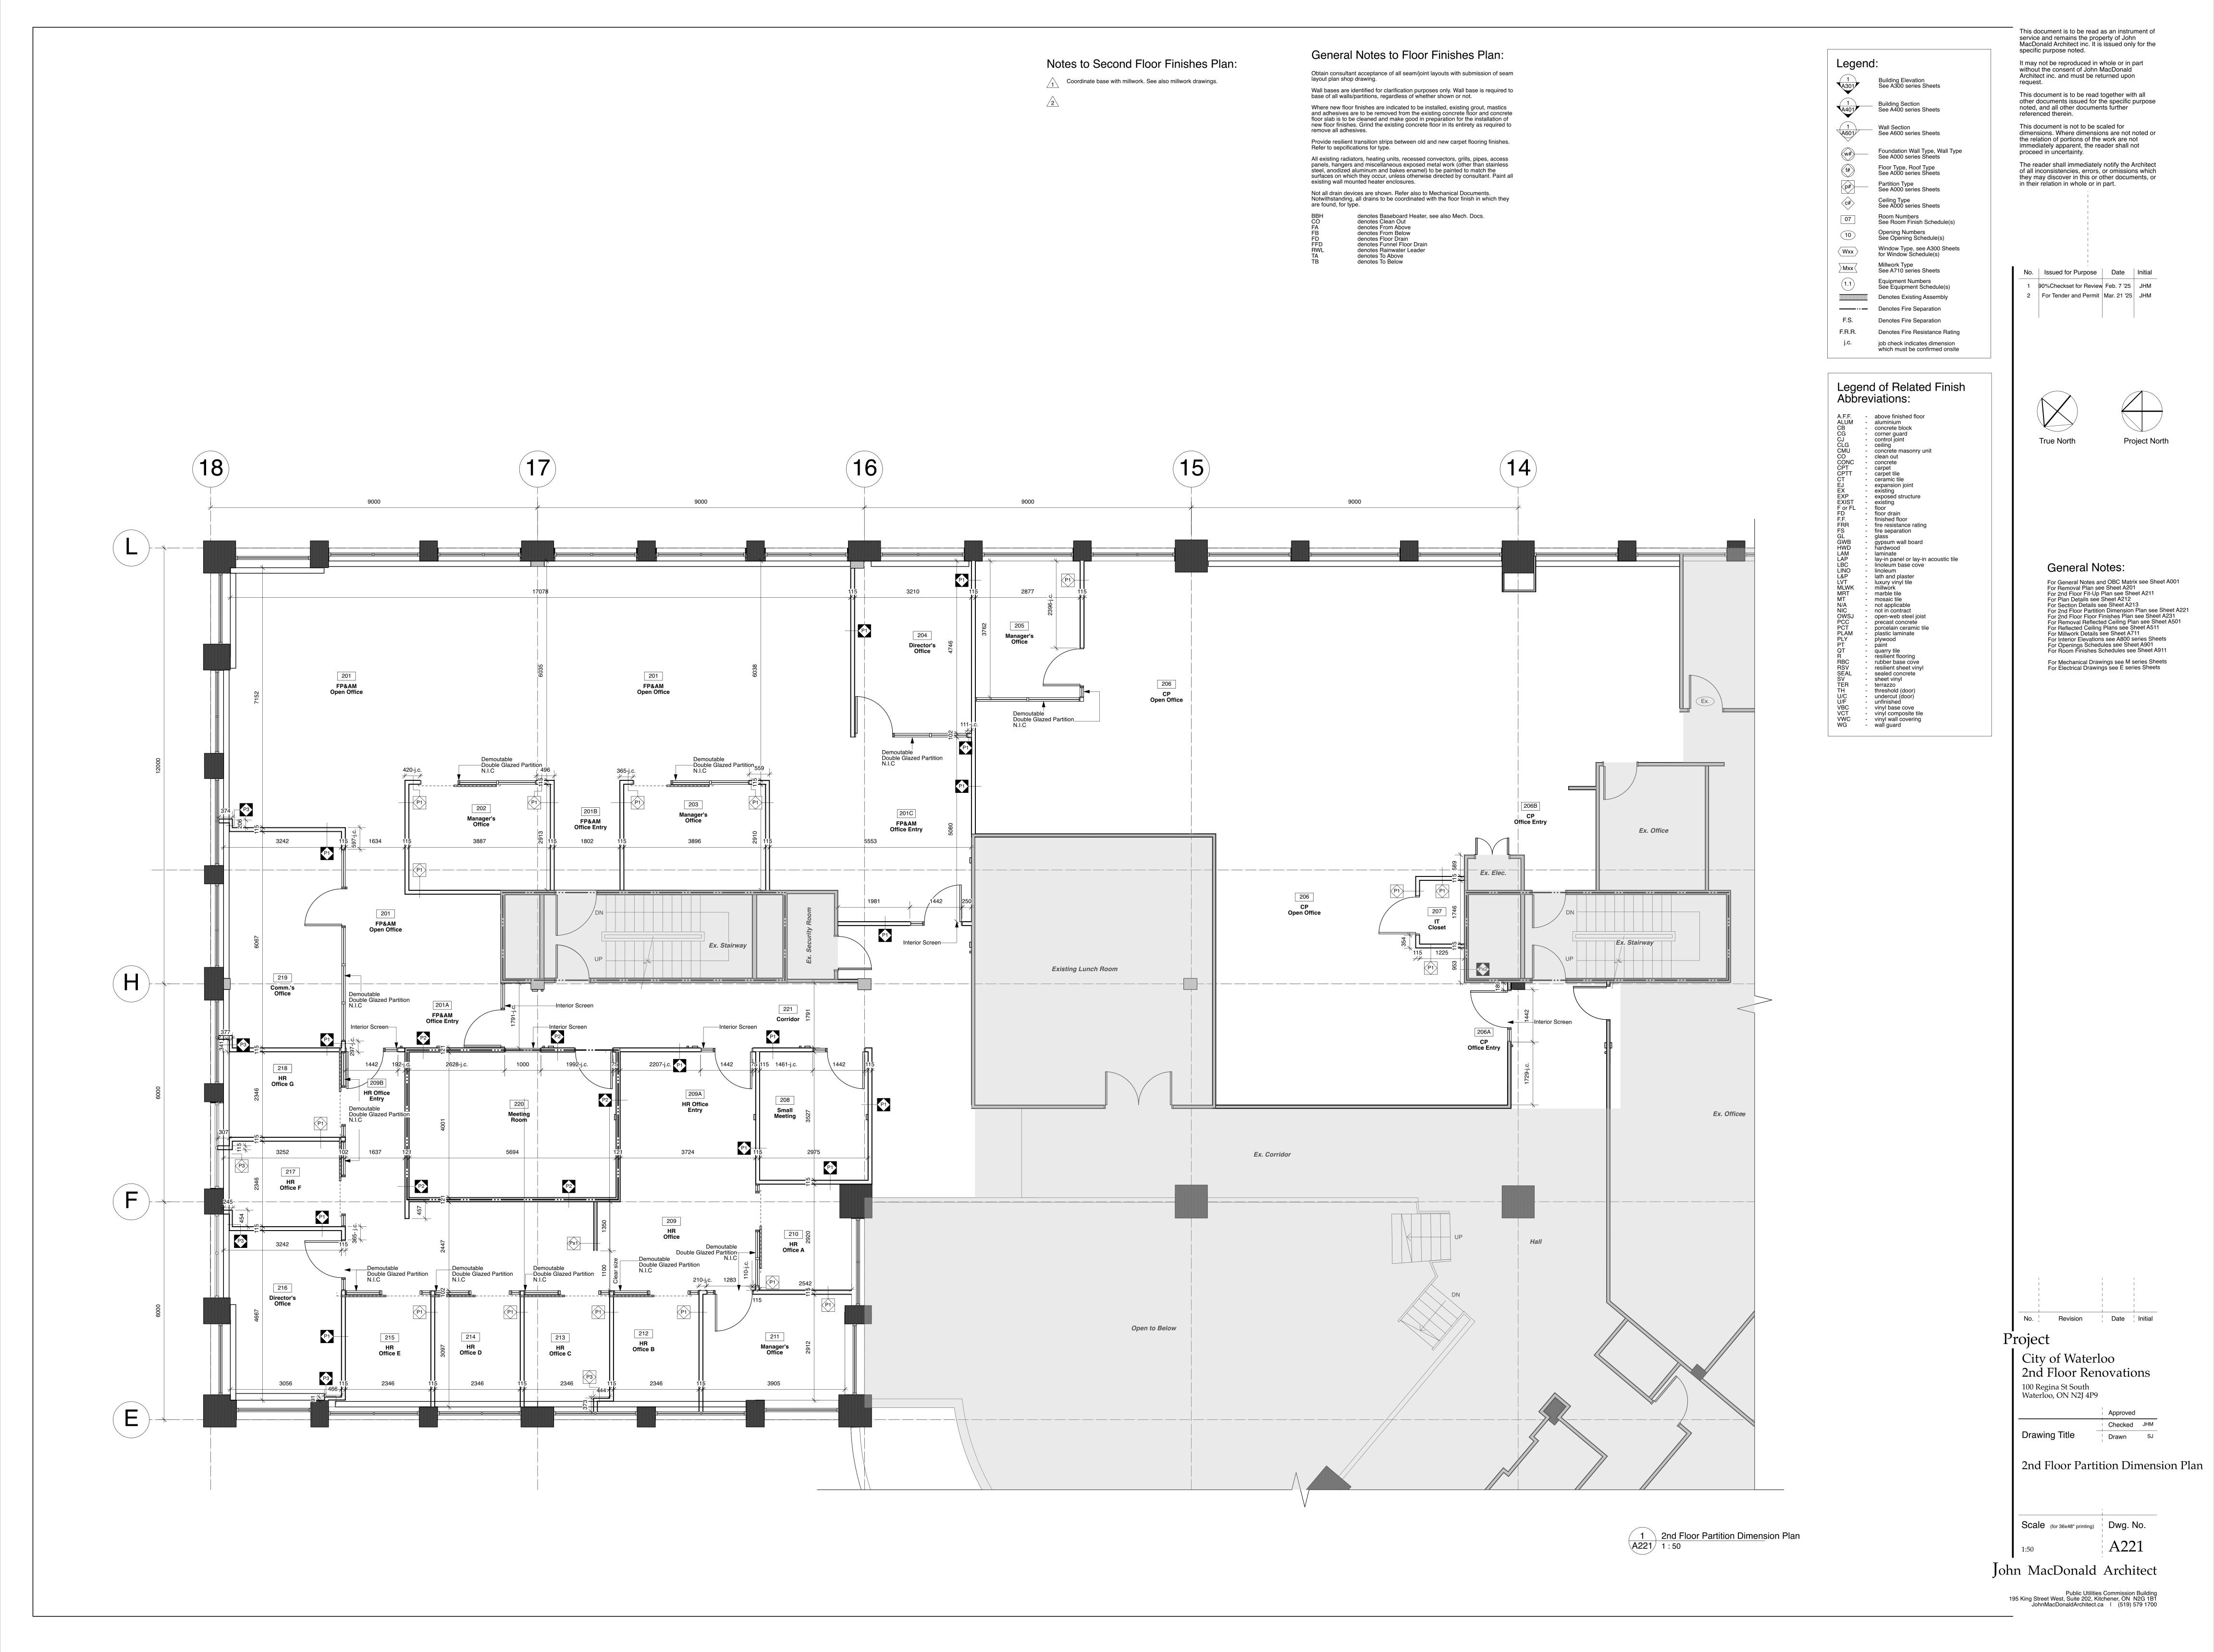
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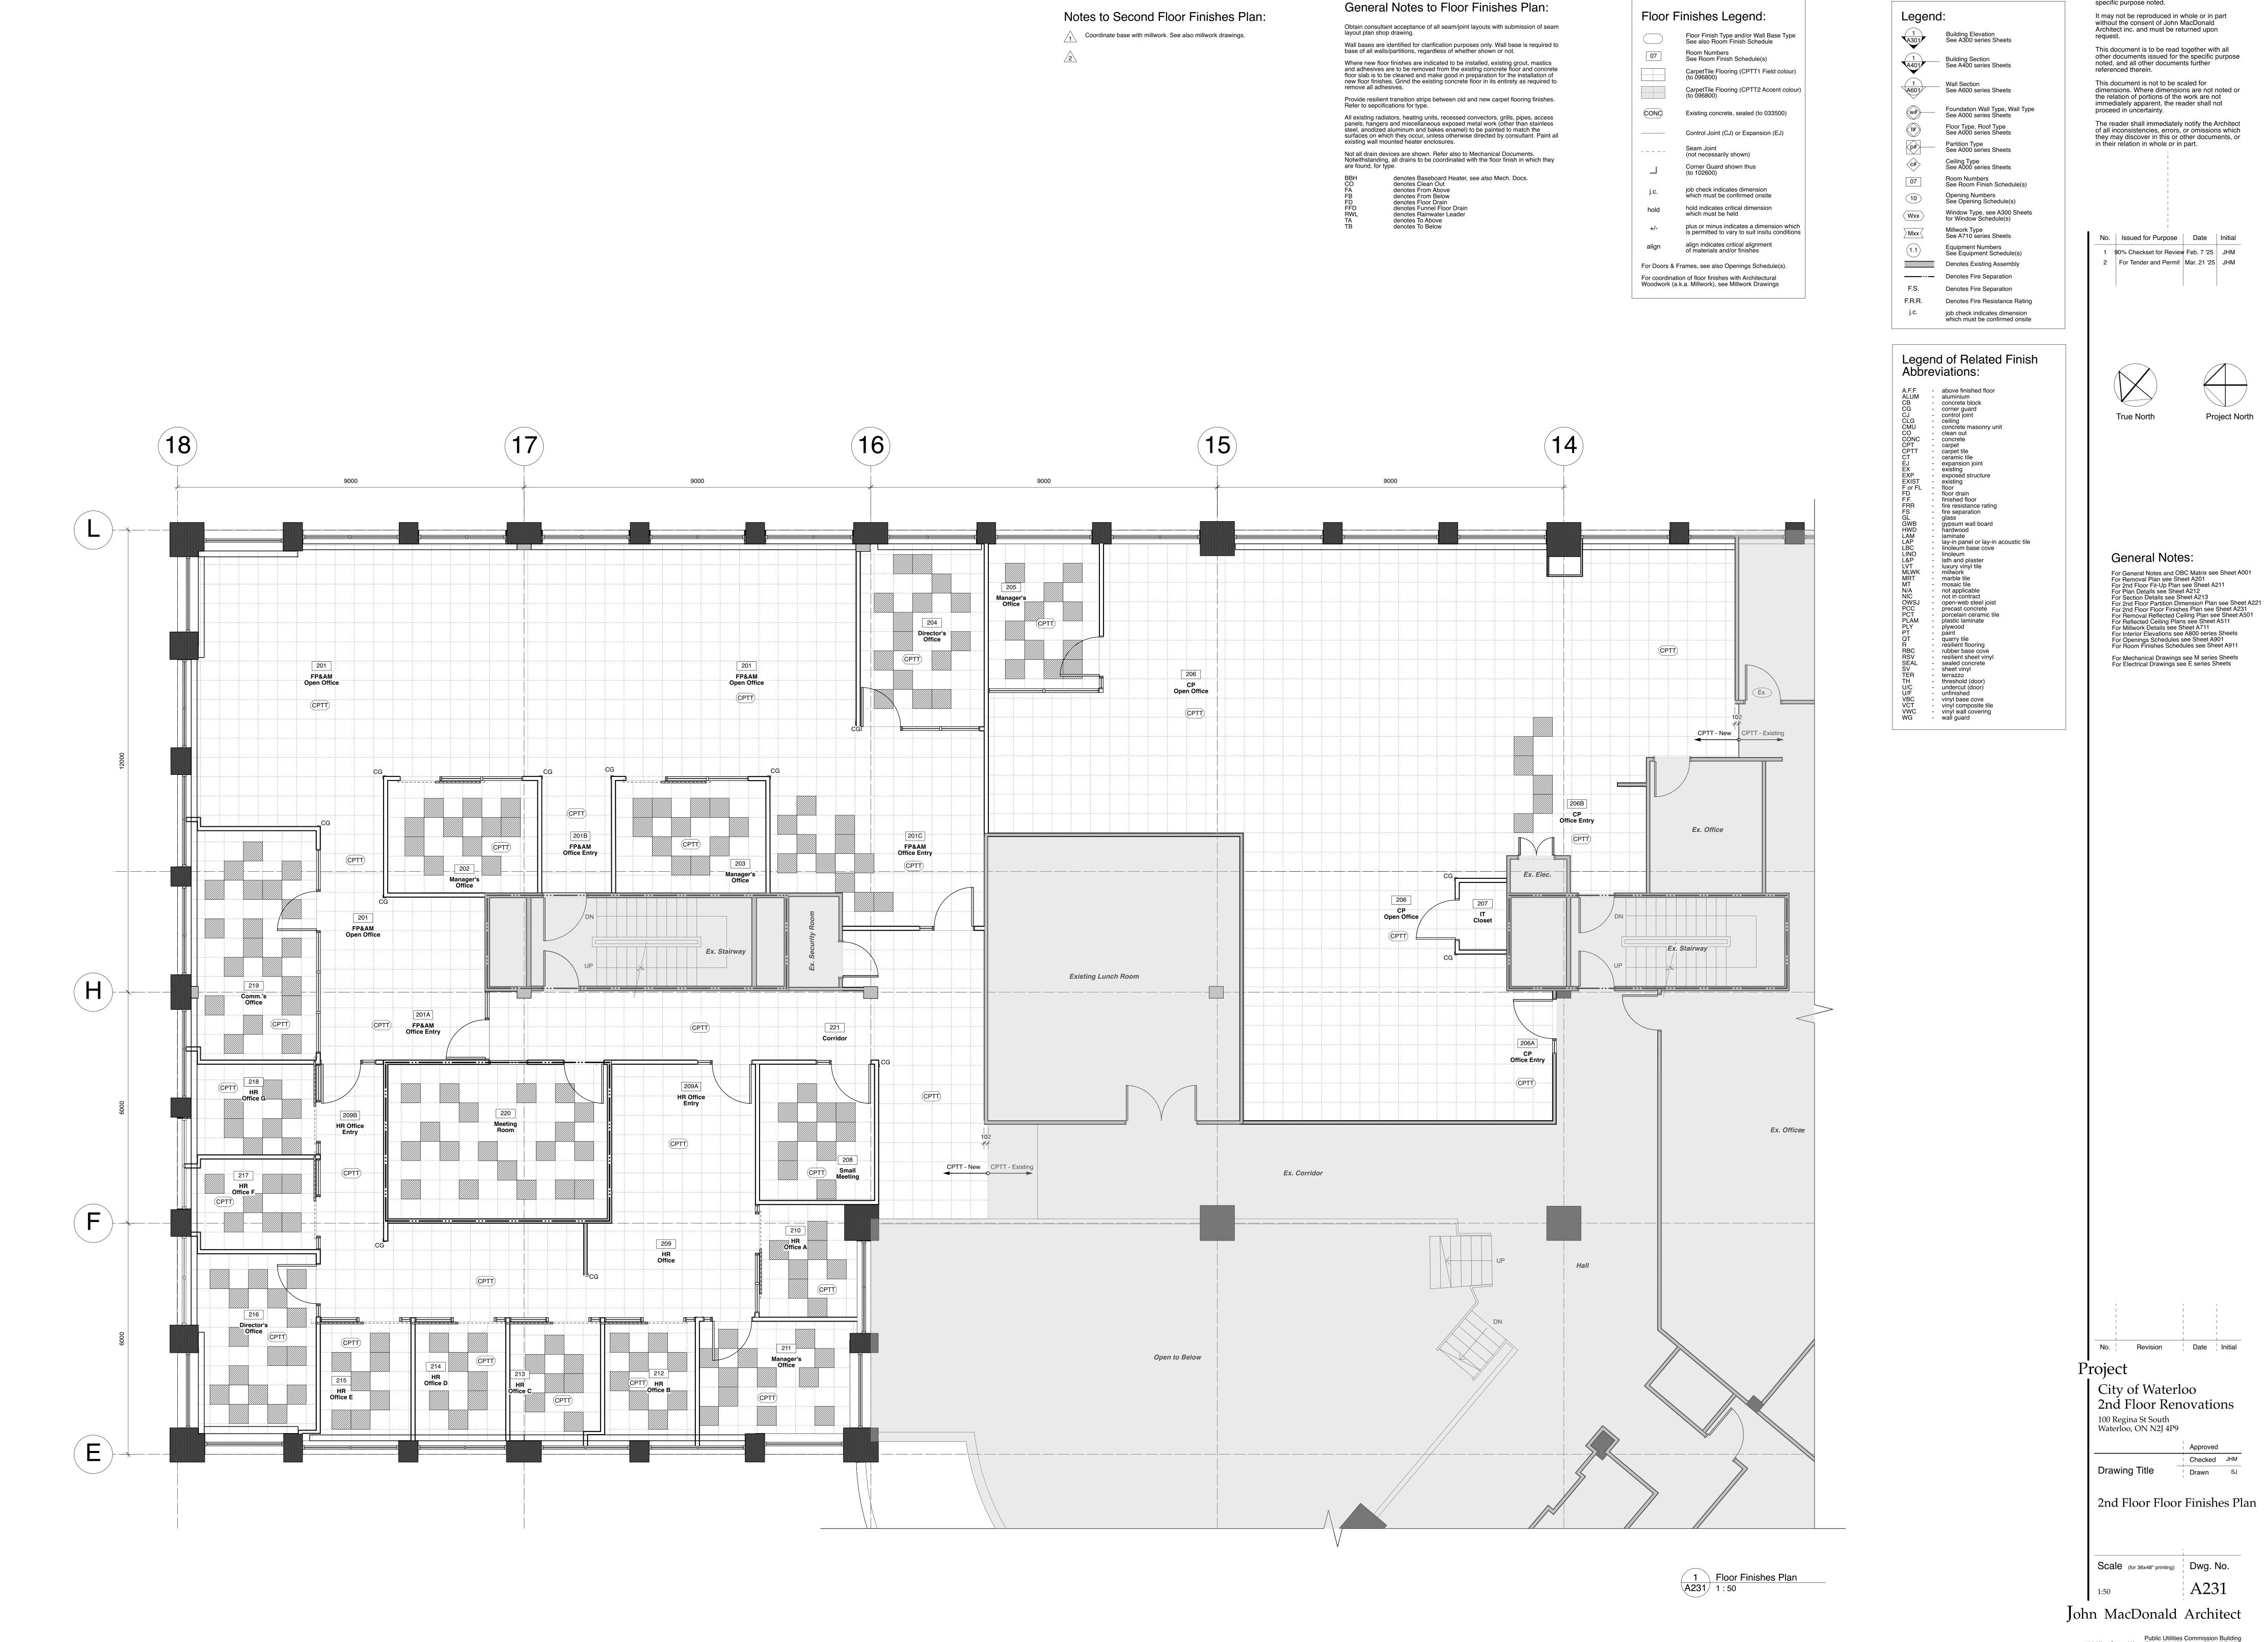
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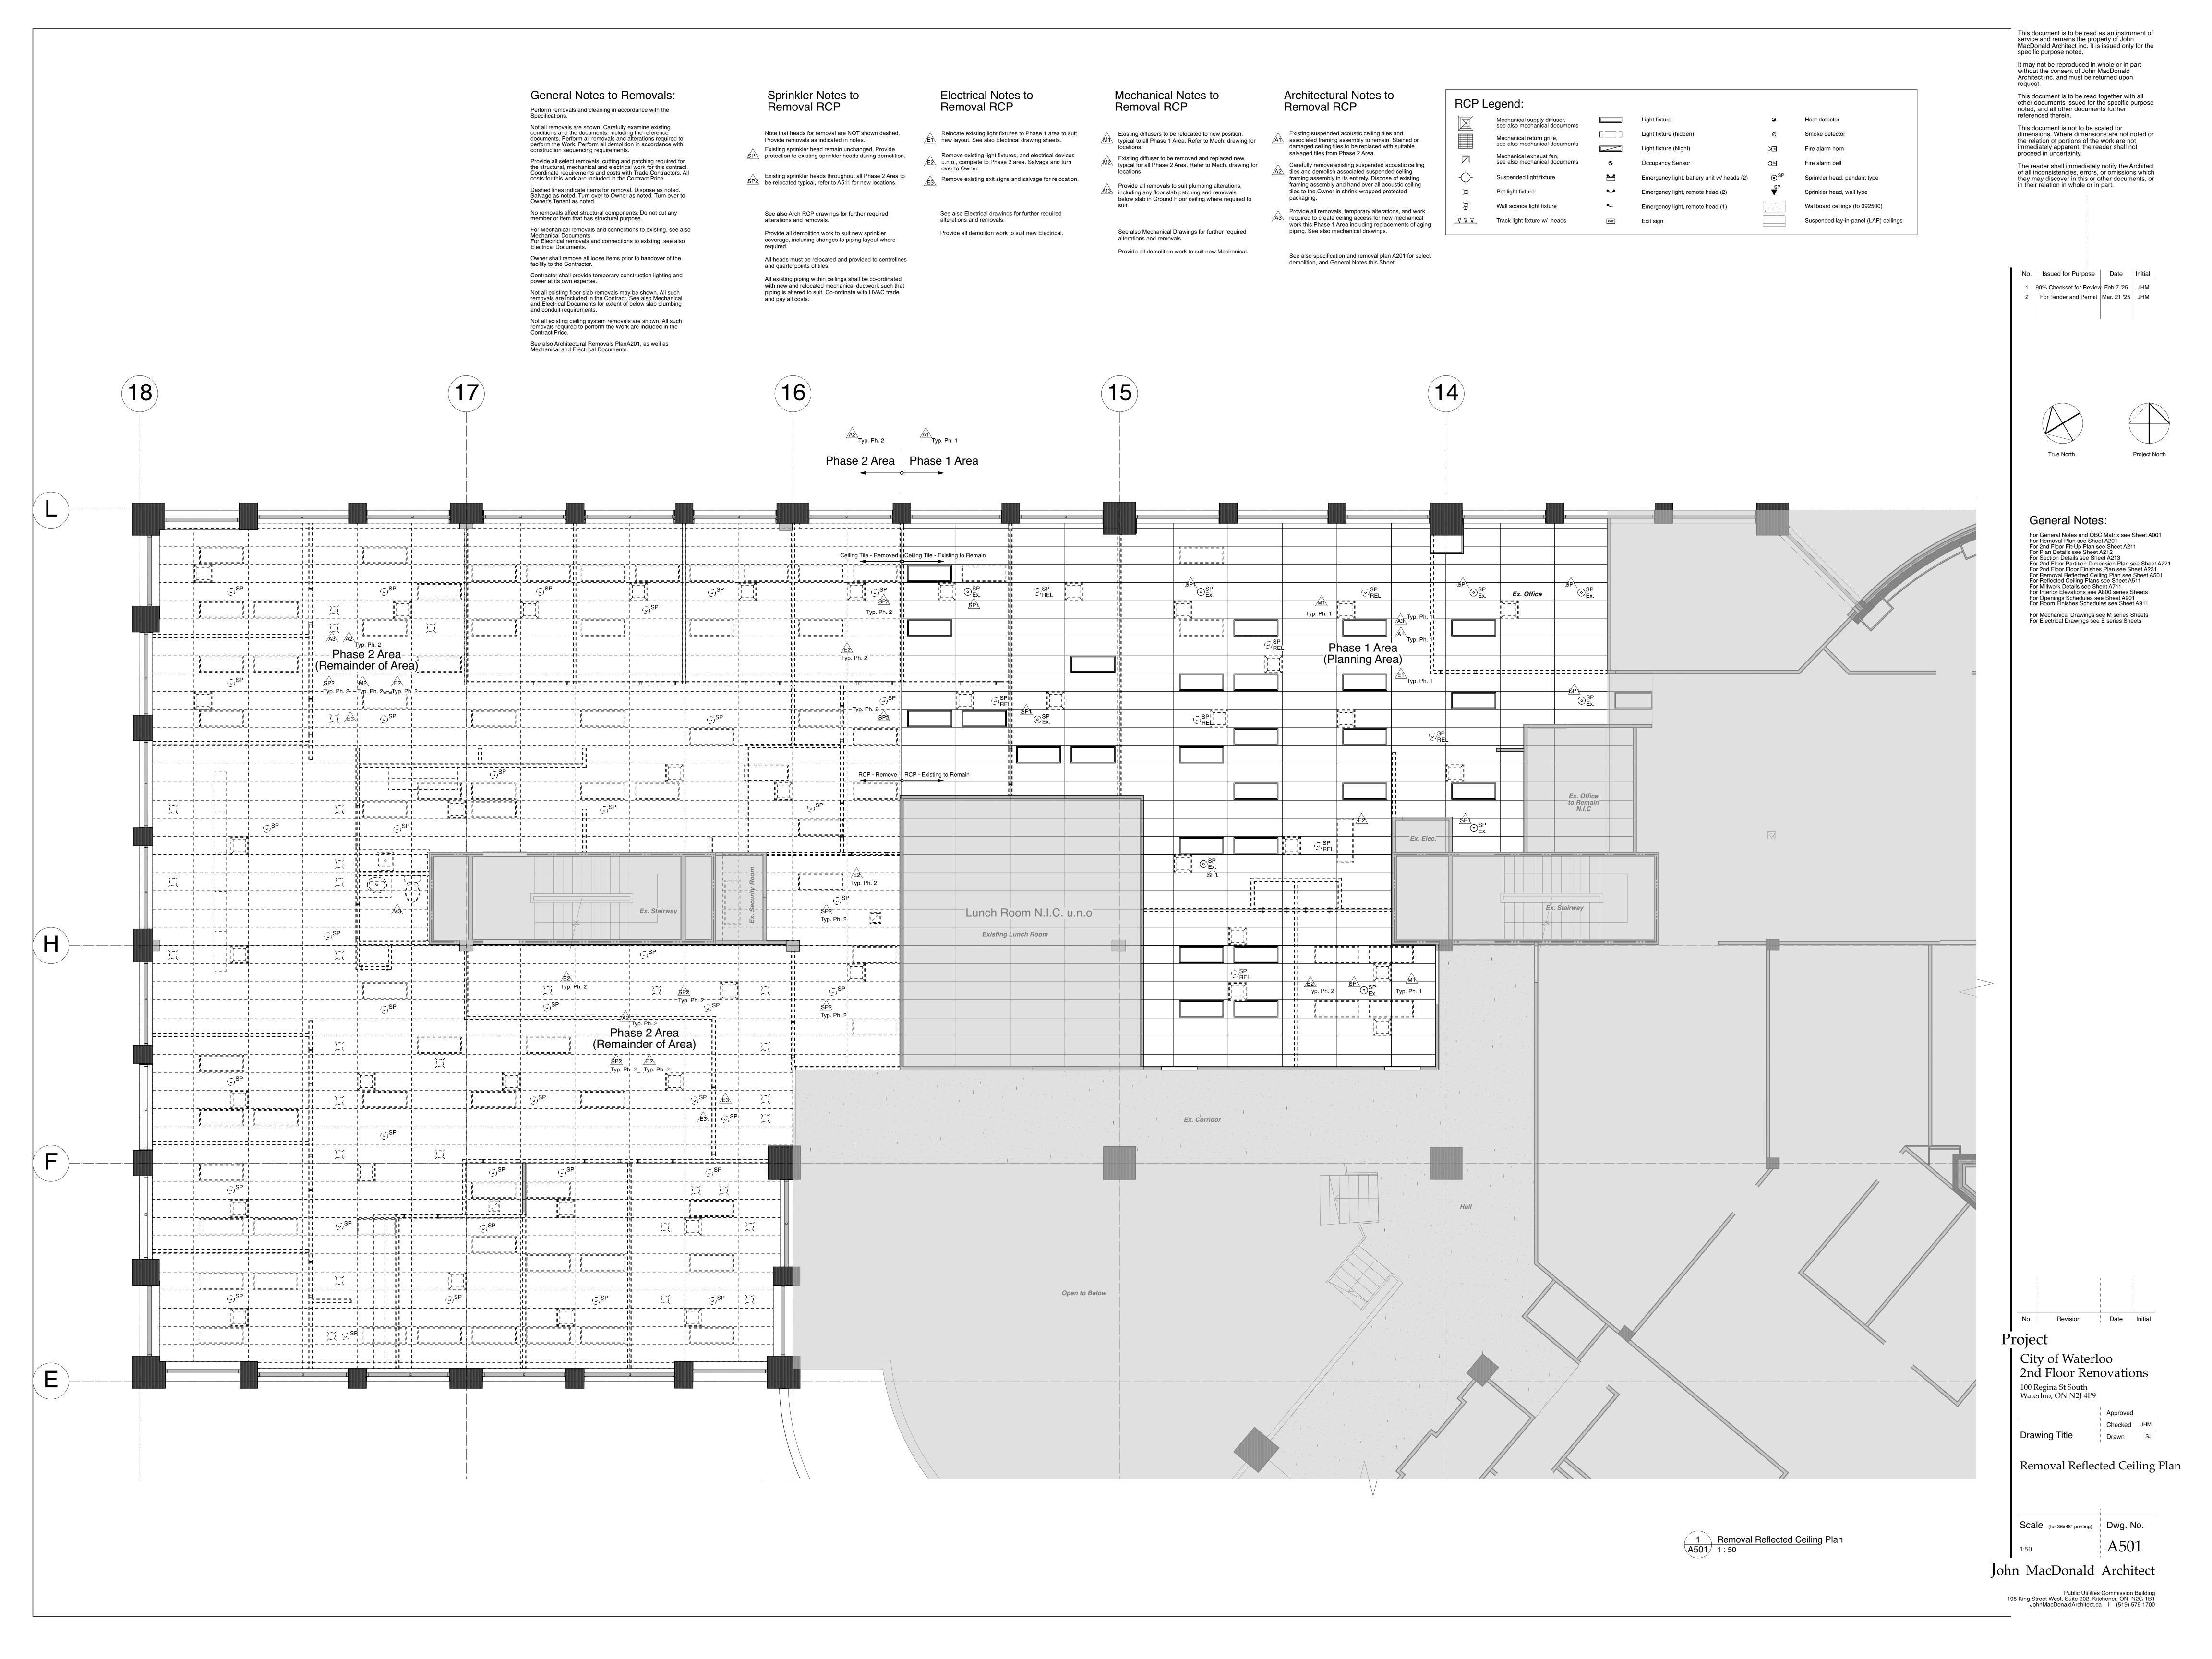





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General Fire Extinguisher Requirements:

General Notes to Ceilings:

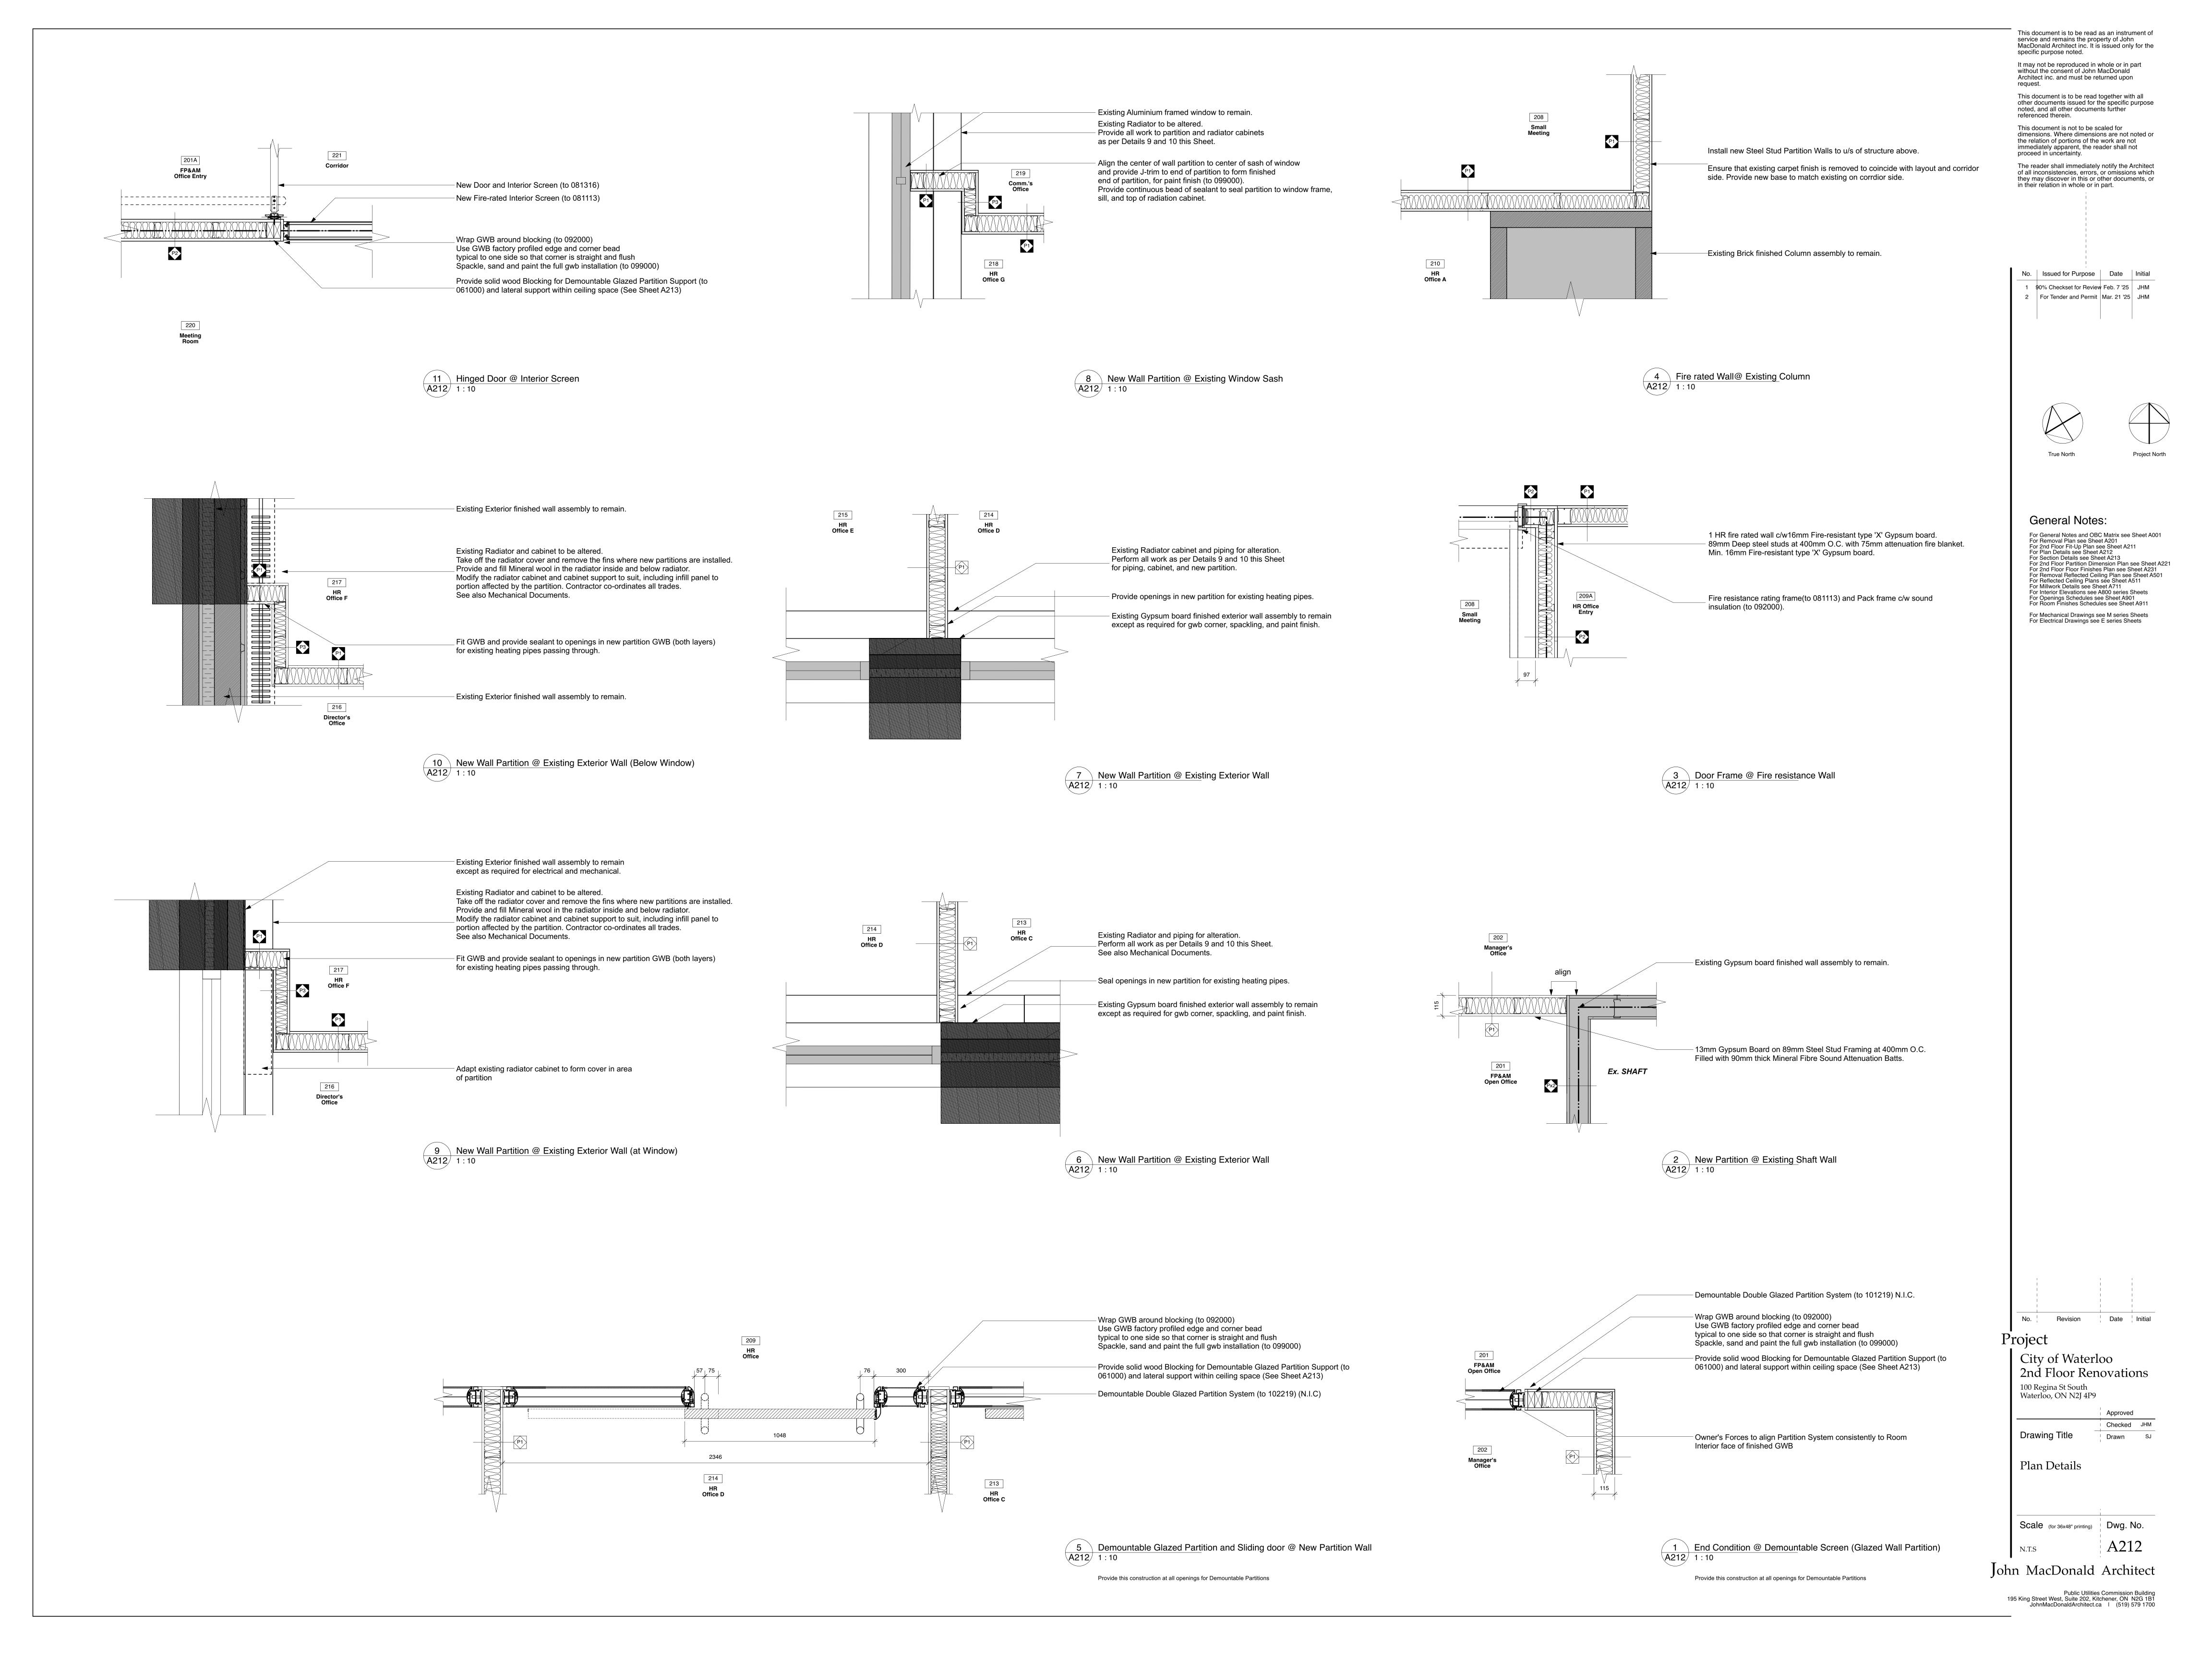General Notes to RCPs:

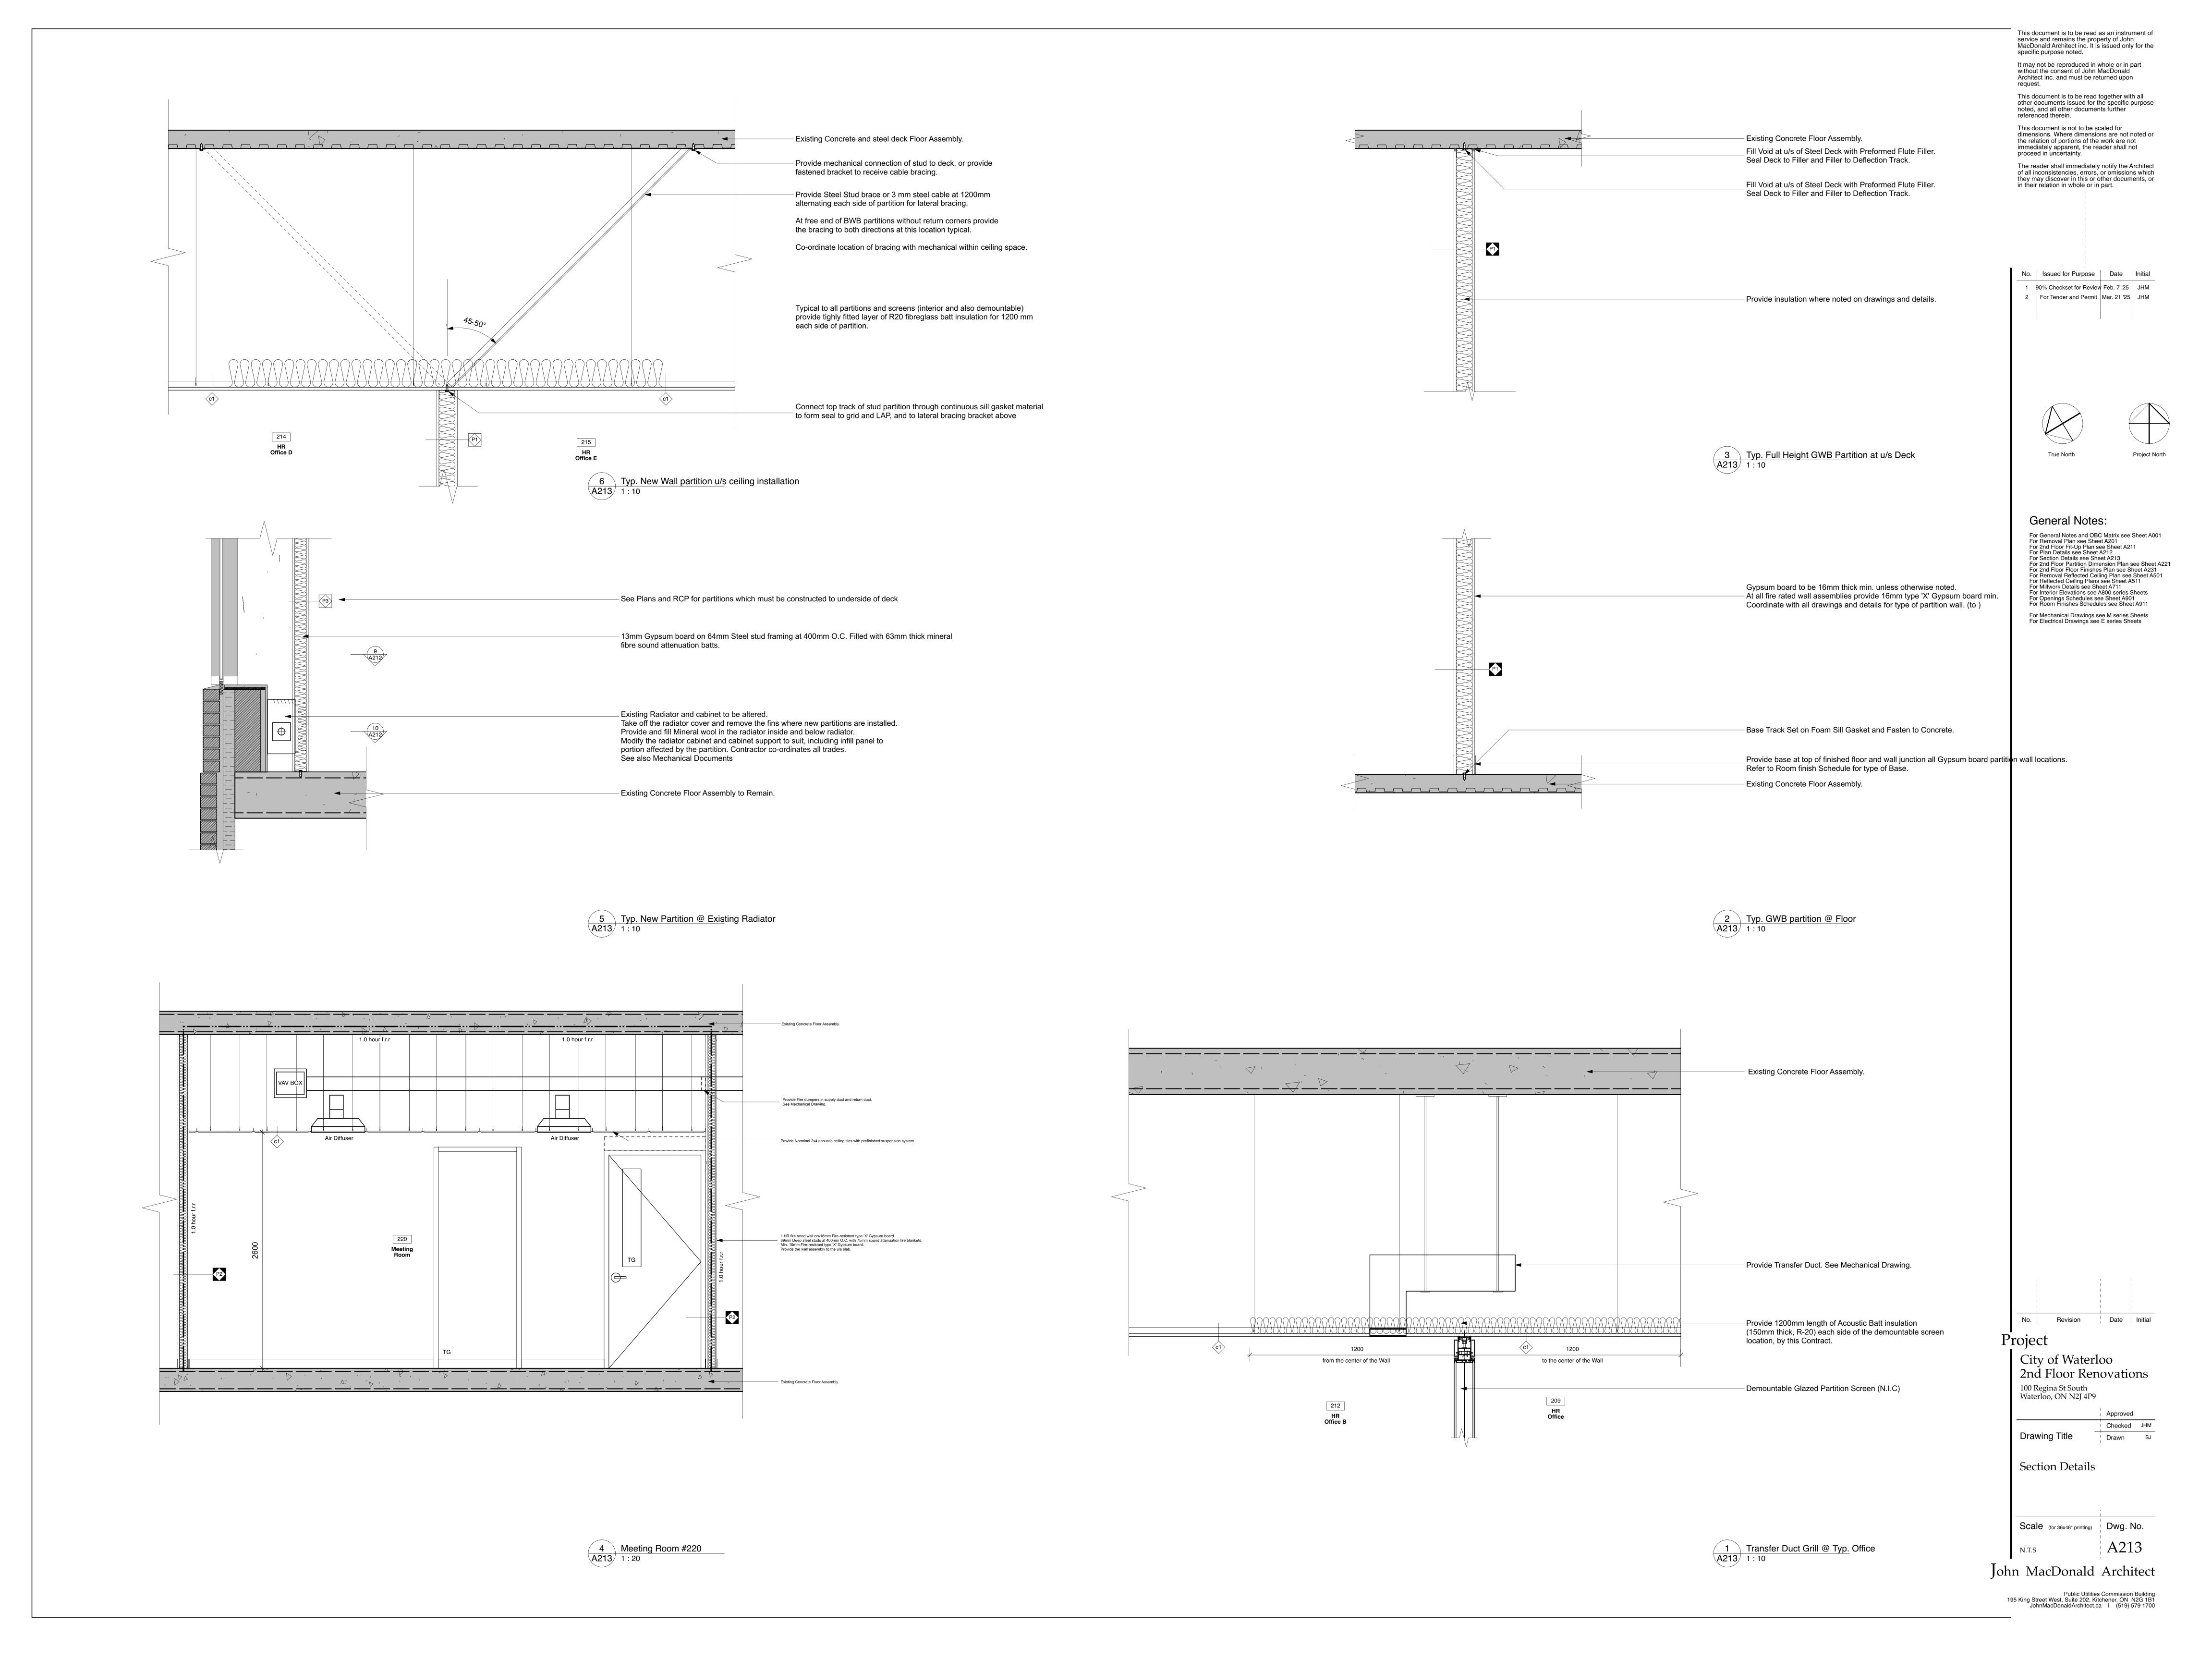
Fire Protection Notes:
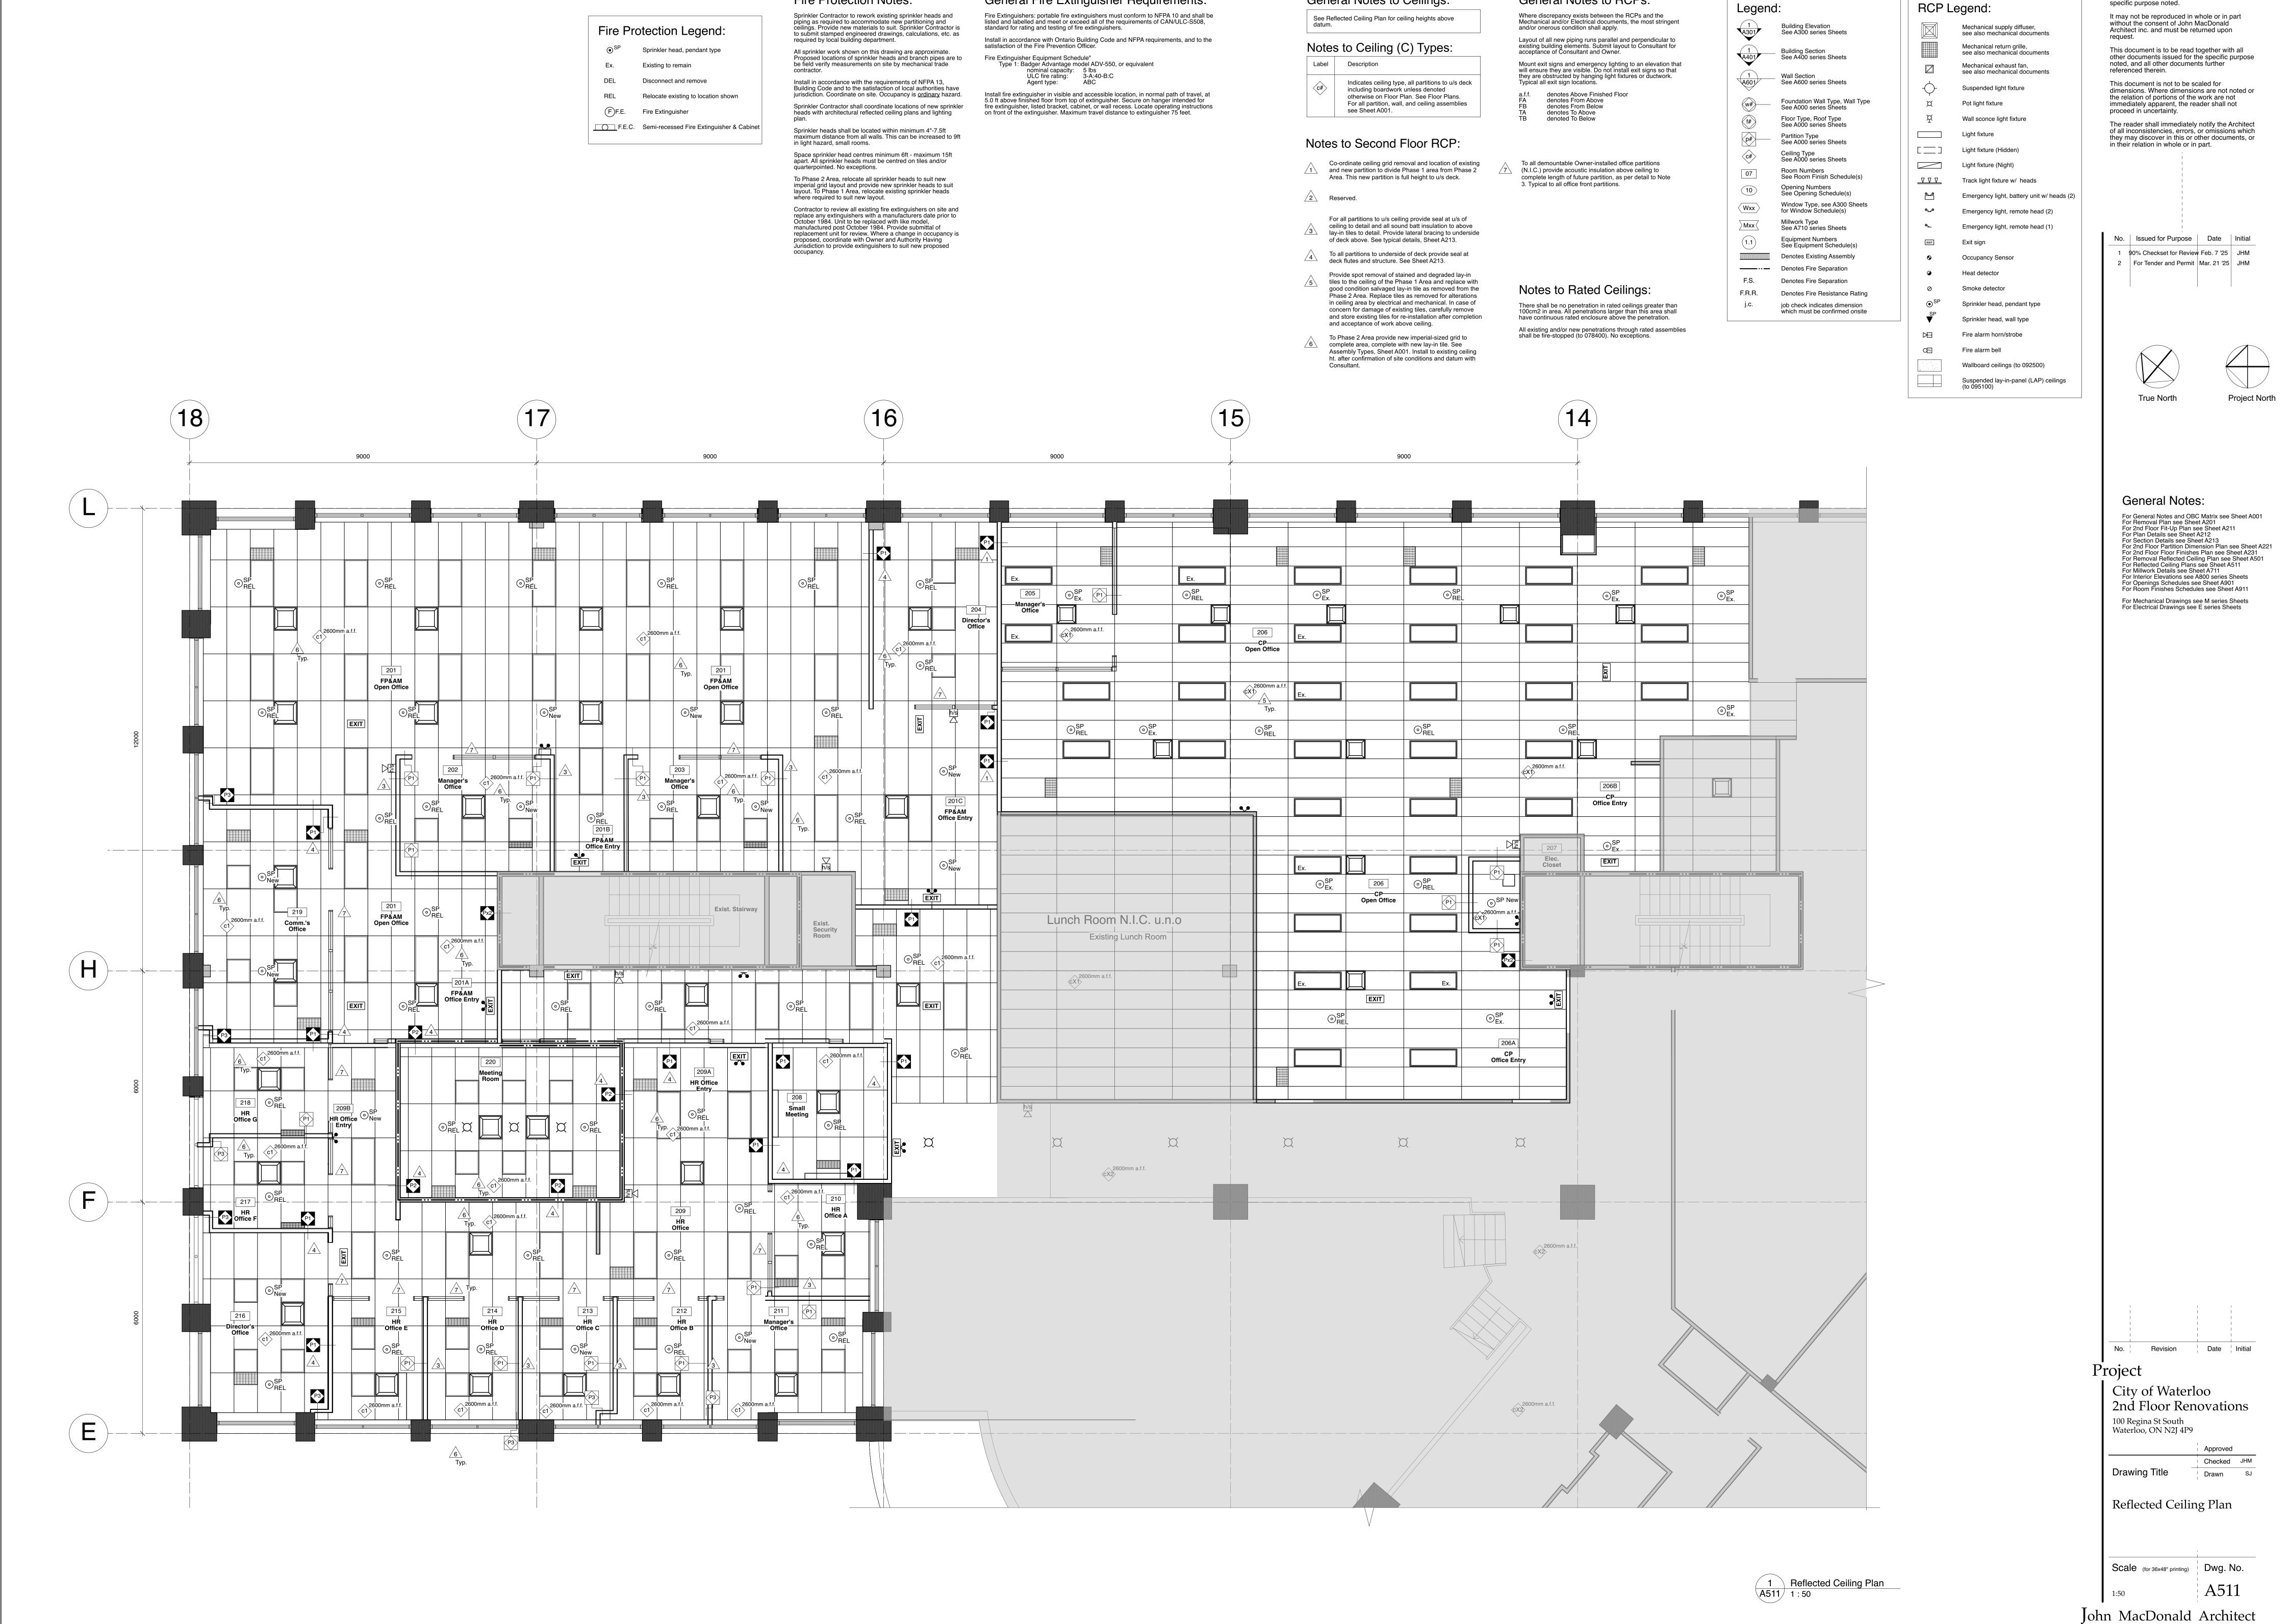
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For Mechanical Drawings see M series Sheets
For Electrical Drawings see E series Sheets

No. Revision Date

Project

City of Waterloo 2nd Floor Renovations 100 Regina St South Waterloo, ON N2J 4P9

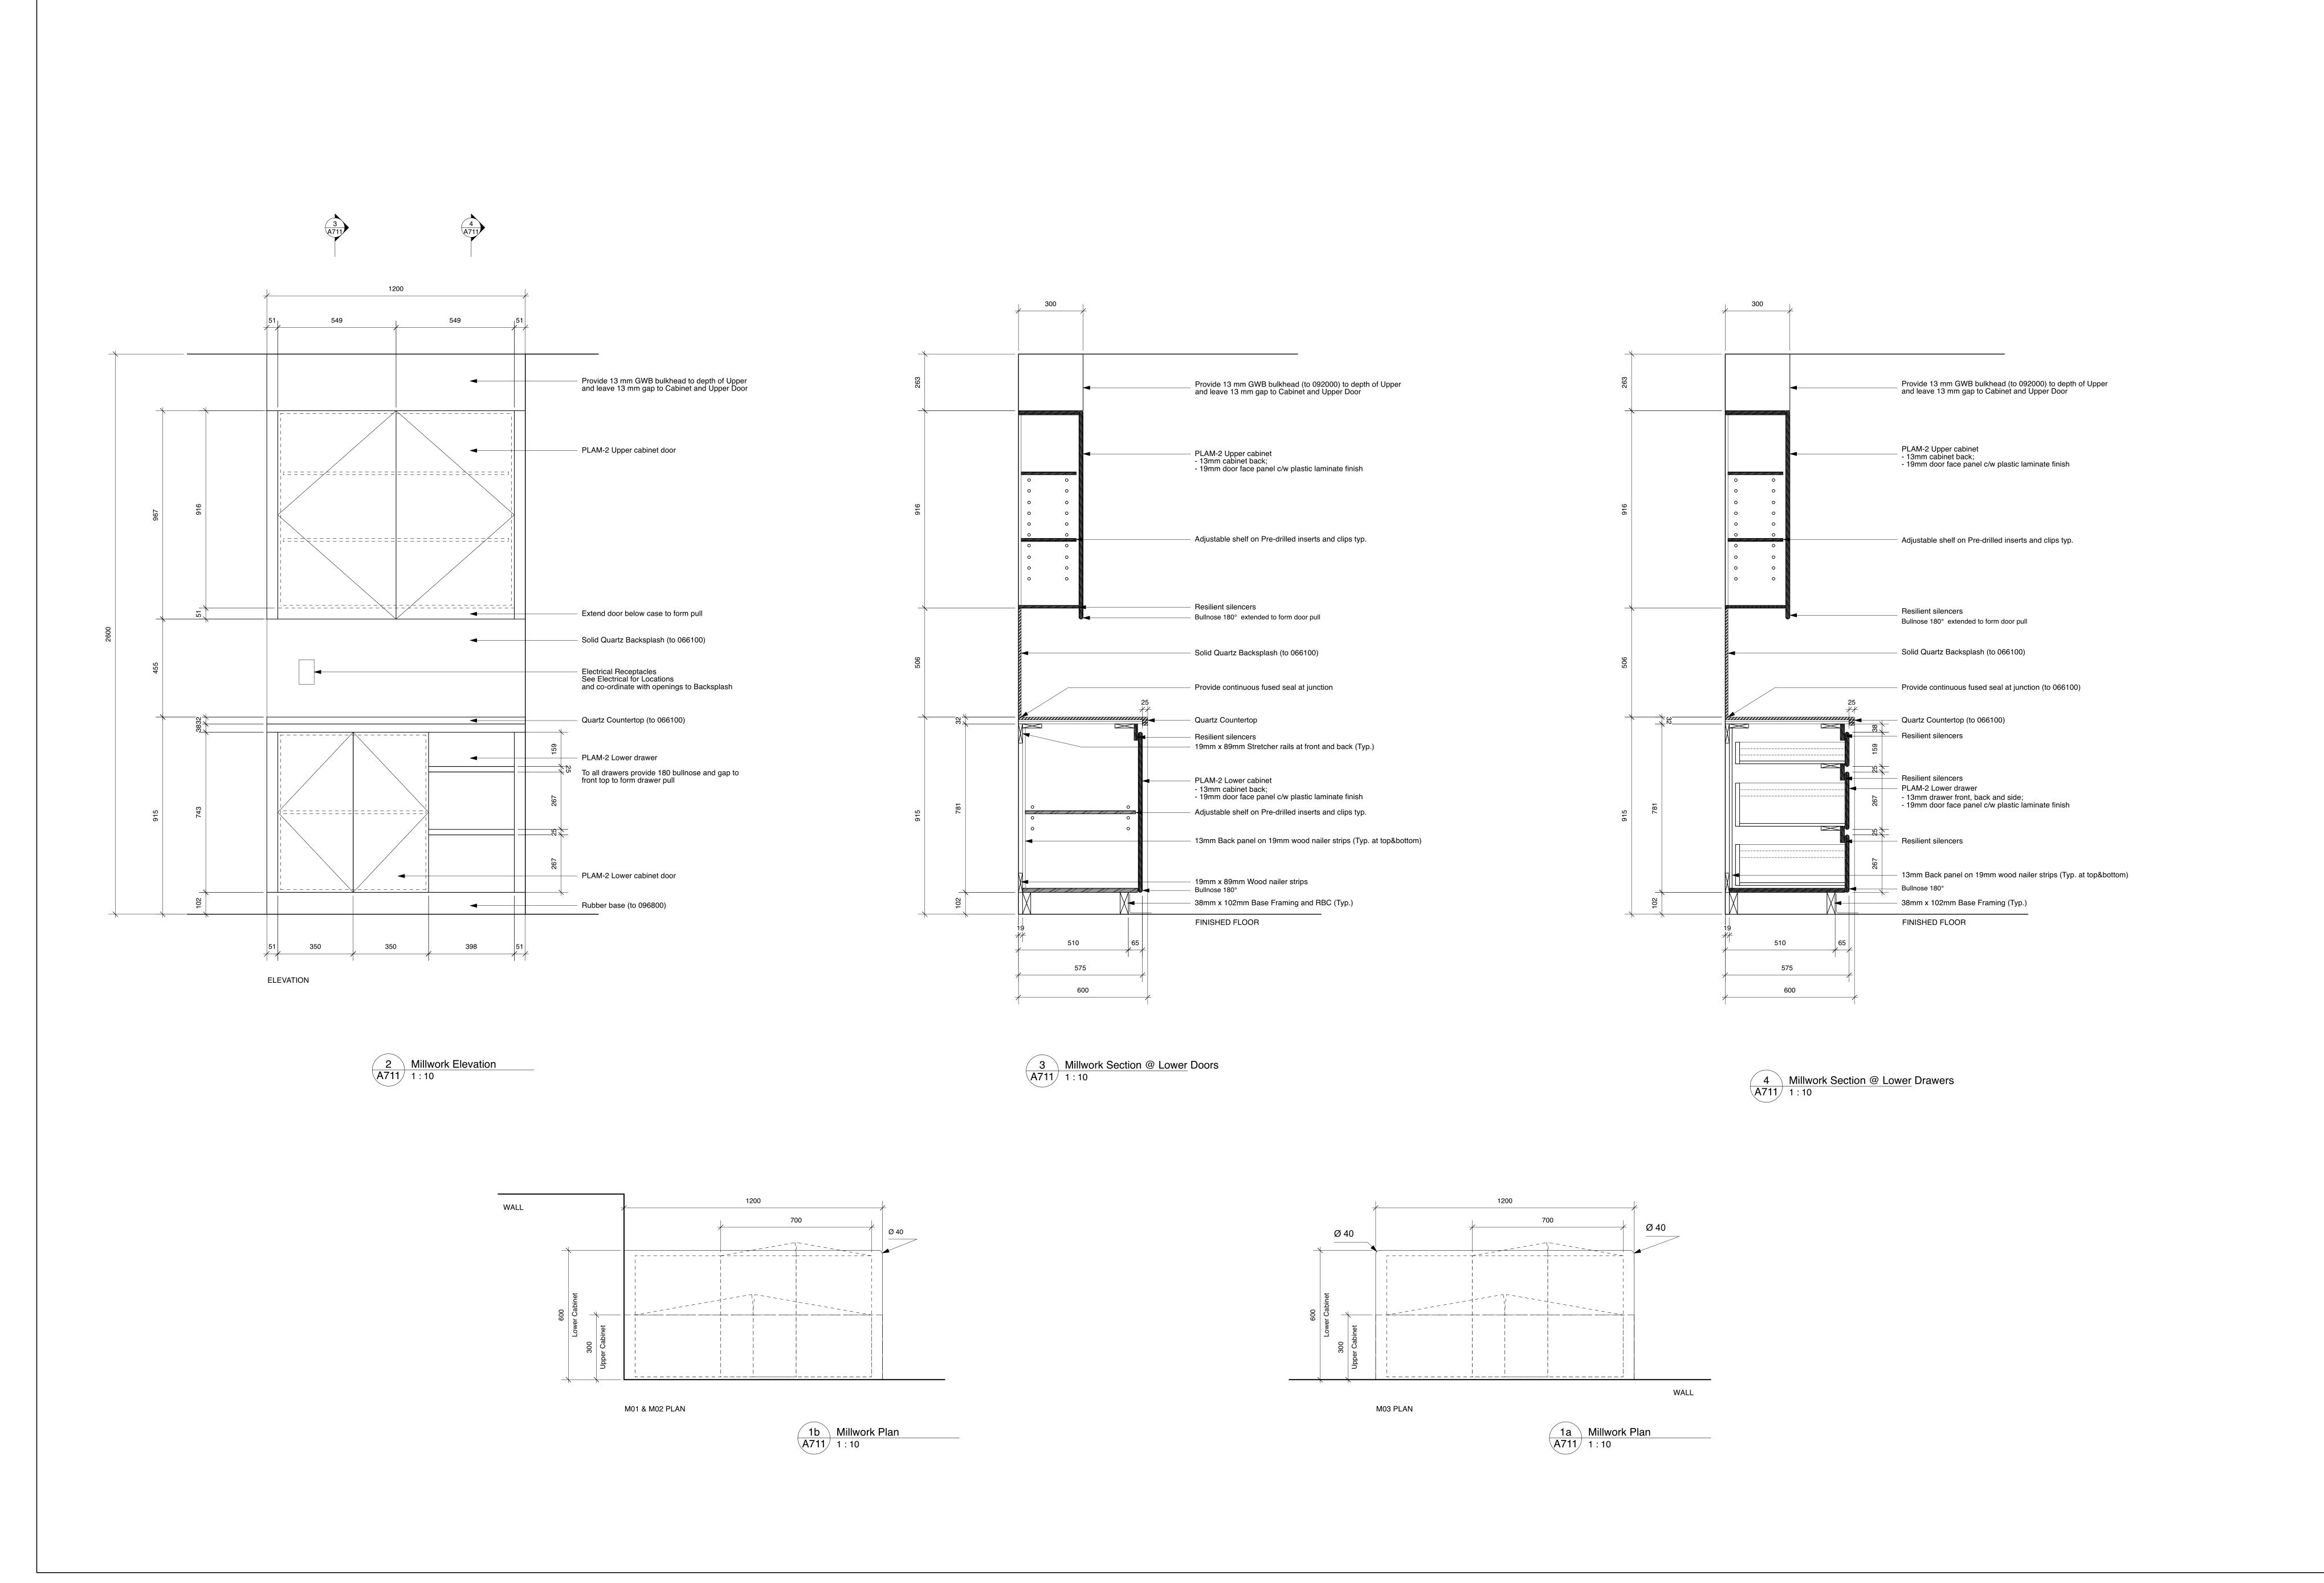Drawing Title Checked Jh

Millwork Details (M01,M02 & M03)


Scale (for 36x48" printing) Dwg. No. A711


John MacDonald Architect






tion			Rating	Fr	ame (to (	081113 8	084113)		Doo	or/Screen (to	081113, 081	400, and 08	84113)				Hardwar	e (see 087	000)													Elec. Fire	e Alarm	Access	Control
<b>.</b>	<b>Room</b> Corridor	Room to FP&AM Office Entr	- Assembly	- Opening	<b>17 Per</b>	Material Material	PRE	Frame Remarks To 081316	1 Feaf	Nominal Size	Handing	<b>D4</b>	Material Material	J B Inner Finish	Duter Finish	Door Remarks  New Aluminium frame & door, To	- Hinge	NOTS Function	E LEVER	- ED	· Bolt	O/H	· CLSR		SM -	- SWP	Emergency Evacuation Marker Acoustic	Drop-Downs	· PTL	ES I	Hardware Remarks New lockset and new hardware (to	· Electrical	MAGLOCK	< Card Reader	Building Systems Remarks  - 1 Card reader
3	Exist. Stairway	to FP&AM Office Entr	, Ex. 1.0	Ex. 45		HM		Existing to remain u.n.o. Providinew paint finishes (to 099000)	de 1	1016 x 215		Dx2	Ex. HM	PT	PT	Existing to remain u.n.o. Provide new paint finishes (to 099000)	-	STOR		Ex.	-	Ex.	Ex.		_	_		_	-		087000)  Exist. Hardware to remain.			Ex.	-
<b>,</b>	Corridor	to FP&AM Office Entr	Hour	min -	F32	ALUM		To 081316	1	1016 x 233		D4	ALUM	PRE	PRE	To 081316	-	STOR	LEVER	-	-	O/H	-		_	-		Υ	-	1	New lockset and new hardware (to			Υ	2 Separate Card reader at differ
	FP&AM Open Office		_		F11	ALUM		Not in Contract	1	1016 x 249			ALUM	PRE	PRE	Not in Contract	_	OFFICE		_	_	_	_		_	_	_	_	_		087000) All other hardware N.I.C			_	heights
	•								'																										
	FP&AM Open Office		-		F12	ALUM		Not in Contract	1	1016 x 249			ALUM	PRE	PRE	Not in Contract	-	OFFICE		-	-	-	-		-	-		-	-		All other hardware N.I.C  New lockset (to 087000) and all			-	-
	FP&AM Open Office		-		F13	ALUM		Not in Contract	1	1016 x 249			ALUM	PRE	PRE	Not in Contract	-	OFFICE		-	-	-	-		-	-		-	-	- (	other hardware N.I.C New lockset (to 087000) and all			-	-
	CP Open Office	to Manager's Office	-		F14 F33	ALUM		Not in Contract	1	1016 x 249		D4	ALUM	PRE PRE	PRE	Not in Contract	-	OFFICE STOR		-	-	O/H	- V		-	-	-   -	-	-	- (	other hardware N.I.C  New lockset and new hardware (to	-   -		- V	1 Cord reader
\ 	Exist. Corridor  Exist. Stairway	to CP Office Entry to CP Office Entry	Ex. 1.0	Ev. 45	Fx1	ALUM HM	DT	To 081316 Existing to remain u.n.o. Providence	de 1	1016 x 233		Dx2	ALUM Ex. HM	PRE	PRE	To 081316  Existing to remain u.n.o. Provide	Ex.	STOR	Ex. KNOE	- Ev	-	Ex.	Ex.		-	-		- -		Y (	087000)  Exist. Hardware to remain.			Ex.	- 1 Card reader
	CP Office Entry	to Exist. Elec.	hour -	min	Fx1	HM	DT	new paint finishes (to 099000) Existing to remain u.n.o. Provide	de o	457 x 2150			Ex. WD	PT	STN	new paint finishes (to 099000)  Existing to remain u.n.o. Provide	Ex.	PASS	Ex. KNOD	EX.	Ex.	<b>-</b>				_					Exist. Hardware to remain.  Exist. Hardware to remain.				_
	CP Open Office	to IT Closet			F1	HM	- ' '	new paint finishes (to 099000)  New to 081113 & 099000	1	1016 x 215		D2	WD WD	PT	STN	new paint finishes (to 099000)  New door & finishes to 081400 &	2	STOR	LEVER	_	LX.	_	V			_				1	New lockset (to 087000) and all				
			-						'							099000	3			-	-	-	T		-	-	-   -	-	-		other hardware N.I.C  New lockset (to 087000) and all			-	
	Corridor	to Small Meeting	-		F36	ALUM		To 081316	1	1016 x 215		D4	ALUM	PRE	PRE	To 081316	3	STOR	LEVER	-	-	O/H	-		-	-		Y	-	Y	other hardware N.I.C  New lockset and new hardware (to			Y	<ul><li>1 Card reader</li><li>2 Separate Card reader at differ</li></ul>
	Corridor	to HR Office Entry	-		F34	ALUM		To 081316	1	1016 x 233		D4	ALUM	PRE	PRE	To 081316	-	STOR	LEVER	-	-	O/H	-		-	-	-   -	Y	-	1 (	087000)		-	Y	heights
<b>,</b>	FP&AM Office Entry	to HR Office Entry	-	-	F35	ALUM	PRE	To 081316	1	1016 x 233	B6 RH	D4	ALUM	PRE	PRE	To 081316	3	STOR	LEVER	-	-	O/H	Υ		-	-		-	-		New lockset and new hardware (to 087000)		-	Y	- 1 Card reader
	HR Office	to HR Office A	-	-	F15	ALUM	PRE	Not in Contract	1	1016 x 249	98 Sliding		ALUM	PRE	PRE	Not in Contract	-	OFFICE	HANDLE	-	-	-	-		-	-	-   -	-	-		All other hardware N.I.C		-	-	-
	HR Office	to Manager's Office	-	-	F16	ALUM	PRE	Not in Contract	1	1016 x 249	98 RH		ALUM	PRE	PRE	Not in Contract	-	OFFICE	LEVER	-	-	-	-		-	-	-   -	-	-	- 1	New lockset (to 087000) and all other hardware N.I.C		-	-	-
	HR Office	to HR Office B	-	-	F17	ALUM	PRE	Not in Contract	1	1016 x 249	98 Sliding		ALUM	PRE	PRE	Not in Contract	-	OFFICE	HANDLE	-	-	-	-		-	-		-	-	-	All other hardware N.I.C		-	-	-
	HR Office	to HR Office C	-	-	F18	ALUM	PRE	Not in Contract	1	1016 x 249	98 Sliding		ALUM	PRE	PRE	Not in Contract	-	OFFICE	HANDLE	-	-	-	-		-	-		-	-	-	All other hardware N.I.C		-	-	-
	HR Office	to HR Office D	-		F19	ALUM		Not in Contract	1	1016 x 249			ALUM	PRE	PRE	Not in Contract	-	OFFICE		-	-	-	-		-	-		-	-		All other hardware N.I.C		-	-	-
	HR Office	to HR Office E to Director's Office	-		F20 F21	ALUM ALUM		Not in Contract  Not in Contract	1	1016 x 249			ALUM ALUM	PRE PRE	PRE PRE	Not in Contract  Not in Contract	-	OFFICE OFFICE		-	-	-	-		-	-		-	-	1	All other hardware N.I.C  New lockset (to 087000) and all		-	-	-
	HR Office	to HR Office F	-		F22	ALUM		Not in Contract	1	1016 x 249			ALUM	PRE	PRE	Not in Contract	-	OFFICE		-	-	-	-		-	-			-		other hardware N.I.C  All other hardware N.I.C		-	-	-
	HR Office	to HR Office G	-		F23	ALUM		Not in Contract	1	1016 x 249			ALUM	PRE	PRE	Not in Contract	-	OFFICE	HANDLE	-	-	-	-		-	-		_	-	-	All other hardware N.I.C			-	-
	FP&AM Open Office	to Comm.'s Office	-	-	F24	ALUM	PRE	Not in Contract	1	1016 x 249	98 LH		ALUM	PRE	PRE	Not in Contract	-	OFFICE	LEVER	-	-	-	-		-	-		-	-	ĭ	New lockset (to 087000) and all other hardware N.I.C		-	Y	- 1 Card reader
	Corridor	to Meeting Room	1.0 hour	45 min	F2	STL	PT	New to 081113 & 099000	1	1016 x 233	B6 LH	D3	WD	PT	PT	New door & finishes to 081400 & 099000	-	STOR	LEVER	-	-	O/H	Υ		-	-		Υ	-		New lockset and new hardware (to 087000)		-	Y	<ul> <li>2 Separate Card reader at diffe heights</li> </ul>
	Corridor	to Exist. Stairway	Ex. 1.0 hour	Ex. 45 min	Fx1	НМ	PT	Existing to remain u.n.o. Providinew paint finishes (to 099000)	de 1	1016 x 2150	j.c. LH	Dx2	Ex. HM	PT	PT	Existing to remain u.n.o. Provide new paint finishes (to 099000)	Ex.	STOR	Ex. KNOE	Ex.	-	Ex.	Ex.	-   -	-	-		-	-		Exist. Hardware to remain, except provide new hardware as indicated		-	Ex.	-
	Corridor	to Ex. Storage Space		-	Fx1	НМ	PT	Existing to remain u.n.o. Providinew paint finishes (to 099000)	de 4	965 x 2550	j.c. LHR	Dx3	Ex. HM	PT	PT	Existing to remain u.n.o. Provide new paint finishes (to 099000)	Ex.	STOR	Ex. LEVER	-	-	-	-		-	-		-	-		Exist. Hardware to remain, except provide new hardware as indicated		-	-	-
	Corridor	to Eviating Office			Ev		Fu			F	LUD	Dv4	- Fy		Γv		Fu	055105		+			Ev											V	One existing Card reader to be relocated and one additional ne
	Corridor	to Existing Office	-	-	Ex.	Ex.	Ex.	Existing to remain u.n.o. Providinew paint finishes (to 099000)	de 1	Ex.	LHR	Dx4	Ex.	Ex.	Ex.	Existing to remain u.n.o. Provide new paint finishes (to 099000)	Ex.	OFFICE	Ex. LEVEF	Ex.	-	Ex.	Ex.		-	-		Y	-	Y E	Exist. Hardware to remain, except provide new hardware as indicated			-	- Y

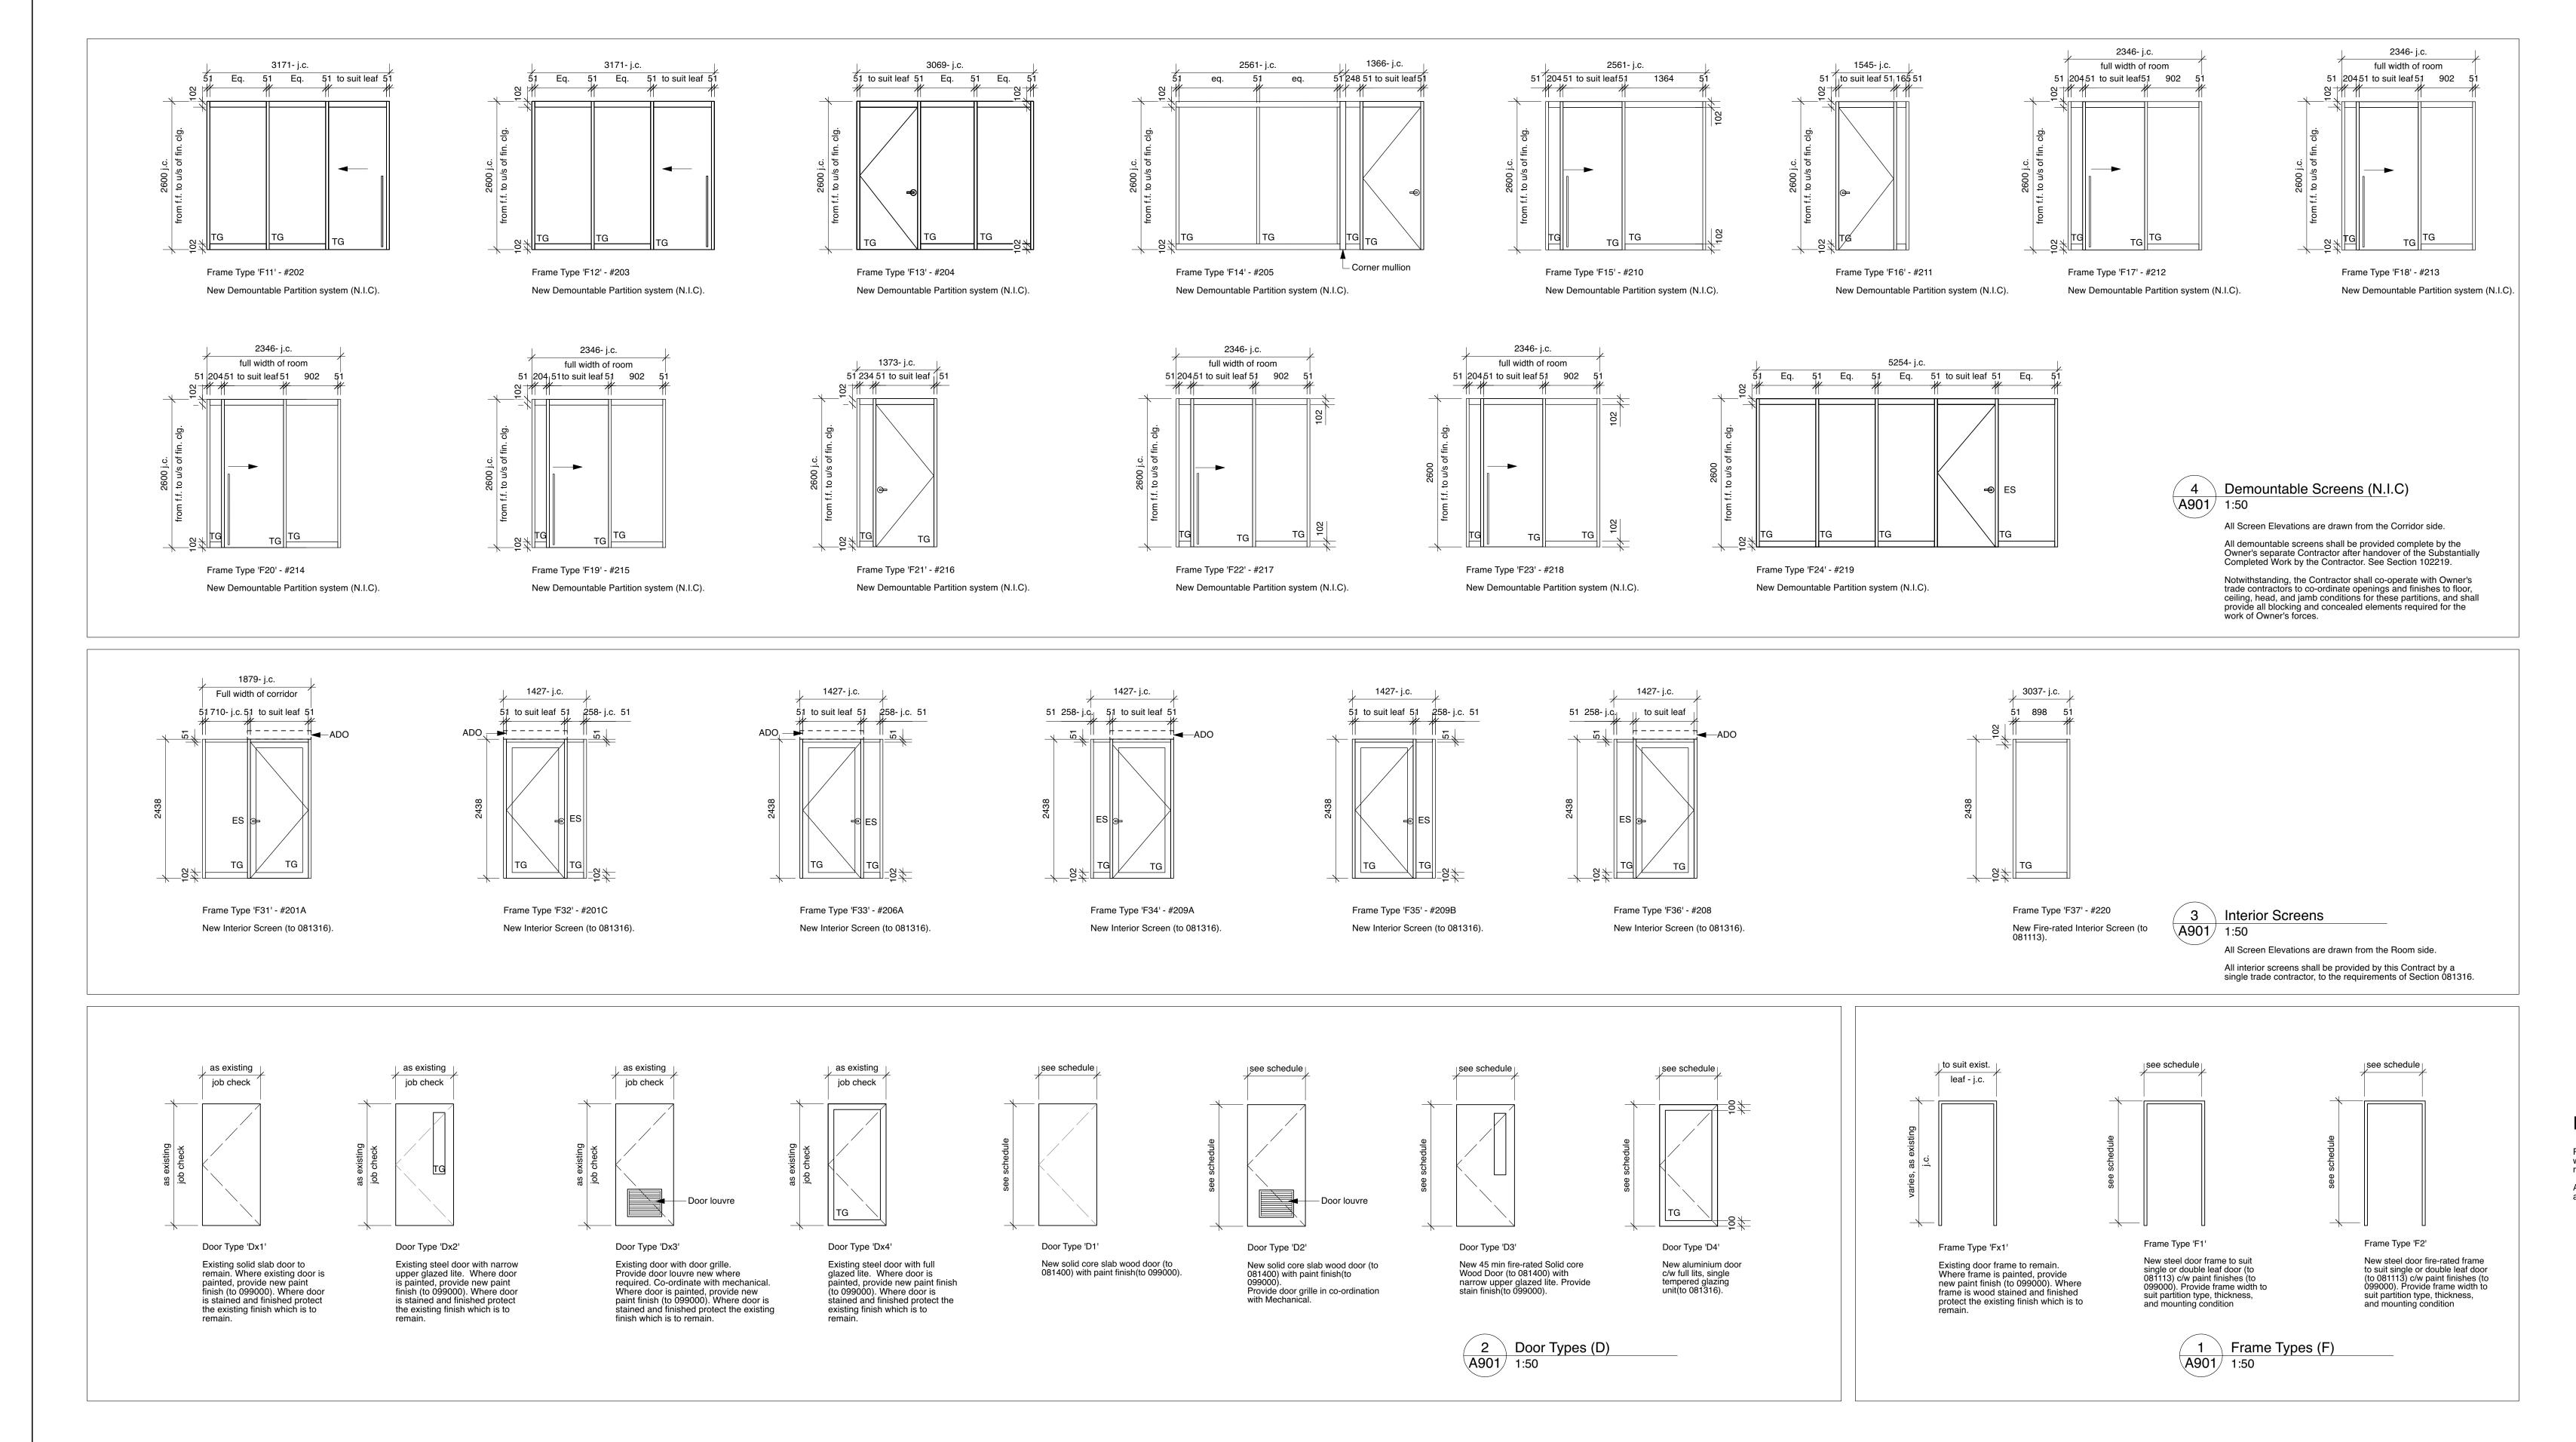

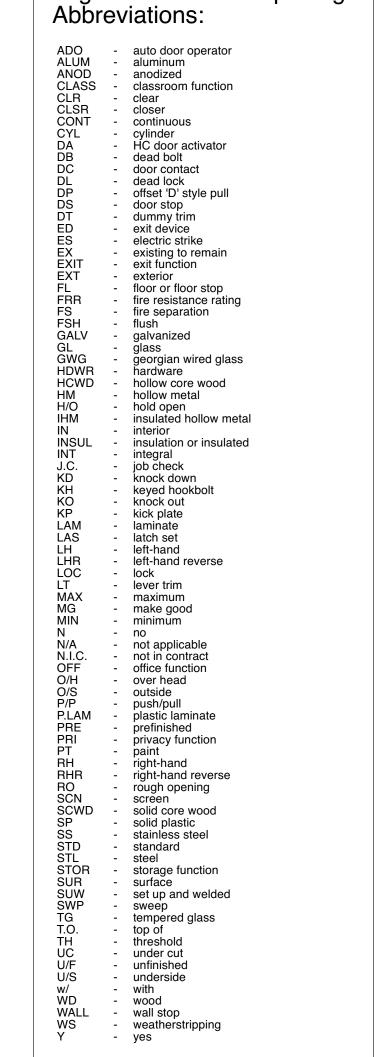

Legend of Related Opening

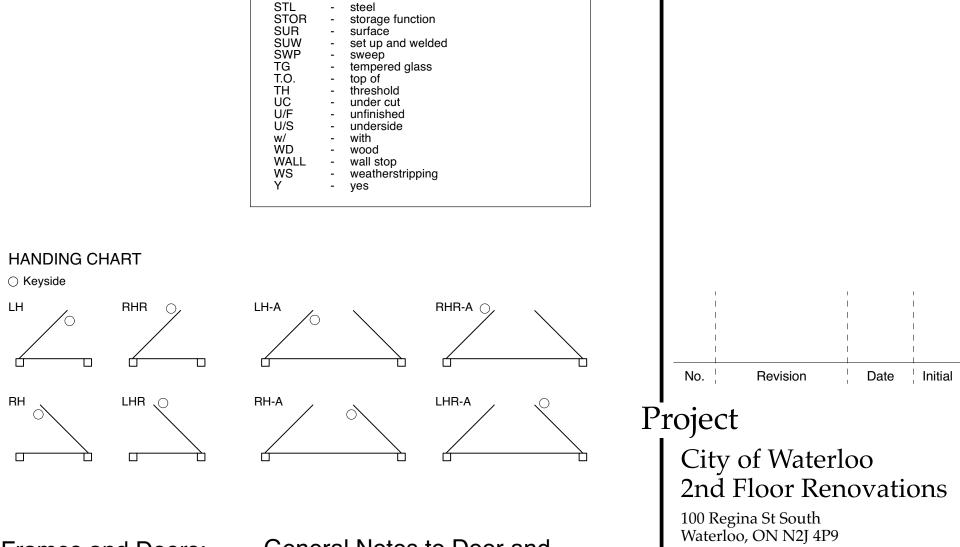

Films to Frames and Doors: Provide privacy control films to sidelites (to 125250) where indicated. Where an opening is scheduled to receive privacy films all lites are to receive such films. All films are installed by the Owner's Trade Contractor after completion of fit-up, N.I.C.

General Notes to Door and Frame Types:

Coordinate with and provide all external connections of Openings to all applicable Building Systems, including but not limited to Barrier-free Path of Travel System, Emergency Egress and Exiting System, Environmental Separation Systems, Fire Alarm System, Access Control and Security Refer also to all Sections of Division 08 for door and frame requirements, including glazing and hardware. All glazing in doors to be tempered glass (TG). No exceptions. All glazing in rated openings shall additionally be ceramic coated fire rated glass. All rated openings to bear ULC labels.

Co-ordinate frame and door height with floor finishes, and with

masonry jointing, to ensure installation provides best fit and operation in each location.

'Not In Contract' doors, frames and hardwares supplied and installed by owner. Contractor to provided the required power connections to be installed into the new door location.

Openings Schedule

John MacDonald Architect

Scale (for 36x48" printing) Dwg. No.

Revision

Drawing Title

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dimensions. Where dimensions are not noted or the relation of portions of the work are not immediately apparent, the reader shall not

The reader shall immediately notify the Architect of all inconsistencies, errors, or omissions which they may discover in this or other documents, or

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1 90% Checkset for Review Feb. 7 '25 JHM 2 For Tender and Permit Mar. 21 '25 JHM

General Notes:

For Removal Plan see Sheet A201 For 2nd Floor Fit-Up Plan see Sheet A211 For Plan Details see Sheet A212 For Section Details see Sheet A213

For Reflected Ceiling Plans see Sheet A511 For Millwork Details see Sheet A711 For Interior Elevations see A800 series Sheets For Openings Schedules see Sheet A901 For Room Finishes Schedules see Sheet A911

For Mechanical Drawings see M series Sheets For Electrical Drawings see E series Sheets

For General Notes and OBC Matrix see Sheet A001

For 2nd Floor Partition Dimension Plan see Sheet A221 For 2nd Floor Floor Finishes Plan see Sheet A231 For Removal Reflected Ceiling Plan see Sheet A501

noted, and all other documents further

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in their relation in whole or in part.

specific purpose noted.

referenced therein.

proceed in uncertainty.

Approved

Drawn

Checked JHM

Room		Flooring				North V	Vall	East W	'all	South \	Wall	West	Wall		Ceilings				Bulkhead			
No.	Room Name	Floor	Floor Remarks	Base	Base Remarks	Sub	Finish	Sub	Finish	Sub	Finish	Sub	Finish	Wall Remarks	Material	Finish	Height (a.f.f.)	Ceiling Remarks	Materials Fi	inish	Height Bu	ulkhead Remarks
201	FP&AM Open Office	CPTT1	New to 096800	RBC	New to 096800	Ex. GWB/ New GWB	PT	Ex. GWB	PT	Ex. GWB/ New GWB	PT	Ex. GWB/ New GWB	PT	All New to 099000	LAP	PRE	2600 mm	New tile to 095100	-	-	-	-
201A	FP&AM Office Entry	CPTT1	New to 096800	RBC	New to 096800	New GWB/Demountabl e Screen(N.I.C)	PT	New GWB	PT	Ex. GWB/ Interior Screen	PT	Interior Screen/ New GWB	PT	All New to 099000	LAP	PRE	2600 mm	New tile to 095100	-	-	-	-
201B	FP&AM Office Entry	CPTT1	New to 096800	RBC	New to 096800	New GWB	PT	-	-	New GWB	PT	Ex. GWB	PT	All New to 099000	LAP	PRE	2600 mm	New tile to 095100	-	-	-	-
201C	FP&AM Office Entry	CPTT1/CPT1	Γ2 New to 096800	RBC	New to 096800	New GWB	PT	Ex. GWB/ Demountable Screen(N.I.C)	PT	Ex. GWB/ New GWB	PT	New GWB/ Interior Screen	PT	All New to 099000	LAP	PRE	2600 mm	New tile to 095100	-	-	-	-
202	Manager's Office	CPTT1/CPT1	Γ2 New to 096800	RBC	New to 096800	New GWB	PT	New GWB/ Demountable Screen(N.I.C)	PT	New GWB	PT	Ex. GWB/ New GWB	PT	All New to 099000	LAP	PRE	2600 mm	New tile to 095100	-	-	-	-
203	Manager's Office	CPTT1/CPT1	Γ2 New to 096800	RBC	New to 096800	New GWB	PT	New GWB/ Demountable Screen(N.I.C)	PT	New GWB	PT	Ex. GWB	PT	All New to 099000	LAP	PRE	2600 mm	New tile to 095100	-	-	-	-
204	Director's Office	CPTT1/CPT1	Γ2 New to 096800	RBC	New to 096800	New GWB	PT	Ex. GWB	PT	New GWB	PT	New GWB/ Demountable Screen(N.I.C)	PT	All New to 099000	LAP	PRE	2600 mm	New tile to 095100	-	-	-	-
205	Manager's Office	CPTT1/CPT1	Γ2 New to 096800	RBC	New to 096800	New GWB	PT	Ex. GWB	PT	New GWB/ Demountable Screen(N.I.C)	PT	New GWB/ Demountable Screen(N.I.C)	PT	All New to 099000	Ex. LAP	Ex.	2600 mm as exist. j.c.	Spot replacement to 095100		-	-	-
206	CP Open Office	CPTT1	New to 096800	RBC	New to 096800	New GWB	PT	Ex. GWB	PT	Ex. GWB/ New GWB	PT	Ex. GWB/ New GWB	PT	All New to 099000	Ex. LAP	Ex.	2600 mm as exist. j.c.	Spot replacement to 095100	-	-	-	
206A	CP Office Entry	CPTT1	New to 096800	RBC	New to 096800	Ex. GWB	PT	New GWB	PT	Ex. GWB/ New GWB	PT	Ex. GWB	PT	All New to 099000	Ex. LAP	Ex.	2600 mm as exist. j.c.	Spot replacement to 095100	-	-	-	
206B	CP Office Entry	CPTT1/CPT1	Γ2 New to 096800	RBC	New to 096800	Ex. GWB	PT	Ex. GWB	PT	Ex. GWB	PT	Ex. GWB	PT	All New to 099000	Ex. LAP	Ex.	2600 mm as exist. j.c.	Spot replacement to 095100	-	-	-	_
207	IT Closet	CPTT1	New to 096800	RBC	New to 096800	New GWB	PT	New GWB	PT	Ex. GWB	PT	New GWB	PT	All New to 099000	Ex. LAP	Ex.	2600 mm as exist. j.c.	Spot replacement to 095100	-	-	-	-
208	Small Meeting	CPTT1/CPT1	Γ2 New to 096800	RBC	New to 096800	New GWB	PT	New GWB	PT	New GWB	PT	New GWB	PT	All New to 099000	LAP	PRE	2600 mm	New to 092000 & 099000	-	-	-	-
209	HR Office	CPTT1	New to 096800	RBC	New to 096800	New GWB/ Demountable Screen(N.I.C)	PT	New GWB/ Interior Screen	PT	New GWB/ Demountable Screen(N.I.C)/ Ex. GWB	PT	New GWB/ Demountable Screen(N.I.C)	PT	All New to 099000	LAP	PRE	2600 mm	New tile to 095100	-	-	-	-
209A	HR Office Entry	CPTT1	New to 096800	RBC	New to 096800	New GWB	PT	-	-	-	-	-	-	All New to 099000	LAP	PRE	2600 mm	New tile to 095100	-	-	-	-
209B	HR Office Entry	CPTT1	New to 096800	RBC	New to 096800	-	-	-	-	New GWB	PT	-	-	All New to 099000	LAP	PRE	2600 mm	New tile to 095100	-	-	-	-
210	HR Office A	CPTT1/CPT1	Γ2 New to 096800	RBC	New to 096800	New GWB/ Demountable Screen(N.I.C)	PT	New GWB	PT	Ex. GWB	PT	New GWB	PT	All New to 099000	LAP	PRE	2600 mm	New tile to 095100	-	-	-	-
211	Manager's Office	CPTT1/CPT1	Γ2 New to 096800	RBC	New to 096800	New GWB	PT	New GWB/ Demountable Screen(N.I.C)	PT	Ex. GWB	PT	Ex. GWB	PT	All New to 099000	LAP	PRE	2600 mm	New tile to 095100	-	-	-	-
212	HR Office B	CPTT1/CPT1	Γ2 New to 096800	RBC	New to 096800	New GWB	PT	Demountable Screen(N.I.C)	PT	New GWB	PT	Ex. GWB	PT	All New to 099000	LAP	PRE	2600 mm	New tile to 095100	-	-	-	-
213	HR Office C	CPTT1/CPT1	Γ2 New to 096800	RBC	New to 096800	New GWB	PT	Demountable Screen(N.I.C)	PT	New GWB	PT	Ex. GWB	PT	All New to 099000	LAP	PRE	2600 mm	New tile to 095100	-	-	-	-
214	HR Office D	CPTT1/CPT1	Γ2 New to 096800	RBC	New to 096800	New GWB	PT	Demountable Screen(N.I.C)	PT	New GWB	PT	Ex. GWB	PT	All New to 099000	LAP	PRE	2600 mm	New tile to 095100	-	-	-	-
215	HR Office E	CPTT1/CPT1	Γ2 New to 096800	RBC	New to 096800	New GWB	PT	Demountable Screen(N.I.C)	PT	New GWB	PT	Ex. GWB	PT	All New to 099000	LAP	PRE	2600 mm	New tile to 095100	-	-	-	-
216	Director's Office	CPTT1/CPT1	Γ2 New to 096800	RBC	New to 096800	Ex. GWB	PT	New GWB	PT	New GWB/ Demountable Screen(N.I.C)	PT	Ex. GWB	PT	All New to 099000	LAP	PRE	2600 mm	New tile to 095100	-	-	-	-
217	HR Office F	CPTT1/CPT1	Γ2 New to 096800	RBC	New to 096800	Ex. GWB	PT	New GWB	PT	Demountable Screen(N.I.C)	PT	New GWB	PT	All New to 099000	LAP	PRE	2600 mm	New tile to 095100	-	-	-	-
218	HR Office G	CPTT1/CPT1	Γ2 New to 096800	RBC	New to 096800	Ex. GWB	PT	New GWB	PT	Demountable Screen(N.I.C)	PT	New GWB	PT	All New to 099000	LAP	PRE	2600 mm	New tile to 095100	-	-	-	-
219	Comm.'s Office	CPTT1/CPT1	Γ2 New to 096800	RBC	New to 096800	Ex. GWB	PT	New GWB	PT	New GWB/ Glazing(N.I.C)	PT	New GWB	PT	All New to 099000	LAP	PRE	2600 mm	New tile to 095100	-	-	-	-
220	Meeting Room	CPTT1/CPT1	Γ2 New to 096800	RBC	New to 096800	New GWB	PT	New GWB/ Interior Screen	PT	New GWB	PT	New GWB	PT	All New to 099000	LAP	PRE	2600 mm	New tile to 095100	-	-	-	-
221	Corridor	CPTT1	New to 096800	RBC	New to 096800	Interior Screen	PT	Ex. GWB/ New GWB/ Interior Screen	PT	Ex. GWB	PT	New GWB/ Interior Screen	PT	All New to 099000	LAP	PRE	2600 mm	New tile to 095100	-	-	-	-

Interior Finishing System:

Provcide all interior finishing work to meet requirements of Section 090500 Interior Finishing System, and Division 1. Consult the specification.

Provide all work to the requirements of individual sections of the specification for components of the INterior Finishing System, regardless of Division of the Specification.

Prrovide all supprt and framing (to 092000) for all substrates and partitions.

Provide all blocking and reinforcement within partitions and ceilings as required to support all further components of the Work and Owner equipment.

Ensure that Owner provides specific information regarding monitor brackets and other wall or ceiling mounted Owner equipment, and provide blocking / suupport to suit. Pay all costs for blocking and support work.

Bracing of Interior Partitions:

Provide all bracing of interior partitions that do not penetrate suspended ceilings. See Details on other Sheets.

Acoustic Seals and Treatments:

Provide all acoustic seals of interior partitions and acoustic insulation to above lay-in ceilings as required by details, typical to all interior partitions. See Details on other Sheets.

	end of Related Finish reviations:
A.F.F.M CBCCMUC CPTTT P FR FRS GWD LAPO LAPO LAPO LAPO LAPO LAPO LAPO PCT M RSS RSS TER VBC VWC VCT M RSS RSS TER VBC VWC	- above finished floor - aluminium - concrete block - ceiling - concrete masonry unit - concrete - carpet - carpet tile - ceramic tile - exposed structure - floor - fire resistance rating - fire separation - glass - gypsum wall board - hardwood - laminate - lay-in panel or lay-in acoustic tile - linoleum - lath and plaster - luxury vinyl tile - millwork - marble tile - not applicable - not in contract - open-web steel joist - precast concrete - porcelain ceramic tile - plastic laminate - plywood - paint - quarry tile - resilient flooring - rubber base cove - rubber stair landing tile - rubber stair riser - rubber stair tread - resilient sheet vinyl - sealed concrete - sheet vinyl - terrazzo - unfinished - vinyl base cove - vinyl composite tile - vinyl wall covering

General Notes to Room Finishes Schedule:

For Ceilings and Bulkheads see also Reflected Ceilings Plans.

Make good existing concrete floor prior to installing new partitions and flooring where existing walls or partitions are demolished.

Clean, repair and make good all walls after removal of existing wall finishes and all associated wall framing, in preparation for new wall finishes. Paint all new and existing walls.

Note that mechanical and electrical systems require cutting and patching and/or fishing within existing assemblies to accomplish the mechanical and electrical work. Make good all substrates and finishes to areas of such cutting and patching or fishing.

Room finishes schedule to be read in conjunction with interior elevations, section details and plan details.

Contractor provides all building systems component layout and interference drawings prior to layout of ceilings, to verify all heights and layout will be achieved. Trades do not lay out the Work.

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		Revision	Date	Initial
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	Roo	om Finishes	Schedi	ale

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No. Issued for Purpose Date Initial

1 90% Checkset for Review Feb. 7 '25 JHM
2 For Tender and Permit Mar. 21 '25 JHM

General Notes:

For General Notes and OBC Matrix see Sheet A001
For Removal Plan see Sheet A201
For 2nd Floor Fit-Up Plan see Sheet A211
For Plan Details see Sheet A212
For Section Details see Sheet A213
For 2nd Floor Partition Dimension Plan see Sheet A221
For 2nd Floor Floor Finishes Plan see Sheet A231
For Removal Reflected Ceiling Plan see Sheet A501
For Reflected Ceiling Plans see Sheet A511
For Millwork Details see Sheet A711
For Interior Elevations see A800 series Sheets
For Openings Schedules see Sheet A901
For Room Finishes Schedules see Sheet A911

For Mechanical Drawings see M series Sheets For Electrical Drawings see E series Sheets

This document is not to be scaled for

the relation of portions of the work are not immediately apparent, the reader shall not

specific purpose noted.

referenced therein.

proceed in uncertainty.

SALVAGE 15 BEST CONDITION METRIC (500x500) S/A DIFFUSERS (200Ø NECK). STORE ON SITE FOR POSSIBLE RE—INSTALLATION. 10 DIFFUSERS ARE REQUIRED. REFER TO M2 DRAWING FOR LOCATIONS. COORDINATE ON SITE. EXISTING HYDRONIC RISER EXISTING HYDRONIC EXISTING HYDRONIC EXISTING CONTROL VALVE. EXISTING HYDRONIC EXISTING CONTROL VALVE. EXISTING CONTROL VALVE. HEATING RAD VERIFY ON SITE. HEATING RAD VERIFY ON SITE. VERIFY ON SITE. HEATING RAD EXIST'G VAV BOX EXIST'G VAV BOX
TO REMAIN EXIST'G VAV BOX TO REMAIN H4 H4 EXIST'G VAV BOX TO REMAIN (H3) EXISTING HYDRONIC— HEATING RAD <u>\_\_\_</u> EXIST'G VAV BOX TO REMAIN EXIST'G DIFFUSER AND DUCTWORK TO BE REMOVED. CAP DUCT AS SHOWN, EXIST'G VAV BOX TO REMAIN EXISTING CONTROL VALVE.—/ VERIFY ON SITE. EXIST'G VAV BOX TO BE RELOCATED.

REFER TO M2 DRAWING EXIST'G VAV BOX
\_\_TO REMAIN \_\_\_\_\_\_ EXIST'G PORTION — OF DUCT TO REMAIN EXISTING TO REMAIN H3 | EXISTING HYDRONIC— HEATING RAD ∖ EXIST'G \_\_EXISTING HYDRONIC \_\_\_EXISTING HYDRONIC HEATING RAD VERIFY ON SITE.

GENERAL DEMOLITION NOTES

AS IF REPEATED ON THIS DRAWING SHEET.

FOR FURTHER MECHANICAL WORK RELATED TO REMOVALS, SEE ARCHITECTURAL DRAWINGS AND DIVISIONS 2 AND 20 SPECIFICATIONS. ALL SELECT DEMOLITION OF MECHANICAL IS INCLUDED IN THE WORK OF THE MECHANICAL TRADE CONTRACTOR

FOR FURTHER MECHANICAL WORK RELATED TO SPRINKLER AND FIRE SUPPRESSION, SEE ARCHITECTURAL DRAWINGS RCP AND DIVISION 21 OF THE SPECIFICATIONS. ALL SELECT DEMOLITION OF FIRE SUPPRESSION SYSTEMS IS

MECHANICAL TRADE CONTRACTOR SHALL COORDINATE ALL WORK WITHIN CEILINGS WITH THE GC AND FIRE SUPPRESSION TRADE CONTRACTOR.

INCLUDED IN THE WORK OF THE FIRE SUPPRESSION TRADE CONTRACTOR.

HVAC DEMOLITION NOTES

PLUMBING DEMOLITION NOTES

SUPERFLUOUS PIPING. FLOOR PATCHING BY G.C. COORDINATE ON SITE.

COORDINATE ON SITE.

P1) REMOVE EXISTING PLUMBING FIXTURE(S) COMPLETE. CAP SANITARY PIPING IN CEILING SPACE BELOW. CAP VENT PIPING IN SECOND FLOOR CEILING SPACE. REMOVE ALL

P2 REMOVE EXISTING ELECTRIC WATER HEATER (LOCATED IN CEILING SPACE). COMPLETE. REMOVE ALL SUPERFLUOUS PIPING. ELECTRICAL CONTRACTOR TO MAKE SAFE.

P3 REMOVE CW PIPING (IN CEILING SPACE) BACK TO APPROXIMATELY THIS LOCATION AND CAP. COORDINATE ON SITE.

H1 EXISTING WASHROOM EXHAUST TO BE REMOVED COMPLETE. CAP DUCT IN CEILING SPACE. COORDINATE ON SITE.

H2 EXISTING VAV BOX TO BE RELOCATED. REFER TO DRAWING M2. CAP EXISTING TAKEOFF AT MAIN. COORDINATE ON SITE.

H3 REMOVE EXISTING S/A DIFFUSER AND DUCT ROUNOUT. EXISTING TAKEOFF AND BALANCING DAMPER TO REMAIN. COORDINATE ON SITE.

H4 REMOVE EXISTING S/A DIFFUSER, DUCT ROUNOUT. TAKEOFF AND BALANCING DAMPER. PATCH VAV PLENUM DUCT. COORDINATE ON SITE.

H5 REMOVE EXISTING S/A DIFFUSER, DUCT ROUNOUT AND DUCTMAIN. COORDINATE ON SITE.

BAS CONTROLS NOTES

THE MECHANICAL TRADE CONTRACTOR AND ITS BAS TRADE CONTRACTOR SHALL PROVIDE ALL REMOVALS AND/OR TEMPORARY RELOCATIONS OF HVAC CONTROLS (SENSORS, THERMOSTATS, BAS DEVICES ETC.) AND RELATED WIRING IN ORDER TO FACILITATE THE ALTERATIONS AND CONSTRUCTION OF THE WORK. REVIEW THE EXISTING CONDITIONS AND INCLUDE FOR ALL SUCH WORK IN THE MECHANICAL PRICE. NOTE THAT THIS WORK MAY NOT BE FULLY INDICATED ON DRAWINGS AND TRADE CONTRACTORS SHALL INSPECT THE PLACE OF THE WORK AND INCLUDE FOR ALL RELEVANT CONTROLS WORK TO ACCOMPLISH THE WORK OF THIS CONTRACT.

THE BAS TRADE CONTRACTOR (JADE LOGIC) SHALL BE AS NOMINATED BY THE CITY, WORKING DIRECTLY IN SUBCONTRACT WITH THE MECHANICAL TRADE CONTRACTOR.

BAS TRADE CONTRACTOR (JADE LOGIC) IS TO PERFORM ALL CONTROLS WORK INCLUDING: REMOVALS, TEMPORARY RELOCATIONS, RELOCATIONS AND NEW WORK TO DEVICES, WIRING, ACCESSORIES, EQUIPMENT CONNECTIONS AND COMMISSIONING. BAS TRADE CONTRACTOR (JADE LOGIC) SHALL BID TO THE MECHANICAL TRADE BIDDERS AND SHALL INCLUDE ALL NECESSARY WORK TO CITY OF WATERLOO STANDARDS FOR THE EXISTING BAS SYSTEM AND POLICIES FOR CHANGES TO THIS SYSTEM.

ALL CONTROL WIRING FOR HVAC AND CONNECTIONS, WHETHER 120V OR LOW VOLTAGE IS THE RESPONSIBILITY OF THE MECHANICAL TRADE CONTRACTOR AND ITS SUBCONTRACTORS IN FULL.

MAR. 21/25 FOR PERMIT AND TENDER

FEB. 5/25 FOR REVIEW AND COORDINATION

DATE ISSUED/REVISIONS

M. A BRYAN

ENGINEERING INC.

285 WEBER ST. N., UNIT BI, WATERLOO, ON N2J 3H8

TEL: (519) 489-2674 E-MAIL: INFO@MABRYAN.COM

THE CONTRACTOR SHALL VERIFY ALL DIMENSIONS AND QUANTITIES ON SITE AND REPORT ANY DISCREPANCIES BEFORE COMMENCING OR PROCEEDING WITH ANY WORK.

DO NOT SCALE THIS DRAWING.

CITY OF WATERLOO

2ND FLOOR RENOVATIONS


100 REGINA ST. SOUTH, WATERLOO

MECHANICAL DEMO PLAN

SCALE: 1:50

DRAWN BY: MAB

PROJECT NO.: 2590

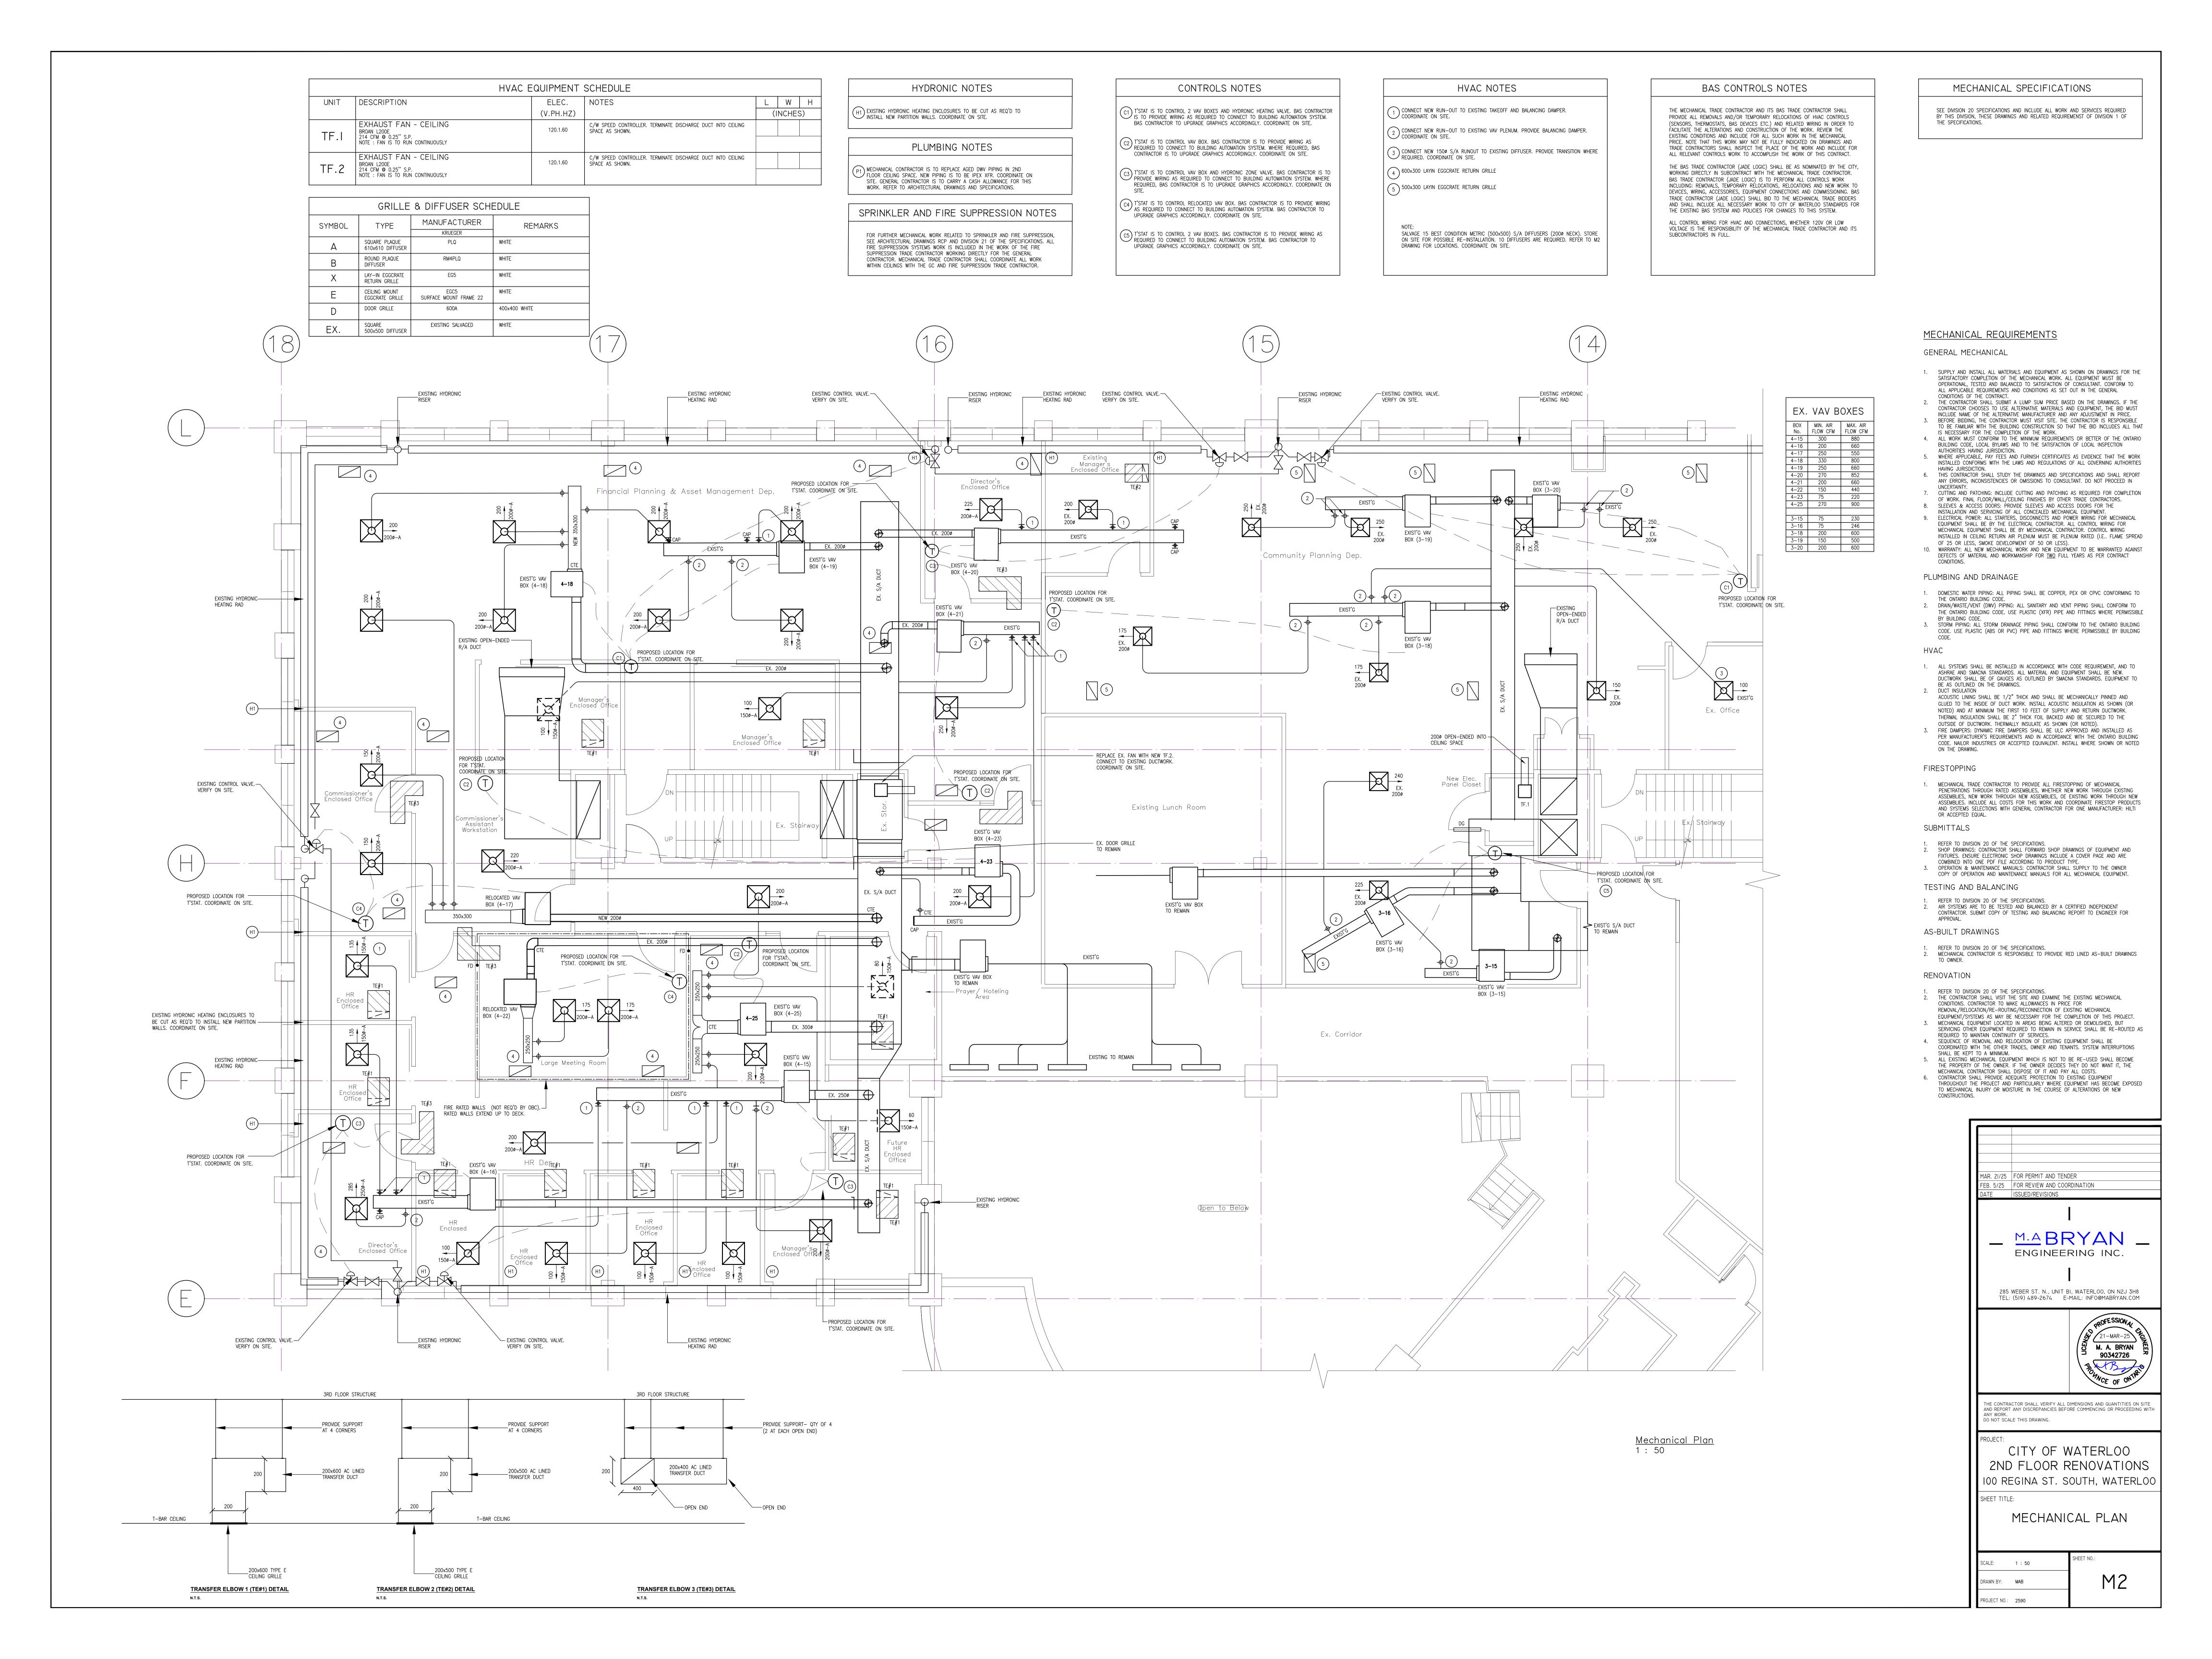

### ELECTRICAL ON DRAWING SPECIFICATION

### GENERAL

- 1.1. ALL GENERAL CONDITIONS OF THE CONTRACT ARE INCLUDED. SEE DIVISIONS 1, 26, 27, AND 28 OF THE SPECIFICATION.
- 1.2. ALL WORK SHALL BE IN FULL ACCORDANCE WITH THE REQUIREMENTS OF THE ONTARIO ELECTRICAL CODE, ELECTRICAL SAFETY AUTHORITY (ESA), AND THE LOCAL INSPECTION DEPARTMENT REQUIREMENTS.
- 1.3. THIS CONTRACTOR IS REQUIRED TO PAY ALL FEES TO THE ESA FOR FIELD INSPECTION. THIS CONTRACTOR SHALL MAINTAIN LIABILITY INSURANCE AS REQUIRED. 1.5. ALL WORKMANSHIP SHALL BE EXECUTED TO A STANDARD DETERMINED BY GOOD

PRACTICE. THE ELECTRICAL CONTRACTOR SHALL GUARANTEE THE INSTALLATION FOR

- TWO YEARS FROM SUBSTANTIAL COMPLETION. 1.6. THE ELECTRICAL CONTRACTOR SHALL SUBMIT ONE SET OF ELECTRONIC PDF SHOP DRAWINGS TO THE ARCHITECT. MATERIALS SHALL NOT BE ORDERED UNTIL REVIEW HAS BEEN COMPLETED. APPROVAL IS FOR GENERAL DESIGN AND ARRANGEMENT ONLY. 1.7. THE OWNERS RESERVE THE RIGHT TO ALTER THE LOCATION OF ANY ITEM UP TO TEN FEET (3m) WITHOUT INCURRING EXTRA COSTS, PROVIDED THE REQUEST IS MADE
- PRIOR TO INSTALLATION. 1.8. ALL MATERIAL AND EQUIPMENT USED ON THIS PROJECT SHALL BE C.S.A. APPROVED, ESA FIELD EVALUATED, OR MUST BEAR AN ESA RECOGNIZED CERTIFICATION MARK.
- ALL CUTTING AND PATCHING FOR ELECTRICAL WORK SHALL BE DONE BY THE GENERAL CONTRACTOR AT THE ELECTRICAL CONTRACTOR'S EXPENSE. 1.10. THE DRAWINGS AND SPECIFICATIONS SHALL BE READ IN CONJUNCTION WITH THE
- ARCHITECTURAL AND MECHANICAL DRAWINGS AND SPECIFICATIONS. ANY DISCREPANCIES OR CONTRADICTIONS SHALL BE BROUGHT TO THE CONSULTANT'S ATTENTION. 1.11. ALL TEMPORARY LIGHTING AND POWER DURING CONSTRUCTION SHALL BE BY THE
- GENERAL CONTRACTOR AFTER AGREEMENT WITH THE ELECTRICAL CONTRACTOR. POWER SHALL BE PROVIDED FROM PANELS WITH REQUIRED SUPPLY AND CAPACITY. 1.12. TENDER SHALL BE BASED UPON THE SPECIFIED EQUIPMENT AND MATERIAL. REQUESTS FOR CONSIDERATION OF ALTERNATES TO THE SPECIFIED MATERIALS SHALL BE MADE TO THE CONSULTANT ONE WEEK PRIOR TO TENDER CLOSING AND SHALL INCLUDE MANUFACTURER, MODEL, AND COST MODIFICATION. COSTS OF ANY CHANGE REQUIRED TO OTHER TRADES AS A RESULT OF USING ALTERNATE EQUIPMENT ARE TO BE
- INCURRED BY THE ELECTRICAL CONTRACTOR. 1.13. ALL CLAIMS FOR EXTRA WORK NOT COVERED IN THE CONTRACT TO BE SUBMITTED WITH A COMPLETE BREAKDOWN OF MATERIAL AND LABOUR.
- 1.14. DO NOT SCALE THESE DRAWINGS. ALL DIMENSIONS ARE TO BE TAKEN FROM THE ARCHITECTURAL DRAWINGS AND CONFIRMED ON SITE.
- 1.15. ALL OVERTIME WORK SHALL BE CARRIED OUT WITH NO ADDITIONAL COST TO THE
- 1.16. PROVIDE FIRE STOPPING PROTECTION FOR OPENINGS THROUGH FIRE RATED WALLS, FLOORS AND ROOF. U.L.C. LISTED ASSEMBLY NUMBERS ARE TO BE USED.

## 2. ELECTRICAL EQUIPMENT

- 2.1. ALL BRANCH CIRCUIT WIRING SHALL BE RUN IN ELECTRICAL METALLIC TUBING (E.M.T.) OR FLEXIBLE ARMOURED CABLE (AC90) RECESSED IN WALLS OR CEILINGS EXCEPT WHERE SPECIFICALLY NOTED ON THE PLANS. NO WIRING SMALLER THAN #12 GAUGE SHALL BE USED. ALL WIRING TO BE COPPER.
- 2.2. ALL SURFACE WIRING SHALL BE T90 COPPER IN EMT CONDUIT WHERE WIRING AND CONDUIT CANNOT BE RECESSED.
- THE ELECTRICAL SERVICE EQUIPMENT, EACH METALLIC PIPING SYSTEM, AND EACH CONDUIT SYSTEM SHALL BE PERMANENTLY AND EFFECTIVELY GROUNDED/BONDED IN
- ACCORDANCE WITH THE ONTARIO ELECTRICAL SAFETY CODE 2.4. ALL ELECTRICAL PANELS TO HAVE BOLT-ON BREAKERS AND LOCKABLE DOORS. 2.5. ALL ELECTRICAL DISTRIBUTION EQUIPMENT MUST BE PROPERLY IDENTIFIED WITH
- LAMACOID NAME PLATES SCREWED ON EQUIPMENT. PANELS ARE TO HAVE TYPED DIRECTORIES. DISCONNECTS ARE TO HAVE MAXIMUM FUSE RATINGS INDICATED. 2.6. THE ELECTRICAL CONTRACTOR SHALL SUPPLY ALL LABOUR AND MATERIALS TO PROVIDE
- ELECTRIC SERVICE COMPLETE WITH FEEDERS AND BRANCH CIRCUITS ALL AS SHOWN 2.7. EXTRA CHARGES FOR PREMIUM TIME LABOUR SHALL BE INCLUDED IN THE TENDER
- PRICE. ALLOWING FOR AFTER HOURS. WEEKEND AND HOLIDAY LABOUR REQUIREMENTS. ALL JUNCTION AND PULLING BOXES ARE TO BE ACCESSIBLE AND BE PROVIDED WITH

1100mm

400mm

400mm

2300mm

2300mm

1200mm

1700mm

1200mm

1000mm

1000mm

- SCREWED PLATES COLOUR MATCHED TO ADJACENT WALL OR CEILING FINISHES. 2.9. PULL BOXES SHALL BE PROVIDED EVERY 30m AND EVERY TWO 90° BENDS.
- 2.10. ALL WIRING SHALL BE PARALLEL WITH ARCHITECTURAL LINES AND DESIGN. 2.11. PROVIDE A PULL STRING IN ALL EMPTY CONDUIT.
- 2.12. FLEXIBLE CONDUIT SHALL BE USED FOR FIXTURE AND EQUIPMENT CONNECTIONS. 2.13. ALL NEW SWITCH AND RECEPTACLE PLATES SHALL BE WHITE. ALL DEVICES TO BE COMMERCIAL GRADE DECORA SERIES. DEVICES AND COVER PLATES ARE TO MATCH
- EXISTING STYLE FOR RENOVATED AREAS. 2.14. ALL CONTROLLED RECEPTACLES SHALL BE PERMANENTLY MARKED TO VISUALLY
- DIFFERENTIATE THEM FROM UNCONTROLLED RECEPTACLES. 2.15. DEVICE MOUNTING HEIGHT TO CENTRE OF DEVICE IS AS FOLLOWS:
  - 2.15.1. LIGHT SWITCHES 2.15.2. RECEPTACLE 2.15.3. TELEPHONE OUTLETS
  - 2.15.4. FIRE ALARM HORN 2.15.5. FIRE ALARM STROBE
  - 2.15.6. MANUAL STATION 2.15.7. END OF LINE RESISTORS 2.15.8. THERMOSTATS
- 2.15.9. POWER DOOR OPERATORS 2.15.10. OTHER BUILDING CONTROLS

## ALL AUDIBLE FIRE ALARM DEVICES MUST BE AT LEAST 150mm BELOW CEILING. 2.16. DO NOT MOUNT WALL OUTLETS BACK TO BACK IN WALLS, STAGGER TO PREVENT

- SOUND TRANSFER. 2.17. ALL RECEPTACLES LOCATED WITHIN 1500mm OF A SINK ARE TO BE PROVIDED WITH
- AN INTEGRAL CLASS A GROUND FAULT CIRCUIT INTERRUPTER. 2.18. WIRING TO FIXTURES IN SUSPENDED CEILINGS IS TO CONSIST OF AC90 'DROPS' WITH A MAXIMUM LENGTH OF 4.5m (15 FT) AND T90 WIRING IN EMT CONDUIT BACK TO
- SOURCE PANEL 2.19. ALL CONDUITS AND CABLES TO BE SECURELY FASTENED WITH APPROVED CLIPS AND
- SCREWS. NAILS OR TIE WIRES ARE NOT ACCEPTABLE. 2.20. ALL ELECTRICAL EQUIPMENT, DEVICES, AND WIRING ARE TO BE INDEPENDENTLY SUPPORTED. KEEP CLEAR OF MECHANICAL PIPING WHERE POSSIBLE.
- 2.21. WIRING FOR MECHANICAL EQUIPMENT SHALL BE AS DETAILED ON THE PLANS. 2.22. THE ELECTRICAL CONTRACTOR IS TO PROVIDE 21mm (3/4") CONDUIT RACEWAY BETWEEN MECHANICAL EQUIPMENT AND CONTROLS AS PÉR MECHANICAL AND ELECTRICAL PLANS.

## 3.1. ELECTRICAL CONTRACTOR SHALL INSTALL ALL FIXTURES AND LAMPS AS PER THE

- MANUFACTURERS SPECIFICATIONS. ALL LED LAMPS ARE TO HAVE A COLOUR TEMPERATURE OF 3500K UNLESS OTHERWISE
- 3.3. INSTALL ALL FIXTURES PARALLEL WITH BUILDING LINES UNLESS INDICATED OTHERWISE.
- 3.4. EXIT FIXTURES ARE TO BE PROVIDED WITH GRAPHICAL SYMBOLS INDICATING THE PATH OF EGRESS FROM THE BUILDING.
- 3.5. PROVIDE SAFETY 'JACK CHAIN' ON ALL FIXTURES WITHIN SUSPENDED CEILINGS. 3.6. INSTALL A SEPARATE NEUTRAL CONDUCTOR TO EACH BRANCH CIRCUIT FEEDING LIGHT
- 3.7. THE ELECTRICAL CONTRACTOR SHALL SUPPLY AND INSTALL LIGHTING FIXTURES AS NOTED ON THE PLANS.
- 3.8. THE ELECTRICAL CONTRACTOR SHALL SUPPLY AND INSTALL A DC BATTERY LIGHTING SYSTEM AS INDICATED ON THE PLANS. THE BATTERY UNIT SHALL BE PROVIDED WITH SEALED LONG LIFE BATTERIES.
- 3.9. EMERGENCY LIGHTING FIXTURES ARE TO BE SUPPLIED WITH MINIMUM 4W LED MR16 LAMPS UNLESS LISTED OTHERWISE.

## 4. COMMUNICATION EQUIPMENT

- 4.1. THE ELECTRICAL CONTRACTOR IS TO PROVIDE ALL MATERIALS AND LABOUR FOR A COMPLETE EMPTY CONDUIT SYSTEM FOR COMMUNICATION OUTLETS AS SHOWN ON THE 4.2. PROVIDE 21mm (3/4") CONDUIT TO EACH OUTLET FROM COMMUNICATION BACKBOARD
- C/W NYLON PULL STRING IN ALL EMPTY CONDUITS. 4.3. COMMUNICATION BACKBOARD TO BE PLYWOOD, 21mm (3/4") THICK, WITH FIRE-RETARDANT PAINT AND #6 GREEN INSULATED GROUND WIRE TO MAIN BUILDING
- 4.4. LIGHTING CONTROL WIRING IS TO BE PLENUM RATED (FT6). LIGHTING CONTROL WIRING THAT RUNS IN A SHARED RACEWAY IS TO BE AN APPROVED BUNDLED CABLE

### 5. FIRE ALARM

- 5.1. WHERE EXISTING, UNLESS NOTED OTHERWISE, FIRE ALARM TO BE KEPT. THE ELECTRICAL CONTRACTOR TO INCLUDE ALL COSTS ASSOCIATED WITH RELOCATION OF
- 5.2. ALL REQUIRED WORK RELATED COMMISSIONING OF LIFE SAFETY SYSTEMS SHALL BE DONE AT NO ADDITIONAL COSTS. RETAIN THE SYSTEM MANUFACTURER'S FORCES TO PERFORM THE FINAL CONNECTIONS, MODIFICATIONS, AND PROVISION OF NEW INTERFACING DEVICES. ETC
- 5.3. THE ELECTRICAL CONTRACTOR IS TO ENSURE THAT ALL NEW LIFE SAFETY DEVICES ARE FULLY COMPATIBLE WITH EXISTING SYSTEM. EXISTING SYSTEM IS NOTIFIER BY
- 5.4. FIRE ALARM HORNS AND HORN-STROBES ARE TO HAVE ADJUSTABLE AUDIBLE OUTPUT. 5.5. THE ELECTRICAL CONTRACTOR IS TO HAVE THE SYSTEM MANUFACTURER TEST AND CERTIFY THE LIFE SAFETY SYSTEM FOR PROPER OPERATION AT THE COMPLETION OF
- 5.6. FIRE ALARM SYSTEM TO BE INSTALLED IN CONFORMANCE WITH CAN/ULC-S524-M, "INSTALLATION OF FIRE ALARM SYSTEMS".
- 5.7. FIRE ALARM SYSTEM TO BE VERIFIED IN CONFORMANCE WITH CAN/ULC-S537-M, "VERIFICATION OF FIRE ALARM SYSTEMS", TO ENSURE SATISFACTORY OPERATION.

## 6. EXISTING CONDITIONS

- 6.1. THE CONTRACTOR SHALL VISIT THE SITE AND EXAMINE THE EXISTING CONDITIONS AND THEN MAKE NECESSARY ALLOWANCES IN HIS TENDER PRICE FOR REMOVAL, RELOCATION, REROUTING AND/OR RECONNECTION OF EXISTING ELECTRICAL EQUIPMENT AND WIRING, AS MAY BE NECESSARY FOR THE EXECUTION AND COMPLETION OF THIS
- 6.2. ELECTRICAL WORK AFFECTING OTHER SPACES IS TO BE PERFORMED AFTER BUSINESS HOURS (EVENINGS AND WEEKENDS). COORDINATE WITH OWNER. 6.3. SERVICE AND DISTRIBUTION SYSTEM POWER INTERRUPTIONS SHALL BE KEPT TO A
- MINIMUM. POWER INTERRUPTIONS MUST BE COORDINATED WITH THE OWNER AND ALL OTHER TRADES BY THIS CONTRACTOR. WRITTEN APPROVAL FOR ELECTRICAL INTERRUPTIONS MUST BE RECEIVED FROM THE OWNER INDICATING THE DATE, TIME AND ESTIMATED DURATION OF THE INTERRUPTION. APPLICATION FOR APPROVAL OF THE POWER INTERRUPTIONS MUST BE SUBMITTED TO THE OWNERS AND/OR ARCHITECTS AT LEAST TWO WEEKS PRIOR TO THE REQUESTED SHUTDOWN DATE.
- 6.4. EXISTING ELECTRICAL EQUIPMENT, REMOVED AND INDICATED FOR REUSE, SHALL BE CLEANED, REPAIRED AND REPAINTED (IF REQUIRED) BEFORE RE-INSTALLATION. 6.5. WIRING LOCATED IN AREAS BEING ALTERED OR DEMOLISHED, BUT FEEDING OUTLETS OR
- EQUIPMENT REQUIRED TO REMAIN IN SERVICE, MUST BE REWORKED IN ORDER TO MAINTAIN THE CONTINUITY OF THESE SERVICES.
- 6.6. REPAIRS TO EXISTING WALLS, FLOORS, AND CEILINGS ARE TO BE PERFORMED BY THE GENERAL CONTRACTOR TO MEET THE EXISTING CONDITIONS. 6.7. SEQUENCE OF REMOVAL AND RELOCATION OF EXISTING EQUIPMENT AND WIRING SHALL
- BE COORDINATED WITH THE OTHER TRADES AND SHALL CONFORM TO THE REQUIREMENTS AND CONDITIONS OUTLINED. 6.8. THE CONTRACTOR SHALL PROVIDE ADEQUATE PROTECTION TO EXISTING WIRING AND EQUIPMENT THROUGHOUT THE PROJECT, PARTICULARLY WHERE WIRING AND ELECTRICAL EQUIPMENT HAVE BECOME EXPOSED TO MECHANICAL DAMAGE OR MOISTURE IN THE
- COURSE OF ALTERATIONS OR NEW CONSTRUCTION. 6.9. IN SOME INSTANCES, NEW OUTLETS AND EQUIPMENT ARE SHOWN IN THE SAME LOCATION AS EXISTING OUTLETS. THESE MAY BE FED THROUGH THE EXISTING CONDUITS PROVIDED THAT THE CONDUITS AND WIRING ARE IN GOOD CONDITION AND ARE ACCEPTABLE TO THE ESA INSPECTION DEPARTMENT AS REUSABLE. ALL UNUSED CONDUIT ENTRANCE OPENINGS SHALL BE SEALED.

- 7.1. ALL EXISTING ELECTRICAL EQUIPMENT, WIRING, DATA CABLING, AND ROUGH-IN DEVICES ARE TO BE REMOVED COMPLETE TO SUIT THE DEMOLITION AND RENOVATION OF THE SPACES. ALL EXISTING ELECTRICAL EQUIPMENT, WHICH IS NOT BEING REUSED, SHALL BECOME THE PROPERTY OF THE OWNER. IF THE OWNER DECIDES THAT HE DOES NOT WANT IT, THE ELECTRICAL CONTRACTOR WILL BE RESPONSIBLE FOR DISPOSING OF IT. 7.2. REMOVE AND TRANSPORT FROM THE CONSTRUCTION SITE ALL EQUIPMENT MADE OBSOLETE CONSECUTIVE TO THE WORK.
- 8.1. ELECTRICAL CONTRACTOR TO SUBMIT FIRE ALARM SYSTEM VERIFICATION AND TESTING REPORTS (INCLUDING DEVICE REPORT): FIRE ALARM MONITORING CERTIFICATION: ESA CERTIFICATE OF INSPECTIONS; AND SIGNED COPY OF EMERGENCY LIGHTING TEST
- 8.2. EMERGENCY LIGHTING TEST REPORT TO PROVIDE WRITTEN VERIFICATION THAT THE EMERGENCY LIGHTING WAS TESTED TO DETERMINE THE RUNTIME OF THE LIGHTING WHEN NORMAL POWER IS LOST
- 8.3. ELECTRICAL CONTRACTOR TO PROVIDE TRAINING SESSIONS TO THE OWNER ON ALL MAJOR ELECTRICAL SYSTEMS INCLUDING FIRE ALARM AND LIGHTING CONTROLS.
- ELECTRICAL CONTRACTOR IS TO PROVIDE RECORD DRAWINGS OF ACTUAL INSTALLATION TO OWNERS WITHIN 30 DAYS OF PROJECT COMPLETION. DRAWINGS ARE TO INCLUDE SINGLE LINE DIAGRAM OF DISTRIBUTION SYSTEM AND FLOOR PLANS SHOWING THE LOCATION OF DISTRIBUTION EQUIPMENT AND THE AREAS SERVED BY THAT EQUIPMENT. 8.5. ELECTRICAL CONTRACTOR IS TO PROVIDE OPERATION AND MAINTENANCE MANUALS OF
- ELECTRICAL DISTRIBUTION SYSTEM TO OWNERS. THE MANUAL MUST INCLUDE EQUIPMENT NAMEPLATE RATINGS, INSTALLED OPTIONS AND ACCESSORIES, REQUIRED MAINTENANCE PROCEDURES (ROUTINE AND OTHERWISE), NAMES AND ADDRESSES OF AT LEAST ONE QUALIFIED SERVICE AGENCY, AND A CLEAR INDICATION OF THE PURPOSE AND OPERATION OF EACH PIECE OF EQUIPMENT (INDIVIDUALLY AND AS A SYSTEM).
- 8.6. AFTER COMPLETION OF WORK REMOVE ALL DEBRIS AND WASTE. RELAMP ALL BULBS THAT ARE BURNT OUT OR BEYOND 30% OF RATED LIFE.
- 8.7. ALL MAJOR SYSTEMS TO BE COMMISSIONED BY MANUFACTURERS REPRESENTATIVE INCLUDING FIRE ALARM AND LIGHTING CONTROL SYSTEMS.
- 8.8. LIGHTING CONTROL SYSTEM TESTING IS TO INCLUDE OCCUPANCY SENSOR PLACEMENT, SENSITIVITY, AND CONTROL SETTING CALIBRATION, PROPERLY OPERATING OCCUPANCY SENSORS ARE TO TURN OFF LIGHTS WITHIN A REASONABLE PERIOD OF TIME IN UNOCCUPIED SPACES AND SHALL NOT TURN LIGHTS ON UNLESS A SPACE IS OCCUPIED. ALL LIGHTING CONTROL SYSTEM TESTING IS TO BE PERFORMED BY MANUFACTURERS REPRESENTATIVE AT ELECTRICIAN'S EXPENSE. TESTING CERTIFICATION IS TO BE INCLUDED IN CLOSE-OUT DOCUMENTS.

## 9. INSPECTIONS BY CONSULTANT


- 9.1. CONTRACTOR TO CONTACT CONSULTANTS OFFICE TO NOTIFY WHEN INSPECTIONS ARE REQUIRED. ALLOW FOR MINIMUM THREE BUSINESS DAYS OF NOTICE PRIOR TO
- 9.2. INSPECTIONS ARE REQUIRED AT THE FOLLOWING MILESTONES: 9.2.1. FINAL INSPECTION

- A. ELECTRICAL TRADE CONTRACTOR PROVIDES ALL FIRESTOPPING OF ELECTRICAL PENETRATIONS THROUGH RATED ASSEMBLIES, WHETHER NEW WORK THROUGH EXISTING ASSEMBLIES. NEW WORK THROUGH NEW ASSEMBLIES, OR EXISTING WORK THROUGH NEW ASSEMBLIES. PAY ALL COSTS FOR THIS WORK AND COORDINATE FIRESTOP PRODUCTS AND SYSTEMS SELECTIONS WITH THE GENERAL CONTRACTOR FOR ONE MANUFACTURE, HILTI OR ACCEPTED
- FOR FURTHER ELECTRICAL WORK RELATED TO REMOVALS. SEE ARCHITECTURAL DRAWINGS. ALL SELECT DEMOLITION OF ELECTRICAL IS INCLUDED IN THE WORK OF THE ELECTRICAL TRADE CONTRACTOR AS IF REPEATED ON THIS DRAWING SET.
- . IN ADDITION TO THESE REQUIREMENTS, THE ELECTRICAL TRADE CONTRACTOR SHALL PERFORM ALL WORK IN ACCORDANCE WITH DIVISIONS 1, 26, 27, AND 28 OF THE SPECIFICATION.

## ELECTRICAL LEGEND LIGHT FIXTURE ( z = TYPE AS PER SCHEDULE NIGHT LIGHT FIXTURE ( z = TYPE AS PER SCHEDULE LIGHT FIXTURE ( z = TYPE AS PER SCHEDULE ) NIGHT LIGHT FIXTURE ( z = TYPE AS PER SCHEDULE CEILING MOUNTED EXIT LIGHT ( SHADED PORTION INDICATES FACE ) WALL MOUNTED EXIT LIGHT ( SHADED PORTION INDICATES FACE ) DIRECTIONAL EXIT LIGHT ( SHADED PORTION INDICATES FACE ) COMBINATION EXIT LIGHT/EMERGENCY LIGHT EMERGENCY BATTERY UNIT REMOTE EMERGENCY LIGHTING HEADS ( SINGLE OR DOUBLE AS SHOWN ) DUPLEX RECEPTACLE $\ominus$ DUPLEX RECEPTACLE ( 102mm ABOVE COUNTER BACKSPLASH, OR AS SHOWN ) 20A T-SLOT RECEPTACLE 20A T-SLOT RECEPTACLE ( 102mm ABOVE COUNTER BACKSPLASH QUAD RECEPTACLE DIRECT WIRED CONNECTION TOGGLE SWITCH ( 3.4 = 3 OR 4 WAY, K = KEY OPERATED DIMMER SWITCH LIGHTING CONTROL SENSOR ( z = TYPE AS PER SCHEDULE ) COMBINATION VOICE/DATA OUTLET PUSHBUTTON CR CARD READER POWER PANEL MANUAL PULL STATION FIRE ALARM HORN/STROBE COMBINATION UNIT ( zz = CANDELA POWER ) GROUND FAULT PROTECTION 15A DUPLEX REC W/DUAL USB CHARGER FLOOR MOUNTED CEILING MOUNTED EXISTING TO REMAIN RELOCATED EXISTING DEVICE EXISTING DEVICE TO BE REMOVED EXISTING DEVICE TO BE REMOVED AND REPLACED SYSTEM FURNITURE BASE POWER FEED J-HOOK EMPTY CONDUIT STUBBED & CAPPED FOR FUTURE USE





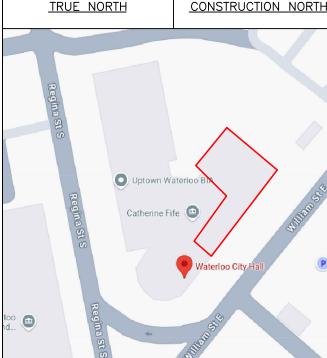



3 | ISSUED FOR PERMIT & TENDER | 2025.03.21 ISSUED FOR PERMIT & TENDER | 2025.03.11 ISSUED FOR REVIEW REVISION DATE

# ENGINEERING


493 LANCASTER ST W, UNIT 204 PH (519) 745-3703 KITCHENER, ON N2K 1L8 WEB www.mighton.com

WATERLOO CITY HALL 2ND FLOOR RENOVATION


150 FREDERICK WATERLOO, ONTARIO DRAWING TITLE:

## ELECTRICAL SCHEDULES & SPECIFICATIONS

DRAWN BY: MOD	CUSTOMER PROJECT No.
CHECKED BY: MRJ	MIGHTON PROJECT No. 44555
DATE: JANUARY 2025	DRAWING No.
SCALE N.T.S.	

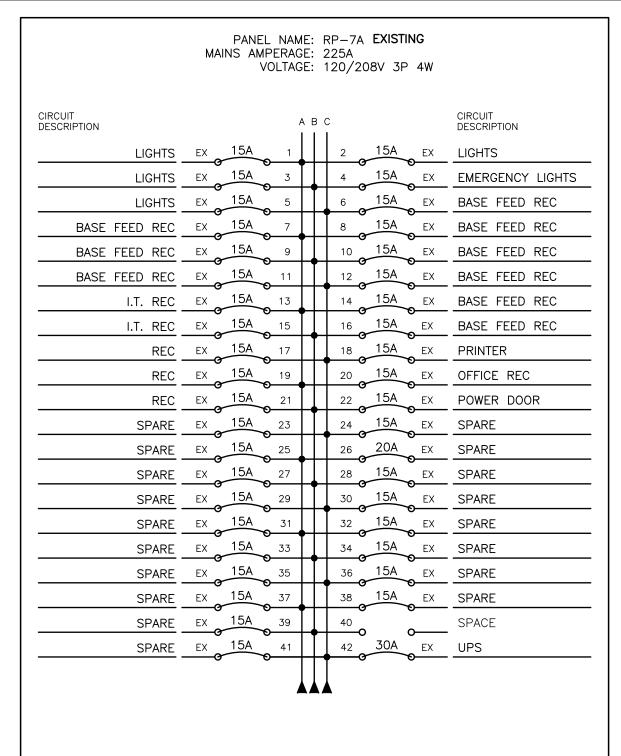

CIRCUIT DESCRIPTION				А В	С			CIRCUIT DESCRIPTION
SPACE			1		2	15A	EX	LIGHTS
LIGHTS	EX	15A		•+	4	15A	EX	LIGHTS
LIGHTS	EX	15A	5 5	╁	6	15A	9—— EX	LIGHTS
LIGHTS	EX	15A	7 7		8	15A	9—— EX	LIGHTS
LIGHTS	EX	15A	9 9	•	10	15A	9—— EX	LIGHTS
LIGHTS	EX	15A	9—— 11	+	12	15A	9—— EX	BASE FEED REC
BASE FEED REC	EX	15A	13	H	14	15A	9—— EX	BASE FEED REC
BASE FEED REC	EX	15A	15	•	16	15A	<b>Э</b> ——	BASE FEED REC
BASE FEED REC	EX	15A	17	╁	18	15A	<b>9</b> ——	BASE FEED REC
FLOOR BOX	EX	15A	19	T	20	15A	<b>9</b> EX	BASE FEED REC
FLOOR BOX	EX	1 <u>5</u> A	21	•	22	1 <u>5</u> A	<b>9</b> EX	BASE FEED REC
FLOOR BOX	EX	15A	23	†	24	15A	9 EX	OFFICE REC
OFFICE REC	EX	15A	<b>)</b> 25		26	15A	<b>9</b> EX	OFFICE REC
OFFICE REC	EX	15A	<b>&gt;</b> ——← 27	•	28	15A	<b>9</b> ——	OFFICE REC
COFFEE STATION REC	EX	20A	29		30		•—	SPACE
OFFICE REC	EX	15A	31		32	15A	EX	- REC
OFFICE REC	EX	15A	33		34		•	SPACE
OFFICE REC	EX	15A	35		36	15A	S EX	REC
OFFICE REC	EX	15A	37	П	38	15A	EX	REC
OFFICE REC	EX	15A	39		40	15A	EX	FLOOR BOX
OFFICE REC	EX	15A	41		42	15A	EX	MEETING ROOM REC
OFFICE REC	EX	15A	43	П	44	15A	EX	MEETING ROOM REC
OFFICE REC	EX	15A	45		46	15A	EX	REC
OFFICE REC	EX	15A	47		48	15A	EX	PRAYER ROOM REC
PRINTER	EX	15A	49		50	15A	EX	POWER DOOR
REC	EX	15A	51		52	15A	EX	POWER DOOR
COFFEE STATION	EX	20A	53		54	20A	EX	SPARE
SPARE	EX	20A	55	$\prod$	56	20A	EX	SPARE
SPARE	EX	20A	57		58	20A	EX	SPARE
SPARE	EX	20A	_ 59		60	20A	EX	SPARE

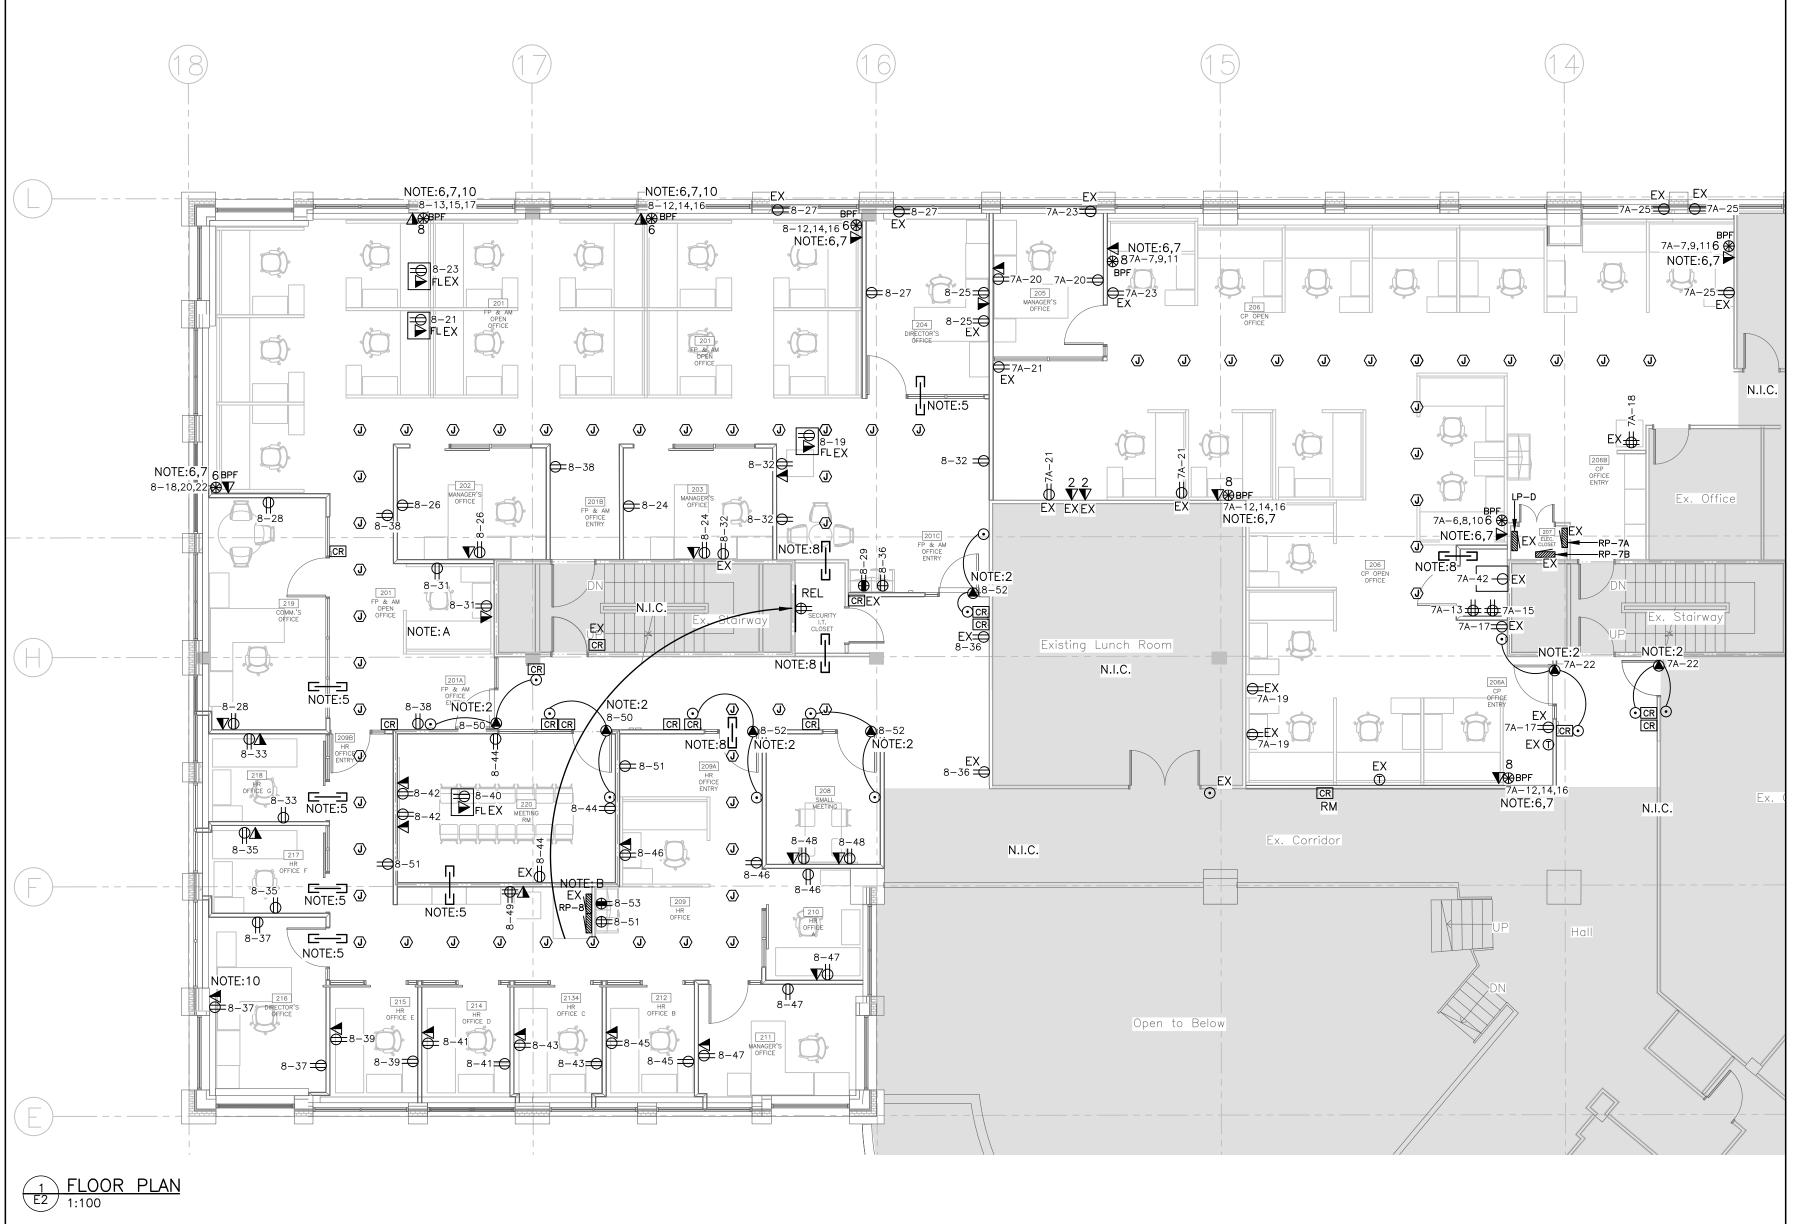

## NOTES:

- A. PERFORM ALL ELECTRICAL REMOVALS ASSOCIATED WITH EXISTING HOT WATER HEATER AND EXHAUST FAN IN THIS LOCATION.

  B. PERFORM ALL ELECTRICAL AND LV REMOVALS ASSOCIATED WITH EXISTING
- I.T., DATACOM, AND TELECOM IN THIS LOCATION.

  C. ALL EXISTING PANELBOARDS MUST REMAIN OPERATIONAL AT ALL NORMAL WORKING HOURS OF THE FACILITY. PERFORM ALL WORK TO PANELBOARDS OUTSIDE OF NORMAL CITY HALL WORKING HOURS BY ARRANGEMENT WITH THE OWNER, AND PAY ALL COSTS FOR THIS WORK AND MULTIPLE MOBILIZATIONS THAT MAY BE REQUIRED.
- D. FOR FURTHER ELECTRICAL WORK RELATED TO REMOVALS, SEE
  ARCHITECTURAL DRAWINGS. ALL SELECT DEMOLITION OF ELECTRICAL IS
  INCLUDED IN THE WORK OF THE ELECTRICAL TRADE CONTRACTOR AS IF
  REPEATED ON THIS DRAWING SET.

## POWER & SYSTEMS NOTES:

- GANG ALL SWITCH—HEIGHT RECEPTACLES AND MOTOR RATED SWITCHES LOCATED AT LATCH SIDE OF DOOR WITH LIGHT SWITCH.
- CONTRACTOR IS TO PROVIDE 16mm CONDUIT BETWEEN PUSHBUTTONS AND DOOR OPERATOR AND PROVIDE NOTED POWER CONNECTION TO OPERATOR. COORDINATE WITH SHOP DRAWINGS AND DOOR HARDWARE SUPPLIER PRIOR TO ROUGH—IN.
- WALL MOUNT CABLE MANAGEMENT HANGERS 100mm ABOVE FINISHED CEILING WHERE POSSIBLE. IN LOCATIONS WHERE WALL IS NOT AVAILABLE FOR MOUNTING, SUSPEND ON 6mm THREADED ROD. SPACE EVERY 4'.
   EXISTING FLOOR BOXES TO REMAIN.
- 5. PROVIDE 1" CONDUIT SLEEVE THROUGH WALL ABOVE CEILING.
- 6. AT NOTED BASE FEED POINTS FOR SYSTEMS FURNITURE PROVIDE 21mm (3/4") CONDUIT FROM BASE FEED FOR POWER CONNECTION TO PANEL. PROVIDE A 100mm (4") SQUARE OUTLET BOX 300mm (12") FROM FINISH FLOOR C/W 90° CONNECTOR FOR 16mm (1/2") LIQUID TIGHT FLEXIBLE CONDUIT WHIP SUPPLIED BY SYSTEMS FURNITURE MANUFACTURER. COORDINATE ON SITE PRIOR TO ROUGH—IN.
- 7. AT NOTED BASE FEED POINTS PROVIDE CONDUIT, SIZED TO SUIT THE NUMBER OF CABLES AS NOTED, FROM DOUBLE—GANG OUTLET BOX TO NEAREST ACCESSIBLE CEILING SPACE FOR DATA CABLES.
- 8. PROVIDE THREE 2" CONDUIT SLEEVES THROUGH WALL ABOVE CEILING.
- 9. ALL NEW DEVICES ARE TO BE FISHED WITHIN EXISTING WALLS.
- 10. NOTED LOCATIONS ARE IN PERIMETER WALLS THAT CURRENTLY HAVE NO POWER OR DATA. WORK TO INCLUDE OPENING UP WALLS FROM NEW DEVICES TO ACCESIBLE CEILING SPACE ABOVE. WALLS TO BE REBUILT TO MEET EXISTING CONDITIONS INCLUDING PAINT, DRYWALL, INSULATION, AND VAPOUR BARRIER.
- 11. PROVIDE NEW BREAKERS COMPATIBLE WITH EXISTING 225A 120/208V 3¢ 4W ELECTRICAL PANEL TO FEED NEW DEVICES. EXISTING BREAKERS MAY BE RE-USED TO FEED NEW DEVICES WHERE THEY ARE MADE SPARE AS A RESULT OF DEMOLITION. CIRCUITS SHOWN ARE USED TO DENOTE GROUPING OF DEVICES ON BREAKERS AND NOT THE BREAKER NUMBER. PROVIDE TYPED PANEL SCHEDULES AND AS BUILT PLANS CLEARLY INDICATING THE BREAKER FEEDING EACH DEVICE. DEVICES IN EXISTING SPACES TO REMAIN ARE TO BE RE-FED WHERE REQUIRED TO MAINTAIN OPERATION.









4 | 3 | ISSUED FOR PERMIT & TENDER | 2025.03.21 | 2 | ISSUED FOR PERMIT & TENDER | 2025.03.11 | 1 | ISSUED FOR REVIEW | 2025.02.05 | No | REVISION | DATE

# MIGHTON

493 LANCASTER ST W, UNIT 204 PH (519) 745-3703 KITCHENER, ON N2K 1L8 WEB www.mighton.com

WATERLOO CITY HALL 2ND FLOOR RENOVATION 150 FREDERICK WATERLOO, ONTARIO

## DRAWING TITLE: ELECTRICAL POWER PLAN

DRAWN BY: MOD	CUSTOMER PROJECT No.
CHECKED BY: MRJ	MIGHTON PROJECT No. 44555
DATE: JANUARY 2025 SCALE	DRAWING No.
1:100	


## LIGHTING & LIFE SAFETY NOTES:

- CONNECT ALL EMERGENCY FIXTURES TO LINE SIDE OF LOCAL LIGHTING
- 2. CONNECT FIRE ALARM SIGNALLING DEVICES TO LOCAL SIGNAL CIRCUIT. ALL WIRING MUST BE SUPERVISED.
- 3. CONNECT FIRE ALARM INITIATING DEVICES TO LOCAL INITIATING CIRCUIT. ALL WIRING MUST BE SUPERVISED.
- 4. PROVIDE AND INSTALL THREE ADDITIONAL EXIT SIGNS AND FOUR ADDITIONAL EMERGENCY LIGHTS TO BE LOCATED ON SITE BY CONSULTANT OR OWNER.


  ANY REMAINING UNINSTALLED EXIT SIGNS AND EMERGENCY LIGHTS TO BE TURNED OVER TO OWNER AT COMPLETION OF PROJECT.
- CIRCUIT BREAKER HANDLE LOCK-ON DEVICES ARE TO BE PROVIDED FOR BREAKERS SERVING EXIT LIGHTING, EMERGENCY LIGHTING.

## LV SYSTEMS NOTES:

- A. SEE DIVISION 26 SPECIFICATIONS AND INCLUDE ALL WORK AND SERVICES REQUIRED BY THIS DIVISION, THESE DRAWINGS AND RELATED REQUIREMENTS OF DIVISION 1 OF THE SPECIFICATION.
- B. SEE DIVISION 27 AND 28 SPECIFICATIONS AND INCLUDE ALL WORK AND SERVICES REQUIRED BY THESE DIVISIONS, THESE DRAWINGS AND RELATED REQUIREMENTS OF DIVISION 1 OF THE SPECIFICATION, EXECPTING ONLY THAT WORK SPECIFICALLY IDENTIFIED IN THE DOCUMENTS AS N.I.C.
- ELECTRICAL TRADE CONTRACTOR BIDDERS AND ALL GENERAL CONTRACTOR BIDDERS SHALL COORDINATE BIDDING TO ENSURE THAT ALL REQUIRED ITEMS OF THE WORK ARE INCLUDED. INCLUDING BUT NOT LIMITED TO:
- C.A. DOOR ACCESS CONTROL SYSTEMS
- C.B. SECURITY SYSTEMS WORK C.C. AUTO DOOR OPERATORS WORK
- C.D. FIRE ALARM WORK C.E. I.T. SYSTEMS WORK
- D. FOR FURTHER ELECTRICAL WORK RELATED TO REMOVALS. SEE ARCHITECTURAL DRAWINGS. ALL SELECT DEMOLITION OF ELECTRICAL IS
- INCLUDED IN THE WORK OF THE ELECTRICAL TRADE CONTRACTOR AS IF REPEATED ON THIS DRAWING SET.

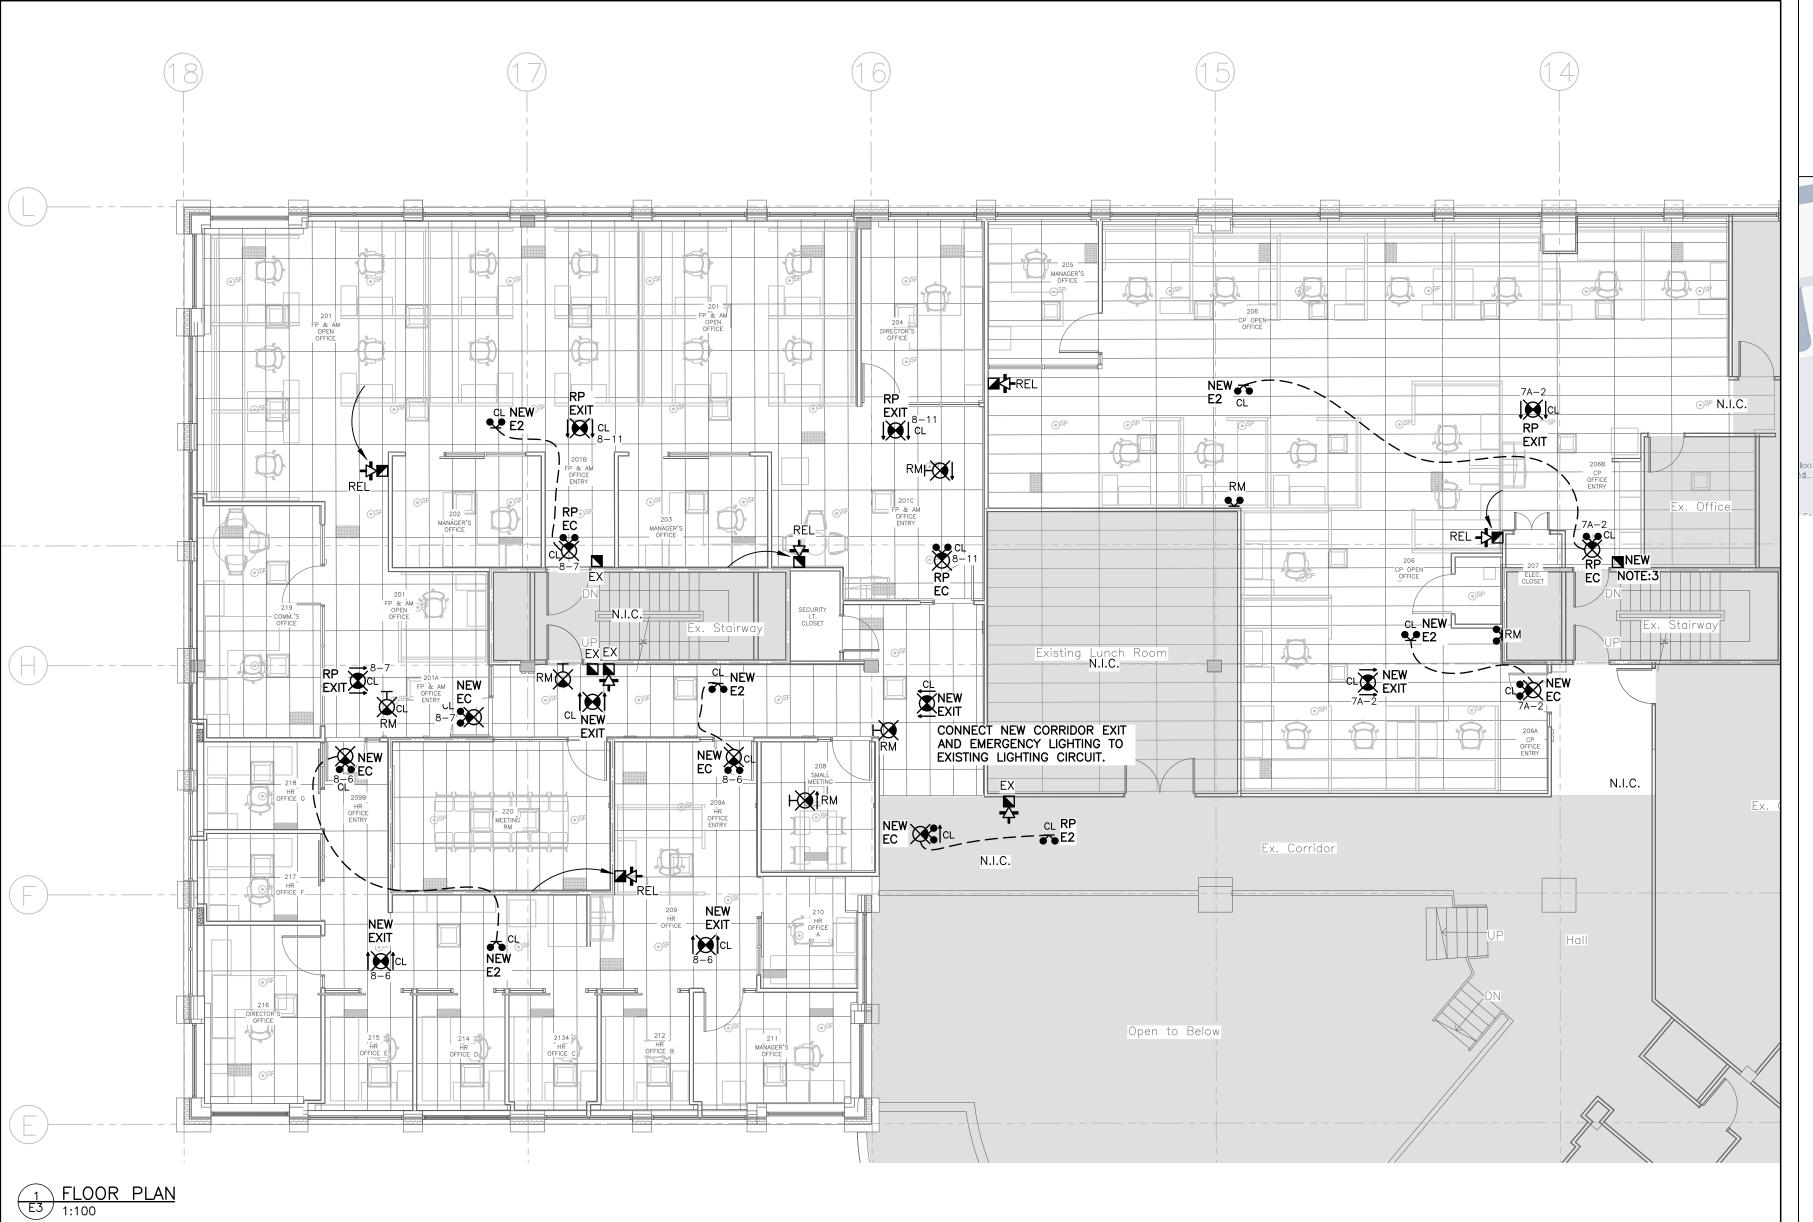



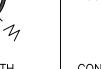

TRUE NORTH







3 ISSUED FOR PERMIT & TENDER 2025.03.21 2 ISSUED FOR PERMIT & TENDER 2025.03.11 1 ISSUED FOR REVIEW 2025.02.05
No REVISION DATE

# ENGINEERING

493 LANCASTER ST W, UNIT 204 PH (519) 745-3703 KITCHENER, ON N2K 1L8 WEB www.mighton.com

WATERLOO CITY HALL 2ND FLOOR RENOVATION 150 FREDERICK
WATERLOO, ONTARIO
DRAWING TITLE:


## ELECTRICAL LIFE SAFETY PLAN


DRAWN BY:	CUSTOMER PROJECT No.
MOD	
CHECKED BY: MRJ	MIGHTON PROJECT No. 44555
DATE:	DRAWING No.
JANUARY 2025	<b>□</b> 7
SCALE 1:100	LJ


## <u>LIGHTING & LIFE SAFETY NOTES:</u>

- 1. GANG ALL LIGHT SWITCHES WITH RECEPTACLES AND MOTOR—RATED SWITCHES LOCATED AT LATCH SIDE OF DOORS.
- PROVIDE MANUFACTURER APPROVED COMPATIBLE DIMMER SWITCHES WHERE NOTED ON THE PLANS. DIMMER MUST BE COMPATIBLE WITH DRIVER AND LOADS
- AS SHOWN. PROVIDE 0-10V CONTROL WIRING WHERE REQUIRED.

  3. MOTION SENSORS TO BE LOCATED AT LEAST SIX FEET FROM ALL DIFFUSER LOCATIONS. COORDINATE LOCATIONS WITH MECHANICAL.
- 4. PROVIDE SEPARATE NEUTRALS ON ALL DIMMERS.
- 5. ALL DEVICES IN THE WALLS OF ROOM 220 TO MAINTAIN THE FIRE RATING OF
- 6. ALL EXISTING FIXTURES TO BE REMOVED AND RELOCATED IN NOTED SPACE.

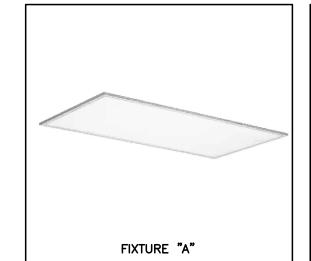


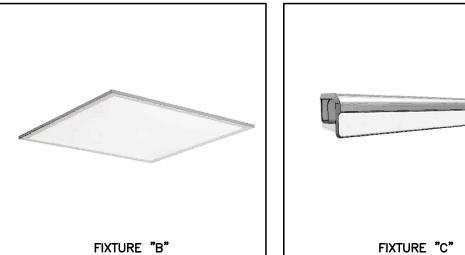

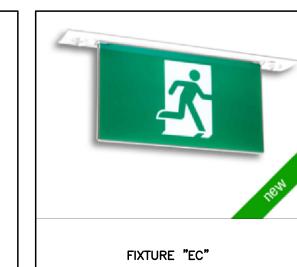


FIXTURE "D"



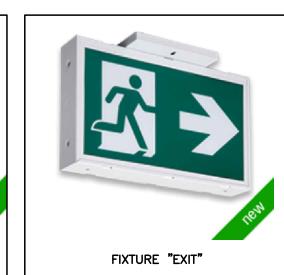

NOTES:

A. FOR FURTHER ELECTRICAL WORK RELATED TO REMOVALS, SEE ARCHITECTURAL DRAWINGS. ALL SELECT DEMOLITION OF ELECTRICAL IS INCLUDED IN THE WORK OF THE ELECTRICAL TRADE CONTRACTOR AS IF REPEATED ON THIS DRAWING SET.

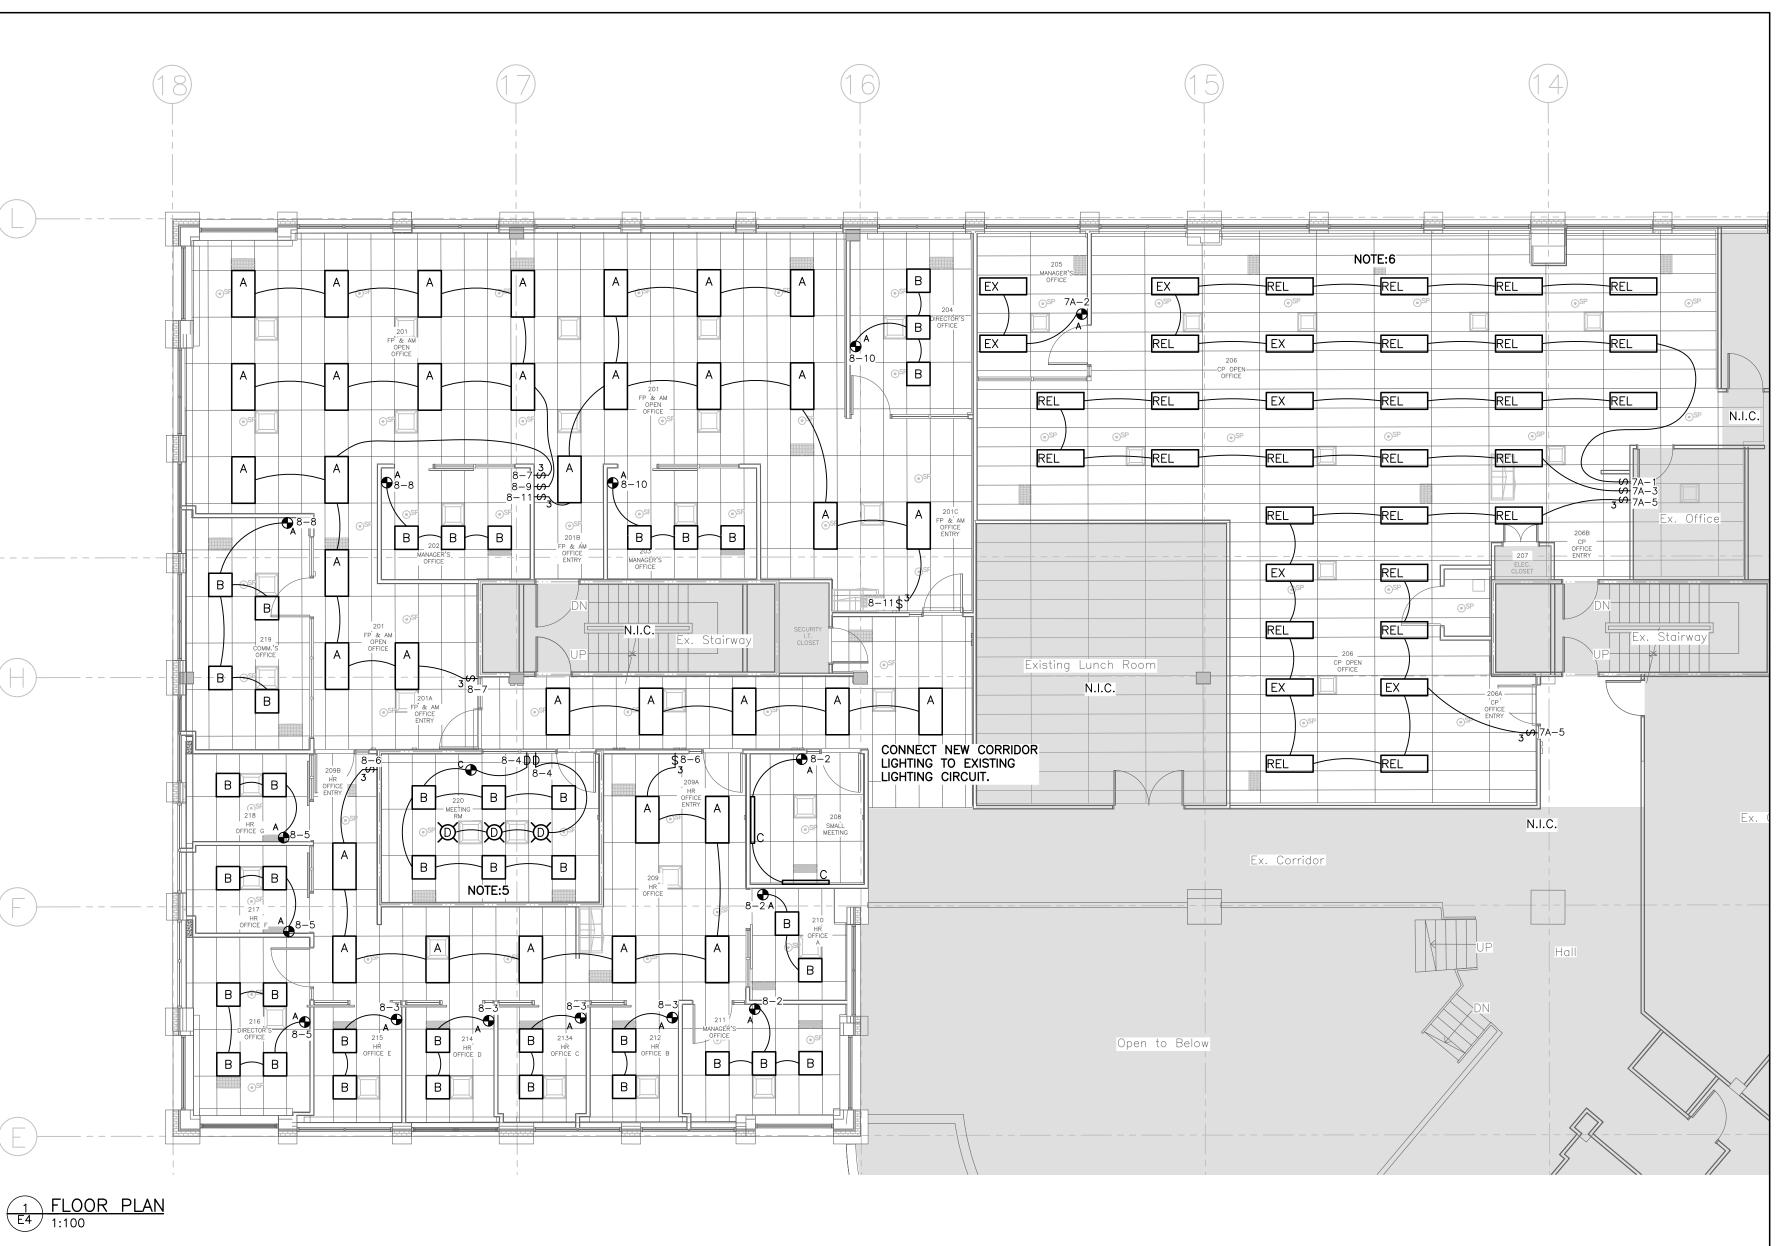

	LUMINAIRE SCHEDULE									
TYPE	ACCEPTABLE MANUFACTURES	MODELS	CATALOGUE NUMBERS	DESCRIPTION WATTS/LUMENS VOLTAGE/KELVIN	LOCATION MOUNTING HEIGHT	NOTES				
А	DAYBRITE SIGNIFY	2FPZ	2FPZ42B835-4-DS-UNV-DIM- CHIC	2'x4' FLAT PANEL 40W 120V	GENERAL RECESSED CEILING					
В	DAYBRITE SIGNIFY	2FPZ	2FPZ38B835-2-DS-UNV-DIM- CHIC	2'x2' FLAT PANEL 33W 120V	GENERAL RECESSED CEILING					
С	LEDALITE SIGNIFY	MODIFLY	MF0WL93530WN04DH1NNNW	4' LINEAR LED 23.5W 120V	HOTELING WALL SEE NOTES	CONFIRM MOUNTING HEIGHT PRIOR TO INSTALLATION.				
D	LIGHTOLIER SIGNIFY	RIVERSTONE	3DP-RS-PB-AQTP-LF-E26-CWH -DI-WHST	DECORATIVE LED 15W 120V	MEETING RM PENDANT CEILING	CONFIRM MOUNTING HEIGHT PRIOR TO INSTALLATION.				
EC	LUMACELL	LAEC	LAEC-SHO	EXIT COMBO 2-3W LED 120/12V	GENERAL RECESSED CEILING	MOUNT BETWEEN 7' AND 10' AFF. C/W 90 MINUTE INTERNAL BATTERY				
E2	LUMACELL	LRAUR	LRAURWHAC2P	EMERGE. REMOTE 6.5W LED 24V	GENERAL RECESSED CEILING	MOUNT BETWEEN 8' AND 12' AFF.				
EXIT	LUMACELL	CM-SS-L	CM-SS-SP-L	EXIT SIGN 3W LED FACE 120V	GENERAL SURFACE CEILING	MOUNT BETWEEN 7' AND 10' AFF. C/W 90 MINUTE INTERNAL BATTERY				

## LIGHTING CONTROL SENSOR SCHEDULE

IT IS THE CONTRACTORS RESPONSIBILITY TO COORDINATE NUMBER OF SENSORS, POWER PACKS AND WIRING DETAILS WITH MANUFACTURER IF AN ALTERNATIVE SENSOR IS USED TO THE ONE SPECIFIED. ALTERNATIVE SENSORS MAY NOT BE COMPATIBLE WITH LOADS DETAILED ON THE PLANS.


ACCEPTABLE MANUFACTURERS: HUBBELL, WATT STOPPER, SENSOR SWITCH, LEVITON, COOPER GREENGATE, STEINEL.

TYPE	MANUFACTURER	CATALOGUE NUMBER	VOLTAGE	SENSOR TECHNOLOGY	MOUNTING	DESCRIPTION	CONTROL SETTINGS
<b>⊕</b> <sup>A</sup>	SENSOR SWITCH	WSX D WH	120V	PIR	WALL @ SWITCH HEIGHT	AUTOMATIC WALL SWITCH (DIMMABLE)	AUTO TIME DELAY 7-20 MINUTES
<b>⊕</b> c	SENSOR SWITCH	CM 9	24V	PIR	CEILING	AUTOMATIC CEILING SENSOR	AUTO TIME DELAY 7-20 MINUTES





ORTH CONSTRUCTION NORTH

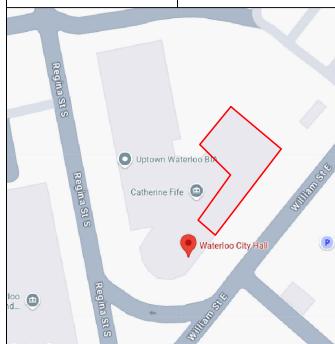



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# MIGHTON ENGINEERING

493 LANCASTER ST W, UNIT 204 PH (519) 745-3703
KITCHENER, ON N2K 1L8 WEB www.mighton.com

WATERLOO CITY HALL
2ND FLOOR RENOVATION

150 FREDERICK
WATERLOO, ONTARIO
DRAWING TITLE:

ELECTRICAL LIGHTING PLAN

DRAWN BY:	CUSTOMER PROJECT No.		
MOD			
CHECKED BY: MRJ	MIGHTON PROJECT No. 44555		
DATE:	DRAWING No.		
JANUARY 2025			
SCALE	l F4		
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