
COLLIERS PROJECT LEADERS ABSORPTION CHILLER DECOMMISSIONING

CLIENT PROJECT #: 230467-274385

M4S PROJECT #: 24279

777 MEMORIAL AVENUE, ORILLIA, ON L3V 7V3

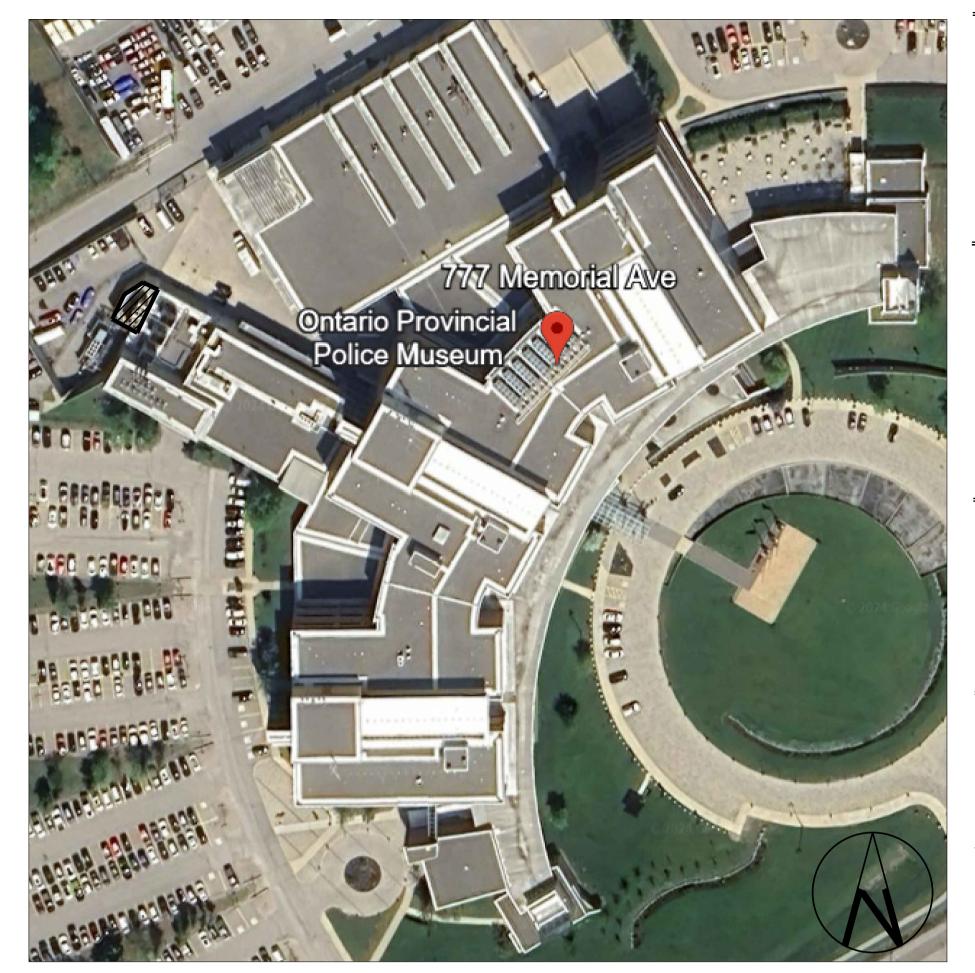




Colliers Project Leaders

3	ISSUED FOR TENDER	2025/04/11
2	ISSUED FOR 99% SUBMISSION	2025/03/19
1	ISSUED FOR 33% SUBMISSION	2025/01/31

Orientation

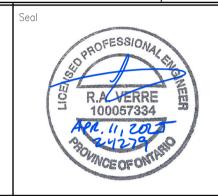

The Contractor shall check and verify all dimensions and reportall errors and omissions to the IO—Owner's/MBS Designee (as applicable) for his/her written direction before proceeding with the Work.



A Detail N

B Sheet No where de



CONTENT	ISSUED FOR	DATE	FILE No.
MECHANICAL DRAWINGS	TENDER	2025/04/11	24279-M
ELECTRICAL DRAWINGS	TENDER	2025/04/11	24279-E



DRAWING LIST

DWG NO. DESCRIPTION

CP-000 COVER PAGE AND DRAWING LIST

M-001 KEY PLAN

M-100 GENERAL NOTES, LEGENDS, SCHEDULES

M-300 MECHANICAL ROOM - GROUND FLOOR & M1 - DEMOLITION

M-301 MECHANICAL ROOM - ROOF - DEMOLITION

M-1000 DETAILS

E-100 GENERAL NOTES, LEGENDS, SCHEDULES

E-300 MECHANICAL AND GENERATOR ROOMS - POWER & SYSTEMS - DEMO

E-301 MECHANICAL ROOM - ROOF - POWER & SYSTEMS - DEMO

S.01 ROOF OPENING REPAIRS DETAILS



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ABSORPTION CHILLER DECOMMISSIONING

Building No B25370

777 MEMORIAL AVENUE, ORILLIA, ON L3V 7V3


10 Project No. 230467-274385 NO.6689

INFRASTRUCTURE ONTARIO

COVER PAGE AND DRAWING LIST

Scale N.T.S.	Project Start Date 20241119
Drawn by P.P.	Substantial Performance Date TBD
Designed by P.P.	Drawing No
Approved by Floor No R.V	
	CADD File NAME 24279-M

594x841mm

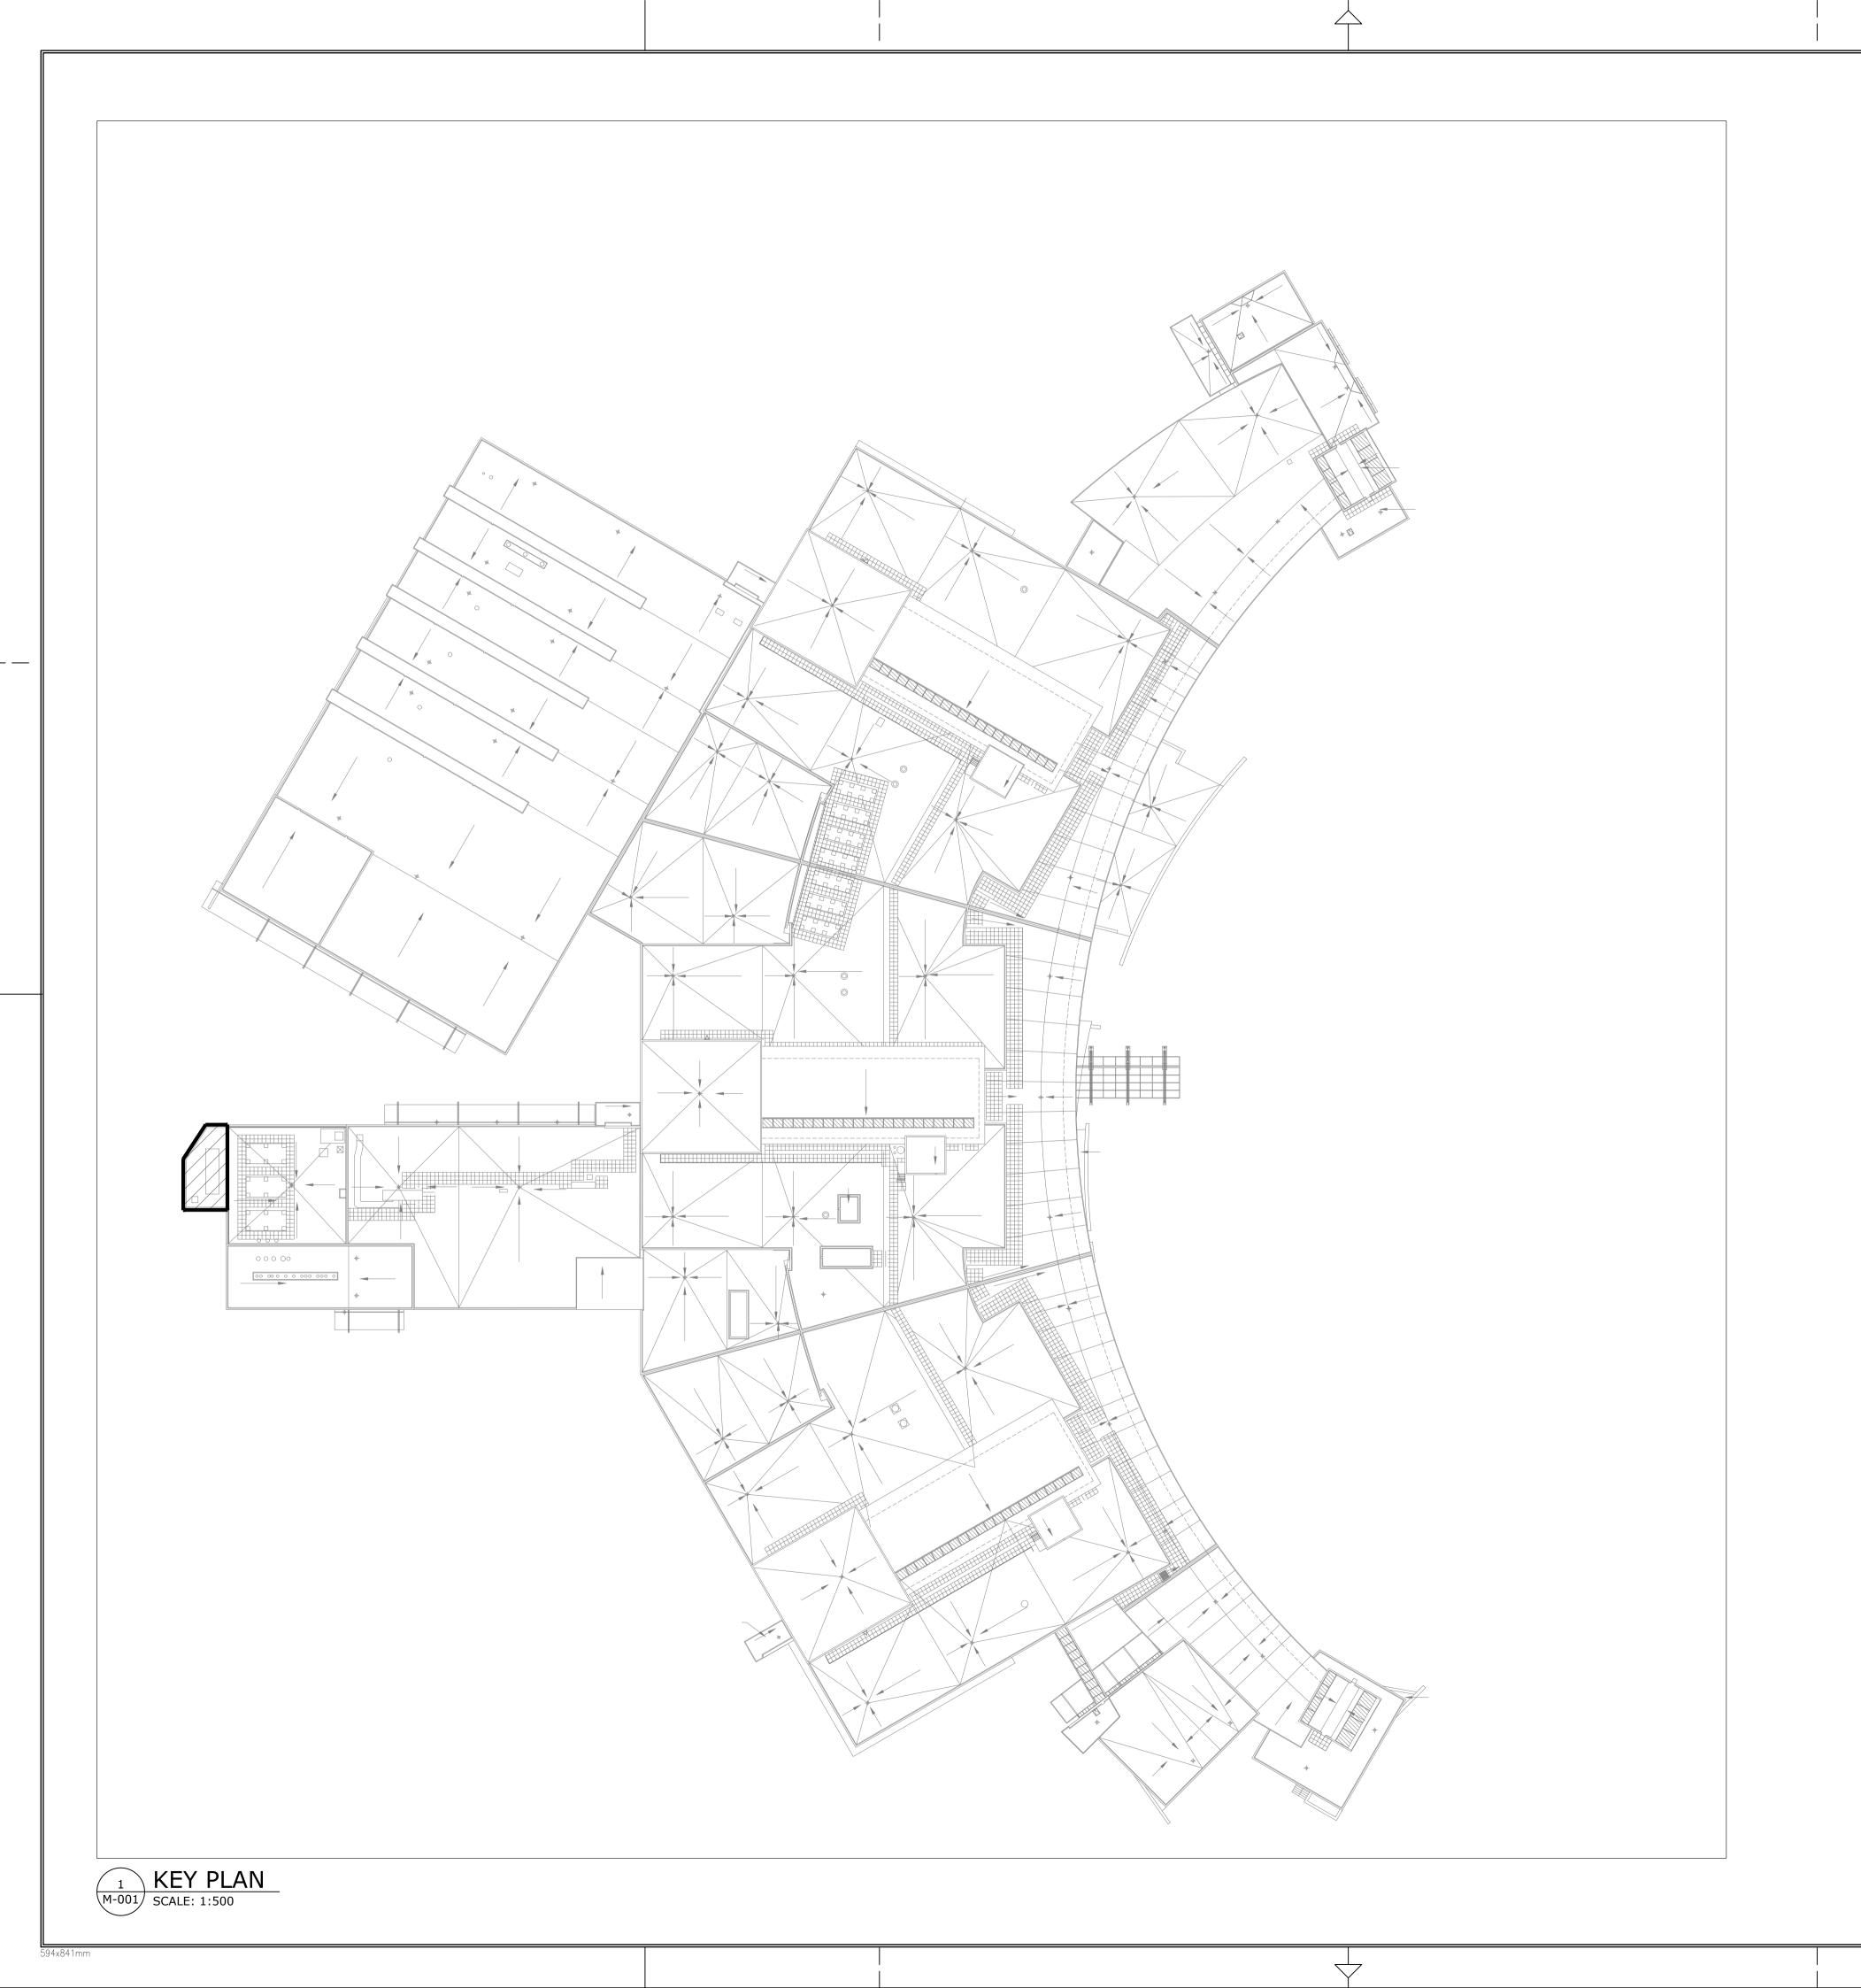



Colliers Project Leaders

3	ISSUED FOR TENDER	2025/04/11
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1	ISSUED FOR 33% SUBMISSION	2025/01/31

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A Detail No

B Sheet No where detailed





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ABSORPTION CHILLER DECOMMISSIONING

777 MEMORIAL AVENUE, ORILLIA, ON L3V 7V3

OPROJECT NO 230467-274385 NO6689

Building No B25370

INFRASTRUCTURE ONTARIO

Drawing Title
KEY PLAN

Scale 1:500	Project Start Date 20241119	
Drawn by P.P.	Substantial Performance Date TBD	
Designed by P.P.	Drawing No	
Approved by Floor No R.V. –	- $ -$ of	

CADD File NAME 24279-M

GENERAL NOTES:

1. THESE GENERAL NOTES APPLY TO ALL DRAWINGS.

2. GENERAL SCOPE OF WORK

- 2.1. FURNISH ALL LABOUR, MATERIALS, EQUIPMENT, TOOLS AND SUPPORTS AS WELL AS SUPERVISION TO PROVIDE A COMPLETE INSTALLATION, TESTED AND IN WORKING ORDER, AS SHOWN ON THE
- 2.2. THE CONTRACTOR SHALL PERFORM THE WORK STIPULATED IN THE CONTRACT AND ANY OR ALL CONTRACT CHANGES AND CHANGE DIRECTIVES, AND SHALL FURNISH, UNLESS OTHERWISE PROVIDED IN THE CONTRACT, EVERYTHING NECESSARY FOR THE PROPER PERFORMANCE AND COMPLETION OF THE
- 2.3. ALL WORK SHALL BE FULLY TESTED, COMMISSIONED AND IN GOOD WORKING ORDER AT TIME OF
- HAND-OVER TO OWNER. 2.4. MAKE GOOD ANY DAMAGES TO EXISTING EQUIPMENT AND/OR SYSTEM(S). COORDINATE WORK AND WORKING HOURS WITH THE OWNER AND OTHER TRADES TO MINIMIZE DISRUPTION.
- 2.5. ALL WORK SHALL BE COMPLETED ONCE ADEQUATE PROTECTION OF ADJACENT SPACES HAS BEEN INSTALLED. CONTRACTOR TO ENSURE MINIMAL DUST CREATION DURING WORK.
- 2.6. PROVIDE CAULKING AND FIRESTOPPING FOR ALL MECHANICAL SERVICES PASSING THROUGH FIRE SEPARATIONS AS INDICATED ON THE ARCHITECTURAL LAYOUT.
- 2.7. FOR EQUIPMENT PERFORMANCE AND CONSTRUCTION. REFER TO SCHEDULES AND SPECIFICATIONS. 2.8. FOR EQUIPMENT INSTALLATION. REFER TO DETAILS, SPECIFICATIONS AND MANUFACTURER'S RECOMMENDATIONS FOR MORE INFORMATION.

DRAWINGS 3.1. DRAWINGS SHOW GENERAL INTENT OF THE WORK AND PROPOSED ROUTING ONLY.

- 3.2. DO NOT SCALE DRAWINGS. CONTRACTOR SHALL CONFIRM ALL DIMENSIONS BY FIELD MEASURE BEFORE PROCEEDING WITH THE WORK.
- 3.3. CONTRACTOR SHALL BE RESPONSIBLE FOR IDENTIFYING POSSIBLE INTERFERENCES AND INFORMING THE ENGINEER PRIOR TO STARTING ANY WORK.
- 3.4. ANY DISCREPANCIES BETWEEN DRAWINGS AND SPECIFICATIONS AND/OR EXISTING CONDITIONS ARE TO BE REFERRED TO CONSULTANT FOR INSTRUCTIONS BEFORE ANY WORK BEGINS AND BEFORE ANY MATERIAL/EQUIPMENT IS ORDERED. THE CONTRACTOR SHALL BE RESPONSIBLE FOR ALL ASSOCIATED COSTS RESULTING FROM ANY REWORK CAUSED BY NOT FOLLOWING THIS PROCESS.

- 4.1. EXAMINE SITE CONDITIONS TO ENSURE THAT WORK CAN BE SATISFACTORILY CARRIED OUT AS SHOWN. IF SITE EXAMINATION REVEALS ANY DIFFICULTIES THAT WILL PREVENT THE WORK FROM BEING CARRIED OUT AS DESIGNED THESE MUST BE INDICATED IN THE TENDER PRICE, AND BROUGHT TO THE ATTENTION OF THE ENGINEER.
- 4.2. THE CONTRACTOR SHALL INFORM THE ENGINEER IN WRITING OF ANY ADDITIONAL DIFFICULTIES. INTERFERENCES AND SITE CONSTRAINTS THAT MAY BE IDENTIFIED DURING THE CONSTRUCTION
- 4.3. ALL WORK TO BE PERFORMED DURING REGULAR WORKING HOURS (8AM 5PM), MONDAY THROUGH
- 4.4. COORDINATE SITE ACCESS AND DELIVERIES WITH LANDLORD AND/OR GENERAL CONTRACTOR. 4.5. ALL EXISTING SERVICES THAT ARE NOT SHOWN ON THE DRAWINGS AND ARE EXPOSED DURING DEMOLITION/CONSTRUCTION SHALL BE VERIFIED BY THE CONTRACTOR AS TO THE SOURCE AND

ROUTING AND SHALL BE REPORTED TO THE CONSULTANT WITH PROPOSED RESOLUTIONS.

- 5.1. CLEAN PREMISES DAILY AT THE END OF EACH WORK DAY.
- 5.2. DO NOT ACCUMULATE EQUIPMENT, TOOLS, DEBRIS AND WASTE MATERIALS ON SITE. REMOVE FROM
- 5.3. COMPLETELY REMOVE ALL DEBRIS AND RUBBISH FROM SPACE ONCE WORK IS COMPLETE.
- 5.4. ALL MATERIALS TO BE DISPOSED OF CONSTRUCTION SITE IN ACCORDANCE WITH ALL APPLICABLE

6. EXISTING EQUIPMENT AND SYSTEMS

- 6.1. DISCONNECT, RECONNECT OR RELOCATE EXISTING EQUIPMENT OR SERVICES WHERE SHOWN OR AS REQUIRED TO PERMIT NEW WORK TO BE INSTALLED WITHOUT INTERFERENCES. ENSURE THAT REQUIRED SERVICES ARE MAINTAINED.
- 6.2. COORDINATE WITH THE OWNER BEFORE INTERRUPTING ANY ESSENTIAL SERVICES.
- 6.3. ROUTING OF NEW SERVICES MAY BE ADJUSTED TO ACCOMMODATE EXISTING SERVICES AND CONDITIONS PROVIDED THAT THE INTENT OF THE DRAWINGS IS MET AND THE ORIGINAL STANDARDS
- 6.4. PROVIDE DRAWINGS OF PROPOSED REVISIONS TO ENGINEER FOR APPROVAL BEFORE BEGINNING ANY
- WORK. INCORPORATE ALL CHANGES IN AS-BUILT DRAWINGS. 6.5. COORDINATE ALL ROUTING CHANGES WITH OTHER TRADES THAT MAY BE AFFECTED.
- 6.6. ENGINEER TO BE ADVISED PRIOR TO CHANGES WHERE CHANGES COULD BE SIGNIFICANT.
- 6.7. THE CONTRACTOR IS TO TAKE EXTRA CARE DURING THIS INSTALLATION NOT TO DISTURB THE OPERATIONS OF THE COMPLEX. IT IS CRITICAL THAT THERE WILL BE NO UNSCHEDULED SHUTDOWNS
- OR INTERRUPTIONS OF ANY OPERATIONS. 6.8. ALL ASSOCIATED COSTS OF THESE ITEMS LISTED ABOVE WILL **BE** THE RESPONSIBILITY OF THE

7. OPEN FLAMES AND WELDING

- 7.1. NO OPEN FLAMES OR WELDING IS PERMITTED WITHIN THE BUILDING WITHOUT WRITTEN PERMISSION
- BY THE OWNER AND/OR THE ENGINEER. 7.2. HOT WORK PERMIT MUST BE VISIBLE AT ALL TIMES.
- 7.3. ADEQUATE NUMBER OF FIRE EXTINGUISHERS MUST BE PROVIDED DURING THE OPEN FLAME PROCESS.

HVAC LEGEND		
SYMBOL	DESCRIPTION	
_/^\	FLEX DUCT	
. ~	CONTROL WIRE	
<u> </u>	PIPE BREAK	
E	CAP	
◀	FLOW ARROW	
T	THERMOSTAT	
T	THERMOSTAT WITH GUARD	
TS	TEMPERATURE SENSOR	
H	HUMIDISTAT	
HS	HUMIDITY SENSOR	
<u>©</u>	CARBON MONOXIDE SENSOR	
(CO ₂)	CARBON DIOXIDE SENSOR	
<u>OS</u>	OCCUPANCY SENSOR	
RS	REFRIGERANT SENSOR	
P	PRESSURE SENSOR	
	HYDRONICS LEGEND	
SYMBOL	DESCRIPTION	
— CHWS— — CHWR—	CHILLED WATER SUPPLY CHILLED WATER RETURN	
— CD —	CONDENSATE DRAIN	
c	CONDENSATE LINE	
— cws—	CONDENSER WATER SUPPLY	
— CWR—	CONDENSER WATER RETURN	
— GLS —	GLYCOL SUPPLY	
— GLR —	GLYCOL RETURN	
— HWS—	HOT WATER SUPPLY	
— HWR—	HOT WATER RETURN	
— SAN —	SANITARY	
SAN	SANITARY - BELOW	
	VENT	
(G)	GAS METER	
T	TEMPERATURE SENSOR	

RELATIVE HUMIDITY SENSOR

HIGH TEMPERATURE CUT OUT

DIFFERENTIAL PRESSURE

CHEMICAL POT FEEDER

AIR SEPARATOR

FLOW SWITCH

LOW WATER CUT OUT

LWCO

HTCO

 (ΔP)

GENE	RAL & ANNOTATION LEGEND
SYMBOL	DESCRIPTION
	NEW WORK
	EXISTING TO REMAIN
	EXISTING TO BE DEMOLISHED
─X XYZ X	XYZ = LINE DESCRIPTION EXISTING LINE TO BE DEMOLISHED
	PIPE RISE
—C—	PIPE DROP
	TEE DROP
<u> </u>	PIPE BREAK
<u> </u>	CAP
<u> </u>	UNION
	FLANGE CONNECTION
—	FLOW ARROW
\bowtie	VALVE - REFER TO SPECIFICATIONS FOR TYPE
	PUMP
KG	SUCTION GUIDE
	TRIPLE DUTY VALVE
VFD	VARIABLE FREQUENCY DRIVE
X Y Z	DIFFUSER TAG X = TYPE: A, B, C, ETC. (REFER TO SPECIFICATIONS FOR MORE DETAIL) Y = AIR FLOW (L/s) Z = FLEX DUCT SIZE (mm)
X MIN MAX	VAV TAG X = NECK SIZE (REFER TO VAV SCHEDULE FOR MORE DETAIL) MIN = MINIMUM SET AIR FLOW (L/s) MAX = MAXIMUM SET AIR FLOW (L/s)
X	DETAIL CALLOUT X = DETAIL NUMBER/LETTER Y = DRAWING NUMBER
X	CONTINUATION/SECTION TAG X = DETAIL NUMBER/LETTER Y = DRAWING NUMBER
XX-Y	EQUIPMENT TAG
X	EQUIPMENT TAG
X@Y% SLOPE	PIPE SLOPE ARROW X = PIPE DIAMETER (mm)







B Sheet No where detailed

2025/04/1

2025/03/19

2025/01/31

VALVES & ACCESSORIES LEGEND		
SYMBOL	DESCRIPTION	
\bowtie	BALANCING VALVE	
```	BUTTERFLY VALVE	
•	CHECK VALVE	
	BACK WATER PREVENTION VALVE ASSEMBLY	
	Y-STRAINER	
$\bowtie$	GATE VALVE	
<del>1</del> 6+	BALL VALVE	
	GLOBE VALVE	
<b>\$</b>	SOLENOID VALVE	
M	WATER METER	
	PRESSURE REDUCING VALVE	
×	PRESSURE RELIEF VALVE	
	2-WAY CONTROL VALVE - DDC	
	3-WAY CONTROL VALVE - DDC	
	3-WAY MOTORIZED CONTROL VALVE	
Ĺ	2-WAY CONTROL VALVE - PNEUMATIC	
	3-WAY CONTROL VALVE - PNEUMATIC	
T	THERMOSTATIC MIXING VALVE	
AAV X	AUTOMATIC AIR VENT	
<b>☆AV</b>	MANUAL AIR VENT	
P	PRESSURE GAUGE	
₽	TEMPERATURE GAUGE	



ABSORPTION CHILLER DECOMMISSIONING

Building No B25370

777 MEMORIAL AVENUE, ORILLIA, ON L3V 7V3 230467-274385 N06689

INFRASTRUCTURE ONTARIO


GENERAL NOTES, LEGENDS, SCHEDULES

Scale N.T.S.	Project Start Date 20241119
Drawn by P.P.	Substantial Performance Date TBD
Designed by P.P.	Drawing No
Approved by Floor No R.V. ####	$ \cup$ $\cup$ of
	CADD File NAME <b>24279-M</b>

REFER TO∕<del>-</del>OO <del>-</del>C√s <del>×</del> O 2/M-300 2/M-300 −REFER TØ _4"Ø 2/M-300 **─**⟨2⟩ REFER TO 2/M-300 CHA-001 CDP-001-(MCC REFERENCE P-3) 2/M-300 CDP-002-(MCC REFERENCE P-4) CDP-003-(MCC REFERENCE P-5) 2/M-300 2/M-300

MECHANICAL ROOM - GROUND FLOOR - LOWER LEVEL - DEMOLITION

SCALE: 1:50

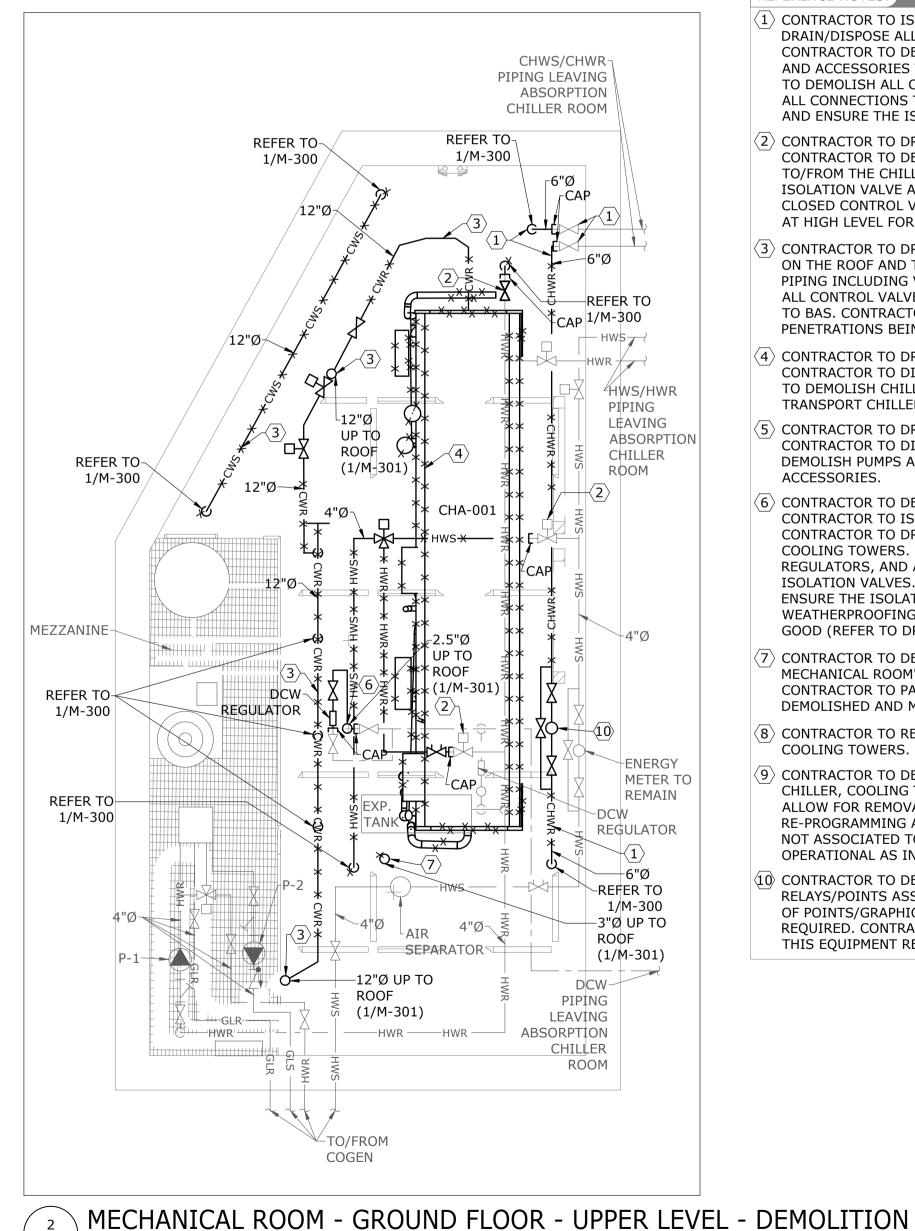

DEMOLITION GENERAL NOTES:

- 1. THESE GENERAL NOTES APPLY TO ALL DEMOLITION DRAWINGS.
- 2. DISCONNECT EXISTING UNUSED EQUIPMENT FROM POWER SUPPLY AND MAKE SAFE.
- 3. PRIOR TO COMMENCING THE DEMOLITION WORK, EXAMINE SITE CAREFULLY INCLUDING ALL THE ELEMENTS THAT NEED TO BE REMOVED.
- 4. REMOVE ALL ABANDONED PIPES, HANGERS, INSERTS, CONDUITS, DUCTS, AND
- 5. SEAL AND FIRESTOP (IF NECESSARY) ALL AFFECTED AREAS TO MATCH EXISTING.
- 6. CONTRACTOR TO CLEAN ALL DEBRIS AND RUBBISH GENERATED FROM THIS WORK
- 7. CONTRACTOR TO REPAIR ANY DAMAGE CAUSED BY THIS WORK AND MAKE GOOD TO MATCH EXISTING.
- 8. CONTRACTOR SHALL REPAIR UNUSED FLOOR AND WALL OPENINGS AT ALL PENETRATIONS OF DEMOLISHED WORK. REPAIRS SHALL MATCH EXISTING **CONDITIONS** AND FINISHES.
- 9. DRAIN ALL AFFECTED SYSTEMS AS REQUIRED AND REFILL AFTER WORK IS COMPLETE. REFER TO SPECIFICATIONS FOR SPECIFIC PIPE FLUSHING MATERIALS AND PROCEDURES.
- 10. ALL EXISTING **SYSTEMS** ARE SHOWN FOR REFERENCE ONLY. CONTRACTOR IS RESPONSIBLE TO SITE VERIFY EXACT LOCATION OF EQUIPMENT AND POINT OF CONNECTION TO EXISTING AS REQUIRED.
- 11. CONTRACTOR SHALL BE RESPONSIBLE FOR DISASSEMBLY AND CUTTING OF ALL EQUIPMENT/MATERIAL TO ALLOW FOR REMOVAL FROM SITE.
- 12. CONTRACTOR TO SEAL ALL PIPE, CONDUIT, SUPPORTS, ETC., PENETRATIONS THROUGH ROOF FROM DEMOLITION. CONTRACTOR TO SEAL, WEATHERPROOF, AND MAKE GOOD ALL PENETRATIONS. REFER TO DRAWING S.01 FOR DETAIL.
- 13. ANY/ALL PIPING INSULATION DAMAGED NEEDS TO BE REPAIRED AND MADE GOOD.
- 14. CONTRACTOR TO UPDATE VALVE INVENTORY LIST TO ENSURE ALL VALVES THAT ARE REMOVED AS PART OF THE DEMOLITION SCOPE ARE REMOVED FROM THE VALVE INVENTORY LIST. CONTRACTOR TO COORDINATE WITH FACILITY STAFF FOR EXISTING LIST.
- REFERENCE NOTES:
- CONTRACTOR TO ISOLATE CHWS/CHWR PIPING AT ISOLATION VALVE. CONTRACTOR TO DRAIN/DISPOSE ALL CHILLED WATER FROM ISOLATION VALVE TO/FROM CHILLER. CONTRACTOR TO DEMOLISH ALL CHWS/CHWR PIPING INCLUDING VALVES, GAUGES AND ACCESSORIES TO/FROM THE CHILLER UNTIL THE ISOLATION VALVE. CONTRACTOR TO DEMOLISH ALL CONTROL VALVES, FLOW SENSORS, ETC. INCLUDING WIRING AND ALL CONNECTIONS TO BAS. CONTRACTOR TO PROVIDE A CAP AT THE ISOLATION VALVE AND ENSURE THE ISOLATION VALVE REMAINS CLOSED.
- (2) CONTRACTOR TO DRAIN/DISPOSE PORTION OF HEATING WATER TO/FROM CHILLER. CONTRACTOR TO DEMOLISH HWS/HWR PIPING INCLUDING GAUGES AND ACCESSORIES TO/FROM THE CHILLER AT HIGH LEVEL. CONTRACTOR TO PROVIDE AND INSTALL NEW ISOLATION VALVE AND CAP AT HIGH LEVEL AS SHOWN. CONTRACTOR TO ALSO LOCK CLOSED CONTROL VALVE AND DISCONNECT FROM BAS, AND PROVIDE A CAP AS SHOWN AT HIGH LEVEL FOR HWS/HWR PIPING.
- ONTRACTOR TO DRAIN/DISPOSE ALL CONDENSING WATER FROM COOLING TOWERS ON THE ROOF AND TO/FROM THE CHILLER. CONTRACTOR TO DEMOLISH ALL CWS/CWR PIPING INCLUDING VALVES, GAUGES, ACCESSORIES, ETC. CONTRACTOR TO DEMOLISH ALL CONTROL VALVES, FLOW SENSORS, ETC., INCLUDING WIRING AND CONNECTION TO BAS. CONTRACTOR TO PATCH ROOF WITH WEATHERPROOFING FOR ALL PIPE PENETRATIONS BEING DEMOLISHED AND MAKE GOOD (REFER TO DRAWING S.01).
- 4 CONTRACTOR TO DRAIN/DISPOSE ALL FLUIDS SAFELY FROM THE CHILLER. CONTRACTOR TO DISCONNECT CHILLER FROM POWER AND MAKE SAFE. CONTRACTOR TO DEMOLISH CHILLER INTO PARTS, INCLUDING ALL CONTROL PANELS, POWER, ETC.. TRANSPORT CHILLER OUT OF THE ROOM IN PARTS.
- (5) CONTRACTOR TO DRAIN/DISPOSE ALL CONDENSING WATER FROM PUMPS.
  CONTRACTOR TO DISCONNECT PUMPS FROM POWER AND MAKE SAFE. CONTRACTOR TO DEMOLISH PUMPS AS SHOWN, INCLUDING ALL PIPING, VALVES, GAUGES, SUPPORTS, ACCESSORIES.
- CONTRACTOR TO DEMOLISH DCW PIPING PENETRATING THROUGH THE ROOF. CONTRACTOR TO ISOLATE DCW PIPING AT ISOLATION VALVES IN MECHANICAL ROOM. CONTRACTOR TO DRAIN/DISPOSE OF ALL DCW FROM ISOLATION VALVES TO/FROM COOLING TOWERS. CONTRACTOR TO DEMOLISH DCW PIPING INCLUDING GAUGES, REGULATORS, AND ACCESSORIES TO/FROM THE COOLING TOWERS UNTIL THE ISOLATION VALVES. CONTRACTOR TO PROVIDE A CAP AT THE ISOLATION VALVES AND ENSURE THE ISOLATION VALVES REMAIN CLOSED. CONTRACTOR TO PATCH ROOF WITH WEATHERPROOFING FOR ALL PIPE PENETRATIONS BEING DEMOLISHED, AND MAKE GOOD (REFER TO DRAWING S.01).
- ONTRACTOR TO DEMOLISH ALL CONDENSING WATER DISCHARGE PIPE FED TO THE MECHANICAL ROOM'S FLOOR DRAIN FROM THE COOLING TOWERS ON THE ROOF.

  CONTRACTOR TO PATCH ROOF WITH WEATHERPROOFING FOR PIPE PENETRATION BEING DEMOLISHED AND MAKE GOOD (REFER TO DRAWING S.01).
- (8) CONTRACTOR TO REMOVE ALL CONTROL WIRING AND CONNECTIONS TO/FROM THE COOLING TOWERS. CONTRACTOR TO DEMOLISH AND REMOVE COOLING TOWER PANEL.
- (9) CONTRACTOR TO DEMOLISH ALL POINTS/RELAYS ASSOCIATED WITH THE ABSORPTION CHILLER, COOLING TOWERS, AND RELATED CONDENSER PUMPS. CONTRACTOR TO ALLOW FOR REMOVAL OF POINTS/GRAPHICS ON THE BAS. CONTRACTOR TO ALLOW FOR RE-PROGRAMMING AS REQUIRED. CONTRACTOR TO ENSURE ALL REMAINING CONTROLS NOT ASSOCIATED TO THE DEMOLISHED EQUIPMENT REMAIN IN PLACE AND ARE OPERATIONAL AS INTENDED.
- CONTRACTOR TO DEMOLISH/REMOVE CHWR ENERGY METER, INCLUDING ALL RELAYS/POINTS ASSOCIATED WITH THE METER. CONTRACTOR TO ALLOW FOR REMOVAL OF POINTS/GRAPHICS ON THE BAS. CONTRACTOR TO ALLOW FOR RE-PROGRAMMING AS REQUIRED. CONTRACTOR TO ENSURE ALL REMAINING CONTROLS NOT ASSOCIATED TO THIS EQUIPMENT REMAIN IN PLACE AND ARE OPERATIONAL AS INTENDED.




Colliers Project Leaders

3	ISSUED FOR TENDER	2025/04/11
2	ISSUED FOR 99% SUBMISSION	2025/03/19
1	ISSUED FOR 33% SUBMISSION	2025/01/31





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A Detail No

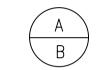B Sheet No where detailed





Ministry PSIF Number

ABSORPTION CHILLER DECOMMISSIONING

777 MEMORIAL AVENUE, ORILLIA, ON L3V 7V3

10 Project No. 230467-274385 NO.6689

Building No B25370

INFRASTRUCTURE ONTARIO

MECHANICAL ROOM — GROUND FLOOR & M1 — DEMOLITION

Scale 1:50	Project Start Date 20241119	
Drawn by P.P.	Substantial Performance Date TBD	
Designed by P.P.	Drawing No	
Approved by Floor No R.V. ####	-	
	CADD File NAME 24279-M	


501,2811

# DEMOLITION GENERAL NOTES:

- 1. THESE GENERAL NOTES APPLY TO ALL DEMOLITION DRAWINGS.
- 2. DISCONNECT EXISTING UNUSED EQUIPMENT FROM POWER SUPPLY AND MAKE SAFE.
- 3. PRIOR TO COMMENCING THE DEMOLITION WORK, EXAMINE SITE CAREFULLY INCLUDING ALL THE ELEMENTS THAT NEED TO BE REMOVED.
- 4. REMOVE ALL ABANDONED PIPES, HANGERS, INSERTS, CONDUITS, DUCTS, AND SERVICES.
- 5. SEAL AND FIRESTOP (IF NECESSARY) ALL AFFECTED AREAS TO MATCH EXISTING.
- 6. CONTRACTOR TO CLEAN ALL DEBRIS AND RUBBISH GENERATED FROM THIS WORK.
- 7. CONTRACTOR TO REPAIR ANY DAMAGE CAUSED BY THIS WORK AND MAKE GOOD TO MATCH EXISTING.
- 8. CONTRACTOR SHALL REPAIR UNUSED FLOOR AND WALL OPENINGS AT ALL PENETRATIONS OF DEMOLISHED WORK. REPAIRS SHALL MATCH EXISTING **CONDITIONS** AND FINISHES.
- 9. DRAIN ALL AFFECTED SYSTEMS AS REQUIRED AND REFILL AFTER WORK IS COMPLETE. REFER TO SPECIFICATIONS FOR SPECIFIC PIPE FLUSHING MATERIALS AND PROCEDURES.
- 10. ALL EXISTING **SYSTEMS** ARE SHOWN FOR REFERENCE ONLY. CONTRACTOR IS RESPONSIBLE TO SITE VERIFY EXACT LOCATION OF EQUIPMENT AND POINT OF CONNECTION TO EXISTING AS REQUIRED.
- 11. CONTRACTOR SHALL BE RESPONSIBLE FOR DISASSEMBLY AND CUTTING OF ALL EQUIPMENT/MATERIAL TO ALLOW FOR REMOVAL FROM SITE.
- 12. CONTRACTOR TO SEAL ALL PIPE, CONDUIT, SUPPORT, ETC., PENETRATIONS THROUGH ROOF FROM DEMOLITION. CONTRACTOR TO SEAL, WEATHERPROOF, AND MAKE GOOD ALL PENETRATIONS. REFER TO DRAWING S.01 FOR DETAIL.
- 13. ANY/ALL PIPING INSULATION DAMAGED NEEDS TO BE REPAIRED AND MADE GOOD.
- 14. CONTRACTOR TO UPDATE VALVE INVENTORY LIST TO ENSURE ALL VALVES THAT ARE REMOVED AS PART OF THE DEMOLITION SCOPE ARE REMOVED FROM THE VALVE INVENTORY LIST. CONTRACTOR TO COORDINATE WITH FACILITY STAFF FOR EXISTING

# REFERENCE NOTES:

- CONTRACTOR TO ISOLATE DCW PIPING AT ISOLATION VALVES IN MECHANICAL ROOM. CONTRACTOR TO DRAIN/DISPOSE OF ALL DCW FROM ISOLATION VALVES TO/FROM COOLING TOWERS. CONTRACTOR TO DEMOLISH DCW PIPING INCLUDING GAUGES, REGULATORS, AND ACCESSORIES TO/FROM THE COOLING TOWERS UNTIL THE ISOLATION VALVES. CONTRACTOR TO PROVIDE A CAP AT THE ISOLATION VALVES AND ENSURE THE ISOLATION VALVES REMAIN CLOSED. CONTRACTOR TO PATCH ROOF WITH WEATHERPROOFING FOR ALL PIPE PENETRATIONS BEING DEMOLISHED AND MAKE GOOD (REFER TO DRAWING S.01).
- (2) CONTRACTOR TO DRAIN/DISPOSE ALL CONDENSING WATER FROM COOLING TOWERS ON THE ROOF AND TO/FROM THE CHILLER. CONTRACTOR TO DEMOLISH ALL CWS/CWR PIPING INCLUDING VALVES, GAUGES, ACCESSORIES, ETC. CONTRACTOR TO DEMOLISH ALL CONTROL VALVES, INCLUDING WIRING AND CONNECTION TO BAS. CONTRACTOR TO PATCH ROOF WITH WEATHERPROOFING FOR ALL PIPE PENETRATIONS BEING DEMOLISHED AND MAKE GOOD (REFER TO DRAWING S.01).
- (3) CONTRACTOR TO DRAIN/DISPOSE ALL FLUIDS SAFELY FROM THE TWO (2) COOLING TOWERS. CONTRACTOR TO DEMOLISH COOLING TOWERS WITH ALL ASSOCIATED PIPING, VALVES, ACCESSORIES, AND SAFELY REMOVE FROM THE ROOF. CONTRACTOR TO DISCONNECT POWER FROM COOLING TOWERS AND MAKE SAFE. CONTRACTOR TO REMOVE COOLING TOWER SUPPORT/STANDS, ENSURING ALL PENETRATIONS THROUGH THE ROOF FROM THE STAND IS PATCHED/WEATHERPROOFED AND MAKE GOOD (REFER TO DRAWING S.01).
- (4) CONTRACTOR TO DEMOLISH ALL CONDENSING WATER DISCHARGE PIPE FED TO THE MECHANICAL ROOM'S FLOOR DRAIN. CONTRACTOR TO PATCH ROOF WITH WEATHERPROOFING FOR THE PIPE PENETRATION BEING DEMOLISHED AND MAKE GOOD (REFER TO DRAWING S.01).

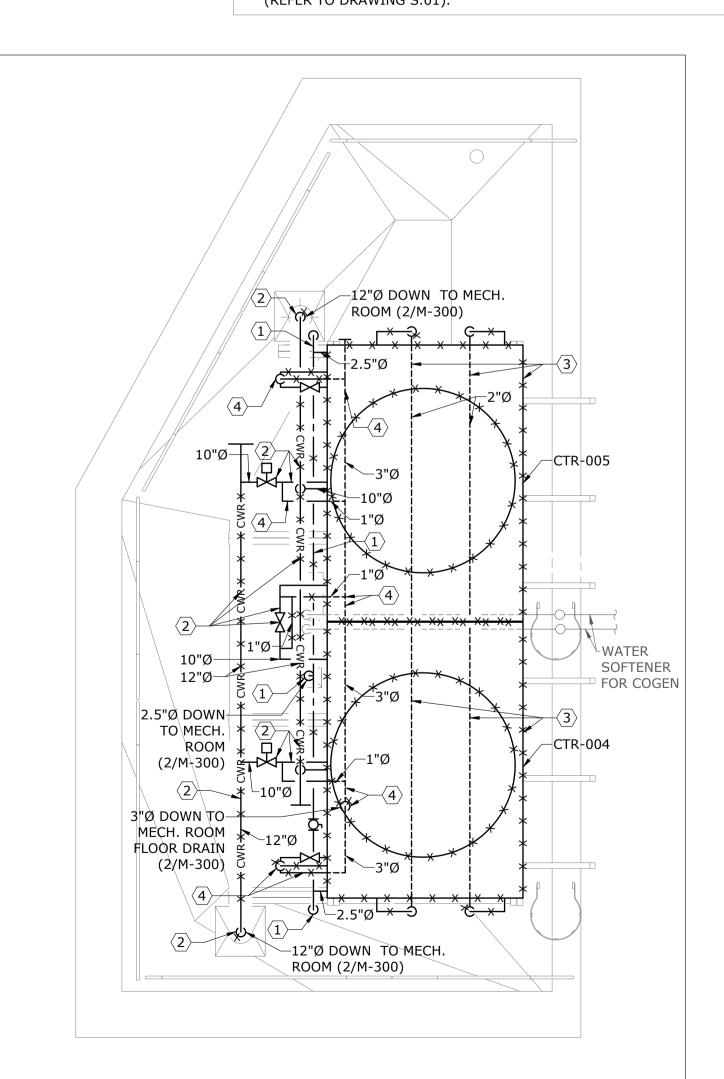

1 MECHANICAL ROOM - ROOF - DEMOLITION SCALE: 1:50



Colliers Project Leaders

3	ISSUED FOR TENDER	2025/04/11
2	ISSUED FOR 99% SUBMISSION	2025/03/19
1	ISSUED FOR 33% SUBMISSION	2025/01/31
No	Revisions	Date





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A Detail No

B Sheet No where detailed





Ministry PSIF Numb

ABSORPTION CHILLER DECOMMISSIONING

777 MEMORIAL AVENUE, ORILLIA, ON L3V 7V3

10 Project No. 230467-274385 N06689


Building No B25370

INFRASTRUCTURE ONTARIO

MECHANICAL ROOM — ROOF — DEMOLITION

Scale 1:50	Project Start Date 20241119	
Drawn by P.P.	Substantial Performance Date TBD	
Designed by P.P.	Drawing No	
Approved by Floor No R.V. RF		
	CADD File NAME <b>24279-M</b>	

594x841

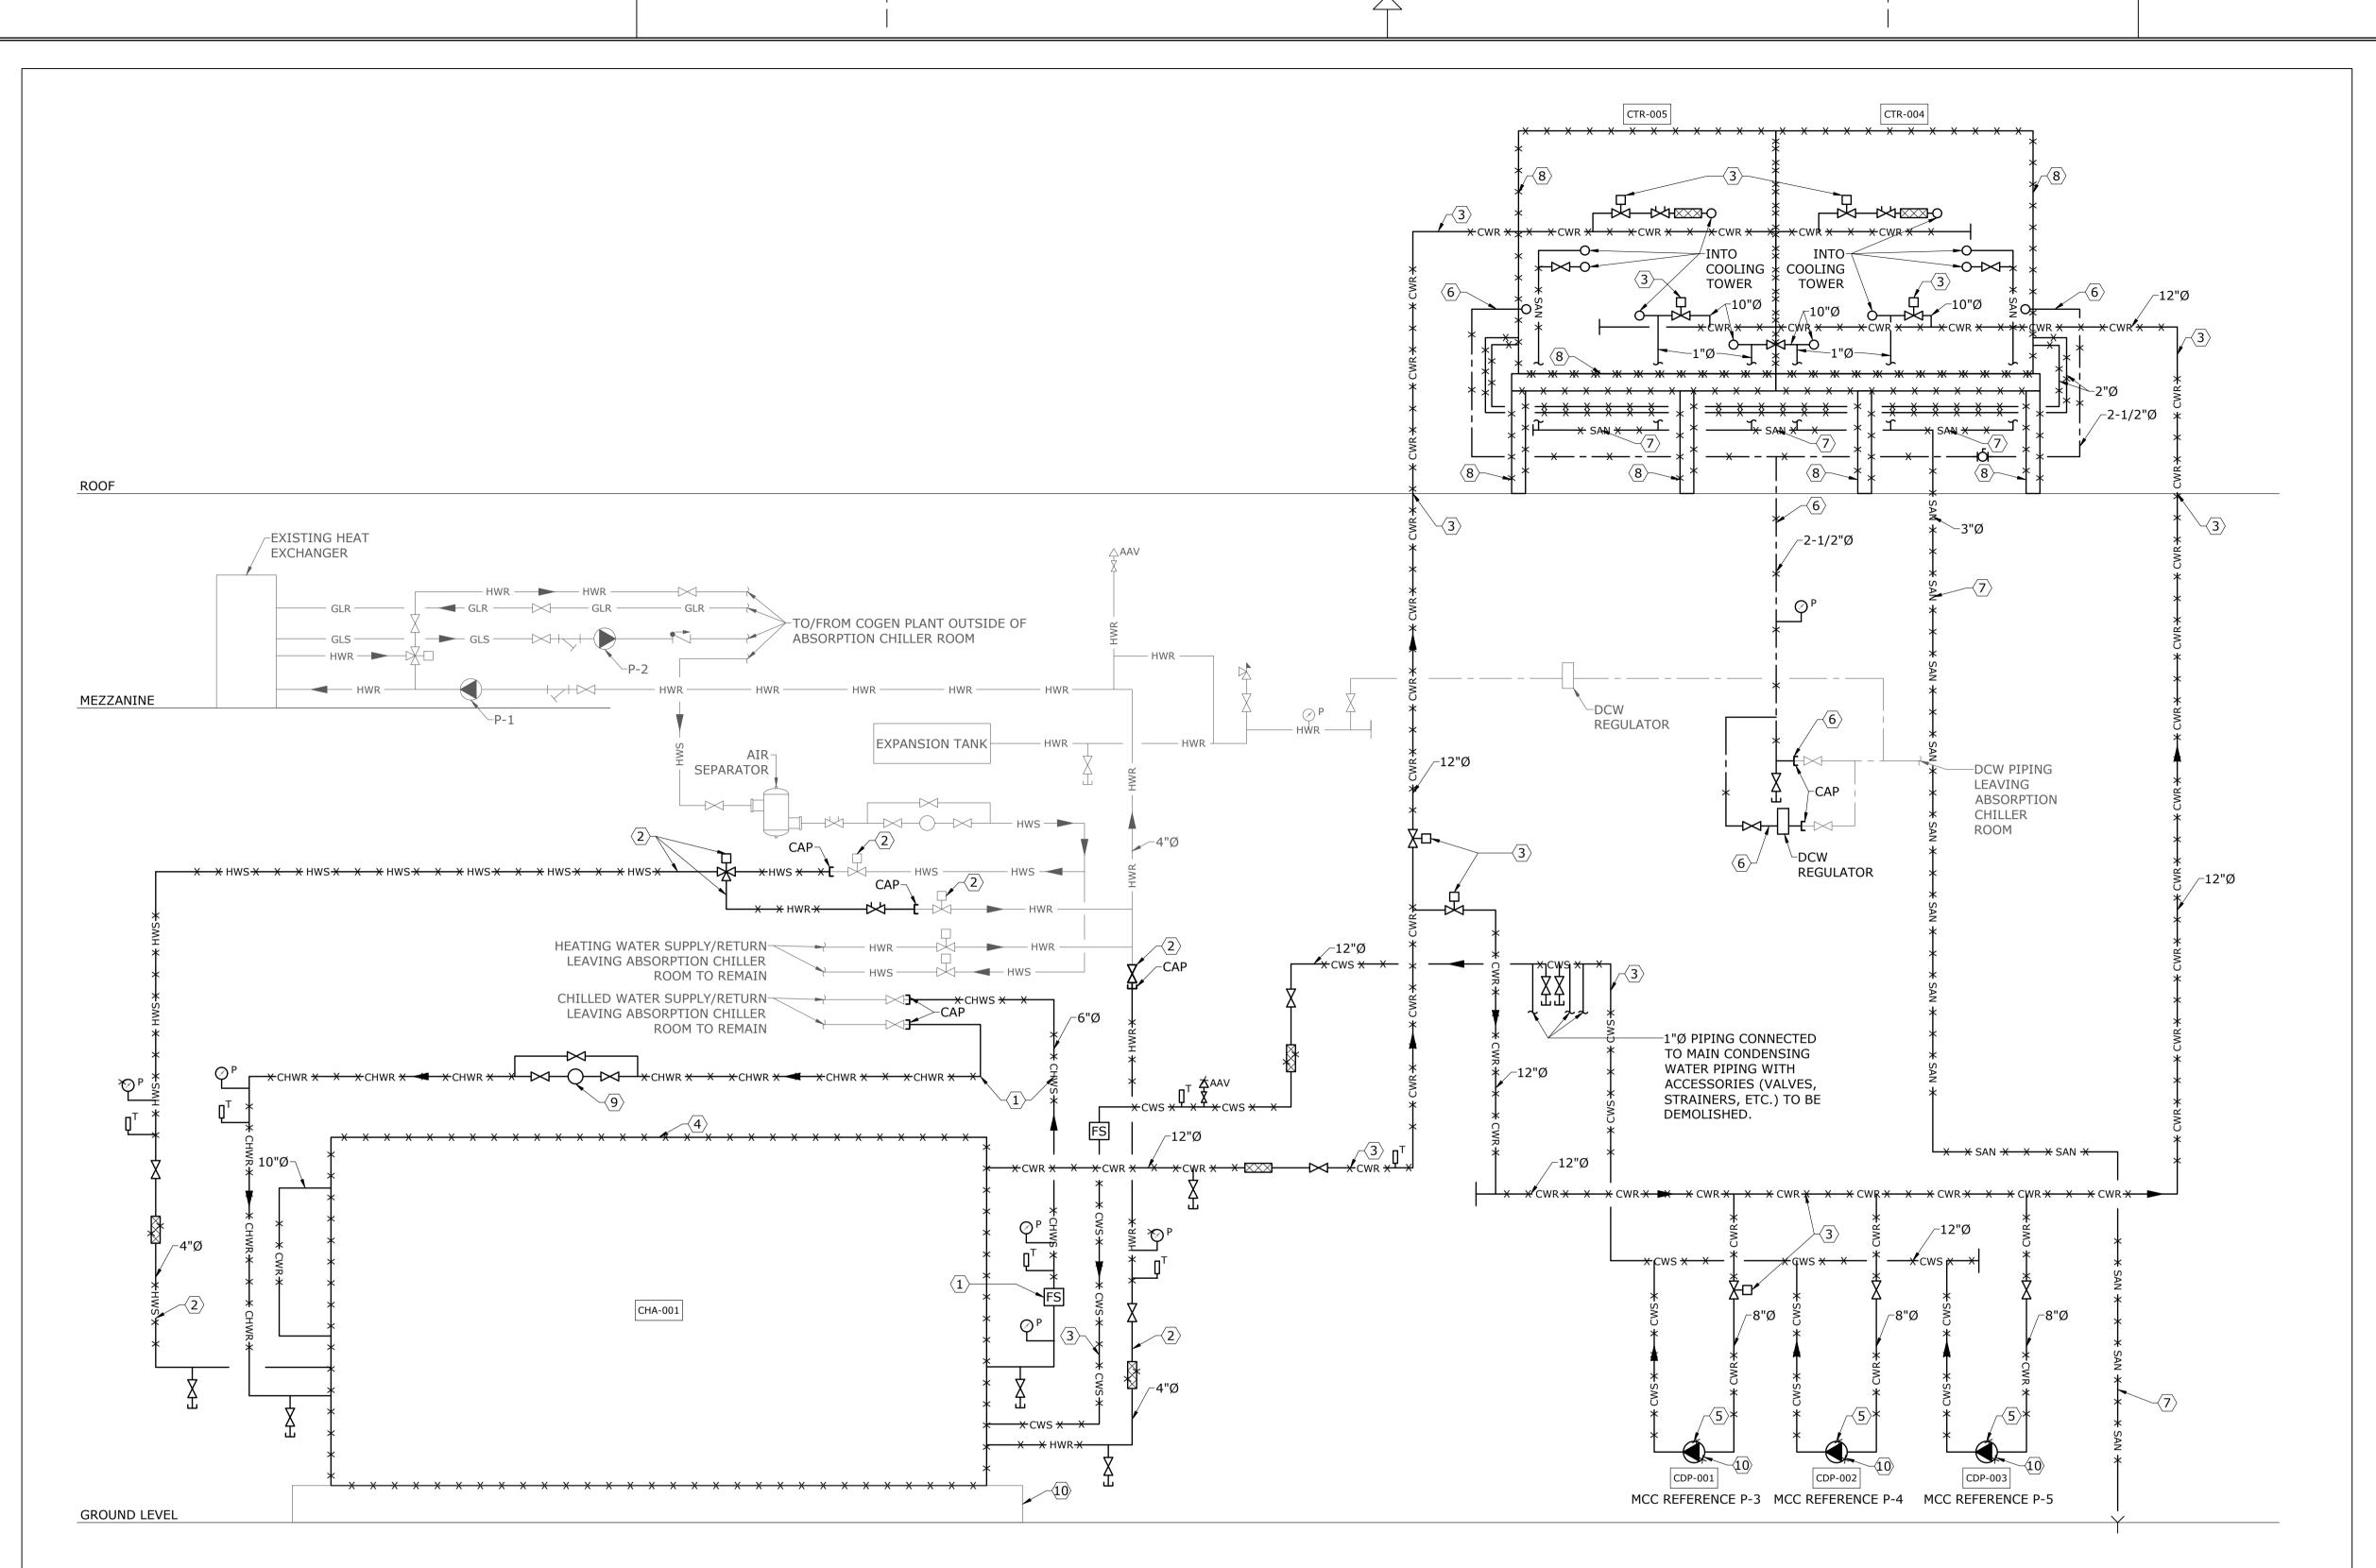

# DEMOLITION - ABSORPTION CHILLER SCHEMATIC M-1000 SCALE: N.T.S.

# DEMOLITION GENERAL NOTES:

- 1. THESE GENERAL NOTES APPLY TO ALL DEMOLITION DRAWINGS.
- 2. DISCONNECT EXISTING UNUSED EQUIPMENT FROM POWER SUPPLY AND MAKE SAFE.
- PRIOR TO COMMENCING THE DEMOLITION WORK, EXAMINE SITE CAREFULLY INCLUDING ALL THE ELEMENTS THAT NEED
  TO BE REMOVED.
- 4. REMOVE ALL ABANDONED PIPES, HANGERS, INSERTS, CONDUITS, DUCTS, AND SERVICES.
- 5. SEAL AND FIRESTOP (IF NECESSARY) ALL AFFECTED AREAS TO MATCH EXISTING.
  6. CONTRACTOR TO CLEAN ALL DERRIS AND RUBRISH GENERATED FROM THIS WORK
- CONTRACTOR TO CLEAN ALL DEBRIS AND RUBBISH GENERATED FROM THIS WORK.CONTRACTOR TO REPAIR ANY DAMAGE CAUSED BY THIS WORK AND MAKE GOOD TO MATCH EXISTING.
- 7. CONTRACTOR TO REPAIR ANY DAMAGE CAUSED BY THIS WORK AND MAKE GOOD TO MATCH EXISTING. 8. CONTRACTOR SHALL REPAIR UNUSED FLOOR AND WALL OPENINGS AT ALL PENETRATIONS OF DEMOLISHED WORK.
- REPAIRS SHALL MATCH EXISTING **CONDITIONS** AND FINISHES.
- DRAIN ALL AFFECTED SYSTEMS AS REQUIRED AND REFILL AFTER WORK IS COMPLETE. REFER TO SPECIFICATIONS FOR SPECIFIC PIPE FLUSHING MATERIALS AND PROCEDURES.
   ALL EXISTING SYSTEMS ARE SHOWN FOR REFERENCE ONLY. CONTRACTOR IS RESPONSIBLE TO SITE VERIFY EXACT
- LOCATION OF EQUIPMENT AND POINT OF CONNECTION TO EXISTING AS REQUIRED.

  11. CONTRACTOR SHALL BE RESPONSIBLE FOR DISASSEMBLY AND CUTTING OF ALL EQUIPMENT/MATERIAL TO ALLOW FOR
- REMOVAL FROM SITE.

  12. CONTRACTOR TO SEAL ALL PIPE, CONDUIT, SUPPORTS, ETC., PENETRATIONS THROUGH ROOF FROM DEMOLITION.
- CONTRACTOR TO SEAL, WEATHERPROOF, AND MAKE GOOD ALL PENETRATIONS. REFER TO DRAWING S.01 FOR DETAIL. 13. ANY/ALL PIPING INSULATION DAMAGED NEEDS TO BE REPAIRED AND MADE GOOD.
- 14. CONTRACTOR TO UPDATE VALVE INVENTORY LIST TO ENSURE ALL VALVES THAT ARE REMOVED AS PART OF THE DEMOLITION SCOPE ARE REMOVED FROM THE VALVE INVENTORY LIST. CONTRACTOR TO COORDINATE WITH FACILITY STAFF FOR EXISTING LIST.

- REFERENCE NOTES:
- CONTRACTOR TO ISOLATE CHWS/CHWR PIPING AT ISOLATION VALVE. CONTRACTOR TO DRAIN/DISPOSE ALL CHILLED WATER FROM ISOLATION VALVE TO/FROM CHILLER. CONTRACTOR TO DEMOLISH ALL CHWS/CHWR PIPING INCLUDING VALVES, GAUGES AND ACCESSORIES TO/FROM THE CHILLER UNTIL THE ISOLATION VALVE. CONTRACTOR TO DEMOLISH ALL CONTROL VALVES, FLOW SENSORS, ETC. INCLUDING WIRING AND ALL CONNECTIONS TO BAS. CONTRACTOR TO PROVIDE A CAP AT THE ISOLATION VALVE AND ENSURE THE ISOLATION VALVE REMAINS CLOSED.
- CONTRACTOR TO DRAIN/DISPOSE PORTION OF HEATING WATER TO/FROM CHILLER. CONTRACTOR TO DEMOLISH HWS/HWR PIPING INCLUDING GAUGES AND ACCESSORIES TO/FROM THE CHILLER AT HIGH LEVEL. CONTRACTOR TO PROVIDE AND INSTALL NEW ISOLATION VALVE AND CAP AT HIGH LEVEL AS SHOWN. CONTRACTOR TO ALSO LOCK CLOSED CONTROL VALVE AND DISCONNECT FROM BAS, AND PROVIDE A CAP AS SHOWN AT HIGH LEVEL FOR HWS/HWR PIPING.
- ONTRACTOR TO DRAIN/DISPOSE ALL CONDENSING WATER FROM COOLING TOWERS ON THE ROOF AND TO/FROM THE CHILLER. CONTRACTOR TO DEMOLISH ALL CWS/CWR PIPING INCLUDING VALVES, GAUGES, ACCESSORIES, ETC. CONTRACTOR TO DEMOLISH ALL CONTROL VALVES, FLOW SENSORS, ETC., INCLUDING WIRING AND CONNECTION TO BAS. CONTRACTOR TO PATCH ROOF WITH WEATHERPROOFING FOR ALL PIPE PENETRATIONS BEING DEMOLISHED AND MAKE GOOD (REFER TO DRAWING S.01).
- (4) CONTRACTOR TO DRAIN/DISPOSE ALL FLUIDS SAFELY FROM THE CHILLER. CONTRACTOR TO DISCONNECT CHILLER FROM POWER AND MAKE SAFE. CONTRACTOR TO DEMOLISH CHILLER INCLUDING ALL CONTROL PANELS, POWER, ETC., INTO PARTS, AND TRANSPORT CHILLER OUT OF THE ROOM IN PARTS.
- (5) CONTRACTOR TO DRAIN/DISPOSE ALL CONDENSING WATER FROM PUMPS. CONTRACTOR TO DISCONNECT PUMPS FROM POWER AND MAKE SAFE. CONTRACTOR TO DEMOLISH PUMPS AS SHOWN, INCLUDING ALL PIPING, VALVES, GAUGES, SUPPORTS, ACCESSORIES.

- CONTRACTOR TO ISOLATE DCW PIPING AT ISOLATION VALVES IN MECHANICAL ROOM. CONTRACTOR TO DRAIN/DISPOSE OF ALL DCW FROM ISOLATION VALVES TO/FROM COOLING TOWERS. CONTRACTOR TO DEMOLISH DCW PIPING INCLUDING GAUGES, REGULATORS, AND ACCESSORIES TO/FROM THE COOLING TOWERS UNTIL THE ISOLATION VALVE. CONTRACTOR TO PROVIDE A CAP AT THE ISOLATION VALVES AND ENSURE THE ISOLATION VALVES REMAIN CLOSED. CONTRACTOR TO PATCH ROOF WITH WEATHERPROOFING FOR ALL PIPE PENETRATIONS BEING DEMOLISHED AND MAKE GOOD (REFER TO DRAWING S.01).
- (7) CONTRACTOR TO DEMOLISH ALL CONDENSING WATER DISCHARGE PIPE FED TO THE MECHANICAL ROOM'S FLOOR DRAIN FROM THE COOLING TOWERS ON THE ROOF. CONTRACTOR TO PATCH ROOF WITH WEATHERPROOFING FOR THE PIPE PENETRATION BEING DEMOLISHED AND MAKE GOOD (REFER TO DRAWING S.01).
- (8) CONTRACTOR TO DRAIN/DISPOSE ALL FLUIDS SAFELY FROM THE TWO (2) COOLING TOWERS. CONTRACTOR TO DEMOLISH COOLING TOWERS WITH ALL ASSOCIATED PIPING, VALVES, ACCESSORIES, AND SAFELY REMOVE FROM THE ROOF. CONTRACTOR TO DISCONNECT POWER FROM COOLING TOWERS AND MAKE SAFE. CONTRACTOR TO REMOVE COOLING TOWER SUPPORT/STANDS, ENSURING ALL PENETRATIONS THROUGH THE ROOF FROM THE STAND IS PATCHED/WEATHERPROOFED AND MAKE GOOD (REFER TO DRAWING S.01).
- (9) CONTRACTOR TO DEMOLISH/REMOVE CHWR ENERGY METER, INCLUDING ALL RELAYS/POINTS ASSOCIATED WITH THE METER. CONTRACTOR TO ALLOW FOR REMOVAL OF POINTS/GRAPHICS ON THE BAS. CONTRACTOR TO ALLOW FOR RE-PROGRAMMING AS REQUIRED. CONTRACTOR TO ENSURE ALL REMAINING CONTROLS NOT ASSOCIATED TO THIS EQUIPMENT REMAIN IN PLACE AND ARE OPERATIONAL AS INTENDED.
- HOUSEKEEPING PADS TO REMAIN FOR THE CHILLER AND PUMPS. CONTRACTOR TO HIGHLIGHT/PAINT THE EDGE OF THE ENTIRE CURB OF THE HOUSEKEEPING PADS YELLOW TO PREVENT TRIPPING HAZARDS.



Colliers Project Leaders

3	ISSUED FOR TENDER	2025/04/11
2	ISSUED FOR 99% SUBMISSION	2025/03/19
1	ISSUED FOR 33% SUBMISSION	2025/01/31

Orientation



The Contractor shall check and verify all dimensions and reportal errors and omissions to the IO—Owner's/MBS Designee (as applicable) for his/her written direction before proceeding with the Work.



A Detail No

B Sheet No where detailed





ABSORPTION CHILLER DECOMMISSIONING

ORILLIA, ON L3V 7V3

Building No. B25370

INFRASTRUCTURE ONTARIO

DETAILS

	Scale N.T.S.	Project Start Date 20241119
ТН	Drawn by P.P.	Substantial Performance Date TBD
<b>=</b>	Designed by P.P.  Approved by Floor No	Drawing No
	R.V. ####	

CADD File NAME 24279-M

594x841mm

# GENERAL NOTES:

1. THESE GENERAL NOTES APPLY TO ALL DRAWINGS.

MANAGEMENT AND OTHER TRADES.

DEBORTOLI PROJECTS)

- CONTRACTOR SHALL CONDUCT A SITE REVIEW PRIOR TO PRICING TO BECOME FAMILIAR WITH THE SITE CONDITIONS. VERIFY ALL LOCATIONS, SIZES, AND CONNECTIONS ON SITE AND REPORT ANY DISCREPANCIES TO THE CONSULTANT WITH PROPOSED RESOLUTION AND OBTAIN CONSULTANT'S APPROVAL.
- ALL EXISTING SERVICES THAT ARE NOT SHOWN ON THE DRAWINGS AND ARE EXPOSED DURING DEMOLITION/CONSTRUCTION SHALL BE VERIFIED BY THE CONTRACTOR AS TO THE SOURCE AND ROUTING AND SHALL BE REPORTED TO THE CONSULTANT WITH PROPOSED
- ALL BASE BUILDING SERVICES NOT IN SCOPE ARE TO REMAIN ON AND INTACT DURING THE DURATION OF WORK. WIRING, CONDUIT, AND EQUIPMENT REQUIRED TO MAINTAIN SERVICE SHALL BE TEMPORARILY SUPPORTED, RE-ROUTED, SERVICED, OR RELOCATED AS REQUIRED. ANY LOSS OF SERVICES TO EXISTING BASE BUILDING OUTSIDE OF SCOPE OF WORK SHALL BE COORDINATED WITH LANDLORD, FACILITY MANAGEMENT.
- 5. ALL EQUIPMENT AND DEVICES SHOWN ARE APPROXIMATE LOCATIONS. EXACT LOCATIONS AND MOUNTING HEIGHTS SHALL BE COORDINATED ON SITE WITH OTHER TRADES AND
- 6. SEAL AND FIRESTOP ALL WALL, FLOOR, AND ROOF PENETRATIONS THROUGH FIRE RATED
- COORDINATE ALL ELECTRICAL WORK AND SHUTDOWNS WITH LANDLORD, FACILITY
- 8. MAKE GOOD ALL SURFACES, INCLUDING CORE HOLES FROM DEMOLISHED OR RELOCATED EQUIPMENT/DEVICES, AFTER COMPLETION OF WORK.
- 9. ALL MATERIALS SHALL BE DISPOSED IN ACCORDANCE WITH ALL APPLICABLE REGULATIONS. 10. COORDINATE ALL WORK TO SUIT PROJECT PHASE SCHEDULE. COORDINATE PHASING WITH
- ARCHITECT/INTERIOR DESIGNER/GC'S DRAWINGS. 11. ALL ELECTRICAL BACK BOXES SHALL BE WRAPPED WITH ACOUSTIGUARD PUTTY PADS (JOHN

ABBREVIATIONS		
ABB.	DESCRIPTION	
BAS	BUILDING AUTOMATION SYSTEM	
CTE	CONNECT TO EXISTING	
ER	EXISTING TO BE REMOVED	
Е	EXISTING TO REMAIN	
GFI	GROUND FAULT CIRCUIT INTERRUPTER	
GND	BONDING CONDUCTOR CONNECTED TO BUILDING GROUND	
N	NEW TO BE PROVIDED	
RL	EXISTING DEVICE/EQUIPMENT IN RELOCATED POSITION	
RR	REMOVE AND REINSTALL	
TYP	TYPICAL	
VFD	VARIABLE FREQUENCY DRIVE	
WP	WEATHERPROOF	

SINGLE LINE DIAGRAM LEGEND		
SYMBOL	DESCRIPTION	
	NEW WORK	
	EXISTING TO REMAIN	
<del></del>	EXISTING TO BE DEMOLISHED	
<b>—</b>	START SWITCH	
	STOP SWITCH	
<b>—</b>	CIRCUIT BREAKER	
<b>→</b> •     ·	LIGHTING ARRESTOR	
<b>→</b>	SWITCH AND FUSE UNIT	
_• <b>*</b> *•	FUSIBLE HIGH VOLTAGE ISOLATION SWITCH	
	TRANSFORMER	
	TRANSFORMER - ELECTROSTATIC SHIELD	

POW	/ER AND SYSTEMS LEGEND
	DESCRIPTION NEW WORK
	EXISTING TO REMAIN
<del></del>	EXISTING TO BE DEMOLISHED
$\triangle$	DATA OUTLET
	DATA OUTLET - FLOOR MOUNTED
	TELEPHONE OUTLET
$\Delta$	COMBINATION TELEPHONE & DATA OUTLET
	COMBINATION TELEPHONE & DATA OUTLET - FLOOR MOUNTED
•	COMBINATION TELEPHONE & DATA OUTLET - CEILING MOUNTED
	COMBINATION POWER & COMMUNICATION FLOOR OUTLET BOX - SURFACE MOUNTED
	COMBINATION POWER & COMMUNICATION FLOOR
F F	OUTLET BOX - FLUSH MOUNTED
	COMBINATION POWER & COMMUNICATION POKE-THRU TYPE FLOOR OUTLET BOX - FLUSH MOUNTED
<b>†</b>	TELEVISION OUTLET
DW	DISHWASHER OUTLET
WH	WATER HEATER OUTLET
×	GENERAL OUTLET X = TYPE
	GENERAL OUTLET - FLOOR MOUNTED X = TYPE
O _X	GENERAL OUTLET - CEILING MOUNTED X = TYPE
Ф	SINGLE RECEPTACLE
	SINGLE RECEPTACLE - FLOOR MOUNTED
$\Box$	SINGLE RECEPTACLE - CEILING MOUNTED
$\Box$	DUPLEX RECEPTACLE
	DUPLEX RECEPTACLE - FLOOR MOUNTED
$\Box$	DUPLEX RECEPTACLE - CEILING MOUNTED
•	DUPLEX RECEPTACLE - C/W ISOLATED GROUND
	DUPLEX RECEPTACLE - 5-20R (T-SLOT)
<b>—</b>	SPLIT WIRED DUPLEX RECEPTACLE
	GFI DUPLEX RECEPTACLE
	GFI DUPLEX RECEPTACLE - 5-20R (T-SLOT)
	QUADRUPLEX RECEPTACLE
	QUADRUPLEX RECEPTACLE - FLOOR MOUNTED
	QUADRUPLEX RECEPTACLE - CEILING MOUNTED
•	QUADRUPLEX RECEPTACLE - C/W ISOLATED GROUND
$\square_{F}$	SYSTEMS FURNITURE BASE FEED - FLOOR
$\square_{w}$	SYSTEMS FURNITURE BASE FEED - WALL
$\square_{SP}$	SYSTEMS FURNITURE BASE FEED - SERVICE POLE
	SYSTEMS FURNITURE BASE FEED - WIREMOLD
	CONNECTRAC RACEWAY
lueble	WIREMOLD RACEWAY C/W POWER RECEPTACLE & COMBINATION OUTLET
<u> </u>	MOTOR CONNECTION
T THE	NON-FUSED DISCONNECT SWITCH
	FUSED DISCONNECT SWITCH
T	THERMOSTAT
	DIRECT CONNECTION TO EQUIPMENT AS NOTED
	ELECTRIC BASEBOARD HEATER
	PANEL - SURFACE MOUNTED
	PANEL - FLUSH MOUNTED
•	PUSH BUTTON SWITCH
JH	JUNCTION BOX - WALL MOUNTED
(J)	JUNCTION BOX - CEILING MOUNTED
[I]	JUNCTION BOX - FLOOR MOUNTED

SYMBOL	DESCRIPTION
	NEW WORK
	EXISTING TO REMAIN
<del></del>	EXISTING TO BE DEMOLISHED
SD	SMOKE DETECTOR - CEILING MOUNTED
HD	HEAT DETECTOR - CEILING MOUNTED
	FIRE ALARM BELL
X	FIRE ALARM HORN
	FIRE ALARM HORN AND STROBE DEVICE
	FIRE ALARM MANUAL PULL STATION
S	FIRE ALARM EVACUATION SPEAKER - CEILING MOUNTED
SH	FIRE ALARM EVACUATION SPEAKER - WALL MOUNTED
S	FIRE ALARM SPEAKER/STROBE COMBINATION - CEILING MOUNTED
S	FIRE ALARM SPEAKER/STROBE COMBINATION - WALL MOUNTED
ST)	FIRE ALARM STROBE - CEILING MOUNTED
ST	FIRE ALARM STROBE - WALL MOUNTED
SA	SMOKE ALARM/STROBE COMBINATION - CEILING MOUNTED
SA	SMOKE ALARM/STROBE COMBINATION - WALL MOUNTED
SD	DUCT MOUNTED SMOKE DETECTOR
FS	FLOW SWITCH
SV	SUPERVISED VALVE
Н	FIREMAN'S HANDSET



3	ISSUED	FOR	TEND		2025/04/11
<u>)</u>	ISSUED	FOR	99%	SUBMISSION	2025/03/19
	ISSUED	FOR	33%	SUBMISSION	2025/01/31
	Revisions				Date



The Contractor shall check and verify all dimensions and report all errors and omissions to the IO-Ówner's/MBS Designee (as applicable) for his/her written direction before proceeding with the Work.



B Sheet No where detailed





# Infrastructure Ontario

Building No B25370


ABSORPTION CHILLER DECOMMISSIONING

777 MEMORIAL AVENUE,
ORILLIA, ON L3V 7V3 230467-274385 N06689

INFRASTRUCTURE ONTARIO

GENERAL NOTES, LEGENDS, SCHEDULES

Scale N.T.S.	Project Start Date 20241119
Drawn by C.S.	Substantial Performance Date TBD
Designed by C.S.	Drawing No
Approved by Floor No R.M	
	CADD File NAME <b>24279-M</b>

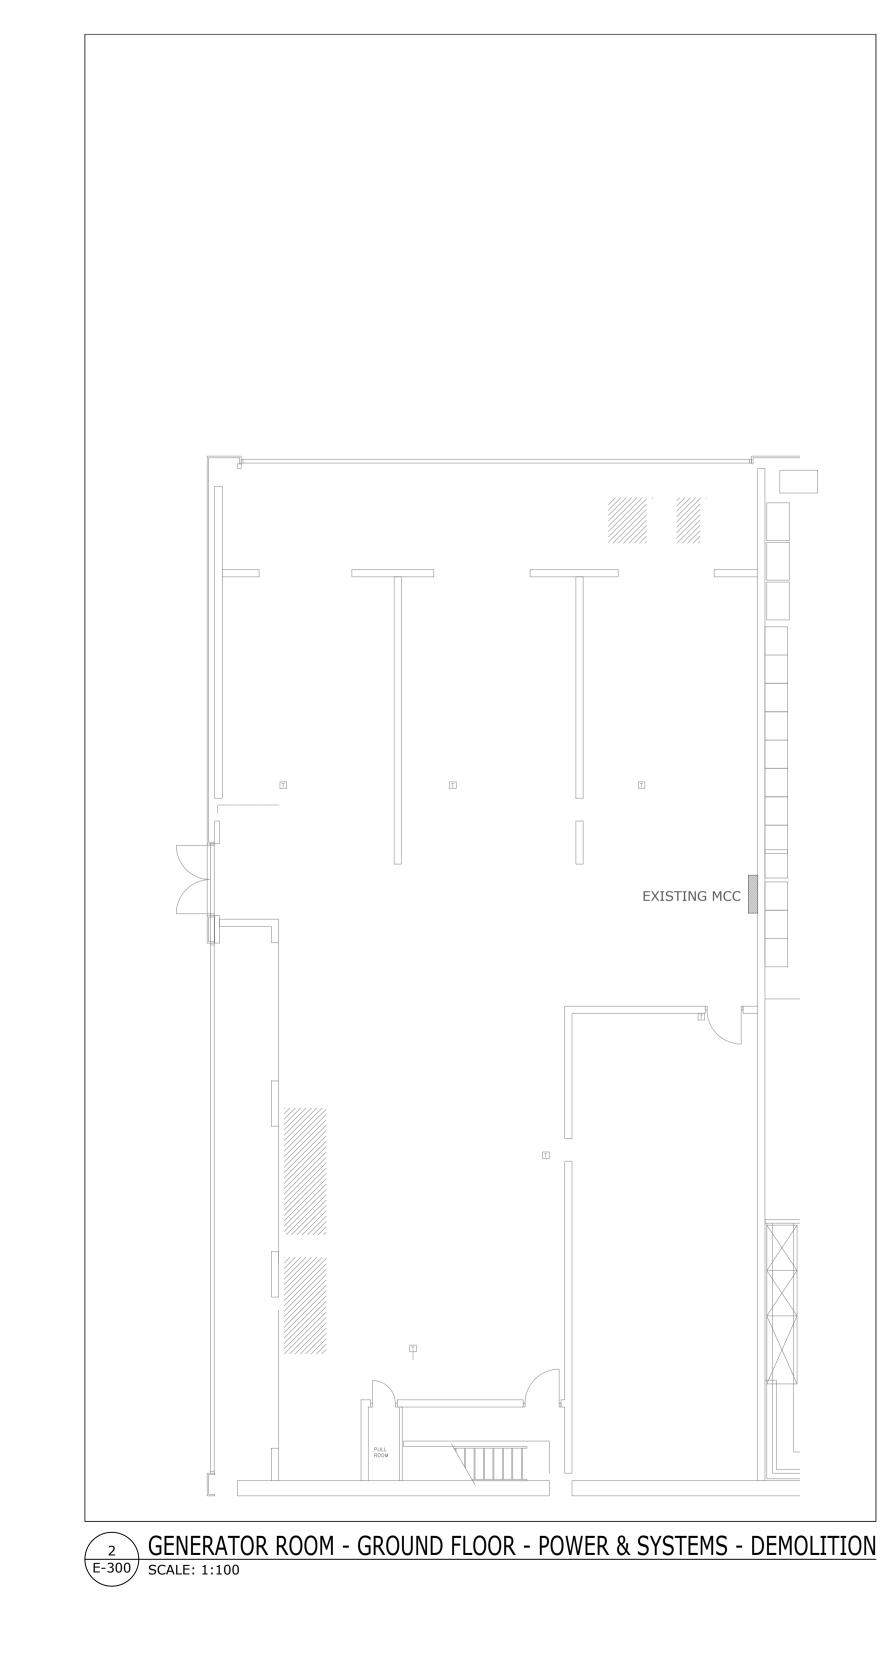

XXXX

XX XX XX

CDP-001

CDP-002

(MCC REFERENCE P-3)

(MCC REFERENCE P-4)

MECHANICAL ROOM - GROUND FLOOR - POWER & SYSTEMS - DEMOLITION
SCALE: 1:50

# DEMOLITION - GENERAL NOTES:

- 1. THESE GENERAL NOTES APPLY TO ALL DEMO DRAWINGS.
- 2. REMOVE ALL WIRING, CONDUITS, EQUIPMENT, AND DEVICES NOT REQUIRED, TO SUIT NEW LAYOUT AND MAKE SAFE. THIS INCLUDES, BUT IS NOT LIMITED TO, REMOVING WIRING AND CONDUIT BACK TO MCC OR SIMILAR POWER SOURCE.
- 3. REMOVE FLOOR MONUMENTS AND CUT BACK ALL ASSOCIATED CONDUIT AND WIRING BACK TO SOURCE. MAKE GOOD ALL FLOOR PENETRATIONS.
- 4. ENSURE ALL EXISTING FIRE ALARM CIRCUITS REMAIN AND ARE MADE SAFE FOR USE DURING THE CONSTRUCTION PHASE.
- 5. ENSURE ALL EXISTING EMERGENCY LIGHTING CIRCUITS AND EXIT LIGHTING CIRCUITS REMAIN AND ARE MADE SAFE FOR USE DURING THE CONSTRUCTION
- 6. CONTRACTOR TO KEEP EXISTING BREAKERS LOCATED IN EXISTING MCC AND RENAME THEM TO "SPARE".


# REFERENCE NOTES:


ALL HIGH VOLTAGE POWER (120V OR HIGHER) TO BE DEMOLISHED FROM CONTROLLER PANEL.



Colliers Project Leaders

3	ISSUED FOR TENDER	2025/04/11
2	ISSUED FOR 99% SUBMISSION	2025/03/19
1	ISSUED FOR 33% SUBMISSION	2025/01/31

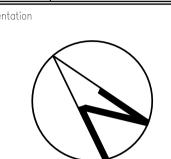

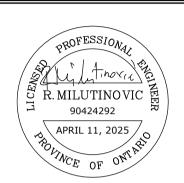

The Contractor shall check and verify all dimensions and report all errors and omissions to the IO-Ówner's/MBS Designee (as applicable) for his/her written direction before proceeding with the Work.



B Sheet No where detailed





ABSORPTION CHILLER DECOMMISSIONING

777 MEMORIAL AVENUE, ORILLIA, ON L3V 7V3 230467-274385 NO6689

Building No B25370

INFRASTRUCTURE ONTARIO


MECHANICAL AND GENERATOR ROOMS - POWER & SYSTEMS - DEMO

AS NOTED		Project Start Date 20241119
Drawn by C.S.		Substantial Performance Date TBD
Designed by C.S.		Drawing No
Approved by R.M.	Floor No O1 & M1	

GENERAL NOTES:

THESE GENERAL NOTES APPLY TO ALL DEMO DRAWINGS.

- 2. REMOVE ALL WIRING, CONDUITS, EQUIPMENT, AND DEVICES NOT REQUIRED, TO SUIT NEW LAYOUT AND MAKE SAFE. THIS INCLUDES, BUT IS NOT LIMITED TO, REMOVING WIRING AND CONDUIT BACK TO MCC OR SIMILAR POWER SOURCE.
- 3. REMOVE ROOF MONUMENTS AND CUT BACK ALL ASSOCIATED CONDUIT AND WIRING BACK TO SOURCE. MAKE GOOD ALL ROOF PENETRATIONS (REFER TO S.01).
- 4. ENSURE ALL EXISTING FIRE ALARM CIRCUITS REMAIN AND ARE MADE SAFE FOR USE DURING THE CONSTRUCTION PHASE.
- 5. ENSURE ALL EXISTING EMERGENCY LIGHTING CIRCUITS AND EXIT LIGHTING CIRCUITS REMAIN AND ARE MADE SAFE FOR USE DURING THE CONSTRUCTION PHASE.
- 6. CONTRACTOR TO KEEP EXISTING BREAKERS LOCATED IN EXISTING MCC AND RENAME THEM TO "SPARE".

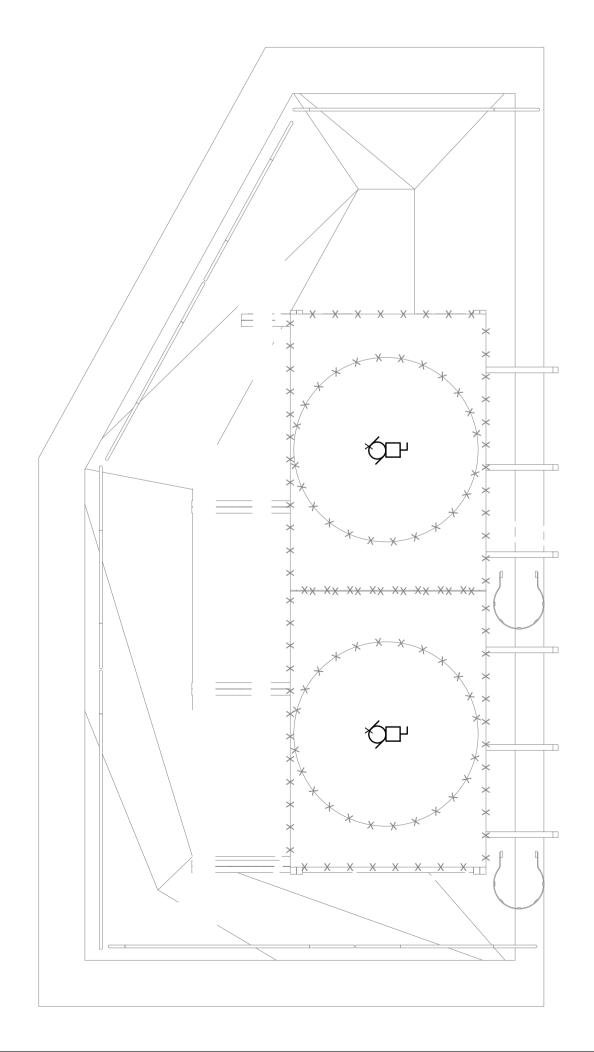


1 MECHANICAL ROOM - ROOF - DEMOLITION SCALE: 1:50



Colliers Project Leaders

3	ISSUED FOR TENDER	2025/04/11
2	ISSUED FOR 99% SUBMISSION	2025/03/19
1	ISSUED FOR 33% SUBMISSION	2025/01/31
	5	5 .



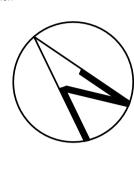



The Contractor shall check and verify all dimensions and report all errors and omissions to the IO-Owner's/MBS Designee (as applicable) for his/her written direction before proceeding with the Work.



\ Detail No

B Sheet No where detailed





Ministry PSIF Num

ABSORPTION CHILLER DECOMMISSIONING

777 MEMORIAL AVENUE, ORILLIA, ON L3V 7V3

OPROJECT NO 230467-274385 NO6689

Building No B25370

INFRASTRUCTURE ONTARIO

MECHANICAL ROOM — ROOF — POWER & SYSTEMS — DEMO

Scale 1:50	Project Start Date 20241119
Drawn by C.S.	Substantial Performance Date TBD
Designed by C.S.	Drawing No 7 /
Approved by Floor No R.M. RF	
	CADD File NAME 24279-M

594x841m

# DRAWING NOTES

- 1. ALL DIMENSIONS ARE IN MILLIMETRES U.N.O.
- DRAWINGS ARE NOT TO BE SCALED. CONTRACTOR TO REFERENCE DIMENSIONS GIVEN ON DRAWINGS.
- 3. FEATURES OF CONSTRUCTION NOT FULLY SHOWN ARE OF THE SAME CHARACTER AS THOSE NOTED FOR SIMILAR CONDITIONS.
- 4. REFER TO ELECTRICAL AND MECHANICAL DRAWINGS FOR ADDITIONAL INFORMATION AND LOCATION OF THE ROOF OPENINGS TO BE REPAIRED. CONTRACTOR TO REVIEW ALL DRAWINGS AND IN THE EVENT OF DISCREPANCY CONTACT CONSULTANTS PRIOR TO PROCEEDING WITH WORK.
- 5. ALL CODES AND STANDARDS REFERENCED IN THESE NOTES TO BE LATEST ISSUE AT TIME OF DRAWING ISSUANCE.

# **GENERAL NOTES**

- ALL NOTES HEREIN REFERRING TO 'CONTRACTOR' ARE TO MEAN THE GENERAL CONTRACTOR & SUB-CONTRACTORS.
- 2. ALL THE WORK SHALL BE CARRIED OUT IN ACCORDANCE WITH THE LATEST EDITION OF THE ONTARIO BUILDING CODE, THE OCCUPATIONAL HEALTH & SAFETY ACT, AND WITH GOOD CONSTRUCTION PRACTICE.
- 3. THE CONTRACTOR IS RESPONSIBLE TO FIELD VERIFY ALL DIMENSIONS & SITE CONDITIONS, COMPARE WITH THOSE INDICATED ON THE DRAWINGS & ADVISE THE DESIGNER OF ANY DISCREPANCY. COMMENCEMENT OF WORK SHALL BE DEEMED AS ACCEPTANCE OF SITE CONDITIONS BY THE CONTRACTOR.
- 4. DISCREPANCIES IDENTIFIED AFTER COMMENCEMENT OF THE WORK SHALL BE RECTIFIED AT THE EXPENSE OF THE CONTRACTOR & TO THE SATISFACTION OF THE CONSULTANT.

20Ø ARC SPOT WELD AT 150 o/c

**EXISTING STEEL DECK** 

EXISTING OPENING IN EXISTING STEEL DECK TO BE COVERED

300 MIN.

(TYP. ALL SIDES)

- 5. CONTRACTOR SHALL PROTECT FROM DAMAGE ALL EXISTING STRUCTURES, FINISHES, EQUIPMENT, AND PROPERTIES ADJACENT THE AREAS OF WORK. ALL DISTURBED AREAS, DAMAGED PROPERTIES AND/OR STRUCTURES SHALL BE RESTORED TO ORIGINAL CONDITION AT THE EXPENSE OF THE CONTRACTOR AND TO THE SATISFACTION OF THE CONSULTANT AND/OR OWNER.
- 6. ALL SERVICES ARE TO BE ACCURATELY LOCATED PRIOR TO CONSTRUCTION & ADEQUATE PROTECTION PROVIDED AT ALL TIMES. ANY INTERFERENCE TO EXISTING SERVICES OR UTILITIES WITH THE PROPOSED CONSTRUCTION OPERATIONS IS TO BE REPORTED TO THE CONSULTANT PRIOR TO THE CONTINUATION OF CONSTRUCTION.
- 7. ALL MATERIALS INDICATED ON THE DRAWINGS ARE NEW U.N.O.
- CONTRACTOR TO FOLLOW ALL MANUFACTURER'S INSTRUCTIONS &
   SPECIFICATIONS FOR MATERIALS USED TO CARRY OUT THE WORK.
- 9. THE CONSTRUCTION SCOPE OF WORK SHOWN ON THESE DRAWINGS HAS BEEN DESIGNED IN ACCORDANCE WITH ALL REQUIRED CURRENT BUILDING CODES & REGULATIONS IN THE MUNICIPALITY IN WHICH THE CONSTRUCTION IS TO OCCUR.

# STEEL NOTES

- 1. ALL WELDING SHALL CONFORM TO CSA W59 AND BE PERFORMED BY COMPANIES CERTIFIED TO CSA W47.1. ELECTRODES TO BE USED ARE E49-XX U.N.O.
- 2. DECK TO CONFORM TO ASTM-A446 GRADE A WITH ZINC COATING CLASSIFICATION OF ZF075. UNLESS NOTED. MINIMUM THICKNESS TO BE 0.91mm (20GA). ALL FIELD WELDS TO BE TOUCHED-UP WITH STANDARD ALUMINUM TOUCH-UP PAINT.

CONTRACTOR TO COVER THE OPENING AS PER THIS DETAIL

AND REINSTATE ROOF MATERIALS TO MATCH EXISTING.

2	ISSUED FOR TENDER	2025.04.04	
1	ISSUED FOR REVIEW	2025.03.13	
No	Revisions	Date	

Orientation



The Contractor shall check and verify all dimensions and report all errors and omissions to the IO—Owner's/MBS Designee (as applicable) for his/her written direction before proceeding with the Work.



A Detail No

B Sheet No where detailed



# Infrastructure Ontario

Ministry PSIF Number

Project

ABSORPTION CHILLER DECOMMISSIONING

Location
777 MEMORIAL AVENUE,
ORILLIA, ON L3V 7V3
10 Project No Site No
230467-274385 NO6689

Building No B25370

Clier

INFRASTRUCTURE ONTARIO

Drawing Title

ROOF OPENING REPAIR DETAILS

Scale	Project Start Date
AS NOTED	YYYYMMDD
Drawn by	Substantial Performance Date
KN	YYYYMMDD
Designed by JT Approved by Floor No BH	Drawing No Of 1

TYPICAL ROOF OPENING REPAIR DETAIL
Scale 1:20



NEW 20 Ga. STEEL DECK TO BE PLACED ON TOP OF EXISTING DECK (DECK PROFILE TO MATCH EXISTING)

279x432mm

01 S.01

CADD File NAME