


MONTGOMERY SISAM ARCHITECTS INC.
ARCHITECTURAL

 **CROSSEY
ENGINEERING**
A Salas O'Brien Company




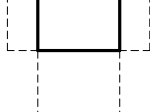
2255 Sheppard Ave East
Suite E-331
Toronto, ON M2J 4Y1
416.497.3111 www.cel.ca

CASTLEVIEW WYCHWOOD TOWERS
SENIOR SERVICES AND LONG-TERM CARE
**351 CHRISTIE ST, TORONTO,
ONTARIO M6G 3C3**



Seniors Services and Long-Term Care Division




GENERAL SYMBOLS AND ABBREVIATIONS

	<p>LINEWORK DESIGNATION</p> <p>  NEW WORK (PIPING AND DUCTWORK)  EXISTING WORK TO REMAIN  EXISTING WORK TO BE REMOVED/DEMOLISHED </p> <p>  ACCESS CLEARANCE (DASHED LINE) NOT ALL CLEARANCES ARE SHOWN ON DRAWINGS CONTRACTOR MUST FOLLOW MANUFACTURER RECOMMENDED CLEARANCES IF NOT SHOWN </p>
<p>(XXX-000)</p> <p>(FFE-000)</p>	<p>XX - DENOTES EQUIPMENT ABBREVIATION (SEE THE LIST BELOW)</p> <p>000 - DENOTES THE UNIT NUMBER</p> <p>XX - DENOTES FLOW FLOW HEATER ABBREVIATION (SEE THE LIST BELOW)</p> <p>000 - DENOTES THE UNIT NUMBER</p>
	<p>GENERAL ABBREVIATIONS</p>
<p>C/W CTE DIA EX</p>	<p>COMPLETE WITH CONNECT TO EXISTING DIAMETER EXISTING</p>

MECHANICAL EQUIP. ABBREVIATIONS

	MECHANICAL EQUIPMENT ABBREVIATIONS
FFE	FORCE FLOW HEATER - ELECTRIC

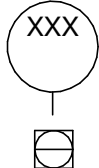

VALVES & SPECIALTIES LEGEND

	PIPING LINEWORK DESIGNATION
—XXX—	PIPE LINE, WHERE XXX - DENOTES PIPING SYSTEM ABBREVIATION
— — —	DENOTES RETURN PIPING SYSTEM
-----	VENT
	SYMBOLS
—  —	ISOLATION VALVE
—  —	BALANCING VALVE
	PIPING ACCESSORY ABBREVIATIONS
AAV	AUTOMATIC AIR VENT
	PIPING CONTROL TAGS
	XXX - DENOTES PIPING CONTROL ABBREVIATION (SEE THE LIST BELOW) CONTROL POINT




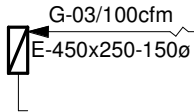





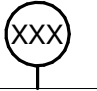
PLUMBING LEGEND

	PLUMBING PIPE LINEWORK DESIGNATION
-----	BURIED SANITARY/STORM DRAIN
— — — — —	DOMESTIC COLD WATER
— — — — —	DOMESTIC HOT WATER
— — — — —	DOMESTIC HOT WATER RECIRC.
	PLUMBING FIXTURE AND ELEMENT ABBREVIATIONS
AD	AREA DRAIN
B	BIDET
BT	BATH TUB
DF	DRINKING FOUNTAIN
EW	EYE WASH
EWSS	EYEWASH AND SAFETY SHOWER
FD	FLOOR DRAIN
FFD	FUNNEL FLOOR DRAIN
JS	JANITORY SINK
HD	HUB DRAIN
HB	HOSE BIB
L	LAVATORY
S	SINK
SH	SHOWER
TD	TRENCH DRAIN
TSP	TRAP SEAL PRIMER
U	URINAL
WB	WASHER BOX
WC	WATER CLOSET

FIRE PROTECTION LEGEND

	<p>SYMBOLS</p> <p> RECESSED FIRE EXTINGUISHER c/w CABINET</p> <p>● PENDENT SPRINKLER HEAD</p> <p>●_D PENDENT DRY SPRINKLER HEAD</p> <p>⊙ CONCEALED SPRINKLER HEAD</p> <p>◐ RECESSED SPRINKLER HEAD</p> <p>◐_D RECESSED DRY SPRINKLER HEAD</p> <p>○ UPRIGHT SPRINKLER HEAD</p> <p>◻ UPRIGHT SPRINKLER HEAD ON DRY SYSTEM</p> <p>○_D UPRIGHT DRY SPRINKLER HEAD</p> <p>▽ SIDEWALL SPRINKLER HEAD</p> <p>▽_D DRY PENDENT HORIZONTAL SPRINKLER HEAD</p> <p> FIRE HYDRANT (PUMPER TYPE) C/W VALVE</p> <p>ELEMENT ABBREVIATIONS</p>
FE	FIRE EXTINGUISHER

VENTILATION LEGEND
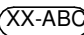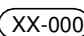
<p>SYMBOLS</p>	
   	<p>EXHAUST AIR DUCT (IN SECTION)</p> <p>SQUARE DIFFUSER</p> <p>OPEN-ENDED BELLMOUTH DUCT c/w VOLUME DAMPER AND 10 mm X 10 mm PROTECTIVE MESH</p> <p>GRILLE/DIFFUSER TAG EXAMPLE, WHERE</p> <p>Arrow - DENOTES AIR FLOW DIRECTION (TO/FROM GRILLE) G - DENOTES ELEMENT ABBREVIATION - GRILLE/DIFFUSER 03 - DENOTES GRILLE/DIFFUSER SEQUENTIAL NUMBER "G-03" REPRESENTS UNIQUE ELEMENT IDENTIFIER 100cfm - DENOTES AIR FLOW RATE E - DENOTES GRILLE/DIFFUSER TYPE 450x250 - DENOTES GRILLE/DIFFUSER SIZE 150ø - DENOTES DIFFUSER NECK SIZE</p>
   	<p>XX - DENOTES HVAC ACCESSORY ABBREVIATION (SEE THE LIST BELOW)</p> <p>ABC - DENOTES HVAC ACCESSORY TYPE</p> <p>000 - DENOTES HVAC ACCESSORY NUMBER</p>
<p>HVAC CONTROL SYMBOLS</p>	
 	<p>CEILING MOUNTED HVAC CONTROL ELEMENT</p> <p>WALL MOUNTED HVAC CONTROL ELEMENT</p> <p>XXX - DENOTES HVAC CONTROL ABBREVIATION (SEE THE LIST BELOW)</p>
<p>DUCT SHAPE DESIGNATIONS</p>	
<p>400X200</p> <p>400/200</p> <p>200ø</p>	<p>400(W) BY 200(H) RECTANGULAR DUCTWORK</p> <p>400(W) BY 200(H) OVAL DUCTWORK</p> <p>200 MM DIAMETER DUCT</p>

HEATING AND COOLING LEGEND

	FORCE FLOW HEATER- ELECTRIC
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DRAWING LIST				
DWG No.	DRAWING NAME	Latest Modification	Date Updated	COMMENT
MECHANICAL GENERAL				
M-001	MECHANICAL DRAWING LIST & LEGEND 1	ISSUED FOR TENDER	2024-12-16	
PHASING LAYOUT				
M-101	MECHANICAL PHASING LAYOUT 1	ISSUED FOR TENDER	2024-12-16	
M-102	MECHANICAL PHASING LAYOUT 2	ISSUED FOR TENDER	2024-12-16	
PLUMBING AND DRAINAGE				
M-201D	LEVEL 3 WASHROOM DEMOLITION PLAN	ISSUED FOR TENDER	2024-12-16	
M-201	LEVEL 3 WASHROOM EAST PROPOSED PLAN	ISSUED FOR TENDER	2024-12-16	
M-202	LEVEL 3 WASHROOM WEST PROPOSED PLAN	ISSUED FOR TENDER	2024-12-16	
FIRE PROTECTION				
M-301D	LEVEL 1 RECEPTION & LEVEL 3 WASHROOM DEMOLITION PLAN	ISSUED FOR TENDER	2024-12-16	
M-301	LEVEL 1 RECEPTION & LEVEL 3 WASHROOM PROPOSED PLAN	ISSUED FOR TENDER	2024-12-16	
HVAC DUCTWORK				
M-401D	LEVEL 3 DEMOLITION PLAN	ISSUED FOR TENDER	2024-12-16	
M-401	LEVEL 1 & LEVEL 3 PROPOSED PLAN	ISSUED FOR TENDER	2024-12-16	
MECHANICAL DETAILS				
M-901	SHEET 1	ISSUED FOR TENDER	2024-12-16	

Montgomery Sisam Architects Inc.

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416.364.7723

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6	2024-12-16	ISSUED FOR TENDER	CEL
5	2024-11-08	ISSUED FOR BUILDING PERMIT	CEL
4	2024-10-10	REISSUED FOR 100%CD	CEL
3	2024-09-30	ISSUED FOR 100% CD	CEL
2	2024-09-04	ISSUED TO MSA FOR FINAL REVIEW	CEL
1	2024-08-23	ISSUED FOR DESIGN DEVELOPMENT	CEL
#	date:	revision:	by



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CASTLEVIEW
WYCHWOOD TOWERS

351 CHRISTIE ST, TORONTO, ONTARIO M6G 3C3

MECHANICAL DRAWING

LIST & LEGEND 1

scale: 1 : 100

drawn by: Author:

reviewed by: VS


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drawing number

M-001

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1 LEVEL 3 WASHROOM WEST PHASING

1 : 50

GENERAL NOTES

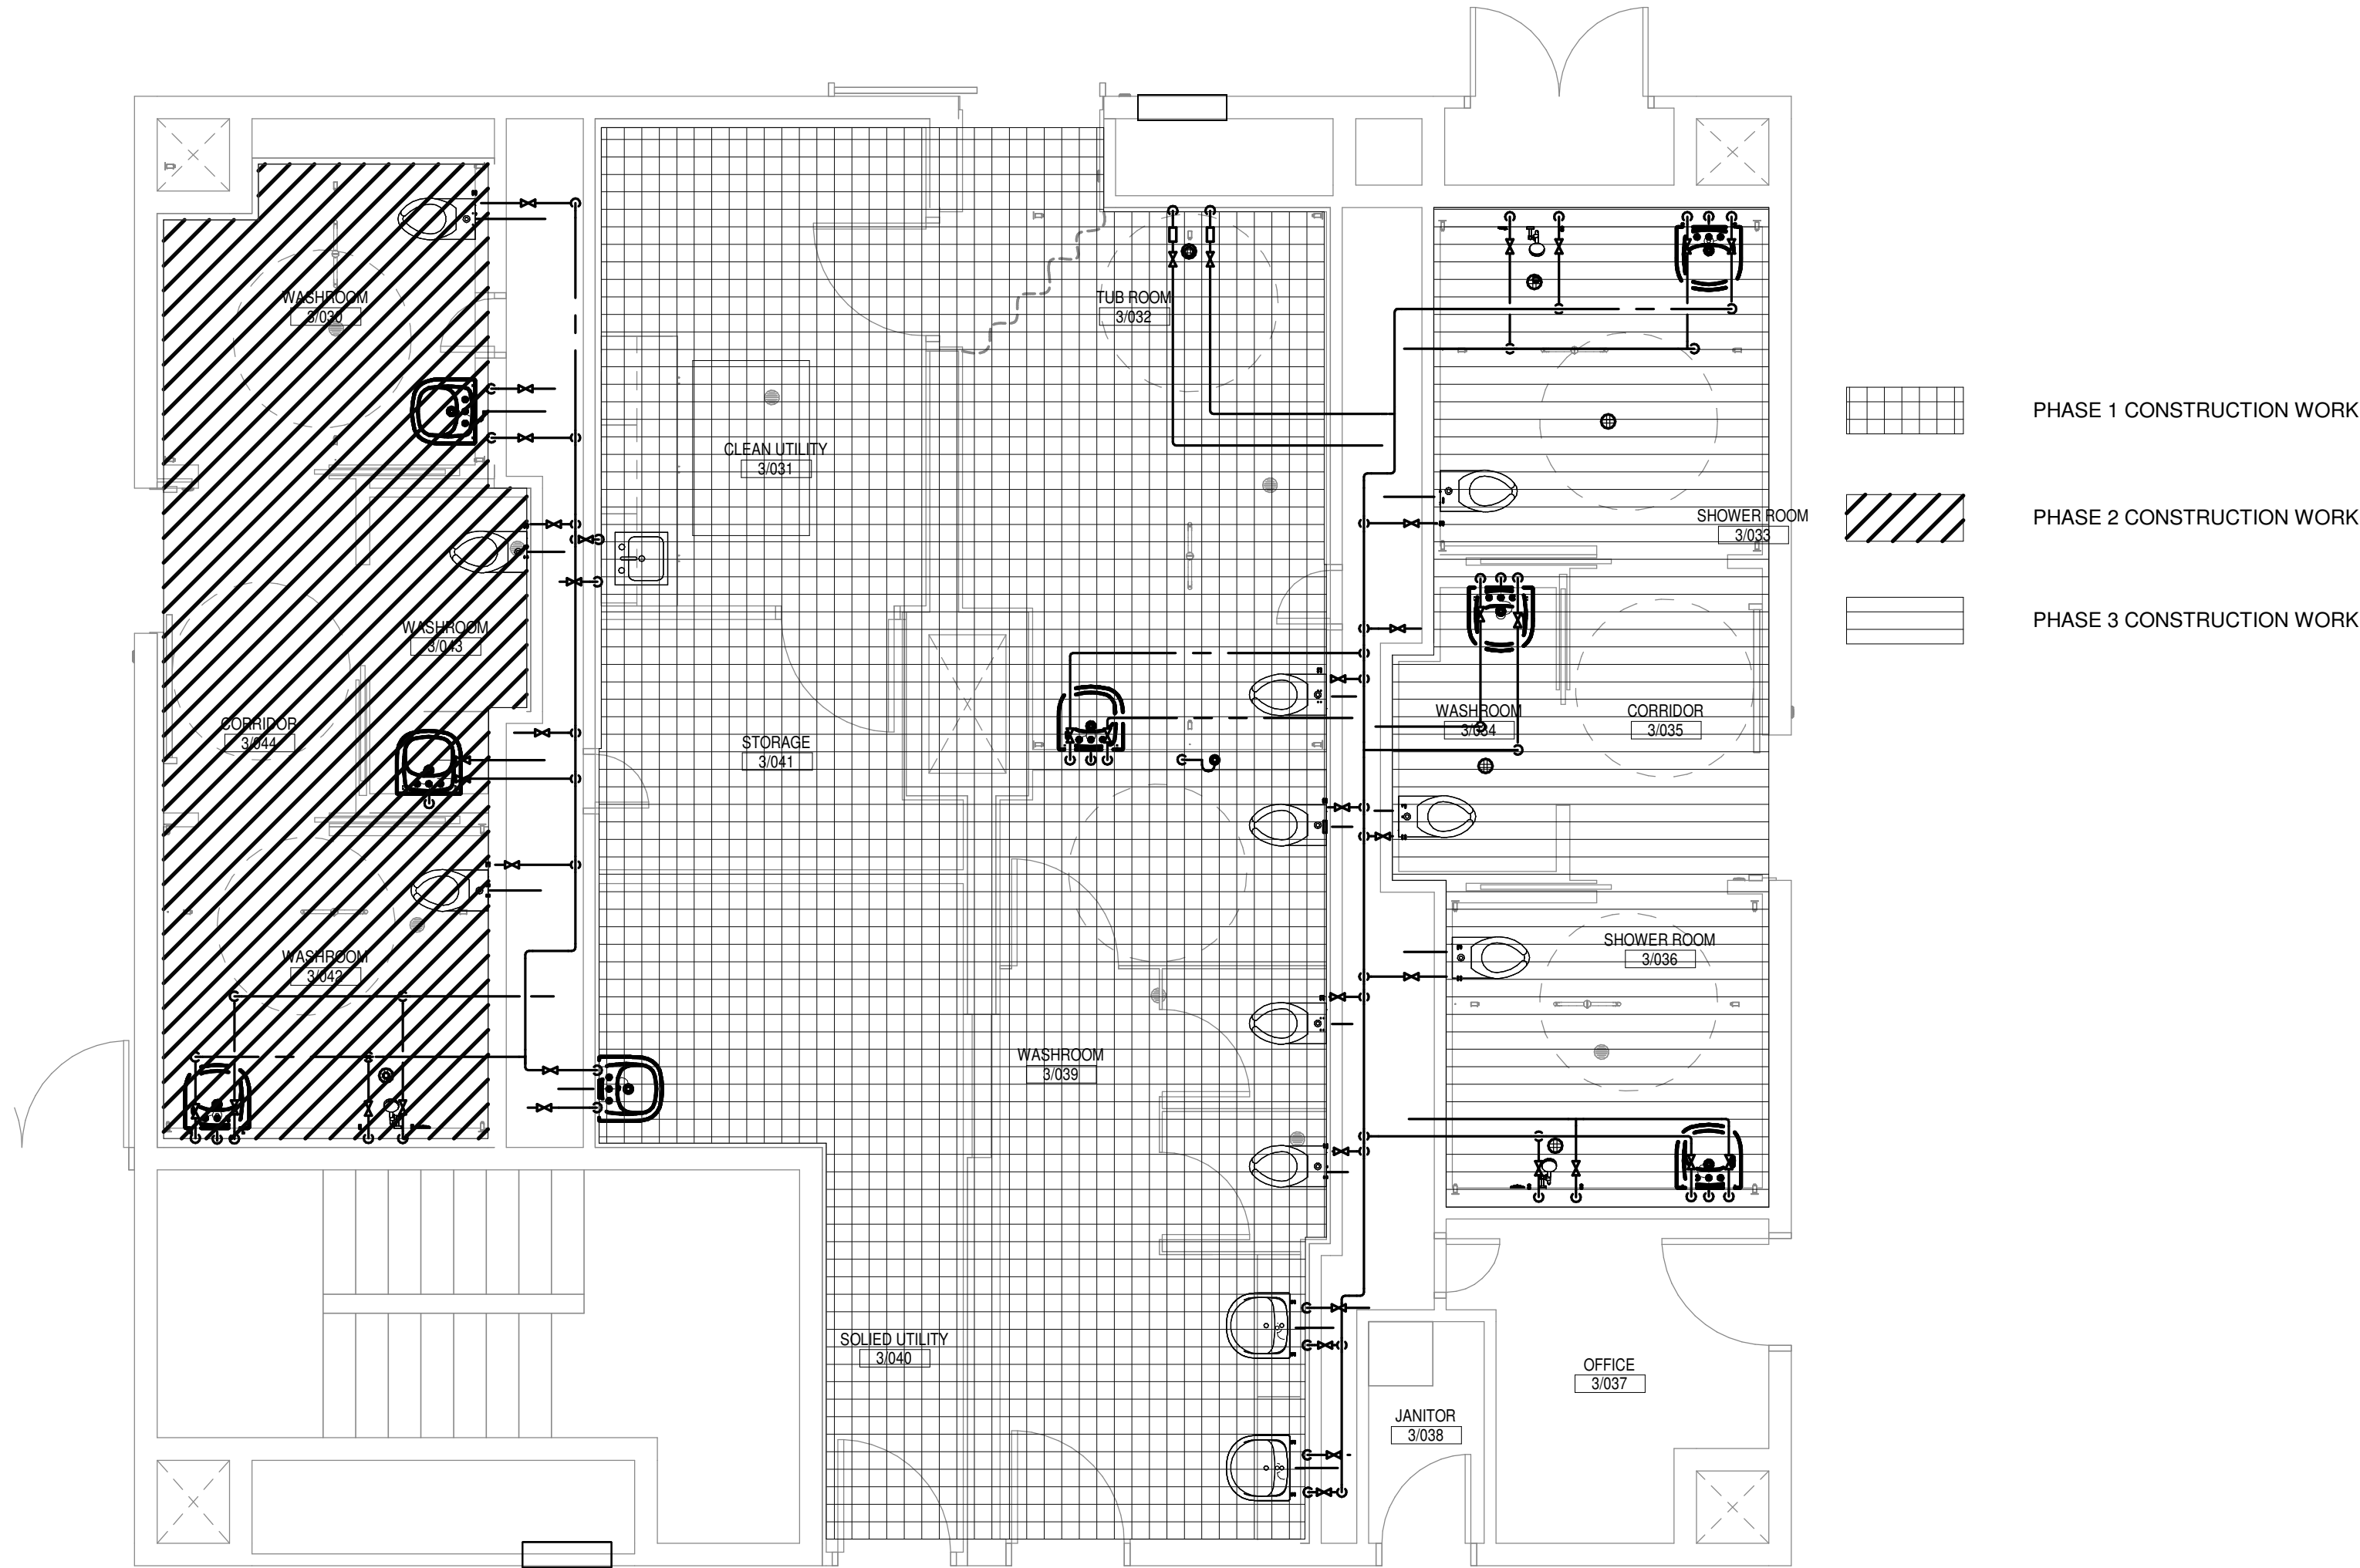- CONTRACTOR SHALL TAKE ALL MEASURES TO PROTECT THE BASE BUILDING FROM DAMAGES DURING CONSTRUCTION.
- DURING DEMOLITION FOR PHASE 2, CONTRACTOR SHALL MAKE SURE ALL PLUMBING FIXTURES, HVAC SERVICES AND FIRE PROTECTION SERVICES IN PHASE 1&3 SHALL REMAIN IN OPERATION.
- DURING DEMOLITION FOR PHASE 3, CONTRACTOR SHALL MAKE SURE ALL PLUMBING FIXTURES, HVAC SERVICES AND FIRE PROTECTION SERVICES IN PHASE 1&2 SHALL REMAIN IN OPERATION.
- DEMOLISH ALL EXISTING PLUMBING FIXTURES, HVAC SERVICES AND SPRINKLER HEADS COMPLETED WITH ALL PIPING ACCORDING TO DRAWING M-201D, M-301D AND M-401D
- FREEZE PLUMBING RISERS BEFORE COMMENCEMENT OF PHASE 1, INSTALL ISOLATION VALVES SO THAT THE BRANCH LINES FEEDING LEVEL 3 CAN BE ISOLATED WIHTOUT CAUSING REPEATED INTERRUPTION OF WATER SUPPLY TO THE BUILDING. FREEZING IS PREFERRED OVER DRAINING THE ENTIRE BUILDING, SINCE DRAINING THE BUILDING DOWN WILL CAUSE LOTS OF WATER WASTE, WILL REQUIRE HIGH LEVELS OF COORDINATION WHEN WATER IS REFILLED AND THE SYSTEM IS VETED FOR AIRLOCKS, SEVERAL BASE BUILDING SYSTEMS WILL BE AFFECTED.
- COORDINATE MECHANICAL PHASING WITH ARCHITECTURAL PHASING DWGS.
- CONTRACTOR SHALL SUBMIT A DETAILED WORK PLAN THAT DESCRIBES HOW PHASING WILL BE IMPLEMENTED.
- CONSTRUCTION ON THIRD FLOOR WILL EFFECT OPERATIONS ON SECOND FLOOR BELOW. ALL CONSTRUCTION PHASING ON THE THIRD FLOOR IS TO BE CONSIDERED CONTIGUOUS WITH THE SECOND FLOOR, AND WILL BE COMPREHENSIVELY SCHEDULED WITH THE HOME PRIOR TO START-UP ON SITE. CONTRACTOR SHALL ACCOUNT AN ALLOWANCE FOR SECOND FLOOR CEILING TO BE CUT, PATCHED AND REPAIRED TO FACILITATE PLUMBING WORK ON THIRD FLOOR.

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MontgomerySisam

CROSSEY
ENGINEERING
A Salas O'Brien Company

- PHASE 1 CONSTRUCTION WORK
- PHASE 2 CONSTRUCTION WORK
- PHASE 3 CONSTRUCTION WORK

6	2024-12-16	ISSUED FOR TENDER	CEL
5	2024-11-08	ISSUED FOR BUILDING PERMIT	CEL
4	2024-10-10	REISSUED FOR 100%CD	CEL
3	2024-09-30	ISSUED FOR 100% CD	CEL
2	2024-09-04	ISSUED TO MSA FOR FINAL REVIEW	CEL
1	2024-08-23	ISSUED FOR DESIGN DEVELOPMENT	CEL
#	date:	revision:	by
revisions			



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CASTLEVIEW
WYCHWOOD TOWERS

351 CHRISTIE ST, TORONTO, ONTARIO M6G 3C3

MECHANICAL PHASING
LAYOUT 1


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reviewed by: VS
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plot date: Issue Date

drawing number:

M-101

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1 Level 3 WASHROOM EAST PHASING
1 : 50

GENERAL NOTES

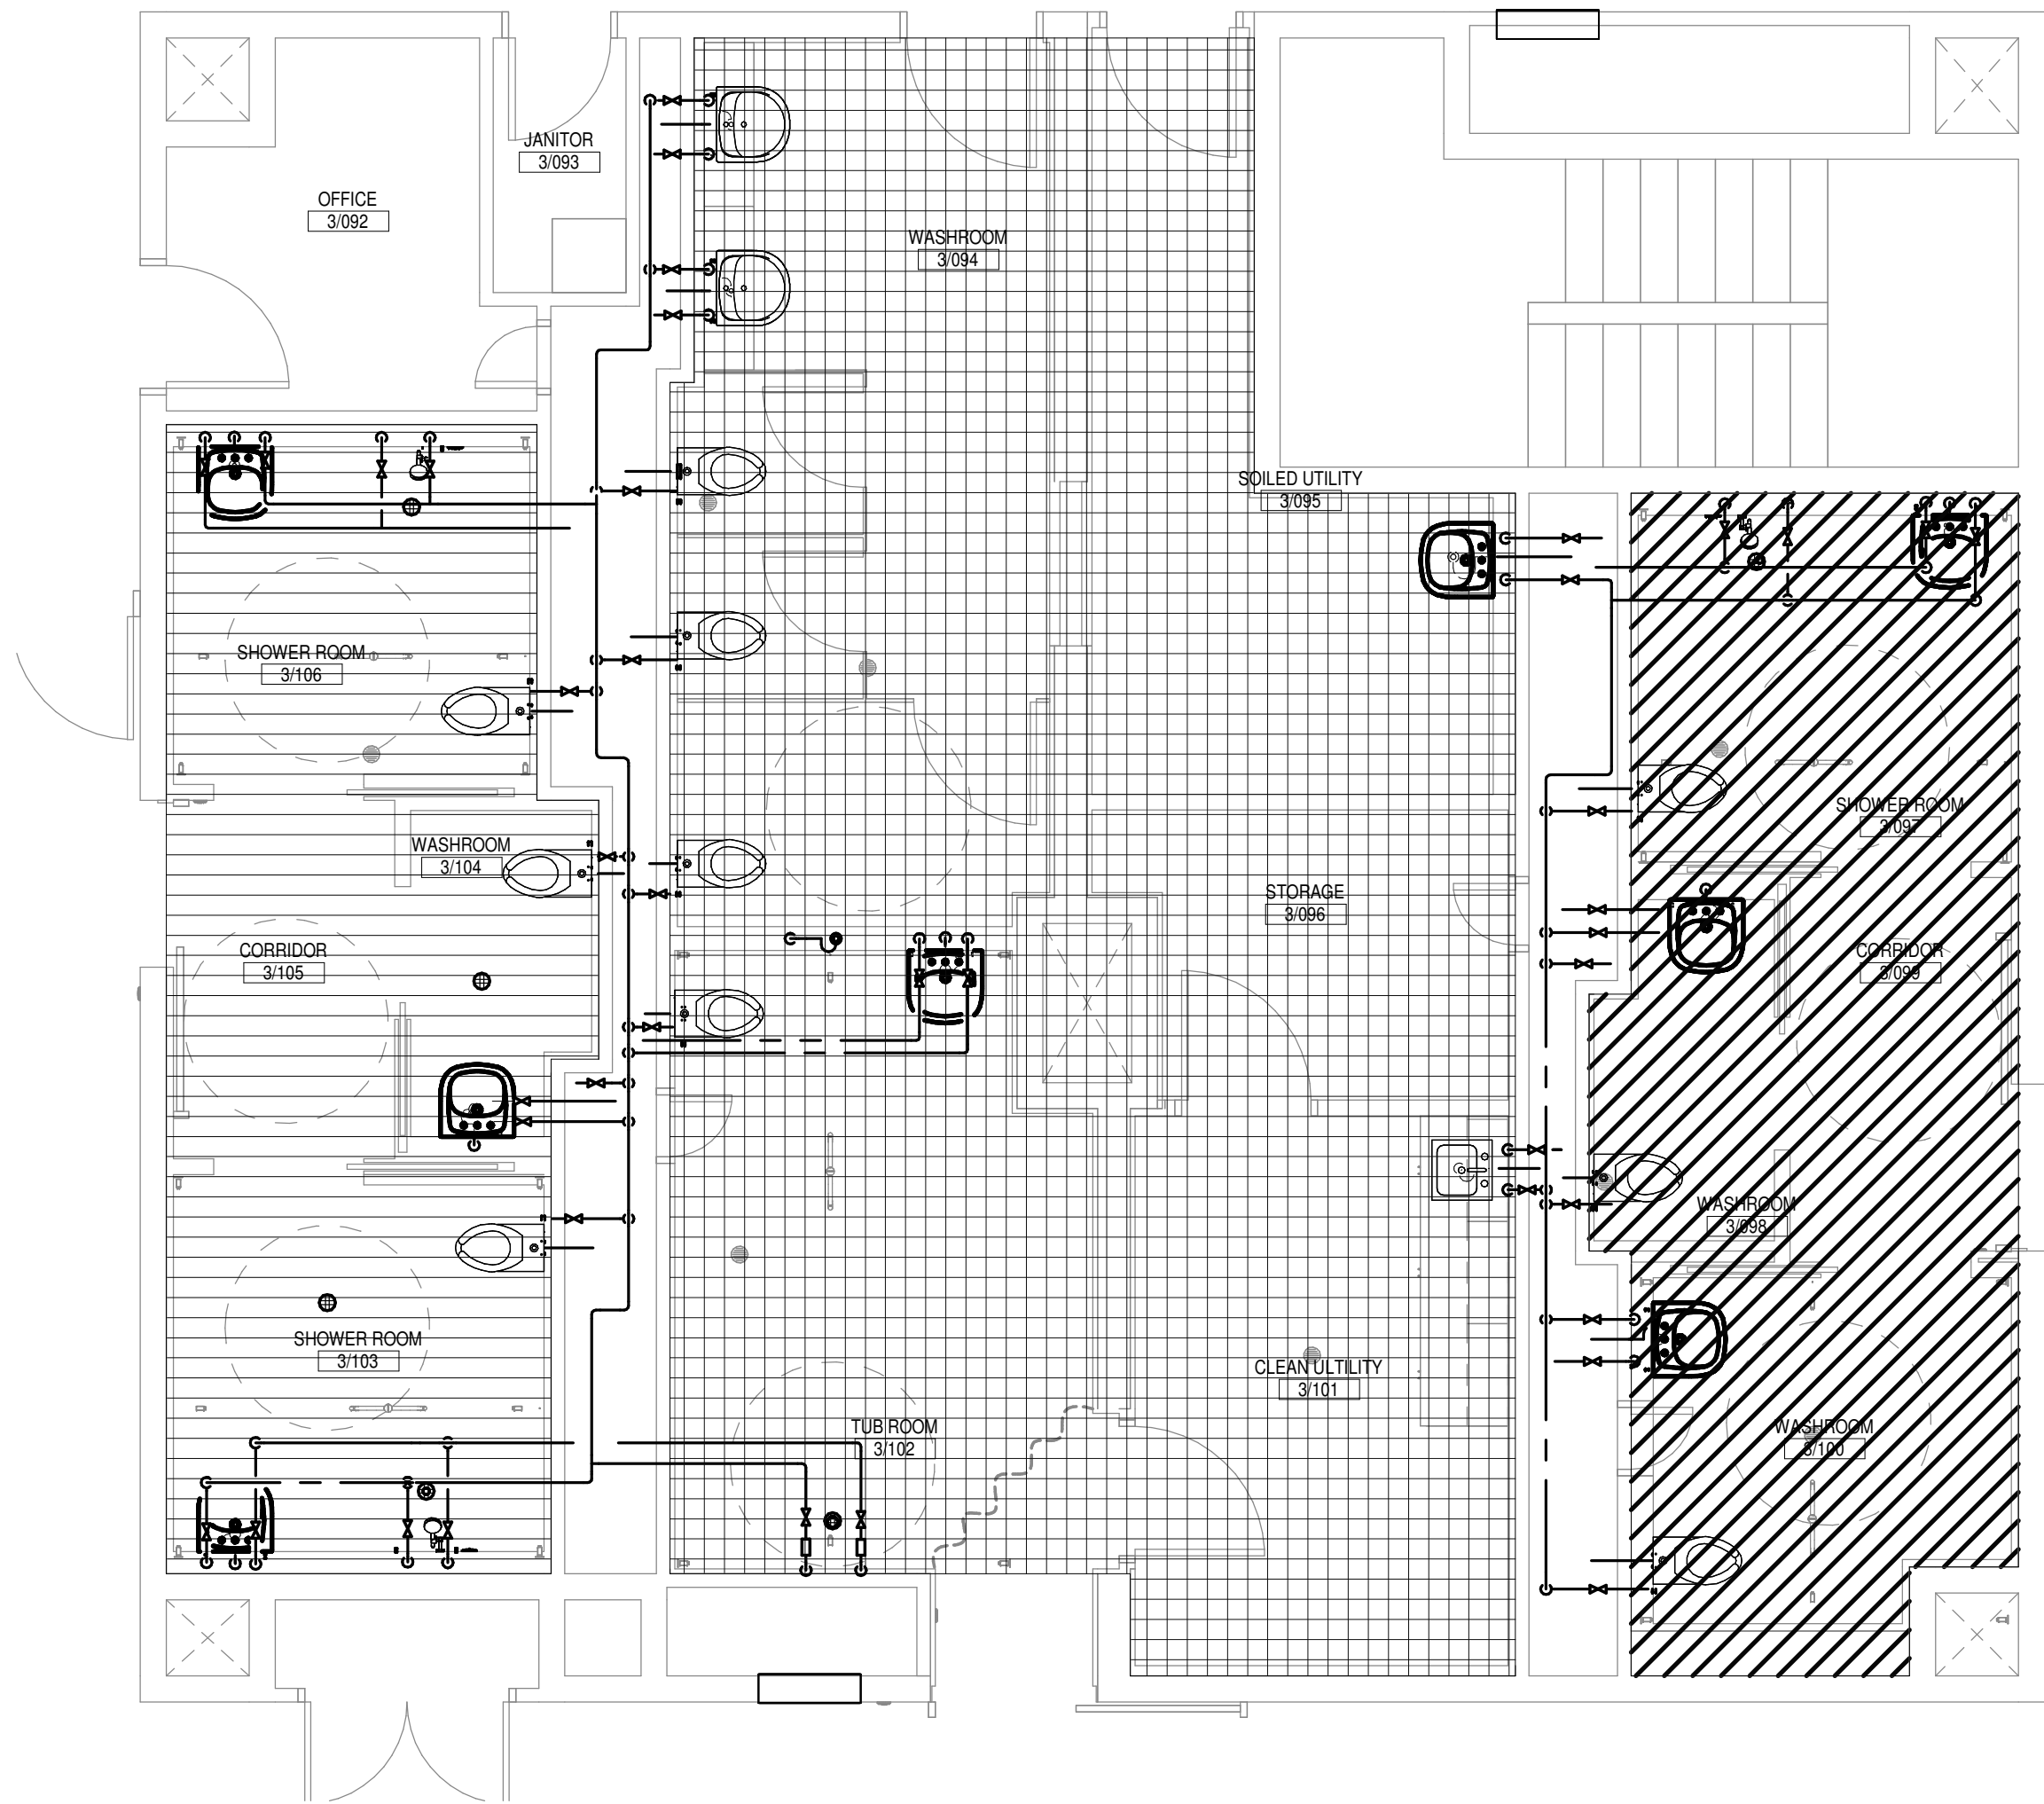- CONTRACTOR SHALL TAKE ALL MEASURES TO PROTECT THE BASE BUILDING FROM DAMAGES DURING CONSTRUCTION.
- DURING DEMOLITION FOR PHASE 2, CONTRACTOR SHALL MAKE SURE ALL PLUMBING FIXTURES, HVAC SERVICES AND FIRE PROTECTION SERVICES IN PHASE 1&3 SHALL REMAIN IN OPERATION.
- DURING DEMOLITION FOR PHASE 3, CONTRACTOR SHALL MAKE SURE ALL PLUMBING FIXTURES, HVAC SERVICES AND FIRE PROTECTION SERVICES IN PHASE 1&2 SHALL REMAIN IN OPERATION.
- DEMOLISH ALL EXISTING PLUMBING FIXTURES, HVAC SERVICES AND SPRINKLER HEADS COMPLETED WITH ALL PIPING ACCORDING TO DRAWING M-201D, M-301D AND M-401D
- FREEZE PLUMBING RISERS BEFORE COMMENCEMENT OF PHASE 1. INSTALL ISOLATION VALVES SO THAT THE BRANCH LINES FEEDING LEVEL 3 CAN BE ISOLATED WIHTOUT CAUSING REPEATED INTERRUPTION OF WATER SUPPLY TO THE BUILDING. FREEZING IS PREFERRED OVER DRAINING THE ENTIRE BUILDING. SINCE DRAINING THE BUILDING DOWN WILL CAUSE LOTS OF WATER WASTE. WILL REQUIRE HIGH LEVELS OF COORDINATION WHEN WATER IS REFILLED AND THE SYSTEM IS VETED FOR AIRLOCKS, SEVERAL BASE BUILDING SYSTEMS WILL BE AFFECTED.
- COORDINATE MECHANICAL PHASING WITH ARCHITECTURAL PHASING DWGS.
- CONTRACTOR SHALL SUBMIT A DETAILED WORK PLAN THAT DESCRIBES HOW PHASING WILL BE IMPLEMENTED.
- CONSTRUCTION ON THIRD FLOOR WILL EFFECT OPERATIONS ON SECOND FLOOR BELOW. ALL CONSTRUCTION PHASING ON THE THIRD FLOOR IS TO BE CONSIDERED CONTIGUOUS WITH THE SECOND FLOOR, AND WILL BE COMPREHENSIVELY SCHEDULED WITH THE HOME PRIOR TO START-UP ON SITE. CONTRACTOR SHALL ACCOUNT AN ALLOWANCE FOR SECOND FLOOR CEILING TO BE CUT, PATCHED AND REPAIRED TO FACILITATE PLUMBING WORK ON THIRD FLOOR.

- PHASE 1 CONSTRUCTION WORK
- PHASE 2 CONSTRUCTION WORK
- PHASE 3 CONSTRUCTION WORK

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5	2024-11-08	ISSUED FOR BUILDING PERMIT	CEL
4	2024-10-10	REISSUED FOR 100%CD	CEL
3	2024-09-30	ISSUED FOR 100% CD	CEL
2	2024-09-04	ISSUED TO MSA FOR FINAL REVIEW	CEL
1	2024-08-23	ISSUED FOR DESIGN DEVELOPMENT	CEL
#	date:	revision:	by
revisions			



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CASTLEVIEW
WYCHWOOD TOWERS


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MECHANICAL PHASING
LAYOUT 2


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drawn by: Author
reviewed by: VS
job number: 24503-03
plot date: Issue Date

drawing number:

M-102

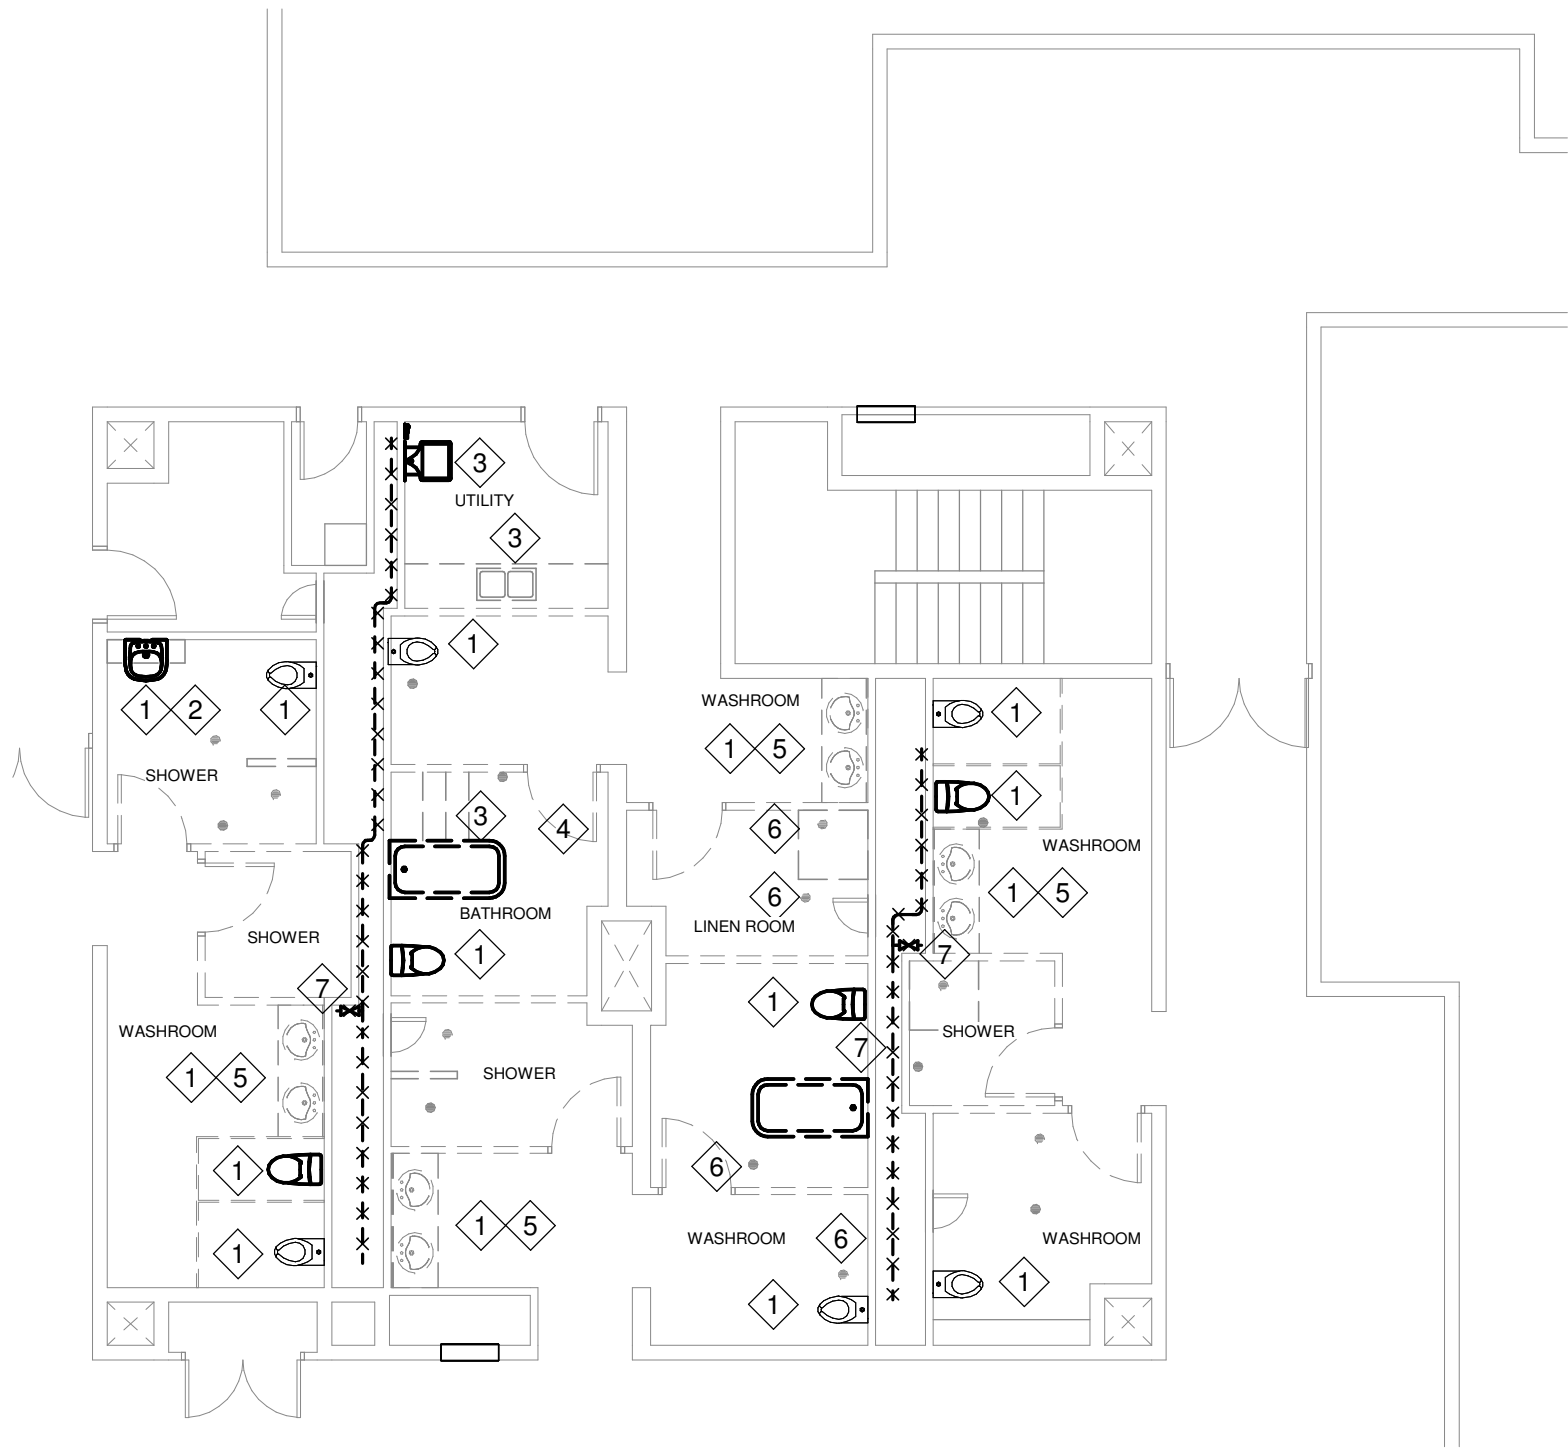

1 LEVEL 3 WASHROOM EAST EXISTING
1 : 100

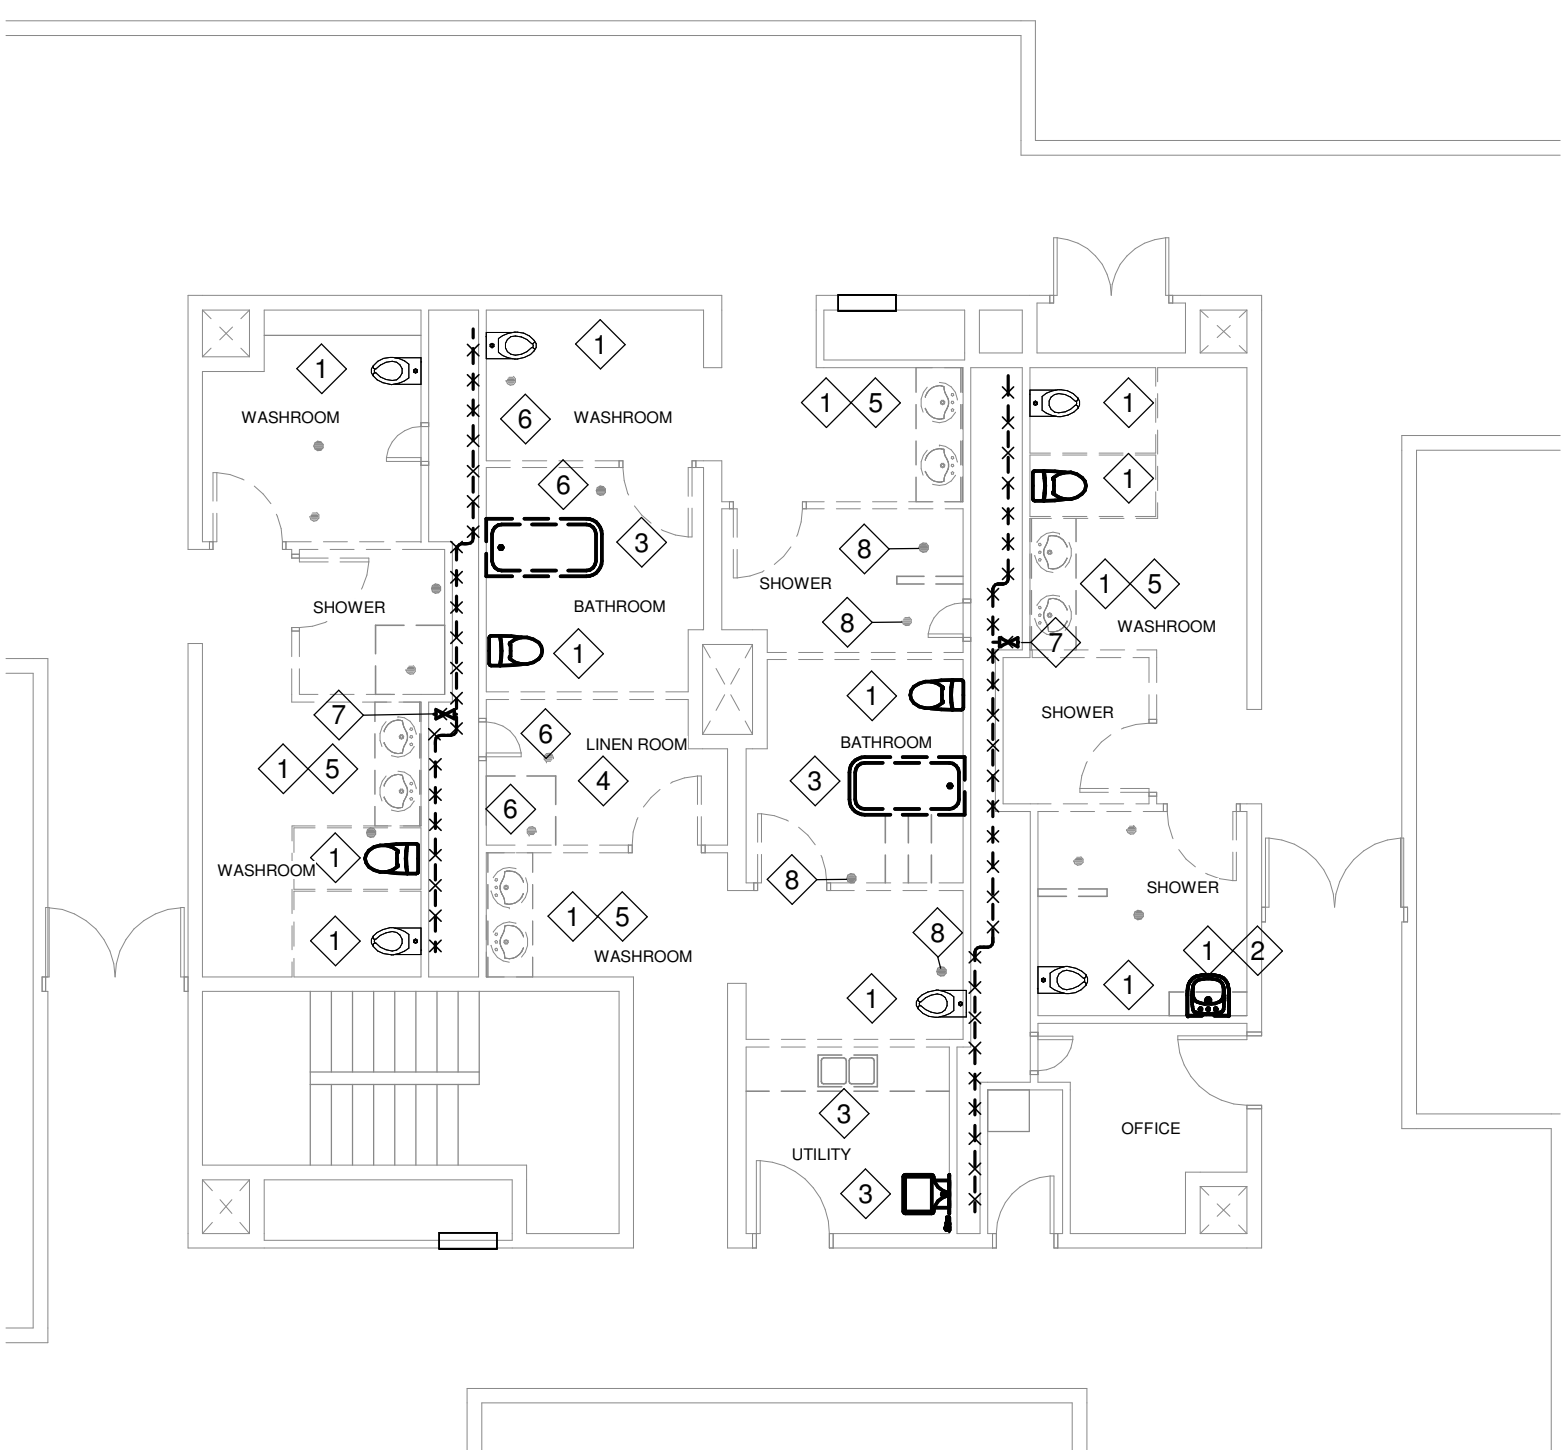

2 LEVEL 3 WASHROOM WEST EXISTING
1 : 100

GENERAL NOTES:

- ALL EXISTING SERVICES SHOWN ON THIS DRAWING ARE FROM EXISTING ARCHIVE DRAWINGS WHICH MAY VARY FROM ACTUAL. CONTRACTOR SHALL REVIEW THE ACTUAL LOCATION OF PIPING TO CONNECT PIPES TO EXISTING. CONTRACTOR SHALL NOTE THE ACTUAL PIPING LAYOUT TO PRODUCE AS-BUILT DWGS.
- CONTRACTOR SHALL TAKE ALL NECESSARY PRECAUTIONS TO AVOID ANY DAMAGE TO EXISTING SERVICES. ANY DAMAGE TO EXISTING SERVICES SHALL BE FIXED BY CONTRACTOR AT NO COST TO THE PROJECT.
- VERIFY EXISTING CONDITION PRIOR TO CONSTRUCTION.
- PROVIDE VENTING AS PER OBC.

DEMOLITION NOTES:

- MECHANICAL CONTRACTOR SHALL DISCONNECT ALL P&D CONNECTIONS AND MAKE THE P&D SYSTEM SAFE. MAKING SAFE INVOLVES SHUTTING OFF THE WATER SUPPLY, CAPPING THE PLUMBING LINES, CAPPING THE DRAINGE PIPES SO THAT THE P&D SYSTEM CAN BE CONCEALED BEHIND NEW WALL AND FLOOR FINISHES. MECHANICAL CONTRACTOR SHALL COORDINATE WITH THE GEN CONTRACTOR AND DEMOLISH THE PLUMBING FIXTURE FROM ITS CURRENT LOCATION.FOR ALL FAUCETS, MECHANICAL CONTRACTOR SHALL DEMOLISH FLUSH VALVES, PLUMBING ACCESSORIES AND DRAINAGE ACCESSORIES RELATED TO THE PLUMBING FIXTURES.
- DEMOLISH EXISTING PLUMBING FIXTURES AS FOLLOWS:
 - CUT & CAP ALL DCW & DHW PIPING AND KEEP IT WITHIN WALL CAVITY.
 - CUT & CAP ALL SANITARY AND VENT PIPING AND KEEP IT WITHIN WALL CAVITY.
- DEMOLISH ALL PLUMBING FIXTURES IN THIS ROOM. CAP ALL PIPES
- PROVIDE ACCESS TO ALL PIPE CAPS
- DEMOLISH EXISTING COUNTER, MILLWORK, SINK, AND CONNECTIONS. CAP PIPES. PROVIDE ACCESS DOOR TO ACCESS PIPE CAPS
- CAP EXISTING FLOOR DRAINS
- DEMOLISH DCW BRANCH PIPE INSIDE THE WALL CHASE

8	2024-12-16	ISSUED FOR TENDER	CEL
7	2024-11-08	ISSUED FOR BUILDING PERMIT	CEL
6	2024-10-10	REISSUED FOR 100%CD	CEL
5	2024-09-30	ISSUED FOR 100% CD	CEL
4	2024-09-04	ISSUED TO MSA FOR FINAL REVIEW	CEL
3	2024-08-23	ISSUED FOR DESIGN DEVELOPMENT	CEL
2	2024-06-26	ISSUED FOR COORDINATION	CEL
1	2024-06-03	ISSUED FOR DESIGN REVIEW	CEL
#	date:	revision:	by
revisions			



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**CASTLEVIEW
WYCHWOOD TOWERS**

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**LEVEL 3 WASHROOM
DEMOLITION PLAN**

scale: 1 : 100
drawn by: Author
reviewed by: Checker
job number: 24503-03
plot date: Issue Date

drawing number:

M-201D


GENERAL NOTES

- ALL EXISTING SERVICES SHOWN ON THIS DRAWING ARE FROM EXISTING ARCHIVE DRAWINGS WHICH MAY VARY FROM ACTUAL. CONTRACTOR SHALL REVIEW THE ACTUAL LOCATION OF PIPING USING X-RAY TO CONNECT NEW PIPES TO EXISTING. CONTRACTOR SHALL NOTE THE ACTUAL PIPING LAYOUT TO PRODUCE ASBUILT DWGS.
- CONTRACTOR SHALL TAKE ALL NECESSARY PRECAUTIONS TO AVOID ANY DAMAGE TO EXISTING SERVICES. ANY DAMAGE TO EXISTING SERVICES SHALL BE FIXED BY CONTRACTOR AT NO COST TO THE PROJECT.
- VERIFY EXISTING CONDITION PRIOR TO CONSTRUCTION.
- ALL P&D SERVICES SHALL BE COORDINATED WITH OTHER MECHANICAL AND ELECTRICAL SERVICES. DESIGN DRAWINGS HAVE BEEN COORDINATED FOR INTERFERENCE COORDINATION. THE CONTRACTOR HOWEVER, IS RESPONSIBLE TO CARRY OUT INTERFERENCE COORDINATION WITH OTHER TRADES DURING CONSTRUCTION.
- SANITARY VENTS ARE NOT INDICATED IN THE DRAWINGS. IT SHALL BE THE CONTRACTOR'S RESPONSIBILITY TO PROVIDE SANITARY VENTING OF ALL PLUMBING FIXTURES AND TRAPS IN ACCORDANCE TO OBC PLUMBING CODES.
- CONTRACTOR IS RESPONSIBLE TO COORDINATE THE LOCATION OF VENT LINES WITH OTHER OVERHEAD SERVICES AND FOR CONCEALED VENT LINE LOCATIONS WITHIN WALLS
- ALL DRAINAGE SYSTEMS SHALL BE INSPECTED AND TESTED IN ACCORDANCE TO BUILDING CODE
- ALL DRAINS SHALL BE PROVIDED WITH TRAP SEAL PRIMERS (TSP) IN ACCORDANCE TO THE PLUMBING CODES.
- LOCATE ALL TRAP SEAL PRIMERS IN PLANT ROOMS/ SERVICE ROOMS, JANITORS' CLOSETS.REFER TO SPECIFICATIONS FOR TSP INFORMATION. ALL TSP SHALL BE INSTALLED BETWEEN 900 MM AND 1200 MM ABOVE FINISHED FLOOR.CONTRACTOR SHALL SUBMIT SHOP DRAWINGS INDICATING THE LOCATION OF ALL TRAP SEAL PRIMERS
- ALL PIPE DROPS TO PLUMBING FIXTURES SHALL BE INSTALLED IN DRYWALL CAVITY. IN CASE OF DISCREPANCY DURING CONSTRUCTION CONTRACTOR SHALL ADDRESS ISSUE WITH ARCHITECT & ENGINEER FOR RESOLUTION.
- ALL PIPE DROPS TO PLUMBING FIXTURES AGAINST EXTERIOR WALL SHALL BE INSTALLED IN DRYWALL CAVITY AND NOT WITHIN EXTERIOR WALL. REFER TO ARCH. DRAWINGS FOR WALL ASSEMBLY INFORMATION.
- CONTRACTOR SHALL ENSURE THAT ALL PLUMBING AND DRAINAGE SYSTEMS ARE SUBMITTED FOR INSPECTION TO THE AUTHORITY HAVING JURISDICTION (AHJ) AND OBTAIN APPROPRIATE SIGN OFFS FROM THE AHJ.
- MECHANICAL CONTRACTOR SHALL PROVIDE LOW VOLTAGE WIRING FROM THE NEAREST ELECTRICAL OUTLET TO POWER THE TSP
- DCW CONNECTION TO THE TSP SHALL BE PROVIDED WITH RED PRESSURE BACK FLOW PREVENTER (RPBFFA). ALL RPBFFA SHALL BE PROVIDED WITH A DRAIN CONNECTION TERMINATED INTO A DRAIN SERVICE BOX.
- CONTRACTOR SHALL MAKE SURE ALL PLUMBING FIXTURES IN OTHER PHASE REMAIN IN OPERATION THROUGHOUT CONSTRUCTION.
- REFER TO STRUCTURE FOR ANY SLAB PENETRATIONS/CORING. ALL PENETRATIONS TO BE REVIEWED AND APPROVED BY STRUCTURE.

CONSTRUCTION NOTES:

- MECHANICAL CONTRACTOR SHALL COORDINATE WITH THE GEN CONTRACTOR. MECHANICAL CONTRACTOR SHALL PREPARE EX. PLUMBING AND DRAINAGE PIPES BEHIND THE WALLS TO CONNECT NEW PLUMBING FIXTURES, AND PROVIDE NEW P&D CONNECTIONS. MECHANICAL CONTRACTOR TO PROVIDE NEW SHUT-OFF VALVES FOR ANY NEW PLUMBING FIXTURES BEING PROVIDED IN THIS SCOPE. REFER TO SPECIFICATIONS FOR DETAILS ON PLUMBING FIXTURES.
- PROVIDE NEW SANITARY PIPES WITH P-TRAP FOR FLOOR DRAINS AT LEVEL 2 AND CONNECT TO MAIN SANITARY STACK INSIDE TE SHAFT AT LEVEL 2 .REFER TO STRUCTURE FOR ANY SLAB PENETRATIONS/CORING. ALL PENETRATIONS TO BE REVIEWED AND APPROVED BY STRUCTURE.
- DHW PIPE CONNECT TO NEAREST MAIN BEHIND THE WALL
- 12 DCW AND 12 DHW DN TO CONNECT FIXTURE AND 32 SAN PIPE DN TO LEVEL 2 AND CONNECT TO NEAREST MAIN RISER INSIDE THE SHAFT
- 40 SAN DN TO LEVEL 2 AND CONNECT TO NEAREAT MAIN RISER INSIDE THE SHAFT
- MECHANICAL CONTRACTOR SHALL COORDINATE WITH THE GENERAL CONTRACTOR TO GAIN ACCESS INTO THE SHAFT TO COMPLETE CONNECTIONS TO THE PLUMBING AND DRAINAGE MAINS INSIDE THE SHAFT.
- TERMINATE 20 DCW & 20 DHW AT MIN.600-700mm AFFL C/W ISOLATION VALVE AND BFPA. MECHANICAL CONTRACTOR SHALL PROVIDE PLUMBING AND DRAINAGE CONNECTION AFTER THE INSTALLATION OF BATHTUB. REFER TO STANDARD DETAIL DWG M-901 FOR DETAILS.
- CAP AND SEAL FLOOR DRAIN, COORDINATE WITH ARCH FLOOR FINISHES
- REUSE AND KEEP EXISTING FLOOR DRAIN . PROVIDE NEW FLOOR DRAIN COVER AND COORDINATE WITH ARCH FLOOR FINISHES
- PROVIDE ALL PLUMBING AND DRAINAGE CONNECTIONS TO BATH TUB.
- SAN PIPE CONNECT TO NEAREST MAIN RISER INSIDE THE SHAFT
- PROVIDE DRAIN PIPING & CONNECT FOR THE BFPA TO CLOSEST WASHBOX WB-1 AS AN INDIRECT DRAIN. PROVIDE TRAP SEAL PRIMER CONNECTION TO WASHBOX

1 Level 3 WASHROOM EAST
1 : 50

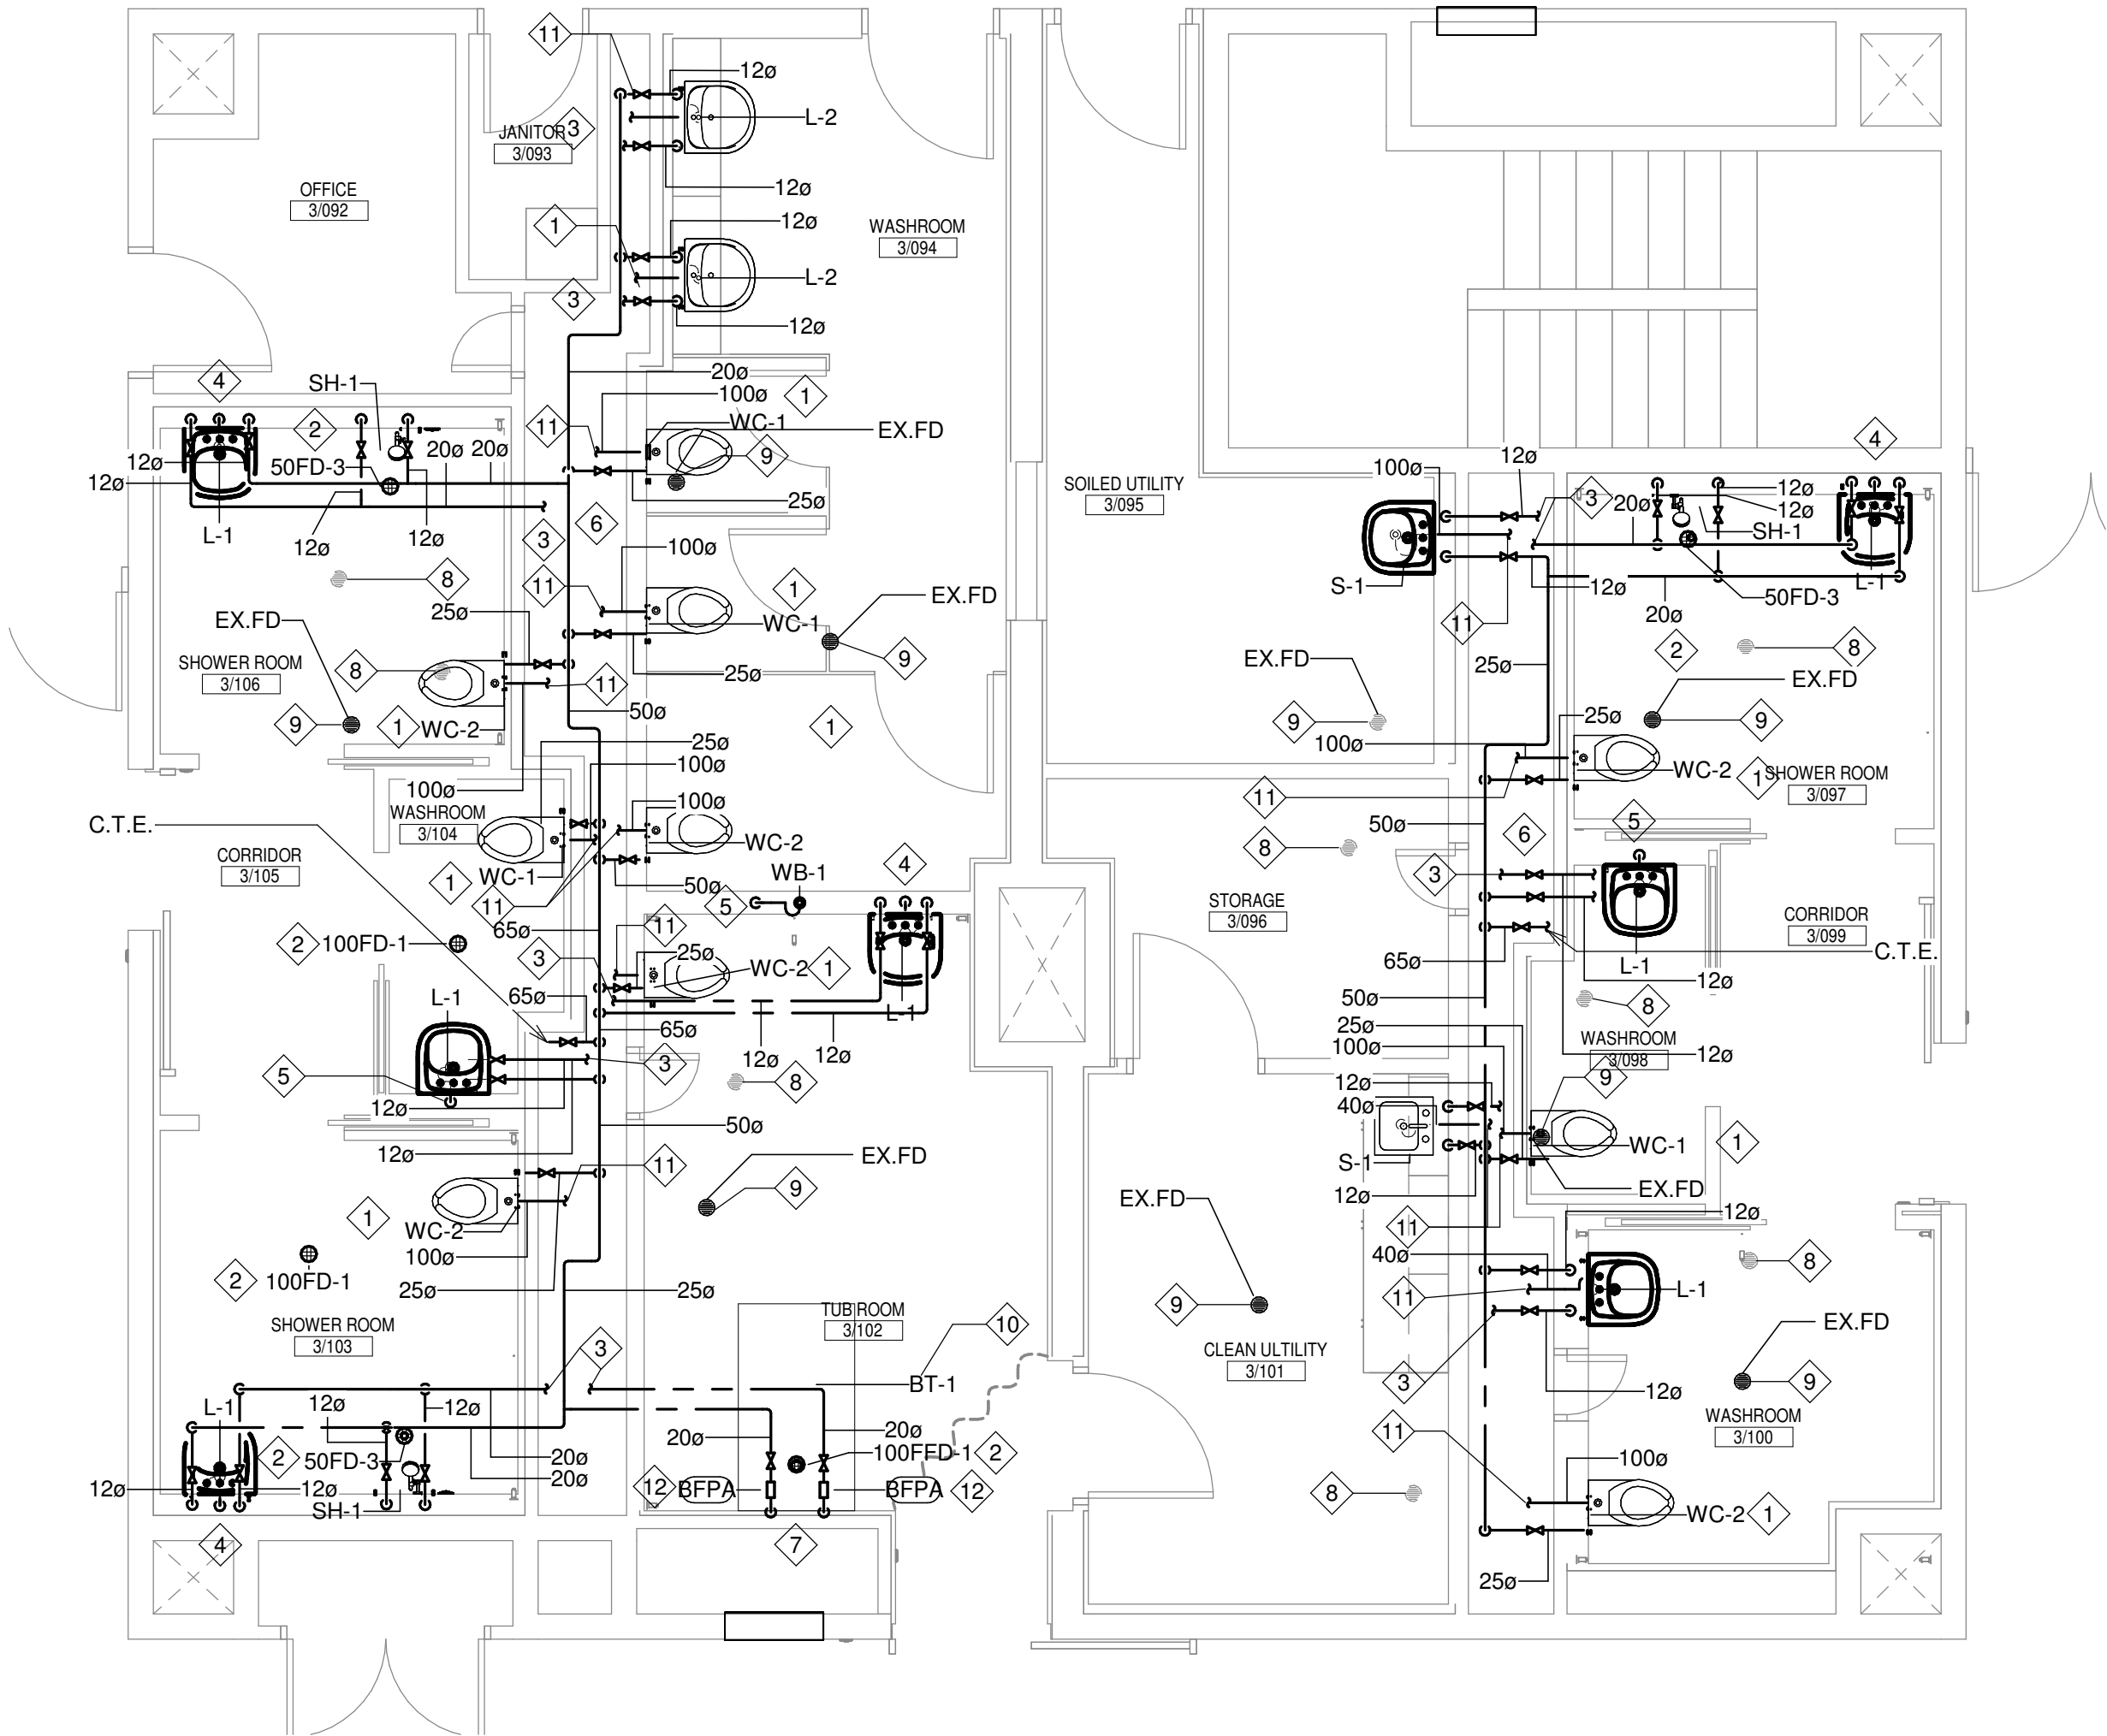

PL - PLUMBING FIXTURE SCHEDULE


Type Tag	FIXTURE	HOT WATER	COLD WATER	WASTE	Count	REMARKS
BT-1	BATHTUB	20	20	75	2	
L-1	LAVATORY	12	12	32	14	
L-2	LAVATORY	12	12	32	4	
S-1	HAND WASH SINK	12	12	40	4	
SH-1	SHOWER	12	12	50	6	
WB-1	WASHBOX			40	2	
WC-1	WATER CLOSET - WALL MOUNTED (F.V.)		25	100	8	
WC-2	WATER CLOSET - BARRIER FREE		25	100	12	

THE QUANTITY OF PLUMBING FIXTURES IN THE TABLE ABOVE SHALL BE USED FOR GUIDANCE PURPOSES ONLY, SINCE THE QUANTITY MAY NOT BE ACCURATE. CONTRACTOR SHALL BE RESPONSIBLE TO DETERMINE QUANTITY.

BRANCH WATER SUPPLY PIPE SIZING CHART

FIXTURE	NUMBER OF FIXTURES			
	1	2-3	4-6	7-12
WATER CLOSET - FLUSH VALVE	50	50	65	65
WATER CLOSET - FLUSH TANK	12	25	40	50
URINAL - FLUSH VALVE	40	50	50	50
LAVATORY	NUMBER OF FIXTURES			
	1-2	3-6	7-12	13-20
LAVATORY	12	20	25	32

8	2024-12-16	ISSUED FOR TENDER	CEL
7	2024-11-08	ISSUED FOR BUILDING PERMIT	CEL
6	2024-10-10	REISSUED FOR 100%CD	CEL
5	2024-09-30	ISSUED FOR 100% CD	CEL
4	2024-09-04	ISSUED TO MSA FOR FINAL REVIEW	CEL
3	2024-08-23	ISSUED FOR DESIGN DEVELOPMENT	CEL
2	2024-06-26	ISSUED FOR COORDINATION	CEL
1	2024-06-03	ISSUED FOR DESIGN REVIEW	CEL
#	date:	revision:	by
revisions			

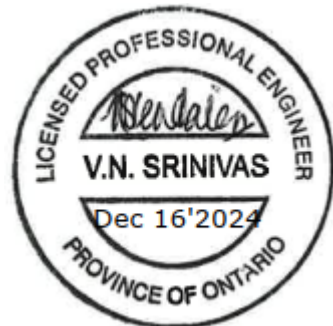

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CASTLEVIEW
WYCHWOOD TOWERS

351 CHRISTIE ST, TORONTO, ONTARIO M6G 3C3

LEVEL 3 WASHROOM
EAST PROPOSED PLAN

scale: As indicated

drawn by: Author

reviewed by: VS

job number: 24503-03

plot date: Issue Date

drawing number:

M-201


GENERAL NOTES

- ALL EXISTING SERVICES SHOWN ON THIS DRAWING ARE FROM EXISTING ARCHIVE DRAWINGS WHICH MAY VARY FROM ACTUAL. CONTRACTOR SHALL REVIEW THE ACTUAL LOCATION OF PIPING USING X-RAY TO CONNECT NEW PIPES TO EXISTING. CONTRACTOR SHALL NOTE THE ACTUAL PIPING LAYOUT TO PRODUCE ASBUILT DWGS.
- CONTRACTOR SHALL TAKE ALL NECESSARY PRECAUTIONS TO AVOID ANY DAMAGE TO EXISTING SERVICES. ANY DAMAGE TO EXISTING SERVICES SHALL BE FIXED BY CONTRACTOR AT NO COST TO THE PROJECT.
- VERIFY EXISTING CONDITION PRIOR TO CONSTRUCTION.
- ALL P&D SERVICES SHALL BE COORDINATED WITH OTHER MECHANICAL AND ELECTRICAL SERVICES. DESIGN DRAWINGS HAVE BEEN COORDINATED FOR INTERFERENCE COORDINATION. THE CONTRACTOR HOWEVER, IS RESPONSIBLE TO CARRY OUT INTERFERENCE COORDINATION WITH OTHER TRADES DURING CONSTRUCTION.
- SANITARY VENTS ARE NOT INDICATED IN THE DRAWINGS. IT SHALL BE THE CONTRACTOR'S RESPONSIBILITY TO PROVIDE SANITARY VENTING OF ALL PLUMBING FIXTURES AND TRAPS IN ACCORDANCE TO OBC PLUMBING CODES.
- CONTRACTOR IS RESPONSIBLE TO COORDINATE THE LOCATION OF VENT LINES WITH OTHER OVERHEAD SERVICES AND FOR CONCEALED VENT LINE LOCATIONS WITHIN WALLS
- ALL DRAINAGE SYSTEMS SHALL BE INSPECTED AND TESTED IN ACCORDANCE TO BUILDING CODE
- ALL DRAINS SHALL BE PROVIDED WITH TRAP SEAL PRIMERS (TSP) IN ACCORDANCE TO THE PLUMBING CODES.
- LOCATE ALL TRAP SEAL PRIMERS IN PLANT ROOMS/ SERVICE ROOMS, JANITORS' CLOSETS.REFER TO SPECIFICATIONS FOR TSP INFORMATION. ALL TSP SHALL BE INSTALLED BETWEEN 900 MM AND 1200 MM ABOVE FINISHED FLOOR.CONTRACTOR SHALL SUBMIT SHOP DRAWINGS INDICATING THE LOCATION OF ALL TRAP SEAL PRIMERS
- ALL PIPE DROPS TO PLUMBING FIXTURES SHALL BE INSTALLED IN DRYWALL CAVITY. IN CASE OF DISCREPANCY DURING CONSTRUCTION CONTRACTOR SHALL ADDRESS ISSUE WITH ARCHITECT & ENGINEER FOR RESOLUTION.
- ALL PIPE DROPS TO PLUMBING FIXTURES AGAINST EXTERIOR WALL SHALL BE INSTALLED IN DRYWALL CAVITY AND NOT WITHIN EXTERIOR WALL. REFER TO ARCH. DRAWINGS FOR WALL ASSEMBLY INFORMATION.
- CONTRACTOR SHALL ENSURE THAT ALL PLUMBING AND DRAINAGE SYSTEMS ARE SUBMITTED FOR INSPECTION TO THE AUTHORITY HAVING JURISDICTION (AHJ) AND OBTAIN APPROPRIATE SIGN OFFS FROM THE AHJ.
- MECHANICAL CONTRACTOR SHALL PROVIDE LOW VOLTAGE WIRING FROM THE NEAREST ELECTRICAL OUTLET TO POWER THE TSP
- DCW CONNECTION TO THE TSP SHALL BE PROVIDED WITH RED PRESSURE BACK FLOW PREVENTER (RPBFPA). ALL RPBFPA SHALL BE PROVIDED WITH A DRAIN CONNECTION TERMINATED INTO A DRAIN SERVICE BOX.
- CONTRACTOR SHALL MAKE SURE ALL PLUMBING FIXTURES IN OTHER PHASE REMAIN IN OPERATION THROUGHOUT CONSTRUCTION.
- REFER TO STRUCTURE FOR ANY SLAB PENETRATIONS/CORING. ALL PENETRATIONS TO BE REVIEWED AND APPROVED BY STRUCTURE.

CONSTRUCTION NOTES:

- MECHANICAL CONTRACTOR SHALL COORDINATE WITH THE GEN CONTRACTOR. MECHANICAL CONTRACTOR SHALL PREPARE EX. PLUMBING AND DRAINAGE PIPES BEHIND THE WALLS TO CONNECT NEW PLUMBING FIXTURES, AND PROVIDE NEW P&D CONNECTIONS. MECHANICAL CONTRACTOR TO PROVIDE NEW SHUT-OFF VALVES FOR ANY NEW PLUMBING FIXTURES BEING PROVIDED IN THIS SCOPE. REFER TO SPECIFICATIONS FOR DETAILS ON PLUMBING FIXTURES.
- PROVIDE NEW SANITARY PIPES WITH P-TRAP FOR FLOOR DRAINS AT LEVEL 2 AND CONNECT TO NEAREST MAIN SANITARY STACK INSIDE THE SHAFT AT LEVEL 2. REFER TO STRUCTURE FOR ANY SLAB PENETRATIONS/CORING. ALL PENETRATIONS TO BE REVIEWED AND APPROVED BY STRUCTURE.
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- 40 SAN DN TO LEVEL 2 AND CONNECT TO NEAREAT MAIN RISER INSIDE THE SHAFT
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- TERMINATE 20 DCW & 20 DHW AT MIN.600-700mm AFFL C/W ISOLATION VALVE AND BFPA. MECHANICAL CONTRACTOR SHALL PROVIDE PLUMBING AND DRAINAGE CONNECTION AFTER THE INSTALLATION OF BATHTUB. REFER TO STANDARD DETAIL DWG M-901 FOR DETAILS.
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- REUSE AND KEEP EXISTING FLOOR DRAIN . PROVIDE NEW FLOOR DRAIN COVER AND COORDINATE WITH ARCH FLOOR FINISHES
- PROVIDE ALL PLUMBING AND DRAINAGE CONENCTIONS TO BATH TUB.
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- PROVIDE DRAIN PIPING & CONNECT FOR THE BFPA TO CLOSEST WASHBOX WB-1 AS AN INDIRECT DRAIN. PROVIDE TRAP SEAL PRIMER CONNECTION TO WASHBOX

1 LEVEL 3 WASHROOM WEST
1 : 50

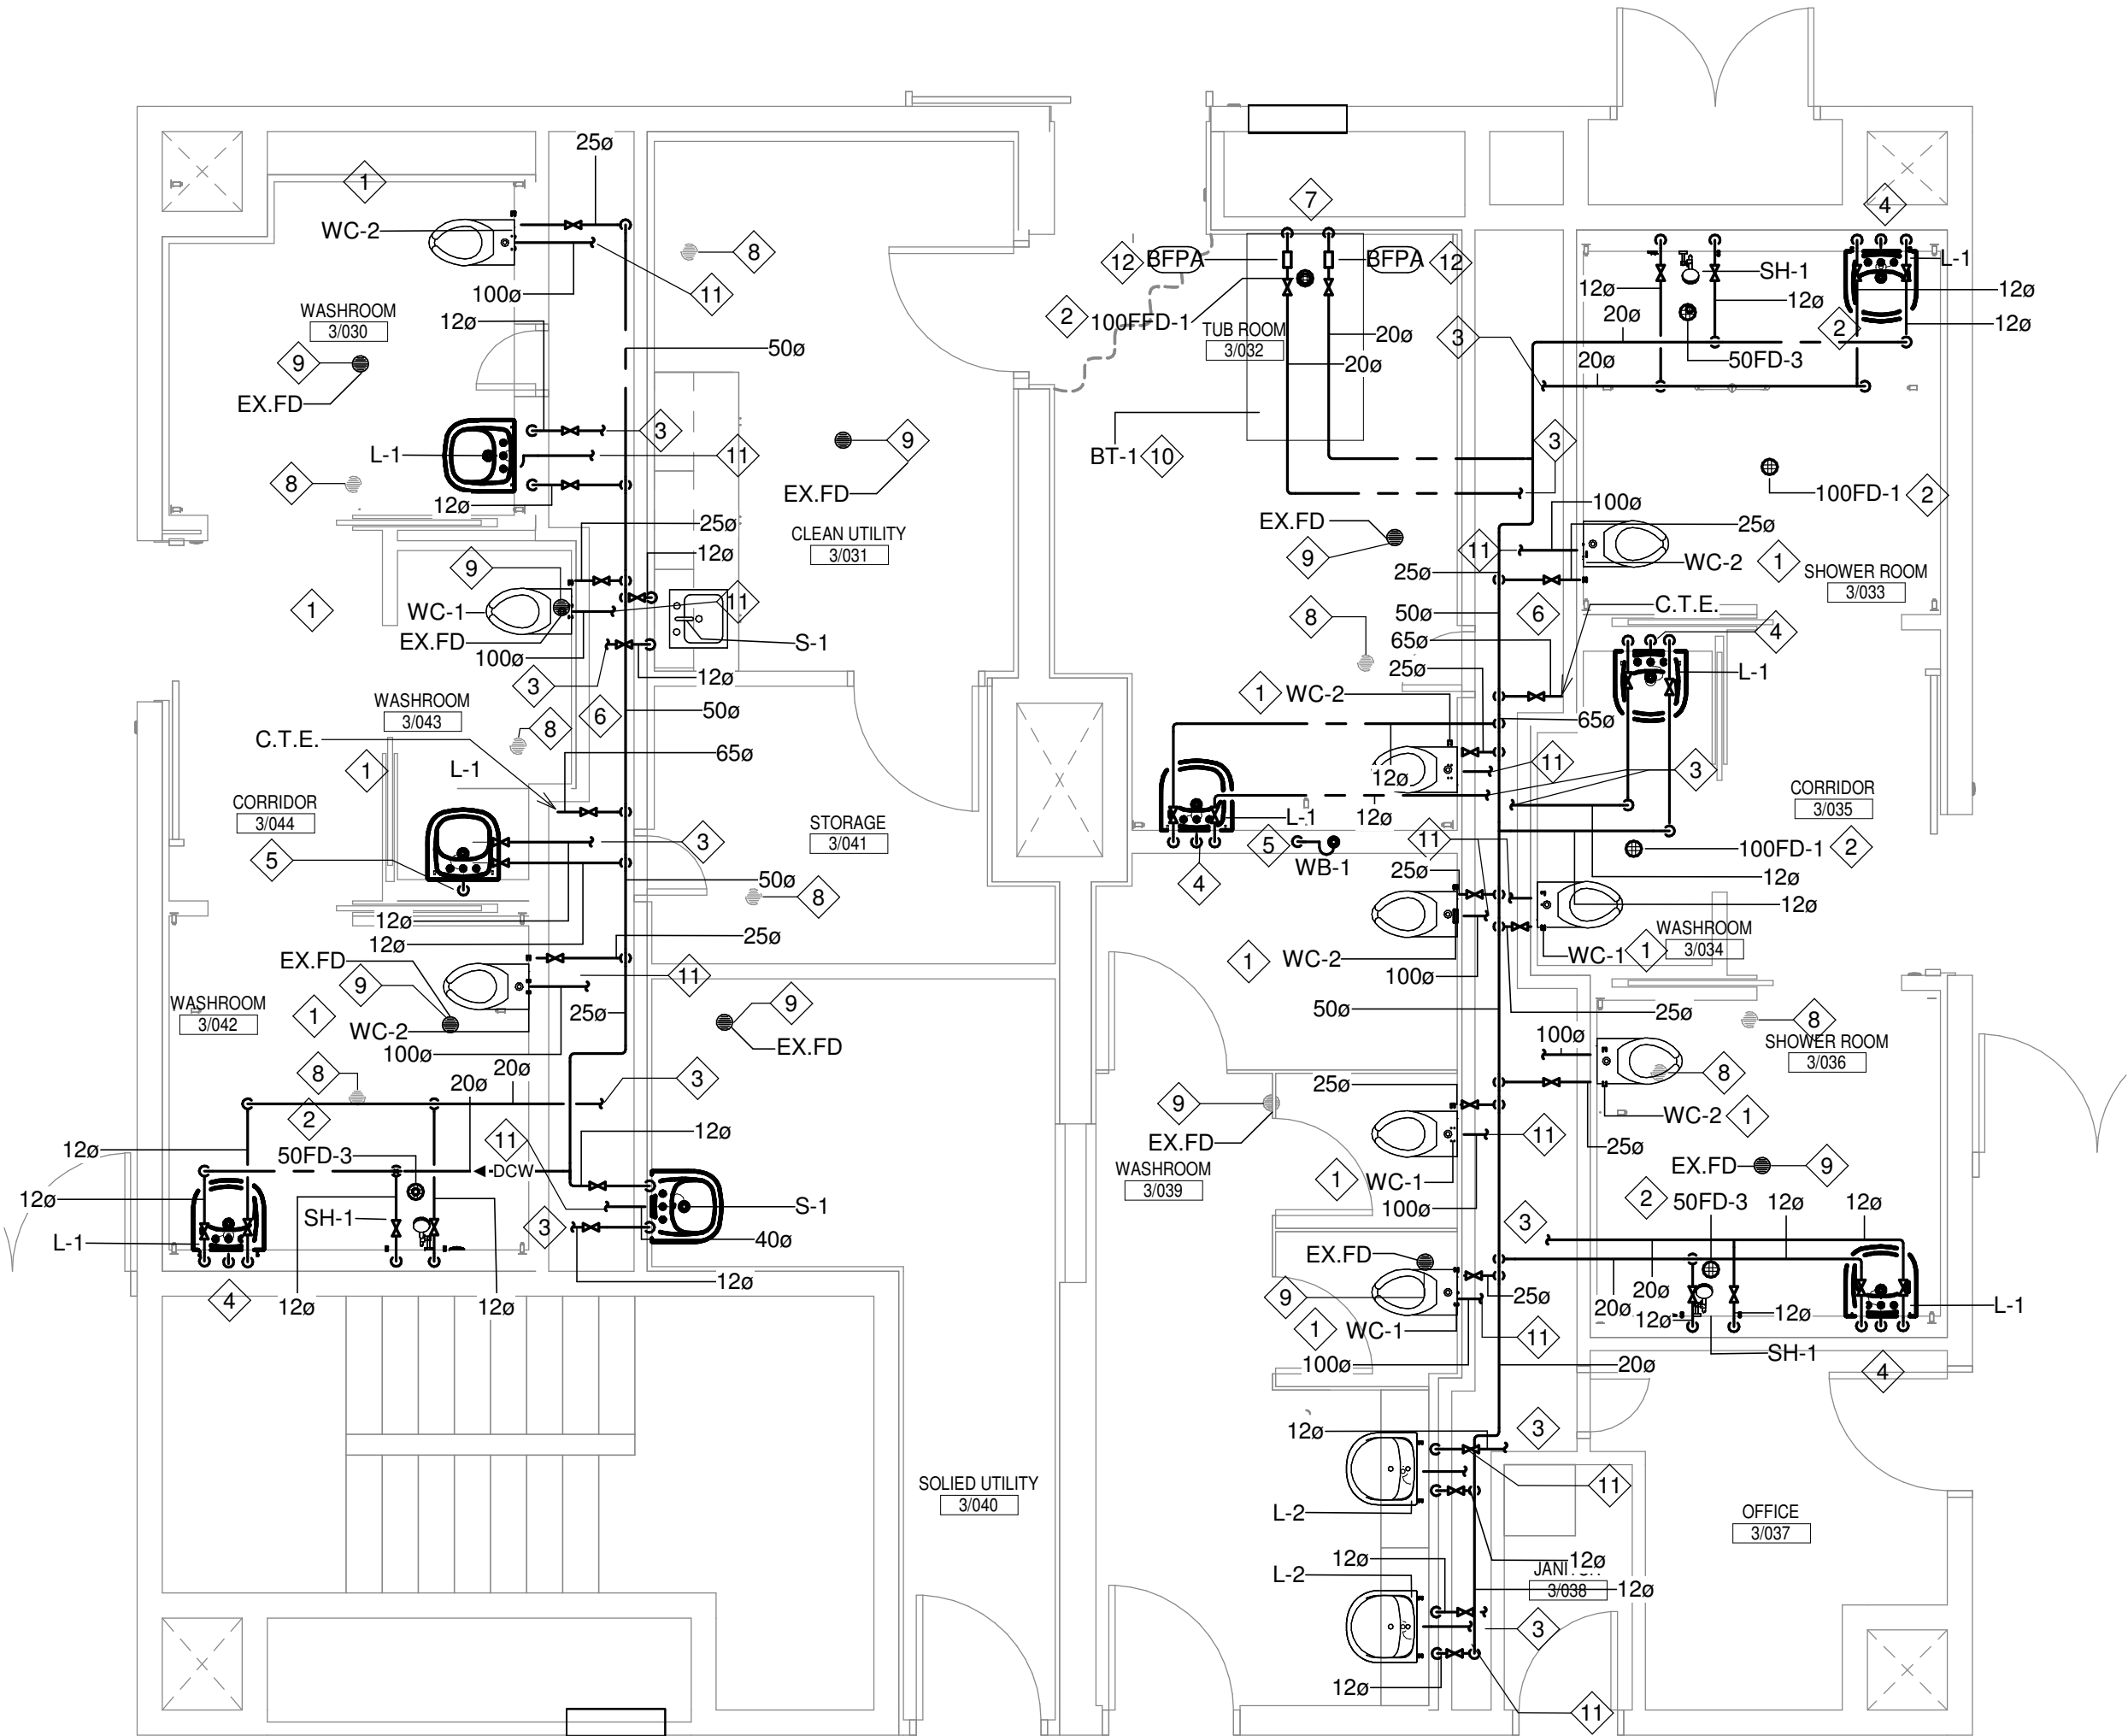

PL - PLUMBING FIXTURE SCHEDULE						
Type Tag	FIXTURE	HOT WATER	COLD WATER	WASTE	Count	REMARKS
BT-1	BATHTUB	20	20	75	2	
L-1	LAVATORY	12	12	32	14	
L-2	LAVATORY	12	12	32	4	
S-1	HAND WASH SINK	12	12	40	4	
SH-1	SHOWER	12	12	50	6	
WB-1	WASHBOX			40	2	
WC-1	WATER CLOSET - WALL MOUNTED (F.V.)		25	100	8	
WC-2	WATER CLOSET - BARRIER FREE		25	100	12	

THE QUANTITY OF PLUMBING FIXTURES IN THE TABLE ABOVE SHALL BE USED FOR GUIDANCE PURPOSES ONLY, SINCE THE QUANTITY MAY NOT BE ACCURATE. CONTRACTOR SHALL BE RESPONSIBLE TO DETERMINE QUANTITY.

BRANCH WATER SUPPLY PIPE SIZING CHART				
FIXTURE	NUMBER OF FIXTURES			
	1	2-3	4-6	7-12
WATER CLOSET - FLUSH VALVE	50	50	65	65
WATER CLOSET - FLUSH TANK	12	25	40	50
URINAL - FLUSH VALVE	40	50	50	50
	NUMBER OF FIXTURES			
	1-2	3-6	7-12	13-20
LAVATORY	12	20	25	32

Montgomery Sisam Architects Inc.

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MontgomerySisam

CROSSEY
ENGINEERING
A Salas O'Brien Company

8	2024-12-16	ISSUED FOR TENDER	CEL
7	2024-11-08	ISSUED FOR BUILDING PERMIT	CEL
6	2024-10-10	REISSUED FOR 100%CD	CEL
5	2024-09-30	ISSUED FOR 100% CD	CEL
4	2024-09-04	ISSUED TO MSA FOR FINAL REVIEW	CEL
3	2024-08-23	ISSUED FOR DESIGN DEVELOPMENT	CEL
2	2024-06-26	ISSUED FOR COORDINATION	CEL
1	2024-06-03	ISSUED FOR DESIGN REVIEW	CEL

date: revision: by
revisions



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CASTLEVIEW
WYCHWOOD TOWERS

351 CHRISTIE ST, TORONTO, ONTARIO M6G 3C3

LEVEL 3 WASHROOM
WEST PROPOSED PLAN

scale: As indicated
drawn by: Author
reviewed by: VS
job number: 24503-03
plot date: Issue Date

drawing number:

M-202



1. PROTECT SPRINKLER HEADS DURING THE RENOVATION WORKS.
2. ALL SPRINKLER HEADS IN THE ROOMS TO BE RETAINED.
3. PROTECT SURROUNDING SPRINKLER HEADS WHEN CEILING TILES ARE REMOVED.
4. REMOVE THE SPRINKLER HEAD WHEN THE CEILINGS ARE REMOVED. MAKE PROVISIONS TO DRAIN THE SPRINKLER SYSTEM BEFORE CEILING REMOVAL. PROVIDE AND INSTALL NEW SPRINKLER HEAD AFTER CEILING WORK IS COMPLETE.
5. PROVIDE ADEQUATE FIRE WATCH WHEN THE SPRINKLER SYSTEM IS NOT ACTIVE.
6. CONTRACTOR SHALL MAKE SURE ALL FIRE PROTECTION SERVICE IN OTHER PHASES REMAIN IN OPERATION THROUGHOUT CONSTRUCTION.

- ### 3 LEVEL 1 RECEPTION DEMOLITION PLAN




CASTLEVIEW
WYCHWOOD TOWERS


LEVEL 1 RECEPTION 8.

scale: 1 : 100
drawn by: Author
reviewed by: VS
job number: 24503-03
plot date: Issue Date


drawing number: **M-301D**

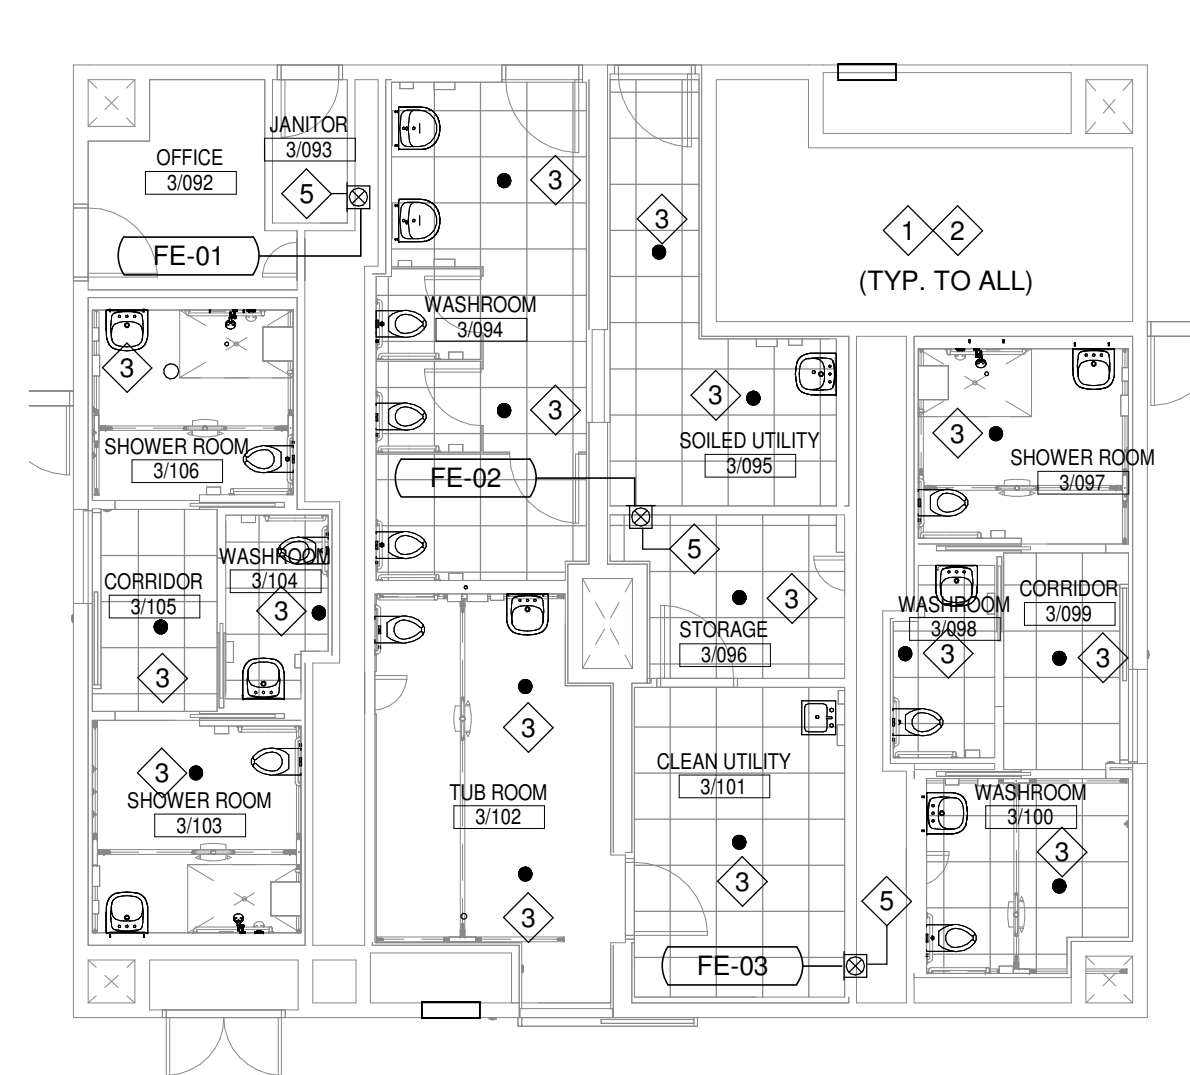

1 LEVEL 3 WASHROOM EAST
1 : 100

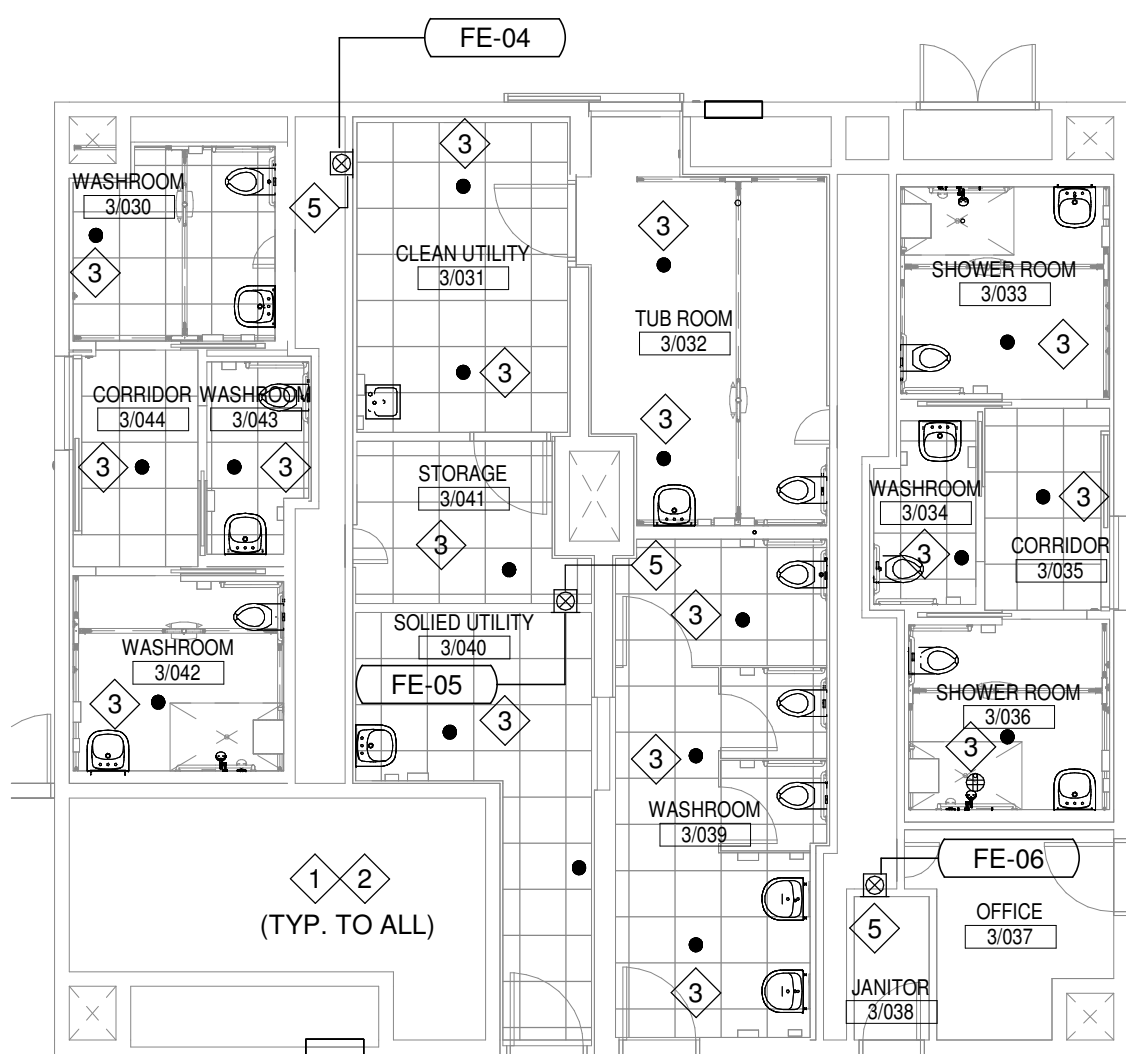

2 LEVEL 3 WASHROOM WEST
1 : 100

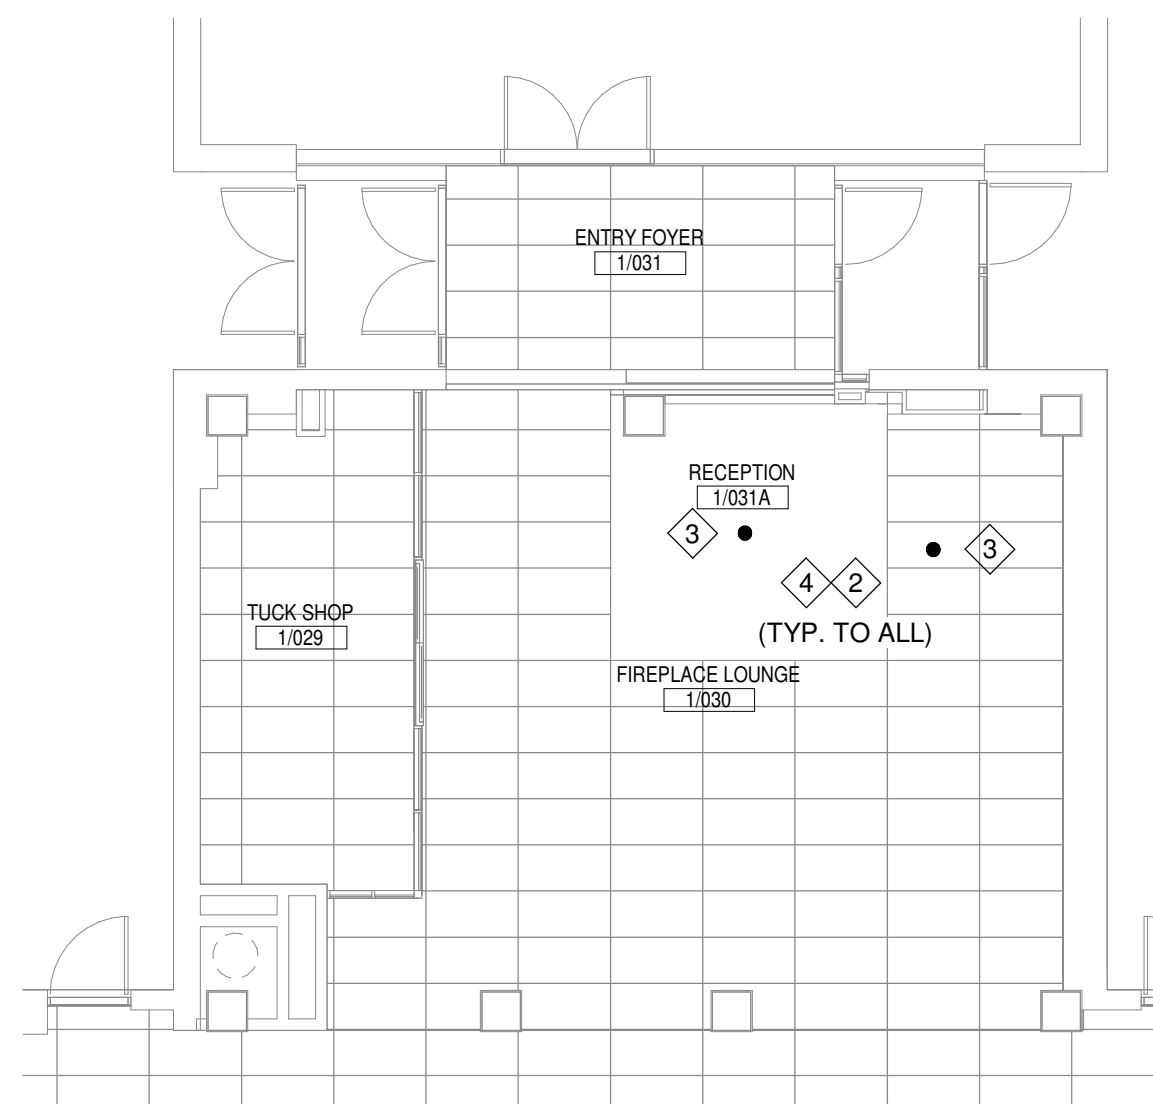

3 LEVEL 1 RECEPTION
1 : 100


GENERAL NOTES:

- REMOVE EX. SPRINKLER HEADS IN THE PHASE THAT IS BEING RENOVATED AND REPLACE WITH NEW SPRINKLER HEADS TO MATCH NEW LAYOUT. IN THE PHASE THAT IS NOT BEING RENOVATED, RETAIN THE EX. SPRINKLER HEADS UNTIL THE RENOVATION STARTS.
- ALL SPRINKLER WORK SHALL BE PERFORMED BY A CERTIFIED AND LICENSED SPRINKLER CONTRACTOR. SPRINKLER CONTRACTOR SHALL PROVIDE ALL NECESSARY DOCUMENTS RELATED TO OBTAINING AND CLOSING PERMIT THAT WOULD INLCUDE BUT NOT LIMITED TO:
 - HYDRAULIC CALCULATIONS.
 - SPRINKLER SHOP DWGS.
 - MATERIAL AND PRODUCT CERTIFICATES.
- PROTECT SURROUNDING SPRINKLER HEADS WHEN CEILING TILES ARE REMOVED.
- REMOVE THE SPRINKLER HEAD WHEN THE CEILINGS ARE REMOVED. MAKE PROVISIONS TO DRAIN THE SPRINKLER SYSTEM BEFORE CEILING REMOVAL. PROVIDE AND INSTALL NEW SPRINKLER HEAD AFTER CEILING WORK IS COMPLETE.
- PROVIDE ADEQUATE FIRE WATCH WHEN THE SPRINKLER SYSTEM IS NOT ACTIVE.
- EXISTING AREA TO REMAIN OPERATIONAL DURING CONSTRUCTION. COORDINATE WHEN ISOLATING SPRINKLER ZONES AND PROVIDE FIRE WATCH AS REQUIRED.
- COORDINATE SPRINKLER HEAD LOCATIONS WITH AIR GRILLES AND ELECTRICAL FIXTURES .

CONSTRUCTION NOTES:

- PROVIDE SPRINKLER COVERAGE TO LEVEL 3 WASHROOM. ALLOW FOR ADDITIONAL HEADS FOR PROTECTION OF MECHANICAL DUCTS AND OBSTRUCTION OVER WIDTH 1200mm. THE CONTRACTOR SHALL COORDINATE WITH OTHER TRADES AND ENSURE TO PROVIDE THE SUFFICIENT COVERAGE ACCORDINGLY.
- NEW SPRINKLER HEADS SHALL BE RE-CONNECTED TO EXISTING SPRINKLER BRANCHES OF ADEQUATE SIZE LOCATED WITHIN THE AREA . PROVIDE FITTINGS AND OFFSETS TO SUIT.
- PROVIDE NEW SPRINKLER HEADS, COORDINATE WITH ARCH RCP.
- PROVIDE SPRINKLER COVERAGE TO LEVEL 1 RECEPTION. ALLOW FOR ADDITIONAL HEADS FOR PROTECTION OF MECHANICAL DUCTS AND OBSTRUCTION OVER WIDTH 1200mm. THE CONTRACTOR SHALL COORDINATE WITH OTHER TRADES AND ENSURE TO PROVIDE THE SUFFICIENT COVERAGE ACCORDINGLY.
- ALL FE SHALL BE FULLY RECESSED

8	2024-12-16	ISSUED FOR TENDER	CEL
7	2024-11-08	ISSUED FOR BUILDING PERMIT	CEL
6	2024-10-10	REISSUED FOR 100%CD	CEL
5	2024-09-30	ISSUED FOR 100% CD	CEL
4	2024-09-04	ISSUED TO MSA FOR FINAL REVIEW	CEL
3	2024-08-23	ISSUED FOR DESIGN DEVELOPMENT	CEL
2	2024-06-26	ISSUED FOR COORDINATION	CEL
1	2024-06-03	ISSUED FOR DESIGN REVIEW	CEL
#	date:	revision:	by
revisions			

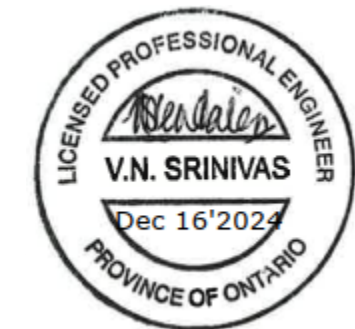

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CASTLEVIEW
WYCHWOOD TOWERS


351 CHRISTIE ST, TORONTO, ONTARIO M6G 3C3

LEVEL 1 RECEPTION &
LEVEL 3 WASHROOM
PROPOSED PLAN

scale: 1 : 100
drawn by: Author
reviewed by: Checker
job number: 24503-03
plot date: Issue Date

drawing number:

M-301

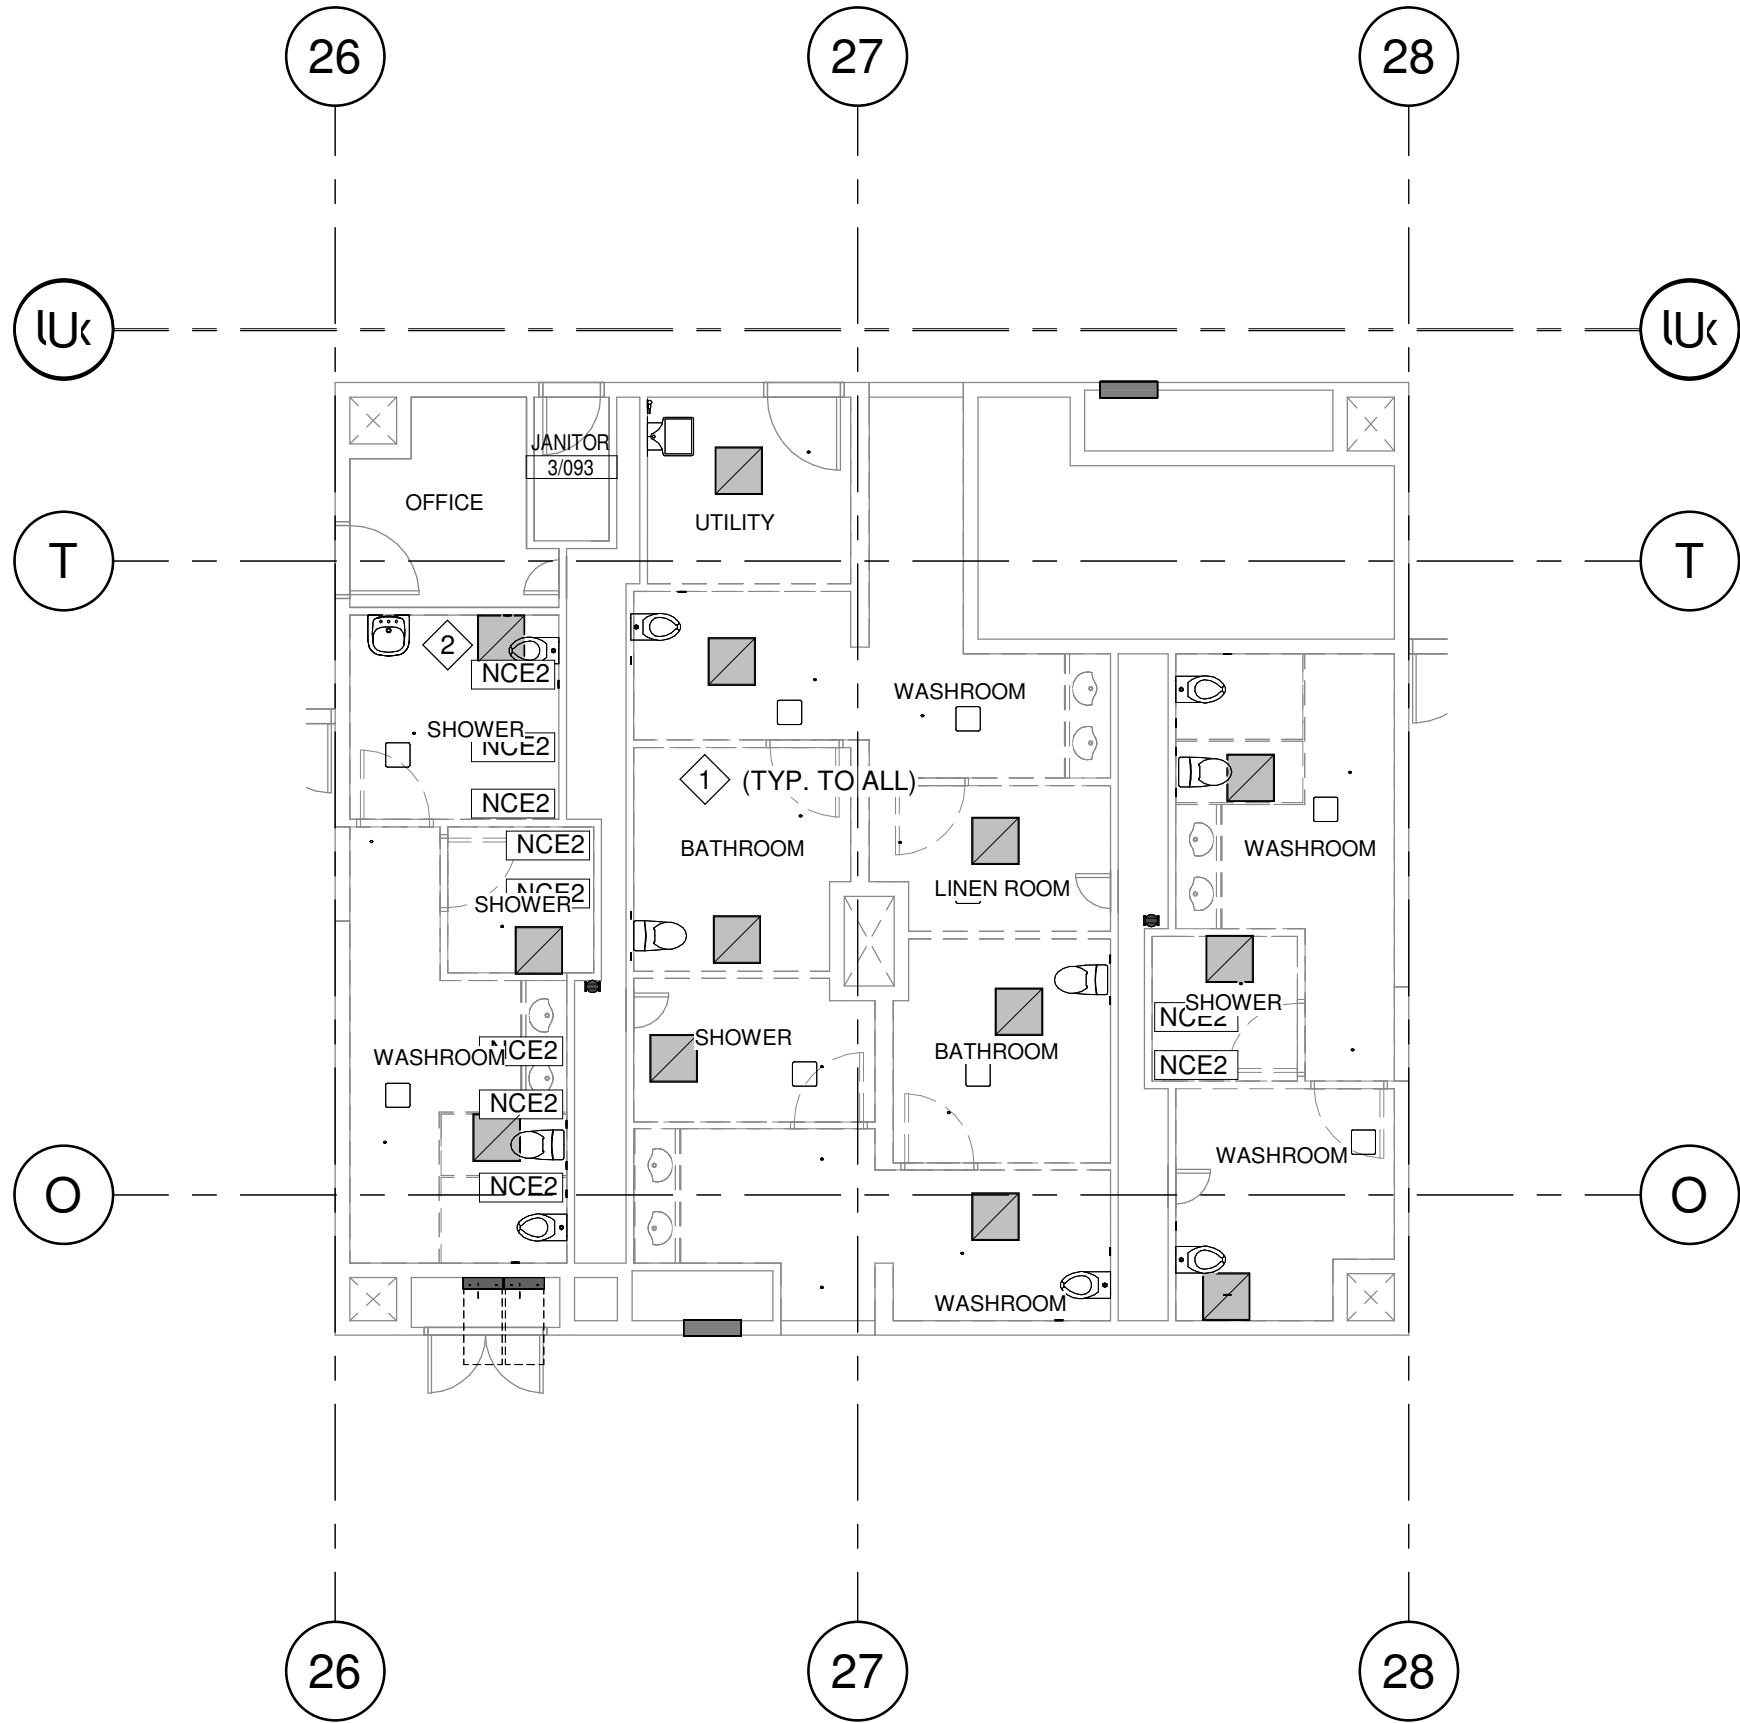


1 LEVEL 3 WASHROOM EAST DEMOLITION PLAN
1 : 100

GENERAL NOTES:

1. MAKE SURE THE EX. DUCTWORK AND BALANCING DAMPER IS NOT DAMAGED. COORDINATE WITH THE REMOVAL AND REPLACEMENT OF CEILING TILES.
2. PROTECT THE EX. RETURN AIR GRILLES FROM DAMAGE DURING CONSTRUCTION
3. SEAL ALL DUCTWORK IN THE CONSTRUCTION AREA TO PREVENT DUST CONTAMINATING HVAC SYSTEM.
4. PROVIDE COMPLETE AIR BALANCING OF THE HVAC DISTRIBUTION SYSTEM AT THE END OF CONSTRUCTION
5. CONTRACTOR SHALL MAKE SURE ALL HVAC SERVICES IN OTHER PHASES REMAIN IN OPERATION THROUGHOUT CONSTRUCTION.
6. PROTECT EXISTING DUCTWORK SYSTEM FROM DAMAGE DURING CONSTRUCTION
7. CONTRACTOR SHALL TAKE ALL NECESSARY PRECAUTIONS TO AVOID ANY DAMAGE TO EXISTING SERVICES. ANY DAMAGE TO EXISTING SERVICES SHALL BE FIXED BY CONTRACTOR AT NO COST TO THE PROJECT.
8. VERIFY EXISTING CONDITION PRIOR TO CONSTRUCTION.

CONSTRUCTION NOTES:

- 1** ALL EX. EXHAUST AIR GRILLES TO BE REMOVED AND REPLACED AS PER NEW DWGS.

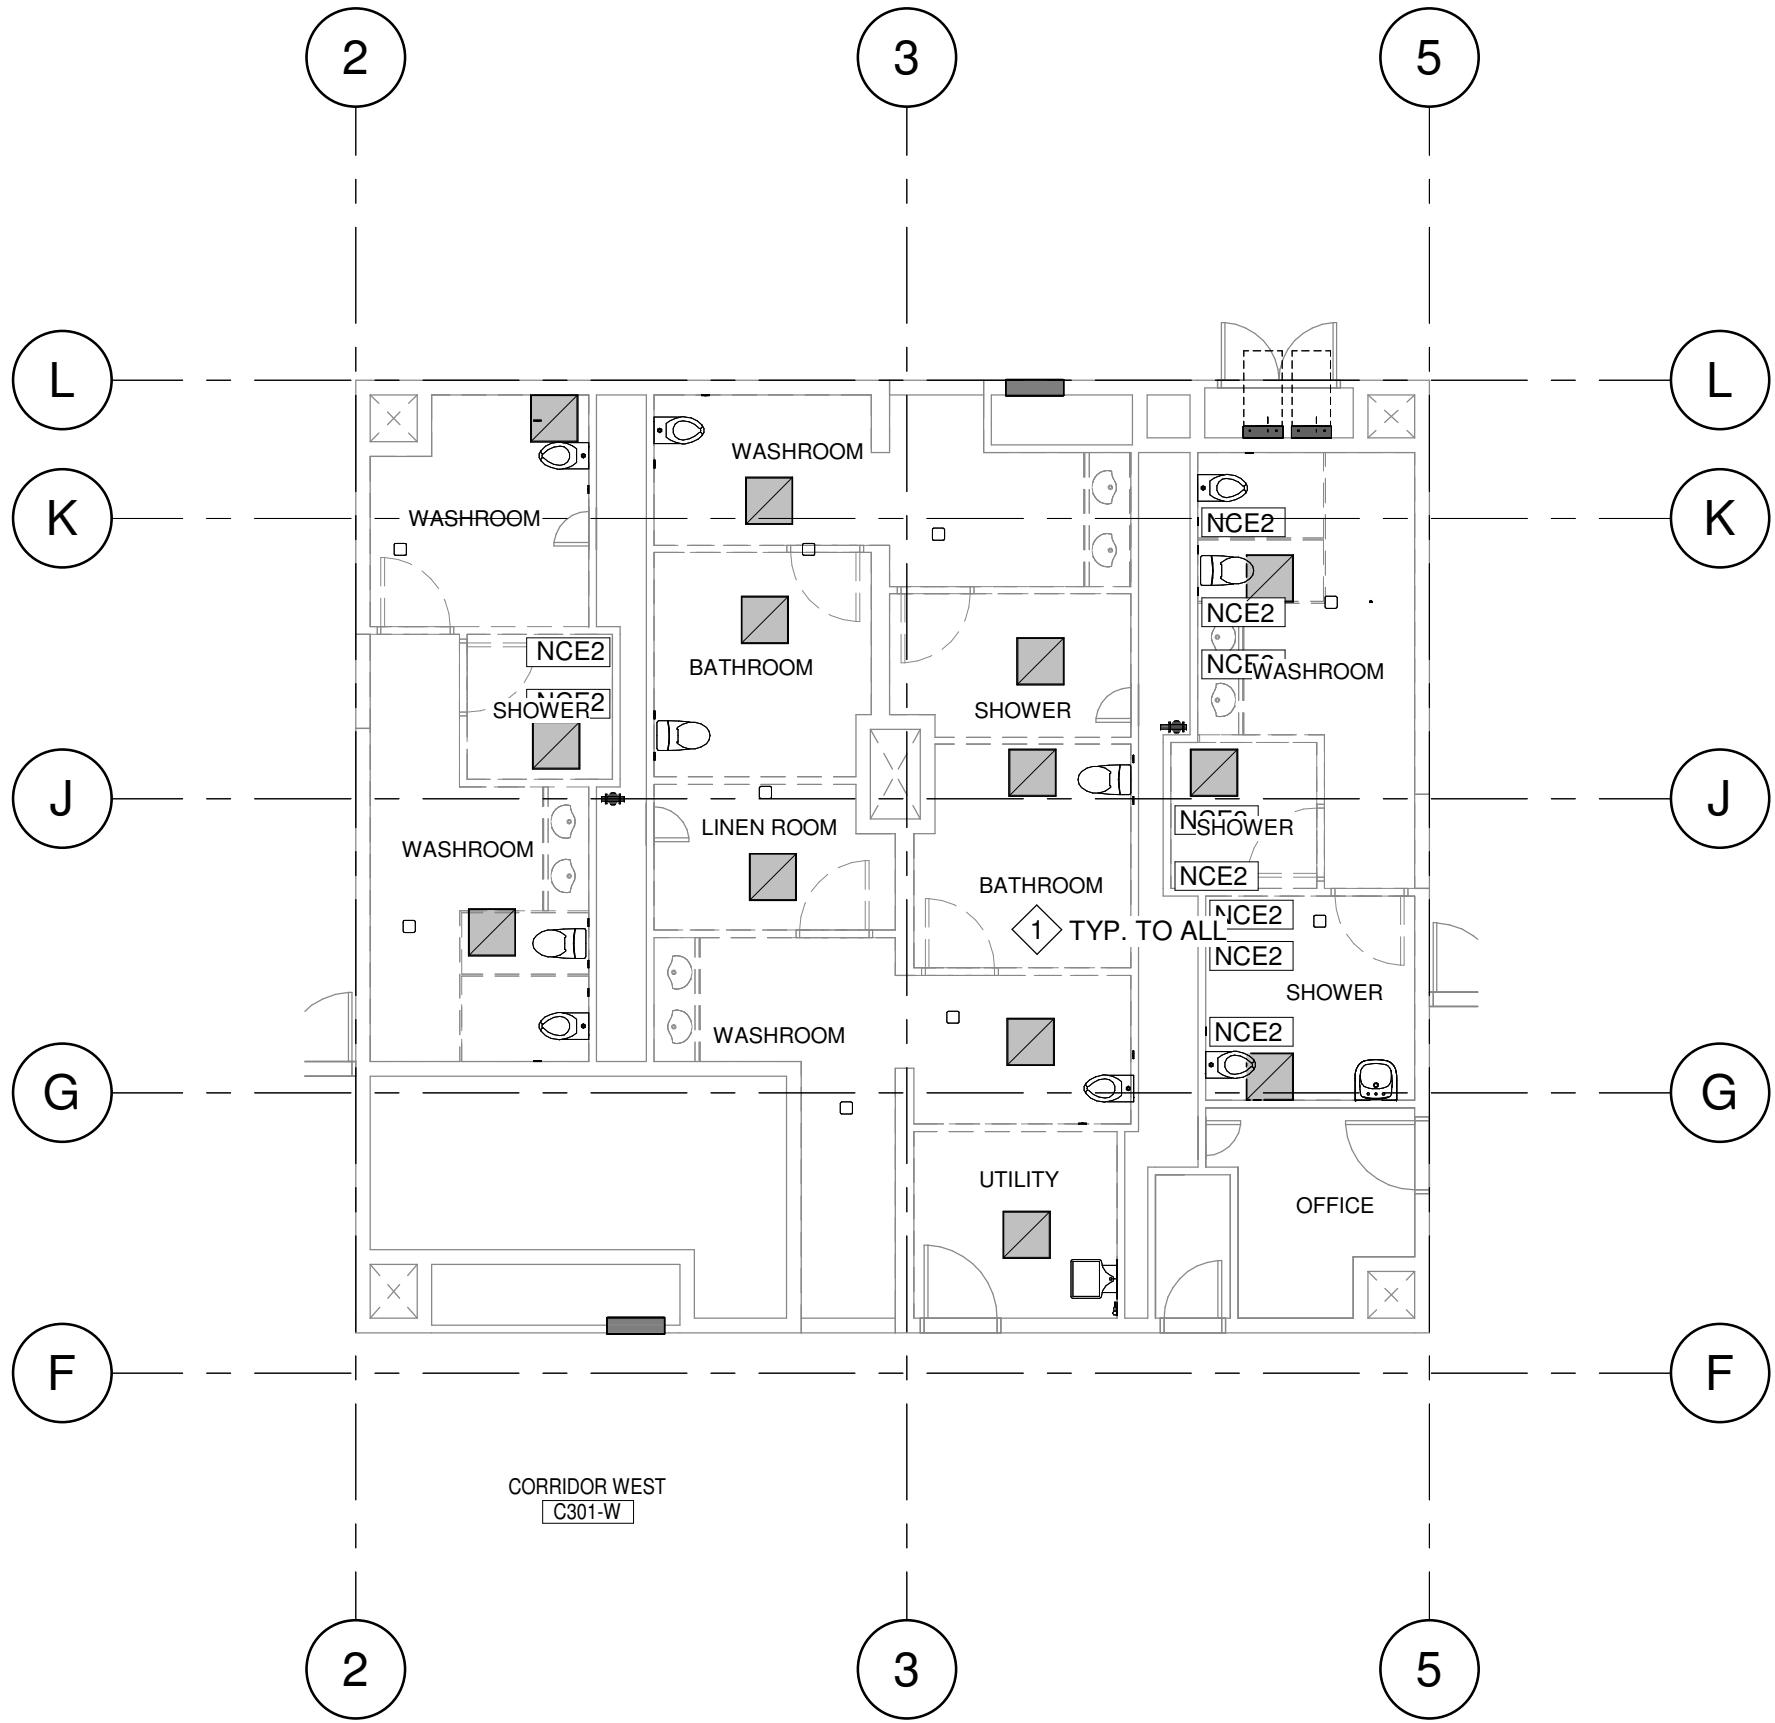

2 LEVEL 3 WASHROOM WEST DEMOLITION PLAN
1 : 100

6	2024-12-16	ISSUED FOR TENDER	CEL
5	2024-11-08	ISSUED FOR BUILDING PERMIT	CEL
4	2024-10-10	REISSUED FOR 100% CD	CEL
3	2024-09-30	ISSUED FOR 100% CD	CEL
2	2024-09-04	ISSUED TO MSA FOR FINAL REVIEW	CEL
1	2024-08-23	ISSUED FOR DESIGN DEVELOPMENT	CEL
#	date:	revision:	by
revisions			



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**CASTLEVIEW
WYCHWOOD TOWERS**


351 CHRISTIE ST, TORONTO, ONTARIO M6G 3C3

**LEVEL 3 DEMOLITION
PLAN**


scale: 1 : 100
drawn by: Author
reviewed by: VS
job number: 24503-03
plot date: Issue Date

drawing number:

M-401D

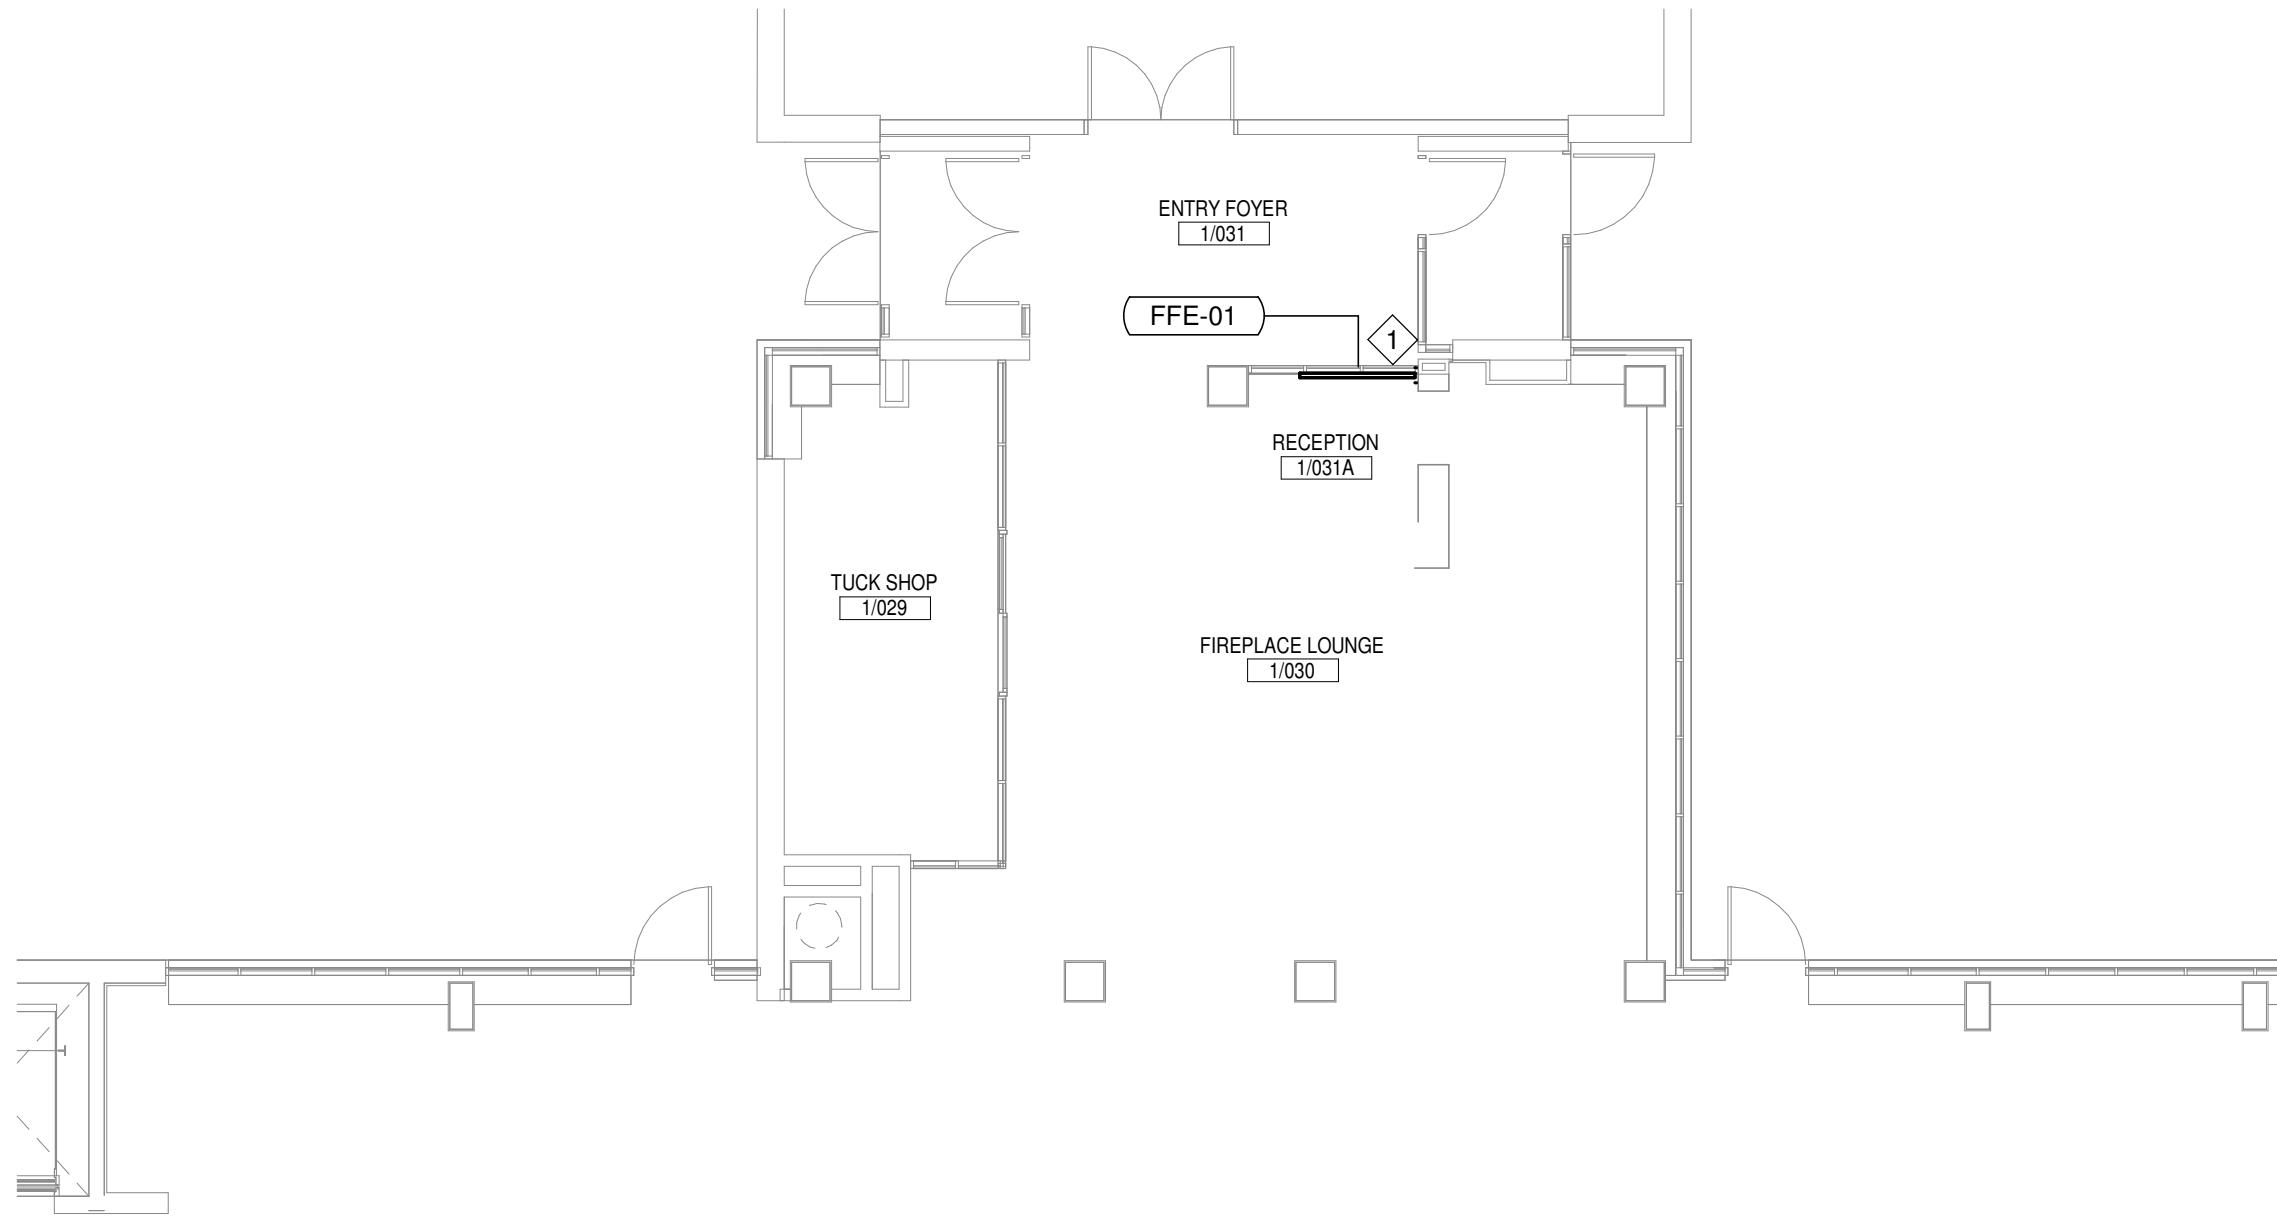

1 PROPOSED PLAN - HVAC LEVEL 1 RECEPTION
1 : 100

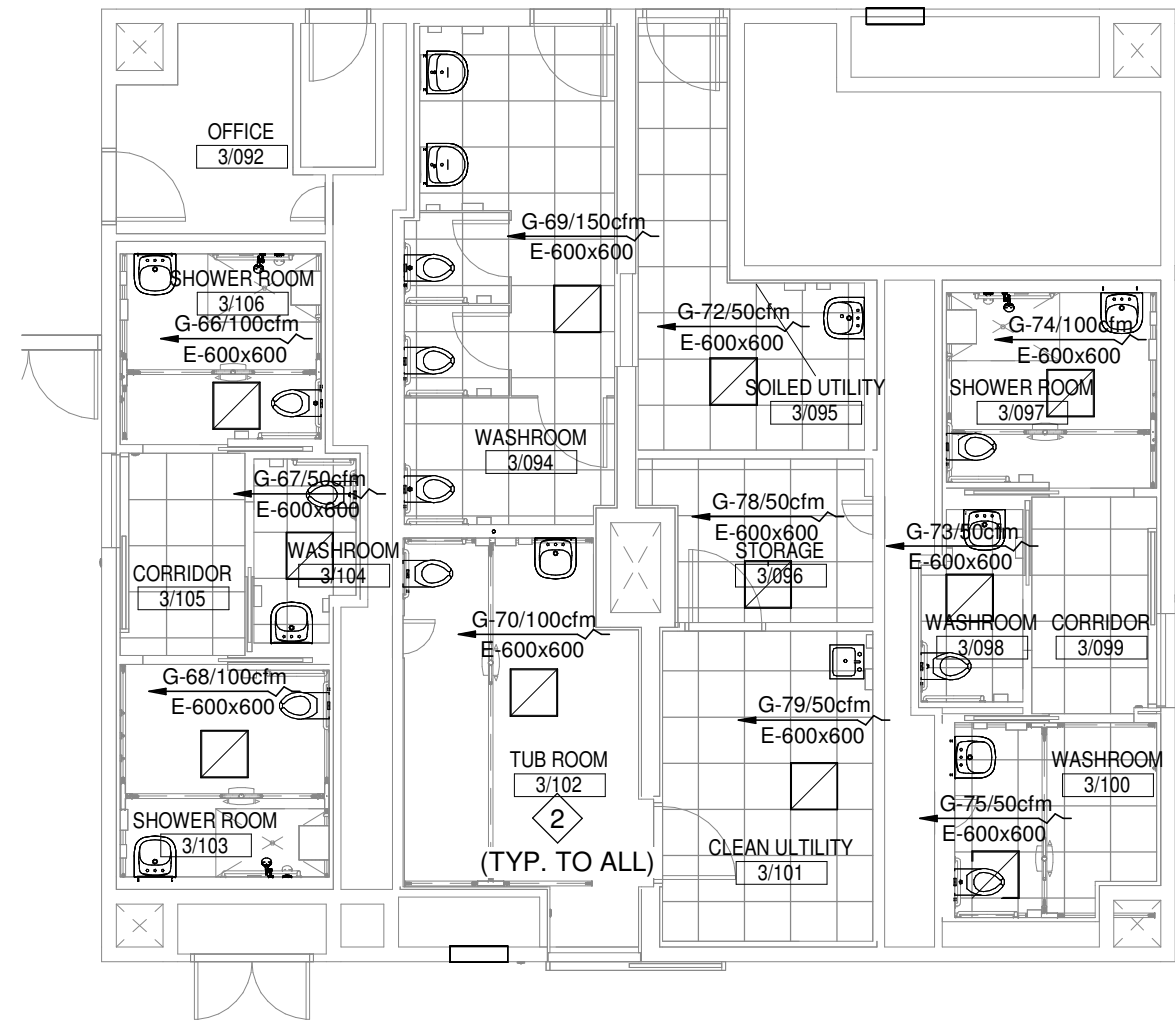


2 LEVEL 3 WASHROOM EAST PROPOSED PLAN
1 : 100

GENERAL NOTES:

1. PROTECT THE HVAC EQUIPMENT FROM DAMAGE DURING CONSTRUCTION
2. SEAL ALL DUCTWORK IN THE CONSTRUCTION AREA TO PREVENT DUST CONTAMINATING HVAC SYSTEM.
3. PROVIDE COMPLETE AIR BALANCING OF THE HVAC DISTRIBUTION SYSTEM BEFORE START AND AT THE END OF CONSTRUCTION.
4. THE HVAC SYSTEM SHALL BE BALANCED TO DESIGN CFM AS NOTED OR MATCH EX. CFM. IN THE EVENT THAT THE DESIGN CFM IS NOT ACHIEVABLE, CONTRACTOR SHALL DISCUSS WITH THE CONSULTANT.
5. MAKE SURE THE EX. DUCTWORK AND BALANCING DAMPER IS NOT DAMAGED. COORDINATE WITH THE REMOVAL AND REPLACEMENT OF CEILING TILES.
6. PROTECT THE EX. RETURN AIR GRILLES FROM DAMAGE DURING CONSTRUCTION
7. COORDINATE THE AIR GRILLE LOCATIONS WITH SPRINKLER HEADS AND ELECTRICAL FIXTURES.

CONSTRUCTION NOTES

- 1 PROVIDE FORCE FLOW ELECTRIC HEATER IN THIS LOCATION. COORDINATE THE LOCATION WITH ARCH DWGS. FORCE FLOW HEATER SHALL BE DIMPLEX MAKE, MODEL #LC6025W31 2500 WATTS, 240/208 VOLTS C/W BUILT IN THERMOSTAT.
- 2 PROVIDE NEW EXHAUST AIR GRILLES, COORDINATE WITH ARCH RCP.

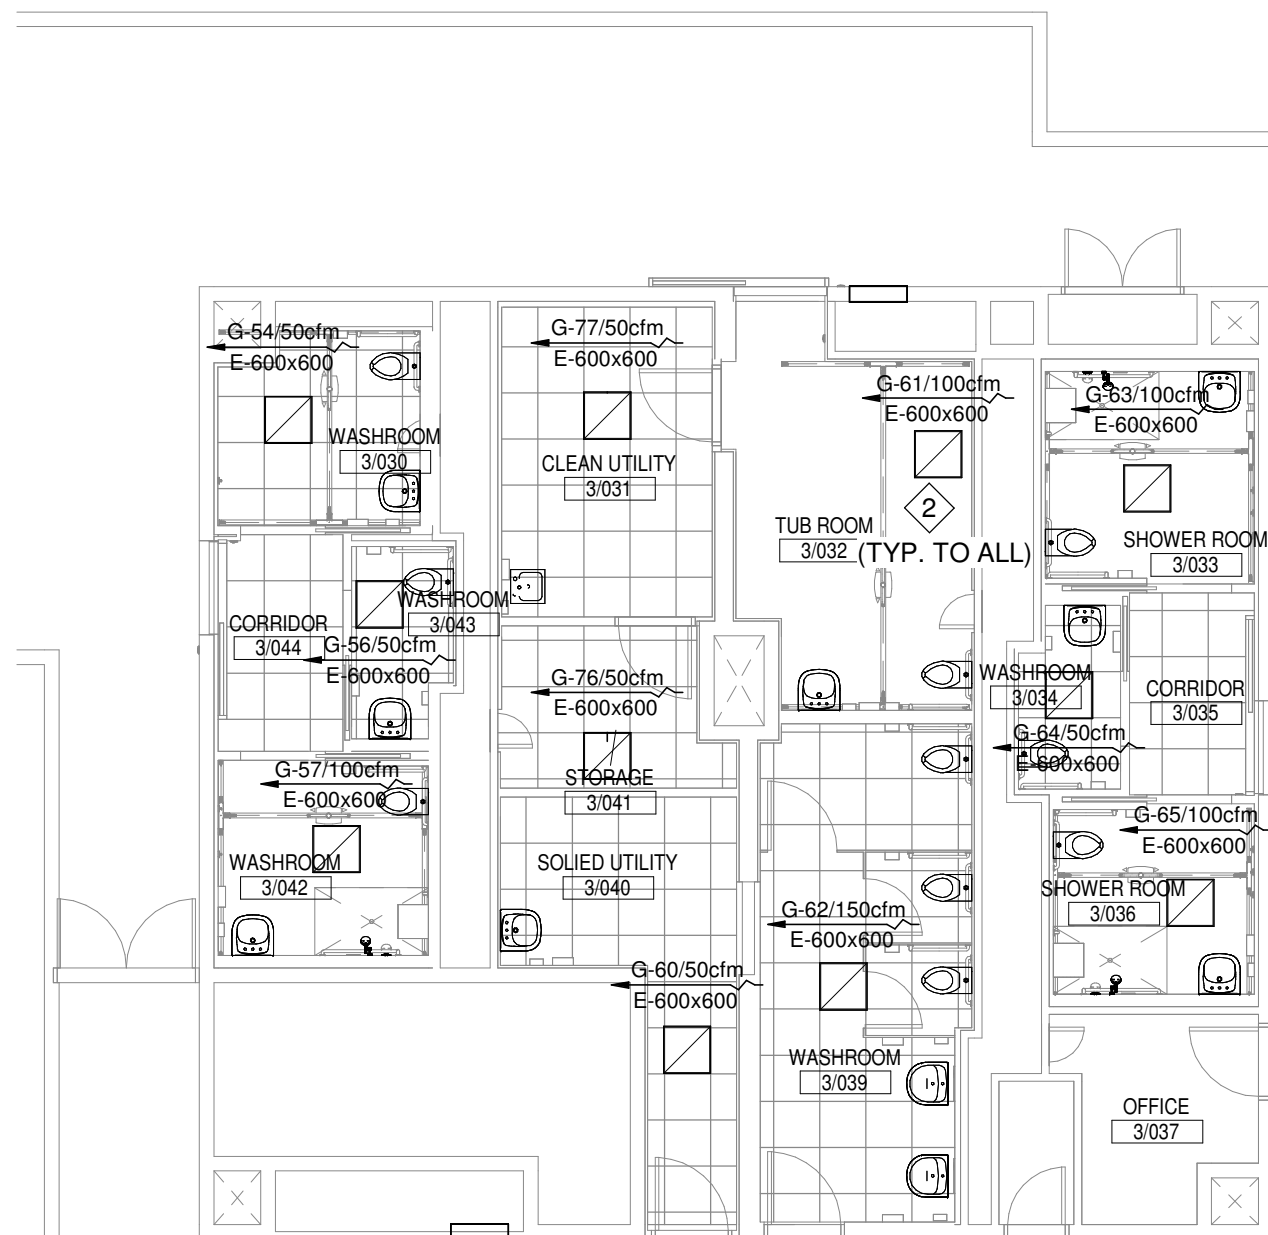

3 LEVEL 3 WASHROOM WEST PROPOSED PLAN
1 : 100

8	2024-12-16	ISSUED FOR TENDER	CEL
7	2024-11-08	ISSUED FOR BUILDING PERMIT	CEL
6	2024-10-10	REISSUED FOR 100%CD	CEL
5	2024-09-30	ISSUED FOR 100% CD	CEL
4	2024-09-04	ISSUED TO MSA FOR FINAL REVIEW	CEL
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#	date:	revision:	by
revisions			



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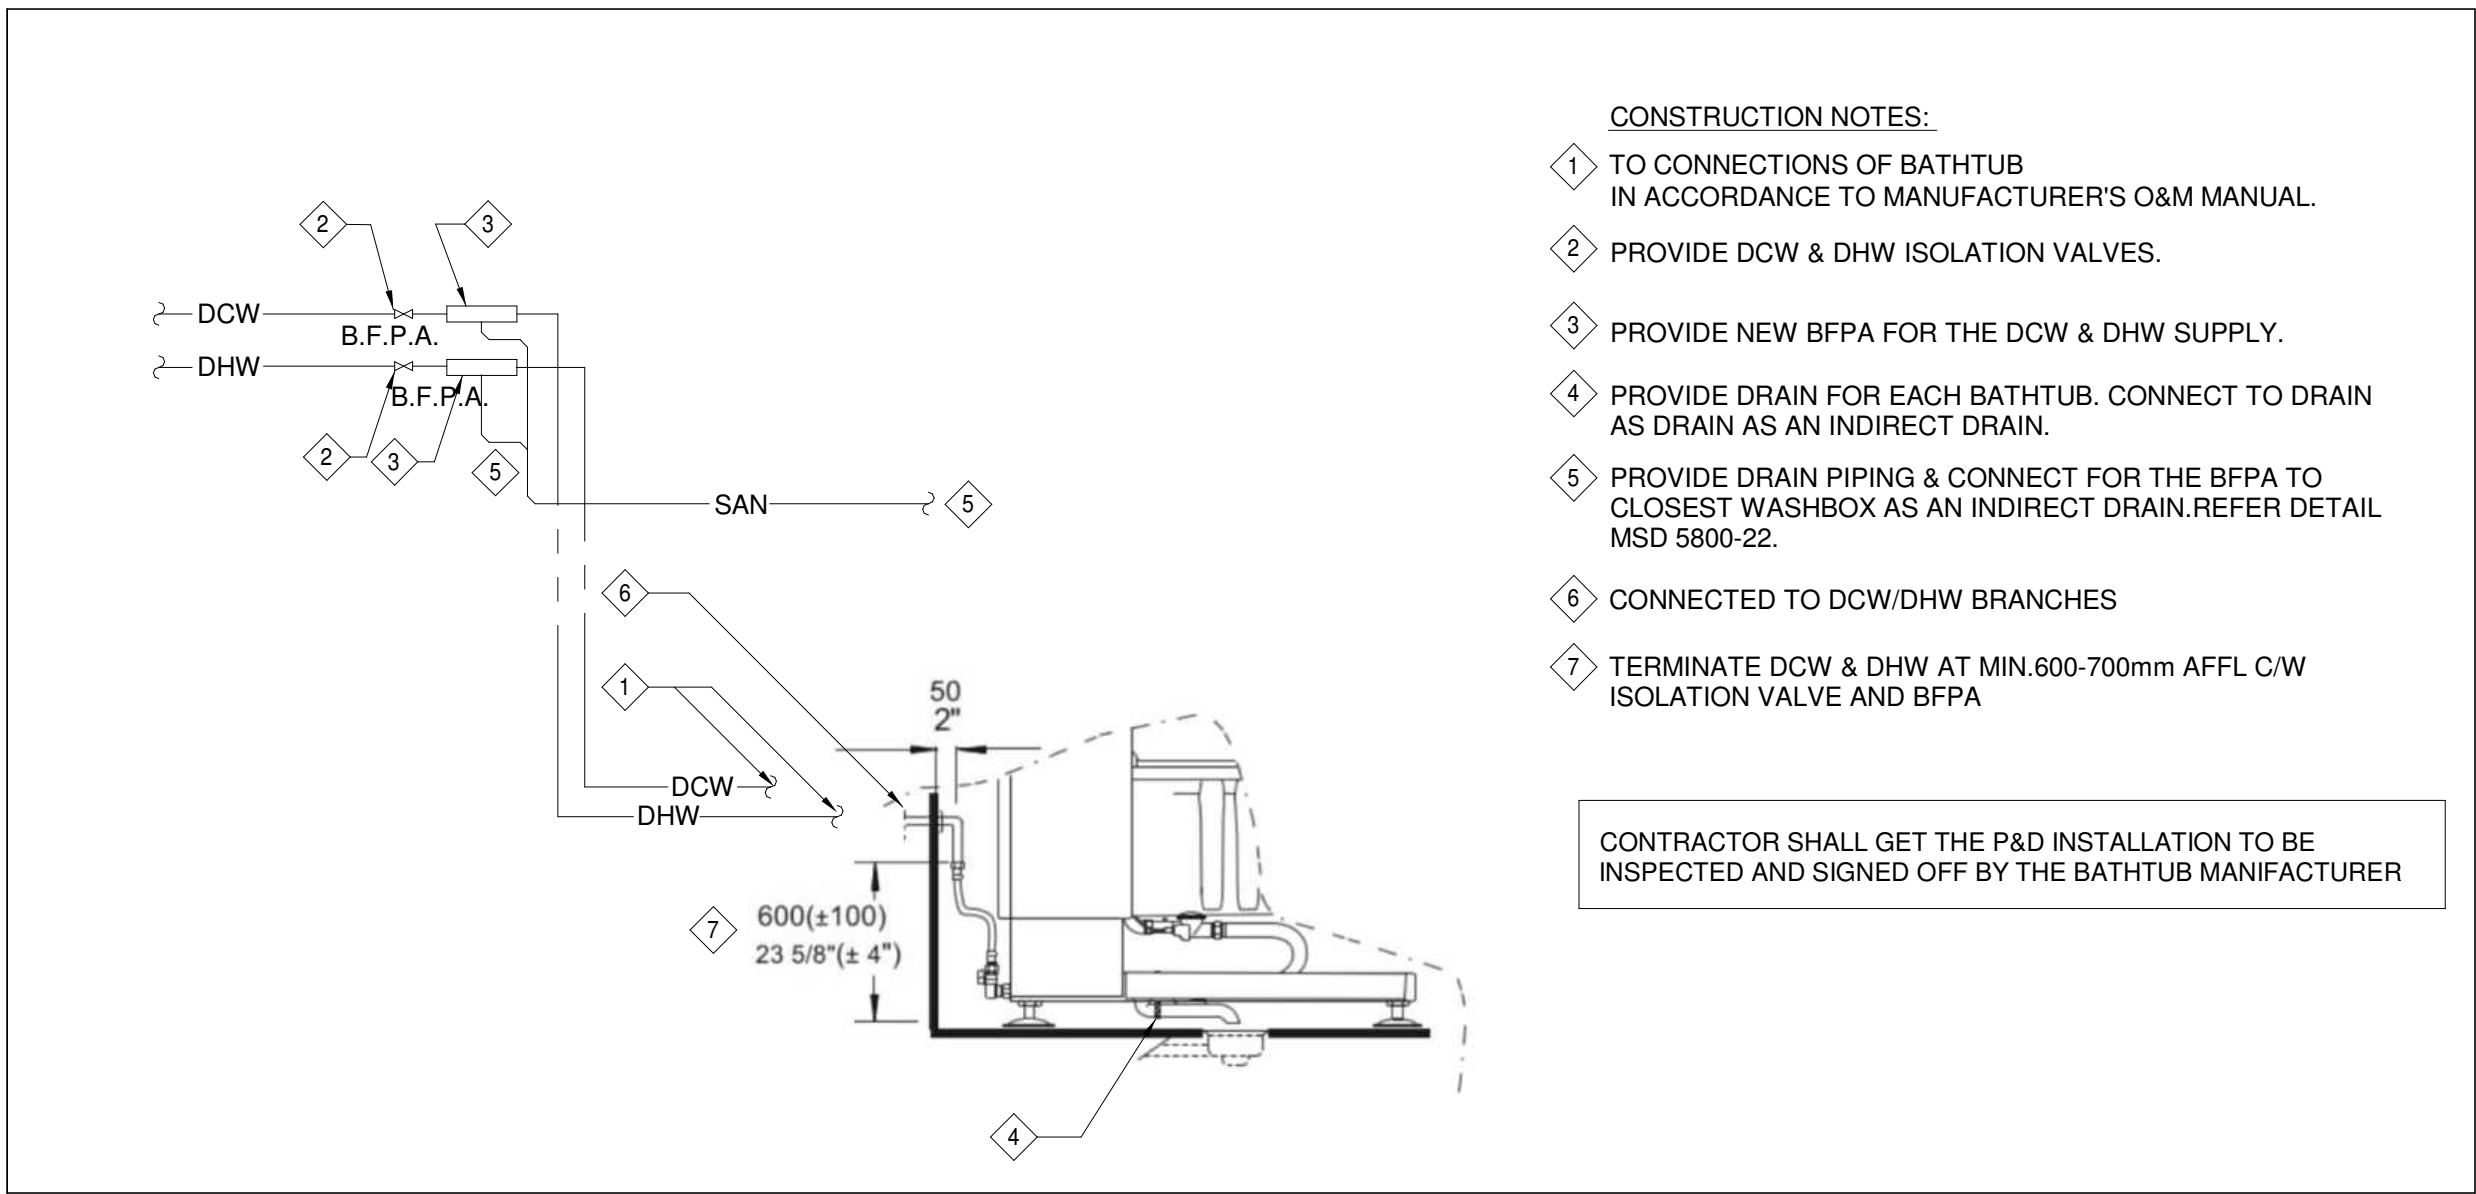
CASTLEVIEW
WYCHWOOD TOWERS

351 CHRISTIE ST, TORONTO, ONTARIO M6G 3C3

LEVEL 1 & LEVEL 3
PROPOSED PLAN


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drawing number:	M-401

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1 PLUMBING DETAIL FOR BATHTUB

N.T.S.



2 WASH BOX FOR INDIRECT DRAIN CONNECTION

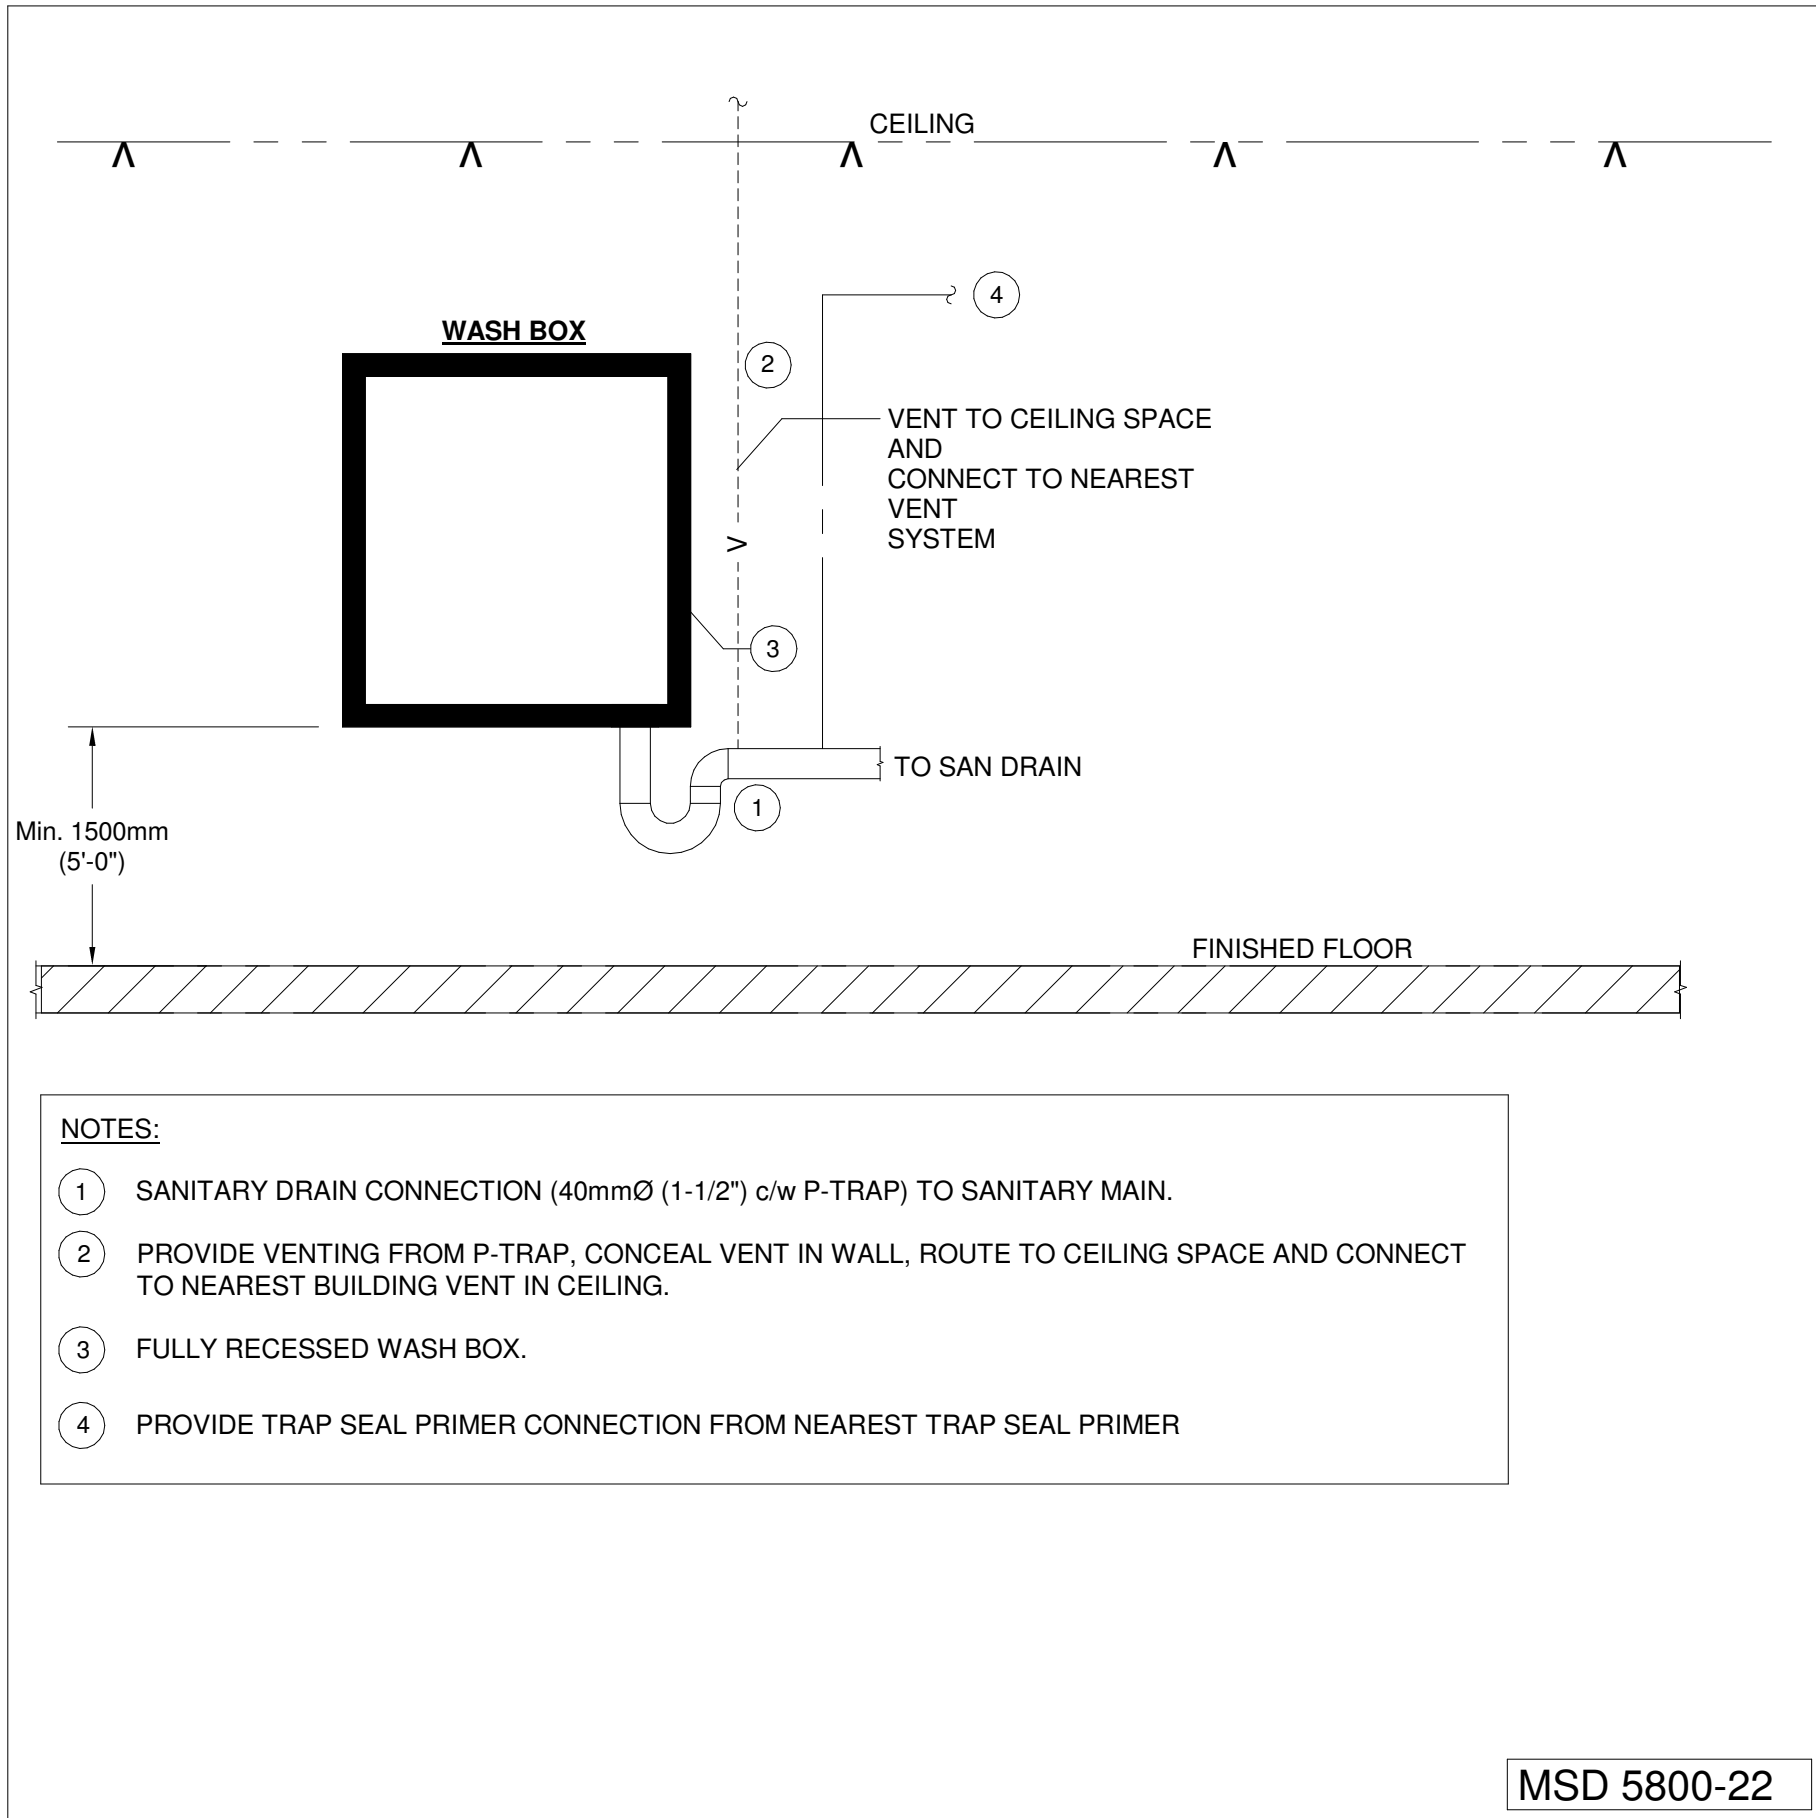N.T.S.

Montgomery Sisam Architects Inc.

197 Spadina Avenue, Toronto, Ontario M5T 2C8
montgomerysisam.com Tel 416.364.8079 Fax
416.364.7723

MontgomerySisam

CROSSEY
ENGINEERING
A Salas O'Brien Company

5	2024-12-16	ISSUED FOR TENDER	CEL
4	2024-11-08	ISSUED FOR BUILDING PERMIT	CEL
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1	2024-09-04	ISSUED TO MSA FOR FINAL REVIEW	CEL

date: revision: by
revisions



All drawing and specifications are the property of the architect. The contractor shall verify all dimensions and information on site and report any discrepancy to architect before proceeding.

CASTLEVIEW
WYCHWOOD TOWERS

351 CHRISTIE ST, TORONTO, ONTARIO M6G 3C3

SHEET 1

scale: N.T.S.
drawn by: Author
reviewed by: VS
job number: 24503-03
plot date: Issue Date

drawing number:

M-901