### GENERAL NOTES

- ALL SERVICES TO BE INSTALLED AS PER CITY OF CAYUGA CONSTRUCTION AND MATERIAL SPECIFICATIONS MANUAL (LATEST EDITION) AND MINISTRY OF THE ENVIRONMENT GUIDELINES (LATEST EDITION).
- 2. APPROVAL OF THIS DRAWING IS FOR MATERIAL ACCEPTABILITY AND COMPLIANCE WITH MUNICIPAL AND PROVINCIAL SPECIFICATIONS AND STANDARDS ONLY.

  APPROVAL AND INSPECTION BY THE CITY OF THE WORKS DOES NOT CERTIFY THE LINE AND GRADE OF THE WORKS AND IT IS THE OWNER'S RESPONSIBILITY TO HAVE THEIR ENGINEER CERTIFY THIS ACCORDINGLY.

# ROAD WORK

#### FINAL ROADWAYS

a) CROSS-FALL TO BE 2.0%.

COURSE ASPHALT (HL 8).

- b) STANDARD DEEP STRENGTH PAVEMENT (40mm HM 3, 80mm HL 8 ON 150mm GRANULAR 'A' & 300mm GRANULAR 'B', TYPE II 100% CRUSHED AGGREGATE) FOR TYPICAL URBAN RESIDENTIAL STREETS.
- c) FOR MAJOR COLLECTOR ROADS (NAME OF ROADS) TYPICAL PAVEMENT PROFILE SHALL BE 40mm HM 3(HD), 100mm HL 8(HS) ON 150mm GRANULAR 'A' & 300mm GRANULAR 'B', TYPE II 100% CRUSHED AGGREGATE.
- d) MANHOLES AND CATCH BASINS SHALL BE INSTALLED FLUSH WITH THE BASE
- e) MANHOLES TO BE ADJUSTED TO MATCH FINAL LIFT OF ASPHALT.
- f) FOR MANHOLE AND CATCH BASIN TOP ADJUSTMENTS, ALL PERMANENT ADJUSTMENTS ARE TO BE POURED IN PLACE.
- g) FINAL ASPHALT COURSE (HM 3) SHALL BE PLACED A MIN. OF ONE YEAR AFTER THE INSTALLATION OF THE ASPHALT BINDER COURSE.

#### LOT GRADING NOTES

#### GENERAL GRADING NOTES:

1. THE WRITTEN PERMISSION REQUIRED FROM THE ADJACENT LANDOWNER SHALL BE OBTAINED PRIOR TO ENTERING THE LANDS. SHOULD PERMISSION NOT BE OBTAINED OR IS WITHDRAWN PRIOR TO COMMENCING THE WORK, THEN THE DEVELOPER SHALL LIMIT HIS ACTIVITIES TO THE LIMITS OF THE DEVELOPMENT SITE.

# COMPACTION REQUIREMENTS

- a) ALL BEDDING AND BACKFILL MATERIAL, ROAD SUB-GRADES AND GENERALLY ALL MATERIAL USED FOR LOT GRADING AND FILL SECTIONS, ETC., SHALL BE COMPACTED TO MIN. 95% SPD (UNLESS OTHERWISE RECOMMENDED BY THE GEOTECHNICAL ENGINEER). ALL MATERIAL SHALL BE PLACED IN LAYERS NOT EXCEEDING 300mm LIFTS.
- b) ALL GRANULAR ROAD BASE MATERIALS SHALL BE COMPACTED TO 95% SPD.
- c) FOR ALL SEWERS AND WATERMAINS IN FILL SECTIONS, THE COMPACTION SHALL BE CERTIFIED BY A GEOTECHNICAL ENGINEER PRIOR TO LAYING OF PIPE.

# SILTATION AND EROSION CONTROL

- A. ALL SILTATION CONTROL MEASURES SHALL BE CLEANED AND MAINTAINED AFTER EACH RAINFALL AND ALSO WEEKLY AS DIRECTED AND TO THE SATISFACTION OF THE
- B. ADDITIONAL SILT CONTROL LOCATIONS MAY BE REQUIRED AS DETERMINED BY THE
- C. PROTECT ALL DISTURBED AND EXPOSED AREAS AS A RESULT OF CONSTRUCTION. STORM WATER MEASURES DURING CONSTRUCTION TO BE UTILIZED TO ENSURE SUITABLE DRAINAGE WHILE MINIMIZING EROSION. STOCKPILES ARE TO BE SEEDED OR COVERED WITH VEGETATIVE GROWTH FOR THE DURATION OF CONSTRUCTION.
- D. PROTECT ALL MANHOLES, AND PIPE ENDS (EXISTING AND NEW) FROM SEDIMENT INTRUSION WITH GEOTEXTILE CLOTH (TERRAFIX 270r), ALL CATCHBASINS TO HAVE SILTSACK AS PER THE ATTACHED DETAILS.
- PREVENT WIND-BLOWN DUST TO THE BEST OF THE CONTRACTORS ABILITY. KEEP SOIL DAMP DURING DRY WHETHER OR BY OTHER MEANS NECESSARY TO COMPLETE THE
- F. EROSION CONTROL STRUCTURES TO BE MONITORED REGULARLY BY CONTRACTOR AND ANY DAMAGE REPAIRED IMMEDIATELY. SEDIMENTS TO BE REMOVED WHEN ACCUMULATIONS REACH A MAXIMUM OF ONE THIRD (1/3) THE HEIGHT OF THE SILT FENCE.
- G. ALL EROSION CONTROL STRUCTURES TO REMAIN IN PLACE UNTIL ALL DISTURBED GROUND SURFACES HAVE BEEN RE-STABILIZED EITHER BY PAVING OR RESTORATION OF VEGETATIVE GROUND COVER.
- H. THE CONTRACTOR IS RESPONSIBLE FOR REMOVING SEDIMENTS FROM THE MUNICIPAL

ROADWAY AND SIDEWALKS AT THE END OF EACH WORK DAY.

## SITE GRADING

- NATIVE BACKFILL MATERIAL SHALL BE COMPACTED TO 98% STANDARD PROCTOR DENSITY. GRANULAR BACKFILL MATERIAL SHALL BE PLACED IN LAYERS 150mm IN DEPTH AND COMPACTED TO 98% STANDARD PROCTOR
- 2. REFER TO SITE PLAN FOR LAYOUT DIMENSIONS AND DETAILS.
- 3. PAVEMENT SHALL BE:

THICKNESS (mm)	
heavy duty asphalt (roadway & drive isles)	
40	
50	
150	
350	


- 4. SUBMIT ASPHALT MIX DESIGN AND TRIAL MIX TEST RESULTS TO CONSULTANT FOR APPROVAL.
- 5. PROOF ROLLING OF SUBGRADE SHALL BE INSPECTED BY THE GEOTECHNICAL
- 6. PLACE GRANULAR BASE TO COMPACTED THICKNESS AS INDICATED. DO NOT PLACE FROZEN MATERIAL.
- 7. ASPHALT MATERIALS SHALL BE ROLLED AND COMPACTED TO A MINIMUM OF
- 8. PROOF ROLLING OF ASPHALT SHALL BE INSPECTED BY THE GEOTECHNICAL CONSULTANT.
- 9. NO PAVING WILL BE ALLOWED DURING RAIN OR WET SUBGRADE AFTER RAIN.


## SITE SPECIFIC NOTES


- ALL PATCHING TO MEET OPSS.PROV 307 FOR PATCHING OF ASPHALT PAVEMENT.


  ALL HOT PATCHING SHALL MEET THE PEOUPPEACENTS OF THE OPSS AMAIN 13.50.

  ALL HOT PATCHING SHALL MEET THE PEOUPPEACENTS OF THE OPSS AMAIN 13.50.
- ALL HOT PATCHING SHALL MEET THE REQUIREMENTS OF THE OPSS.MUNI 1150.
   COLD OR HOT PATCH OR BOTH CAN APPLY DEPENDING ON THE WEATHER
- CONDITIONS. IN CASE COLD PATCH IS APPLIED AND THEN THE HOT PATCH IS APPLIED, THE AREA AROUND THE COLD PATCH IS TO BE SAW CUT AND TO BE CLEANED AND COMPACTED PRIOR TO THE APPLICATION OF THE HOT PATCH.
- 4. FOR AREAS MORE THAN 4 m2 MECHANICAL COMPACTION EQUIPMENT TO BE USED.

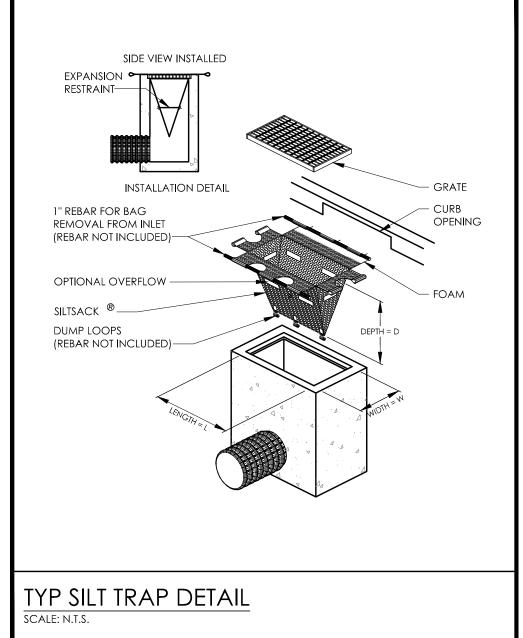

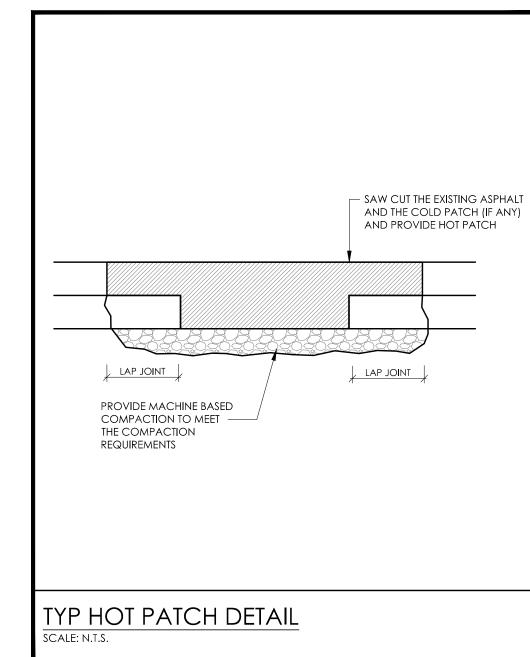

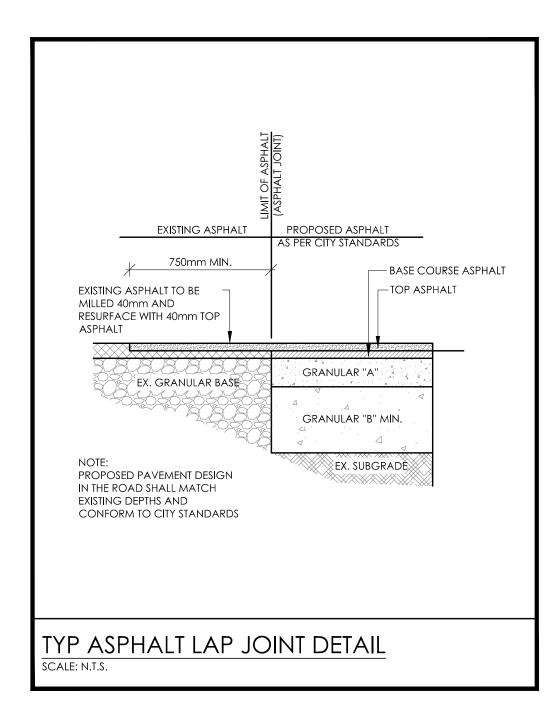

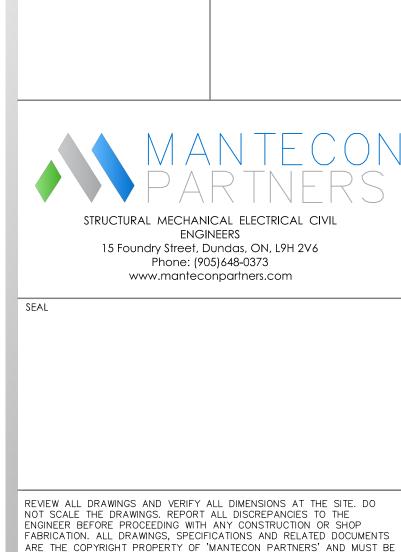

THE ENGINEER'S WRITTEN PERMISSION.

RETURNED UPON REQUEST. REPRODUCTION OF DRAWINGS, SPECIFICATIONS


2025-03-31

2025-02-07

2025-01-15

DATE BY

AND RELATED DOCUMENTS IN PART OR WHOLE IS FORRIDDEN WITHOUT

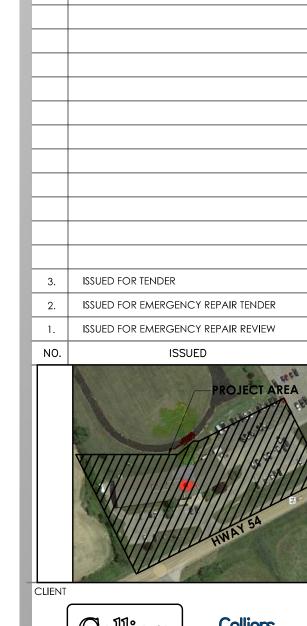

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Infrastructure
Ontario
PROJECT 1101603-274031

ONTARIO PROVINCIAL POLICE

PROJECT:

CAYUGA DETACHMENT
72 HALDIMAND COUNTY HWY
54, CAYUGA, ON, NOA 1E0


EMERGENCY HOT PATCH

DRAWING TITLE:

GENERAL NOTES

RAWN BY:	SCALE:
H.S.	N.T.S
HECKED BY:	DRAWING NUMBER:
Y.T.	
ATE:	$\bigcirc$
2024-02-23	C0.0
ROJECT NUMBER:	
23-137	

March 31, 2025 — 01:31pm Plotted by: Gakinlade

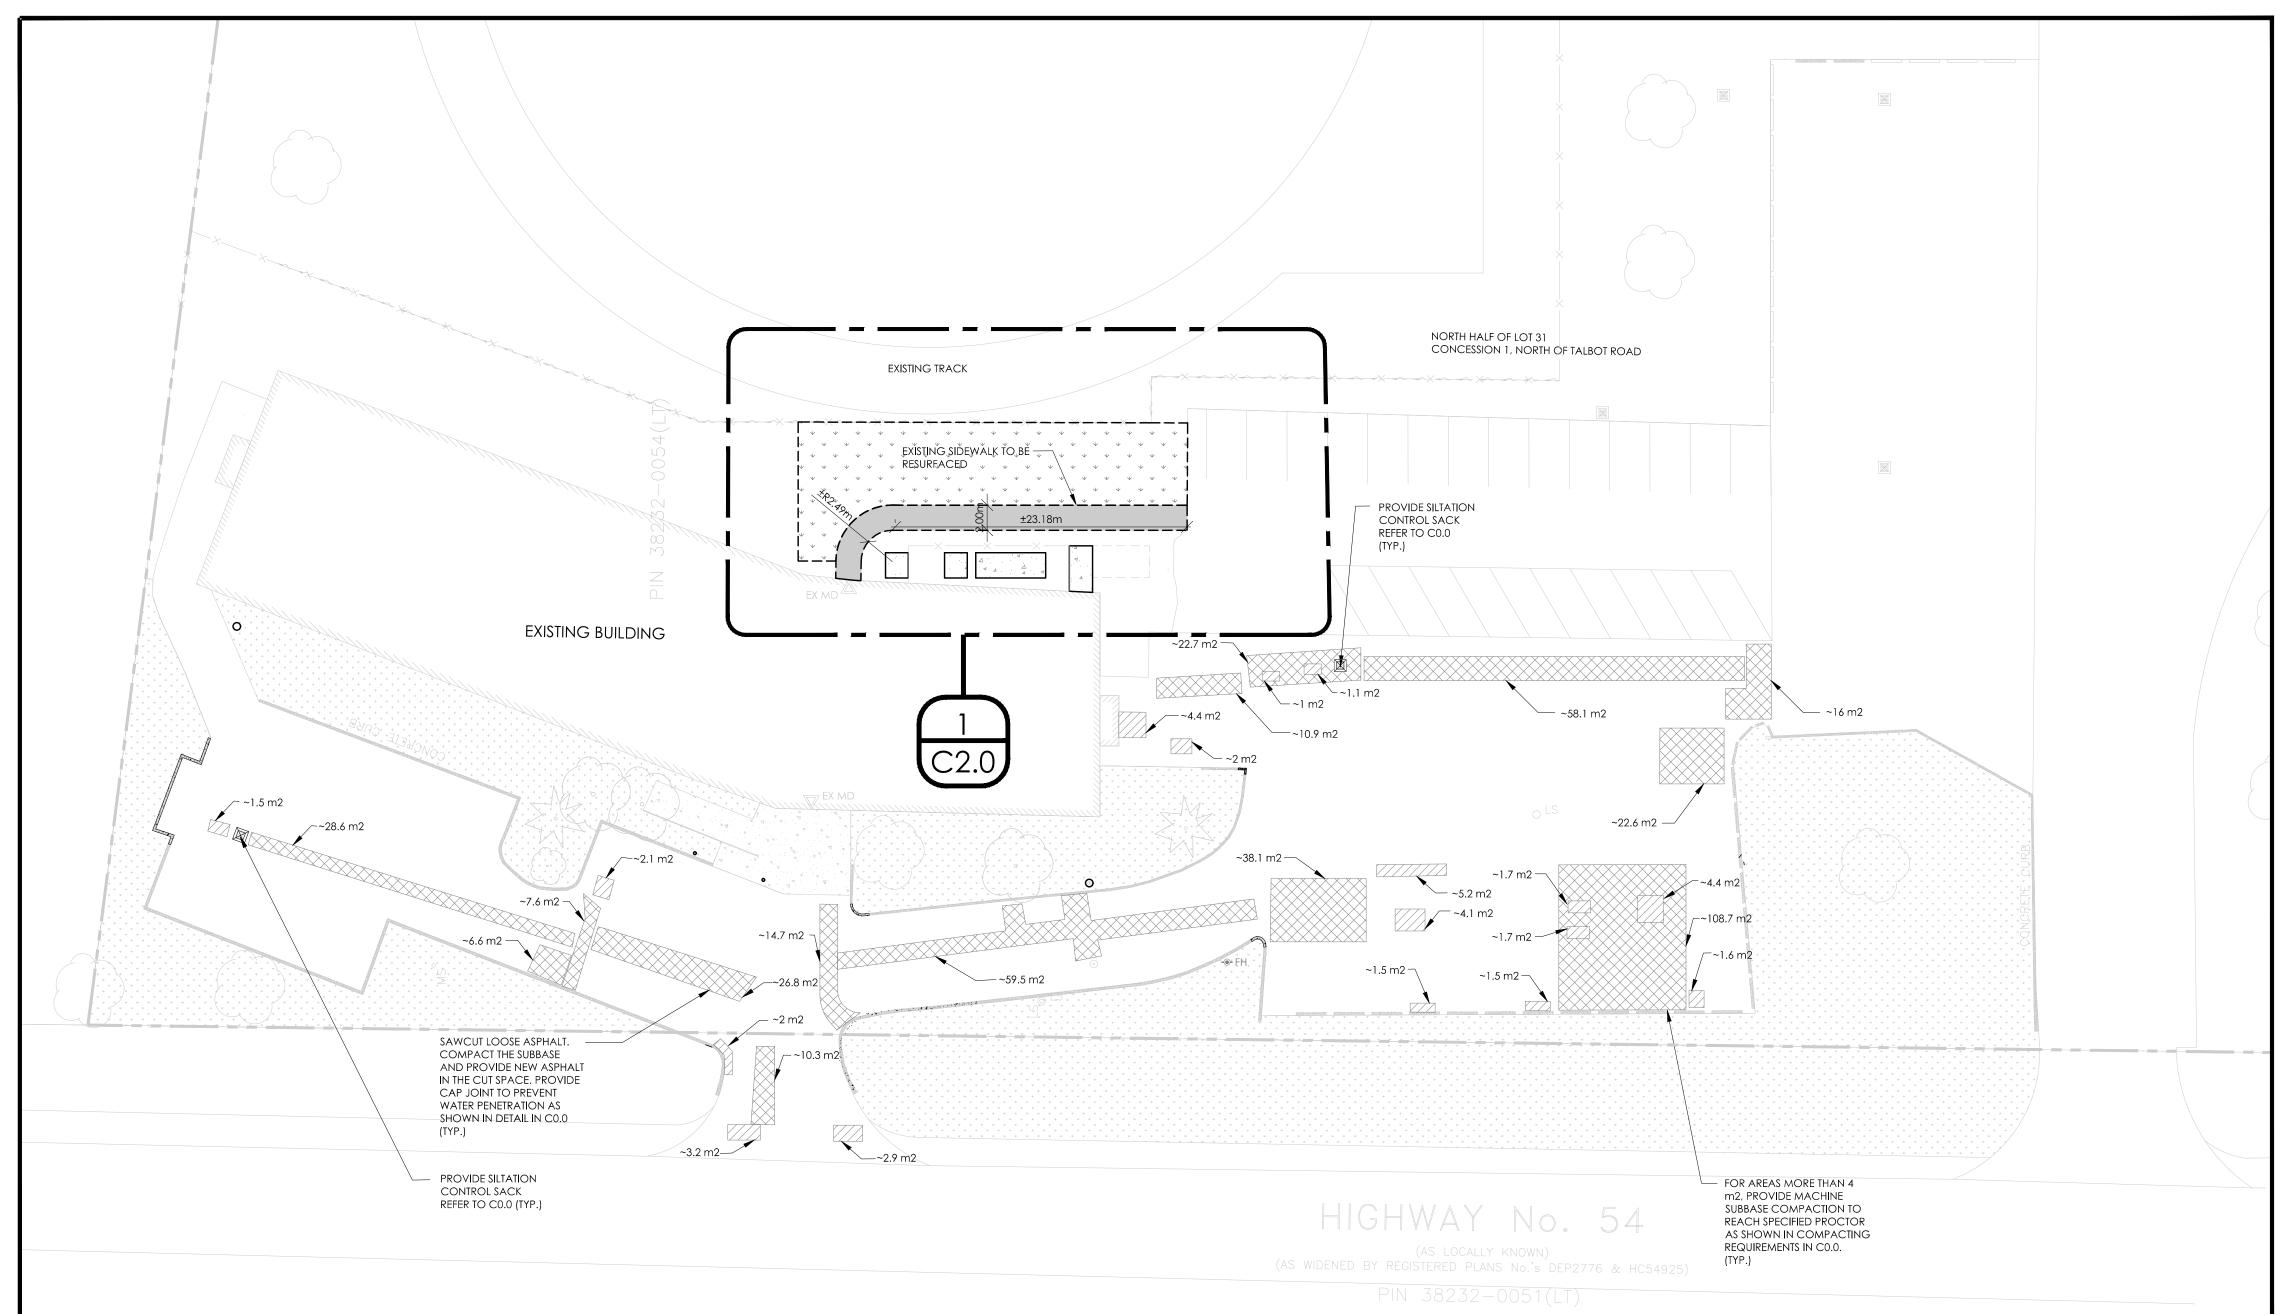

THIS LEGEND OF SYMBOLS REPRESENTS MANTECON PARTNERS INC. STANDARD/GENERIC LEGEND. ALL SYMBOLS MAY NOT APPEAR ON DRAWINGS.

REFER DESCRIPTION

ALLIGATOR CRACKING

POTHOLE

PR SILTATION SACK

AREA QUANTITIES		
REFER	SUBTOTAL AREA	
ALLIGATOR CRACKING	424.6	
POTHOLE	48.5	
TOTAL AREA FOR HOT PATCHING	473.1	
NOTE: AREA QUANTITIES ARE IN SQUARE	METERS	

METRIC: DISTANCES SHOWN ON THIS PLAN ARE IN METRES AND CAN BE CONVERTED TO FEET BY

# HOT PATCHING


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# DEFINITION: HOT PATCHING R

HOT PATCHING REFERS TO THE METHOD USED TO FIX DEFECTS IN ASPHALT SURFACES, PARTICULARLY POTHOLES, CRACKS, AND DEPRESSIONS. THIS TECHNIQUE INVOLVES THE USAGE OF HEATED ASPHALT MATERIALS TO FILL AND LEVEL THE DAMAGED AREA, CREATING A UNIFORM AND SMOOTH SURFACE ONCE IT COOLS AND HARDENS.

#### FREQUENCY:

HOT-PATCH ASPHALT IS GENERALLY CONSIDERED A LONG-TERM SOLUTION, USED FOR FIXING LARGER ROAD ISSUES SUCH AS POTHOLES, CRACKS, AND OTHER TYPES OF PAVEMENT DAMAGE. IF HIGH-QUALITY HOT PATCH MATERIAL IS USED, IT COULD TYPICALLY LAST UP TO 3 - 7 YEARS.



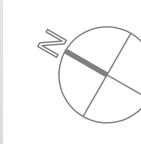

TRUE NORTH CONSTRUCTION NO


STRUCTURAL MECHANICAL ELECTRICAL CIVIL ENGINEERS
15 Foundry Street, Dundas, ON, L9H 2V6
Phone: (905)648-0373
www.manteconpartners.com

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3. ISSUED FOR TENDER 2025-03-31 Y.T.
2. ISSUED FOR EMERGENCY REPAIR TENDER 2025-02-07 Y.T.
1. ISSUED FOR EMERGENCY REPAIR REVIEW 2025-01-15 Y.T.

NO. ISSUED DATE BY





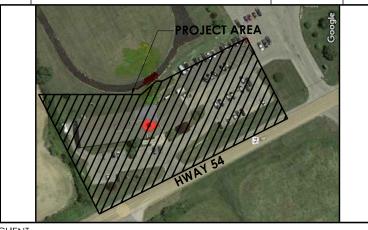

ONTARIO PROVINCIAL POLICE

PROJECT:

CAYUGA DETACHMENT
72 HALDIMAND COUNTY HWY
54, CAYUGA, ON, NOA 1E0

EMERGENCY HOT PATCH

DRAWING TITLE:


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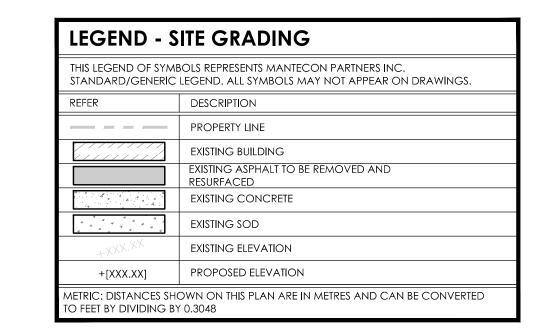
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ROJECT NUMBER: 23-137	


EMERGENCY REPAIRS (PATCHING)
SCALE: 1:300

ORIGINAL SHEET — ARCH D

March 31, 2025 — 05:11pm Plotted by: Gakinlade



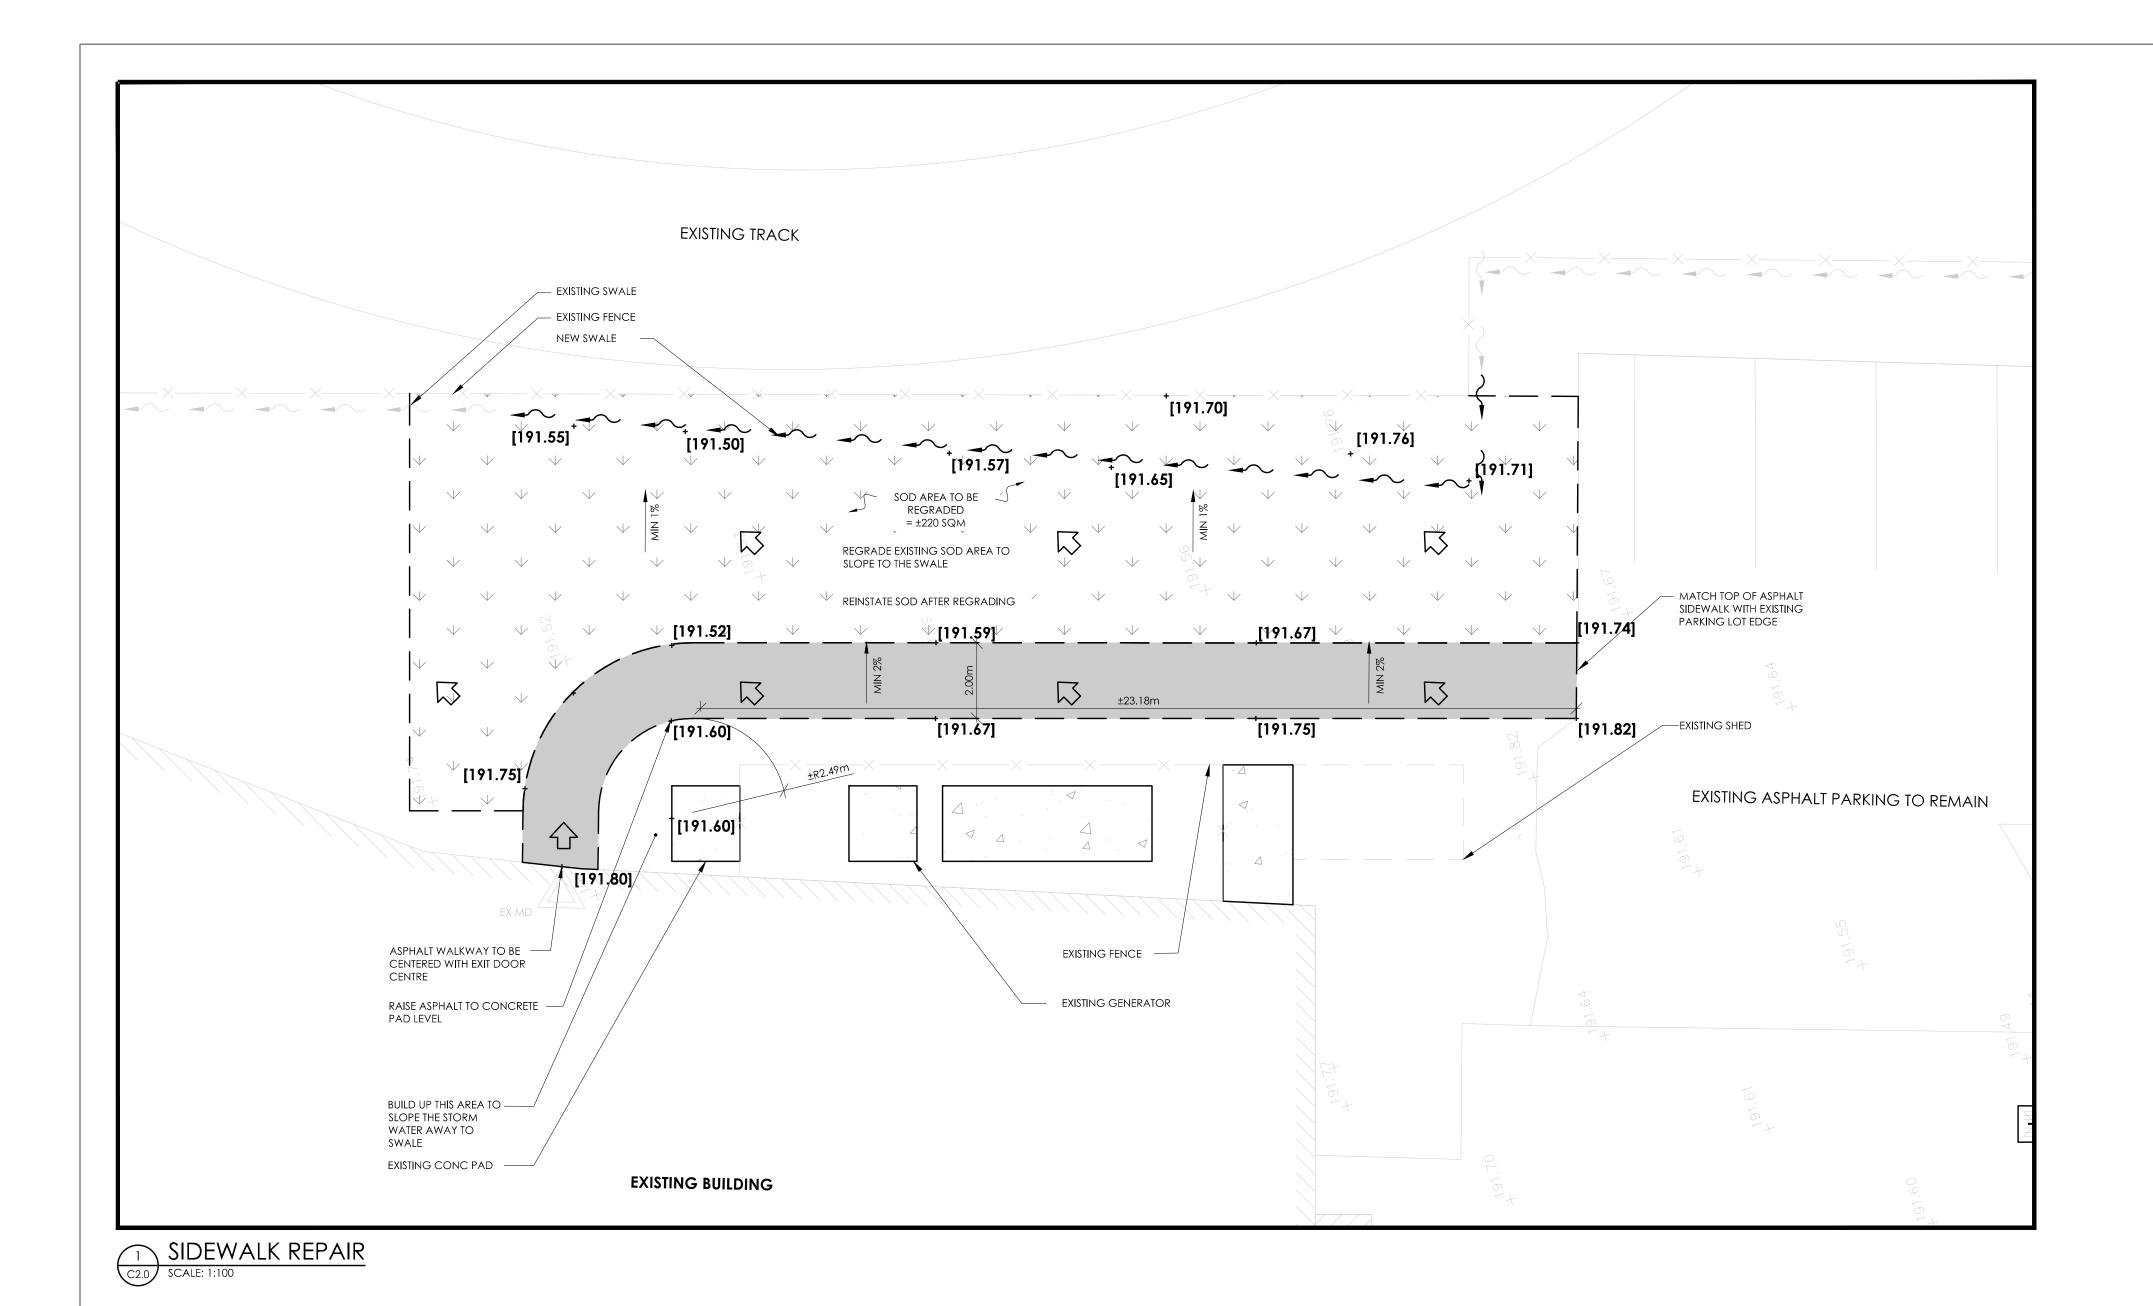

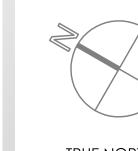




TRUE NORTH CONSTRUCTION NO

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2025-02-07

2025-01-15

ISSUED FOR EMERGENCY REPAIR TENDER

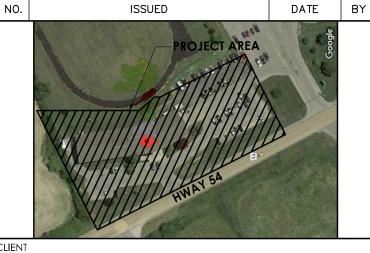ISSUED FOR EMERGENCY REPAIR REVIEW





ONTARIO PROVINCIAL POLICE

PROJE

CAYUGA DETACHMENT
72 HALDIMAND COUNTY HWY
54, CAYUGA, ON, NOA 1E0

EMERGENCY HOT PATCH

DRAWING TITLE:

SIDEWALK REPAIR

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D24-02-23	C2.0
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March 31, 2025 — 05:09pm Plotted by: Gakinlade

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