	ELECTRICAL DRAWING LIST
E0.00	COVER SHEET
E0.01	LEAD SHEET
E0.02	ELECTRICAL DEMOLITION SITE PLAN
E0.03	ELECTRICAL SITE PLAN - PHASE 1 A
E1.01	BASEMENT DEMOLITION LIGHTING AND FIRE ALARM PLAN - PHASE 1A & 1B
E1.02	BASEMENT DEMOLITION POWER AND COMMUNICATION PLAN - PHASE 1A & 1B
E1.03	LEVEL 1 DEMOLITION LIGHTING AND FIRE ALARM PLAN - PHASE 1A & 1B
E1.04	LEVEL 1 DEMOLITION POWER AND COMMUNICATION PLAN - PHASE 1A & 1B
E2.01	BASEMENT PROPOSED LIGHTING AND FIRE ALARM PLAN - PHASE 1A & 1B
E2.02	BASEMENT PROPOSED POWER AND COMMUNICATION PLAN - PHASE 1A & 1B
E2.03	LEVEL 1 PROPOSED LIGHTING AND FIRE ALARM PLAN - PHASE 1A & 1B
E2.04	LEVEL 1 PROPOSED POWER AND COMMUNICATION PLAN - PHASE 1A & 1B
E2.05	ATTIC LEVEL PROPOSED LIGHTING AND FIRE ALARM PLAN - PHASE 1A & 1B
E2.06	ATTIC LEVEL PROPOSED POWER AND COMMUNICATION PLAN - PHASE 1A & 1B
E3.00	FIRE ALARM RISER DIAGRAM
E4.00	SINGLE LINE DIAGRAM
E5.00	ELECTRICAL DETAILS
E5.01	TORONTO HYDRO DETAILS (SHEET 1 OF 2)
E5.02	TORONTO HYDRO DETAILS (SHEET 2 OF 2)
E6.00	PANEL SCHEDULE

Project Issue Issue Date

# HIGH PARK NATURE AND VISITOR'S CENTER

ISSUED FOR TENDER 2025-02-25

Owner Project Address Project Number

375 COLBORNE LODGE DR, TORONTO, ON M6R 2Z3 22-142





STRUCTURAL MECHANICAL PROCESS ELECTRICAL CIVIL ENGINEERS AND PROJECT MANAGERS

15 Foundry Street, Dundas, ON, L9H 2V6 Phone: (905)648-0373 www.manteconpartners.com

GENERAL NOTES	LEGEND -
1. DO NOT SCALE DRAWINGS FOR INSTALLATION PURPOSES. OBTAIN ALL DIMENSIONS FROM THE ARCHITECTURAL PLANS, MANUFACTURER'S SHOP DRAWINGS, AND ON SITE INSPECTIONS.	THIS LEGEND OF SY STANDARD LEGEND
2. PRIOR TO INSTALLATION OF BOXES IN WALLS, VERIFY THAT NO INTERFERENCES EXIST. CHECK	SYMBOL
ARCHITECTURAL PLANS AND ELEVATIONS.	
3. MECHANICAL AND ELECTRICAL TRADES SHALL WORK IN CONJUNCTION WITH EACH OTHER SO	
AS TO AVOID INTERFERENCES BETWEEN PIPING, DUCTWORK, CONDUIT, LIGHTING FIXTURES, ETC.	
4. WORK IN CONJUNCTION WITH THE ARCHITECTURAL REFLECTED CEILING PLAN WHEN LOCATING LIGHT FIXTURES.	
5. REVIEW ARCHITECTURAL, MECHANICAL, AND STRUCTURAL DRAWINGS AND PROVIDE ON SITE INSPECTIONS TO DETERMINE FULL EXTENT OF PROJECT PRIOR TO SUBMITTING BID.	
6. ALL WORK SHALL BE PERFORMED IN ACCORDANCE WITH THE ONTARIO BUILDING CODE (OBC), ONTARIO ELECTRICAL SAFETY CODE (OESC) AND THE LOCAL AUTHORITIES REQUIREMENTS.	
7. THE ELECTRICAL CONTRACTOR SHALL COORDINATE THE INSTALLATION WITH THE WORK OF OTHER TRADES. PROVIDE HORIZONTAL AND/OR VERTICAL OFFSETS AS REQUIRED TO SUIT THIS COORDINATION.	
8. REFER TO THE ARCHITECTURAL DRAWINGS FOR ALL WIRING DEVICE FINAL HEIGHT AND LOCATION.	Å
9. ALL WIRING SHALL BE A MINIMUM #12 AWG IN CONDUIT SUITABLE FOR THE APPLICATION.	
10. AC90 (BX) SHALL ONLY BE ALLOWED FOR SHORT RUNS OF LESS THAN 5 FEET IN LENGTH, UNLESS OTHERWISE NOTED.	
11. ALL MATERIALS SHALL BEAR A CSA (CANADIAN STANDARDS ASSOCIATION LABEL.	Ø
12. ALL INTERIOR LIGHT SWITCHES, RECEPTACLES, AND DATA OUTLETS, INCLUDING CONDUITS SHALL BE "CONCEALED" WITIN THE WALL STRUCTURE.	<u></u>
	_

13. Electrical switches, outlets, push-buttons etc. shall comply with accessibility for ONTARIANS WITH DISABILITES ACT (AODA) FOR MOUNTING HEIGHTS AND LOCATION WHERE APPLICABLE.

14. EXIT SIGNS SHALL BE GREEN, EDGE-LIT, "RUNNING-MAN" PICTOGRAM C/W LED LIGHT SOURCE, ALUMINUM HOUSING, AND UNIVERSAL MOUNTING. WHERE HIGH CEILING EXIST PROVIDE A PENDANT MOUNT TYPE SUSPENDED FROM A THREADED ROD OR EMT CONDUIT AT THE HEIGHT SPECIFIED.

15. BATTERY PACKS SHALL C/W 20% SPARE CAPACITY, 12VOLT, ALUMINUM HOUSING C/W TWO (2) 4-WATT, LED, MR-16, DIE CAST HEADS AND WHITE FINISH. PROVIDE MATCHING REMOTE HEADS. 16. ALL UNIVERSAL WASHROOM HARDWARE DEVICES TO BE PROVIDED BY THE ELECTRICAL CONTRACTOR C/W WIRING AND CONDUIT FOR A COMPLETE INSTALLATION, UNLESS OTHERWISE NOTED.

17. ALL SECURITY DOOR ACCESS HARDWARE DEVICES SHALL BE SUPPLIED "BY OTHERS". THE ELECTRICAL CONTRACTOR SHALL PROVIDE ALL WIRING AND CONDUIT ROUGH-IN FOR A COMPLETE INSTALLATION, UNLESS OTHERWISE NOTED.

18. ALL COMMUNICATION CABLING TO BE PROVIDED BY THE ELECTRICAL CONTRACTOR C/W CONDUIT, OUTLET JACKS, AND FACE PLATES FOR A COMPLETE INSTALLATION, UNLESS OTHERWISE NOTED. MAXIMUM LENGTH OF ETHERNET CABLES SHALL BE 300 FEET.

19. ALL AUDIO/VISUAL DEVICES SHALL BE SUPPLIED "BY OTHERS". THE ELECTRICAL CONTRACTOR SHALL PROVIDE CONDUIT ROUGH-IN ONLY, UNLESS OTHERWISE NOTED.

20. POWER AND CONTROL WIRING FOR MECHANICAL EQUIPMENT ON THE ROOF MUST RISE WITHIN THE CURB UNLESS OTHERWISE NOTED.

21. ALL EXTERIOR OUTLET BOXES TO BE "CONCEALED" AND SHALL C/W A VAPOUR BARRIER CHAMBER TO PREVENT AIR LEAKAGE.

22. THE ELECTRICAL CONTRACTOR SHALL PROVIDE BALANCED PHASING (A,B,C) FOR ALL EQUIPMENT PANEL LOADS, ADJUST BREAKER SCHEDULES AS REQUIRED.

23. PROVIDE FIRE-STOP MATERIAL AS REQUIRED FOR ALL WALL AND FLOOR PENETRATIONS TO MAINTAIN THE SMOKE SEAL AND FIRE RATING. FOR RECESSED JUNCTION BOXES USE HILTI - FIRE BLOK.

24. PROVIDE ALL MATERIALS AND ACCESSORIES REQUIRED FOR A COMPLETE GROUNDING SYSTEM AS REQUIRED BY THE GOVERNING AUTHORITIES. GROUND ALL EQUIPMENT AND DEVICES AS REQUIRED AND IN ACCORDANCE WITH THE OESC.

25. UPON THE COMPLETION OF THE CONTRACT, ISSUE A FORMAL CERTIFICATE INDICATING THE DATE OF COMPLETION OF WORK. REPAIR OR REPLACE ANY DEFECTS WHICH MAY APPEAR IN ANY OF THE WORK WITHIN ONE (1) YEAR.

NOTE: READ IN CONJUNCTION WITH ALL SPECIFICATIONS.

# - LIGHTING SYSTEM

LEGEND -	LIGHTING SYSTEM
	MBOLS REPRESENTS MANTECON PARTNERS INC. D. ALL SYMBOLS MAY NOT APPEAR ON DRAWINGS.
SYMBOL	DESCRIPTION
	2'x2' FIXTURE
	2'x4' FIXTURE
	1'x4' FIXTURE
	2' STRIP FIXTURE
	4' STRIP FIXTURE
	8' STRIP FIXTURE
Å	POLE MOUNTED LIGHT
	4' STRIP FIXTURE - WALL
	EXTERIOR SOFFIT MOUNT LED FIXTURE
$\oslash$	POTLIGHT
÷	PENDANT
오 오	WALL SCONCE
F	TRACK LIGHT
Ì	BOLLARD LIGHT
\$	1-GANG SWITCH
\$	2-GANG SWITCH
\$ <sub>D</sub>	DIMMER SWITCH
\$ <sub>D</sub>	2-gang dimmer switch
\$3	3-WAY SWITCH
\$ <sub>K</sub>	KEY SWITCH
\$	LOW VOLTAGE SWITCH
\$	SWITCH WITH OCCUPANCY SENSOR
Τ <sub>C</sub>	TIME CLOCK
PC	PHOTOCELL
	2'x2' EMERGENCY FIXTURE
	2'x4' EMERGENCY FIXTURE
	1'x4' EMERGENCY FIXTURE
•	EMERGENCY POT LIGHT
$\diamond$	LIGHTING CONTROLS - OCCUPANCY SENSOR (PIR) (CEILING MOUNTED TYPE)
DL	DAY-LIGHT SENSOR

#### LEGEND - EMERGENCY SYSTEM

THIS LEGEND OF SYMBOLS REPRESENTS MANTECON PARTNERS INC.         STANDARD LEGEND. ALL SYMBOLS MAY NOT APPEAR ON DRAWINGS.         REFER       DESCRIPTION         S       EXIT SIGN - SINGLE FACE - CEILING         S       EXIT SIGN - SINGLE FACE - WALL         S       EXIT SIGN - SINGLE FACE DIRECTIONAL - CEILING         S       EXIT SIGN - SINGLE FACE DIRECTIONAL - CEILING         S       EXIT SIGN - DOUBLE FACE DIRECTIONAL - CEILING         S       EXIT SIGN SELF-POWERED W/ REMOTE HEADS - WALL         S       SINGLE REMOTE HEAD - CEILING         S       DOUBLE REMOTE HEAD - CEILING         S       DOUBLE REMOTE HEAD - CEILING         S       BATTERY PACK W/ DOUBLE REMOTE HEADS - WALL		
Image: Second regression         Image: Se		
Image: Strength of Strengthof Strengt of Strength of Strengthof Strength of Strengt	REFER	DESCRIPTION
<ul> <li>EXIT SIGN - SINGLE FACE DIRECTIONAL - CEILING</li> <li>EXIT SIGN - DOUBLE FACE DIRECTIONAL - CEILING</li> <li>EXIT SIGN SELF-POWERED W/ REMOTE HEADS - WALL</li> <li>SINGLE REMOTE HEAD - CEILING</li> <li>DOUBLE REMOTE HEADS - CEILING</li> <li>SINGLE REMOTE HEAD - WALL</li> <li>DOUBLE REMOTE HEAD - WALL</li> </ul>	$\overline{\mathbf{N}}$	EXIT SIGN - SINGLE FACE - CEILING
EXIT SIGN - DOUBLE FACE DIRECTIONAL - CEILING         EXIT SIGN SELF-POWERED W/ REMOTE HEADS - WALL         SINGLE REMOTE HEAD - CEILING         DOUBLE REMOTE HEADS - CEILING         SINGLE REMOTE HEAD - WALL         DOUBLE REMOTE HEAD - WALL	$\overline{\mathbf{A}}$	EXIT SIGN - SINGLE FACE - WALL
<ul> <li>EXIT SIGN SELF-POWERED W/ REMOTE HEADS - WALL</li> <li>SINGLE REMOTE HEAD - CEILING</li> <li>DOUBLE REMOTE HEADS - CEILING</li> <li>SINGLE REMOTE HEAD - WALL</li> <li>DOUBLE REMOTE HEADS - WALL</li> </ul>	ً ♦ ♦	EXIT SIGN - SINGLE FACE DIRECTIONAL - CEILING
Image: Single Remote Head - Ceiling         Image: Double Remote Heads - Ceiling         Image: Single Remote Head - Wall         Image: Double Remote Heads - Wall		EXIT SIGN - DOUBLE FACE DIRECTIONAL - CEILING
Image: Constraint of the constr	Ĩ. Š	EXIT SIGN SELF-POWERED W/ REMOTE HEADS - WALL
SINGLE REMOTE HEAD - WALL       DOUBLE REMOTE HEADS - WALL	•~	SINGLE REMOTE HEAD - CEILING
DOUBLE REMOTE HEADS - WALL	••	DOUBLE REMOTE HEADS - CEILING
	_ <b>P</b>	SINGLE REMOTE HEAD - WALL
• BATTERY PACK W/ DOUBLE REMOTE HEADS (EBST) - WALL	••	DOUBLE REMOTE HEADS - WALL
		BATTERY PACK W/ DOUBLE REMOTE HEADS (EBST) - WALL

#### LEGEND - FIRE ALARM SYSTEM

THIS LEGEND OF SYMBOLS REPRESENTS MANTECON PARTNERS INC. STANDARD LEGEND. ALL SYMBOLS MAY NOT APPEAR ON DRAWINGS.

JIANDAN	D LEGEND. ALL STMBOLS MAT NOT AT LAK ON DRAWINGS.
REFER	DESCRIPTION
	BELL - WALL
Σ¢-	BELL AND STROBE - WALL
	HORN - WALL
\$	HORN & STROBE - WALL
Œ	HORN AND STROBE - CEILING
-¢-	STROBE - CEILING
⊢(Ē-	STROBE - WALL
	FIRE ALARM PULLSTATION
${\color{black} \bullet}$	SMOKE DETECTOR - CEILING
	DUCT SMOKE DETECTOR
	HEAT DETECTOR - CEILING
0	CARBON MONOXIDE - CEILING
	FIRE ALARM/ANNUNCIATOR PANEL
PS	PRESSURE SWITCH
FS	FLOW SWITCH
SV	SUPERVISORY VALVE
$\Theta_{R}$	SMOKE DETECTOR C/W RELAY BASE

GEND OF SYMBOLS REPRESENTS MANTECON PARTNERS INC.         ARD LEGEND. ALL SYMBOLS MAY NOT APPEAR ON DRAWINGS.         DESCRIPTION         REMOVE         EXISTING TO BE RELOCATED         EXISTING TO REMAIN         NIGHT LIGHT         WEATHER-PROOF         AUTOMATIC DOOR OPENER         WIRE GUARD         FIRE ALARM CONTROL PANEL         ANNUNCIATOR         PUSH TO OPEN         PUSH TO OPEN         ASSISTANCE REQUIRED SOUNDER         COMPLETE WITH         ABOVE FINISHED FLOOR         RECALL         UNDERGROUND         OVERHEAD	GEND - ABBREVIATION
REMOVE         EXISTING TO BE RELOCATED         EXISTING TO REMAIN         NIGHT LIGHT         WEATHER-PROOF         AUTOMATIC DOOR OPENER         WIRE GUARD         FIRE ALARM CONTROL PANEL         ANNUNCIATOR         PUSH TO OPEN         PUSH TO OPEN         EMERGENCY PUSH BUTTON         ASSISTANCE REQUIRED SOUNDER         COMPLETE WITH         ABOVE FINISHED FLOOR         RECALL         UNDERGROUND	
EXISTING TO BE RELOCATED         EXISTING TO REMAIN         NIGHT LIGHT         WEATHER-PROOF         AUTOMATIC DOOR OPENER         WIRE GUARD         FIRE ALARM CONTROL PANEL         ANNUNCIATOR         PUSH TO OPEN         PUSH TO OPEN         EMERGENCY PUSH BUTTON         ASSISTANCE REQUIRED SOUNDER         COMPLETE WITH         ABOVE FINISHED FLOOR         RECALL         UNDERGROUND	DESCRIPTION
EXISTING TO REMAIN         NIGHT LIGHT         WEATHER-PROOF         AUTOMATIC DOOR OPENER         WIRE GUARD         FIRE ALARM CONTROL PANEL         ANNUNCIATOR         PUSH TO OPEN         PUSH TO OPEN         PUSH TO LOCK         EMERGENCY PUSH BUTTON         ASSISTANCE REQUIRED SOUNDER         COMPLETE WITH         ABOVE FINISHED FLOOR         RECALL         UNDERGROUND	REMOVE
NIGHT LIGHT         WEATHER-PROOF         AUTOMATIC DOOR OPENER         WIRE GUARD         FIRE ALARM CONTROL PANEL         ANNUNCIATOR         PUSH TO OPEN         PUSH TO LOCK         EMERGENCY PUSH BUTTON         ASSISTANCE REQUIRED SOUNDER         COMPLETE WITH         ABOVE FINISHED FLOOR         RECALL         UNDERGROUND	EXISTING TO BE RELOCATED
WEATHER-PROOF         AUTOMATIC DOOR OPENER         WIRE GUARD         FIRE ALARM CONTROL PANEL         ANNUNCIATOR         PUSH TO OPEN         PUSH TO LOCK         EMERGENCY PUSH BUTTON         ASSISTANCE REQUIRED SOUNDER         COMPLETE WITH         ABOVE FINISHED FLOOR         RECALL         UNDERGROUND	EXISTING TO REMAIN
AUTOMATIC DOOR OPENER         WIRE GUARD         FIRE ALARM CONTROL PANEL         ANNUNCIATOR         PUSH TO OPEN         PUSH TO LOCK         EMERGENCY PUSH BUTTON         ASSISTANCE REQUIRED SOUNDER         COMPLETE WITH         ABOVE FINISHED FLOOR         RECALL         UNDERGROUND	NIGHT LIGHT
WIRE GUARD         FIRE ALARM CONTROL PANEL         ANNUNCIATOR         PUSH TO OPEN         PUSH TO LOCK         EMERGENCY PUSH BUTTON         ASSISTANCE REQUIRED SOUNDER         COMPLETE WITH         ABOVE FINISHED FLOOR         RECALL         UNDERGROUND	WEATHER-PROOF
FIRE ALARM CONTROL PANEL         ANNUNCIATOR         PUSH TO OPEN         PUSH TO LOCK         EMERGENCY PUSH BUTTON         ASSISTANCE REQUIRED SOUNDER         COMPLETE WITH         ABOVE FINISHED FLOOR         RECALL         UNDERGROUND	AUTOMATIC DOOR OPENER
ANNUNCIATOR         PUSH TO OPEN         PUSH TO LOCK         EMERGENCY PUSH BUTTON         ASSISTANCE REQUIRED SOUNDER         COMPLETE WITH         ABOVE FINISHED FLOOR         RECALL         UNDERGROUND	WIRE GUARD
PUSH TO OPEN         PUSH TO LOCK         EMERGENCY PUSH BUTTON         ASSISTANCE REQUIRED SOUNDER         COMPLETE WITH         ABOVE FINISHED FLOOR         RECALL         UNDERGROUND	FIRE ALARM CONTROL PANEL
PUSH TO LOCK         EMERGENCY PUSH BUTTON         ASSISTANCE REQUIRED SOUNDER         COMPLETE WITH         ABOVE FINISHED FLOOR         RECALL         UNDERGROUND	ANNUNCIATOR
EMERGENCY PUSH BUTTON         ASSISTANCE REQUIRED SOUNDER         COMPLETE WITH         ABOVE FINISHED FLOOR         RECALL         UNDERGROUND	PUSH TO OPEN
ASSISTANCE REQUIRED SOUNDER COMPLETE WITH ABOVE FINISHED FLOOR RECALL UNDERGROUND	PUSH TO LOCK
COMPLETE WITH ABOVE FINISHED FLOOR RECALL UNDERGROUND	EMERGENCY PUSH BUTTON
ABOVE FINISHED FLOOR RECALL UNDERGROUND	ASSISTANCE REQUIRED SOUNDER
RECALL UNDERGROUND	COMPLETE WITH
UNDERGROUND	ABOVE FINISHED FLOOR
	RECALL
OVERHEAD	UNDERGROUND
	OVERHEAD

LEGE	ND - COMMUNICATIONS
	ND OF SYMBOLS REPRESENTS MANTECON PARTNERS INC. D LEGEND. ALL SYMBOLS MAY NOT APPEAR ON DRAWINGS.
REFER	DESCRIPTION
$\bigtriangledown$	DATA OUTLET
▼	TELEPHONE OUTLET
$\forall$	DATA OUTLET - CEILING
$\mathbf{\nabla}$	TELEPHONE AND DATA OUTLET
$\forall$	COAXIAL OUTLET
(A)	PUBLIC ADDRESS SPEAKER
CS	PUBLIC ADDRESS SPEAKER AND CALL SWITCH
PA	PUBLIC ADDRESS PAGING SPEAKER AND HANDSET
WAP	WIRELESS ACCESS POINT - WIFI

### LEGEND - SECURITY SYSTEM

	ND OF SYMBOLS REPRESENTS MANTECON PARTNERS INC. D LEGEND. ALL SYMBOLS MAY NOT APPEAR ON DRAWINGS.
REFER	DESCRIPTION
ES	ELECTRIC STRIKE
CR	CARD READER
DC	DOOR CONTACT
	MAGLOCK
●	WAVE STYLE ADO
$\bigtriangledown$	MOTION SENSOR - CEILING
JB	SECURITY JUNCTION BOX
	SECURITY PANEL
$\bigtriangledown$	SECURITY INTERCOM
$\Box \forall$	SECURITY CAMERA - WALL MOUNT
□ C	360 SECURITY CAMERA - CEILING MOUNT
$\triangleleft$	MOTION SENSOR (INTRUSION)
$\triangleleft$	MOTION SENSOR (LONG RANGE INTRUSION)
K	SECURITY SYSTEM KEY PAD
DHO	DOOR HOLD OPEN
<b>AO</b>	AUTOMATIC DOOR OPENER

ND OF SYMBOLS REPRESENTS MANTECON PARTNERS INC. D LEGEND. ALL SYMBOLS MAY NOT APPEAR ON DRAWINGS.
DESCRIPTION
DUPLEX RECEPTACLE
GFCI RECEPTACLE
SPLIT RECEPTACLE
SINGLE RECEPTACLE
QUAD RECEPTACLE
DUPLEX RECEPTACLE - FLOOR MOUNTED
QUAD RECEPTACLE - FLOOR MOUNTED
DUPLEX RECEPTACLE - CEILING MOUNTED
DIRECT CONNECTION
NON FUSED DISCONNECT SWITCH
FUSED DISCONNECT SWITCH
NON-FUSED DIRECT CONNECTION
MOTOR CONNECTION (DISCONNECT BY ELECTRICAL)
MOTOR CONNECTION (COMBINATION STARTER BY ELECTRICAL)
MOTOR CONNECTION (UNIT MOUNTED DISCONNECT BY MECHANICAL)
POWER JUNCTION BOX
POWER PACK
SPEED SWITCH
RELAY
ELECTRICAL PANEL
GROUND BAR
DIGITAL MULTI METER
GROUND ROD
TRANSFORMER
POLE-MOUNTED TRANSFORMER
UTILITY METER
PULL BOX

LEGEND - POWER SYSTEM

AND FINI	RACTOR AND FIXTURE SUPPLIER ARE RESPONSIB SHING FRAMES, MOUNTING HARDWARE, AND , CTURAL CEILING SCHEDULE.		
TYPE	DESCRIPTION	LAMPS	MTG
LI	609mm uplight wall mount light Ensconce #\$403-\$-18-C-02-m-00-J-twh- ZX	LED @ 16W	REFER TO ARCH DETAILS
L2	50mm Linear Wall Mount Light Fase1 #F50-W-2-RA-OP-DN-35-ST-UN- OS1-01	LED	REFER TO ARCH DETAILS
L2A	50MM LINEAR SURFACE MOUNT CEILING LIGHT 4FT FASE1 #F50-C-4-RA-OP-DN-35-ST-UN- OS1-01	LED	REFER TO ARCH DETAILS
L2B	50MM LINEAR SURFACE MOUNT CEILING LIGHT 2FT FASE1 #F50-C-2-RA-OP-DN-35-ST-UN- OS1-01	LED	REFER TO ARCH DETAILS
L2C	50MM LINEAR SURFACE MOUNT CEILING LIGHT 8FT FASE1 #F50-C-8-RA-OP-DN-35-ST-UN- OS1-01	LED	REFER TO ARCH DETAILS
L3	305*1200 SURFACE MOUNT LIGHT NPDBL #NPDBL-E14/334-W-MS	LED @ 30W	REFER TO ARCH DETAILS
L4	914mm dia pendant light Fullmoon #3601-a-CS-35-du36-1-d	LED @ 26W	REFER TO ARCH DETAILS
L4A	457mm dia pendant light fullmoon #1801-a-CS-35-du18-1-d	LED @ 68W	REFER TO ARCH DETAILS
L5	EXTERIOR WALL LIGHT - ADJUSTABLE LUMENS AND COLOUR - 2700 LM, 3000K ASWPLED1S-20W-3000K	LED @ 20W	REFER TO ARCH DETAILS
L6	EXTERIOR PENDANT LIGHT - ADJUSTABLE LUMENS AND COLOUR - 5000 LM, 3000K LITHONIA #CNY-LED-ALO-UVOLT-DDB	LED @ 34W	REFER TO ARCH DETAILS
L7	LED VAPORPROOF WALL FIXTURE CANLET #01-20W-L-W-F-OG-09	LED @ 20W	REFER TO ARCH DETAILS
L8	Exterior floodlights - Adjustable Lumens and Colour - 8500 Lm, 3000K Lithonia #esxf3-alo-sww2-ddb	LED @ 53W	REFER TO ARCH DETAILS

SCOPE	CONTRACTOR	HYDRO	OWNER
NEW HYDRO POLES AND NEW POLE- MOUNTED HYDRO TRANSFORMER	COORDINATION WITH HYDRO; PAY HYDRO CONNECTION COSTS.	PROVIDE NEW HYDRO POLES; PROVIDE NEW POLE-MOUNTED HYDRO TRANSFORMER ON P375-2.	REIMBURSE HYDRO CONNECTION COSTS
HV WIRING BETWEEN NEW HYDRO POLE P403 AND NEW HYDRO TRANSFORMER ON POLE 375-2	COORDINATION WITH HYDRO; PAY HYDRO CONNECTION COSTS.	SUPPLY NEW O/H PRIMARY BETWEEN HYDRO POLE 403 AND NEW HYDRO TRANSFORMER; TERMINATE ON HYDRO TRANSFORMER PRIMARY BUSHINGS.	REIMBURSE HYDRO CONNECTION COSTS
LV WIRING AND DUCTBANK BETWEEN NEW HYDRO TRANSFORMER ON NEW HYDRO POLE 375-2 AND LV PANEL 2P-1	PROVIDE NEW CONCRETE ENCASED DUCT BANK TO OESC AND TORONTO HYDRO REQUIREMENTS; PROVIDE SECONDARY FEEDER BETWEEN TRANSFORMER AND PANEL MAINS; RUN ALL SECONDARY CONDUCTORS TO HYDRO TRANSFORMER BUSHINGS; PAY HYDRO CONNECTION COSTS.	COORDINATE WITH CONTRACTOR AND TERMINATE WIRING ON TRANSFORMER SECONDARY BUSHINGS.	REIMBURSE HYDRO CONNECTION COSTS
LV MAIN PANELBOARD 2P-1 HYDRO METERING	PROVIDE NEW LV MAIN PANELBOARD. PROVIDE NEW HYDRO METERING CABINET TO HYDRO REQUIREMENTS. INSTALL HYDRO PROVIDED CT'S AND METER IN CABINET; COORDINATE WITH HYDRO; PAY HYDRO CONNECTION COSTS.	REVIEW/ACCEPTANCE OF METERING LOCATION PROVIDE CT'S TO CONTACTOR; INSTALL HYDRO METER AFTER ESA AUTHORIZATION TO CONENCT.	REIMBURSE HYDRO CONNECTION COSTS
REMOVAL OF EXISTING HYDRO POLES AND HYDRO TRANSFORMER	COORDINATION WITH HYDRO; PAY HYDRO FEES; ARRANGE DISCONNECTION OF POWER WITH HYDRO; DISCONNECT EXISTING SECONDARY WIRING.	COORDINATE WITH CONTRACTOR FOR DISCONNECTION OF EXISTING SERVICE. REMOVE EXISTING TRANSFORMER. DEMOLISH EXISTING PRIMARY WIRING. REMOVE EXISTING HYDRO POLES.	REIMBURSE HYDRO FEES.
REMOVAL OF EXISTING HYDRO METERING EQUIPMENT	COORDINATION WITH HYDRO; PAY HYDRO FEES; ARRANGE DISCONNECTION OF POWER TO EXISTING MAIN PANEL;	COORDINATE WITH CONTRACTOR FOR DISCONNECTION OF EXISTING SERVICE;	REIMBURSE HYDRO FEES.

	OM TYPE	DESCRIPTION			
ROOMS /OFFICE	RVICE /STORAGE E/VISITORS' ENTRE	LIGHTS AUTOMATICALLY TURN C MANUAL CONTROL OF EACH RC AUTOMATICALLY TURN OFF AFTE	10 AIV MOC	I/OFF WALL SWITC	
WASH	IROOM	LIGHTS AUTOMATICALLY TURN C AND TURN OFF AFTER 20 MINUTE			CY IS DETECTED
	ation/ves e/stair	LIGHTS AUTOMATICALLY TURN C AND DIM TO 20% AFTER 20 MINU ON/OFF 3 WAY SWITCHES ON TH	JTES OF VAC		
	ROGRAM ACE	LIGHTS AUTOMATICALLY TURN C AND TURN OFF AFTER 20 MINUTE SPACE VIA ON/OFF WALL SWITC PROVIDED VIA CEILING MOUNT SHOWN ON DRAWINGS. DAYLIC FIXTURES WITHIN THE ROOM BAS LIGHTING ENTERING THROUGH	ES OF VACAN CHES AT THE E ED DAYLIGH GHT SENSORS ED ON THE A	ICY. MANUAL CC NTRANCE. DAYLIC I SENSORS, WHER SHALL DIM THE G MOUNT OF NATU	NTROL OF THE GHT HARVESTING E APPLICABLE AN EENERAL PENDAN
					1
<u>NOTES:</u> 1. CONT AND FIN	Ractor an Ishing fram	D FIXTURE SUPPLIER ARE RESPONSI MES, MOUNTING HARDWARE, AND LING SCHEDULE.	BLE TO PROV	IDE ALL PLASTER	
<u>NOTES:</u> 1. CONT AND FIN	Ractor an Ishing fram	D FIXTURE SUPPLIER ARE RESPONSII MES, MOUNTING HARDWARE, AND	BLE TO PROV	IDE ALL PLASTER	
<u>NOTES:</u> 1. CONT AND FIN ARCHITE	RACTOR AN ISHING FRAM CTURAL CEII EDGELIT CAT: RME	d fixture supplier are responsi Mes, mounting hardware, and Ling schedule.	BLE TO PROV ACCESSORII	IDE ALL PLASTER ES TO SUIT	
<u>NOTES:</u> 1. CONT AND FIN ARCHITE TYPE	RACTOR AN ISHING FRAM CTURAL CEII EDGELIT I CAT: RME MANUFA MR16 SU HEADS CAT: MR	D FIXTURE SUPPLIER ARE RESPONSI MES, MOUNTING HARDWARE, AND LING SCHEDULE. DESCRIPTION RUNNING MAN SIGN EA-BA-UDC	BLE TO PROV ACCESSORII	IDE ALL PLASTER ES TO SUIT MTG REFER TO	

# SEPERATION OF RESPONSIBILITIES - MAIN ELECTRICAL SERVICE UPGRADE

REVIEW ALL DRAWINGS AND VERIFY ALL DIMENSIONS AT THE SITE. DO NOT SCALE THE DRAWINGS. REPORT ALL DISCREPANCIES TO THE ENGINEER BEFORE PROCEEDING WITH ANY CONSTRUCTION OR SHOP FABRICATION. ALL DRAWINGS, SPECIFICATIONS AND RELATED DOCUMENTS ARE THE COPYRIGHT PROPERTY OF 'MANTECON PARTNERS' AND MUST BE RETURNED UPON REQUEST. REPRODUCTION OF DRAWINGS, SPECIFICATIONS AND RELATED DOCUMENTS IN PART OR WHOLE IS FORBIDDEN WITHOUT THE ENGINEER'S WRITTEN PERMISSION.

#### NOTE: REFER TO ARCHITECTURAL DRAWINGS FOR PHASING INFORMATION

375 COLBORNE LODGE DR, TORONTO, ON M6R 2Z3

10 ISSUED FOR TENDER 2025-02-25 RE-ISSUED FOR TORONTO 2025-02-24 HYDRO

6 ISSUED FOR TORONTO HYDRO 2024-08-12

1 ISSUED FOR COORDINATION 2024-01-05

MANTECON

PARTNERS

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RE-ISSUED FOR PERMIT

3 ISSUED FOR COSTING

2 ISSUED FOR PERMIT

RE-ISSUED FOR TORONTO 2024-10-18

RE-ISSUED FOR COSTING 2024-02-20

2024-02-20

2024-02-08

2024-01-31

Date

9

5

4

Consultants

Seals


HYDRO


Rev.# Description

#### HIGH PARK NATURE AND **VISITOR'S CENTER**

Drawing Name: LEAD SHEET

Project Number: 22-142 Drawing Scale: As Indicated Date: 2025-02-25 File Name: Drawn By: M.Z. NORTH ARROW Reviewed By: N.A. Drawing No.:

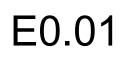

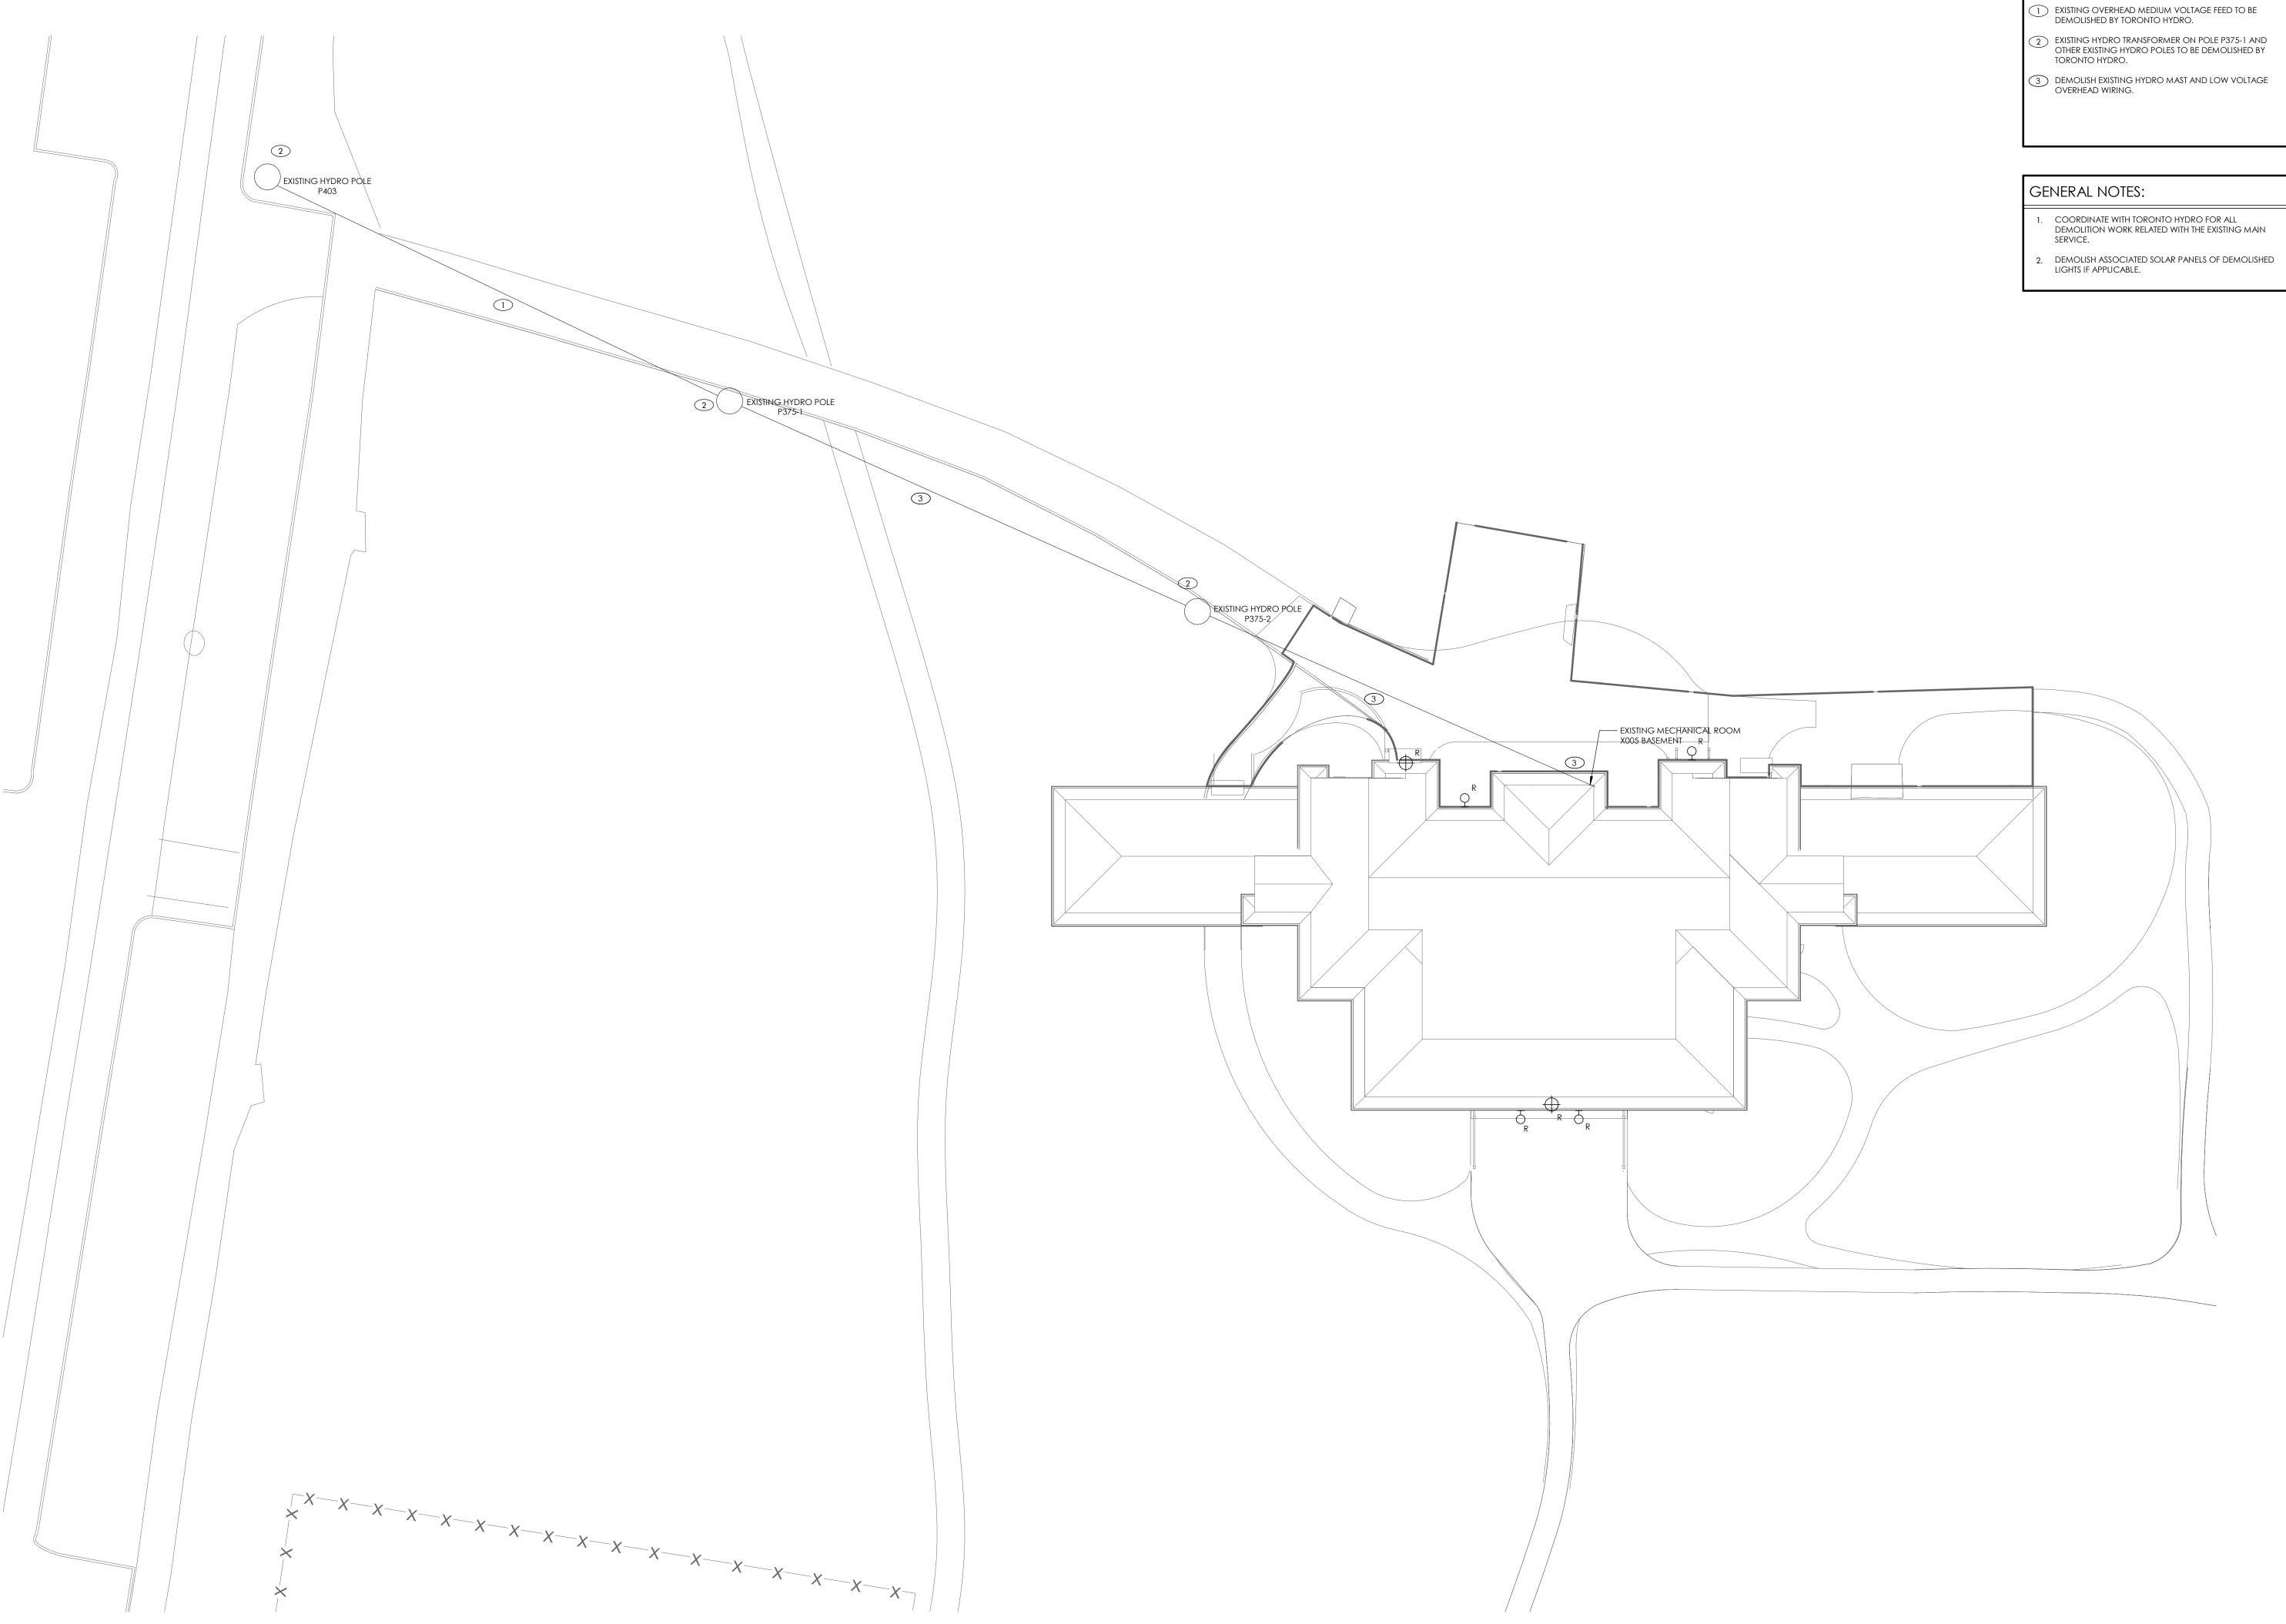

1 ELECTRICAL DEMOLITION SITE PLAN

REVIEW ALL DRAWINGS AND VERIFY ALL DIMENSIONS AT THE SITE. DO NOT SCALE THE DRAWINGS. REPORT ALL DISCREPANCIES TO THE ENGINEER BEFORE PROCEEDING WITH ANY CONSTRUCTION OR SHOP FABRICATION. ALL DRAWINGS, SPECIFICATIONS AND RELATED DOCUMENTS ARE THE COPYRIGHT PROPERTY OF MANTECON PARTNERS' AND MUST BE RETURNED UPON REQUEST. REPRODUCTION OF DRAWINGS, SPECIFICATIONS AND RELATED DOCUMENTS IN PART OR WHOLE IS FORBIDDEN WITHOUT THE ENGINEER'S WRITTEN PERMISSION.


NOTE: REFER TO ARCHITECTURAL DRAWINGS FOR PHASING INFORMATION

10	ISSUED FOR TENDER	2025-02-25	
9	RE-ISSUED FOR TORONTO HYDRO	2025-02-24	
7	RE-ISSUED FOR TORONTO HYDRO	2024-10-18	
6	ISSUED FOR TORONTO HYDRO	2024-08-12	
5	RE-ISSUED FOR COSTING	2024-02-20	
4	RE-ISSUED FOR PERMIT	2024-02-20	
3	ISSUED FOR COSTING	2024-02-08	
2	ISSUED FOR PERMIT	2024-01-31	
1	ISSUED FOR COORDINATION	2024-01-05	
Rev.#	Description	Date	
Consultan	ts		
	PARTNERS	Ν	
STRUC	TURAL MECHANICAL PROCESS ELECTRICAL CIVIL ENGINEERS AND PROJECT MANAGERS	-	
	15 Foundry Street, Dundas, ON, L9H 2V6		
Ph	one: (905)648-0373 www.manteconpartners.com		
Seals			
oodio			
375 COL	BORNE LODGE DR, TORONTO, C	ON M6R 2Z3	
-	HIGH PARK NATURE AND VISITOR'S CENTER		

Drawing Name: ELECTRICAL DEMOLITION SITE PLAN

Project Number:	22-142	
Drawing Scale:	As Indicated	
Date:	2025-02-25	
File Name:		
Drawn By:	M.Z.	
Reviewed By:	N.A.	NORTH ARROW
 Drawing No.:		



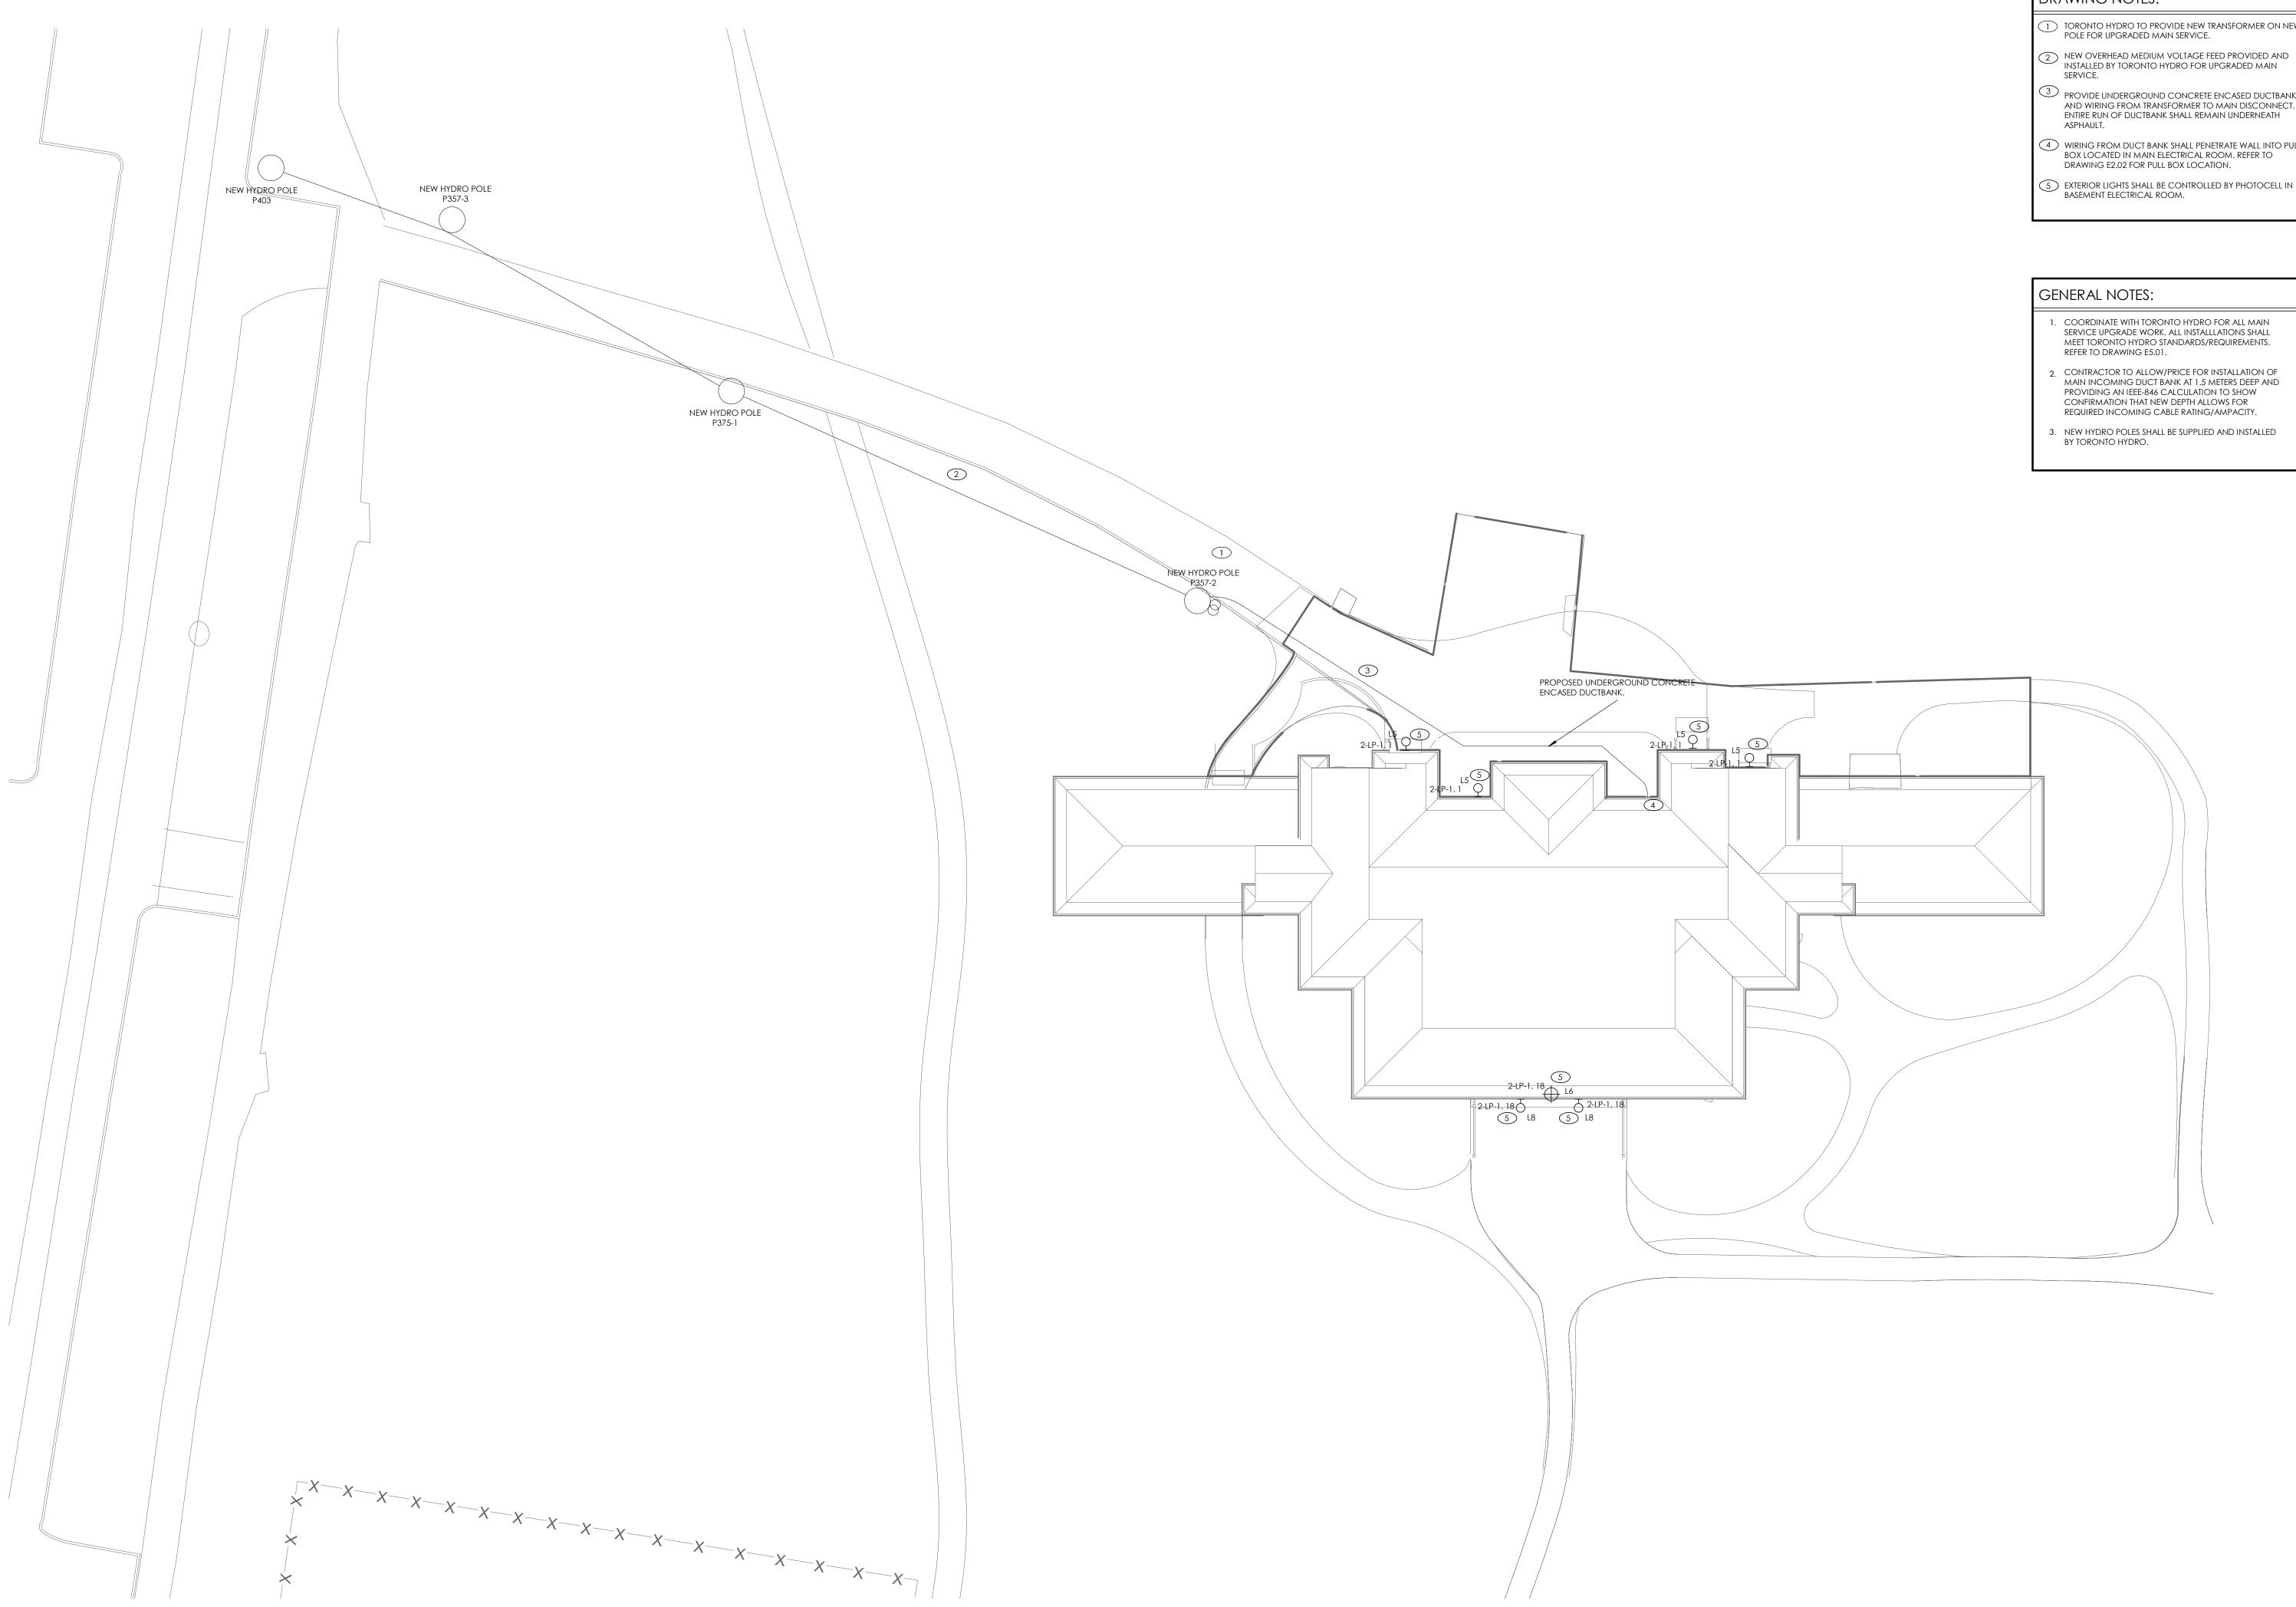

- 1) TORONTO HYDRO TO PROVIDE NEW TRANSFORMER ON NEW POLE FOR UPGRADED MAIN SERVICE.
- PROVIDE UNDERGROUND CONCRETE ENCASED DUCTBANK, AND WIRING FROM TRANSFORMER TO MAIN DISCONNECT.
- WIRING FROM DUCT BANK SHALL PENETRATE WALL INTO PULL BOX LOCATED IN MAIN ELECTRICAL ROOM. REFER TO DRAWING E2.02 FOR PULL BOX LOCATION.
- 5 EXTERIOR LIGHTS SHALL BE CONTROLLED BY PHOTOCELL IN BASEMENT ELECTRICAL ROOM.

- 1. COORDINATE WITH TORONTO HYDRO FOR ALL MAIN SERVICE UPGRADE WORK. ALL INSTALLLATIONS SHALL MEET TORONTO HYDRO STANDARDS/REQUIREMENTS. REFER TO DRAWING E5.01.
- CONTRACTOR TO ALLOW/PRICE FOR INSTALLATION OF MAIN INCOMING DUCT BANK AT 1.5 METERS DEEP AND PROVIDING AN IEEE-846 CALCULATION TO SHOW CONFIRMATION THAT NEW DEPTH ALLOWS FOR
- 3. NEW HYDRO POLES SHALL BE SUPPLIED AND INSTALLED

10	ISSUED FOR TENDER	2025-02-25			
9	RE-ISSUED FOR TORONTO HYDRO	2025-02-24			
7	RE-ISSUED FOR TORONTO HYDRO	2024-10-18			
6	ISSUED FOR TORONTO HYDRO	2024-08-12			
5	RE-ISSUED FOR COSTING	2024-02-20			
4	RE-ISSUED FOR PERMIT	2024-02-20			
3	ISSUED FOR COSTING	2024-02-08			
2	ISSUED FOR PERMIT	2024-01-31			
1	ISSUED FOR COORDINATION	2024-01-05			
Rev.#	Description	Date			
Consultan	Consultants				
PARTNERS					
	PARTNERS				
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STRUCTURAL MECHANICAL PROCESS ELECTRICAL CIVIL ENGINEERS AND PROJECT MANAGERS 15 Foundry Street, Dundas, ON, L9H 2V6 Phone: (905)648-0373 www.manteconpartners.com

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#### HIGH PARK NATURE AND **VISITOR'S CENTER**


Drawing Name: ELECTRICAL SITE PLAN - PHASE 1A

Project Number:	22-142	
Drawing Scale:	As Indicated	
Date:	2025-02-25	
File Name:		
Drawn By:	M.Z.	
Reviewed By:	N.A.	NORTH ARRO
Drawing No.:		



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#### NOTE: REFER TO ARCHITECTURAL DRAWINGS FOR PHASING INFORMATION

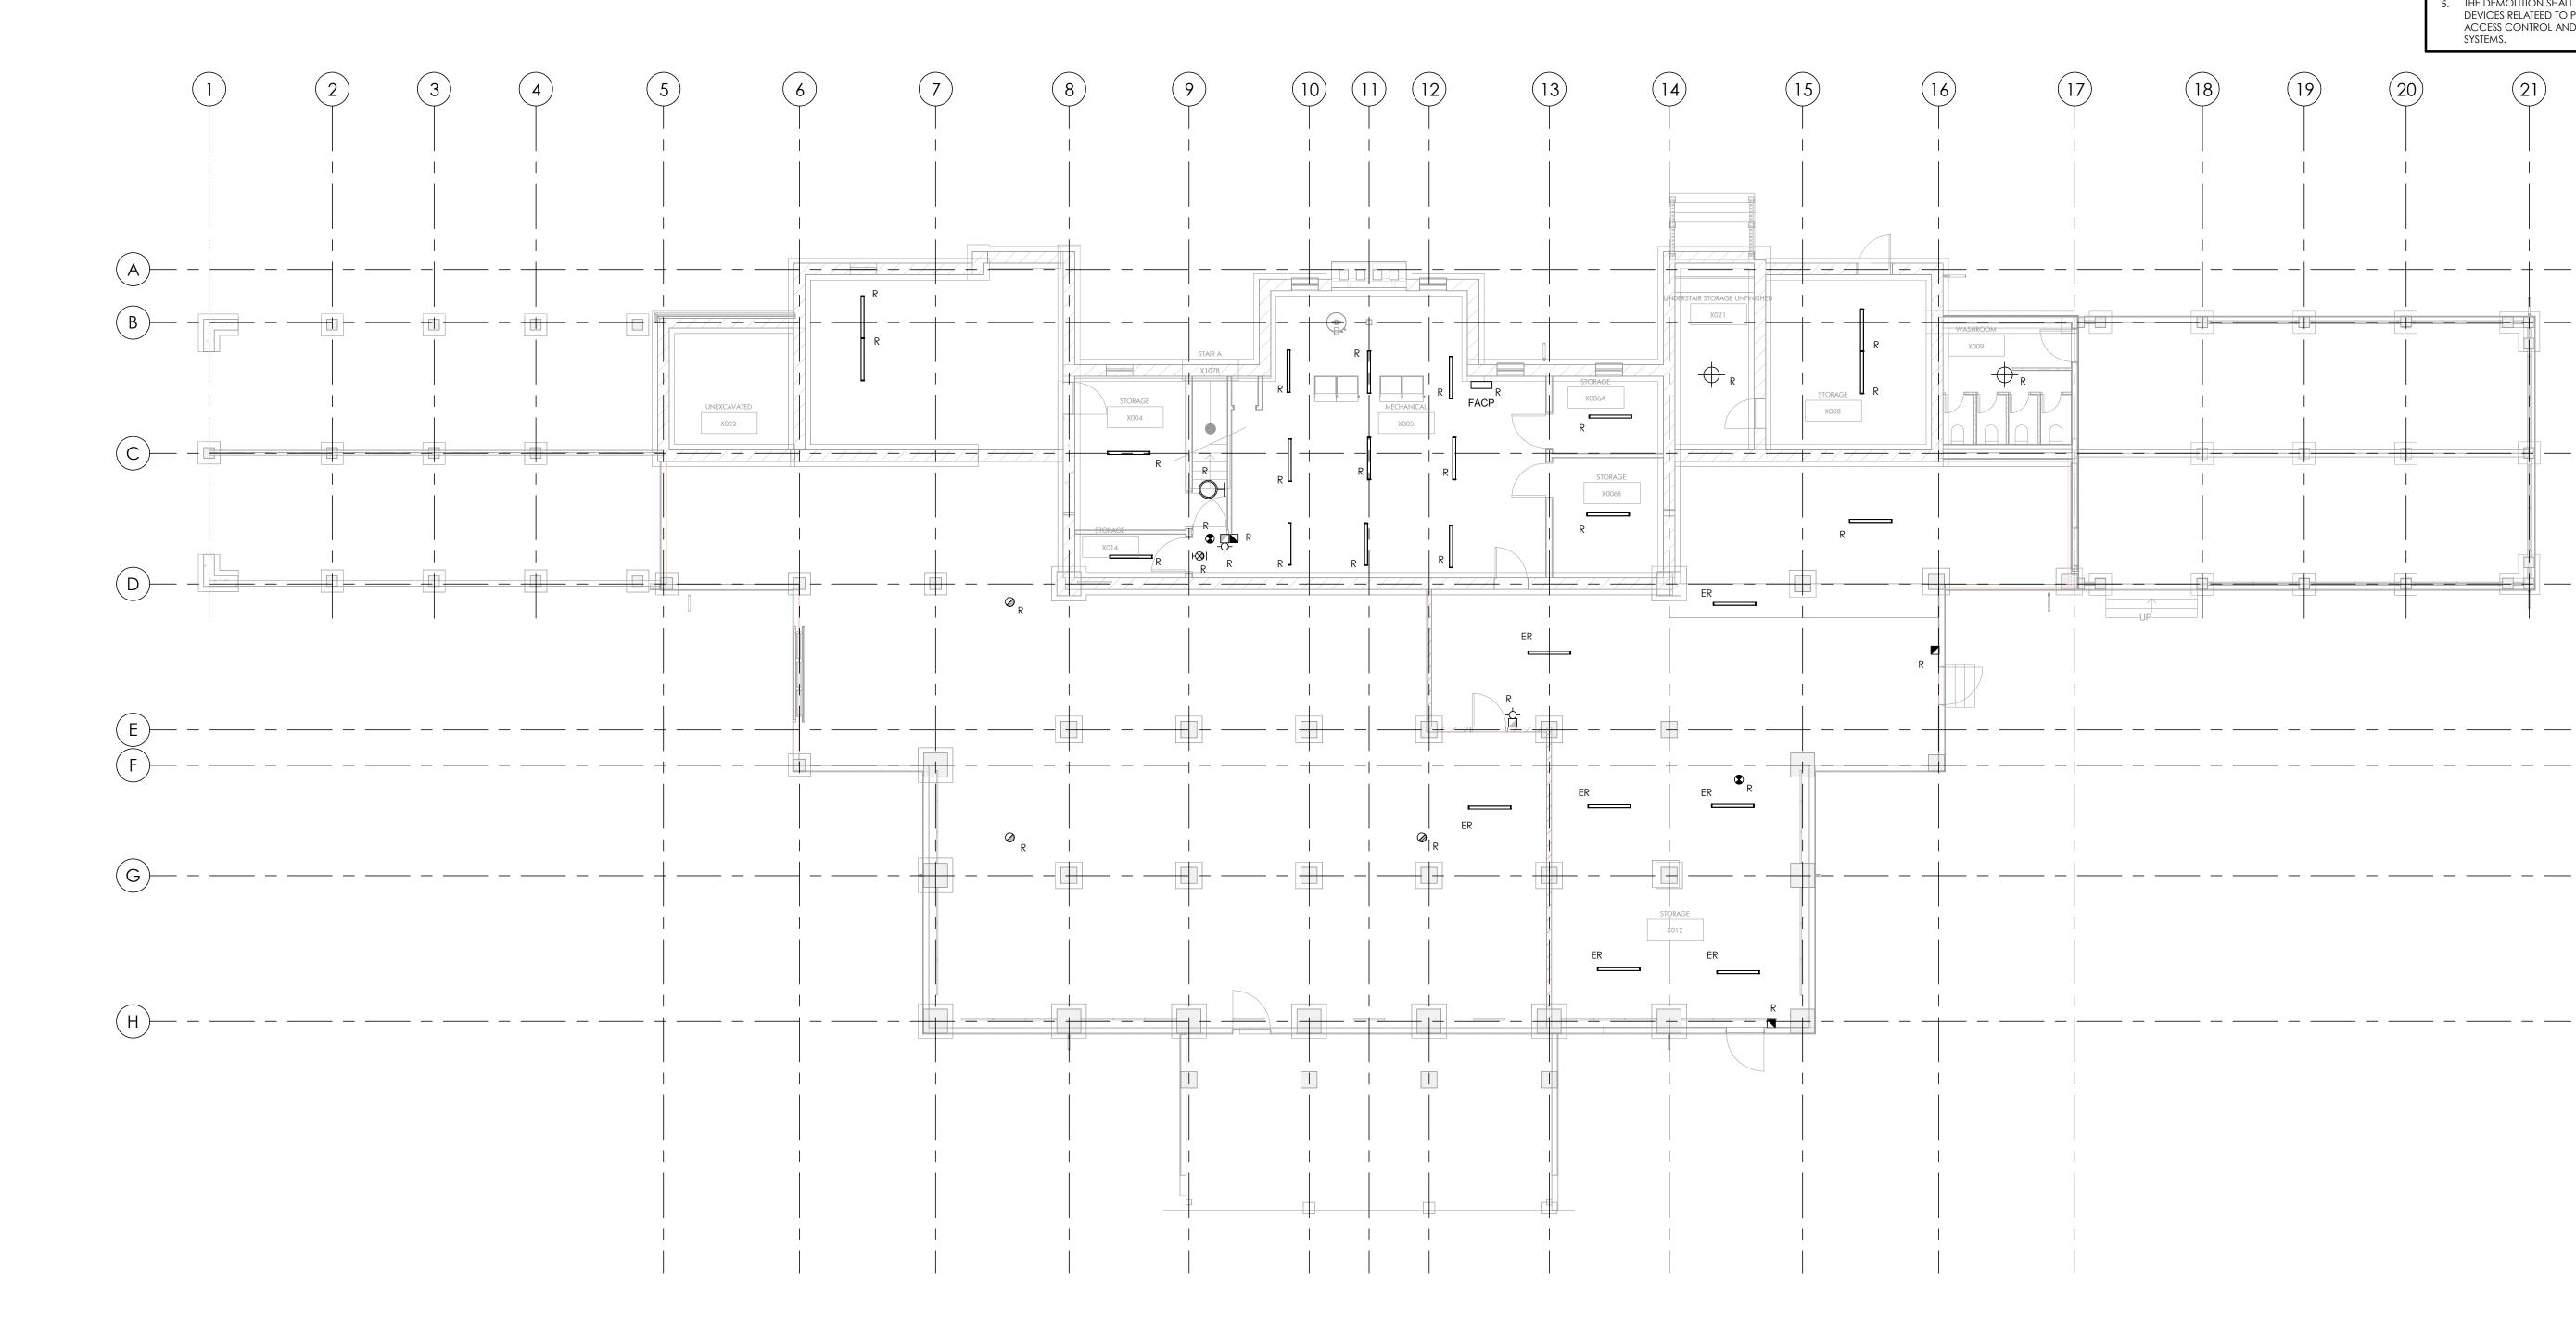

#### GENERAL NOTES:

(20)


- EXISTING LIGHTING FIXTURES LOCATED UNDER GRIDLINE d in basement storage Rm 012 to be disconnected AND RETAINED FOR RE-USE DURING NEW CEILING AND INSULATION WORK. REINSTALL EXISTING ELECTRICAL IN APPROX. THE SAME POSITIONS WITH POWER FROM PANEL 2-LP-1 AND NEW FIRE ALARM DEVICES CONNECTED TO NEW FACP AS REQUIRED.
- ALL DEMOLITION WORK SHALL BE INCLUDED IN THE BASE CONTRACT.
- SINCE ALL EXISTING DEVICES ARE NOT SHOWN ON THE PLANS, THE BASE CONTRACT SCOPE SHALL INCLUDE DEMOLITION OF EMERGENCY REMOTE HEADS, LIGHT SWITCHES AND SMOKE DETECTORS SPACED 20 FEET APART AND/OR IN EACH ROOM.
- DEMOLISH ALL CONDUIT, WIRING, BOXES SUPPORTS AND ACCESSORIES FOR EACH DEVICE ALL THE WAY BACK TO THE SOURCE EQUIPMENT.
- THE DEMOLITION SHALL INCLUDE ALL EQUIPMENT AND DEVICES RELATEED TO POWER, DATA, SECURUTY, ACCESS CONTROL AND OTHER COMMUNICATION SYSTEMS.

(21)

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#### REVIEW ALL DRAWINGS AND VERIFY ALL DIMENSIONS AT THE SITE. DO NOT SCALE THE DRAWINGS. REPORT ALL DISCREPANCIES TO THE ENGINEER BEFORE PROCEEDING WITH ANY CONSTRUCTION OR SHOP FABRICATION. ALL DRAWINGS, SPECIFICATIONS AND RELATED DOCUMENTS ARE THE COPYRIGHT PROPERTY OF `MANTECON PARTNERS' AND MUST BE RETURNED UPON REQUEST. REPRODUCTION OF DRAWINGS, SPECIFICATIONS AND RELATED DOCUMENTS IN PART OR WHOLE IS FORBIDDEN WITHOUT THE ENGINEER'S WRITTEN PERMISSION.

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Seals


375 COLBORNE LODGE DR, TORONTO, ON M6R 2Z3
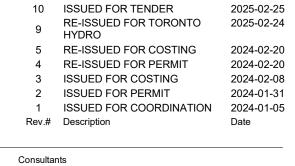
#### HIGH PARK NATURE AND **VISITOR'S CENTER**


Drawing Name:

BASEMENT DEMOLITION LIGHTING AND FIRE ALARM PLAN - PHASE 1A & 1B

Project Number:	22-142	
Drawing Scale:	As Indicated	
Date:	2025-02-25	
File Name:		
Drawn By:	M.Z.	
Reviewed By:	N.A.	NORTH ARROW
Drawing No.:		

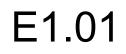

- 1 DEMOLISH EXISTING MAIN PANEL. REMOVE ALL DOWNSTREAM WIRING/CONDUIT BACK TO
- source. 2 DEMOLISH DISCONNECT, SPLITTER, AND ASSOCIATED WIRING/CONDUIT BACK TO EXISTING MAIN ELECTRICAL SPACE AND TO LOADS/ FLOOD LIGHTS. DEMOLISH EXISTING FLOOD lights.
- (3) ELECTRICAL IN STORAGE ROOM UNDER GRIDLINE D TO REMAIN UNTIL PHASE 2.

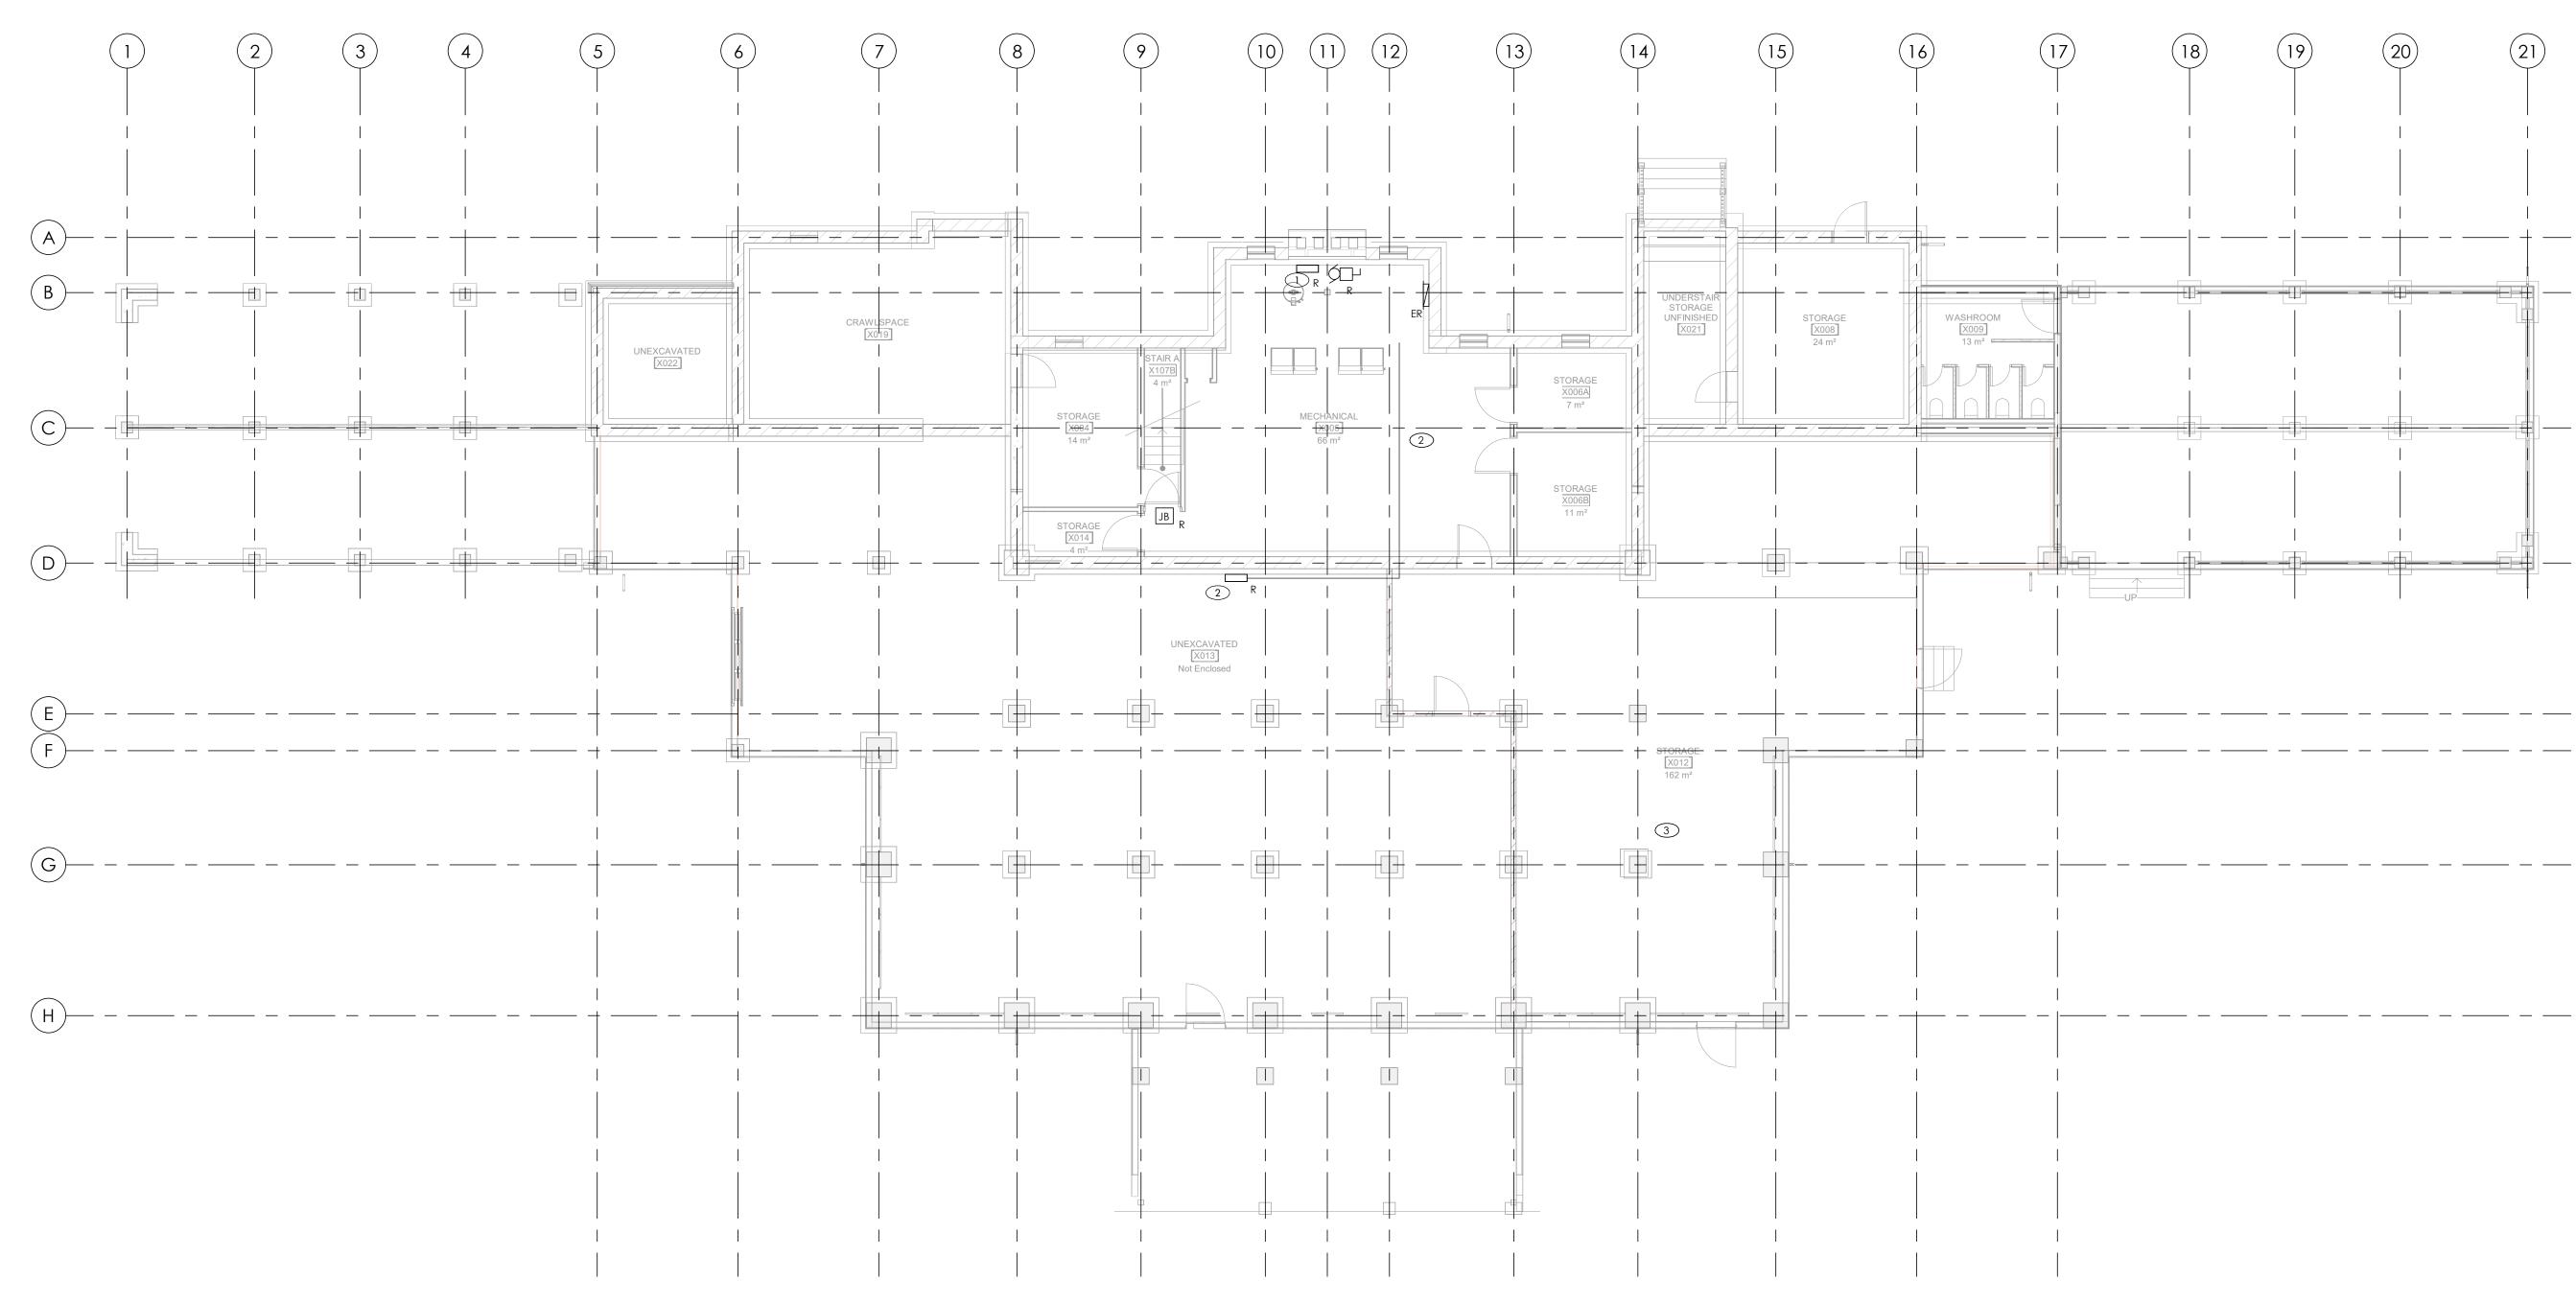


### GENERAL NOTES:


ON AVERAGE.

- ALL DEMOLITION WORK SHALL BE INCLUDED IN THE BASE CONTRACT. SINCE ALL EXISTING DEVICES ARE NOT SHOWN ON THE PLANS, THE BASE CONTRACT SCOPE SHALL INCLUDE DEMOLITION OF DEVICES SPACED 6 FEET WALL LENGTH
- DEMOLISH ALL CONDUIT, WIRING, BOXES SUPPORTS AND ACCESSORIES FOR EACH DEVICE ALL THE WAY BACK TO THE SOURCE EQUIPMENT.
- THE DEMOLITION SHALL INCLUDE ALL EQUIPMENT AND DEVICES RELATEED TO POWER, DATA, SECURUTY, ACCESS CONTROL AND OTHER COMMUNICATION SYSTEMS.

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NOTE: REFER TO ARCHITECTURAL DRAWINGS FOR PHASING INFORMATION



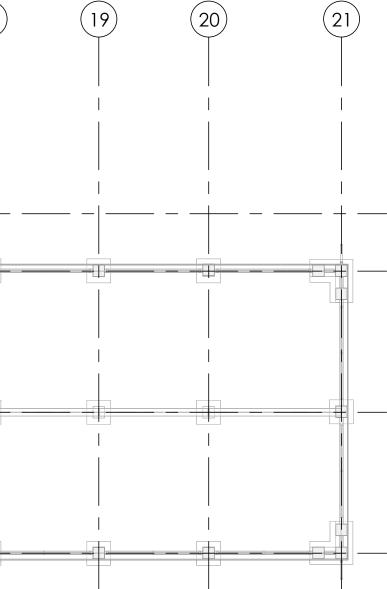

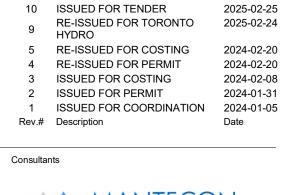

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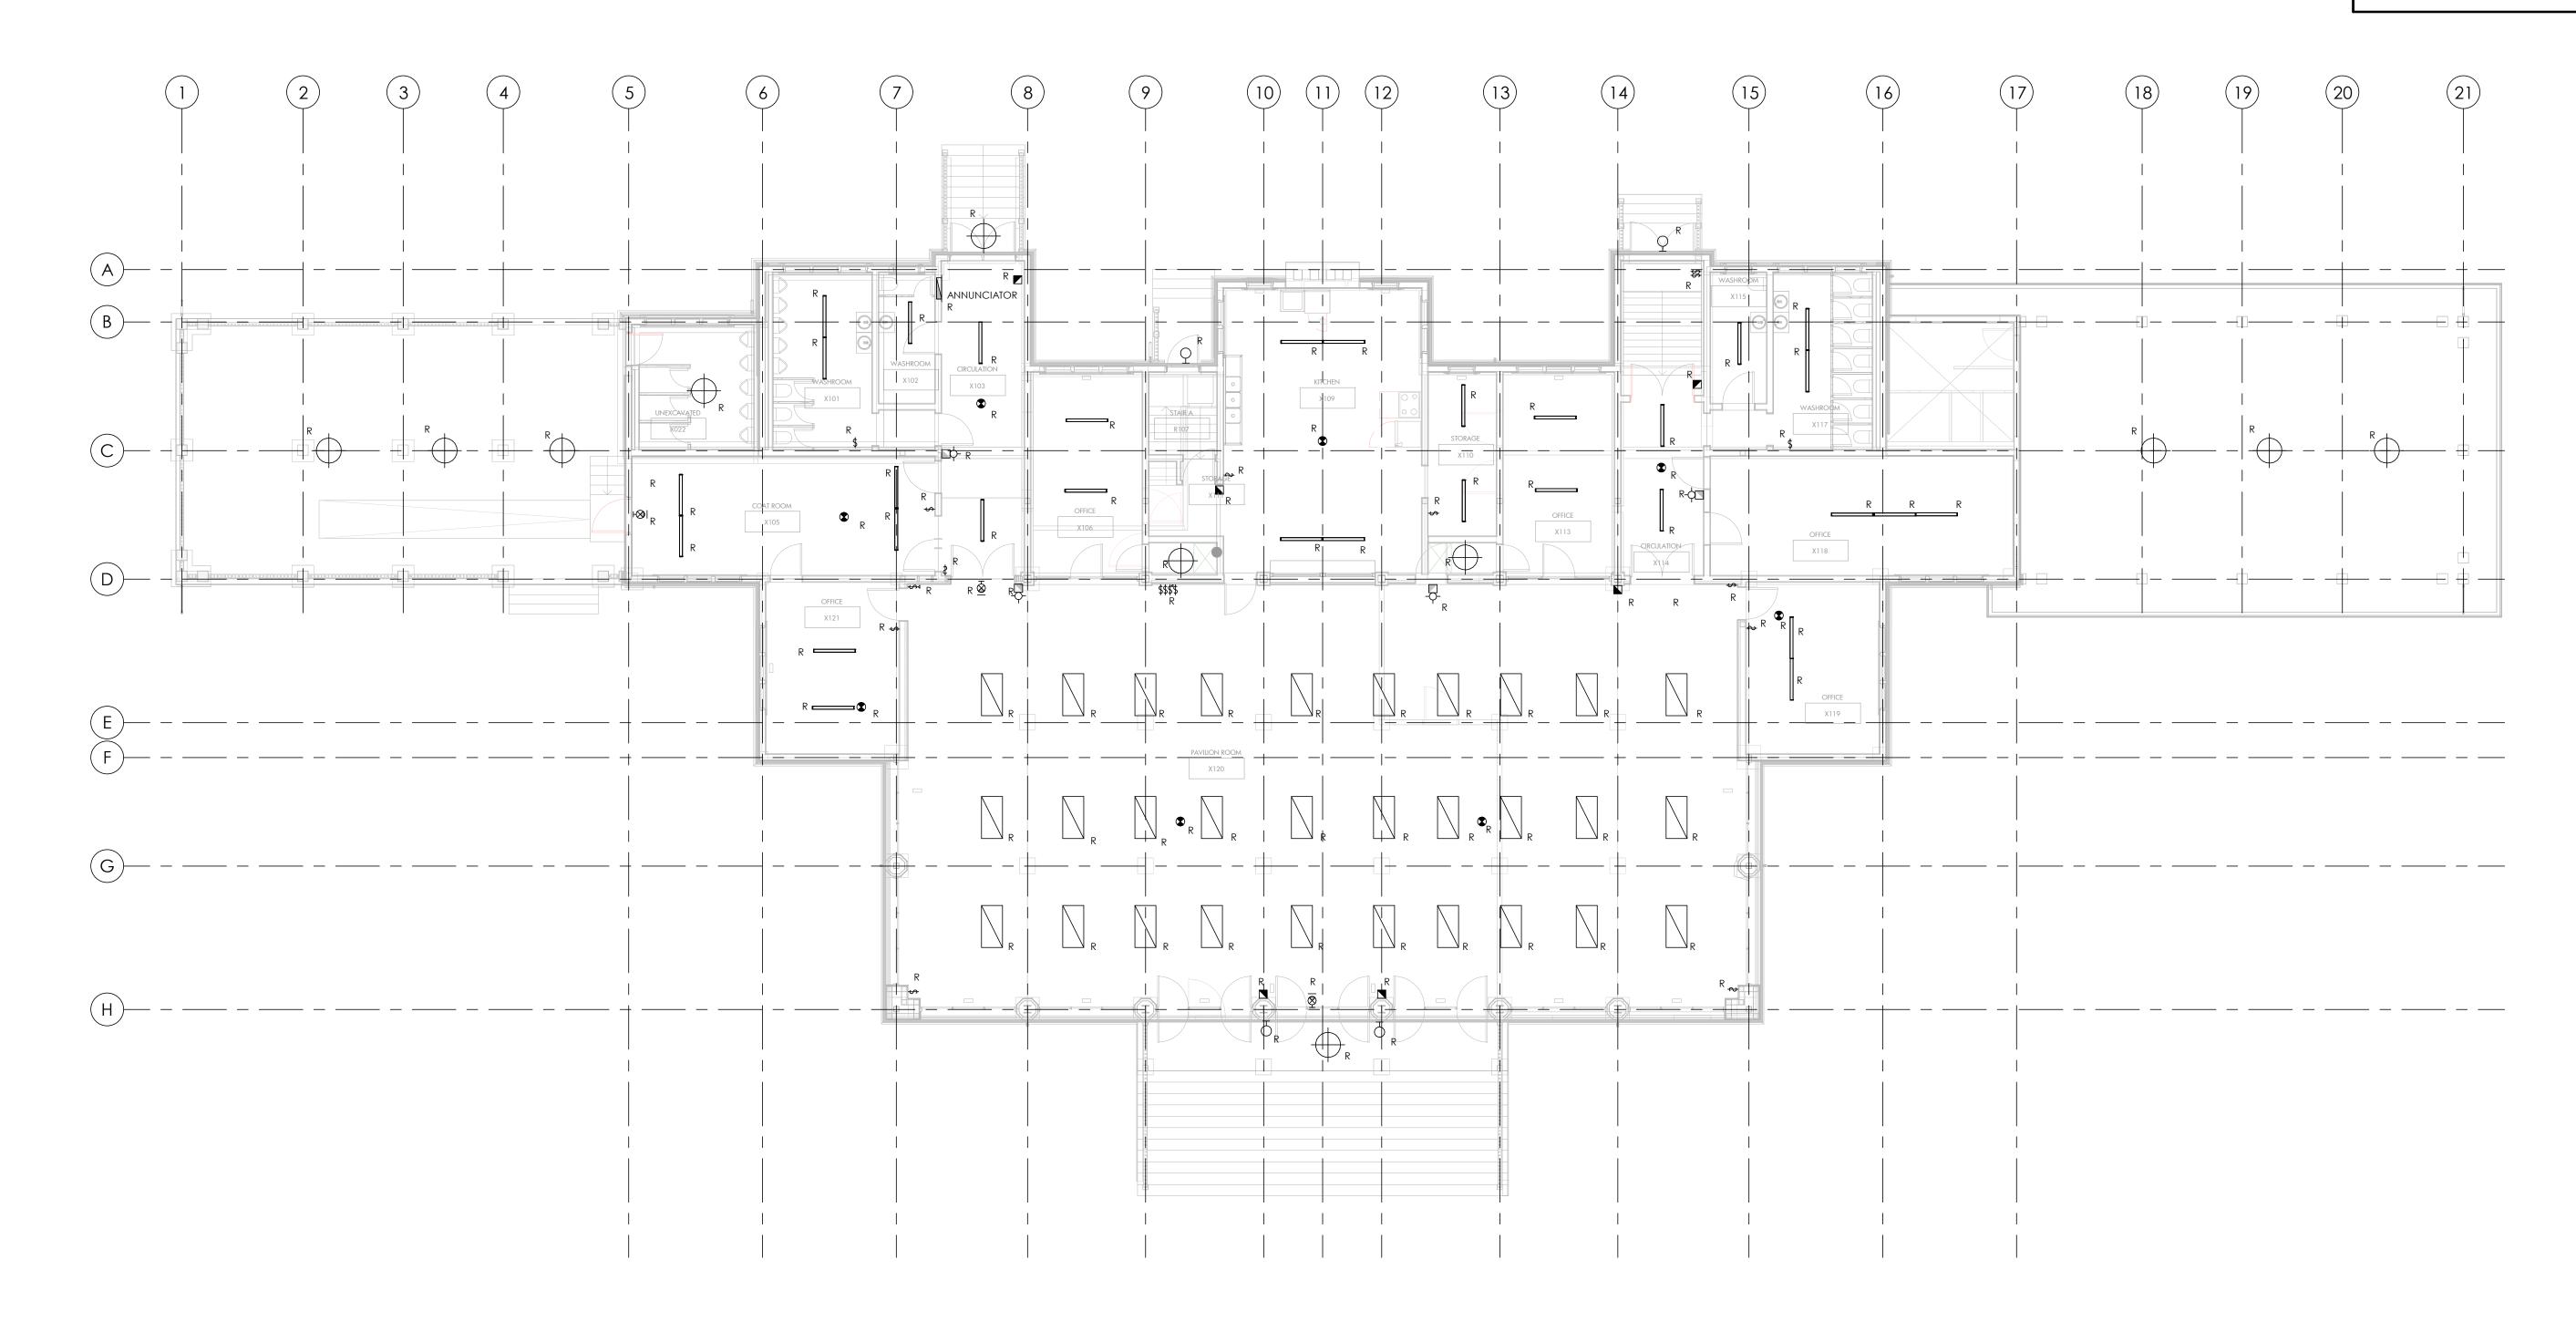
HIGH PARK NATURE AND **VISITOR'S CENTER** 

Drawing Name:

BASEMENT DEMOLITION POWER AND COMMUNICATION PLAN -PHASE 1A & 1B

Project Number:	22-142	
Drawing Scale:	As Indicated	
Date:	2025-02-25	
File Name:		
Drawn By:	M.Z.	
Reviewed By:	N.A.	NORTH ARROW
Drawing No.:		






#### GENERAL NOTES:

 DEMOLISH ASSOCIATED SOLAR PANELS OF DEMOLISHED LIGHTS IF APPLICABLE.

- 2. ALL DEMOLITION WORK SHALL BE INCLUDED IN THE BASE CONTRACT.
- 3. SINCE ALL EXISTING DEVICES ARE NOT SHOWN ON THE PLANS, THE BASE CONTRACT SCOPE SHALL INCLUDE DEMOLITION OF EMERGENCY REMOTE HEADS, LIGHT SWITCHES AND SMOKE DETECTORS SPACED 20 FEET APART AND/OR IN EACH ROOM.
- 4. DEMOLISH ALL CONDUIT, WIRING, BOXES SUPPORTS AND ACCESSORIES FOR EACH DEVICE ALL THE WAY BACK TO THE SOURCE EQUIPMENT.
- 5. THE DEMOLITION SHALL INCLUDE ALL EQUIPMENT AND DEVICES RELATEED TO POWER, DATA, SECURUTY, ACCESS CONTROL AND OTHER COMMUNICATION SYSTEMS.

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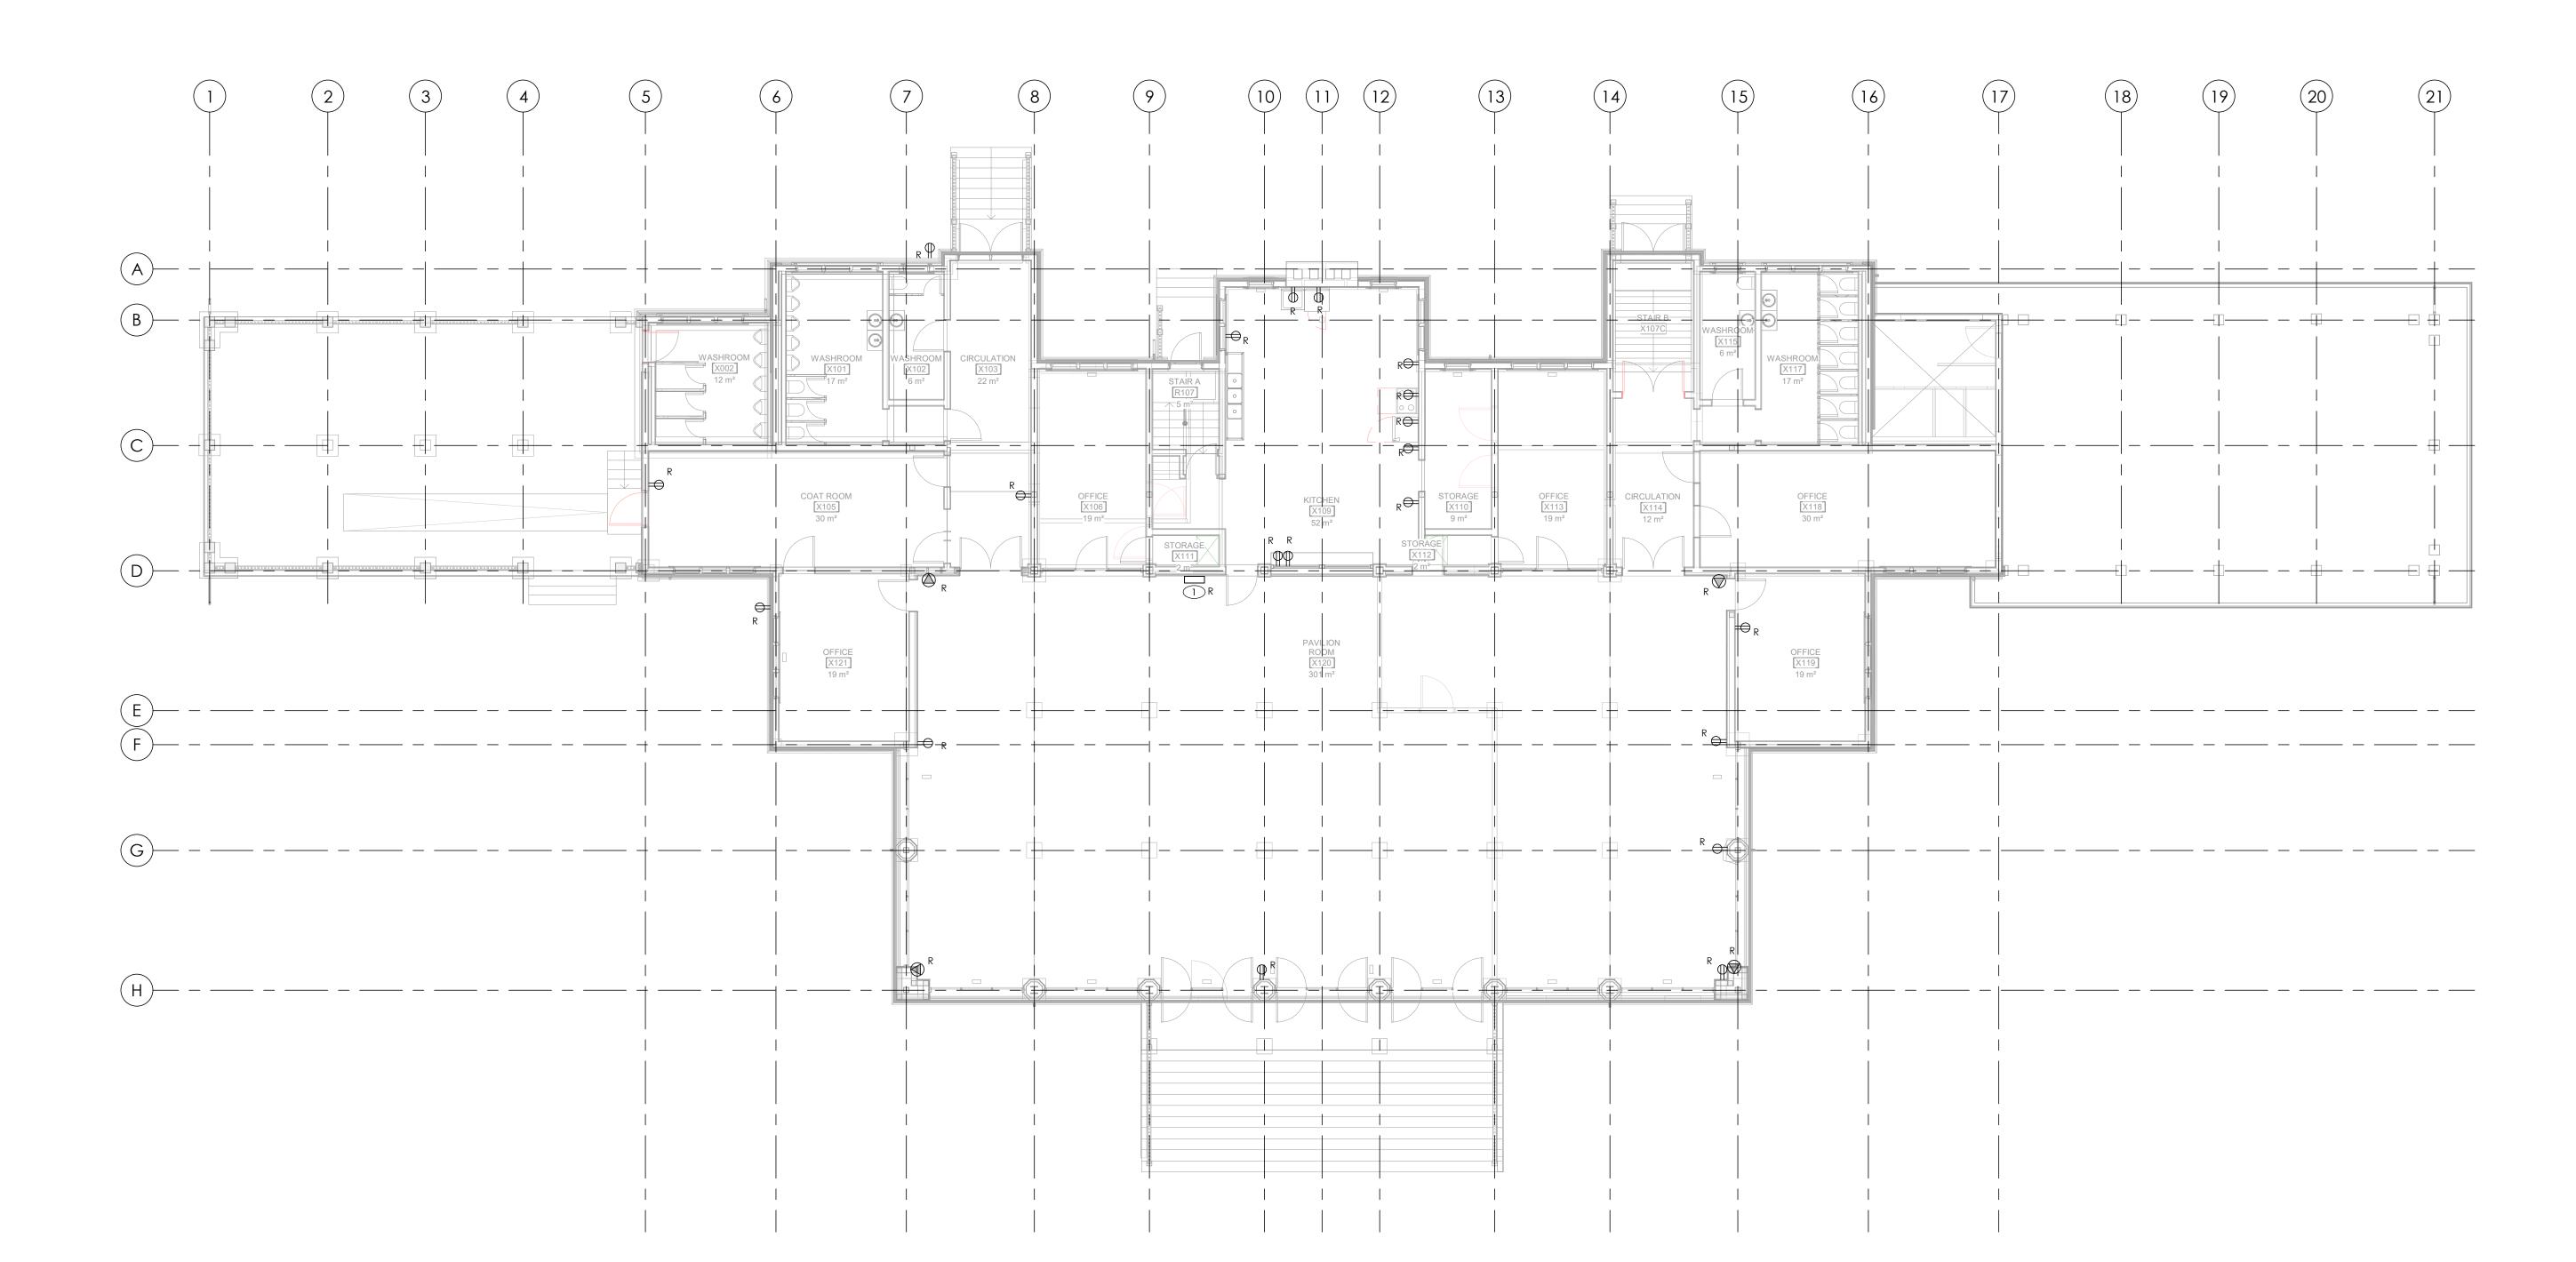
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#### HIGH PARK NATURE AND VISITOR'S CENTER

Drawing Name: LEVEL 1 DEMOLITION LIGHTING AND FIRE ALARM PLAN - PHASE 1A & 1B

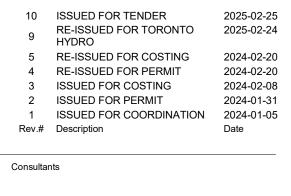Project Number:	22-142	
Drawing Scale:	As Indicated	
Date:	2025-02-25	
File Name:		
Drawn By:	M.Z.	
Reviewed By:	N.A.	NORTH ARROW
Drawing No.:		





DRAWING NOTES:			
$\subset$	1)	EXISTING PANEL AND ASSOCIATED WIRING/CONDUIT TO AND FROM PANEL SHALL BE	

1 LEVEL 1 DEMOLITION POWER AND COMMUNICATION PLAN


DEMOLISHED.

### GENERAL NOTES:

- ALL DEMOLITION WORK SHALL BE INCLUDED IN THE BASE CONTRACT. SINCE ALL EXISTING DEVICES ARE NOT SHOWN ON THE
- PLANS, THE BASE CONTRACT SCOPE SHALL INCLUDE DEMOLITION OF DEVICES SPACED 6 FEET WALL LENGTH ON AVERAGE.
- DEMOLISH ALL CONDUIT, WIRING, BOXES SUPPORTS AND ACCESSORIES FOR EACH DEVICE ALL THE WAY BACK TO THE SOURCE EQUIPMENT.
- THE DEMOLITION SHALL INCLUDE ALL EQUIPMENT AND DEVICES RELATEED TO POWER, DATA, SECURUTY, ACCESS CONTROL AND OTHER COMMUNICATION SYSTEMS.

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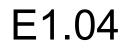
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375 COLBORNE LODGE DR, TORONTO, ON M6R 2Z3


#### HIGH PARK NATURE AND **VISITOR'S CENTER**

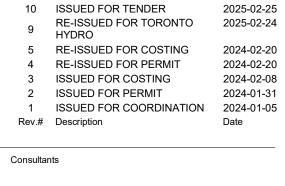Drawing Name: LEVEL 1 DEMOLITION POWER AND COMMUNICATION PLAN -PHASE 1A & 1B

Project Number:	22-142	
Drawing Scale:	As Indicated	
Date:	2025-02-25	
File Name:		
Drawn By:	M.Z.	
Reviewed By:	N.A.	NORTH ARROW
Drawing No.:		




(1) REINSTALL ALL EXISTING LIGHT FIXTURES AND ASSOCIATED WIRING UNDER GRIDLINE D. REFER TO DEMOLITION PLAN E1.01 GENERAL NOTES.

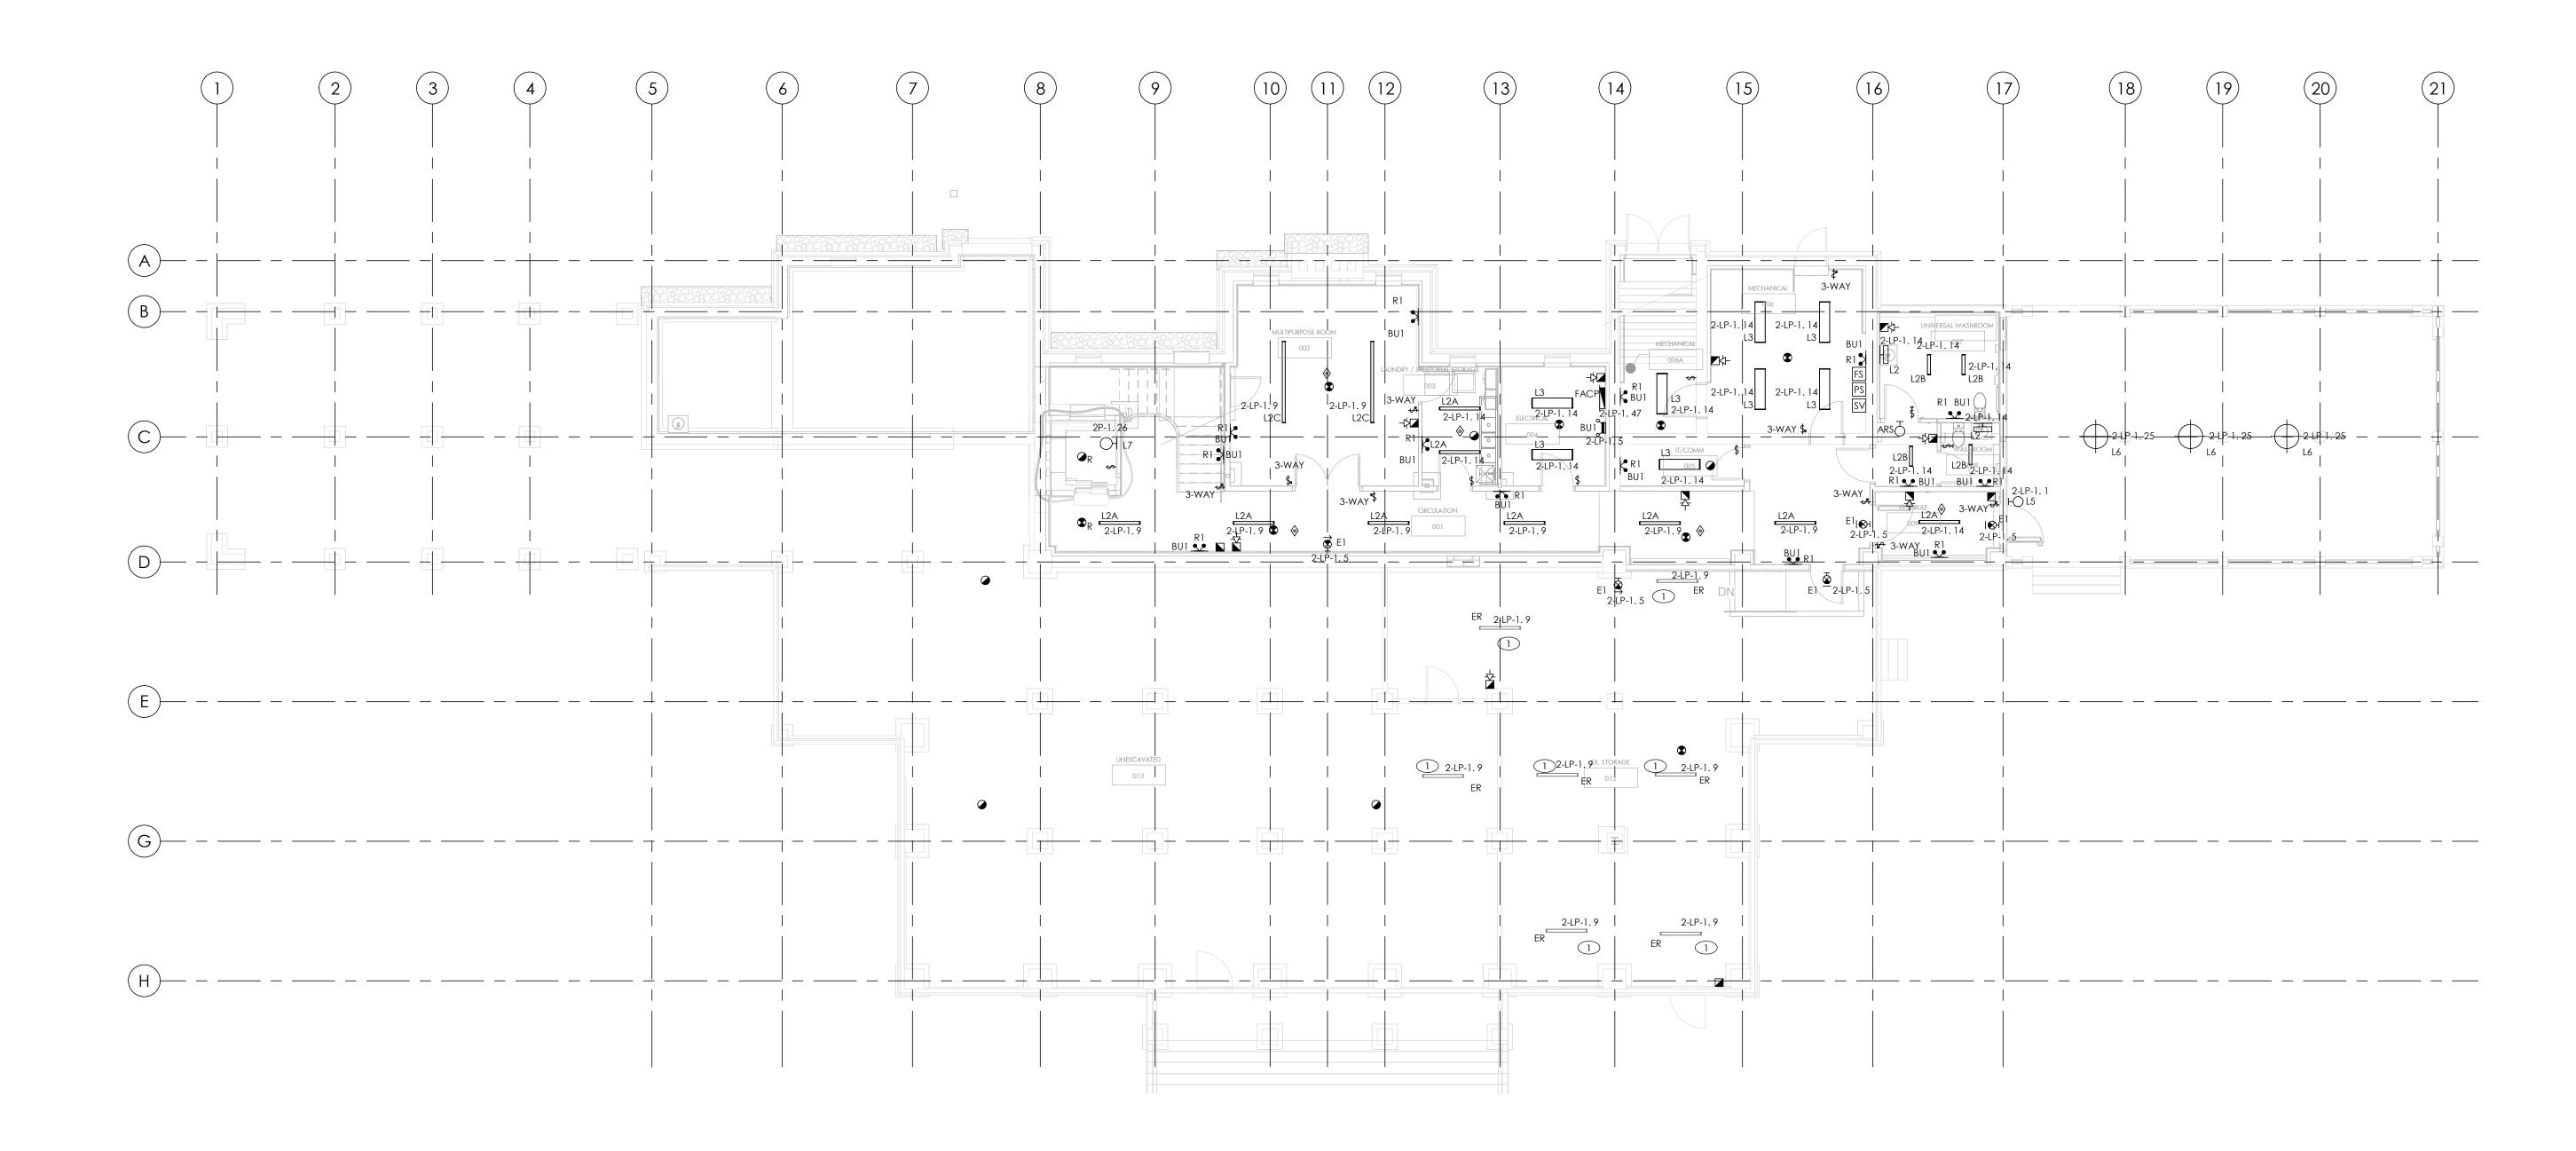

REVIEW ALL DRAWINGS AND VERIFY ALL DIMENSIONS AT THE SITE. DO NOT SCALE THE DRAWINGS. REPORT ALL DISCREPANCIES TO THE ENGINEER BEFORE PROCEEDING WITH ANY CONSTRUCTION OR SHOP FABRICATION. ALL DRAWINGS, SPECIFICATIONS AND RELATED DOCUMENTS ARE THE COPYRIGHT PROPERTY OF 'MANTECON PARTNERS' AND MUST BE RETURNED UPON REQUEST. REPRODUCTION OF DRAWINGS, SPECIFICATIONS AND RELATED DOCUMENTS IN PART OR WHOLE IS FORBIDDEN WITHOUT THE ENGINEER'S WRITTEN PERMISSION.

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Seals
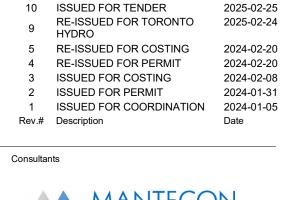
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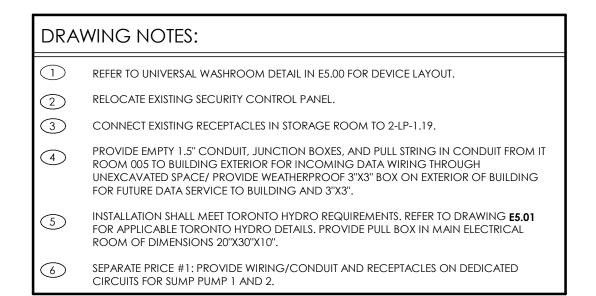
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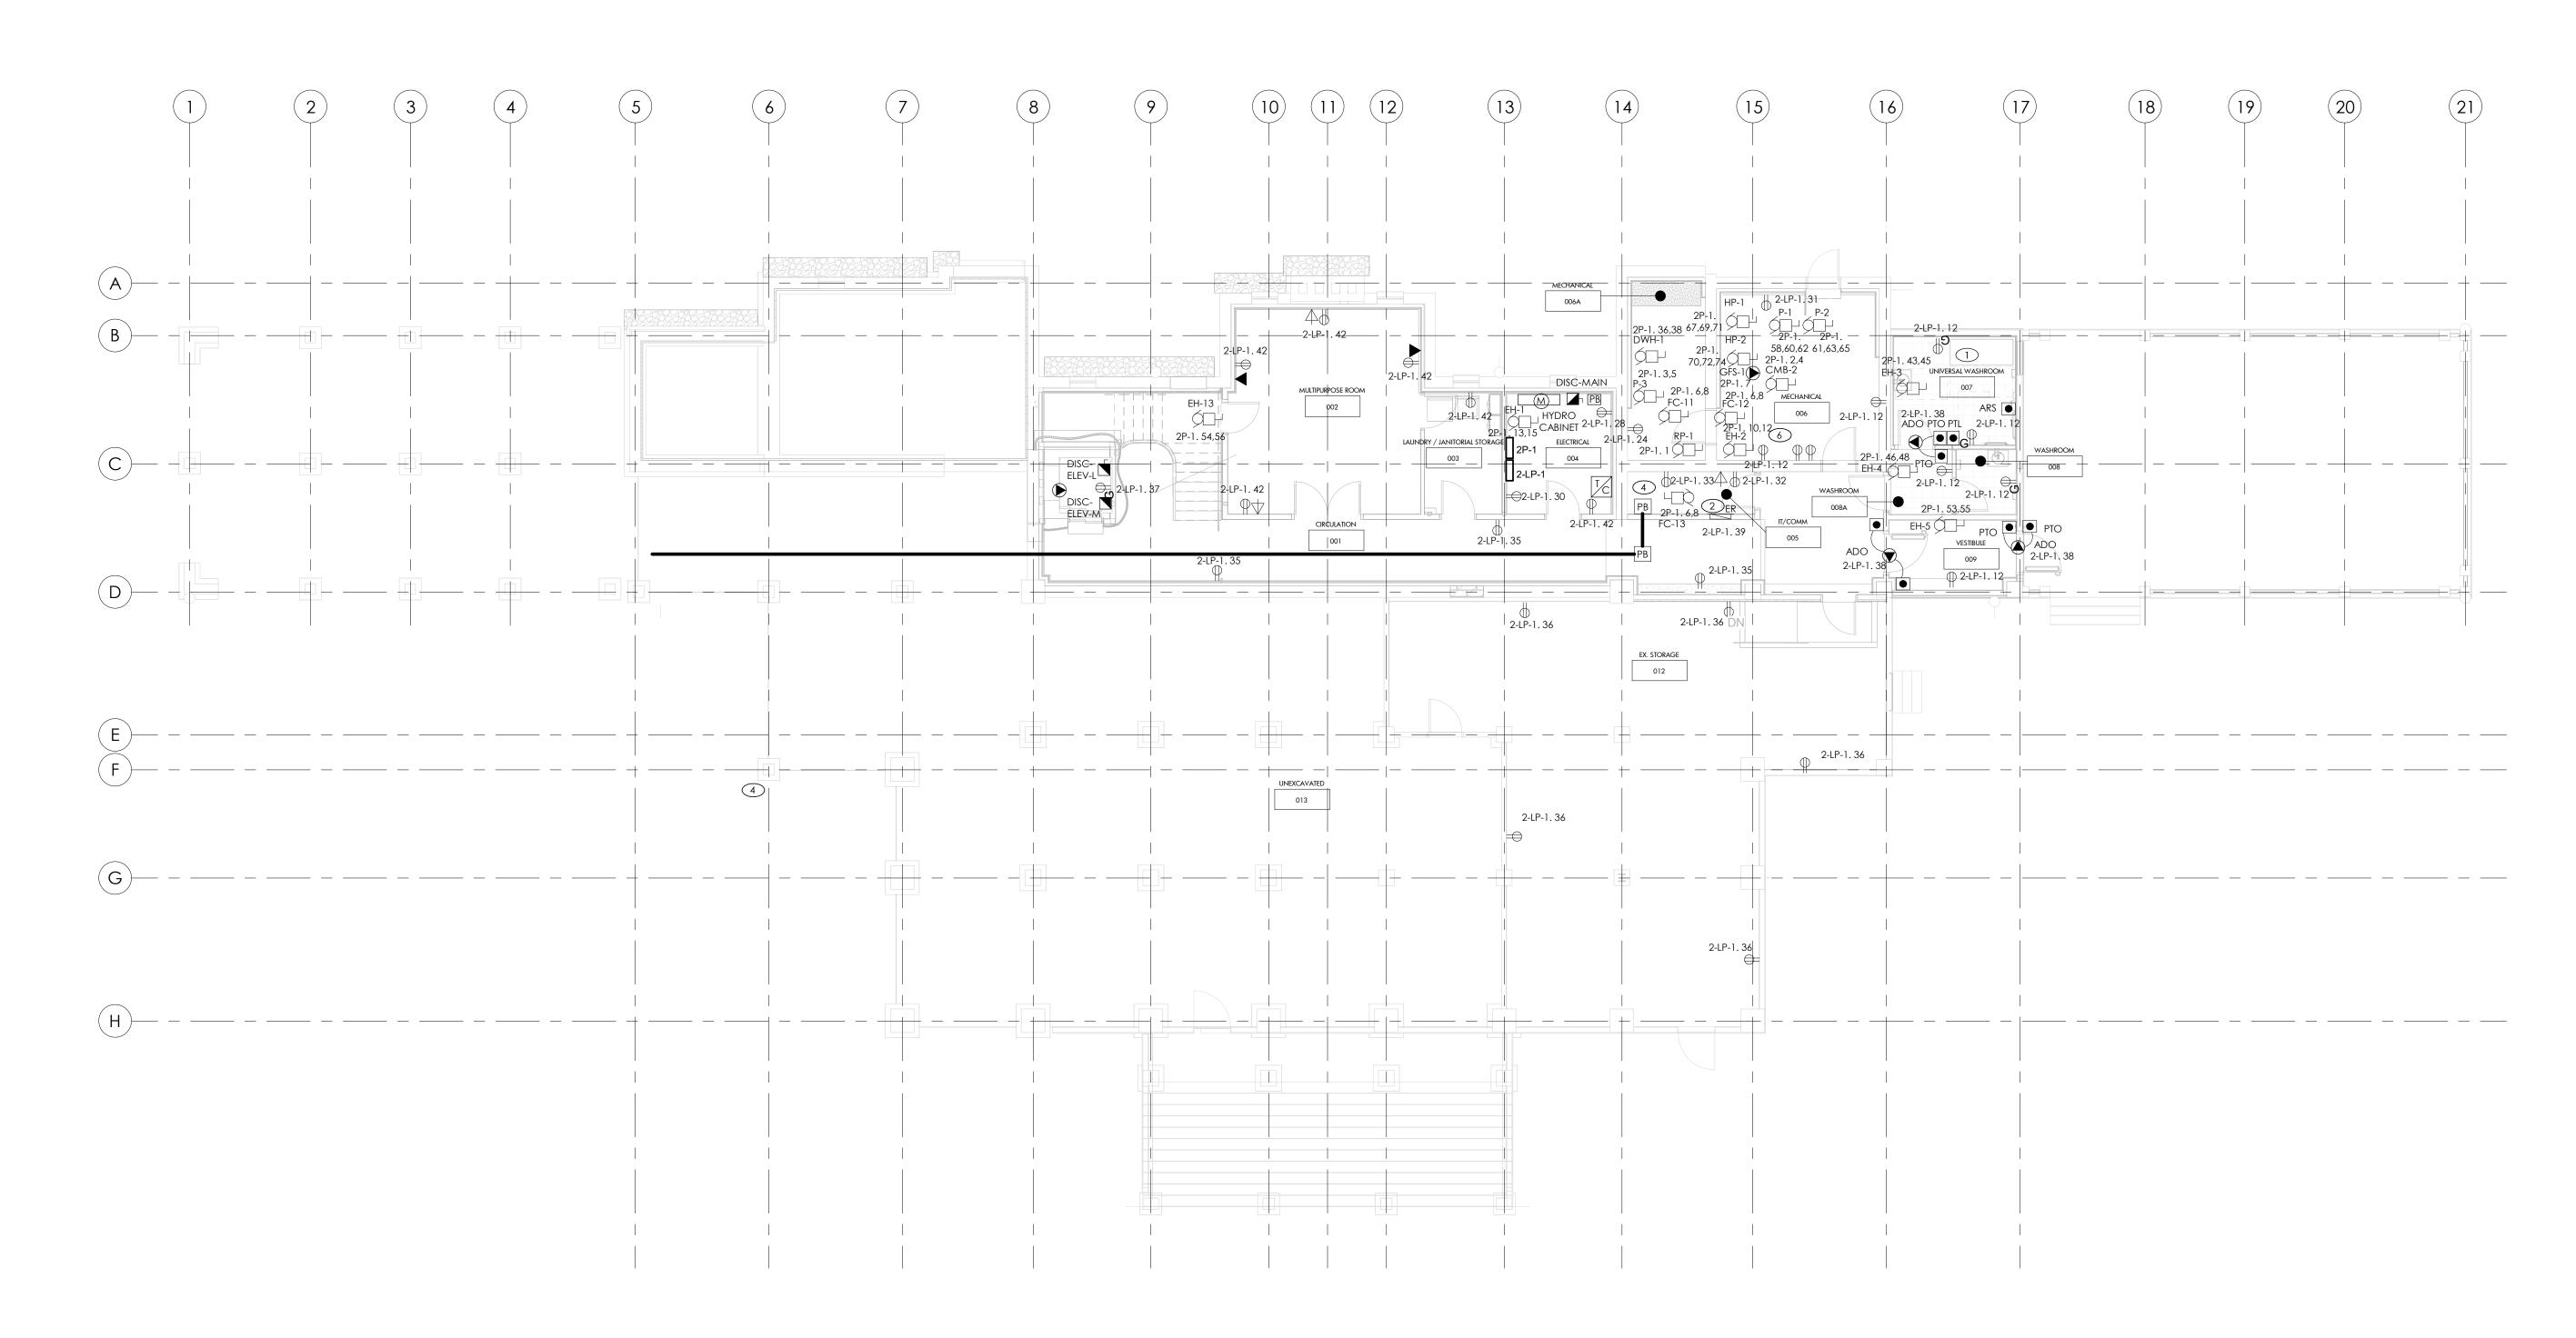
HIGH PARK NATURE AND VISITOR'S CENTER

Drawing Name: BASEMENT PROPOSED LIGHTING AND FIRE ALARM PLAN - PHASE 1A & 1B

Project Number:	22-142	
Drawing Scale:	As Indicated	
Date:	2025-02-25	
File Name:		
Drawn By:	M.Z.	
Reviewed By:	N.A.	NORTH ARROW
Drawing No.:		







NOTE: REFER TO ARCHITECTURAL DRAWINGS FOR PHASING INFORMATION

10	ISSUED FOR TENDER	2025-02-25
9	RE-ISSUED FOR TORONTO HYDRO	2025-02-24
8	RE-ISSUED FOR TORONTO HYDRO	2024-12-19
5	RE-ISSUED FOR COSTING	2024-02-20
4	RE-ISSUED FOR PERMIT	2024-02-20
3	ISSUED FOR COSTING	2024-02-08
2	ISSUED FOR PERMIT	2024-01-31
1	ISSUED FOR COORDINATION	2024-01-05
Rev.#	Description	Date



Seals

Consultants

375 COLBORNE LODGE DR, TORONTO, ON M6R 2Z3

#### HIGH PARK NATURE AND VISITOR'S CENTER


Drawing Name:

BASEMENT PROPOSED POWER AND COMMUNICATION PLAN -PHASE 1A & 1B

Project Number:	22-142	
Drawing Scale:	As Indicated	
Date:	2025-02-25	
File Name:		
Drawn By:	M.Z.	
Reviewed By:	N.A.	NORTH ARROW
Drawing No.:		




# DRAWING NOTES: LIGHTS SHALL BE MOUNTED AT TOP OF EXTERIOR OVERHANG. SEE E2.01 BASMENT PROPOSED LIGHTING AND FIRE ALARM PLAN.

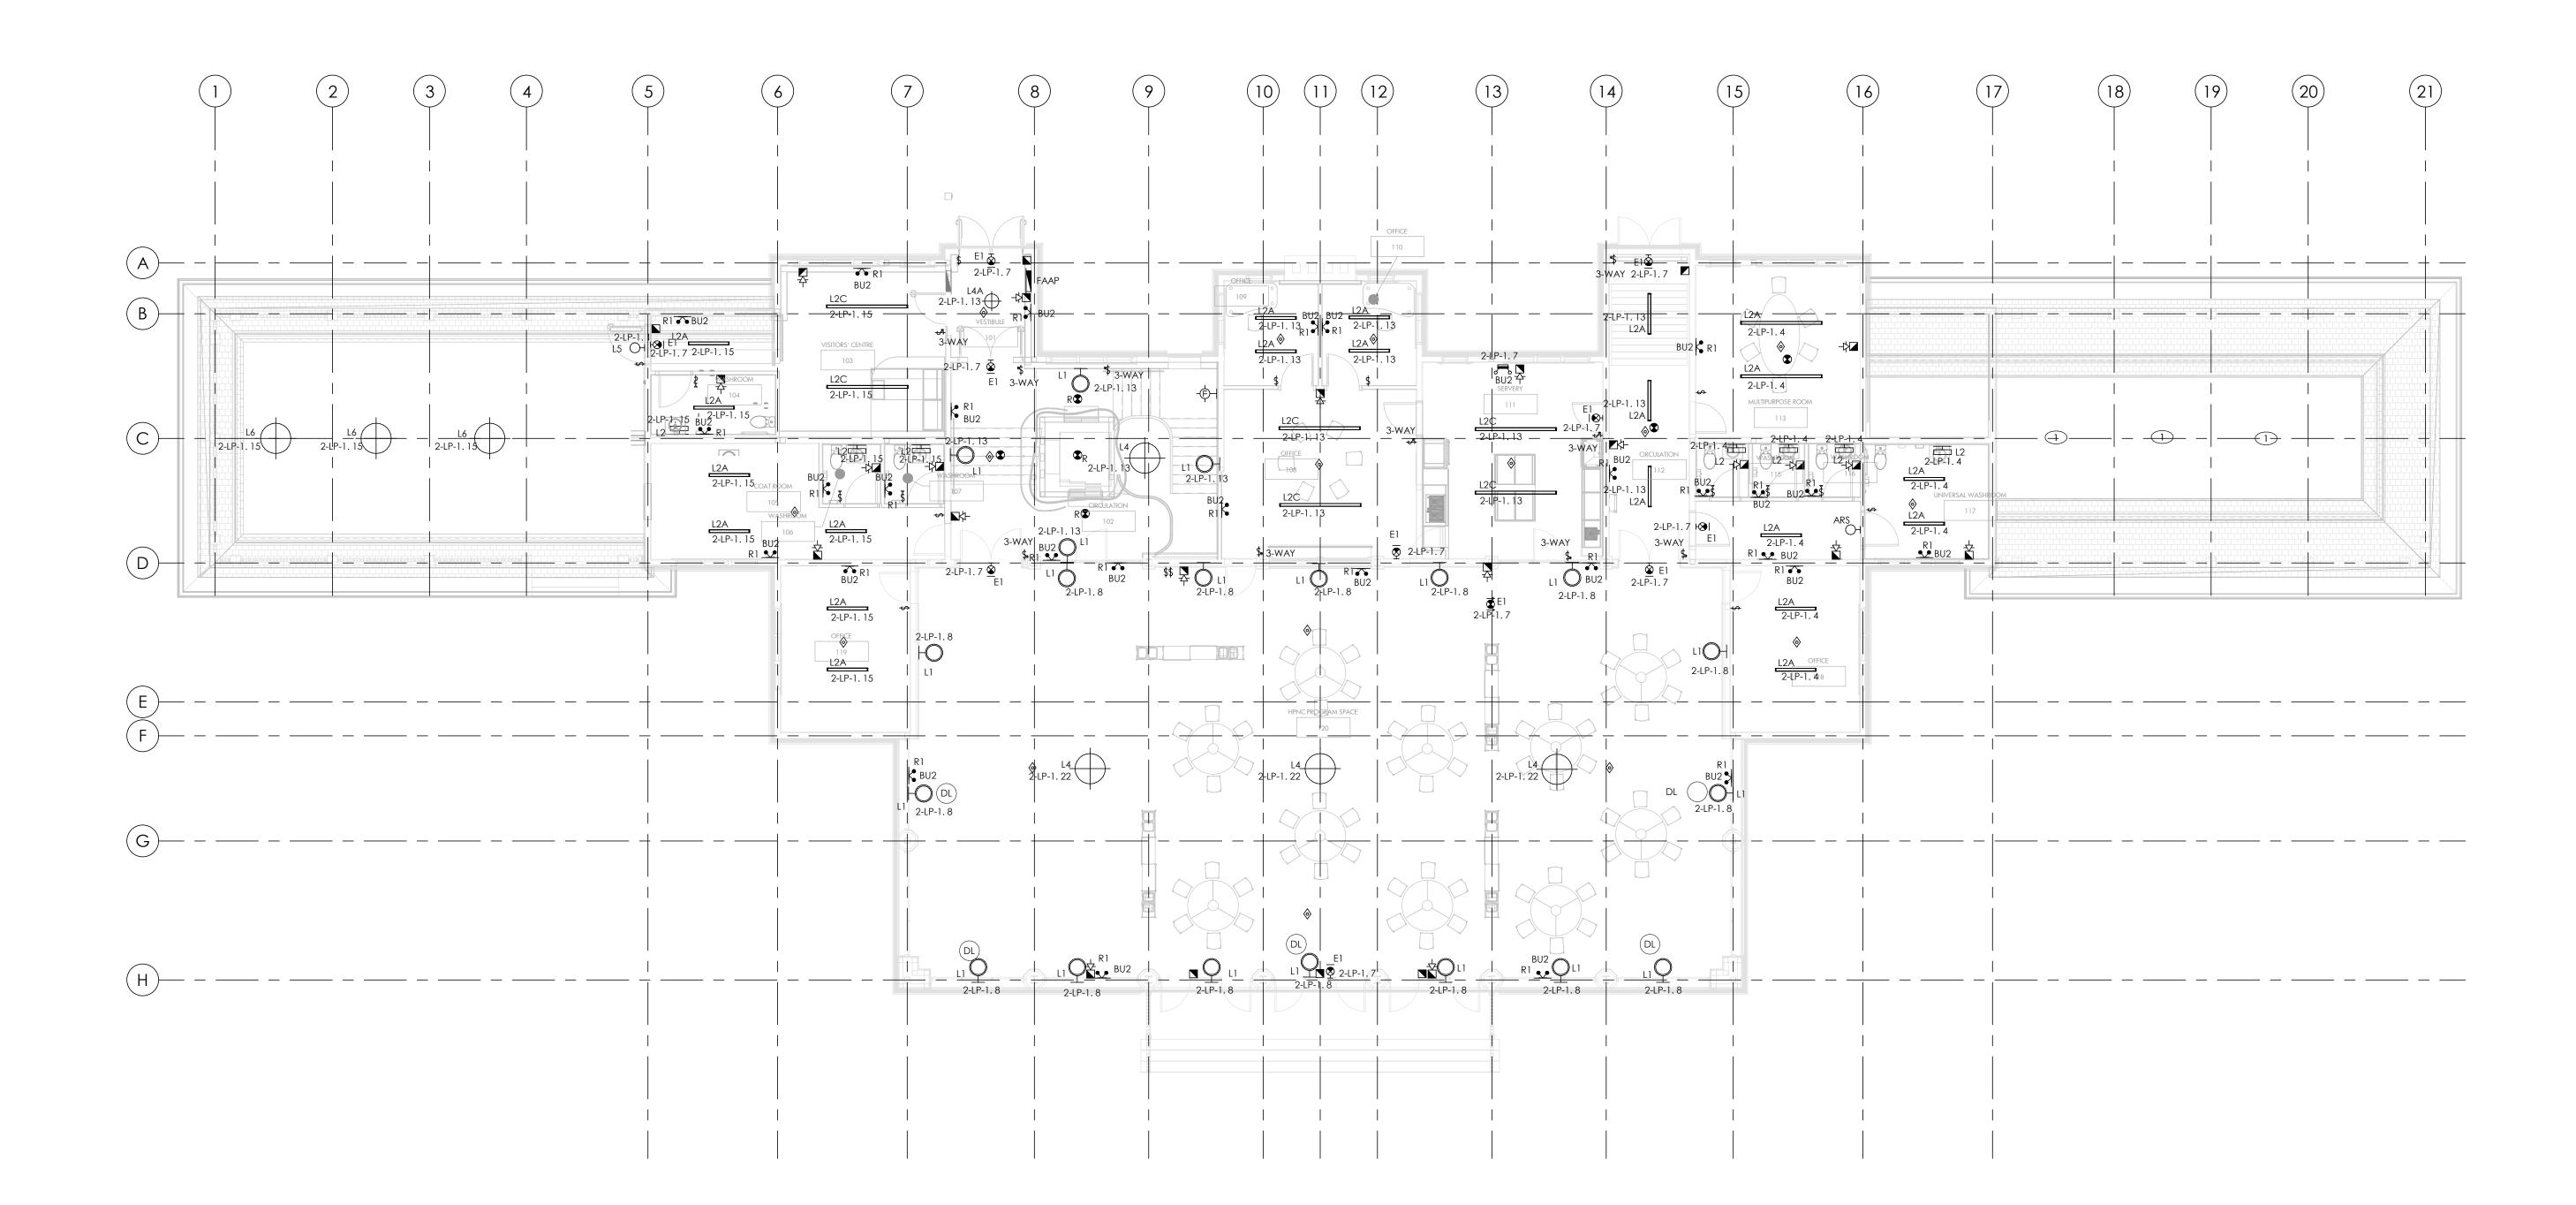

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NOTE: REFER TO ARCHITECTURAL DRAWINGS FOR PHASING INFORMATION



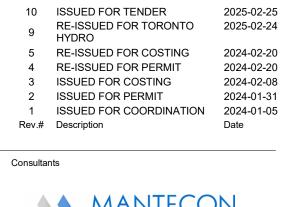

Seals

375 COLBORNE LODGE DR, TORONTO, ON M6R 2Z3

#### HIGH PARK NATURE AND VISITOR'S CENTER


Drawing Name: LEVEL 1 PROPOSED LIGHTING AND FIRE ALARM PLAN - PHASE 1A & 1B

Project Number:	22-142	
Drawing Scale:	As Indicated	
Date:	2025-02-25	
File Name:		
Drawn By:	M.Z.	
Reviewed By:	N.A.	NORTH ARROV
Drawing No.:		






EXTERIOR SHALL BE RIGID METAL, CONDUIT WITHIN BUILDING SHALL BE EMT. CONDUIT SHALL PENETRATE EXTERIOR WALL AT INDICATED PULLBOX, TRANSITION TO EMT AND RUN DOWN TO BASEMENT LEVEL UNEXCAVATED SPACE. REFER TO DRAWING E2.02.

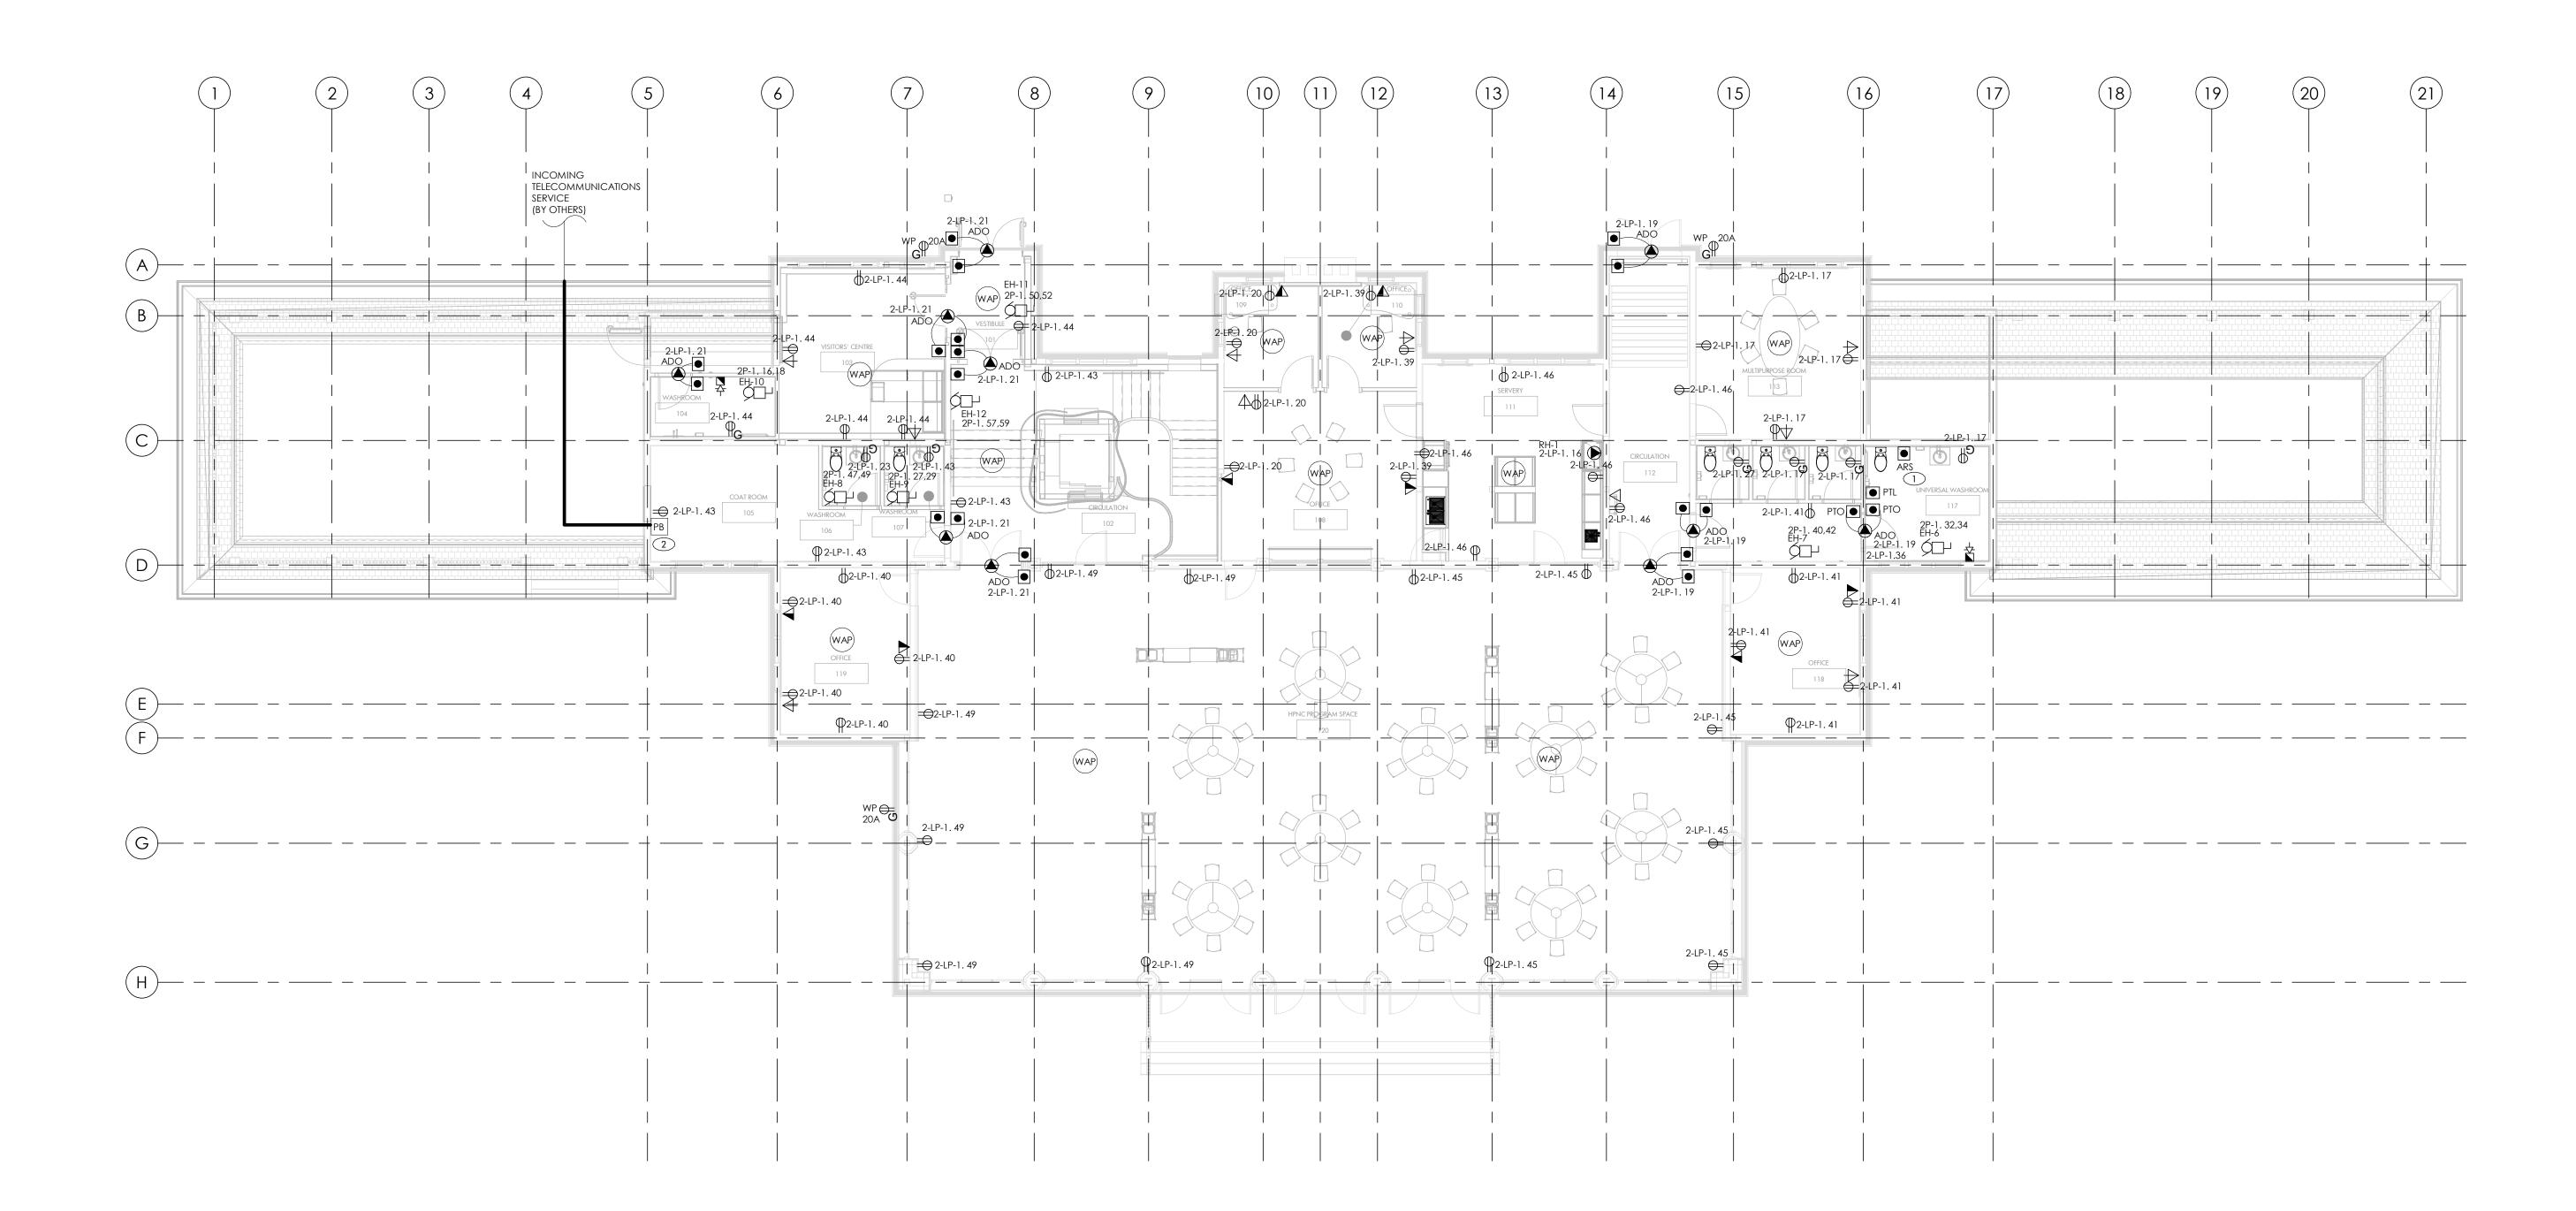

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NOTE: REFER TO ARCHITECTURAL DRAWINGS FOR PHASING INFORMATION



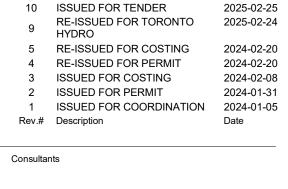

Seals

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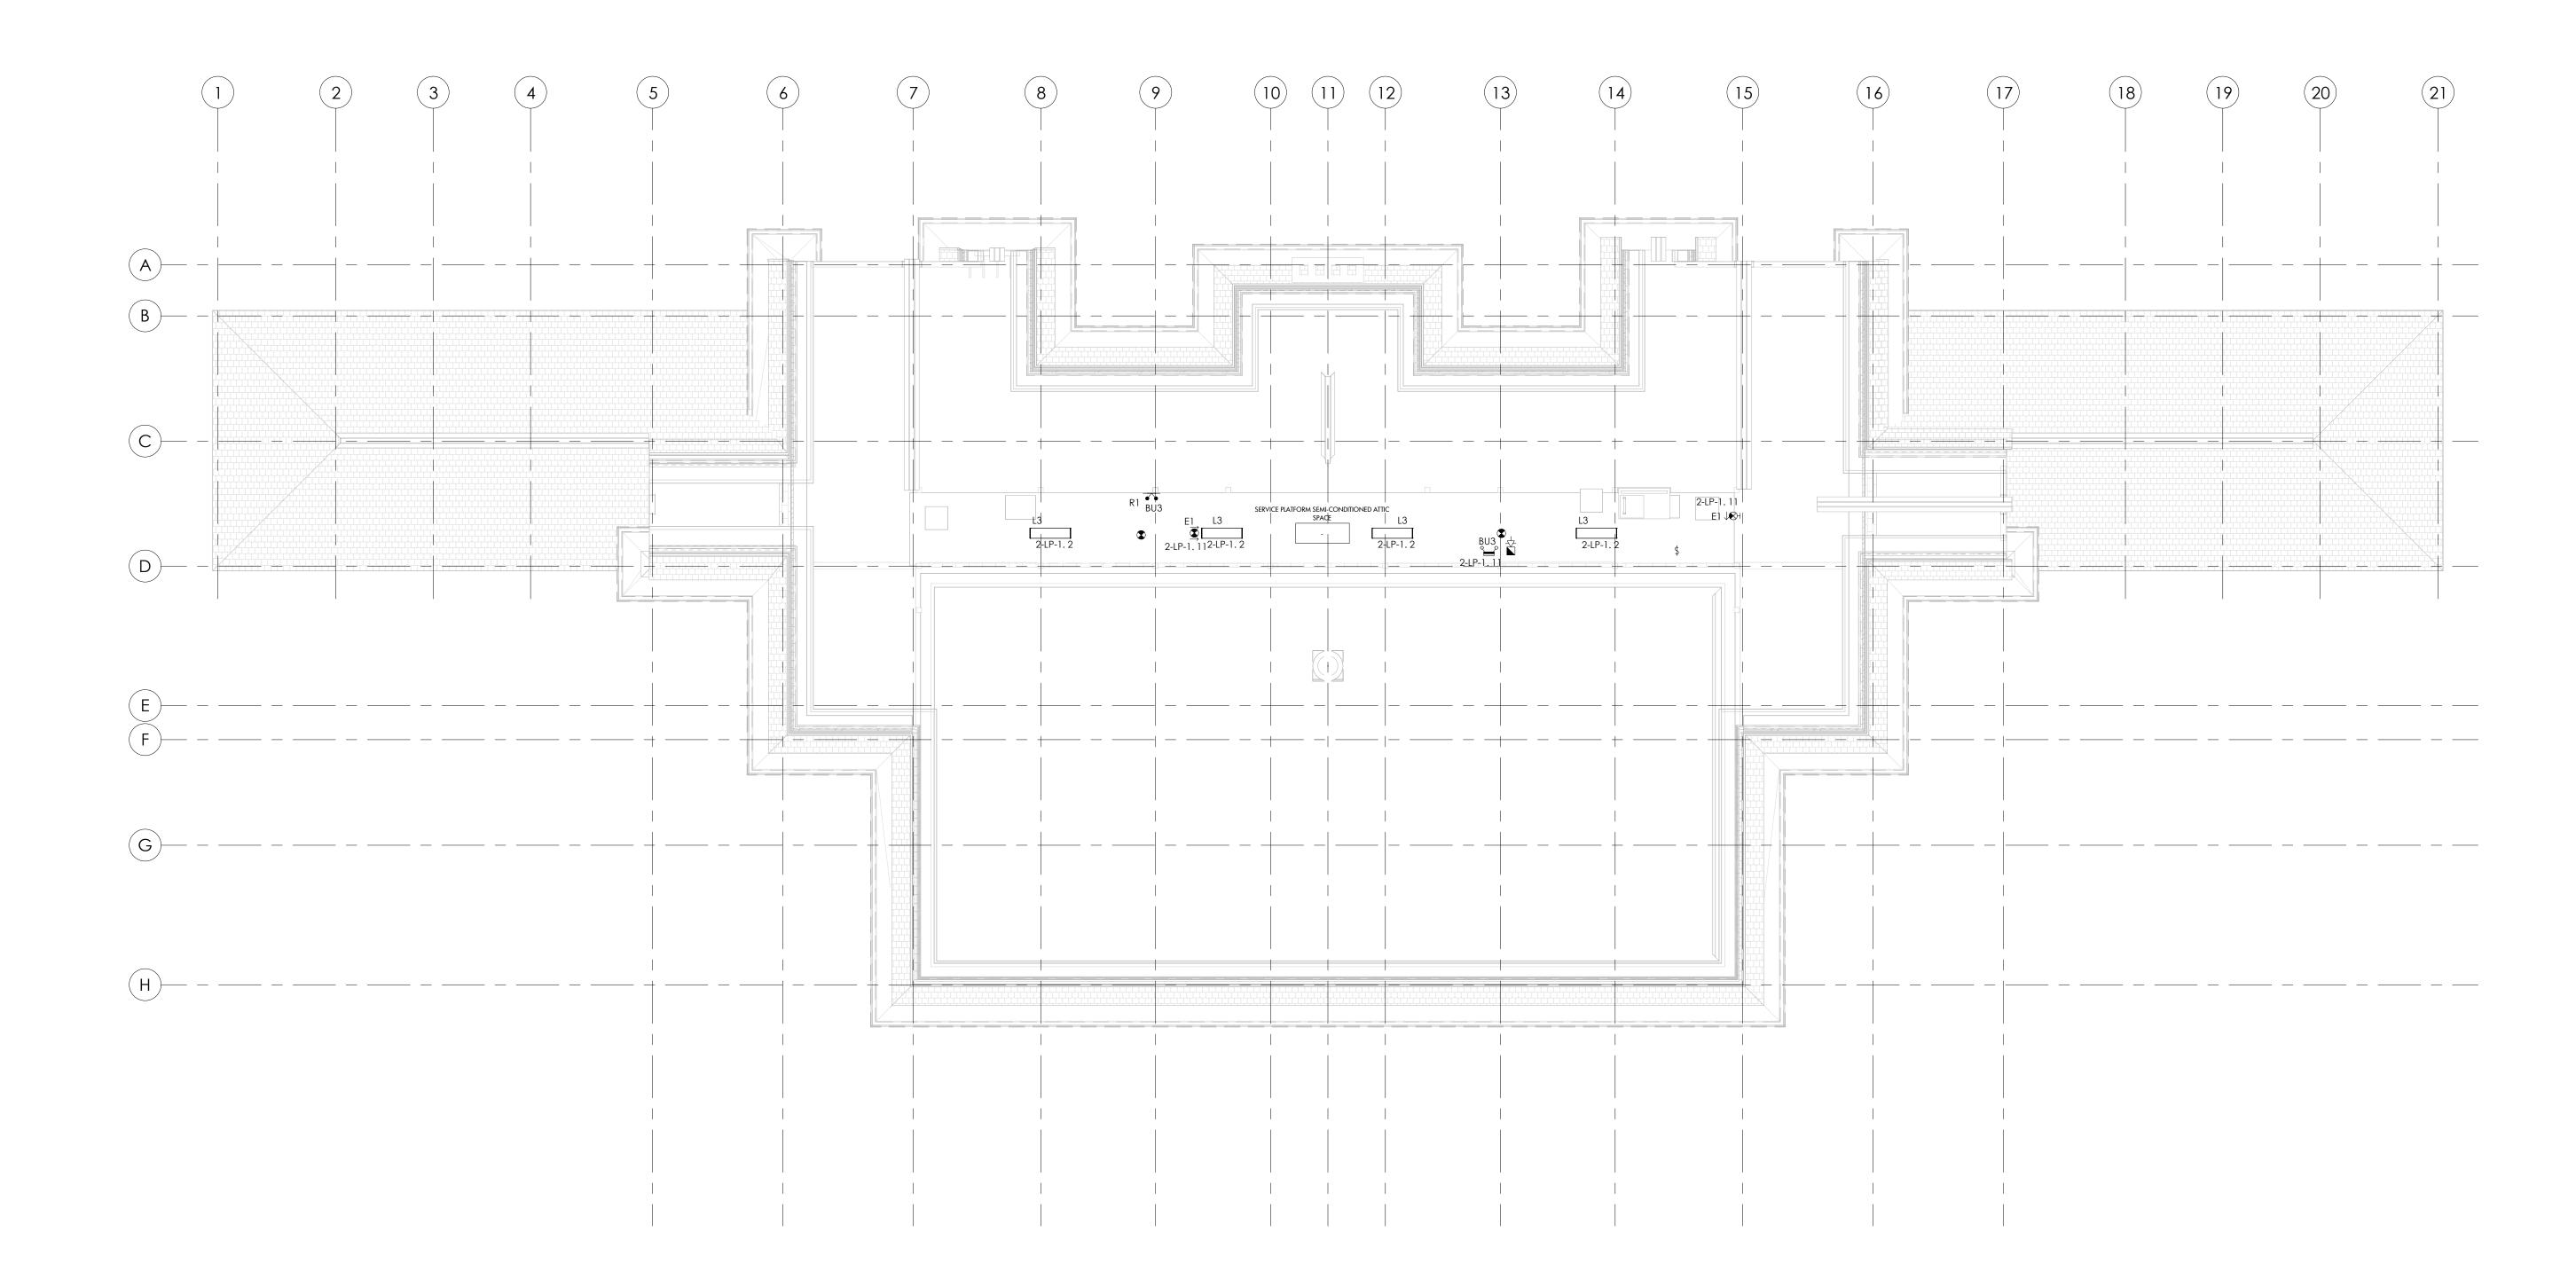
#### HIGH PARK NATURE AND **VISITOR'S CENTER**

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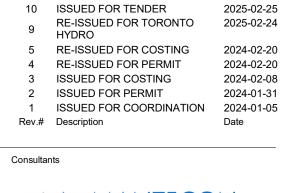
LEVEL 1 PROPOSED POWER AND COMMUNICATION PLAN - PHASE 1A & 1B

Project Number:	22-142	
Drawing Scale:	As Indicated	
Date:	2025-02-25	
File Name:		
Drawn By:	M.Z.	
Reviewed By:	N.A.	NORTH ARROW
Drawing No.:		





NOTE: REFER TO ARCHITECTURAL DRAWINGS FOR PHASING INFORMATION





Seals

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375 COLBORNE LODGE DR, TORONTO, ON M6R 2Z3


HIGH PARK NATURE AND VISITOR'S CENTER

Drawing Name:

ATTIC LEVEL PROPOSED LIGHTING AND FIRE ALARM PLAN - PHASE 1A & 1B

Project Number:	22-142	
Drawing Scale:	As Indicated	
Date:	2025-02-25	
File Name:		
Drawn By:	M.Z.	
Reviewed By:	N.A.	NORTH ARROW
 Drawing No.:		



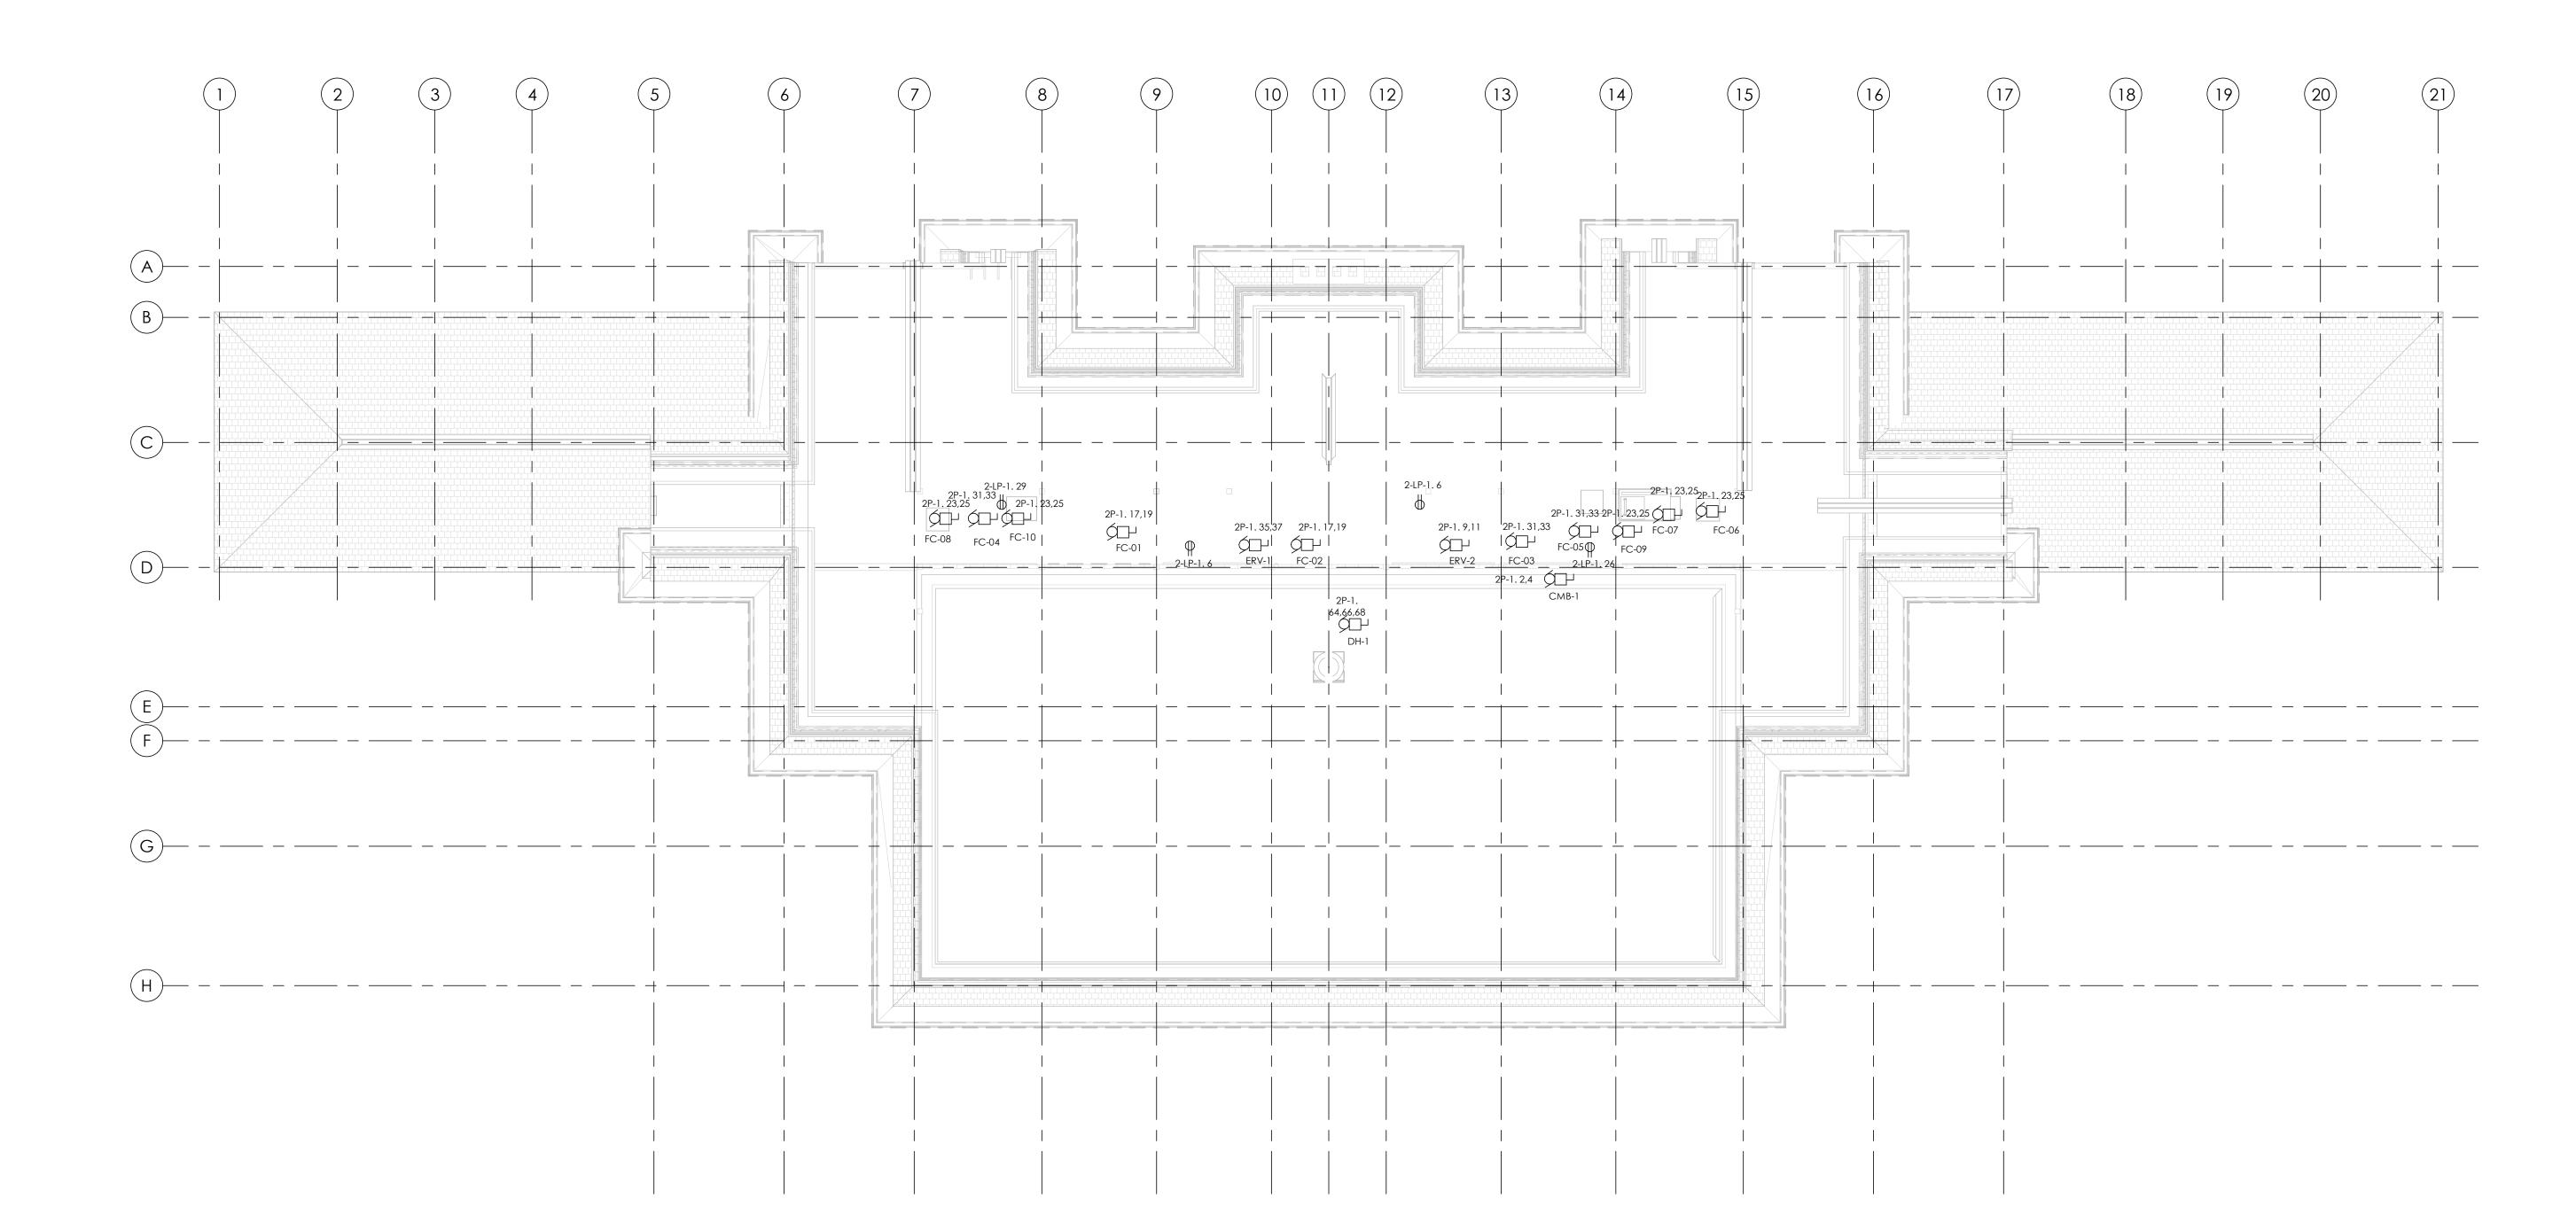

NOTE: REFER TO ARCHITECTURAL DRAWINGS FOR PHASING INFORMATION

10	ISSUED FOR TENDER	2025-02-2
9	RE-ISSUED FOR TORONTO HYDRO	2025-02-2
5	RE-ISSUED FOR COSTING	2024-02-2
4	RE-ISSUED FOR PERMIT	2024-02-2
3	ISSUED FOR COSTING	2024-02-0
2	ISSUED FOR PERMIT	2024-01-3
1	ISSUED FOR COORDINATION	2024-01-0
Rev.#	Description	Date
Consultar	nts	



Seals

375 COLBORNE LODGE DR, TORONTO, ON M6R 2Z3


#### HIGH PARK NATURE AND VISITOR'S CENTER

Drawing Name:

ATTIC LEVEL PROPOSED POWER AND COMMUNICATION PLAN -PHASE 1A & 1B


Project Number:	22-142	
Drawing Scale:	As Indicated	
Date:	2025-02-25	
File Name:		
Drawn By:	M.Z.	
Reviewed By:	N.A.	NORTH ARROW
Drawing No.:		



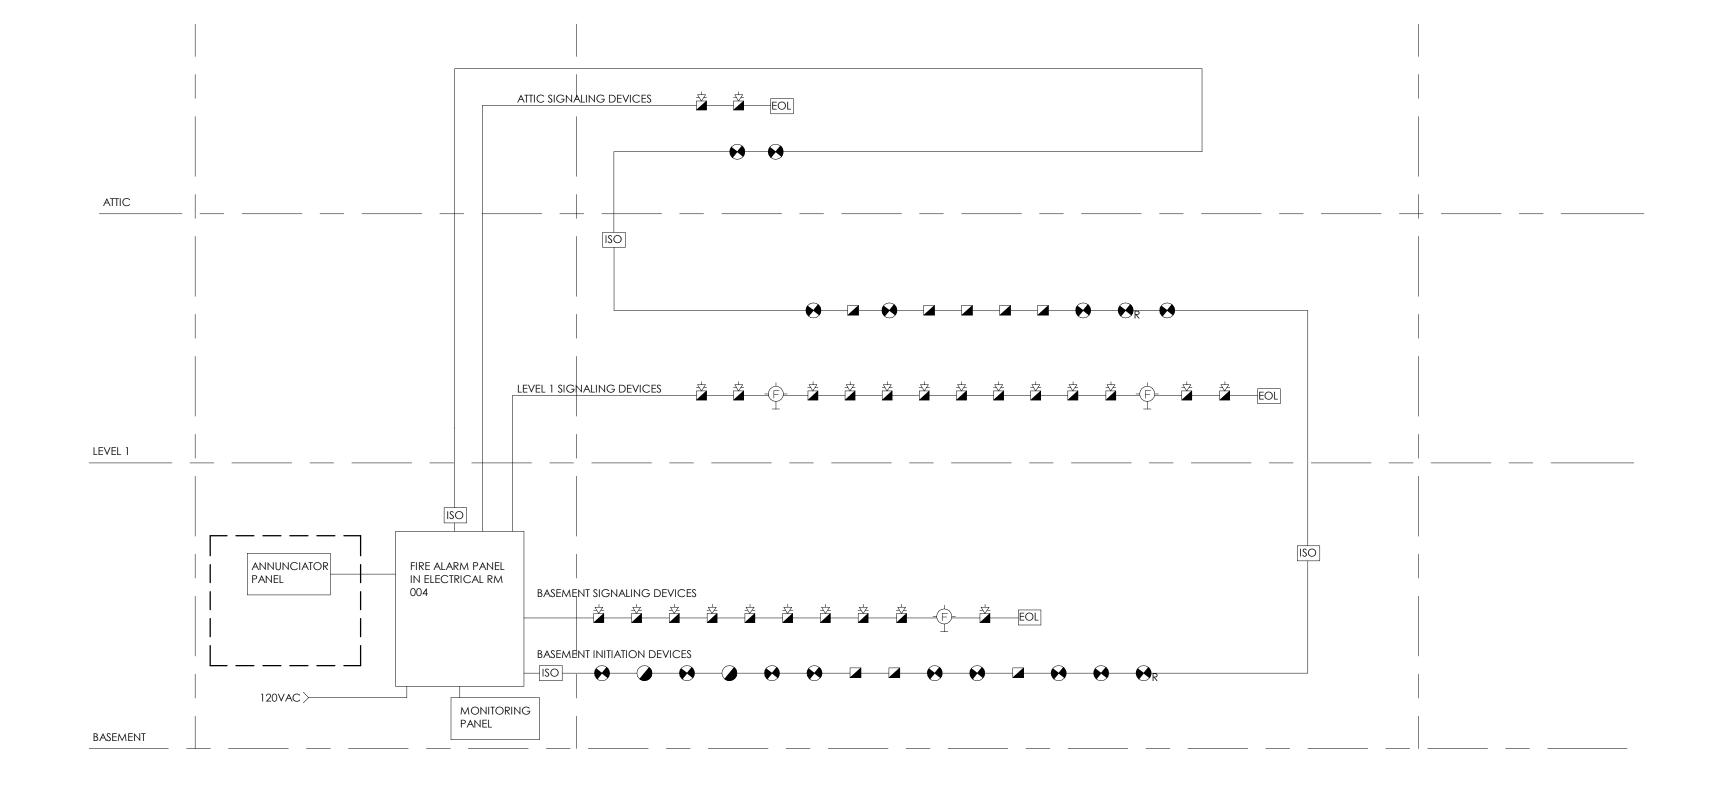

	FIRE ALARM ZONE SCHEDUL
ZONE	DESCRIPTION
Z1	FIRE ALARM ZONE 1 - BASEMENT
Z2	FIRE ALARM ZONE 2 - LEVEL 1
Z3	FIRE ALARM ZONE 3 - ATTIC
Z4	SPRINKLER SYSTEM SUPERVISED VALVE
Z5	SPRINKLER FLOW SWITCH
Z6	SPRINKLER PRESSURE SWITCH

NOTE: REFER TO ARCHITECTURAL DRAWINGS FOR PHASING INFORMATION

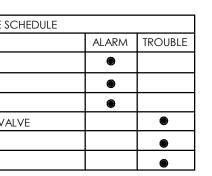

10ISSUED FOR TENDER2025-02-259RE-ISSUED FOR TORONTO2025-02-249HYDRO2024-02-205RE-ISSUED FOR COSTING2024-02-204RE-ISSUED FOR PERMIT2024-02-203ISSUED FOR COSTING2024-01-311ISSUED FOR PERMIT2024-01-05Rev.#DescriptionDate



Seals

375 COLBORNE LODGE DR, TORONTO, ON M6R 2Z3


HIGH PARK NATURE AND VISITOR'S CENTER

Drawing Name: FIRE ALARM RISER DIAGRAM


Project Number:22-142Drawing Scale:As IndicatedDate:2025-02-25File Name:Drawn By:Drawn By:M.Z.Reviewed By:N.A.Drawing No.:





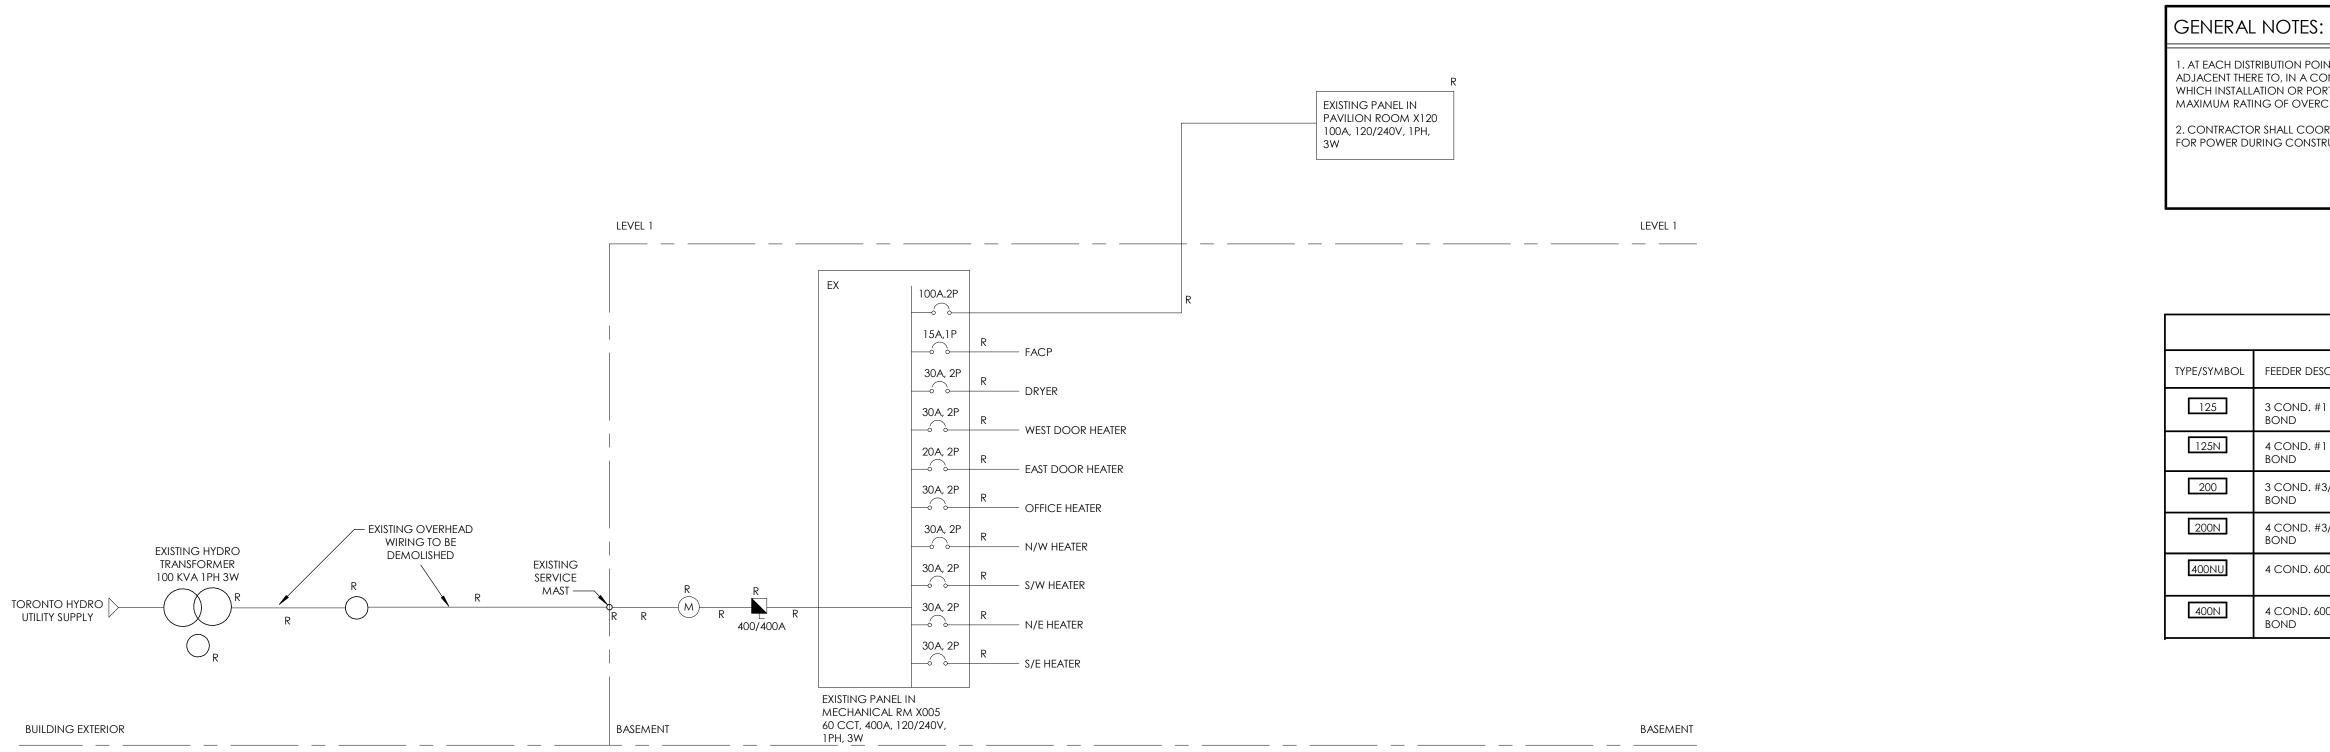

1 SINGLE LINE DIAGRAM DEMOLITION N.T.S.

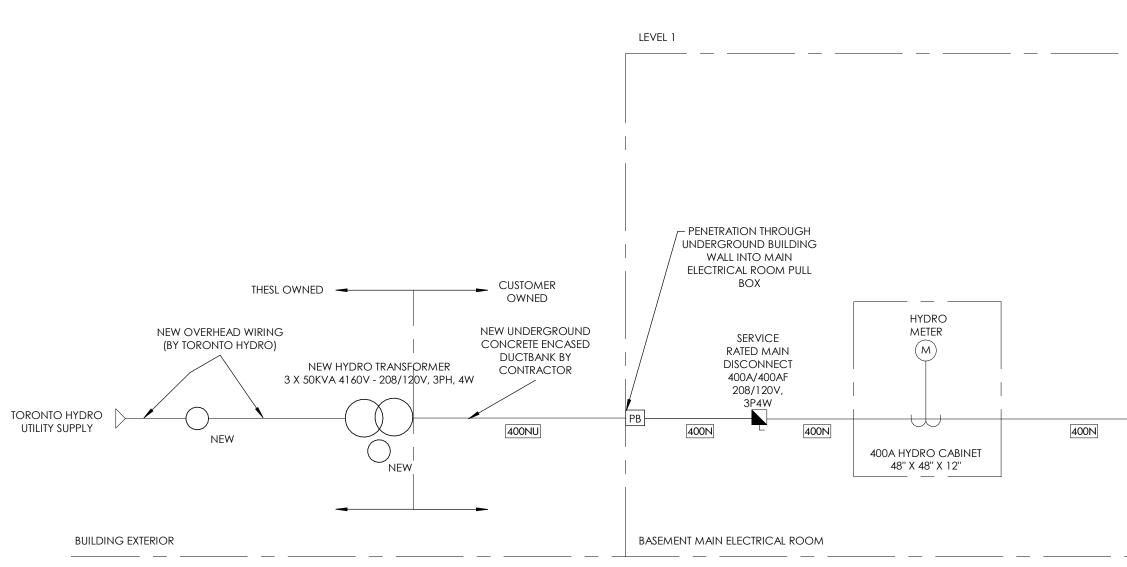

2 E4.00 N.T.S.

ATTIC AND LEVEL 1 LIGHTING & RECEPTACLES ATTIC AND LEVEL 1 MECHANICAL LOADS LEVEL 1 \_\_\_\_\_ • ٠ • BASEMENT MECHANICAL LOADS \_\_\_\_\_ - BASEMENT LIGHTING & RECEPTACLES 200A3P 200N \_\_\_\_\_ 15A1P DISC-ELEV-LIGHTS 15A/15AF 120V, 1P 30A3P DISC-ELEV-MOTOR \_\_\_\_\_ 60A/30AF └ 208V, 3P NEW PANEL 2-LP-1 IN ELECTRICAL RM 004 PROPOSED PANEL 2P-1 IN ELECTRICAL RM 004 60 CCT, 400A, 120/208V, 3PH, 4W 84 CCT, 600A, 120/208V, 3PH, 4W BASEMENT MAIN ELECTRICAL ROOM REVIEW ALL DRAWINGS AND VERIFY ALL DIMENSIONS AT THE SITE. DO NOT SCALE THE DRAWINGS. REPORT ALL DISCREPANCIES TO THE ENGINEER BEFORE PROCEEDING WITH ANY CONSTRUCTION OR SHOP FABRICATION. ALL DRAWINGS, SPECIFICATIONS AND RELATED DOCUMENTS ARE THE COPYRIGHT PROPERTY OF 'MANTECON PARTNERS' AND MUST BE RETURNED UPON REQUEST. REPRODUCTION OF DRAWINGS, SPECIFICATIONS AND RELATED DOCUMENTS IN PART OR WHOLE IS FORBIDDEN WITHOUT THE ENGINEER'S WRITTEN PERMISSION.

#### NOTE: REFER TO ARCHITECTURAL DRAWINGS FOR PHASING INFORMATION

1. AT EACH DISTRIBUTION POINT, CIRCUIT BREAKERS, FUSES AND SWITCHES SHALL BE MARKED ADJACENT THERE TO, IN A CONSPICUOUS AND LEGIBLE MANNER TO INDICATE CLEARLY WHICH INSTALLATION OR PORTION OF INSTALLATION THEY PROTECT OR CONTROL AND THE MAXIMUM RATING OF OVERCURRENT DEVICE THAT IS PERMITTED AS PER OESC. 2. CONTRACTOR SHALL COORDINATE WITH TORONTO HYDRO FOR A TEMPORARY SERVICE

FOR POWER DURING CONSTRUCTION.

WIRE AND CONDUIT SCHEDULE									
FEEDER DESCRIPTION	CONDUIT DESCRIPTION								
3 COND. #1 AWG R90 CU + #6 BOND	IN 1-1/2" EMT CONDUIT								
4 COND. #1 AWG R90 CU + #6 BOND	IN 2" EMT CONDUIT								
3 COND. #3/0 AWG R90 CU + #4 BOND	IN 2" EMT CONDUIT								
4 COND. #3/0 AWG R90 CU + #4 BOND	IN 2-1/2" EMT CONDUIT								
4 COND. 600 MCM AWG RWU90 CU	IN 4" CONDUIT WITH 1X(ONE) SPARE 4" CIRCUIT, CONCRETE ENCASED								
4 COND. 600 MCM R90 CU + #2 BOND	IN 3-1/2" EMT CONDUIT								

10	ISSUED FOR TENDER	2025-02-25							
9	RE-ISSUED FOR TORONTO HYDRO	2025-02-24							
8	RE-ISSUED FOR TORONTO HYDRO	2024-12-19							
7	RE-ISSUED FOR TORONTO HYDRO	2024-10-18							
6	ISSUED FOR TORONTO HYDRO	2024-08-12							
5	RE-ISSUED FOR COSTING	2024-02-20							
4	RE-ISSUED FOR PERMIT	2024-02-20							
3	ISSUED FOR COSTING	2024-02-08							
2	ISSUED FOR PERMIT	2024-01-31							
1	ISSUED FOR COORDINATION	2024-01-05							
Rev.#	Description	Date							
Consultants									



Seals

\_\_\_\_

375 COLBORNE LODGE DR, TORONTO, ON M6R 2Z3


#### HIGH PARK NATURE AND **VISITOR'S CENTER**

Drawing Name: SINGLE LINE DIAGRAM


Project Number: 22-142 Drawing Scale: As Indicated Date: 2025-02-25 File Name: Drawn By: M.Z. N.A. Reviewed By: Drawing No.:






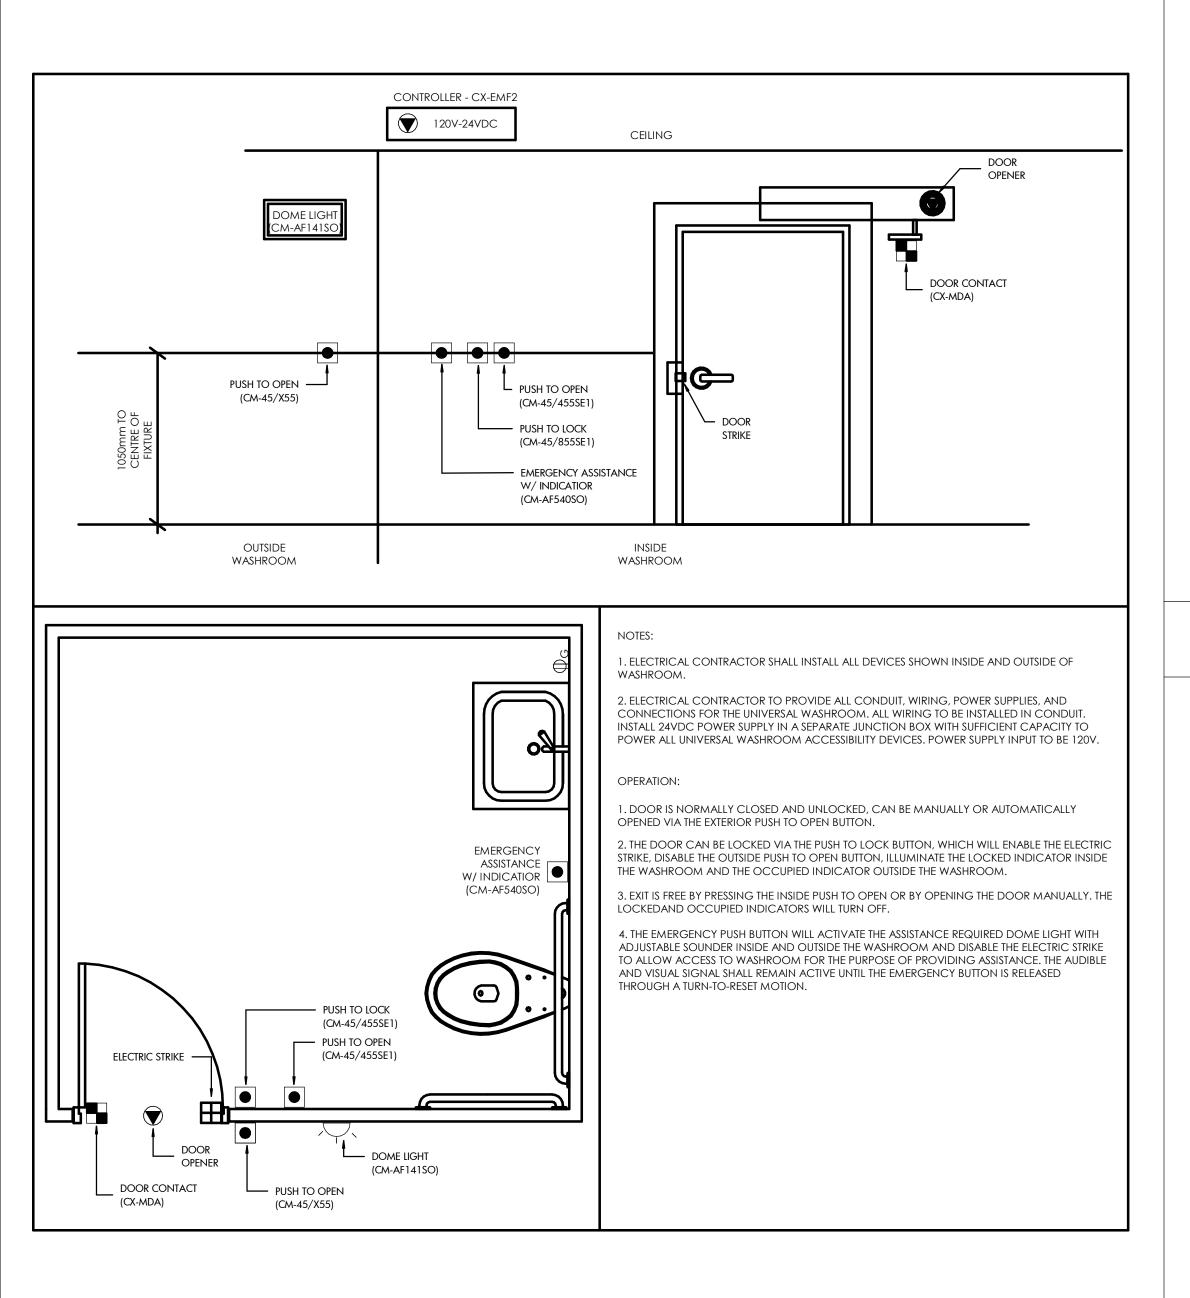


# 1 UNIVERSAL WASHROOM TYPICAL DETAIL E5.00 N.T.S.

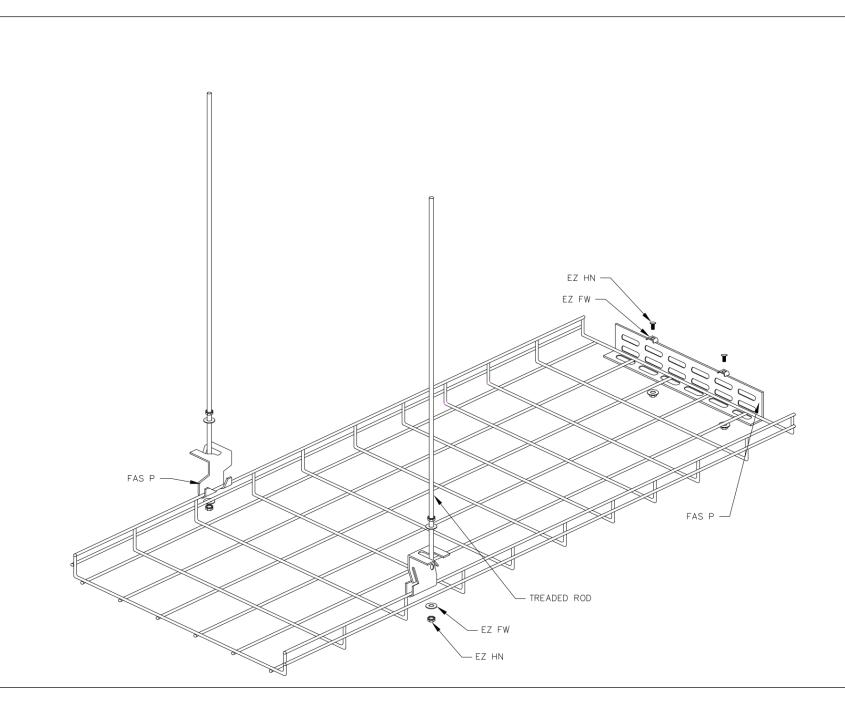

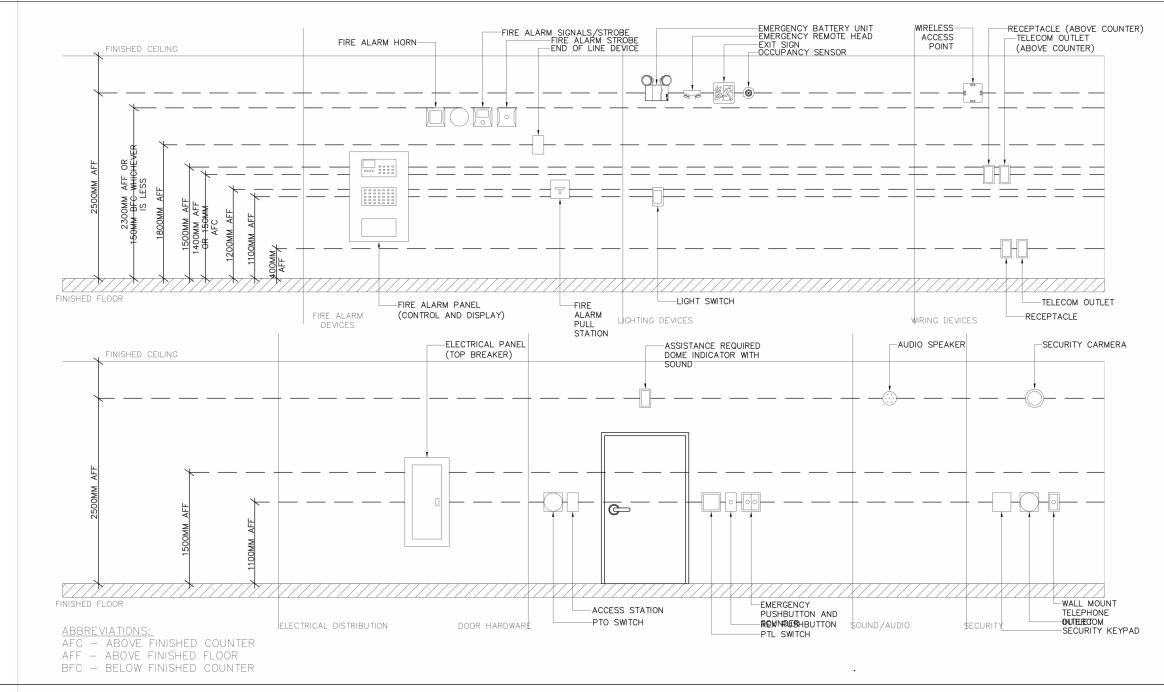


# 2 ELECTRICAL STANDARD WALL MOUNTING HEIGHT DETAIL N.T.S.

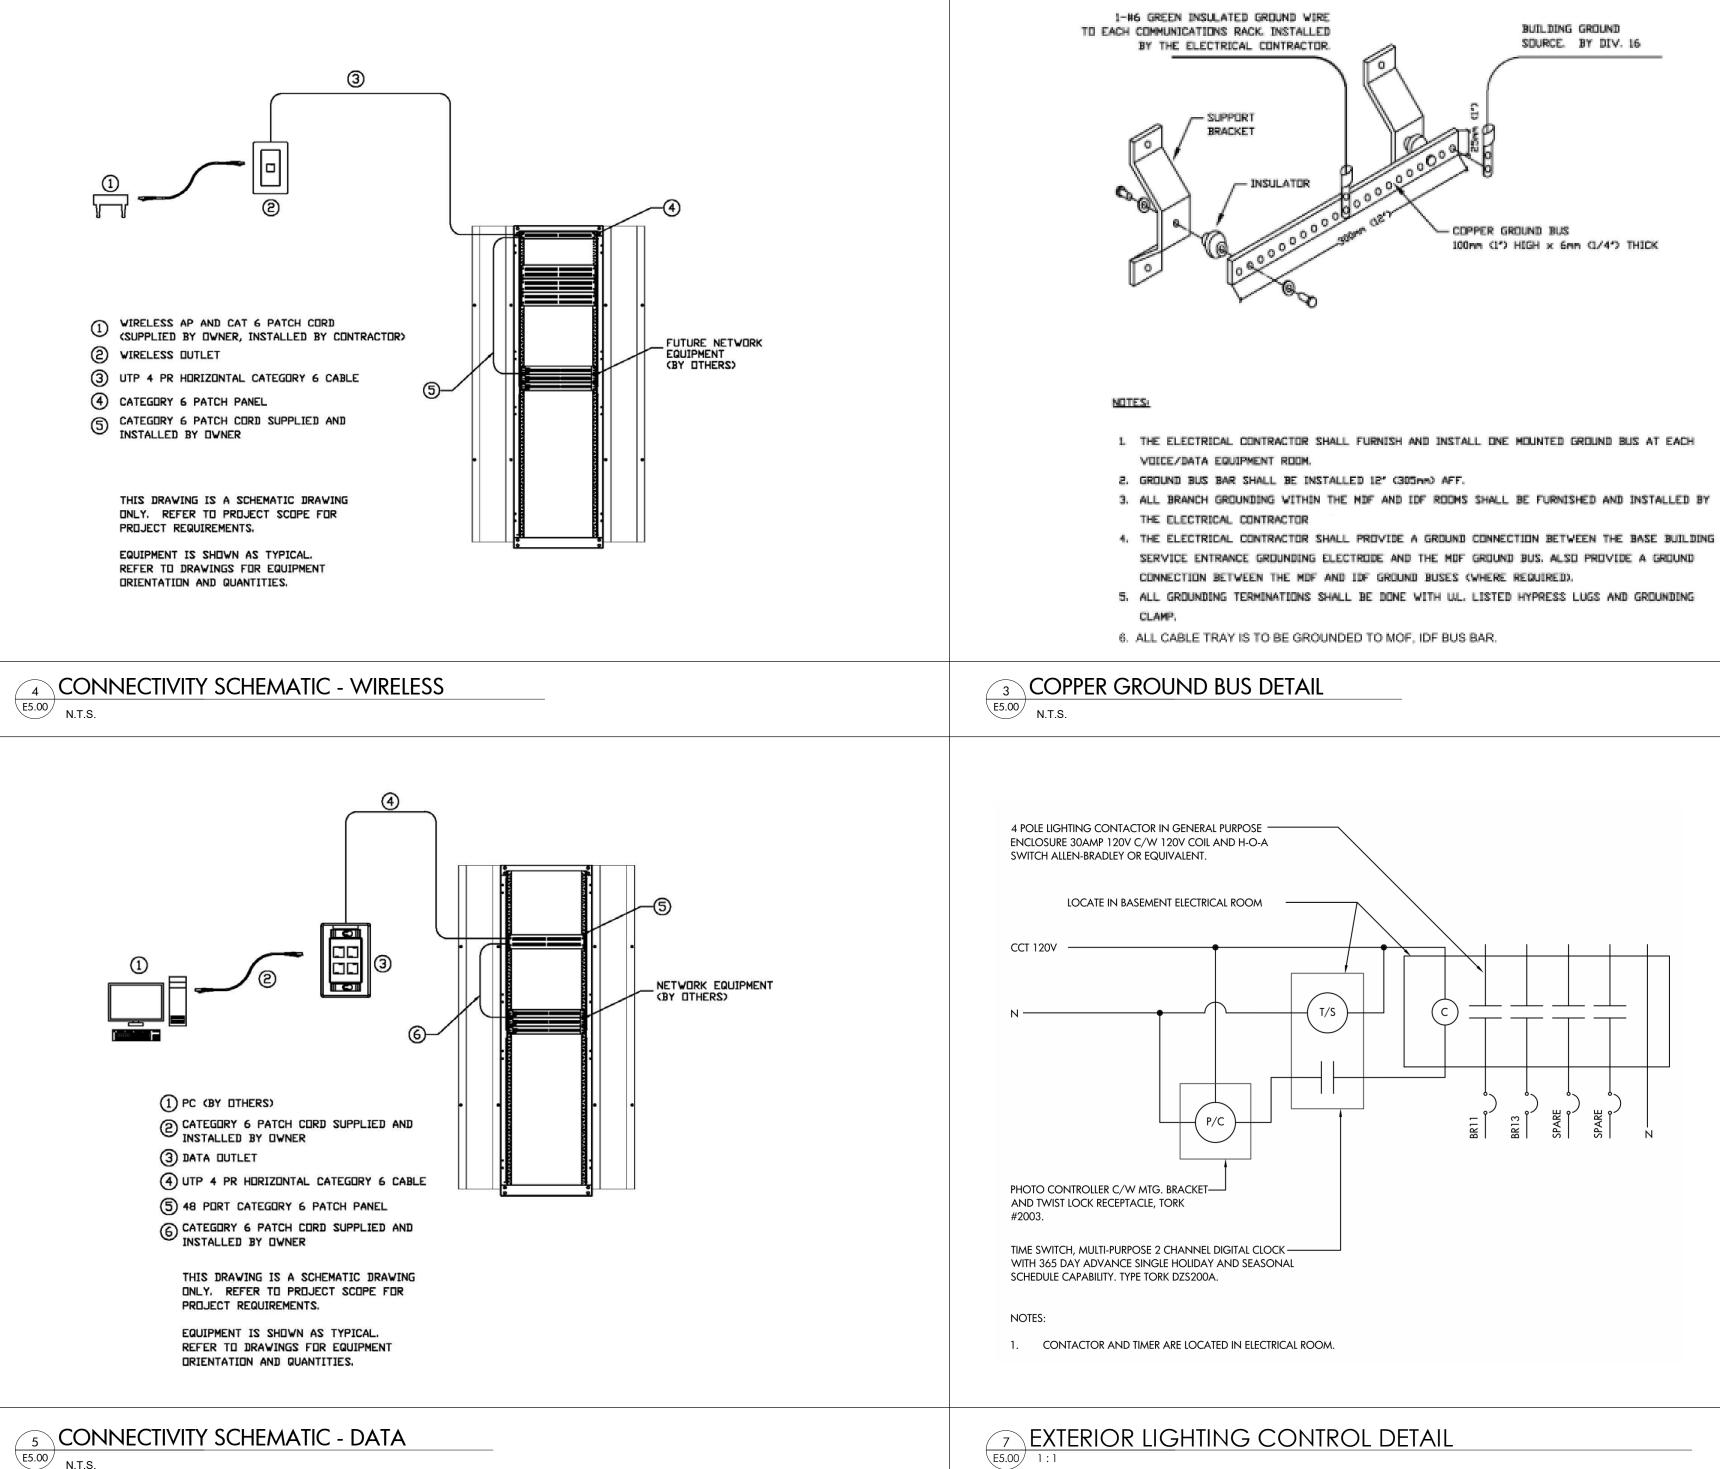





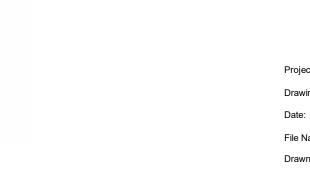

Project Number: 22-142 File Name: Drawn By: M.Z Reviewed By: N.A.

Drawing No.:

Drawing Name:

10 ISSUED FOR TENDER

HYDRO

Rev.# Description

5

Consultants

Seals

**RE-ISSUED FOR TORONTO** 

ISSUED FOR COORDINATION 2024-01-05

MANTECON

STRUCTURAL MECHANICAL PROCESS ELECTRICAL CIVIL ENGINEERS AND PROJECT MANAGERS

15 Foundry Street, Dundas, ON, L9H 2V6

Phone: (905)648-0373 www.manteconpartners.com

RE-ISSUED FOR COSTING

RE-ISSUED FOR PERMIT

ISSUED FOR COSTING

ISSUED FOR PERMIT

2025-02-25

2025-02-24

2024-02-20

2024-02-20

2024-02-08

2024-01-31

ELECTRICAL DETAILS

Drawing Scale: As Indicated 2025-02-25

375 COLBORNE LODGE DR, TORONTO, ON M6R 2Z3

HIGH PARK NATURE AND

**VISITOR'S CENTER** 






100nn (1') HIGH x 6nn (1/4') THICK


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## NOTE: REFER TO ARCHITECTURAL DRAWINGS FOR PHASING INFORMATION

				CLEARANCES AS PER C (EDGE TO EDGE)						
		Utilities or	Plant			tical (feet)	Horizo mm (fe			
		He	avv R	ail (CN/CP/GO)			TD. 31-1310	<i>.</i> ,		
Railwa	ys			TC/LRT/Metrolinx)			TD. 31-1200			
Hydro C	)ne			nfrastructure		(3'-4")	1000 (3	'-4")		
119410 0				Manholes		(3'-4")	1000 (3	,		
		Bell	Co	oncrete Encased Ducts		(2'-0")	600 (2'			
Communio	cation	Canada		Direct Buried Ducts		<u>1'-0")</u>	600 (2'	,		
		Others		All Infrastructure		(1'-0")	600 (2'			
Enwave E	norav		Ste	eam Pipes		(2'-0")	600 (2'	,		
Corpora	•••			d Water Pipes		<u>1'-0")</u>	300 (1'	,		
				n (12") (Open Trench)		(1'-0")	600 (2'	,		
Enbridge National E			ated F	Pipelines and Vital Mains en Trench)		(2'-0")	1000 (3			
Board		ALL Pipeli	nes D	irectional Drilling/Boring	1000	(3'-4")	1000 (3	'-4")		
			Regu	lator Stations	Consult	with City	1000 (3	1000 (3'-4")		
				Trees	See	Note 1 a	nd Std. 31-040	d Std. 31-0400		
			Ca	tch Basins	Consult	with City	500 (1'	500 (1'-8")		
		-	Traffic	: Signal Ducts	300 (	(1'-0")	600 (2'	600 (2'-0")		
				< 150 (6") Dia.	150	(6")	600 (2'	600 (2'-0")		
		Storm	15	0 (6") < 750 (2'-6") Dia.	300 (	(1'-0")	750 (2'	-6")		
		Sewer		≥ 750 (2'-6") Dia.	500 (	(1'-8")	900 (3'	-0")		
				Maintenance Hole		-	600 (2'	600 (2'-0")		
City of To	ronto			< 100 (4") Dia.	150	(6")	600 (2'	600 (2'-0")		
City of To	TONIO	Sanitary/	100 (4") < 375 (1'-3") Dia.		300 (1'-0")		750 (2'	750 (2'-6")		
		Combined Sewer		≥ 375 (1'-3") Dia.	500 (	(1'-8")	900 (3'	-0")		
				Maintenance Hole		-	600 (2'	600 (2'-0")		
				< 100 (4") Dia.	150	(6")	600 (2'	600 (2'-0")		
			≥ 10	00 (4") < 400 (1'-4") Dia.	300 (	(1'-0")	750 (2'	750 (2'-6")		
		Water Mains		≥ 400 (1'-4") Dia.	500 (	(1'-8")	900 (3'	900 (3'-0")		
			V	Vater Valve Chamber	See N	Note 5	600 (2'	-0")		
				Fire Hydrant	400 (	[1'-4")	1500 (4'	-11")		
Toronto	ludro			(Direct Buried)	See St		400, 04-4100 5100	and		
Toronto H (This to be us				lounted Poles/ d Sidewalk Bays		See	Note 3			
other Utilitie	es are eir plant	Cable (	Cham	ber/Vault/Tap Boxes g Outside Structures)		-	600 (2'	-0")		
close to Th infrastruc		Padmou	unts/S Inding	ub Vaults/Splice Vaults Outside Structure)			TD. 31-4100			
			Ducts	s/Duct Banks	300 (	(1'-0")	600 (2'	-0")		
	CONSTRU /il Constru Approved b		RD	UNDERGR			ANCES			
TORONTO				Original issue	Orali					
HYDRO	Drafted by: J.D.	Designed b B.D.	y:	Original issue: J.D. 2000-12-28	Scale: N.T.S.	Rev. 9	31-0100 1/			

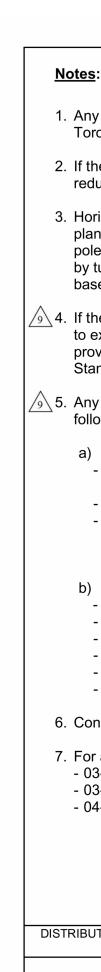


# 1 TORONTO HYDRO 31-0100

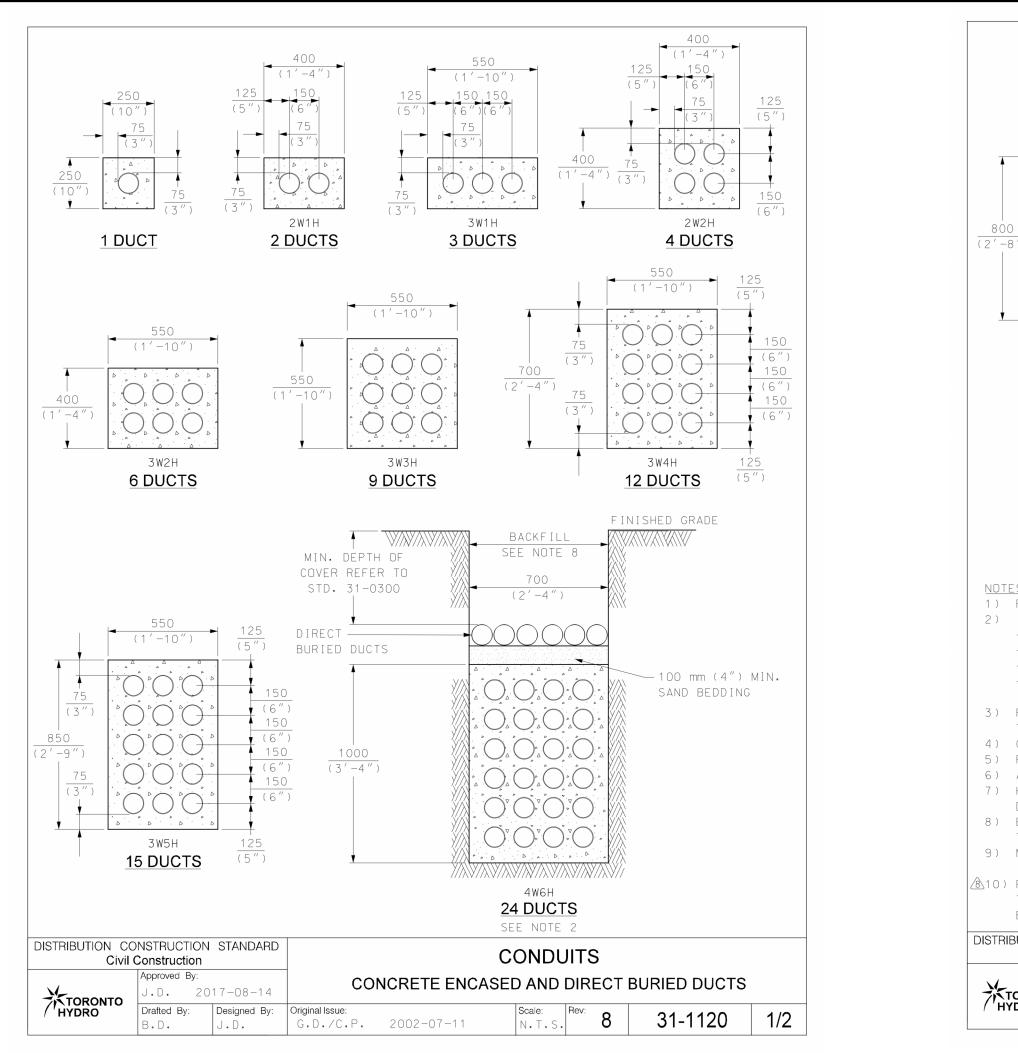


<u>Notes</u> :			
		ty of trees shall be carried out in compliance with latest City of d Specification for Construction Near Trees" document.	
	nimum clearances shown ca clearances.	nnot be met, the subject utilities approval may be obtained for	
plant. Co	ontractor shall at no time cut	dge of reinforced sidewalk bay or pole base to edge of proposed into reinforced sidewalk bays and pole bases. Sidewalk bays and for the pole. Plant can be installed under reinforced sidewalk bays	
		learance of 600 mm (2'-0"). Plant shall not be installed under pole	CONDUIT
to existir providing	ng field conditions, clearance	for utilities installing plant close to THESL plant cannot be met due e can be reduced to 300mm (1'-0") with the Contractor/Customer d clearance. Approvals can be provided by Toronto Hydro clearance.	
	posed horizontal clearance log supporting documentation:	ess than 300 mm (1'-0") will require an ESA deviation with the	THE "MINIMUM DEPTH OF COVER" As follows:
- Tha well - The - Tha ider	t the Contractor/Customer is as any damages and assoc method of protection and/or t this is a unique scenario th tify that the deviation is also	a Professional Engineer of Ontario, outlining: a responsible for all costs associated with support and inspection, as biated costs; r support. Support is required if Toronto Hydro plant is undermined; at requires a deviation from typical construction standard, and o from the typical clearances set out by Toronto Hydro and the City	TYPE
b) Drav - Star - Len - Met	gth of the plant being suppo	port system in both plan and section views;	CURBED RDADS
- Defl - Bac 6. Contact 7. For aboy	ection monitoring system pla kfilling procedures. the City of Toronto for minin ve grade clearance refer to:	acement if soil settlement will occur on site; num vertical clearance to water valve chamber.	UNCURBED ROADS
- 03-240	0 Building and Permanent S 0 Poles and Private Fences 0 Pole Location Guidelines		BOULEVARDS
			NOTES: 1) THE DEPTHS OF COVER ARE IN ACCOR 2) THE DEPTHS OF COVER APPLY TO ALL
	CONSTRUCTION STANDARD vil Construction Approved by:	UNDERGROUND CLEARANCES	DISTRIBUTION CONSTRUCTION STANDARD Civil Construction
HYDRO	Drafted by: Designed by: J.D. B.D.	Original issue:         Scale:         Rev.         9         31-0100         2/2           J.D. 2000-12-28         N.T.S.         9         31-0100         2/2	TORONTOB.D. 2018-08-29Drafted By:Designed By:OriginM.D.B.D.J.E
			2 TORONTO HYDRO 31-03
(2 -8 ) 	$\begin{array}{c} 700 \\ (2'-4'') \\ \hline 125 \\ (5'') \\ \hline \\ \\ 150 \\ (5'') \\ \hline \\ \\ \\ \\ \\ \\ \\ \\ \\ \\ \\ \\ \\ \\ \\ \\ \\ $	TORONTO (3")(TYP.) HYDRO	SIDEWALK GRADE OR BOULEVARD MIN. DEPTH OF COVER REFER TO STD. 31-0300
			NOTE: THIS ALSO AF
2) IN / - I - I IF N 3) REIN (4) CON( 5) REIN 6) ALL 7) HOR DUC 8) EXC/ TORI 9) MAX IN / (❀10) RED THIS BE I DISTRIBUTIC	DUCTS ARE CARRYING PRIMA DUCTS ARE UNDER ROADWAY DUCT HAVE 90 DEGREE BEND THE NUMBER OF DUCTS ARE NONE OF THE ABOVE CATEGO NFORCED DUCT BANK SHALL LE. CRETE SHALL BE A MIN. 20 NFORCING SHALL CONFORM T DUCTS SHALL BE 100 mm ( IZONTAL AND VERTICAL SEP T SPACERS. AVATION SHALL BE BACKFILLIN NUMBER OF DIRECT BURIE A MAX. OF TWO ROWS. DUCT SHALL BE USED IN A S INCLUDES ELECTRICAL CA JSED FOR COMMUNICATION C N CONSTRUCTION STANDARD Civil Construction	SEE NOTES 2, 9 and 10 MIN. DEPTH OF COVER. TION, ENCASE THE DUCTS IN CONCRETE IF: RY CABLES (750 V OR MORE), OR DRIVEWAY, DS, MORE THAN 8. DRY APPLIES, THEN THE DUCTS SHALL BE DIRECT BURIED. BE USED ONLY IN POOR SOIL CONDITIONS OR WHERE THERE IS HIGH WATER O MPG, WITH 10 mm ( <sup>3</sup> <sub>8</sub> ") AGGREGATES. TO CSA STANDARD G30.18-09, Fy = 400 MPG. 4") IN DIAMETER UNLESS NOTED OTHERWISE. PARATION BETWEEN DUCTS IS CONTROLLED DURING CONSTRUCTION BY PLASTIC LED TO GRADE AS PER SPECIFICATION #CV-CON-01 CLAUSE 5.1.17 AND/OR IG REQUIREMENT. DD DUCTS SHALL BE 8. DUCTS MAY BE PLACED IN AN IRREGULAR FORMATION ALL NEW AND REBUILD UNDERGROUND DIRECT BURIED INSTALLATIONS. BELES AND COMMUNICATION CABLES. IF REQUIRED, 50 mm (2") DUCT CAN	PLACE 10 mm STEEL         PLATE WITH YELLOW         WARNING TAPE ON TOP         OF THE PLATE         MIN. DEPTH OF         COVER REFER TO         STD. 31-0300         JUCT BANK         DETAIL "E         REDUCED DEPTH OF         COVER MAY BE USED WITH CITY'S APP         2) IF MINIMUM DEPTH OF COVER IS REDU         PROVIDED AS SHOWN IN DETAIL "B".         DISTRIBUTION CONSTRUCTION STANDARD         Civil Construction         Approved By:
TOROI HYDRO		CONCRETE ENCASED AND DIRECT BURIED DUCTS       Original Issue:       G.D./C.P.     2002-07-11       Scale:     Rev:     8     31-1120     2/2	HYDRO HYDRO
L			B.D. B.D. G.E


4 TORONTO HYDRO 31-1150 1:10

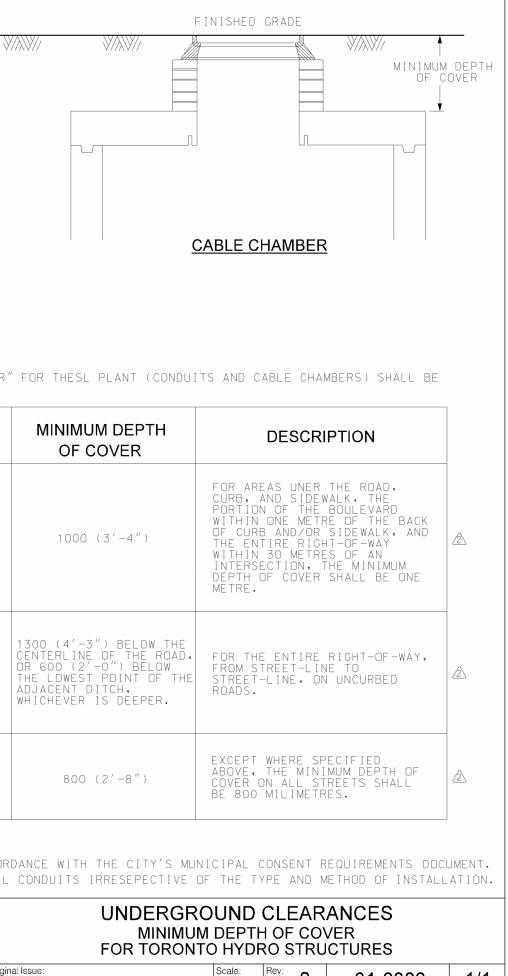



## 300

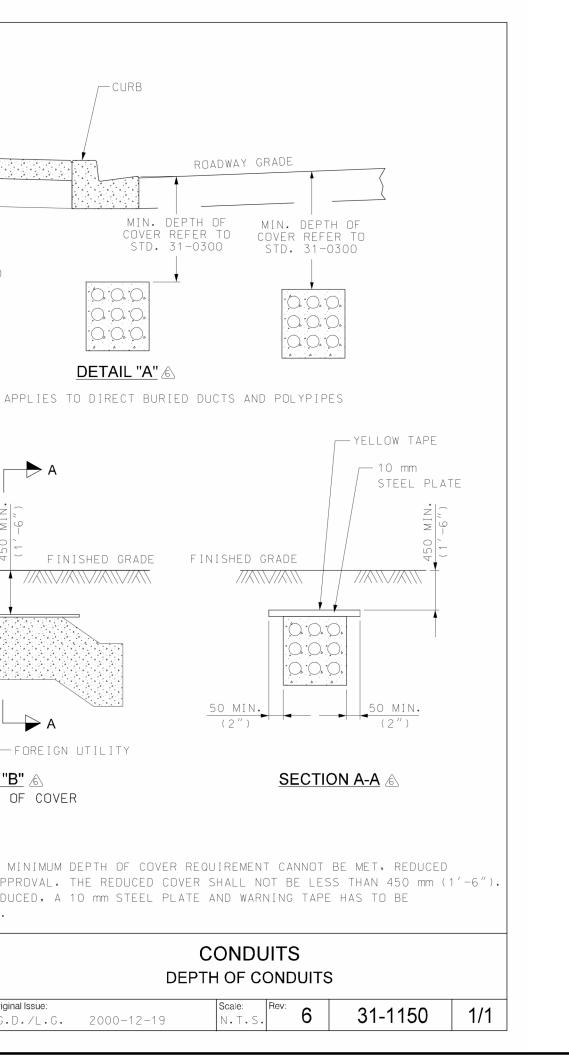

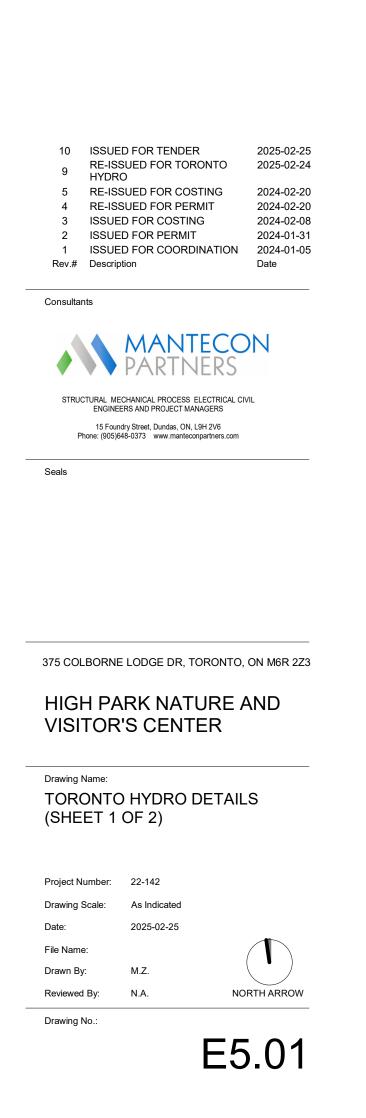

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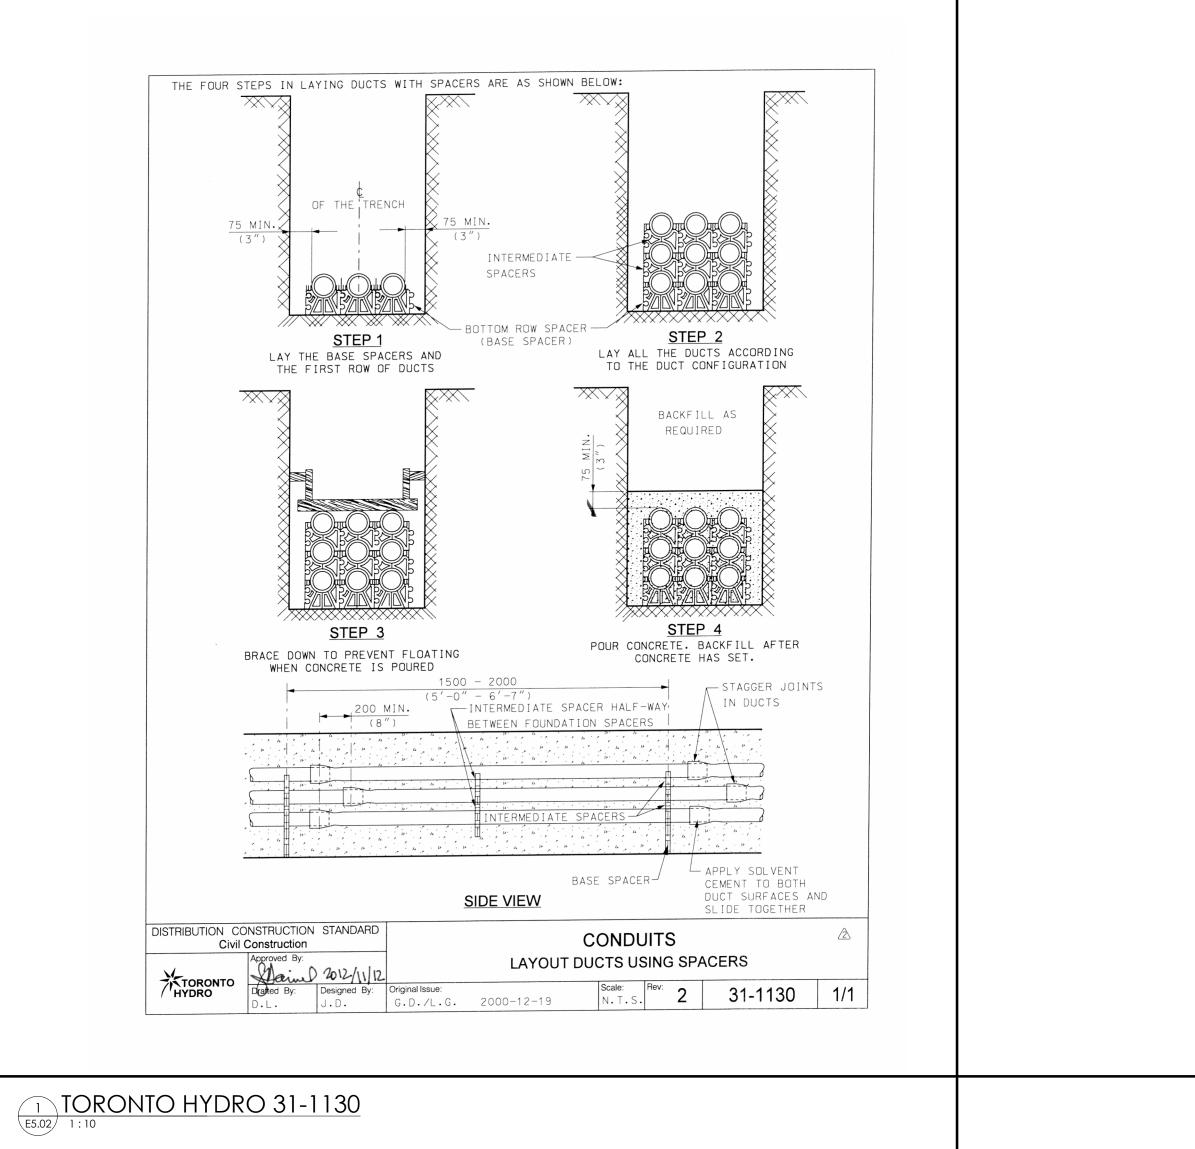
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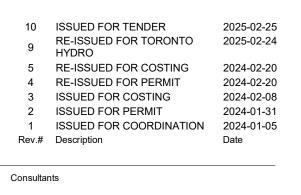
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NOTE: REFER TO ARCHITECTURAL



NOTE: REFER TO ARCHITECTURAL DRAWINGS FOR PHASING INFORMATION





Seals

375 COLBORNE LODGE DR, TORONTO, ON M6R 2Z3

#### HIGH PARK NATURE AND VISITOR'S CENTER

Drawing Name: TORONTO HYDRO DETAILS (SHEET 2 OF 2)

 Project Number:
 22-142

 Drawing Scale:
 As Indicated

 Date:
 2025-02-25

 File Name:
 Image: Comparison of the second second



# Branch Panel: 2P-1

Location: ELECTRICAL 004 Supply From: Mounting: Surface Enclosure: Type 2

Volts: 120/208 Wye Phases: 3 Wires: 4

A.I.C. Rating: 18kAIC FULLY RATED MINIMUM Mains Type: MLO Mains Rating: 400 A MCB Rating: 400 A

Notes:

Wire Size	CKT Circuit Description	Trip	Poles	A			3		c	Poles	Trip	Circuit Description	скт	Wire Size
12AWG R90 CU #12 BOND IN	1 RP-1	15 A	1		327 VA								2	#12AWG R90 CU
12AWG R90 CU	3					195 VA	327 VA			2	15 A	CMB-1, CMB-2	4	+ #12 BOND IN 3/4" EMT
+ #12 BOND IN 3/4" EMT	P-3	15 A	2					195 VA	708 VA				6	#12AWG R90 CU
12AWG R90 CU + #12 BOND IN	7 GFS-1	20 A	1	180 VA	708 VA					2	15 A	FC-11, FC-12, FC-13	8	+ #12 BOND IN 3/4" EMT
#12AWG R90 CU	9					432 VA	750 VA						10	#12AWG R90 CU
+ #12 BOND IN 3/4" EMT	ERV-2	15 A	2					432 VA	750 VA	2	20 A	EH-2	12	+ #12 BOND IN 3/4" EMT
#12AWG R90 CU	13			750 VA	0 VA					1	15 A	SPARE	14	
+ #12 BOND IN 3/4" EMT	EH-1	15 A	2			750 VA	1000 VA						16	#12AWG R90 CU
#12AWG R90 CU	17							884 VA	1000 VA	2	15 A	EH-10	18	+ #12 BOND IN 3/4" EMT
+ #12 BOND IN 3/4" EMT	FC-01, FC-02	15 A	2	884 VA	7776 VA								20	
#12AWG R90 CU	21 SUMP PUMP RECEPTACLE 1	15 A	1				8107 VA			3	200 A	2-I P-1	22	#3/0AWG R90 CU+ #4BOND IN
+ #12 BOND IN	23							955 \/A	8102 VA	Ū	2007		24	2.5" EMT
#12AWG R90 CU + #12 BOND IN 3/4" EMT	EC-06, FC-07, FC-08, FC-09, FC-10	15 A	2	955 VA	23 VA			333 VA	0102 VA	1	15 A	ELEVATOR PIT LIGHT		#12AWG R90 CU
				955 VA	23 VA	2000 \/A	2000.1/4				15 A			+ #12 BOND IN
#12AWG R90 CU + #12 BOND IN 3/4" EMT	27 EH-9	15 A	2			2000 VA	2000 VA	0.1/4	0.1/0	2	15 A	RP-1		#12AWG R90 CU + #12 BOND IN 3/4" EMT
	29				4000.144			0 VA	0 VA				30	
#12AWG R90 CU + #12 BOND IN 3/4" EMT	31 FC-03, FC-04, FC-05	15 A	2	1041 VA	1000 VA					2	15 A	EH-6		#12AWG R90 CU + #12 BOND IN 3/4" EMT
0,1 2.001	33					1041 VA	1000 VA						34	
#12AWG R90 CU + #12 BOND IN 3/4" EMT	35 ERV-1	15 A	2					1080 VA	2600 VA	2	20 A	DWH-1		#12AWG R90 CU + #12 BOND IN 3/4" EMT
3/4 EIVIT	37			1080 VA	2600 VA								38	3/4 EIVIT
	39 SPARE	15 A	1			0 VA	1000 VA			2	15 A	EH-7	40	#12AWG R90 CU + #12 BOND IN
#12AWG R90 CU + #12 BOND IN	41 SUMP PUMP RECEPTACLE 2	15 A	1					180 VA	1000 VA				42	3/4" EMT
#12AWG R90 CU + #12 BOND IN	43 EH-3	15 A	2	1000 VA	0 VA					1	15 A	SPARE	44	
3/4" EMT	45					1000 VA	1000 VA			2	15 A	EH-4	46	#12AWG R90 CU + #12 BOND IN
#12AWG R90 CU + #12 BOND IN	47 EH-8	15 A	2					1000 VA	1000 VA				48	3/4" EMT
3/4" EMT	49			1000 VA	1000 VA					2	15 A	EH-11	50	#12AWG R90 CU + #12 BOND IN
	51 SPARE	15 A	1			0 VA	1000 VA			-	1077		52	3/4" EMT
#12AWG R90 CU + #12 BOND IN	53 EH-5	15 A	2					1000 VA	1000 VA	2	15 A	EH-13	54	#12AWG R90 CU + #12 BOND IN
3/4" EMT	55		2	1000 VA	1000 VA					2	13 A		56	3/4" EMT
#12AWG R90 CU	57	45.0	0			1000 VA	1167 VA						58	
+ #12 BOND IN 3/4" EMT	EH-12	15 A	2					1000 VA	1167 VA	3	20 A	P-1	60	#12AWG R90 CU + #12 BOND IN 3/4" EMT
	61			1167 VA	1167 VA								62	O, I LIII
#12AWG R90 CU + #12 BOND IN 3/4" EMT	63 P-2	20 A	3			1167 VA	4000 VA						64	
3/4 EIVIT	65							1167 VA	4000 VA	3	45 A	DH-1		#8AWG R90 CU + #10 BOND IN 3/4' EMT
	67			4203 VA	4000 VA								68	
#6AWG R90 CU + #8 BOND IN 1"	69 HP-1	60 A	3			4203 VA	4203 VA						70	
EMT	71							4203 VA	4203 VA	3	60 A	HP-2	72	#6AWG R90 CU + #8 BOND IN 1"
	73			1387 VA	4203 VA								74	EMT
#10AWG R90 CU+ #10BOND IN		30 A	3			1387 VA	180 VA			1	15 A	ELEVATOR CAB LIGHTS DISCONNECT	76	#12AWG R90 CU + #12 BOND IN
3/4" EMT	77							1387 VA					78	
	79												80	
	81												82	
	83					3883	0.1/1	0.0.5					84	
			tal Load:	3841	o va	, <u>, , , , , , , , , , , , , , , , , , </u>			'8 VA			1		

Notes:

# Branch Panel: 2-LP-1

Location: ELECTRICAL 004 Supply Fi2L-1 2P-1 Mounting: Surface Enclosure: Type 2

Volts: 120/208 Wye Phases: 3 Wires: 4

Notes:

Wire Size	скт	Circuit Description	Trip	Poles		<b>A</b>	E	3	(	2	Poles	Trip	Circuit Description	скт	Wire Size
#12AWG R90 CU + #12 BOND IN	1	SITE LIGHTING	15 A	1	0 VA	184 VA					1	15 A	LIGHTING	2	#12AWG R90 CU + #12 BOND IN
#12AWG R90 CU + #12 BOND IN	3	SECURITY PANEL	15 A	1			200 VA	322 VA			1	15 A	LIGHTING	4	#12AWG R90 CU + #12 BOND IN
#12AWG R90 CU + #12 BOND IN	5	BU1 AND EXIT SIGN	15 A	1					235 VA	360 VA	1	15 A	RECEPTACLE	6	#12AWG R90 CU + #12 BOND IN
#12AWG R90 CU + #12 BOND IN	7	BU2 AND EXIT SIGN	15 A	1	255 VA	368 VA					1	15 A	LIGHTING	8	#12AWG R90 CU + #12 BOND IN
#12AWG R90 CU + #12 BOND IN	9	LIGHTING	15 A	1			690 VA	506 VA			1	15 A	LIGHTING	10	#12AWG R90 CU + #12 BOND IN
#12AWG R90 CU + #12 BOND IN	11	BU3 AND EXIT SIGN	15 A	1					405 VA	1260 VA	1	15 A	RECEPTACLE	12	#12AWG R90 CU + #12 BOND IN
#12AWG R90 CU + #12 BOND IN	13	LIGHTING	15 A	1	644 VA	690 VA					1	15 A	LIGHTING	14	#12AWG R90 CU + #12 BOND IN
#12AWG R90 CU + #12 BOND IN	15	LIGHTING	15 A	1			529 VA	600 VA			1	15 A	RH-1	16	#12AWG R90 CU + #12 BOND IN
#12AWG R90 CU + #12 BOND IN	17	RECEPTACLE	15 A	1					1260 VA	69 VA	1	15 A	SITE LIGHTING	18	#12AWG R90 CU + #12 BOND IN
#12AWG R90 CU + #12 BOND IN	19	ADO [LEVEL 1 EAST]	15 A	1	720 VA	720 VA					1	15 A	RECEPTACLE	20	#12AWG R90 CU + #12 BOND IN
#12AWG R90 CU + #12 BOND IN	21	ADO [LEVEL 1 WEST]	15 A	1			1080 VA	69 VA			1	15 A	LIGHTING	22	#12AWG R90 CU + #12 BOND IN
#12AWG R90 CU + #12 BOND IN	23	RECEPTACLE	15 A	1					180 VA	180 VA	1	15 A	RECEPTACLE	24	#12AWG R90 CU + #12 BOND IN
#12AWG R90 CU + #12 BOND IN	25	LIGHTING	15 A	1	69 VA	180 VA					1	15 A	RECEPTACLE	26	#12AWG R90 CU + #12 BOND IN
#12AWG R90 CU + #12 BOND IN	27	RECEPTACLE	15 A	1			180 VA	180 VA			1	15 A	RECEPTACLE	28	#12AWG R90 CU + #12 BOND IN
#12AWG R90 CU + #12 BOND IN	29	RECEPTACLE	15 A	1					180 VA	180 VA	1	15 A	RECEPTACLE	30	#12AWG R90 CU + #12 BOND IN
#12AWG R90 CU + #12 BOND IN	31	RECEPTACLE	15 A	1	180 VA	180 VA					1	15 A	IT ROOM RECEPTACLES	32	#12AWG R90 CU + #12 BOND IN
#12AWG R90 CU + #12 BOND IN	33	IT ROOM RECEPTACLES	20 A	1			180 VA	180 VA			1	20 A	EXTERIOR RECEPTACLE	34	#12AWG R90 CU + #12 BOND IN
#12AWG R90 CU + #12 BOND IN	35	RECEPTACLE	15 A	1					540 VA	900 VA	1	15 A	RECEPTACLE	36	#12AWG R90 CU + #12 BOND IN
#12AWG R90 CU + #12 BOND IN	37	ELEVATOR PIT RECEPTACLE	20 A	1	180 VA	540 VA					1	15 A	ADO [BASEMENT]	38	#12AWG R90 CU + #12 BOND IN
#12AWG R90 CU + #12 BOND IN	39	RECEPTACLE	15 A	1			540 VA	900 VA			1	15 A	RECEPTACLE	40	#12AWG R90 CU + #12 BOND IN
#12AWG R90 CU + #12 BOND IN	41	RECEPTACLE	15 A	1					1080 VA	1080 VA	1	15 A	RECEPTACLE	42	#12AWG R90 CU + #12 BOND IN
#12AWG R90 CU + #12 BOND IN	43	RECEPTACLE	15 A	1	900 VA	1080 VA					1	15 A	RECEPTACLE	44	#12AWG R90 CU + #12 BOND IN
#12AWG R90 CU + #12 BOND IN	45	RECEPTACLE	15 A	1			1080 VA	1080 VA			1	15 A	RECEPTACLE	46	#12AWG R90 CU + #12 BOND IN
#12AWG R90 CU + #12 BOND IN	47	FACP	15 A	1					200 VA					48	
#12AWG R90 CU + #12 BOND IN	49	RECEPTACLE	15 A	1	1080 VA									50	
	51													52	
	53													54	
	55													56	
	57													58	
	59													60	
	I		To	tal Load:	777(	5 VA	8107	7 VA	8102	2 VA				1	
			Tota	al Amps:	65	λ	68	A	68	3 A					
Notes:													1		

REVIEW ALL DRAWINGS AND VERIFY ALL DIMENSIONS AT THE SITE. DO NOT SCALE THE DRAWINGS. REPORT ALL DISCREPANCIES TO THE ENGINEER BEFORE PROCEEDING WITH ANY CONSTRUCTION OR SHOP FABRICATION. ALL DRAWINGS, SPECIFICATIONS AND RELATED DOCUMENTS ARE THE COPYRIGHT PROPERTY OF MANTECON PARTNERS' AND MUST BE RETURNED UPON REQUEST. REPRODUCTION OF DRAWINGS, SPECIFICATIONS AND RELATED DOCUMENTS IN PART OR WHOLE IS FORBIDDEN WITHOUT THE ENGINEER'S WRITTEN PERMISSION.

#### NOTE: REFER TO ARCHITECTURAL DRAWINGS FOR PHASING INFORMATION

A.I.C. Rating: 18kAIC FULLY RATED MINIMUM Mains Type: Mains Rating: 200 A MCB Rating: 200 A





\_\_\_\_\_ Seals

375 COLBORNE LODGE DR, TORONTO, ON M6R 2Z3

#### HIGH PARK NATURE AND **VISITOR'S CENTER**

Drawing Name: PANEL SCHEDULE

Project Number: 22-142 Drawing Scale: As Indicated 2025-02-25 Date: File Name: Drawn By: M.Z. N.A. Reviewed By: \_\_\_\_\_ Drawing No.:



