## CITY OF TORONTO ACCESSIBILITY UPGRADES GROUP 5

9119-19-0162 / Arcadis 30279056

Google Maps Toronto Projects
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COVER PAGE GROUP 05				
SHEE	Т#	SHEET TITLE		
G05-GAL-	G1001	COVER PAGE, GENERAL DRAWING LIST, BUILDING LIST		

GENERAL LAYOUTS GROUP 05				
SHEET#	SHEET TITLE			
G05-GAL-G1002	ARCHITECTURAL GENERAL NOTES, ABBREVIATIONS & REFERENCE SYMBOLS			
G05-GAL-G1003	WALL TYPES			
G05-GAL-G1004	DOOR TYPES			
G05-GAL-G2001	STRUCTURAL GENERAL NOTES			
G05-GAL-G2002	ABBREVIATIONS & SYMBOLES			
G05-GAL-G3001	MECHANICAL LEGEND SHEET 1 OF 2			
G05-GAL-G3002	MECHANICAL LEGEND SHEET 2 OF 2			
G05-GAL-G4001	ELECTRICAL LEGEND SHEET 1 OF 2			
G05-GAL-G4002	ELECTRICAL LEGEND SHEET 2 OF 2			
G05-GAL-G4003	ELECTRICAL GENERAL NOTES			

GROUP 05 BUILDING INDEX				
SERIAL#	BUILDING ADDRESS	BUILDING DESCRIPTION		
1	10 WILLIAM CARSON CRESCENT	FIRE HALL NO. 121		
10	1026 FINCH AVE. W	FINCH YARD BLDG A		
30	125 MOATFIELD DR	DAVID DUNCAN HOUSE - RESTAURANT		
48	14 DYAS RD	CITY CLERK'S RECORDS CENTRE		
59	143 BOND AVE.	FIRE HALL NO. 123		
83	160 DUNCAN MILL RD.	BUILDING		
143	2545 BAYVIEW AVE.	FIRE HALL NO. 122		
175	300 LESMILL RD.	BUILDING		
249	50 UPJOHN RD.	POLICE NO. 33 DIVISION		

TOUCH AND FEEL BOOKLET

TYPICAL DETAILS BOOKLET

IMAGE SOURCES: GOOGLE MAPS

NOT FOR CONSTRUCTION

ISSUED FOR TENDER

CITY OF TORONTO



55 John ST. TORONTO, ON M5V 3C6

ISSUES

 No.
 DESCRIPTION
 DATE

 A
 50% SUBMISSION
 2022-01-20

 B
 90% SUBMISSION
 2022-02-22

 C
 ISSUED FOR PERMIT
 2022-03-18

 D
 ISSUED FOR TENDER
 2025-04-11

PRIME CONSULTANT



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PROJECT NO:
9119- 19- 0162 / Arcadis 30279056

DATE: 2025-04-11

SHEET NUMBER
G05-GAL-G0001

01 L


#### **ABBREVIATIONS**

@ A A/C	AT ANGLE AIR CONDITIONER / CONDITIONING		EMERGENCY CALL BUTTON EMERGENCY CALL SIGNAGE EACH FREE	LNS LNT LP	LINOLEUM SHEET LINOLEUM TILE LOW POINT	RS RST RSTR	RUBBER SHEET FLOORING RUBBER STAIR TREADS RUBBER STAIR TREADS & RISERS
ABV	ABOVE	EIFS	EXTERIOR INSULATION AND FINISH	LT	LIGHT	RT	RUBBER TILE
CCS CSDR	ACCESSORIES ACCESS DOOR	EJ	SYSTEM EXPANSION JOINT	LVR LWT	LOUVER LIGHT WEIGHT	RWB RWD	RUBBER WALL BASE REDWOOD
	ACCESS FLOOR	EL	ELEVATION	LVVI	LIGHT WEIGHT	RWL	RAIN WATER LEADER
ST / OUS	ACOUSTICAL		ELECTRICAL ELEVATOR	MACH	MACHINE	C	COLITI
CT	ACOUSTICAL CEILING TILE		EMERGENCY	MAINT MAT	MAINTENANCE ANTI-FATIGUE MATTING	S SC	SOUTH SOLID CORE
)	AREA DRAIN		ENGINEERED WOOD FLOORING	MATL	MATERIAL	SCD	SEAT COVER DISPENSER
A DL	AMERICANS WITH DISABILITIES ACT ADDITIONAL		ENCLOSED / ENCLOSURE ENGINEER	MAX MC	MAXIMUM MEDICINE CABINET	SCHED SCN	SCHEDULE SCREEN
DM	ADDENDUM	EOD	EDGE OF DECK	ME	MECHANICAL EQUIPMENT	SCT	STAINED CONCRETE
J MIN	ADJUSTABLE / ADJACENT ADMINISTRATION		EDGE OF SLAB EQUAL(LY)	MECH	MECHANICAL	SD	SOAP DISPENSER / STORM DRAIN
C	ABOVE FINISHED COUNTER		EQUIPMENT	MEZZ MFR	MEZZANINE MANUFACTURE(R)	SDC SECT	SEALED CONCRETE SECTION
FF	ABOVE FINISHED FLOOR		ESTIMATE COOL ED	MH	MANHOLE	SF	SQUARE FEET
:G :S	ABOVE FINISHED GRADE ABOVE FINISHED SLAB		ELECTRIC WATER COOLER EXISTING	MIN MIR	MINIMUM MIRROR	SHLF SHT	SHELF SHEET
GGR	AGGREGATE	EXP	EXPANSION	MISC	MISCELLANEOUS	SHTG	SHEATHING
HR HU	ANCHOR AIR HANDLING UNIT	EXT	EXTERIOR	MLD / MLDG	MOULDING	SHWC	SHOWER CURTAIN AND ROD
./	ALUMINUM	FA	FIRE ALARM	MO	MASONRY OPENING	SHWR SHWS	SHOWER SHOUR SEAT
.UM .NMT	ALIGNMENT		FASTEN(ER)	MR	MOISTURE RESISTANT	SIM	SIMILAR
T	ALTERNATE		FLOOR CLEAN OUT FLOOR DRAIN	MTD MTL	MOUNTED METAL	SND SNR	SANITARY NAPKIN DISPENSER SANITARY NAPKIN RECEPTACLE
OD	ANODIZED	FDN	FOUNDATION	MUL	MULLION	SOG	SLAB ON GRADE
IUN	ASSISTANCE REQUIRED INDICATIOR/ALARM		FIRE EXTINGUISHER FIRE EXTINGUISHER CABINET	MW	MICROWAVE	SPD	SOAP DISPENSER WITH COLLECTOR
)	ACCESS PANEL	FEC (R)	FIRE EXTINGUISHER CABINET,	N	NORTH	SPEC	SPECIFY / SPECIFICATION
PROX	ACOUSTICAL PANEL CEILING APPROXIMATELY		RECESSED FIRE EXTINGUISHER CABINET,	NA OR N/A	NOT AVAILABLE / APPLICABLE	SPK	SPEAKER
PPVD	APPROVED	, ,	SEMI-RECESSED	N/A ND	FEMININE NAPKIN WASTE BIN	SQ SQFT	SQUARE SQUARE FEET
R-LED RCH	DOOR LOCK INDICATOR ARCHITECT(URAL)		FIRE EXTINGUISHER, WALL MOUNTED	NFPA	NATIONAL FIRE PROTECTION ASSOCIATION	SQIN	SQUARE INCH(ES)
CH SPH	ASPHALT	FF	FINISHED FLOOR	NIC	NOT IN CONTRACT	SS ST	STAINLESS STEEL STONE
MT	AMERICAN SOCIETY FOR TESTING MATERIALS		FINISH FLOOR LEVEL FIBERGLASS	NO / #	NUMBER	STA	STATION
JTO	AUTOMATIC		FINISH(ED)	NOM NTS	NOMINAL NOT TO SCALE	STC	SOUND TRANSMISSION CLASS
/G	AVERAGE	FIXT	FIXTURE			STD STDS	STANDARD STUDS
	AND		FLOOR FLASH(ING)	OA OBS	OVERALL OBSCURE	STIFF	STIFFENER
)	BOARD	FLUOR	FLUORESCENT	OC	ON CENTER	STL STN	STEEL STAINED
ET FACT	BETWEEN BARRIER FREE ADULT CHANGE		FACE OF CONCRETE FACE OF FINISH	OCI	OCCUPIED INDICATOR	STOR	STORAGE
ACT	TABLE		FACE OF MASONRY	OD OFCI	OUTSIDE DIAMETER OWNER FURNISHED CONTRACTOR	STRUCT	
AO	BARRIE FREE AUTOMATIC OPENER		FACE OF STUDS		INSTALLED	SUSP SV	SUSPENDED STOVE
PB WO	BARRIER FREE PUSH BUTTON BARRIER FREE WAVE TO OPEN		FACE OF WALL FIREPROOF	OFF OPG /	OFFICE OPENING	SW	SWITCH
}	BUMPER GUARD		FIREPLACE	OPNG		SYM SYN	SYMMETRICAL SYNTHETIC
TUM	BITUMINOUS BLACK		FRAME	OPP OZ	OPPOSITE OUNCE	SYS	SYSTEM
DG	BUILDING		FIBER REINFORCED CONCRETE FIRE RATED GLASS	02	CONCL	TOD	TOD AND DOTTOM
.K	BLOCK		FIBER REINFORCED GYPSUM PLASTER	PART	PARTIAL	T&B T&G	TOP AND BOTTOM TONGUE AND GROOVE
.KG ∕I	BLOCKING BEAM		FIRE RETARDANT TREATED	PAT PB	PATTERN PORCELAIN BASE	TB	TOWEL BAR
<b>IS</b>	BALANCE MAGNETIC SWITCH	FS	FLOOR SINK	PBD	PARTICLE BOARD	TBD TC	TO BE DETERMINED TOP OF CURB
OS OT	BOTTOM OF STEEL BOTTOM		FOOTING FURRING	PC / PCC PED	PRECAST CONCRETE PEDESTAL	TEL	TELEPHONE
? 1	BACKREST		FUTURE	PER	PERIMETER	TEMP	TEMPORARY / TEMPERATURE
6	BOTH SIDES	0.4	ONLOG	PERF	PERFORATED	TER	TERRAZZO
AΒ	CABINET		GAUGE GALVANIZE(D)	PERP PF	PERPENDICULAR PRE-FINISHED	TGL THK	TEMPERED GLASS THICK
AS	CASEWORK	GB	GRAB BAR	PFT	PORCELAINE FLOOR TILE	THRU	THROUGH
i M	CATCH BASIN CEMENT		GRAB BAR FOLD DOWN GENERAL CONTRACTOR	PIP PL	POURED-IN-PLACE PLATE	TOC TOS	TOP OF CONCRETE TOP OF SLAB
ER	CERAMIC		GLASS / GLAZING	PLAM		TOW	TOP OF WALL
F	CUBIC FOOT	GND	GROUND	PLAS	PLASTER	TPD	TOILET PAPER DISPENSER
G H	CORNER GUARD CEILING HEIGHT		GRAVEL	PLYWD PMF	PLYWOOD PRESSED METAL FRAMES	TPTN TV	TOILET PARTITION TELEVISION
HAM	CHAMFER		GLASS TILE	POP	POINT OF PRESENCE	TYP	TYPICAL
IBD	CHALKBOARD CAST IRON		GYPSUM WALL BOARD GEORGIAN WIRED GLASS	PR PRCST	PAIR PRE-CAST	UC	UNDERCUT
	CONTRACTOR INSTALLED		GYPSUM	PREFAB	PREFABRICATED	UG	UNDERGROUND
)	CAST IN PLACE	חח	HUCE BID	PROP	PROPERTY	UL	UNDERWRITER'S LABORATORY
<u>-</u>	CONTROL JOINT CENTER LINE		HOSE BIB HOLLOW CORE	PRT PSF	PORCELAIN TILE POUNDS PER SQUARE FOOT	UNF / UNFIN	UNFINISHED
G	CEILING	HCP	HANDICAPPED	PSI	POUNDS PER SQUARE INCH	UON	UNLESS OTHERWISE NOTED
.0 .R	CLOSET		HEAVY DUTY HEADER	PT PTD	PAINT PAPER TOWEL DISPENSER	UPS UR	UNINTERRUPTIBLE POWER SUPPL'URINAL
MU	CONCRETE MASONRY UNIT	HDWR	HARDWARE		PAPER TOWEL DISPENSER &		
) )	CLEAN/CLEAR OUT		HIGH	PTDF	WASTE RECEPTACLE PRESSURE TREATED DOUGLAS FIR	V VAC	VOLT VACUUM
OL ONC	COLUMN CONCRETE		HOLLOW METAL HOLLOW METAL INSULATED	PTLB	PUSH TO LOCK BUTTON	VAC VB	VAPOR BARRIER
ONST	CONSTRUCTION	HNDR	HAND DRYER	PTN	PARTITION	VCT	VINYL COMPOSITION TILE
ONT ORR	CONTINUOUS CORRIDOR	HOR / HORIZ	HORIZONTAL	PTOB PTR	PUSH TO OPEN BUTTON PAPER TOWEL RECEPTACLE	VENT VERT	VENTILATE VERTICAL
P	CONCRETE PAVER		HIGH POINT	PVC	POLYVINYL CHLORIDE	VEST	VESTIBULE
PR	COPPER		HANDRAIL	0	OLIA D.T.7	VIF	VERIFY IN FIELD
PT Γ	CARPET(ED)(ING) CERAMIC TILE		HEIGHT HEATING / VENTILATION / AIR	Q QT	QUARTZ QUARRY TILE	VNR VST	VENEER VINYL STAIR TREADS
TH	COAT HOOK		CONDITIONING	QTY	QUANTITY	VSTR	VINTYL STAIR TREADS & RISERS
TR	COUNTER		HARDWARE HYDRANT	R	RISER	VTR VWC	VENT THRU ROOF VINYL WALLCOVERING
BL	DOUBLE			RAD	RADIUS		
FS	DIRECT APPLIED EXTERIOR FINISH		INSIDE DIAMETER INCH / INCHES	RB BCD	RUBBER BASE	W W/	WEST
EG	SYSTEM DEGREE		INCLUDE(D) / INCLUDING	RCP RD	REFLECTED CEILING PLAN ROOF DRAIN	W/ W/O	WITH WITHOUT
MO	DEMOLISH	INSUL	INSULATE / INSULATION	REF	REFERENCE	WC	WATER CLOSET
EP ET	DEPRESSION DETAIL	INT ITGL	INTERIOR INSULATED TEMPERED GLASS	REFR REG	REFRIGERATOR REGISTER	WCV WD	WALLCOVERING WOOD
<u>:</u>   :	DRINKING FOUNTAIN			REINF	REINFORCE(D)	WD WF	WIDE FLANGE
١	DIAMETER	JAN	JANITOR	REQ	REQUIRED	WH	WALL HOSE / HYDRANT
AG M	DIAGONAL DIMENSION	JT	JOINT	RESIL RESS	RESILIENT RESILIENT SHEET	WI WIN	WROUGHT IRON WINDOW
SP	DISPENSER	KIT	KITCHEN	REST	RESILIENT TILE	WK	WORK
<i>/</i>	DIVISION	LAB	LABORATORY	RET	RETAINING	WNSCT	WAINSCOT
<b>S</b>	DOWN DOOR		LAMINATE(D)	REV RFG	REVISE / REVISION ROOFING	WP WPT	WATERPROOF(ING) WORK POINT
3	DOWNSPOUT	LAV	LAVATORY	RFL	REFLECTED	WR	WATER RESISTANT
N NG	DISHWASHER DRAWING	, ,	POUND(S) LINEAR FOOT (FEET)	RH RM	RIGHT HAND ROOM	WRR	WOOD RISER
* * U	DIV WINO		LEFT HAND	RIVI RO	ROUGH OPENING		

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LKR LOCKER

#### REFERENCE SYMBOLS

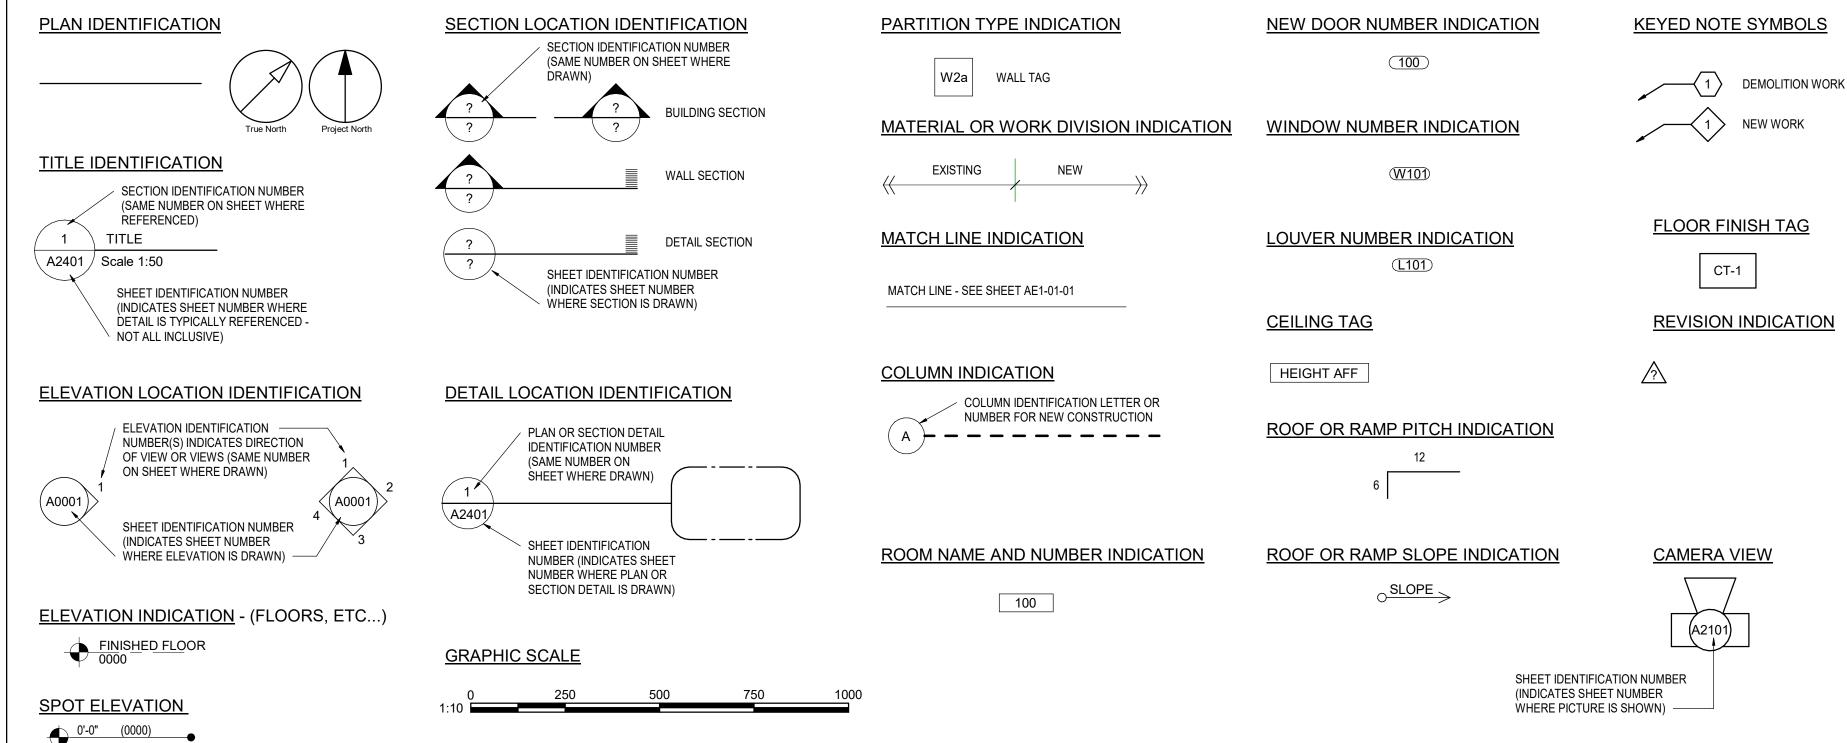

CLIENT CITY OF TORONTO Corporate Real Estate Management Project Management Office Metro Hall Toronto, ON

Written dimensions shall have precedence over scaled dimensions. Contractor shall verify and be responsible for all dimensions and conditions on the job, and IBI Group shall be informed of any variations from the dimensions and conditions shown on the drawing. Shop drawings shall be submitted to IBI Group for general conformance before proceeding with fabrication. IBI Group Professional Services (Canada) Inc. is a member of the IBI Group of companies

M5V 3C6

DESCRIPTION A 50% SUBMISSION 2022-01-20 B 90% SUBMISSION 2022-02-22 C ISSUED FOR PERMIT 2022-03-18 D ISSUED FOR TENDER 2025-04-11

#### **GENERAL NOTES**

- 1. PERFORM THE WORK IN ACCORDANCE WITH THE LATEST EDITION OF THE ONTARIO BUILDING CODE, CITY OF TORONTO ACCESSIBILITY DESIGN GUIDELINES OCTOBER 7th 2016 DRAFT AND ANY OTHER APPLICABLE REQUIREMENT OF AUTHORITIES HAVING JURISDICTION AND/OR LEGISLATION, PROVIDED THAT, IN THE CASE OF CONFLICT OR DISCREPANCY.
- 2. THE CONSULTANT IS NOT RESPONSIBLE FOR INFORMATION CONCERNING THE SITE AND SURVEY INFORMATION PREPARED BY OTHERS.
- 3. DRAWINGS ARE TO BE READ IN CONJUNCTION WITH THE SPECIFICATIONS AND THE ASSOCIATED STRUCTURAL, MECHANICAL, ELECTRICAL DRAWINGS AND ALL OTHER RELEVANT CONSULTANT DRAWINGS.
- 4. CONTRACTOR TO SITE VERIFY ALL DIMENSIONS AND REPORT ANY DISCREPANCIES TO CONSULTANT.
- 5. CONTRACTOR SHALL VERIFY THE SITE INFORMATION PRIOR TO PROCEEDING WITH THE WORK. FAILURE TO REPORT ANY DISCREPANCIES SHALL CONSTITUTE ACCEPTANCE OF THE SITE CONDITIONS.
- 6. THE CONTRACTOR SHALL REVIEW THE DRAWINGS FOR SCOPE OF DEMOLITION AND NEW WORK, INCLUDING ALL DISCIPLINES, AND SHALL COORDINATE WITH NEW WORK DRAWINGS FOR EXACT EXTENT OF DEMOLITION.
- 7. SCOPE OF WORK SHALL NOT BE LIMITED TO THAT SHOWN ON THE DRAWINGS AND SHALL INCLUDE WORK REQUIRED TO ELIMINATE ALL EXISTING, ABANDONED OR REDUNDANT COMPONENTS, AND TO FACILITATE PROPER EXECUTION OF THE WORK.
- 8. ALL DIMENSIONS, INCLUDING EXISTING DIMENSIONS AND SETTING-OUT GEOMETRIES, SHALL BE SITE VERIFIED BY THE CONTRACTOR PRIOR TO PROCEEDING WITH THE WORK.
- 9. COORDINATE AND PROVIDE APPROPRIATE CUTS TO ALL PARTITIONS FOR THE INSTALLATION OF DOOR FRAMES AS REQUIRED.
- 10. PROVIDE 16-18 GA SHEET METAL REINFORCEMENT INSTALLED ON THE STUDS PRIOR TO INSTALLING THE GYPSUM BOARD IN THE LOCATIONS REQUIRED TO SUPPORT WALL MOUNTED ITEMS.
- 11. ISOLATE ALL MECHANICAL PIPES DUCTS AND EQUIPMENT FROM INTERIOR PARTITIONS TO AVOID ACOUSTIC NOISE TRANSFER.
- 12. MAINTAIN CONTINUITY OF BUILDING ENVELOPE AIR / VAPOUR BARRIER TRANSITIONS AND PENETRATIONS WITH MEMBRANES LAPPED AND APPROVED SEALANTS COMPATIBLE WITH MEMBRANE PRODUCTS USED.
- 13. REINSTATE INTEGRITY OF FIRE SEPARATION WHEN PATCHING. PROVIDE AND INSTALL FIRE STOPPING AND SMOKE SEALS AT ALL NEW SERVICE PENETRATIONS THROUGH FLOORS, WALLS AND CEILINGS IN ACCORDANCE WITH OBC. LATEST EDITION REQUIREMENTS. REFER TO MECHANICAL DRAWINGS FOR ANY FIRE DAMPER REQUIREMENTS.
- 14. ENSURE THAT FOR ALL FIRE SEPARATIONS INDICATED ON THE DRAWINGS, ALL COMPONENTS OF THE ASSEMBLY SHALL BE OF APPROVED MATERIALS, AND INSTALLATION/FABRICATION PROCEDURES ARE PER DIRECTION OF THE INDICATED "UNDERWRITERS LABORATORIES OF CANADA LTD." LATEST EDITION MANUAL AND OTHERWISE MEETING THE REQUIREMENTS OF THE ONTARIO BUILDING CODE. ALL FIRE SEPARATIONS MUST BE CONTINUOUS, AND ALL JOINTS TO BE SMOKE TIGHT. MAINTAIN CONTINUITY OF ALL FIRE SEPARATIONS AND PENETRATIONS WITH APPROVED U.L.C. LISTED FIRE STOPPING SYSTEMS AND FIRE SEALANTS BOTH SIDES OF PARTITIONS.

15. ULC LISTED FIRE-RATED SEALANT IS TO BE APPLIED TO ALL FIRE-RATED PARTITIONS AND LEFT EXPOSED FOR INSPECTION PURPOSES

- 16. FOR ALL SUPPORTS AND CONNECTIONS OF EQUIPMENT PROVIDE SHOP DRAWINGS DESIGNED AND STAMPED BY A PROFESSIONAL ENGINEER LICENCED IN THE PROVINCE OF ONTARIO.
- 17. WHERE ITEMS NOTED TO BE DEMOLISHED MEET EXISTING WALLS / CEILING AND/OR FLOOR TO REMAIN, PATCH REPAIR AND MAKE GOOD EXISTING SURFACES. PROVIDE NEW INFILL MATERIAL TO MATCH EXISTING AND. MAINTAIN ALL FIRE RATED WALL CONSTRUCTION
- 18. PROVIDE CUTTING, PATCHING AND CORING OF ALL WALLS, CEILING, ROOF AND OTHER SURFACES AS REQUIRED TO PERFORM THE WORK. PRIOR TO CUTTING OR CORING, SCAN THE SLAB/WALL/ROOF AND COORDINATE DRILLING/CUTTING TO AVOID CUTTING REINFORCING, CONDUITS, WIRING AND OTHER HIDDEN ITEMS. OBTAIN WRITTEN VERIFICATION OF PROPOSED DRILLING AND CUTTING LOCATIONS FROM THE STRUCTURAL ENGINEER.
- 19. PATCH REPAIR AND MAKE GOOD EXISTING FLOOR SLAB.. IDENTIFY ON AS-BUILTS ALL LOCATIONS OF PATCH WORK
- 20. BEFORE COMMENCING WORK, ESTABLISH LOCATION AND EXTENT OF EXISTING SERVICE LINES IN AREA OF WORK AND NOTIFY CONSULTANT OF FINDINGS. WHERE UNKNOWN SERVICES ARE ENCOUNTERED, IMMEDIATELY ADVISE AND CONFIRM FINDINGS IN WRITING.
- 21. PROVIDE FOR DEMOLITION OF INCLUDING BUT NOT LIMITED TO, EXISTING WALLS, FLOORS, CEILINGS, ASSOCIATED FINISHES, MECHANICAL AND ELECTRICAL FIXTURES, DEVICES, DUCTS TO ALLOW FOR NEW WORK TO BE INSTALLED. COORDINATE BETWEEN TRADES FOR REMOVAL.
- 22. CONCEAL ALL MECHANICAL AND ELECTRICAL WORK IN WALLS AND CEILINGS, EXCEPT AS INDICATED OTHERWISE OR APPROVED.
- 23. VAPOUR BARRIER TO BE CONTINUOUS UNDER ALL NEW FLOOR SLABS. PATCH ALL CONCRETE CORE TEST AREAS, DEFECTS AND DEMOLITION LOCATIONS.
- 24. ALL SPECIFIED MATERIALS SHALL BE INSTALLED AND FINISHED IN ACCORDANCE WITH MANUFACTURERS WRITTEN INSTRUCTIONS. SHOULD SUCH INSTRUCTIONS DIFFER FROM THE SPECIFICATIONS OR DETAILS, ADVISE CONSULTANT IMMEDIATELY FOR DIRECTION.
- 25. DETAILS MARKED "TYPICAL" SHALL APPLY IN ALL SIMILAR CONDITIONS UNLESS NOTED OR DETAILED OTHERWISE
- 26. BRING ALL OMISSIONS AND DISCREPANCIES, INCLUDING DIMENSIONS, TO THE ATTENTION OF THE CONSULTANT PRIOR TO COMMENCEMENT OF ANY WORK.
- 27. FULLY COORDINATE ALL ADDITIONAL SUPPORT REQUIRED FOR ANCHORAGE OF MECHANICAL EQUIPMENT OR DUCTS AND ELECTRICAL FIXTURES/EQUIPMENT. PROVIDE SEISMIC RESTRAINT DRAWINGS STAMPED BY A THIRD PARTY PROFESSIONAL ENGINEER LICENCED IN
- 28. WALL ASSEMBLIES SHALL EXTEND TO UNDERSIDE OF ROOF OR STRUCTURE ABOVE UNLESS NOTED OR DETAILED OTHERWISE
- 29. REFER TO ELECTRICAL DRAWINGS FOR LOCATION OF ALL ELECTRICAL EQUIPMENT, CONDUIT, LIGHTING AND RECEPTACLE LOCATIONS.
- 30. REFER TO MECHANICAL DRAWINGS FOR LOCATION OF ALL MECHANICAL EQUIPMENT AND PROVISIONS
- 31. REFER TO STRUCTURAL DRAWINGS FOR LOCATION AND SIZING OF ALL STRUCTURAL ELEMENTS
- 32. DIMENSIONS ARE SHOWN IN MILLIMETERS UNLESS OTHERWISE NOTED.
- 33. REMOVAL AND DISPOSAL OF HAZARDOUS MATERIALS SHALL BE IN ACCORDANCE WITH LOCAL REGULATIONS AND AUTHORITIES HAVING JURISDICTION.
- 34. UNLESS NOTED OTHERWISE, MAKE GOOD ALL AREAS DISTURBED BY EXCAVATION AND/OR INSTALLATION OF CIVIL, STRUCTURAL, MECHANICAL AND ELECTRICAL SERVICES. REFER TO CIVIL, STRUCTURAL, MECHANICAL, AND ELECTRICAL DRAWINGS.
- 35. PROPER HOARDING AROUND ALL NEW EXTERIOR WORK LOCATIONS TO BE PROVIDED.

CONSULTANTS

SEAL

PRIME CONSULTANT

100 - 175 Galaxy Blvd, Toronto, ON M9W 0C9, Canada tel 416 679 1930

PROJECT TITLE CITY OF TORONTO

**ACCESSIBILITY UPGRADES** 

PROJECT ADDRESS

www.arcadis.com

PROJECT NO: 9119- 19- 0162 / Arcadis 30279056 DRAWN BY: CHECKED BY:

A. BOYNARIAN L. BANDIERA PROJECT MGR APPROVED BY: F.BOLOURIAN E. FENUTA SHEET TITLE

GENERAL NOTES, **ABBREVIATIONS &** REFERENCE SYMBOLS

SHEET NUMBER

G05-GAL-G0002 D


EAST

EACH

#### CONCRETE BLOCK **ASSEMBLY** DESCRIPTION FRR TYPE NO. - 90mm CONCRETE BLOCK NORMAL WEIGHT TO U/S OF DECK/ SLAB ABOVE 1.0 HR - 140mm CONCRETE BLOCK NORMAL WEIGHT TO U/S OF DECK/ SLAB ABOVE OBC SB-2 - 190mm CONCRETE BLOCK 48 NORMAL WEIGHT TO U/S OF DECK/ SLAB ABOVE OBC SB-2 - 240mm CONCRETE BLOCK 49 LIGHT WEIGHT TO U/S OF DECK/ SLAB ABOVE - 305mm CONCRETE BLOCK NORMAL WEIGHT TO U/S OF DECK/ SLAB ABOVE

#### **WALL TYPE NOTES:**

- ACOUSTIC BATT INSULATION TO EXTEND FULL HEIGHT OF WALL ASSEMBLIES UNLESS NOTED OTHERWISE
- 2. PROVIDE MOISTURE RESISTANT GYPSUM BOARD ON ALL WALLS OF WASHROOMS, KITCHEN AREAS AND BEHIND DRINKING FOUNTAINS.
- 3. PROVIDE TILE BACKER BOARD BEHIND ALL CERAMIC TILE APPLICATIONS.
- 4. ANY PENETRATIONS THROUGH FIRE RATED WALLS SHOULD BE PROTECTED WITH ULC LISTED FIRE STOPPING.
- 5. AT FIRE RATED WALLS AND SMOKE BARRIERS ABOVE ACCESSIBLE CEILING, PROVIDE IDENTIFICATION SIGNAGE, SPACED AT NOT MORE THAN 9 METRE MEASURED HORIZONTALLY, INDICATING "FIRE AND/OR SMOKE BARRIER - PROTECT OPENINGS AS PER OBC 3.1.9".
- 6. PROVIDE FIRE BLOCKING IN CONCEALED SPACES OF STUD WALLS AND PARTITIONS VERTICALLY AT THE CEILING AND FLOOR LEVELS AND HORIZONTALLY.
- 7. FURRING WALLS AROUND COLUMNS, SHAFTS AND PIPING THAT ARE ALSO DEMISING WALLS BETWEEN ROOMS SHALL GO TO U/S OF DECK/ SLAB ABOVE AND CARRY ACOUSTIC INSULATION CONTINUITY FROM ADJACENT WALLS.

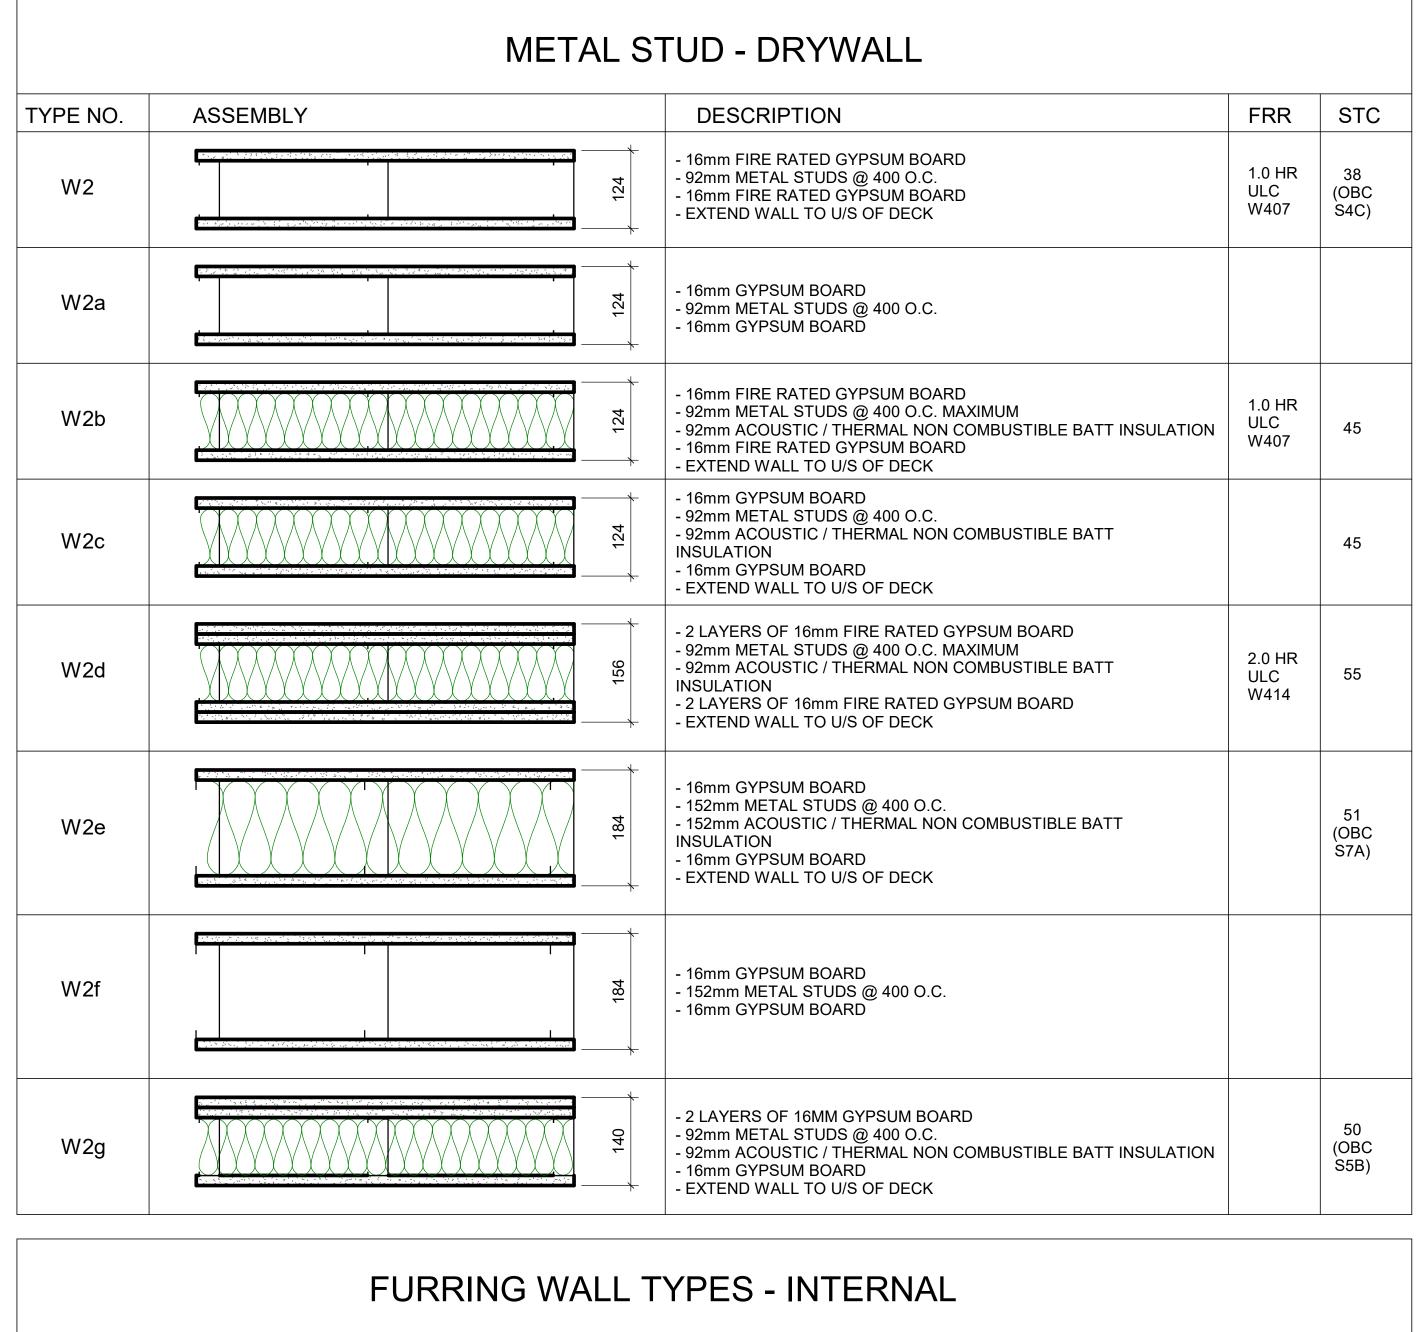

TYPE NO.	ASSEMBLY	DESCRIPTION	FRR
W3a	<u> </u>	38mm FURRING - TO 150mm ABOV FIN. CEILING - 16mm GYPSUM BOARD - 22mm MIN HAT CHANNEL @ 400 O.C.	
W3b	88 (a) (b) (c) (c) (c) (c) (c) (c) (c) (c) (c) (c	80mm FURRING - TO 150mm ABOV FIN. CEILING - 16mm GYPSUM BOARD - 64mm MIN STEEL STUDS @ 400 O.C.	
W3c	108	108mm FURRING - TO 150mm ABOV FIN. CEILING UNLESS OTHERWISE NOTED - 16mm GYPSUM BOARD - 92mm MIN STEEL STUDS @ 400 O.C.	
W3d	108	108mm FURRING - TO 150mm ABOV FIN. CEILING UNLESS OTHERWISE NOTED - 16mm GYPSUM BOARD - 92mm MIN STEEL STUDS @ 400 O.C 92mm ACOUSTIC NON COMBUSTIBLE BATT INSULATION	

SHAFT WALL TYPES - INTERNAL						
TYPE NO.	ASSEMBLY	DESCRIPTION	FRR	STC		
W4a		-25.4mm FIRE RATED GYPSUM BOARD -102mm "C-H" SHAPED STUD @600 O.C. - 16mm FIRE RATED GYPSUM BOARD TO U/S OF DECK/ SLAB ABOVE	1.0 HR ULC W452			
W4b	<u> </u>	-25.4mm FIRE RATED GYPSUM BOARD -102mm "C-H" SHAPED STUD @600 O.C 102mm ACOUSTIC / THERMAL NON COMBUSTIBLE BATT INSULATION - 19.1mm FIRE RATED GYPSUM BOARD TO U/S OF DECK/ SLAB ABOVE	2.0 HR ULC W508	52		

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shall verify and be responsible for all dimensions and conditions on the job, and IBI Group shall be informed of any variations from the dimensions and conditions shown on the drawing. Shop drawings shall be submitted to IBI Group for general conformance before proceeding with fabrication.

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CONSULTANTS

PRIME CONSULTANT

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PROJECT TITLE CITY OF TORONTO **ACCESSIBILITY UPGRADES** 

PROJECT ADDRESS

PROJECT NO:


F.BOLOURIAN

9119- 19- 0162 / Arcadis 30279056 DRAWN BY: CHECKED BY: A. BOYNARIAN L. BANDIERA PROJECT MGR APPROVED BY:

E. FENUTA

SHEET TITLE WALL TYPES

SHEET NUMBER G05--GAL-G0003 D

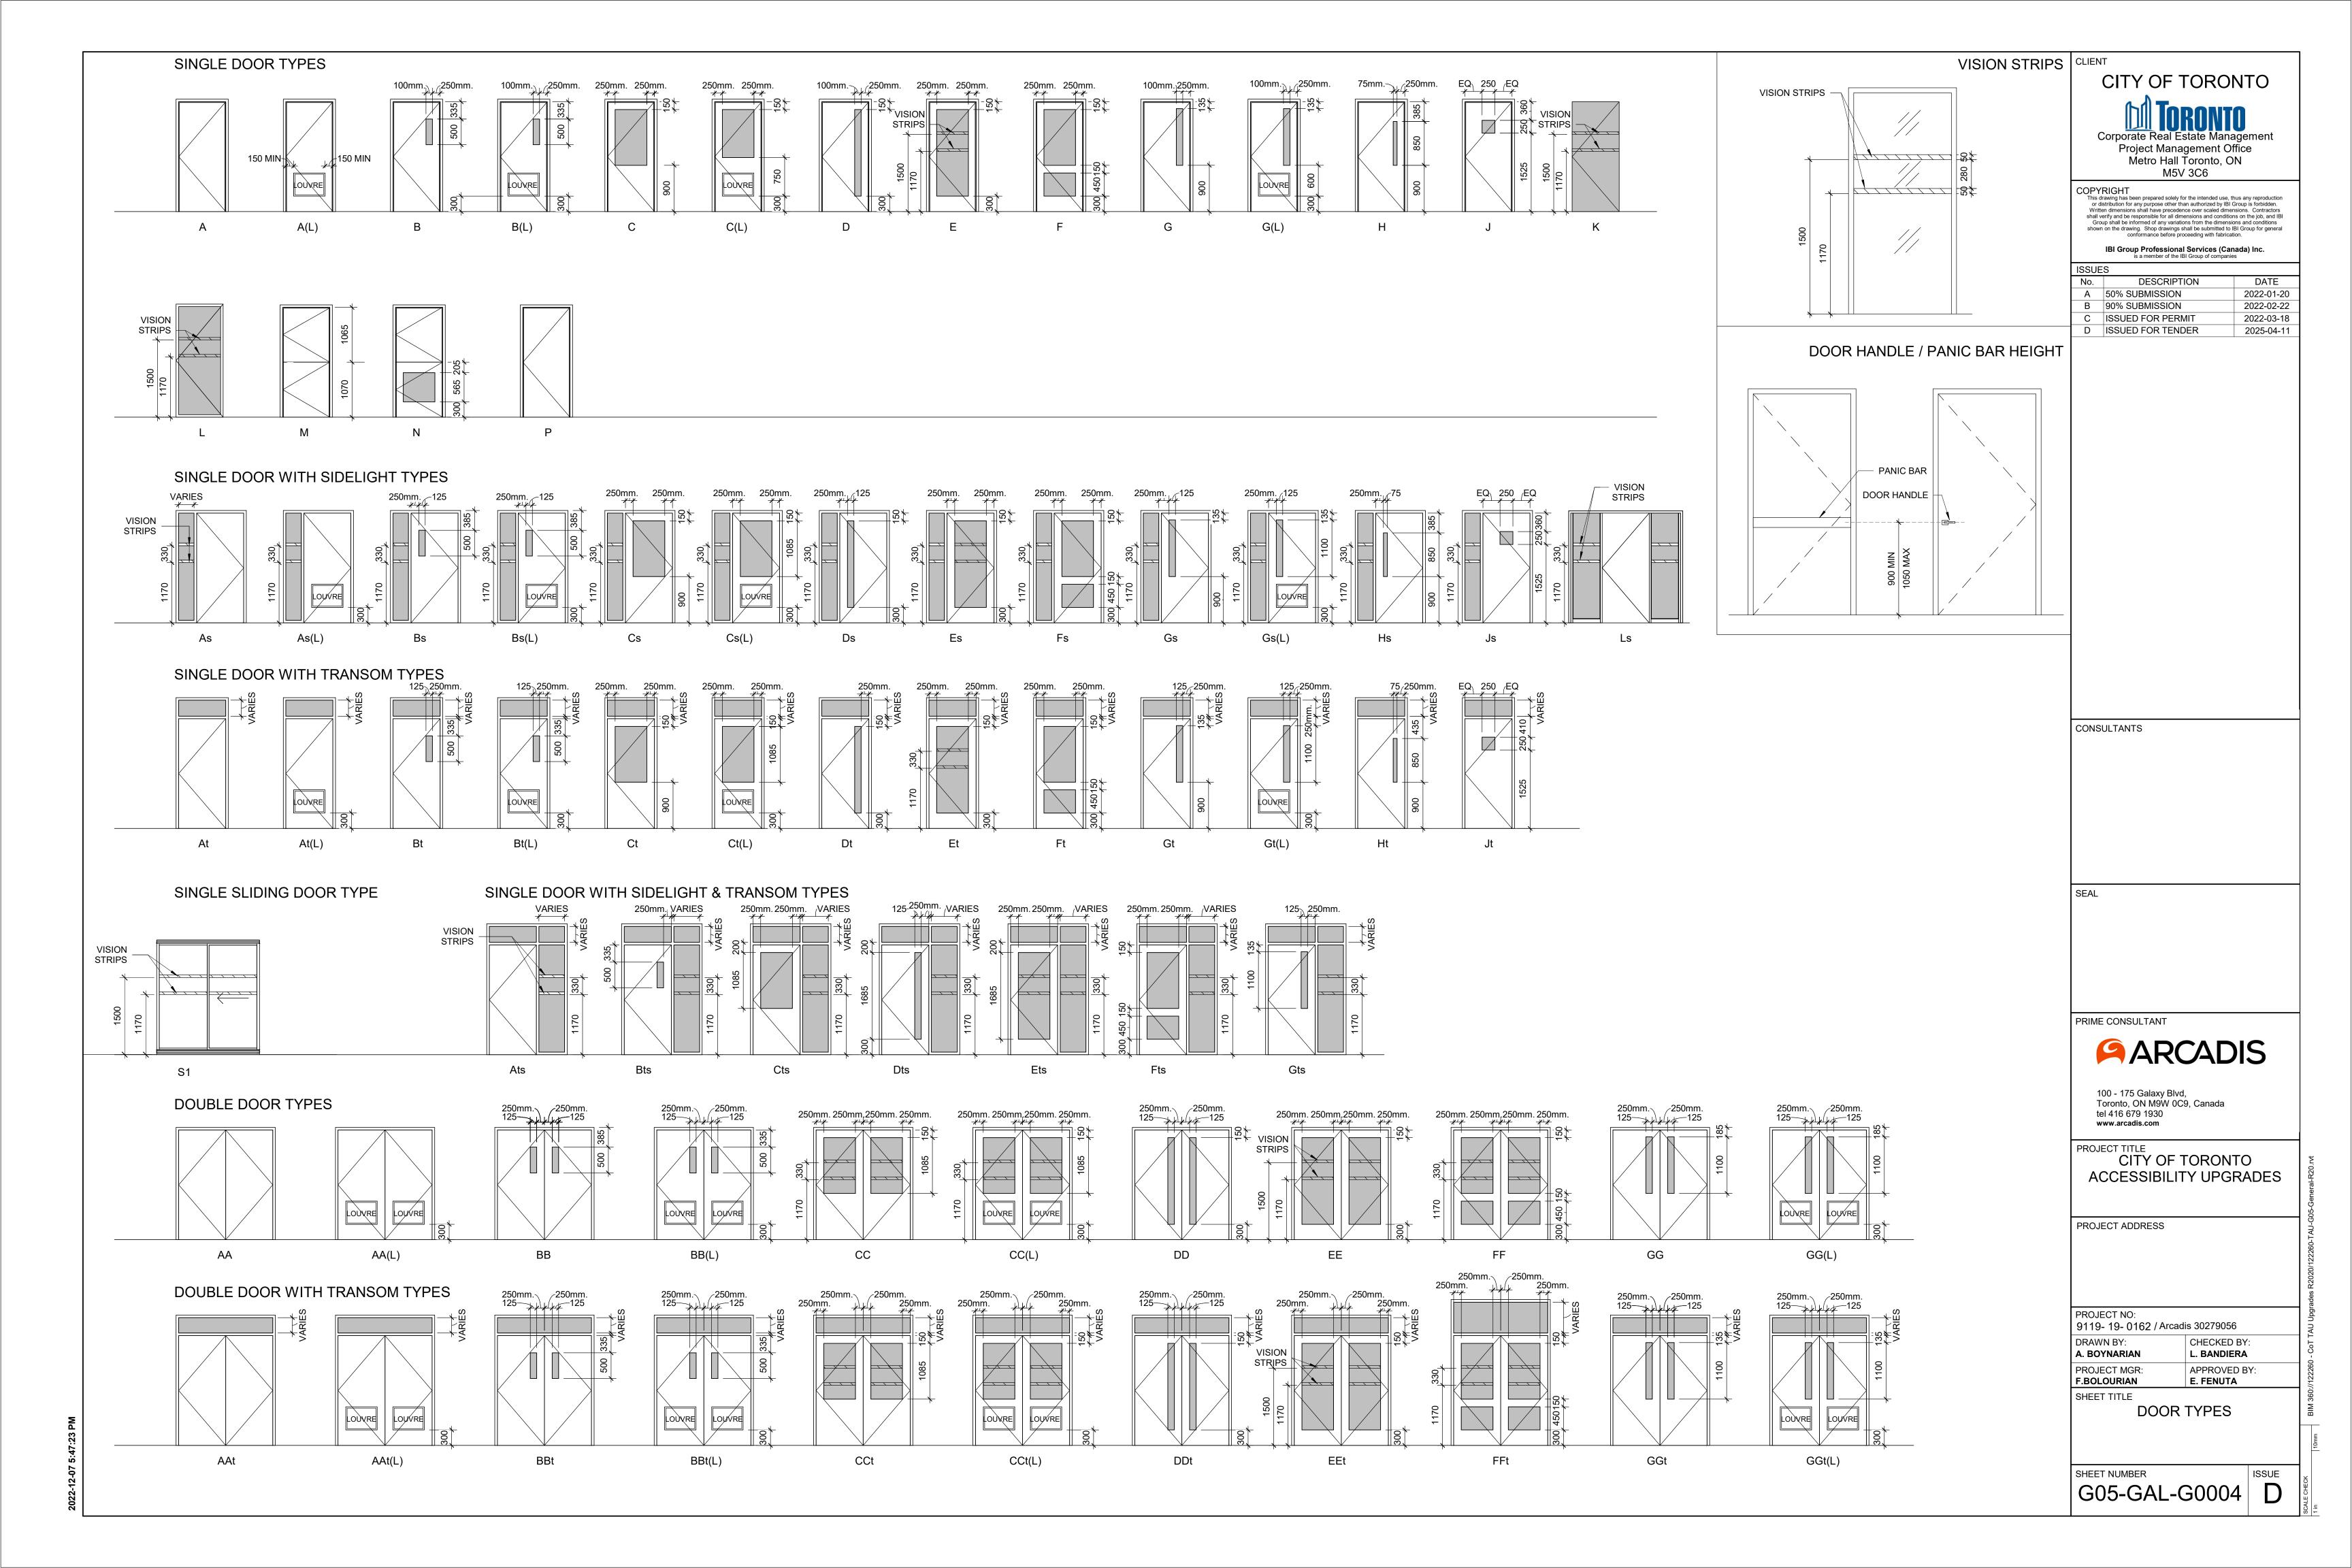

#### GENERAL:

- 1. DO NOT SCALE THE DRAWINGS.
- 2. THE DRAWINGS ARE TO BE READ IN CONJUNCTION WITH THE SPECIFICATIONS, ALL RELATED ARCHITECTURAL, MECHANICAL, ELECTRICAL, PROCESS & CIVIL DRAWINGS, AND OTHER RELEVANT CONTRACT DOCUMENTS.
- 3. CONTRACTOR SHALL PROVIDE COMPLETE SET OF ARCHITECTURAL, MECHANICAL, ELECTRICAL, CIVIL & PROCESS DRAWINGS & APPLICABLE SPECIFICATION SECTIONS TO THE STRUCTURAL STEEL, JOIST & METAL FABRICATIONS CONTRACTORS PRIOR TO SUBMISSION OF ANY RELATED SHOP DRAWINGS
- 4. THE DESIGN AND CONSTRUCTION OF ALL WORK ON THIS PROJECT IS TO CONFORM TO THE 2012 EDITION OF THE ONTARIO BUILDING CODE (REGULATION 332/12).
- 5. THE CONTRACTOR SHALL FIELD CHECK AND VERIFY ALL DIMENSIONS, ELEVATIONS AND CONDITIONS AT THE SITE AND REPORT TO THE ENGINEER ANY DISCREPANCIES OR UNSATISFACTORY CONDITIONS WHICH MAY ADVERSELY AFFECT THE PROPER COMPLETION, COST, SCHEDULE OR QUALITY OF WORK. COMMENCEMENT OF WORK BY THE CONTRACTOR IMPLIES ACCEPTANCE OF THE EXISTING CONDITIONS.
- IMPLIES ACCEPTANCE OF THE EXISTING CONDITIONS.6. THE CONTRACTOR SHALL PROTECT ALL EXISTING STRUCTURES, UNDERGROUND UTILITIES AND OTHER EXISTING SERVICES DURING CONSTRUCTION, AND MAKE GOOD ANY DAMAGE RESULTING
- 7. THE CONTRACTOR SHALL PROVIDE, MAINTAIN AND TAKE RESPONSIBILITY FOR ALL TEMPORARY BRACING AND SHORING.

FROM THE WORK ON THIS PROJECT TO THE SATISFACTION OF THE OWNER AND ENGINEER.

- 8. TYPICAL DETAILS SHOWN ON DRAWINGS SHALL GOVERN THE WORK. IF DETAILS DIFFER ON OTHER DRAWINGS, THE MOST STRINGENT SHALL GOVERN.
- 9. WORK NOT INDICATED ON A PART OF THE DRAWINGS BUT REASONABLY IMPLIED TO BE SIMILAR TO THAT SHOWN AT CORRESPONDING PLACES SHALL BE REPEATED.
- 10. UNLESS NOTED OTHERWISE ON THE STRUCTURAL DRAWINGS, THE CORING OR CUTTING OF OPENINGS AND HOLES SHOWN ON THE STRUCTURAL DRAWINGS THROUGH THE EXISTING STRUCTURE SHALL NOT CUT ANY REINFORCING BARS. THE CONTRACTOR SHALL LOCATE THE LOCATION, SIZE, LENGTH, ORIENTATION AND POSITION OF EXISTING REINFORCING AND PROVIDE IBI WITH HARD COPIES OF SUCH FOR OUR REVIEW IN THE VICINITY OF THE HOLES AND SLEEVES TO BE CUT OR CORED, AND THE HOLES AND SLEEVES SHALL BE LOCATED TO AVOID CUTTING OF REINFORCING BARS.
- 11. NEW OPENINGS OR CORING TO BE CUT THROUGH EXISTING FLOOR SLAB OR WALLS SHALL BE CLEARLY MARKED OUT BY THE CONTRACTOR. THE CONTRACTOR SHALL NOTIFY IBI ONCE THE MARKING OUT HAS BEEN COMPLETED SO THAT IBI CAN REVIEW THE PROPOSED LOCATIONS OF ALL NEW OPENINGS. DO NOT PROCEED WITH CUTTING OF NEW OPENINGS WITHOUT THE APPROVAL OF IBI.
- 12. UNLESS NOTED OTHERWISE ON THE DRAWINGS NEW STRAIGHT SIDED OPENINGS THROUGH EXISTING SLABS AND WALLS SHALL BE SAWCUT WITH NO OVERCUTS. USE CORED HOLES AT THE CORNERS. JACKHAMMERING SHALL NOT BE PERMITTED REFER TO THE DETAILS AND PROCEDURES INDICATED ON THE STRUCTURAL DRAWINGS FOR THE NEW OPENINGS. ALTERNATES TO THE ABOVE PROCEDURE MUST BE REVIEWED BY IBI PRIOR TO THE START OF DEMOLITION OR CONSTRUCTION.

#### DESIGN CRITERIA:

- 1. STRUCTURE HAS BEEN DESIGNED TO RESIST WIND AND SEISMIC LOADS WHICH ARE IN ACCORDANCE WITH THE USER'S GUIDE NBC 2015 STRUCTURAL COMMENTARIES (PART 4 OF DIVISION B), FOR THE IMPORTANCE CATEGORY STATED IN NOTE #12, THE WIND AND SEISMIC PARAMETERS FOUND IN NOTE #13, AND FOR SITE CLASS D,  $F_a$  =1.24,  $F_v$  =1.55,  $I_EF_aS_a(0.2)$  = 0.271 ,  $R_d$  = 1.5 ,  $R_o$  = 1.3 (CONVENTIONAL CONSTRUCTION OF MOMENT-RESISTING FRAMES AND BRACED FRAMES), AND NO IRREGULARITIES, USING STATIC ANALYSIS IN BOTH DIRECTIONS.
- 2. LATERAL LOADS DUE TO WIND AND SEISMIC FORCES ACT THROUGH THE METAL ROOF DECK DIAPHRAGM, AND ARE RESISTED BY MOMENT-RESISTING FRAMES IN THE NORTH-SOUTH DIRECTION AND BY BRACED FRAMES IN THE EAST-WEST DIRECTION.
- 3. ROOF ELEMENTS SUCH AS JOISTS, JOISTS GIRDERS, METAL DECK, ETC. AND THEIR CONNECTIONS TO THE SUPPORTING STRUCTURE ARE TO BE DESIGNED FOR UPWARD SUCTION DUE TO WIND
- 4. ROOF STRUCTURE (INCLUDING JOISTS AND JOIST GIRDERS) IS TO BE DESIGNED FOR PONDING INCLUDING PONDING INSTABILITY. MAXIMUM DESIGN PONDING DEPTH AT ROOF DRAINS TO BE 150 mm.
- 5. AS A MINIMUM, WIND LOADS SHALL BE CALCULATED ON THE BASIS OF OPEN TERRAIN AND BUILDING CATEGORY 3 AS DEFINED IN THE USER'S GUIDE NBC 2015 STRUCTURAL COMMENTARIES (PART 4 OF DIVISION B). IF OTHER PROVISIONS OF SAID COMMENTARIES RESULT IN HIGHER WIND LOADS AND/OR MORE STRINGENT WIND EFFECTS, THESE LOADS AND EFFECTS SHALL BE CONSIDERED IN THE DESIGN.
- 6. ALL LOADS SHOWN ON DRAWINGS ARE SPECIFIED (NO LOAD FACTOR APPLIED) LOADS UNLESS NOTED OTHERWISE. HOWEVER, (ULS) IMPORTANCE FACTORS ARE APPLIED, UNLESS NOTED
- 7. ALL LOAD EFFECTS (AXIAL FORCES, SHEARS. MOMENTS AND TORSIONS) ARE FACTORED, UNLESS OTHERWISE NOTED.
- 8. DESIGN SPECIFIED (UNFACTORED) DEAD AND LIVE LOADS ARE SHOWN ON THE DRAWINGS.
- 9. STRUCTURES ARE NOT STABLE UNTIL ALL COMPONENTS (INCLUDING BUT NOT LIMITED TO MOMENT CONNECTIONS, BRACING, FLOOR & ROOF DECK AND SHEATHING) ARE CONSTRUCTED.

10. MATERIALS: STRUCTURAL STEEL:		RAL STEEL:	CAN/CSA-G40.20/G40.21.	
		COLD-FORMED STEEL: HOLLOW STRUCTURAL SECTIONS (HSS):		GRADE 350W FOR W-SECTIONS. GRADE 300W FOR OTHERS. YIELD STRENGTH = 350 MPa MIN.
				CONFORM TO CAN/CSA G40-20/G40.21-M GRADE 350W, CLASS C.
		WELDING:		E49XX ELECTRODES.
		BOLTS, NUTS AND WASHERS: ANCHOR BOLTS:		CONFORM TO ASTM A325.
				CONFORM TO ASTM F1554 GRADE 36, UNLESS NOTED OTHERWIS
		PRIMER:		SEE SPECIFICATION.
		REINFORCING STEEL: WOOD: LUMBER:		DEFORMED CONCRETE REINFORCING BARS CONFORMING TO CAN/CSA-G30.18, GRADE 400R OR 400W, UNLESS NOTED OTHERWISE. WHERE WELDABLE REINFORCING STEEL IS SPECIFIED, IT SHALL BE GRADE 400W, UNLESS NOTED OTHERWISE.
				GRADED TO NLGA RULES NO.1/NO.2 S-DRY, UNLESS NOTED OTHERWISE. MSR GRADE FOR TRUSSES AS REQUIRED.
			GLULAM:	CSA 0122 SP GRADE 20FE BENDING STRESS, UNLESS NOTED OTHERWISE. 12CE COMPRESSION STRESS, UNLESS NOTED OTHERWISE.

PLYWOOD: CSA 0151 SOFTWOOD EXTERIOR GRADE.

- 12. STRUCTURE HAS BEEN ASSIGNED THE 1 IMPORTANCE CATEGORY, AS DEFINED IN THE APPLICABLE EDITION OF THE ONTARIO BUILDING CODE.
- 13. STRUCTURES HAVE BEEN DESIGNED CONSIDERING THE FOLLOWING CLIMATIC AND SEISMIC DATA:

WIND	SEISMIC	SNOW	RAIN
q 1/50 = 0.47	Sa(0.2) = 0.190 Sa(0.5) = 0.110 Sa(1.0) = 0.068 Sa(2.0) = 0.022 PGA = 0.076	Ss = 1.2 Sr = 0.4	ONE DAY = 92

- 14. THE STRUCTURE HAS BEEN DESIGNED FOR FUTURE EXPANSION AS SHOWN.
- 15. NO STRUCTURES HAVE BEEN DESIGNED FOR FUTURE EXPANSION.

#### CONCRETE:

- THE DESIGN AND CONSTRUCTION OF ALL WORK ON THIS PROJECT SHALL CONFORM TO THE APPLICABLE EDITION OF THE FOLLOWING CSA STANDARDS: CSA-A23.1 "CONCRETE MATERIALS AND METHODS OF CONCRETE CONSTRUCTION"; CSA-A23.2 "TEST METHODS AND STANDARD PRACTICES FOR CONCRETE"; CSA-A23.3 "DESIGN OF CONCRETE STRUCTURES";
- 2. UNLESS NOTED OTHERWISE, MINIMUM CONCRETE COMPRESSIVE STRENGTH AT 28 DAYS SHALL BE AS FOLLOWS:

CAN/CSA-G30.18 "BILLET-STEEL BARS FOR CONCRETE REINFORCEMENT"

- LEAN CONCRETE FILL	 15 MPa			
- MUD SLAB	 15 MPa	(EXPOSURE (	CLASS F-	-1)
- FOOTINGS				
- PIERS, WALLS & CURBS				
- SLABS ON GRADE (INTERIOR)				
- SLABS ON GRADE (EXTERIOR)				
- EXTERIOR APRONS	 35 MPa(	EXPOSURE (	CLASS C	-1) <sup>′</sup>

3. MINIMUM CONCRETE COVER TO REINFORCING BARS:

CONCRETE CLEAR COVER (CSA A23.1						
EXPOSURE CONDITION	EXPOSURE CLASS					
	N	F-1	C-1			
CAST AGAINST AND PERMANENTLY EXPOSED TO EARTH, INCLUDING FOOTINGS AND PILES	75 mm	75 mm	75 mm			
BEAMS, GIRDERS, COLUMNS AND PILES	30 mm (#1)	40 mm	60 mm			
SLABS, WALLS, JOISTS, SHELLS AND FOLDED PLATES	20 mm (#1)	40 mm	60 mm			
RATIO OF COVER TO NOMIMAL BAR DIAMETER (#2)	1.0 (#1)	1.5	2.0			
RATIO OF COVER TO NOMIMAL MAXIMUM AGGREGATE SIZE	1.0 (#1 & #3)	1.5	2.0			

#### IOTES:

- #1. THIS REFERS ONLY TO CONCRETE THAT WILL BE CONTINUALLY DRY WITHIN THE CONDITIONED SPACE (i.e., MEMBERS ENTIRELY WITHIN THE VAPOUR BARRIER OF THE BUILDING ENVELOPE).
- #2. THE COVER FOR A BUNDLE OF BARS SHALL BE THE SAME AS THAT FOR A SINGLE BAR WITH AN EQUIVALENT AREA.
- #3. THE SPECIFIED COVER FROM SCREEDED SURFACES SHALL BE AT LEAST 1.5 TIMES THE NOMINAL MAXIMUM AGGREGATE SIZE TO REDUCE INTERFERENCE BETWEEN AGGREGATE AND REINFORCEMENT WHERE VARIATIONS IN BAR PLACEMENT RESULT IN A COVER SMALLER THAN SPECIFIED.
- 4. DETAIL, BEND, PLACE AND SUPPORT REINFORCING STEEL IN CONFORMANCE WITH THE LATEST RSIC MANUAL OF STANDARD PRACTICE, UNLESS NOTED OTHERWISE.
- 5. ALTERNATE 90° HOOKS OF CROSSTIES END FOR END OVER HEIGHT OF ALL MEMBERS IN WHICN CROSSTIES ARE SPECIFIED.
- 6. ALL LAP SPLICES SHALL BE CLASS B TENSION SPLICES. FOR HORIZONTAL REINFORCEMENT THAT WILL BE PLACED IN SUCH A WAY THAT MORE THAN 300 mm OF FRESH CONCRETE IS CAST IN THE MEMBER BELOW THE SPLICE, BAR LOCATION FACTOR (k/1) EQUAL TO 1.3 SHALL BE APPLIED IN DETERMINING CLASS B TENSION SPLICE LENGTH, IN ACCORDANCE WITH APPLICABLE EDITION OF CSA-A23.3.
- PLAIN (UNREINFORCED) CONCRETE EXPOSED TO DEICING CHEMICALS SHALL MEET EXPOSURE CLASS C-2 IN ACCORDANCE WITH APPLICABLE EDITION OF CSA-A23.1.
- 8. REINFORCED CONCRETE EXPOSED TO CHLORIDES SHALL MEET EXPOSURE CLASSIFICATION C-1 IN ACCORDANCE WITH APPLICABLE EDITION OF CSA-A23.1.
- 9. PROVIDE CORROSION INHIBITOR IN ALL CONCRETE OF EXPOSURE CLASS C-1. REFER TO SPECIFICATIONS FOR CORROSION INHIBITOR DOSAGE RATE.
- 10. USE TYPE GU PORTLAND CEMENT FOR ALL CONCRETE, UNLESS NOTED OTHERWISE.
- 11. ALL HORIZONTAL WALL AND GRADE BEAM REINFORCING SHALL BE CONTINUOUS THROUGH PIERS. UNLESS NOTED OTHERWISE, SPLICE TOP BARS AT MID-SPAN AND BOTTOM BARS AT SUPPORTS FOR ALL GRADE BEAMS.
- 12. WHEREVER OPENINGS OCCUR, INTERRUPTING ONE OR MORE REINFORCING BARS, IN SLABS OR WALLS, PROVIDE ADDITIONAL REINFORCING STEEL EQUAL TO THE REINFORCING STEEL DISPLACED BY THE OPENING UNLESS OTHERWISE SHOWN. DISTRIBUTE REINFORCEMENT EQUALLY ON EACH SIDE OF THE OPENING AND EXTENDING THE FULL SPAN LENGTH.
- 13. NO SLEEVES, PIPES, HOLES OR NOTCHES SHALL BE PLACED IN OR THROUGH WALLS, COLUMNS, PIERS, BEAMS, GRADE BEAMS, SLABS, FOOTINGS, OR ANY OTHER CONCRETE MEMBER, EXCEPT AS SHOWN ON THE STRUCTURAL DRAWINGS OR APPROVED BY THE ENGINEER.
- 14. DO NOT PLACE CONCRETE FOOTINGS OR ANY OTHER CONCRETE MEMBER UNTIL ALL DESIGNATED REINFORCING STEEL HAS BEEN PLACED AND INSPECTED AND ANY CONDUITS, PIPING OR OTHER EMBEDDED ITEMS ARE INSTALLED AND VERIFIED.
- 15. MAXIMUM WATER-TO-CEMENTING MATERIALS RATIO (w/cm) SHALL BE 0.55, AND MINIMUM 28-DAY COMPRESSIVE STRENGTH SHALL BE 25 MPa FOR ALL CONCRETE FLOOR SLABS (BOTH SLABS ON GRADE AND SLABS ON DECK).

#### **FOUNDATION:**

- ALL INT. FOOTINGS SHALL BEAR ON NATIVE MATERIAL OR ENGINEERED FILL WITH MINIMUM SLS BEARING RESISTANCE OF 150 kPa AND MINIMUM ULS BEARING RESISTANCE OF 200 kPa, NOTED OTHERWISE.
- 2. ALL EXT. FOOTINGS SHALL BEAR ON SUITABLE FOUNDING MATERIAL WITH MINIMUM SLS BEARING RESISTANCE OF 150 kPa, MINIMUM ULS BEARING RESISTANCE OF 200 kPa, FRICTION ANGLE OF AT LEAST 35 ° AND MINIMUM FACTORED SLIDING RESISTANCE OF 150 . MAX. ALLOWABLE TOTAL SETTLEMENT TO BE 25 mm. MAX. ALLOWABLE DIFFERENTIAL SETTLEMENT TO BE 25 mm.
- 3. ALL BEARING VALUES AND GEOTECHNICAL INFORMATION ARE BASED ON GEOTECHNICAL REPORT SEE PER BUILDING NOTES IF APPLICABLE
- THE CONTRACTOR SHALL PROTECT SOIL FROM WATER AND FREEZING ADJACENT TO AND BELOW ALL FOOTINGS, GRADE BEAMS AND OTHER CONCRETE POURS WITH MINIMUM 1200 mm SOIL COVER OR EQUIVALENT.
- 5. ALL EXCAVATIONS AND FOUNDING MATERIAL SHALL BE INSPECTED AND APPROVED BY A QUALIFIED SOILS ENGINEER PRIOR TO CONCRETE PLACEMENT.
- 6. THE CONTRACTOR SHALL PROVIDE ALL SHORING WHERE REQUIRED DURING EXCAVATION TO PREVENT CAVE-IN.
- 7. EXCAVATION SHALL NOT EXTEND BELOW A LINE EXTENDING DOWN AND AWAY FROM ANY FOOTING EDGE OR CORNER AT A RATIO OF 7 VERTICAL TO 10 HORIZONTAL.
- 8. ANY OVER EXCAVATION NECESSITATED BY LOCAL SOFT AREAS OR OTHER DELETERIOUS CONDITIONS SHALL BE MADE GOOD WITH 15 MPa LEAN CONCRETE FILL.
- 9. FOUNDATION WALL BACKFILL SHALL BE OPSS TYPE 1 GRANULAR 'B' OR APPROVED FREE-DRAINING, IN-SITU MATERIAL COMPACTED, IN LAYERS NOT TO EXCEED 200 mm, TO 98% STANDARD PROCTOR MAXIMUM DRY DENSITY.
- 10. BACKFILL TO PROCEED SIMULTANEOUSLY ON BOTH SIDES OF FOUNDATION WALLS UNLESS TEMPORARY SUPPORT IS PROVIDED. DO NOT BACKFILL UNTIL CONCRETE HAS ATTAINED 75% OF ITS SPECIFIED 28-DAY COMPRESSIVE STRENGTH.
- 11. CONSTRUCTION JOINTS AND CONTROL JOINTS IN REINFORCED FOUNDATION WALLS SHALL BE LOCATED AT THE EDGE OF PIERS (WHERE PIERS ARE PRESENT). MAXIMUM SPACING OF CONSTRUCTION JOINTS SHALL BE AS REQUIRED, BUT NOT GREATER THAN 20 m. UNLESS NOTED OTHERWISE. MAXIMUM SPACING OF CONTROL JOINTS SHALL BE 6 m, AND 3 m FROM CORNERS.
- 12. FOUNDATIONS SHALL BE CONSTRUCTED AS SHOWN ON THE DRAWINGS. CONTRACTOR SHALL INCLUDE IN THEIR WORK ALL PROVISIONS, INCLUDING BUT NOT LIMITED TO EXCAVATION AND FORMING, AS REQUIRED TO CONSTRUCT FOUNDATIONS THUS.

#### SLAB ON GRADE & PAD:

- 1. SEE PLAN FOR SLAB ON GRADE & PAD THICKNESS.
- 2. PLACE SLAB ON GRADE ON MIN. 200 mm OPSS GRANULAR 'A' COMPACTED TO 100% STANDARD PROCTOR MAXIMUM DRY DENSITY.
- 3. PRIOR TO PLACING GRANULAR FILL MATERIALS, PROOF-ROLL EXISTING SUB-GRADE TO IDENTIFY INCONSISTENCIES OR SOFT AREAS. PROCEED WITH GRANULAR PLACEMENT ONLY AFTER THESE AREAS HAVE BEEN REWORKED AND COMPACTED TO THE SATISFACTION OF THE SOILS ENGINEER.
- 4. DO NOT PLACE CONCRETE UNTIL ALL ELECTRICAL, MECHANICAL AND PROCESS CONDUITS, PIPING OR OTHER EMBEDDED SERVICES ARE INSTALLED AND VERIFIED.
- 5. AGREE ON LOCATION OF CONSTRUCTION JOINTS WITH ENGINEER PRIOR TO CONSTRUCTION.
- 6. PROVIDE SAWCUT CONTROL JOINTS AS SHOWN ON PLANS.
- 7. PROVIDE EXTERIOR COLUMN ISOLATION JOINTS AND SAWCUTTING AS PER DETAILS SHOWN.
- 8. PERFORM SAWCUTTING FOR CONTROL JOINTS USING DRY METHOD (SOFF-CUT SAW) AS SOON AS POSSIBLE AFTER CONCRETE PLACEMENT WITHOUT LEAVING TREAD MARKS, DISLODGING AGGREGATE AND BEFORE UNCONTROLLED SHRINKAGE OCCURS. FILL CONTROL JOINTS, AS SPECIFIED, NO SOONER THAN 120 DAYS AFTER CONCRETE PLACEMENT.
- 9. FLOOR FINISH: SEE SPECIFICATIONS.

#### METAL DECK:

- ALL METAL DECK SHALL BE NEW AND SHALL BE DESIGNED, FABRICATED AND INSTALLED TO CONFORM TO THE REQUIREMENTS OF THE APPLICABLE EDITION OF CAN/CSA-S136 "NORTH AMERICAN SPECIFICATIONS FOR THE DESIGN OF COLD FORMED STEEL STRUCTURAL MEMBERS (USING THE APPENDIX B PROVISIONS APPLICABLE TO CANADA)" AND THE REQUIREMENTS OF THE CANADIAN SHEET STEEL BUILDING INSTITUTE.
- 2. ALL ROOF AND FLOOR DECK SHALL BE DESIGNED AND DETAILED BY A PROFESSIONAL ENGINEER LICENSED TO PRACTICE IN THE PROVINCE OF ONTARIO, AND SHALL BE OF THICKNESS REQUIRED TO SUPPORT ALL LOADS AND EFFECTS SHOWN ON DRAWINGS BUT SHALL NOT BE LESS THAN THAT SHOWN ON DRAWINGS. AFOREMENTIONED DESIGN SHALL INCLUDE APPLICABLE SEISMIC LOADS & EFFECTS. REFER TO SPECIFICATION FOR COATING.
- 3. SPAN DECK UNITS OVER FOUR OR MORE STRUCTURAL SUPPORTS (MINIMUM 3 CONTINUOUS SPANS) FOR INCREASED RIGIDITY.
- 4. DESIGN AND CONNECT METAL EDGE AND CLOSURE STRIPS TO SAFELY RESIST CONSTRUCTION LOADS AND PREVENT THE LOSS OF CONCRETE/GROUT WHEN DECK IS CONCRETED.
- 5. PLACE DECK IN ACCORDANCE WITH MANUFACTURER'S SHOP DRAWINGS. END LAPS SHALL ALWAYS OCCUR OVER SUPPORTS. SIDE LAPS SHALL BE ON HALF CORRUGATION. MINIMUM ROOF DECK END LAP IS 50 mm FOR WELDED ATTACHMENT.
- ALL CONNECTIONS OF ROOF DECK TO SUPPORTING STRUCTURE SHALL BE DESIGNED BY A
  PROFESSIONAL ENGINEER LICENSED TO PRACTICE IN THE PROVINCE OF ONTARIO TO RESIST ALL
  LOADS AND EFFECTS SHOWN ON DRAWINGS, BUT SHALL NOT BE LESS THAN THAT SHOWN ON
  DRAWINGS.
- 7. ATTACH DECK UNITS TO TOP OF SUPPORTS BY FUSION WELDS WITH A MINIMUM EFFECTIVE DIAMETER OF 19 mm. MAXIMUM SPACING OF FUSION WELDS AND SIDE LAP BUTTON CLINCH SHALL BE AS FOLLOWS:
- WELDS AT 150 C/C (EACH FLUTE) TRANSVERSE TO SPAN OF DECK AND AROUND PERIMETER.
- LONGITUDINAL WELDS @ 600 C/C - SIDE LAP BUTTON CLINCH @ 300 C/C
- 8. FIELD CUTTING OF DECK UNITS SHALL BE DONE IN WORKMANLIKE MANNER. CUT OPENINGS AND REINFORCE EDGES AS REQUIRED FOR PIPES, DUCTS, ETC. THE MAXIMUM SIZE OF AN UNREINFORCED OPENING IS 150 mm SQUARE OR IN DIAMETER. ROOF OPENINGS LARGER THAN 450 mm WIDE AND FLOOR OPENINGS LARGER THAN 300 mm WIDE SHALL BE SUPPORTED BY STEEL FRAMING.
- 9. DESIGN METAL ROOF DECK FOR MAXIMUM LIVE, SNOW AND RAIN LOAD DEFLECTIONS OF L/360.

#### MASONRY:

- 1. THE DESIGN AND CONSTRUCTION OF ALL WORK ON THIS PROJECT IS TO CONFORM TO APPLICABLE EDITION OF CSA STANDARDS CSA-S304.1, CSA-A370, CSA-A371, CSA-A179 AND CAN/CSA-G30.18. PROVIDE TYPE S MORTAR IN ACCORDANCE WITH APPLICABLE EDITION OF CSA STANDARD CSA-A179.
- 2. PROVIDE STANDARD, HOLLOW 15 MPa CONCRETE BLOCK UNITS UNLESS NOTED OTHERWISE. AT LOCATIONS WHERE VERTICALLY-REINFORCED MASONRY IS SPECIFIED, PROVIDE ONE ADDITIONAL VERTICAL BAR OF SIZE EQUAL TO DISTRIBUTED VERTICAL REINFORCING, FULL HEIGHT AT EACH SIDE OF CONTROL JOINTS, AND AT CORNERS, INTERSECTIONS, ENDS OF WALLS AND TO EACH SIDE OF ALL OPENINGS, UNLESS NOTED OTHERWISE. PROVIDE 2 ADDITIONAL BARS WHERE OPENING WIDTH IS GREATER THAN 1200 mm. PROVIDE MATCHING DOWELS TO FOOTING, SLAB THICKENING, SLAB ON DECK OR OTHER SUPPORTING STRUCTURE, FOR ALL VERTICAL WALL REINF. (TYP. U/N).
- 3. FOR HIGH-LIFT GROUTING, PROVIDE CLEAN-OUT HOLES IN BOTTOM COURSE AND MINIMUM SLUMP OF 200 mm.
- 4. MASONRY GROUT SHALL BE FINE GROUT, AND SHALL BE PROPORTIONED ACCORDING TO, AND MEET ALL REQUIREMENTS OF APPLICABLE EDITION OF CSA-A179.
- 5. PROVIDE CONTINUOUS, HORIZONTAL, STANDARD LADDER-TYPE HORIZONTAL JOINT REINFORCEMENT @ 400 mm C/C, IN BOTTOM TWO BED JOINTS, TOP TWO BED JOINTS AND FIRST BED JOINT ABOVE AND BELOW ALL WALL OPENINGS. ALL SUCH REINF. SHALL BE SPLICED USING CLASS B TENSION LAP SPLICES (AS DEFINED IN APPLICABLE EDITION OF CSA-S304.1). PREFABRICATED CORNER AND INTERSECTION JOINT REINFORCING PIECES SHALL BE USED. MINIMUM WIRE DIAMETER TO BE 3.65 mm.
- 6. REFER TO ARCHITECTURAL DRAWINGS FOR LOCATION OF ALL MASONRY WALLS.
- 7. PROVIDE VERTICAL REINFORCING IN ALL MASONRY WALLS AS PER TABLE ON SPECIFIC BLD. DRAWING ALL REINFORCED CORES SHALL BE GROUTED SOLID FOR FULL HEIGHT OF WALLS. VERTICALLY-CANTILEVERED WALLS SHALL BE CONSTRUCTED OF SOLID-GROUTED MASONRY.
- 8. PROVIDE VERTICAL REINFORCING AT EACH LATERAL SUPPORT LOCATION (SEE BLD. SPECIFIC DRW.)
- 9. LAP ALL 15M BARS 675 mm MINIMUM. LAP ALL 20M BARS 850 mm MINIMUM.
- 10. UNLESS NOTED OTHERWISE, MINIMUM CLEARANCE OF XX mm SHALL BE PROVIDED BETWEEN MASONRY WALLS AND STEEL COLUMNS, BEAMS, GIRDERS, JOIST AND GIRTS. THIS REQUIREMENT DOES NOT APPLY WHERE MASONRY IS INTENDED (BY DESIGN) TO BEAR ON STEEL MEMBER.
- 11. WHERE POST-INSTALLED ANCHORS ARE INSTALLED IN MASONRY ELEMENTS/MEMBERS, EXISTING REINFORCING STEEL (INCLUDING HORIZONTAL BED JOINT REINFORCING), CAST-INS AND EMBEDDED ITEMS SHALL BE ACCURATELY LOCATED, AND EDGE OF ANCHOR HOLES SHALL BE LOCATED A DISTANCE AWAY FROM EXISTING REINFORCING STEEL (INCLUDING HORIZONTAL BED JOINT REINFORCING), CAST-INS END EMBEDDED ITEM SUCH THAT AT LEAST MINIMUM CONCRETE COVER REQUIREMENTS (SEE MASONRY NOTE #1) ARE MET. EXISTING REINFORCING STEEL (INCLUDING HORIZONTAL BED JOINT REINFORCING), CAST-INS AND EMBEDDED ITEMS SHALL NOT BE DAMAGED ANCHORING ACTIVITIES, INCLUDING DRILLING.
- 12. MORTAR SHALL BE TYPE :S: PREPARED BY PROPORTION SPECIFICATION IN ACCORDANCE WITH CAN/CSA-A179.
- 13. HOLLOW CONCRETE BLOCK MASONRY WITH MORTAR TYPE "S" SHALL HAVE A MINIMUM ULTIMATE COMPRESSIVE STRENGTH OF 12.5 MPa - f'm.
- 14. ALL INTERSECTING MASONRY WALLS TO HAVE MASONRY BOND OR HEAVY DUTY (BLOCK-LOCK) OR EQUIVALENT AT 200mm VERTICALLY MAXIMUM.
- 15. A MINIMUM 50 mm WIDE ISOLATION JOINT SHALL BE PROVIDED AT ALL LOCATIONS WHERE MASONRY WALLS INTERSECT VERTICAL FACES OF CONCRETE STRUCTURE. NO POSITIVE CONNECTION BETWEEN MASONRY MASONRY WALLS AND VERTICAL FACES OF CONCRETE STRUCTURE SHALL BE MADE.
- 16. CONCRETE AND STEEL BEAMS BEARING ON MASONRY WALLS SHALL HAVE A MINIMUM BEARING OF 200mm UNLESS OTHERWISE NOTED ON PLAN.
- 17. PROVIDE 15M DOWELS WITH 150 mm MIN. EMBEDMENT TO THE EXISTING SLAB TO MATCH ALL VERTICAL REINFORCING, UNLESS NOTED OTHERWISE. SCAN EXISTING SLAB PRIOR TO DOWEL INSTALLATION.
- 18. PROVIDE LINTELS OVER ALL OPENINGS AND RECESSES FOR MECHANICAL AND ELECTRICAL TRADES AS SPECIFIED ON PLANS. SEE ARCHITECTURAL AND MECHANICAL DRAWINGS FOR LOCATIONS AND SIZES OF OPENINGS AND RECESSES.
- 19. PROVIDE VERTICAL REINFORCEMENT IN ALL NON-LOAD BEARING CMU WALLS AS FOLLOWS IN ADDITION TO THAT NOTED IN (2):

O IN (2):

WALL THK. MAX HEIGHT. REINFORCEMENT.

140mm 4200mm 15M@600

190mm 5500mm 15M@600

240mm 6000mm 15M@600

CITY OF TORONTO

Corporate Real Estate Management
Project Management Office
Metro Hall Toronto, ON
M5V 3C6

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No.	DESCRIPTION	DATE
Α	50% SUBMISSION	2022-04-27
В	90% SUBMISSION	2022-07-29
С	ISSUED FOR PERMIT	2022-07-29
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PROJECT TITLE
CITY OF TORONTO
ACCESSIBILITY UPGRADES

PROJECT ADDRESS

DRAWN BY:

G. POULOU

PROJECT NO: 9119- 19- 0162 / Arcadis 30279056

PROJECT MGR: APPROVED BY: N. FRISCIC K. ANGER
SHEET TITLE

SHEET NUMBER

STRUCTURAL - GENERAL NOTES

G05-GAL-G2000 [

CHECKED BY:

M. FAYAZI

/29/2025 10:56:29 AI

#### REINFORCING STEEL

- 1 ALL REINFORCING STEEL SHALL CONFORM TO CAN/CSA-G30.18-M-2009 (R2014), GRADE
- 2 MINIMUM CLEAR SPACING BETWEEN PARALLEL REINFORCING BARS SHALL BE 1.4 TIMES THE BAR DIAMETER, 1.4 TIMES THE MAX. AGGREGATE SIZE OR 30mm WHICHEVER IS GREATER. PROVIDE 75mm MINIMUM LAPPED REBAR CLEARANCE FOR CONCRETE VIBRATOR ACCESS.
- DEVELOPMENT LENGTHS AND LAP SPLICES SHALL BE IN ACCORDANCE WITH THE REINFORCING STEEL INSTITUTE OF CANADA, MANUAL OF STANDARD PRACTICE UNLESS INDICATED OTHERWISE. ALL LAP SPLICES SHALL BE CLASS 'B' TENSION LAP SPLICES AND CLASS 'B' TENSION LAP SPLICES SHALL BE PROVIDED FOR ALL SHRINKAGE AND TEMPERATURE BARS. WHERE TWO BARS OF DIFFERENT DIAMETERS ARE LAPPED, PROVIDE CLASS 'B' TENSION LAP LENGTH CORRESPONDING TO THE SMALLER BAR BUT NO LESS THAN FULL TENSION DEVELOPMENT LENGTH OF THE LARGER BAR.
- 4 PROVIDE EMBEDMENT LENGTH FOR FULL TENSION DEVELOPMENT IN ACCORDANCE WITH CSA A23.3
- 5 DEVELOPMENT LENGTH AND SPLICE LENGTH FOR FY = 400MPa AND F'C=35MPa TO BE AS PER TABLE BELOW, UNLESS OTHERWISE SHOWN ON DRAWINGS.


	fc' = 35MF	Pa	fy = 400M	fy = 400MPa					
		TENSIO	N STEEL		COMPRESSION STEEL				
BAR SIZE	HORIZONTAL TO	P BARS*	ALL OTHER E	BARS**	COMPRESSI	COMPRESSION STEEL			
	DEVELOPMENT	SPLICES	DEVELOPMENT	SPLICES	DEVELOPMENT	LAP SPLICES			
(mm)									
(******)	(mm)	(mm)	(mm)	(mm)	(mm)	(mm)			
10	360	470	280	370	200	330			
15	510	670	390	510	290	470			
20	620	810	480	630	350	590			
25	1000	1300	770	1010	450	740			
30	1190	1550	910	1190	530	880			
35	1420	1850	1090	1420	630	1050			
45	-	-	-	-	800	-			

REFERENCE: CAN/CSA A23.3-14

- db= MAX. OF NORMAL AND ACTUAL BAR DIAMETER
- \* HORIZONTAL TOP BARS WITH MORE THAN 300mm OF FRESH CONCRETE POURED BELOW
- THE BARS. AND WALL HORIZONTAL REINFORCEMENT.
- \*\* HORIZONTAL BARS WITH NOT MORE THAN 300mm OF FRESH CONCRETE POURED BELOW THE BARS, VERTICAL BARS.
- 6 STANDARD 90° HOOK TO CONFORM TO A23.3 AND THE FOLLOWING TABLE, WHICHEVER IS MORE STRINGENT, UNLESS OTHERWISE SHOWN ON DRAWINGS.

#### STANDARD 90° HOOK DIMENSION

fc' = 35	5MPa	fy = 400MPa		
BAR SIZE	BAR SIZE D***		I <sub>dh</sub> ****	
d <sub>b</sub>				
(mm)	(mm)	(mm)	(mm)	
10M	70	190	150	
15M	100	260	190	
20M	120	320	240	
25M	150	410	300	
30M	250	520	360	
35M	300	620	430	

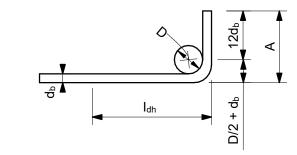

90° HOOK SEE A23.3

\*\*\* SEE A23.1, TABLE 16 \*\*\*\* SEE A23.3, §12.5.1, §12.5.3 (b) =  $0.7x100d_b$  / fc<sup>0.5</sup> > 150 OR 8 d<sub>b</sub>.

#### STRUCTURAL STEEL:

- 1. THE DESIGN AND CONSTRUCTION OF ALL WORK IN THIS PROJECT SHALL CONFORM TO THE APPLICABLE EDITION OF CAN/CSA-S16.
- 2. ALL SHOP CONNECTIONS SHALL BE WELDED. ALL FIELD CONNECTIONS SHALL BE WELDED OR BOLTED USING HIGH TENSILE-STRENGTH BOLTS, BEARING TYPE. WHERE APPLICABLE, AND UNLESS NOTED OTHERWISE, CONNECTIONS SHALL BE CISC DOUBLE ANGLE BEAM CONNECTIONS FOR A325 BOLTS AND E49XX FILLET WELDS, MINIMUM SIZE OF BOLTS - M20 DIAMETER.
- 3. ALL WELDING SHALL BE CARRIED OUT IN ACCORDANCE WITH APPLICABLE EDITION OF FOLLOWING CSA STANDARDS:
- W47.1 FOR QUALIFICATIONS OF WELDERS
- W48.1 TO W48.7 FOR ELECTRODES - W59 FOR DESIGN AND WORKMANSHIP
- 4. ALL COLUMN ENDS SHALL BE SAWCUT AND WELDED TO BASE/CAP PLATES.
- 5. ALL COLUMNS TO HAVE ANGLES AT TOP TO SUPPORT STEEL DECK WHERE REQUIRED.
- 6. BRACING MEMBERS SHALL BE CONNECTED FOR THE FOLLOWING (WHICHEVER IS LARGER): - 50% OF THE NOMINAL TENSION CAPACITY OF THE MEMBER BASED ON GROSS AREA
- FORCES AS SHOWN ON THE DRAWINGS - A MINIMUM OF TWO BOLTS
- 7. FOR DOUBLE-ANGLE BRACING (E.G. CROSS-BRACING), ANGLES SHALL HAVE INTERCONNECTING BATTENS AND/OR SPACERS SUCH THAT SLENDERNESS RATIO OF INDIVIDUAL ANGLES (BASED ON LEAST RADIUS OF GYRATION OF INDIVIDUAL ANGLES) DOES NOT EXCEED SLENDERNESS RATIO OF BUILT-UP (DOUBLE-ANGLE) MEMBER.
- 8. THE CONTRACTOR SHALL SUPPLY, INSTALL, MAINTAIN AND REMOVE ANY TEMPORARY BRACING REQUIRED DURING CONSTRUCTION.
- 9. FORCES ARE DESIGNATED BY (+) FOR TENSION AND (-) FOR COMPRESSION.
- 10. CONNECTIONS FOR BEAMS, GIRDERS AND JOISTS SUBJECT TO AXIAL FORCES SHALL BE DESIGNED FOR THE AXIAL FORCES IN ADDITION TO THE SHEAR FORCES, MOMENT FORCES/EFFECTS AND TORSION FORCES/EFFECTS. FORCES INDICATED ARE FACTORED AND IN kN. MOMENTS AND TORSIONS INDICATED ARE FACTORED AND IN kN-m.
- 11. ALL EXTERIOR STEEL, AND STEEL THAT IS NOT IN A TEMPERATURE AND HUMIDITY CONTROLLED ENVIRONMENT, SHALL BE HOT-DIPPED GALVANIZED (BOTH STRUCTURAL STEEL AND MISCELLANEOUS STEEL). THIS SHALL INCLUDE NUTS, BOLTS, WASHERS, BASE PLATES, LEVELING PLATES, ANCHOR BOLTS AND ANCHORS.
- 12. FILLER BEAMS AND JOISTS SHALL BE PLACED EQUALLY BETWEEN ESTABLISHED DIMENSIONS, UNLESS NOTED OTHERWISE.
- 13. PROVIDE WELDED STIFFENER PLATES ON BOTH SIDES OF THE WEB OF BEAMS AND GIRDERS AT POINTS OF CONCENTRATED LOAD, INCLUDING BEAMS AND GIRDERS SUPPORTING COLUMNS OR RUNNING OVER TOPS OF COLUMNS. MINIMUM STIFFENER PLATE THICKNESS SHALL BE 10 mm OR FLANGE THICKNESS OF COLUMNS ABOVE OR BELOW, WHICHEVER IS GREATER. MINIMUM SIZE OF WELD SHALL BE 5 mm DOUBLE FILLET WELD, OR SHALL BE SUFFICIENT TO DEVELOP THE FULL STRENGTH OF THE STIFFENER, WHICHEVER IS GREATER.
- 14. FOR LOCATIONS OF DOOR FRAMES, WALL OPENINGS, ROOF AND FLOOR OPENINGS, ETC., AND RELATED DETAILS, SEE ARCHITECTURAL, MECHANICAL, ELECTRICAL, PROCESS & CIVIL DRAWINGS.
- SHOWN ON PLANS DENOTES AXIAL LOADS ALONG BEAMS AND GIRDERS DUE TO WIND OR EARTHQUAKE LOADS. DESIGN BEAM-TO-BEAM, BEAM-TO-GIRDER AND GIRDER-TO-GIRDER CONNECTIONS, AS WELL AS BEAM-TO-COLUMN AND GIRDER-TO-COLUMN CONNECTIONS FOR THESE LOADS IN COMBINATION WITH APPLICABLE GRAVITY LOADS.
- 16. PERIMETER ROOF ANGLE SHALL BE CONTINUOUS AND BUTT WELDED TOGETHER AT JOINTS. ENSURE CONNECTION OF PERIMETER ANGLE TO SUPPORTING STRUCTURE IS SUFFICIENT TO RESIST MAXIMUM UNIT SHEAR FROM DECK DIAPHRAGM. REFER TO ROOF-DIAPHRAGM SHEAR DIAGRAM ON DRAWINGS
- 17. ALL WELDABLE REINFORCING STEEL ANCHORS SHALL BE WELDED TO BASE PLATES/BEARING PLATES TO FULLY DEVELOP BARS IN TENSION.
- 18. REFER TO SPECIFICATIONS FOR BEAM AND GIRDER CAMBER REQUIREMENTS.

#### ABBREVIATIONS:

2L	two angles	HP	high point
AB	anchor bolt	HS	high strength
ADD	addendum	ID :-	inside diameter
ADJ	adjacent	IE 	invert elevation
AFF	above finished floor	IF IN	inside face
AHU	air handling unit	IN	inches
ALT	alternate	INCL	include
ANC	anchor	INFO	information
APPROX	approximate	JT	joint
ARCH	architectural	kN kNm	kilonewton
ASTM	American Society	kNm kDe	kilonewton meter
B/B	for Testing and Materials	kPa '	kilopascal
BC	back to back bottom chord	L LB	length
BET	between	LG	pound long
BLDG	building	LL	live load
BLK	block	LLBB	long legs back-to-back
BM	beam	LLH	long leg horizontal
BOF	bottom of footing	LLV	long leg vertical
BOS	bottom of steel	LO	louver opening
BOT	bottom	LP	low point
BRCG	bracing	LS	louver sill
BRG	bearing	m	metre
BRKT	bracket	MACH	machine
BSMT	basement	MAX	maximum
CA	column above	MECH	mechanical
CB	column below	MEZZ	mezzanine
C/C	center to center	MFR	manufacturer
CERT	certified	MIN	minimum
CHKD PL	checkered plate	MISC	miscellaneous
CIP	cast in place	mm	millimetre
CJ	construction joint	MT	metric ton
CL	centerline	NIC	not in contract
CLJ	control joint	NO	number
CLR	clear	NTS	not to scale
COL	column	O/O	out to out
CONC	concrete	OPNG	opening
CONN	connection	OPP	opposite
CONSTR	construction	PC	piece
CONT	continuation (continuous)	PEN	penetration
CONTR	contractor	PL	plate
CSA	Canadian Standards Association	PROJ	projection
CT	cooling tower	PSF	pounds per square foot
CTR	center	PSI	pounds per square inch
C/W	complete with	R	radius
DET	detail	RCB	reinforced concrete beam
DIA	diameter	REF	reference
DIAG	diagonal	REINF	reinforcement
DIM	dimension	REMV	removable
DL	dead load	REQD	required
DO	door opening	RR	railroad
DWG	drawing	R/W	reinforced with
DWL	dowel	SCH	schedule
EA	each	SECT	section
EF	each face	SIM	similar
EL	elevation	SOG	slab on grade
ELEC	electrical	SP	space
EMB	embedment	SPEC	specifications
EQ	equal	SQ	square
EQPT	equipment	SSC	structural steel contract
EW	each way	STAGG	staggered
EXP	expansion	STD	standard
EX	existing	STIFF	stiffener
EXT	exterior	STL	steel
FDN	foundation	STRU	structural
FDNC	foundation contract	SYM	symmetrical
FIN	finish	t T	thickness
FL	floor	T	tread
FLG	flange	T&B	top and bottom
FT	feet	TC	top chord
FTG	footing	TEMP	temperature
FUT	future	THK	thick
GA	gauge	TL	total load
GC CALV	general contract	TOF	top of footing
GALV	galvanized	TOS	top of steel
GENL	general	TYP	typical
GOL	gauge outstanding leg	UON	unless otherwise noted
GR	grade	VERT	vertical
GRT	grating	VIF	vertical inside face
H	high	VOF	vertical outside face
HEF	horizontal each face	W	width (wide)
HGR	hanger	W/	with
HGT	height	W/O	without
HH	hooked-hooked	WP	working point
HIF	horizontal inside face	WPL	wall plate
HOF	horizontal outside face	WS	water stop
HORIZ	horizontal	WT WWF	weight welded wire fabric
		VV VV E	Weiged Wire tabric

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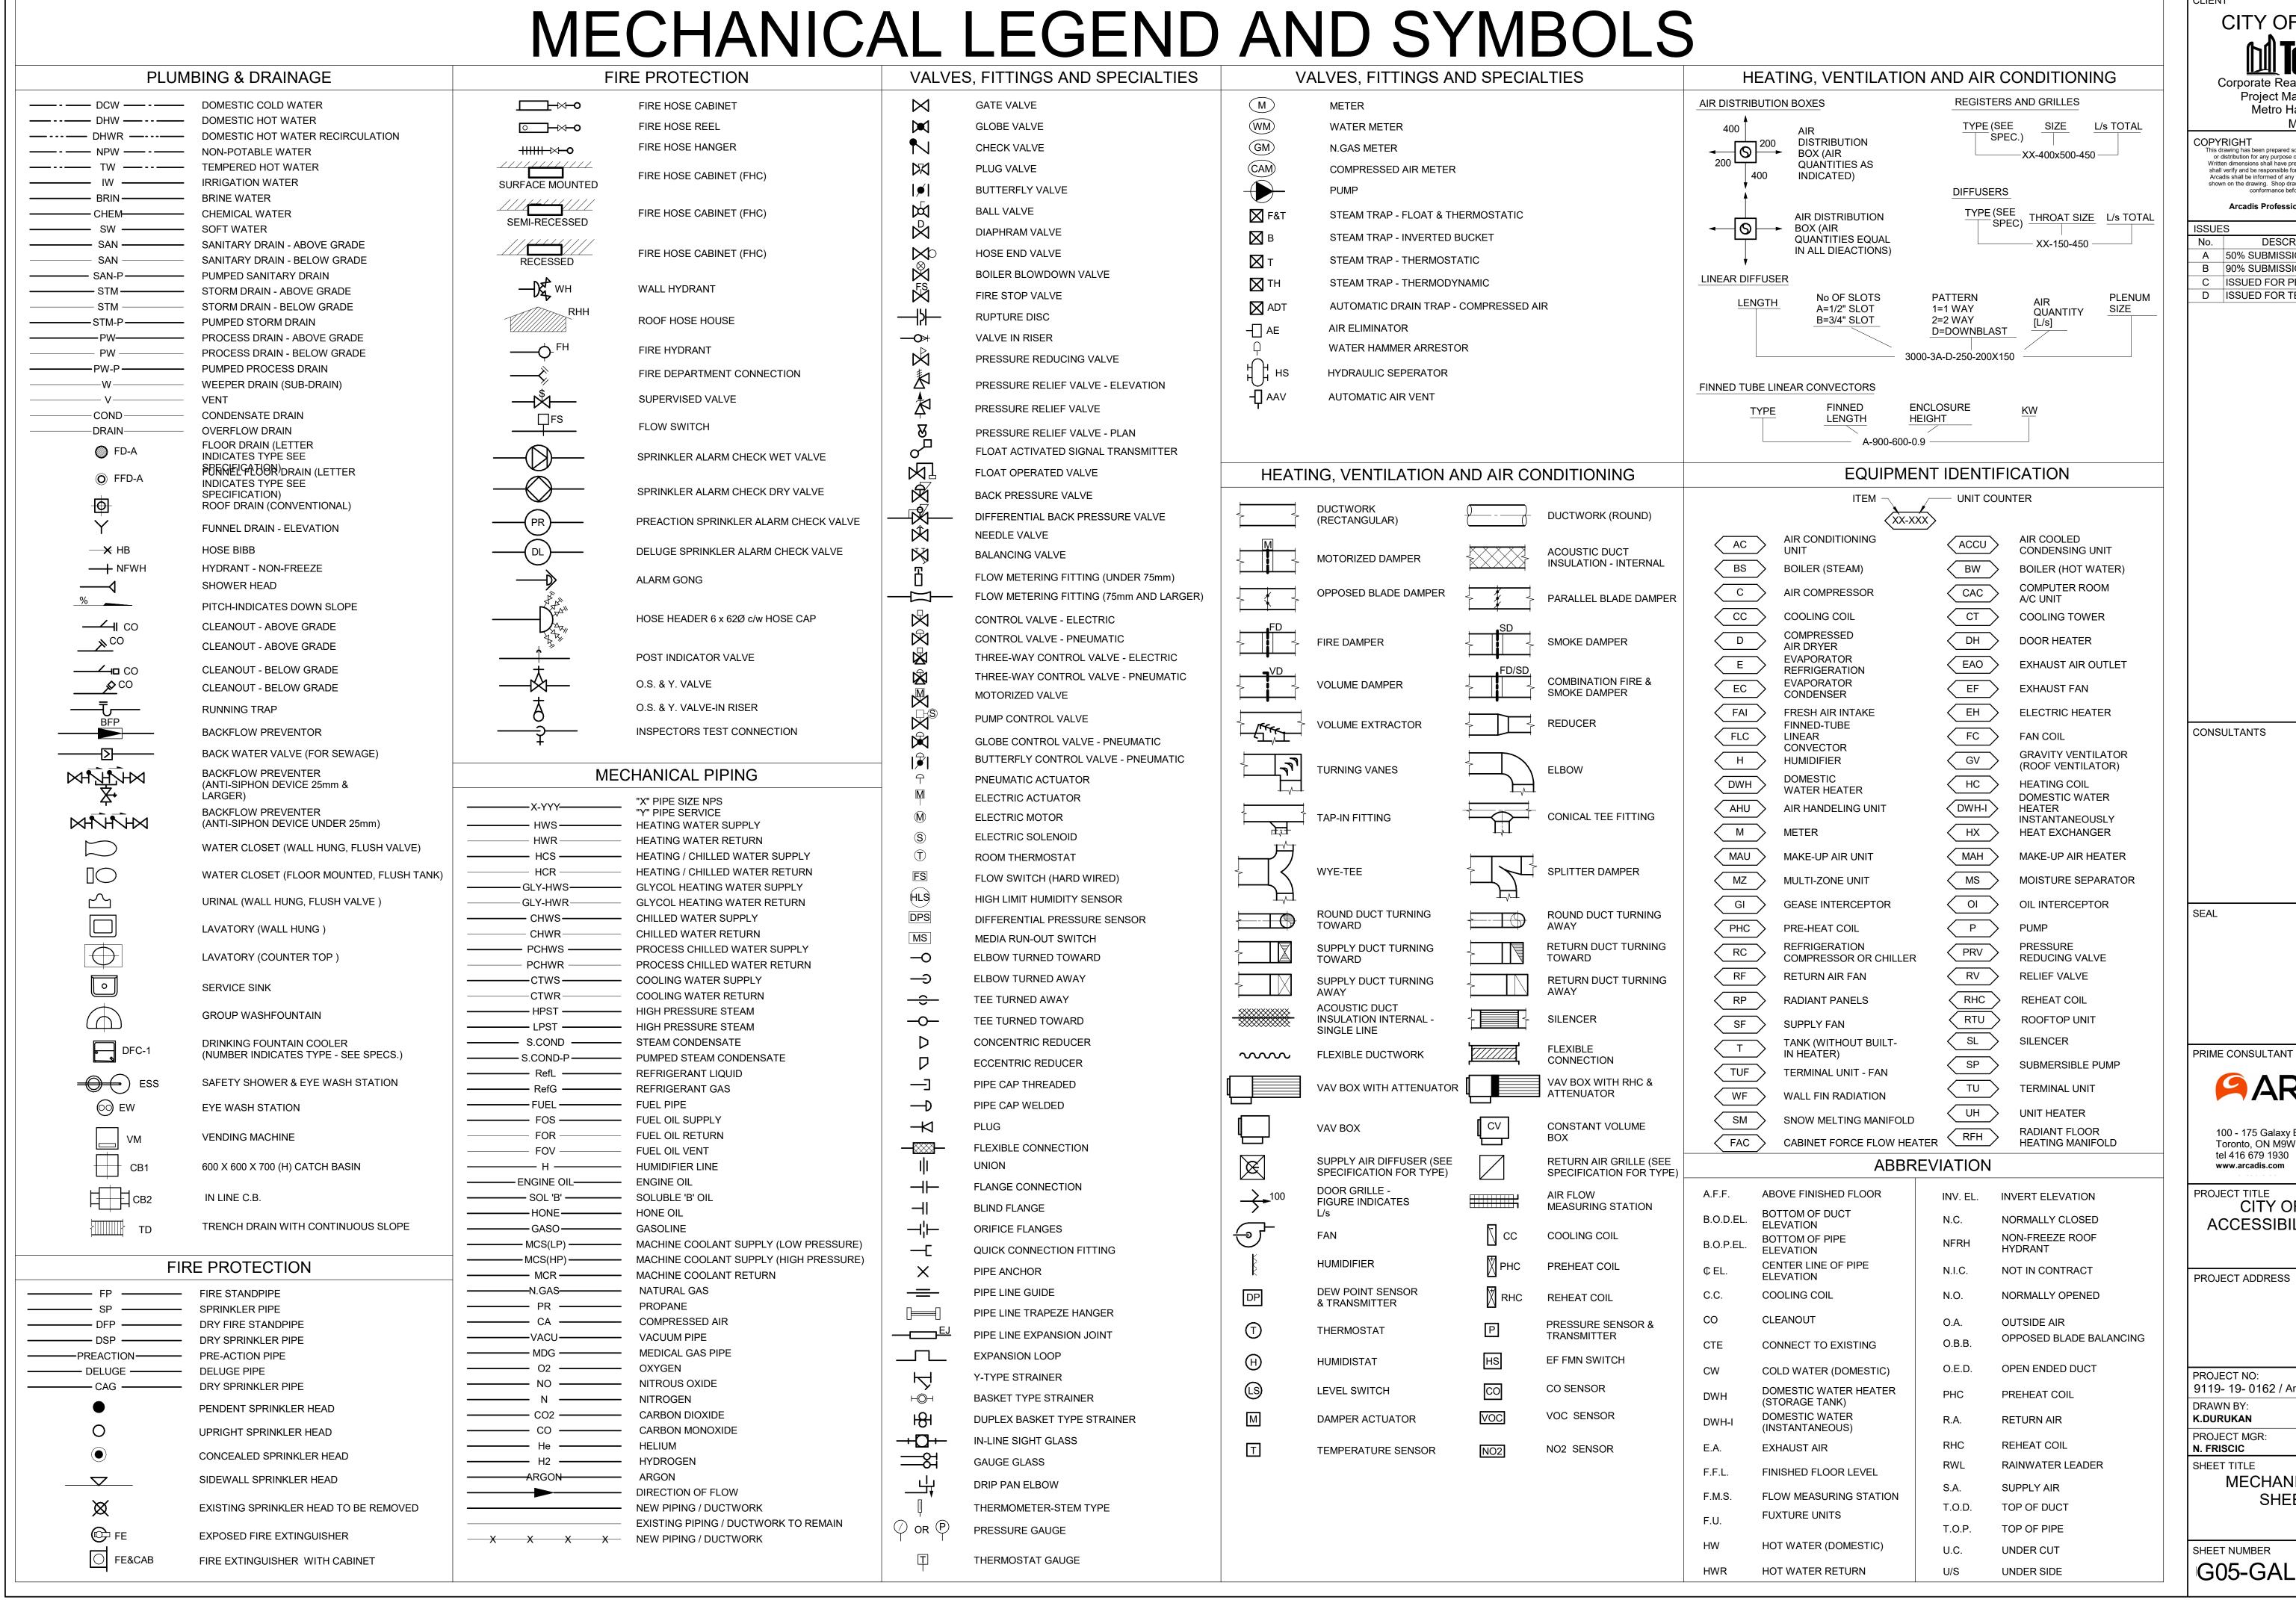
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PROJECT MGR APPROVED BY: N. FRISCIC K. ANGER SHEET TITLE STRUCTURAL - GENERAL NOTES, SYMBOLS &

**ABBREVIATIONS** 

SHEET NUMBER G05-GAL-G2002 E



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PROJECT NO: 9119- 19- 0162 / Arcadis 30279056

DRAWN BY: **K.DURUKAN** PROJECT MGR

N. FRISCIC SHEET TITLE

MECHANICAL LEGEND SHEET 1 OF 2

CHECKED BY:

APPROVED BY:

**B.LIAO** 

S. LIU

SHEET NUMBER G05-GAL-G3001 D


#### CONTROLS POINT FUNCTION ABBREVIATION

	FIRST LETTER		SECOND LETTER		THIRD LETTER		FOURTH LETTER
Α	AIR	А	H-O-A STATUS	Н	HIGH	Н	HIGH
С	COMPRESSED GAD	С	CLOSE	L	LOW	L	LOW
D	DAMPER	E	VOLTAGE	X	TRASMITTER		
Е	EQUIPMENT	F	FIRE (ALARM) SMOKE	Z	INDICATING TRANSMITTER		
G	NATURAL GAS	FL	FLOW	D	DIFFERENTIAL		
L	LIQUID	Н	HUMIDITY				
S	STEAM	I	CURRENT				
V	VALVE	L	LEVEL				
М	MISCELLANEOUS	0	OPEN				
		OL	OVERLOAD				
		OR	OVERRIDE				
		Р	PRESSURE				
		SS	START / STOP				
		ST	STATUS				
		Т	TEMPERATURE				
		V	VELOCITY / SPEED				
		WT	WINDING TEMPERATURE				
		X	POSITION				
		Y	SERIAL COMM'S				

BMS POINT NOTE: IF AN INSTRUMENT IS NOT DESIGNATED AS A TRANSMITTER "X" OR AN INDICATING TRANSMITTER "Z", IT IS A SENSOR OR SWITCH, DEPENDING ON POINT TYPE.

XX - YYYY POINT FUNCTION ABBREVIATION POINT TYPE AI: ANALOG INPUT AO: ANALOG OUTPUT DIGITAL INPUT DO: DIGITAL OUTPUT

HW: HARDWIRED

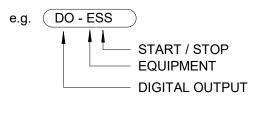

#### **GENERAL NOTES**

FOR ROOF OPENING AND ROOF CURB DETAILS SEE ARCHITECTURAL DRAWINGS.

SC: SERIAL COMMINICATION

- ALL FRESH AIR OR EXHAUST AIR LOUVRES IN BUILDING WALLS BY GENERAL TRADES UNLESS OTHERWISE NOTED. FOR DETAILS SEE ARCHITECTURAL DRAWINGS.
- ALL STORM COLLAR FLASHINGS BY MECHANICAL FOR DETAILS OF FLASHINGS SEE ARCHITECTURAL DRAWINGS.
- THE CONTRACTOR SHALL VERIFY ALL CONDITIONS AND MEASUREMENTS AT THE SITE AND REPORT TO THE OWNER'S REPRESENTATIVE ANY DISCREPANCIES OR UNSATISFACTORY CONDITIONS WHICH MAY ADVERSELY AFFECT THE PROPER COMPLETION OF THE WORK.
- DIMENSIONS SHOWN ARE FOR PREFERRED LOCATION AND GENERAL ARRANGEMENT OF MECHANICAL SYSTEMS. IT SHALL REMAIN THE CONTRACTORS RESPONSIBILITY TO ENSURE OVERALL COORDINATION OF HIS WORK WITH OTHER TRADES. SHOULD DEVIATION FROM LOCATIONS SHOWN ON DRAWINGS BECOME NECESSARY DUE TO CONFLICTS WITH OTHER
- TRADES OR LOCAL PROBLEMS THEY MUST BE BROUGHT TO THE ATTENTION OF THE OWNER'S REPRESENTATIVE FOR APPROVAL PRIOR TO PROCEEDING WITH WORK. THIS IS THE STANDARD SHEET FORM NOT ALL ITEMS ARE ASSOCIATED WITH THIS PROJECT.
- ALL EXISTING SERVICES TO REMAIN UNLESS NOTED OTHERWISE.
- ALL SYSTEMS TO REMAIN FUNCTIONAL UNLESS PERMISSION FOR SHUTDOWN IS GRANTED BY THE OWNER.

#### GENERAL NOTES: PLUMBING & DRAINAGE

- ALL SANITARY DRAINS NPS 4 SIZE & LARGER SHALL SLOPE AT 1.0%, ALL SANITARY DRAINS NPS 3 & SMALLER SHALL SLOPE AT 2%.
- ALL PLUMBING, DRAINAGE & VENTING SHALL BE IN CONFORMANCE WITH PART 7 OF THE O.B.C. AND IS THE RESPONSIBILITY OF THE PLUMBING CONTRACTOR.
- ALL VENTING AND TRAP SEAL PRIMER NOT SHOWN BUT REQUIRED, SHALL BE BY PLUMBING CONTRACTOR. ALL DOMESTIC COLD AND HOT WATER PIPING SHALL BE THERMALLY INSULATED.
- ALL ABOVE GROUND HORIZONTAL RAIN WATER LEADER AND STORM DRAIN SHALL BE THERMALLY INSULATED.

#### GENERAL NOTES: FIRE PROTECTION

- ALL MATERIAL SHALL BE UNDERWRITER'S LABORATORIES OF CANADA (ULC) LISTED AND SHALL COMPLY WITH THE OWNER'S INSURER'S STANDARDS AND REQUIREMENTS AND LOCAL
- FIRE PROTECTION CONTRACTOR TO COORDINATE ON SITE WITH OTHER TRADES BEFORE ANY WORK IS DONE. ANY SERVICE RELOCATION DUE TO INSUFFICIENT COORDINATION TO BE DONE AT NO
- EXTRA COST TO THE OWNER. BEFORE PROCEEDING WITH WORK, DUCTWORK, PIPING AND ELECTRICAL DRAWINGS TO BE STUDIED BY FIRE PROTECTION CONTRACTOR. SHOP DRAWINGS TO REFLECT COORDINATED ELEVATIONS.
- REFER TO MECHANICAL AND ELECTRICAL DRAWINGS FOR SIZE AND LOCATION OF DUCTWORK, PIPING, AND LIGHTING FIXTURES, ETC. DETAILED FIRE PROTECTION DESIGN SHOP DRAWINGS TO BE STAMPED BY PROFESSIONAL ENGINEER LICENSED IN ONTARIO AND TO BE SUBMITTED TO CONSULTANT AND AUTHORITY HAVING
- JURISDICTION FOR REVIEW. PROVIDE TYPE ABC FIRE EXTINGUISHERS AS PER ONTARIO FIRE CODE. FINAL LOCATION TO BE COORDINATED ON FIELD.
- FIRE PROTECTION CONTRACTOR TO PROVIDE PIPE HANGERS AS PER NFPA 13.
- FIRE PROTECTION SYSTEM SHALL BE SUPPLIED AND INSTALLED IN ACCORDANCE WITH THE LATEST EDITION OF NFPA 13. CONTRACTOR TO CONDUCT FLOW TEST AND USE THE RESULTS FOR HYDRAULIC CALCULATIONS.
- HYDRAULIC CALCULATION SHALL START AT FIRE MAIN BUILDING CONNECTION. MAXIMUM SYSTEM PRESSURE TO BE 35KPA (5 PSI) LESS THAN THE PRESSURE TEST RESULT AT REQUIRED FLOW
- RATE, TO ACCOUNT FOR FUTURE FLUCTUATION IN WATER SUPPLY PRESSURE. PIPE DIMENSIONS TO BE DETERMINED BY THE RESULTS OF HYDRAULIC CALCULATION.
- SPRINKLER SYSTEMS TO BE HYDRAULICALLY DESIGNED TO DELIVER THE DENSITIES OVER THE MOST REMOTE AREA AS LISTED IN THE SCHEDULE SPRINKLER COVERAGES INDICATED ARE TO BE CONFIRMED BY FIRE PROTECTION CONTRACTOR.
- PROVIDE SPRINKLER PROTECTION UNDER ALL PLATFORMS INCLUDING BUT NOT LIMITED TO CONVEYORS, STAIRS, CATWALKS, SHELVING PLATFORMS, OVERHEAD DOORS, MEZZANINES, DUCTS OR
- ANY OBSTRUCTIONS WIDER THAN 1200MM. SPRINKLER SHOWN ARE FOR COORDINATION PURPOSE ONLY. FINAL LOCATION OF THE SPRINKLERS TO BE DETERMINED BY FIRE PROTECTION CONTRACTOR BASED ON HYDRAULIC CALCULATIONS.
- USE UPRIGHT SPRINKLER IN SPACE WITHOUT CEILING.
- LOCATE SPRINKLER HEADS IN THE CENTRE OF CEILING TILES.
- SPRINKLER HEAD LOCATION TO BE COORDINATED WITH ARCHITECT PRIOR TO SHOP DRAWING PRODUCTION.
- PIPING AND SPRINKLER HEADS MARKED FOR DEMOLITION TO BE REMOVED AND DISPOSED OF FROM SITE UNLESS OTHERWISE NOTED. REFER TO EXISTING SHOP DRAWINGS.
- ALL EXISTING SPRINKLERS TO BE ADJUSTED TO SUIT NEW BUILDING LAYOUT IN ACCORDANCE WITH NFPA 13. PROVIDE FIRE WATCH DURING SHUT DOWN.

#### GENERAL NOTES: HVAC

- ALL DUCTWORK TO BE INSTALLED TO LOW-PRESSURE DUCTWORK TO S.M.A.C.N.A. STANDARDS.
- DUCTWORK: FABRICATED OF PRIME QUALITY GALVANIZED STEEL SHEETS WITH Z275 (G90) DESIGNATION ZINC COATING TO ASTM A653/A653M
- ALL DUCTWORK C/W SEAL CLASS 'A' AS PER S.M.A.C.N.A. STANDARDS. ALL EXHAUST DUCTWORK SHALL BE THERMALLY INSULATED FOR 1500mm BEFORE EXITING THE BUILDING ENVELOPE.
- ALL FLEXIBLE DUCT TO BE MAXIMUM 3000MM LONG AND INSULATED.
- ALL SUPPLY AIR DUCTWORK INSIDE CEILING SPACE SHALL BE THERMALLY INSULATED. ALL REFRIGERANT LINES SHALL BE THERMALLY INSULATED.
- ALL CONDENSATE DRAIN SHALL BE THERMALLY INSULATED.
- ALL CONTROL WIRING SHALL BE FT-6 RATED.

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PROJECT ADDRESS

K.DURUKAN

PROJECT MGR:

PROJECT NO: 9119- 19- 0162 / Arcadis 30279056 DRAWN BY: CHECKED BY:

APPROVED BY: N. FRISCIC S. LIU SHEET TITLE

MECHANICAL LEGEND SHEET 2 OF 2

**B.LIAO** 

SHEET NUMBER G05-GAL-G3002 D

SYMBOL	DESCRIPTION	SYMBOL	DESCRIPTION	SYMBOL	DESCRIPTION	SYMBOL	DESCRIPTION	SYMBOL	DESCRIPTION
	GENERAL				HEAT TRACING		<u>CCTV</u>		DUDUG ADDDESS & INTEDGOM
	NORTH ARROW		COMBINATION MAGNETIC STARTER	HT-STORM	DIRECT CONNECTION TO HEAT TRACING:  I — HEAT TERACING				PUBLIC ADDRESS & INTERCOM
	ARROW INDICATES PROJECT NORTH		MAGNETIC STARTER  MANUAL STARTER	III	II - PIPE SYSTEM ID STORM		INDOOR PTZ CAMERA		INTERCOM
<u> </u>		\$1	HORSEPOWER RATED MOTOR TOGGLE SWITCH		SANITARY TPL: TRAP SEAL PRIMER	<b>→</b>	INDOOR FIXED CAMERA		C — AUDIO E — EMERGENCY CALL H — HANDSET
N# E-###	NOTE REFERENCE TAG N# — DENOTES NOTE NUMBER E—### — DENOTES DRAWING NUMBER	\$HOA	HORSEPOWER RATED MOTOR HAND/OFF/AUTO SWITCH		DCW: DOMESTIC COLD WATER		OUTDOOR/WALL/ROOF MOUNTED PTZ CAMERA		P — PANEL S — SERVER
	BURIED GROUNDING CONDUCTOR		DISCONNECT SWITCH - NON-FUSIBLE	T <sub>HT</sub>	HEAT TRACING THERMOSTAT	<b>→</b>	OUTDOOR/WALL/ROOF MOUNTED FIXED CAMERA		V — VIDEO  A — AUDIO SIREN & STROBE
<u> </u>	LIGHTNING GROUND CONDUCTOR		FUSED DISCONNECT SWITCH		HEAT TRACING IN LINE TEMPERATURE SENSOR	<b>←⑤</b>	OUTDOOR FIXED CAMERA POLE MOUNTED		D — WITH IMAGE DISPLAY E — ELEVATOR
	GROUND ROD C/W INSPECTION CAN	MD	MOTORIZED DAMPER			<b>1 1 1 </b> ■	OUTDOOR PTZ CAMERA POLE MOUNTED		F — FURNITURE MTD M — MAINTENANCE S — COMMUNICATION STATUS INDICATOR
<b>■</b> *	GROUNDING CONDUCTOR CONNECTION	СР	CONTROL PANEL		LIGHTING			S	PA SPEAKER
<b>€</b> 	AIR TERMINAL (LIGHTNING ROD)	<u> </u>	JUNCTION BOX	L01	TYPICAL LUMINAIRE NOMENCLATURE: LO1 — DENOTES LUMINAIRE TYPE L2B1—28.1 — DENOTES CIRCUIT NUMBER	⊗ <sub>6m,A</sub>	STEEL POLE BASE MOUNTED 6m — DENOTES POLE HEIGHT	P ZA	HORN/CONE SPEAKER
	CONDUCTOR DOWN TO BUILDING GROUND LOOP	M	MOTOR	LZD1-Z0.1	L2B1 — DENOTES PANELBOARD  (REFER TO POWER AND CONTROL)		A — DENOTES POLE BASE TYPE A — 900mm HIGH CONCRETE BASE, NOT HINGED	A	ZA — DENOTES ZONE A  AMPLIFIER
	DIRECT BURIED CONDUIT(S) OR CABLE(S)	0	BLANK JUNCTION BOX		28 — DENOTES CIRCUIT NUMBER .1 — DENOTES CONTROL NUMBER		B — 300mm HIGH CONCRETE BASE, HINGED	ED	END OF LINE DEVICE
	CONCRETE ENCASED CONDUIT(S)	TBS	TERMINAL BOX WITH TERMINAL STRIPS	0	CEILING OR PENDANT MOUNTED LUMINAIRE	RP2	REMOTE PANEL RP2 DENOTES REMOTE PANEL NO.2		
	EXPOSED CONDUIT OR CABLE		BASEBOARD HEATING UNIT	Y 2 2 2 2 2 2 2 2 2 2 2 2 2 2 2 2 2 2 2	WALL MOUNTED LUMINAIRE	VD 2	CLOSED CIRCUIT TELEVISION VIDEO DISPLAY 2 DENOTES MONITOR TYPE		FIRE ALARM
	CONDUIT OR CABLE TURNING UP	СН	ELECTRIC CONVECTION HEATER	O P01	POLE MOUNTED LUMINAIRE PO1-LUMINAIRE TYPE			ANN	FIRE ALARM CONTROL PANEL  REMOTE ANNUNCIATOR PANEL
_	CONDUIT OR CABLE TURNING DOWN	FF	ELECTRIC FORCE—FLOW HEATER				<u>SECURITY</u>	AZ-##	FIRE ALARM ZONE NUMBER
<b>→</b>	SLOPE — ARROW INDICATES DOWNWARD SLOPE	D	DOOR CONTROL PANEL	\$ OR <b>\[ \]</b>	CEILING, PENDANT OR WALL MOUNTED LUMINAIRE LIGHT SWITCH		SECURITY CONTROL PANEL	A	CO2 ABORT STATION
мН	MANHOLE	(DL)	DOCK LEVELER		DESIGNATIONS FOR LIGHT SWITCHES  3 — 3—WAY	<u> </u>	GLASS BREAK DETECTOR	\$\circ\circ\circ\circ\circ\circ\circ\cir	ACTIVE FIELD DEVICE — COMBINATION CONTROL AND MONITOR MODULE
НН	HAND HOLE	Ф	SINGLE RECEPTACLE		4 — 4—WAY D — DIMMER		KEY PAD	(CS)	COMBINATION HEAT AND SMOKE DETECTOR
РВ	CONCRETE PULL BOX (MINIMUM INTERNAL DIMENSIONS: 900x610x900)	Ф	DUPLEX RECEPTACLE		MC — MOMENTARY CONTACT P — PILOT LIGHT K — KEY OPERATED			<u></u>	CO2 DUMP STATION
P	PULL BOX	Ö	TWO DUPLEX RECEPTACLES WITH BARRIER		LV — LOW VOLTAGE	K	CARD READER	DH	MAGNETIC DOOR HOLDER DEVICE
$\bigoplus$	UTILITY POLE		GFCI DUPLEX RECEPTACLE	OR OR	LUMINAIRE ON LIFE SAFETY CIRCUIT	Ms	DOOR MONITOR SWITCH	E	EMERGENCY POWER OFF STATION
	POWER AND CONTROL	Ш	COMBINATION DUPLEX RECEPTACLE/TELECOMMUNICATION OUTLET	(S)	OCCUPANCY SENSOR		DATA IN	FS	SPRINKLER SYSTEM FLOW ALARM SWITCH
PP-EBA1	POWER AND/OR DISTRIBUTION PANELBOARD  — SURFACE MOUNTED	ä	(DUPLICATED ON COMMS DRAWINGS)  COMBINATION TWO DUPLEX RECEPTACLES/TELECOMMUNICATION OUTLET	PE	PHOTO-ELECTRIC CONTROL		DATA OUT	H	COMBINATION RATE OF RISE AND FIXED TEMPERATURE HEAT DETECTOR
TX	PAD MOUNT TRANSFORMER		(DUPLICATED ON COMMS DRAWINGS AS COMBINATION DUPLEX RCT) WITH BARRIER BETWEEN RECEPTACLES	$\otimes$	EXIT SIGN — CEILING MOUNTED ARROW DENOTES DIRECTION CHEVRON		DOOR BY—PASS KEYED SWITCH	ID	DUCT SMOKE DETECTOR
TX	SUSPENDED TRANSFORMER	ф	COMBINATION MULTI-RECEPTACLE/TELECOMMUNICATION FLOOR BOX (DUPLICATED ON COMMS DRAWINGS)	$\otimes$	EXIT SIGN — WALL MOUNTED		ELECTRIC DOOR STRIKE	IL)	ISOLATOR MODULE  INFRA RED DETECTOR
PP-EBA1	DENOTES PANEL	₩ #	LINE DENOTES ABOVE COUNTER HEIGHT OUTLET 1200 AFF OR 300 ABOVE COUNTER, UNLESS OTHERWISE NOTED	<u> </u>				M	ALARM MONITOR CONTACT
	DENOTES SEQUENTIAL IDENTIFIER (1,2,3,)		DESIGNATIONS FOR RECEPTACLE TYPES		EMERGENCY LIGHTING BATTERY WITH 2 HEADS AND SINGLE RECEPTACLE		MAGNETIC DOOR LOCK	P	POST INDICATOR VALVE
L A	DENOTES FLOOR (B.1.2.7)		A RACK RECEPTACLE L-20R B L21-20R C CEILING		EMERGENCY LIGHTING BATTERY FOR REMOTE HEADS AND SINGLE RECEPTACLE		ELEVATOR HALL CALL BUTTON	PS	PRESSURE SWITCH
B	DENOTES FLOOR (B,1,2,3) *UPS PANELS DENOTE PDU SOURCE		D DEPRESSED WITH FLOOR SLAB/ACCESS FLOOR E ENCLOSURE	4.▷	DOUBLE REMOTE EMERGENCY LIGHTING HEADS	%	ELEVATOR CARD CALL BUTTON	R	FIRE ALARM RELAY
LS LS	DENOTES NON-LIFE SAFETY DENOTES LIFE SAFETY		F FURNITURE MTD GFCI GROUND FAULT CIRCUIT INTERRUPTER H 5-30R	#	SPACE TYPE FOR LIGHTING CONTROL. REFER TO SCHEDULE IN SPECIFICATION SECTION 16590	К	MAGNETIC LOCK RELEASE/RESET KEY	\$ A	AREA SMOKE DETECTOR A DENOTES ASPIRATION TYPE
L U*	DENOTES LIGHTING DENOTES UNINTERRUPTIBLE POWER SUPPLY		S MTD ON SURFACE OF FLOOR U UNDERFLOOR			PE	PUSH TO EXIT		U DENOTES BELOW RAISED FLOOR  AREA SMOKE DETECTOR COMPLETE WITH REMOTE
DP	*U2A1 DENOTES FROM PDU-U2A		DIRECT CONNECTION TO EQUIPMENT		COMMUNICATIONS COMMUNICATION OUTLET:			\$ -	ALARM LIGHT  SPRINKLER SYSTEM SUPERVISED VALVE
PP PP PP	DISTRIBUTION PANEL POWER PANEL RECEPTACLE PANEL	(T)	THERMOSTAT	lacksquare	<ul><li>SOLID DENOTES COPPER CONDUCTORS</li><li>OPEN DENOTES OPTICAL FIBRE CONDUCTORS</li></ul>		TRANSOM REQUEST TO EXIT	$\bigvee$	AIR SAMPLING SMOKE DETECTOR
LP SW	LIGHTING PANEL SWITCHBOARD	Ŷ	SWITCH HEATER/BLOWER		- BOXED DENOTES INDUSTRIAL OUTLET		AUDIBLE ANNUNCIATOR	O F	FIRE ALARM BELL
T PDU	TRANSFORMER POWER DISTRIBUTION UNIT		HIGH/LOW TEMPERATURE THERMOSTAT	$\overline{\nabla}$	FLUSH WITH SURFACE COMMUNICATIONS PASS TROUGH	PA	POWER ASSIST		FIRE ALARM HORN
EF	MECHANICAL OR ELECTRICAL EQUIPMENT	•	WEATHERPROOF PUSHBUTTON FOR POWER OPERATED DOOR		FURNITURE FEED F — DENOTES FLOOR MOUNTED		POWER ASSIST CONNECTION	F	FIRE ALARM MINI HORN C/W STROBE LIGHT
1	TAG NUMBER  AC — AIR CONDITIONING UNIT	$\bigcirc$	FURNITURE FEED — POWER	шф	COMBINATION DUPLEX RECEPTACLE(S)/TELECOMMUNICATION OUTLET/FLOOR BOX (DUPLICATED ON POWER DRAWINGS)				STROBE LIGHT
	ACC — AIR COOLED CONDENSER UNIT C — COMPRESSOR		MISCELLANEOUS		TELECOMMUNICATIONS ENCLOSURE		DOOR RELEASE		WARNING LIGHT
	CH — CABINET UNIT HEATER CU — CONDENSER UNIT DH — DOOR HEATER	l Wc	DYNAMIC GLASS WINDOW CONTROLLER		DESIGNATIONS FOR COMMUNICATION OUTLETS	•	PUSH BUTTON REMOTE RELEASE		FIRE ALARM MANUAL PULL STATION (RED)
	EF — EXHAUST FAN ETU — EXHAUST TERMINAL UNIT EW — EYE WASH	wc zc	DYNAMIC GLASS ZONE CONTROLLER	<b>V</b> XXX #	XXX CABLE TERMINATION # QUANTITY		PUSH BUTTON DURESS		MANUAL RELEASE PULL STATION (BLUE)
	H — HUMIDIFIER HV — HEATING AND VENTILATING UNIT HW — HOT WATER HEATER		CLOCK	М	M MOUNTING STYLE S — SURFACE MTD P — PENDANT		PUSH BAR BOLT RETRACT		ABORT PUSH BUTTON
	MD — MOTORIZED DAMPER P — PUMP		NETWORK ATTACHED POE CLOCK WITH NETWORK CONNECTION 'C' — CEILING/PENDANT 'W' — WALL/SURFACE MOUNT		F — FENDANT F — FURNITURE R — RACK MOUNT PATCH PANEL		PUSH BAR ELECTRIC BOLT RETRACT	ED F A	END OF LINE DEVICE  FIREMAN'S TELEPHONE HANDSET
	RAF — RETURN AIR FAN SF — SUPPLY FAN UH — UNIT HEATER		'S' — SINGLE SIDE 'D' — DOUBLE SIDE 2.5" 2.5"(64MM) DIGIT DISPLAY		W — FLUSH WITH SURFACE WALL MOUNTED D — DEPRESSED WITH FLOOR SLAB/ACCESS FLOOR	IR	PASSIVE INFRARED MOTION DETECTOR		TINLIMAN S TELLITIONE HAINUSET
	V — VENTILATING UNIT		4" 4" (100MM) DIGIT DISPLAY		C — CEILING O — OVERHEAD				
SYMBOLS ANI	D LEGEND AS APPLICABLE	SYMBOLS A	AND LEGEND AS APPLICABLE	SYMBOLS AN	D LEGEND AS APPLICABLE	SYMBOLS A	ND LEGEND AS APPLICABLE	SYMBOLS A	ND LEGEND AS APPLICABLE

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PROJECT TITLE
CITY OF TORONTO ACCESSIBILITY UPGRADES

PROJECT ADDRESS

PROJECT NO: 9119- 19- 0162 / Arcadis 30279056

DRAWN BY: V. MAC CHECKED BY: M. BOJIC

PROJECT MGR: APPROVED BY: **P. WILLIAMS** F.BOLOURIAN SHEET TITLE

**ELECTRICAL LEGEND 1** 

ISSUE

SHEET NUMBER G05-G4001

SYMBOL	DESCRIPTION	SYMBOL	DESCRIPTION	SYMBOL	DESCRIPTION		ABBREVIATIONS		ABBREVIATIONS
	SINGLE LINE				METERING AND PROTECTION DEVICES	AFF	ABOVE FINISHED FLOOR	MCC	MOTOR CONTROL CENTRE
	POWER TRANSFORMER	6)	DRAWOUT LOW VOLTAGE CIRCUIT BREAKER		CONTROL TRANSFORMER	BIX	BIX TYPE PUNCH DOWN IDC TERMINATION	MCOV	MAXIMUM CIRCUIT OPERATING VOLTAGE
$\overline{m}$		γ/				BKR	CIRCUIT BREAKER	MECH	MECHANICAL
m m	TRANSFORMER			3	CURRENT TRANSFORMER, NUMBERS DENOTE	BLDG	BUILDING	mm	MILLIMETER
				100:5	QUANTITY AND RATIO	BLR	BOILER	mmC	TRADE SIZE CONDUIT IN MILLIMETERS
		600AF	LOW VOLTAGE CIRCUIT BREAKER WITH SOLID STATE TRIP UNIT			ВОТ	BOTTOM OF TRAY	MO	MANUALLY OPERATED
	LOW VOLTAGE DISCONNECT SWITCH (NUMBER DENOTES AMPERE RATING)	LSIG	AF- BREAKER FRAME UNIT AT - TRIP RATING		ZERO SEQUENCE CURRENT TRANSFORMER	BR	BRIDGE	M/W	MICROWAVE
	(NOMBER DENOTED ANNI ERE IVITAG)		MO - MANUALLY OPERATED EO - ELECTRICALLY OPERATED			CC	CONCENTRATOR COMPLEX	MTD	MOUNTED
			L - LONG TIME TRIP FUNCTION S - SHORT TIME TRIP FUNCTION		FIXED FUSE AND FIXED POTENTIAL TRANSFORMER (PT)	CD	CANDELA	NC	NORMALLY CLOSED
/201		$\bigvee$	I - INSTANTANEOUS A - GROUND FAULT ALARM	2	NUMBER DENOTES QUANTITY	СР	CONTROL PANEL	NGR	NEUTRAL GROUNDING RESISTOR
/30A	LOW VOLTAGE FUSED DISCONNECT SWITCH (NUMBER DENOTES AMPERE RATING)		G - GROUND FAULT TRIP FUNCTION			CTL	CONTROL	NIC	NOT IN CONTRACT
15A		<u></u>	CONTACTOR, NUMBER DENOTES SIZE OR RATING	十 早		C/W	COMPLETE WITH	NO	NORMALLY OPEN
l		'	RATING			CAT6	CATEGORY 6 CABLE	O/H	OVER HEAD
		Y	GENERATOR		WITHDRAWABLE FUSE AND WITHDRAWABLE POTENTIAL TRANSFORMER (PT) NUMBER DENOTES QUANTITY	COMMS	COMMUNICATIONS	OC	ON CENTRE
15A	FUSE (NUMBER DENOTES AMPERE RATING)			2		СР	CONTROL PANEL	OESC	ONTARIO ELECTRICAL SAFETY CODE
l			POWER FACTOR CORRECTION CAPACITOR			DISC	DISCONNECT	OVP	OVER VOLTAGE PROTECTION
°)	CIRCUIT BREAKER					DIV	DIVISION	PLATF	PLATFORM
07		(A) L-O (L-O	KEY INTERLOCKS			DSP	GROUND FAULT PROTECTION SYSTEM	PPT	PATCH PANEL TERMINATION
	NORMALLY OPEN CONTACTS					DSP-CA	CABLE ADAPTER MODULE	R	REMOVE
	NORMALLY CLOSED CONTACTS	(20)	MOTOR - NUMBER DENOTES SIZE (HP)		WITHDRAWABLE FUSE AND FIXED POTENTIAL TRANSFORMER (PT) NUMBER DENOTES QUANTITY	DSP-CAS	CABLE ADAPTER MODULE	RCT	RECEPTACLE
		$\Diamond$	NEON LIGHT VOLTAGE INDICATOR		(FI)NOMBER BENOTED GOVINTITY	DSP-DFM	DSP FEEDER MODULE	RJ	U/UTP RJ45 CONNECTION
(c)-	RELAY COIL			2		E	EXISTING TO REMAIN	RM	ROOM
		M				EL	ELEVATION	RR	REMOVE AND RELOCATE
	DRAMOUT OR BUILD IN COMMENTION	I T	MANUAL MOTOR OTARTER	OFF		ELEV	ELEVATOR	SC	SHORT CIRCUIT
	DRAWOUT OR PLUG-IN CONNECTION		MANUAL MOTOR STARTER	HAND AUTO	SELECTOR SWITCH - HAND-OFF-AUTO	EMS	ENERGY MANAGEMENT SYSTEM	SLD	SINGLE LINE DIAGRAM
						EO	ELECTRICALLY OPERATED BREAKER	SP	SPARE
	MEDIUM VOLTAGE LOAD INTERRUPTER SWITCH - NUMBER DENOTES SWITCH RATING	<u> </u>		0 0		ETSP	ELECTRONIC TRAP SEAL PRIMER	SRP	SUPPRESSION RELEASE PERIPHERAL
/600A		Ţ	MAGNETIC MOTOR STARTER	مله	STOP	EX	EXISTING	ST	SHUNT TRIP
		8				FB#1	FEEDER CIRCUIT BREAKER (#1 DENOTES NUMBER)	STN	STATION
<b>│</b>	GROUND CONNECTION			0 0	START	FEPO	FIREMAN EMERGENCY POWER OFF	STP	SHIELDED TWISTED PAIR CABLE
•		SF F			PILOT LIGHT	GFR	GROUND FAULT RELAY	STS	STATIC TRANSFER SWITCH
) o	LIGHTNING ARRESTER OR SURGE DIVERTER	ا لے ل	TWO-SPEED MAGNETIC MOTOR STARTER			GND	GROUND	SW	SWITCH
	NUMBER DENOTES QUANTITY				OVERLOAD	нт	HEAT TRACING	SWBD	SWITCH BOARD
_						HTR	HEATER	SWGR	SWITCH GEAR
$  \   \ \langle \rangle \  $	STRESS CONE		SURGE SUPRESSOR	СМ	DIGITAL CIRCUIT MONITOR	НОА	HAND-OFF-AUTO	ТВ	TIE CIRCUIT BREAKER
	DELTA MANYE TO ANICEODMED COMMECTION MATERIA					HVAC	HEATING - VENTILATION AND AIR CONDITIONING	TVSS	TRANSIENT VOLTAGE SURGE SUPPRESSOR
\ \ }	DELTA/WYE TRANSFORMER CONNECTION WITH WYE POINT RESISTANCE GROUNDED			₹	VARIABLE FREQUENCY DRIVE	IAM	INDIVIDUAL ADDRESSABLE MODULE	TYP	TYPICAL
Ž						LAV	LAVATORY	U/G	UNDER GROUND
						LCD	LIQUID CRYSTAL DISPLAY	UON	UNLESS OTHERWISE NOTED
	DELTA/WYE TRANSFORMER CONNECTION WITH WYE POINT GROUNDED					LED	LIGHT EMITTING DIODE	VFD	VARIABLE FREQUENCY DRIVE
<del>4</del> 						LSIA	LONG TIME TRIP; SHORT TIME TRIP; INSTANTANEOUS TRIP;	WP	WEATHER PROOF
	WYE/WYE TRANSFORMER CONNECTION					1.010	GROUND FAULT ALARM	XP	EXPLOSION PROOF
	DELTA/DELTA TRANSFORMER CONNECTION					LSIG	LONG TIME TRIP; SHORT TIME TRIP; INSTANTANEOUS TRIP; GROUND FAULT TRIP	*	REFER TO A-002 FOR ABBREVIATIONS NOT INCLUDED IN THIS LIST
						LVL	LEVEL		
d 6 ATS	AUTOMATIC TRANSFER SWITCH					LVR	LAYOVER		
						МВ	MAIN CIRCUIT BREAKER		
						MBPS	UPS - MAINTENANCE BY-PASS SWITCH - EXTERNAL		
SYMBOLS A	ND LEGEND AS APPLICABLE	SYMBOLS A	ND LEGEND AS APPLICABLE	SYMBOLS /	AND LEGEND AS APPLICABLE	SYMBOLS	AND LEGEND AS APPLICABLE	SYMBOLS	S AND LEGEND AS APPLICABLE

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PROJECT TITLE
CITY OF TORONTO ACCESSIBILITY UPGRADES

PROJECT ADDRESS

PROJECT NO: 9119- 19- 0162 / Arcadis 30279056

DRAWN BY: CHECKED BY: V. MAC M. BOJIC APPROVED BY: **P. WILLIAMS** PROJECT MGR: F.BOLOURIAN

SHEET TITLE ELECTRICAL LEGEND 2

SHEET NUMBER G05-G4002

MOUNTING HEIGHTS SCI	HEDULE	
MOUNTING HEIGHTS TO TOP OF DEVICE. ALL DIMENSIONS ARE ABOVE FINISHED FLOOR (AFF) UNLESS NOTED	O OTHERWISE.	
LIGHT SWITCH — — — — — — — — — — —	— — 1050mm	
RECEPTACLE - FINISHED AREAS — — — — — — — —	- — 460mm	
RECEPTACLE - UNFINISHED AREAS — — — — — — —	— — 1050mm	
RECEPTACLE - ABOVE COUNTER	300mm	ABOVE COUNTER
DATA OUTLET - FINISHED AREA	460mm	
DATA OUTLET - UNFINISHED AREA	— — 1050mm	
FIRE ALARM MANUAL PULL STATION — — — — — — — —	— — 1200mm	
FIRE ALARM HORN/STROBE — — — — — — — — —	— — 2460mm	
FIRE ALARM STROBE — — — — — — — — —	— — 2460mm	
FIRE ALARM END OF LINE DEVICE — — — — — — — —	— — 1500mm	
FIRE ALARM HEAT DETECTOR	CEILING	
FIRE ALARM SMOKE DETECTOR — — — — — — — — —	— — CEILING	
FIRE ALARM REMOTE ANNUNCIATOR — — — — — — —	— — 2000mm	
PANEL — — — — — — — — — — — — —	— — 2000mm	
CONTROL PANEL — — — — — — — — — — —	– — 2000mm	
MOTOR STARTER — — — — — — — — — — — —	– — 1800mm	
DISCONNECT SWITCH — — — — — — — — — — —	– — 1800mm	
PUSH BUTTON STATION — — — — — — — — — — — — — — — — — — —	— — 1050mm	
DOOR ACCESS CONTROL CARD READER — — — — — —	— — 1050mm	
VIDEO INTERCOM — — — — — — — — — — — —		R MANUF. INSTRUCTION
DOOR BY-PASS KEYED SWITCH — — — — — — — — —	— — 1050mm	
BATTERY OPERATED EMERGENCY LIGHT — — —	— — 2700mm	
EMERGENCY LIGHT BATTERY UNIT — — — — —	— — 2700mm	
THERMOSTAT — — — — — — — — — — — —	– — 1200mm	
MOUNTING HEIGHTS AS APPLICABLE		

**GENERAL NOTES:** 

- 1. PROVIDE 1-#6 GND WIRE FOR ALL UNDERGROUND EMPTY CONDUITS AND COMMUNICATIONS CONDUITS WITHOUT METAL WIRING/CABLES TO FACILITATE FUTURE DETECTION.
- 2. NO SPLICES ARE ALLOWED FOR COMMUNICATION CABLES.
- 3. NO SPLICES ARE ALLOWED BELOW GRADE FOR POWER WIRE AND CABLE.
- 4. THERE MUST BE A BREAK IN ALL UNDERGROUND CONDUITS OUTSIDE THE BUILDING/TOWERS/ELECTRICAL/COMMUNICATIONS/BOILER ROOM TO ALLOW DRAINAGE OF RACEWAY BEFORE ENTERING THE ROOMS.
- 5. PROVIDE LAYOUT (WITH DIMENSIONS) OF ALL UNDERGROUND PULL POINTS INCLUDING HAND HOLES, MAN HOLES AND CONCRETE PULL BOXES TO THE CONSULTANT FOR APPROVAL PRIOR TO INSTALLATION.
- 6. INSTALL HAND HOLES AWAY FROM MAJOR TRAFFIC AREAS (TYPICAL).
- 7. PROVIDE HEAT TRACING PROTECTION FOR WATER PIPES, STORM PIPES AND SANITARY PIPES AS SHOWN ON ELECTRICAL DRAWINGS. REFER TO MECHANICAL DRAWINGS FOR PIPING LAYOUT. HEAT TRACING SHALL BE RAYCHEM MODEL #8XL-TRACE, 208V, 1PH, SELF REGULATING TRACING CABLE OR APPROVED EQUIVALENT, C/W POWER SUPPLY MODULE, THERMOSTAT AND ALL ACCESSORIES FOR A COMPLETE AND FUNCTIONING SYSTEM. STARTUP TEMPERATURE -29°C (-20°F).
- 8. WHERE CONDUITS ARE INSTALLED ACROSS EXPANSION JOINTS, PROVIDE CONDUITS WITH EXPANSION/CONTRACTION FITTINGS.
- 9. <u>ELEVATOR FIRE ALARM AUTOMATIC RECALL:</u>

ELEVATOR LOBBY MOUNTED FIRE DETECTORS AND SECURITY PANEL TO RECALL ELEVATORS TO DESIGNATED LEVEL UPON FIRE ALARM. SHOULD DETECTOR AT DESIGNATED LEVEL ELEVATOR LOBBY INDICATE FIRE, ELEVATOR TO BE DIRECTED TO ALTERNATE LEVEL. REFER TO ELEVATOR AUTOMATIC FIRE RECAL SCHEDULE. ELEVATOR CONTRACTOR TO COORDINATE WITH TSSA AND CONFIRM DESIGNATED/ALTERNATE LEVELS.

- 10. SMOKE DETECTOR AT TOP OF ELEVATOR SHAFT TO BE AIR SAMPLING SMOKE DETECTOR TYPE. INSTALL CONTROL UNIT IN A TAMPER PROOF ENCLOSURE (NEMA 4X) OUTSIDE OF ELEVATOR CLOSET. AIR SAMPLING SMOKE DETECTOR TO BE EST READY SET BY EDWARDS OR APPROVED EQUAL.
- 11. SITE PLAN DRAWINGS INDICATE UNDERGROUND POWER CONDUITS AND CORRESPONDING PULL POINTS (CONCRETE PULL BOXES, HAND HOLES OR MAN HOLES). WHERE OEC REQUIRES ADDITIONAL PULL POINTS FOR WIRING SEPARATION, PROVIDE ADDITIONAL CONCRETE PULL BOX (OR HAND HOLE) AS REQUIRED. IF AN ADDITIONAL MAN HOLE IS REQUIRED, IT IS PREFERRED TO PROVIDE AN ADDITIONAL HAND HOLE OR CONCRETE PULL BOX IF POSSIBLE.

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 DRAWN BY:
 CHECKED BY:

 V. MAC
 M. BOJIC

 PROJECT MGR:
 APPROVED BY:

F.BOLOURIAN
SHEET TITLE

ELECTRICAL GENERAL NOTES

P. WILLIAMS

SHEET NUMBER
G05-G4002

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# CITY OF TORONTO ACCESSIBILITY UPGRADES TYPICAL DETAILS BOOKLET

### 9119-19-0162 / Arcadis 30279056

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D1402	STAIR DETAILS - 02					
D1403	RAMP DETAILS - 01					
D1404	RAMP DETAILS - 02					
D1405	TACTILE DETAILS					
D1501	MISCELLANEOUS DETAILS - 01					
D1502	MISCELLANEOUS DETAILS - 02					
D1601	ELEVATOR DETAILS					
D1602	ELEVATOR CONTROL & INTERIOR CABIN DETAILS					
D1701	ACCESSIBLE PARKING AND SITE MARKING DETAILS					
D1702	CURB DETAILS					
D1801	PHASING / HOARDING DETAILS					

	STRUCTURAL TYPICAL DETAILS INDEX	MECHANICAL TYPICAL DETAILS INDEX				
SHEET#	SHEET TITLE	SHEET#	SHEET TITLE			
D2100	CONCRETE - TYPICAL DETAIL	D3201	PLUMBING DETAILS			
D2200	STRUCTURAL STEEL DETAILS - 1	D3301	DRAINAGE DETAILS			
D2201	STRUCTURAL STEEL DETAILS - 2	D3401	FIRE PROTECTION DETAILS			
D2300	MASONRY DETAILS	D3501	HVAC DETAILS			
		D3601	PIPING DETAILS SHEET 1 OF 2			
		D3602	PIPING DETAILS SHEET 2 OF 2			

	ELECTRICAL TYPICAL DETAILS INDEX							
SHEET #	SHEET TITLE							
D4001	ELECTRICAL DETAILS 1							

CITY OF TORONTO



55 John ST. TORONTO, ON

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No.DESCRIPTIONDATEAISSUED FOR TENDER2025-04-11



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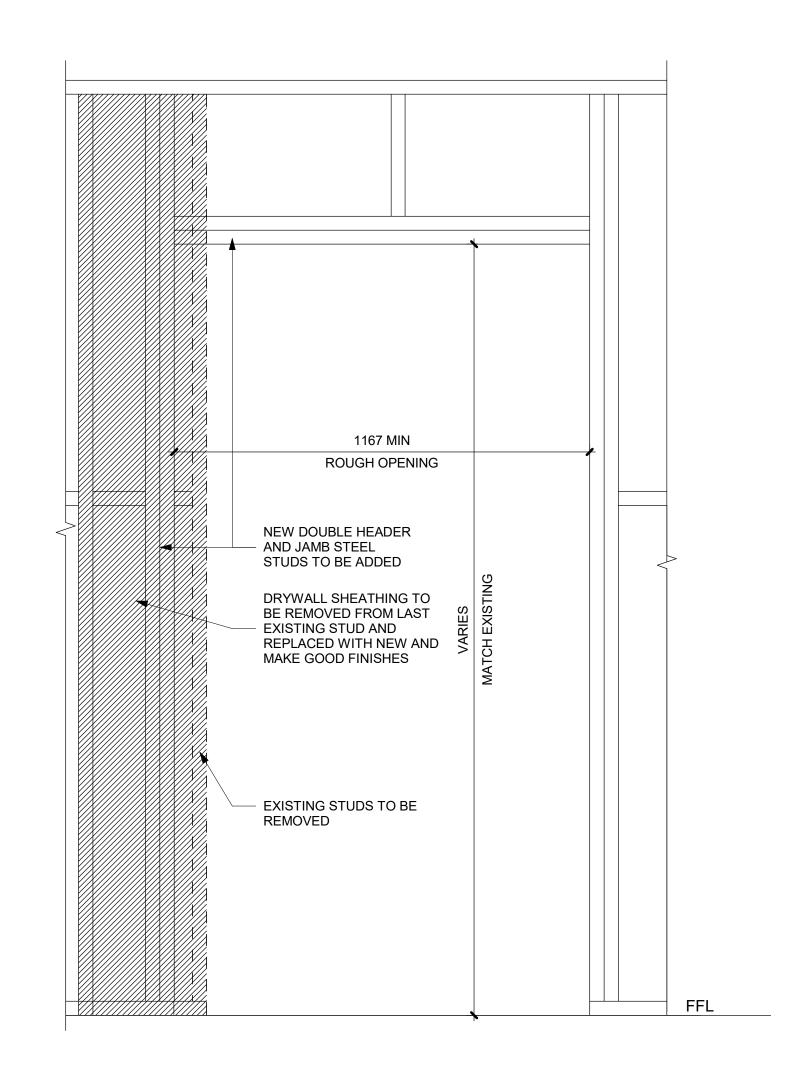
9119- 19- 0162 / Arcadis 30279056

DATE:
2025-04-11

SHEET NUMBER

000





PROPOSED SEQUENCE OF WORK

D1002 Scale: 1:20

CREATE NEW 150x150mm HOLES @ 400mm INTO EXISTING MASONRY WALL AND SHORE THE WALL ABOVE, SEE DETAIL 1.

OR SHORE THE WALL ABOVE BY USING 2 CHANNELS BACK TO BACK AND THROUGH BOLTS @350mm, SEE DETAIL 2

DEMOLISH THE EXISTING LINTEL, THE VOID FOR NEW BEAM AND THE WALL FROM EACH SIDE OF THE NEW OPENING


AND BOTTOM OF EACH CORE, INJECT GROUT, CLOSE HOLES WITH MORTAR AND MAKE GOOD SURFACE)

INSTALL NEW LINTEL. SEE LINTEL SCHEDULE FOR LINTEL SIZE

5 ADD MASONRY FACES AT LINTEL AND REPAIR MASONRY COURSE

WIDENING WALL OPENING

FILL TWO CORES MIN. OF EXISTING MASONRY WALL WITH GROUT EACH SIDE OF THE NEW OPENING, (DRILL HOLES TOP

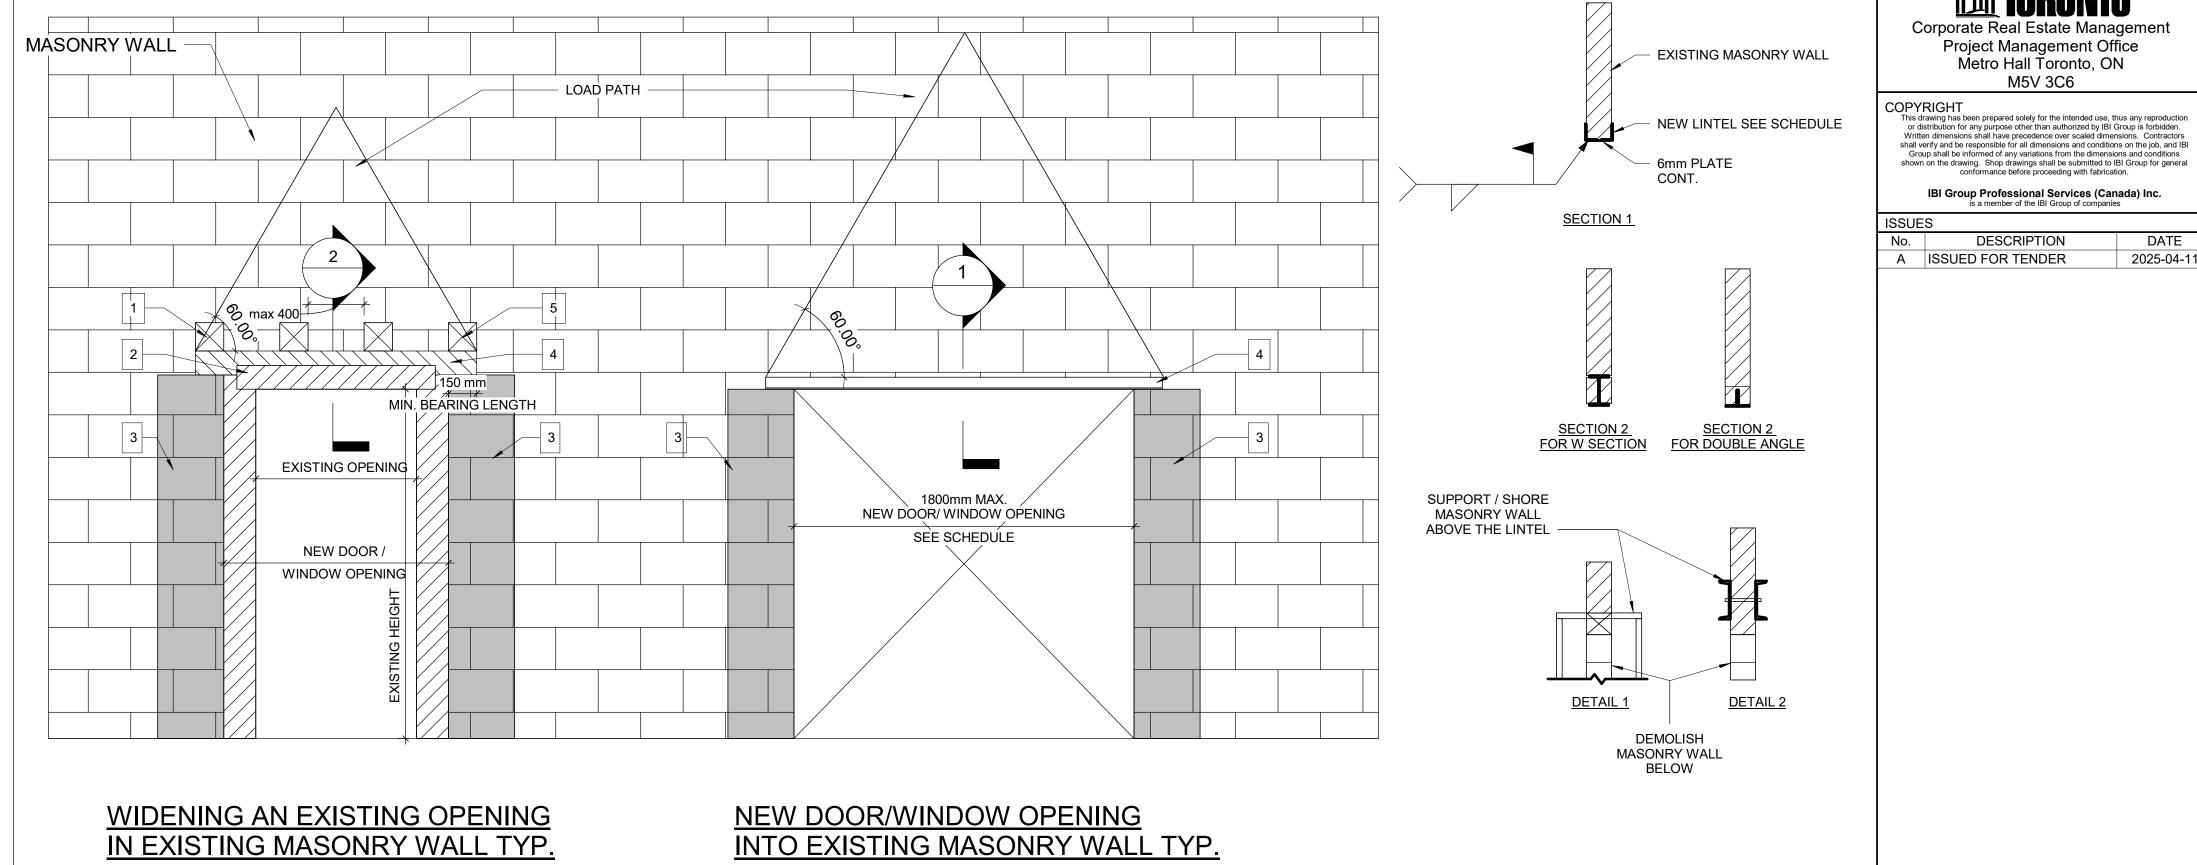

LINTEL:


	<del>-</del> .					
CLEAR SPAN mm (ft-in)	140 (6") WALL	190 (8") WALL	240 (10") WALL	290 (12") WALL	350 WALL	430 WALL
UP TO 1200 (4'-0")	L127x127x7.9	2-L89x89x7.9 +170x6mm PL	L89x89x7.9 +L127x89x7.9 LLV +220x6mm PL	3-L89x89x7.9 +270x6mm PL	3-L127X89X7.9 (LLV)	3-L127X127X7.9 +410X6mm PL
1201 TO 1800 (4'0 - 6'-)	2-L89x64x6.4LLV	2-L127x89x7.9LLV	L127x89x7.9LLV +L127x127x7.9	3-L127x89x7.9LLV		
1801 TO 3100 ( 6'- 10')	2-L89x64x9.5LLV	2-L152x89x9.5LLV	2-L152x89x9.5LLV	3-L152x89x9.5LLV		

OVER ALL OPENINGS IN MASONRY WALLS PROVIDE THE FOLLOWING LINTELS. UNLESS OTHERWISE SHOWN.

STEEL	LIN	ΓELS

CLEAR SPAN mm (ft-in)	140 (6") WALL	190 (8") WALL	240 (10") WALL	290 (12") WALL	350 WALL	430 WALL
UP TO 1200 (4'-0")	L127x127x7.9	2-L89x89x7.9 +170x6mm PL	L89x89x7.9 +L127x89x7.9 LLV +220x6mm PL	3-L89x89x7.9 +270x6mm PL	3-L127X89X7.9 (LLV)	3-L127X127X7 +410X6mm P
1201 TO 1800 (4'0 - 6'-)	2-L89x64x6.4LLV	2-L127x89x7.9LLV	L127x89x7.9LLV +L127x127x7.9	3-L127x89x7.9LLV		
1801 TO 3100 ( 6'- 10')	2-L89x64x9.5LLV	2-L152x89x9.5LLV	2-L152x89x9.5LLV	3-L152x89x9.5LLV		

1 DRYWALL - DOOR CUTOUT DETAIL D1002 Scale: 1:10

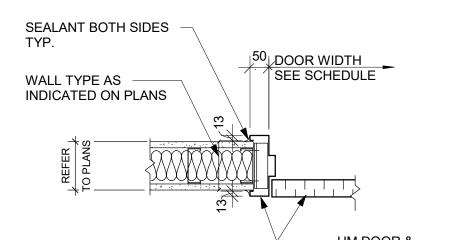

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Corporate Real Estate Management

Project Management Office Metro Hall Toronto, ON

M5V 3C6

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2025-04-11

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PROJECT TITLE CITY OF TORONTO ACCESSIBILITY UPGRADES

PROJECT ADDRESS

PROJECT NO: 9119- 19- 0162 / Arcadis 30279056 DRAWN BY: CHECKED BY:

A. BOYNARIAN K. TILAHUN APPROVED BY: **E. FENUTA** PROJECT MGR: F.BOLOURIAN SHEET TITLE

DRYWALL CUT OUT


SHEET NUMBER


D1002

NOTE: FOR MASONRY WALL CUT OUT, REFER TO STRUCTURAL DETAIL


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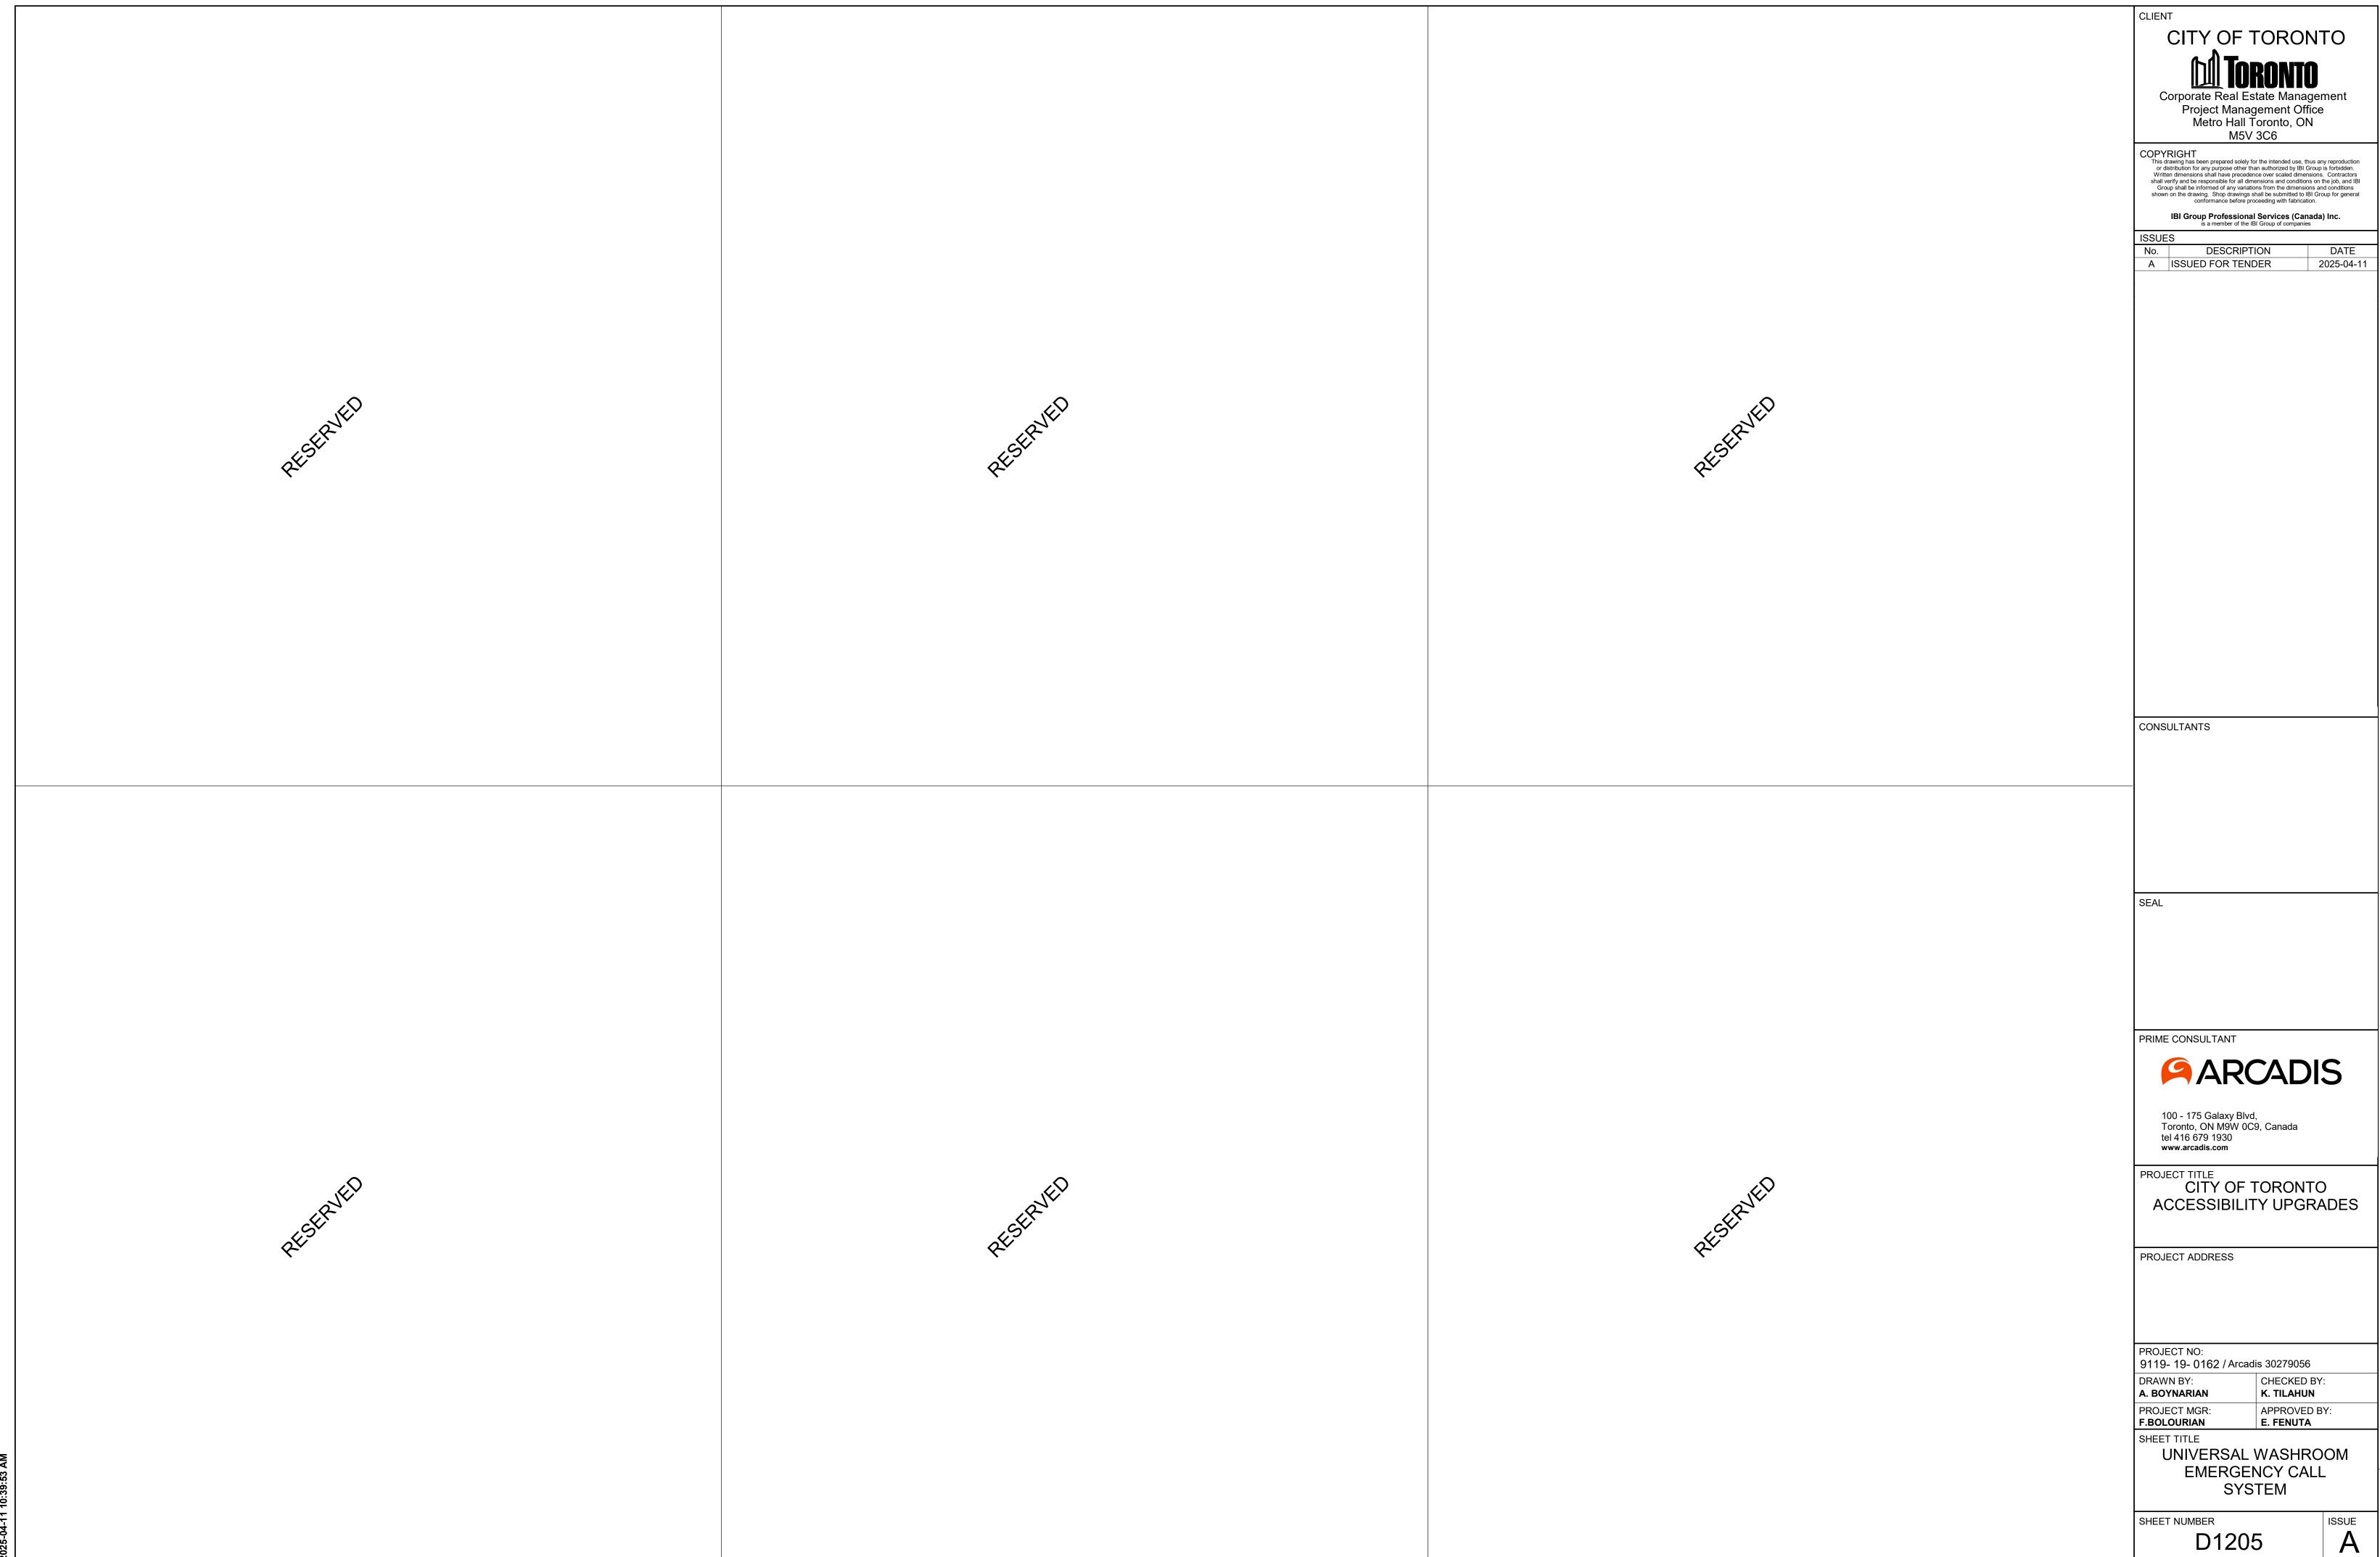
2 DRYWALL - DOOR JAMB SECTION DETAIL D1002 Scale: 1:10



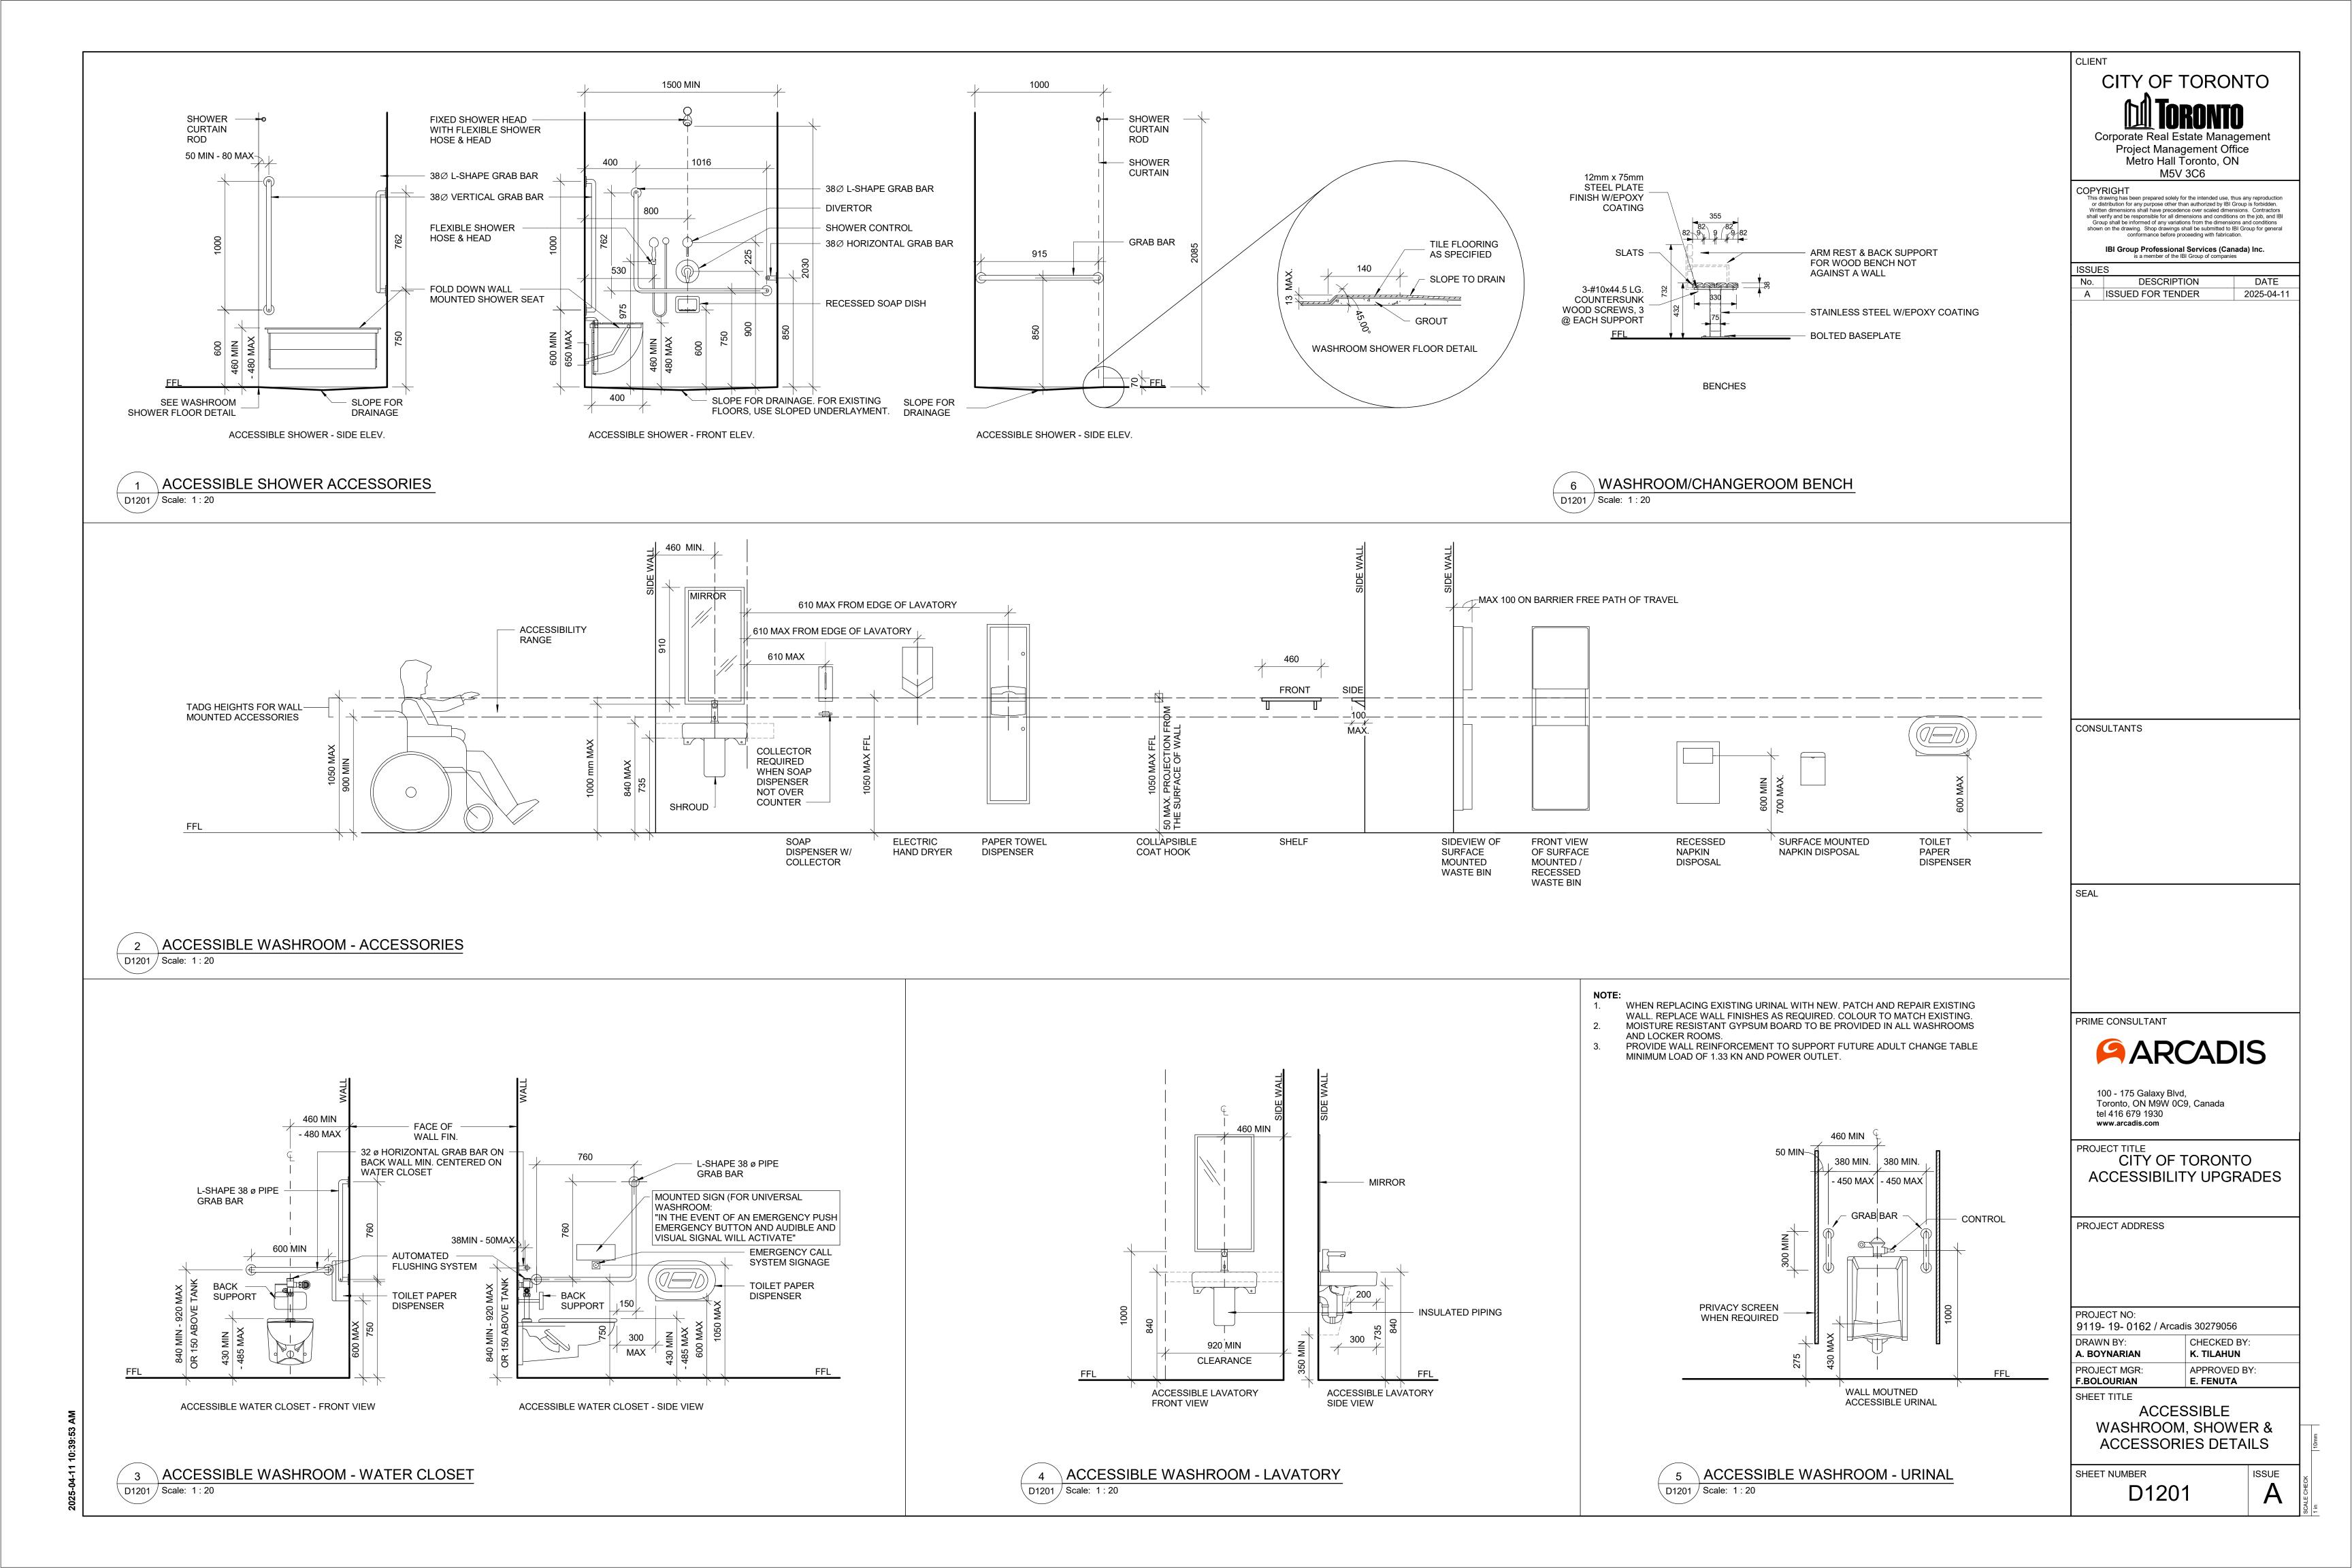


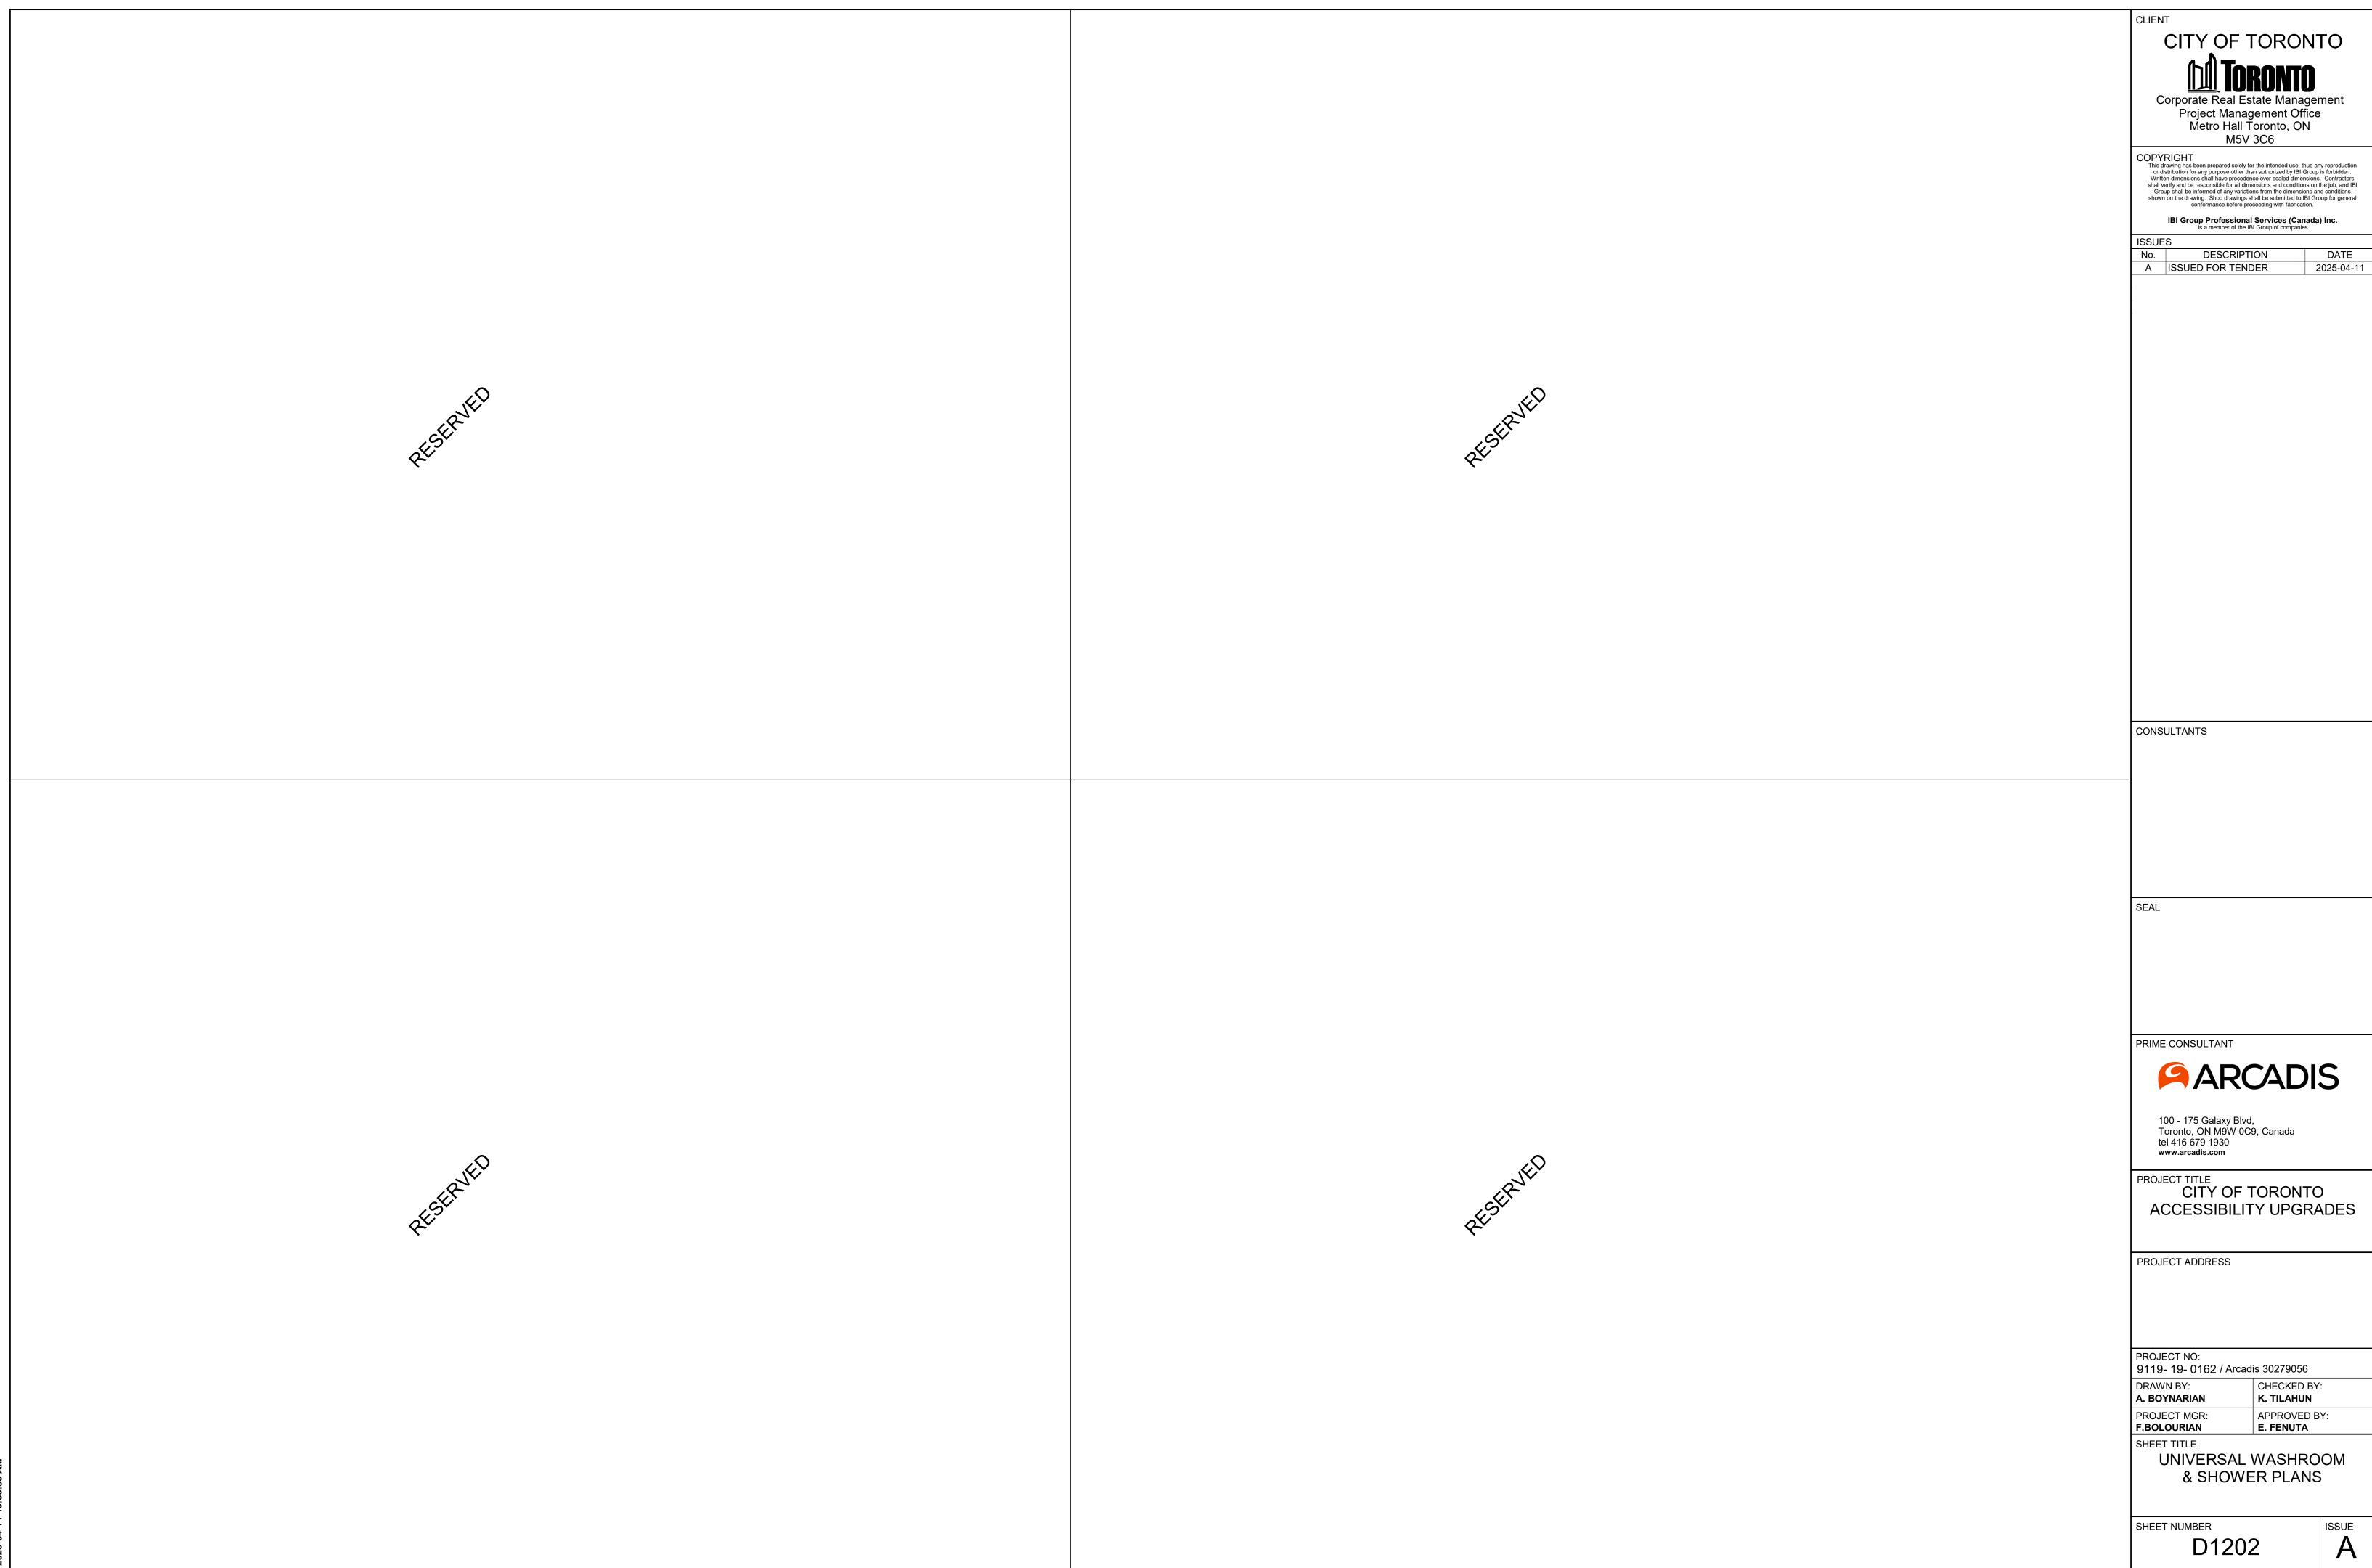
RESERVED.	ak strain and a st	RESERVED	CITY OF TORONTO  Corporate Real Estate Management Project Management Office Metro Hall Toronto, ON M5V 3C6  COPYRIGHT  This drawing has been prepared solely for the intended use, thus any reproduction of statistication for any purpose other than authorized by 181 Croup is orbidden, and hall verify and be responsible for all dismensions and conditions on the job, and 181 Group shall be informed of 181 Corpor for general distributions before proceeding with Indirection.  IBI Group Professional Services (Canada) Inc. is a member of the 181 Group of companies  ISSUES  No. DESCRIPTION DATE A ISSUED FOR TENDER 2025-04-11
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WESTERMEN	RESERVED	RESERVED	PRIME CONSULTANT  PROJECT NO: 9119- 19- 0162 / Arcadis 30279056  DRAWN BY: A. BOYNARIAN PROJECT MGR: F.BOLOURIAN SHEET TITLE UNIVERSAL WASHROOM ELEVATIONS  PROJECT NO: 911203  A 100 - 175 Galaxy Blvd, Toronto, ON M9W 0C9, Canada tel 416 679 1930 www.arcadis.com  PROJECT TITLE CITY OF TORONTO ACCESSIBILITY UPGRADES  PROJECT ADDRESS  PROJECT NO: 9119- 19- 0162 / Arcadis 30279056  DRAWN BY: A. BOYNARIAN K. TILAHUN PROJECT MGR: E. FENUTA  SHEET TITLE UNIVERSAL WASHROOM ELEVATIONS




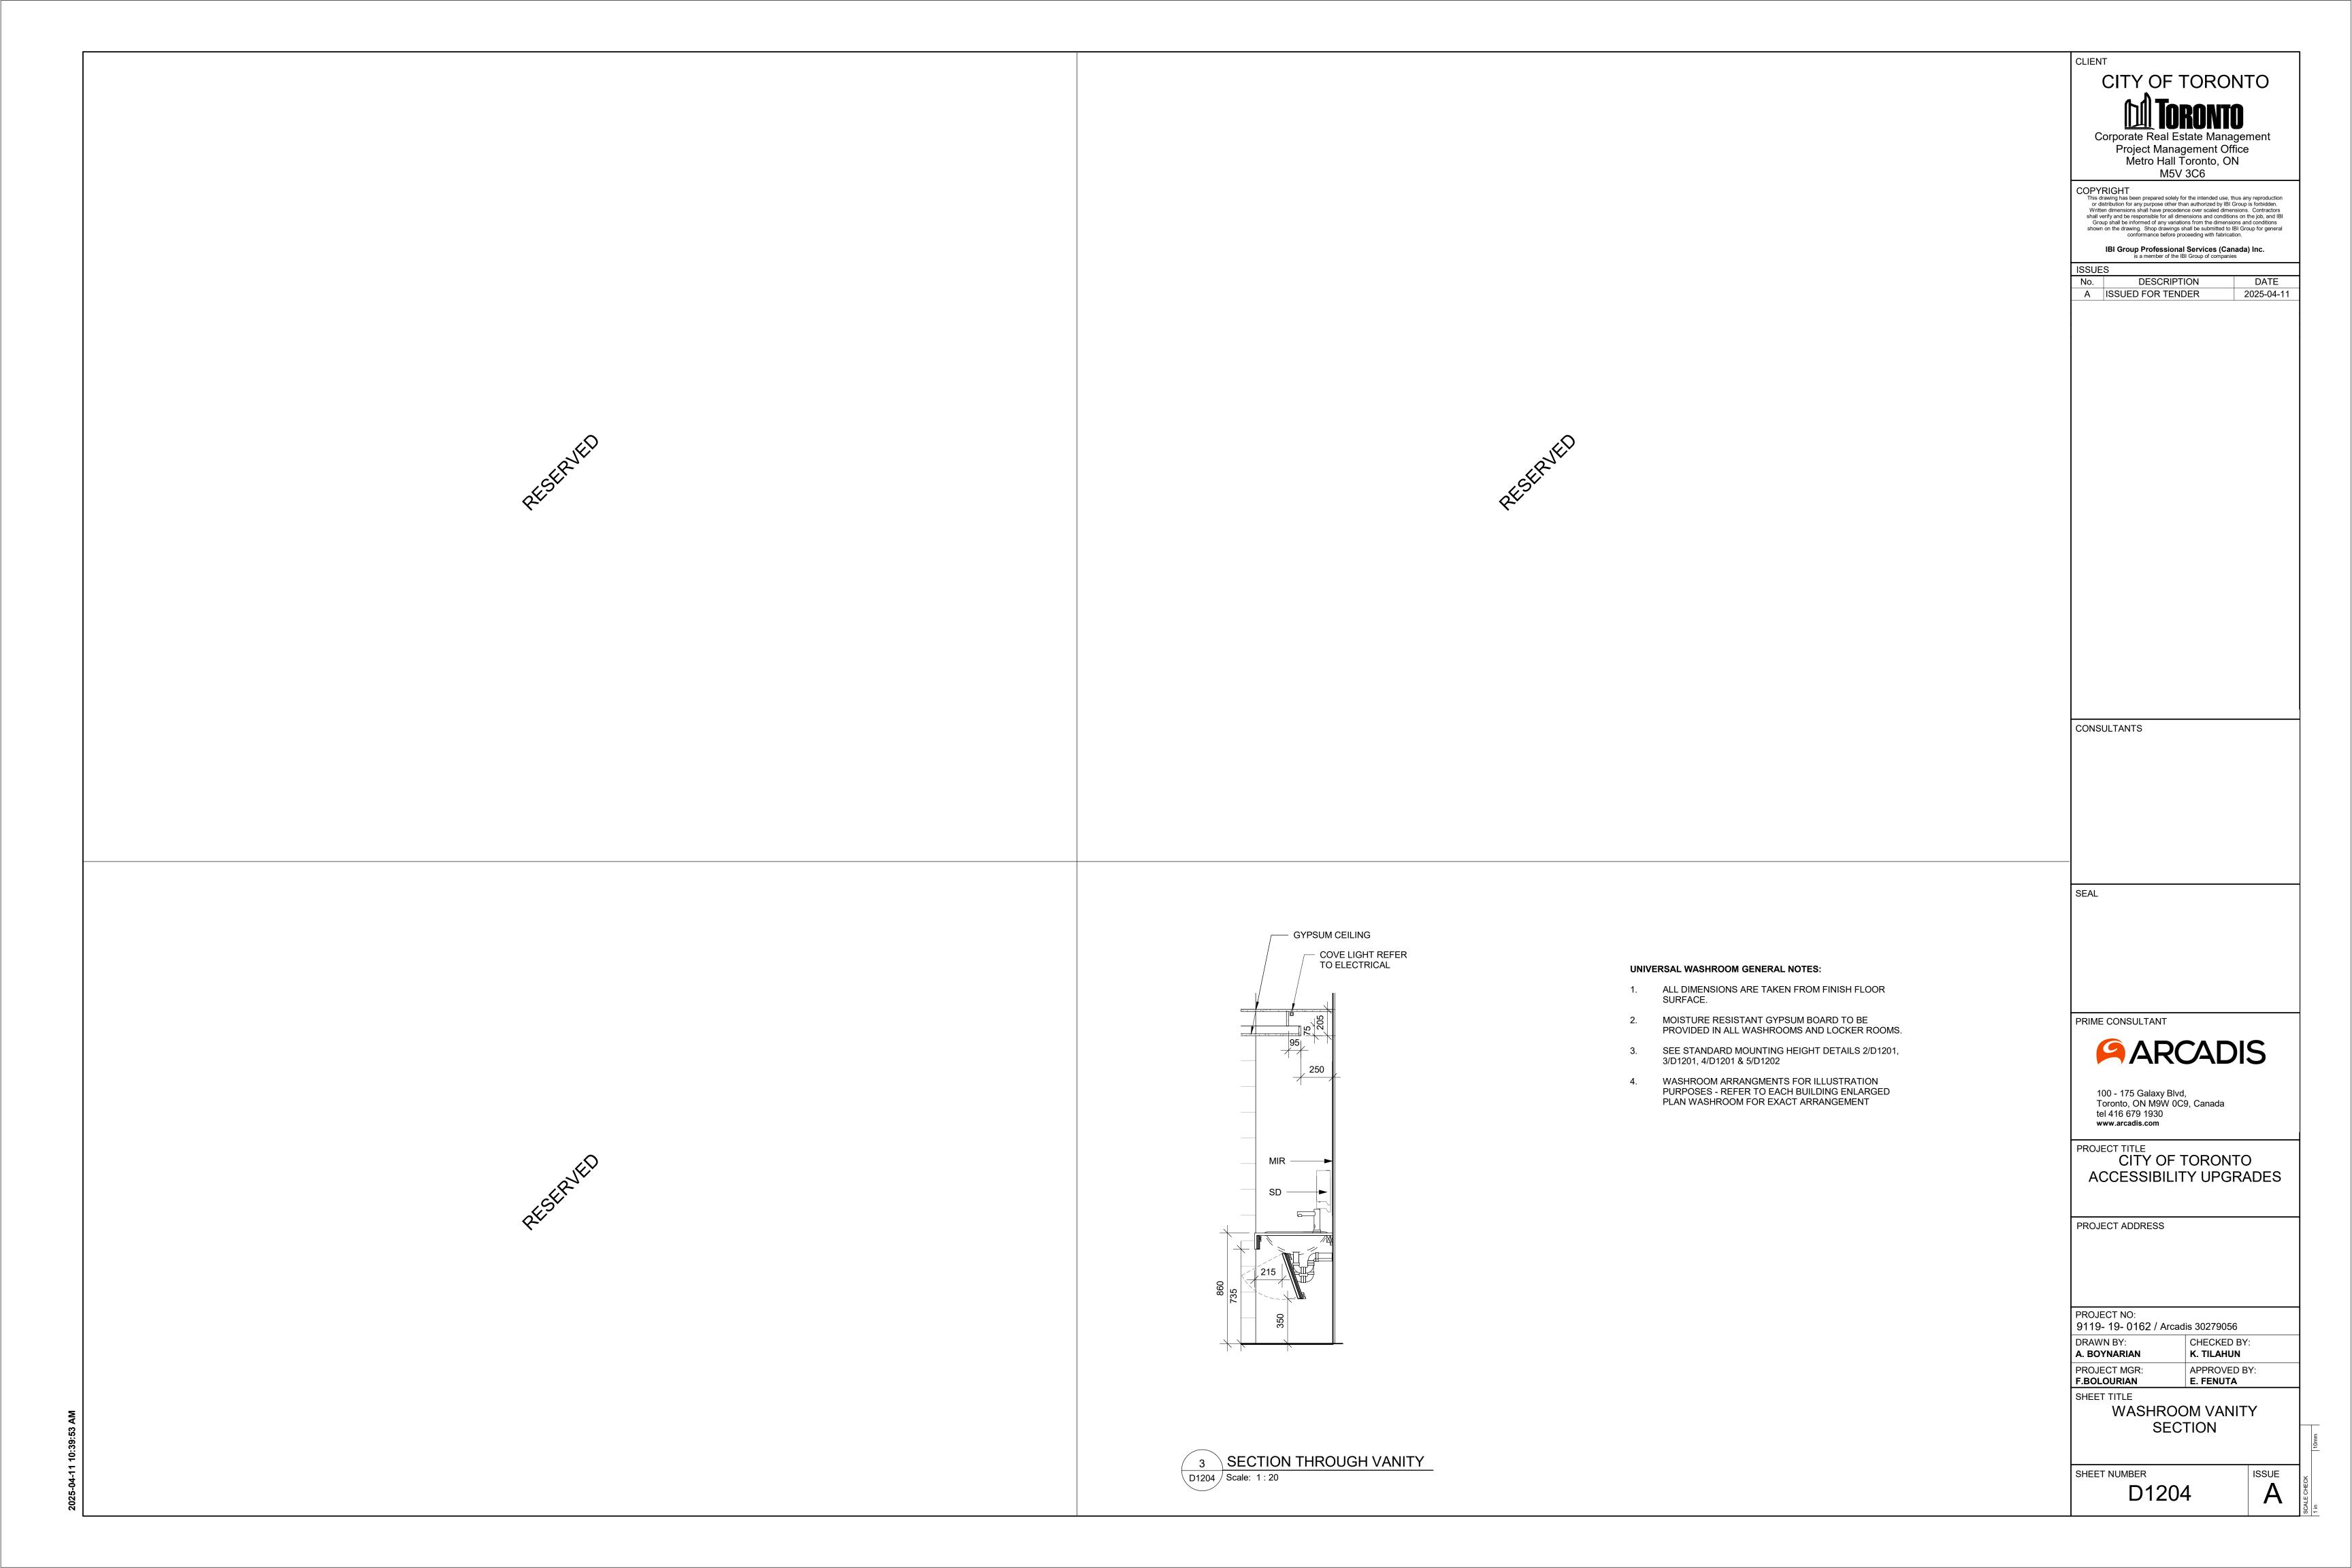


X. | 10mm

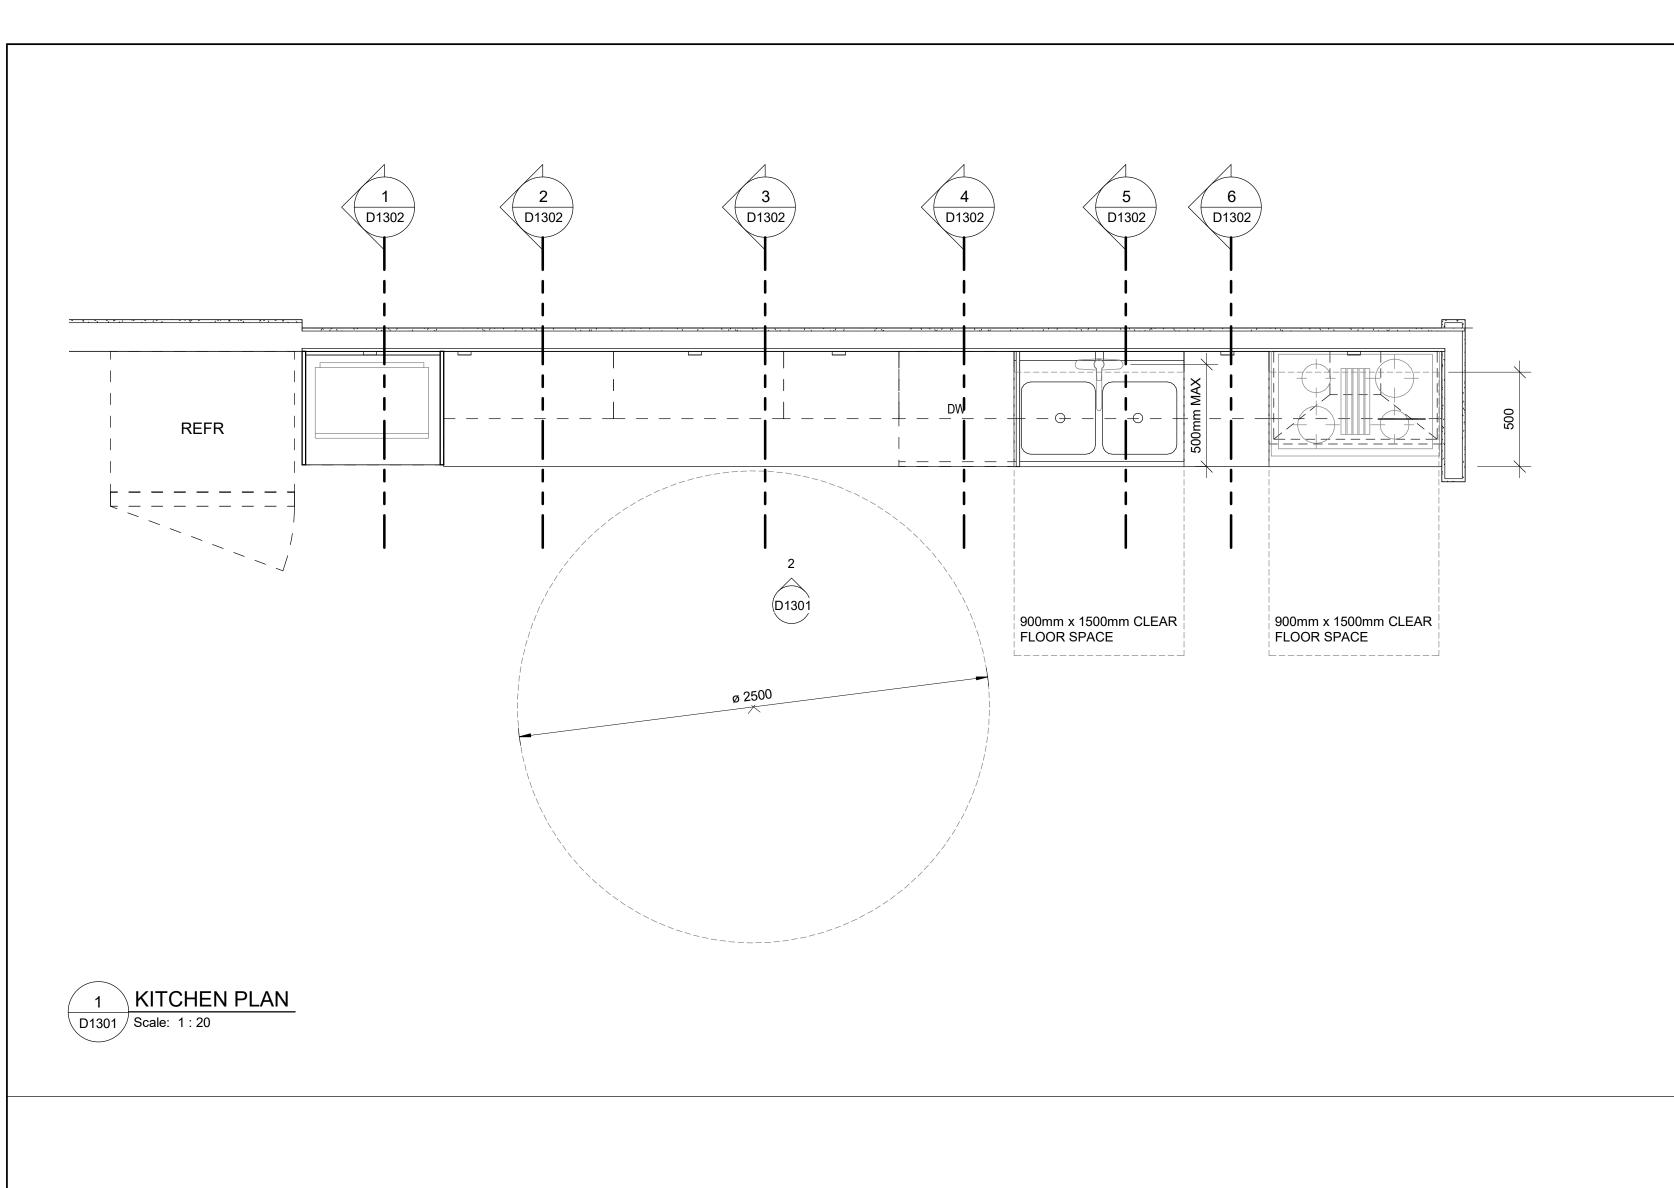


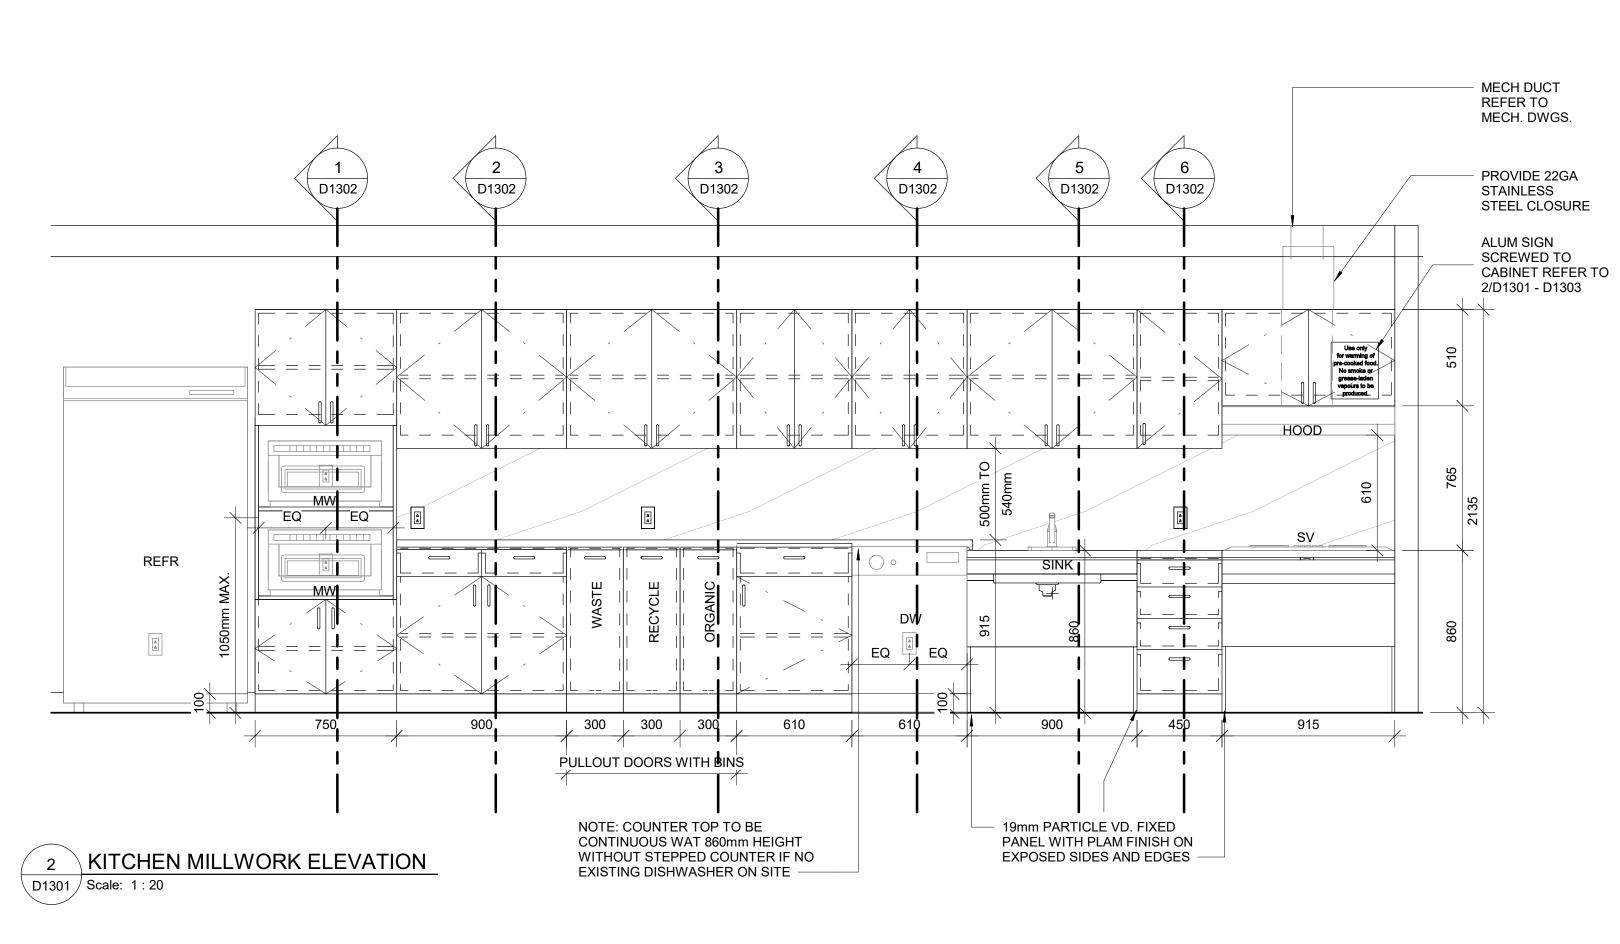

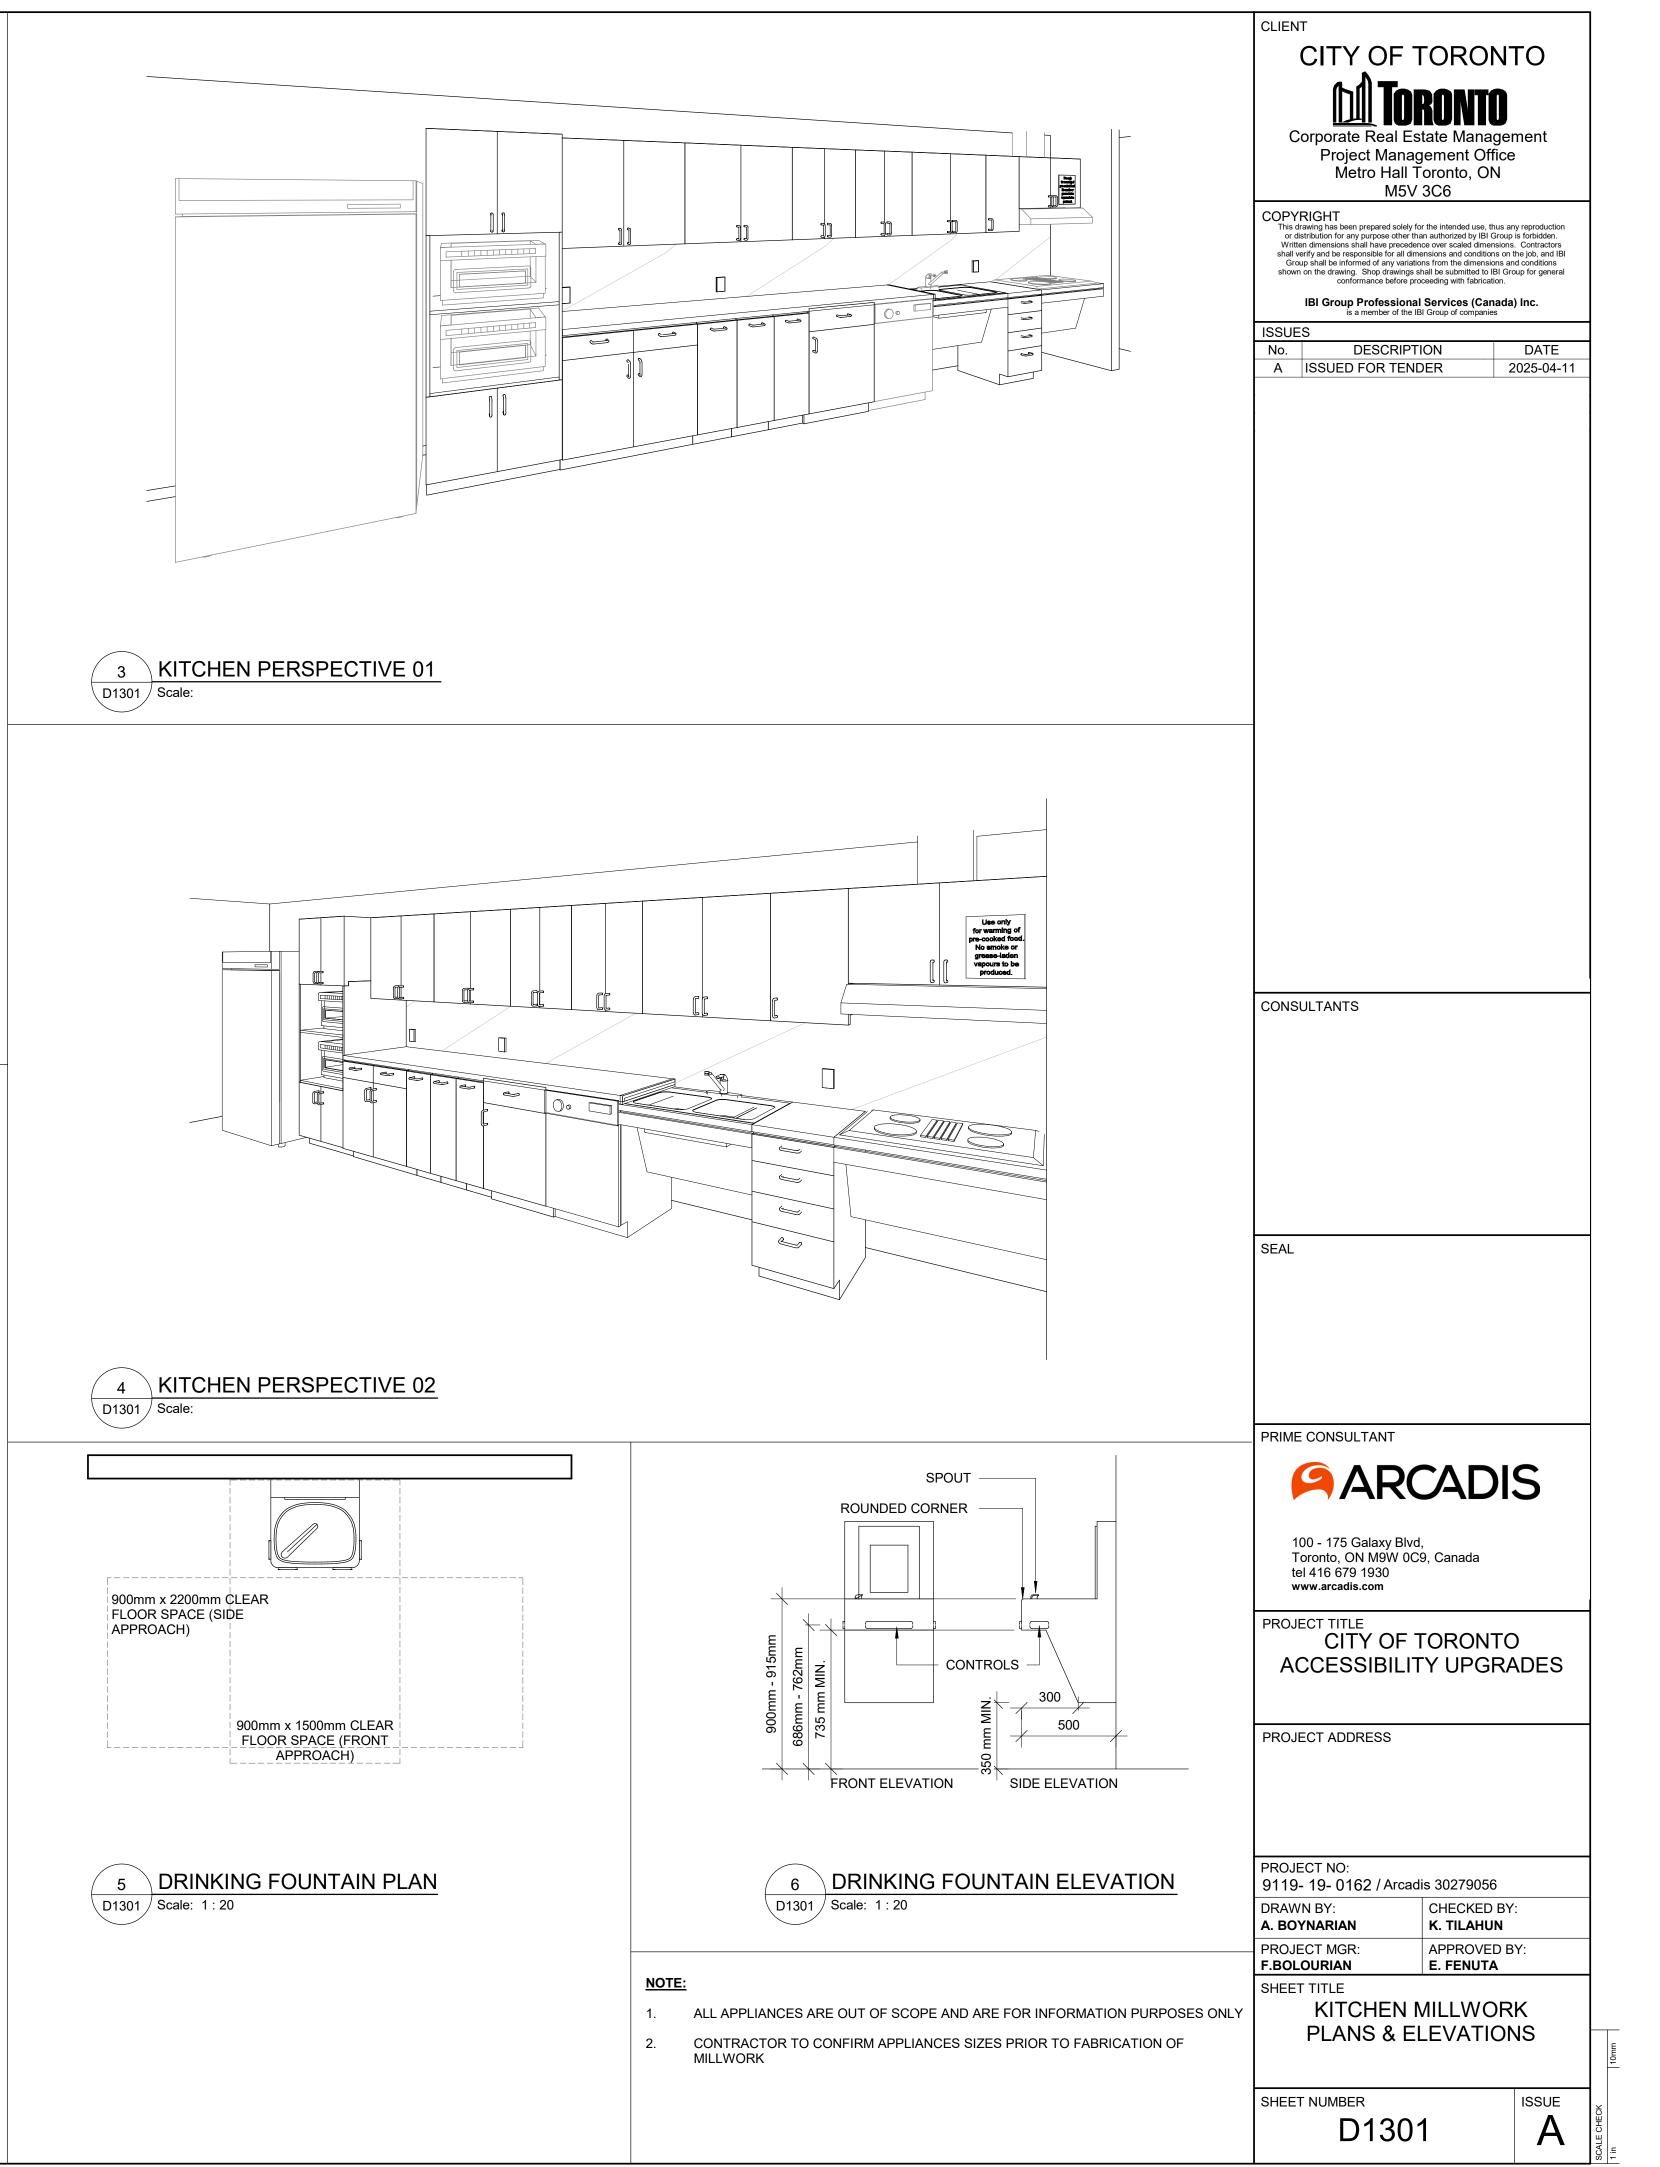


5-04-11 10:39:53 /

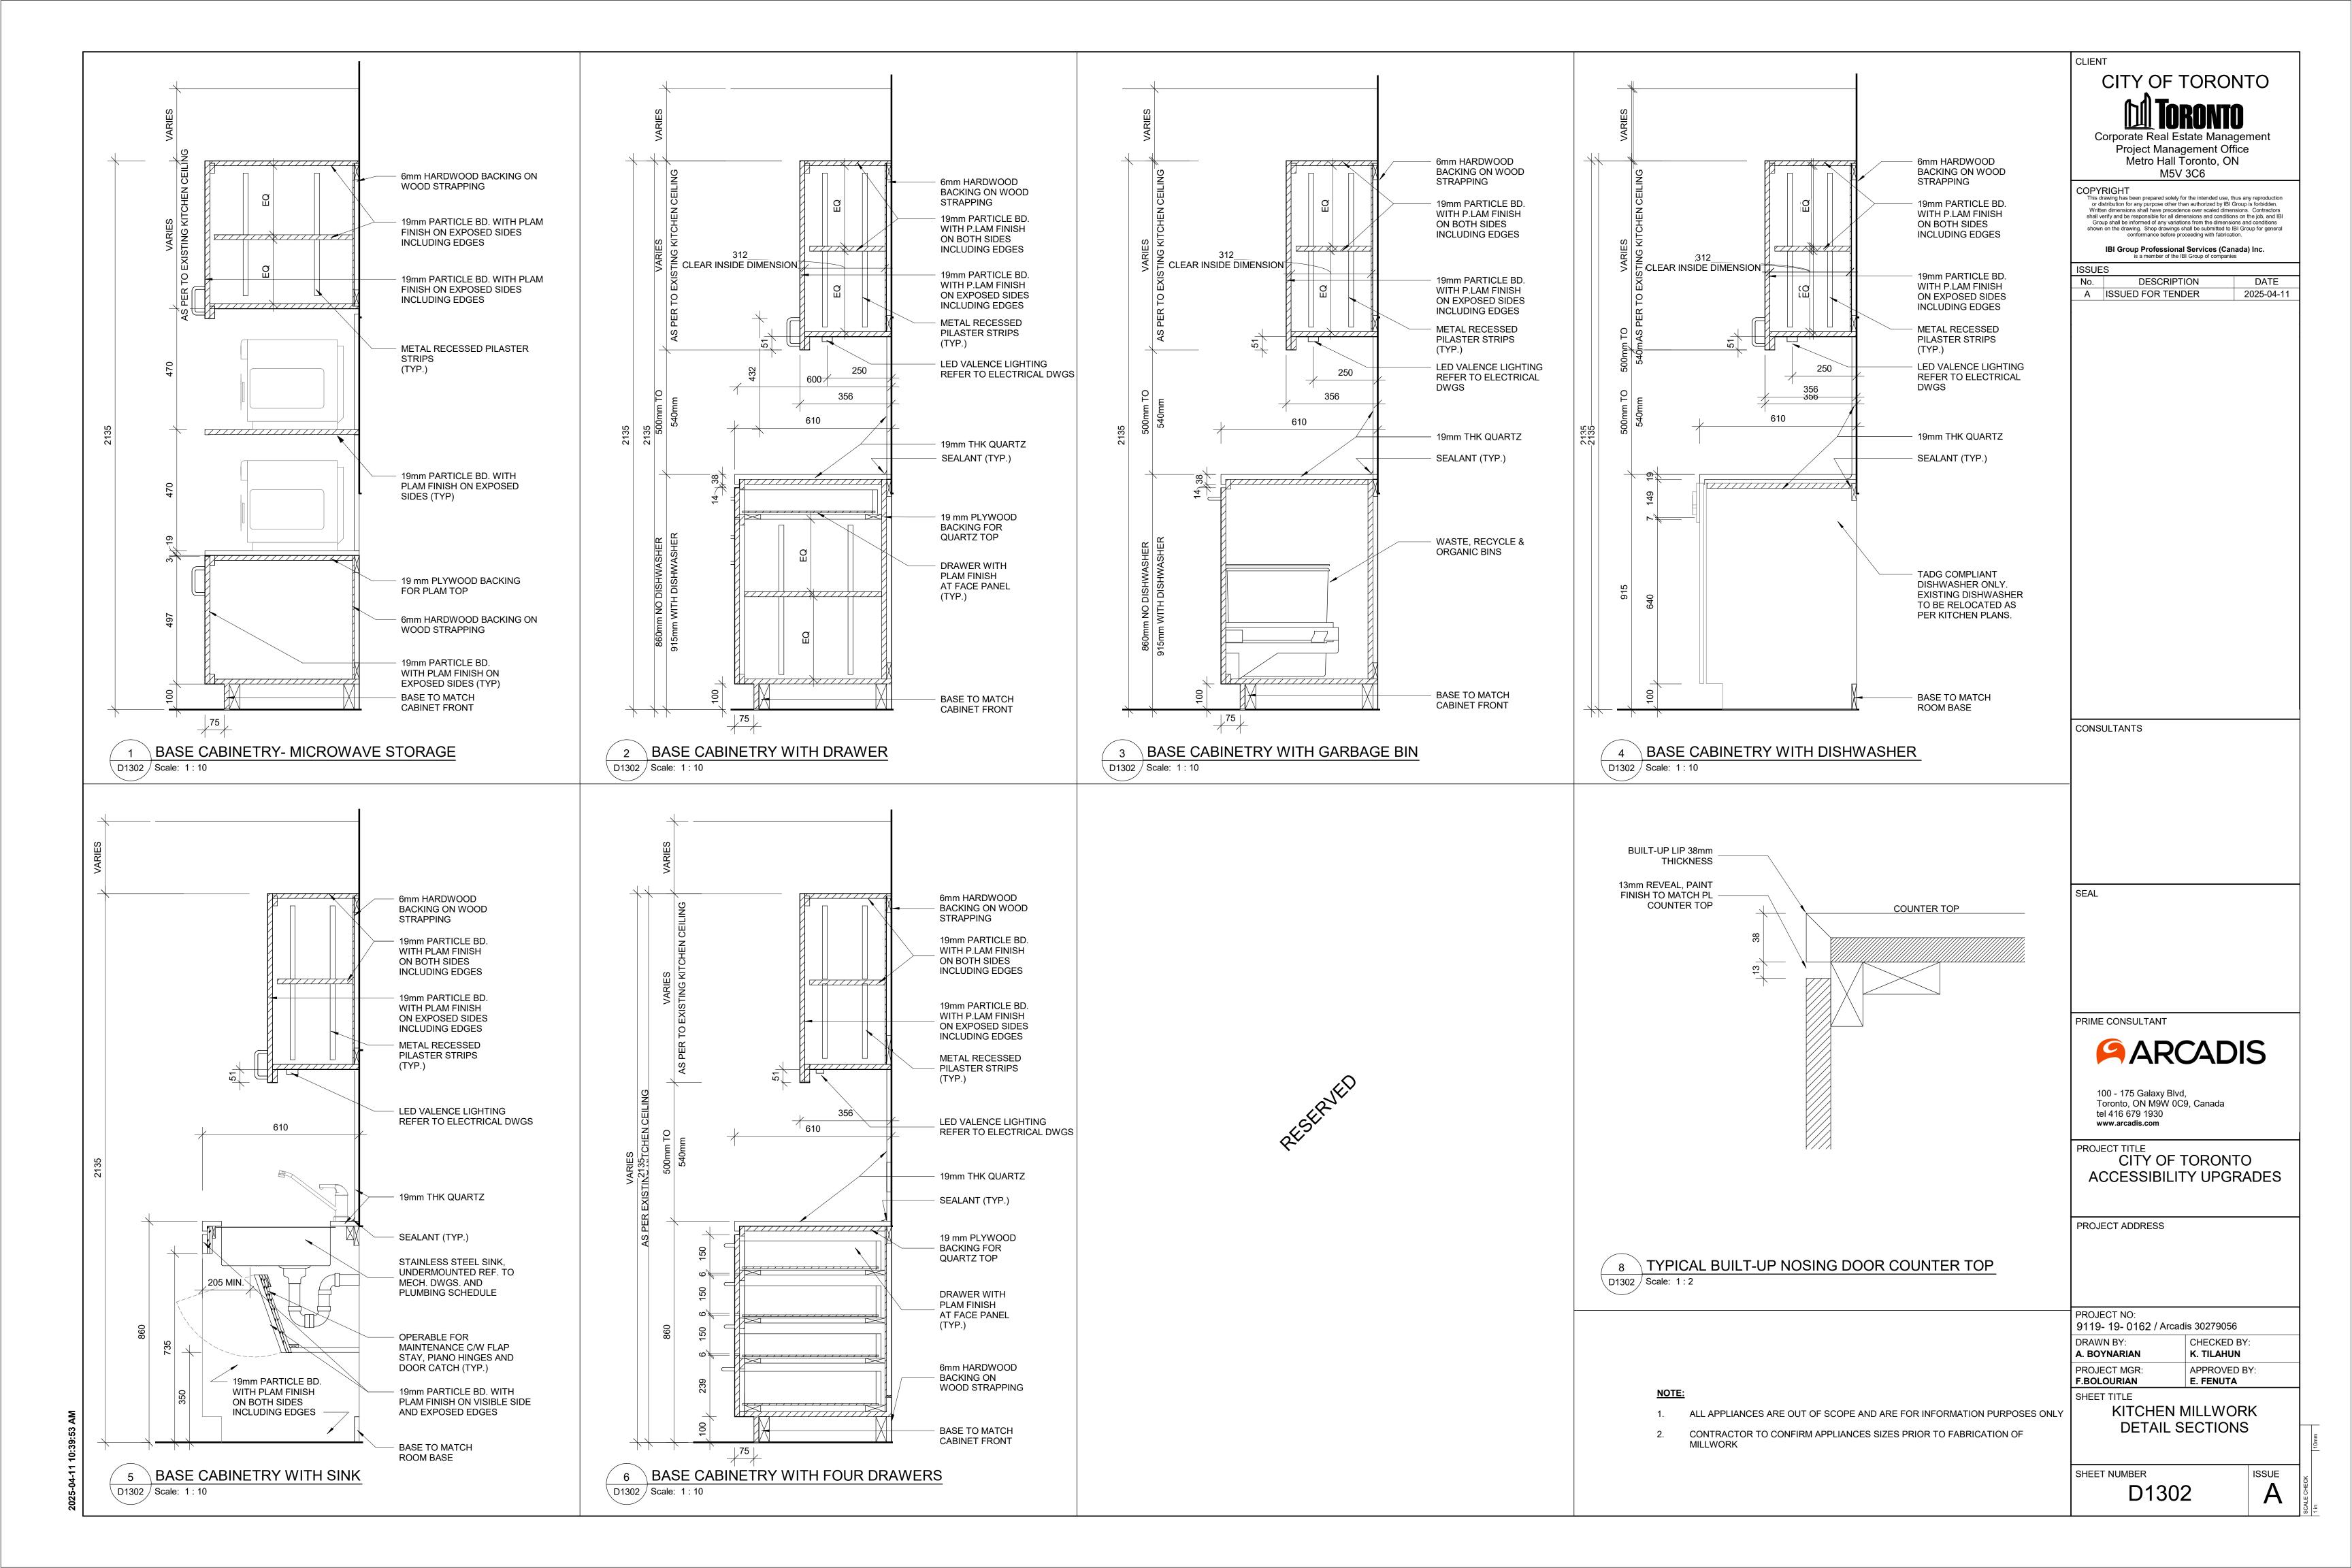


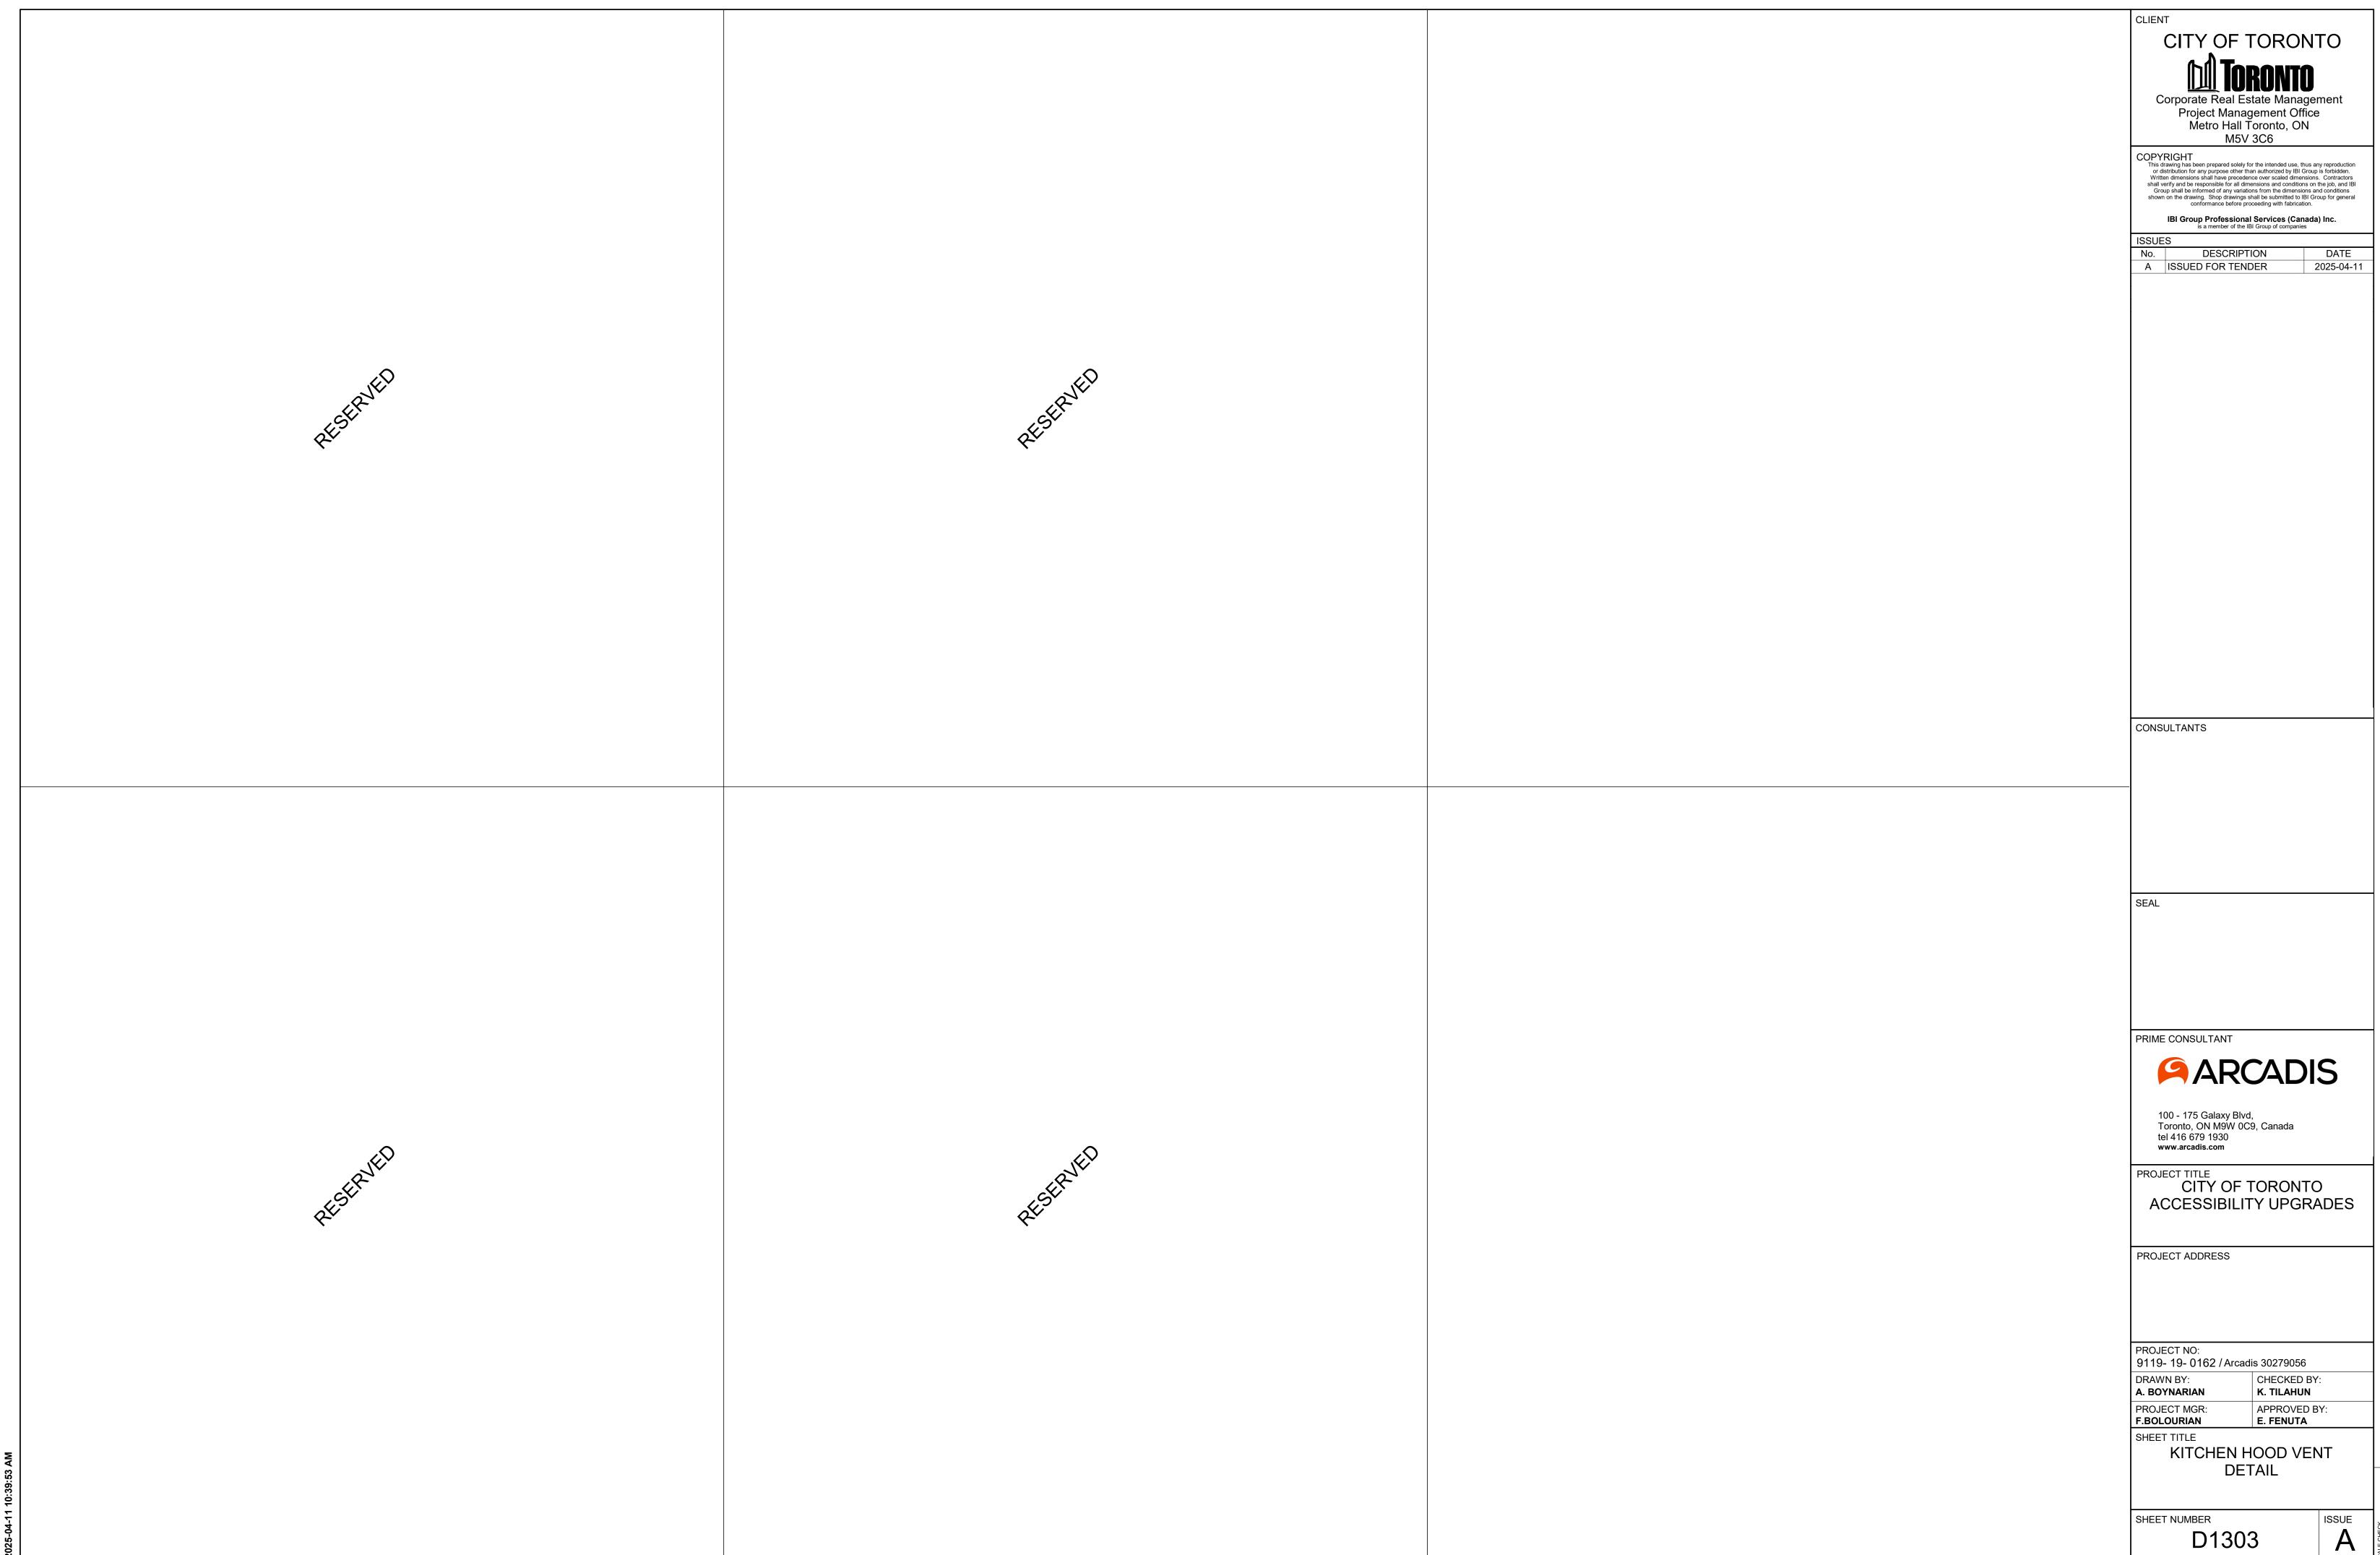


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	RESERVED	at Strate	RESERVED	CONSULTANTS  SEAL  PRIME CONSULTANT
2025-04-11 10:39:53 AM	RESERVED	RESERVED.	AKESE.	PROJECT NO: 9119- 19- 0162 / Arcadis 30279056  DRAWN BY: A. BOYNARIAN PROJECT MGR: F.BOLOURIAN SHEET TITLE RECEPTION DESK WITH TEMPERED GLASS MILLWORK  PROJECT NO: 911305  A 100 - 175 Galaxy Blvd, Toronto, ON M9W 0C9, Canada tel 416 679 1930 www.arcadis.com  PROJECT TITLE CITY OF TORONTO ACCESSIBILITY UPGRADES  PROJECT NO: 9119- 19- 0162 / Arcadis 30279056  DRAWN BY: A. BOYNARIAN K. TILAHUN PROJECT MGR: E. FENUTA  SHEET TITLE RECEPTION DESK WITH TEMPERED GLASS MILLWORK  SHEET NUMBER D1305  A 100-175 Galaxy Blvd, TORONTO MISSING ISSUE A 100-175 GAIAN SHEET NUMBER B 100-175

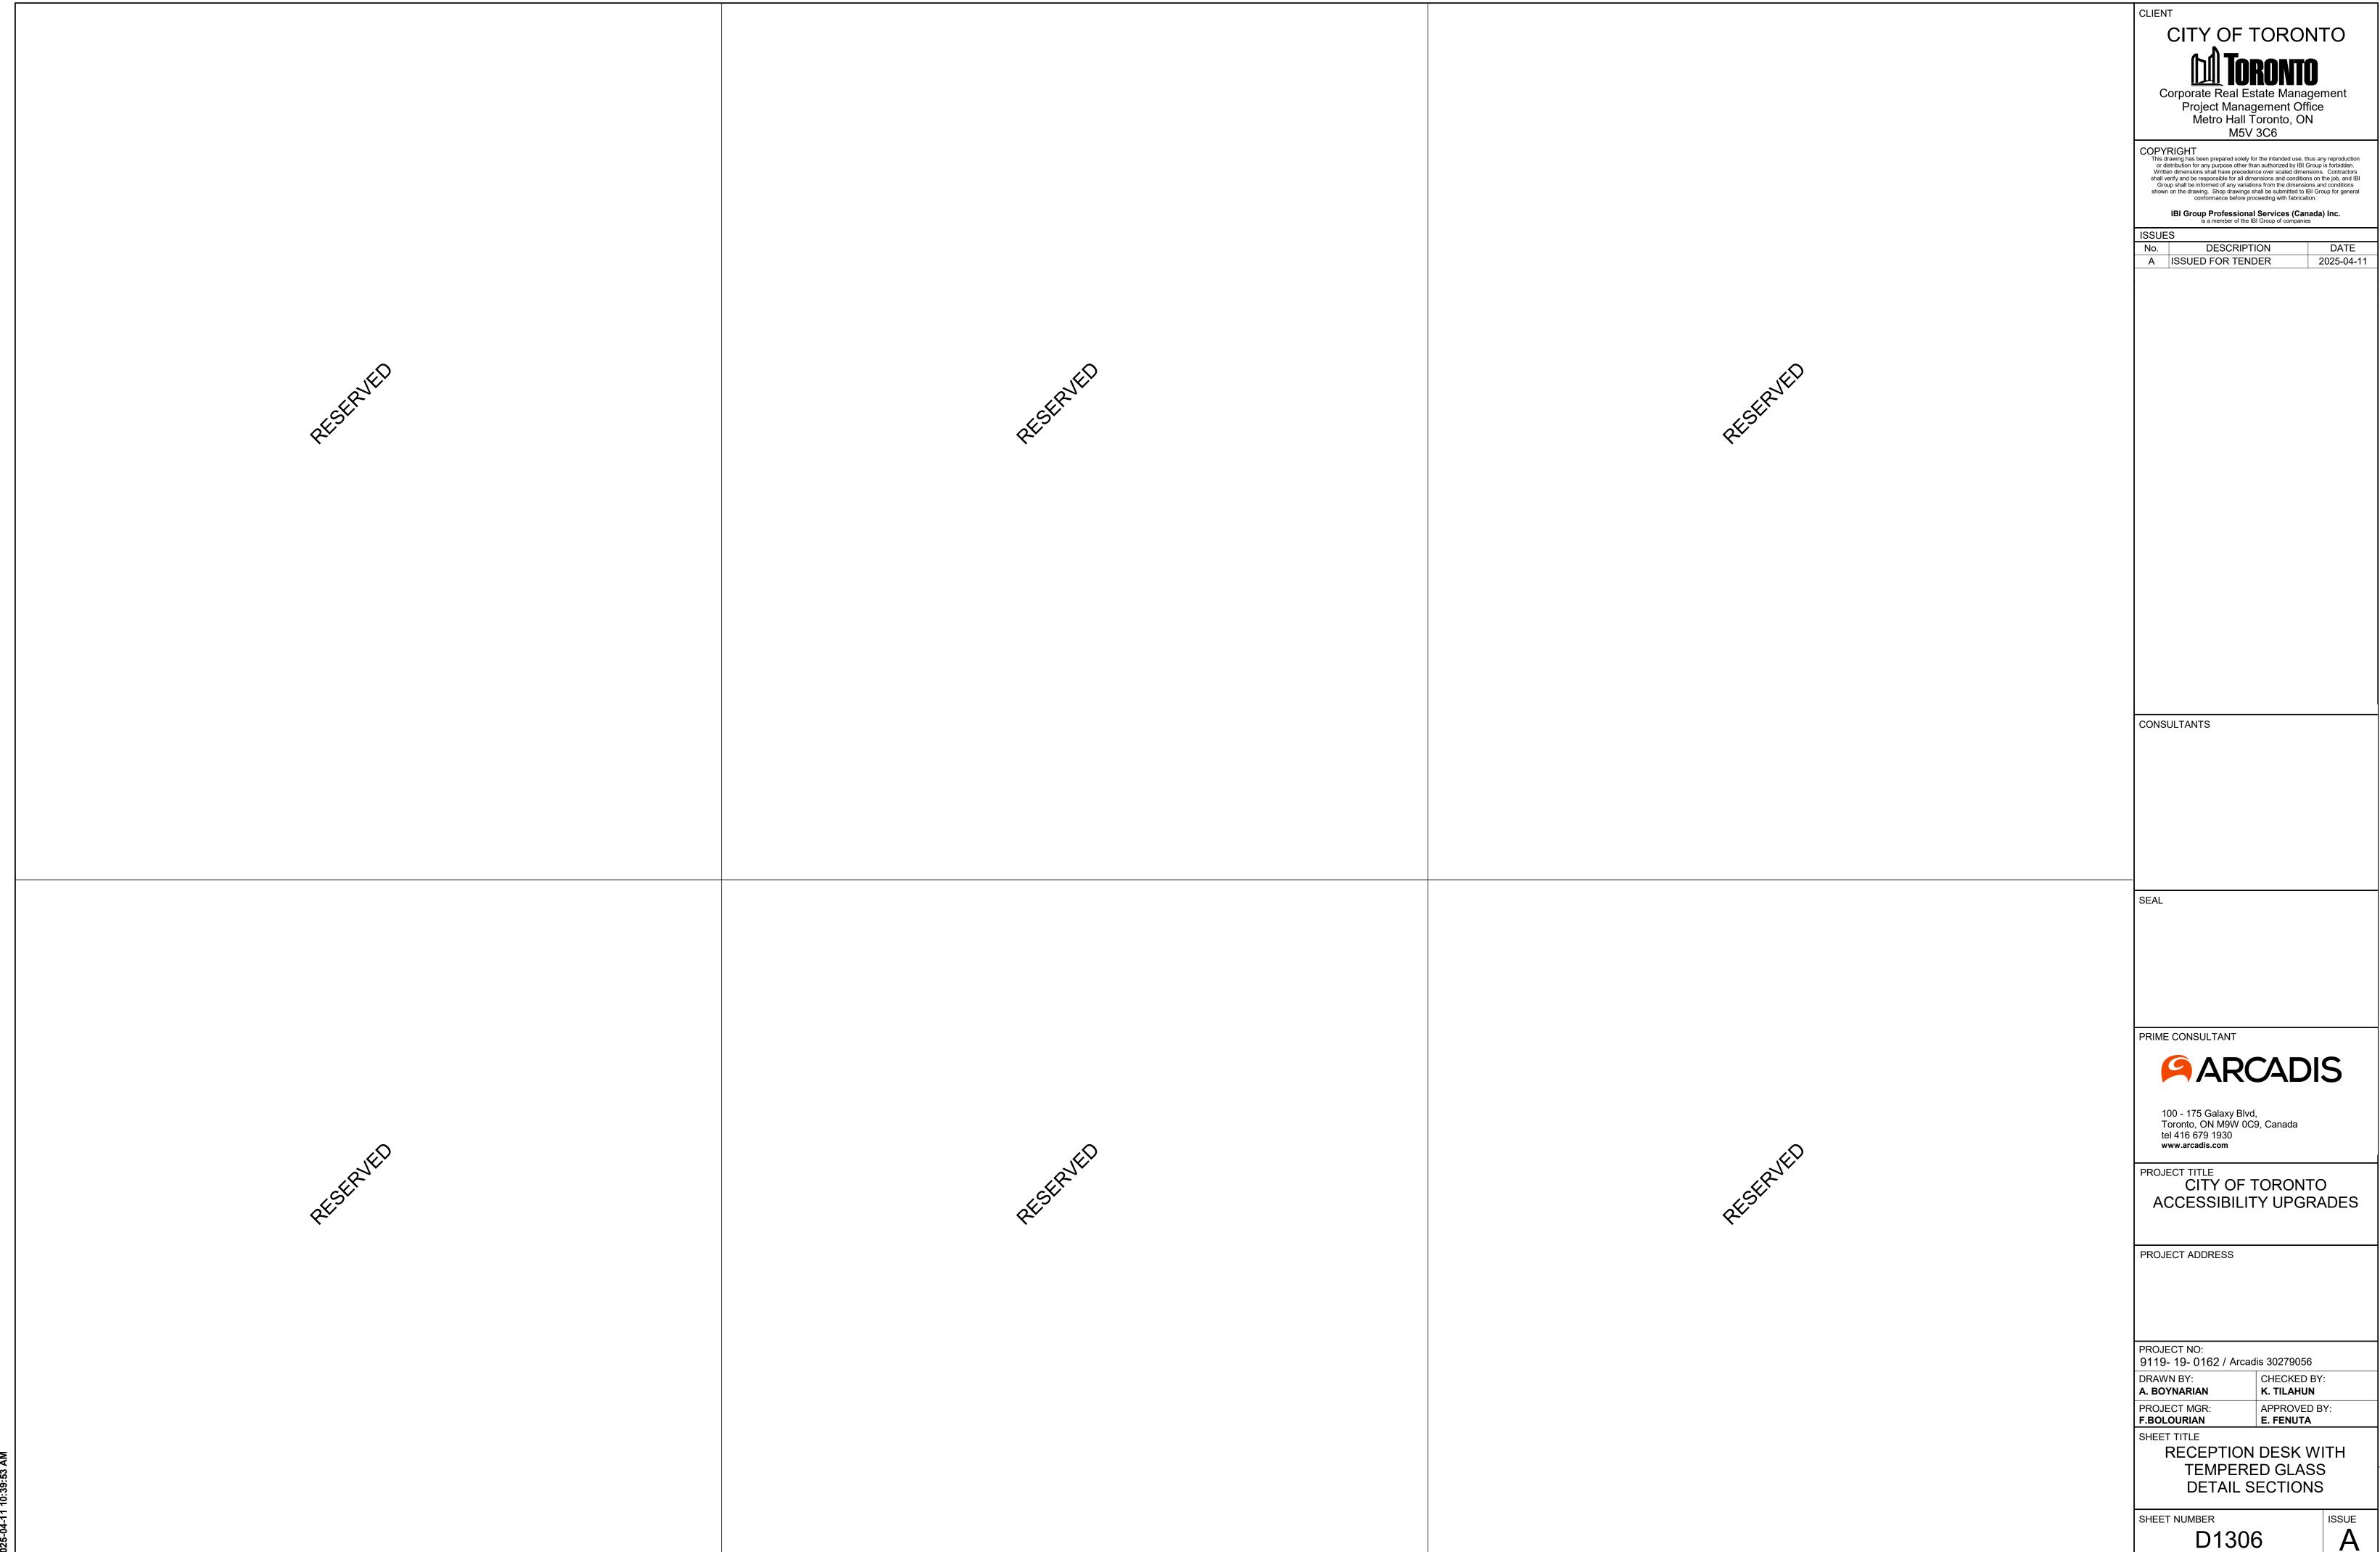

A

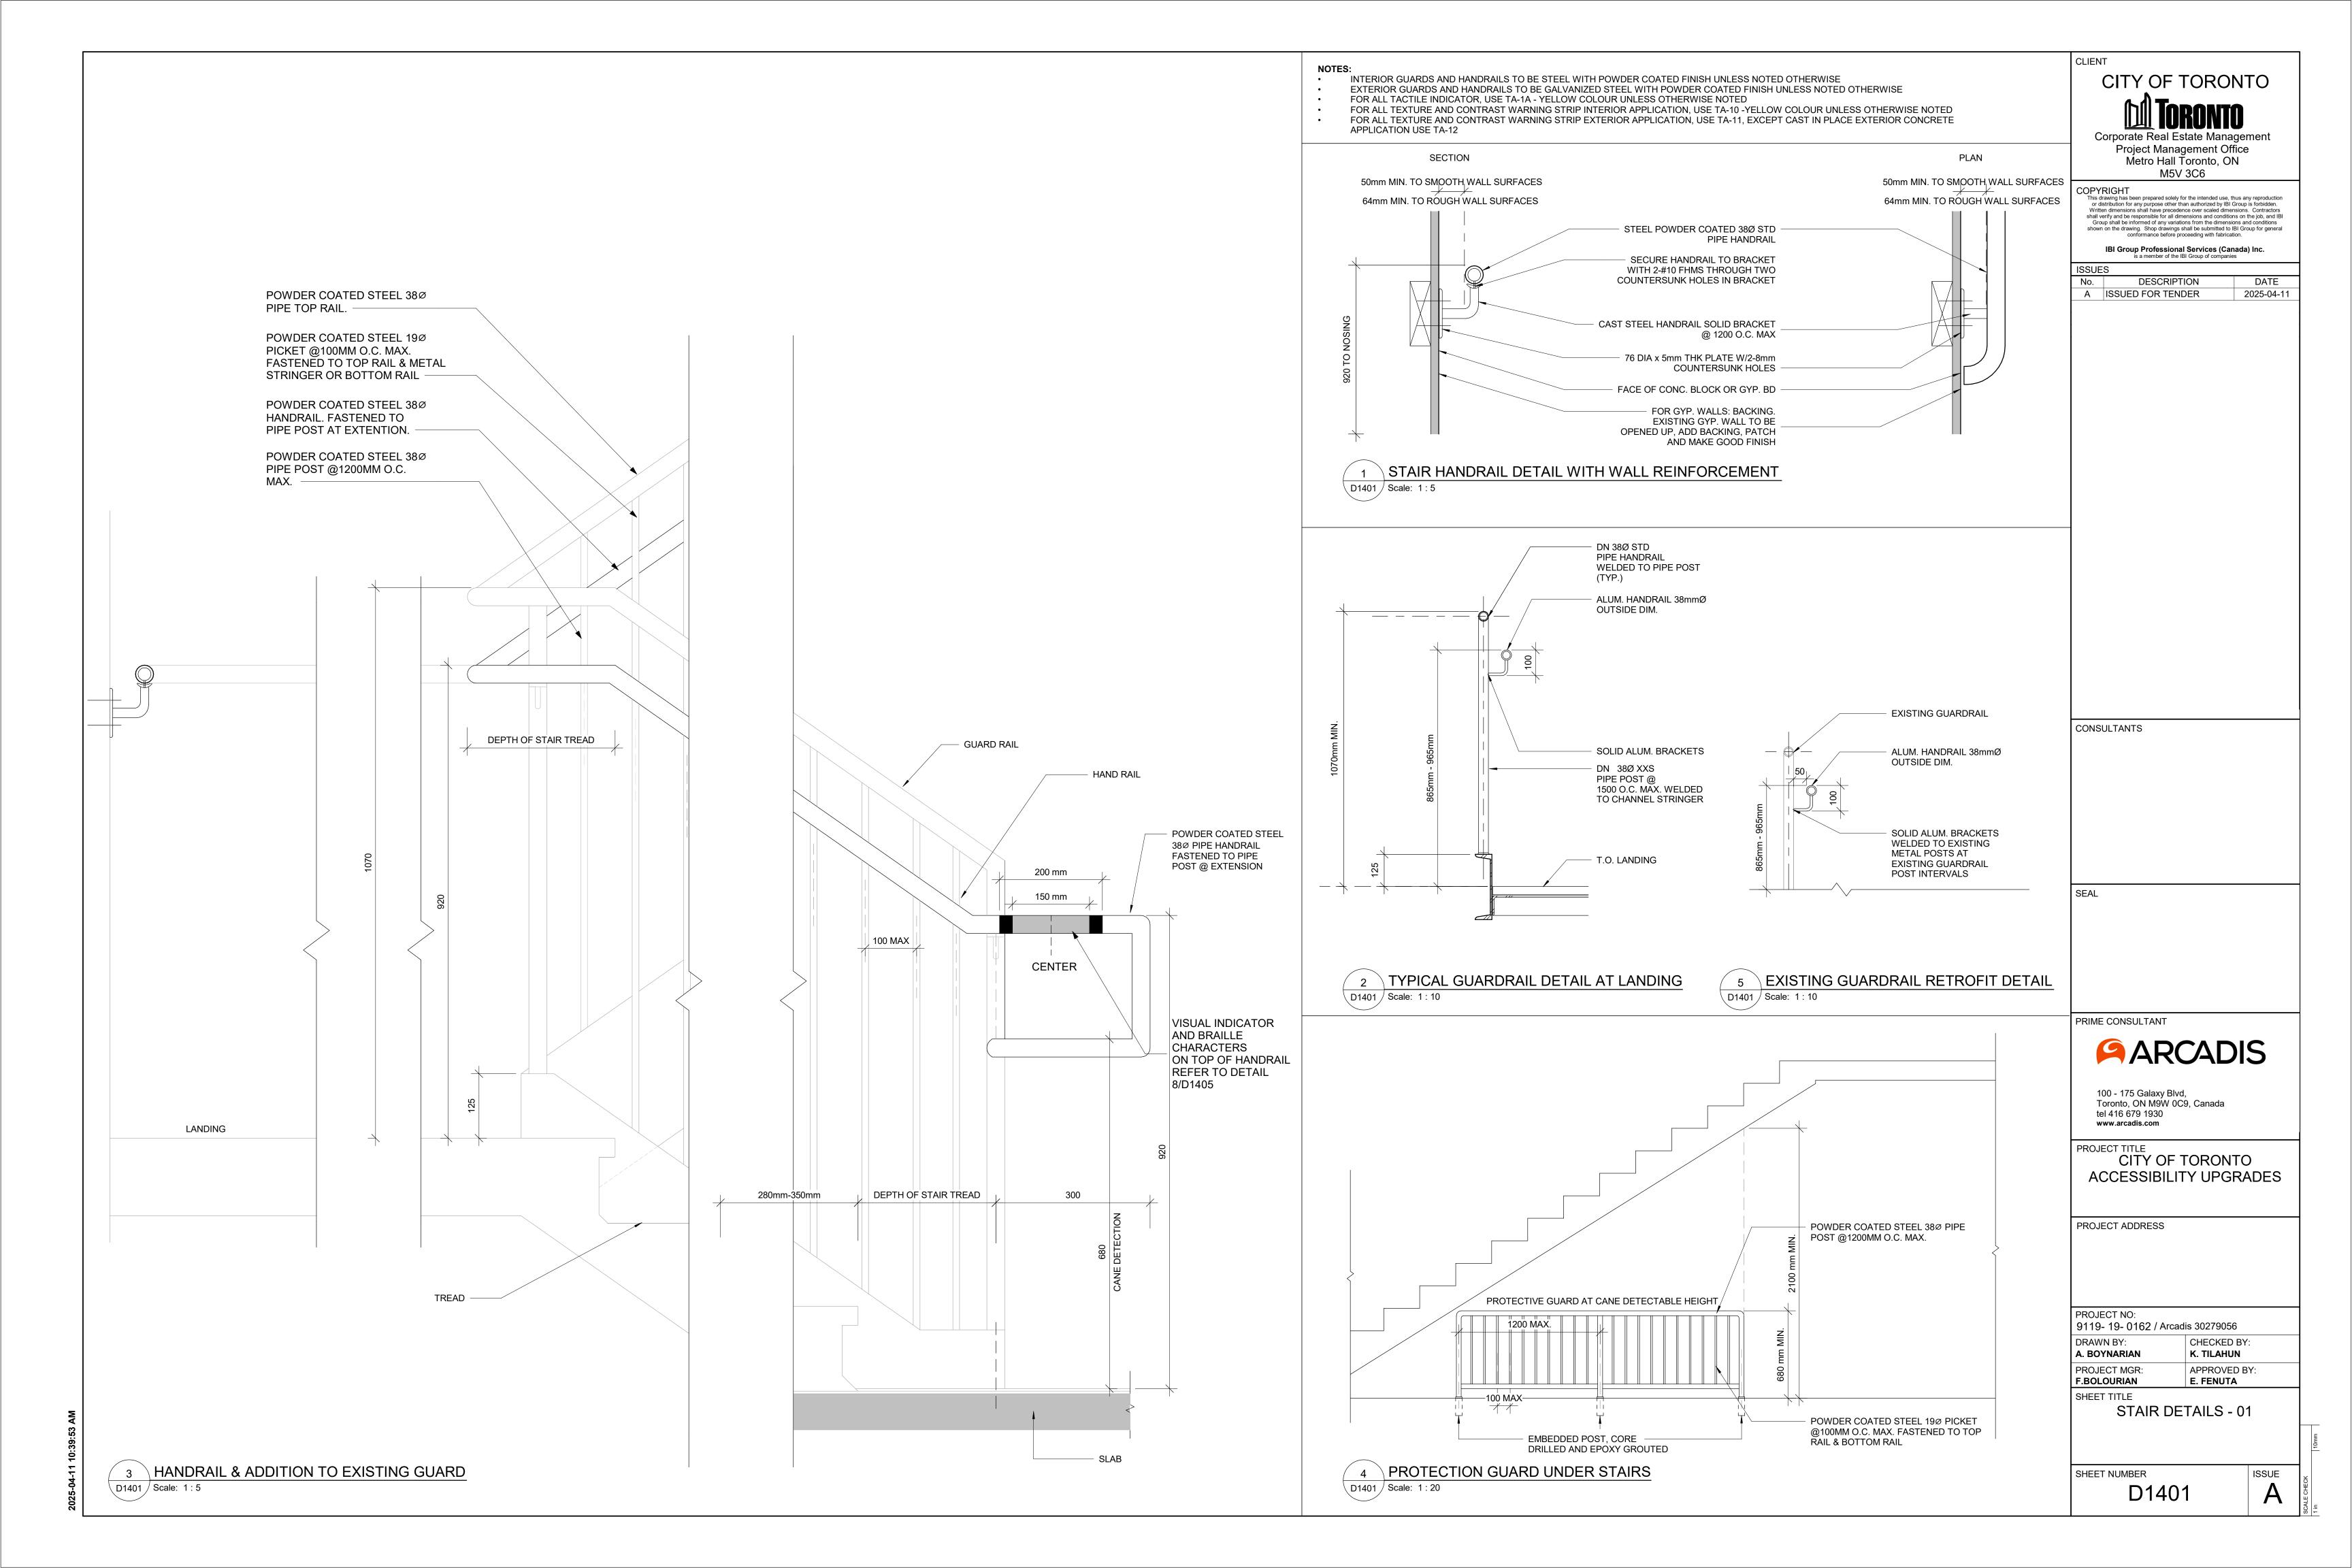

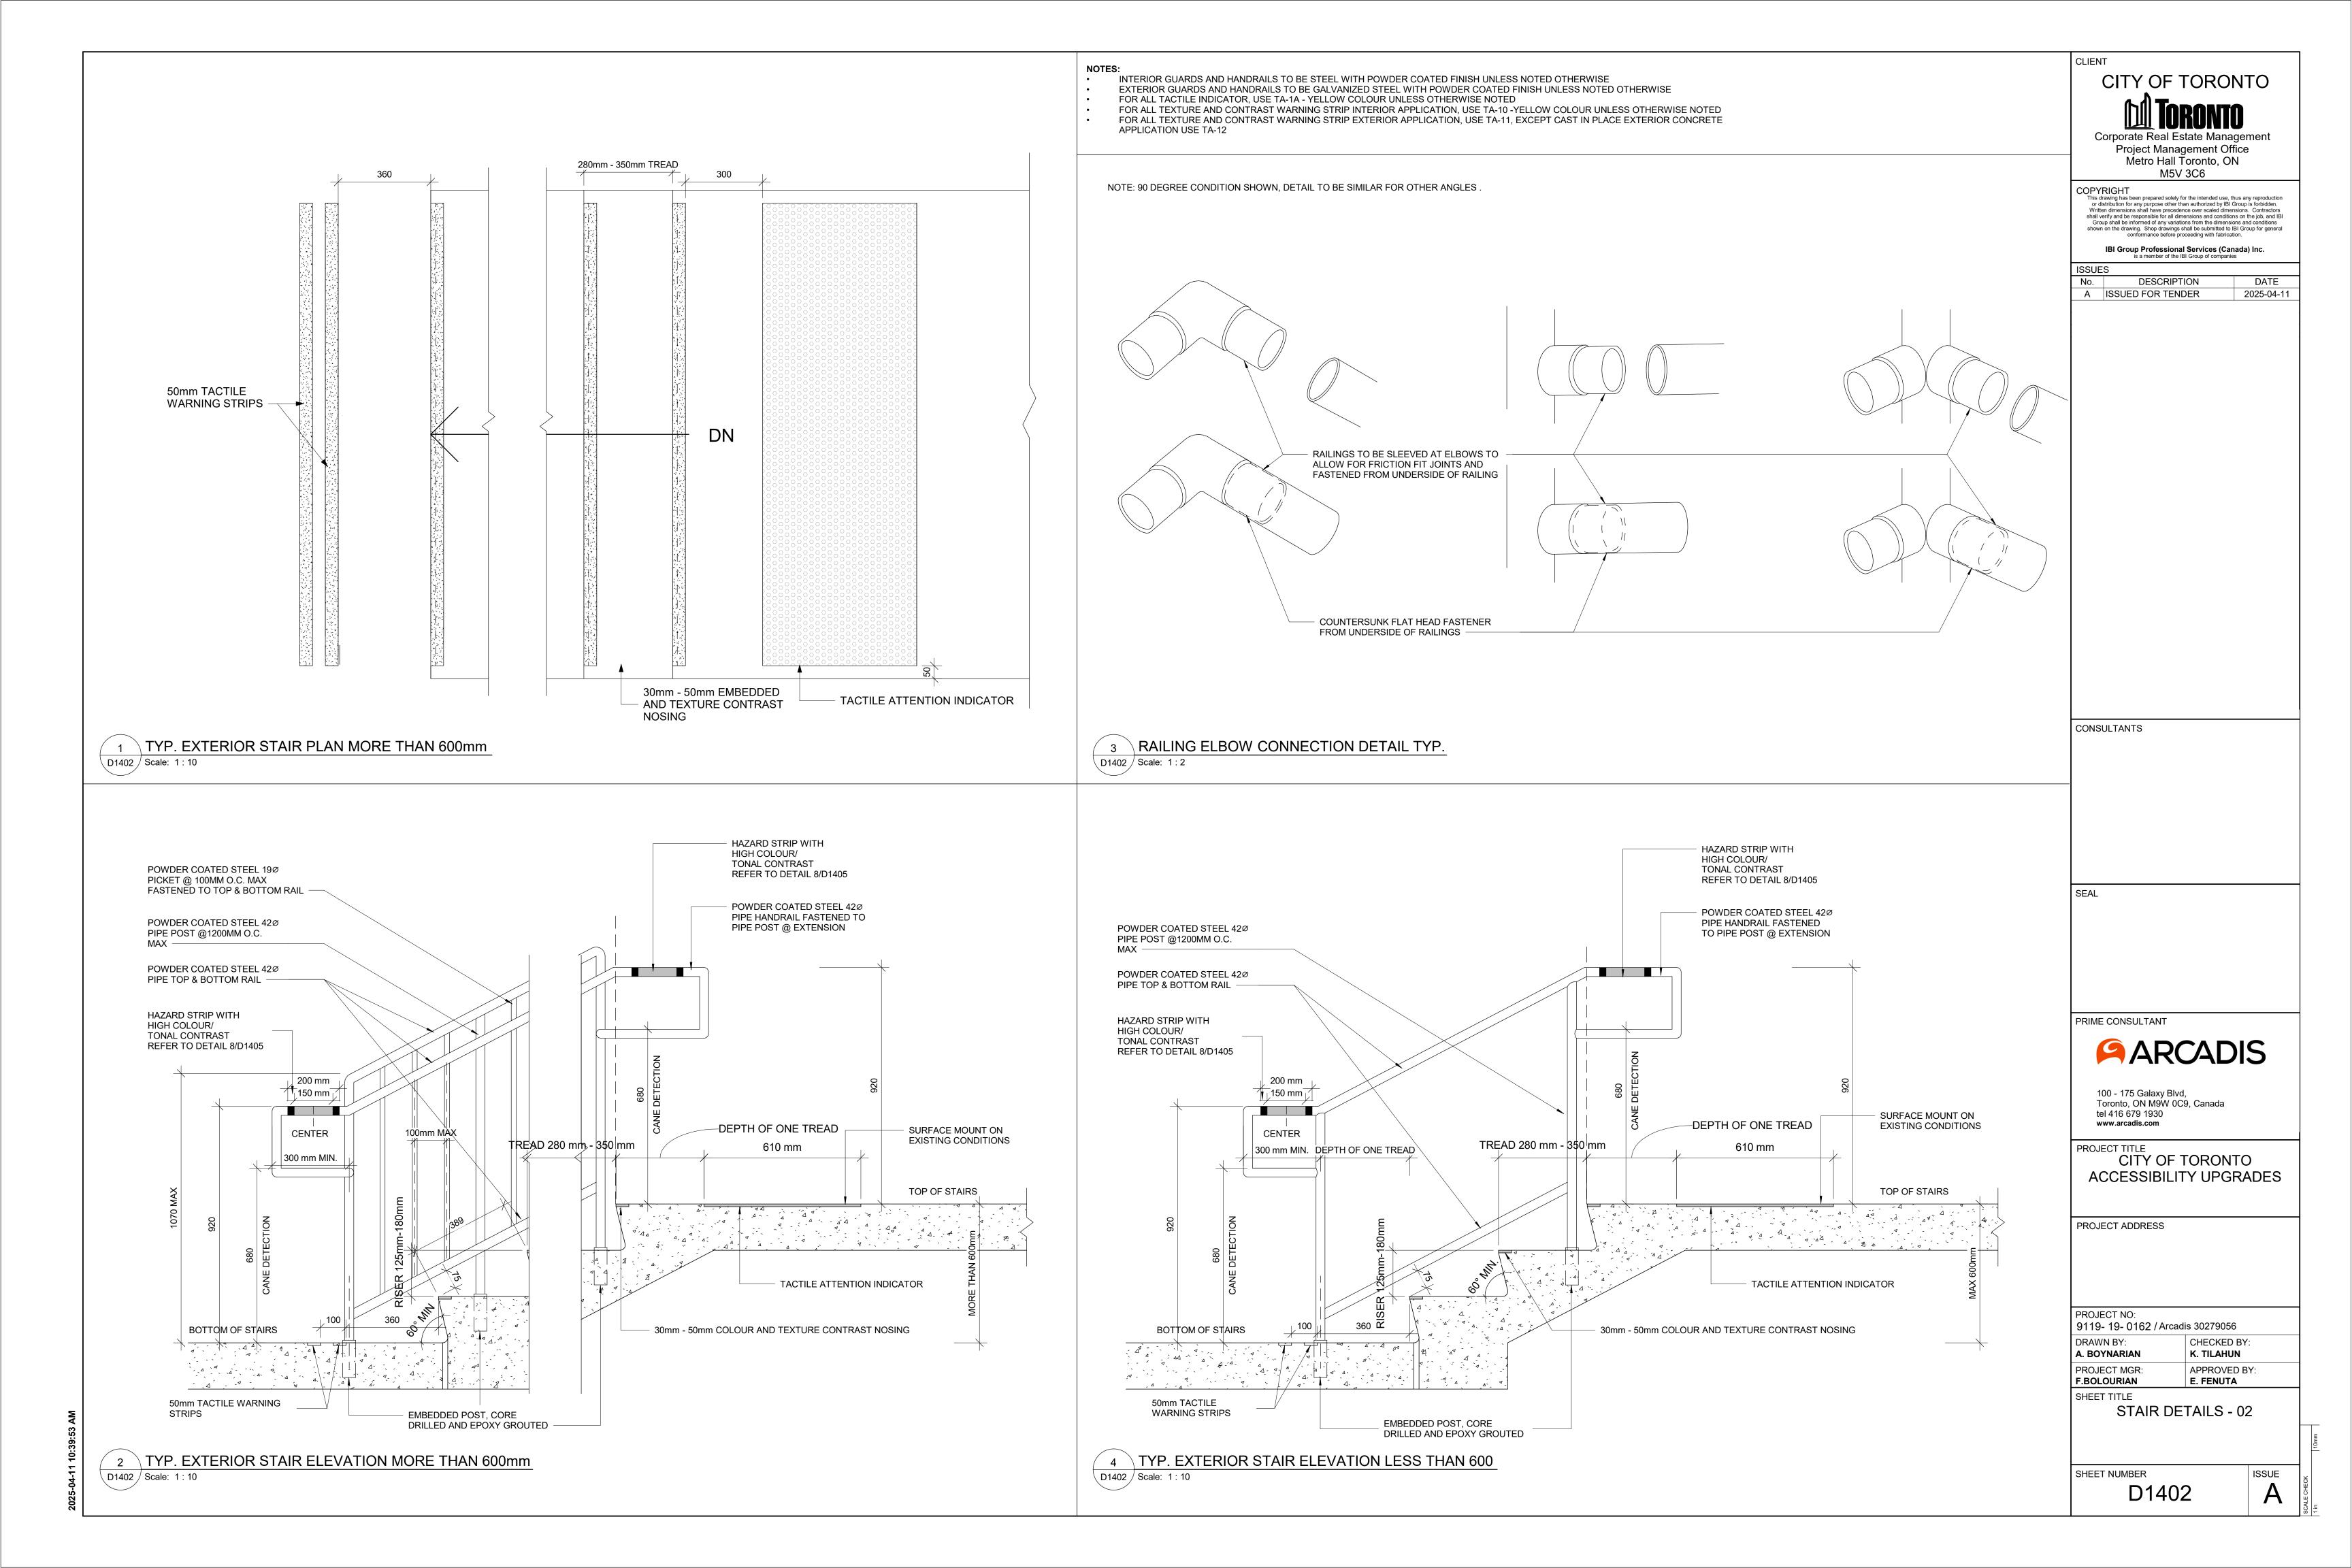

NOTES:

INTERIOR GUARDS AND HANDRAILS TO BE STEEL WITH POWDER COATED FINISH UNLESS NOTED OTHERWISE


EXTERIOR GUARDS AND HANDRAILS TO BE GALVANIZED STEEL WITH POWDER COATED FINISH UNLESS NOTED OTHERWISE


FOR ALL TACTILE INDICATOR, USE TA-1A - YELLOW COLOUR UNLESS OTHERWISE NOTED

FOR ALL TEXTURE AND CONTRAST WARNING STRIP INTERIOR APPLICATION, USE TA-10 -YELLOW COLOUR UNLESS OTHERWISE NOTED FOR ALL TEXTURE AND CONTRAST WARNING STRIP EXTERIOR APPLICATION, USE TA-11, EXCEPT CAST IN PLACE EXTERIOR CONCRETE

APPLICATION USE TA-12

10x38 BAR FASTENED 19Ø BAR PICKETS FASTENED TO BETWEEN POSTS STEEL BAR @ 100 O.C. MAX NON SLIP NOSING (TYP.) DN 38 Ø XXS PIPE POST @ 1200 O.C. MAX. FASTENED TO CHANNEL STRINGER

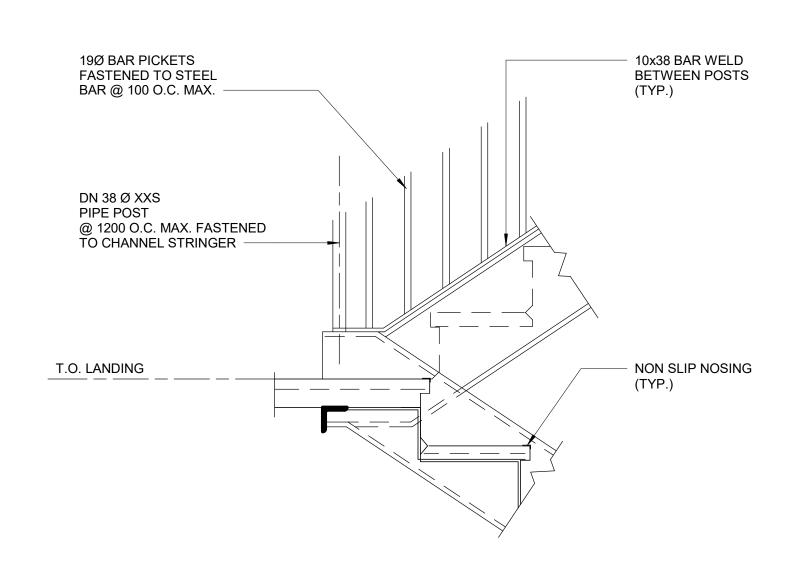

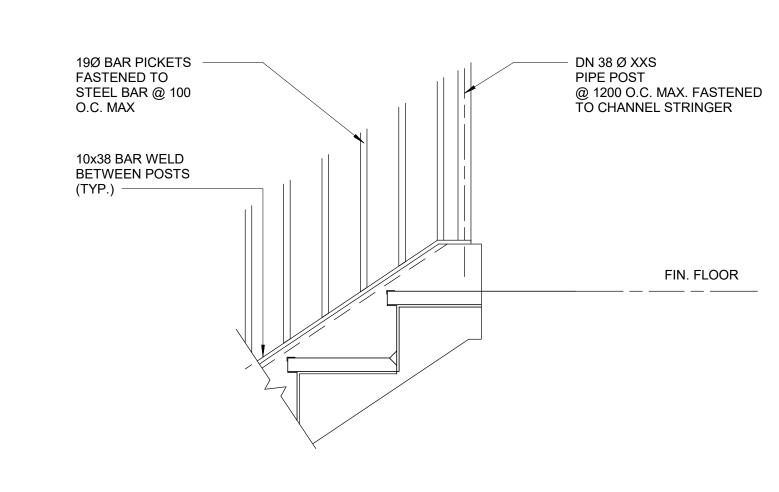

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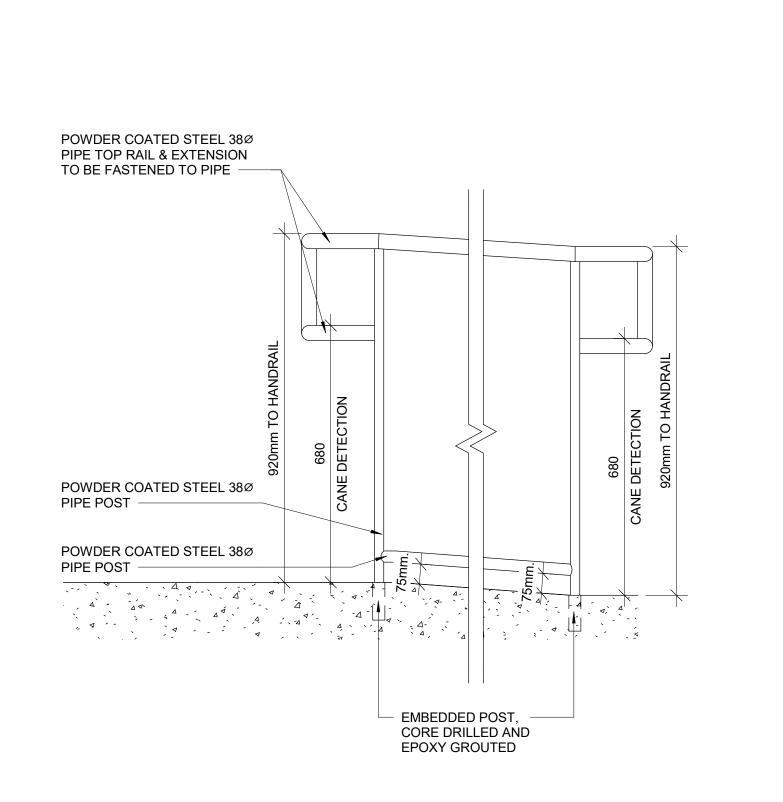
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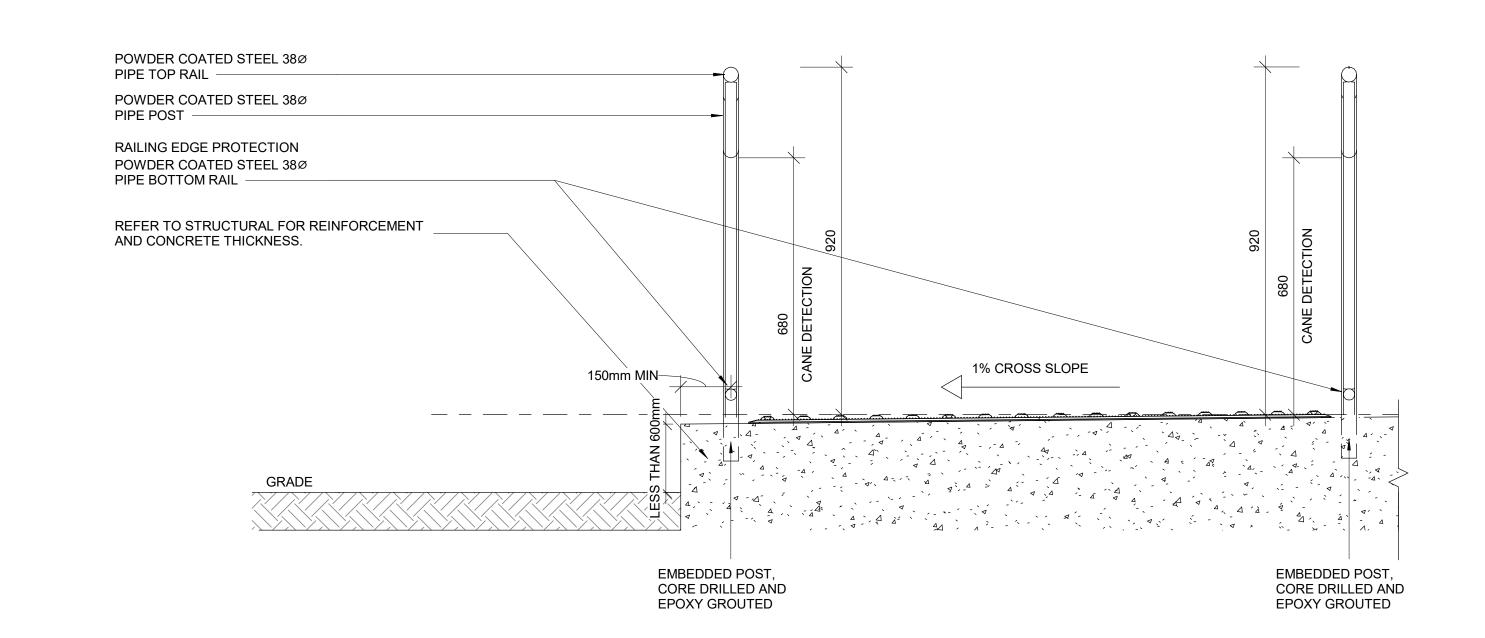
DATE

2025-04-11

✓ 1 TYP. GUARDRAIL CONNECTION DETAIL AT STEEL STRINGER D1403 Scale: 1:10



2 ELEVATION OF GUARDRAIL FOR RAMP AT GRADE DIFFERENCE LESS THAN 600 MM D1403 / Scale: 1:10



3 SECTION OF GUARDRAIL FOR RAMP AT GRADE DIFFERENCE LESS THAN 600 MM D1403 Scale: 1:10

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PROJECT TITLE CITY OF TORONTO ACCESSIBILITY UPGRADES

PROJECT ADDRESS

PROJECT NO:


9119- 19- 0162 / Arcadis 30279056 DRAWN BY: CHECKED BY: A. BOYNARIAN K. TILAHUN


PROJECT MGR APPROVED BY: E. FENUTA F.BOLOURIAN SHEET TITLE


RAMP DETAILS - 01

SHEET NUMBER

ISSUE D1403 A

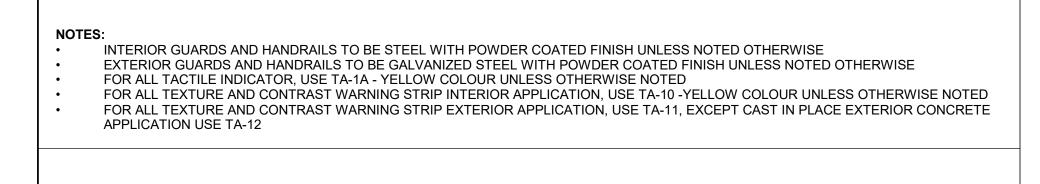

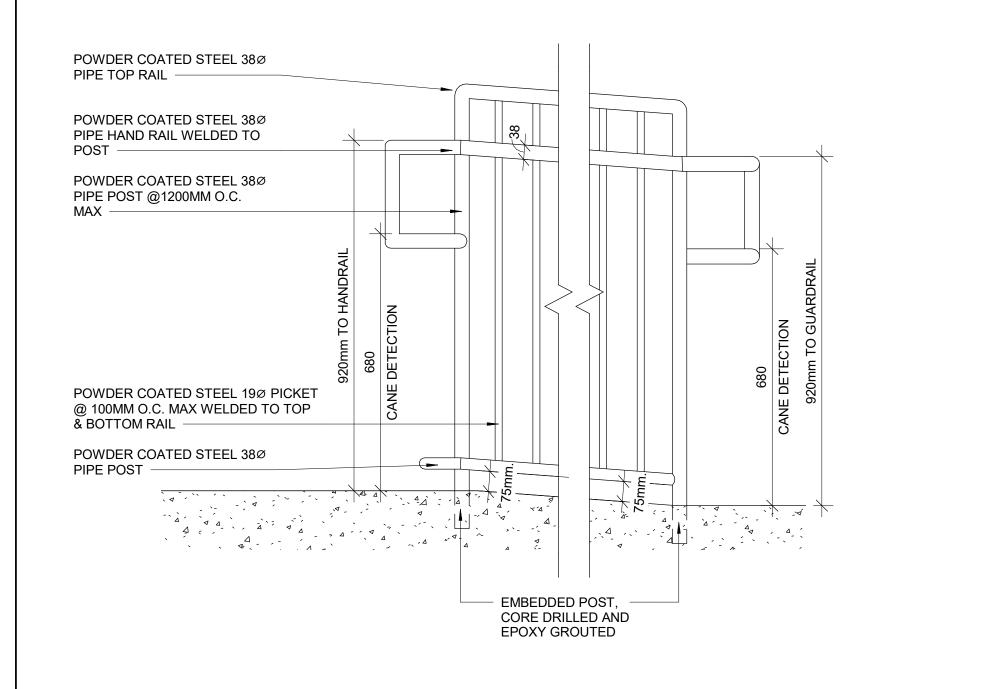

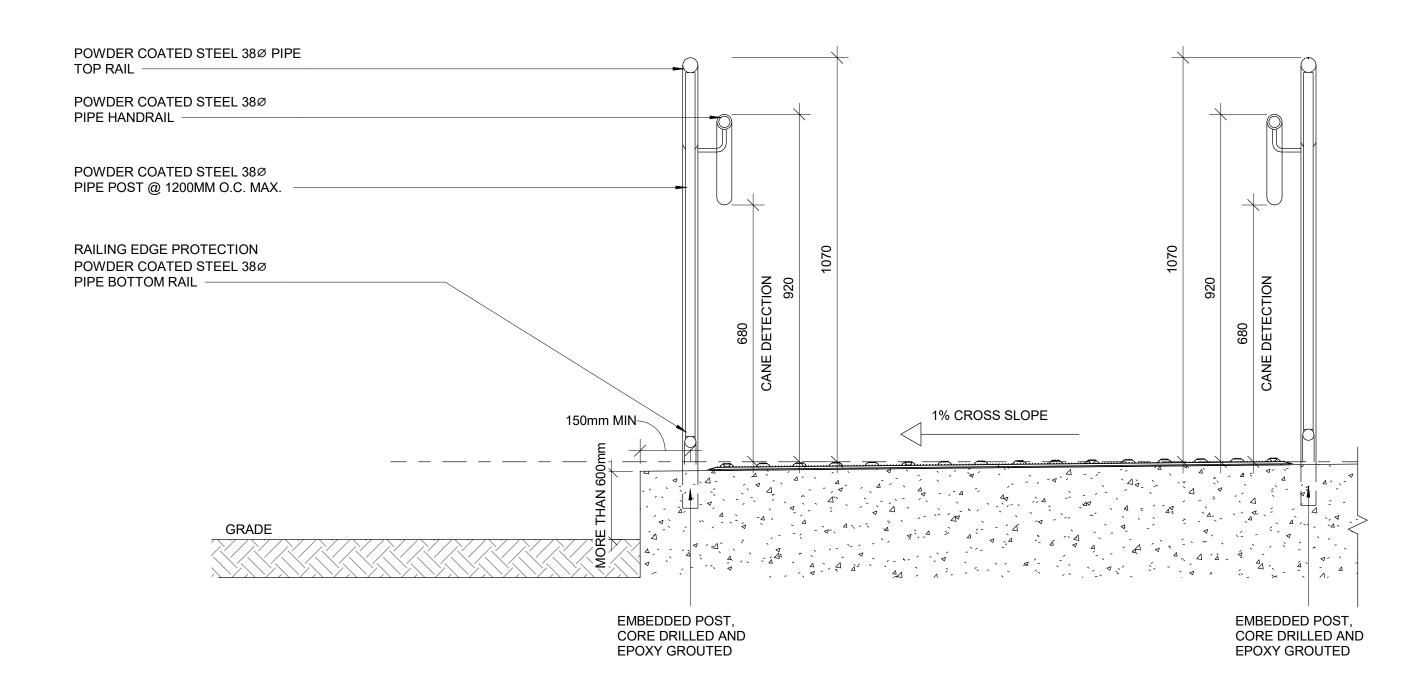

1 ELEVATION OF GUARDRAIL FOR RAMP AT GRADE DIFFERENCE MORE THAN 600 MM D1404 Scale: 1:10

2 SECTION OF GUARDRAIL FOR RAMP AT GRADE DIFFERENCE MORE THAN 600 MM D1404 | Scale: 1:10

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PROJECT ADDRESS


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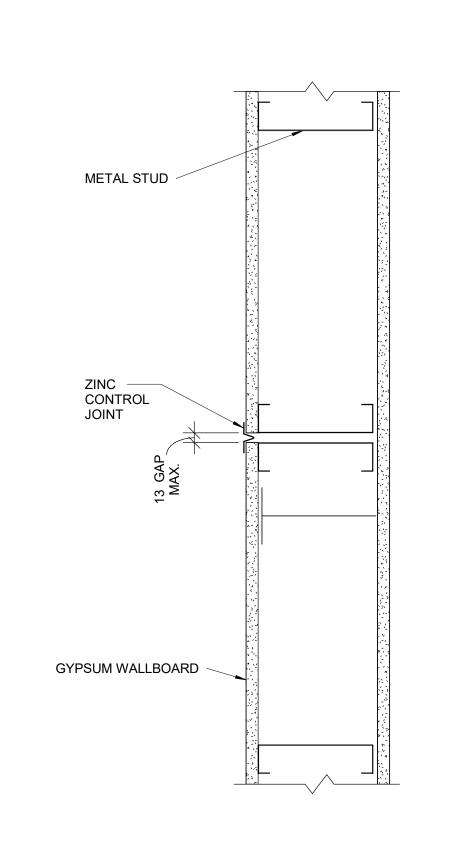
9119- 19- 0162 / Arcadis 30279056 DRAWN BY: CHECKED BY:

K. TILAHUN A. BOYNARIAN APPROVED BY: **E. FENUTA** PROJECT MGR: F.BOLOURIAN

SHEET TITLE RAMP DETAILS - 02


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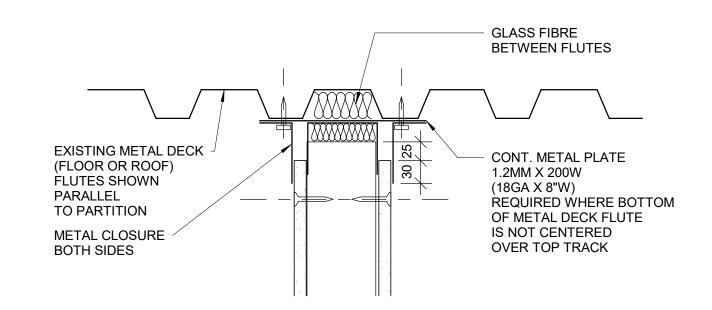



1 CONTROL JOINT PLAN DETAIL - DRYWALL

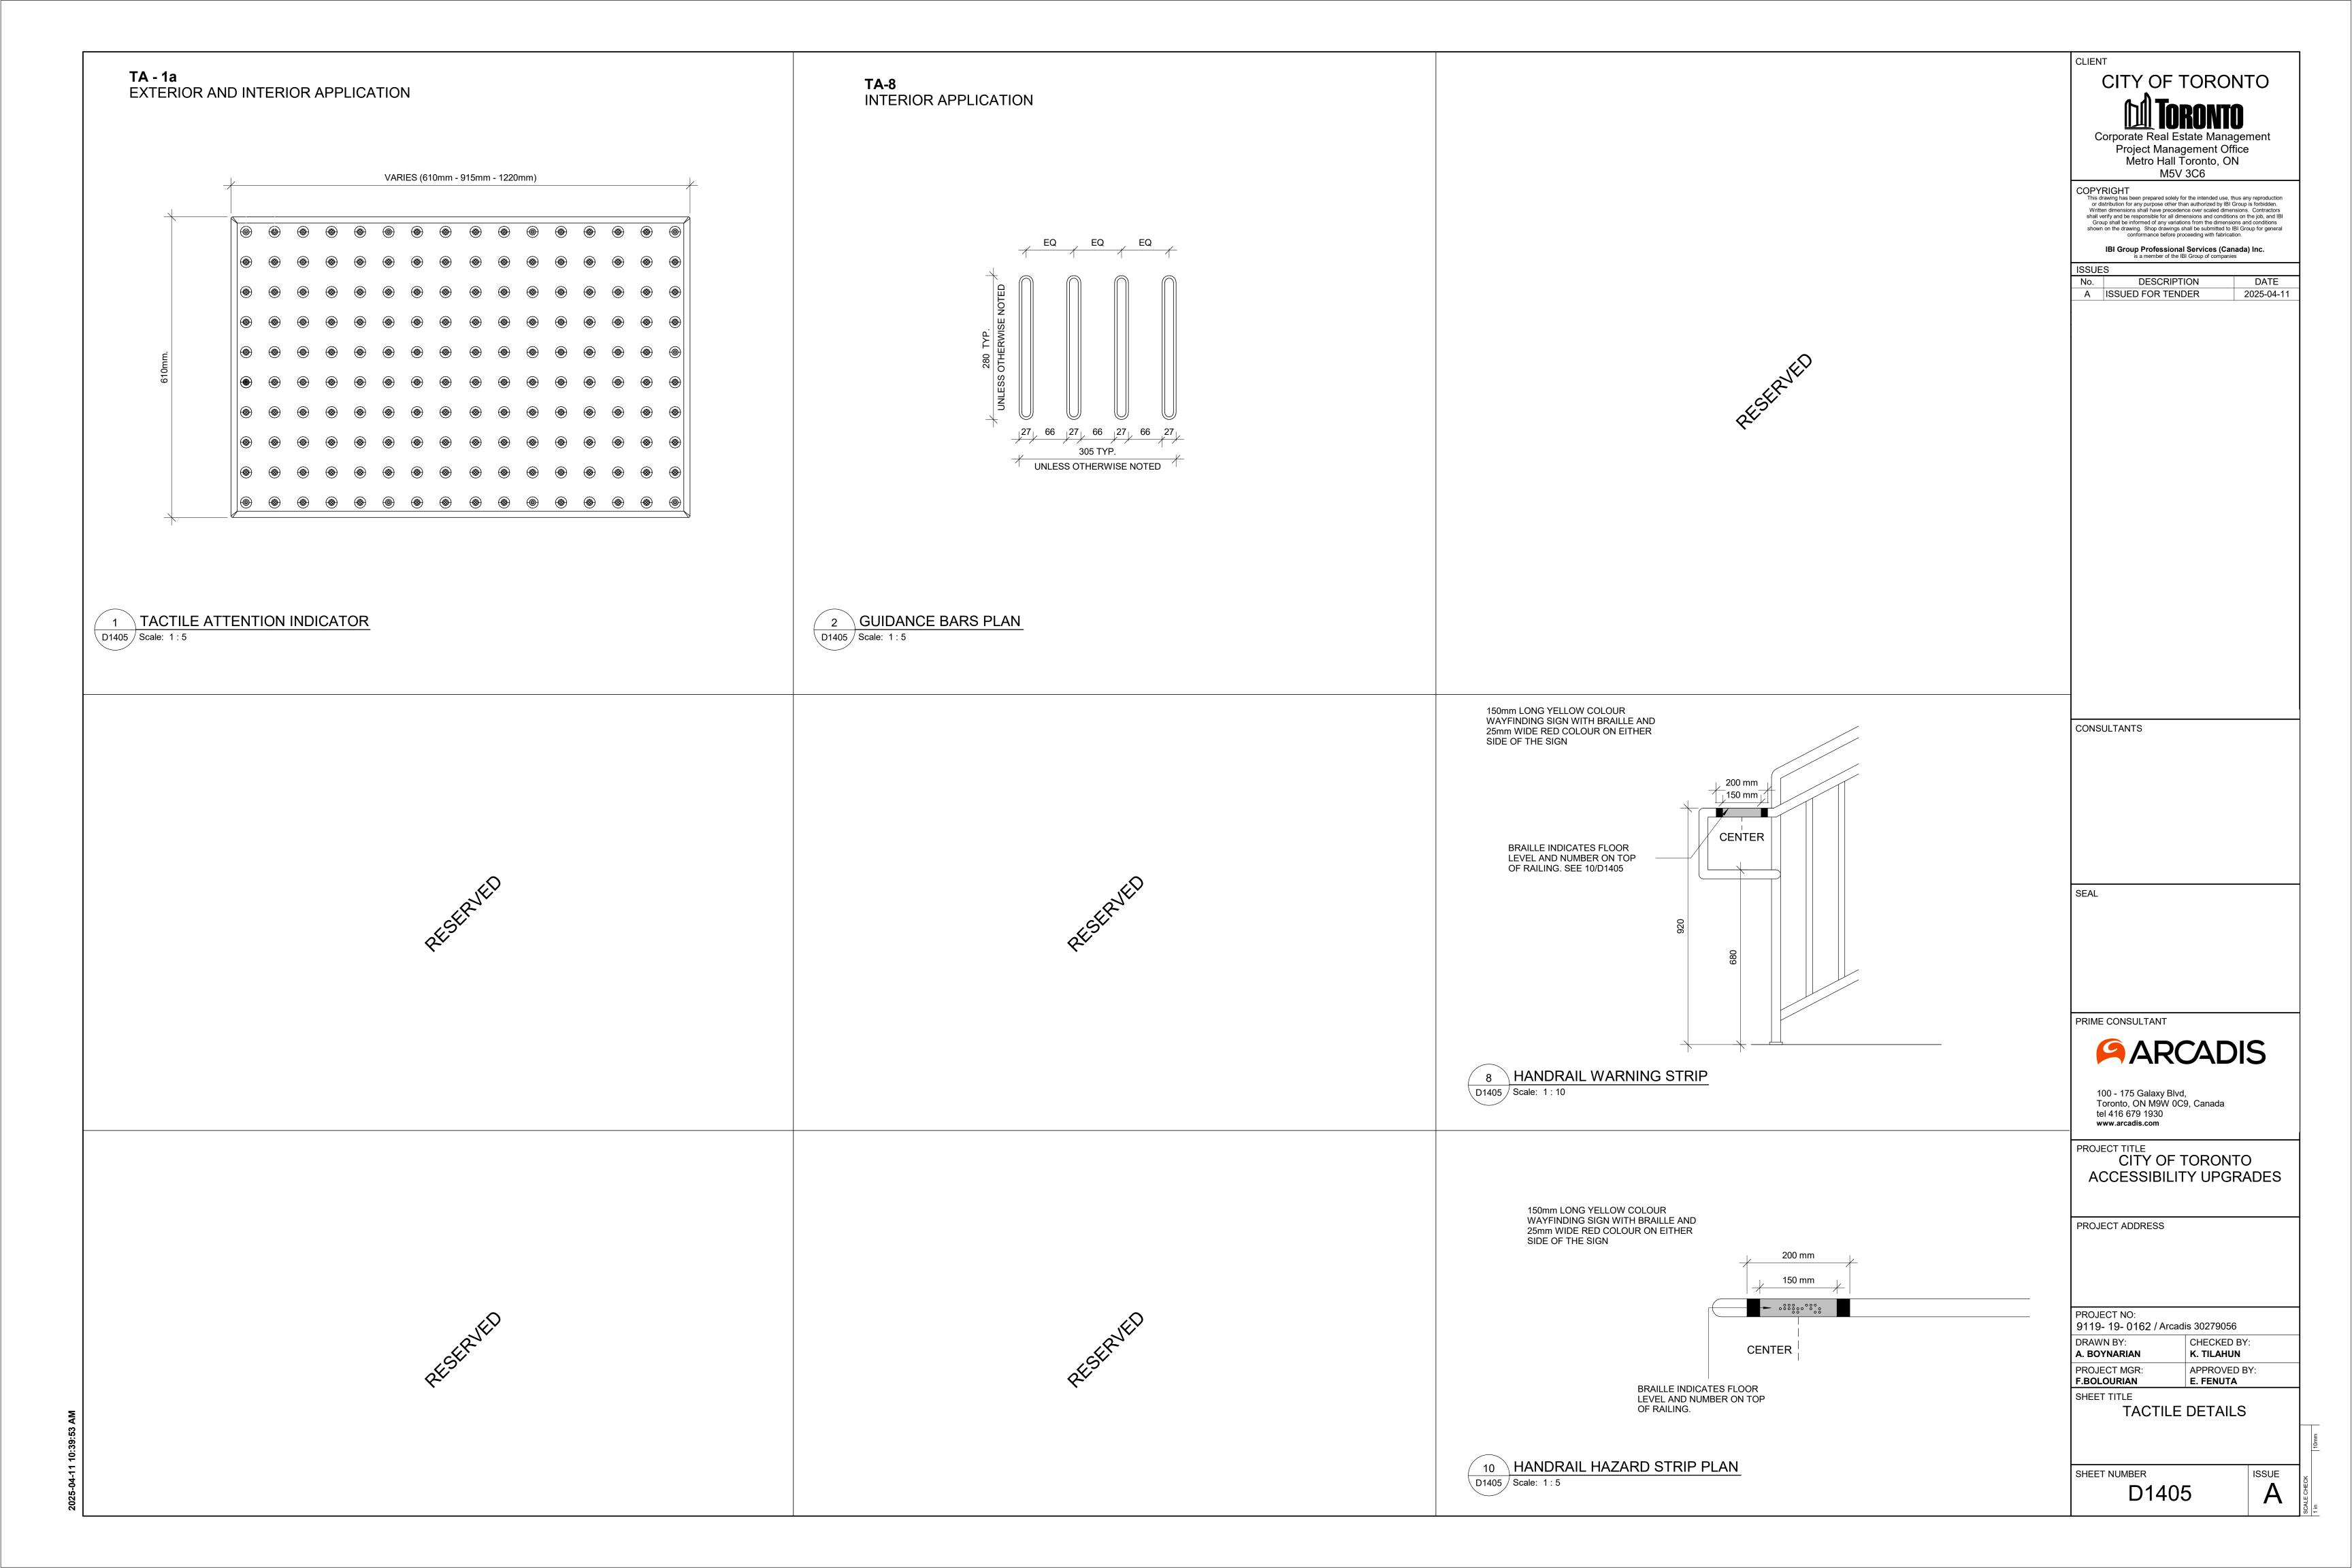




3 HEAD DRYWALL FIRE RATED PARTITION D1501 Scale: 1:5

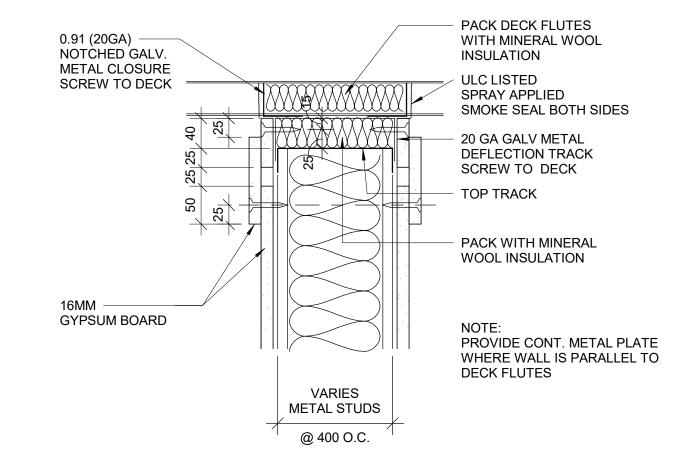

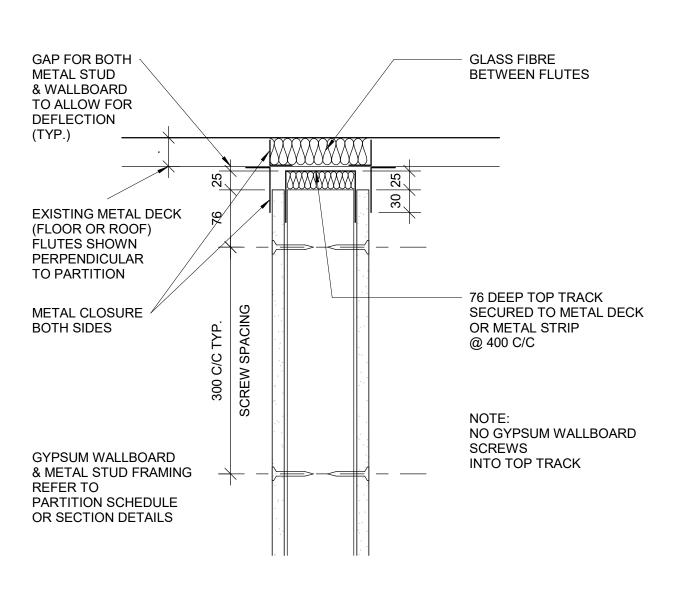

4 HEAD FULL HEIGHT DRYWALL PARTITION - NON RATED D1501 Scale: 1:5

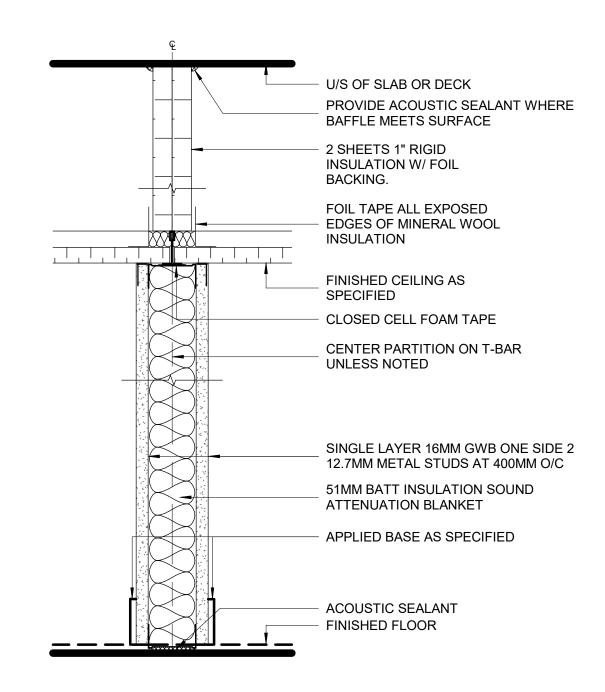

NOTE: ANCHOR TOP TRACK TO T-BAR WITH CLIPS OR FASTENERS DO NOT SCREW TO MAIN T's

5 DRYWALL - ACOUSTICAL TREATMENT ABOVE CEILING

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PROJECT TITLE CITY OF TORONTO ACCESSIBILITY UPGRADES

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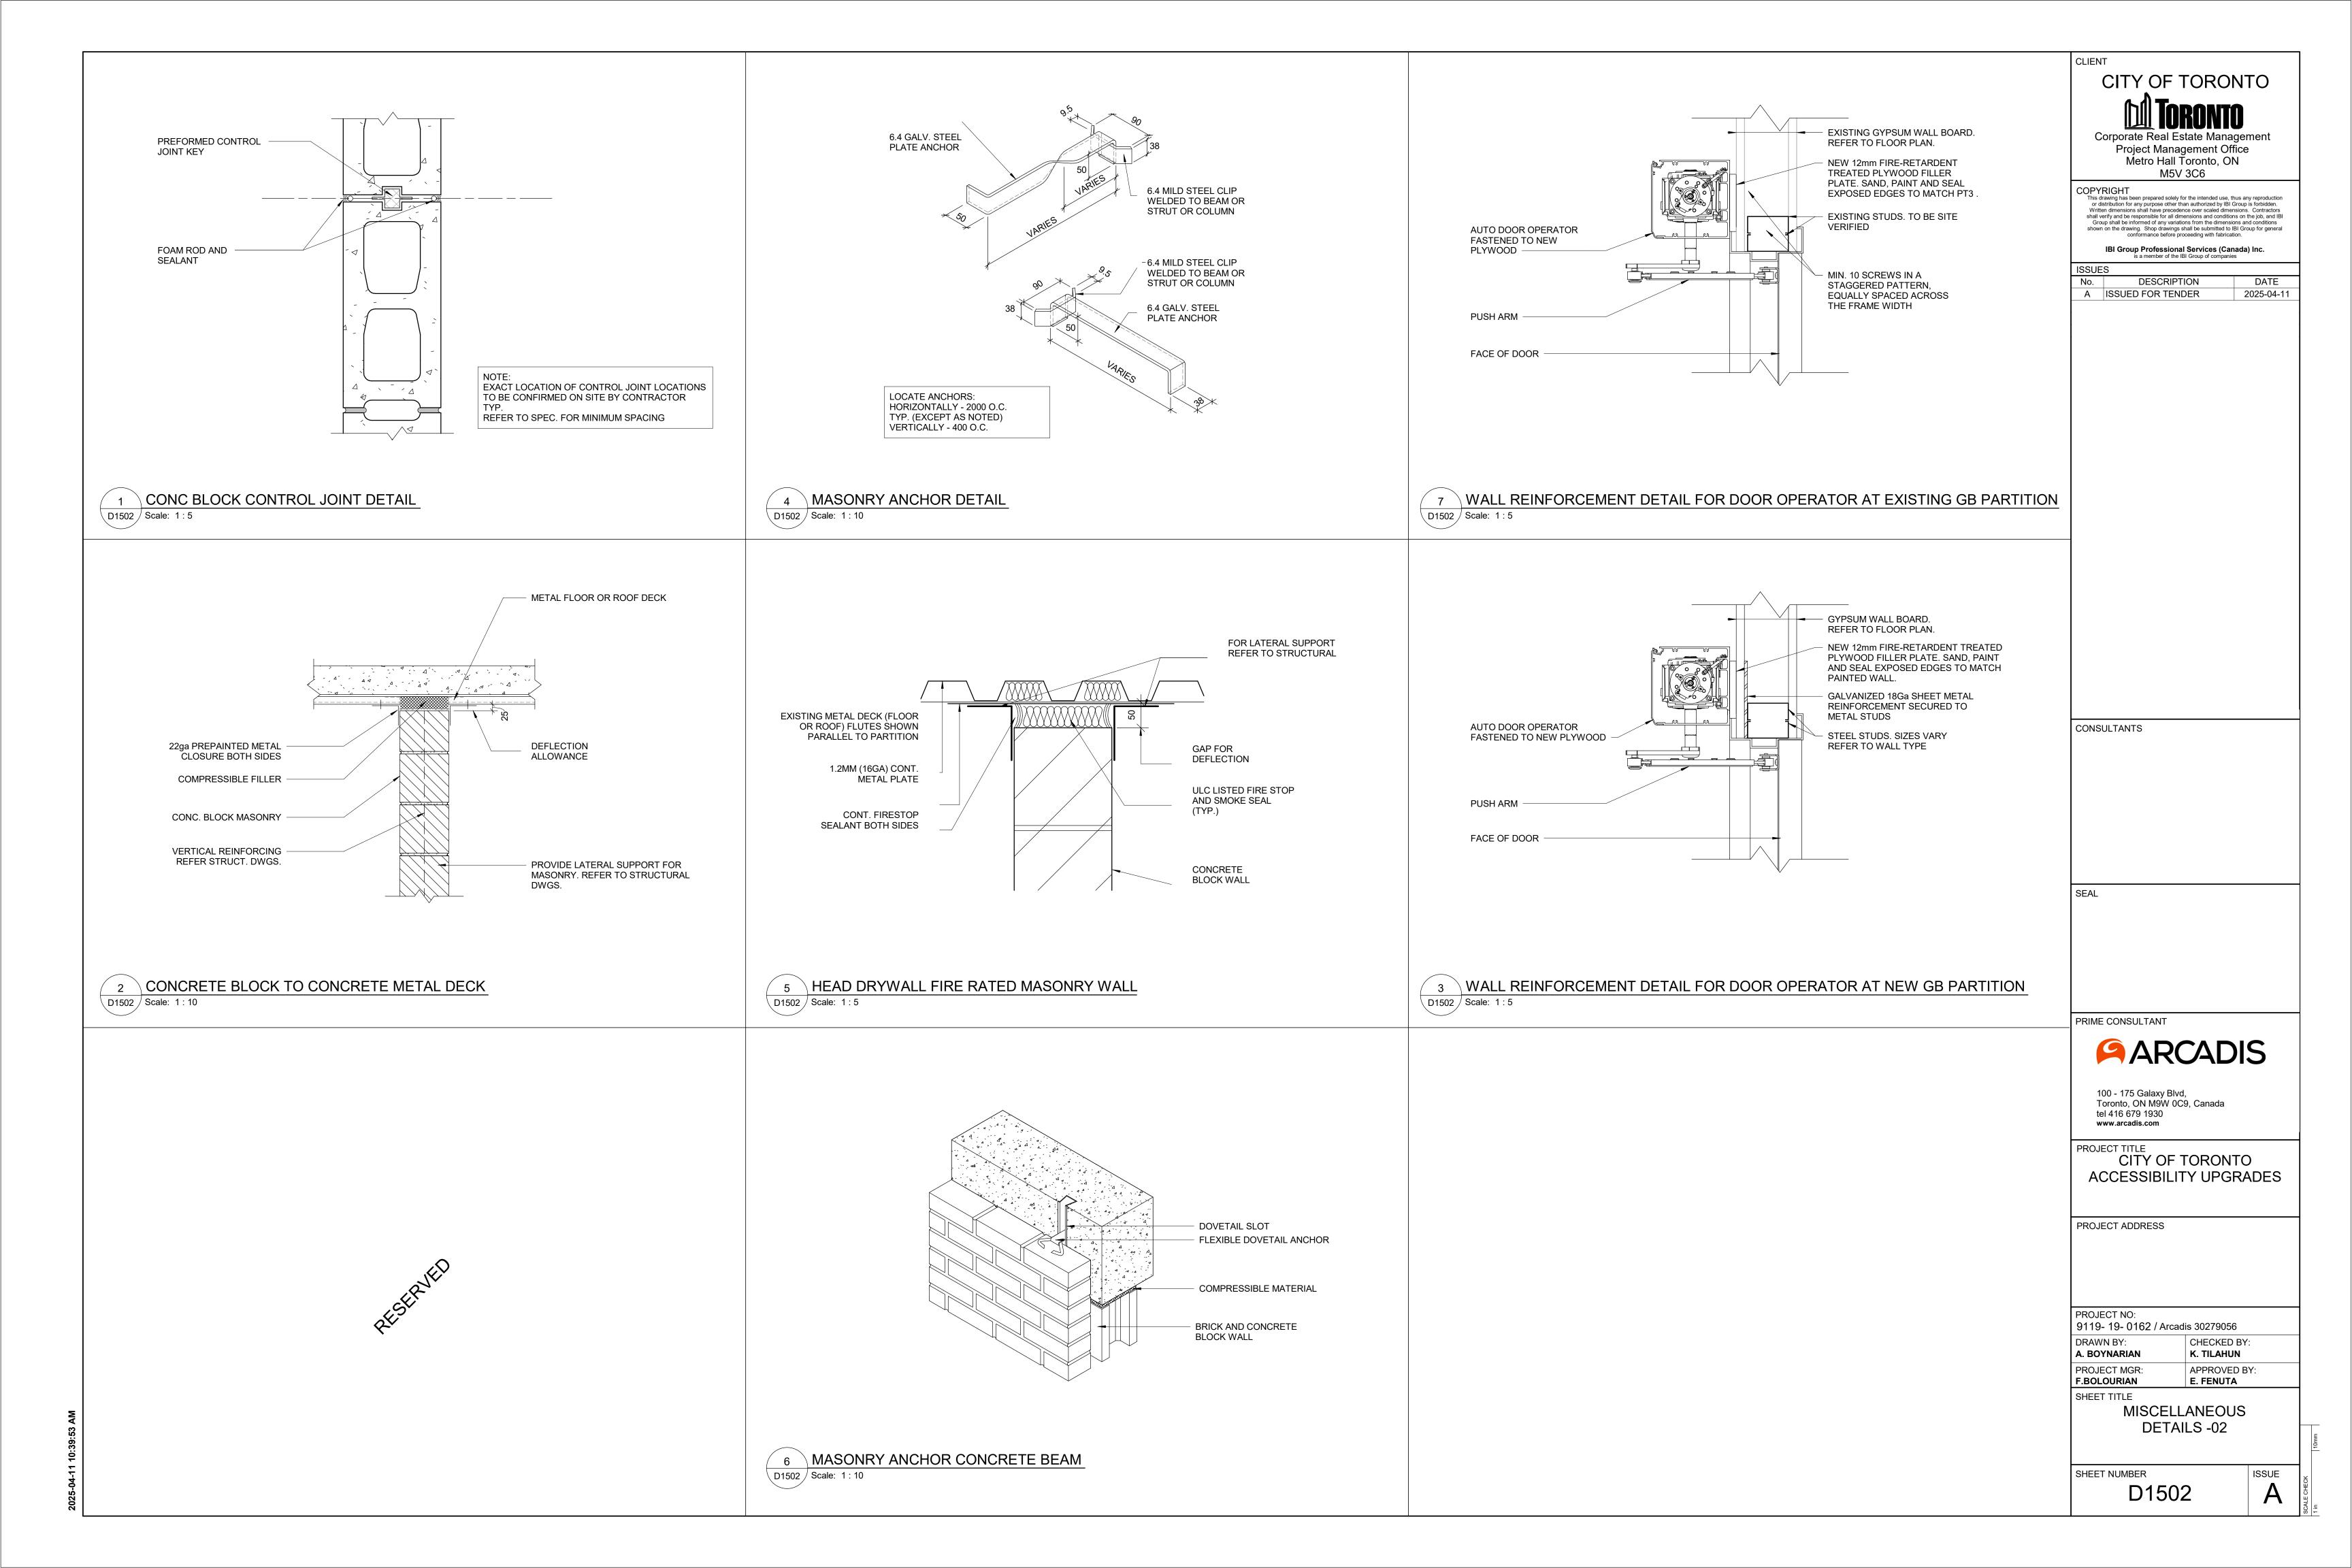
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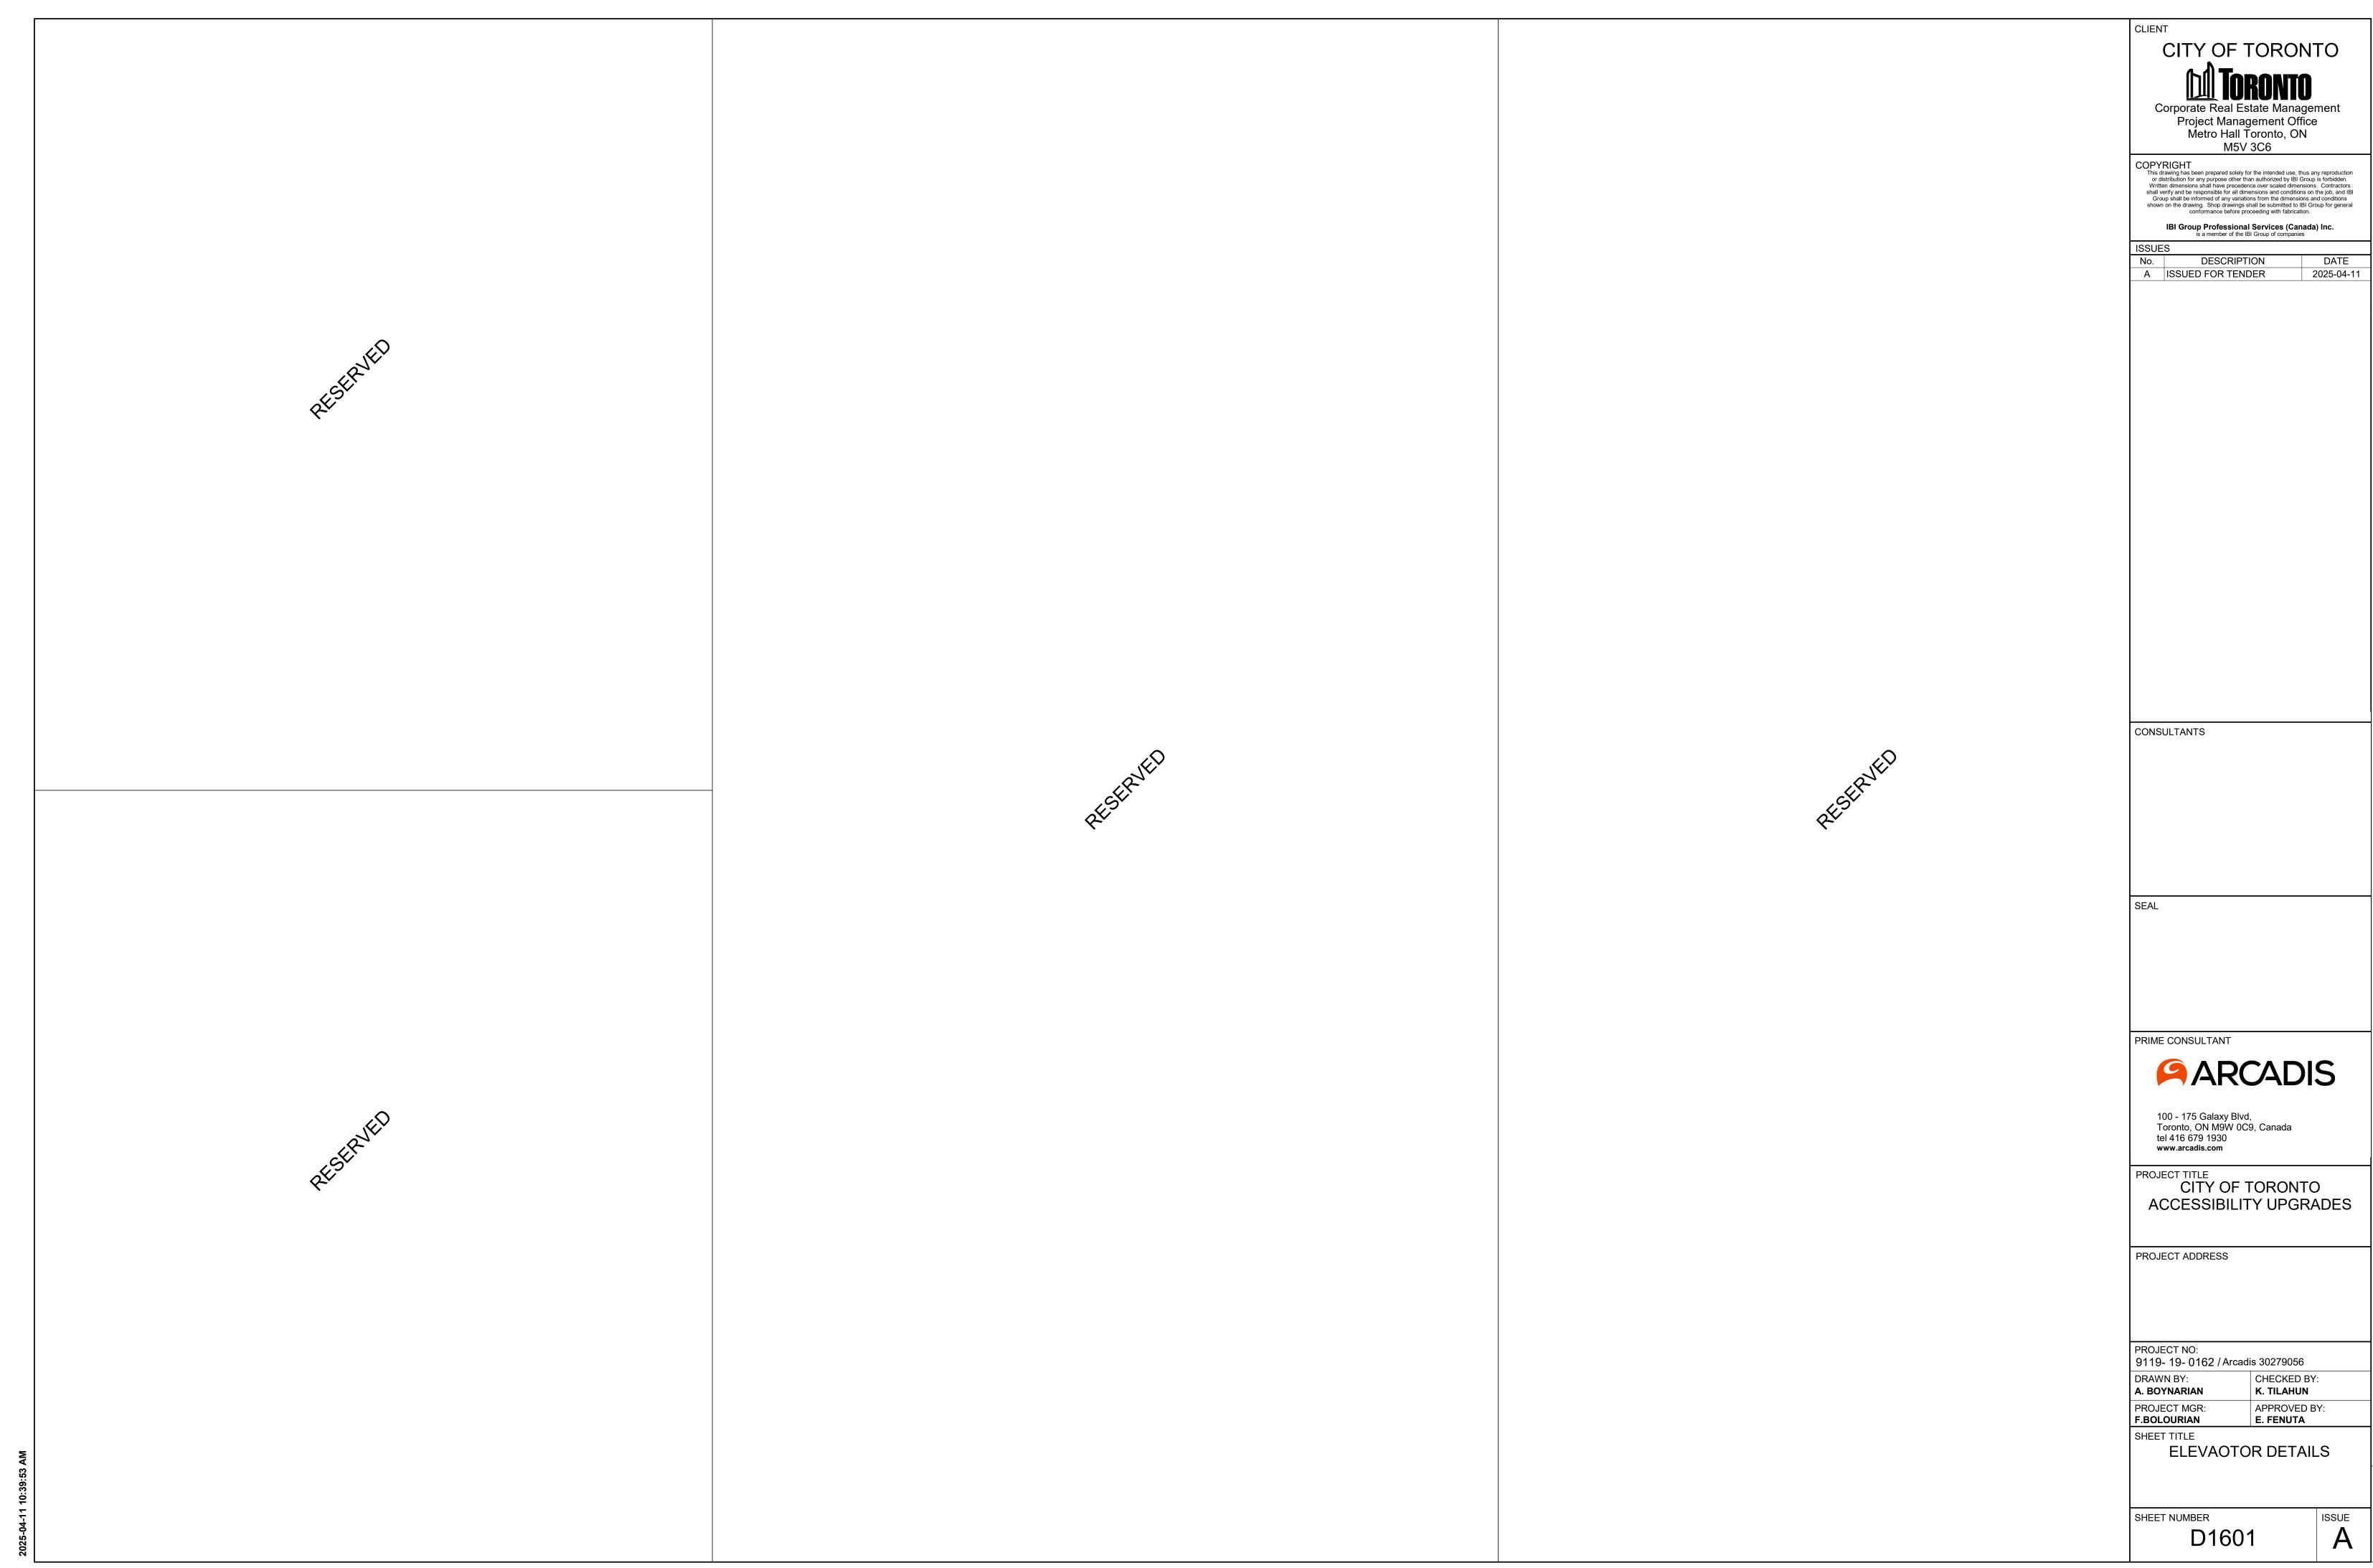
9119- 19- 0162 / Arcadis 30279056 DRAWN BY: CHECKED BY: A. BOYNARIAN K. TILAHUN PROJECT MGR: APPROVED BY:


E. FENUTA F.BOLOURIAN SHEET TITLE **MISCELLANEOUS** DETAILS - 01

SHEET NUMBER

D1501





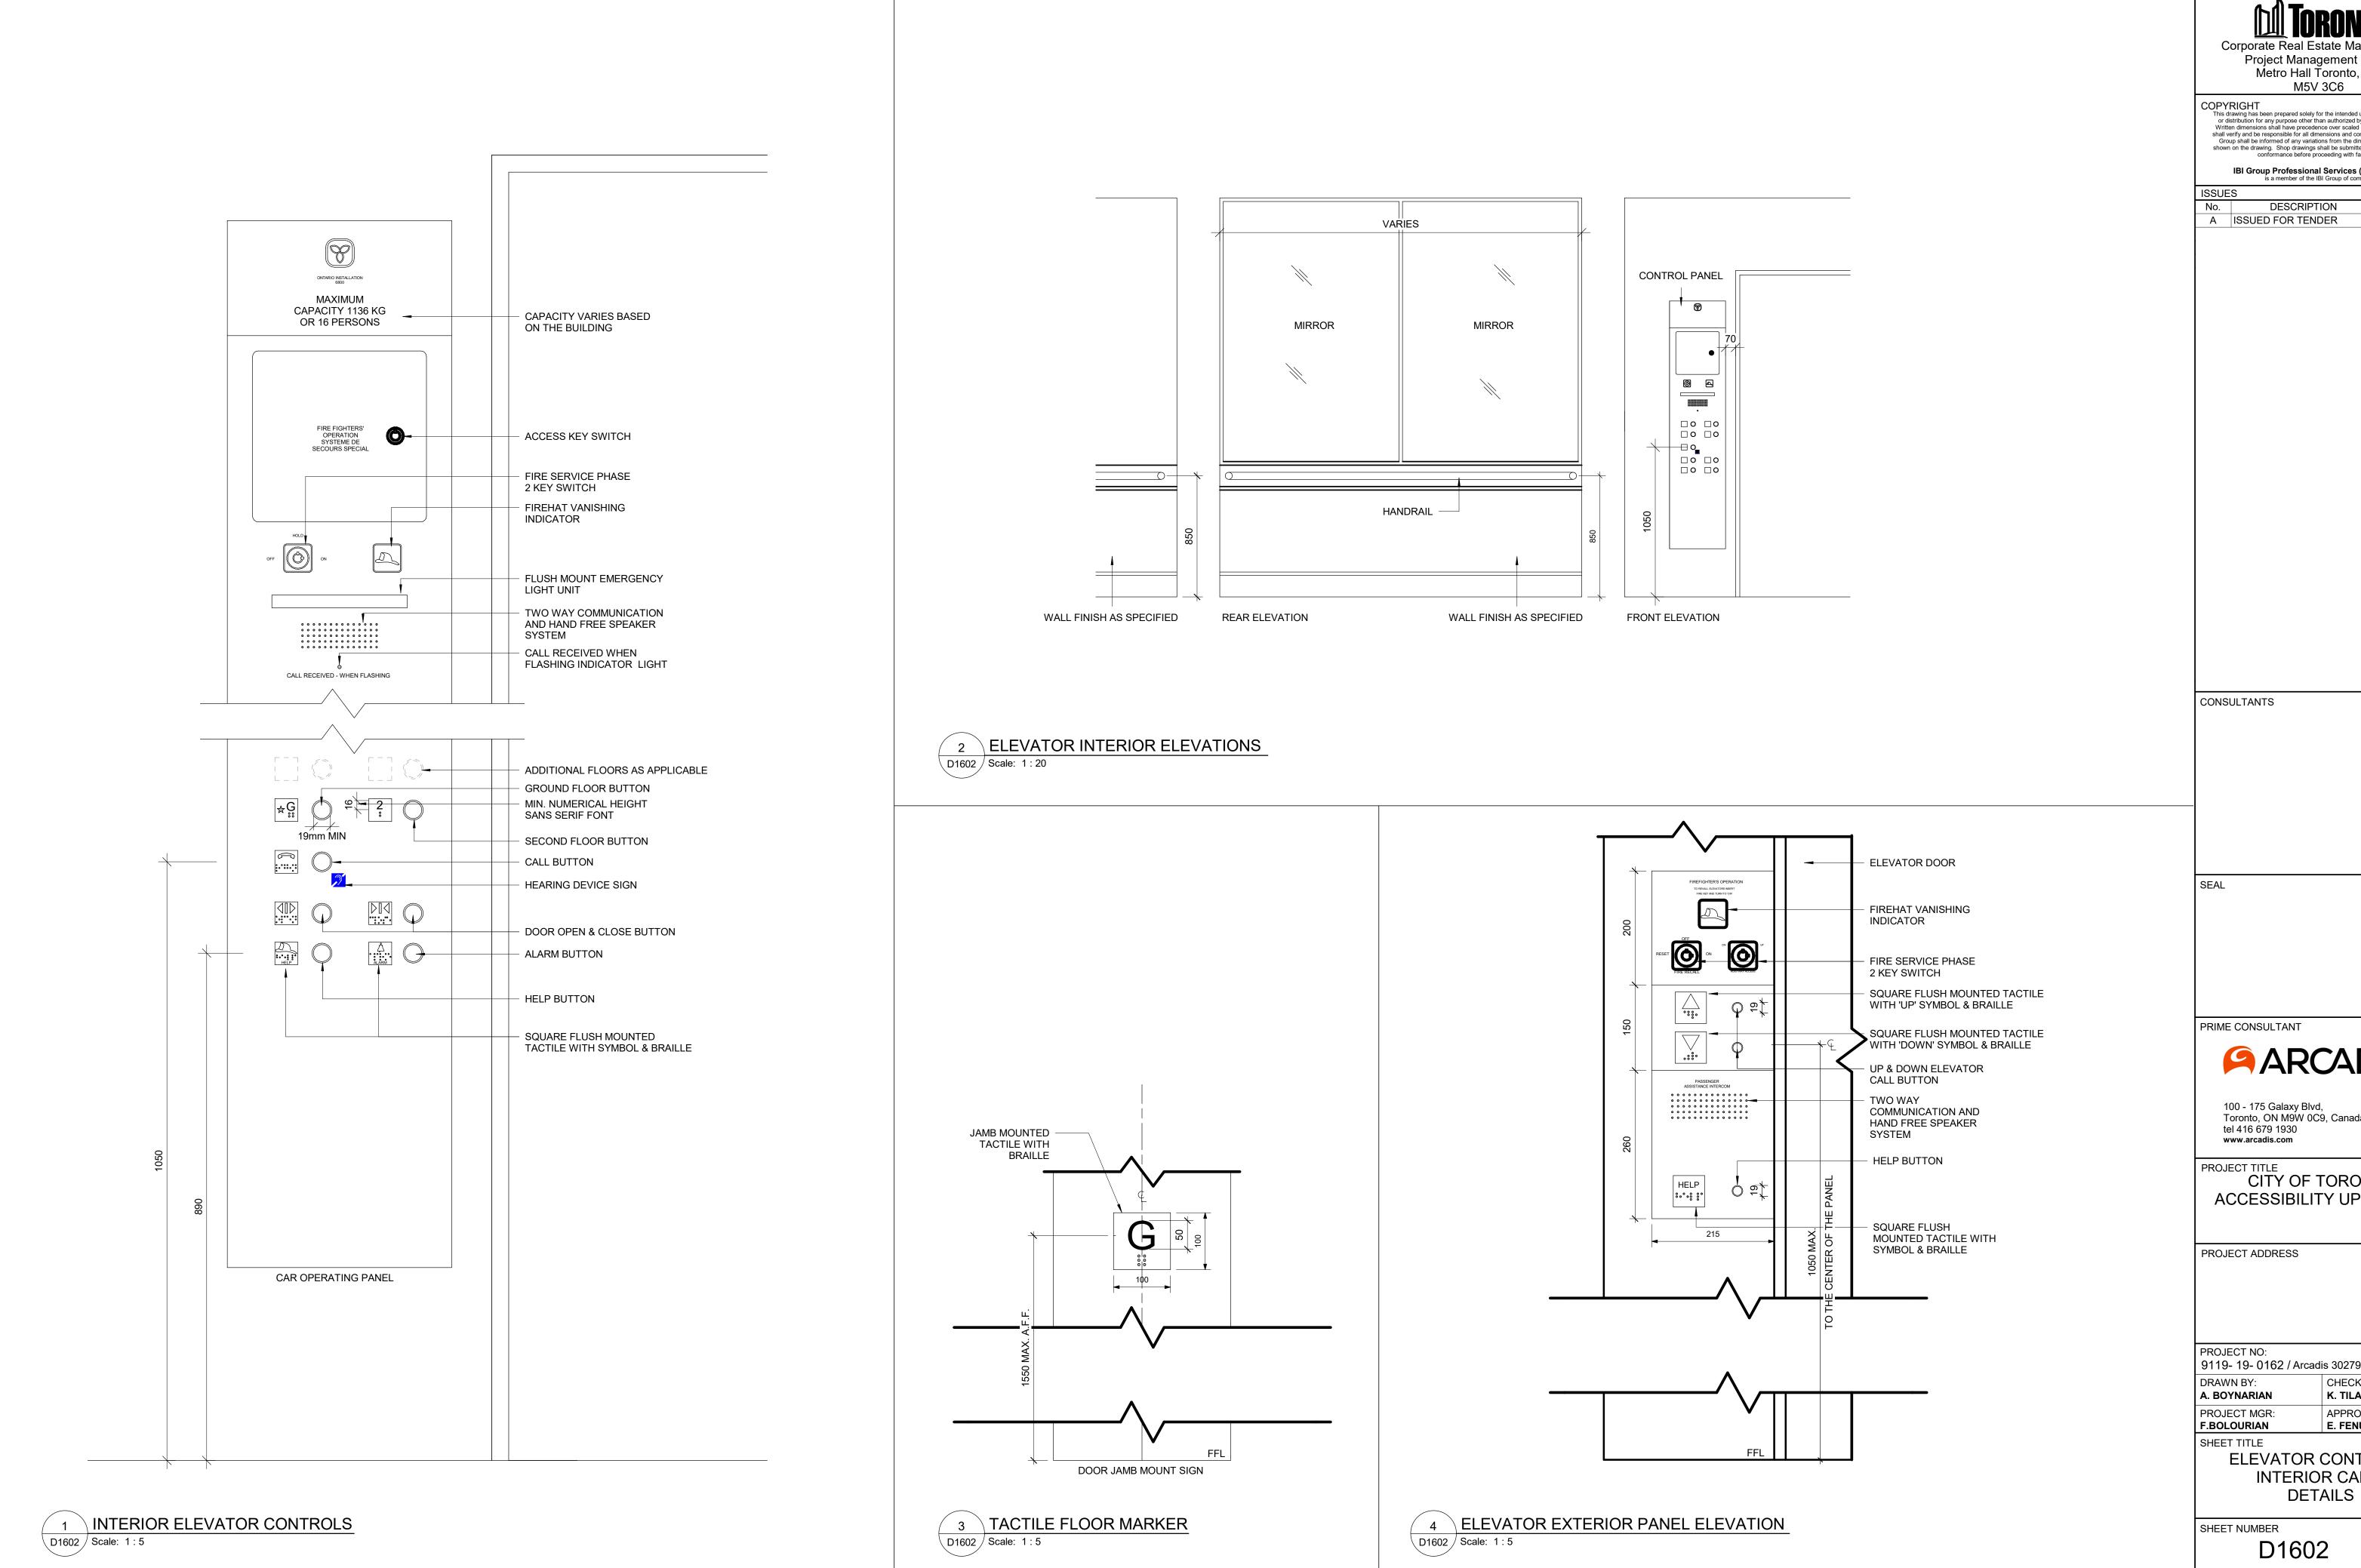

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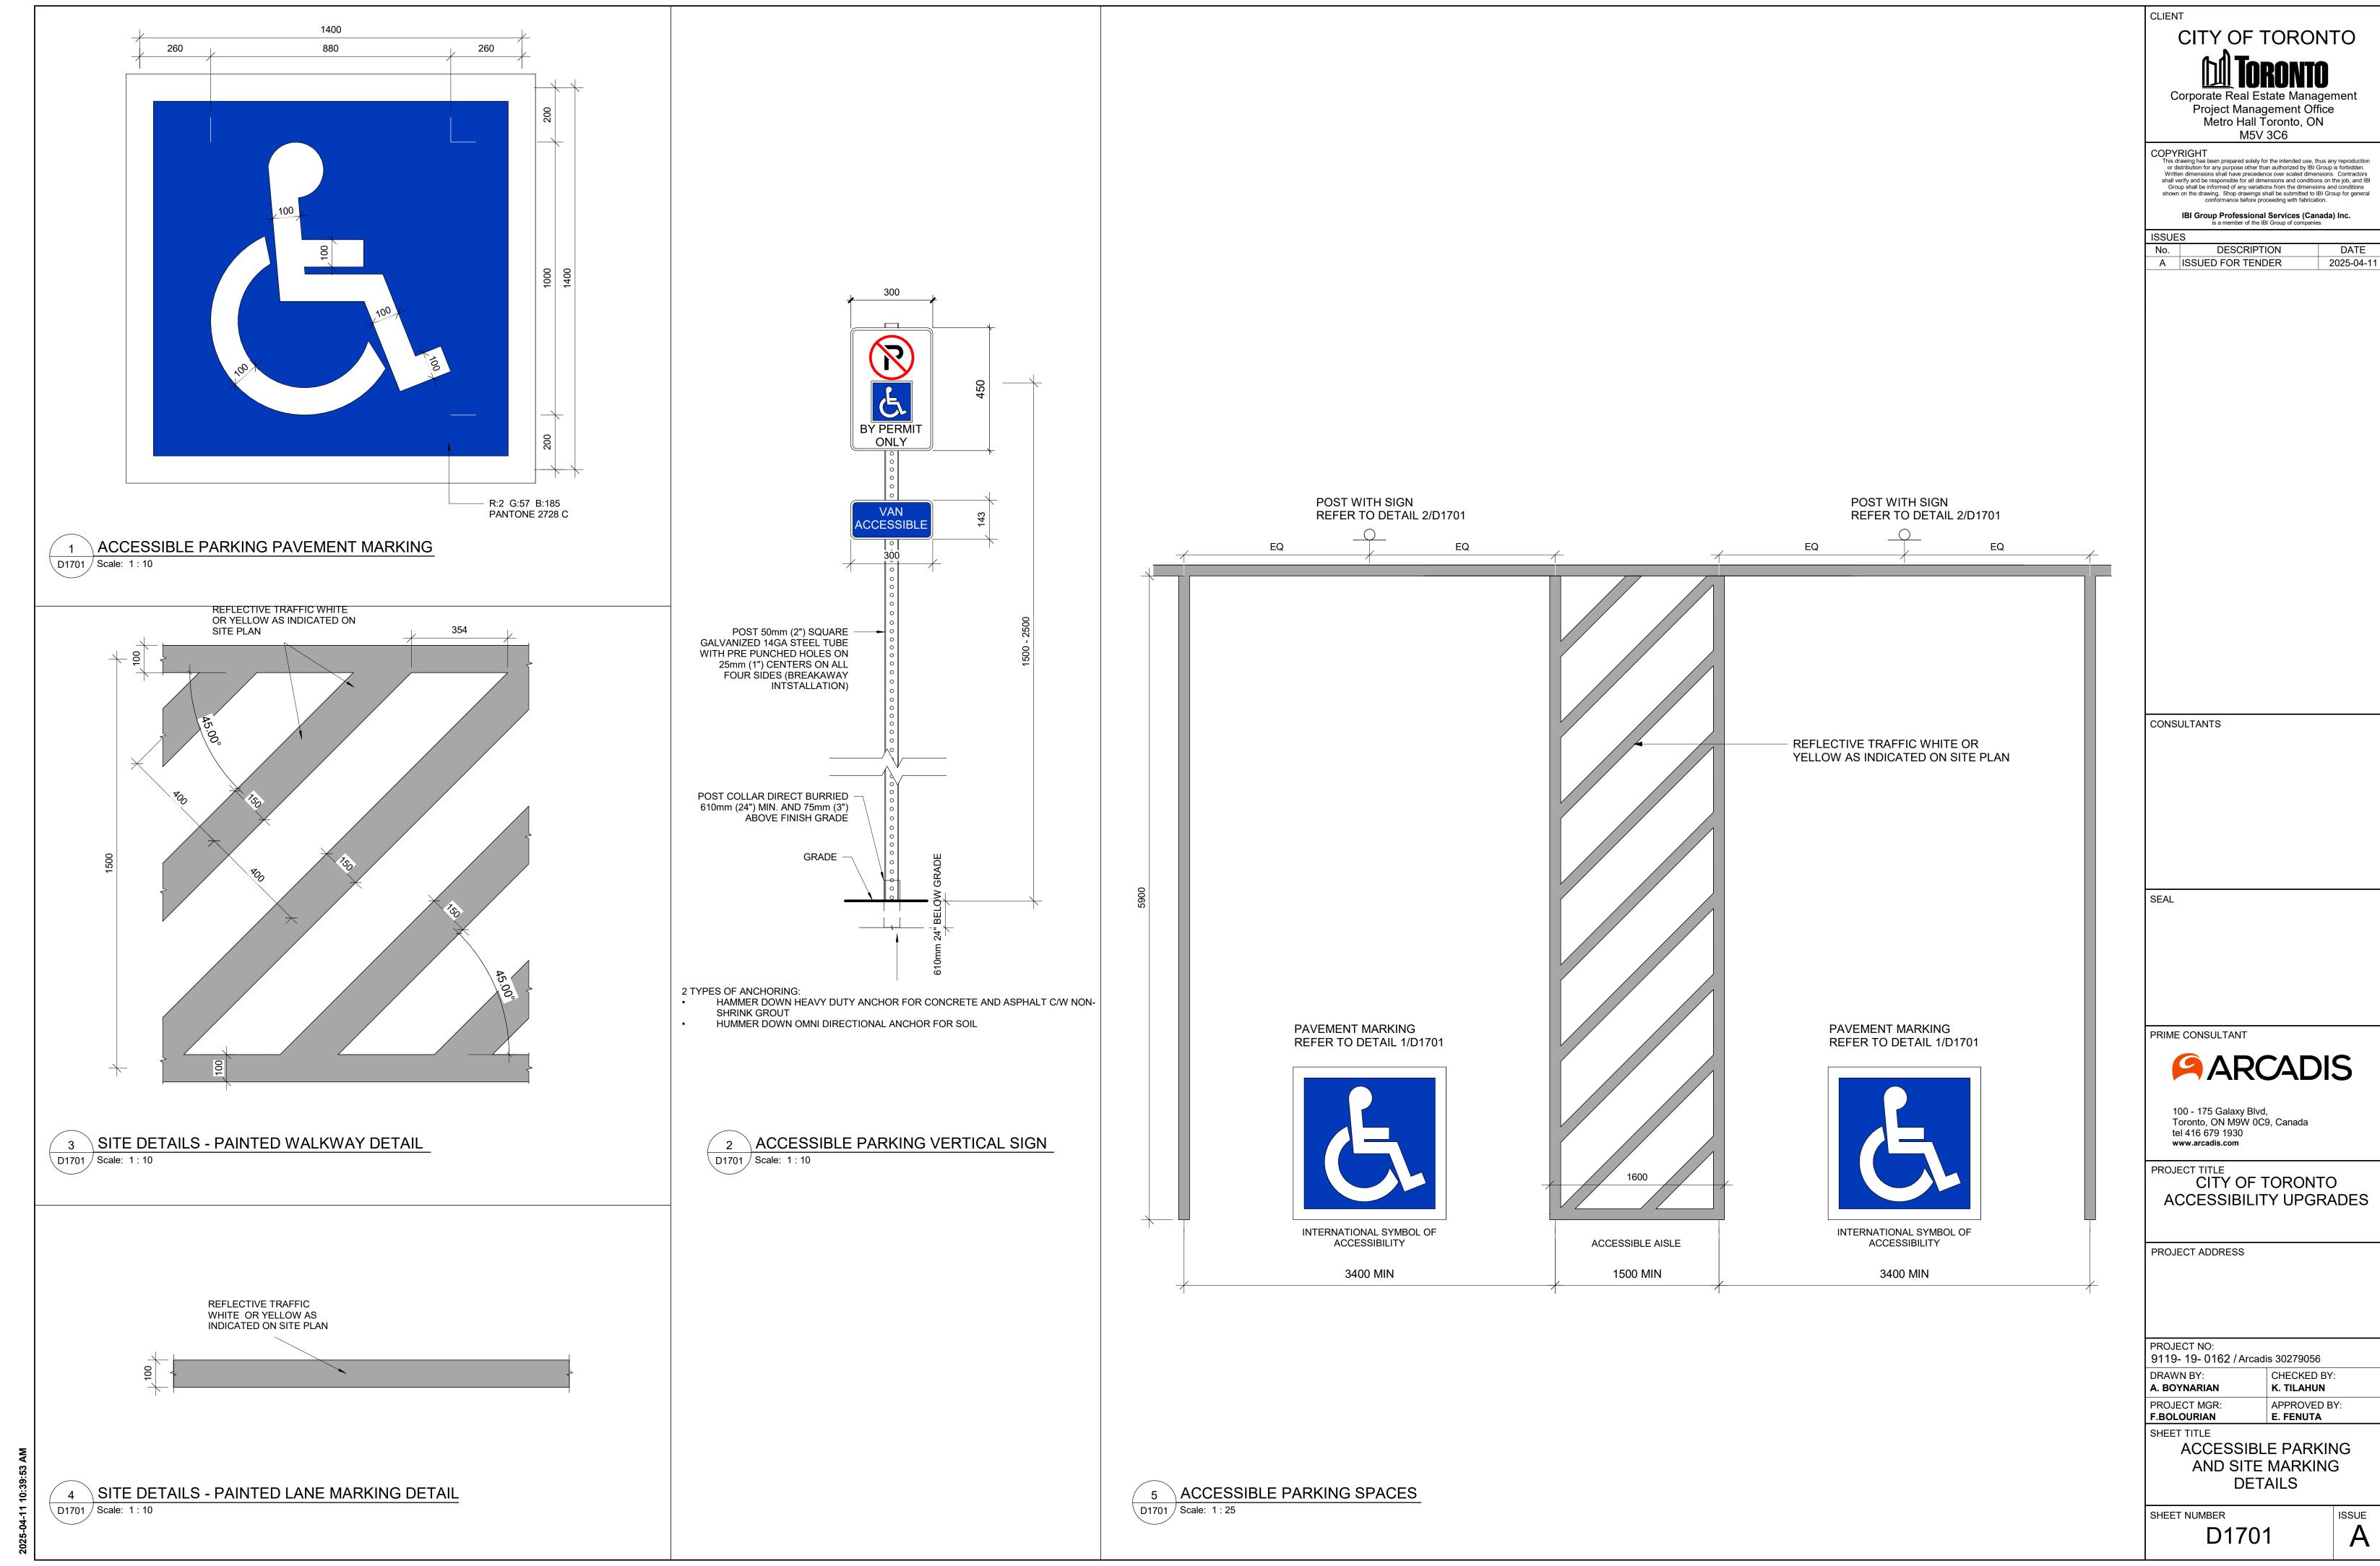
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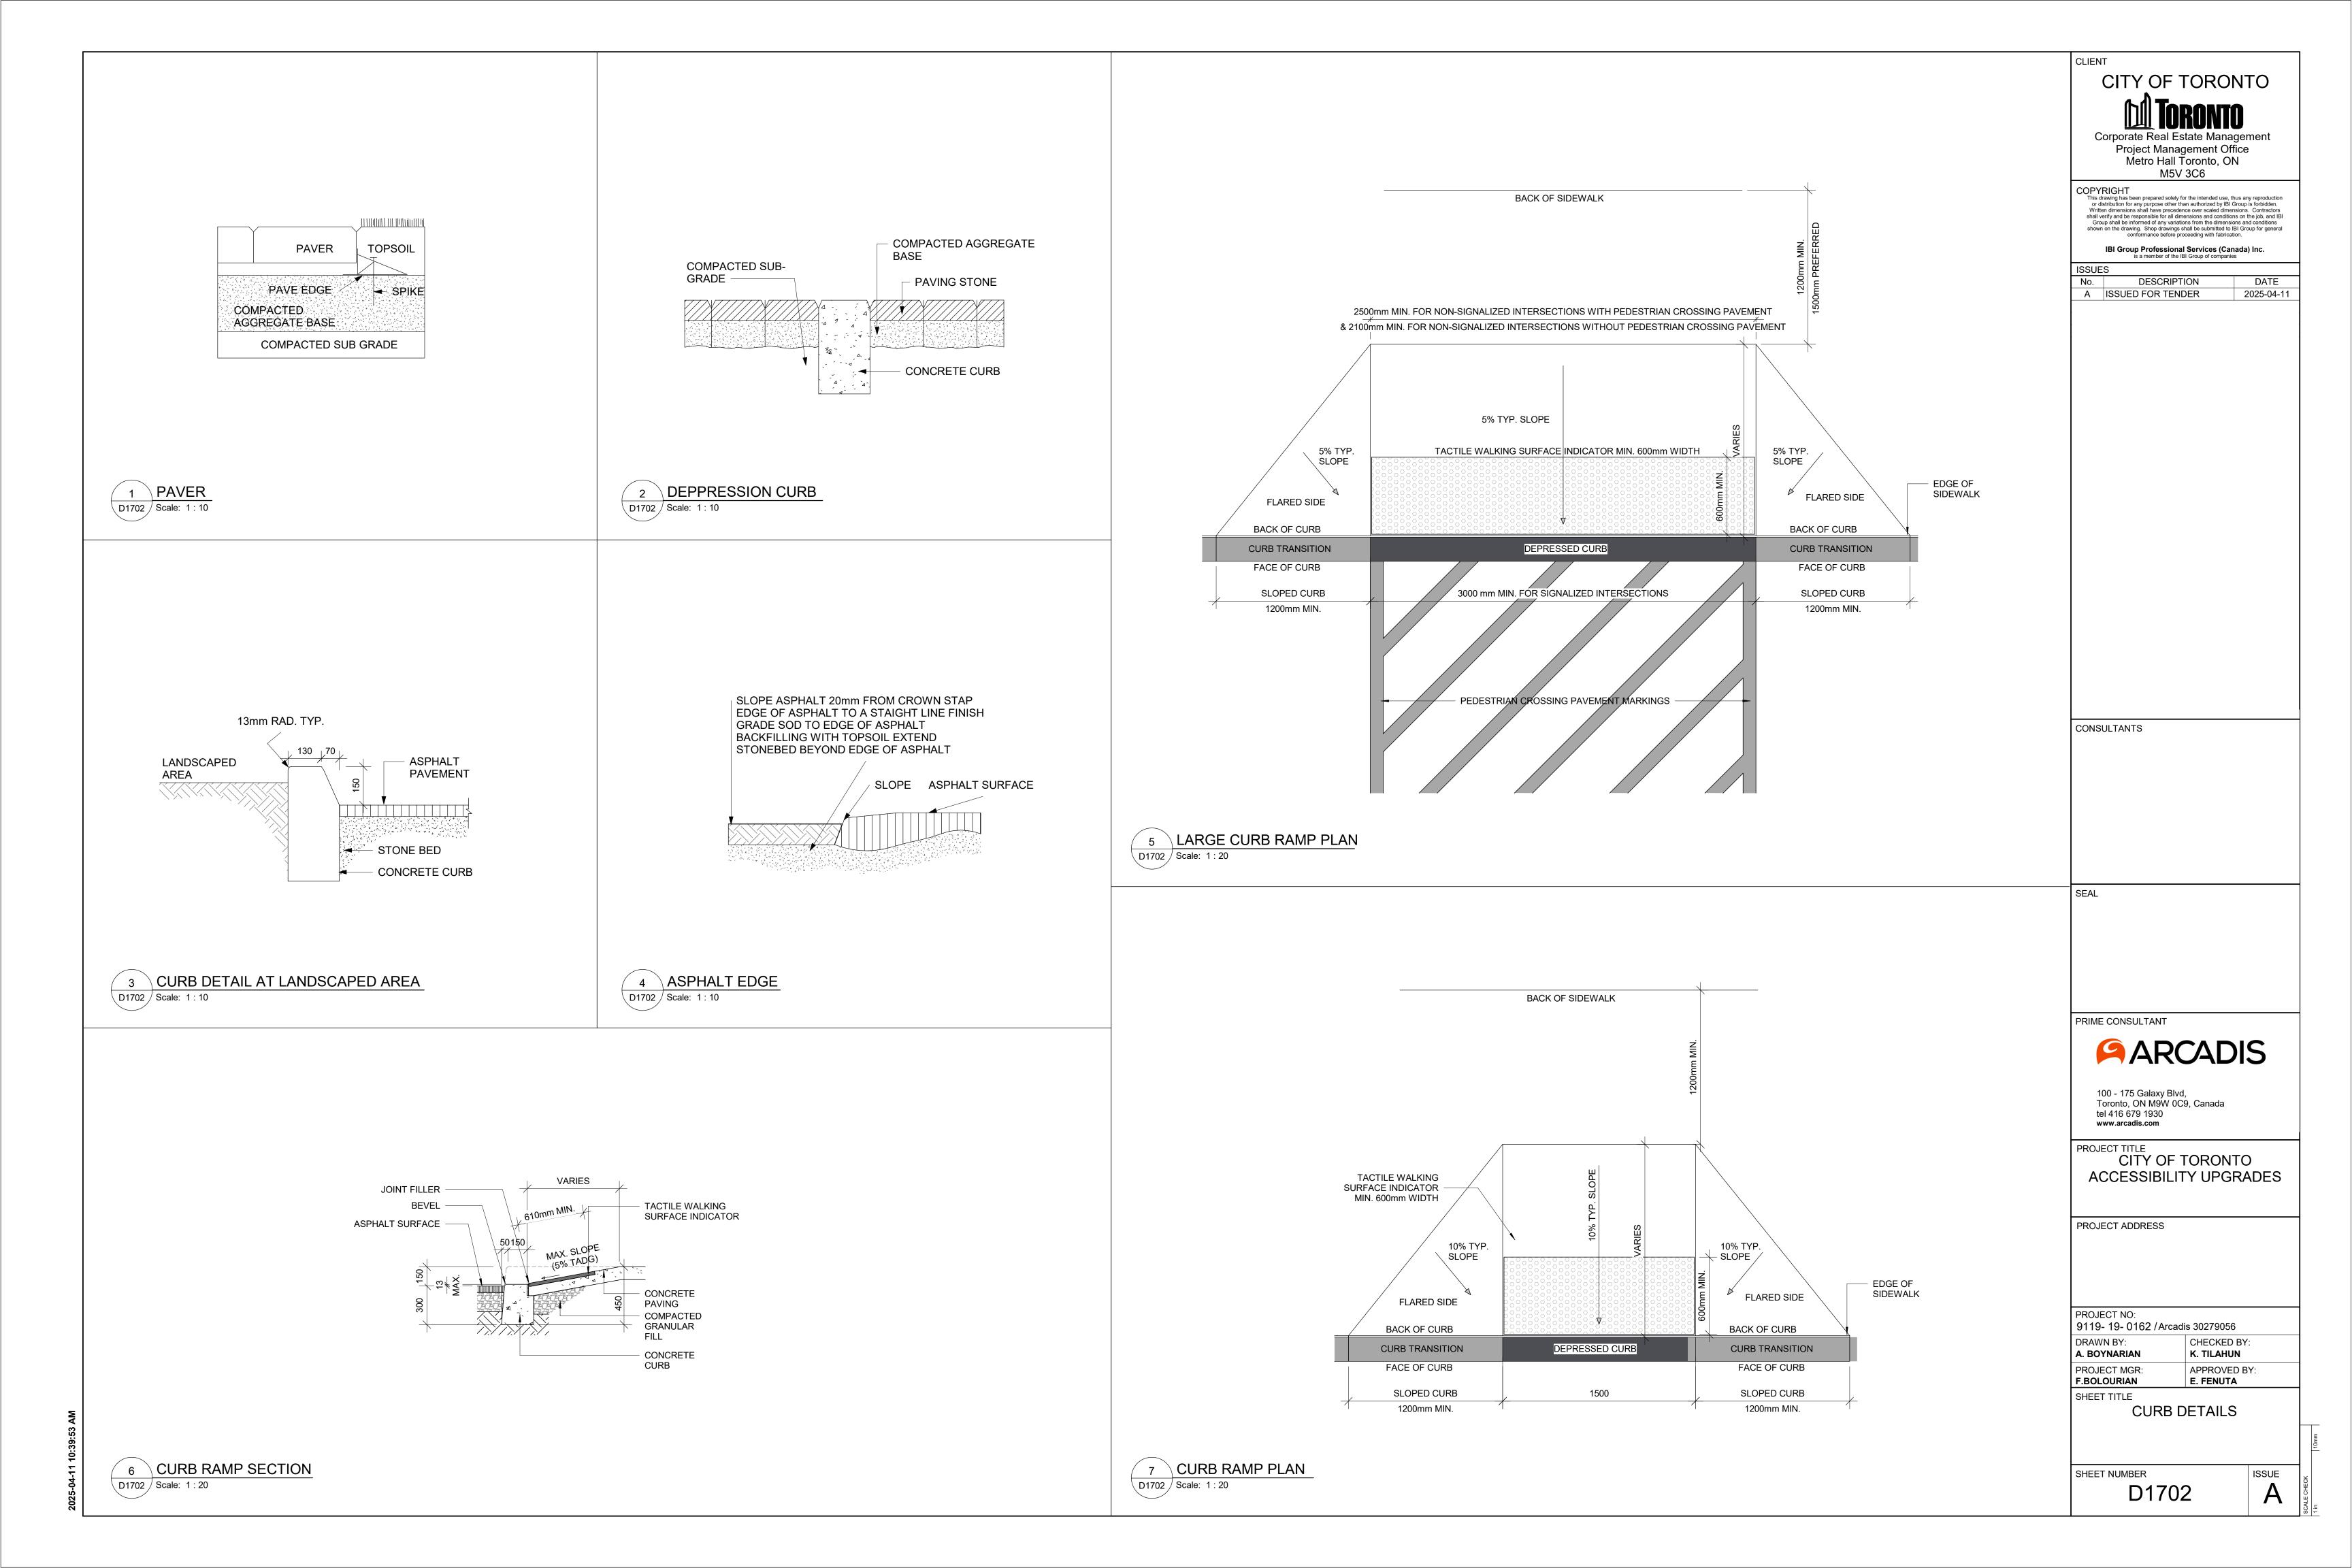
CITY OF TORONTO ACCESSIBILITY UPGRADES


9119- 19- 0162 / Arcadis 30279056

CHECKED BY: K. TILAHUN APPROVED BY: **E. FENUTA** 

**ELEVATOR CONTROL &** INTERIOR CABIN





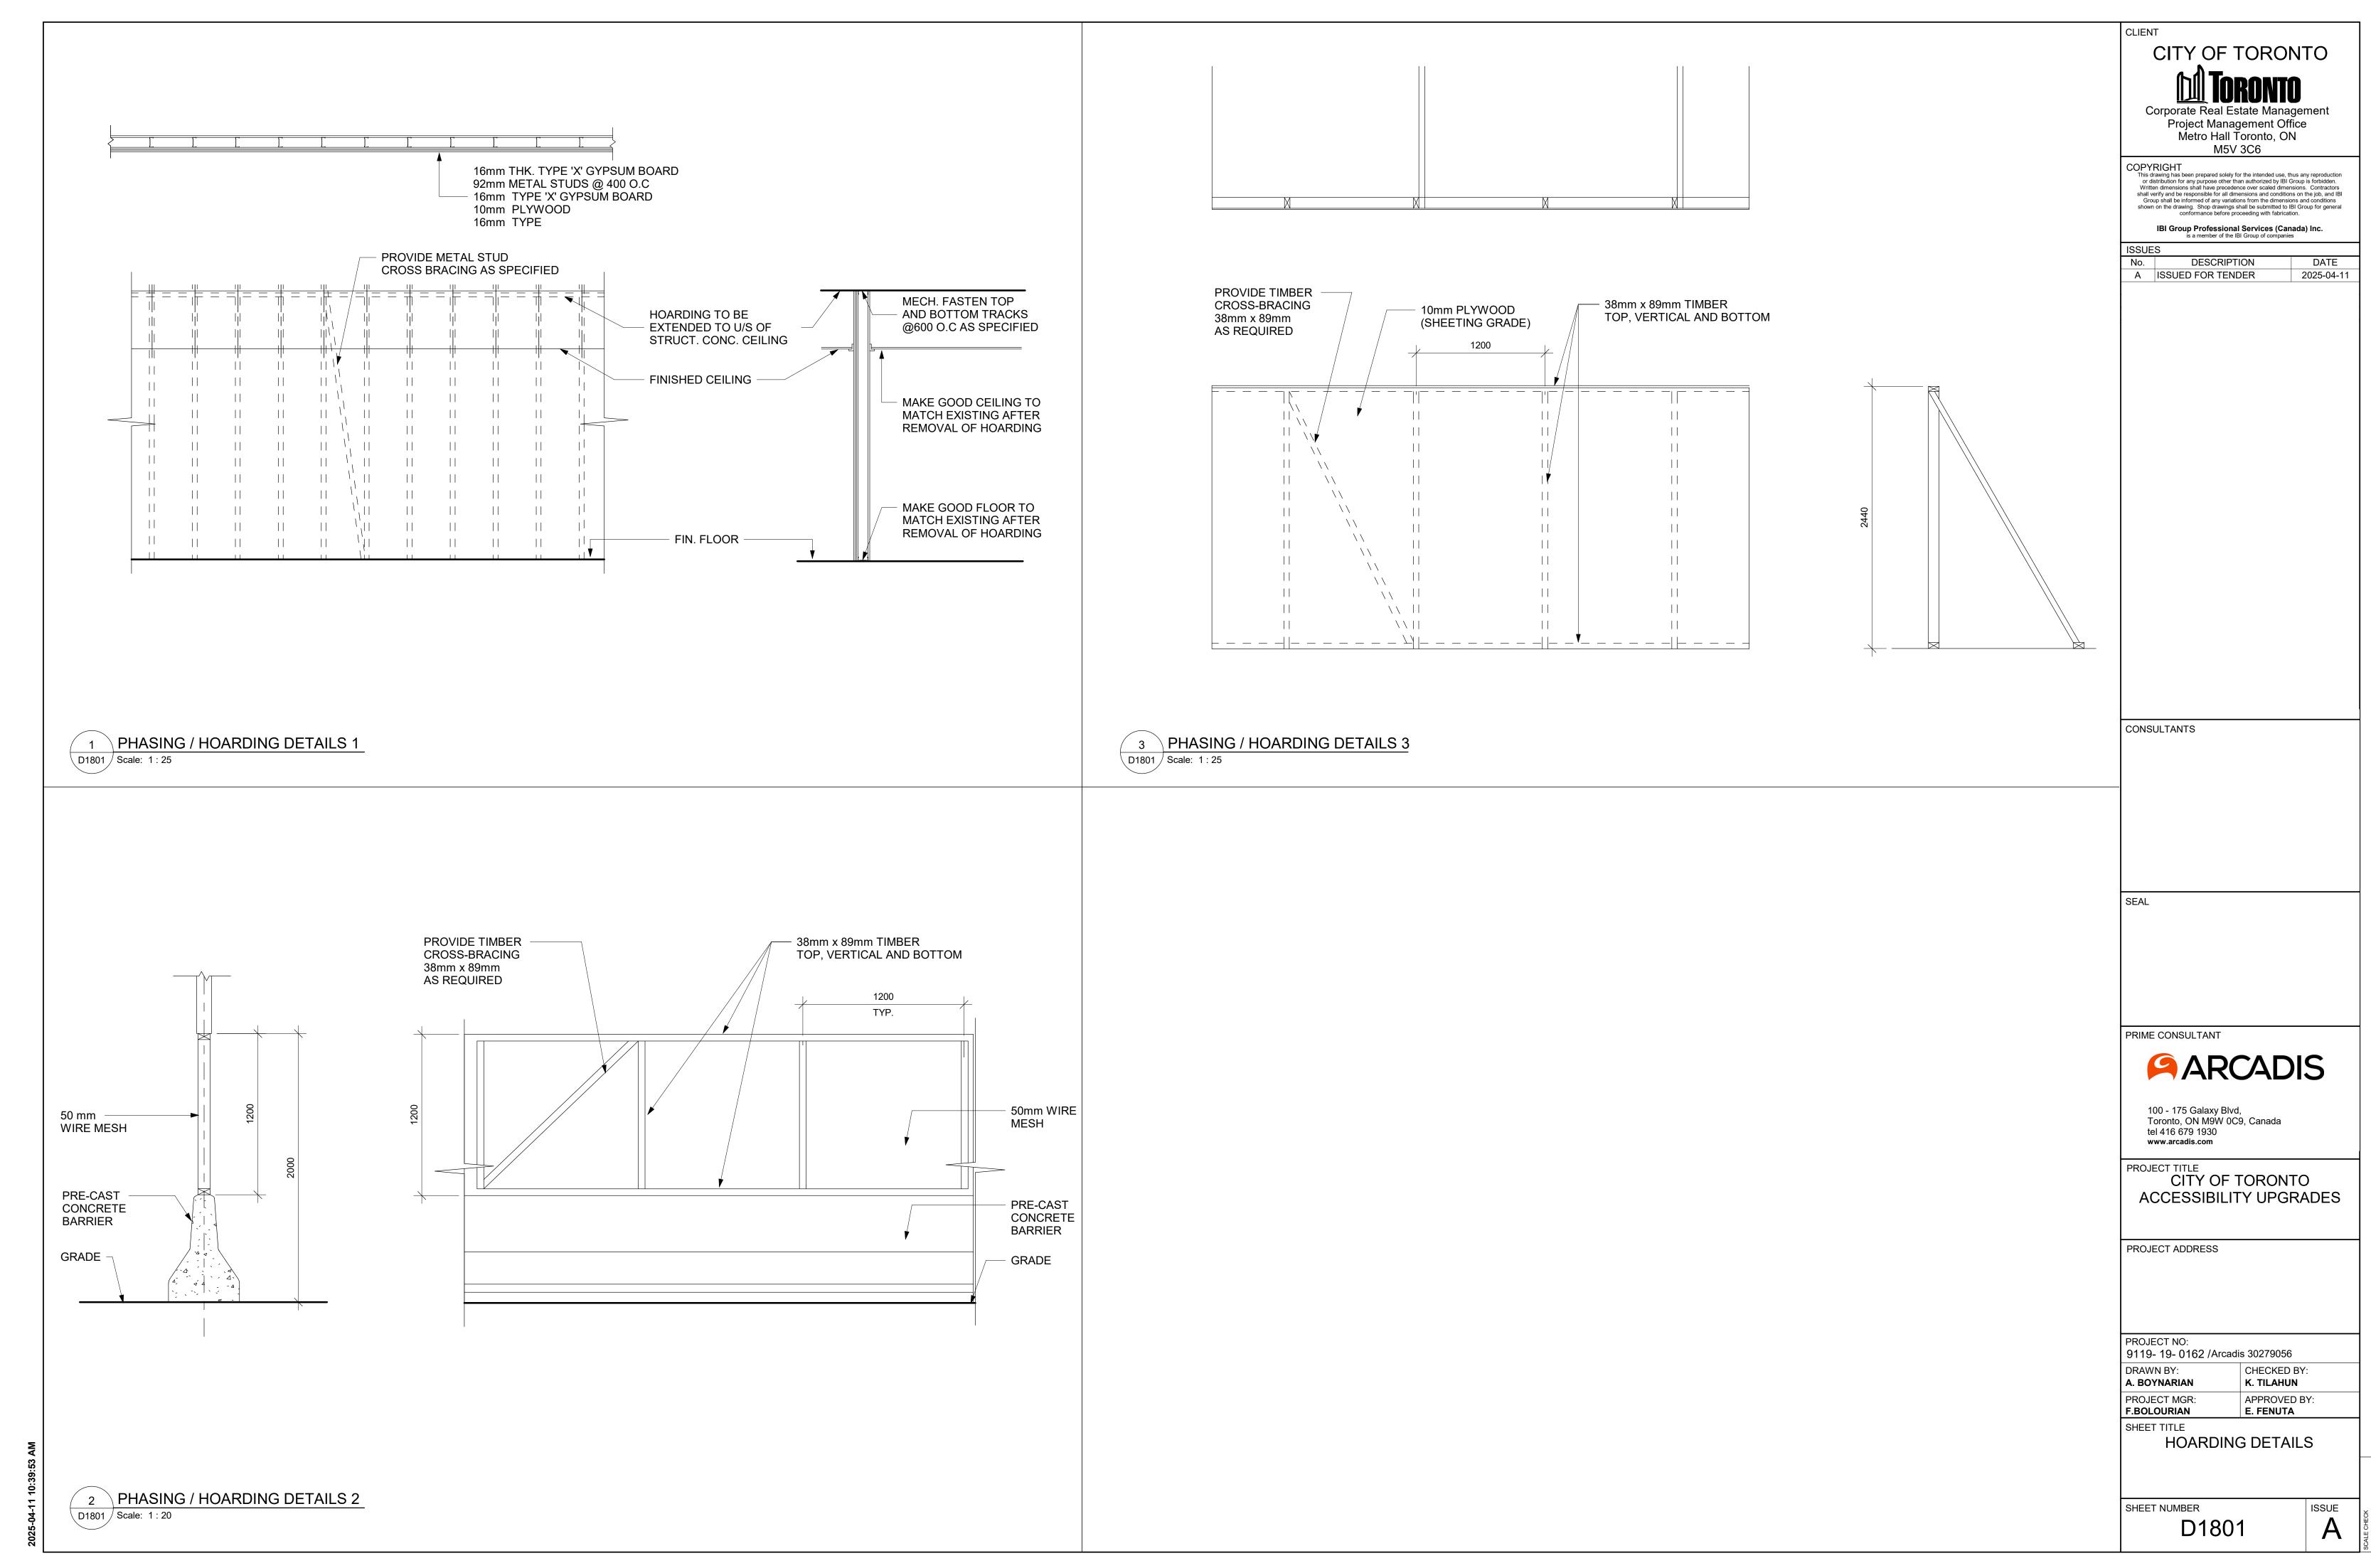

UNIVERS - CONDENSED

Base font used throughout the signage for the City of Toronto


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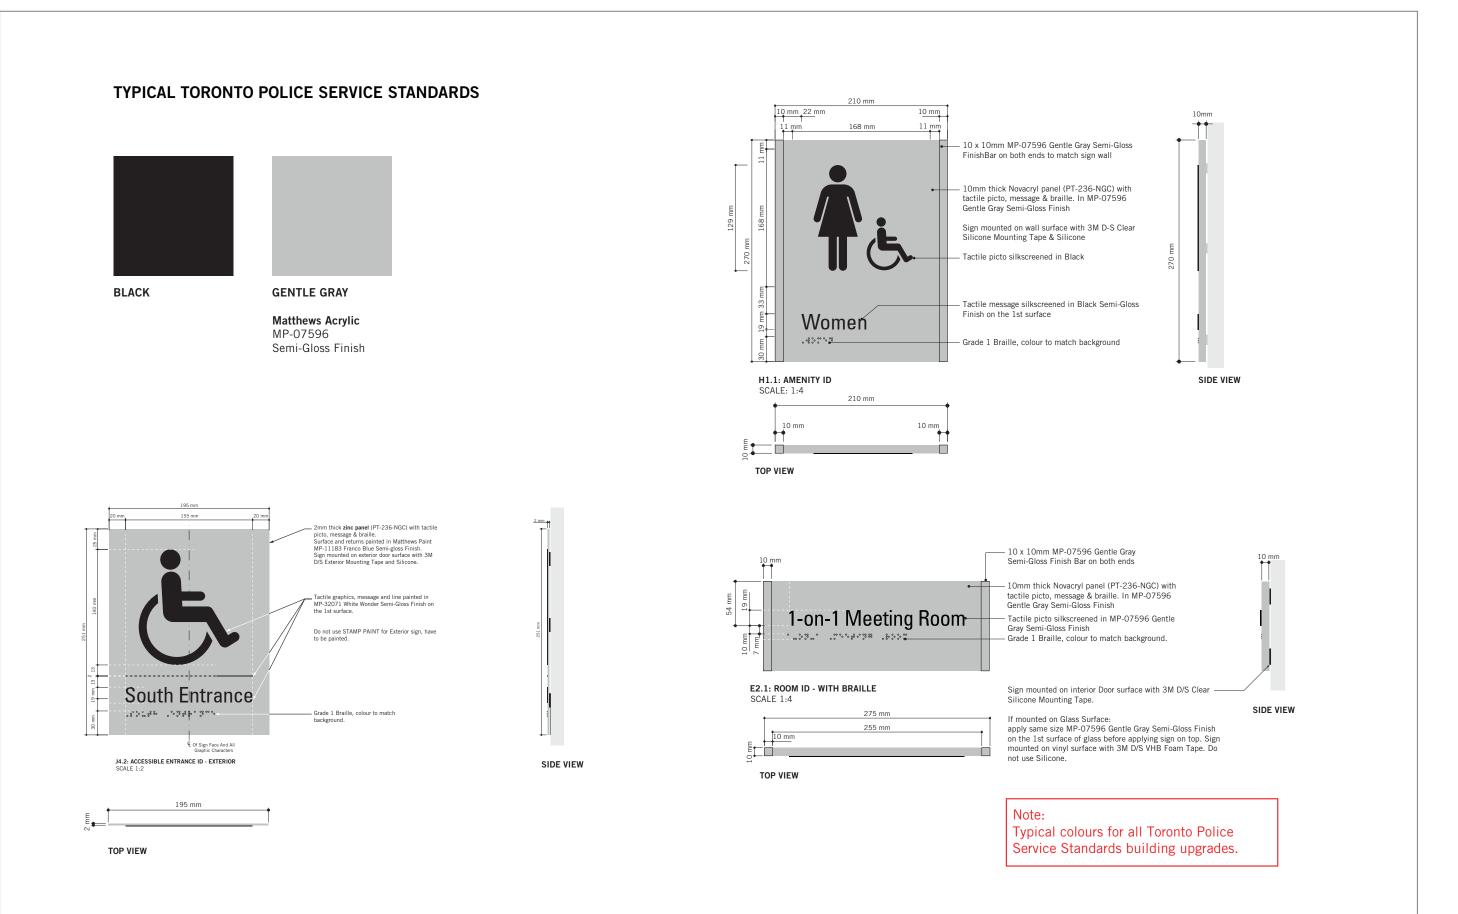
UNIVERS - BOLD CONDENSE
Used for numeric identifiers,
eg: Stairwell IDs or Building
Street Number


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GRADE 1 BRAILLE







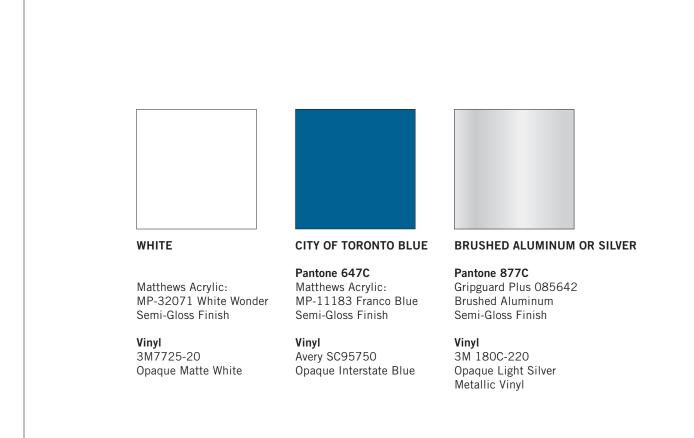

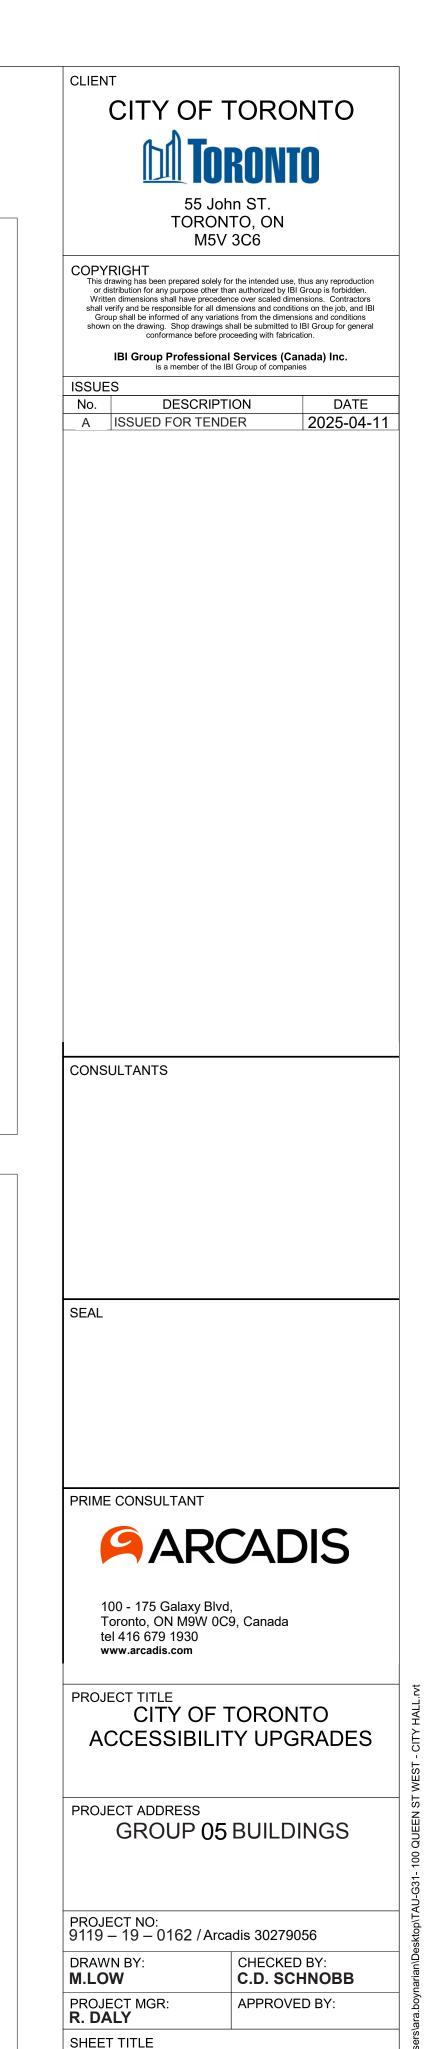
SIGNAGE & WAYFINDING DETAILS


D1901

SHEET NUMBER

**GENERAL SPECIFICATIONS** 

ISSUE

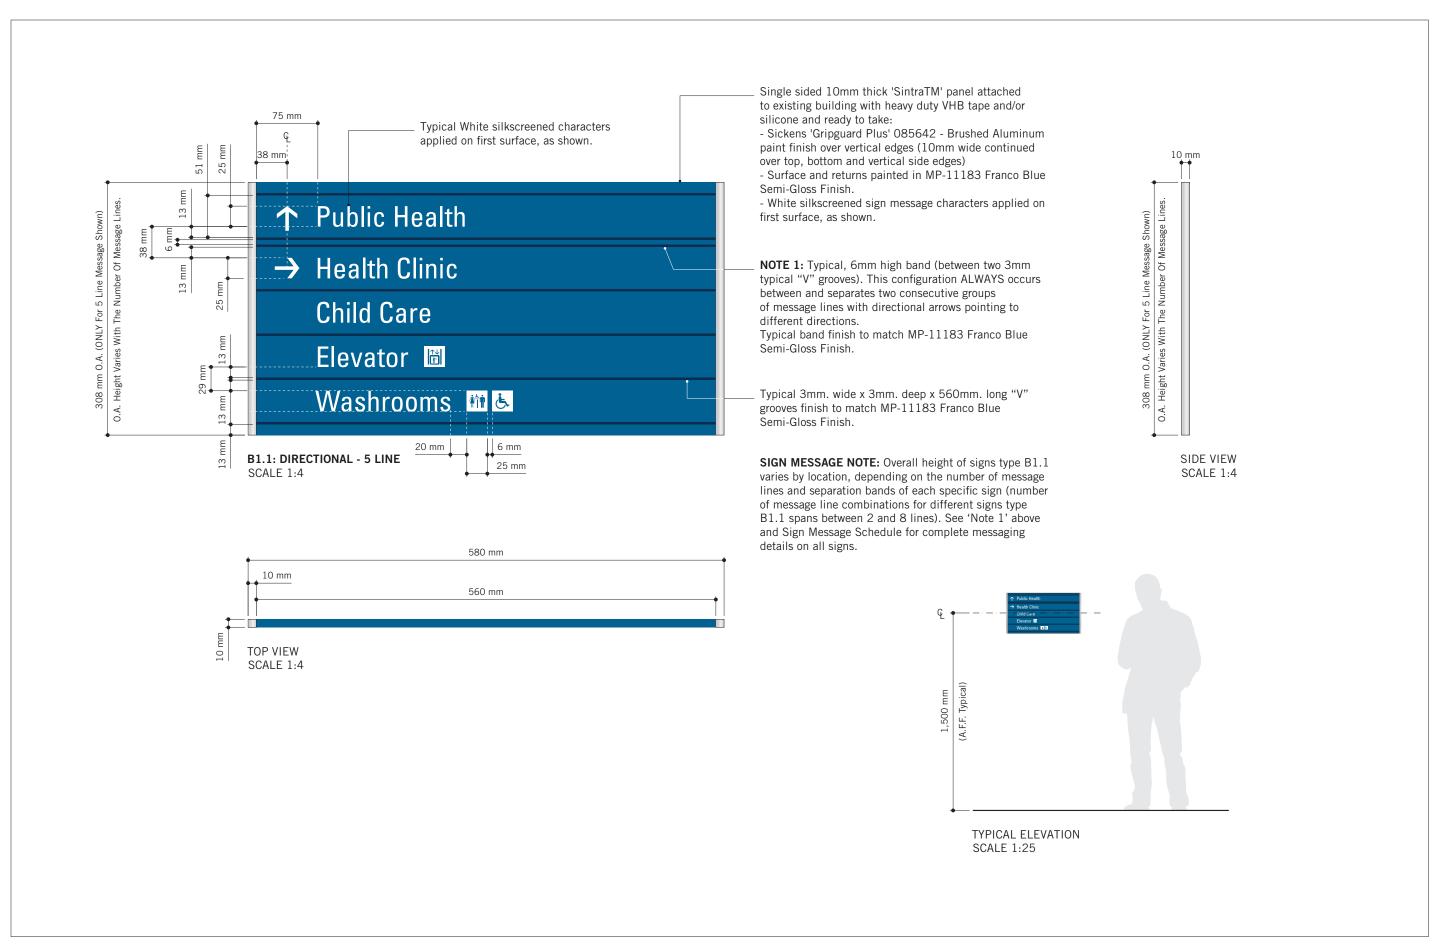

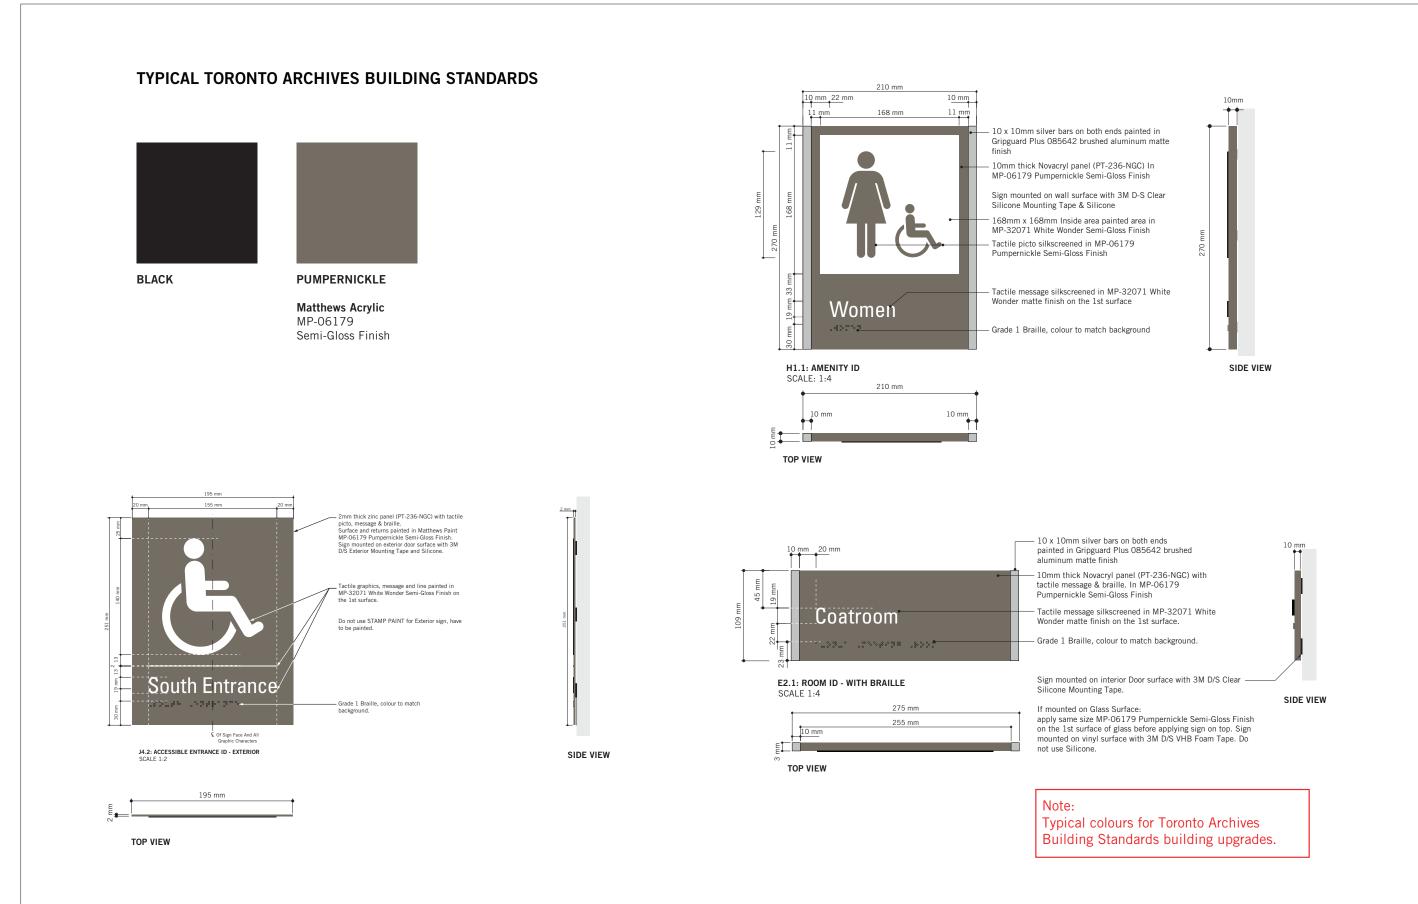



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PROJECT TITLE
CITY OF TORONTO ACCESSIBILITY UPGRADES

PROJECT ADDRESS **GROUP 05 BUILDINGS** 

PROJECT NO: 9119 – 19 – 0162 / Arcadis 30279056 CHECKED BY: C.D. SCHNOBB DRAWN BY: M.LOW PROJECT MGR: R. DALY


SHEET TITLE SIGNAGE & WAYFINDING


**DETAILS** 

**B1.1: DIRECTIONAL SIGNAGE** SHEET NUMBER


D1902

APPROVED BY:

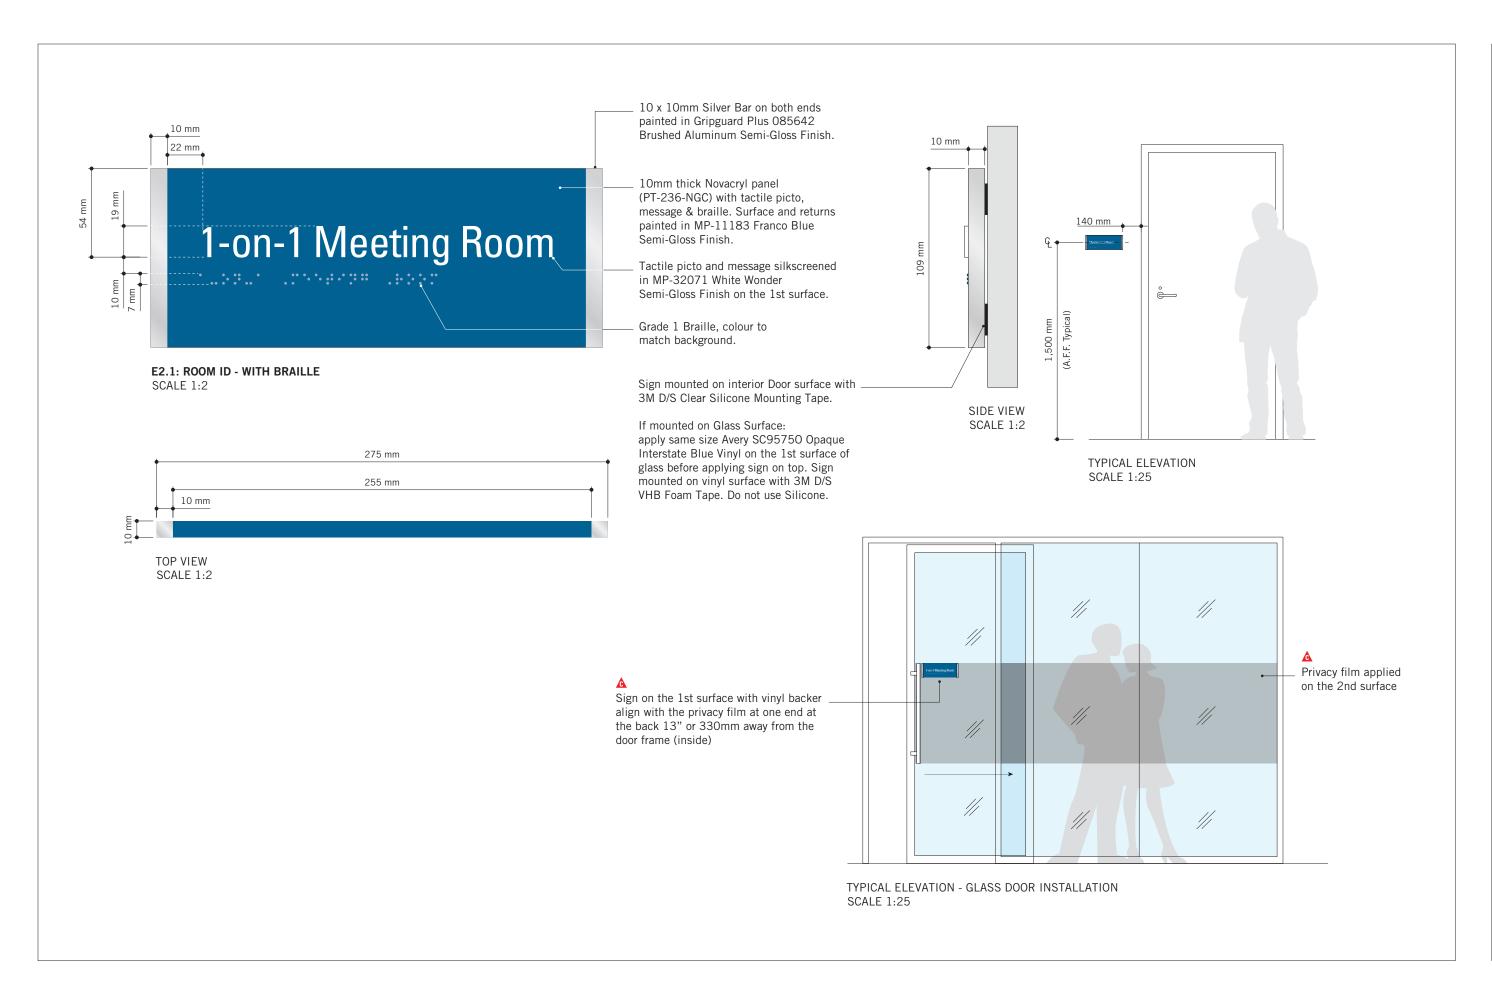

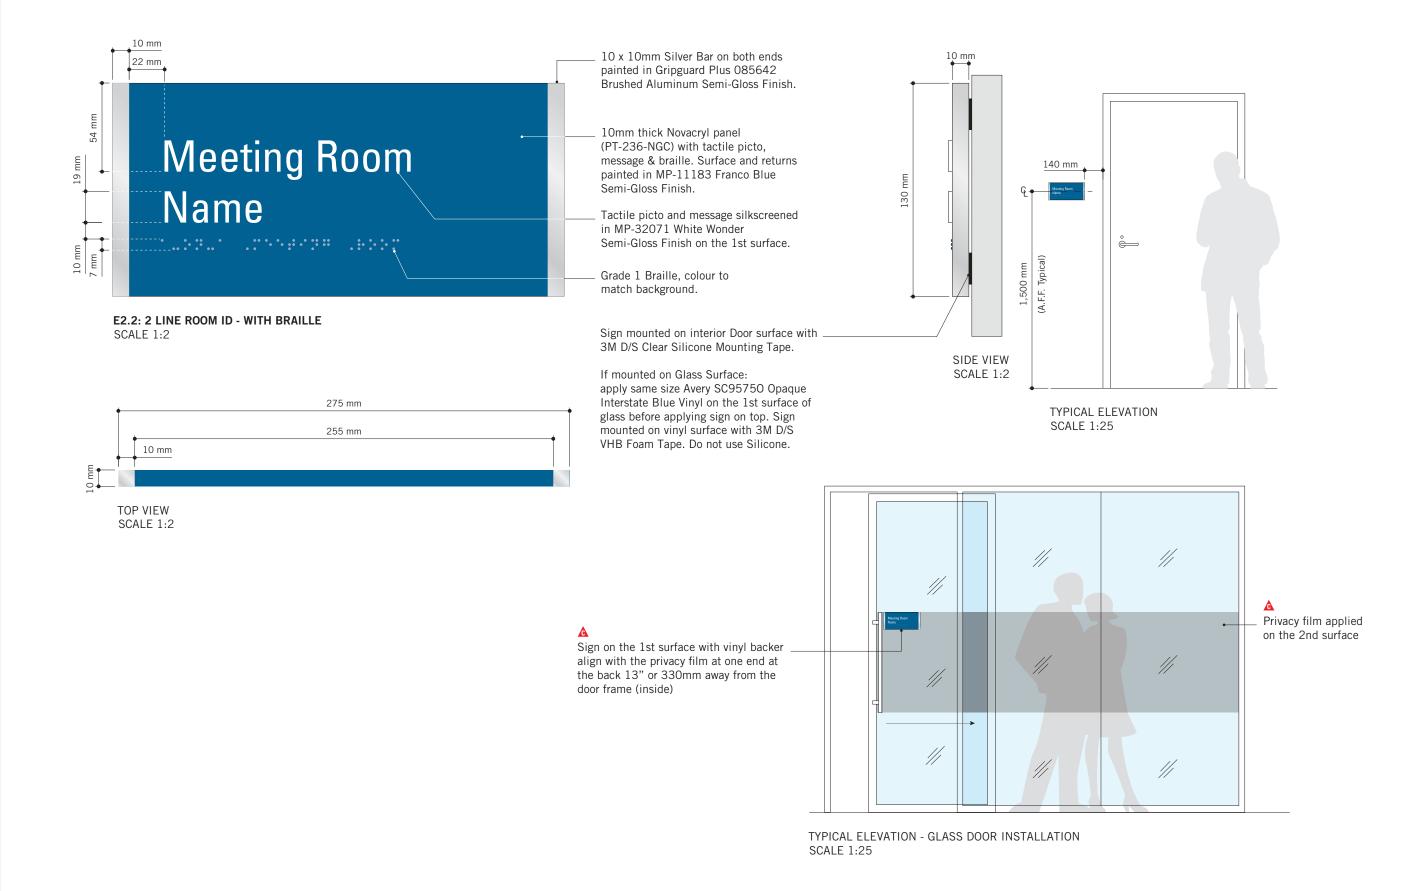



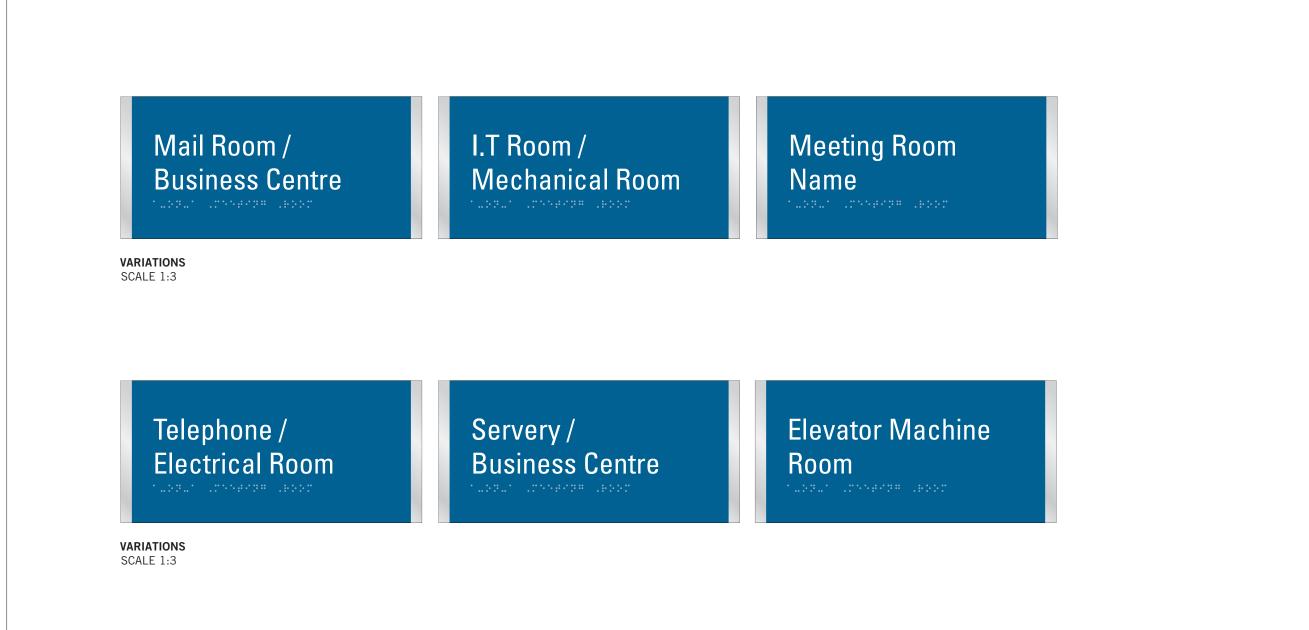



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ACCESSIBILITY UPGRADES

PROJECT ADDRESS
GROUP 05 BUILDINGS

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PROJECT NO: 9119 – 19 – 0162 / Arcadis 30279056

DRAWN BY: CHECKED BY:

DRAWN BY:
M.LOW

PROJECT MGR:
R. DALY


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C.D. SCHNOBB

APPROVED BY:

SHEET TITLE
SIGNAGE & WAYFINDING
DETAILS
E2: ROOM ID

SHEET NUMBER
D1903

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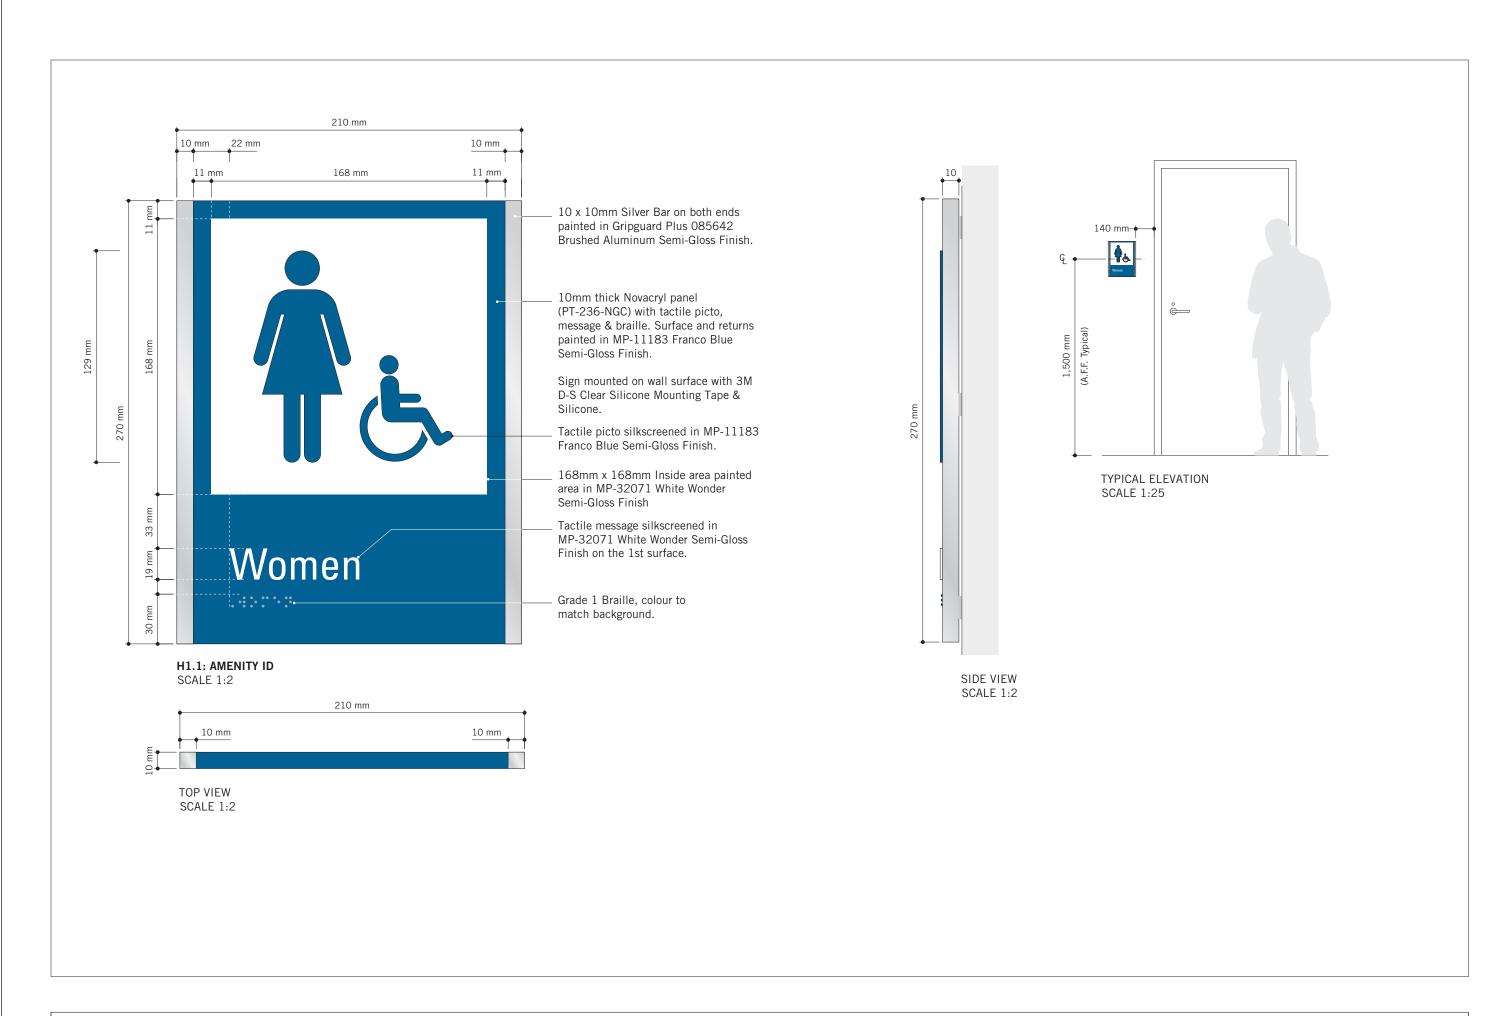
PROJECT MGR:
R. DALY
CHECKED BY:
C.D. SCHNOBB

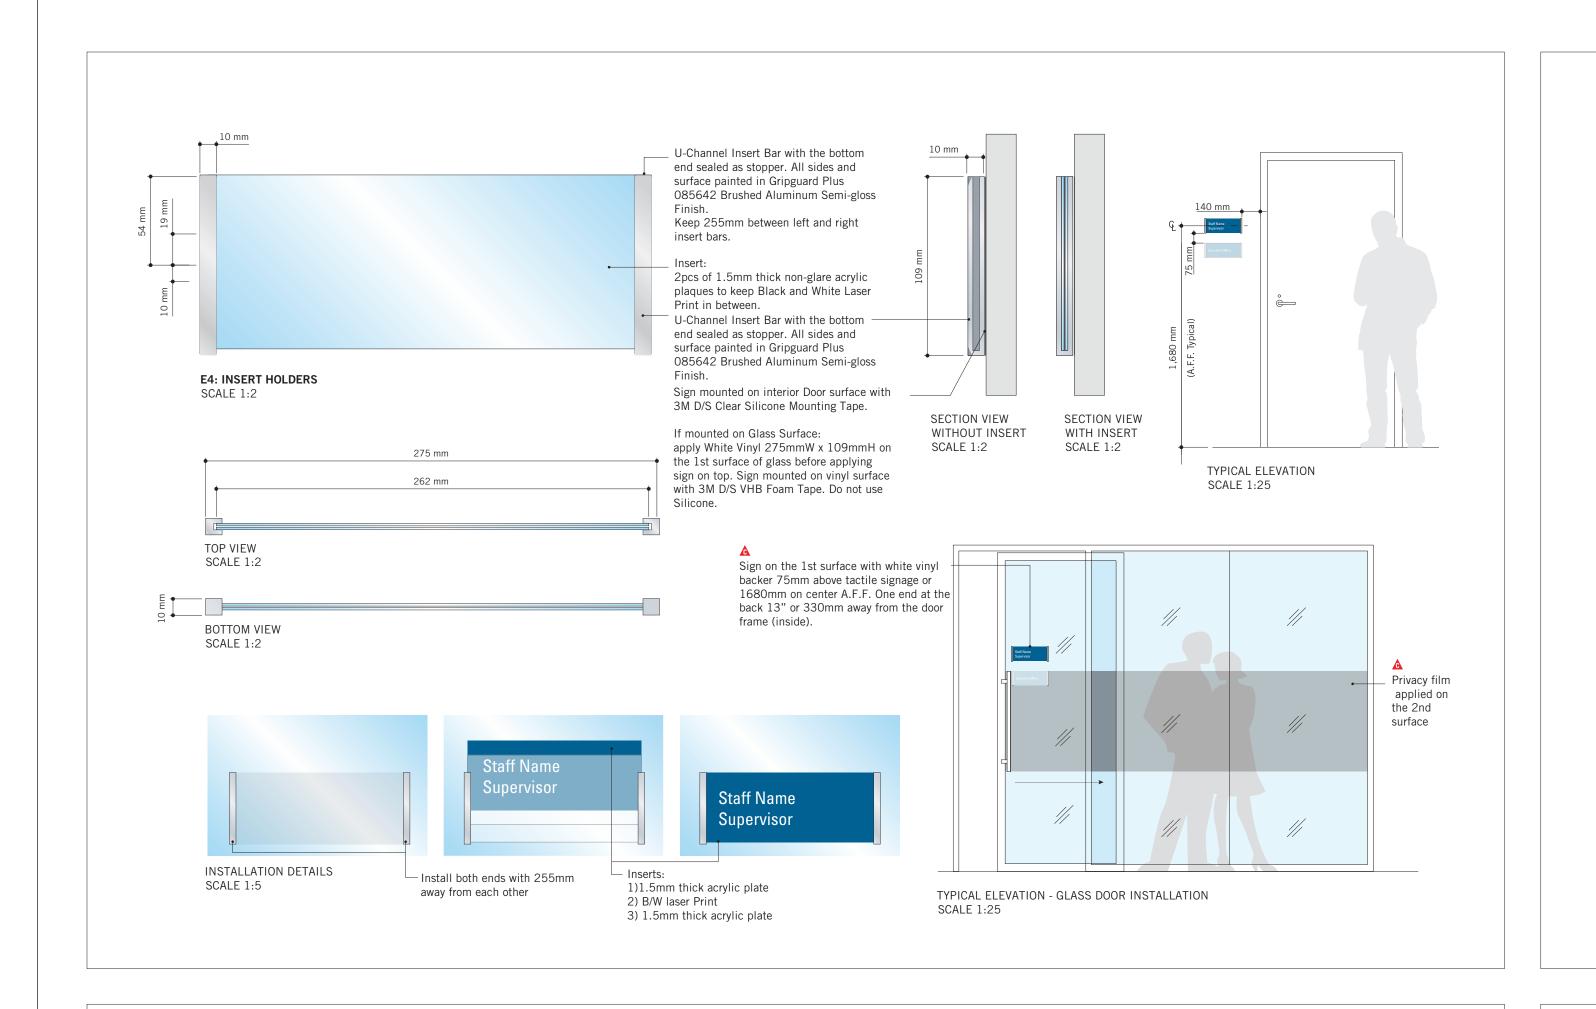
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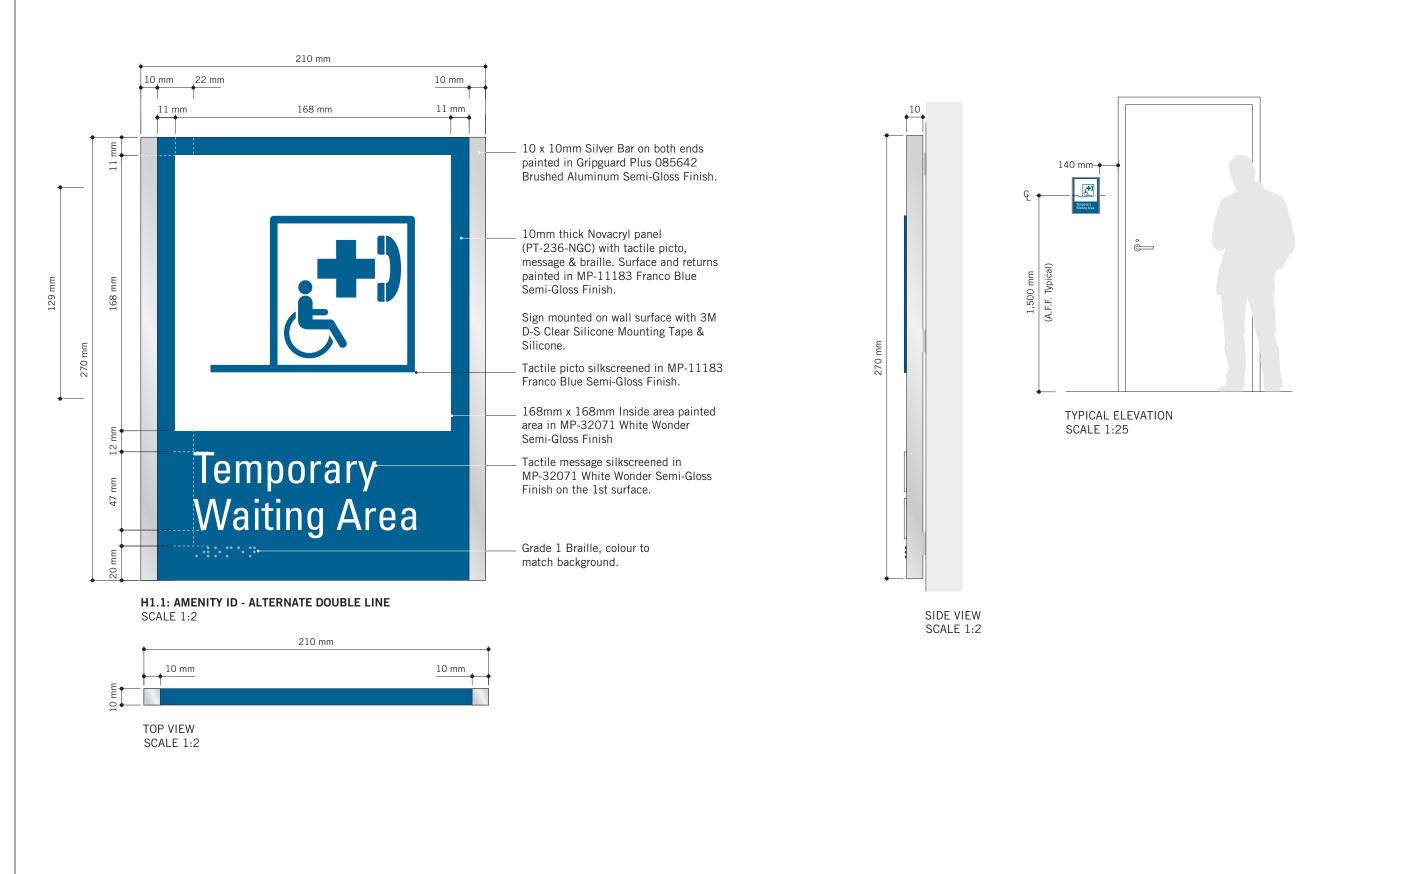
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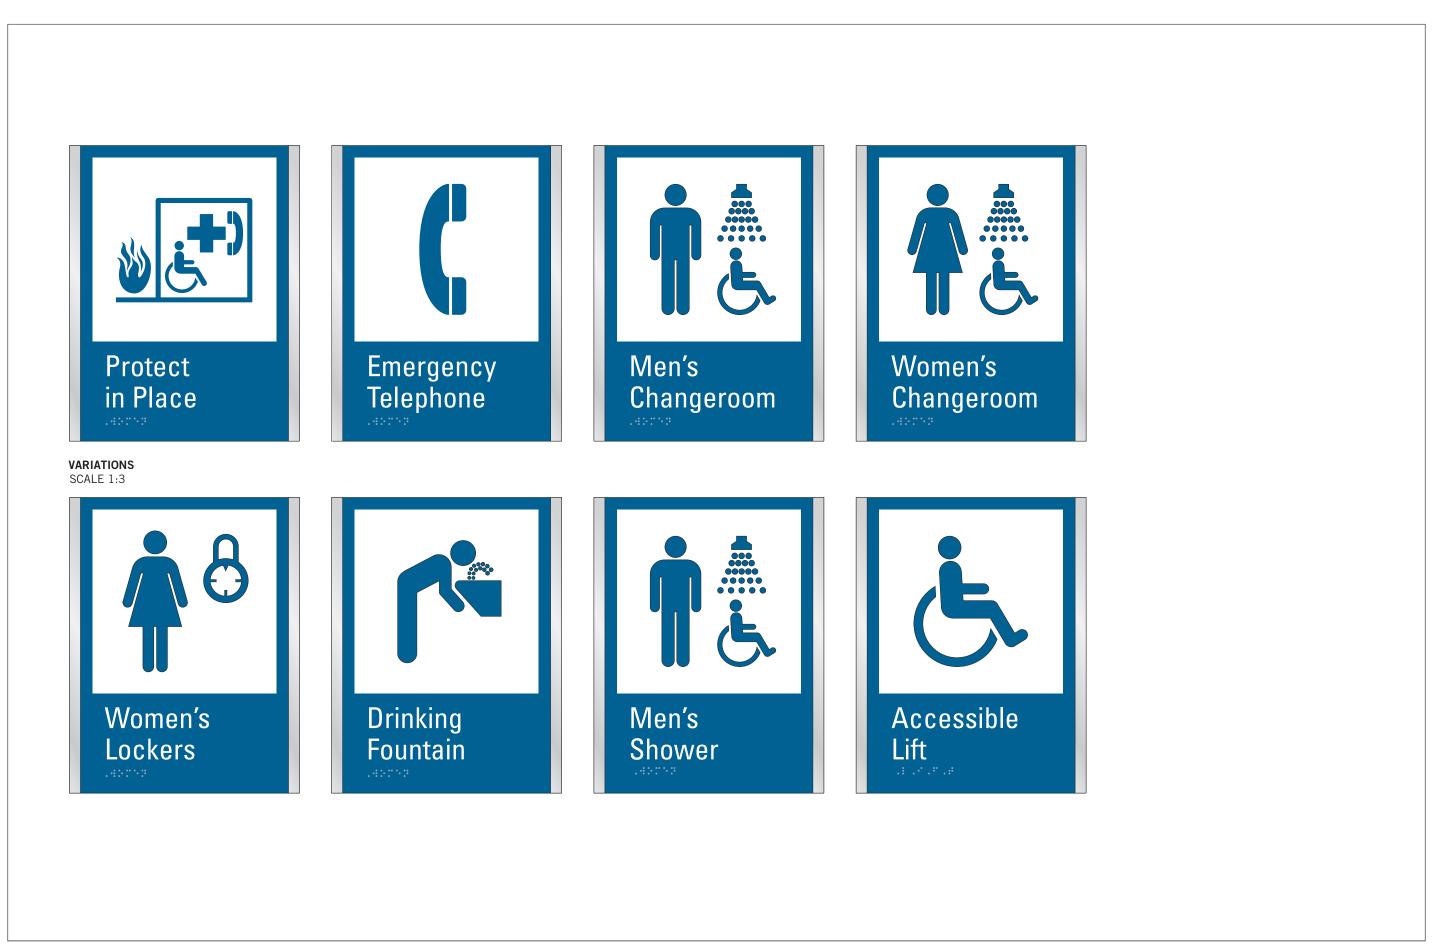
JMBER **D1904** 

)4 A







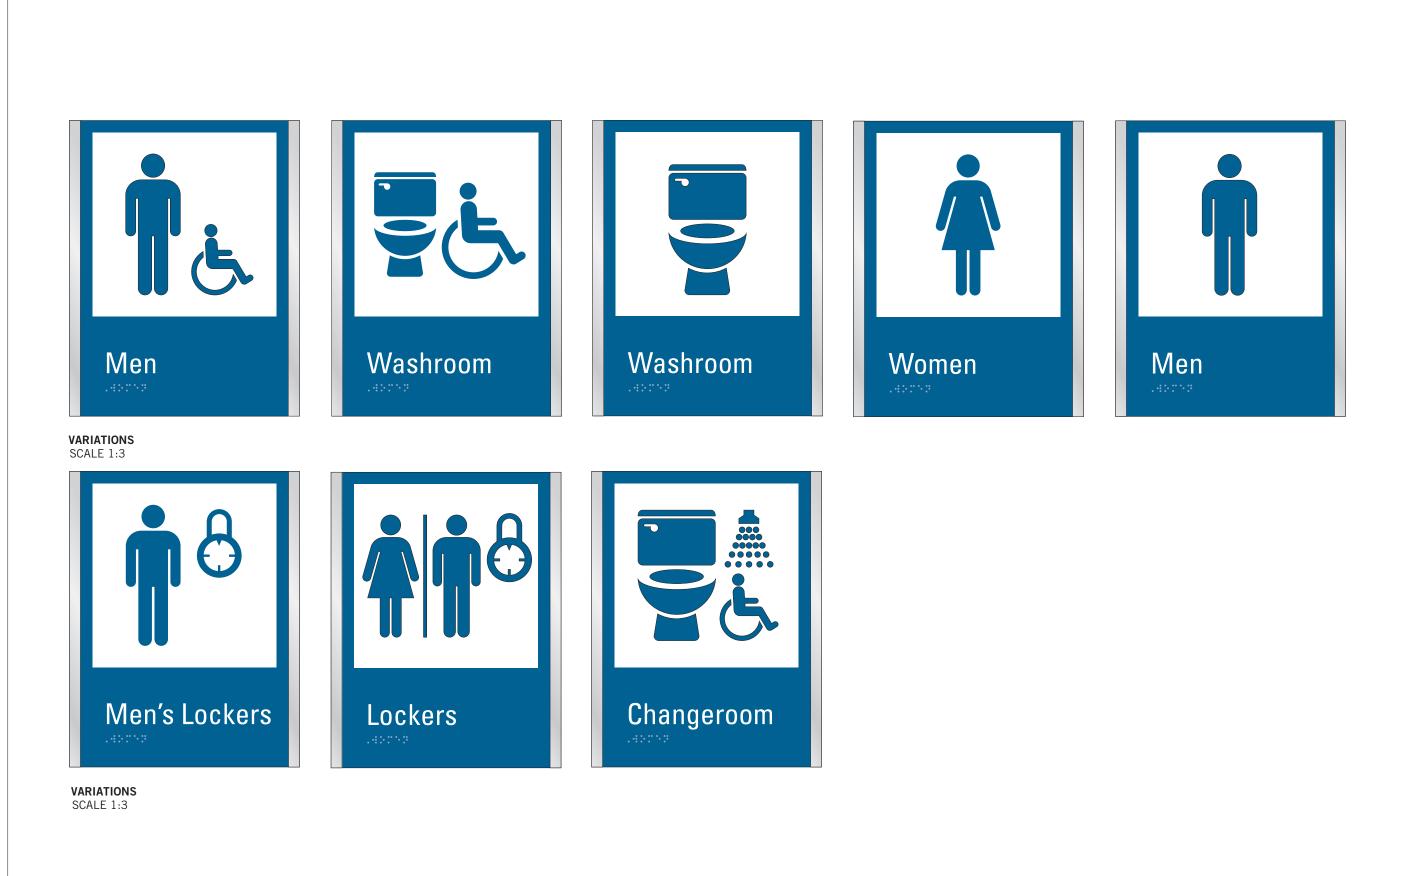



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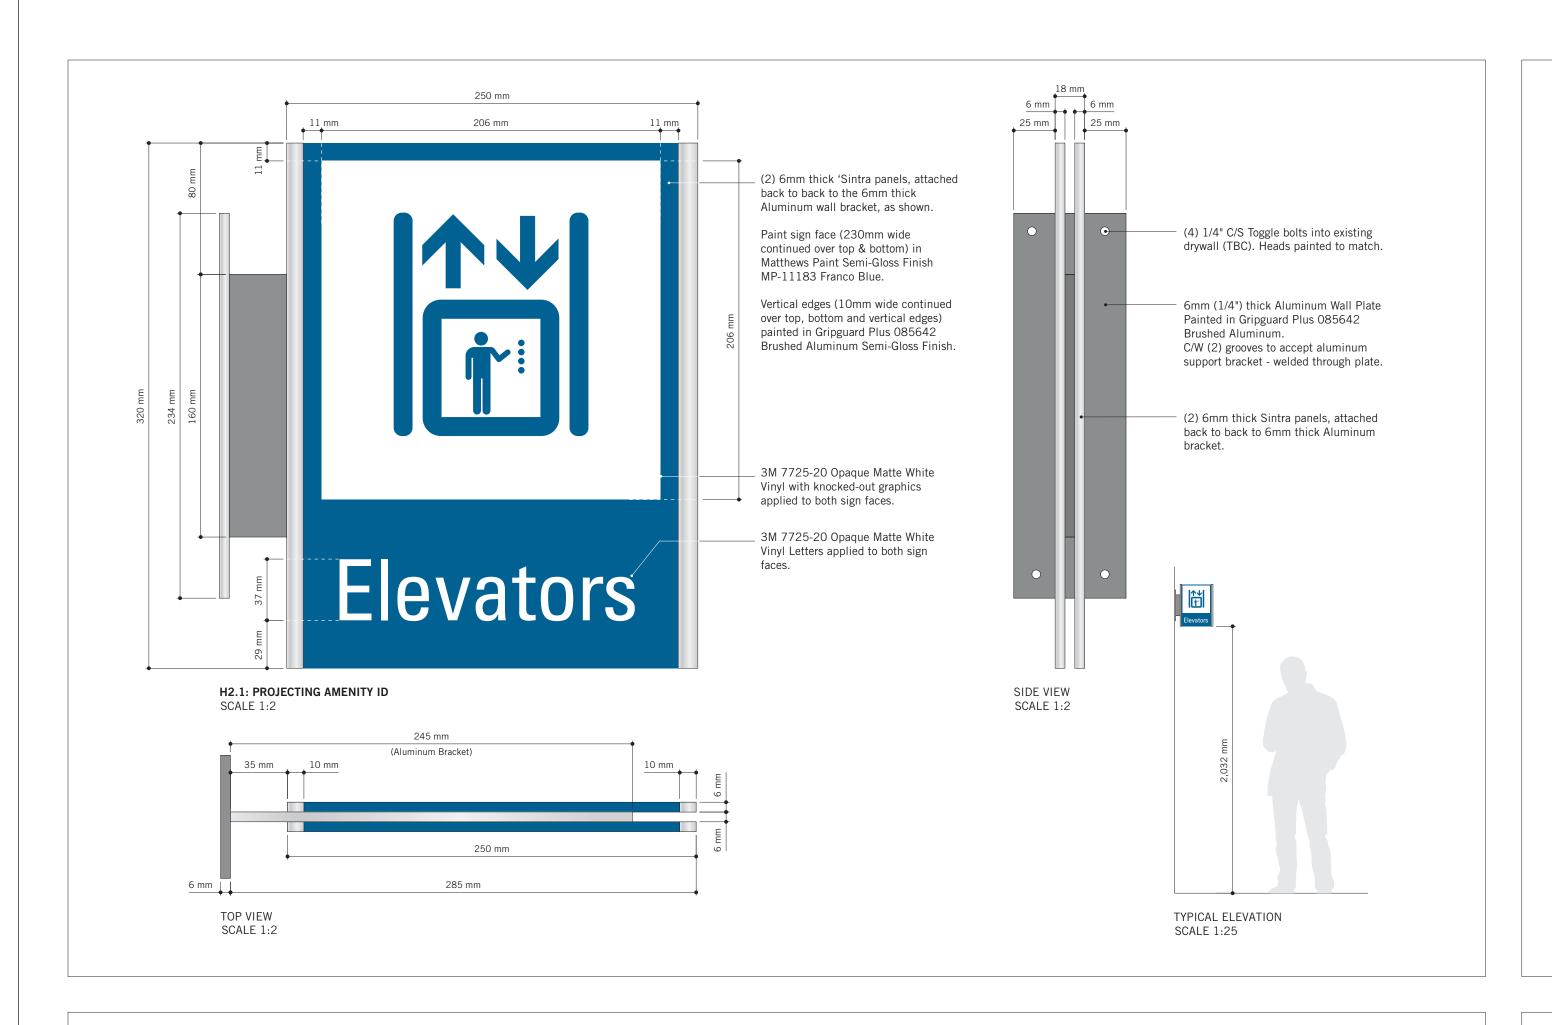
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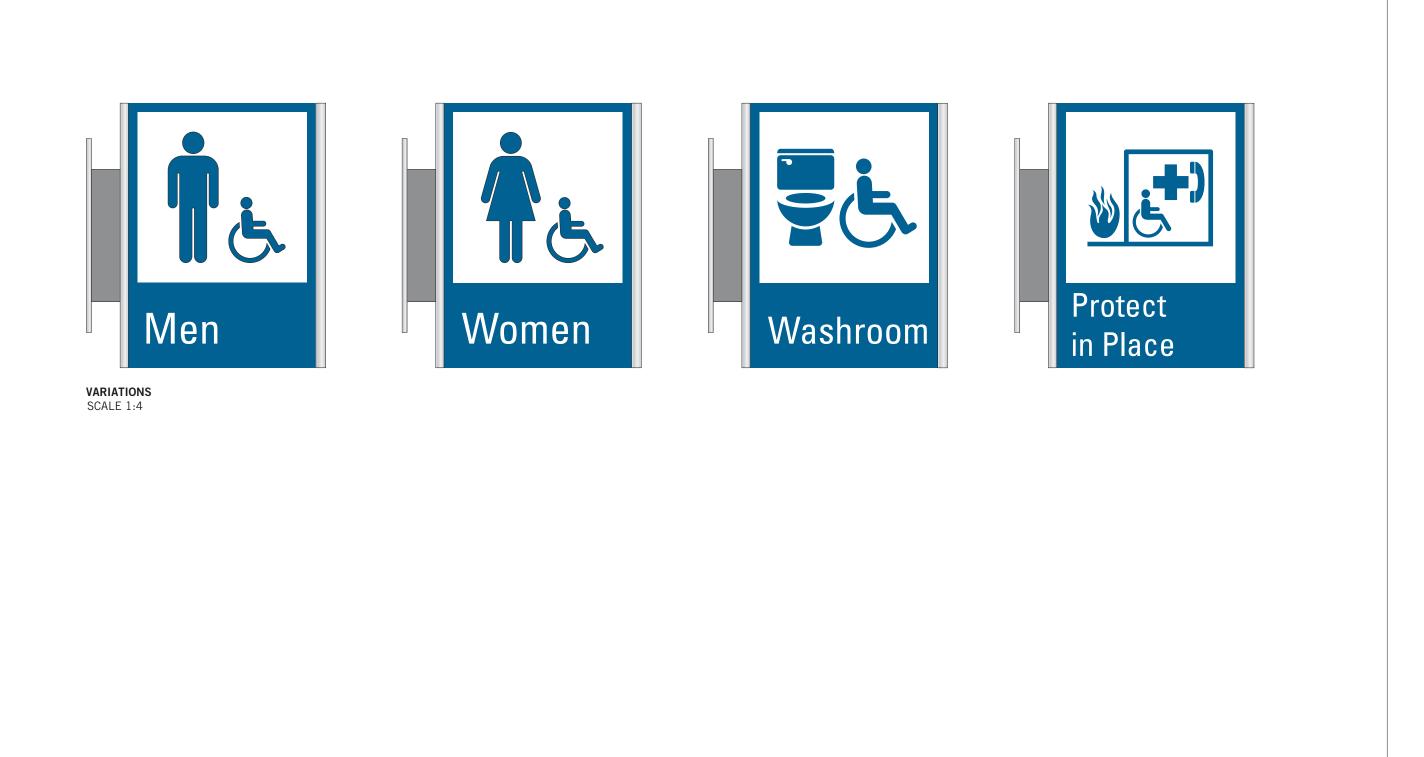
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DETAILS H1.1: AMENITY ID

SHEET NUMBER
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PROJECT MGR:
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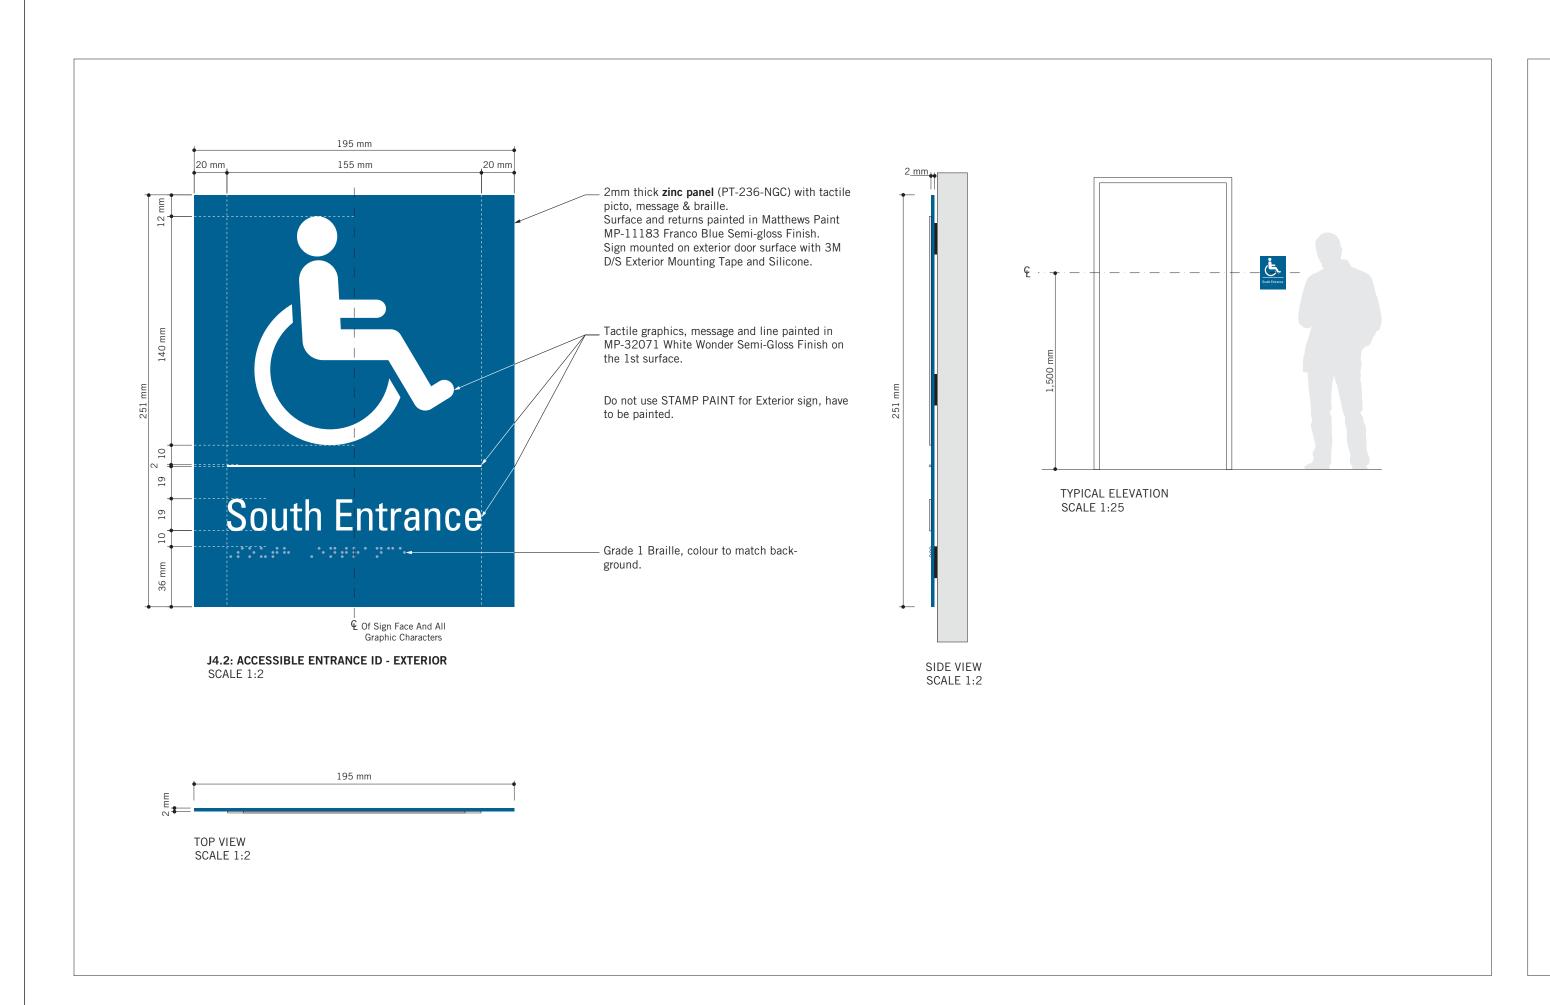
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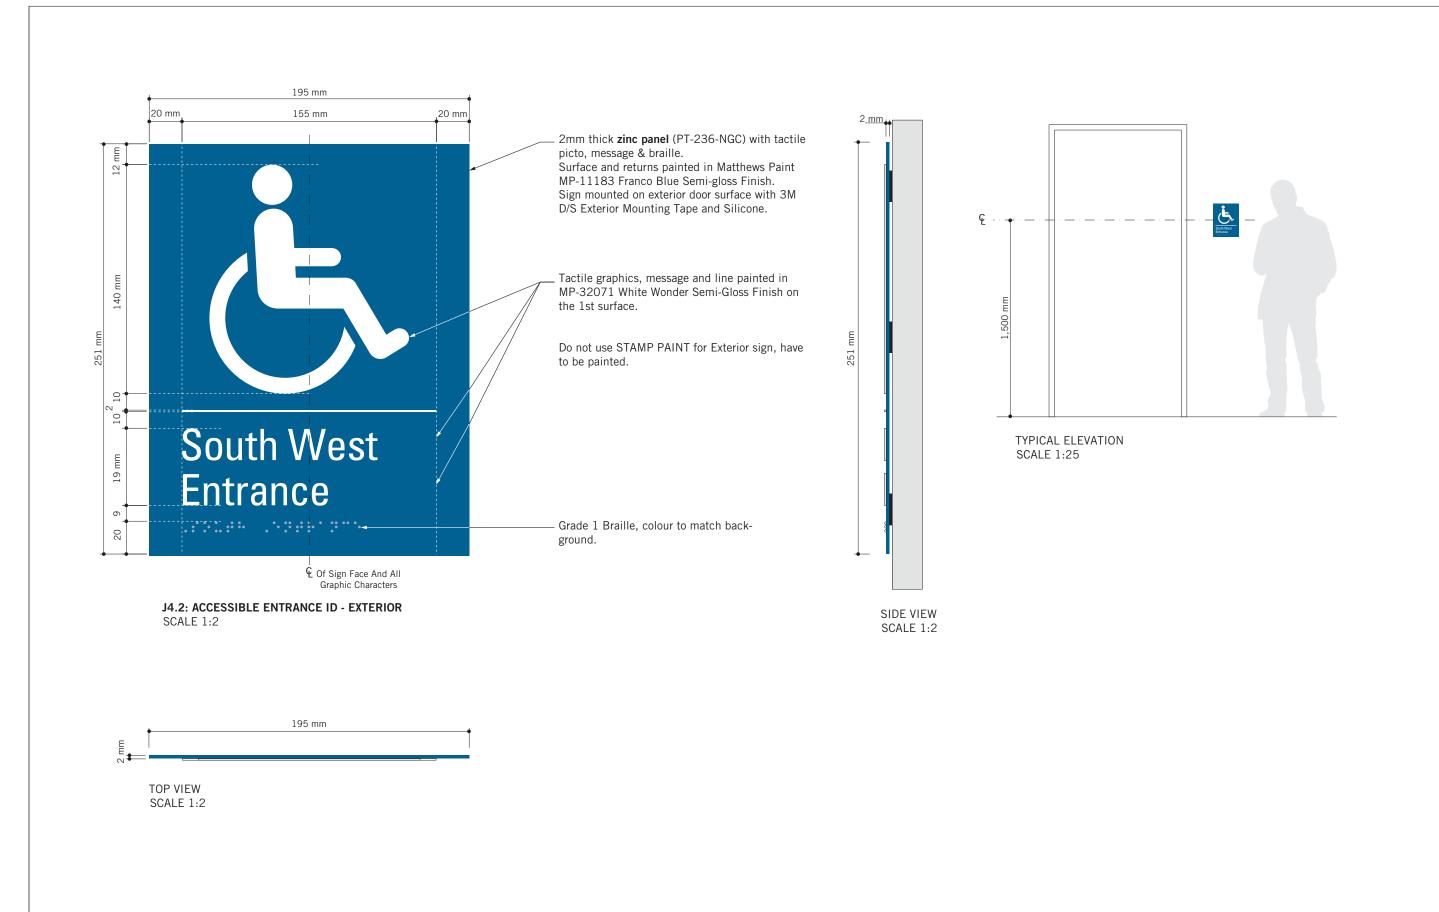
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SHEET NUMBER

D1906 ISSUE









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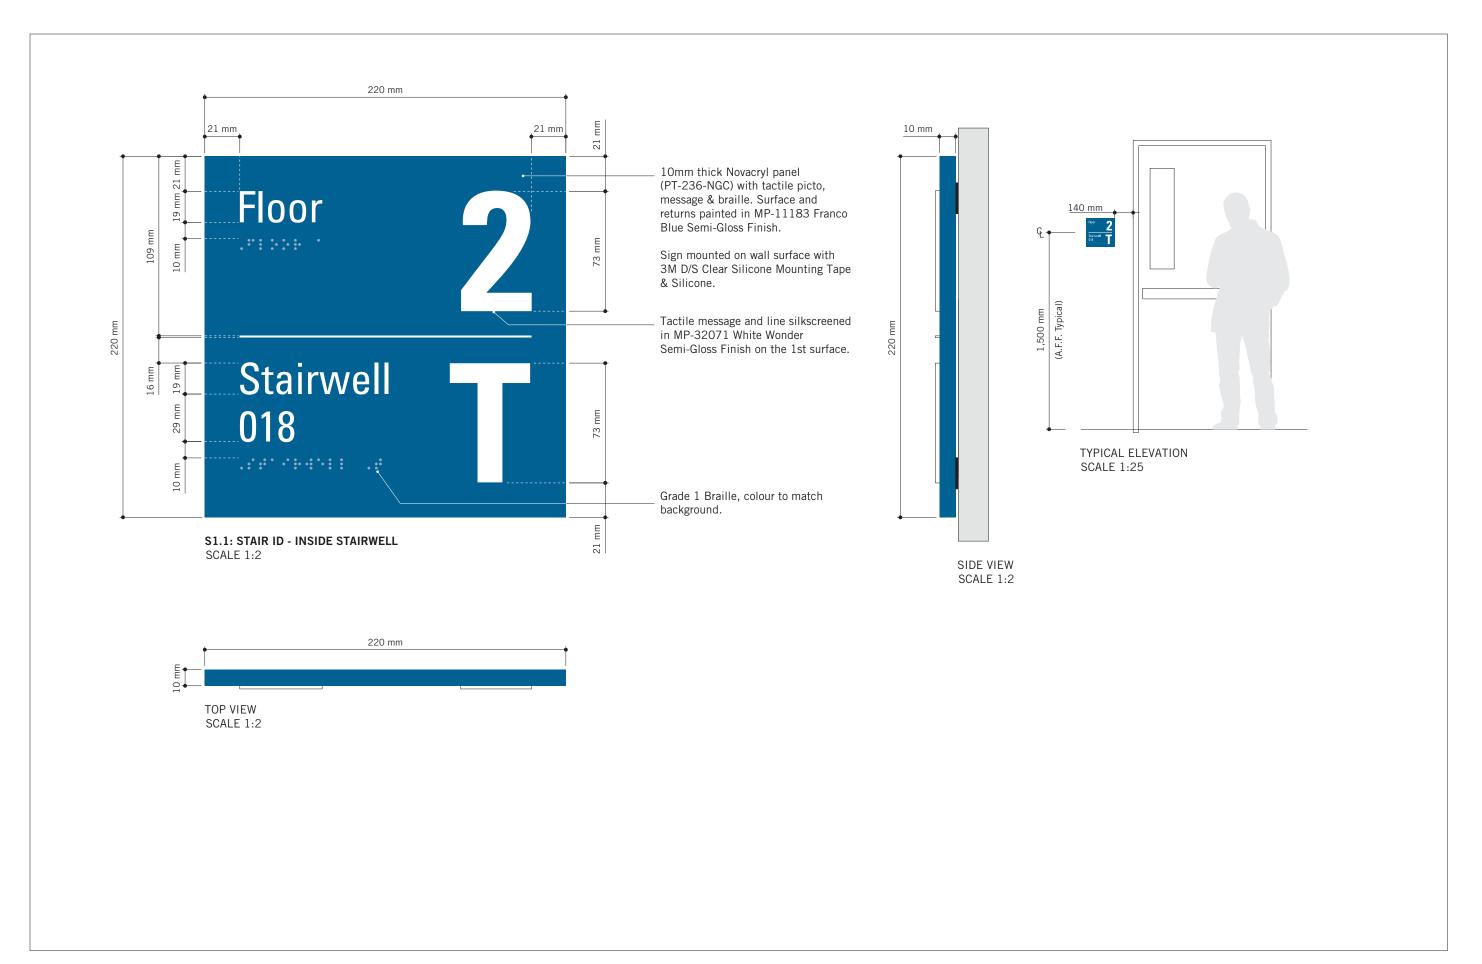
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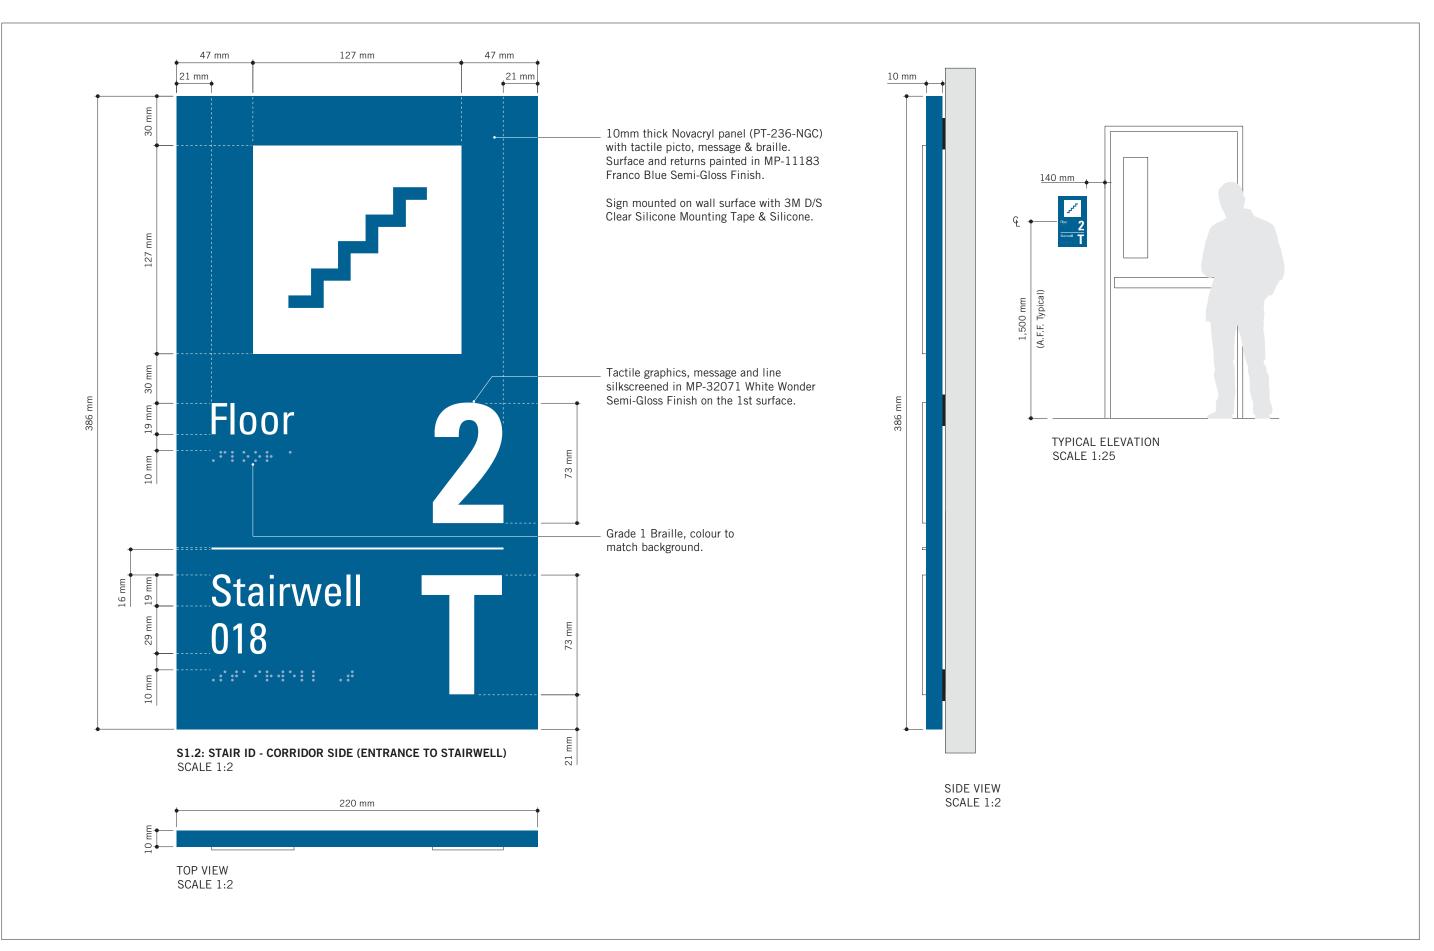
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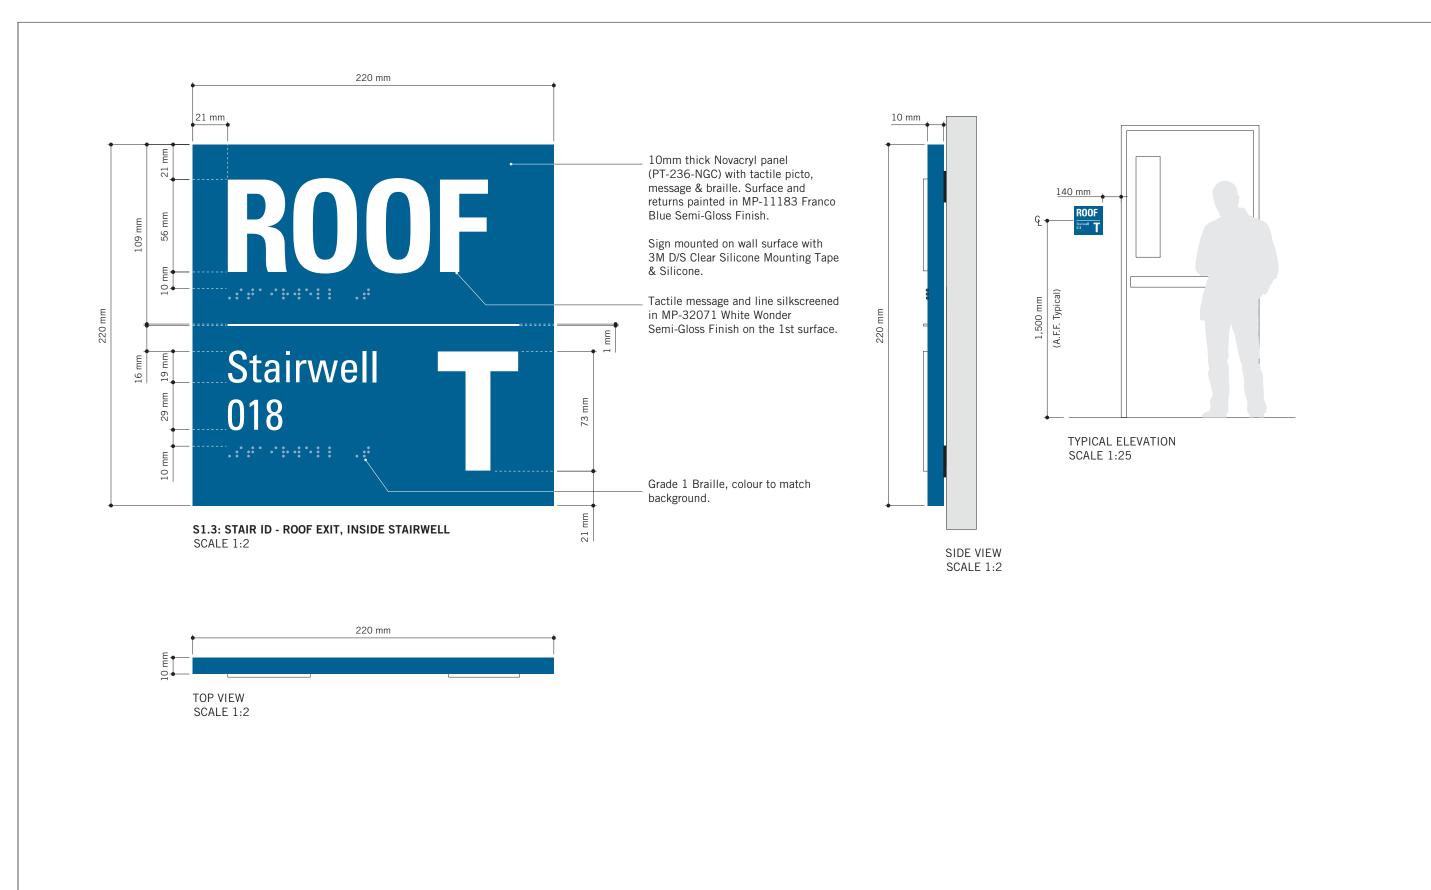
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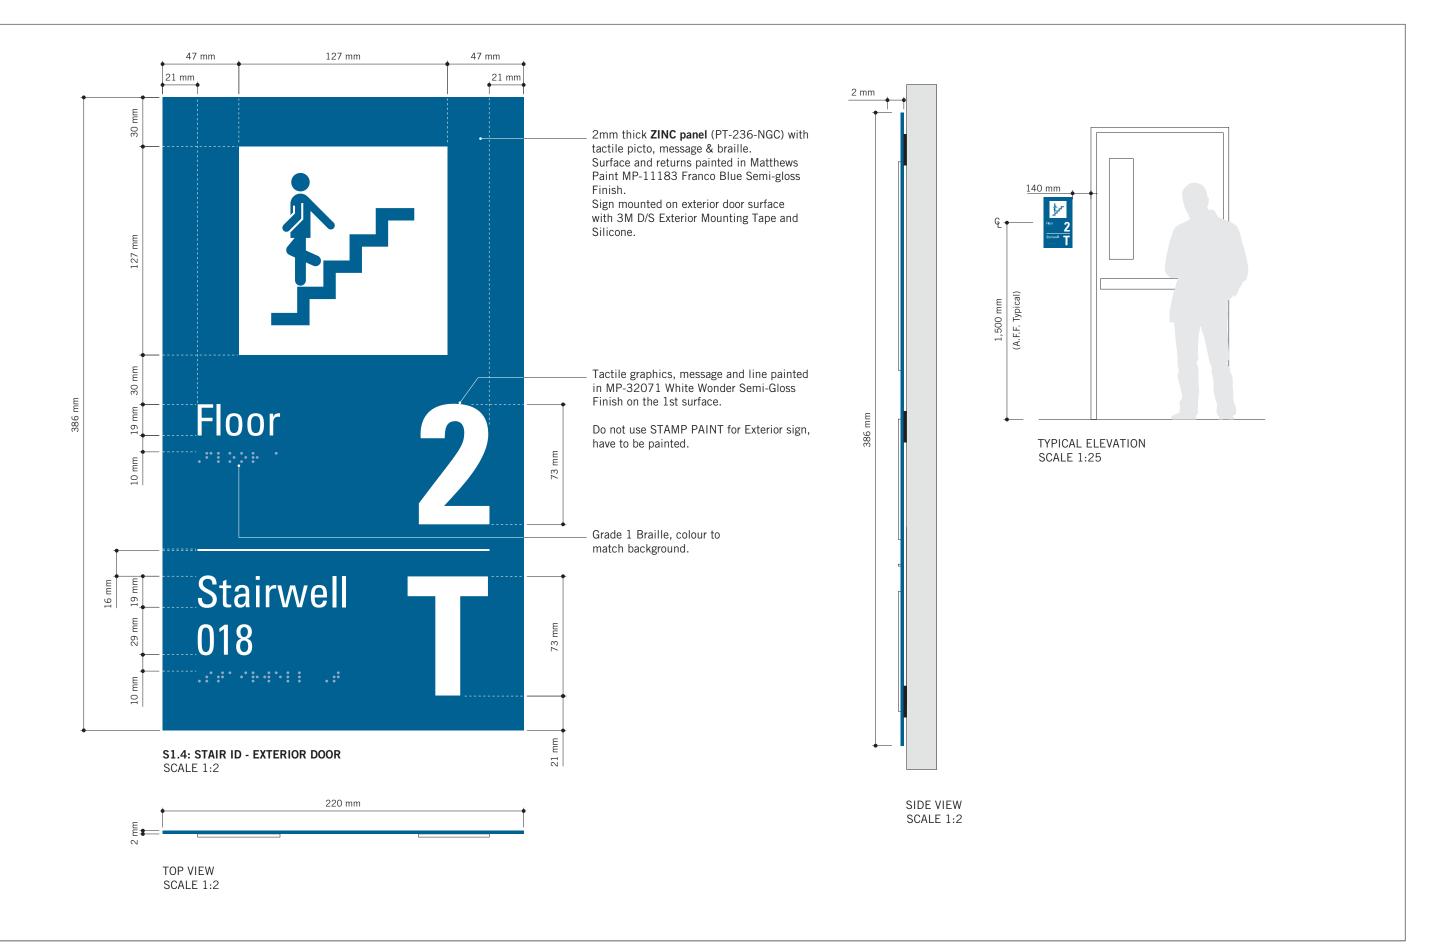
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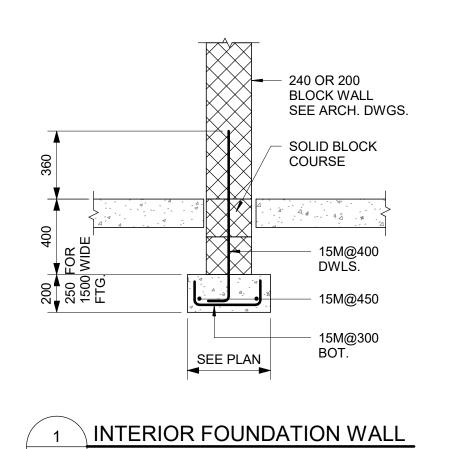
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C.D. SCHNOBB

PROJECT MGR:
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C.D. SCHNOBB


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SIGNAGE & WAYFINDING
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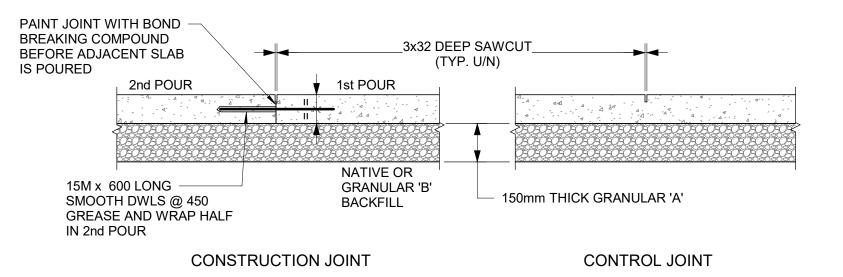
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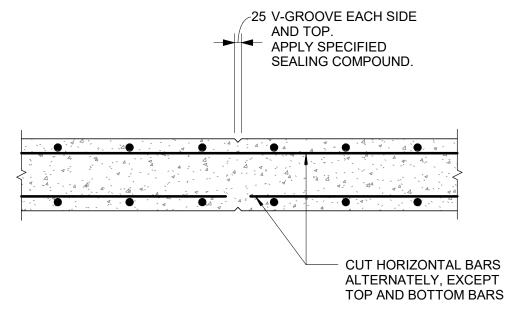
D1908 A



∖ D2100 / Scale: NTS





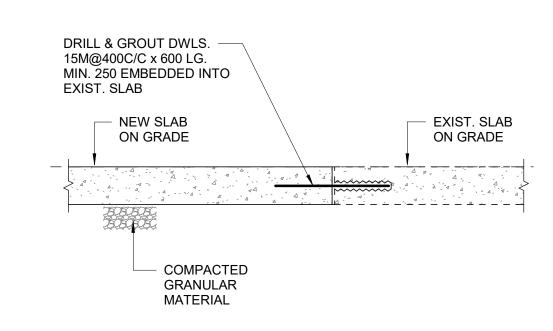

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CITY OF TORONTO

Corporate Real Estate Management

Project Management Office

M5V 3C6

2022-07-29

2022-12-09

2025-04-11

Metro Hall Toronto, ON

CLIENT

4 RETAINING WALL CONTROL JOINT ∖ D2100 / Scale: 1 : 20

NEW SLAB CONNECTION TO EXISTING SLAB ∖ D2100 / Scale: NTS


EXTERNAL FACE

WATERSTOP WHERE

SHOWN ON DWGS.

TYPE 1WS


3 SLAB ON GRADE ∖ D2100 / Scale: NTS

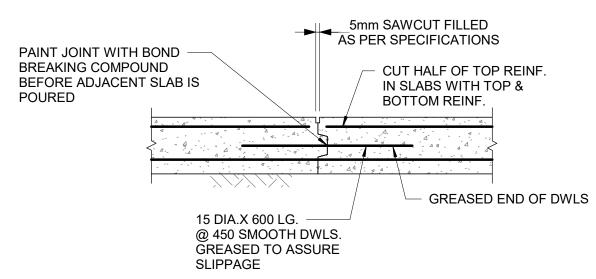


# **CONTROL JOINT**


# TYPE 1

WALL THICKNESS	KEY			
"T"	"D"	"W"	"a"	
200 TO 300	50	100	5	
310 TO 440	50	150	10	
450 TO 590	75	200	20	
600 TO 890	75	250	20	_

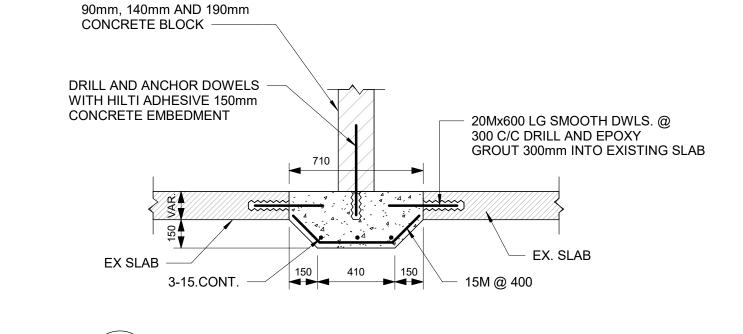

BLOCK WALL SLAB - THICKENING AT EXISTING SLAB

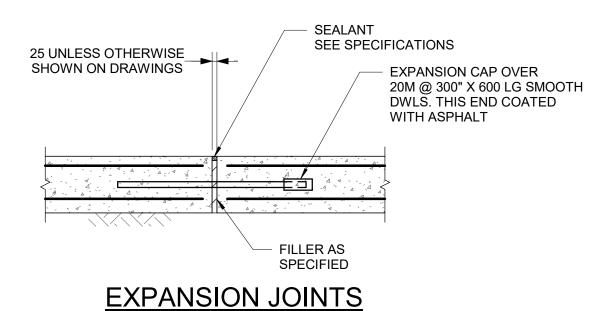


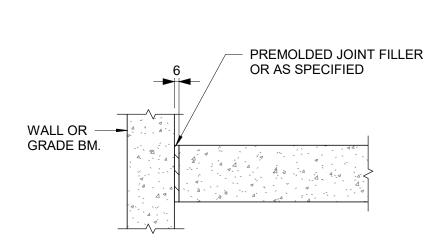

**ISOLATION JOINT** 

7 FLOOR JOINTS 

5	TYPICAL CONSTRUCTION JOINT AT EXTERIOR WALL
D2100	Scale: 1:20

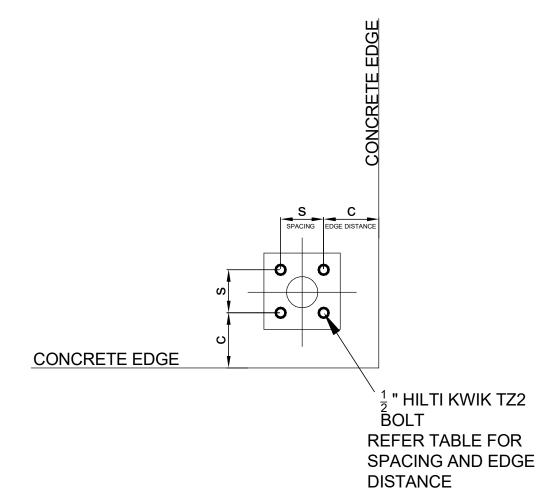

D2100 | Scale: 1:20

HILTI KWIKBOLT TZ2 CARBON STEEL, DIA 1/2"						
CONCRETE THICKNESS		Case 1		Case 2	Case 2	
THORNES	MENT	MIN EDGE DIST. C <sub>MIN1</sub>	FOR SPACING S <sub>MIN1</sub>	MIN EDGE DIST. C <sub>MIN2</sub>	FOR SPACING S <sub>MIN2</sub>	
200	83	57	133	121	51	
150	64	70	248	203	76	
125	51	70	140	254	89	
100	38	203	305	203	305	

SPACING AND EDGE REQUIREMENTS FOR WEDGE ANCHORS (TYPICALLY USED FOR HANDRAILS) D2100 Scale: 1:5

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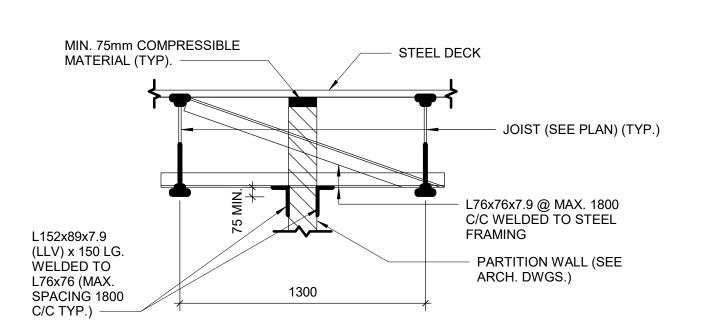
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APPROVED BY: K. ANGER N. FRISCIC SHEET TITLE CONCRETE TYPICAL **DETAILS** 


SHEET NUMBER

G05-D2100


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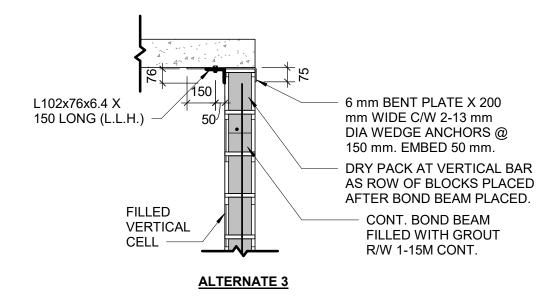


# **PARTITION WALL BETWEEN JOIST** D2200 Scale: 1:20

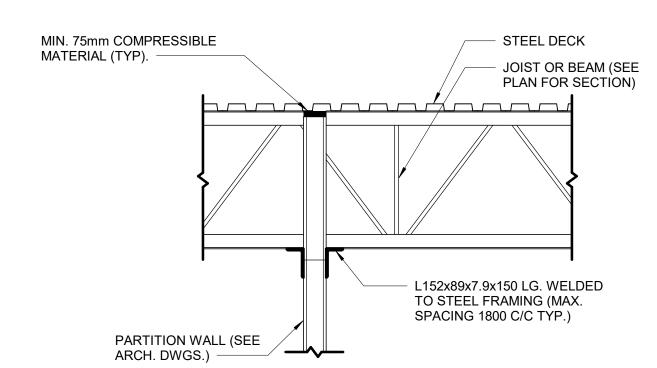

## 4 PARTITION WALL PERPENDICULAR TO JOIST OR BEAM D2200 / Scale: 1 : 20




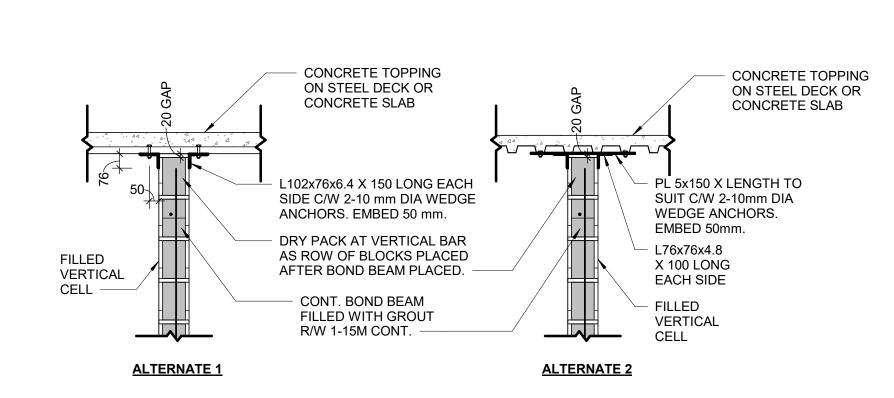


NOTES:

1. ALL CONNECTIONS TO BE AT FILLED VERTICAL CELLS AT 1200 mm O/C MAXIMUM UNLESS NOTED OTHERWISE. 2. FIELD WELD ANGLES TO EMBEDDED PLATE.


7 SUPPORT DETAIL AT TOP OF BLOCK WALL D2200 / Scale: 1 : 20

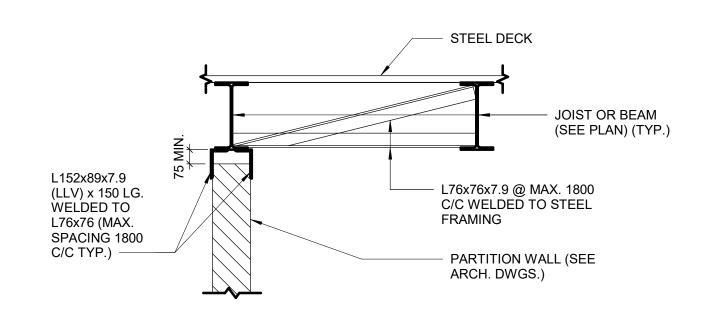


## 2 PARTITION WALL PARALLEL TO AND CENTERED ON JOIST OR BEAM ∖ D2200 / Scale: 1 : 20

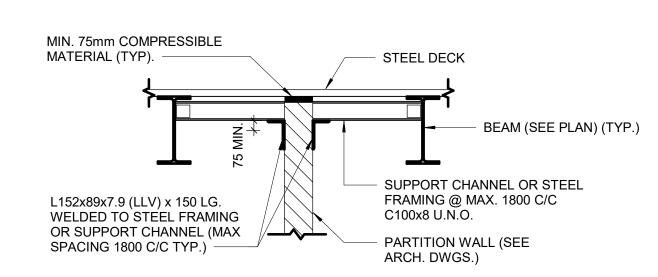


## PARTITION WALL BETWEEN BEAMS ∖ D2200 / Scale: 1 : 20

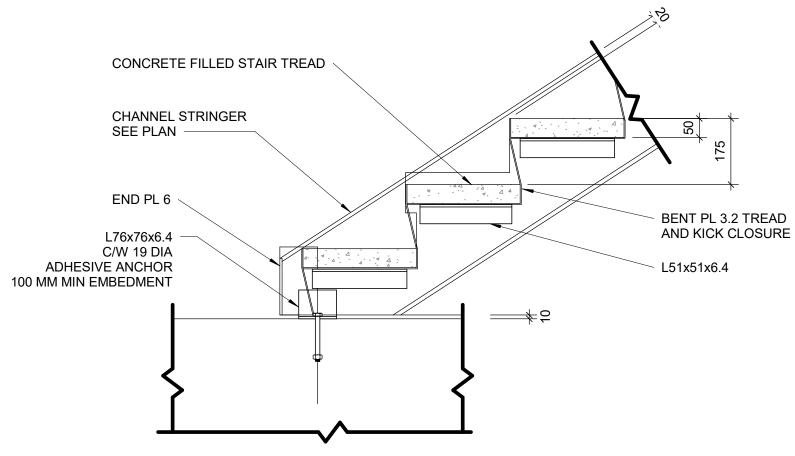


8 TYPICAL SLAB UNDER STRINGER 

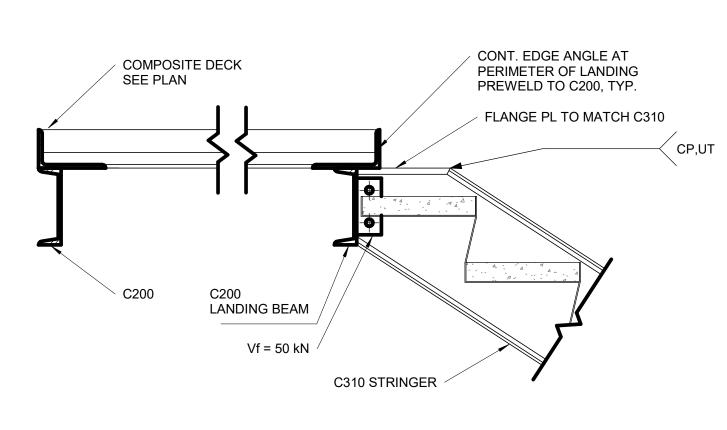




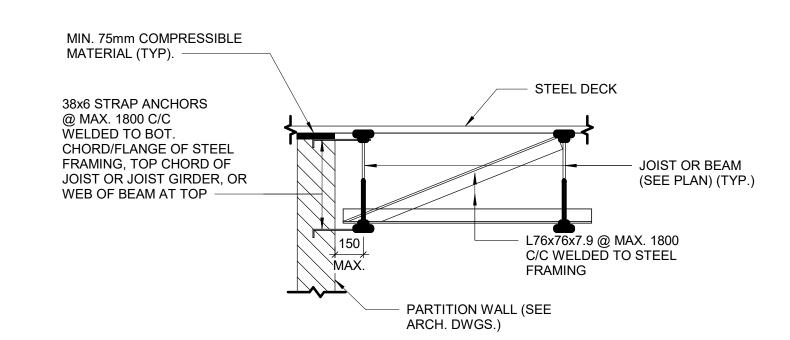


# 3 PARTITION WALL PARALLEL TO JOISTS OR BEAM √D2200 / Scale: 1 : 20

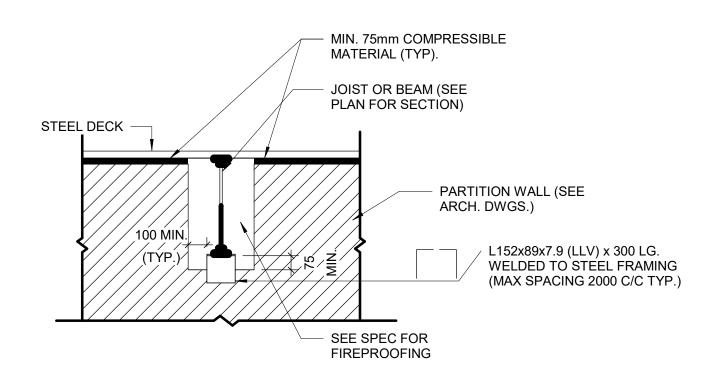


6 PARTITION PERPENDICULAR TO JOIST OR BEAMS √D2200 / Scale: 1 : 20

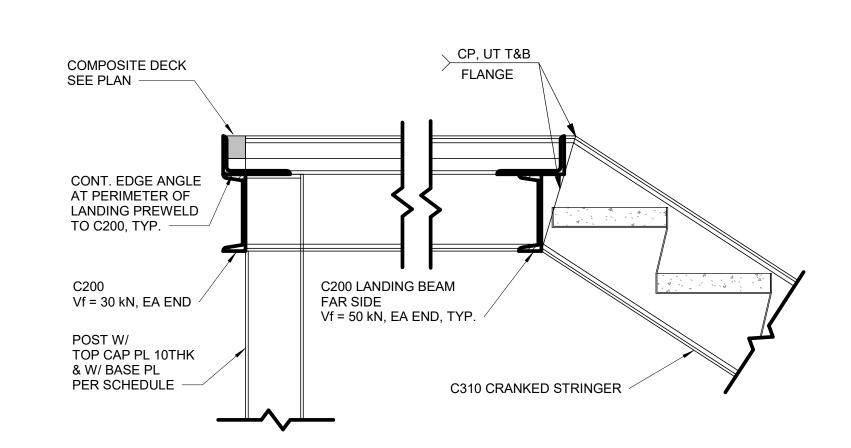

# $oxed{egin{array}{c} 9 \end{array}}$ TYPICAL SECTION AT UPPER LANDING STRINGER D2200 / Scale: 1 : 10

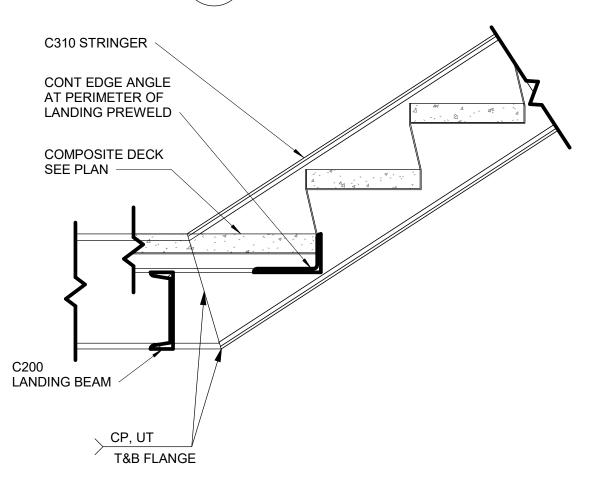



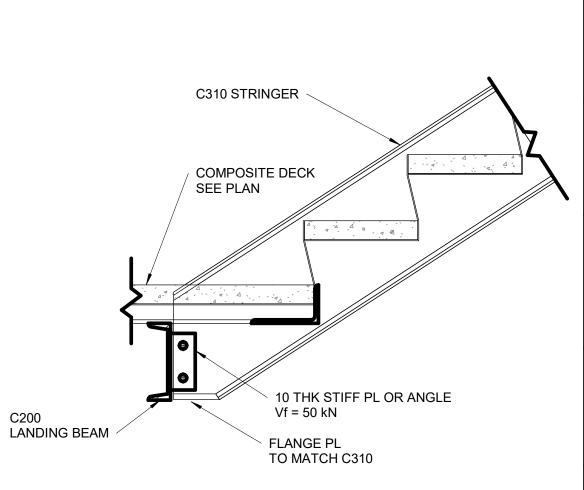

11 TYPICAL SECTION AT LOWER LANDING ∖ D2200 / Scale: 1 : 10



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С	ISSUED FOR PERMIT	2022-07-29
D	ISSUED FOR TENDER	2022-12-09
Е	ISSUED FOR TENDER	2025-04-11

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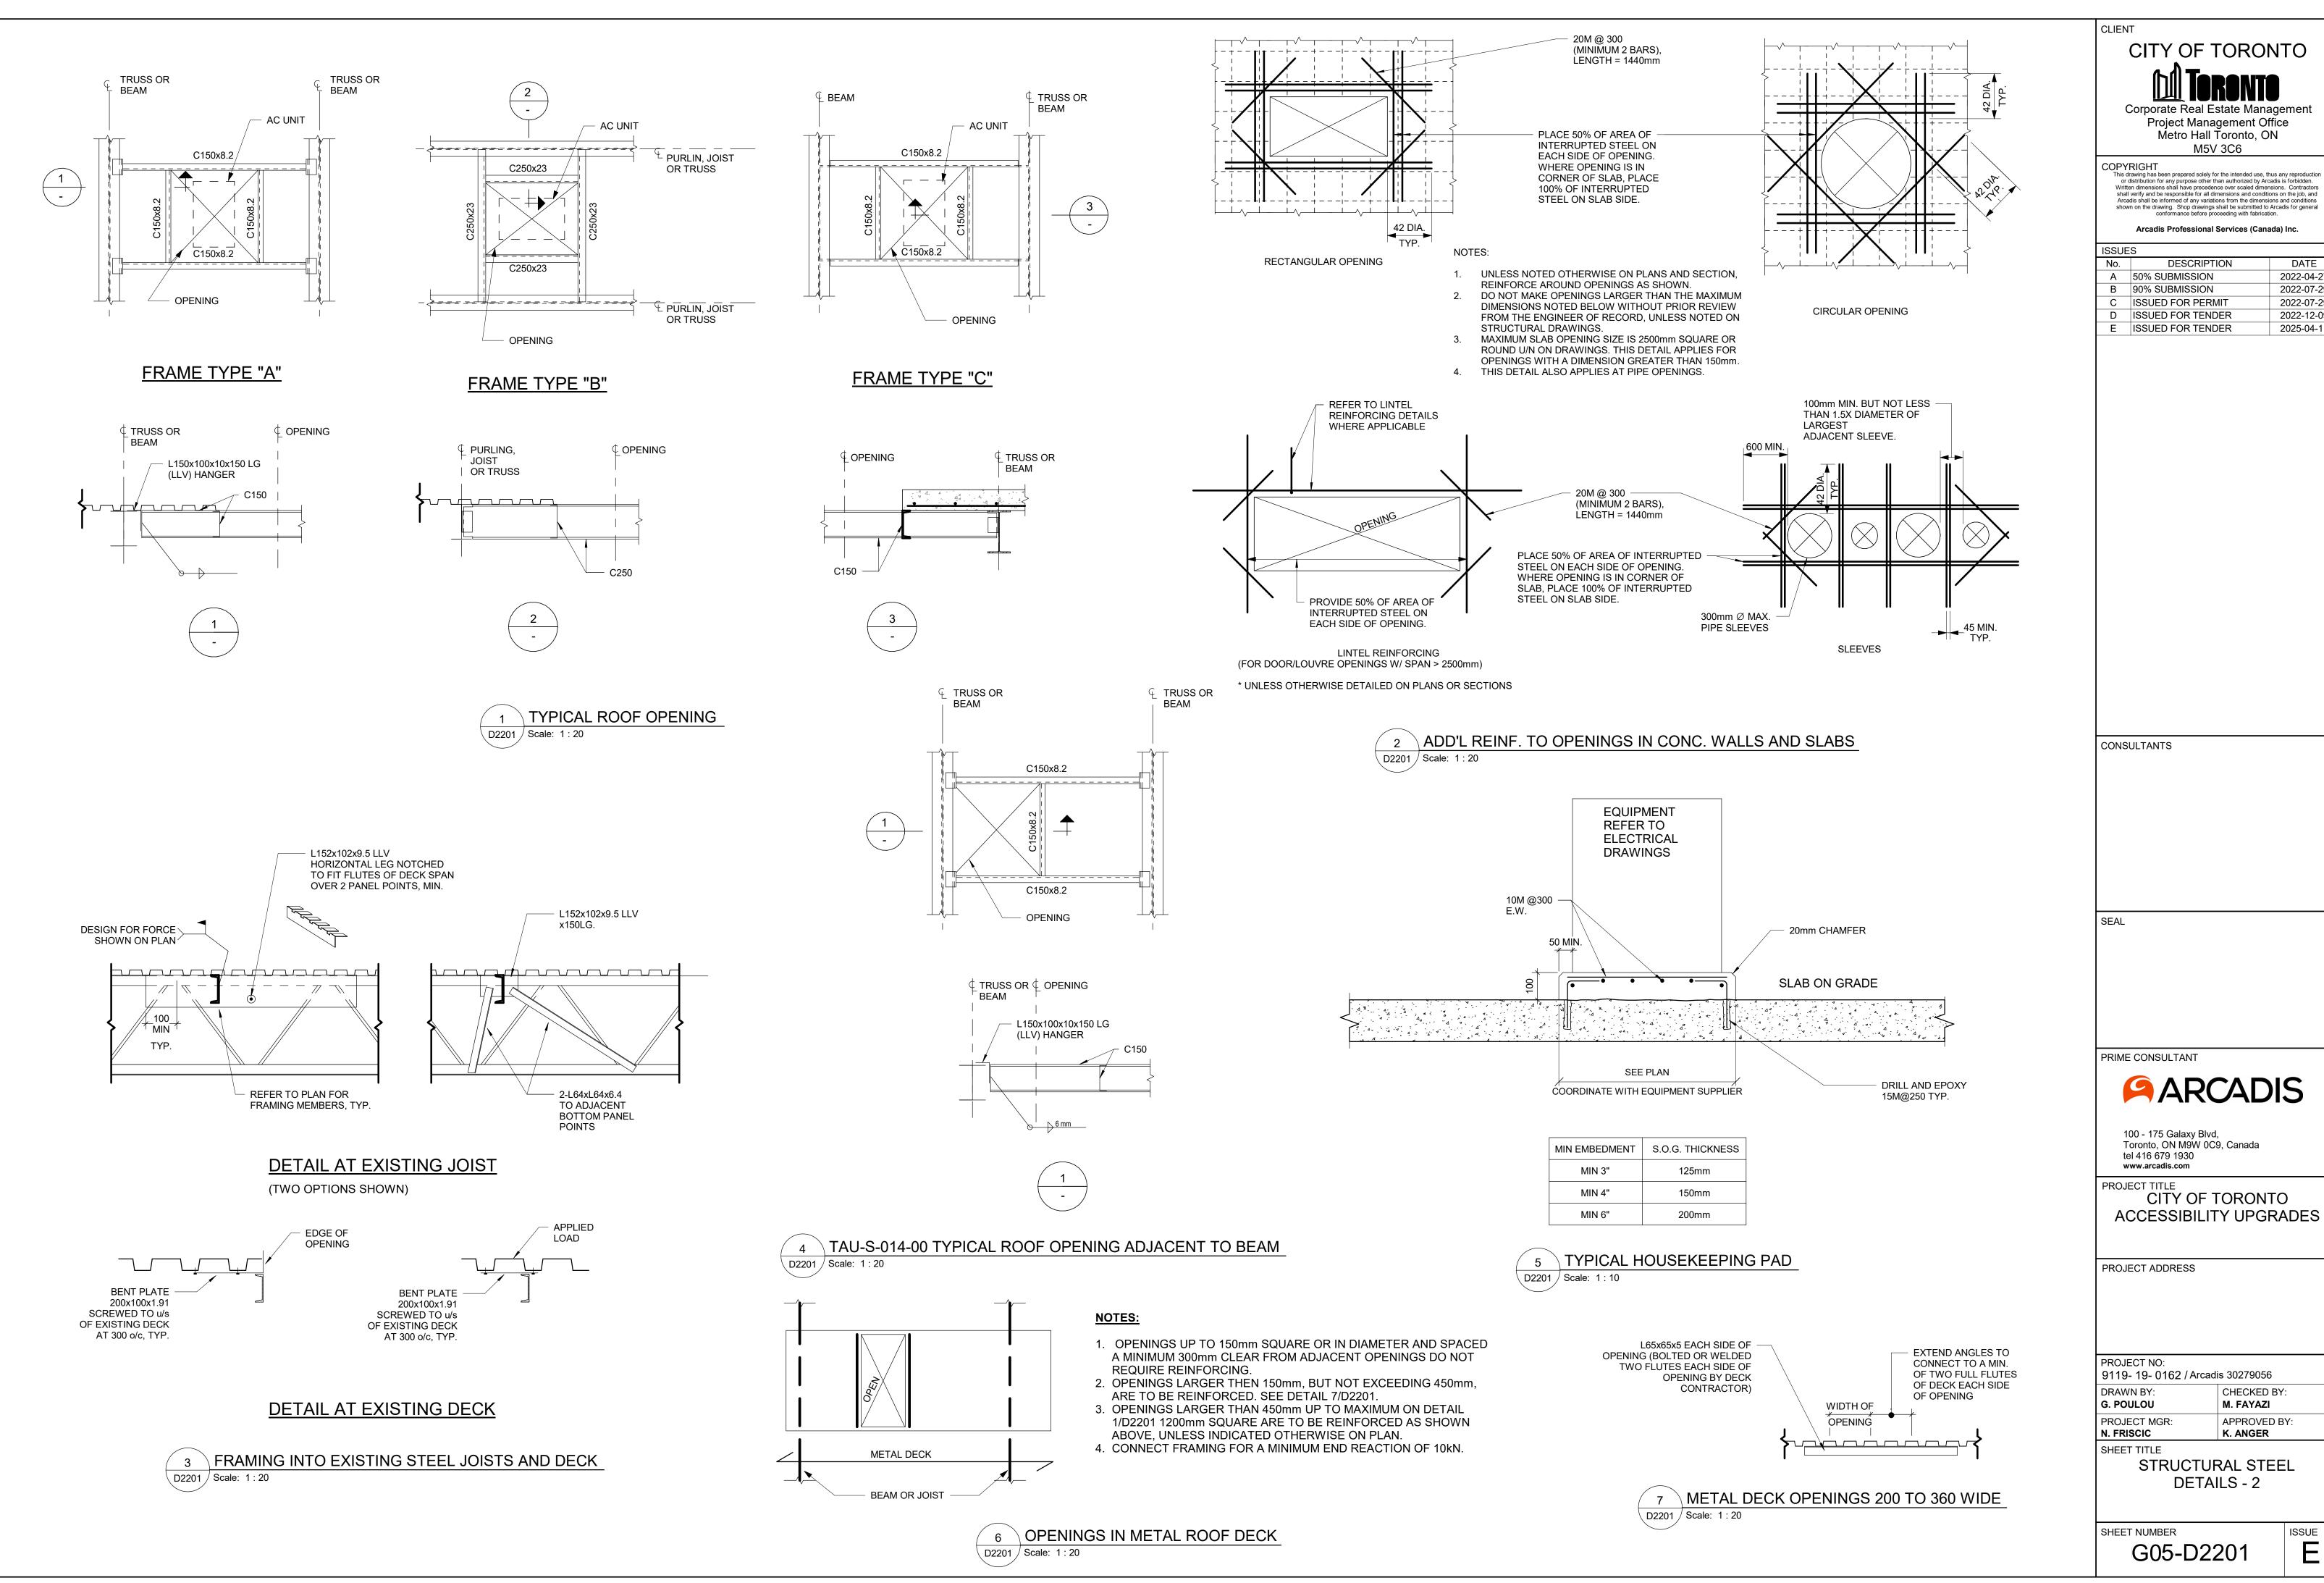
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SHEET TITLE STRUCTURAL STEEL DETAILS - 1

SHEET NUMBER

ISSUE G05-D2200



G05-D2201

CITY OF TORONTO

CHECKED BY:

APPROVED BY:

ISSUE

M. FAYAZI

K. ANGER

STRUCTURAL STEEL

DETAILS - 2

CITY OF TORONTO

Project Management Office

Metro Hall Toronto, ON

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Arcadis Professional Services (Canada) Inc.

2022-04-27


2022-07-29

2022-07-29

2022-12-09

2025-04-11

DESCRIPTION

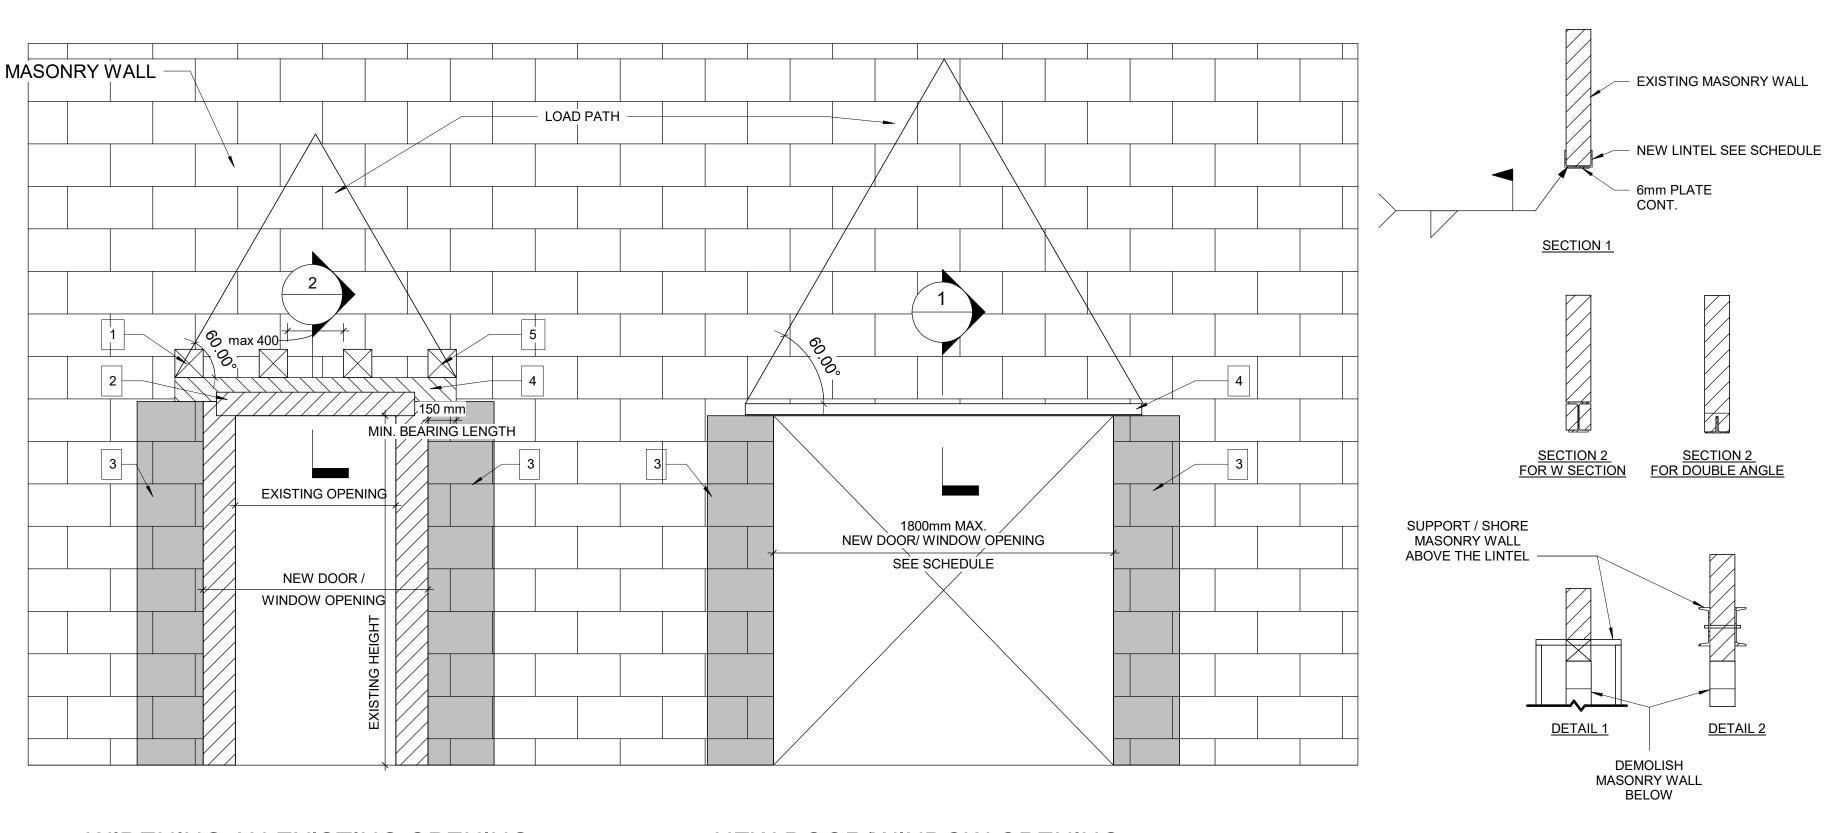

# WIDENING AN EXISTING OPENING IN EXISTING MASONRY WALL TYP.

# NEW DOOR/WINDOW OPENING INTO EXISTING MASONRY WALL TYP.

### PROPOSED SEQUENCE OF WORK

	1	CREATE NEW 150x150mm HOLES @ 400mm INTO EXISTING MASONRY WALL AND SHORE THE WALL ABOVE, SEE DETAIL 1. OR SHORE THE WALL ABOVE BY USING 2 CHANNELS BACK TO BACK AND THROUGH BOLTS @350mm, SEE DETAIL 2
	2	DEMOLISH THE EXISTING LINTEL, THE VOID FOR NEW BEAM AND THE WALL FROM EACH SIDE OF THE NEW OPENING
3	3	FILL TWO CORES MIN. OF EXISTING MASONRY WALL WITH GROUT EACH SIDE OF THE NEW OPENING, (DRILL HOLES TOP AND BOTTOM OF EACH CORE, INJECT GROUT, CLOSE HOLES WITH MORTAR AND MAKE GOOD SURFACE)
	4	INSTALL NEW LINTEL. SEE LINTEL SCHEDULE FOR LINTEL SIZE
	5	ADD MASONRY FACES AT LINTEL AND REPAIR MASONRY COURSE

 $igcap _1$  igcap WIDENING MASONRY WALL OPENING OR NEW OPENING IN EXISTING MASONRY WALL

# LINTEL:

OVER ALL OPENINGS IN MASONRY WALLS PROVIDE THE FOLLOWING LINTELS. UNLESS OTHERWISE SHOWN.

# STEEL LINTELS

CLEAR SPAN mm (ft-in)	140 (6") WALL	190 (8") WALL	240 (10") WALL	290 (12") WALL	350 WALL	430 WALL
UP TO 1200 (4'-0")	L127x127x7.9	2-L89x89x7.9 +170x6mm PL	L89x89x7.9 +L127x89x7.9 LLV +220x6mm PL	3-L89x89x7.9 +270x6mm PL	3-L127X89X7.9 (LLV)	3-L127X127X7.9 +410X6mm PL
1201 TO 1800 (4'0 - 6'-)	2-L89x64x6.4LLV	2-L127x89x7.9LLV	L127x89x7.9LLV +L127x127x7.9	3-L127x89x7.9LLV		
1801 TO 3100 ( 6'- 10')	2-L89x64x9.5LLV	2-L152x89x9.5LLV	2-L152x89x9.5LLV	3-L152x89x9.5LLV		

- TO INSTALL A LINTEL TO THE EXISTING BLOCK WALL FOR A NEW OPENING, CUT A GROOVE THROUGH THE EXISTING BLOCK WALL AT THE TOP OF THE NEW OPENING AND INSTALL THE ANGLE FROM ONE SIDE OF THE WALL FOR SINGLE SNGLE OR FROM BOTH SIDES OF THE WALL FOR DOUBLE ANGLE AND THEN CUT THE OPENING.
- MINIMUM BEARING FOR STEEL LINTELS SHALL BE 150mm
- ALL STEEL LINTELS AND SHELF ANGLES IN THE EXTERIOR MASONRY SHALL BE HOT DIP GALVANIZED
- THESE LINTELS ARE FOR NON-LOAD BEARING WALLS. VERIFY THE WALLS DO NOT SUPPORT FLOOR OR ROOF FRAMING. DO NOT IN LOAD BEARING WALLS UNLESS REVIEWED BY THE CONSULT.
- VERIFY THE FOLLOWING:
- I) NO CONTROL OR MOVEMENT JOINTS ABOVE THE LINTEL AND/OR BEYOND THE
- II) WALL EXTENDS MINIMUM 50% OF SPAN (AND 50% OF OPENING HEIGHT) BEYOND THE OPENING.
- III) WALL EXTENDS MINIMUM 70% OF SPAN ABOVE THE OPENING.
- STRENGTHEN BEARING POINTS TO FOUNDATION, OR 400 DEEP WHEN SPAN BELOW 3600, GROUT CMU OR STONE MASONRY. BRICK IN AND GROUT VOIDS IN MULTI-WY THE BRICK, REPORT MORTAR JOINTS.
- DRYPACK WITH NON-SHRINK GROUT WHERE NECESSARY TO ACHIEVE UNIFORM BEARING THROUGHOUT. ENSURE EVEN BEARING BELOW LINTEL ENDS.
- SEE GENERAL NOTES FOR OTHER REQUIREMENTS (i.e. GROUT BEARING POINTS).
- HOT-DIP GALVANIZE LINTELS IN EXTERIOR WALLS EXPOSED TO WEATHER.
- SEE ARCH FOR STEEL FIRE PROTECTION.
- DOUBLE BEARING LENGTH FOR SOFT OR MEDIUM BRICK IN LIME MORTAR, AND FOR RUBBLE STONE IN LIME MORTAR OR LIME AND CEMENT MORTAR.

							WITH GROUT (TYP)
CLEAR SPAN mm (ft-in)	140 (6") WALL	190 (8") WALL	240 (10") WALL	290 (12") WALL	350 WALL	430 WALL	
UP TO 1200 (4'-0")	L127x127x7.9	2-L89x89x7.9 +170x6mm PL	L89x89x7.9 +L127x89x7.9 LLV +220x6mm PL	3-L89x89x7.9 +270x6mm PL	3-L127X89X7.9 (LLV)	3-L127X127X7.9 +410X6mm PL	42xBAR D OR 180 M
1201 TO 1800 (4'0 - 6'-)	2-L89x64x6.4LLV	2-L127x89x7.9LLV	L127x89x7.9LLV +L127x127x7.9	3-L127x89x7.9LLV			FOR BON BEAM AB
1801 TO 3100 ( 6'- 10')	2-L89x64x9.5LLV	2-L152x89x9.5LLV	2-L152x89x9.5LLV	3-L152x89x9.5LLV			AND BELO MASONR OPENING

1. PROVIDE FULL TENSION LAP IN VERTICAL REINF AS REQUIRED.

TYPICAL NEW MASONRY WALL DETAILS D2300 / Scale: 1:20

FACE OF EXIST. WALL

1-15M FOR 2-FULL

BRICK VENEER WITH HOLES

D2300 / Scale: 1 : 10

SEE TYPICAL INTERIOR

SEE DETAIL 4/D2300

OR SLAB

**BOND BEAM** 

REINF AT -

(TYP)

SHADED

AREA INDICATES CELLS

TO BE FILLED SOLID

CORNERS AND END OF WALLS

> 42xBAR DIA OR 180 MIN

FOR BOND BEAM ABOVE

AND BELOW

MASONRY

OPENING

MASONRY WALL OPENING

**GROUTED CORES** 

FOR HOLLOW CONC. BLOCK AND 86 EMBED FOR

2 TYPICAL CMU WALL CONNECTION TO EXISTING WALL

6 GALV. BENT PL. CONT. C/W 13ØX89 EMBED HILTI KWIK OR EQUIVALENT

USE 13Ø HILTI HIT HY-20 ADHESIVE ANCHOR C/W 51 EMBED OR EQUIVALENT


- LATERAL SUPPORTS

ANCHORED TO SLAB

BOLT II @ 600 O/C INTO CORE FILLED CONC. BLOCK/CONC. SURFACE.

MASONRY WALL

REFER TO PLAN & SCHEDULE

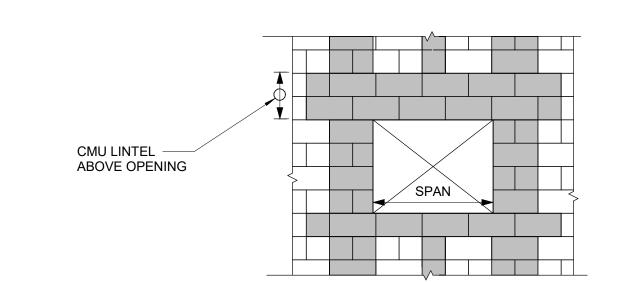

4 OPENING IN NEW MASONRY WALL D2300 / Scale: 1:20

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TYPICAL VERTICAL

ON DRAWINGS)

REINF. (SEE SCHEDULE

BOND BEAM

DOWELS IN SLAB TO

MATCH VERTICAL REINFORCING

SEE SCHED. FOR

HORIZONTAL REINF

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N. FRISCIC SHEET TITLE

MASONRY DETAILS


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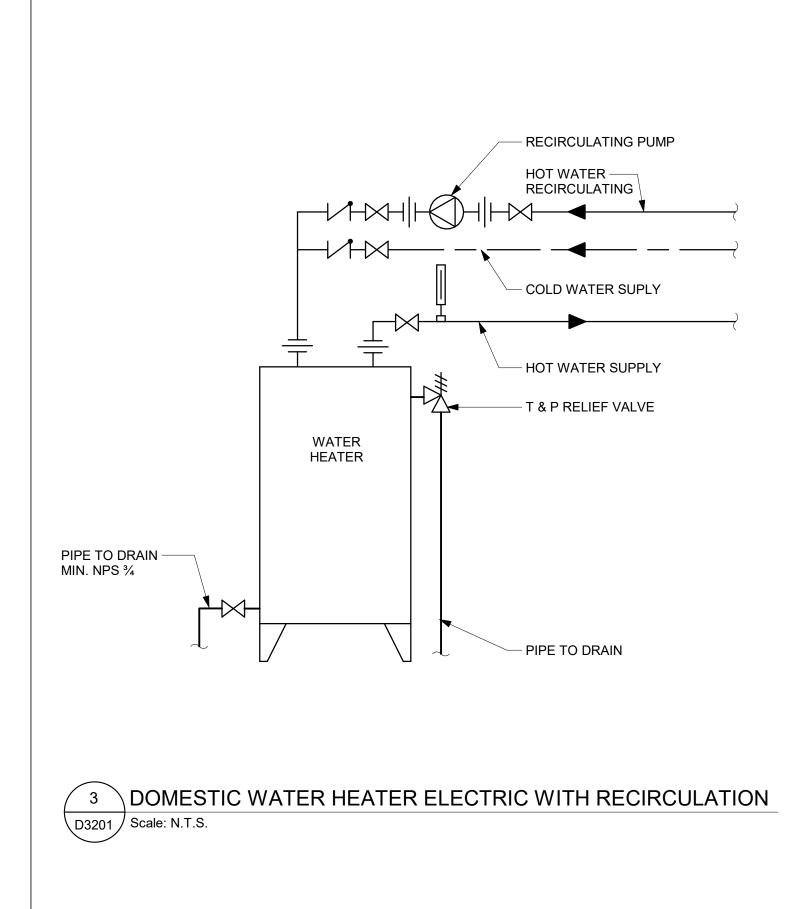
D2300 / Scale: 1 : 20


### PLUMBING FIXTURE SCHEDULE SERVICES DESCRIPTION REMARKS HW WASTE VENT WATER CLOSET (FLUSH VALVE) 40 WATER CLOSET (FLUSH TANK) 40 URINAL (FLUSH VALVE) 20 40 12 URINAL (FLUSH TANK) 12 32 LAVATORY 12 SHOWER 32 12 SERVICE SINK DRINKING FOUNTAIN 12 32 SINKS 12 32 GROUP WASH FOUNTAIN 25 40


- 1. SIZING OF SUPPLIES INSIDE WASHROOM TO BE BASED ON 35 KPa PRESSURE DROP PER 30m OF PIPE OR MAXIMUM VELOCITY OF 1.2 mps.
- 2. CONTRACTOR SHALL PROVIDE SHOP DRAWING OF PLUMBING AND DRAINAGE INSIDE WASHROOM AREA FOR ALL WASHROOMS.






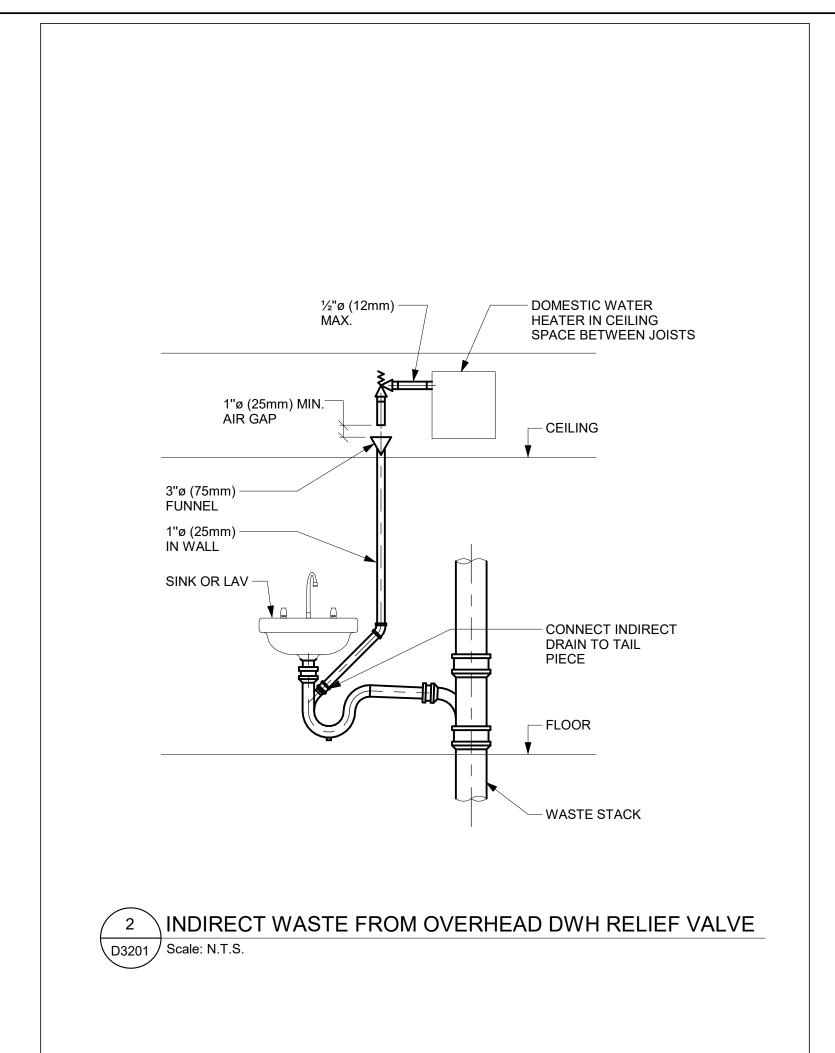

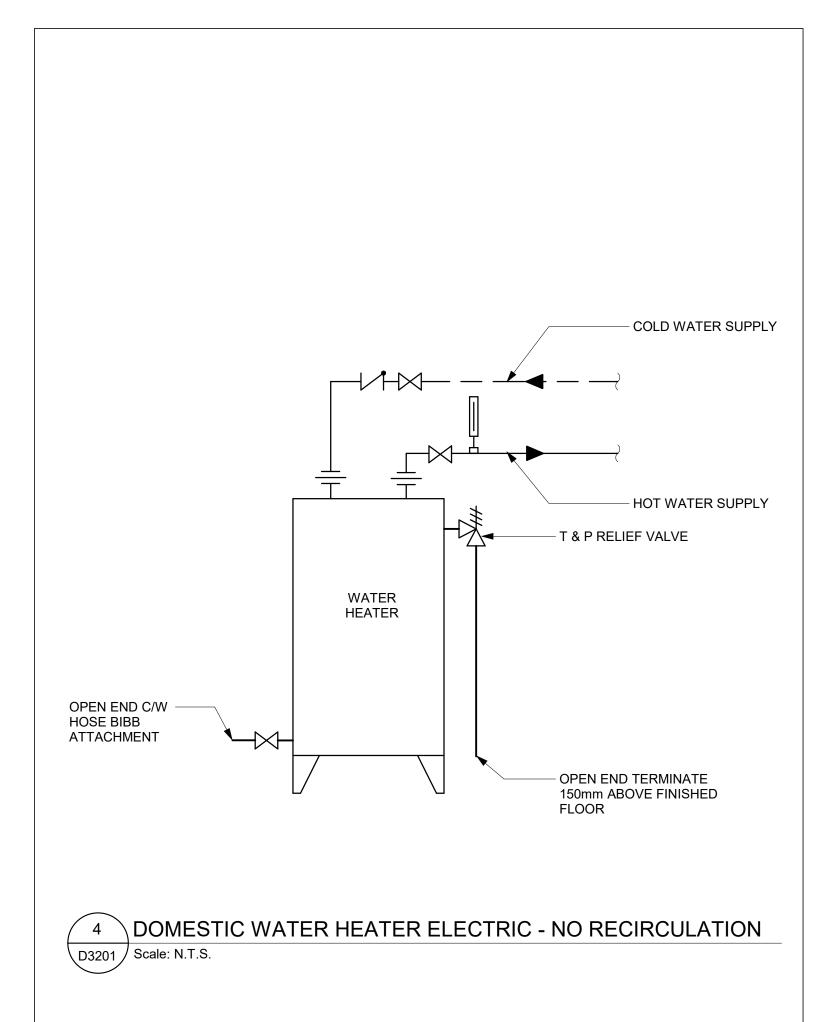

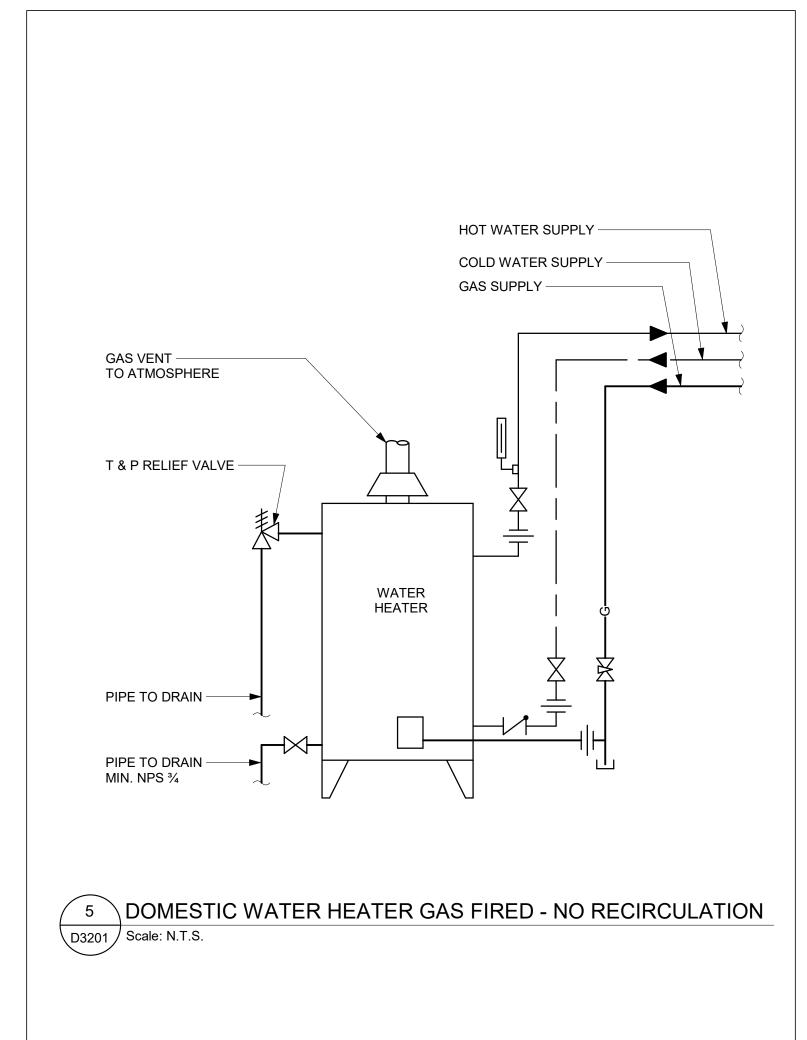

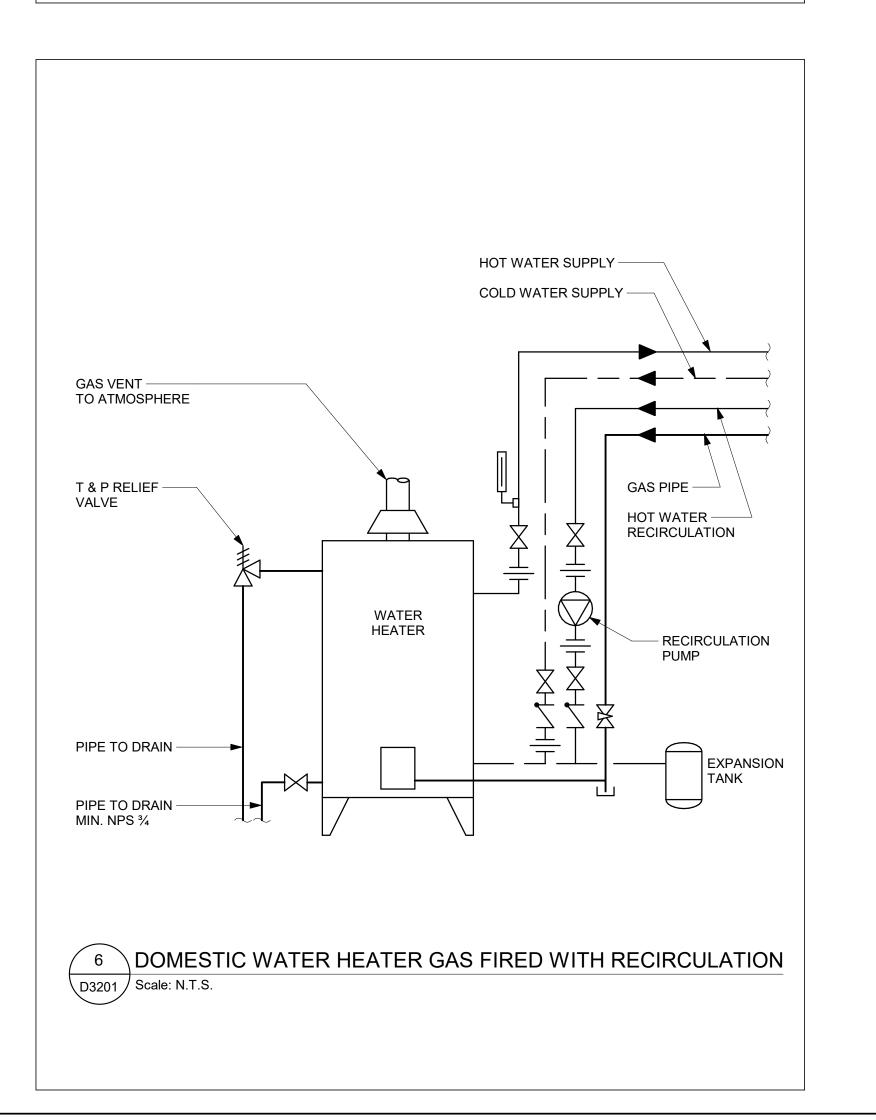

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Metro Hall Toronto, ON

M5V 3C6

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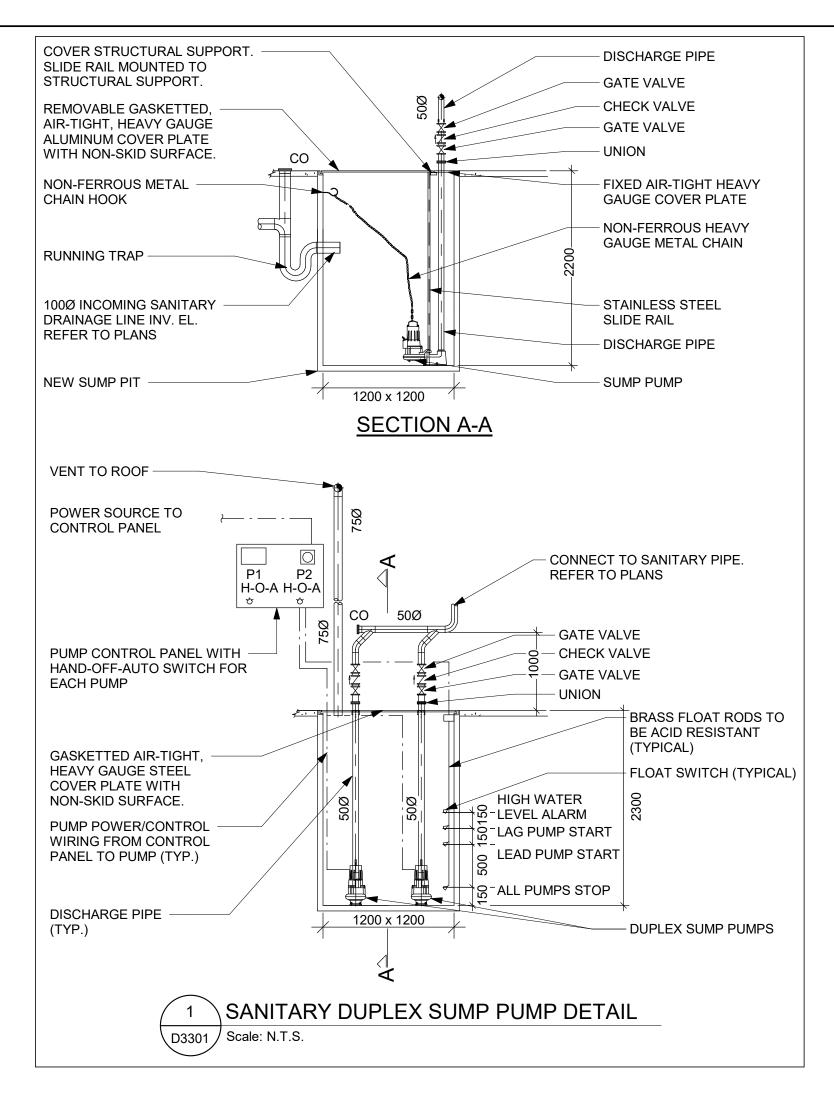
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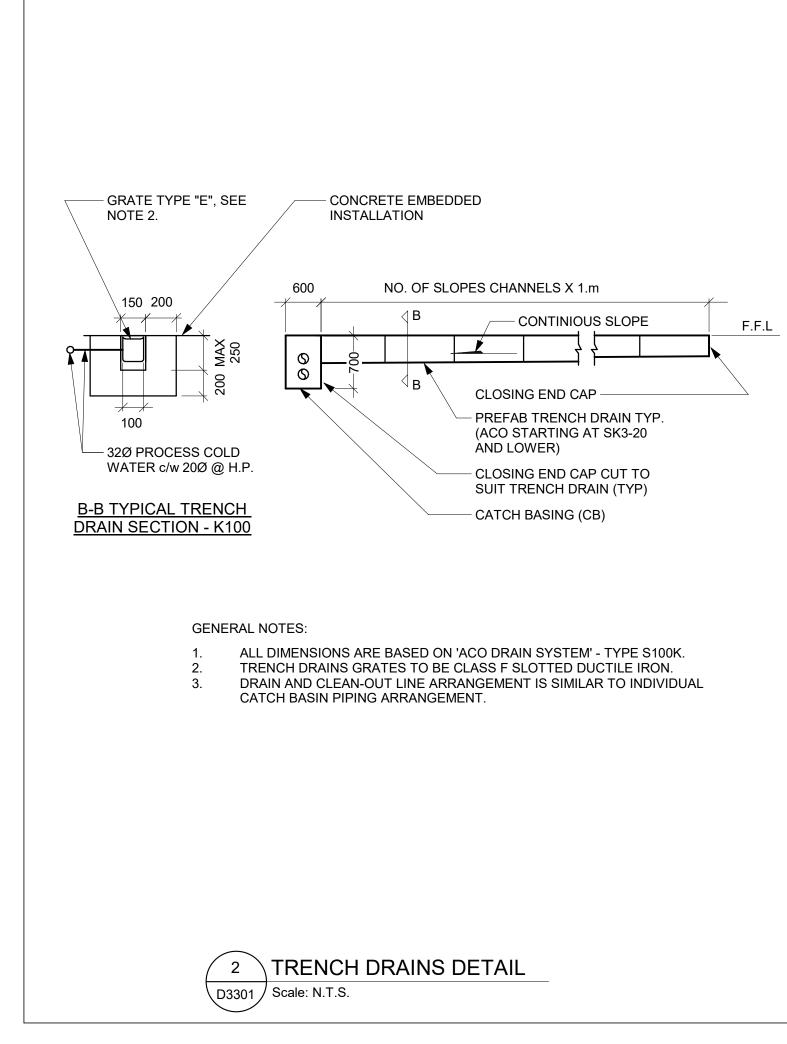
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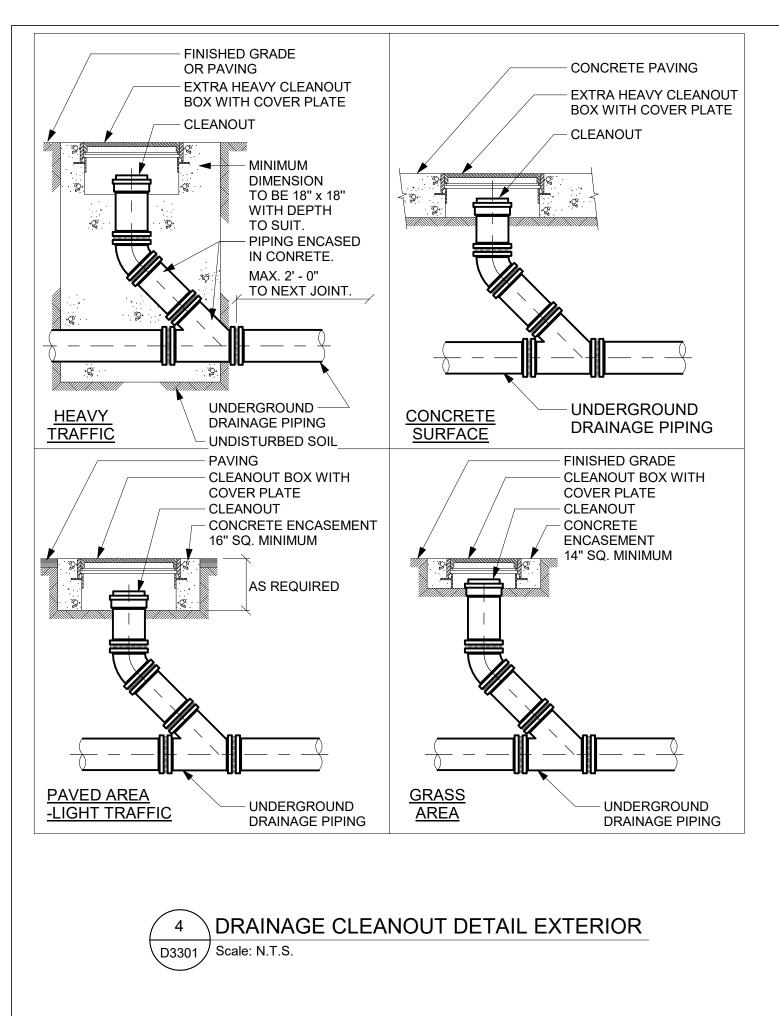
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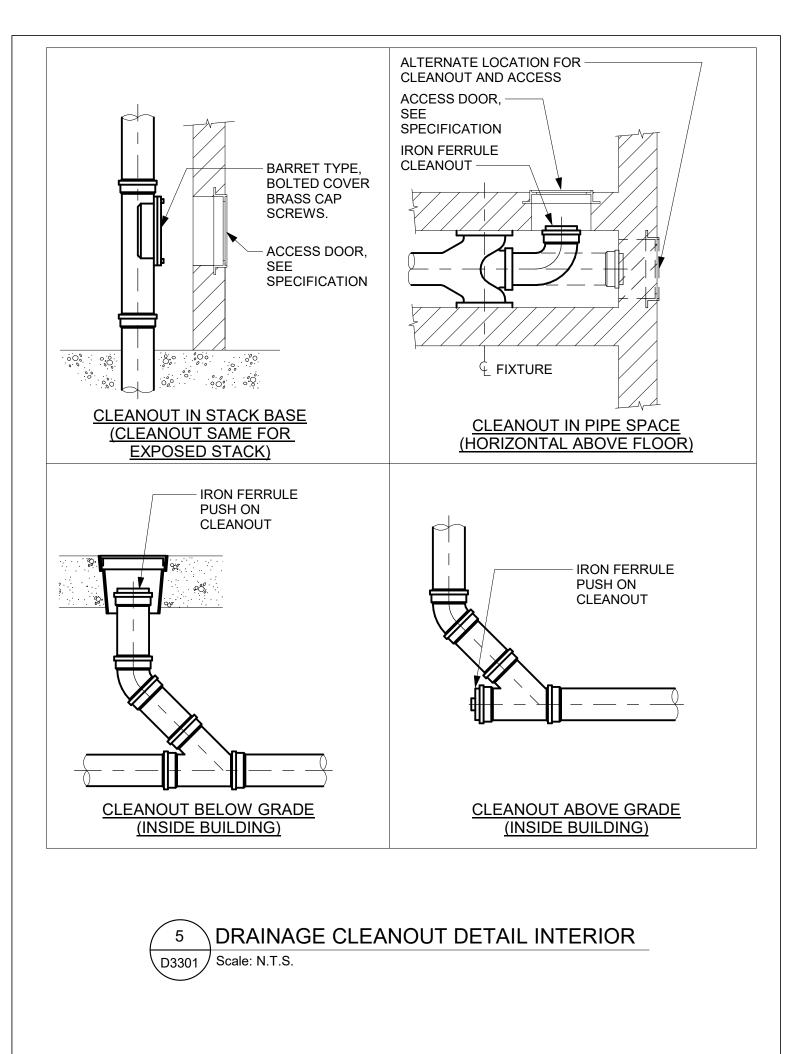
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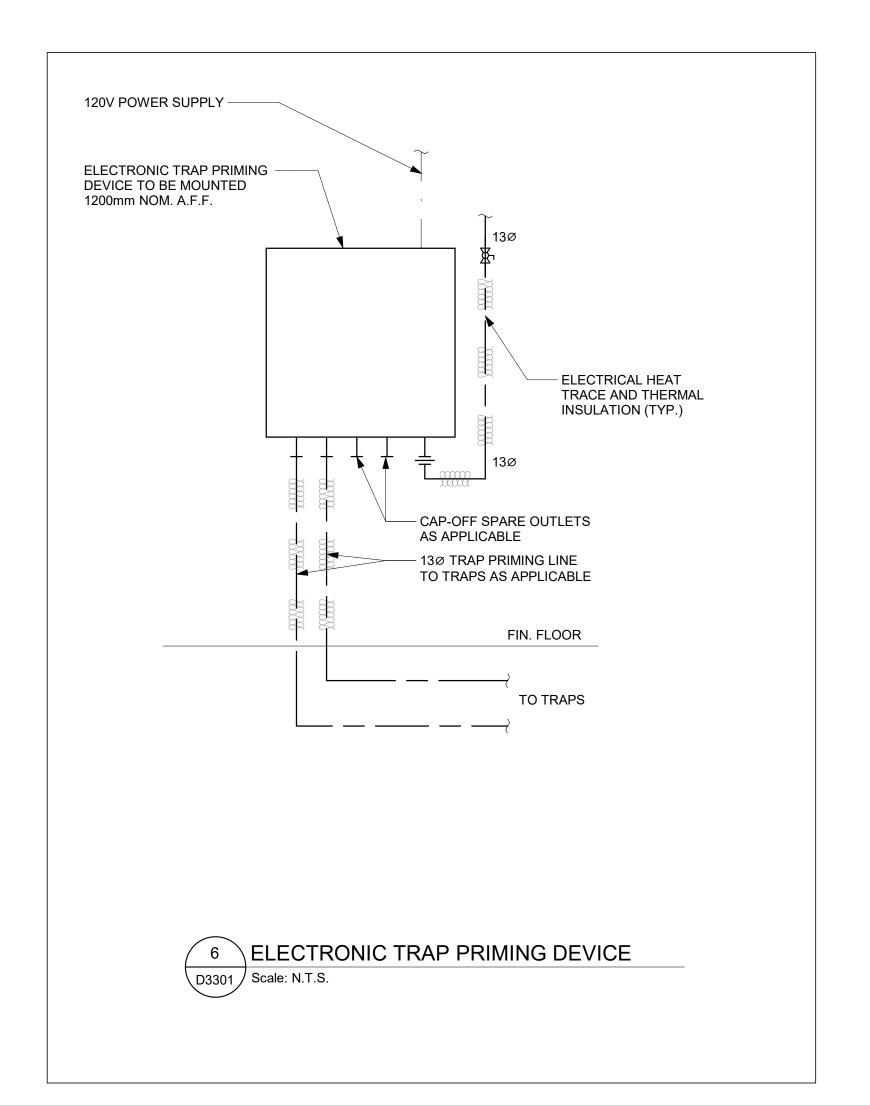
G05-GAL-D3201 F












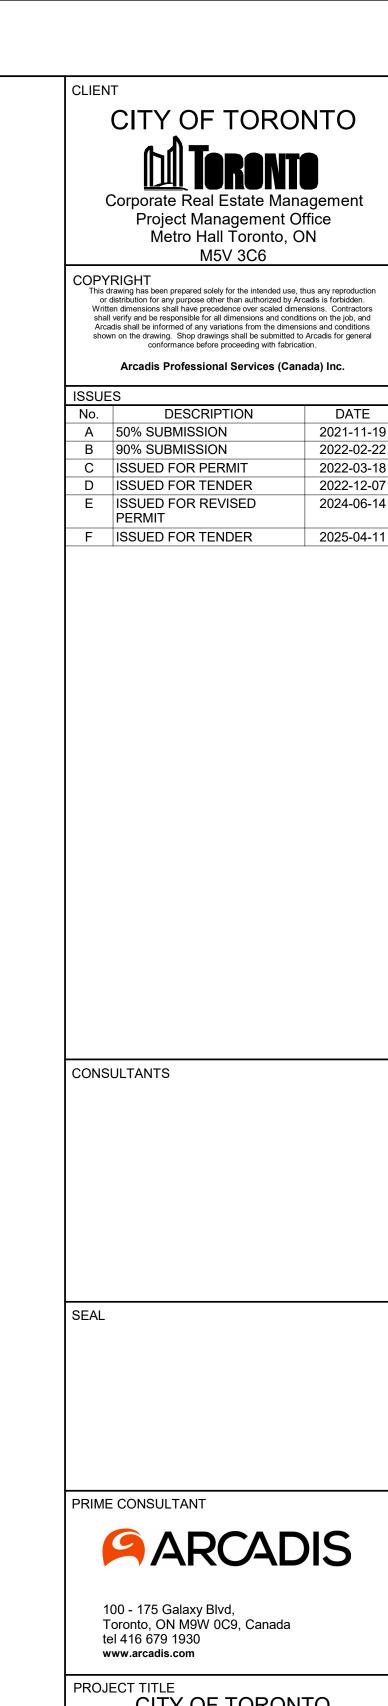


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SHEET TITLE DRAINAGE DETAILS

SHEET NUMBER G05-GAL-D3301 F



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K. DURUKAN


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F. BOLOURIAN

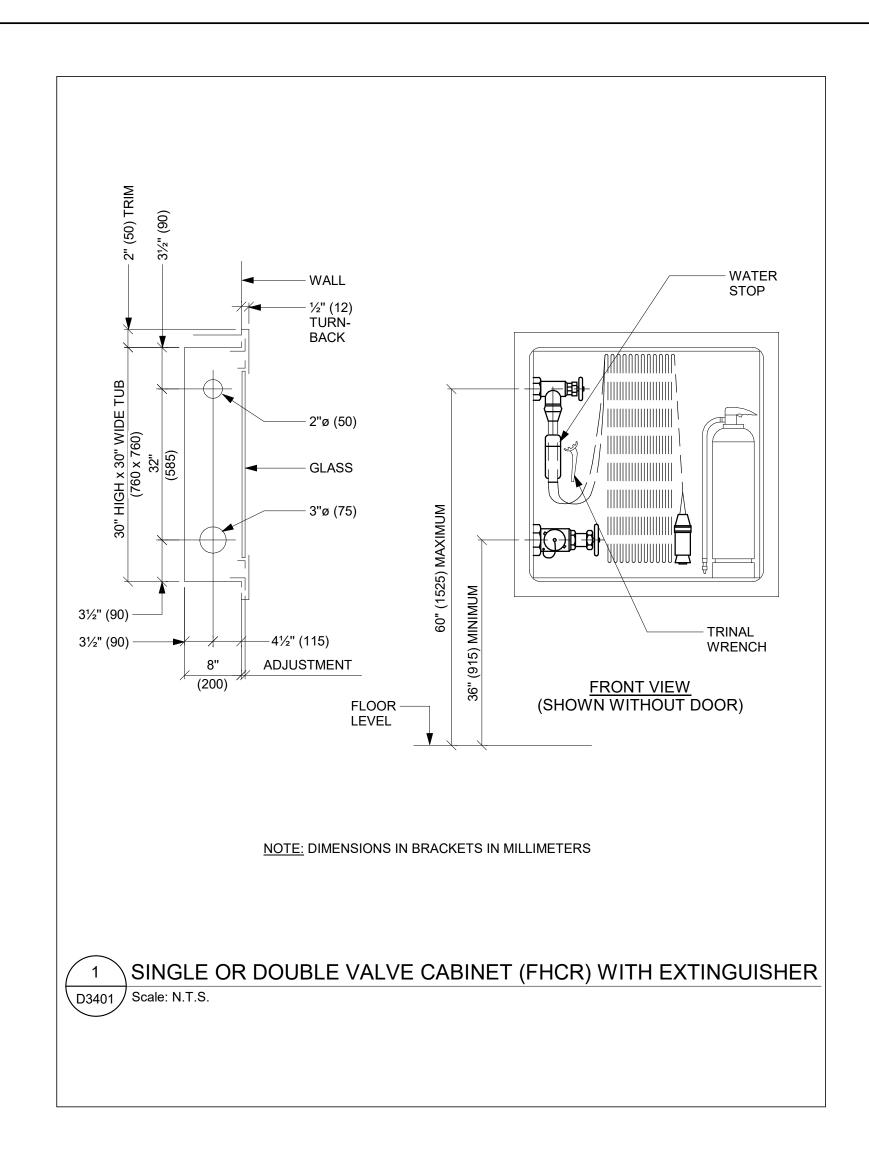
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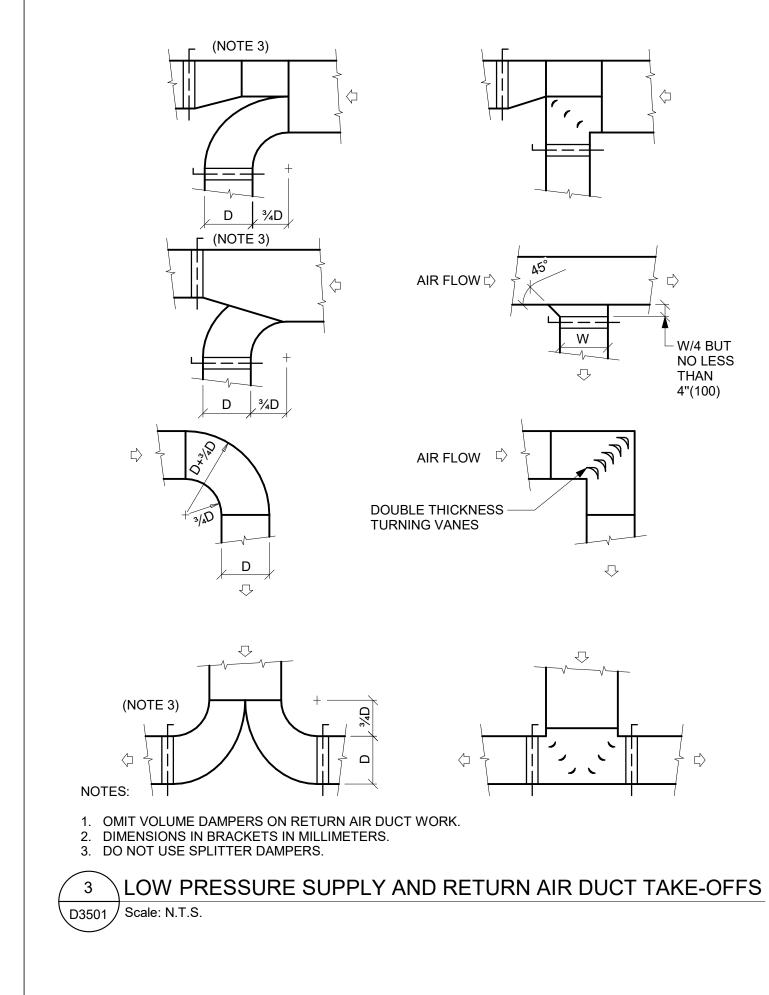
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DETAILS


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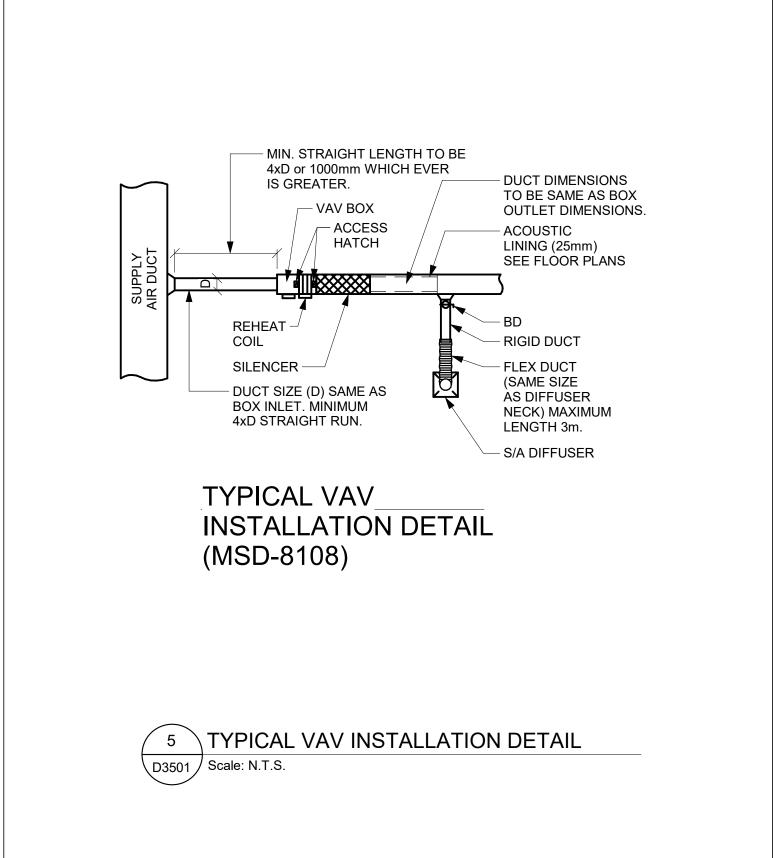
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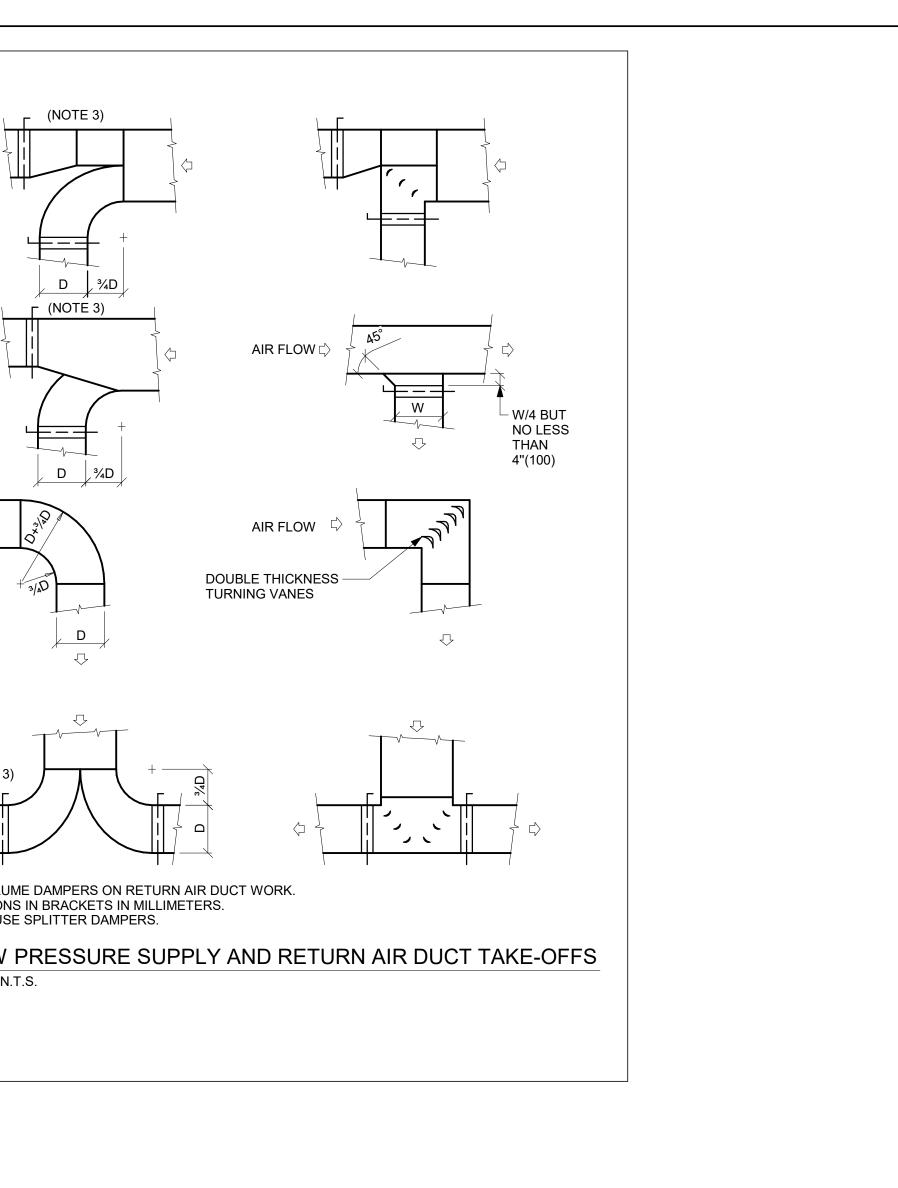







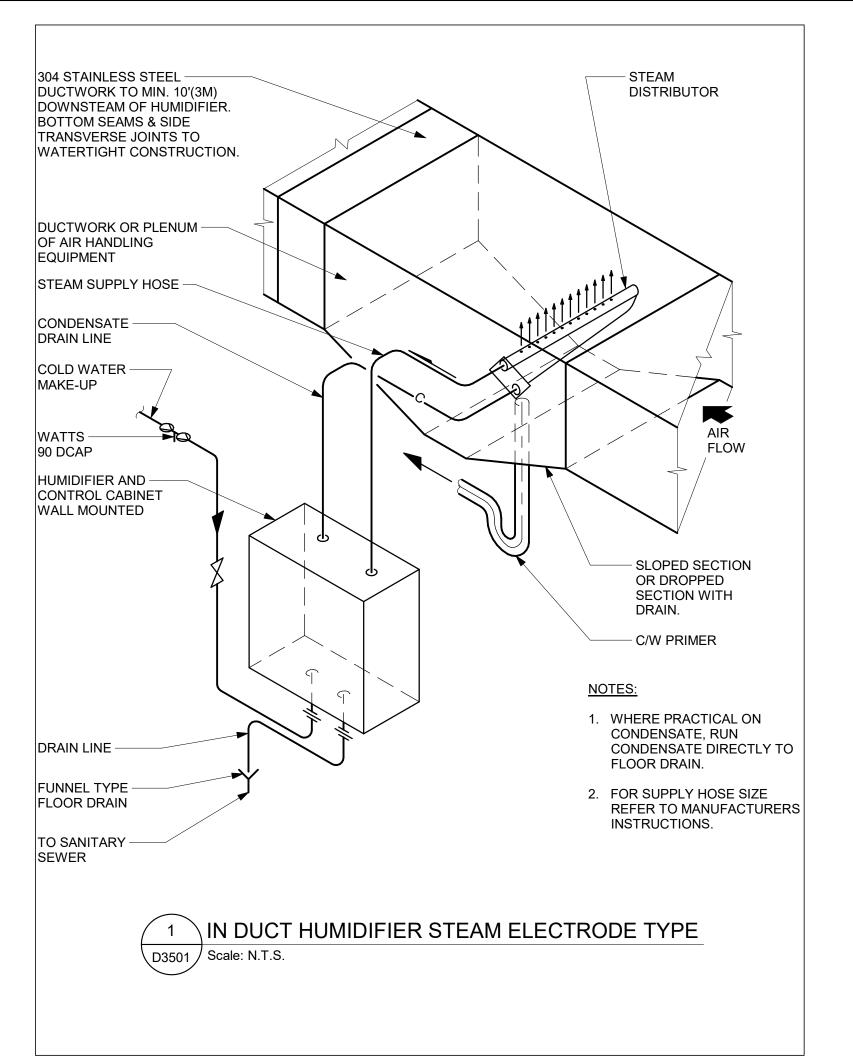

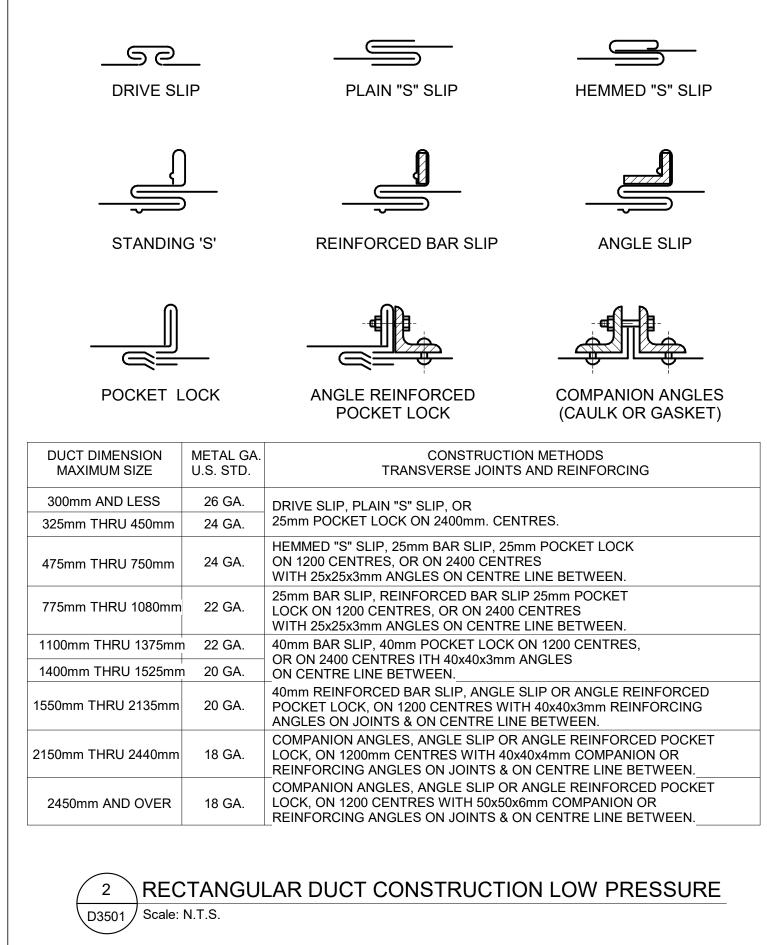

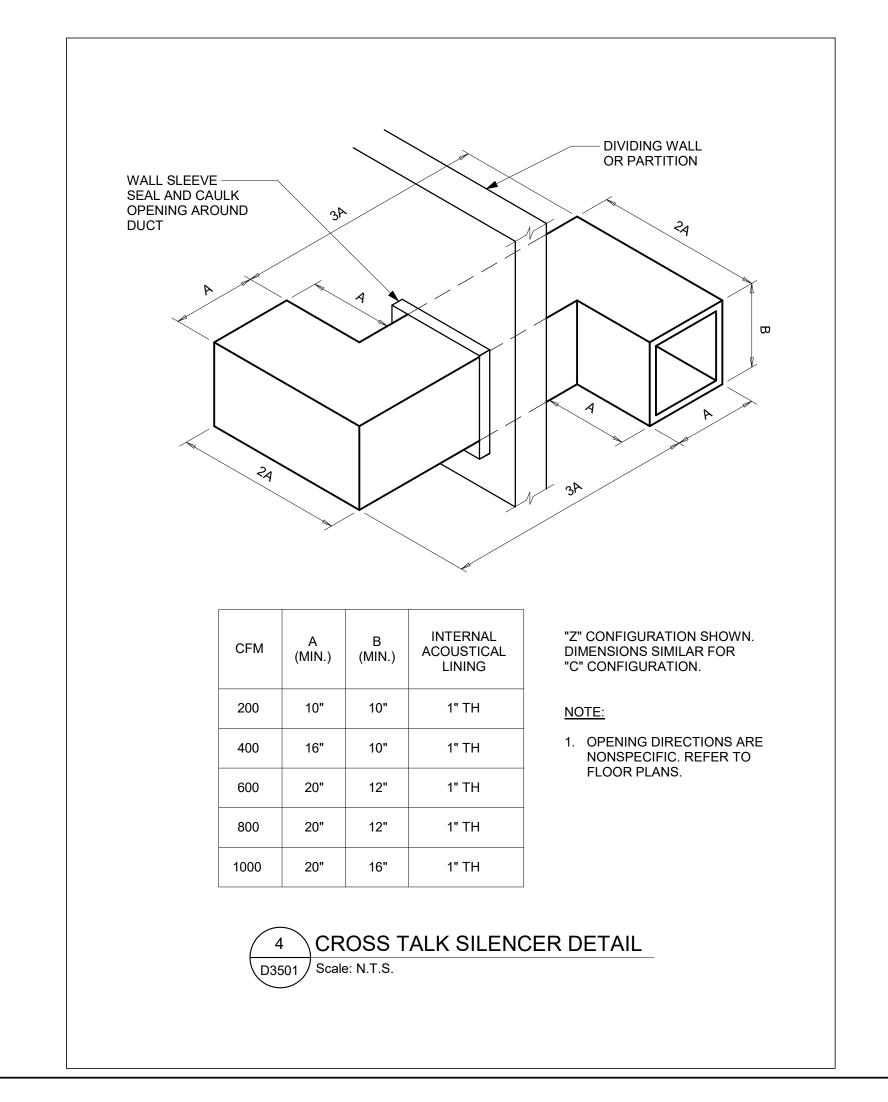

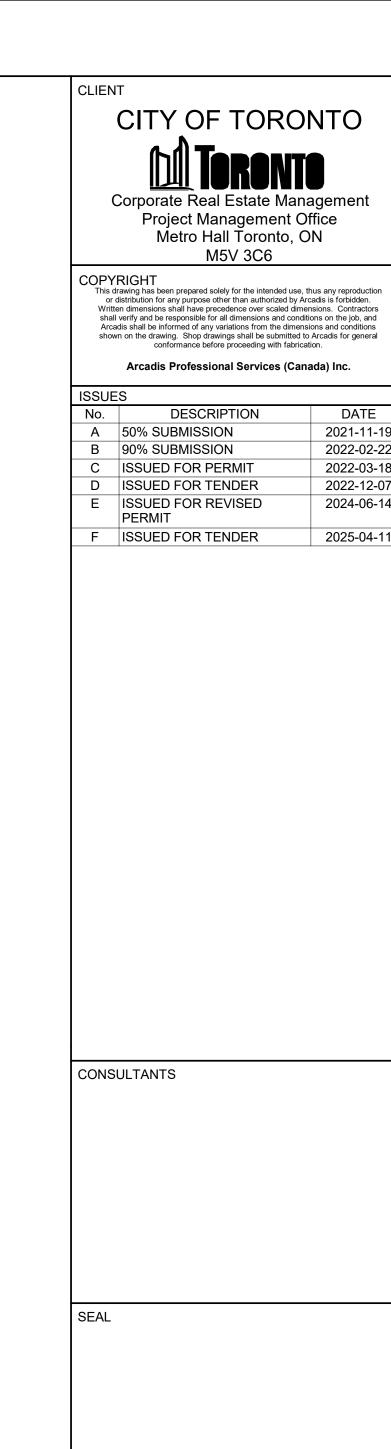

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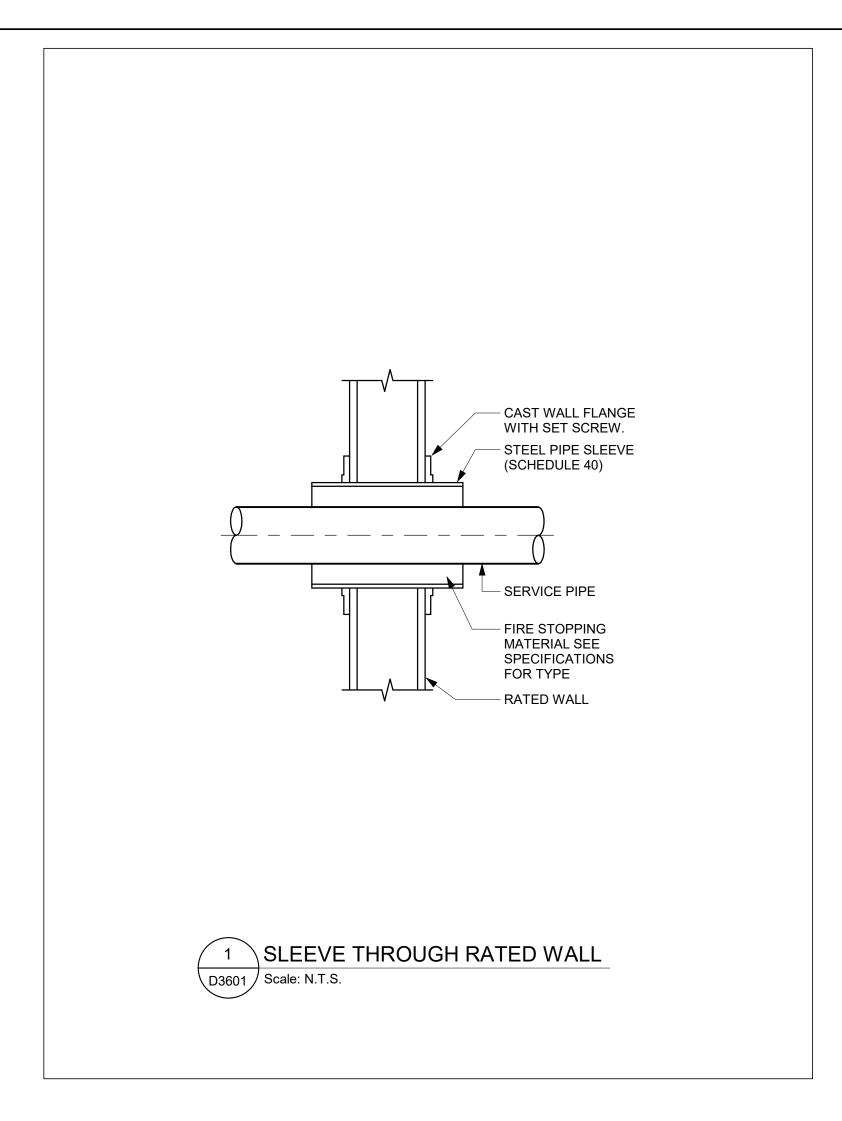
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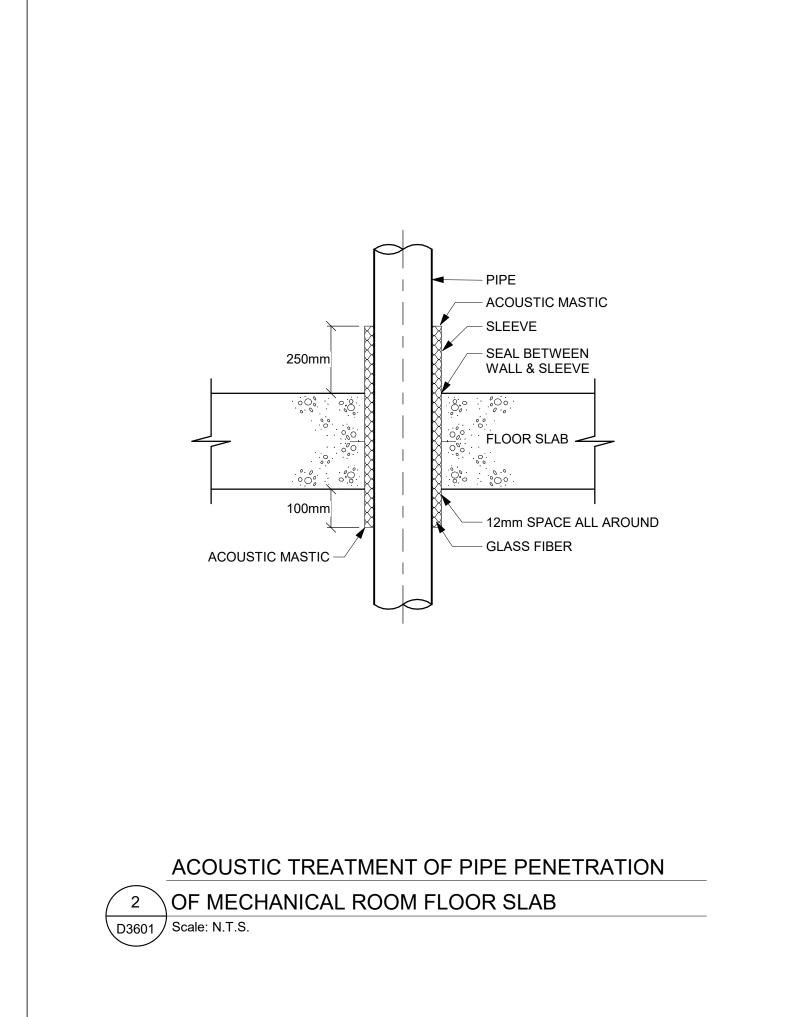
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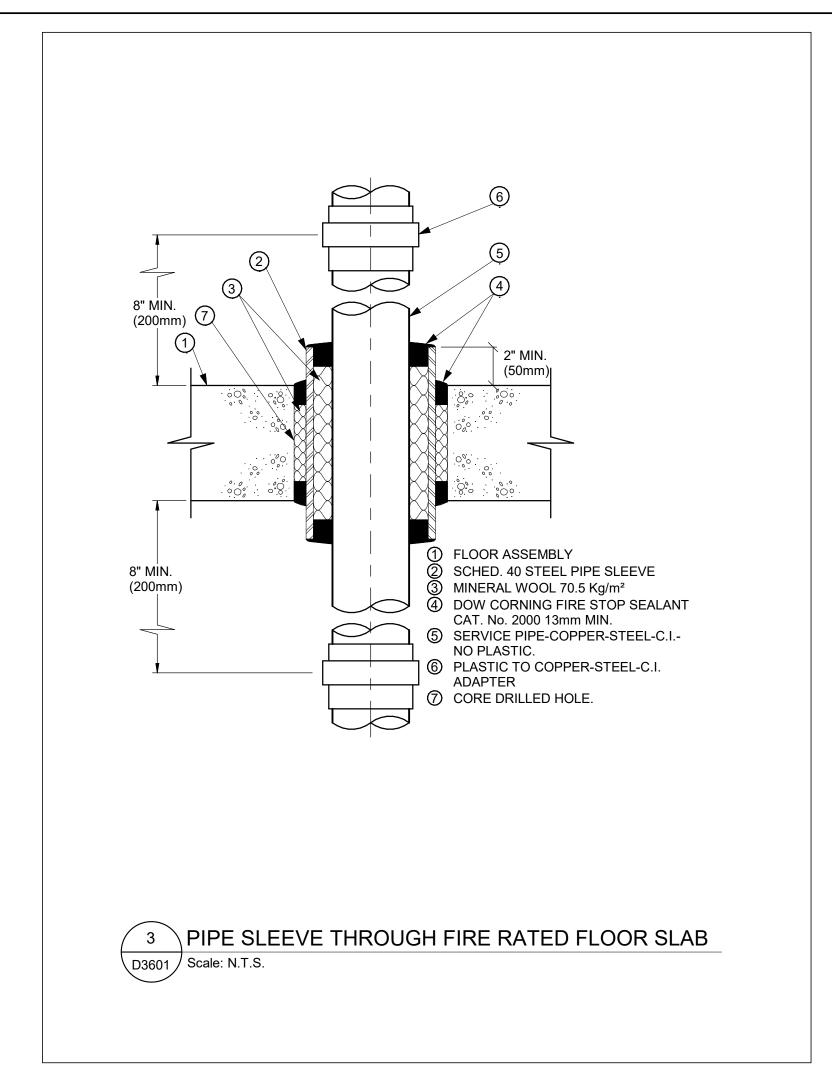
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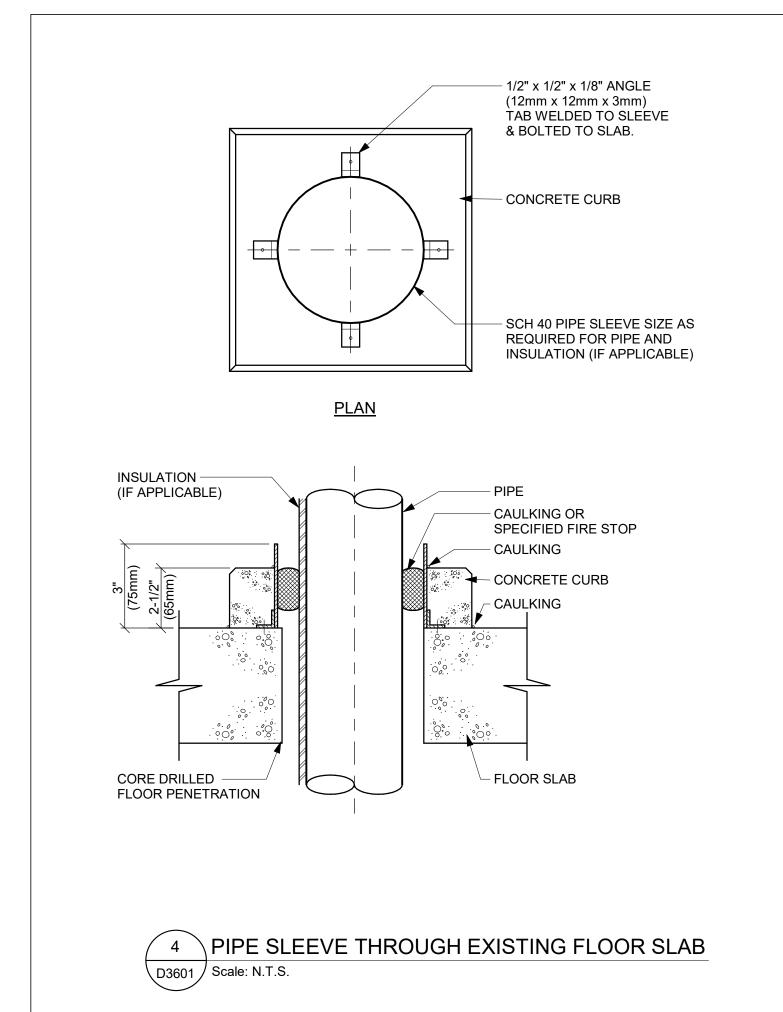
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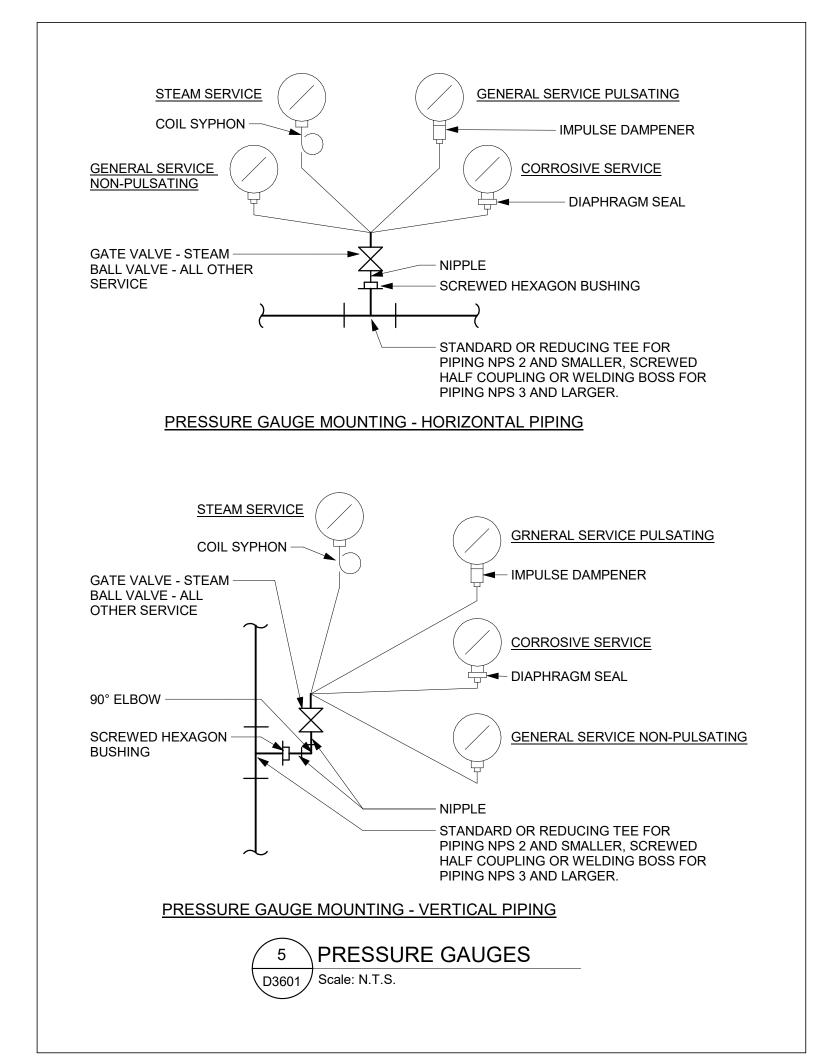
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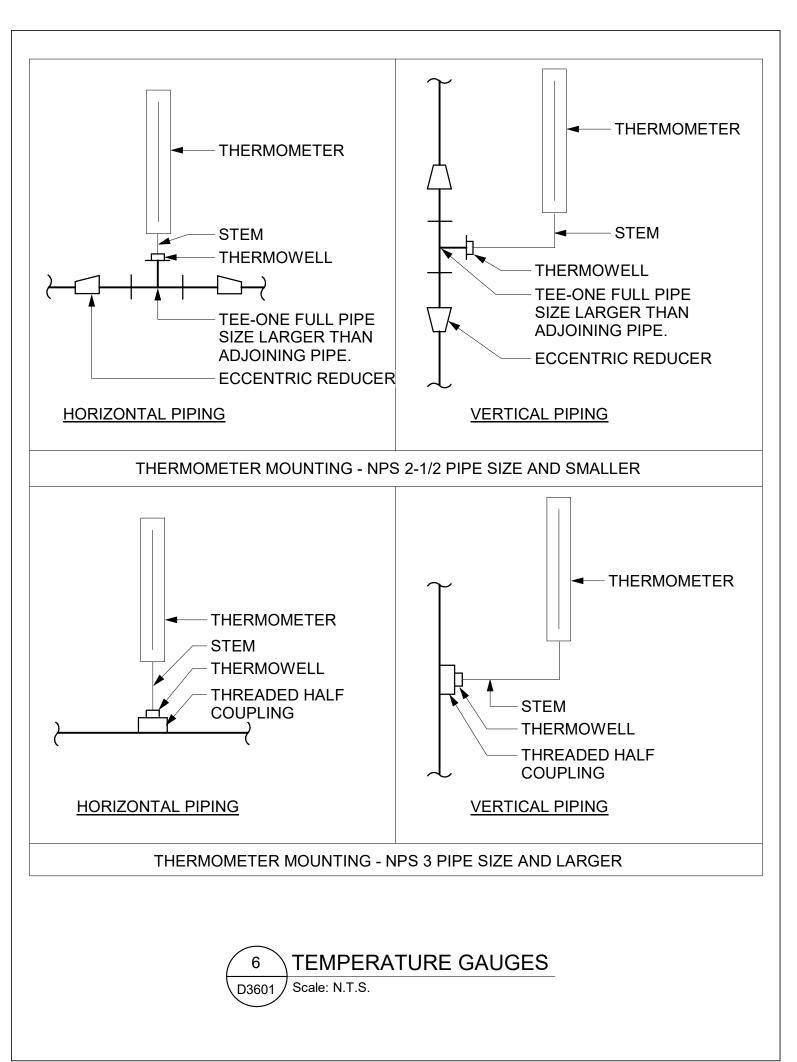













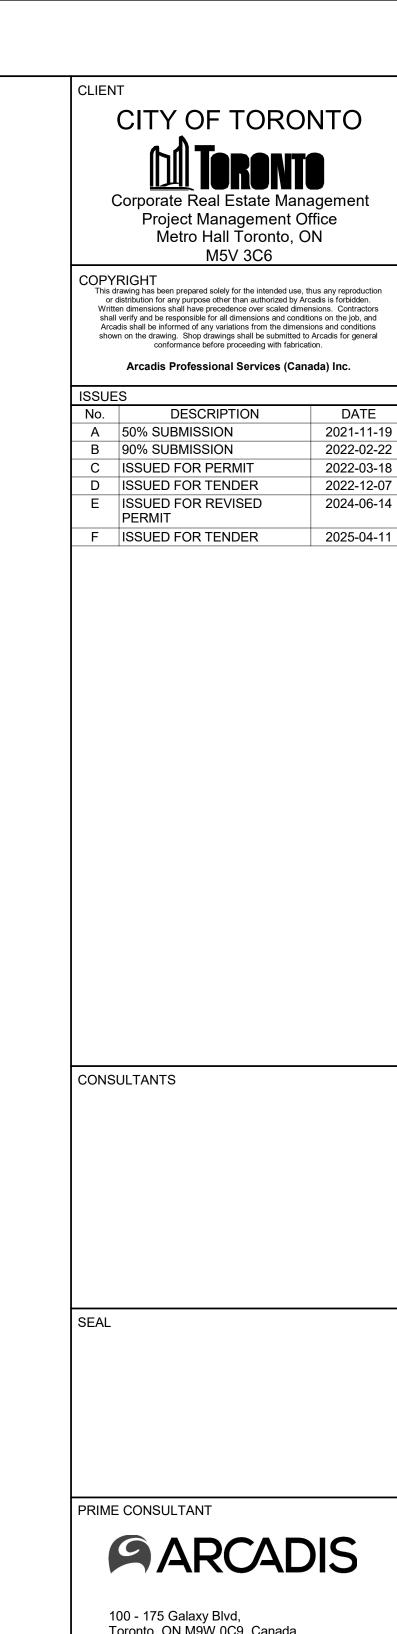





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SHEET 1 OF 2

SHEET NUMBER G05-GAL-D3601 F



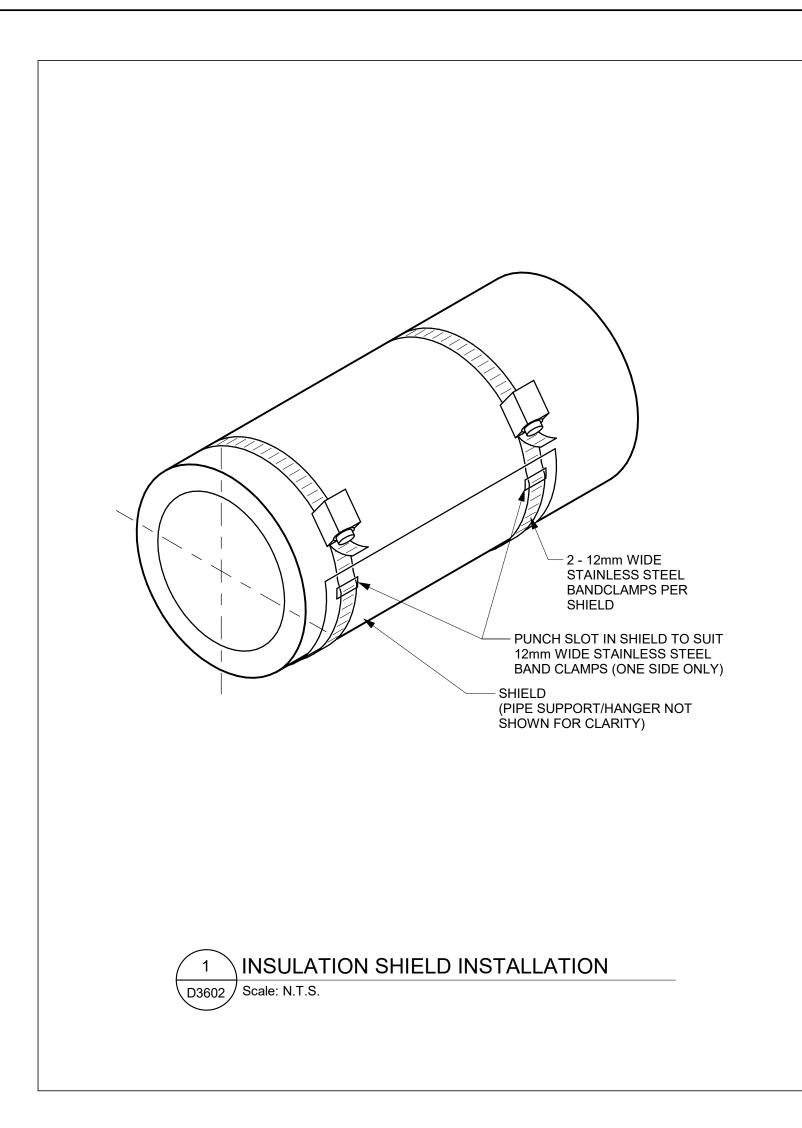
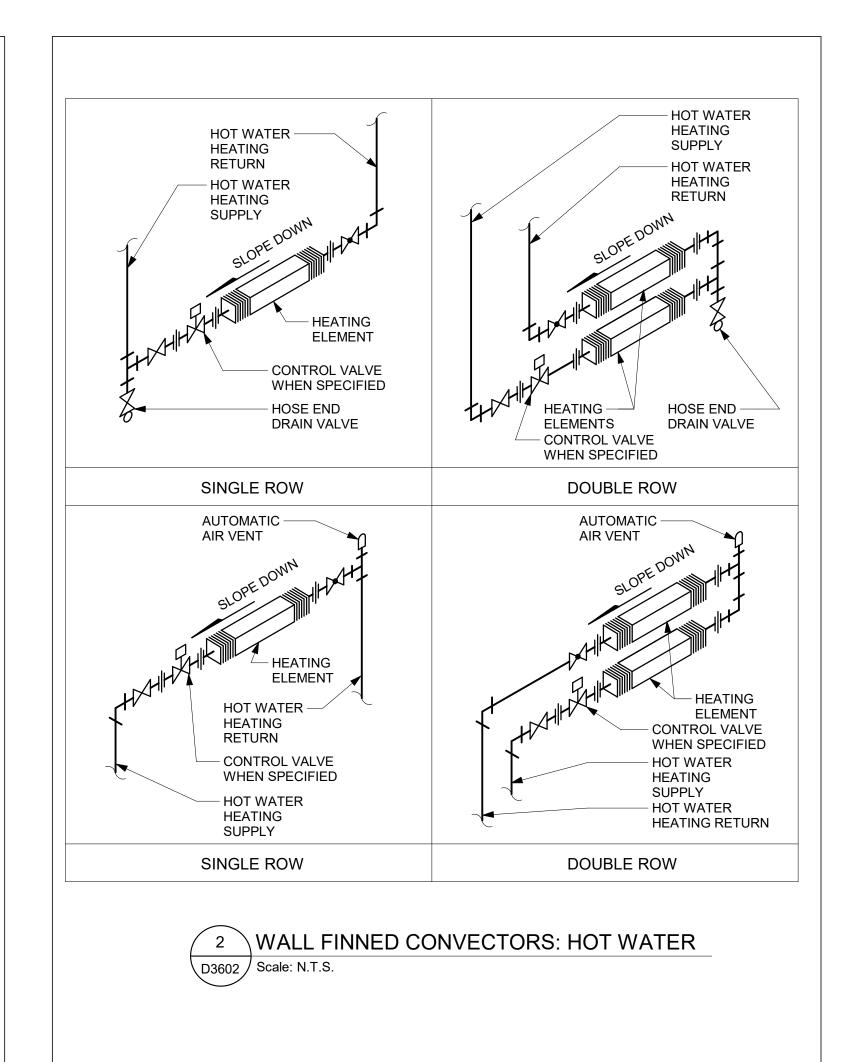
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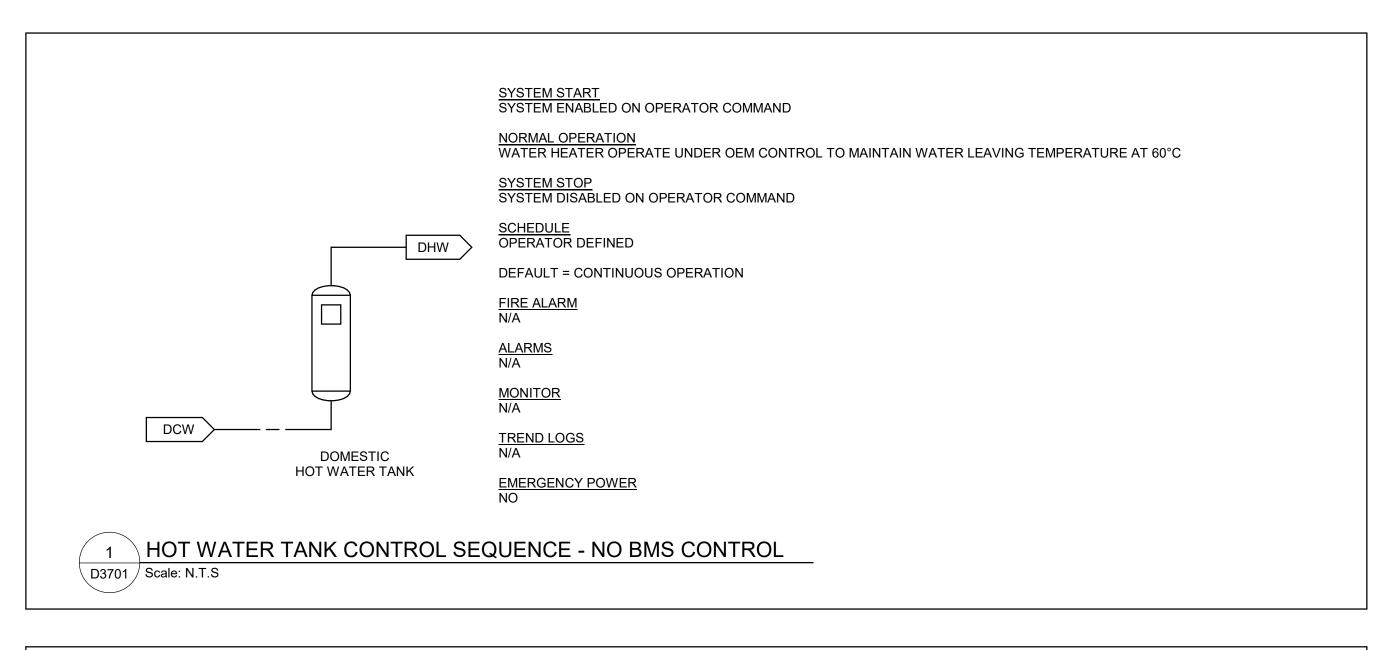
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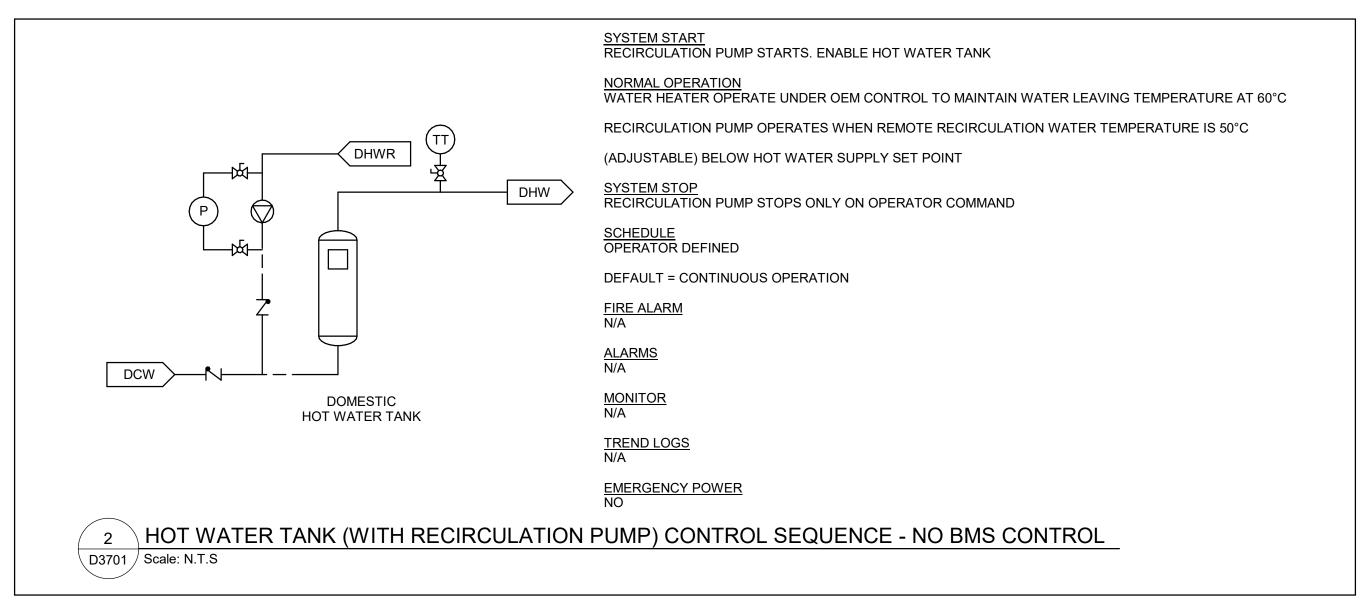
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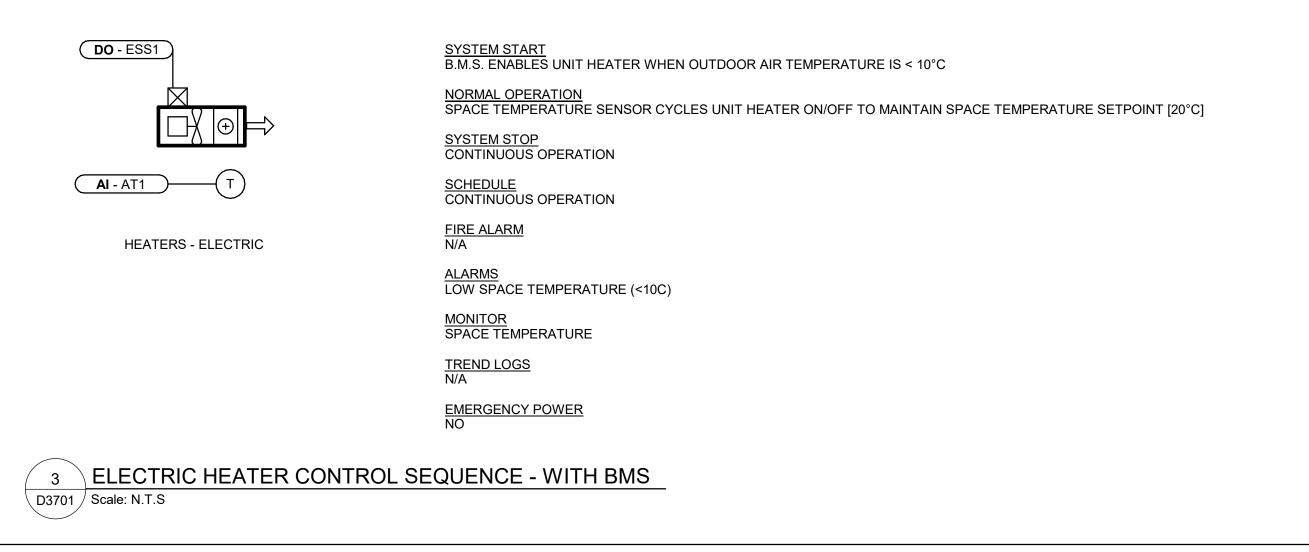
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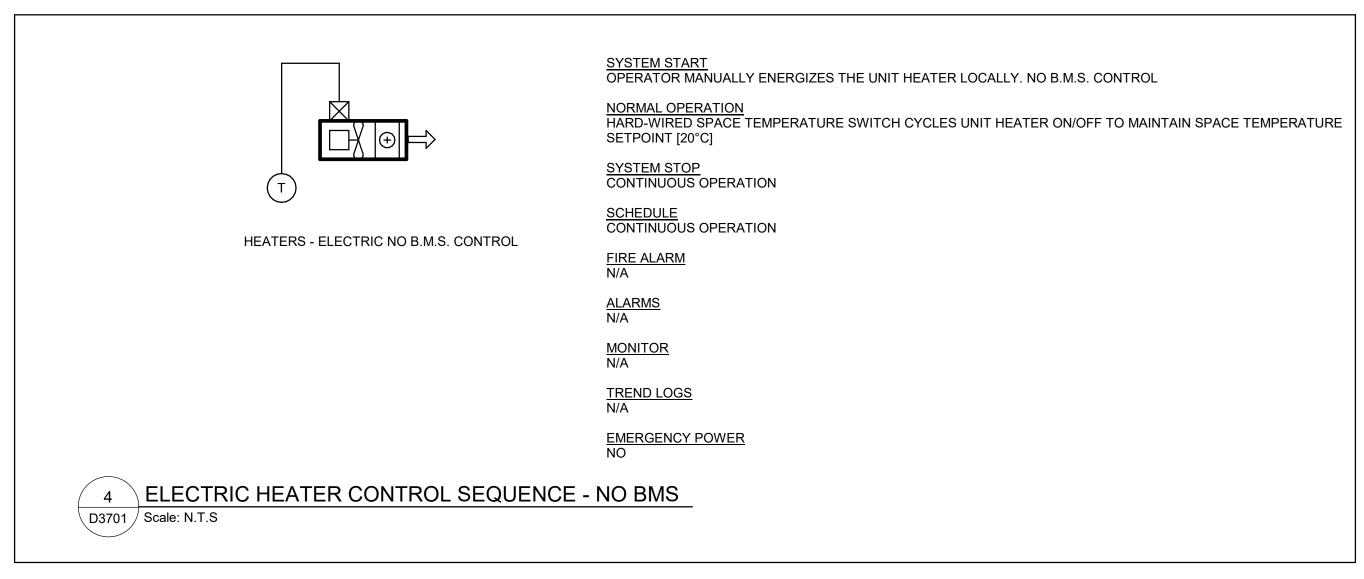
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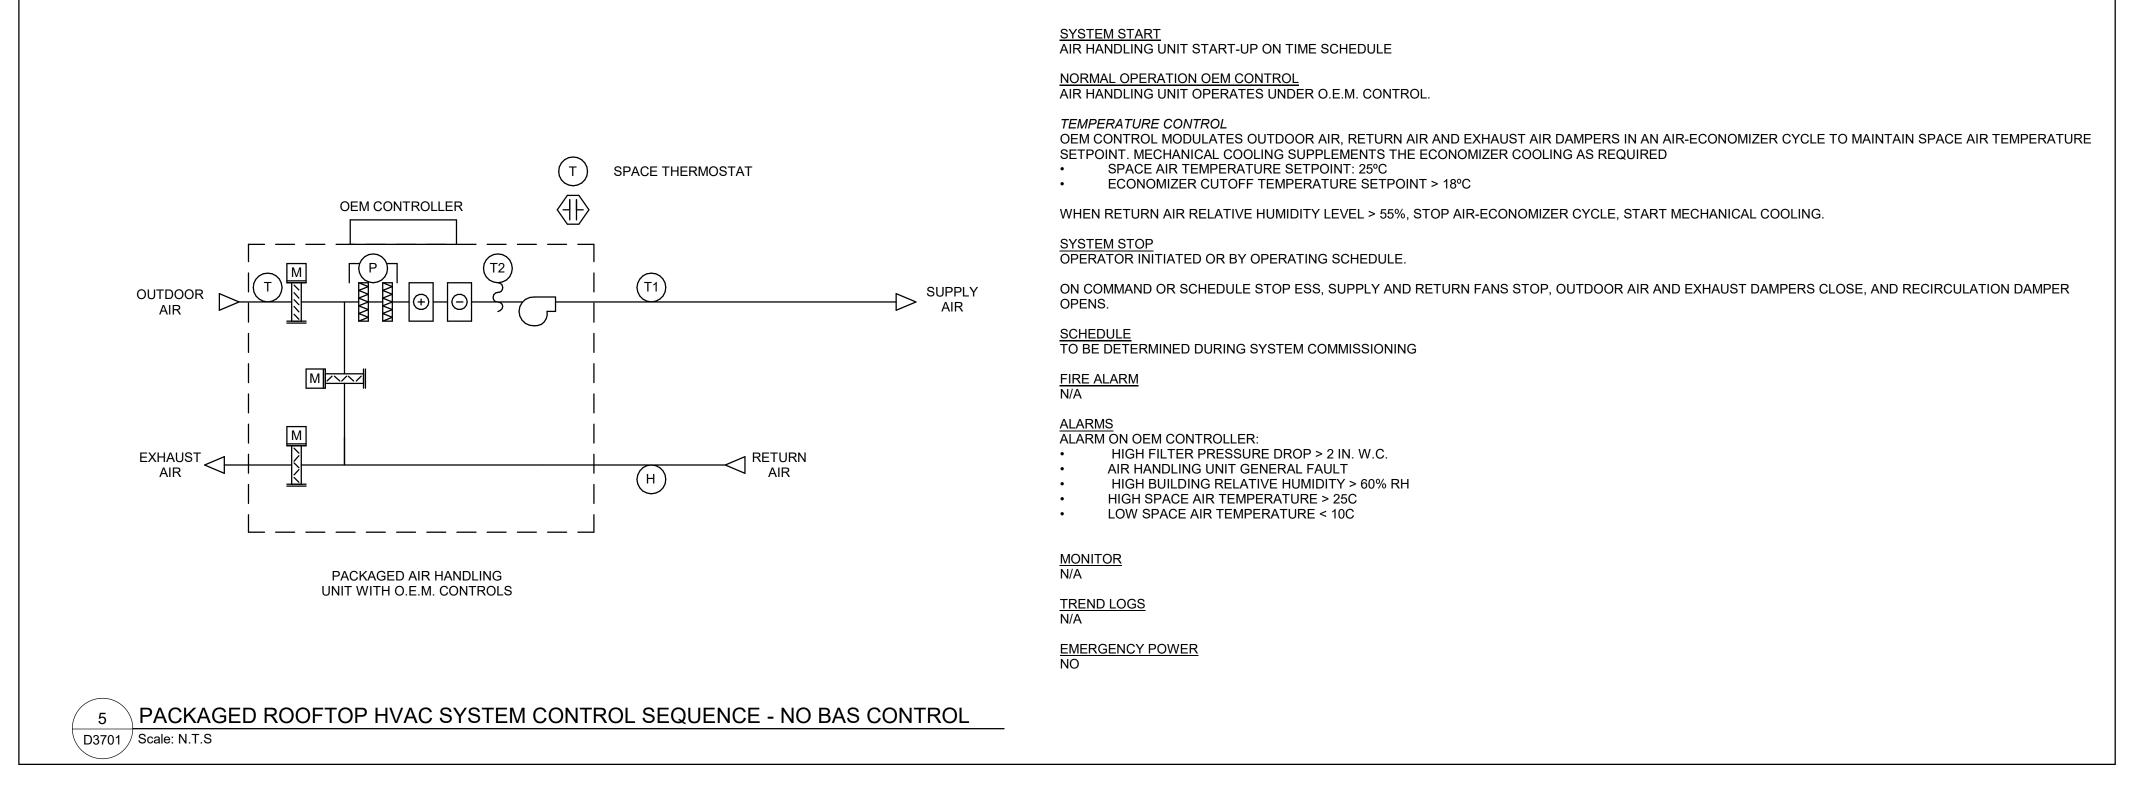
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N. KHOURY

PROJECT MGR

F. BOLOURIAN

SHEET NUMBER

SHEET TITLE

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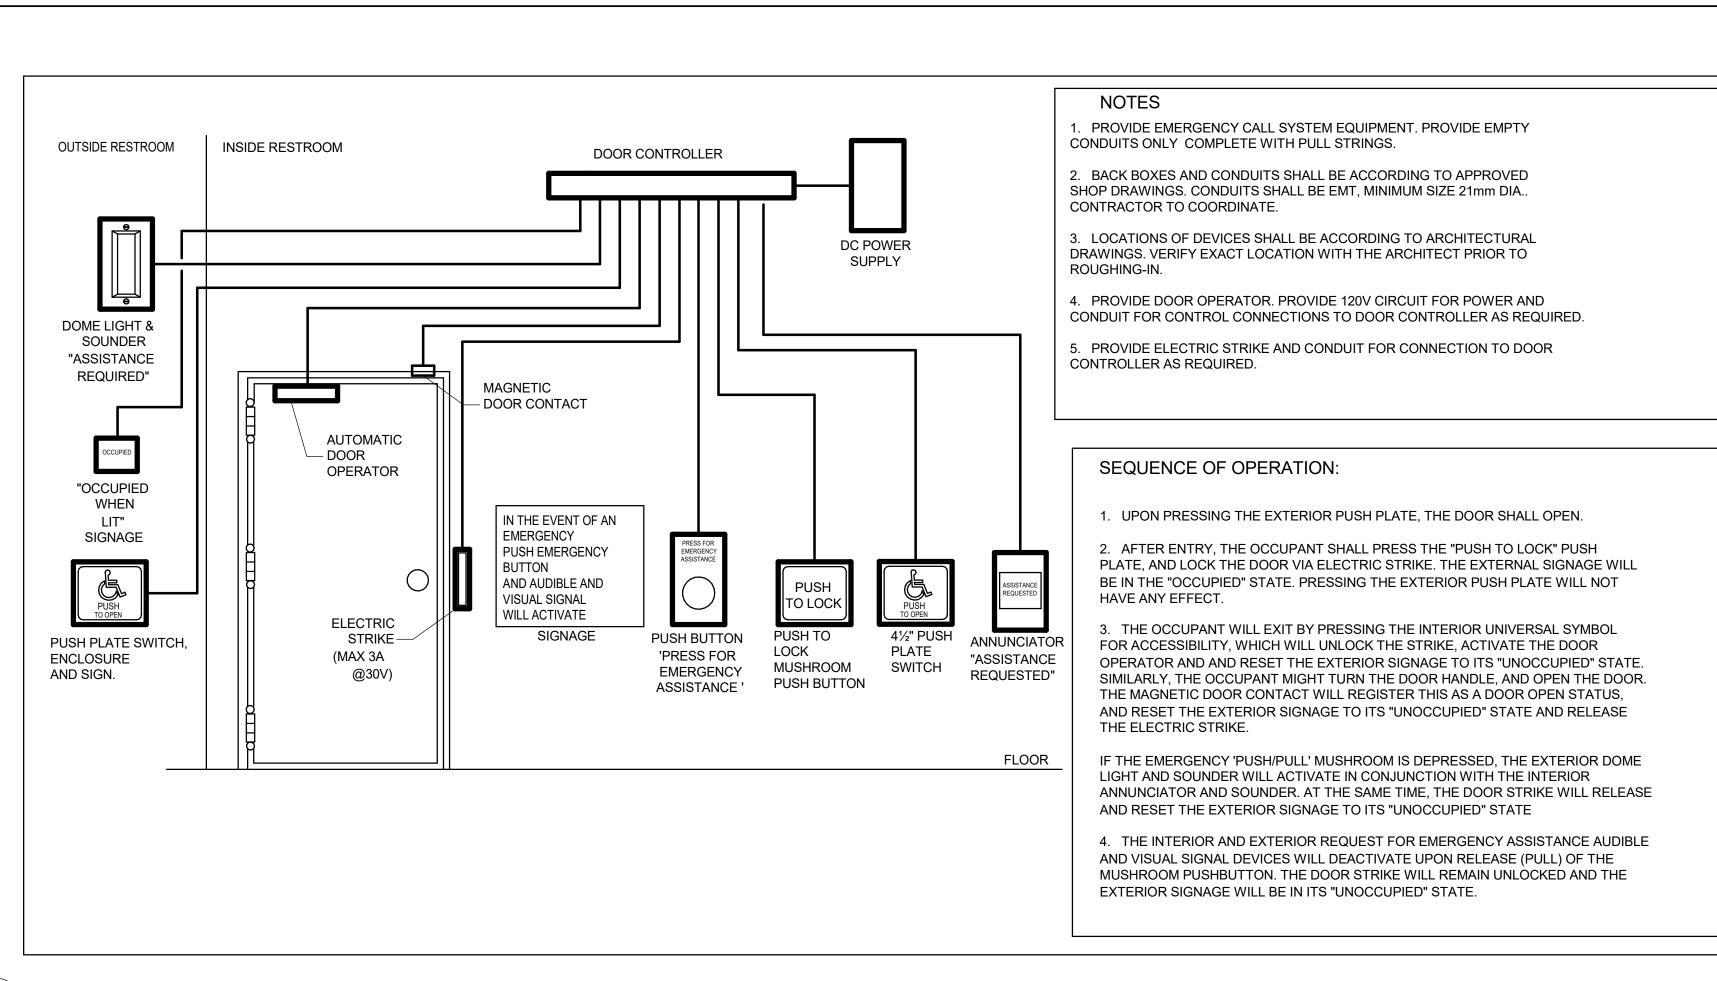
CONTROL DETAILS

G05-GAL-D3701 E

Scale 1:100

5 PACKAGED ROOFTOP HVACE
D3701 Scale: N.T.S

0 2.5 5



1 UNIVERSAL WASHROOM DETAIL

D4001 / Scale: NTS

---- 1-27C MIN - NOTE-6 TO POWER PANEL TO SECURITY CONTROL PANEL DOOR - 1-21C (TYP.) CONTROL NOTE-7 (TYP.) BOX CEILING LINE OR EQUIVALENT (3000 AFF) CONCEAL CONDUIT BELOW CEILING LINE OR 3000AFF (TYP.) COORDINATE CONDUIT WITH PREFORMED LOCATION FOR DOOR DEVICE BOX FOR REQUEST TO EXIT MONITOR SWITCH DOOR OPERATOR SENSOR AND/OR AUDIO ANNUNCIATOR WHERE REQUIRED (NOTE-8) ACTUATING MAGNET FOR DOOR MONITOR SWITCH INSTALLED IN TOP EDGE OF DOOR. (NOTE-10) EXTEND CONDUIT INSIDE DOOR FRAME JAMB TO STRIKE POSITION - ELECTRICAL TRANSFER HINGE/LINK DOOR POWER PUSH BUTTON CARD READER-SECURE MOUNTED ON SECURE SIDE OF WALL WHEN INDICATED. CARD READER AND/OR KEY PAD ON PUBLIC SIDE OF WALL WHERE DOOR MOUNTED BOLT RELEASE/RETRACT DEVICES REQUIRED (NOTE-8) WHEN USED. (NOTE-9) 1-21C (NOTE-11) ELECTRIC STRIKE (NOTE-12) FLOOR

### NOTES:

- 1. THIS CONSTRUCTION DETAIL IS FOR SCHEMATIC PURPOSE ONLY, REFER TO POWER AND SECURITY LAYOUT DRAWINGS AND DOOR HARDWARE SCHEDULE FOR EXACT COMPONENTS REQUIRED AND CONDUIT ROUTING.
- 2. ALL CONDUITS WITH PULL STRING, JUNCTION BOXES, PULL BOXES, DEVICE BOXES AND POWER WIRES BY DIV.26.
- 3. SECURITY DOOR CONTROLLER, CARD READER, ALARM BUZZER, KEYPAD, REQUEST TO EXIT SENSOR AND SECURITY WIRES BY SECURITY VENDER WHERE REQUIRED.
- 4. POWER SUPPLY, DOOR OPERATOR/CONTROLLER, DOOR POWER PUSH BUTTON, ELECTRIC STRIKE/BOLT/LATCH, DOOR CONTACT (MONITOR SWITCH), BY DOOR HARDWARE CONTRACTOR WHERE REQUIRED.
- 5. PROVIDE CONTINUOUS ELECTRICAL RACEWAY CONSISTING OF CONDUIT AND/OR CABLE TRAY. NO FREE AIR RUNNING SECURITY CABLE.
- 6. JUNCTION BOX SIZED TO ACCOMMODATE LOCAL DOOR CONTROL SYSTEM; MIN. 300x300x150 WITH REMOVABLE AND TAMPER RESISTANT COVER; SURFACE MOUNTED FOR SOLID WALL CONSTRUCTION. SAME WITH 100x100x54 DEVICE BOX WITH 38MM EXTENSION RING TO DEPTH OF 92MM, FLUSH MOUNT FOR CAVITY OR BLOCK WALL CONSTRUCTION. USE COMMON CONDUIT, PULL BOXES AND JUNCTION BOXES FOR INTRUSION DETECTION AND ACCESS CONTROL WIRING.
- 7. USE JUNCTION BOX AT CORNER FOR BLOCK WALL CONSTRUCTION. CONCEAL VERTICAL CONDUIT. SURFACE MOUNT HORIZONTAL CONDUIT ON SOLID WALL ONLY
- 8. DEVICE BOX MOUNTED FLUSH WITH SURFACE. PROVIDE SINGLE DEVICE COVER PLASTER RING FOR CAVITY OR BLOCK WALL CONSTRUCTION. REFER TO LAYOUT DRAWING FOR LOCATION. COORDINATE WITH DOOR HARDWARE SCHEDULE FOR EXACT SIZE. DISPENSE WITH WALL BOX WHEN MULLION MOUNT IS INDICATED IN THE DOOR HARDWARE SCHEDULE.
- 9. BOLT RELEASE/RETRACT DEVICE MAY BE PUSH-BAR OR LEVER TYPE. USE TYPE INDICATED IN DOOR HARDWARE
- 10. WHERE DOOR PERFORMANCE REQUIREMENTS CALL FOR INTRUSION DETECTION AND ACCESS CONTROL, USE MAY BE MADE OF 2 SEPARATE SINGLE POLE SWITCHES OR ONE COMMON 2 POLE SWITCH. MAINTAIN SEPARATION BETWEEN WIRING OF TWO SYSTEMS.
- 11. USE OF BRIDGING CONDUIT ACCEPTABLE FOR CAVITY OR BLOCK WALL CONSTUCTION WHERE SITE CONDITIONS PERMIT.
- 12. OMIT WHEN ELECTRIC LATCH IS USED.
- 13. ENSURE THAT WHEN CREDENTIAL IS NOT PRESENTED AND DOOR PUSH BUTTON IS TRIGGERED THAT MOTOR DOES NOT ENGAGE. SEQUENCE OF OPERATION IS TO PRESENT CREDENTIAL -> ACTIVATE DOOR OPERATOR PUSH BUTTON

2 SECURITY SINGLE DOOR DETAIL - POWER OPERATED
D4001 Scale: 1:1



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PROJECT TITLE
CITY OF TORONTO
ACCESSIBILITY UPGRADES

PROJECT ADDRESS

PROJECT NO: 9119- 19- 0162 / Arcadis 30279056

DRAWN BY:

V. MAC

PROJECT MGR:

N. FRISCIC

CHECKED BY:

M. BOJIC

APPROVED BY:

P. WILLIAMS

SHEET TITLE

ELECTRICAL DETAILS 1

SHEET NUMBER
D4001

D

2025-05-07 11:03:06 AM

MOUNTING HEIGHTS SCHEDULE						
MOUNTING HEIGHTS TO TOP OF DEVIC ALL DIMENSIONS ARE ABOVE FINISHED						
	0 FLOOR (AFF) UNLESS NOTED OTHERWISE.	ABOVE COUNTER  R MANUF. INSTRUCTION				
MOUNTING HEIGHTS AS APPLICABLE						

**GENERAL NOTES:** 

- 1. PROVIDE 1-#6 GND WIRE FOR ALL UNDERGROUND EMPTY CONDUITS AND COMMUNICATIONS CONDUITS WITHOUT METAL WIRING/CABLES TO FACILITATE FUTURE DETECTION.
- 2. NO SPLICES ARE ALLOWED FOR COMMUNICATION CABLES.
- 3. NO SPLICES ARE ALLOWED BELOW GRADE FOR POWER WIRE AND CABLE.
- 4. THERE MUST BE A BREAK IN ALL UNDERGROUND CONDUITS OUTSIDE THE BUILDING/TOWERS/ELECTRICAL/COMMUNICATIONS/BOILER ROOM TO ALLOW DRAINAGE OF RACEWAY BEFORE ENTERING THE ROOMS.
- 5. PROVIDE LAYOUT (WITH DIMENSIONS) OF ALL UNDERGROUND PULL POINTS INCLUDING HAND HOLES, MAN HOLES AND CONCRETE PULL BOXES TO THE CONSULTANT FOR APPROVAL PRIOR TO INSTALLATION.
- 6. INSTALL HAND HOLES AWAY FROM MAJOR TRAFFIC AREAS (TYPICAL).
- 7. PROVIDE HEAT TRACING PROTECTION FOR WATER PIPES, STORM PIPES AND SANITARY PIPES AS SHOWN ON ELECTRICAL DRAWINGS. REFER TO MECHANICAL DRAWINGS FOR PIPING LAYOUT. HEAT TRACING SHALL BE RAYCHEM MODEL #8XL-TRACE, 208V, 1PH, SELF REGULATING TRACING CABLE OR APPROVED EQUIVALENT, C/W POWER SUPPLY MODULE, THERMOSTAT AND ALL ACCESSORIES FOR A COMPLETE AND FUNCTIONING SYSTEM. STARTUP TEMPERATURE -29°C (-20°F).
- 8. WHERE CONDUITS ARE INSTALLED ACROSS EXPANSION JOINTS, PROVIDE CONDUITS WITH EXPANSION/CONTRACTION FITTINGS.
- 9. <u>ELEVATOR FIRE ALARM AUTOMATIC RECALL:</u>

ELEVATOR LOBBY MOUNTED FIRE DETECTORS AND SECURITY PANEL TO RECALL ELEVATORS TO DESIGNATED LEVEL UPON FIRE ALARM. SHOULD DETECTOR AT DESIGNATED LEVEL ELEVATOR LOBBY INDICATE FIRE, ELEVATOR TO BE DIRECTED TO ALTERNATE LEVEL. REFER TO ELEVATOR AUTOMATIC FIRE RECAL SCHEDULE. ELEVATOR CONTRACTOR TO COORDINATE WITH TSSA AND CONFIRM DESIGNATED/ALTERNATE LEVELS.

- 10. SMOKE DETECTOR AT TOP OF ELEVATOR SHAFT TO BE AIR SAMPLING SMOKE DETECTOR TYPE. INSTALL CONTROL UNIT IN A TAMPER PROOF ENCLOSURE (NEMA 4X) OUTSIDE OF ELEVATOR CLOSET. AIR SAMPLING SMOKE DETECTOR TO BE EST READY SET BY EDWARDS OR APPROVED EQUAL.
- 11. SITE PLAN DRAWINGS INDICATE UNDERGROUND POWER CONDUITS AND CORRESPONDING PULL POINTS (CONCRETE PULL BOXES, HAND HOLES OR MAN HOLES). WHERE OEC REQUIRES ADDITIONAL PULL POINTS FOR WIRING SEPARATION, PROVIDE ADDITIONAL CONCRETE PULL BOX (OR HAND HOLE) AS REQUIRED. IF AN ADDITIONAL MAN HOLE IS REQUIRED, IT IS PREFERRED TO PROVIDE AN ADDITIONAL HAND HOLE OR CONCRETE PULL BOX IF POSSIBLE.

CLIENT

# CITY OF TORONTO TORONTO Corporate Real Estate Management Project Management Office Metro Hall Toronto, ON

M5V 3C6

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С	ISSUED FOR PERMIT	2022-03-18
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PROJECT TITLE
CITY OF TORONTO
ACCESSIBILITY UPGRADES

PROJECT ADDRESS

PROJECT NO:
9119- 19- 0162 / Arcadis 30279056

DRAWN BY: CHECKED BY:
V. MAC M. BOJIC

APPROVED BY: **P. WILLIAMS** 

PROJECT MGR:
F.BOLOURIAN
SHEET TITLE

ELECTRICAL GENERAL NOTES

SHEET NUMBER
G05-G4003

D

2025-05-07 11:09:33 AM

# CITY OF TORONTO ACCESSIBILITY UPGRADES

	TOUCH AND FEEL INDEX				
SHEET#	SHEET TITLE				
Т00	COVER PAGE				
T01	WASHROOM				
T02	WASHROOM ACCESSORIES				
T02.1	WASHROOM ACCESSORIES				
Т03	WASHROOM FIXTURES & DRINKING FOUNTAIN				
T04	KITCHEN MATERIALS AND FIXTURES				
T05	RESERVED				
T06	TACTILE ATTENTION INDICATORS				
T07	TEXTURAL & COLOUR CONTRAST WARNING STRIP AND NOSING				
T08	DOOR THRESHOLDS				





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# TOUCH AND FEEL INTERIOR FIXTURES AND MATERIALS

**Project Number:** 9119- 19- 0162 / Arcadis 30279056


**Date:** 2025-04-11


TOUCH-AND-FEEL DOCUMENT SHOULD BE READ IN CONJUNCTION WITH DRAWINGS AND SPECIFICATIONS

WASHROOM FINISHES				
WASHROOM / SHOWER WALLS COLLECTION: COLOUR & DIMENSION				
CWT-1	COLOUR: ARCTIC WHITE MATTE			
	SIZE: 100mm X 400mm (4"X16")			
	SUPPLIER: OLYMPIA			
WASHINGON / OLIOWED WALL ACCENT	MATOU EVIOTINO			
WASHROOM / SHOWER WALL ACCENT CWT-2	MATCH EXISTING TILE SIZE IS INDICATED ON ROOM FINISH SCHEDULE			
	THE SIZE IS INSIGNATED STATES OF THE SIZE IS IN THE			
WASHROOM / SHOWER WALL ACCENT	COLLECTION: COLOUR & DIMENSION			
CWT-3	COLOUR: TAUPE, MATTE			
	SIZE: 100mm X 400mm (4"X16")			
	SUPPLIER: OLYMPIA			
WASHROOM / SHOWER WALL ACCENT	COLLECTION: COLOUR & DIMENSION			
CWT-4	COLOUR: DARK GREY MATTE			
0001-4	SIZE: 100mm X 400mm (4"X16")			
	SUPPLIER: OLYMPIA			
	SOLI ELEK. SELIMI IX			
FLOORS	COLLECTION: MICA, MATTE FINISH			
PFT-1	SIZE: 300mm X 600mm (12"X24")			
	MEETS DYNAMIC COEFFICIENT OF FRICTION			
	PREFERRED SUPPLIER: D9 / EMOTION			
SHOWER FLOORS	COLLECTION: STI MOSAICO			
PFT-2	COLOUR: MID GREY UNGLAZ			
	SIZE: 50mm X 50mm (2"X2")			
	MEETS DYNAMIC COEFFICIENT OF FRICTION			
	SUPPLIER: STONE TILE			
FLOORS	MATCH EXISTING			
PFT-3	TILE SIZE IS INDICATED ON ROOM FINISH SCHEDULE			
FLOORS	COLLECTION: CORE COLLECTION TERRA			
PFT-4	COLOUR: 200 SMOOTH (V)			
	SIZE: 304.8mm X 609.6mm (12"X24")			
	MEETS DYNAMIC COEFFICIENT OF FRICTION			
	SUPPLIER: MOSA TILE			


FOR WASHROOMS WHERE ALL FIXTURES AND WALLS ARE BEING REMOVED ONLY



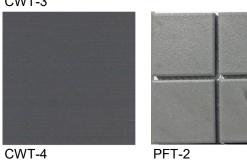

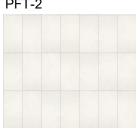

PFT-4

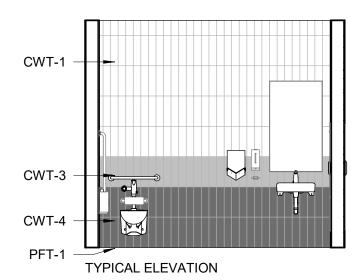



PICTURE 1



PICTURE 2

**NOTE**: PICTURES ARE ONLY FOR ILLUSTRATION PURPOSES

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AND STAKEHOLDERS



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NOTE: THE FINISHES PRESENTED ON THIS PAGE ARE THE BASIS OF DESIGN - ANY ALTERNATES ARE SUBJECT TO APPROVAL BY CITY OF TORONTO, PROJECT MANAGER, FACILITY MANAGER

DRAWING TITLE:

WASHROOM

**Project No:** 9119- 19- 0162 / Arcadis 30279056

Date: 2025-04-11

Issue: ISSUED FOR TENDER

NO.



SHELF: SHLF GAMCO MS-18 STAINLESS STEEL MIRROR SHELF – 18"



**SOAP DISH: SDI-1** 

**SOAP DISH: SDI-2** 

**BRADLEY MODEL NO. SA16** 

RECESSED MOUNTED SOAP DISH, HEAVY

DUTY STAIN FINISH STAINLESS STEEL.

SURFACE MOUNTED, STAINLESS STEEL, TYPE 304 FLANGE. BRADLEY MODEL NO. 901

COAT HOOK: CTH-2
B-2116 12-GAUGE (2.7mm)
CASE HARDENED STEEL.
ONE PIECE BRASS
CASTING WITH SATIN
NICKEL-PLATED FINISH

COAT HOOK: CTH-1

EDGES.

B-983 STAINLESS STEEL, 14-

GAUGE AUTO-RELEASE

EXPOSED STAIN FINISH,

**FACEPLATE WITH SLOPED** 

**CLOTHES HOOK WITH** 



HAND DRYER: HNDR
DYSON SPRAYED NICKEL 307174-01,
NET WEIGHT: 2.9 KG / 6.17 LBS.
H:39.3CM X W:19CM X D:10CM



TOILET TISSUE DISPENSER: TPD SURFACE-MOUNTED TWIN JUMBO-ROLL B-2892: 18-8, TYPE-304, 20-GAUGE (1.0MM) STAINLESS STEEL WITH SATIN-FINISH. EQUIPPED WITH A TUMBLER LOCK KEYED LIKE OTHER BOBRICK WASHROOM ACCESSORIES.



MIRROR: MIR
6 MM" FLOAT GLASS, SELECTED FOR
SILVERING, ELECTROLYTICALLY
COPPER-PLATED BY GALVANIC
PROCESS FURNISH UNITS IN TYPE 430
STAINLESS STEEL FRAMING



SOAP DISPENSER: SD-1
WALL MOUNTED, AUTOMATIC STAINLESS
STEEL WITH STAIN FINISH, CLEAR ACRYLIC
REFILL INDICATOR WINDOW AND KEY LOCK.
BRADLEY 6A00-11.



SOAP DISPENSER: SD-2
COUNTER MOUNTED, TOUCH FREE, ONE
PIECE, CAST BRASS CONSTRUCTION ABOVE
DECK, SINGLE MOUNT FOAM SOAP
DISPENSER WITH ADJUSTABLE SENSOR.
MOEN, MODEL NO. 8560



L-SHAPED GRAB: GRB-1
SATIN FINISH WITH PEENED GRIPPING
SURFACE; 18-GAUGE (1.2MM) STAINLESS
STEEL TUBING WITH SATIN-FINISH. 38MM
OUTSIDE DIAMETER. ENDS ARE HELIARC
WELDED TO FLANGES. CLEARANCE
BETWEEN THE GRAB BAR AND WALL IS
38MM. 30" X 30"
762MM X 762MM)



L-SHAPED GRAB: GRB-2
SATIN FINISH WITH PEENED GRIPPING
SURFACE; 18-GAUGE (1.2MM) STAINLESS
STEEL TUBING WITH SATIN-FINISH. 38MM
OUTSIDE DIAMETER. ENDS ARE HELIARC
WELDED TO FLANGES. CLEARANCE
BETWEEN THE GRAB BAR AND WALL IS
38MM. 40" X 30"
(1016MM X 762MM)





**GRAB BAR: GRB-3** 

SATIN FINISH WITH PEENED GRIPPING SURFACE; 18-GAUGE (1.2MM) STAINLESS STEEL TUBING WITH SATIN-FINISH. 38MM OUTSIDE DIAMETER. ENDS ARE HELIARC WELDED TO FLANGES. CLEARANCE BETWEEN THE GRAB BAR AND WALL IS 38MM. 30" (762MM) **GRAB BAR: GRB-4** 

SATIN FINISH WITH PEENED GRIPPING SURFACE; 18-GAUGE (1.2MM) STAINLESS STEEL TUBING WITH SATIN-FINISH. 38MM OUTSIDE DIAMETER. ENDS ARE HELIARC WELDED TO FLANGES. CLEARANCE BETWEEN THE GRAB BAR AND WALL IS 38MM. 36" (914MM) GRAB BAR: GRB-5

SATIN FINISH WITH PEENED GRIPPING SURFACE; 18-GAUGE (1.2MM) STAINLESS STEEL TUBING WITH SATIN-FINISH. 38MM OUTSIDE DIAMETER. ENDS ARE HELIARC WELDED TO FLANGES. CLEARANCE BETWEEN THE GRAB BAR AND WALL IS 38MM. 40" (1016MM)



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ACCESSIBILITY UPGRADES
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CITY OF TORONTO ACCESSIBILITY UPGRADES DRAWING TITLE:

WASHROOM ACCESSORIES

**Project No:** 9119- 19- 0162 / Arcadis 30279056

**Date**: 2025-04-11

Issue: ISSUED FOR TENDER

NO.



**PAPER TOWEL DISPENSER &** WASTE RECEPTACLE: PTD/WR (SR) WASTE RECEPTACLE: PTD/WR (R) **SEMI-RECESSED** B-38032: 18-8, TYPE 304, HEAVY-GAUGE STAINLESS STEEL. ALL-WELDED CONSTRUCTION.



PAPER TOWEL DISPENSER AND RECESSED CONVERTIBLE B-3940: 18-8, TYPE 304, HEAVY-GAUGE STAINLESS STEEL. EXPOSED SURFACES HAVE STAIN-FINISH.



PAPER TOWEL DISPENSER AND WASTE RECEPTACLE: PTD/WR (S) SURFACE-MOUNTED B-3699: 18-8, TYPE 304, 22-GAUGE (0.8mm) STAINLESS STEEL. ALL-WELDED CONSTRUCTION. EXPOSED SURFACES HAVE STAIN-FINISH.





PAPER TOWEL DISPENSER: PTD (S) PAPER TOWEL DISPENSER: PTD (R) SURFACE MOUNTED B-2974: TYPE RECESSED B-35903: TYPE 304, 304, 18 GUAGE STAINLESS STEEL. ALL-WELDED CONSTRUCTION.

HEAVY-GAUGE STAINLESS STEEL. ALL-WELDED CONSTRUCTION. EXPOSED SURFACES HAVE STAIN-FINISH.



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ACCESSIBILITY UPGRADES

DRAWING TITLE:

WASHROOM ACCESSORIES

**Project No:** 9119- 19- 0162 / Arcadis 30279056

**Date**: 2025-04-11

**Issue: ISSUED FOR TENDER** 

T02.1



WALL MOUNTED SINK:
(BARRIER FREE USE) L1H
DECORUM WALL HUNG
LAVATORY WITH EVERCLEAN
9024.001EC.020 - VITREOUS
CHINA, WHITE FINISH, WITH
SINGLE FAUCET HOLE AND
OVERFLOW



COUNTER-MOUNTED SINK: L1
WHITE, SELF-RIMMING,
REAR/FRONT OVERFLOW,
DRILLED FOR 100 MM SUPPLY
FITTING.
AMERICAN STANDARD
"AQUALYN" #0475.047.020 518 X
441 MM



COUNTER-MOUNTED SINK: (BARRIER FREE USE) L2H WHITE, FOR BARRIER FREE USE, SELF-RIMMING WITH SEALANT, OVERFLOW, DRILLED FOR 100 MM SUPPLY FITTING. AMERICAN STANDARD "AQUALYN" #0475.047.020 518 X 441 MM



WALL MOUNTED SINK C/O WITH SHROUD: (BARRIER FREE USE)
L3H
DECORUM WALL HUNG
LAVATORY WITH EVERCLEAN
NO.
9134.001EC/0059.020EC
SHROUD - VITREOUS CHINA,
WHITE FINISH, WITH SINGLE

FAUCET HOLE AND OVERFLOW



UNDER-MOUNTED SINK: (BARRIER FREE USE) L4H WHITE, FOR BARRIER FREE USE WITH REAR OVERFLOW AND UNDERMOUNT CLIPS AMERICAN STANDARD OVALYN UNICERSAL ACCESS 9482.000 489 X 400MM

### **DRINKING FOUNTAIN**



DRINKING FOUNTAIN: DF
EZSDWSLK GALVANIZED STEEL WALL MOUNTED,
WHEELCHAIR TYPE WATER COOLER WITH STAINLESS
STEEL TOP, FRONT AND SIDE MOUNTED PUSH TO
OPERATE LEVER(S), SENSOR, TOUCHLESS
ACTIVATION WITH AUTO SHUT OFF BOTTLE FILLER,
FLEXI-GUARD SAFETY BUBBLER, AND TRAP PACKAGE.

### **FAUCET: TO BE USED WITH ALL LAVATORY TYPES**

MOEN ALIGN SENSOR FAUCET - 8559 ELECTRONIC 'NO-TOUCH' HARDWIRED POWERED FAUCET



**TOILET: W1H**<u>WALL HUNG</u> - WHITE FINISH - VITREOUS
CHINA WITH EVERCLEAN ANTIMICROBIAL
SURFACE. NO. 3351.101.002



**TOILET: W2H**<u>FLOOR MOUNTED</u> WHITE FINISH - VITREOUS CHINA WITH EVERCLEAN ANTIMICROBIAL SURFACE. NO. 3461.001.020



**TOILET WITH TANK: W3H**<u>FLOOR MOUNTED</u> WHITE FINISH - VITREOUS CHINA WITH EVERCLEAN ANTIMICROBIAL SURFACE. PA TANK, 1.1 GPF WHITE



URINAL: U1H
WALL HUNG 6590.001.020 - WASHBROOK FLOWISE EXTENDED SIDES FOR PRIVACY - WASHDOWN
ACTION - FLUSHING RIM - 19 MM DIA.



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**ACCESSIBILITY UPGRADES** 

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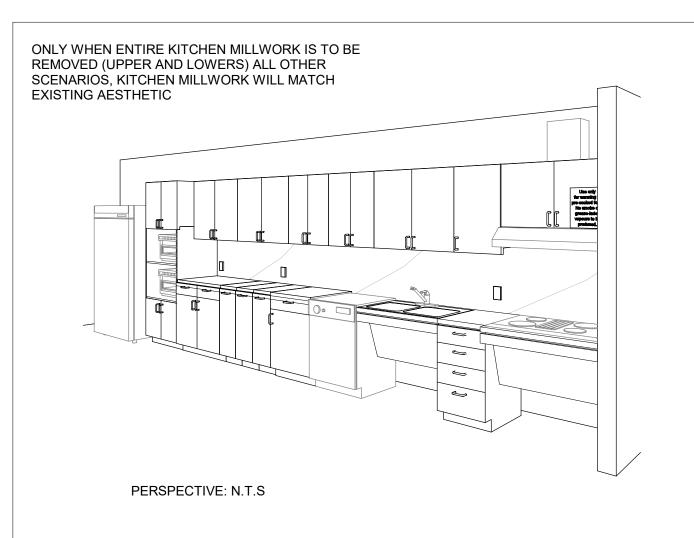
WASHROOM FIXTURES & DRINKING FOUNTAIN


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**ELEVATION: N.T.S** 


PERSPECTIVE & ELEVATION VIEWS ARE REPRESENTATIVE ONLY - REFER TO BUILDING-SPECIFIC DRAWINGS




COUNTERTOP AND
BACKSPLASH: Q-1
CAESARSTONE - QUARTZ
SUPERNATURAL COLLECTION
SEA D90
1111 VIVID WHITE

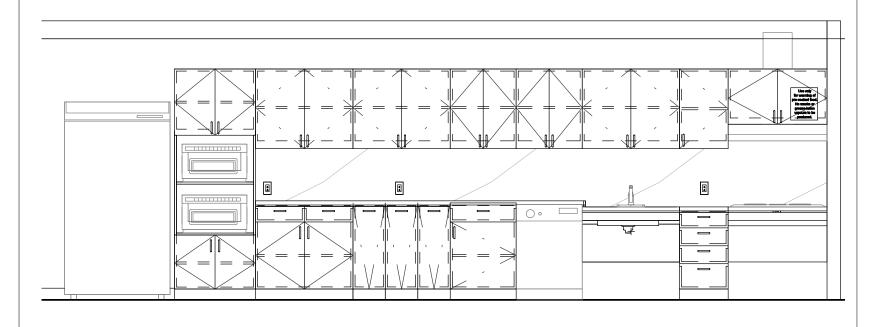

CABINETS: PLAM-1 PLASTIC LAMINATE WILSONART NORTH SEA D90

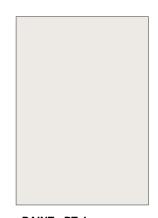

PAINT: PT-1 SHERWIN WILLIAMS SW 7004 SNOWBOUND PAINT SHIELD EGGSHEL SHEEN

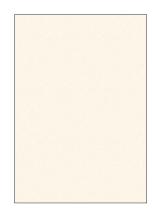

UPPER CABINETS: PLAM-2 PLASTIC LAMINATE WILSONART ALABASTER D431



FAUCET:
AMERICAN STANDARD NO.
7074100.00
SINK:
UCS6105P-1 SINGLE BOWL



FAUCET:
AMERICAN STANDARD NO.
7074100.00
SINK:
FRANKE COMMERCIAL
UCD6405P



FAUCET:
MOEN ALIGN WITH
MOTIONSENSE NO. 7565EC
SINK:
UCS6105P-1 SINGLE BOWL



FAUCET:
MOEN ALIGN WITH
MOTIONSENSE NO. 7565EC
SINK:
FRANKE COMMERCIAL
UCD6405P

NO.



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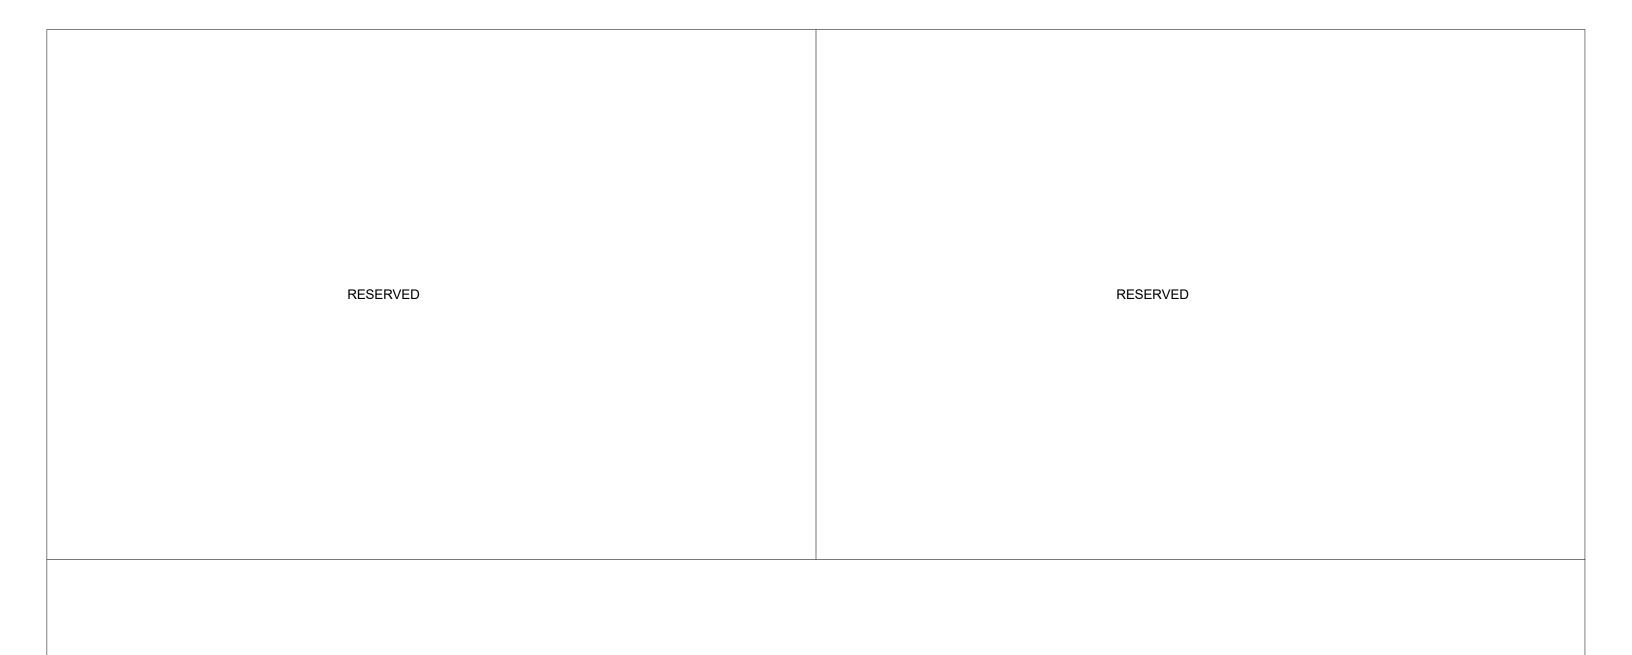
CITY OF TORONTO ACCESSIBILITY UPGRADES CITY OF TORONTO ACCESSIBILITY UPGRADES DRAWING TITLE:

KITCHEN MATERIALS AND FIXTURES

**Project No:** 9119- 19- 0162 / Arcadis 30279056

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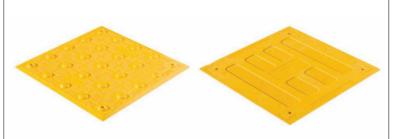
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Date: 2025-04-11

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TA - 1a (SURFACE MOUNTED) INTERIOR AND EXTERIOR TA - 1b (CAST IN PLACE) EXTERIOR

TA - 1c (SURFACE MOUNTED FIRE RATED) INTERIOR



TA - 2a (SURFACE MOUNTED) INTERIOR AND EXTERIOR TA - 2b (CAST IN PLACE) EXTERIOR





WAYFINDING BARS





TRUNCATED DOMES

WAYFINDING BARS

TA - 4

### POLYMER, COMPOSITE TACTILE INDICATORS

- SURFACE APPLIED SUITABLE FOR INTERIOR APPLICATIONS
- FIRE RATED TILES FOR INTERIOR APPLICATIONS HIGHER THAN 6 FLOORS
- CAST IN PLACE SUITABLE FOR EXISTING

ENGINEERED POLYMER COMPOSITE TACTILE INDICATORS


- EXTERIOR APPLICATIONS
- FOR NEWLY CONSTRUCTED CURBS RAMPS, STAIRS, RAMPS, OR PLATFORM EDGES

RESILIENT POLYMER TACTILE INDICATORS

- INTERIOR OR EXTERIOR APPLICATIONS
- TRUNCATED DOME OR WAYFINDING BAR VARIANTS.
- FOR SKATE RINK EDGES OR USE WITH VCT FLOORING

PORCELAIN TACTILE INDICATORS

- INTERIOR OR EXTERIOR APPLICATIONS
- TRUNCATED DOME OR WAYFINDING BAR VARIANTS.
- FOR USE WITH PORCELAIN TILE FLOORING

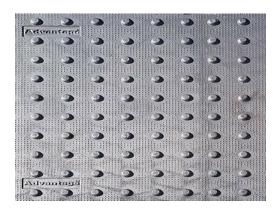

TA - 5



**TA - 6** 



TA - 7

TA - 3



TA - 8

### TRUNCATED DOMES:

- INDIVIDUAL STAINLESS STEEL TACTILE INDICATORS
- INTERIOR OR EXTERIOR APPLICATIONS
- CAN BE INSTALLED ON ALL SURFACES
- FOR HIGH PROFILE ARCHITECTURAL SPACES WHERE AESTHETICS ARE IMPORTANT
- TO BE USED ON NON-HERITAGE DESIGNATED STAIRS

### **GUIDANCE BARS:**

- INDIVIDUAL STAINLESS STEEL, BRASS, BRONZE OR ALUMINUM CARBORUNDUM NON-SLIP OR LINEAR GROOVE PATTERN.
- INTERIOR APPLICATIONS
- CAN BE INSTALLED ON ALL SURFACES
- FOR HIGH PROFILE ARCHITECTURAL SPACES WHERE AESTHETICS ARE IMPORTANT
- TO BE USED ON NON-HERITAGE DESIGNATED STAIRS

CAST IRON CAST IN PLACE TACTILE INDICATORS

- EXTERIOR APPLICATION
- HIGHLY DURABLE
- FOR NEW CONSTRUCTION HIGH TRAFFIC AREAS

INDIVIDUAL STAINLESS STEEL PLATE TACTILE INDICATORS

- INTERIOR OR EXTERIOR APPLICATIONS
- FOR HIGH PROFILE ARCHITECTURAL SPACES WHERE AESTHETICS ARE IMPORTANT

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TACTILE ATTENTION INDICATORS

**Project No:** 9119- 19- 0162 / Arcadis 30279056

Date: 2025-04-11

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TA - 11 INTERIOR AND EXTERIOR TEXTURAL WARNING STRIP

- AFFIXED WITH ADHESIVE AND SCREWS
- SIZES: 50.8MM X 203MM
- REFER TO DRAWINGS FOR REQUIRED LENGTH AND WIDTH



WHEN CONCRETE IS POURED

SIZES: 50.8MM X 76.2MM WIDE

AND WIDTH

INSTALLED IN WET-SET CONCRETE.


TA - 12 EXTERIOR CAST IN PLACE CONTRAST AND TEXTURAL WARNING STRIP






TA - 16 INTERIOR AND EXTERIOR USE (ON EXISTING) ON SMOOTH SURFACES STAIR NOSING FOR:
TILE, CONC, WOOD, CARPET, VINYL.

- ANODIZED ALUMINUM NOSE, INSTALLED WITH EITHER NON-SLIP STRIP OR WITH PHOTOLUMINESCENT CONTRAST STRIP.
- AVAILABLE IN 5 DIFFERENT PROFILES TO MATCH
  THE DESIGN OF THE STEP EDGE
- AFFLICTED WITH ADHESIVE OR ADHESIVE AND SCREWS
- SIZES: 70.1MM 78.7MM WIDE
- REFER TO DRAWINGS FOR REQUIRED LENGTH AND WIDTH

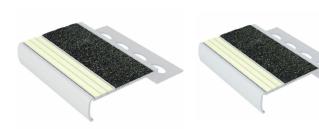

TA - 17 INTERIOR USE ON NEW TILED SURFACES. STAIR NOSING.

- ALUMINUM NOSE SPECIFICALLY DESIGNED FOR INSTALLATION ON TILED STAIRS.
- 3.2MM TILED STAIRS OR 2.54MM TILED STAIRS.
- REFER TO DRAWINGS FOR REQUIRED LENGTH AND WIDTH

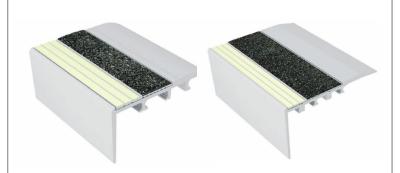

TA - 18 INTERIOR USE ON NEW CARPETED FLOORING. STAIR NOSING.

- ANODIZED ALUMINUM NOSE, SPECIFICALLY
   DESIGNED FOR CARPETED STAIRS, INSTALLED
   WITH EITHER NON-SLIP STRIP OR WITH
   PHOTOLUMINESCENCE CONTRAST STRIP
- INSTALLED WITH SCREWS
- SIZES: 66MM 89MM
- REFER TO DRAWINGS FOR REQUIRED LENGTH
  AND WIDTH



DESIGNED FOR INSTALLATION ON STEP EDGES


REFER TO DRAWINGS FOR REQUIRED LENGTH

TA - 19 EXTERIOR USE ON POURED CONCRETE. STAIR NOSING.

- HEAT TREATED EXTRUDED ALUMINUM ALLOY 6063-T-6, FILLED WITH A MIXTURE OF VIRGIN ALUMINUM OXIDE AND SILICON CARBIDE ABRASIVE GRANULES IN AN EPOXY BINDER.
- FULL LENGTH, INTEGRALLY EXTRUDED 5/8" ANCHOR.
- SIZES: 79.4MM X 25.4MM
- REFER TO DRAWINGS FOR REQUIRED LENGTH AND WIDTH
- TO BE USED ON NON-HERITAGE DESIGNATED STAIRS





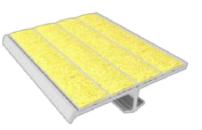

# TA - 20 INDOOR AND OUTDOOR USE ON NEW POURED CONCRETE STAIR NOSING.

- INSTALL INTO WET CONCRETE. USED ON CONCRETE STAIRS, CONCRETE-FILLED STEEL PAN STAIRS, AND PRE-CAST CONCRETE STAIRS.
- AVAILABLE IN CUT TO LENGTH SIZES. (TOLERANCE +OR- 1/8") STANDARD LENGTHS ARE 8FT AND 10FT.
- INSERTS ATTACHED OR UNATTACHED INSERTS UNATTACHED CAN BE INSTALLED LATER TO ENSURE THE PRODUCT IS CLEAN AND HAS NOT BEEN DAMAGED DURING CONSTRUCTION. INSERTS ARE INSTALLED WITH A PREMIUM POLYURETHANE ADHESIVE.
- A CLEAR PROTECTIVE TAPE WRAPS AROUND THE PRODUCT TO KEEP THE PRODUCT CLEAN DURING INSTALLATION. TO REMOVE, CUT THE TAPE ALONG THE EDGES AND PEEL AWAY.



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CITY OF TORONTO ACCESSIBILITY UPGRADES

CITY OF TORONTO ACCESSIBILITY UPGRADES DRAWING TITLE:

TEXTURAL & COLOUR CONTRAST WARNING STRIP AND NOSING

**Project No:** 9119- 19- 0162 / Arcadis 30279056

**Date:** 2025-04-11

Issue: ISSUED FOR TENDER

NO.



SMOOTH 6" WIDE THRESHOLD WITH ANTI-SLIP COATING



TH-2a

EXTERIOR APPLICATIONS - THERMALLY BROKEN METAL THRESHOLD ANY EXISTING FLOORING MATERIAL TO ANY EXISTING FLOORING MATERIAL



TH-3a

METAL THRESHOLD ANY EXISTING FLOORING MATERIAL TO ANY EXISTING FLOORING MATERIAL





TH-4a

ANODIZED ALUMINUM TRANSITION STRIP BETWWEEN NEW AND EXISTING FLOOR



Typical Wall .125

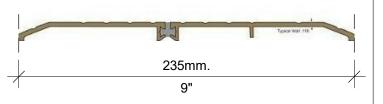

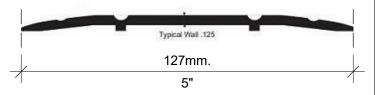

TH-5a

SATIN ANODIZED ALUMINUM TRANSITION STRIP FOR NEW FLOORING ON BOTH SIDE VARIES HEIGHTS (TILE TO ANY FLOOR SURFACE)



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CITY OF TORONTO ACCESSIBILITY UPGRADES CITY OF TORONTO ACCESSIBILITY UPGRADES DRAWING TITLE:

**DOOR THRESHOLDS & TRANSITIONS** 

**Project No:** 9119- 19- 0162 / Arcadis 30279056

**Date:** 2025-04-11

Issue: ISSUED FOR TENDER

NO.

# CITY OF TORONTO ACCESSIBILITY UPGRADES

9119-19-0162 / Arcadis 30279056

FIRE HALL NO. 121 10 WILLIAM CARSON CRESCENT



NOT FOR CONSTRUCTION

ISSUED FOR TENDER



ISSUE	ES	
No.	DESCRIPTION	DATE
Α	50% SUBMISSION	2021-11-19
В	90% SUBMISSION	2022-02-22
С	ISSUED FOR PERMIT	2022-03-18
_		

CITY OF TORONTO ACCESSIBILITY UPGRADES PROGRAM GROUP 5



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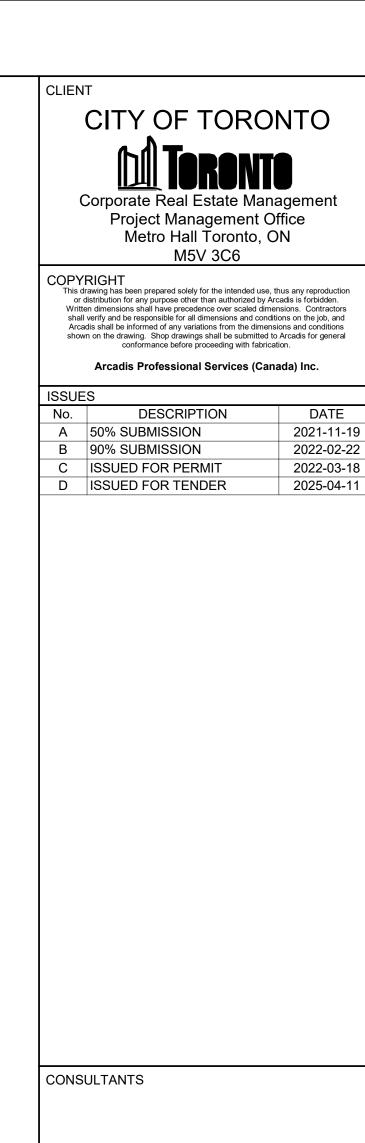
PROJECT NO: 9119-19-0162 / IBI 122260 DATE:

2025-04-11 SHEET NUMBER G05-001-G0001

GENERAL DRAWING INDEX			
SHEET NUMBER	SHEET NAME		
G0001	COVER SHEET		
G0002	DRAWING LIST		

ARCHITECTURAL DRAWING INDEX				
SHEET NUMBER	SHEET NAME			
A1201	SITE PLAN			
A2001	BASEMENT DEMOLITION PLAN			
A2011	FIRST FLOOR DEMOLITION PLAN			
A2021	SECOND FLOOR DEMOLITION PLAN			
A2101	BASEMENT STAGING PLAN			
A2111	FIRST FLOOR STAGING PLAN			
A2121	SECOND FLOOR STAGING PLAN			
A2401	BASEMENT PROPOSED PLAN			
A2411	FIRST FLOOR PROPOSED PLAN			
A2421	SECOND FLOOR PROPOSED PLAN			
A9111	DOOR AND ROOM FINISH SCHEDULE			

Part	Firm Name: IBI GROUP AR		Name of Project			ITEM	Л	Ontario's 2012 Buildin				DBC REFERENCE nces are to Division B unless noted	REMARKS
Martin   M	CERTIFICATE OF PRACTIC	,		ACCESSIBILITY UPGR	RADES				Data Matrix Part 3 or 9				
Martin	Toronto, ON M9W OC9	620	10 WILLIAM CARSOI				RESISTANCE RATING	BERS			SB-2 TABLE 2.1.1		
Martin   M	ITEM	Ontario's 2012 Building Code	ОВС	REFERENCE				JNS <u>INO CHANGE</u>			05 2 17 15 12 2:1:1:		
Mary					REMARKS								
March   Marc	1. PROJECT DESCRIPTION	3.74						<u> </u>			SB-2 TABLE 2.1.1.		
Part	☐ CHANGE		1.1.2. [A]	1.1.2. [A] & 9.10.1.3.									
Part	2. MAJOR OCCUPANCY(S)	GROUP F DIVISION 2 - MEDIUM HAZARD INDUSTRIAL OCCUPANCIES	3.1.2.1. (1)	9.10.2.		19.							
Mathematic	SUBSIDIARY OCCUPANO	CY(S) GROUP D - BUSINESS AND PERSONAL SERVICE OCCUPANCIES			EXISTING NO CHANGE		EBF (m²) (M) H/I	-					EXISTING NO CHANGE
Minima		GROUP C - RESIDENTIAL OCCUPANCIES							- 0	-			_
Marche   Ministry	3. BUILDING AREA (m²)	EXISTING - 407.2 NEW TOTAL - 407.2	1.4.1.2. [A]	1.4.1.2. [A]					- 0	-			
Mathematical Control of Math	4. GROSS AREA (m²)	EXISTING - 1220.13 NEW TOTAL - 1220.13	1.4.1.2. [A]	1.4.1.2. [A]	EXISTING NO CHANGE			TMENTO	- 0	-			
Mathematical Control	, ,					_   20.	PLUMBING FIXTURE REQUIRE	EMENIS			-		OBC REFERENCE
National Control   1						$\dashv$	MALE / FEMALE COUNT @	% / %	EXISTING NO CHANGE				
Part		<del></del>				1 1				ODO TABLE NUM	FIXTURES		
Part		<u> </u>				_	MA IOR OCCUPANCY					PROVIDED	
Part	8. SPRINKLER SYSTEM PR			9.10.8.2	EXISTING NO CHANGE		MAJOR GOOD AROT				X		
NOT CONTROL   STANDER PROJUCT   STANDER PROJUC									X FEMALE	3.7.4.9.	X	X 3.7.4.9.	
NAME				INDEY		21.	EXITS/ ACCESS TO EXIT-						
Mathematical Regiment   1			INDEX	INDEX									EXISTING NO CHANGE
Mathematical Control	9. STANDPIPE REQUIRED		3.2.9.	N/A	EXISTING NO CHANGE								
Markame recorded   Markame rec	STANDPIPE PROVIDED												
Mark	10. FIRE ALARM REQUIRED		324	9 10 18	EXISTING NO CHANGE	22.	OTHER (DESCRIBE) -						
Martin	FIRE ALARM PROVIDED					ITE	M Ontar	io Building Code Data Matr	iy - Part 11 - Renovation of Evis	ting Building		OBC REFERENCE	PEMAPKS
CASSIFICATION   CASSIFICATION   CONSIDERATION   CONSIDERATIO		Y	3.2.5.7.	N/A	EXISTING NO CHANGE		1 EXISTING BUILDING						KEMAKKO
A C   CANSTRUCTION     CANSTRUCTION     CANSTRUCTION     CANSTRUCTION     CANSTRUCTION     CANSTRUCTION     CANSTRUCTION   CANSTRUCTION     CANSTRUCTION   CANSTRUCTION     CANSTRUCTION	12. HIGH BUILDING	□ YES □ NO	3.2.6.	N/A			CLASSIFICATION:	USE:					
ACTUAL CONSTRUCTION   PORTURNITION	13. CONSTRUCTION RESTRI	ICTIONS □ COMBUSTIBLE □ NON-COMBUSTIBLE ☒ BOTH	3.2.2.67.	9.10.6.								TABLE 11.2.1.1.B.	
A   MEZZANINE (S) AREA   m'   m'   m'   m'   m'   m'   m'   m		PERMITTED REQUIRED			EXISTING NO CHANGE			NOT APPLICATION     NOT APPLICATION	ABLE (NO CHANGE OF MAJOR (	OCCUPANCY)		TON	
4.   MEZZANIKE (\$) ARE A   FENTING (\$) ARE A	ACTUAL CONSTRUCTION	N ☐ COMBUSTIBLE ☐ NON-COMBUSTIBLE ☐ BOTH				11.2		BASIC RENOVATI	ON	$\boxtimes$		11.3.3.1.	
The content of the	14. MEZZANINE (S) AREA m	ı² N/A	3.2.1.1. (3) - (8)	9.10.4.1.			BUILDING IS.	EXTENSIVE RENO	OVATION			11.3.3.2.	
STRICTURAL:						11.3		STRLICTLIDAL .		⊠ N∩	□ VES	11.4.2	
STRIOR:   OCCUPANCY:   LOAD   PERSONS   PERSONS   PERSONS   DOAD   PERSONS   PERSONS   PERSONS   DOAD   PERSONS		= ==:::::	J	1.5.16.	EXISTING NO CHANGE		FENFORMANCE LEVEL:		OCCUPANT LOAD:				
No   Coupancy   Sewage System:   Sewag	1ST FLOOR:	OCCUPANCY LOAD PERSONS						BY CHANGE OF M	IAJOR OCCUPANCY:	⊠ NO	☐ YES	11.4.2.2.	
MEZZANNE FLOOR:   OCCUPANCY	2ND FLOOR:											11.4.2.3.	
RESISTANCE RATING   FRC   FR	MEZZANINE FLOOR:							SEWAGE SYSTEM	Λ: 	⊠ NO	U YES	44.4.2	
WORK - COMPLIANT WITH CITY OF TORONTO ACCESSIBILITY DESIGN GUIDELINE DRAFT 2016 WHEN POSSIBLE   AZARDOUS SUBSTANCE   YES  No						11.4		STRUCTURAL:		⊠ NO	☐ YES (EXPLAIN		
17.   HAZARDOUS SUBSTANCE   YES   VES   NO   YES (EXPLAIN)   11.4.3.5     11.4.3.	16. BARRIER FREE DESIGN	⊠ YES □ NO (EXPLAIN)	3.8.	9.5.2.	WORK - COMPLIANT WITH CITY OF TORONTO ACCESSIBILITY DESIGN GUIDELINE DRAFT 2016						`		
18a. REQUIRED FIRE RESISTANCE RATING (FRR)  RESISTANCE RATING (FRR)  ROF NO CHANGE  LISTED DESIGN NO. OR DESCRIPTION (SB-2)  3.2.2.67. & 3.2.1.4.  9.10.9.  9.10.8. 9.10.9.  11.5 COMPLIANCE ALTERNATIVES	17. HAZARDOUS SUBSTANC	CES DYES NO	3.3.1.2 & 3.3.1.19	9.10.1.3.(4)				PI I IMRING:		⊠ N∩	☐ VES (EYDI AIN	11 4 3 5	
RESISTANCE RATING (FRR)  RESISTANCE RATING (FRR)  ROOF NO CHANGE  ROOF NO CHAN	18a. REQUIRED FIRE		3.2.2.67.	9.10.8.		+		i Edwidii40.		Z INO	L ILO (EXFLAIN	,, , , , , , , , , , , , , , , , , , , ,	
(FRR)    The state of the state	DESISTANCE DATING	FRR (HOURS) OR DESCRIPTION (SB-2)	& 3.2.1.4.	9.10.9.				SEWAGE SYSTEM	Л:	⊠ NO	☐ YES (EXPLAIN	11.4.3.6	
ALIEROATIVES VES. (CIV.E MUMPERS)						11.9		⊠ NO				11.5.1	
	' '							☐ YES (GIVE NU	MBERS)				



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PROJECT TITLE
CITY OF TORONTO ACCESSIBILITY UPGRADES

PROJECT ADDRESS

SEAL

FIRE HALL NO. 121 10 WILLIAM CARSON CRESCENT

PROJECT NO: 9119-19-0162 / Arcadis 30279056 DRAWN BY: **A. SUNIL** CHECKED BY: K. TILAHUN APPROVED BY: **E. FENUTA** 

PROJECT MGR: F. BOLOURIAN SHEET TITLE

DRAWING LIST

G05-001-G0002 D

2 KEY PLAN A1201 Scale: 1:1000



PHOTO 01 - EXISTING PARKING SPACES



PHOTO 02 - BUILDING FACADE



PHOTO 03 - EXISTING PARKING SPACES



PHOTO 04 - MAIN **ENTRANCE** 

## SITE LEGEND



NEW BARRIER FREE PARKING SPACE - REFER TO DETAIL 1/D1701 & 5/D1701




ACCESSIBLE PARKING SIGN ON POST - REFER TO DETAIL 2/D1702




EXISTING MAIN ENTRANCE




EXISTING EXIT TO REMAIN

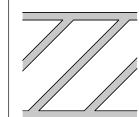

NEW PAINTED LINE MARKING DETAIL - REFER TO DETAIL 3/D1701

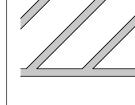

NEW PAINTED LINE MARKING DETAIL - REFER TO DETAIL 4/D1701

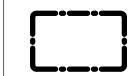

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DASHED AREA INDICATES AREA OF WORK

# KEYPLAN

CLIENT

ISSUES

A 50% SUBMISSION

B 90% SUBMISSION C ISSUED FOR PERMIT

D ISSUED FOR TENDER

CITY OF TORONTO

Corporate Real Estate Management

Project Management Office

Metro Hall Toronto, ON M5V 3C6

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Arcadis Professional Services (Canada) Inc.

2021-11-19

2022-02-22

2022-03-18

2025-04-11

DESCRIPTION

## SITE PLAN GENERAL NOTES

- SITE PLAN DIMENSIONS ARE APPROXIMATE BASED ON GOOGLE MAPS. CONTRACTOR TO VERIFY ALL DIMENSIONS AND EXISTING SITE SERVICES AND TO REPORT ANY DISCREPANCY TO THE CONSULTANT AND THE OWNER
- BEFORE COMMENCEMENT OF THE WORK. DURING CONSTRUCTION, CONTRACTOR TO COORDINATE ENTRANCES WITH OWNER FOR HOARDING AND EXTERIOR FENCING. RESTORE EXTERIOR WALKWAY, DRIVEWAY, PAVING AND ALL SOFT LANDSCAPING MATERIAL AROUND ALL EXTERIOR EXCAVATED AREAS AFTER CONSTRUCTION AS NEEDED WITH THE SAME MATERIAL AND FINISH.

DIGGING AND REPORT ANY CONFLICTS TO THE

VERIFY ALL UNDERGROUND BURIED UTILITIES PRIOR TO

CONSULTANTS

PRIME CONSULTANT

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PROJECT TITLE CITY OF TORONTO ACCESSIBILITY UPGRADES

PROJECT ADDRESS


FIRE HALL NO. 121 10 WILLIAM CARSON CRESCENT


PROJECT NO: 9119-19-0162 / Arcadis 30279056 CHECKED BY: K. TILAHUN DRAWN BY: A. SUNIL


PROJECT MGR: APPROVED BY: **E. FENUTA** F. BOLOURIAN SHEET TITLE

SITE PLAN

SHEET NUMBER G05-001-A1201 D

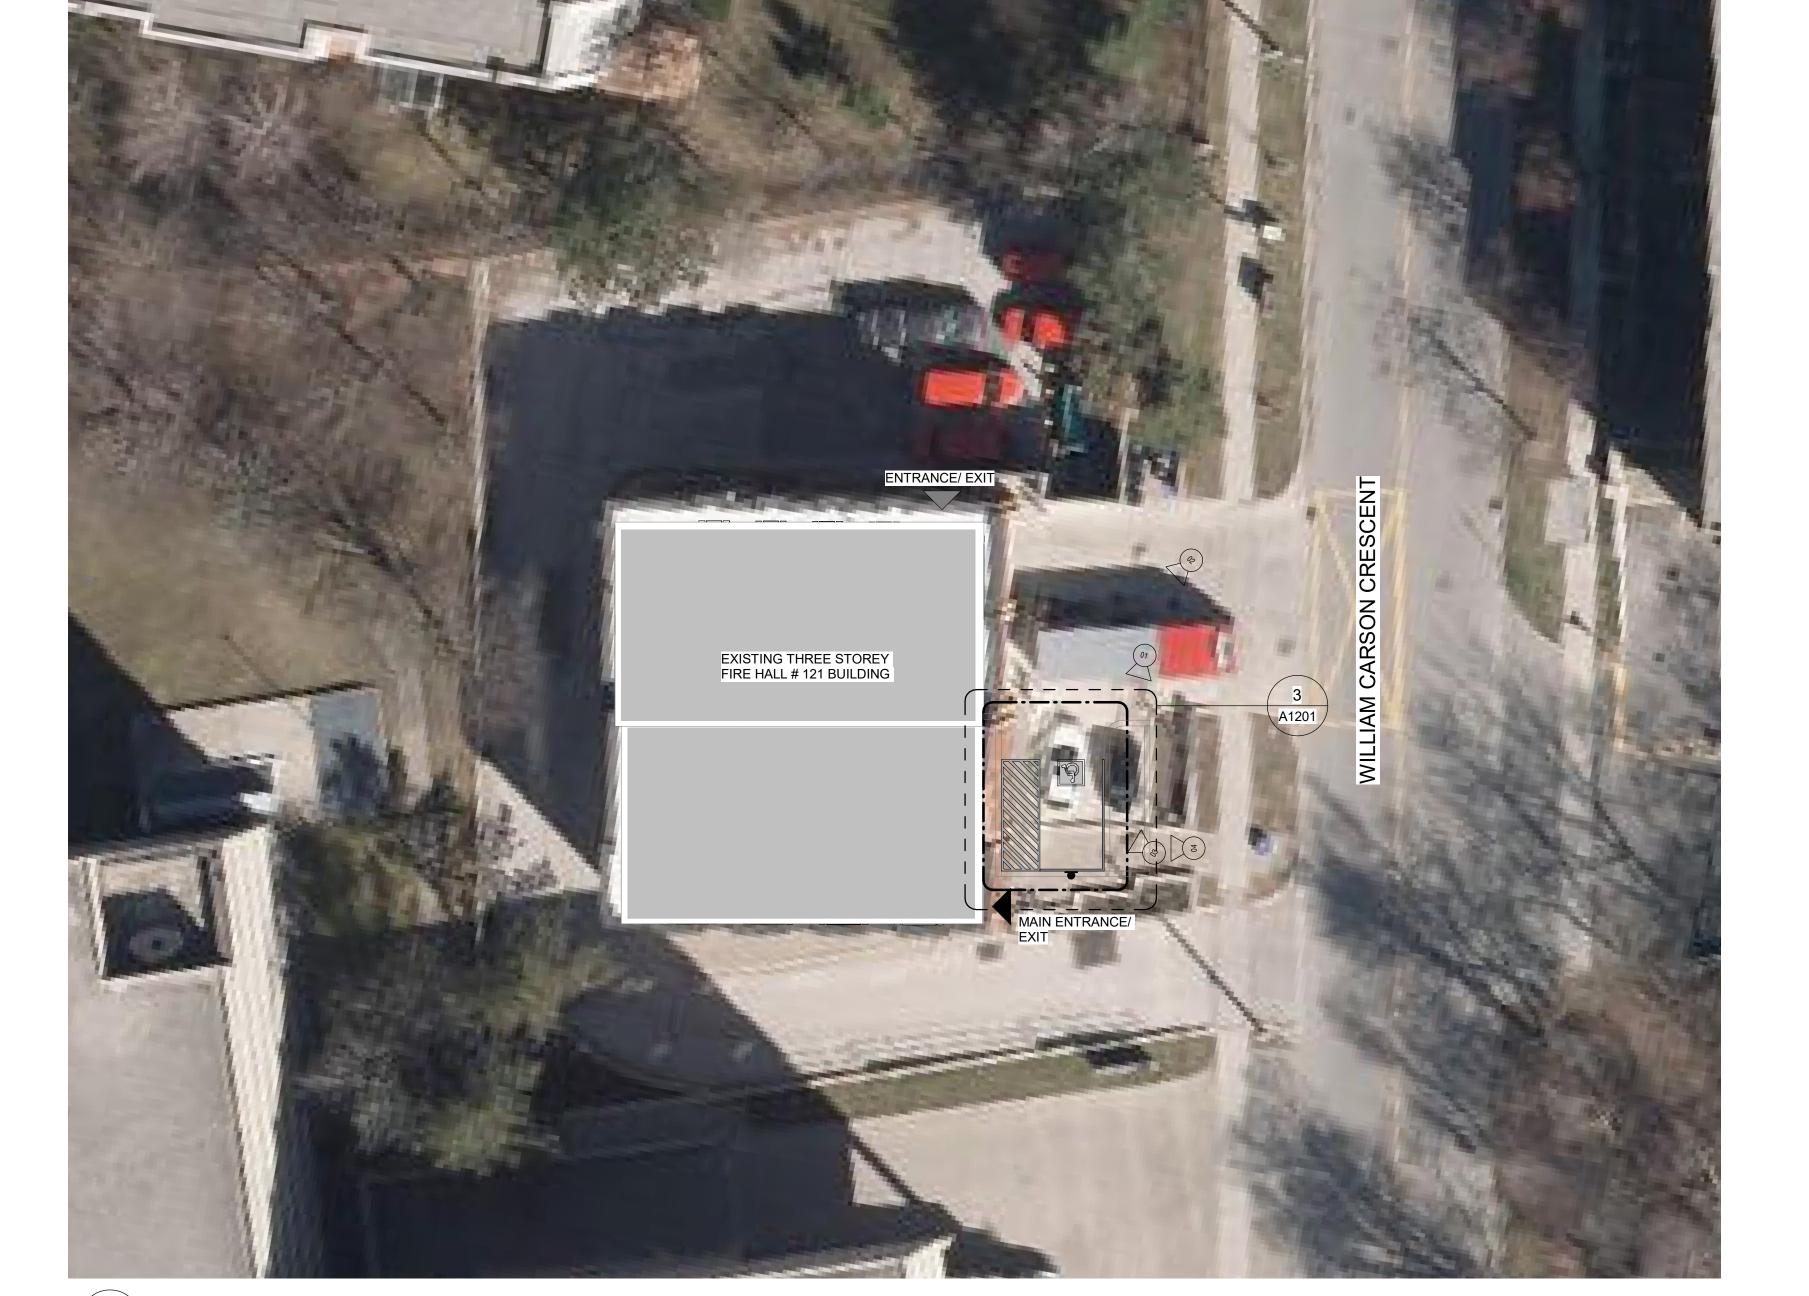

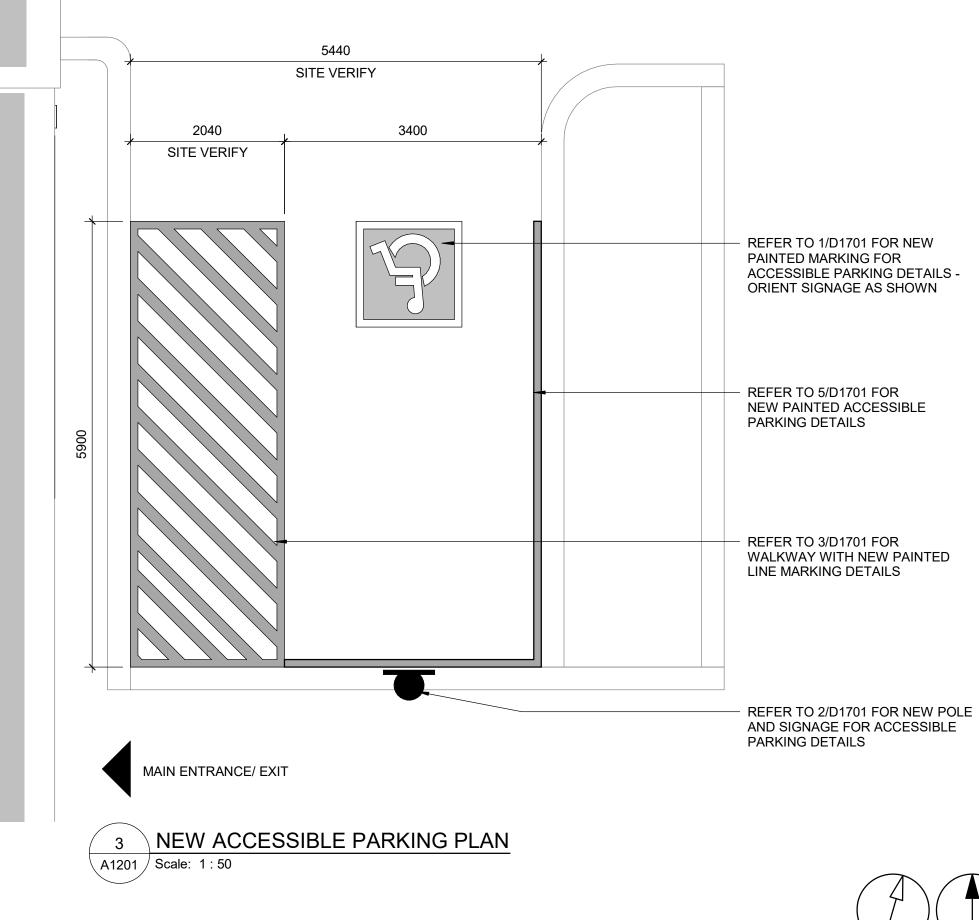

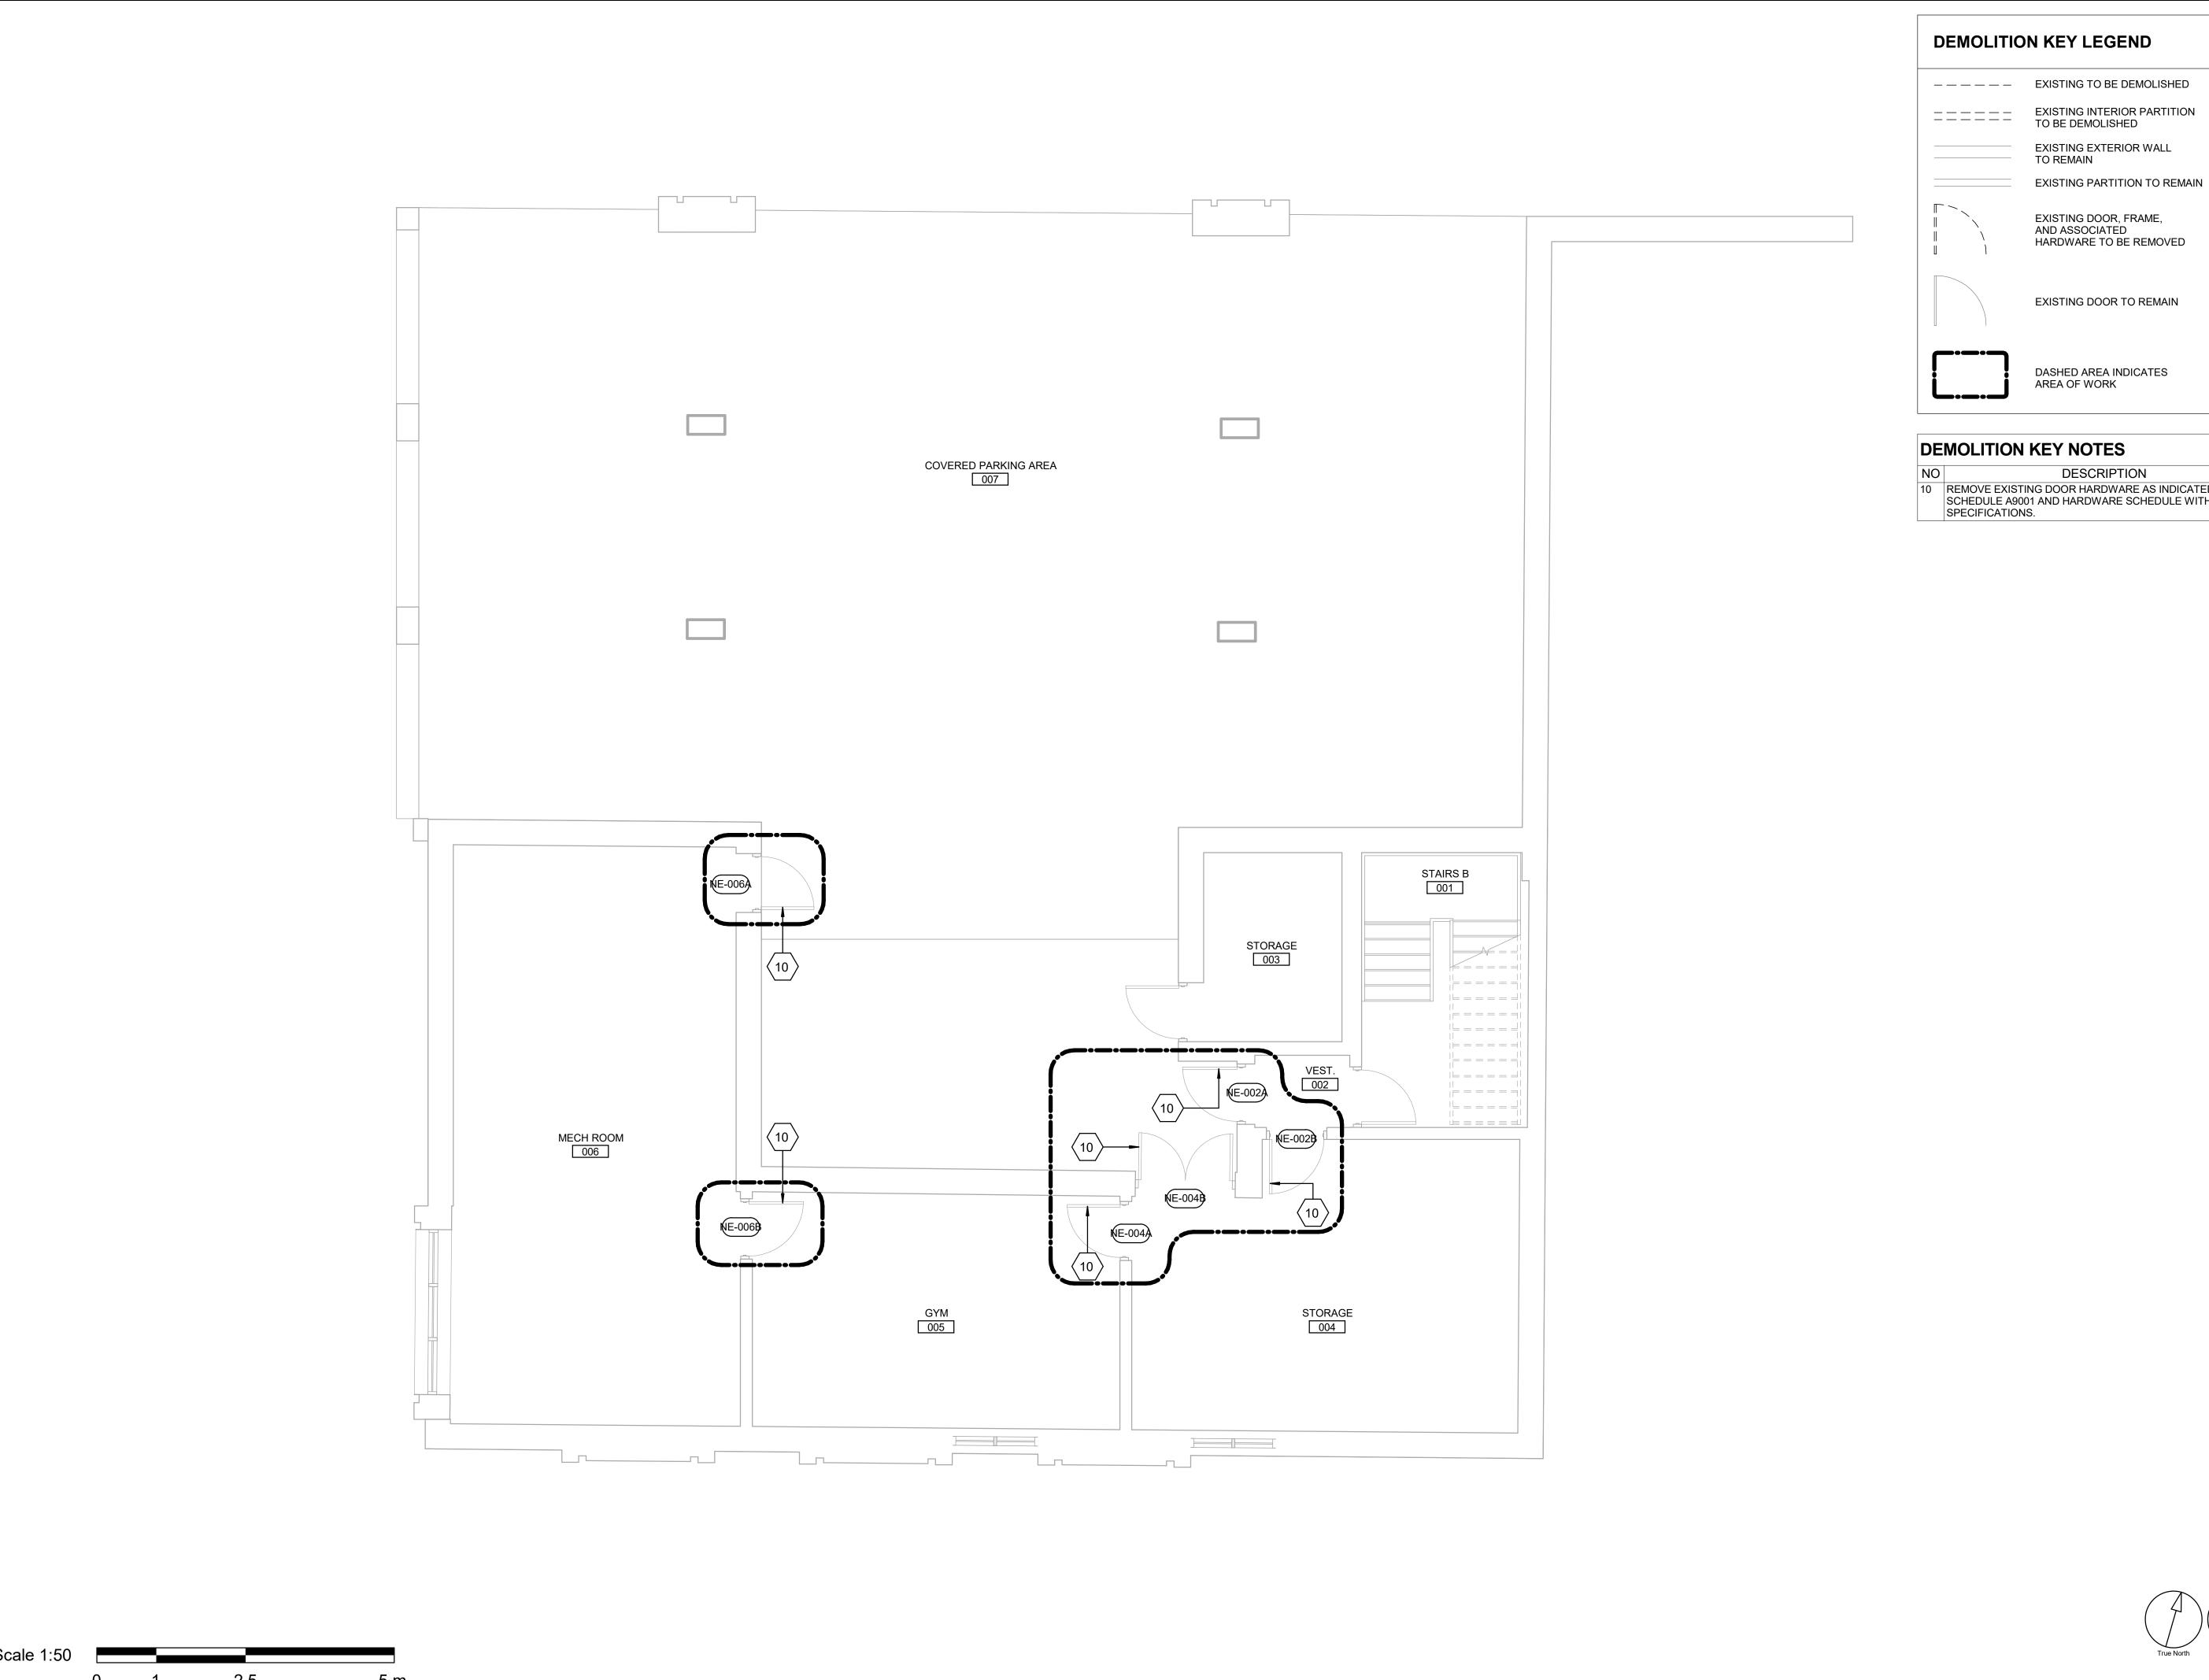

10 REMOVE EXISTING DOOR HARDWARE AS INDICATED IN DOOR SCHEDULE A9001 AND HARDWARE SCHEDULE WITHIN

CLIENT

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D	ISSUED FOR TENDER	2025-04-11				

KEYPLAN

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PROJECT TITLE
CITY OF TORONTO ACCESSIBILITY UPGRADES

PROJECT ADDRESS


FIRE HALL NO. 121 10 WILLIAM CARSON CRESCENT

PROJECT NO: 9119-19-0162 / <b>Arca</b> d	lis 30279056
0110 10 010277 (10ad	113 0027 3000
DRAWN BY:	CHECKED BY:
A. SUNIL	K. TILAHUN

PROJECT MGR: F. BOLOURIAN

APPROVED BY: **E. FENUTA** SHEET TITLE BASEMENT DEMOLITION PLAN

G05-001-A2001 D

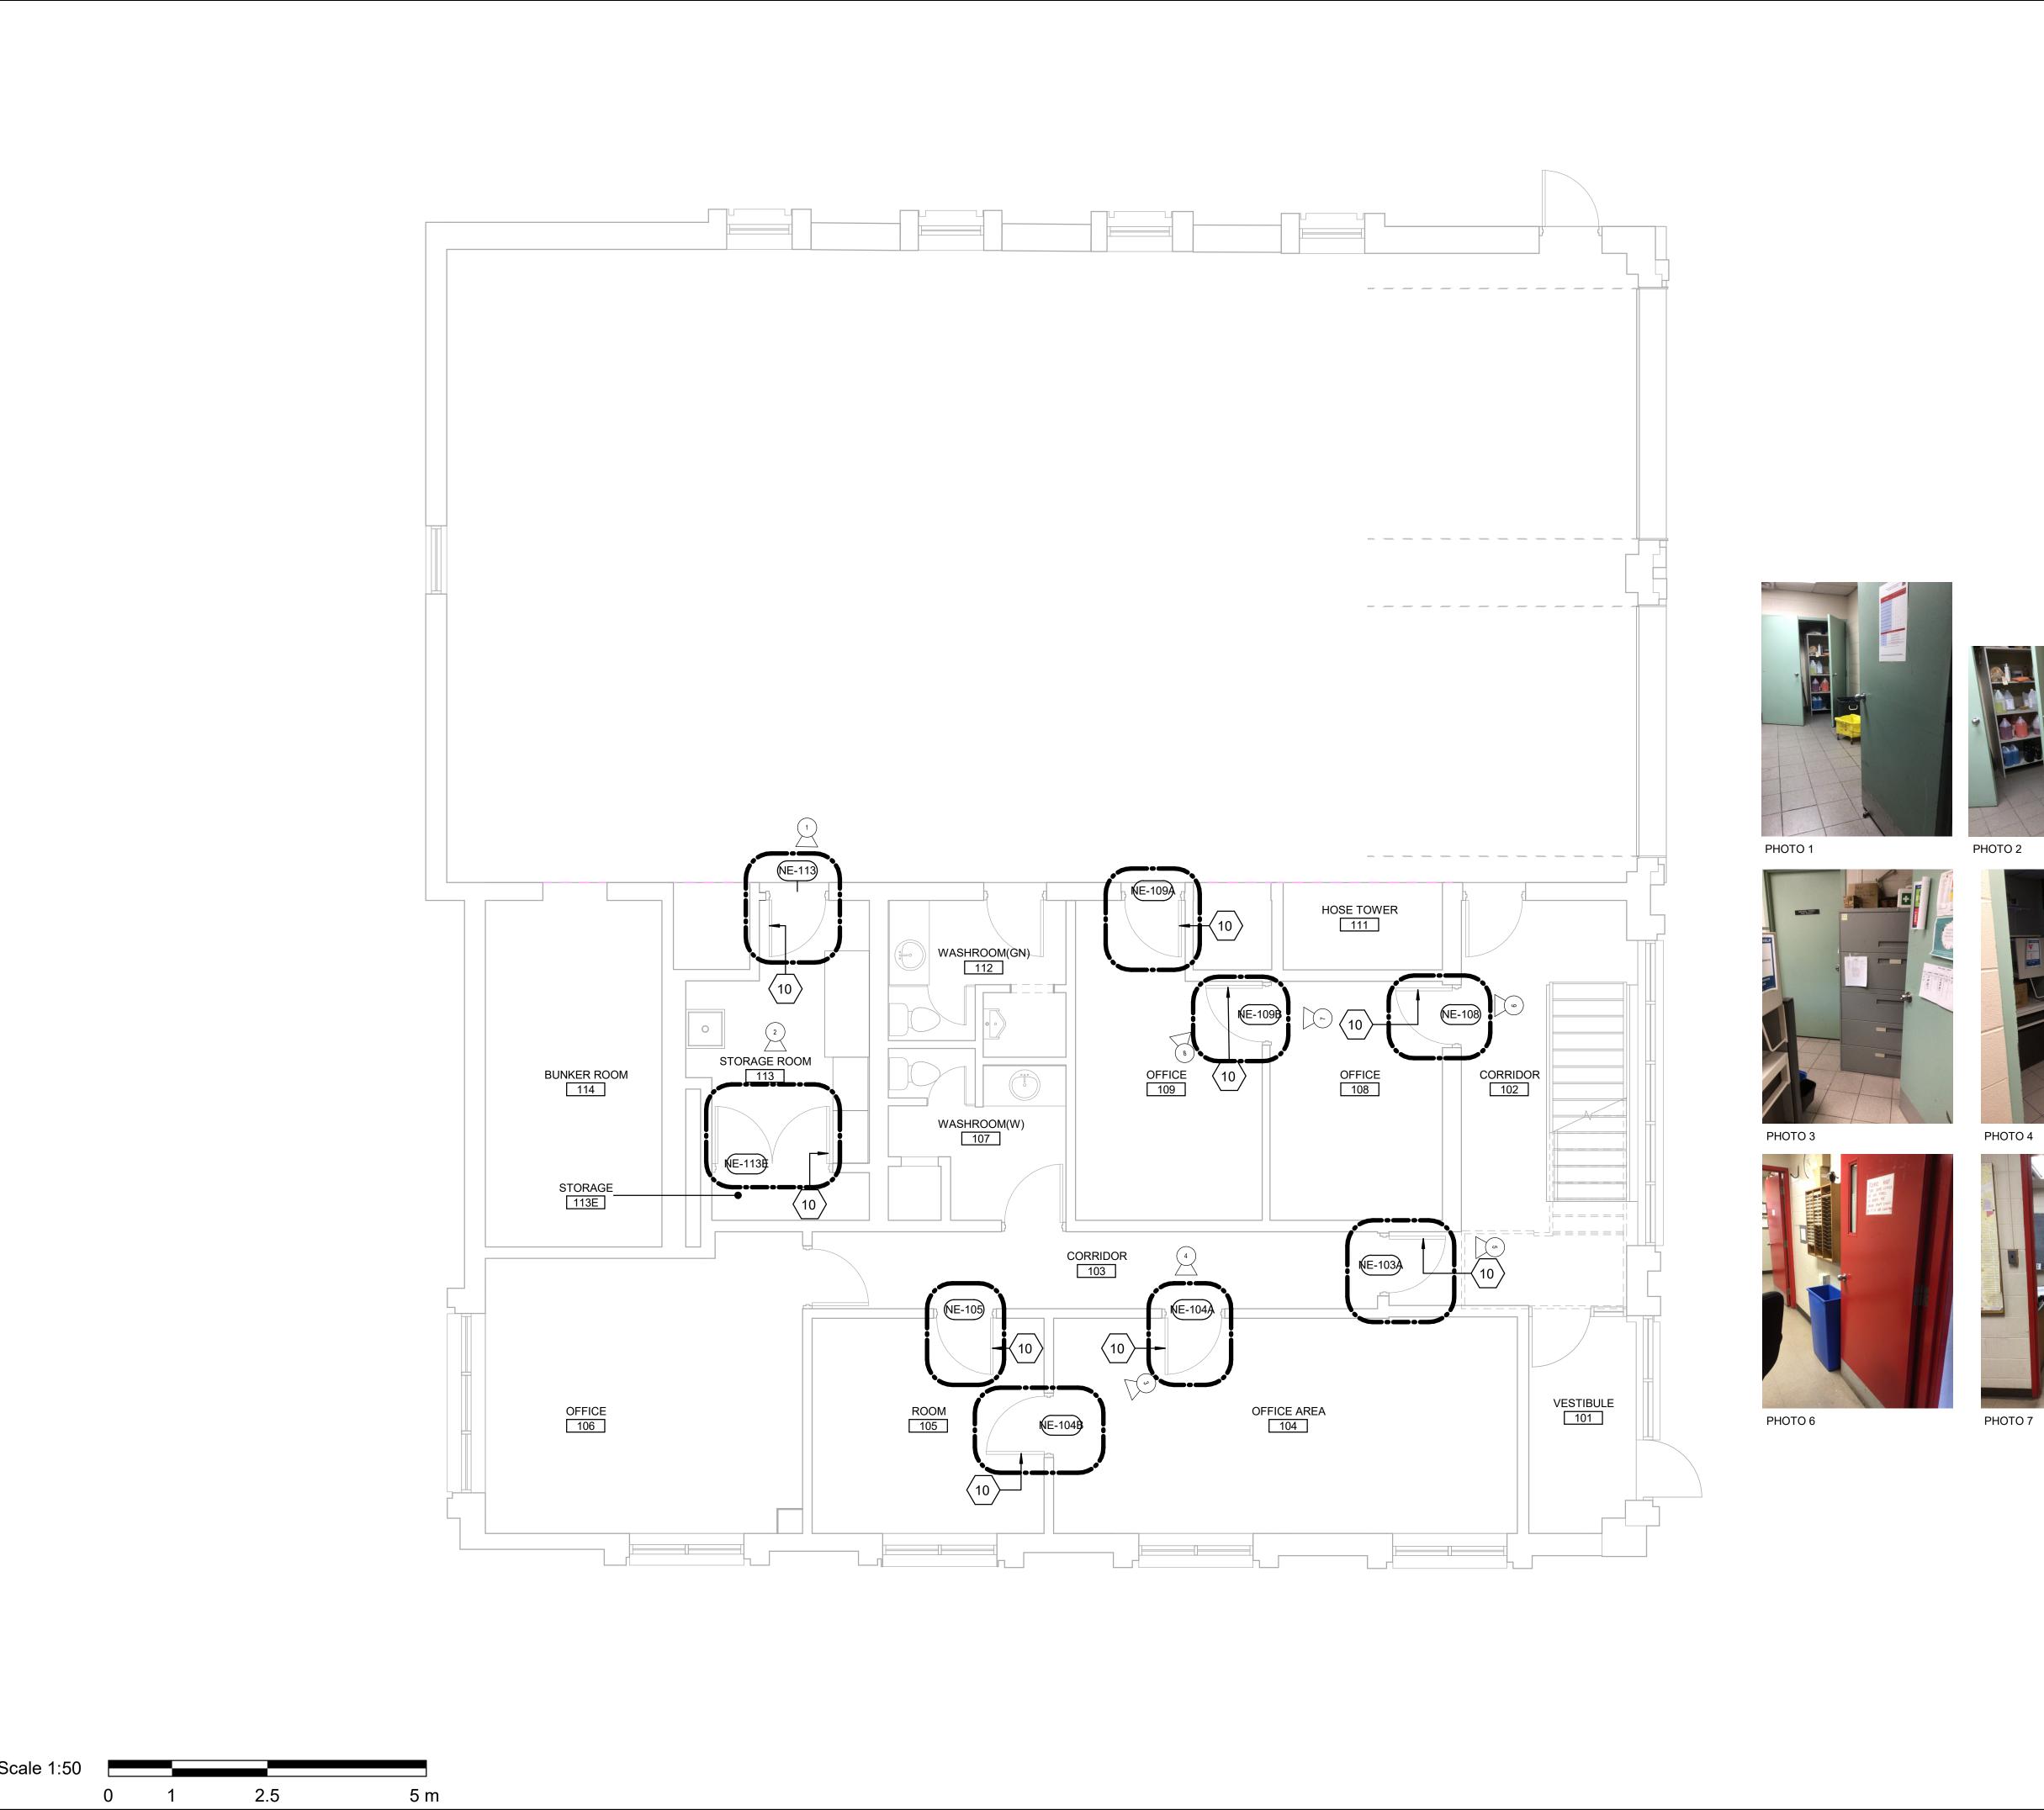

# **DEMOLITION KEY LEGEND**

---- EXISTING TO BE DEMOLISHED


EXISTING INTERIOR PARTITION TO BE DEMOLISHED

EXISTING EXTERIOR WALL TO REMAIN

EXISTING PARTITION TO REMAIN

EXISTING DOOR, FRAME, AND ASSOCIATED HARDWARE TO BE REMOVED

EXISTING DOOR TO REMAIN

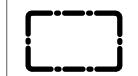


DASHED AREA INDICATES AREA OF WORK

## **DEMOLITION KEY NOTES**

DESCRIPTION

10 REMOVE EXISTING DOOR HARDWARE AS INDICATED IN DOOR SCHEDULE A9001 AND HARDWARE SCHEDULE WITHIN SPECIFICATIONS.



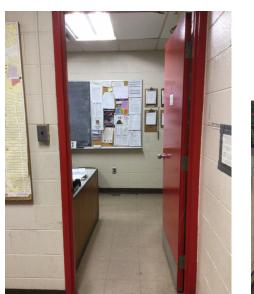



РНОТО 8

PHOTO 5

CLIENT

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С	ISSUED FOR PERMIT	2022-03-18
D	ISSUED FOR TENDER	2025-04-11

KEYPLAN

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PROJECT ADDRESS

PROJECT MGR:

FIRE HALL NO. 121 10 WILLIAM CARSON CRESCENT


PROJECT NO:	
9119-19-0162 / <b>Arca</b> c	lis 30279056
DRAWN BY:	CHECKED BY: K. TILAHUN
A. SUNIL	K. TILAHUN


F. BOLOURIAN E. FENUTA SHEET TITLE

FIRST FLOOR **DEMOLITION PLAN** 

APPROVED BY:

SHEET NUMBER G05-001-A2011

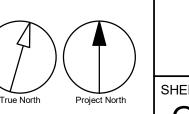

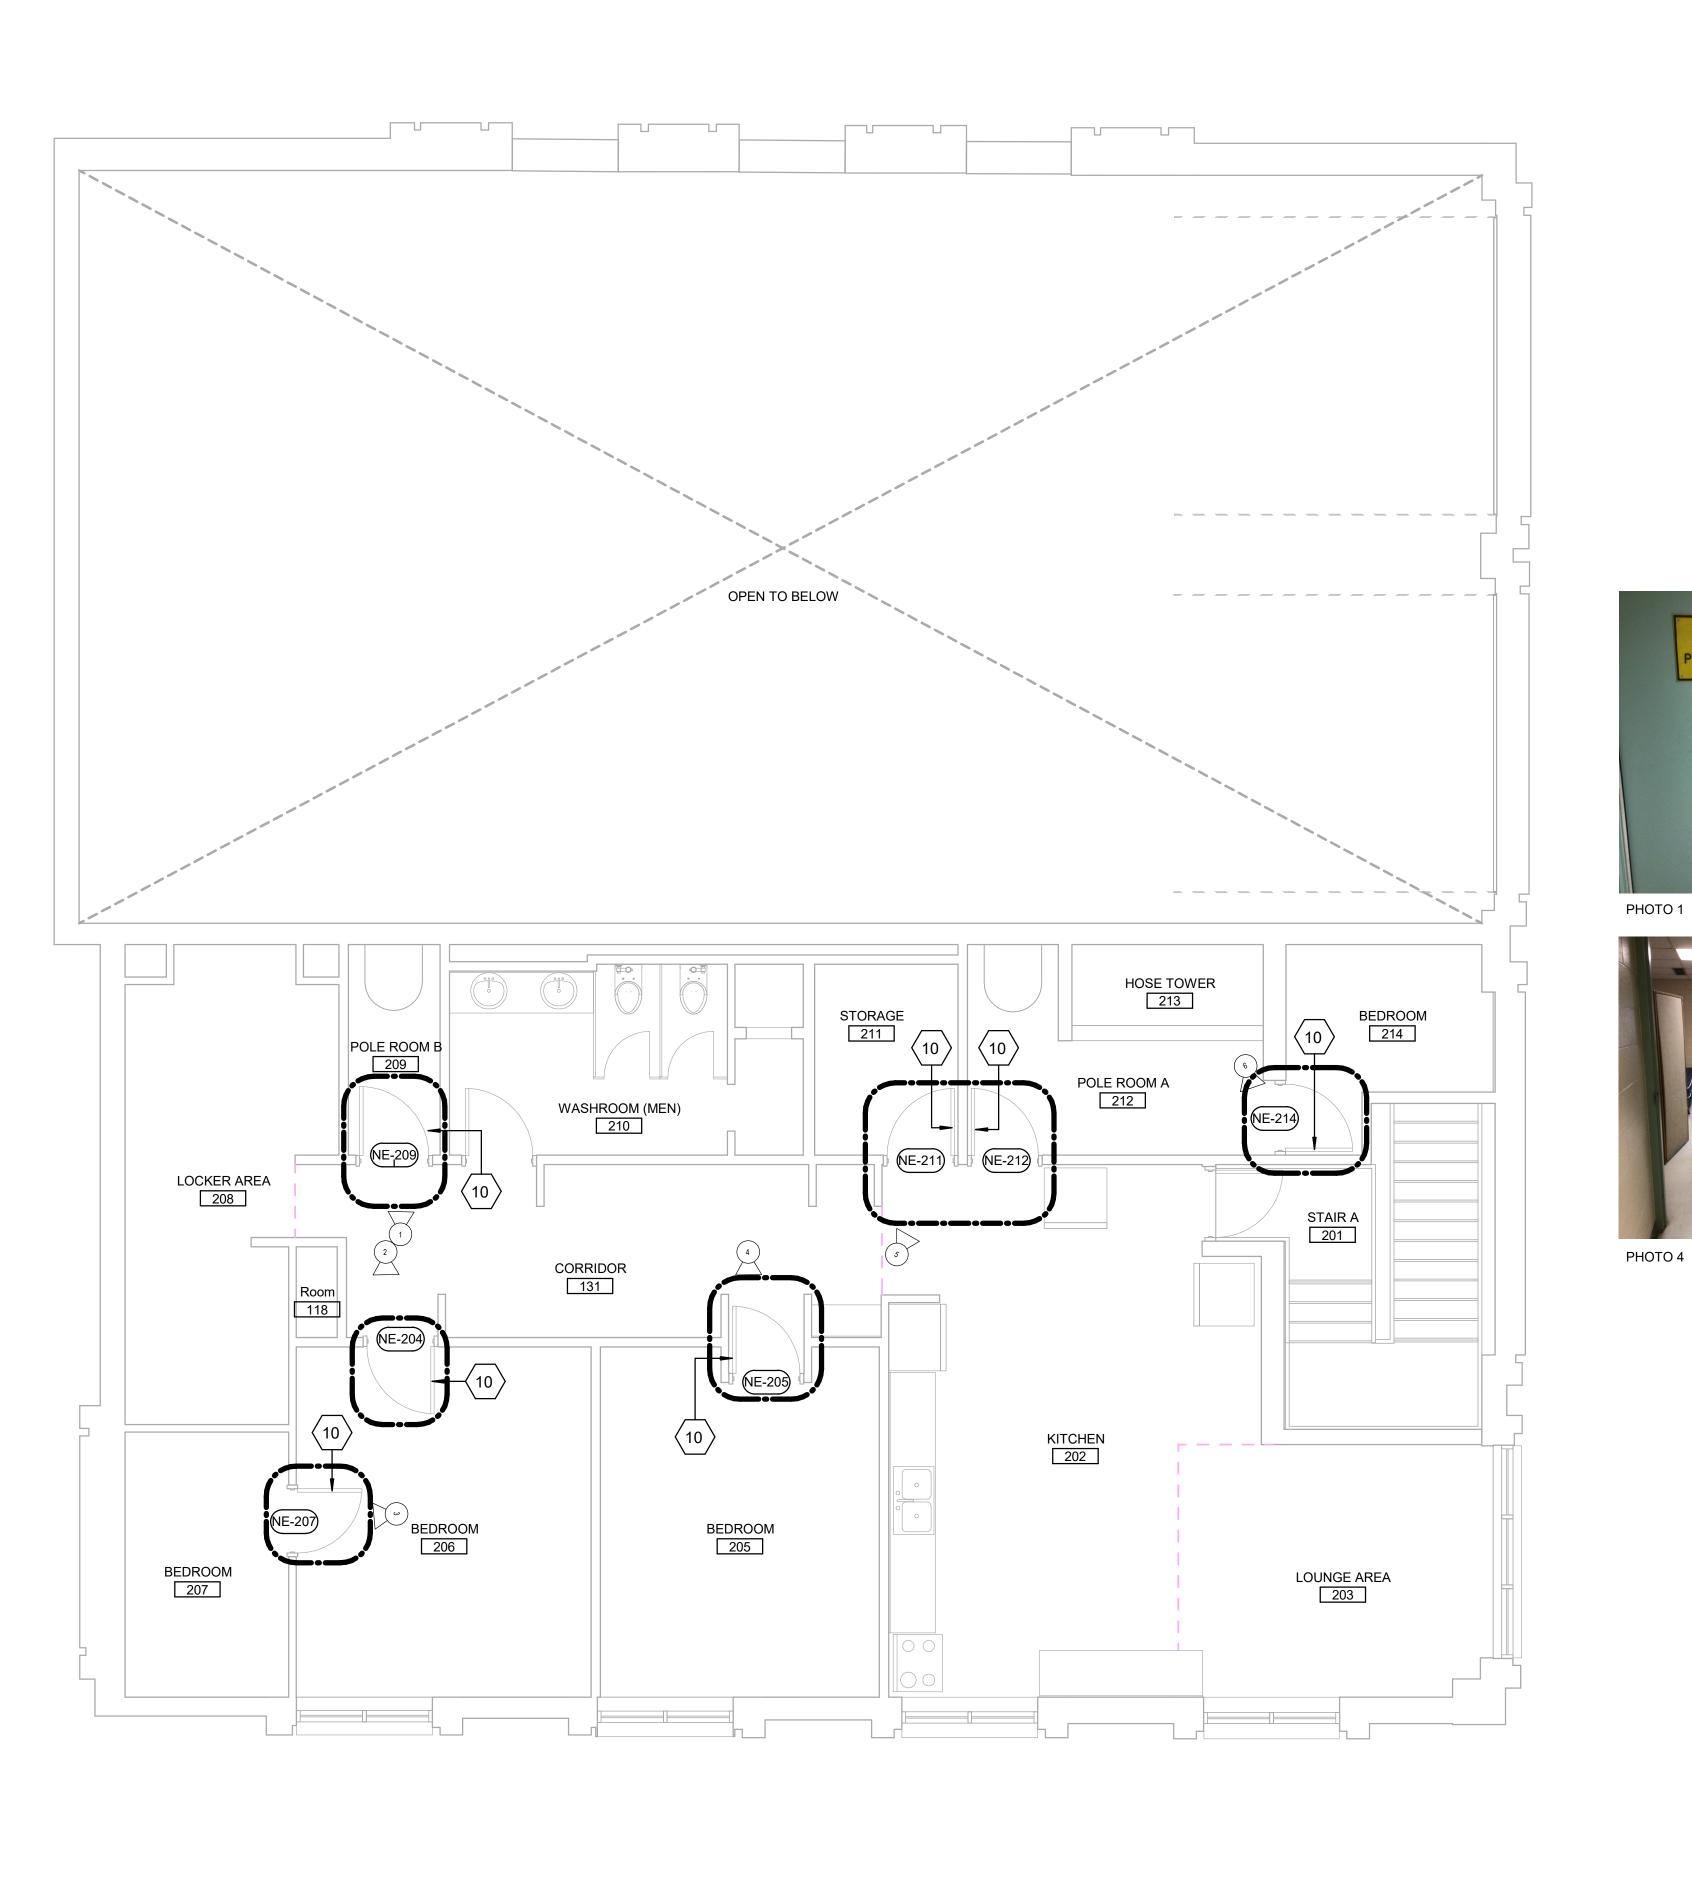

#### **DEMOLITION KEY LEGEND**

---- EXISTING TO BE DEMOLISHED


EXISTING INTERIOR PARTITION TO BE DEMOLISHED

EXISTING EXTERIOR WALL TO REMAIN

EXISTING PARTITION TO REMAIN

EXISTING DOOR, FRAME, AND ASSOCIATED HARDWARE TO BE REMOVED

EXISTING DOOR TO REMAIN

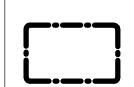

DASHED AREA INDICATES AREA OF WORK

### **DEMOLITION KEY NOTES**

DESCRIPTION

РНОТО 3

10 REMOVE EXISTING DOOR HARDWARE AS INDICATED IN DOOR SCHEDULE A9001 AND HARDWARE SCHEDULE WITHIN SPECIFICATIONS.











PHOTO 5

PHOTO 6

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Arcadis Professional Services (Canada) Inc.										
ISSUES										
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D	ISSUED FOR TENDER	2025-04-11								

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PROJECT ADDRESS

FIRE HALL NO. 121 10 WILLIAM CARSON CRESCENT

PROJECT NO: 9119-19-0162 / Arcadis 30279056 CHECKED BY: K. TILAHUN DRAWN BY: A. SUNIL


PROJECT MGR: F. BOLOURIAN SHEET TITLE

SECOND FLOOR **DEMOLITION PLAN** 

APPROVED BY: **E. FENUTA** 

SHEET NUMBER

G05-001-A2021

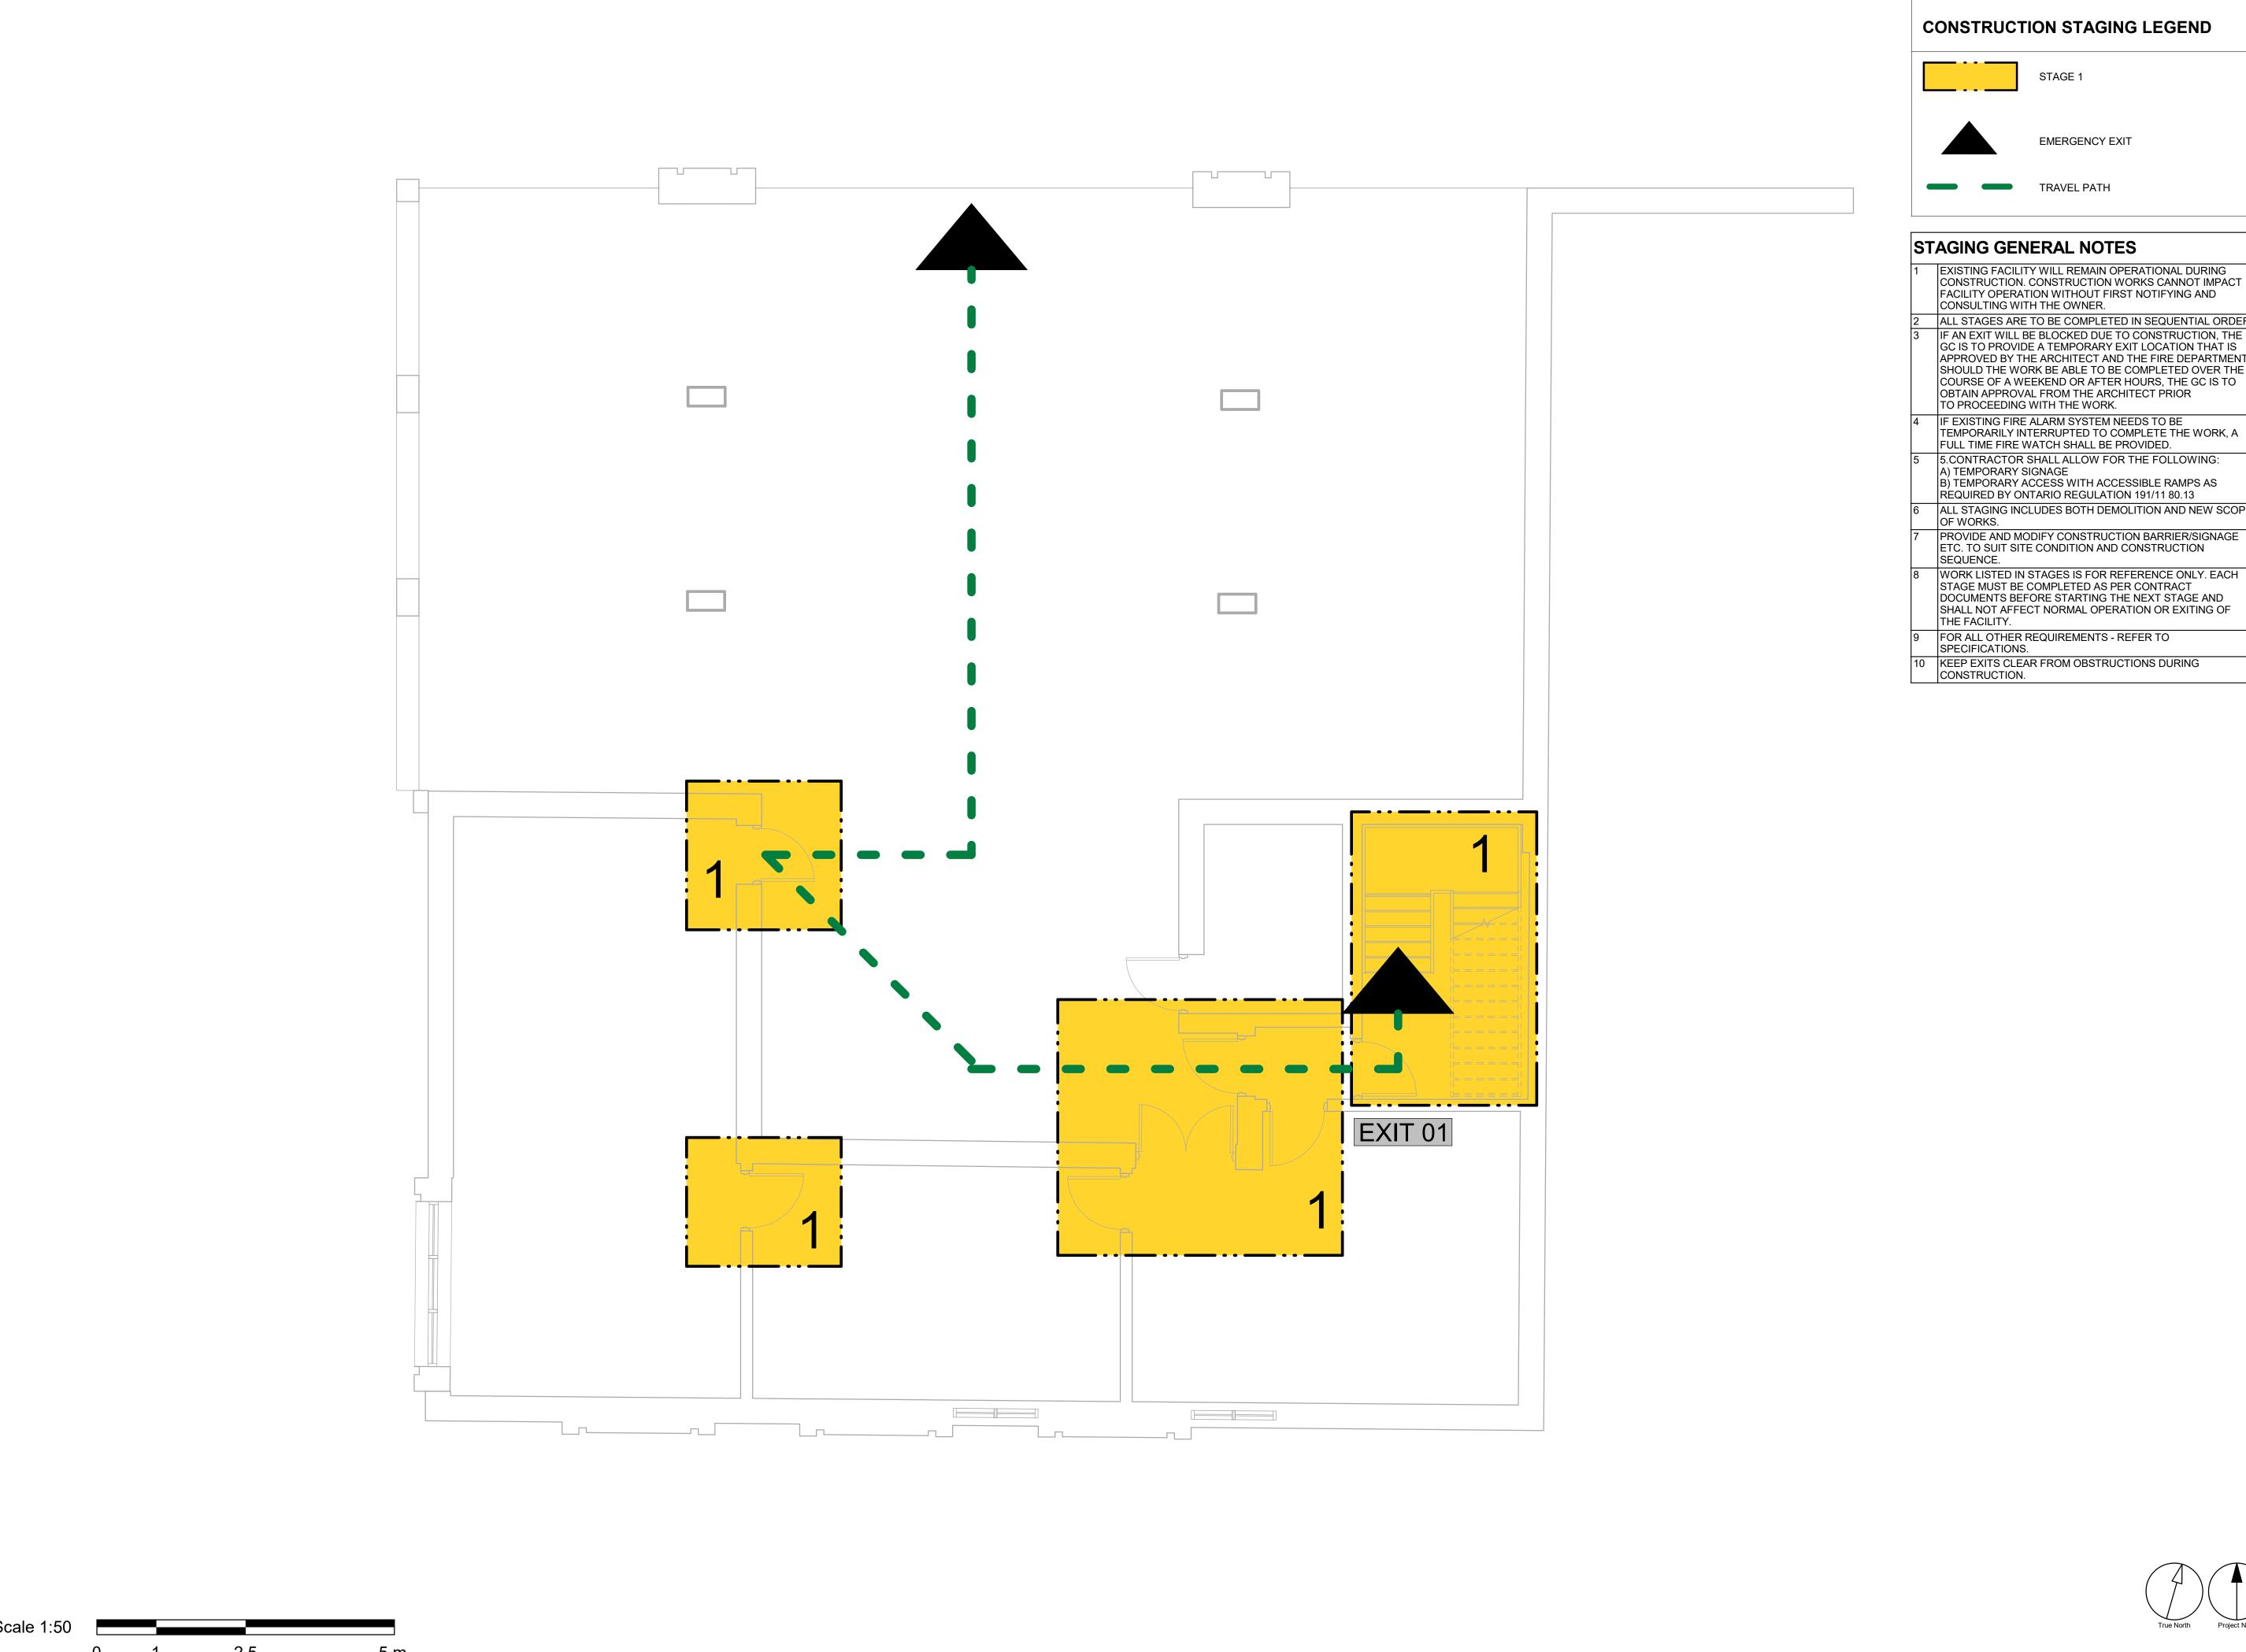

EXISTING FACILITY WILL REMAIN OPERATIONAL DURING CONSTRUCTION. CONSTRUCTION WORKS CANNOT IMPACT FACILITY OPERATION WITHOUT FIRST NOTIFYING AND

2 ALL STAGES ARE TO BE COMPLETED IN SEQUENTIAL ORDER. IF AN EXIT WILL BE BLOCKED DUE TO CONSTRUCTION, THE GC IS TO PROVIDE A TEMPORARY EXIT LOCATION THAT IS APPROVED BY THE ARCHITECT AND THE FIRE DEPARTMENT. SHOULD THE WORK BE ABLE TO BE COMPLETED OVER THE COURSE OF A WEEKEND OR AFTER HOURS, THE GC IS TO OBTAIN APPROVAL FROM THE ARCHITECT PRIOR

IF EXISTING FIRE ALARM SYSTEM NEEDS TO BE TEMPORARILY INTERRUPTED TO COMPLETE THE WORK, A FULL TIME FIRE WATCH SHALL BE PROVIDED.

B) TEMPORARY ACCESS WITH ACCESSIBLE RAMPS AS RÉQUIRED BY ONTARIO REGULATION 191/11 80.13

ALL STAGING INCLUDES BOTH DEMOLITION AND NEW SCOPE

PROVIDE AND MODIFY CONSTRUCTION BARRIER/SIGNAGE ETC. TO SUIT SITE CONDITION AND CONSTRUCTION

STAGE MUST BE COMPLETED AS PER CONTRACT DOCUMENTS BEFORE STARTING THE NEXT STAGE AND SHALL NOT AFFECT NORMAL OPERATION OR EXITING OF

FOR ALL OTHER REQUIREMENTS - REFER TO

KEEP EXITS CLEAR FROM OBSTRUCTIONS DURING

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KEYPLAN

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PROJECT TITLE CITY OF TORONTO ACCESSIBILITY UPGRADES

PROJECT ADDRESS


FIRE HALL NO. 121 10 WILLIAM CARSON CRESCENT

PROJECT NO: 9119-19-0162 / Arcadis 30279056								
DRAWN BY: <b>A. SUNIL</b>	CHECKED BY: K. TILAHUN							

PROJECT MGR: APPROVED BY: F. BOLOURIAN E. FENUTA SHEET TITLE

**BASEMENT STAGING** PLAN

SHEET NUMBER G05-001-A2101 D

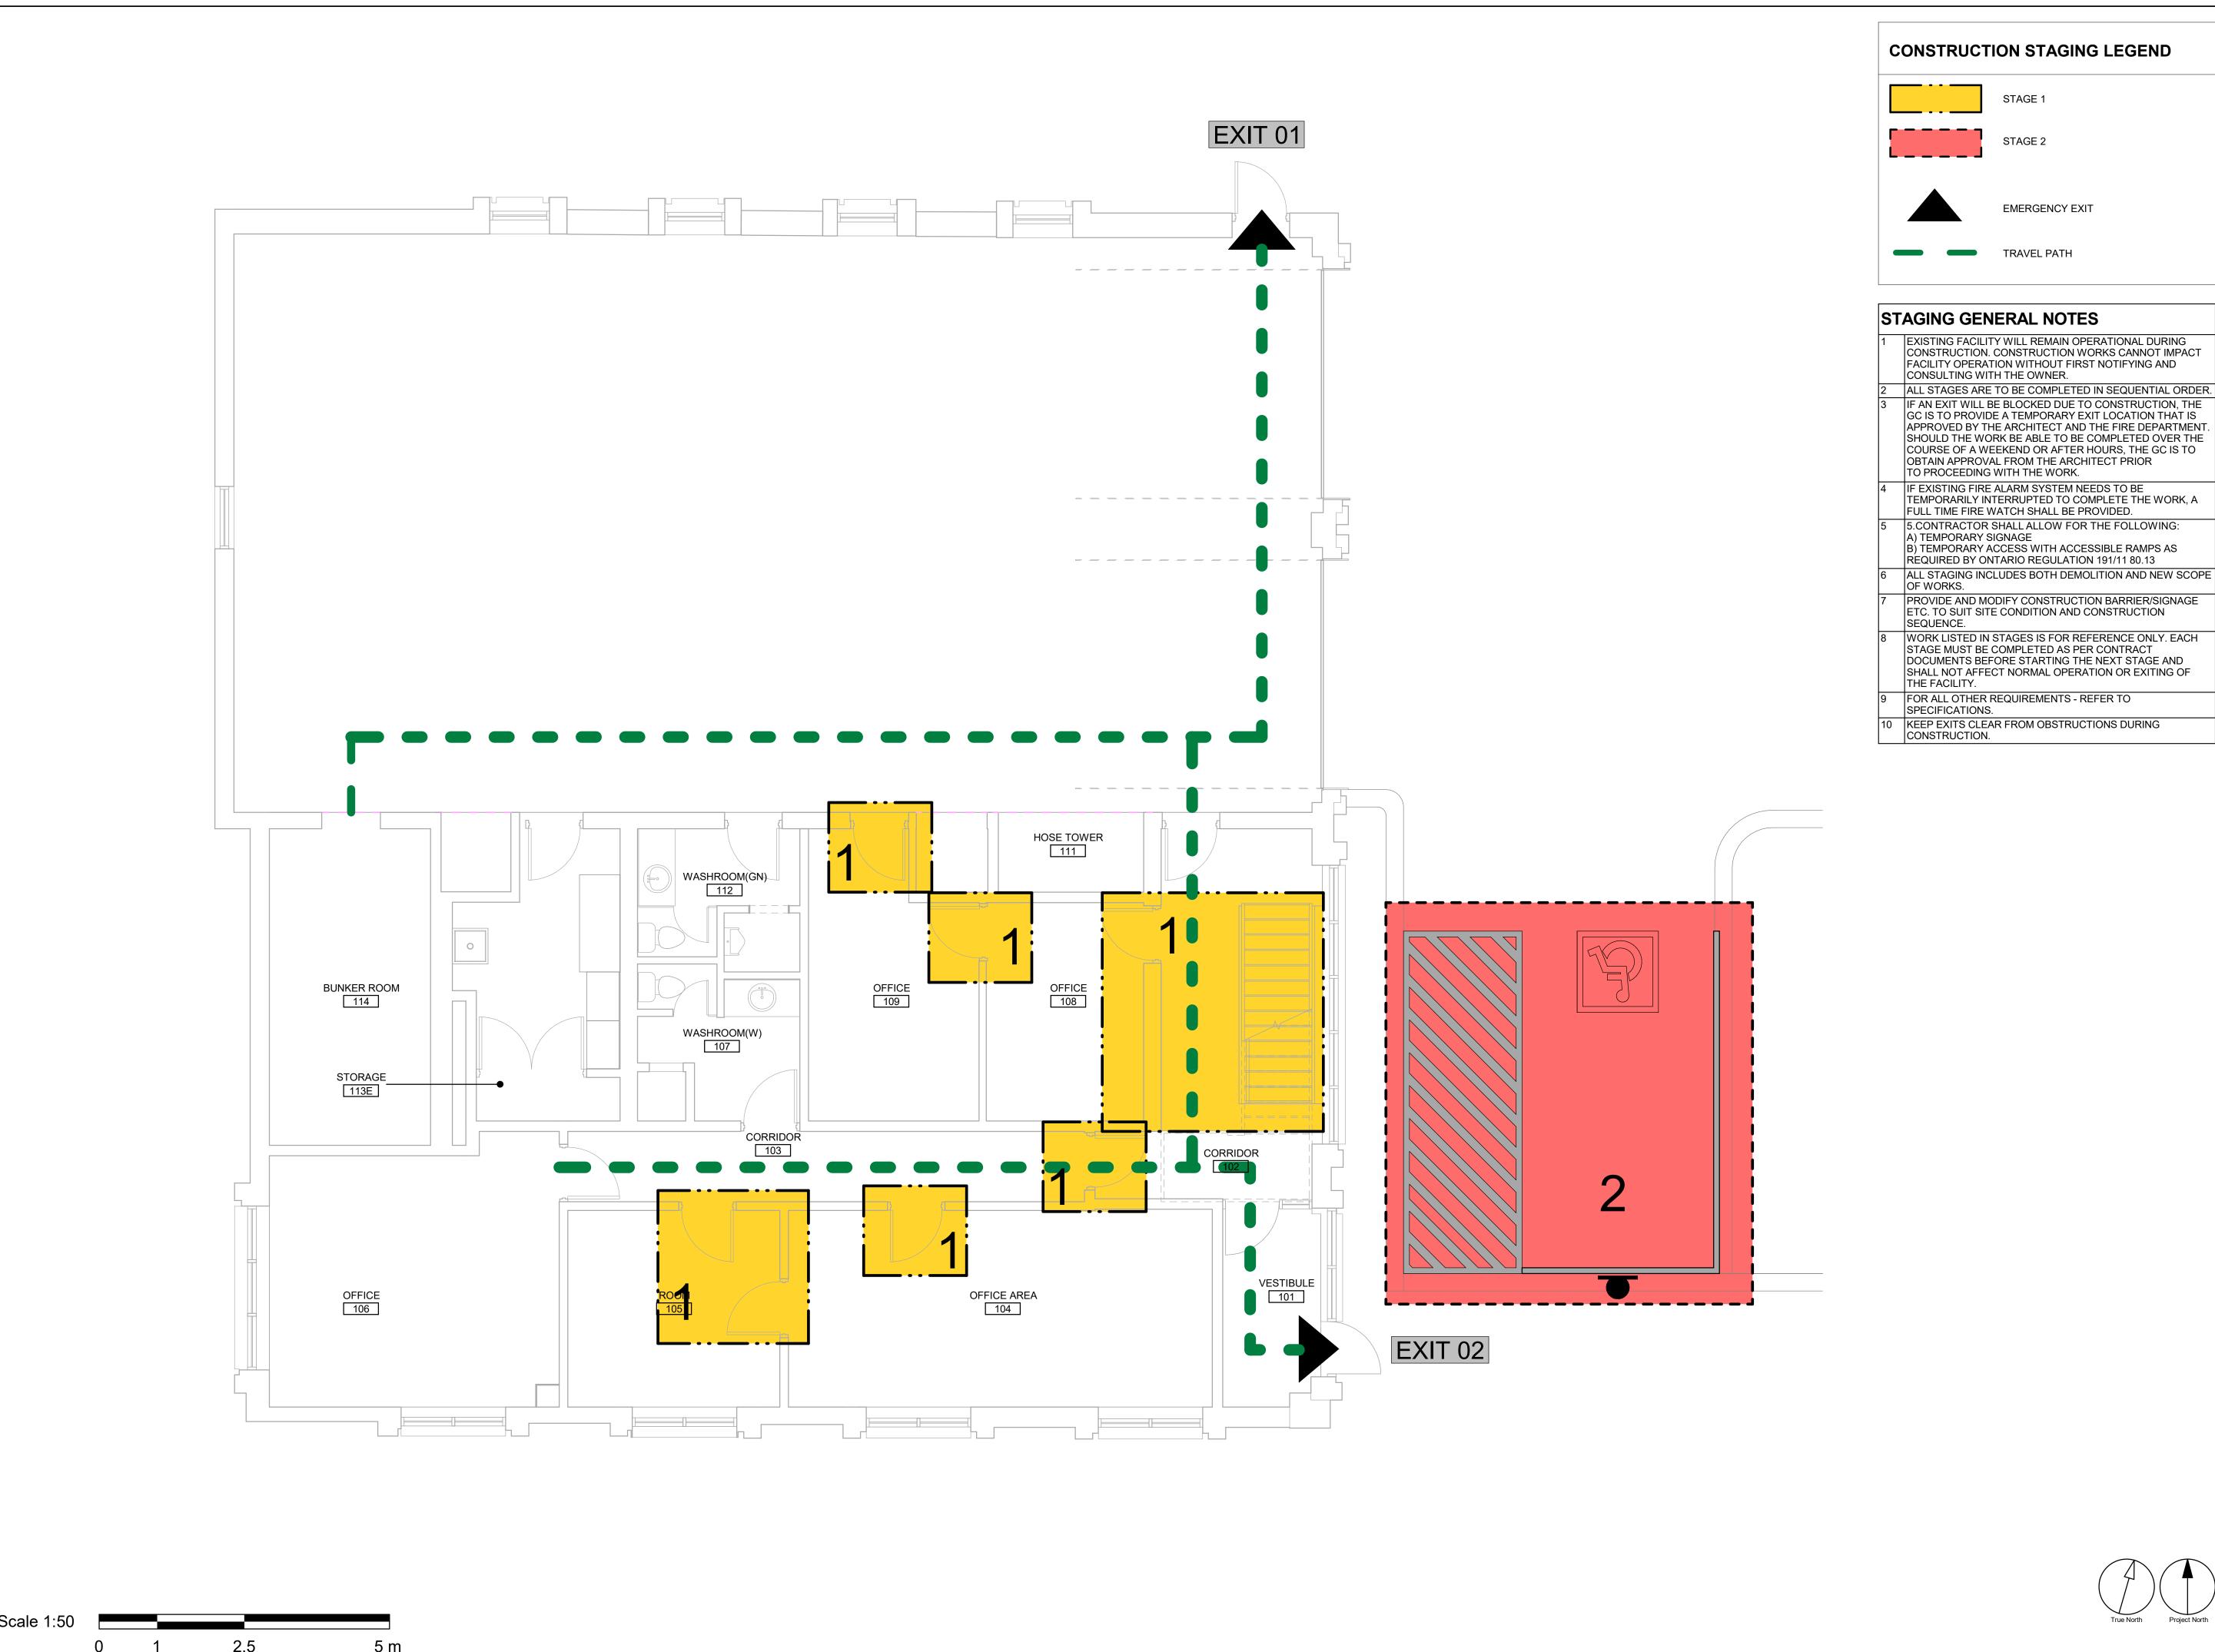

CONSTRUCTION. CONSTRUCTION WORKS CANNOT IMPACT

IF AN EXIT WILL BE BLOCKED DUE TO CONSTRUCTION, THE GC IS TO PROVIDE A TEMPORARY EXIT LOCATION THAT IS APPROVED BY THE ARCHITECT AND THE FIRE DEPARTMENT. SHOULD THE WORK BE ABLE TO BE COMPLETED OVER THE COURSE OF A WEEKEND OR AFTER HOURS, THE GC IS TO

TEMPORARILY INTERRUPTED TO COMPLETE THE WORK, A

B) TEMPORARY ACCESS WITH ACCESSIBLE RAMPS AS

PROVIDE AND MODIFY CONSTRUCTION BARRIER/SIGNAGE

WORK LISTED IN STAGES IS FOR REFERENCE ONLY. EACH DOCUMENTS BEFORE STARTING THE NEXT STAGE AND SHALL NOT AFFECT NORMAL OPERATION OR EXITING OF

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DRAWN BY: <b>A. SUNIL</b>	CHECKED BY:  K. TILAHUN
A. SUNIL	K. HLAHUN

PROJECT MGR: APPROVED BY: E. FENUTA F. BOLOURIAN SHEET TITLE

FIRST FLOOR STAGING PLAN

SHEET NUMBER G05-001-A2111 D



#### **CONSTRUCTION STAGING LEGEND**

STAGE 1



EMERGENCY EXIT

TRAVEL PATH

#### STAGING GENERAL NOTES

- EXISTING FACILITY WILL REMAIN OPERATIONAL DURING CONSTRUCTION. CONSTRUCTION WORKS CANNOT IMPACT FACILITY OPERATION WITHOUT FIRST NOTIFYING AND CONSULTING WITH THE OWNER.
- ALL STAGES ARE TO BE COMPLETED IN SEQUENTIAL ORDER.

  IF AN EXIT WILL BE BLOCKED DUE TO CONSTRUCTION, THE GC IS TO PROVIDE A TEMPORARY EXIT LOCATION THAT IS APPROVED BY THE ARCHITECT AND THE FIRE DEPARTMENT. SHOULD THE WORK BE ABLE TO BE COMPLETED OVER THE COURSE OF A WEEKEND OR AFTER HOURS, THE GC IS TO OBTAIN APPROVAL FROM THE ARCHITECT PRIOR TO PROCEEDING WITH THE WORK.
- IF EXISTING FIRE ALARM SYSTEM NEEDS TO BE TEMPORARILY INTERRUPTED TO COMPLETE THE WORK, A FULL TIME FIRE WATCH SHALL BE PROVIDED.
- 5 5.CONTRACTOR SHALL ALLOW FOR THE FOLLOWING:
  A) TEMPORARY SIGNAGE
  B) TEMPORARY ACCESS WITH ACCESSIBLE RAMPS AS
- REQUIRED BY ONTARIO REGULATION 191/11 80.13
- 6 ALL STAGING INCLUDES BOTH DEMOLITION AND NEW SCOPE OF WORKS.
- 7 PROVIDE AND MODIFY CONSTRUCTION BARRIER/SIGNAGE ETC. TO SUIT SITE CONDITION AND CONSTRUCTION SEQUENCE.
- 8 WORK LISTED IN STAGES IS FOR REFERENCE ONLY. EACH STAGE MUST BE COMPLETED AS PER CONTRACT DOCUMENTS BEFORE STARTING THE NEXT STAGE AND SHALL NOT AFFECT NORMAL OPERATION OR EXITING OF THE FACILITY.
- 9 FOR ALL OTHER REQUIREMENTS REFER TO SPECIFICATIONS.
- 10 KEEP EXITS CLEAR FROM OBSTRUCTIONS DURING CONSTRUCTION.

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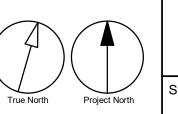
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DRAWN BY:	CHECKED BY:
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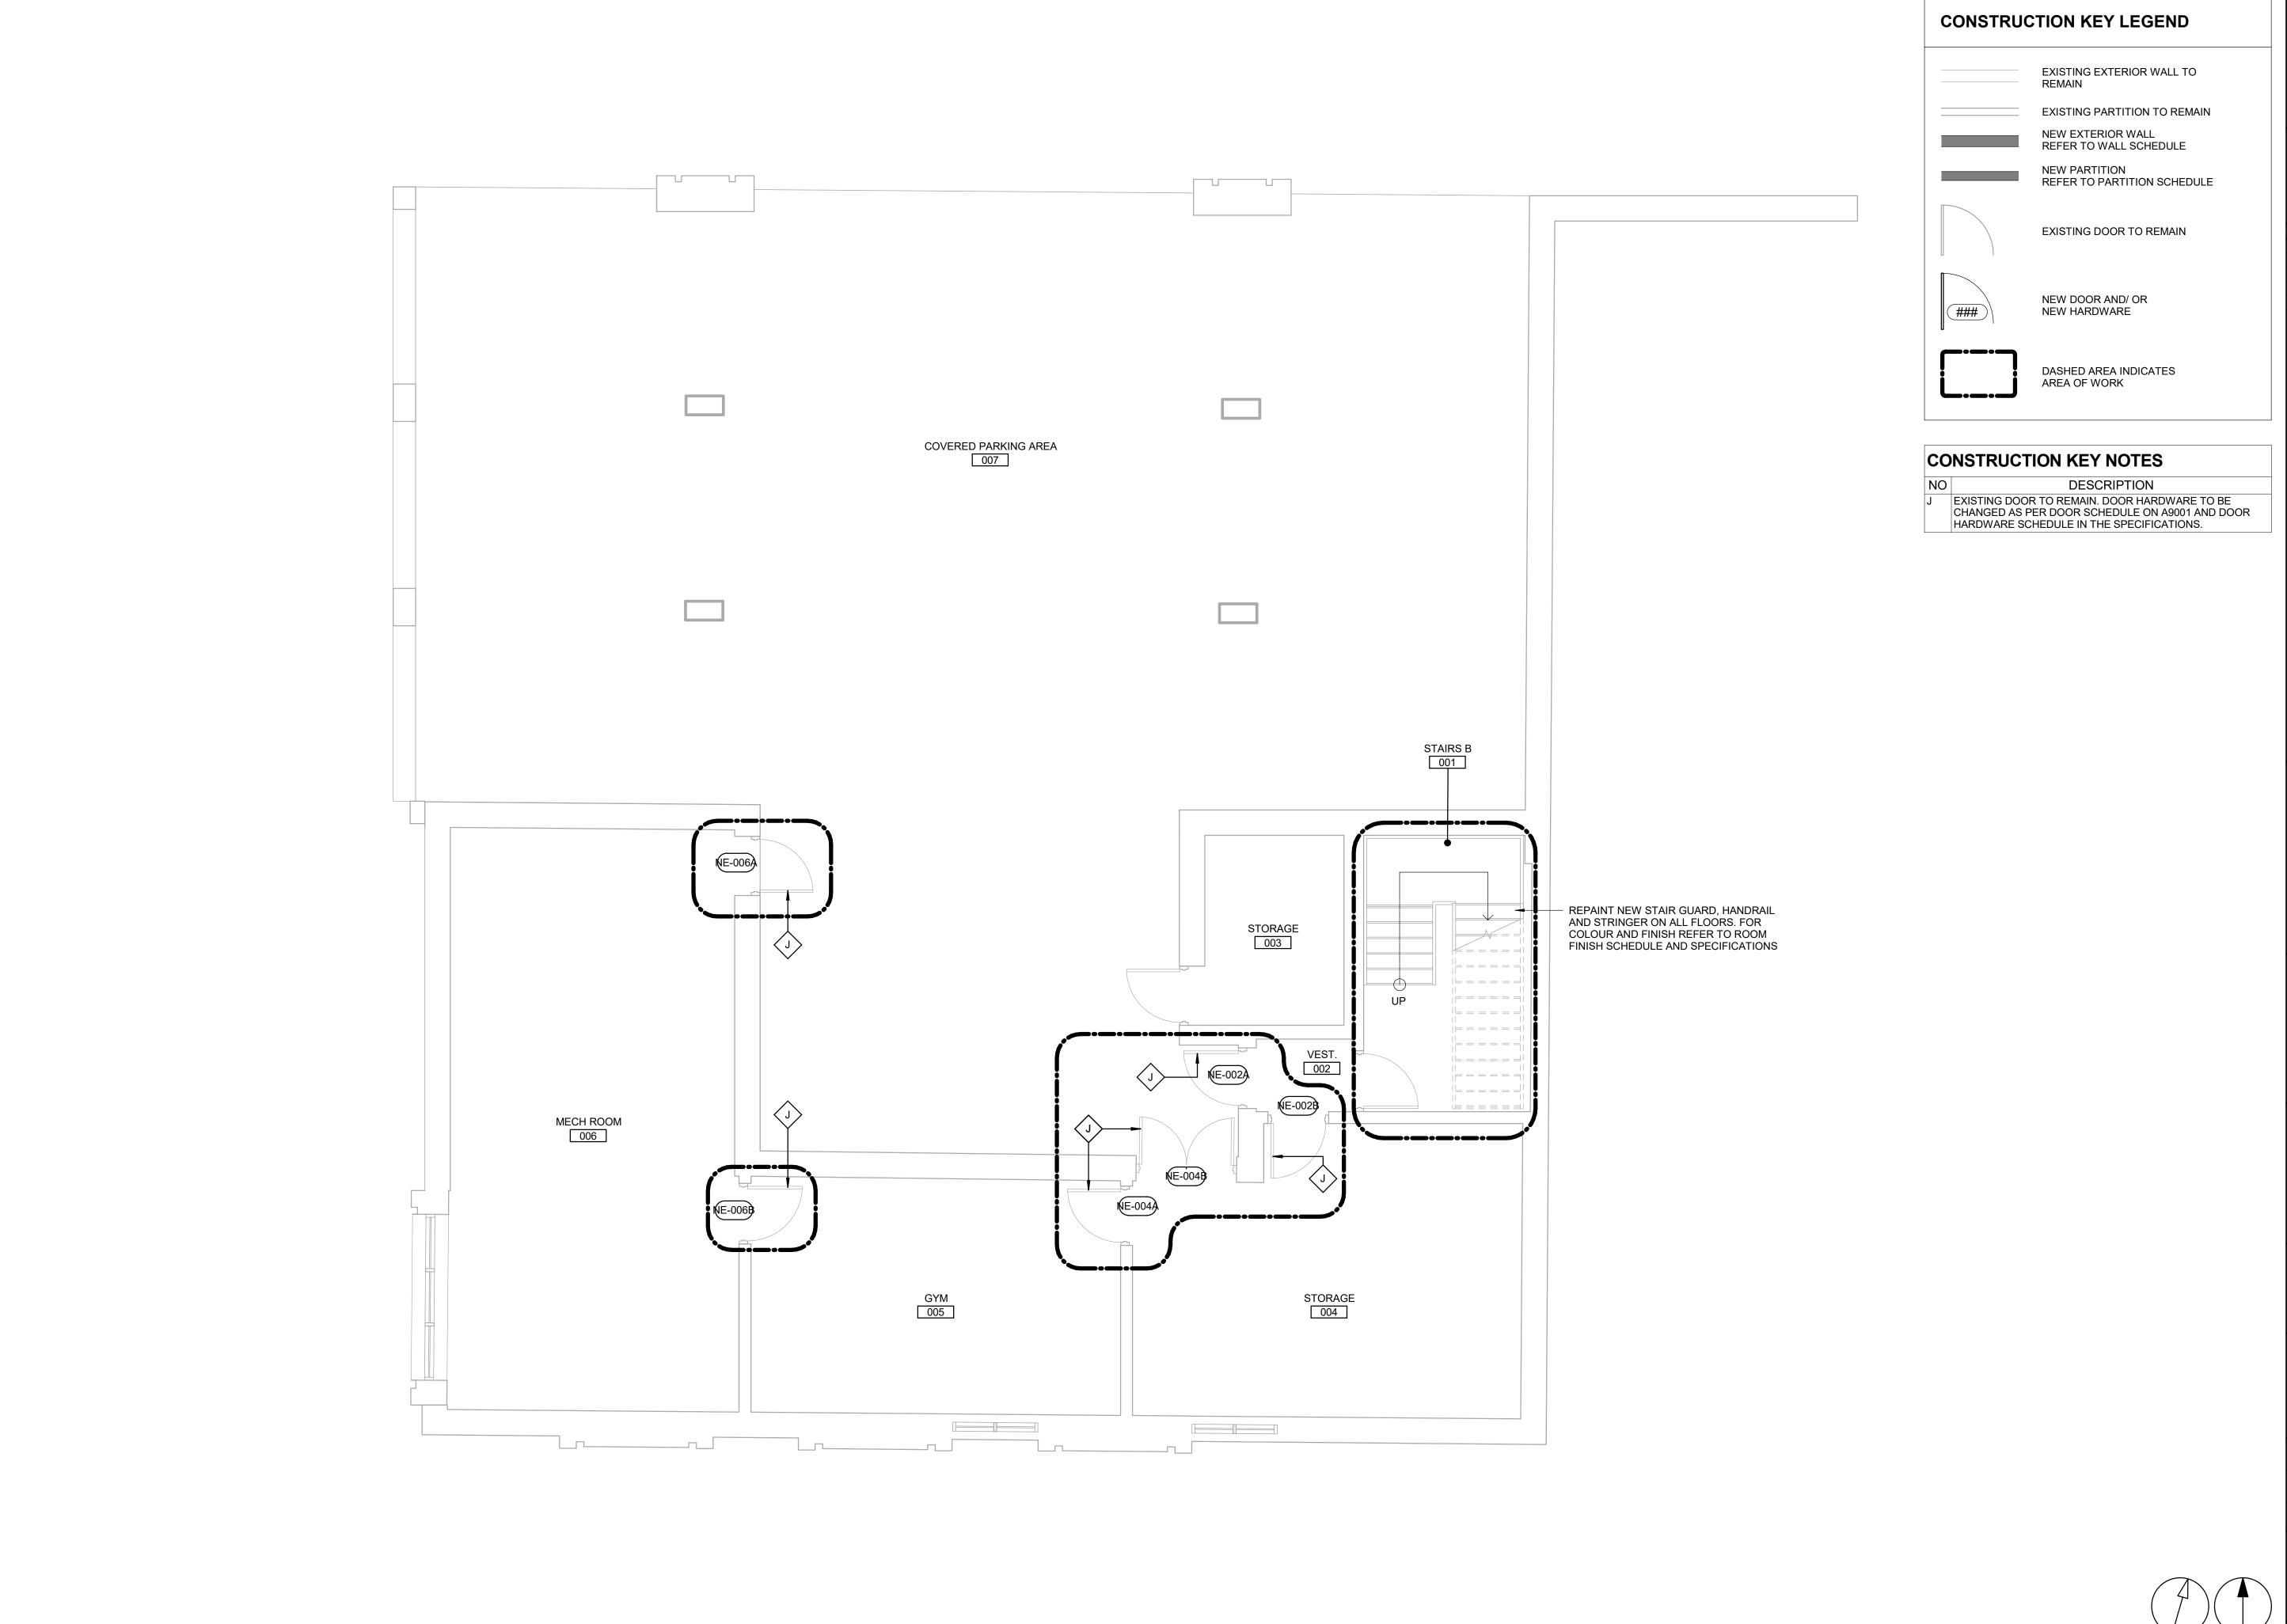
PROJECT MGR:
F. BOLOURIAN
SHEET TITLE

SECOND FLOOR STAGING PLAN

APPROVED BY: **E. FENUTA** 

SHEET NUMBER G05-001-A2121





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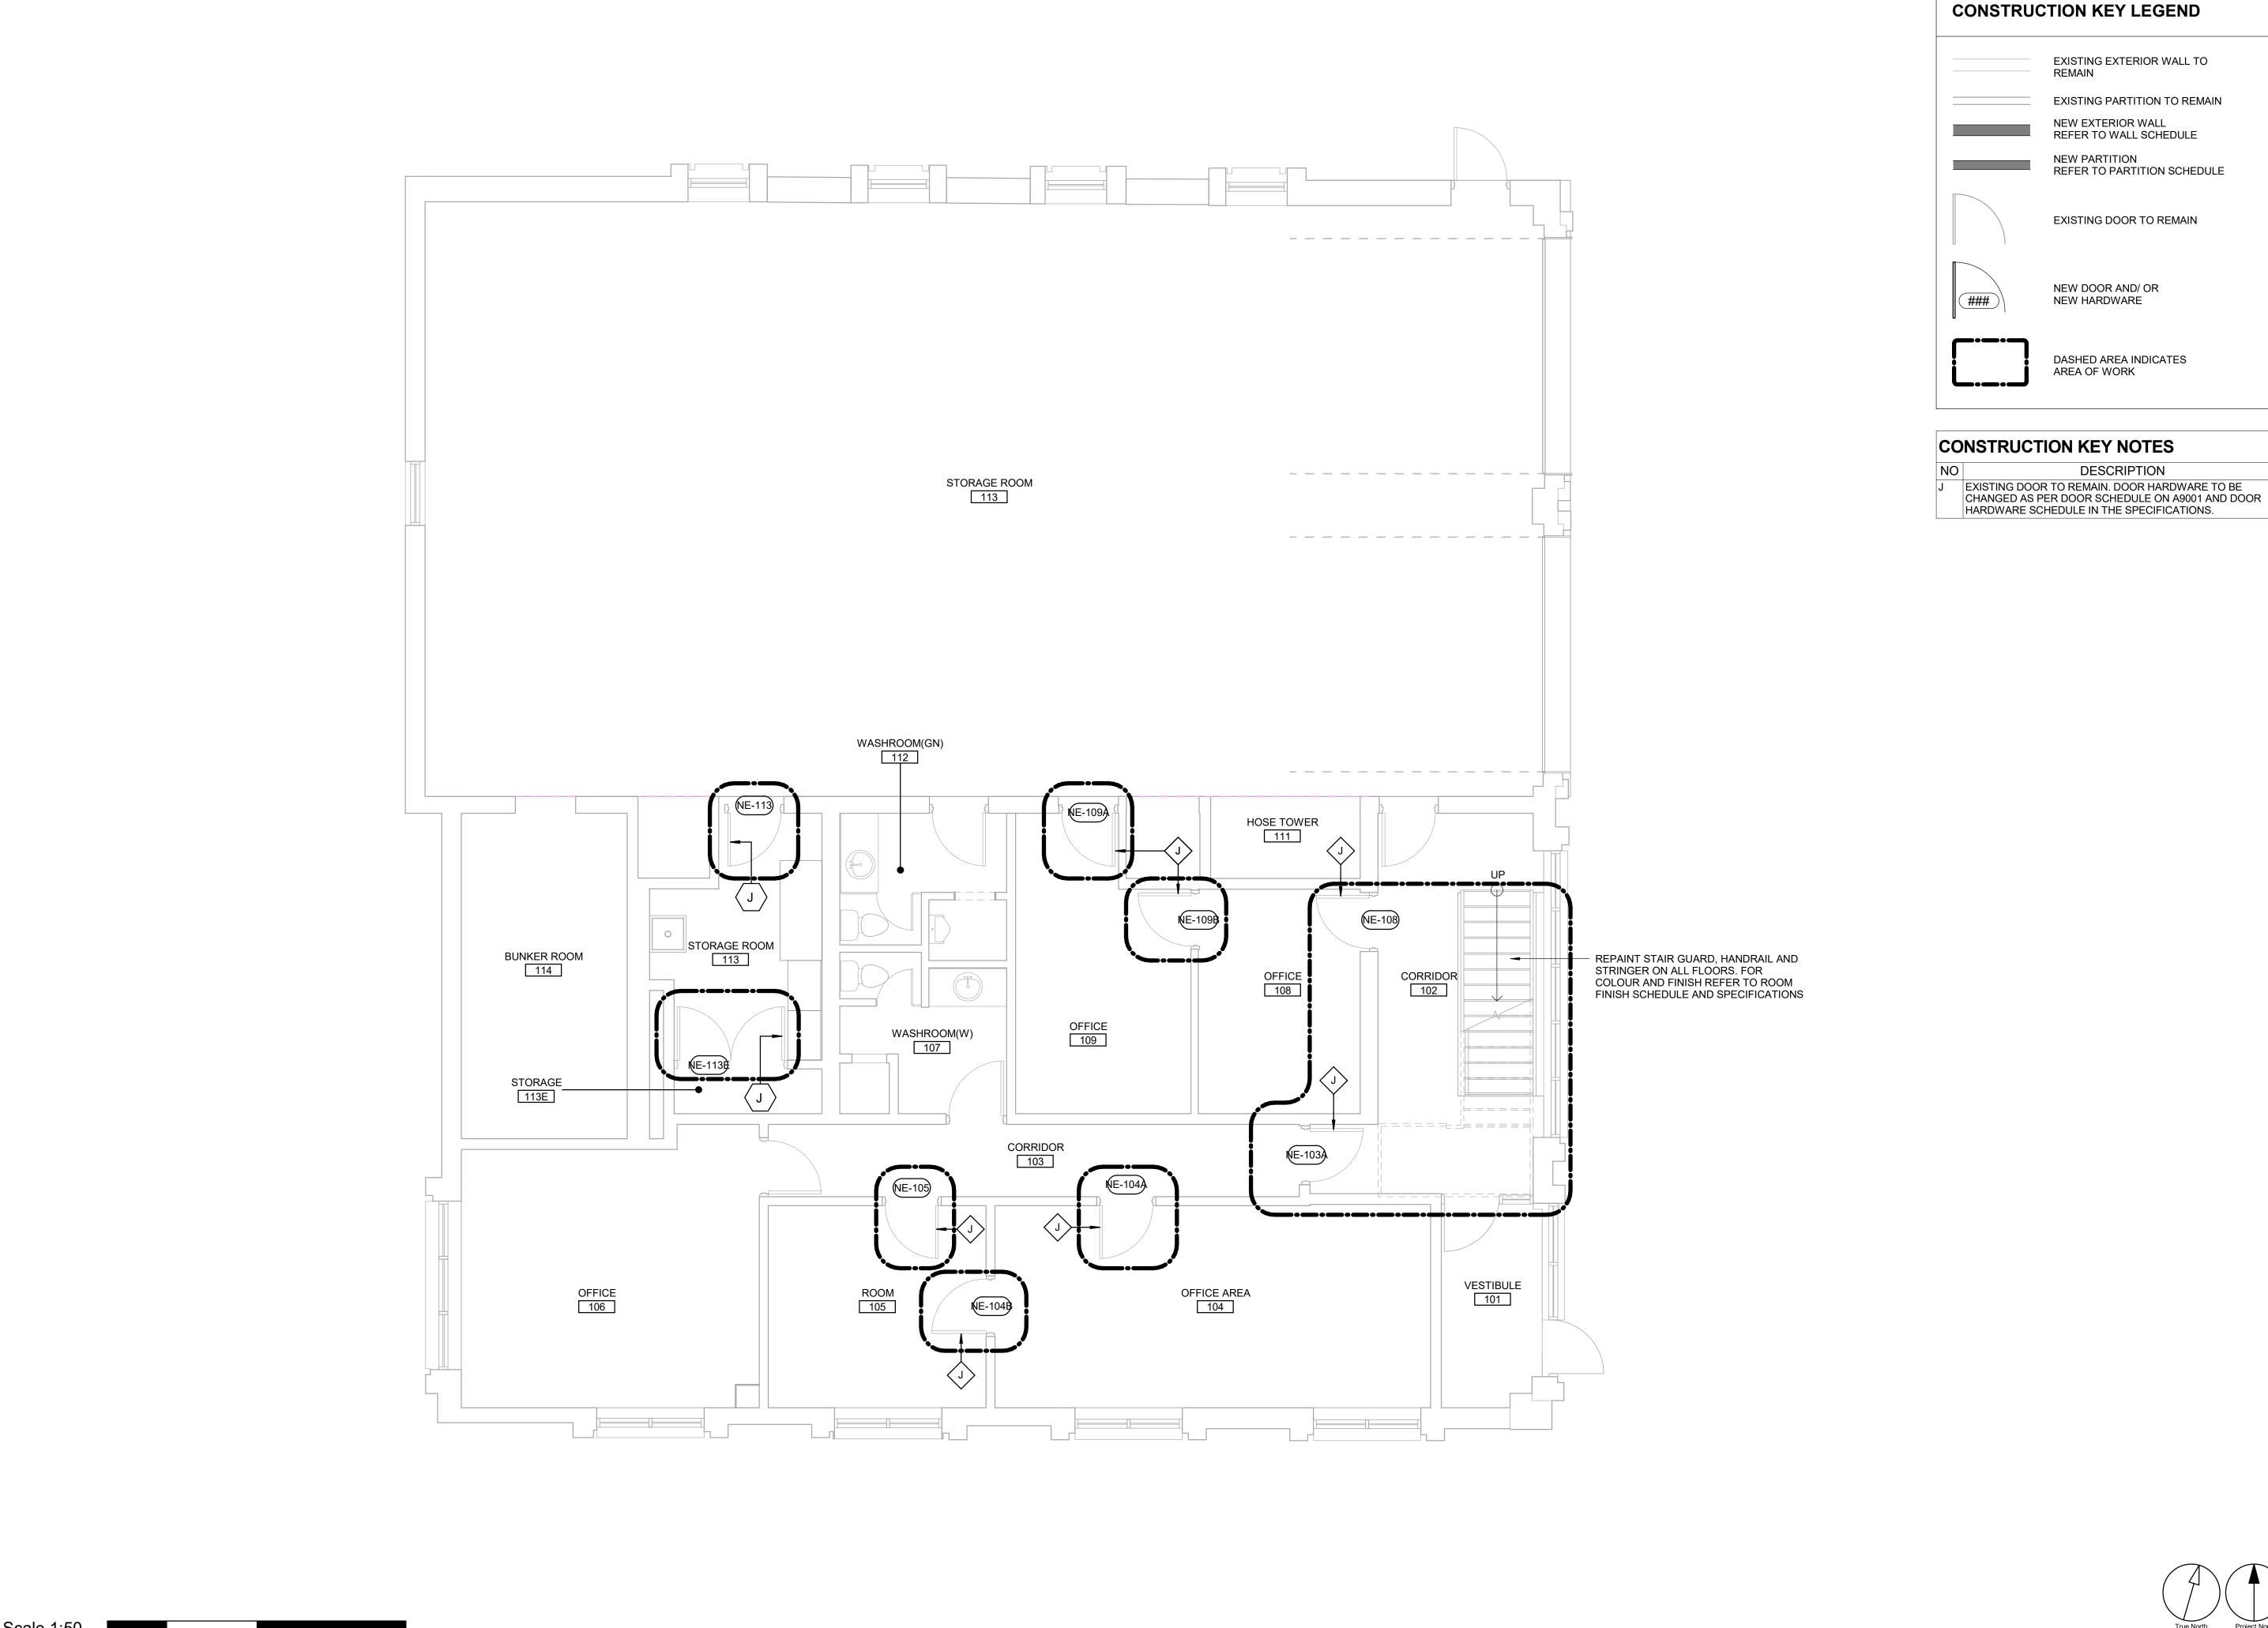
PROJECT NO: 9119-19-0162 / Arcadis 30279056

DRAWN BY: K. TILAHUN A. SUNIL PROJECT MGR: APPROVED BY: E. FENUTA

F. BOLOURIAN SHEET TITLE

BASEMENT PROPOSED PLAN

G05-001-A2401



CONSTRUCTION KEY LEGEND

EXISTING EXTERIOR WALL TO

EXISTING PARTITION TO REMAIN

NEW EXTERIOR WALL REFER TO WALL SCHEDULE

**NEW PARTITION** REFER TO PARTITION SCHEDULE

EXISTING DOOR TO REMAIN

**CONSTRUCTION KEY NOTES** 

DESCRIPTION

HARDWARE SCHEDULE IN THE SPECIFICATIONS.

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9119-19-0162 / Arcadis 30279056							
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A. SUNIL	K. TILAHUN						

F. BOLOURIAN SHEET TITLE

PROJECT MGR:


FIRST FLOOR PROPOSED PLAN

SHEET NUMBER

G05-001-A2411 D

APPROVED BY:

E. FENUTA

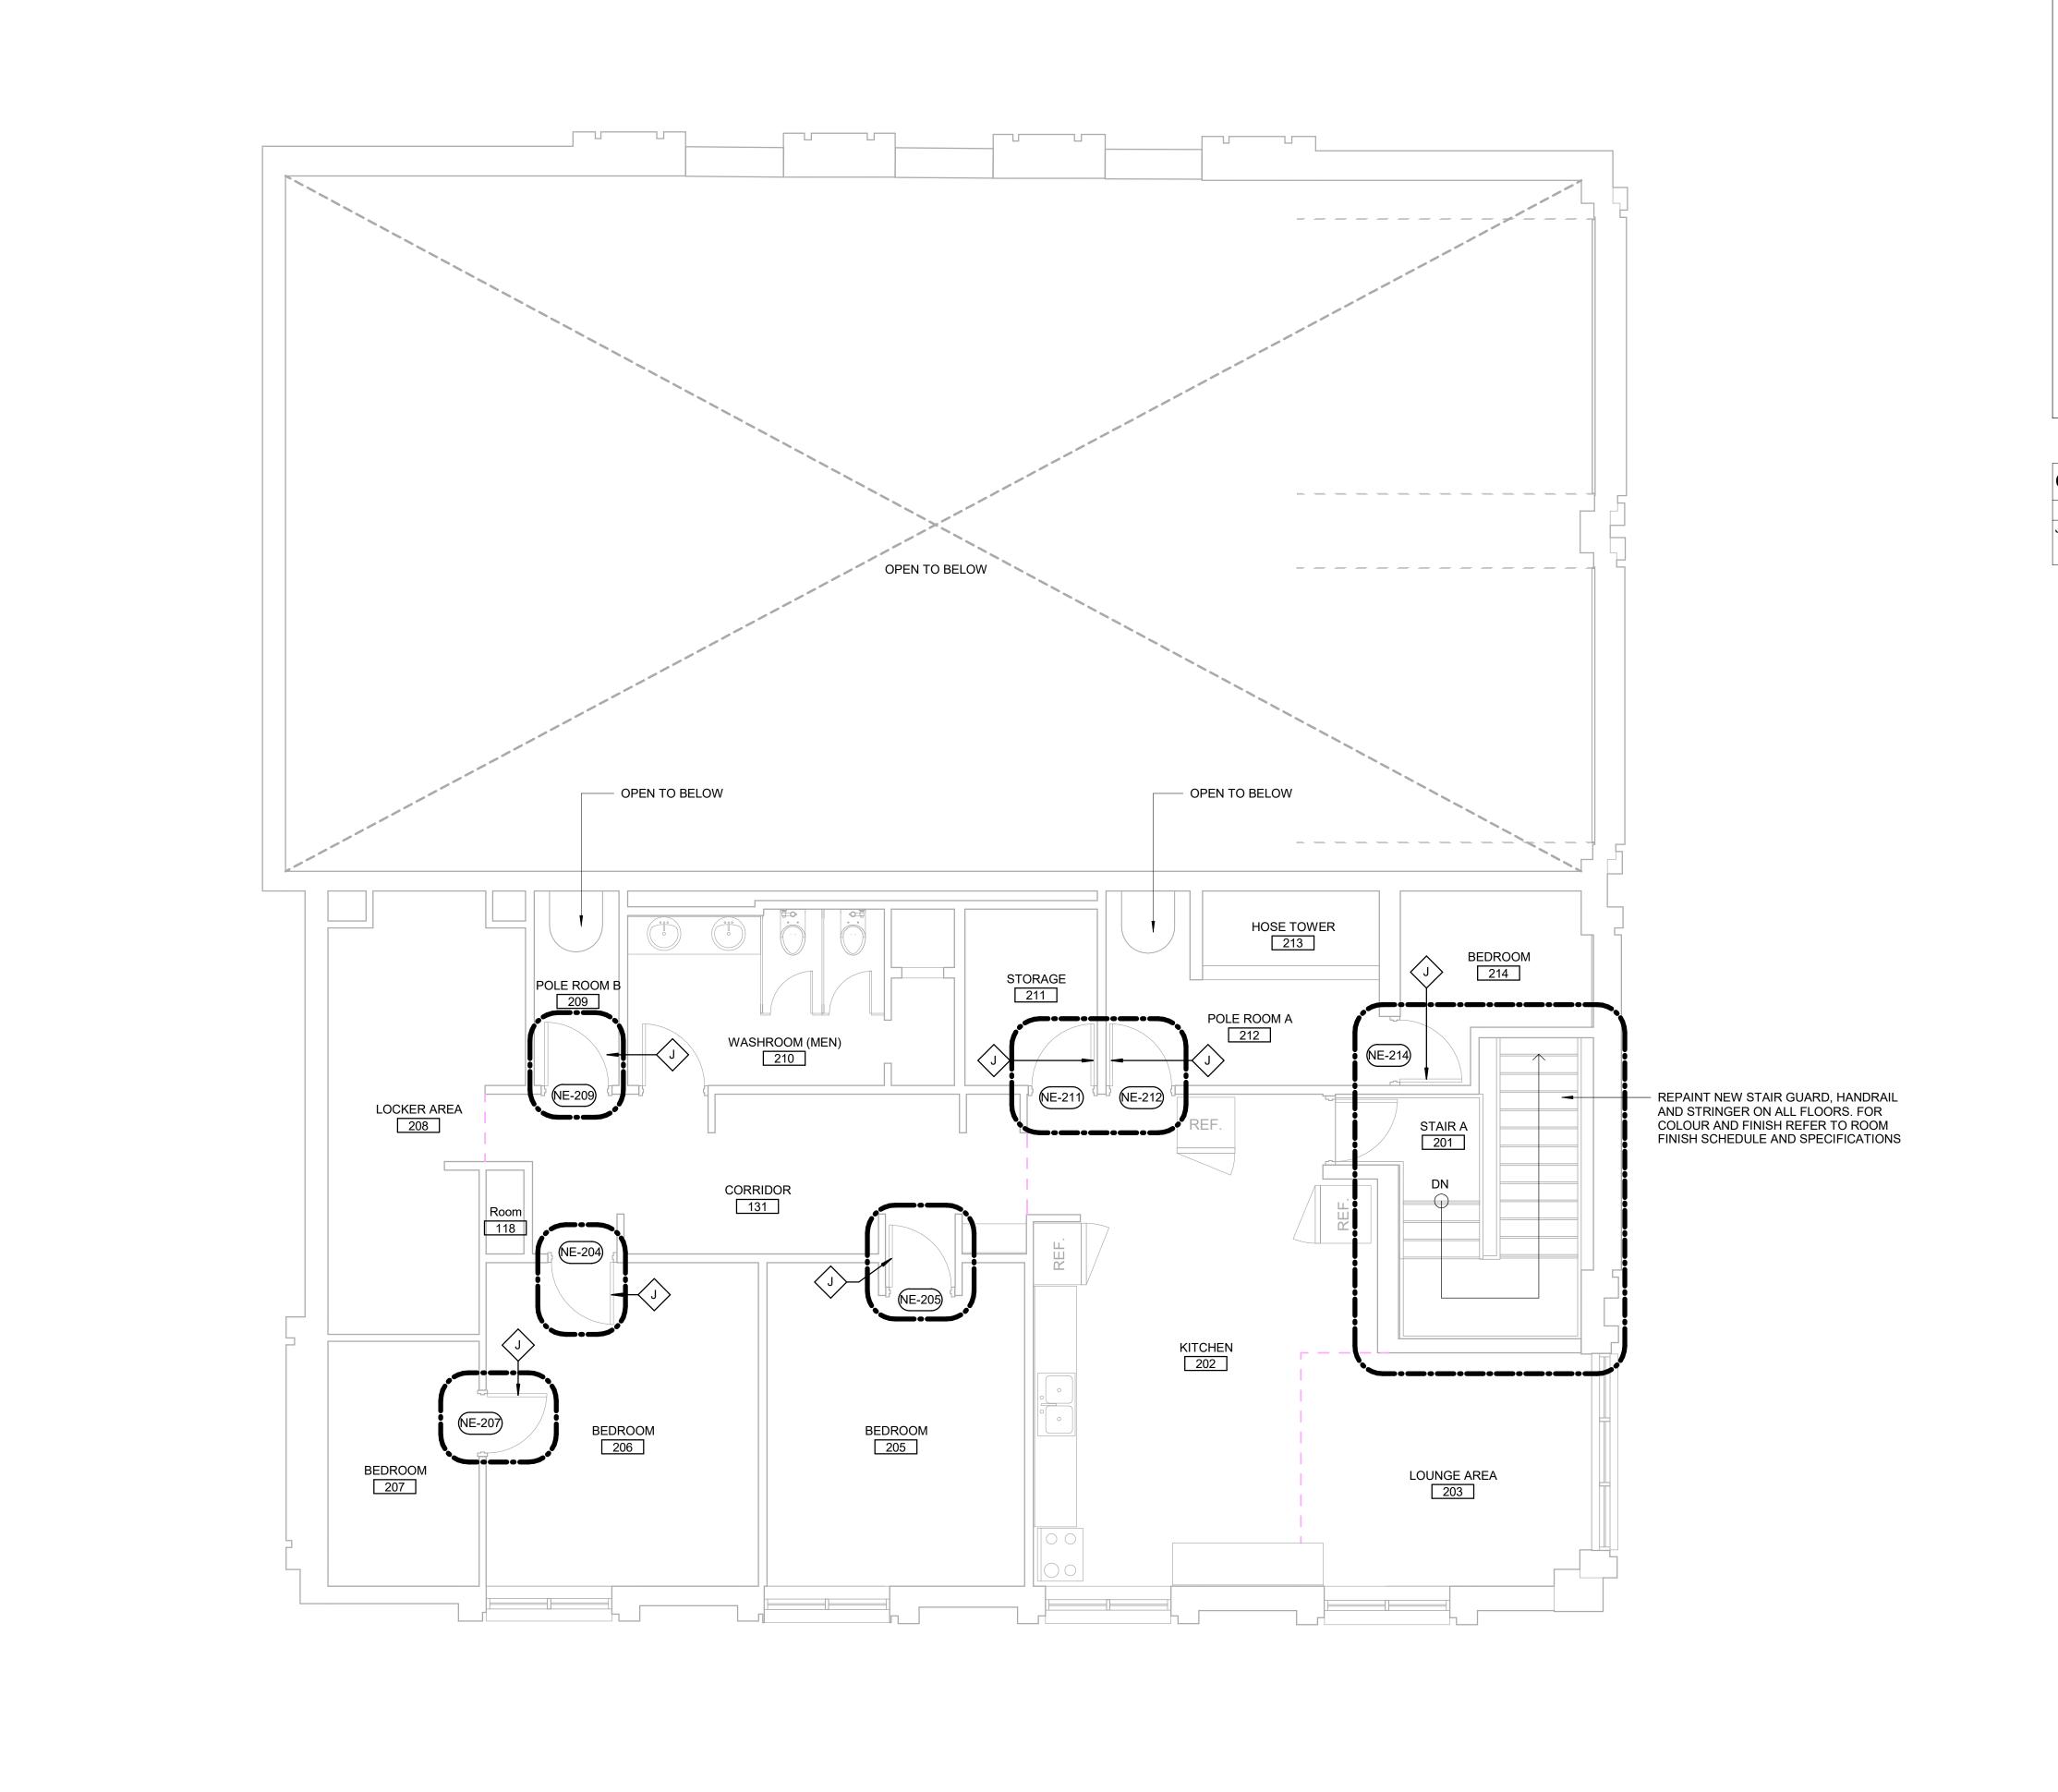



EXISTING EXTERIOR WALL TO REMAIN

EXISTING PARTITION TO REMAIN NEW EXTERIOR WALL REFER TO WALL SCHEDULE

**NEW PARTITION** REFER TO PARTITION SCHEDULE

EXISTING DOOR TO REMAIN

NEW DOOR AND/ OR **NEW HARDWARE** 

(###)

DASHED AREA INDICATES AREA OF WORK

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#### CONSTRUCTION KEY NOTES

DESCRIPTION J EXISTING DOOR TO REMAIN. DOOR HARDWARE TO BE CHANGED AS PER DOOR SCHEDULE ON A9001 AND DOOR HARDWARE SCHEDULE IN THE SPECIFICATIONS.

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PROJECT MGR: APPROVED BY: F. BOLOURIAN E. FENUTA SHEET TITLE

SECOND FLOOR PROPOSED PLAN

SHEET NUMBER

G05-001-A2421

DOOR SCHEDULE																
DOOR							PANEL		FRA	AME	D	OOR HARDWAF	RE			
DOOR NO.	LOCATION	TYPE	WIDTH	HEIGHT	THICKNESS	MAT.	FIN.	GLASS	MAT.	FIN.	SECURITY ACCESS CONTROL DEVICE	BFPB/BFWO/ BFAO	PANIC DEVICE	FIRE RATING (MINUTES)	SIGN	REMARKS
BASEMENT	-	'														
NE-002A	VEST.	EXIST	EXIST.	EXIST.	EXIST.	EXIST	PT-3	EXIST	EXIST	PT-3	EXIST	EXIST	EXIST	EXIST	EXIST	REPLACE EXISTING LATCH SET WITH LEVER TYPE HARDWARE
NE-002B	VEST.	EXIST	EXIST.	EXIST.	EXIST.	EXIST	PT-3	EXIST	EXIST	PT-3	EXIST	EXIST	EXIST	EXIST	EXIST	REPLACE EXISTING LATCH SET WITH LEVER TYPE HARDWARE
NE-004A	STORAGE	EXIST	EXIST.	EXIST.	EXIST.	EXIST	PT-3	EXIST	EXIST	PT-3	EXIST	EXIST	EXIST	EXIST	EXIST	REPLACE EXISTING LATCH SET WITH LEVER TYPE HARDWARE
NE-004B	STORAGE	EXIST	EXIST.	EXIST.	EXIST.	EXIST	PT-3	EXIST	EXIST	PT-3	EXIST	EXIST	EXIST	EXIST	EXIST	REPLACE EXISTING LATCH SET WITH LEVER TYPE HARDWARE
NE-006A	MECH ROOM	EXIST	EXIST.	EXIST.	EXIST.	EXIST	PT-3	EXIST	EXIST	PT-3	EXIST	EXIST	EXIST	EXIST	EXIST	REPLACE EXISTING LATCH SET WITH LEVER TYPE HARDWARE
NE-006B	MECH ROOM	EXIST	EXIST.	EXIST.	EXIST.	EXIST	PT-3	EXIST	EXIST	PT-3	EXIST	EXIST	EXIST	EXIST	EXIST	REPLACE EXISTING LATCH SET WITH LEVER TYPE HARDWARE
FIRST FLOOR																
NE-103A	CORRIDOR	EXIST	EXIST.	EXIST.	EXIST.	EXIST	PT-3	EXIST	EXIST	PT-3	EXIST	EXIST	EXIST	EXIST	EXIST	REPLACE EXISTING LATCH SET WITH LEVER TYPE HARDWARE
NE-104A	CORRIDOR	EXIST	EXIST.	EXIST.	EXIST.	EXIST	PT-3	EXIST	EXIST	PT-3	EXIST	EXIST	EXIST	EXIST	EXIST	REPLACE EXISTING LATCH SET WITH LEVER TYPE HARDWARE
NE-104B	OFFICE AREA	EXIST	EXIST.	EXIST.	EXIST.	EXIST	PT-3	EXIST	EXIST	PT-3	EXIST	EXIST	EXIST	EXIST	EXIST	REPLACE EXISTING LATCH SET WITH LEVER TYPE HARDWARE
NE-105	CORRIDOR	EXIST	EXIST.	EXIST.	EXIST.	EXIST	PT-3	EXIST	EXIST	PT-3	EXIST	EXIST	EXIST	EXIST	EXIST	REPLACE EXISTING LATCH SET WITH LEVER TYPE HARDWARE
NE-108	CORRIDOR	EXIST	EXIST.	EXIST.	EXIST.	EXIST	PT-3	EXIST	EXIST	PT-3	EXIST	EXIST	EXIST	EXIST	EXIST	REPLACE EXISTING LATCH SET WITH LEVER TYPE HARDWARE
NE-109A	OFFICE	EXIST	EXIST.	EXIST.	EXIST.	EXIST	PT-3	EXIST	EXIST	PT-3	EXIST	EXIST	EXIST	EXIST	EXIST	REPLACE EXISTING LATCH SET WITH LEVER TYPE HARDWARE
NE-109B	OFFICE	EXIST	EXIST.	EXIST.	EXIST.	EXIST	PT-3	EXIST	EXIST	PT-3	EXIST	EXIST	EXIST	EXIST	EXIST	REPLACE EXISTING LATCH SET WITH LEVER TYPE HARDWARE
NE-113	STORAGE ROOM	EXIST	EXIST	EXIST.	EXIST.	EXIST	PT-3	EXIST	EXIST	PT-3	EXIST	EXIST	EXIST	EXIST	EXIST	REPLACE EXISTING LATCH SET WITH LEVER TYPE HARDWARE
NE-113E	STORAGE	EXIST	EXIST	EXIST.	EXIST.	EXIST	PT-3	EXIST	EXIST	PT-3	EXIST	EXIST	EXIST	NA	EXIST	REPLACE EXISTING LATCH SET WITH LEVER TYPE HARDWARE
SECOND F	LOOR			•												
NE-204	BEDROOM	EXIST	EXIST.	EXIST.	EXIST.	EXIST	PT-3	EXIST	EXIST	PT-3	EXIST	EXIST	EXIST	EXIST	EXIST	REPLACE EXISTING LATCH SET WITH LEVER TYPE HARDWARE
NE-205	BEDROOM	EXIST	EXIST.	EXIST.	EXIST.	EXIST	PT-3	EXIST	EXIST	PT-3	EXIST	EXIST	EXIST	EXIST	EXIST	REPLACE EXISTING LATCH SET WITH LEVER TYPE HARDWARE
NE-207	BEDROOM	EXIST	EXIST.	EXIST.	EXIST.	EXIST	PT-3	EXIST	EXIST	PT-3	EXIST	EXIST	EXIST	EXIST	EXIST	REPLACE EXISTING LATCH SET WITH LEVER TYPE HARDWARE
NE-209	POLE ROOM B	EXIST	EXIST.	EXIST.	EXIST.	EXIST	PT-3	EXIST	EXIST	PT-3	EXIST	EXIST	EXIST	EXIST	EXIST	REPLACE EXISTING LATCH SET WITH LEVER TYPE HARDWARE
NE-211	KITCHEN	EXIST	EXIST.	EXIST.	EXIST.	EXIST	PT-3	EXIST	EXIST	PT-3	EXIST	EXIST	EXIST	EXIST	EXIST	REPLACE EXISTING LATCH SET WITH LEVER TYPE HARDWARE
NE-212	KITCHEN	EXIST	EXIST.	EXIST.	EXIST.	EXIST	PT-3	EXIST	EXIST	PT-3	EXIST	EXIST	EXIST	EXIST	EXIST	REPLACE EXISTING LATCH SET WITH LEVER TYPE HARDWARE
NE-214	POLE ROOM A	EXIST	EXIST.	EXIST.	EXIST.	EXIST	PT-3	EXIST	EXIST	PT-3	EXIST	EXIST	EXIST	EXIST	EXIST	REPLACE EXISTING LATCH SET WITH LEVER TYPE HARDWARE

	ROOM FINISH SCHEDULE																
DOOM		FLC	OOR	ВА	SE										CEILING		
ROOM NUMBER	ROOM NAME	MAT.	FIN.	MAT.	FIN.	NO	RTH	EA	ST	SO	JTH	WE	ST	MAT.	EINI	HEIGHT	
NOMBER	-N	MAI. FII	ΓIIN.	IVIA I .	FIIN.	MAT.	FIN.	MAT.	FIN.	MAT.	FIN.	MAT.	FIN.	IVIA I .	FIIN.	ПЕІВПІ	NOTES
BASEMENT							,										
001	STAIRS B	EXIST	EXIST	EXIST	EXIST	EXIST	EXIST	EXIST	EXIST	EXIST	EXIST	EXIST	EXIST	EXIST	EXIST	EXIST	PAINT STAIR GUARD, HANDRAIL AND STRINGER - PT-7.
FIRST FLOO	OR .																
102	CORRIDOR	EXIST	EXIST	EXIST	EXIST	EXIST	EXIST	EXIST	EXIST	EXIST	EXIST	EXIST	EXIST	EXIST	EXIST	EXIST	PAINT STAIR GUARD, HANDRAIL AND STRINGER - PT-7.
SECOND FI	_OOR																
201	STAIR A	EXIST	EXIST	EXIST	EXIST	EXIST	EXIST	EXIST	EXIST	EXIST	EXIST	EXIST	EXIST	EXIST	EXIST	EXIST	PAINT STAIR GUARD, HANDRAIL AND STRINGER - PT-7.

ROOM FINISH KEY SCHEDULE							
ABBRV	MATERIAL	COLOUR	FINISH	SIZE	REF	SUPPLIER	NOTES
PT-3	PAINT	MATCH EXISTING PAINT	TBD	N/A		BENJAMIN MOORE	GC TO PROVIDE SAMPLE ON 12"X12" CARD FOR APPROVAL. PAINT ENTIRE WALL OR CEILING AS SPECIFIED IN ROOM FINISH SCHEDULE.
PT-7	PAINT	HC-116 KENDALL CHARCOAL		N/A	HISTORICAL COLOURS	BENJAMIN MOORE	

#### DOOR SCHEDULE GENERAL NOTES

- DOOR HEIGHT IS FOR INFO ONLY DOOR HEIGHT TO MATCH EXISTING DOOR HEIGHT AND IS TO BE SITE MEASURED. REFER TO ELECTRICAL DRAWINGS FOR DOOR CARD
- READER LOCATION ON EXISTING DOORS. REFER TO DOOR HARDWARE SCHEDULE AND TO THE SPECIFICATIONS FOR A COMPLETE SET OF DOOR HARDWARE.

#### DOOR ABBREVIATIONS

*	DENOTES YES
ALUM	ALUMINUM
ANOD	ANODIZED
BFAO	BARRIER-FREE AUTOMATIC OPENER
BFPB	BARRIER-FREE PUSH BUTTON
BFWO	BARRIER-FREE WAVE TO OPEN
CR	CARD READER
EXIST	EXISTING
FBM	FINGER BIOMETRIC
GWB	GYPSUM WALL BOARD
GWG	GEORGIAN WIRE GLASS
HM	HOLLOW METAL
IHM	INSULATED HOLLOW METAL
ITGL	INSULATED TEMPERED (SAFETY) GLAS
KP	KEY PAD
OBM	OCULAR BIOMETRIC
PF	PRE FINISHED
PLAM	PLASTIC LAMINATE
PT	PAINT
SIM	SIMILAR
SS	STAINLESS STEEL
TGL	TEMPERED GLASS
WD	WOOD

WOOD

WD

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CITY OF TORONTO ACCESSIBILITY UPGRADES

PROJECT ADDRESS

FIRE HALL NO. 121 10 WILLIAM CARSON CRESCENT

PROJECT NO: 9119-19-0162 / Arcadis 30279056

CHECKED BY: K. TILAHUN DRAWN BY: A. SUNIL APPROVED BY: **E. FENUTA** PROJECT MGR:

F. BOLOURIAN SHEET TITLE

DOOR AND ROOM FINISH SCHEDULE

SHEET NUMBER G05-001-A9111 D

MECHANICAL DRAWING LIST			
Sheet			
Number	Sheet Name		
M0001	MECHANICAL DRAWING LIST		
M1001	DEMOLITION PLAN - BASEMENT		
M1101	DEMOLITION PLAN - GROUND FLOOR		
M2001	PLUMBING - BASEMENT		
M2101	PLUMBING - GROUND FLOOR		
M3001	DRAINAGE - BASEMENT		
M3101	DRAINAGE - GROUND FLOOR		
M5101	HVAC - GROUND FLOOR		

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PROJECT ADDRESS

FIRE HALL NO. 121 10 WILLIAM CARSON CRESCENT

PROJECT NO: Arcadis 30279056

CHECKED BY: B. LIAO DRAWN BY: K. DURUKAN PROJECT MGR: F. BOLOURIAN APPROVED BY: S. LIU

SHEET TITLE

MECHANICAL DRAWING LIST

SHEET NUMBER

G05-001-M0001 A

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PROJECT NO: Arcadis 30279056

DRAWN BY: CHECKED BY: K. DURUKAN B. LIAO PROJECT MGR: APPROVED BY:

SHEET TITLE

F. BOLOURIAN S. LIU **DEMOLITION PLAN -**

**BASEMENT** 

SHEET NUMBER G05-001-M1001

**GENERAL NOTES:** 

CONTRACTOR TO VERIFY SITE CONDITION.

REMOVE AND CAP EXISTING SERVICES AS SHOWN ON THE DRAWING.

ALL EXISTING SERVICES SHALL REMAIN UNLESS OTHERWISE NOTED.

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PROJECT NO: Arcadis 30279056 DRAWN BY: CHECKED BY: K. DURUKAN B. LIAO PROJECT MGR: APPROVED BY:

SHEET TITLE

F. BOLOURIAN S. LIU **DEMOLITION PLAN -**

GROUND FLOOR

SHEET NUMBER G05-001-M1101

**GENERAL NOTES:** 

CONTRACTOR TO VERIFY SITE CONDITION.
REMOVE AND CAP EXISTING SERVICES AS SHOWN ON THE DRAWING.
ALL EXISTING SERVICES SHALL REMAIN UNLESS OTHERWISE NOTED.

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Arcadis Professional Services (Canada) Inc.

DESCRIPTION DATE

CONSULTANTS

PRIME CONSULTANT



100 - 175 Galaxy Blvd, Toronto, ON M9W 0C9, Canada tel 416 679 1930 www.arcadis.com

PROJECT TITLE CITY OF TORONTO ACCESSIBILITY UPGRADES

PROJECT ADDRESS

FIRE HALL NO. 121 10 WILLIAM CARSON CRESCENT

PROJECT NO: Arcadis 30279056 DRAWN BY: CHECKED BY: K. DURUKAN B. LIAO PROJECT MGR: APPROVED BY: S. LIU

F. BOLOURIAN

SHEET TITLE PLUMBING - BASEMENT

SHEET NUMBER G05-001-M2001

REFER TO SPECIFICATIONS FOR PLUMBING FIXTURE UNIT TYPES. ALL NEW FIXTURES TO BE FITTED WITH ISOLATION VALVES.

\_\_\_\_\_ ------------ CLIENT

# CITY OF TORONTO

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PROJECT TITLE CITY OF TORONTO ACCESSIBILITY UPGRADES

PROJECT ADDRESS

FIRE HALL NO. 121 10 WILLIAM CARSON CRESCENT

PROJECT NO: Arcadis 30279056

DRAWN BY: CHECKED BY: K. DURUKAN B. LIAO PROJECT MGR: APPROVED BY:

F. BOLOURIAN SHEET TITLE

PLUMBING - GROUND

FLOOR

S. LIU

SHEET NUMBER G05-001-M2101

REFER TO SPECIFICATIONS FOR PLUMBING FIXTURE UNIT TYPES. ALL NEW FIXTURES TO BE FITTED WITH ISOLATION VALVES.

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PROJECT TITLE CITY OF TORONTO ACCESSIBILITY UPGRADES

PROJECT ADDRESS

FIRE HALL NO. 121 10 WILLIAM CARSON CRESCENT

PROJECT NO:

Arcadis 30279056 DRAWN BY: CHECKED BY: K. DURUKAN B. LIAO PROJECT MGR: APPROVED BY: S. LIU

F. BOLOURIAN SHEET TITLE

DRAINAGE - BASEMENT

SHEET NUMBER G05-001-M3001

REFER TO SPECIFICATIONS FOR PLUMBING FIXTURE UNIT TYPES.

PROVIDE SANITARY VENT FOR EACH NEW PLUMBING FIXTURE AND CONNECT TO EXISTING SANITARY VENT MAIN. PROVIDE P-TRAP FOR EACH PLUMBING FIXTURE AS PER OBC.

ALL NEW FLOOR DRAINS SHALL BE C/W P-TRAP AND PRIMER.

PROVIDE FIRE STOP FOR ALL PIPE PENETRATIONS THROUGH FIRE SEPERATIONS. ALL UNDERGROUND SANITARY PIPING SHALL BE MINIMUM 75mmØ UNLESS OTHERWISE NOTED.

-----

CLIENT

## CITY OF TORONTO

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Arcadis Professional Services (Canada) Inc.

ISSUES DESCRIPTION DATE

CONSULTANTS

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PROJECT TITLE CITY OF TORONTO ACCESSIBILITY UPGRADES

PROJECT ADDRESS

FIRE HALL NO. 121 10 WILLIAM CARSON CRESCENT

PROJECT NO: Arcadis 30279056 DRAWN BY: CHECKED BY: K. DURUKAN B. LIAO PROJECT MGR: APPROVED BY:

F. BOLOURIAN SHEET TITLE

S. LIU DRAINAGE - GROUND

FLOOR

SHEET NUMBER G05-001-M3101

REFER TO SPECIFICATIONS FOR PLUMBING FIXTURE UNIT TYPES.

PROVIDE SANITARY VENT FOR EACH NEW PLUMBING FIXTURE AND CONNECT TO EXISTING SANITARY VENT MAIN.

PROVIDE P-TRAP FOR EACH PLUMBING FIXTURE AS PER OBC. ALL NEW FLOOR DRAINS SHALL BE C/W P-TRAP AND PRIMER.

PROVIDE FIRE STOP FOR ALL PIPE PENETRATIONS THROUGH FIRE SEPERATIONS. ALL UNDERGROUND SANITARY PIPING SHALL BE MINIMUM 75mmø UNLESS OTHERWISE NOTED.

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PROJECT TITLE
CITY OF TORONTO ACCESSIBILITY UPGRADES

PROJECT ADDRESS

FIRE HALL NO. 121 10 WILLIAM CARSON CRESCENT

PROJECT NO: Arcadis 30279056 DRAWN BY: CHECKED BY: K. DURUKAN B. LIAO APPROVED BY: **S. LIU** PROJECT MGR:

F. BOLOURIAN SHEET TITLE

HVAC - GROUND FLOOR

SHEET NUMBER G05-001-M5101

GENERAL NOTES:
1. ADD AND ADJUST DUCTS TO FIT NEW DIFFUSERS/GRILLES.
2. THERMOSTATS TO BE MOUNTED AT 1200mm A.F.F.